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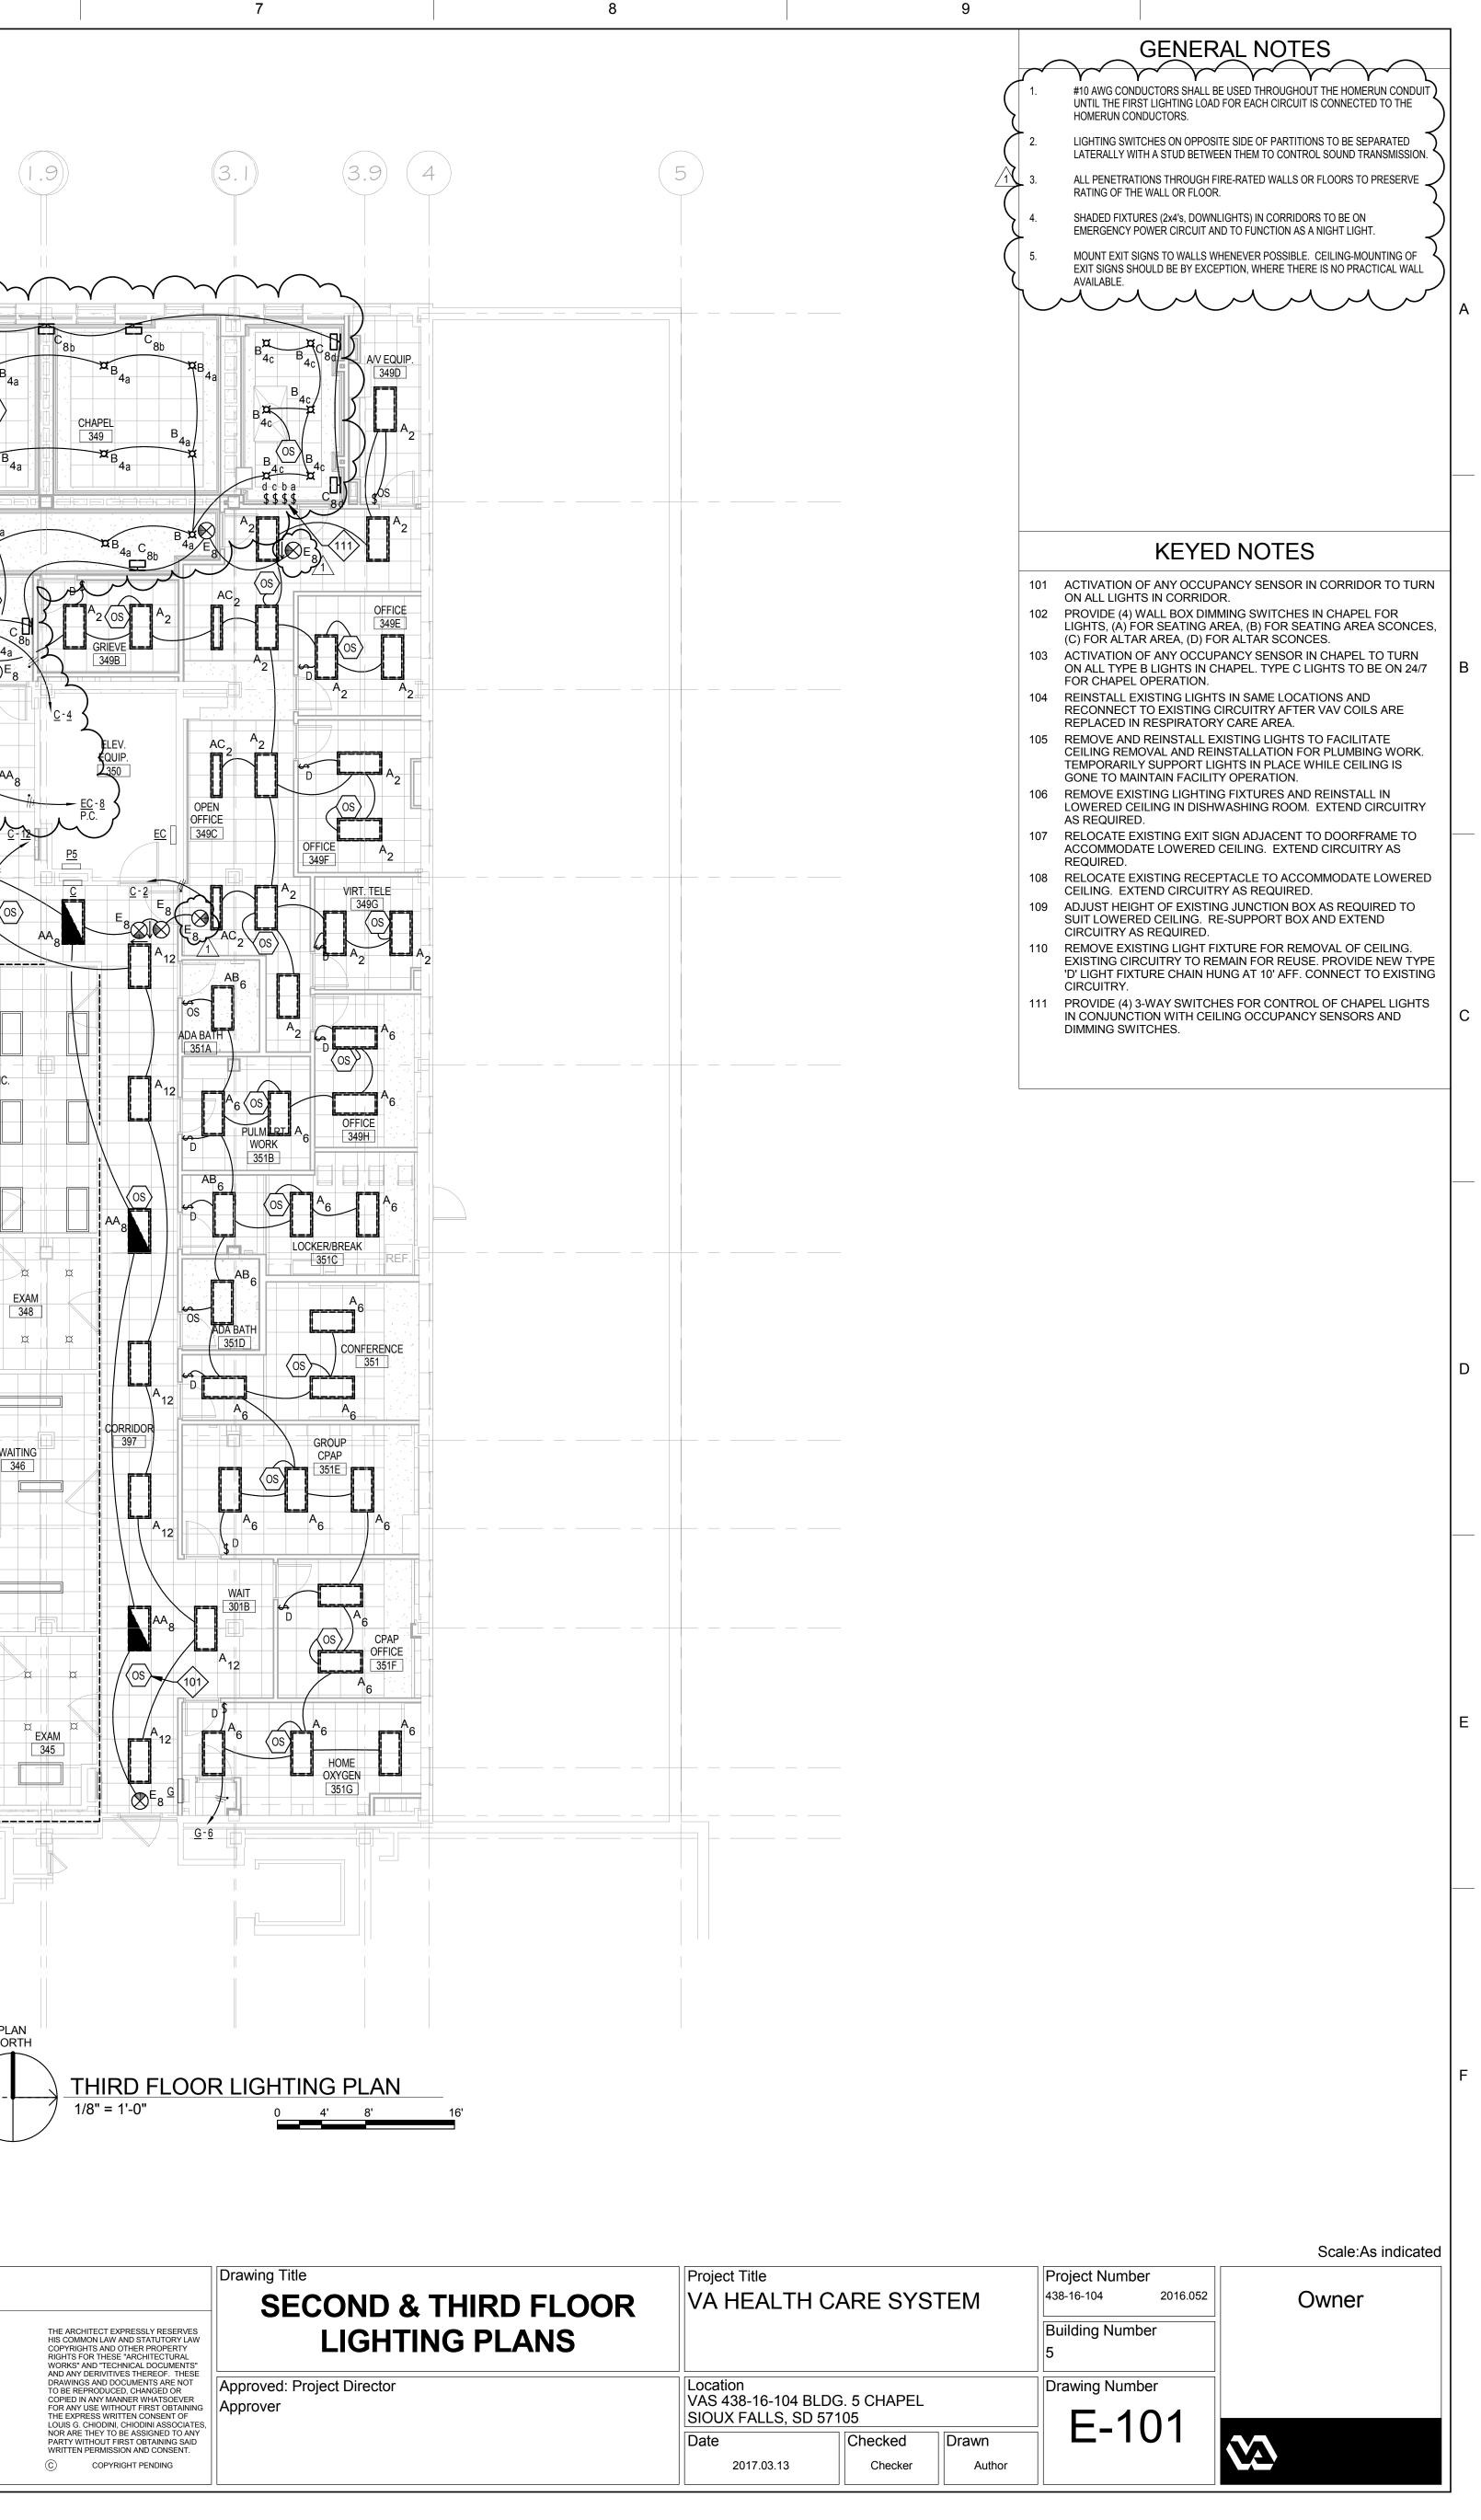
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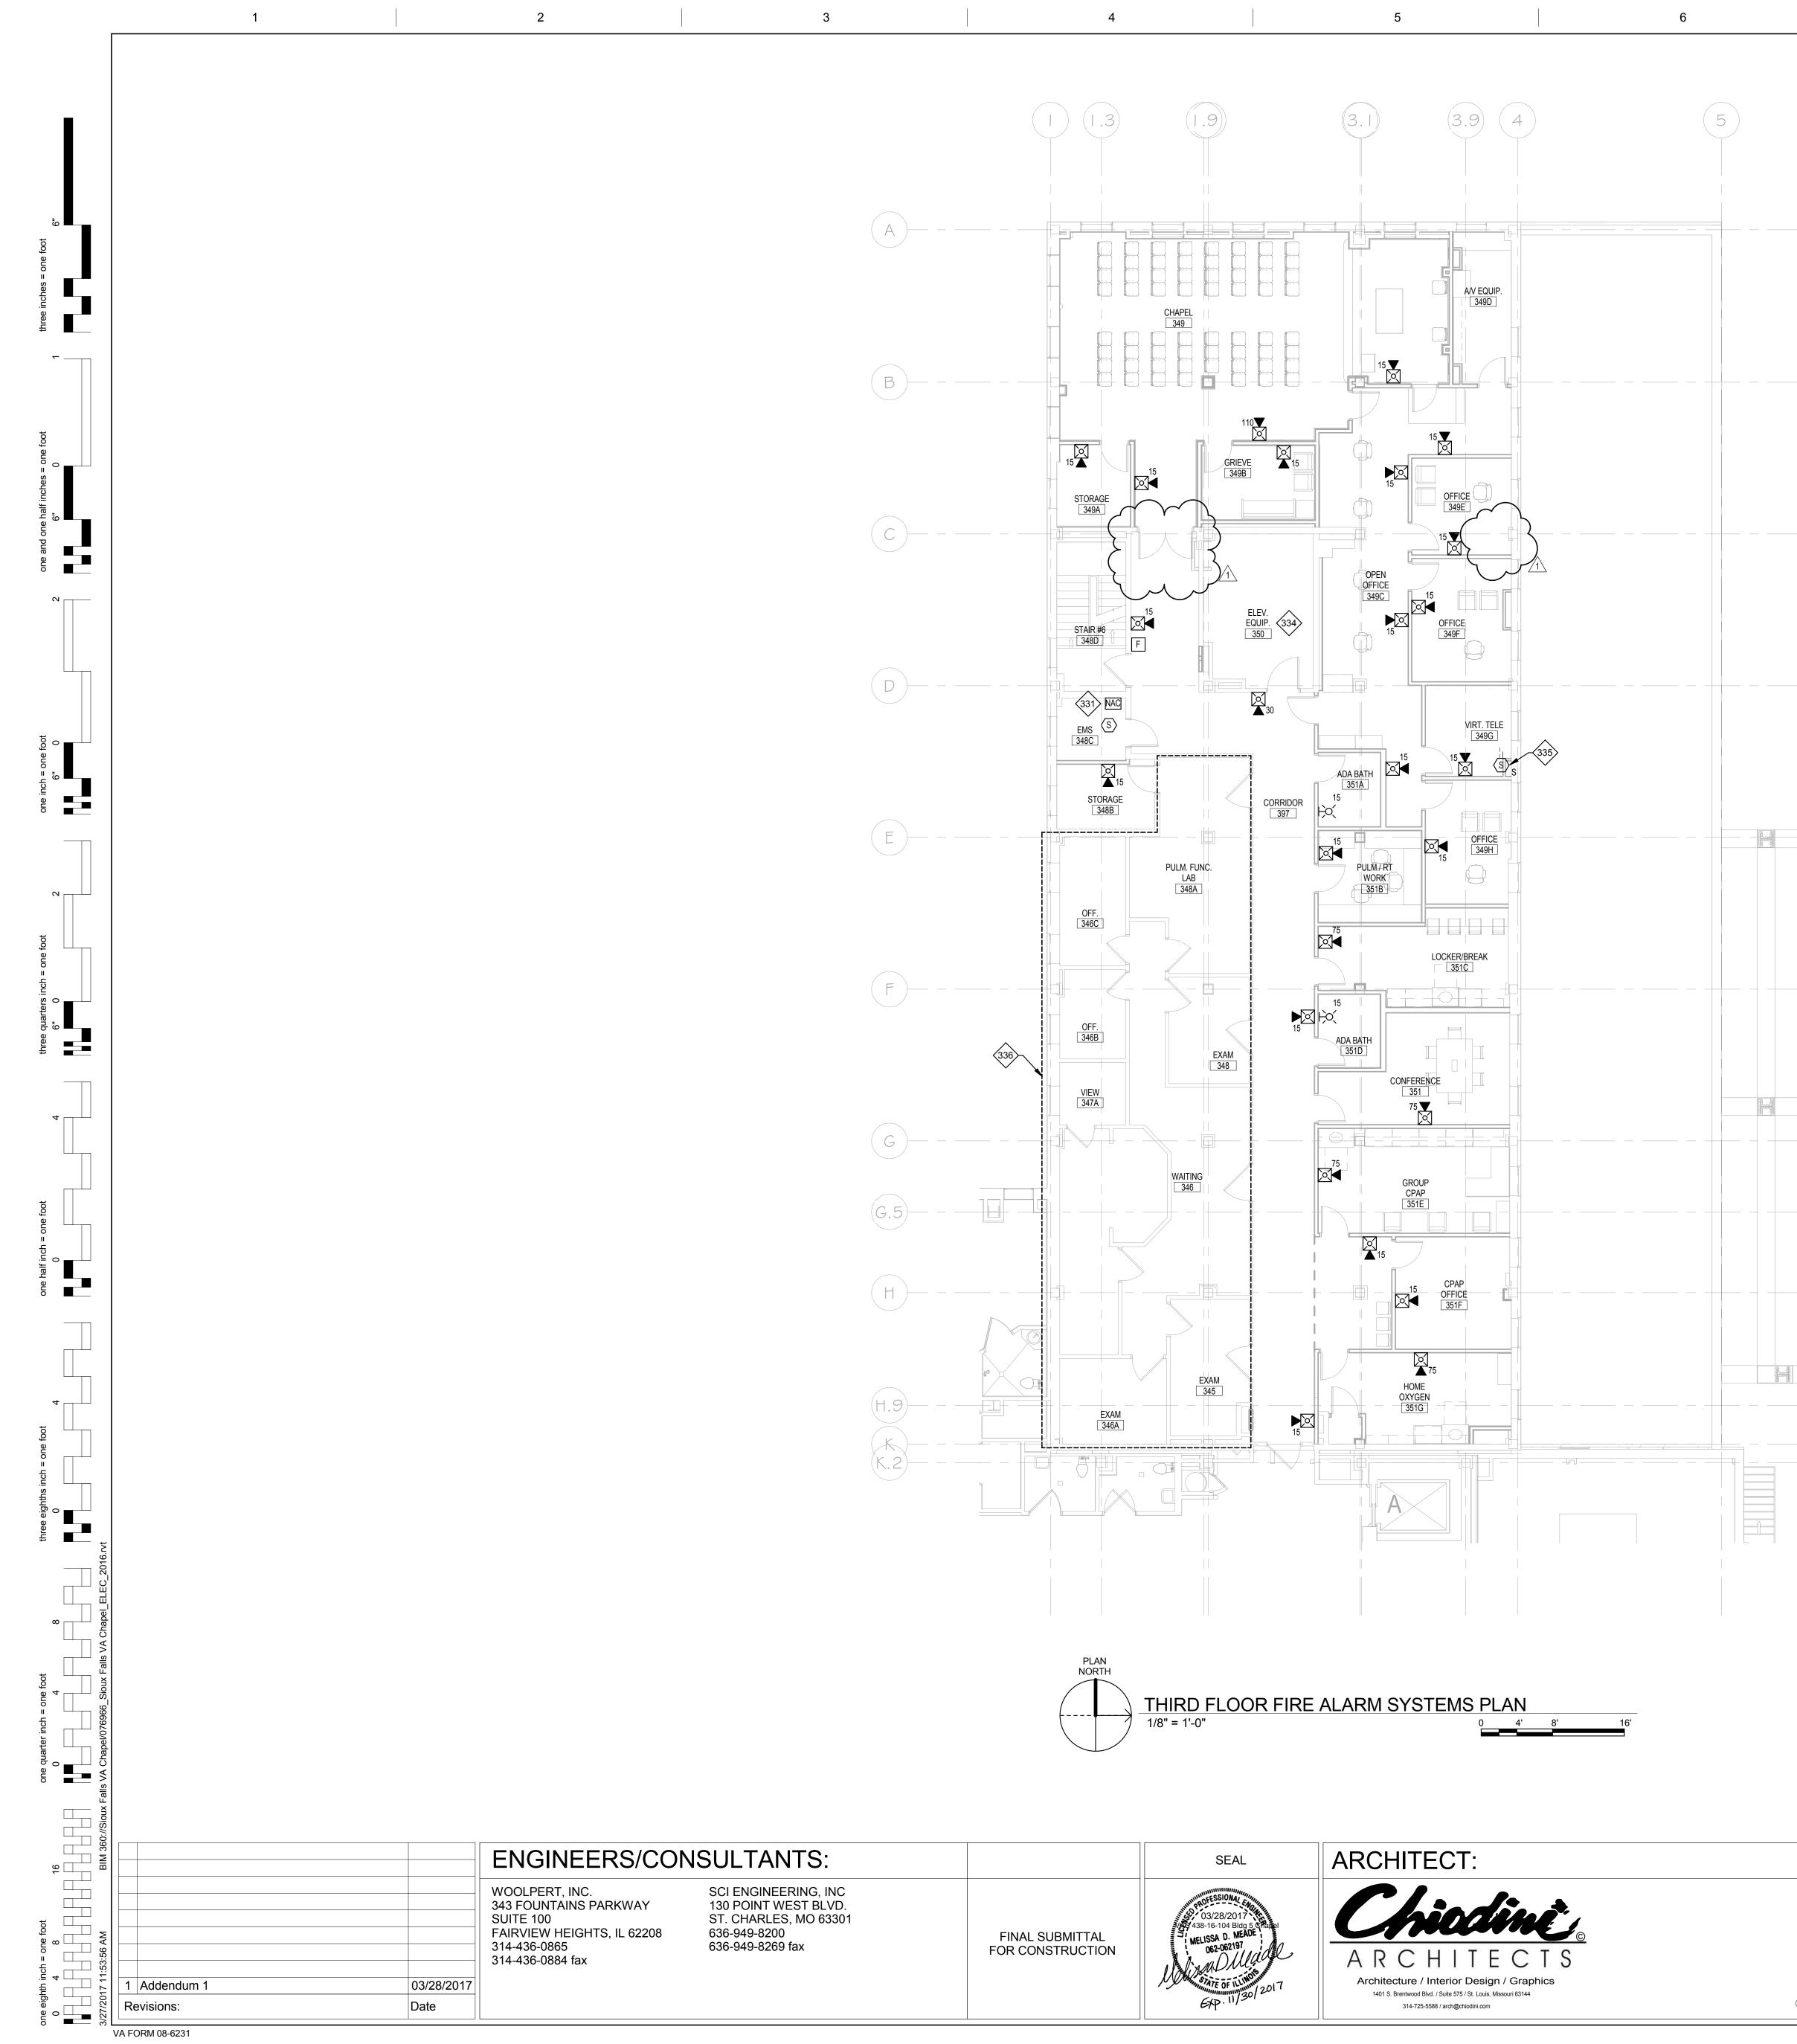
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		Drawing Title SECOND & THIRD FLOOR LIGHTING PLANS		Project Title VA HEALTH CARE SYSTEM Location VAS 438-16-104 BLDG. 5 CHAPEL SIOUX FALLS, SD 57105			Project Num 438-16-104	
•	THE ARCHITECT EXPRESSLY RESERVES HIS COMMON LAW AND STATUTORY LAW COPYRIGHTS AND OTHER PROPERTY RIGHTS FOR THESE "ARCHITECTURAL WORKS" AND "TECHNICAL DOCUMENTS"						Building Nur 5	
S	AND ANY DERIVITIVES THEREOF. THESE DRAWINGS AND DOCUMENTS ARE NOT TO BE REPRODUCED, CHANGED OR COPIED IN ANY MANNER WHATSOEVER FOR ANY USE WITHOUT FIRST OBTAINING THE EXPRESS WRITTEN CONSENT OF LOUIS C. CHIODINI, CHIODINI ASSOCIATES,	Approved: Project Director Approver					Drawing Nu	
3	NOR ARE THEY TO BE ASSIGNED TO ANY PARTY WITHOUT FIRST OBTAINING SAID WRITTEN PERMISSION AND CONSENT. C COPYRIGHT PENDING			Date 2017.03.13	Checked Checker	Drawn Author		
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VA FIRE PROTECTION DESIGN MANUAL - U.S. DEPARTMENT OF VETERANS AFFAIRS, SEVENTH EDITION (DECEMBER 2015)

NFC - NATIONAL FIRE CODES, PUBLISHED BY NATIONAL FIRE PROTECTION ASSOCIATION (NFPA)

NFPA 70 - NATIONAL ELECTRICAL CODE (2017 EDITION)

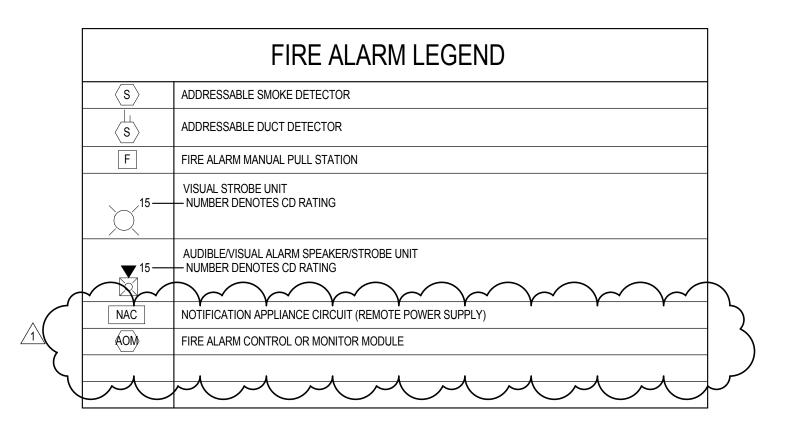
NFPA 72 - NATIONAL FIRE ALARM AND SIGNALING CODE (2016 EDITION)

NFPA 101 - LIFE SAFETY CODE (2015 EDITION)

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NFPA 170 - STANDARD FOR FIRE SAFETY AND EMERGENCY SYMBOLS (2015 EDITION) NOTE 1: FOR DESIGN FEATURES THAT ARE ADDRESSED BY BOTH THE IBC AS WELL AS BY NFPA 101 OR THE NFC, THE DOCUMENT REFERENCED BY NFPA 101 OR THE NFC SHALL BE USED EXCLUSIVELY.

NOTE 2: FIRE PROTECTION FEATURES NOT ADDRESSED BY THE NFC OR OTHERWISE ADDRESSED IN THE VA FIRE PROTECTION DESIGN MANUAL SHALL BE DESIGNED TO COMPLY WITH THE REQUIREMENTS OF THE LATEST EDITION OF THE INTERNATIONAL BUILDING CODE (IBC).



	Drawing Title THIRD FLOOR FIRE ALARM	Project Title VA HEALTH	Project Title VA HEALTH CARE SYSTEM			
IE ARCHITECT EXPRESSLY RESERVES S COMMON LAW AND STATUTORY LAW OPYRIGHTS AND OTHER PROPERTY GHTS FOR THESE "ARCHITECTURAL ORKS" AND "TECHNICAL DOCUMENTS" ID ANY DERIVITIVES THEREOF. THESE RAWINGS AND DOCUMENTS ARE NOT D BE REPRODUCED, CHANGED OR OPIED IN ANY MANNER WHATSOEVER OR ANY USE WITHOUT FIRST OBTAINING IE EXPRESS WRITTEN CONSENT OF DUIS G. CHIODINI, CHIODINI ASSOCIATES, DR ARE THEY TO BE ASSIGNED TO ANY RATY WITHOUT FIRST OBTAINING SAID RITTEN PERMISSION AND CONSENT.	PLAN				Building N 5	
	Approved: Project Director Approver	Location VAS 438-16-104 BL SIOUX FALLS, SD	Drawing N			
		Date 2017.03.13	Checked Checker	Drawn Author		

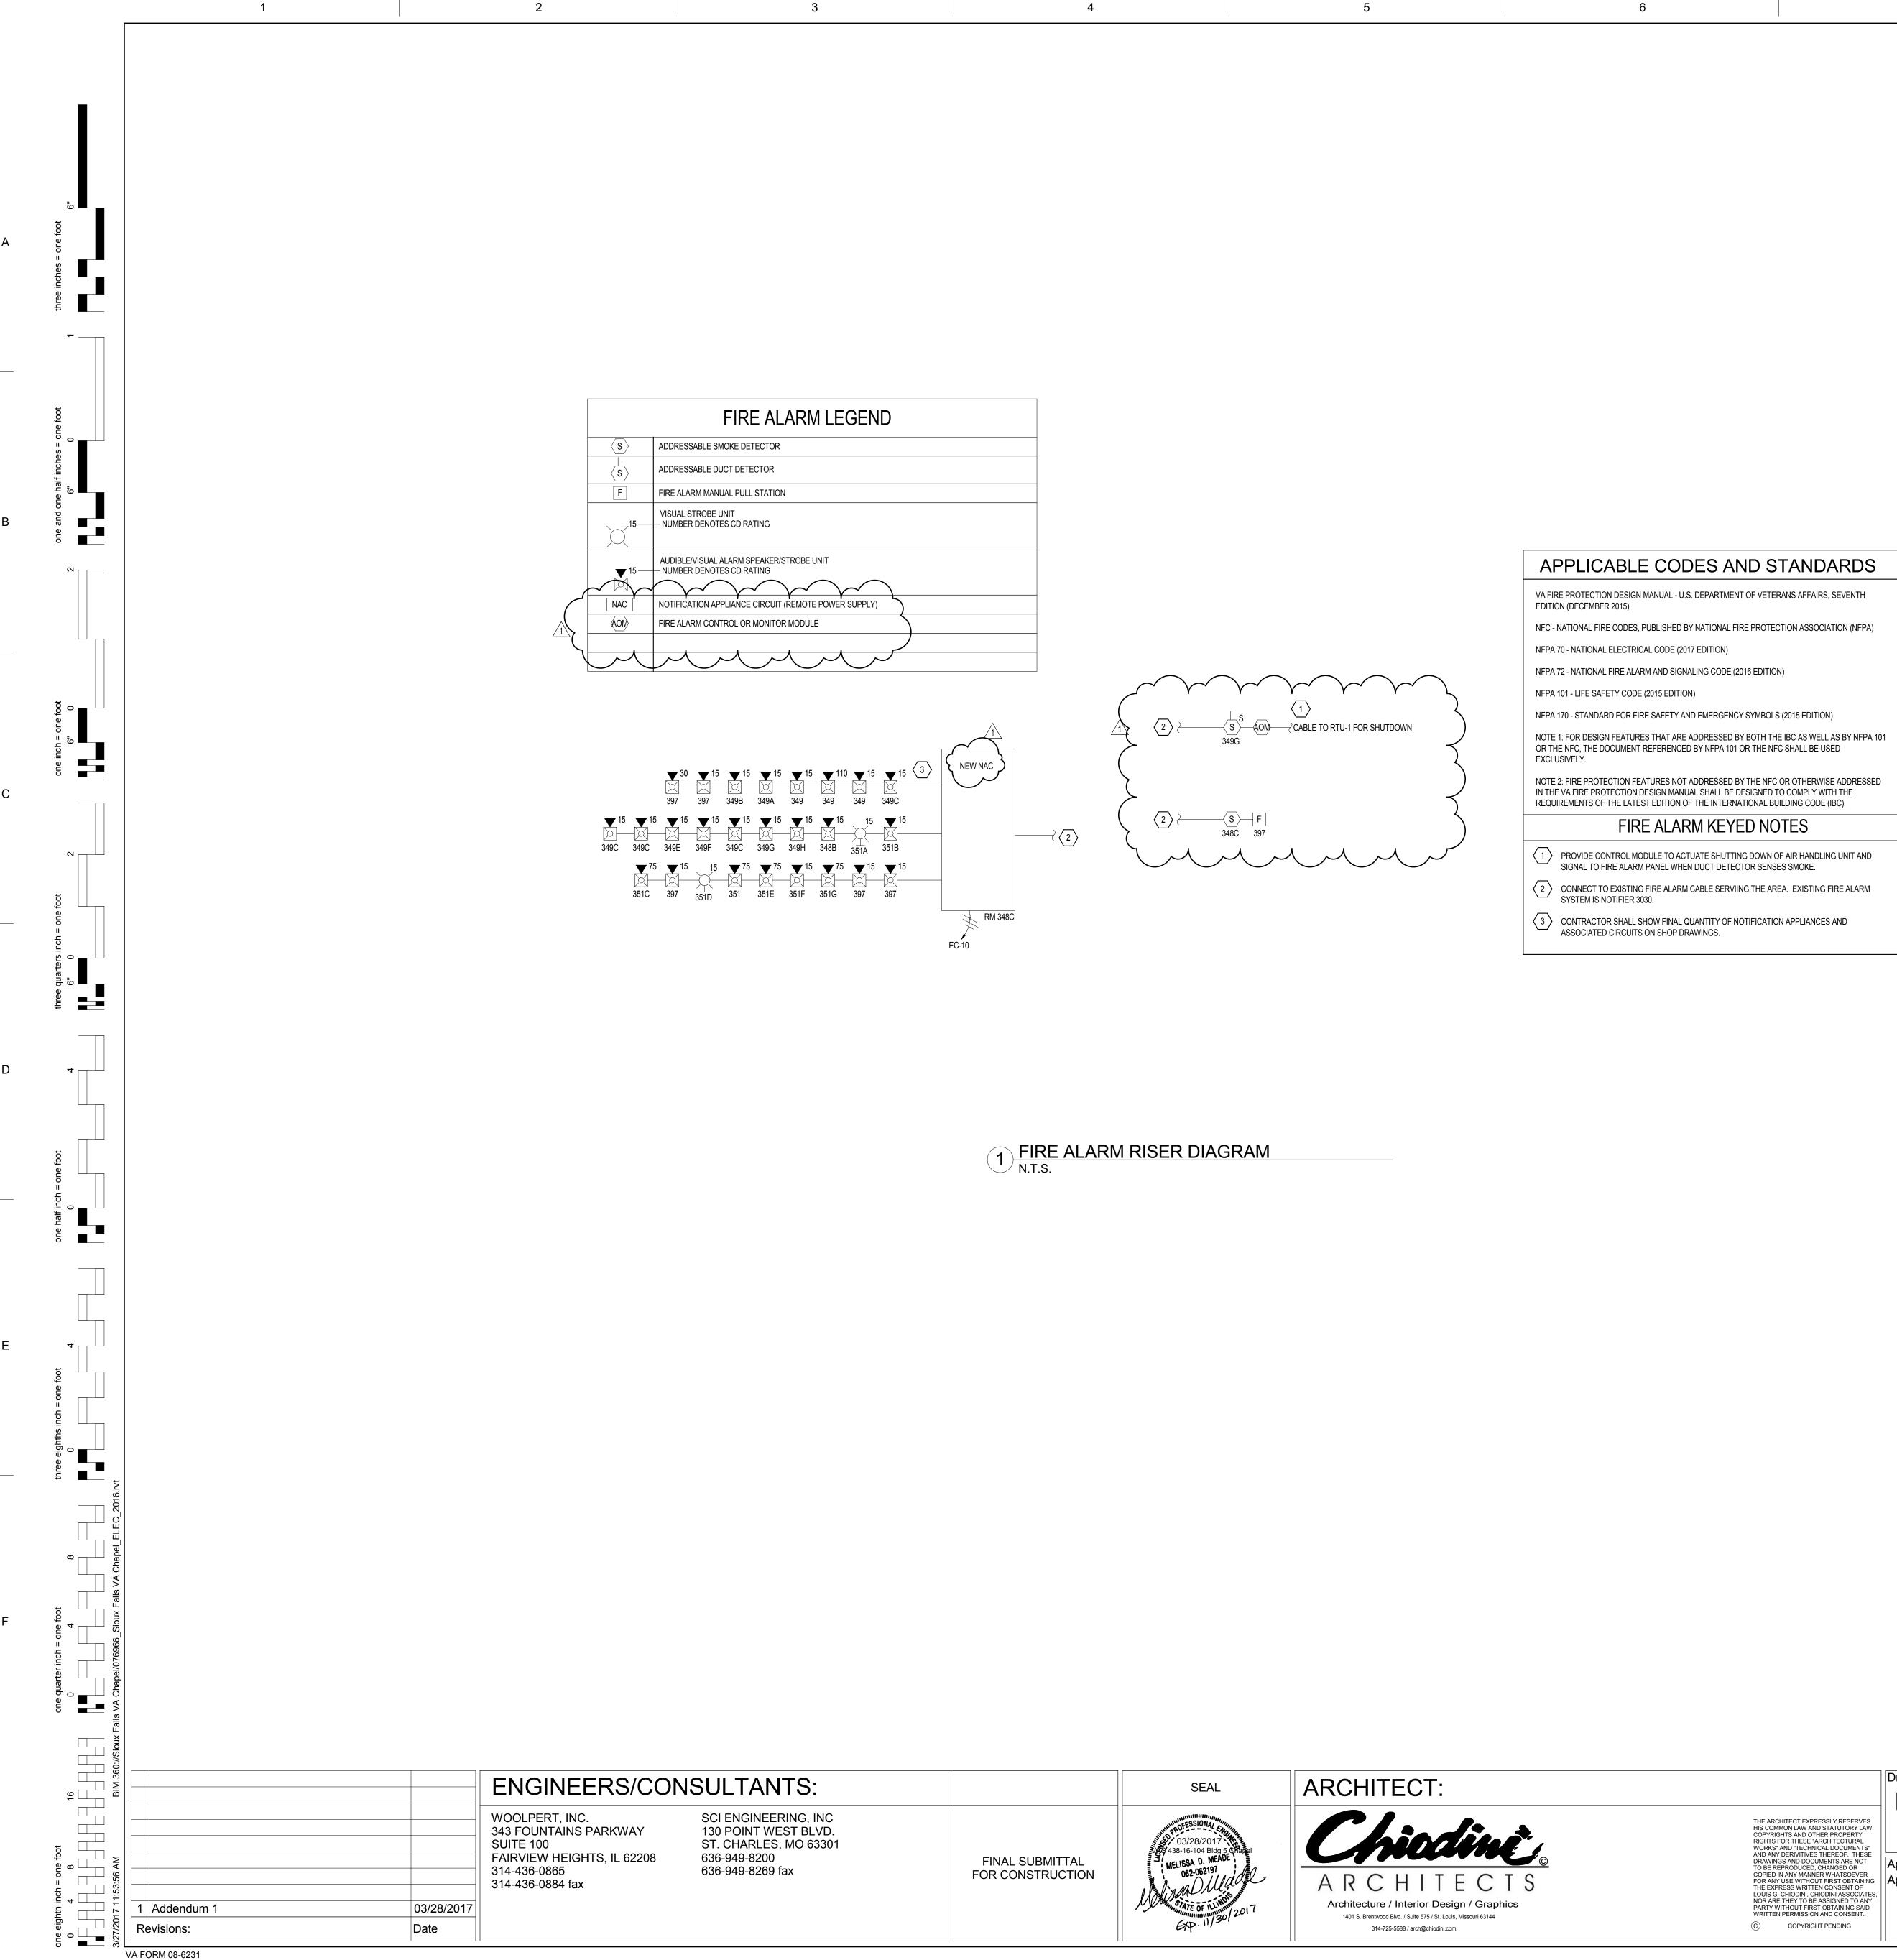
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GENERAL NOTES FIRESTOP ALL PENETRATIONS THROUGH FIRE-RATED WALLS OR FLOORS TO PRESERVE RATING. SYNCHRONIZE STROBES IN ALL AREAS IN ACCORDANCE WITH NFPA 72. THESE WORK PLANS ARE TO BE CONSIDERED DIAGRAMMATIC AND REFLECT GENERAL ORDER OF MAGNITUDE. FINAL DESIGN, CALCULATIONS, AND ALL ELEMENTS NECESSARY FOR A COMPLETE SYSTEM ARE THE RESPONSIBILITY OF THE CONTRACTOR. QUANTITIES OF COMPONENTS AND FINAL WIRING SHALL BE VERIFIED WITH THE FIRE ALARM SYSTEM SUPPLIER. THE CONTRACTOR SHALL BE RESPONSIBLE FOR ANY AND ALL ADDITIONAL POWER SUPPLIES, CONTROL MODULES, MONITOR MODULES, WIRE SIZE, WIRE QUANTITY, ETC., FOR A COMPLETE SYSTEM IN ACCORDANCE WITH THE APPLICABLE CODES, DESIGN DOCUMENTS, AND SPECIFICATIONS. ALL WORK SHALL CONFORM TO THE NATIONAL FIRE CODES (NFC), NFPA 70, NFPA 72, NFPA 101, THE VA FIRE PROTECTION DESIGN MANUAL, AND ADDITIONAL REFERENCED CODES AND STANDARDS. FINALIZED DUCT DETECTOR LOCATIONS SHALL BE COORDINATED WITH THE MECHANICAL CONTRACTOR. WHERE A DUCT SMOKE DETECTOR IS LOCATED ABOVE A CEILING OR IN A DIFFICULT TO REACH LOCATION, PROVIDE A REMOTE INDICATING LAMP AND A TEST KEY SWITCH ON NEARBY WALL AT 7 FEET ABOVE THE FINISHED FLOOR TO FACILITATE TESTING. SPRINKLER FLOW AND TAMPER SWITCHES SHALL HAVE REMOTE INDICATOR LIGHTS WITH LABELED IDENTIFICATIONS LOCATED IN NEAREST CEILING ACCESSIBLE TO THE PUBLIC OR AS DIRECTED BY OWNER. CONTROL MODULES AND MONITOR MODULES ARE NOT ALL SHOWN ON FLOOR PLANS. PROVIDE FINAL LOCATIONS AND QUANTITIES WITH SHOP DRAWINGS. CONTRACTOR SHALL BE RESPONSIBLE FOR PROVIDING MONITOR MODULES FOR ALL TAMPER AND FLOW SWITCHES. COORDINATE EXACT QUANTITY WITH SPRINKLER CONTRACTOR. ALL FIRE ALARM WIRING SHALL BE INSTALLED IN METAL RACEWAY SEPARATE FROM ALL OTHER SYSTEMS IN ACCORDANCE WITH VA FIRE PROTECTION DESIGN MANUAL, PARAGRAPH 7.2.D. CIRCUITS IN THE RENOVATED AREA SHALL MATCH THE EXISTING SYSTEM. WIRING FOR FIRE ALARM SYSTEM SHALL BE SPECIFIED AND DEFINED IN NFPA 72 AS FOLLOWS: INITIATING DEVICE CIRCUITS (IDC), CLASS B; SIGNALING LINE CIRCUITS (SLC), CLASS B; NOTIFICATION APPLIANCE CIRCUITS (NAC), CLASS B. NOTIFICATION APPLIANCES SHALL BE MOUNTED IN ACCORDANCE WITH NFPA 72 AND ACCESSIBILITY REQUIREMENTS. WALL MOUNTED VISUAL APPLIANCES (STROBES) SHALL BE MOUNTED SO THAT THE LENS IS A MINIMUM OF 80 INCHES ABOVE THE FLOOR OR A MINIMUM OF 6 INCHES FROM THE CEILING, WHICHEVER IS LOWER. CEILING MOUNTED VISUAL APPLIANCES SHALL COMPLY WITH NFPA 72. MANUAL PULL STATIONS SHALL BE MOUNTED SO THAT THE OPERATING MECHANISM IS LOCATED 42" TO 48" AFF. PROIVIDE END OF LINE RESISTORS AS REQUIRED PER NFPA 70, NFPA 72, AND MANUFACTURER REQUIREMENTS. SEE SHEET E-501 FOR FIRE ALARM SYSTEM DETAILS. THE EXISTING FIRE ALARM CONTROL PANEL (NOTIFIER 303 VOICE SYSTEM) SHALL REMAIN IN SERVICE AND THE COMPONENTS IN THE RENOVATED AREA SHALL BE CONNECTED TO THE EXISTING FACP. CONTRACTOR SHALL INCLUDE A MATRIX ON THE SHOP DRAWINGS INDICATING THE INTENDED OPERATION OF THE SYSTEM. THE PROGRAMMING OF THE EXISTING FIRE ALARM CONTROL PANEL (NOTIFIER 303 VOICE SYSTEM) SHALL BE MODIFIED AS NEEDED TO ACCOMODATE THE CHANGES TO THE SYSTEM IN THE RENOVATED AREA. CONTRACTOR SHALL MATCH THE GENERAL OPERATIONAL FEATURES AND REPORTING ZONES OF THE EXISTING SYSTEM. ANY NEW DEVICE LOCATIONS ON EXISTING MASONRY WALLS WHICH ARE NOT BEING FURRED OUT SHALL BE SERVED USING DECORATIVE METALLIC SURFACE RACEWAY, PAINTED TO MATCH WALLS. **KEYED NOTES** 331 PROVIDENTEW REMOTE POWER SUPPLY IN ROOM 348C. 332 NOT USED. 333 🔒 NOT USED. 334 NO FIRE LARM WORK IN ELEVATOR EQUIPMENT ROOM. 335 COORDINATE LOCATIONS AND INSTALLATION OF DUCT DETECTORS WITH MECHANICAL CONTRACTOR. 336 NO FIRE ALARM WORK IN RESPIRATORY CARE AREA. Scale:As indicated lumber 2016.052 Owner lumber Number -310



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	Drawing Title		Project Title			Project Num
	FIRE ALARM RIS	SER DIAGRAM	VA HEALTH C	ARE SYST	ГЕМ	438-16-104
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COPIED IN ANY MANNER WHATSOEVER	Approved: Project Director Approver		Location VAS 438-16-104 BLDG. 5 CHAPEL SIOUX FALLS, SD 57105			Drawing Nu
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