
PROJECT LOCATION LOCATION MAP

ABBREVIATIONS					
		C A	CALICE	R	RISER
ACT	ACOUSTICAL CEILING TILE	GA	GAUGE	R-#	R-VALUE
AFF	ABOVE FINISH FLOOR	GALV	GALVANIZED	RB	RESILIENT BASE
ALT	ALTERNATE	GFRC	GLASS-FIBER REINFORCED CONCRETE	RCP	REFLECTED CEILING PLAN
ALUM	ALUMINUM	GRG	GLASS-REINFORCED GYPSUM	RD	ROOF DRAIN
ARCH	ARCHITECTURAL / ARCHITECT	GLU LAM	GLUE LAMINATED WOOD	RE	REFER TO
		GYP BD	GYPSUM BOARD	REF	REFRIGERATOR
BD	BOARD			RESIL	RESILIENT
BLDG	BUILDING	Н	HIGH / HEIGHT		
BLKG	BLOCKING	HM	HOLLOW METAL	REV	REVISION
	BOTTOM OF	HORIZ	HORIZONTAL	RF.	RESILIENT FLOORING
BO_		HR	HAND RAIL	RM	ROOM
		HVAC	HEATING, VENTILATING AND AIR	RO	ROUGH OPENING
CF/CI	CONTRACTOR FURNISHED/	TIVAC	CONDITIONING	RS	RESINOUS FLOORING
	CONTRACTOR INSTALLED		CONDITIONING	RTU	ROOF TOP UNIT
CF/OI	CONTRACTOR FURNISHED/		WITTENAN		
	OWNER INSTALLED	INT	INTERIOR	5	SOUTH
CG	CORNER GUARD			SCHED	SCHEDULE
CJ	CONTROL JOINT	JAN	JANITOR	SF	SQUARE FEET
CL	CENTER LINE	JT	JOINT	SIM	SIMILAR
CMU	CONCRETE MASONRY UNIT			SPEC	SPECIFICATION
CP	CARPET	L-	ANGLE (SIZE)		
CR	CARD READER			55	STAINLESS STEEL
	CERAMIC TILE	MAX	MAXIMUM	STOR	STORAGE
CT	CERAIVIIC TILE	MECH	MECHANICAL	STRUCT	STRUCTURAL
_		MEZZ	MEZZANINE		
D	DEEP / DEPTH	MFR	MANUFACTURER	T	TREAD
DIA	DIAMETER			T#G	TONGUE AND GROOVE
DIAG	DIAGONAL	MIN	MINIMUM	TLT	TOILET
DISP	DISPENSER	MISC	MISCELLANEOUS	TO	TOP OF
DN	DOWN	MO	MASONRY OPENING	TOM	TOP OF MASONRY
DS	DOWNSPOUT			TOS	TOP OF STEEL
		N	NORTH	TOW	TOP OF WALL
E	EAST	NA	NOT APPLICABLE	TPD	TOILET PAPER DISPENSER
EIFS	EXTERIOR INSULATION AND	NIC	NOT IN CONTRACT		
LII S	FINISH SYSTEM	NTS	NOT TO SCALE	TYP	TYPICAL
EJ	EXPANSION JOINT			UL	UNDERWRITERS LABORATOR
EL	ELEVATION	OC	ON CENTER	UNO	UNLESS NOTED OTHERWISE
ELEC	ELECTRIC / ELECTRICAL	OF/CI	OWNER FURNISHED / CONTRACTOR	0110	ONLESS NOTED STILLINGS
ELEV	ELEVATOR	INSTALLED		VCT	VINYL COMPOSITION TILE
EQ	EQUAL	OF/OI	OWNER FURNISHED / OWNER	VIF	VERIFY IN FIELD
EQUIP	EQUIPMENT	INSTALLED			
		OH DR	OVERHEAD DOOR	VSF	VINYL SHEET FLOORING
EXIST	EXISTING	OPH	OPPOSITE HAND	VWC	VINYL WALL COVERING
EXT	EXTERIOR	OPNG	OPENING		
		OPP	OPPOSITE	W	WEST
FD	FLOOR DRAIN	ORD	OVERFLOW ROOF DRAIN	W/(O)	WITH / (OUT)
FE	FIRE EXTINGUISHER	UND	UVLNI LUW KUUI DKAIN	WB	WOOD BASE
FEC	FIRE EXTINGUISHER CABINET	D.	DI ACTIC I ANAIMATE	WC	WALL COVERING
FF	FINISH FLOOR	PL	PLASTIC LAMINATE	WD	WOOD
FOC	FACE OF CONCRETE	PLYWD	PLYWOOD	WF	WOOD FLOORING
FRP	FIBERGLASS REINFORCED PANEL	PNL	PANEL / PANELING	WP	WALL PROTECTION
FRTP	FIRE RETARDANT TREATED PLYWOOD	PR	PAIR	WSCT	WALLTROTECTION WAINSCOT
FRTW	FIRE RETARDANT TREATED WOOD	PNT	PAINT		
FURN	FURNITURE	PTD	PAPER TOWER DISPENSER	WT	WINDOW TREATMENT
IUNN	IUNITURE			WH	WATER HEATER



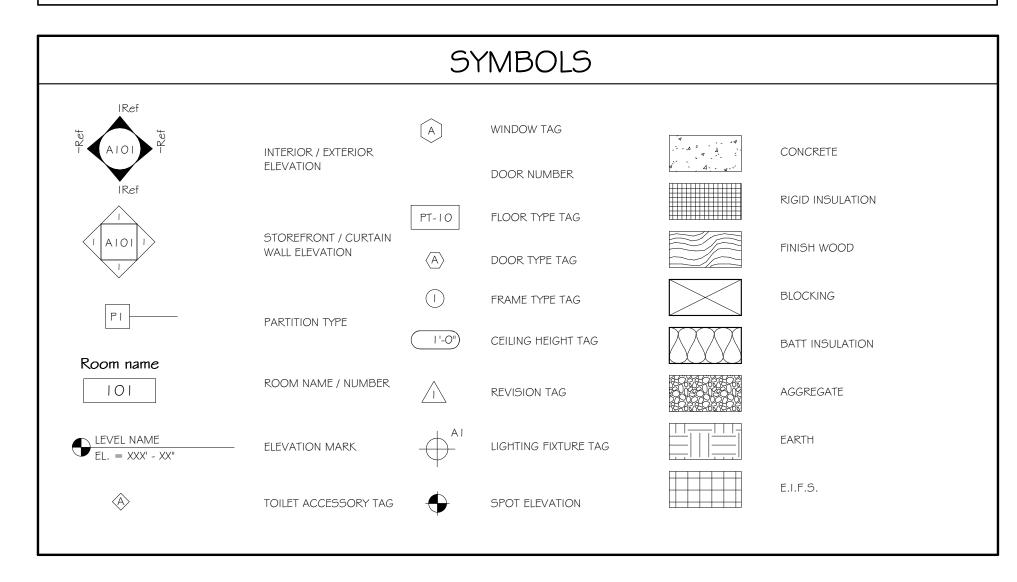

VA HEALTH CARE SYSTEM

VAS 438-16-104 BLDG. 5 CHAPEL SIOUX FALLS, SD 57105

GENERAL NOTES

- GENERAL CONTRACTOR TO COORDINATE ALL TOP OF STEEL BEARING HEIGHTS AND TOP OF MASONRY HEIGHTS WITH STRUCTURAL DRAWINGS. NOTIFY ARCHITECT IMMEDIATELY OF ANY ALL WRITTEN CORRESPONDENCE WILL BE TRANSMITTED FROM SUBCONTRACTOR THROUGH GENERAL CONTRACTOR THROUGH OWNER'S REP TO ARCHITECT. ALL PARTIES INVOLVED ARE TO RECEIVE WRITTEN AND SIGNED COPIES OF SUCH. NO VERBAL AGREEMENTS AFFECTING COST OR ALTERNATIVE CONSTRUCTION METHODS AND ARRANGEMENTS WILL BE CONSIDERED
- GENERAL CONTRACTOR IS TO FIELD VERIFY ALL EXISTING CONDITIONS / DIMENSIONS PRIOR TO CONSTRUCTION. NOTIFY ARCHITECT IMMEDIATELY OF ANY DISCREPANCIES. GENERAL CONTRACTOR SHALL COMPLY WITH ALL DIRECTIVES OF THE OWNER. IF CONFLICTS BETWEEN DRAWINGS, SPECIFICATIONS AND REQUIREMENTS OF BUILDING OWNER AND/OR OPERATORS ARISE, THEY SHALL BE BROUGHT TO THE ATTENTION OF THE ARCHITECT IMMEDIATELY.

GENERAL CONTRACTOR TO BE RESPONSIBLE FOR REPAIRING ANY AND ALL SURFACES TO REMAIN DAMAGED BY HIMSELF OR SUBCONTRACTORS UNDER HIS CONTROL. REPAIRS ARE TO

- CIVIL FINISH FLOOR ELEVATION XXX.XX' = ARCHITECTURAL FINISH FLOOR ELEVATION 100'-0". THE CONTRACTOR SHALL CONTAIN ALL CONSTRUCTION ACTIVITY, INCLUDING STORAGE OF MATERIAL AND EQUIPMENT, WITHIN THE CONSTRUCTION LIMITS, AT ALL TIMES BEING RESPONSIBLE FOR AND ABIDING BY RULES AND REGULATIONS OF THE OWNER.
- MATCH EXISTING MATERIALS AND MUST BE ACCEPTABLE TO OWNER. ALL FLOOR TRANSITIONS BETWEEN DIFFERENT MATERIALS SHALL BE SMOOTH AND FLUSH (MAXIMUM = 1/8" PER FOOT). GENERAL CONTRACTOR SHALL REMOVE ALL CONSTRUCTION DEBRIS FROM JOBSITE. ALL CONSTRUCTION DEBRIS SHALL BE CONTAINED INSIDE CONSTRUCTION LIMITS.
- ALL WALLS WITH ITEMS SUCH AS GRAB BARS, TOILET ACCESSORIES, WOOD TRIM, SHELVING, CASEWORK, ETC. SHALL BE REINFORCED WITH CONCEALED, FIRE TREATED WOOD
- BLOCKING. (GENERAL CONTRACTOR TO INSTALL BLOCKING TYPICAL). 13. ALL WOOD BLOCKING, PLYWOOD, ETC. SHALL BE FIRE RETARDANT TREATED LUMBER.

DISCLAIMER OF RESPONSIBILITY

THROUGH A900, DATED 02/27/17 AND SPECIFICATION DIVISIONS 2 THROUGH 14, DATED 02/27/2017; AND I HEREBY DISCLAIM ANY RESPONSIBILITY FOR ALL OTHER PLANS, OR SURVEYING FOR THIS PROJECT.

MISSOURI ARCHITECT, LICENSE NUMBER: A-2006

I HEREBY SPECIFY, PURSUANT TO RSMO 327.411, THAT THE DOCUMENTS INTENDED TO BE AUTHENTICATED BY MY SEAL ARE LIMITED TO: ARCHITECTURAL DRAWINGS LISTED ABOVE (A000 SPECIFICATIONS, ESTIMATES, REPORTS OR OTHER DOCUMENTS OR INSTRUMENTS RELATING TO OR INTENDED TO BE USED FOR ANY PART OR PARTS OF THE ARCHITECTURE, ENGINEERING, BY: CHIODINI ASSOCIATES

LOUIS G. CHIODINI		

			Sheet Number		Revision #
			MD102	MECHANICAL SECOND FLOOR DEMO PLAN	
	AESBESTOS ABATEMENT		MD103	MECHANICAL THIRD FLOOR DEMO PLAN	
Shoot Number	Sheet Name	Revision #	MD40 I	ENLARGED MECH. FOURTH & FIFTH FLR. DEMO PLANS	
Sheet Number		Revision #	MOO I	MECHANICAL LEGENDS AND NOTES	
X- I	THIRD FLOOR ABATEMENT PLAN		M102	MECHANICAL SECOND FLOOR PLAN	
X-2	SECOND FLOOR ABATEMENT PLAN		M103	MECHANICAL THIRD FLOOR PLAN	
			M40 I	ENLARGED MECHANICAL FOURTH & FIFTH FLR. PLANS	
	ADCLUTECTUDAL		M501	MECHANICAL DETAILS	
	ARCHITECTURAL		M601	MECHANICAL SCHEDULES	
Sheet Number	Sheet Name	Revision #	M70 I	MECHANICAL CONTROL DIAGRAMS	
		Revision #	M702	MECHANICAL PIPING AND CONTROL DIAGRAMS	
D102	SECOND FLOOR DEMO PLAN				
D103	THIRD FLOOR DEMO PLAN			PLUMBING	
D402	SECOND FLOOR DEMO RCP			1 LOWIDING	
D403	THIRD FLOOR DEMO RCP		Sheet Number	Sheet Name	Revision #
A102	SECOND FLOOR PLAN		PD103	PLUMBING THIRD FLOOR DEMOLITION PLAN	1,000,000,000
A103	THIRD FLOOR PLAN		P00 I	PLUMBING LEGENDS AND NOTES	+
A104	FOURTH FLOOR PLAN		P102	PLUMBING SECOND FLOOR PLAN	+
4105	FIFTH FLOOR PLAN		P103	PLUMBING THIRD FLOOR PLAN	+
A120	ENLARGED FLOOR PLANS				_
A200	EXTERIOR ELEVATIONS		P401	ENLARGED PLUMBING PLANS	
A300	BUILDING SECTIONS		P501	PLUMBING DETAILS	
A350	STAIR SECTIONS AND DETAILS		P601	PLUMBING SCHEDULES	
A401	THIRD FLOOR RCP		P901	PLUMBING RISER DIAGRAMS	
A450	RCP DETAILS				
A500	WALL SECTIONS				
A501	WALL SECTIONS			ELECTRICAL	
A520	ENLARGED DETAILS				T
A550	ENLARGED SECTION DETAILS		Sheet Number	Sheet Name	Revision #
A600	INTERIOR ELEVATIONS		ED-001	THIRD FLOOR ELECTRICAL DEMOLITION PLAN	
A601	INTERIOR ELEVATIONS		E-00 I	LEGEND AND GENERAL NOTES	
4602	INTERIOR ELEVATIONS		E-101	SECOND & THIRD FLOOR LIGHTING PLANS	
4603	INTERIOR ELEVATIONS		E-201	SECOND, THIRD & FIFTH FLOOR POWER PLANS	
A650	MILLWORK DETAILS		E-301	SECOND, THIRD & FOURTH FLOOR SYSTEMS PLANS	
A700	DOOR AND WINDOW SCHEDULE		E-310	THIRD FLOOR FIRE ALARM PLAN	
	PARTITION TYPES		E-501	FIRE ALARM RISER DIAGRAM	
	1742111611111111111111111111111111111111		E-601	EQUIPMENT AND LIGHT FIXTURE SCHEDULES	+
A70 I	FINISH LEGEND NOTES & DETAILS				
470 I 4800	FINISH LEGEND, NOTES & DETAILS		E-602		
470 4800 480	THIRD FLOOR FINISH PLAN		E-602	ELECTRICAL PANEL SCHEDULES	
A70 A800 A80 A85	THIRD FLOOR FINISH PLAN THIRD FLOOR FURNITURE PLAN		E-602		
470 4800 480	THIRD FLOOR FINISH PLAN		E-602		
A70 A800 A80 A85	THIRD FLOOR FINISH PLAN THIRD FLOOR FURNITURE PLAN		E-602 Sheet Number	FIRE PROTECTION	Revision #
A70 A800 A80 A85	THIRD FLOOR FINISH PLAN THIRD FLOOR FURNITURE PLAN			FIRE PROTECTION	Revision #
A70 A800 A80 A85	THIRD FLOOR FINISH PLAN THIRD FLOOR FURNITURE PLAN		Sheet Number	FIRE PROTECTION Sheet Name	Revision #
A70 A800 A80 A85	THIRD FLOOR FINISH PLAN THIRD FLOOR FURNITURE PLAN		Sheet Number	FIRE PROTECTION Sheet Name SPRINKLER THIRD FLOOR DEMOLITION PLAN	Revision #

DRAWING INDEX

Revision #

Sheet Number

STRUCTURAL

MECHANICAL

MECHANICAL SUPPORT FRAMING AND DETAILS

Revision #

COVERSHEET

CODE DATA AND LIFE SAFETY

GROUND FLOOR LIFE SAFETY PLAN FIRST FLOOR LIFE SAFETY PLAN

SECOND FLOOR LIFE SAFETY PLAN

THIRD FLOOR LIFE SAFETY PLAN

Sheet Name

Sheet Number

PROJECT DIRECTORY

<u>OWNER</u>	ARCHITECT	STRUCTURAL	MECHANICAL	<u>PLUMBING</u>	ELECTRICAL	FIRE PROTECTION
VA HEALTH CARE SYSTEM VAS 438-16-104 BLDG. 5 CHAPEL SIOUX FALLS, SD 57105	CHIODINI ASSOCIATES 1401 S. BRENTWOOD SUITE 425 ST. LOUIS, MO 63144 P: (314)725-5588 F: (314)725-4347	WOOLPERT, INC. 343 FOUNTAINS PARKWAY SUITE 100 FAIRVIEW HEIGHTS, IL 62208 P: (618)632-2889 F: (618)632-0100	WOOLPERT, INC. 343 FOUNTAINS PARKWAY SUITE 100 FAIRVIEW HEIGHTS, IL 62208 P: (618)632-2889 F: (618)632-0100	WOOLPERT, INC. 343 FOUNTAINS PARKWAY SUITE 100 FAIRVIEW HEIGHTS, IL 62208 P: (618)632-2889 F: (618)632-0100	WOOLPERT, INC. 343 FOUNTAINS PARKWAY SUITE 100 FAIRVIEW HEIGHTS, IL 62208 P: (618)632-2889 F: (618)632-0100	WOOLPERT, INC. 343 FOUNTAINS PARKWAY SUITE 100 FAIRVIEW HEIGHTS, IL 62208 P: (618)632-2889 F: (618)632-0100

FINAL SUBMITTAL

FOR CONSTRUCTION

ENGINEERS/CONSULTANTS:

3 16


VA FORM 08-6231

WOOLPERT, INC. 343 FOUNTAINS PARKWAY SUITE 100 FAIRVIEW HEIGHTS, IL 62208 314-436-0865 314-436-0884 fax

Date

SCI ENGINEERING, INC 130 POINT WEST BLVD. ST. CHARLES, MO 63301 636-949-8200 636-949-8269 fax



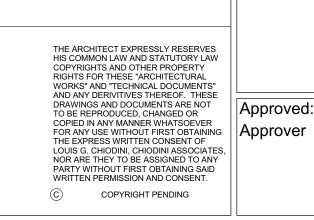

Drawing Title Project Title VA HEALTH CARE SYSTEM **COVERSHEET** Approved: Project Director VAS 438-16-104 BLDG. 5 CHAPEL SIOUX FALLS, SD 57105 Checked

Project Number 438-16-104 2016.052 Owner **Building Number** Drawing Number Drawn

CJN

RLK


2017.03.13

Scale: 12" = 1'-0"

CODE DATA **EXIT REQUIREMENTS:** (IBC TABLE 803.11) ALLOWABLE REDUCTION W/ REQUIRED **PROJECT DESCRIPTION: INTERIOR FINISH REQUIREMENTS:** FIRE RESISTANCE REQUIREMENTS: SPRINKLER SYSTEM XISTING BUILDING EXIT STAIRS AND EXIT CORRIDORS ON FIRST AND MASONRY VENEER OVER CONCRETE STRUCTURE INTERIOR EXIT STAIRWAYS, RAMPS & PASSAGEWAYS BUILDING ELEMENTS (IBC TABLE 601) SECOND FLOOR ARE AS BUILT EXISTING TO REMAIN GROUP A-3 CLASS B PRIMARY STRUCTURAL FRAME: CLASS B I HOUR GROUP B TYPICAL OCCUPANT LOAD (IBC TABLE 1004.1.1) 4 + MEZZANINE LEVEL - EXISTING TO REMAIN NO. OF STORIES AT OR ABOVE GRADE GROUP S CLASS C SUPPORTING ROOF ONLY I HOUR ACCESSORY STORAGE AREAS, MECHANICAL/EQUIPMENT 300 GROSS SF PER OCCUPANT CORRIDORS & ENCLOSURES FOR EXIT ACCESS STAIRWAYS & RAMPS EXTERIOR WALLS: I - EXISTING TO REMAIN NO. OF STORIES BELOW GRADE ASSEMBLY - CHAIRS ONLY 7 NET SF PER OCCUPANT EXISTING TO REMAIN CLASS B BUILDING HEIGHT GROUP A-3 BEARING 2 HOUR BUSINESS AREAS 100 GROSS SF PER OCCUPANT EXISTING TO REMAIN NONBEARING BY FIRE SEPARATION DISTANCE BUILDING AREA GROUP B CLASS B FIRST FLOOR EXISTING TO REMAIN GROUP S CLASS B 0' TO 5' I HOUR CAPACITY \$ EXIT WIDTH (IBC 1005.3) SECOND FLOOR EXISTING TO REMAIN ROOMS # ENCLOSED SPACES 5' TO 10' I HOUR STAIRWAYS 0.3" PER OCCUPANT 3RD FLOOR (AREA OF WORK) (WEST WING) APPROX 6875 SF (WEST WING) CLASS C I HOUR GROUP A-3 10' TO 30' OTHER EGRESS COMPONENTS 0.2" PER OCCUPANT GROUP B CLASS C OVER 30' O HOUR FULLY SPRINKLERED AUTOMATIC SPRINKLER SYSTEM INTERIOR WALLS: GROUP S CLASS C DOOR WIDTH (IBC 1010.1.1) BEARING MINIMUM WIDTH I HOUR 2 HOUR MAXIMUM WIDTH BUILDING ENVELOPE DESIGN REQUIREMENTS: SUPPORTING ROOF ONLY I HOUR APPLICABLE CODES NONBEARING WALLS O HOUR STAIRWAY WIDTH (IBC 1009.1) FLOOR CONSTRUCTION: MINIMUM WIDTH 2015 INTERNATIONAL BUILDING CODE INSULATION ENTIRELY ABOVE DECK R-20 ci 2 HOUR TYPICAL LESS THAN 50 OCCUPANTS 2015 INTERNATIONAL MECHANICAL CODE WALLS (ABOVE GRADE) ROOF CONSTRUCTION: 2015 INTERNATIONAL PLUMBING CODE R-9.5 cı TYPICAL I HOUR RAMP WIDTH (IBC 1012.5.1) 2015 INTERNATIONAL ENERGY CODE METAL FRAMED R-13 + R-7.5 cı 20' OR MORE ABOVE FLOOR BELOW I HOUR MEANS OF EGRESS RAMP PER 1012.1 2014 NATIONAL ELECTRICAL CODE WALLS (BELOW GRADE) RAMP BETWEEN HANDRAILS 2015 INTERNATIONAL FUEL GAS CODE NOT REQUIRED MASS SHAFT ENCLOSURES (IBC 713) 2015 INTERNATIONAL FIRE CODE SLAB ON GRADE FLOORS NOT REQUIRED 4 STORIES OR MORE 2 HOUR ASSEMBLY COMMON PATH OF TRAVEL (IBC 1006.2.1) NFPA 13, INSTALLATION OF SPRINKLER SYSTEMS OPAQUE DOORS 3 STORIES OR LESS I HOUR ASSEMBLY ASSEMBLY OCCUPANCY NFPA 14, STANDPIPE \$ HOSE SYSTEM U-0.70 SWINGING (ASSEMBLY) BUSINESS OCCUPANCY 100' NFPA 72, NATIONAL FIRE ALARM CODE ROLLING (ASSEMBLY) U-0.50 **CORRIDOR WALLS:** AMERICANS with DISABILITY ACT (ADA) - ICC/ANSI 117.1-2009 FENESTRATION - METAL FRAMING CURTAIN WALL / STOREFRONT U-0.50 MINIMUM NUMBER OF EXITS (IBC 1006.2) FIRE PARTITIONS - CORRIDOR WALLS (IBC TABLE 1020.1) SEISMIC DESIGN CATEGORY =A ENTRANCE DOOR U-0.85 O HOUR I-49 OCCUPANTS I EXIT U-0.55 ALL OTHERS 49-500 OCCUPANTS 2 EXITS 501-1,000 OCCUPANTS 3 EXITS MORE THAN 1,000 OCCUPANTS 4 EXITS FIRE RESISTANCE REQUIREMENTS @ TRAVEL DISTANCE (IBC TABLE 1017.2) ASSEMBLY OCCUPANCY 250' **OPENINGS:** BUSINESS OCCUPANCY 300' TYPE OF CONSTRUCTION, BUILDING HEIGHT & AREA: PLUMBING FIXTURE COUNTS: (IBC TABLE 716.5) OPENING PROTECTIVES DEAD ENDS (IBC 1020.4) FIRE WALLS & FIRE BARRIERS ASSEMBLY OCCUPANCY CONSTRUCTION TYPE (IBC CHAPTER 6) TYPE IB (EXISTING NON-COMBUSTIBLE) (FULLY MINIMUM NUMBER OF REQUIRED PLUMBING FIXTURES (TABLE 2902.1) 4 HOUR ASSEMBLY 3 HOUR ASSEMBLY BUSINESS OCCUPANCY SPRINKLERED) 3 HOUR ASSEMBLY 3 HOUR ASSEMBLY ALLOWABLE HEIGHT (IBC TABLE 504.3 AND SECTION 504) EXISTING TO REMAIN - NO INCREASE IN HEIGHT ASSEMBLY OCCUPANTS = 119 occ (ACTUAL: 70 occ) 2 HOUR ASSEMBLY I I/2 HOUR ASSEMBLY CORRIDOR WIDTH (IBC TABLE 1020.2) EXISTING TO REMAIN - NO INCREASE IN AREA ALLOWABLE AREA (IBC TABLE 506.2) BUSINESS OCCUPANTS = 34 occ I I/2 HOUR ASSEMBLY I I/2 HOUR ASSEMBLY MINIMUM WIDTH ALLOWABLE AREA INCREASE (IBC SECTION 506) EXISTING TO REMAIN - NO INCREASE IN AREA SHAFT, EXIT ENCLOSURES & EXIT PASSAGEWAY ACCESS TO EQUIPMENT ALLOWABLE AREA INCREASE (IBC SECTION 506) EXISTING TO REMAIN - NO INCREASE IN AREA MALE/FEMALE **FEMALE** 2 HOUR ASSEMBLY I I/2 HOUR ASSEMBLY MALE LESS THAN 50 OCCUPANTS OTAL ALLOWABLE AREA (W/INCREASES SECTION 506) EXISTING TO REMAIN - NO INCREASE IN AREA FIRE BARRIERS ENCLOSURES FOR SHAFTS & EXIT ACCESS I HOUR ASSEMBLY I HOUR ASSEMBLY ASSEMBLY (A-3) OCCUPANCY CLASSIFICATION: I PER 150 I PER 75 OTHER FIRE BARRIERS EGRESS EXIT CALCULATION: (1016.1) WATER CLOSETS I HOUR ASSEMBLY 3/4 HOUR ASSEMBLY LAVATORIES I PER 200 PRIMARY OCCUPANCY CLASSIFICATIONS (IBC CHAPTER 3) OTHER FIRE PARTITIONS DRINKING FOUNTAIN I PER 1000 EXISTING BUILDING OCCUPANCY IS INSTITUTION GROUP 1-2 I HOUR ASSEMBLY 3/4 HOUR ASSEMBLY SERVICE SINK 1/2 HOUR ASSEMBLY 1/3 HOUR ASSEMBLY BUSINESS GROUP - B (DOCTOR OFFICES) BUSINESS = 42ocd.2" = 9" BUSINESS (B) EXTERIOR WALLS ASSEMBLY GROUP - A3 (AREA OF WORSHIP) ASSEMBLY = 119occ/.3" = 36"I PER 25 FIRST 50 3 HOUR ASSEMBLY I I/2 HOUR ASSEMBLY WATER CLOSETS STORAGE GROUP 2 HOUR ASSEMBLY I PER 50 OVER 50 I I/2 HOUR ASSEMBLY (2) EXIT STAIRS PROVIDED - EXISTING I HOUR ASSEMBLY 3/4 HOUR ASSEMBLY LAVATORIES I PER 40 FIRST 80 EGRESS LOAD = 163 occ / 0.3" = (49") STAIR WIDTH REQUIRED 1 PER 80 OVER 80 SMOKE BARRIERS DRINKING FOUNTAIN I HOUR ASSEMBLY 1/3 HOUR ASSEMBLY 1 PER 100 REQUIRED SEPARATION OF OCCUPANCIES: (IBC TABLE 508.4) EGRESS PROVIDED = STAIR | EXISTING = 60" (53" CLEAR BETWEEN HANDRAILS) SERVICE SINK STAIR 4 EXISTING = 54" (4 I " CLEAR BETWEEN HANDRAILS) FIRE DAMPERS (IBC TABLE 717.3.2.1) ASSEMBLY TO BUSINESS - I HR W/ FULLY SPRINKLERED TOTAL WIDTH PROVIDED (EXISTING) = 94" LESS THAN 3 HOUR ASSEMBLY I I/2 HOUR 3 HOUR OR GREATER ASSEMBLY TOTAL OCCUPANTS = 163 OCCUPANTS / 0.2" = 33" REQUIRED INTERIOR EXIT STAIRWAYS & RAMPS (IBC 1023) TOTAL WIDTH OF EGRESS PROVIDED 4 STORIES OR MORE 2 HOUR ASSEMBLY 3 STORIES OR LESS I HOUR ASSEMBLY OCCUPANCY LOAD CALCULATION: (IBC TABLE 1004.1.1) EXIT PASSAGEWAYS (IBC 1024) I HOUR ASSEMBLY REQUIRED ASSEMBLY PROVIDED ASSEMBLY REQUIRED BUSINESS PROVIDED BUSINESS HORIZONTAL EXITS (IBC 1026) 2 HOUR ASSEMBLY BUSINESS GROUP "B" = 100 GROSS SQFT PER PERSON ASSEMBLY GROUP "A-3" = 7 NET PER PERSON BUSINESS = 42ocd.2" = 9"ASSEMBLY = 119occl.3" = 36"STORAGE GROUP "S" = 300 GROSS SQFT PER PERSON WATER CLOSETS URINALS (2) EXIT STAIRS PROVIDED - EXISTING LAVATORIES FIRE PROTECTION SYSTEMS: EGRESS LOAD = 163 occ / 0.3" = (49") STAIR WIDTH REQUIRED THIRD FLOOR: AREA OF WORK AUTOMATIC SPRINKLER SYSTEMS (IFC 903) EGRESS PROVIDED = STAIR | EXISTING = 60" (53" CLEAR BETWEEN HANDRAILS) WATER CLOSETS BUSINESS = 4159 SQFT / 100 = 41.59 occ (42)FIRE DEPARTMENT CONNECTIONS (IFC 903.3.7) STAIR 4 EXISTING = 54" (4 I " CLEAR BETWEEN HANDRAILS) LAVATORIES ASSEMBLY = 833 SQFT /7net = 119 occ (ACTUAL: 70 occ) MONITORING (IFC 903.4.5) TOTAL WIDTH PROVIDED (EXISTING) = 94" STORAGE = $518 \, \text{SQFT} / 300 = 1.7 \, occ (2)$ ALARMS (IFC 903.4.2) DRINKING FOUNTAINS STANDPIPE SYSTEMS (IFC 905 \$ NFPA 14) FIRE EXTINGUISHERS (IFC 906 \$ NFPA I 0) TOTAL OCCUPANTS = 163 OCCUPANTS / 0.2" = 33" REQUIRED OTHER TOTAL OCCUPANTS = 163 OCCUPANTS FIRE ALARM SYSTEMS (IFC 907 \$ NFPA 72) TOTAL WIDTH OF EGRESS PROVIDED SERVICE SINK

16 ENGINEERS/CONSULTANTS: WOOLPERT, INC. SCI ENGINEERING, INC 343 FOUNTAINS PARKWAY 130 POINT WEST BLVD. SUITE 100 ST. CHARLES, MO 63301 636-949-8200 FAIRVIEW HEIGHTS, IL 62208 FINAL SUBMITTAL 314-436-0865 636-949-8269 fax FOR CONSTRUCTION 314-436-0884 fax Date

VA FORM 08-6231

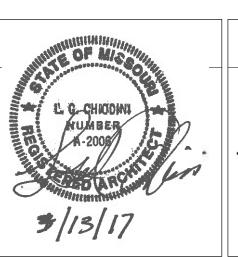

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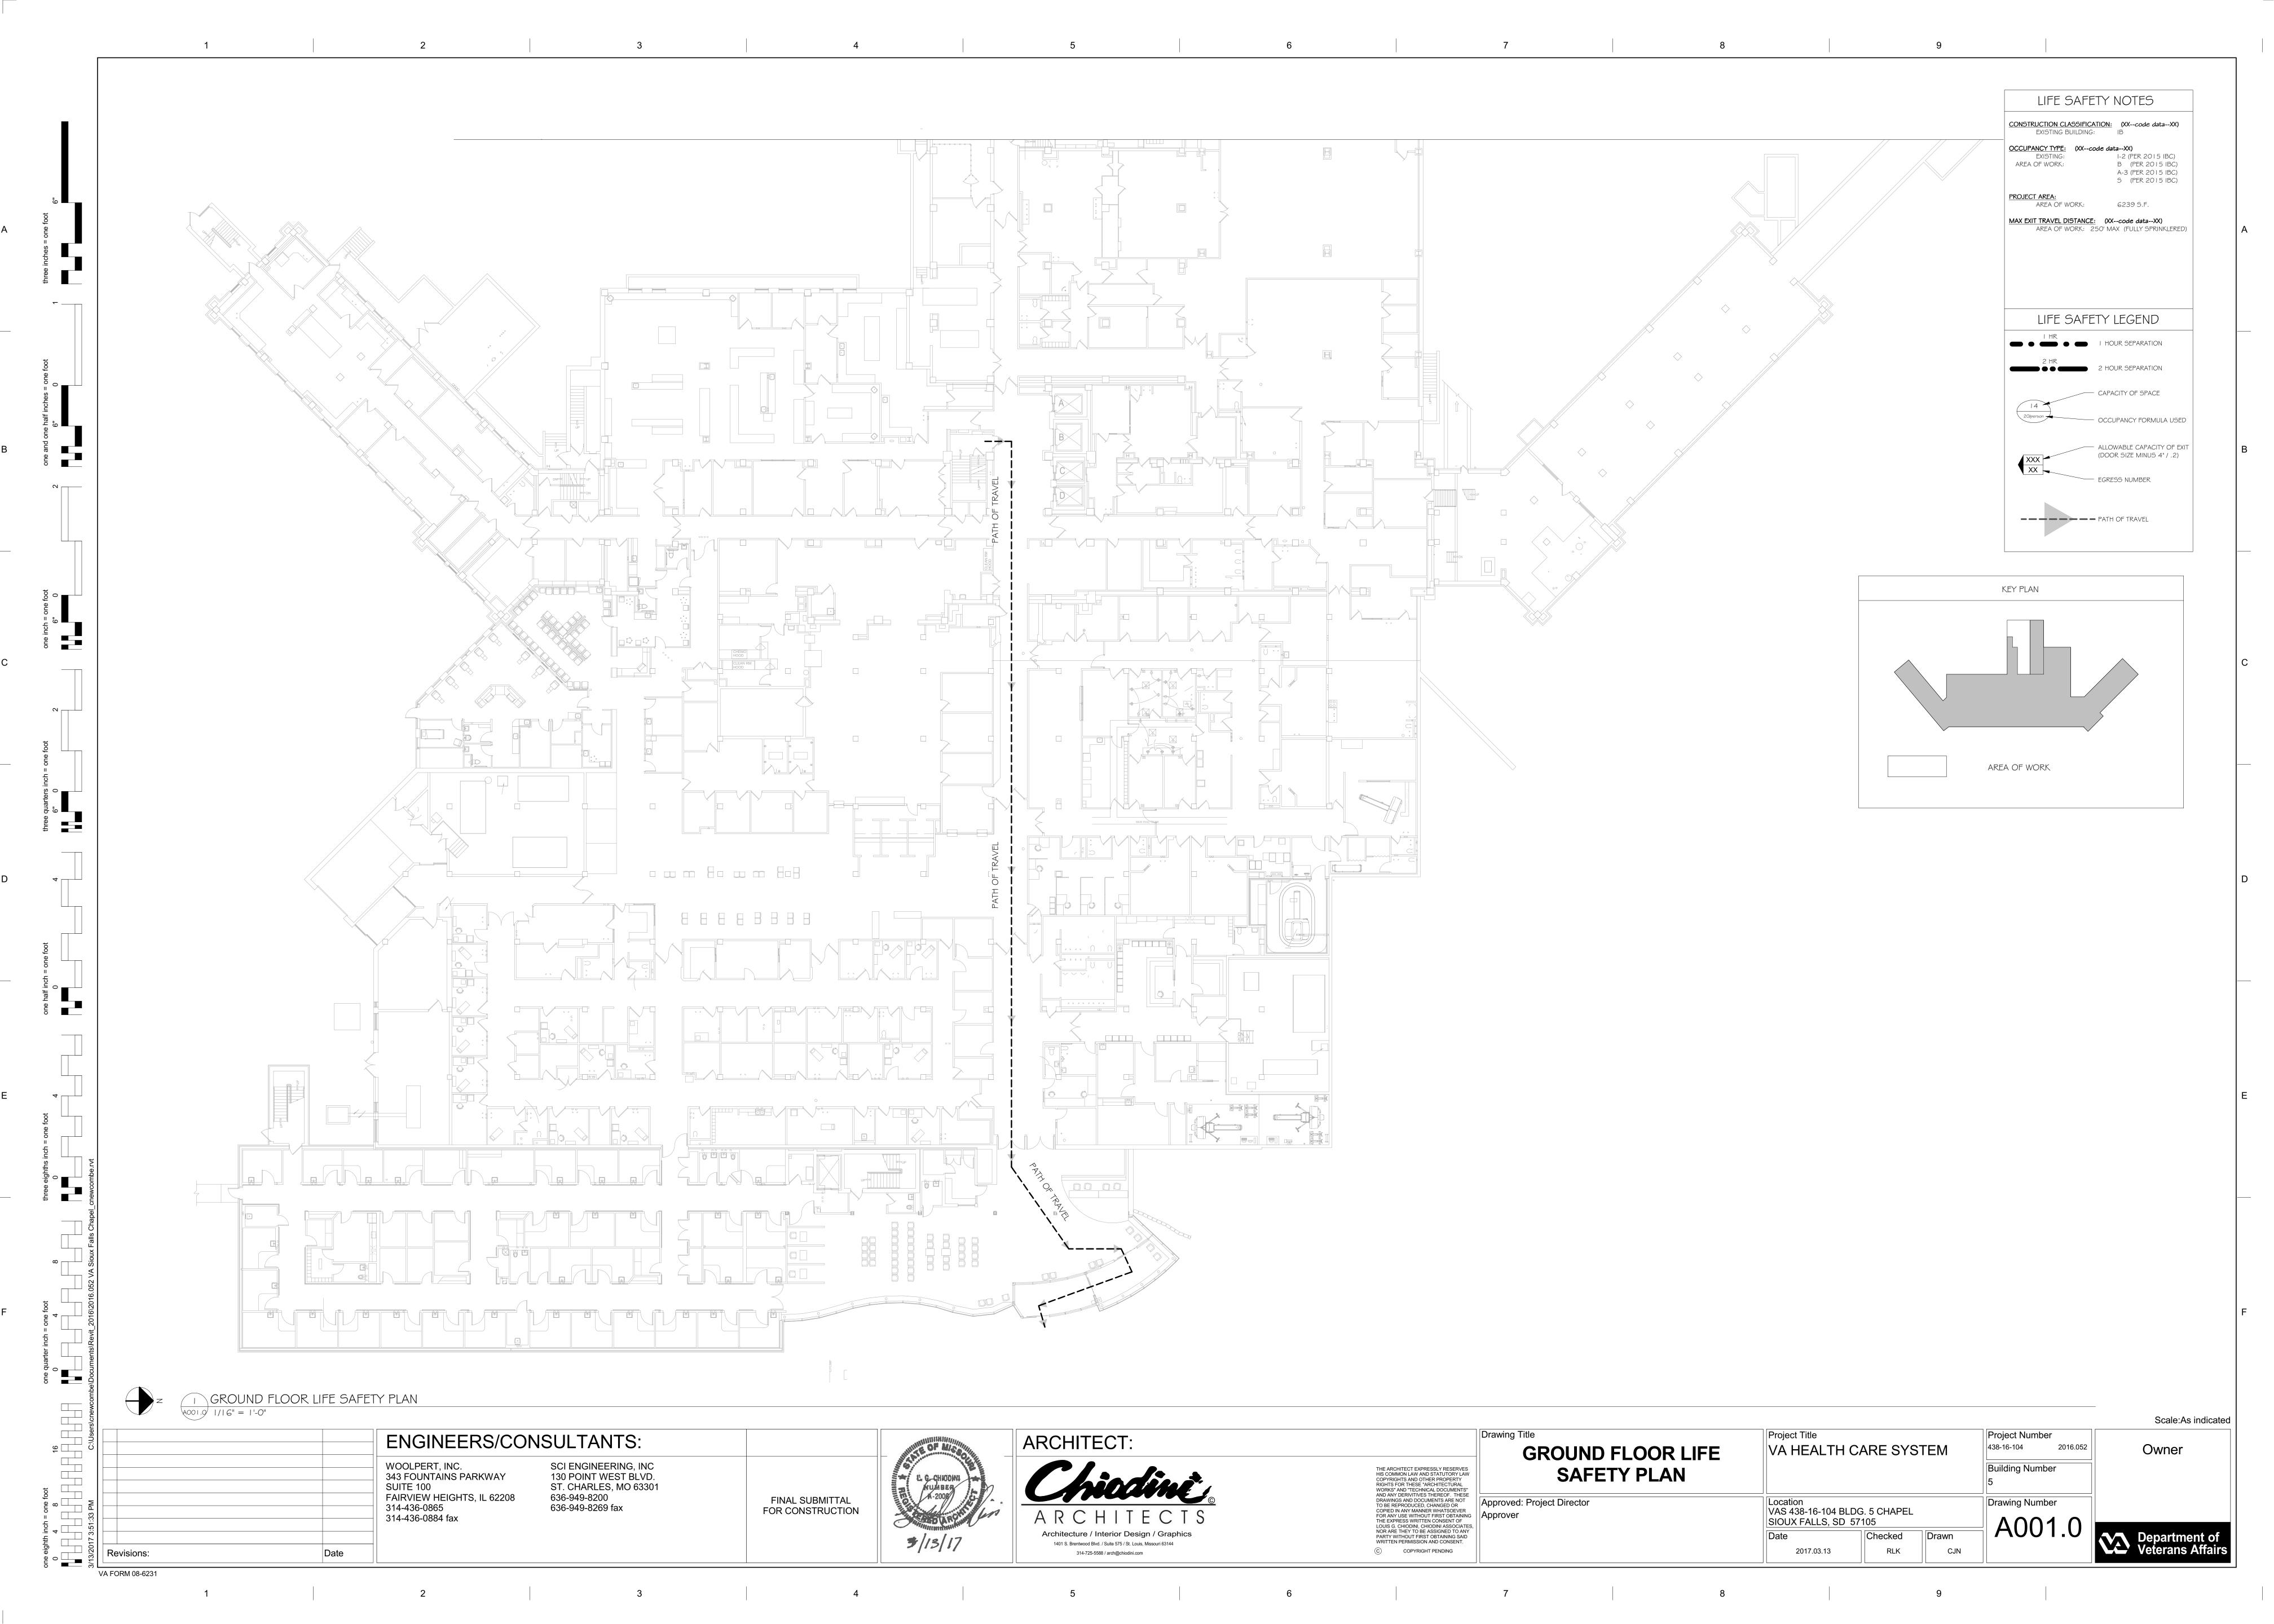
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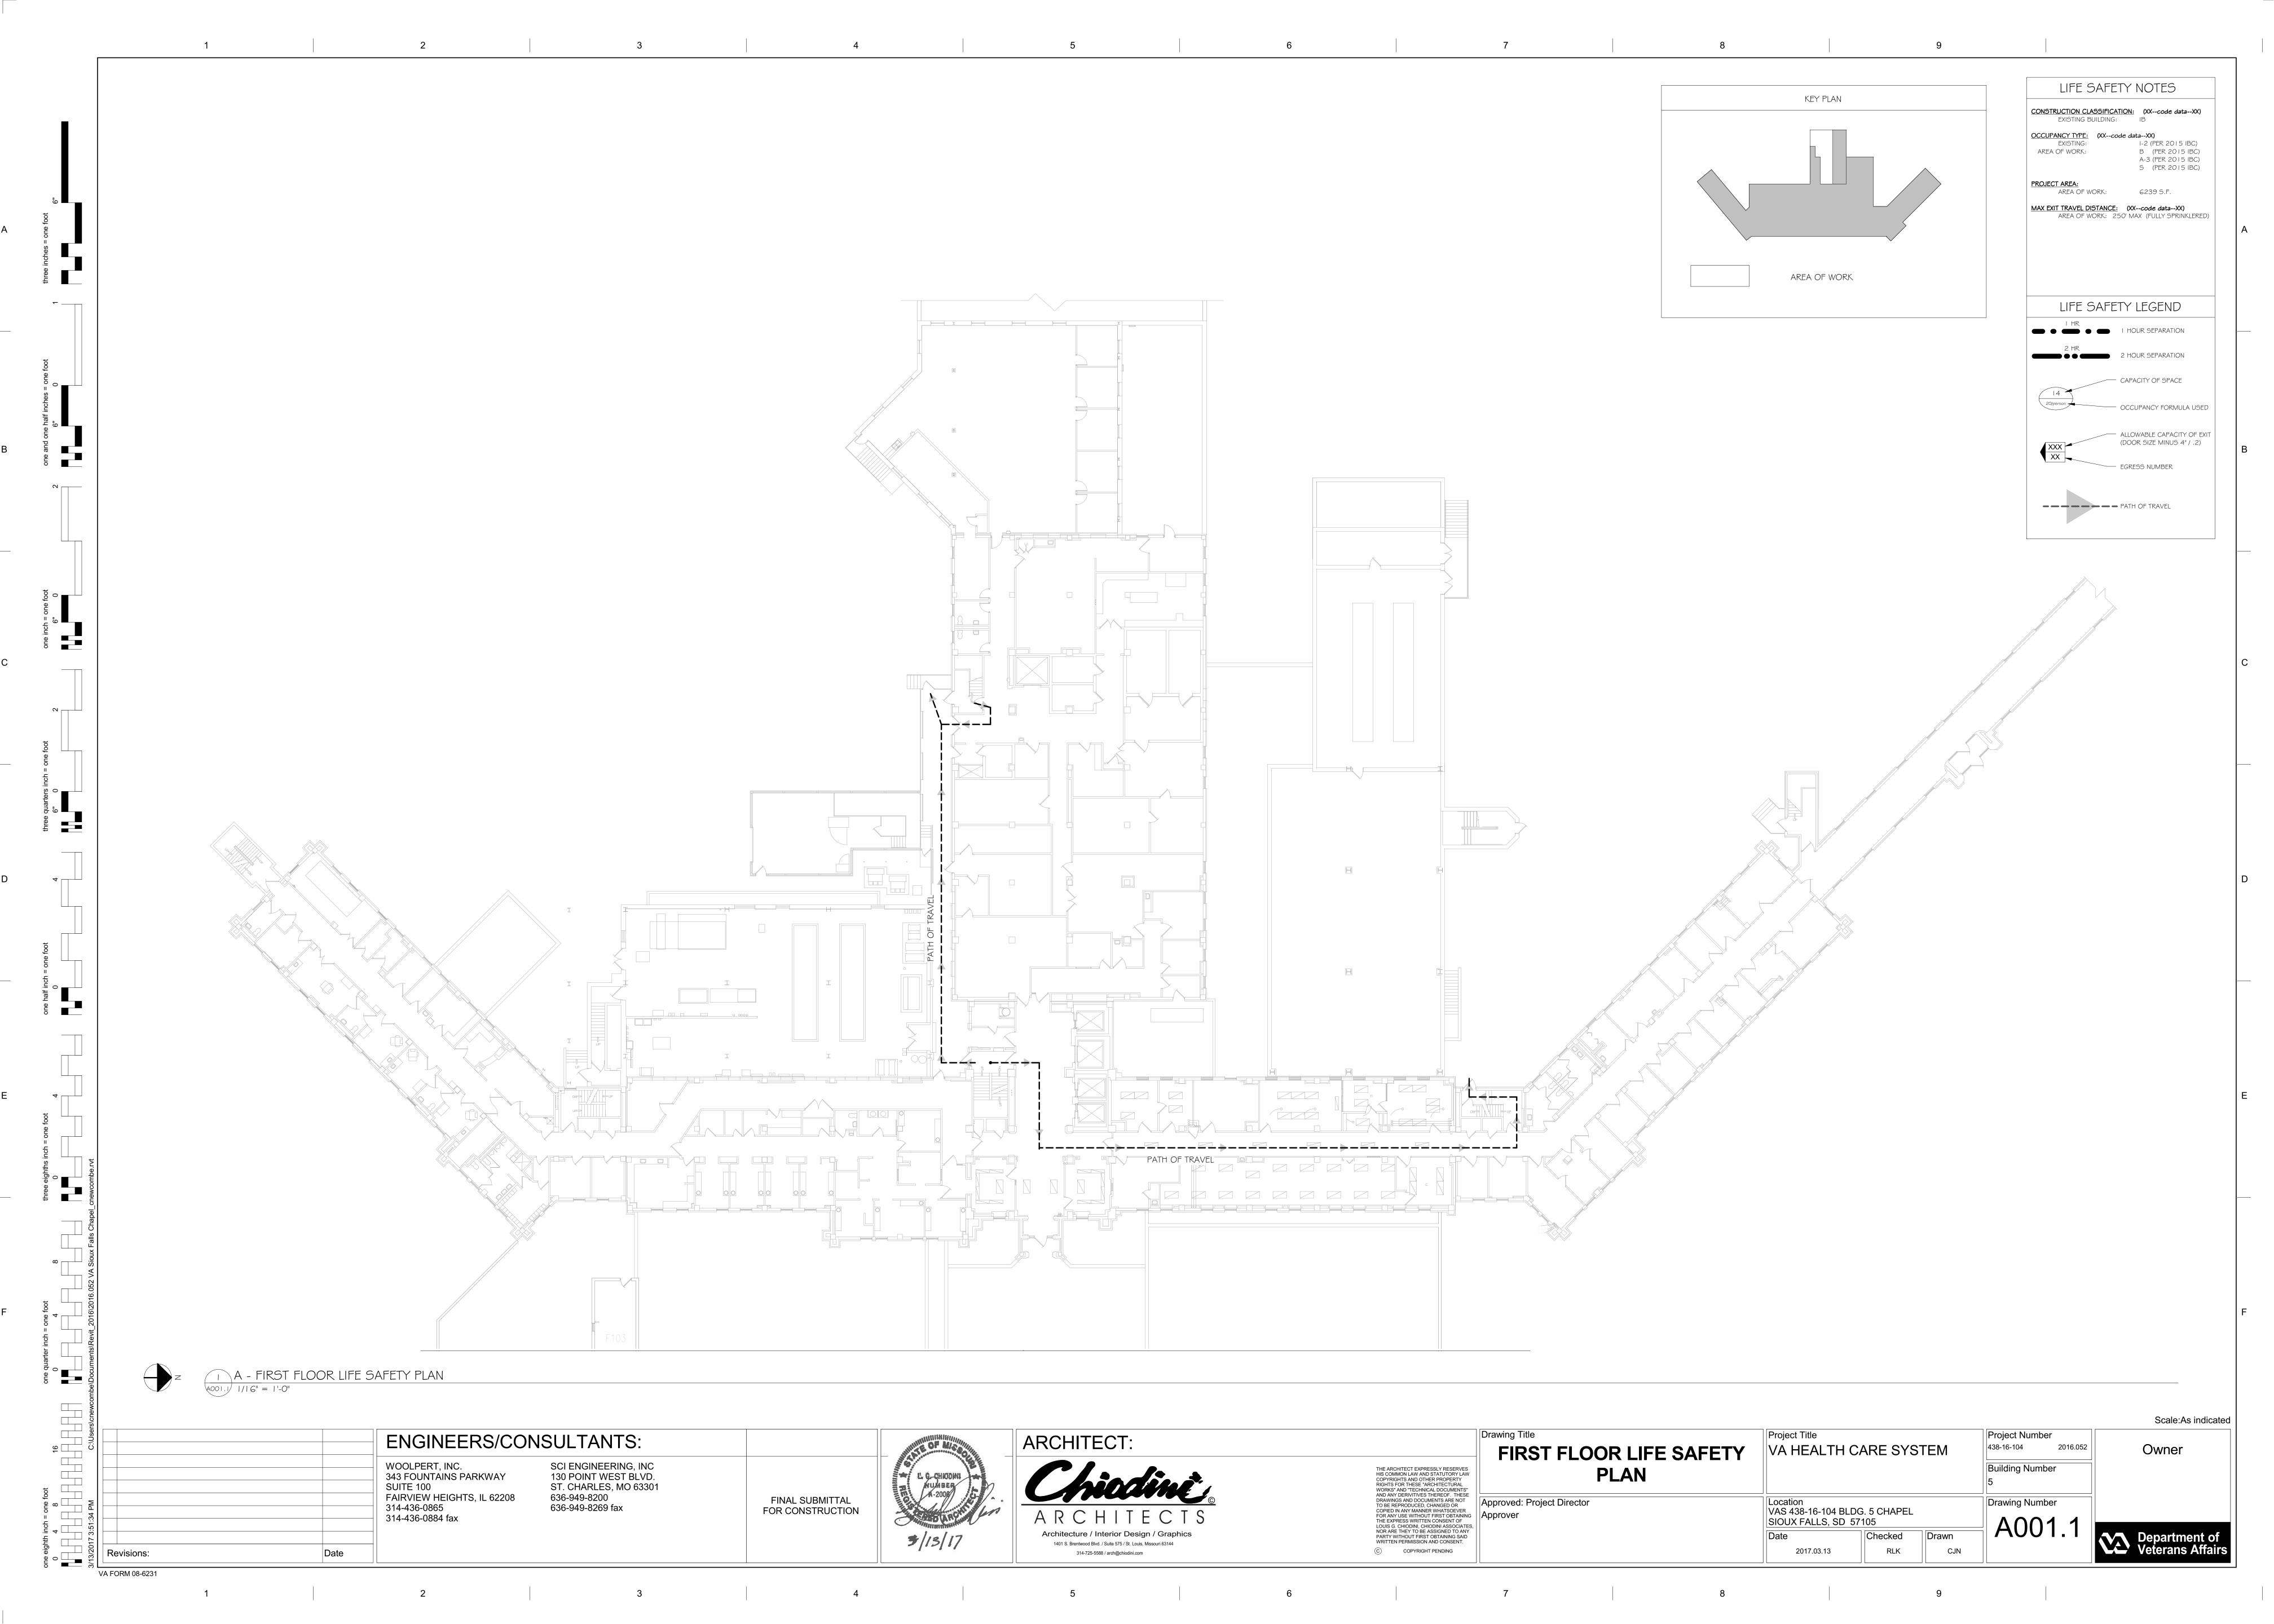
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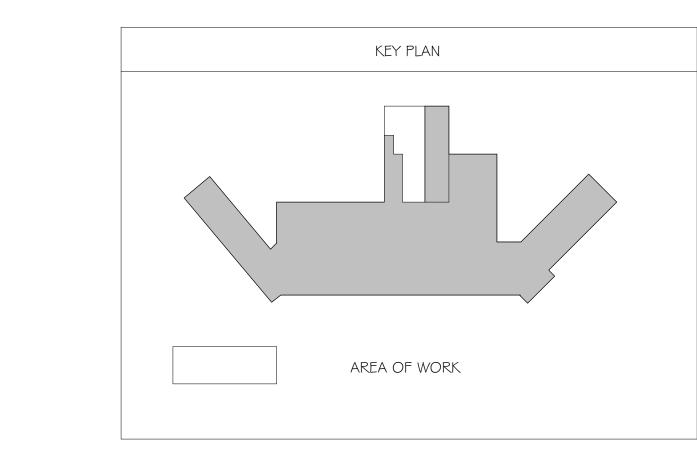
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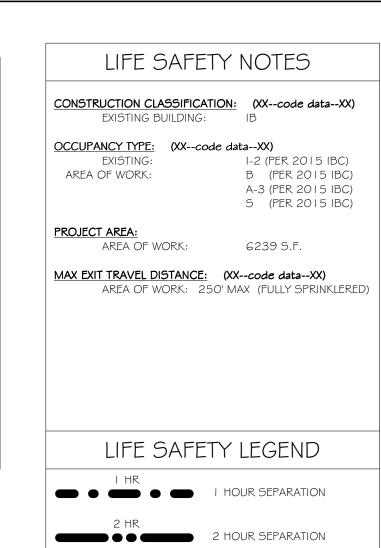
Scale: 12" = 1'-0" Project Number 438-16-104 2016.052 Owner **Building Number** Drawing Number

SIOUX FALLS, SD 57105 Checked 2017.03.13 RLK









CAPACITY OF SPACE

EGRESS NUMBER

OCCUPANCY FORMULA USED

— ALLOWABLE CAPACITY OF EXIT (DOOR SIZE MINUS 4" / .2)



ENGINEERS/CONSULTANTS:

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343 FOUNTAINS PARKWAY
SUITE 100
FAIRVIEW HEIGHTS, IL 62208
314-436-0884 fax

Revisions:

Date


ENGINEERS/CONSULTANTS:

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FINAL SUBMITTAL
FOR CONSTRUCTION

A - SECOND FLOOR LIFE SAFETY PLAN

VA FORM 08-6231

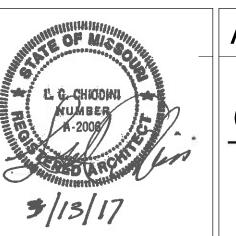

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awing Title	Project Title
SECOND FLOOR LIFE SAFETY PLAN	VA HEALTH CARE SYSTEM
proved: Project Director	Location
pproved. Project Director	VAS 438-16-104 BLDG. 5 CHAPEL SIOUX FALLS, SD 57105

	Scale:As indicated
Project Number	
438-16-104 2016.052	Owner
Building Number	
5	
Drawing Number	
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