

6" MINIMUM -1"-2" WASHED ROCK -

- DUMP STRAP 1" (25 mm) REBAR FOR BAG REMOVAL FROM INLET - 2 EACH DUMP SILT SACK -EXPANSION RESTRAINT [1/4" (6 mm) NYLON ROPÈ, 2" (51 mm) FLAT WASHERS]

TRENCH DRAIN DETAIL


⚠ ADDENDUM #3


Revisions:


VA FORM 08 - 6231

ROCK CONSTRUCTION ENTRANCE DETAIL

NINLET PROTECTION DETAIL 3 SCALE: NTS

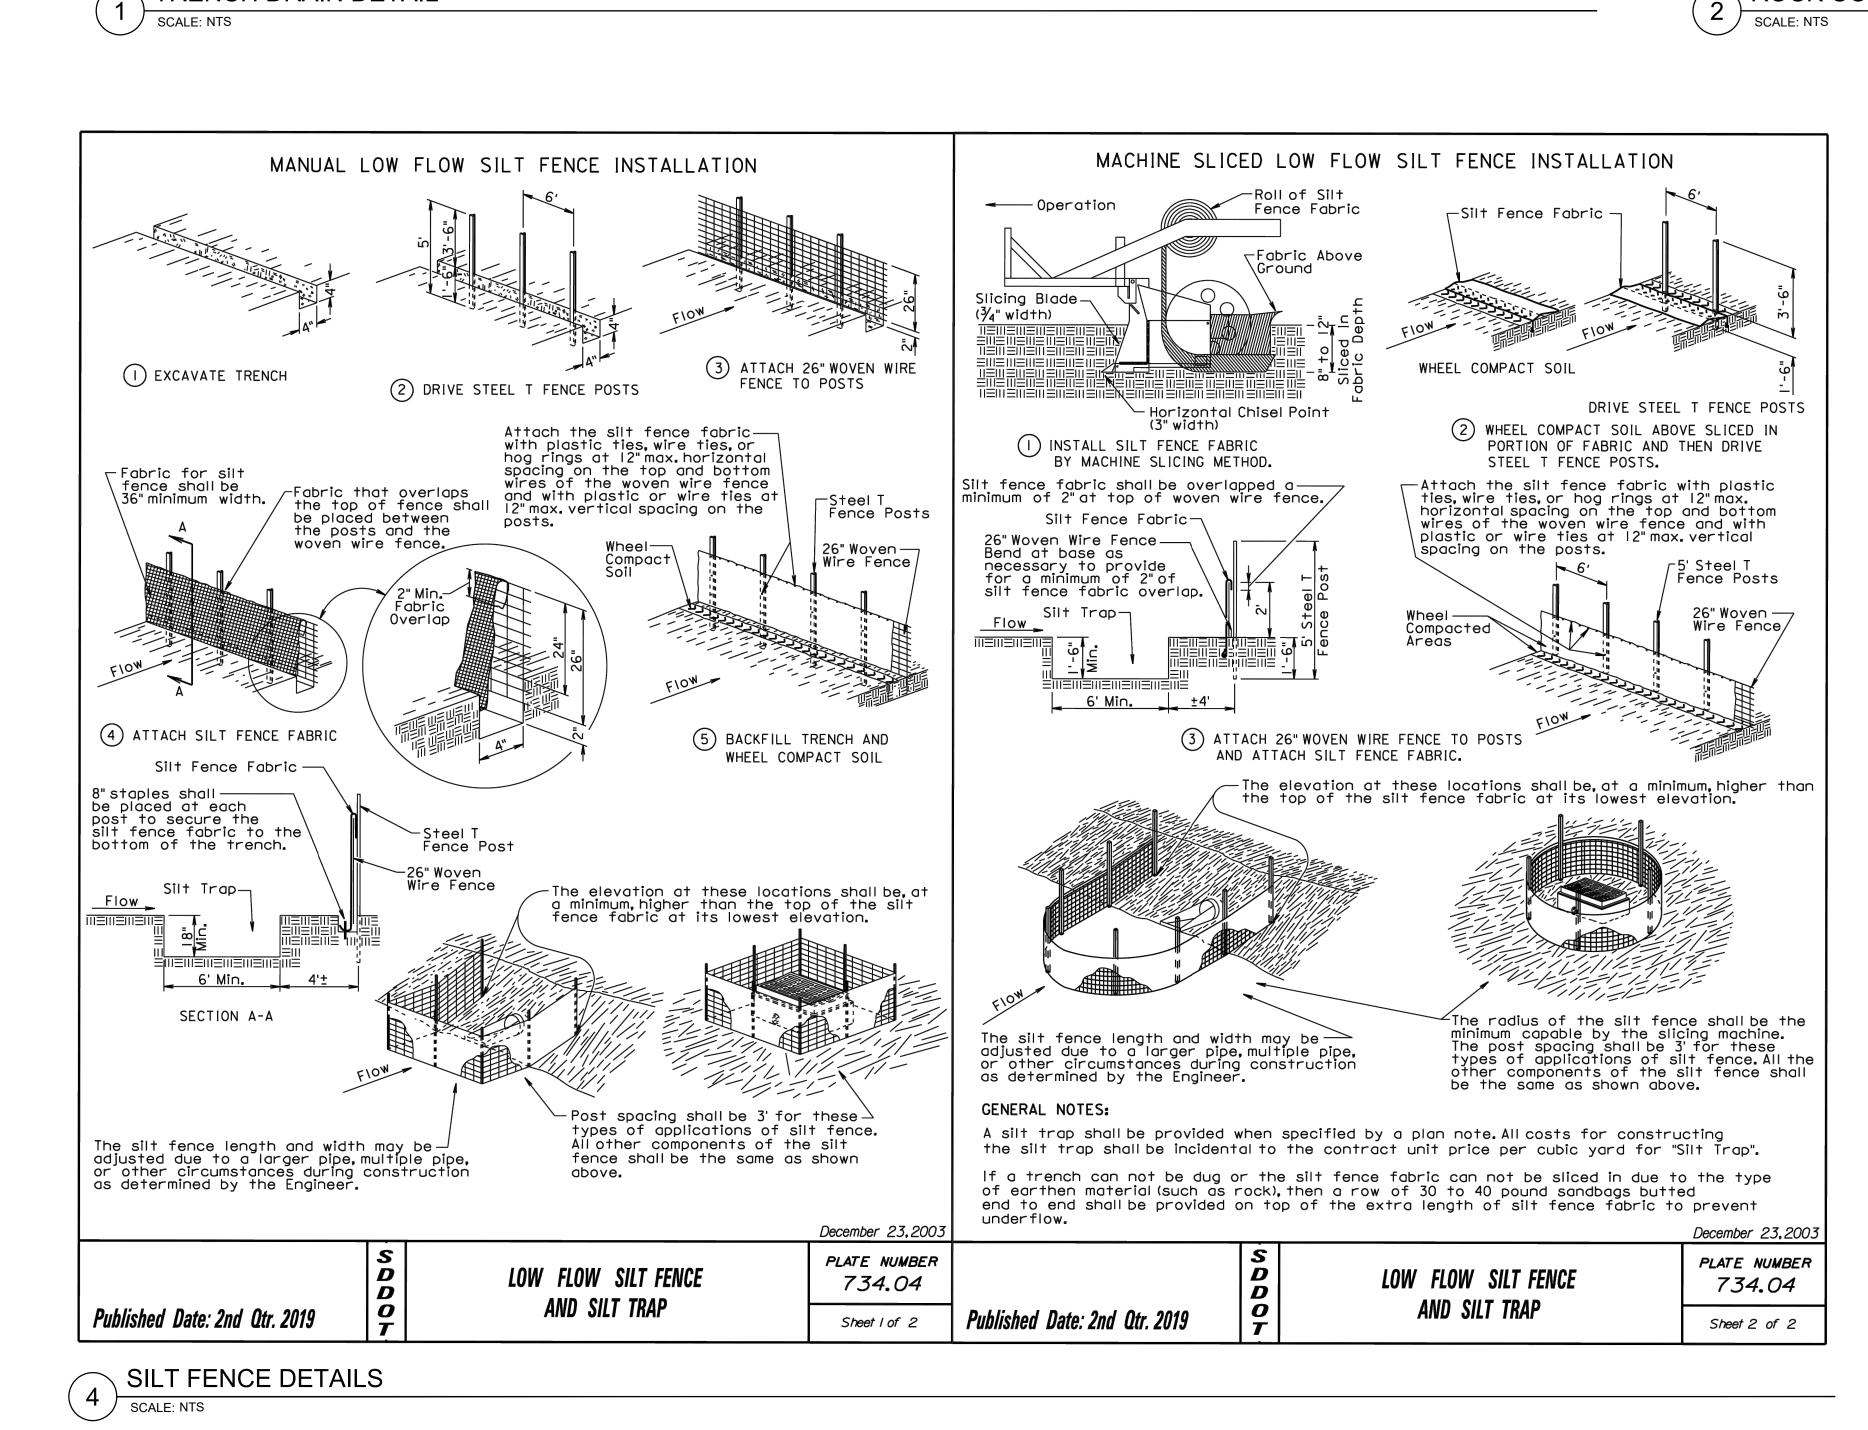

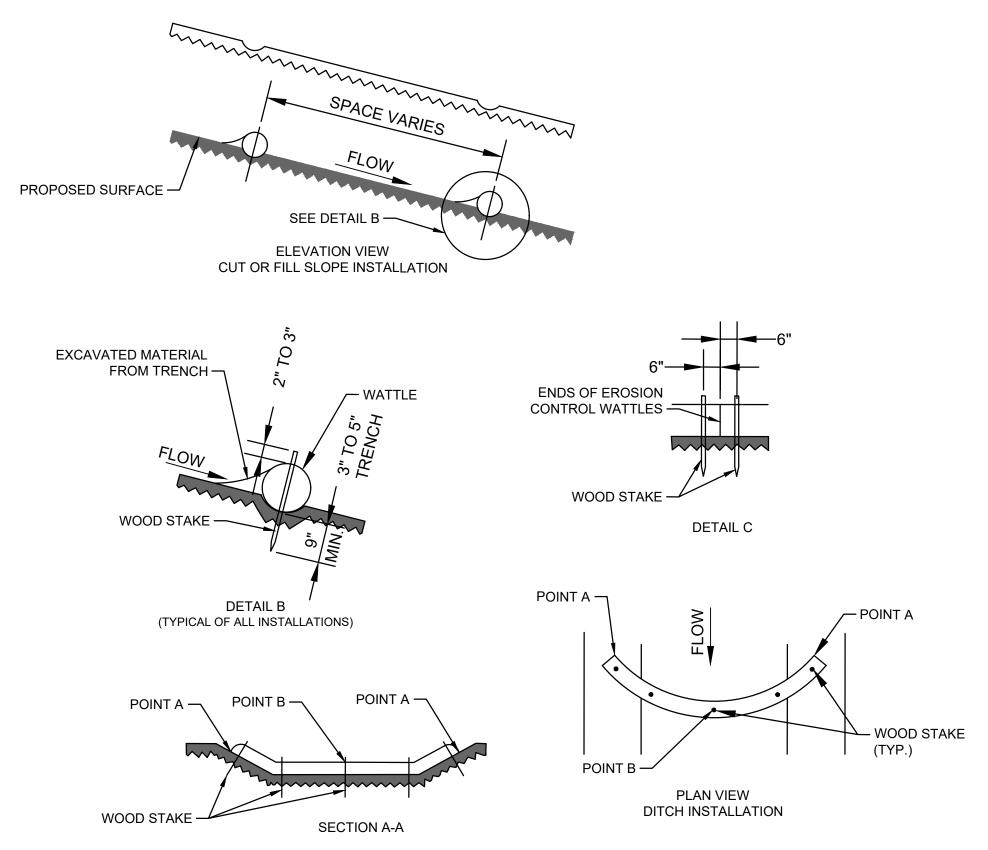

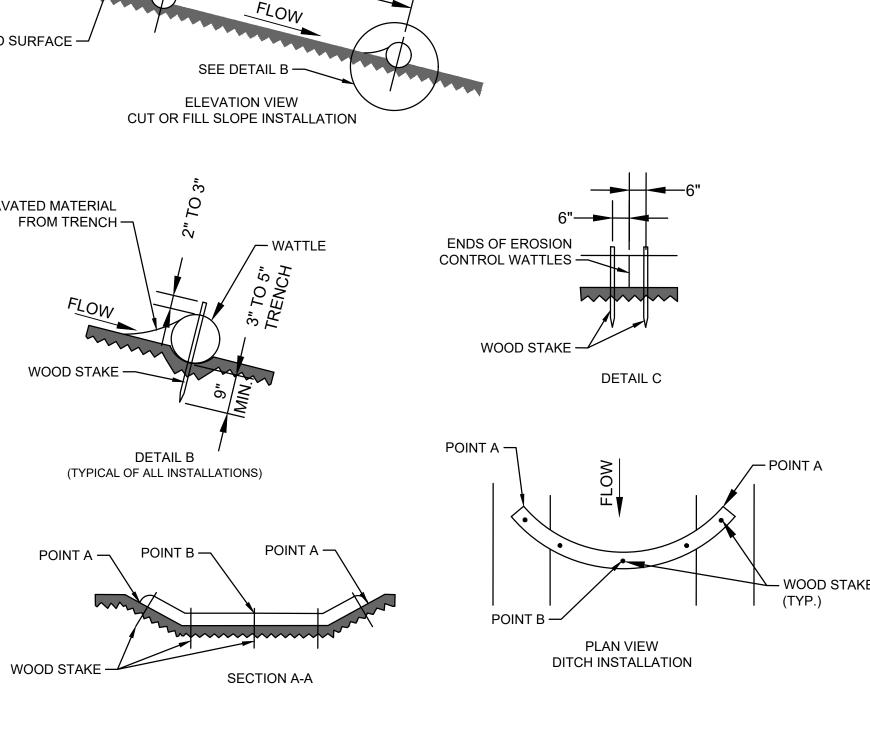


AT CUT OR FILL SLOPE INSTALLATIONS WATTLES SHALL BE INSTALLED ALONG THE CONTOUR AND PERPENDICULAR TO

NOT BE SEEN UNDER THE WATTLE, AND THEN COMPACT THE SOIL EXCAVATED FROM THE TRENCH AGAINST THE WATTLE

- THE WATER FLOW. AT DITCH INSTALLATIONS, POINT "A" MUST BE HIGHER THAN POINT "B" SO THAT WATER FLOWS OVER THE WATTLE AND NOT AROUND THE ENDS. THE CONTRACTOR SHALL DIG A 3" TO 5" TRENCH, INSTALL THE WATTLE TIGHTLY IN THE TRENCH SO THAT DAYLIGHT CAN
- ON THE UPHILL SIDE. SEE DETAIL B. THE STAKES SHALL BE 1"X2" OR 2"X2" WOOD STAKES. HOWEVER, OTHER TYPES OF STAKES SUCH AS REBAR MAY BE USED. THE STAKES SHALL BE PLACED 6" FROM THE ENDS OF THE WATTLES AND THE SPACING OF THE STAKES ALONG THE WATTLES SHALL BE 3' TO 4'.
- WHERE INSTALLING RUNNING LENGTHS OF WATTLES, THE CONTRACTOR SHALL BUTT THE SECOND WATTLE TIGHTLY AGAINST THE FIRST AND SHALL NOT OVERLAP THE ENDS. SEE DETAIL C

SEDIMENT CONTROL WATTLE

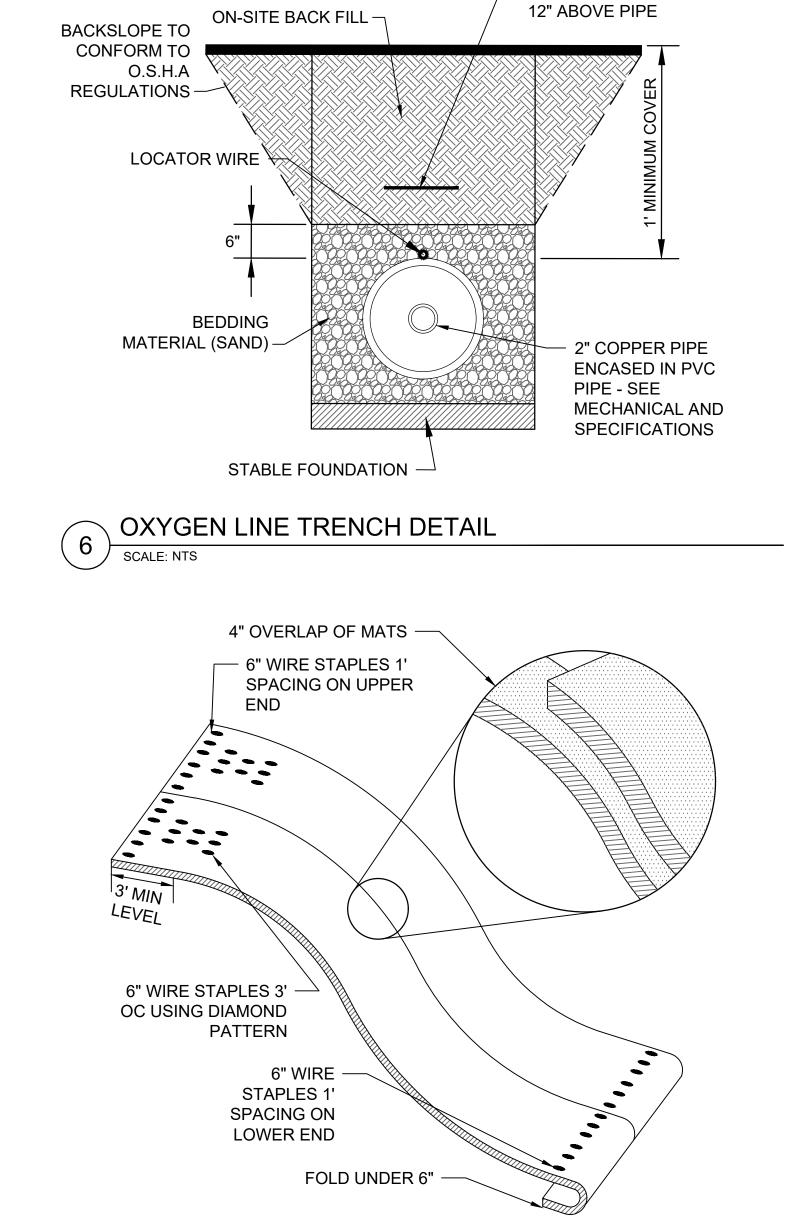

EROSION CONTROL BLANKET

- WARNING TAPE



ARCHITECT/ENGINEER OF RECORD | STAMP ANDERSON


SPECIFICATION, OR REPORT, WAS PREPARED BY ME OR UNDER MY DIRECT SUPERVISION, AND THAT I AM A DULY LICENSED PROFESSIONAL NGINEER UNDER THE LAWS OF THE STATE, OF MINNESOTA 13605 1st Ave. N. #100 Plymouth, MN 55441 P 763.412.4000 | F 763.412.4090 | ae-mn.com Anderson Engineering of Minnesota, LLC | Proj # 16584 EDWIN J. Y. BRODMARKLE, PE DATE: 2025.02.14 LICENSE NO: 55409


Office of Construction and Facilities Management U.S. Department of Veterans Affairs


	Drawing Title
	CIVIL DETAILS
	Approved: Project Director
	SIOUX FALLS VA
-	HEALTH CADE SYSTE


ng Title	Phase	Project Title			Project Number	
CIVIL DETAILS	DID DOOLIMENTO	CONSTRUCT NEW SPS			438-460	
OIVIL DLIAILO	BID DOCUMENTS				Building Number 5	
ved: Project Director SIOUX FALLS VA		Location SIOUX FALLS, SOUTH DAKOTA			Drawing Number	
HEALTH CARE SYSTEM	FULLY SPRINKLERED	Issue Date 02/14/2025	Checked EB	Drawn AB	C-506	


SCALE: NTS

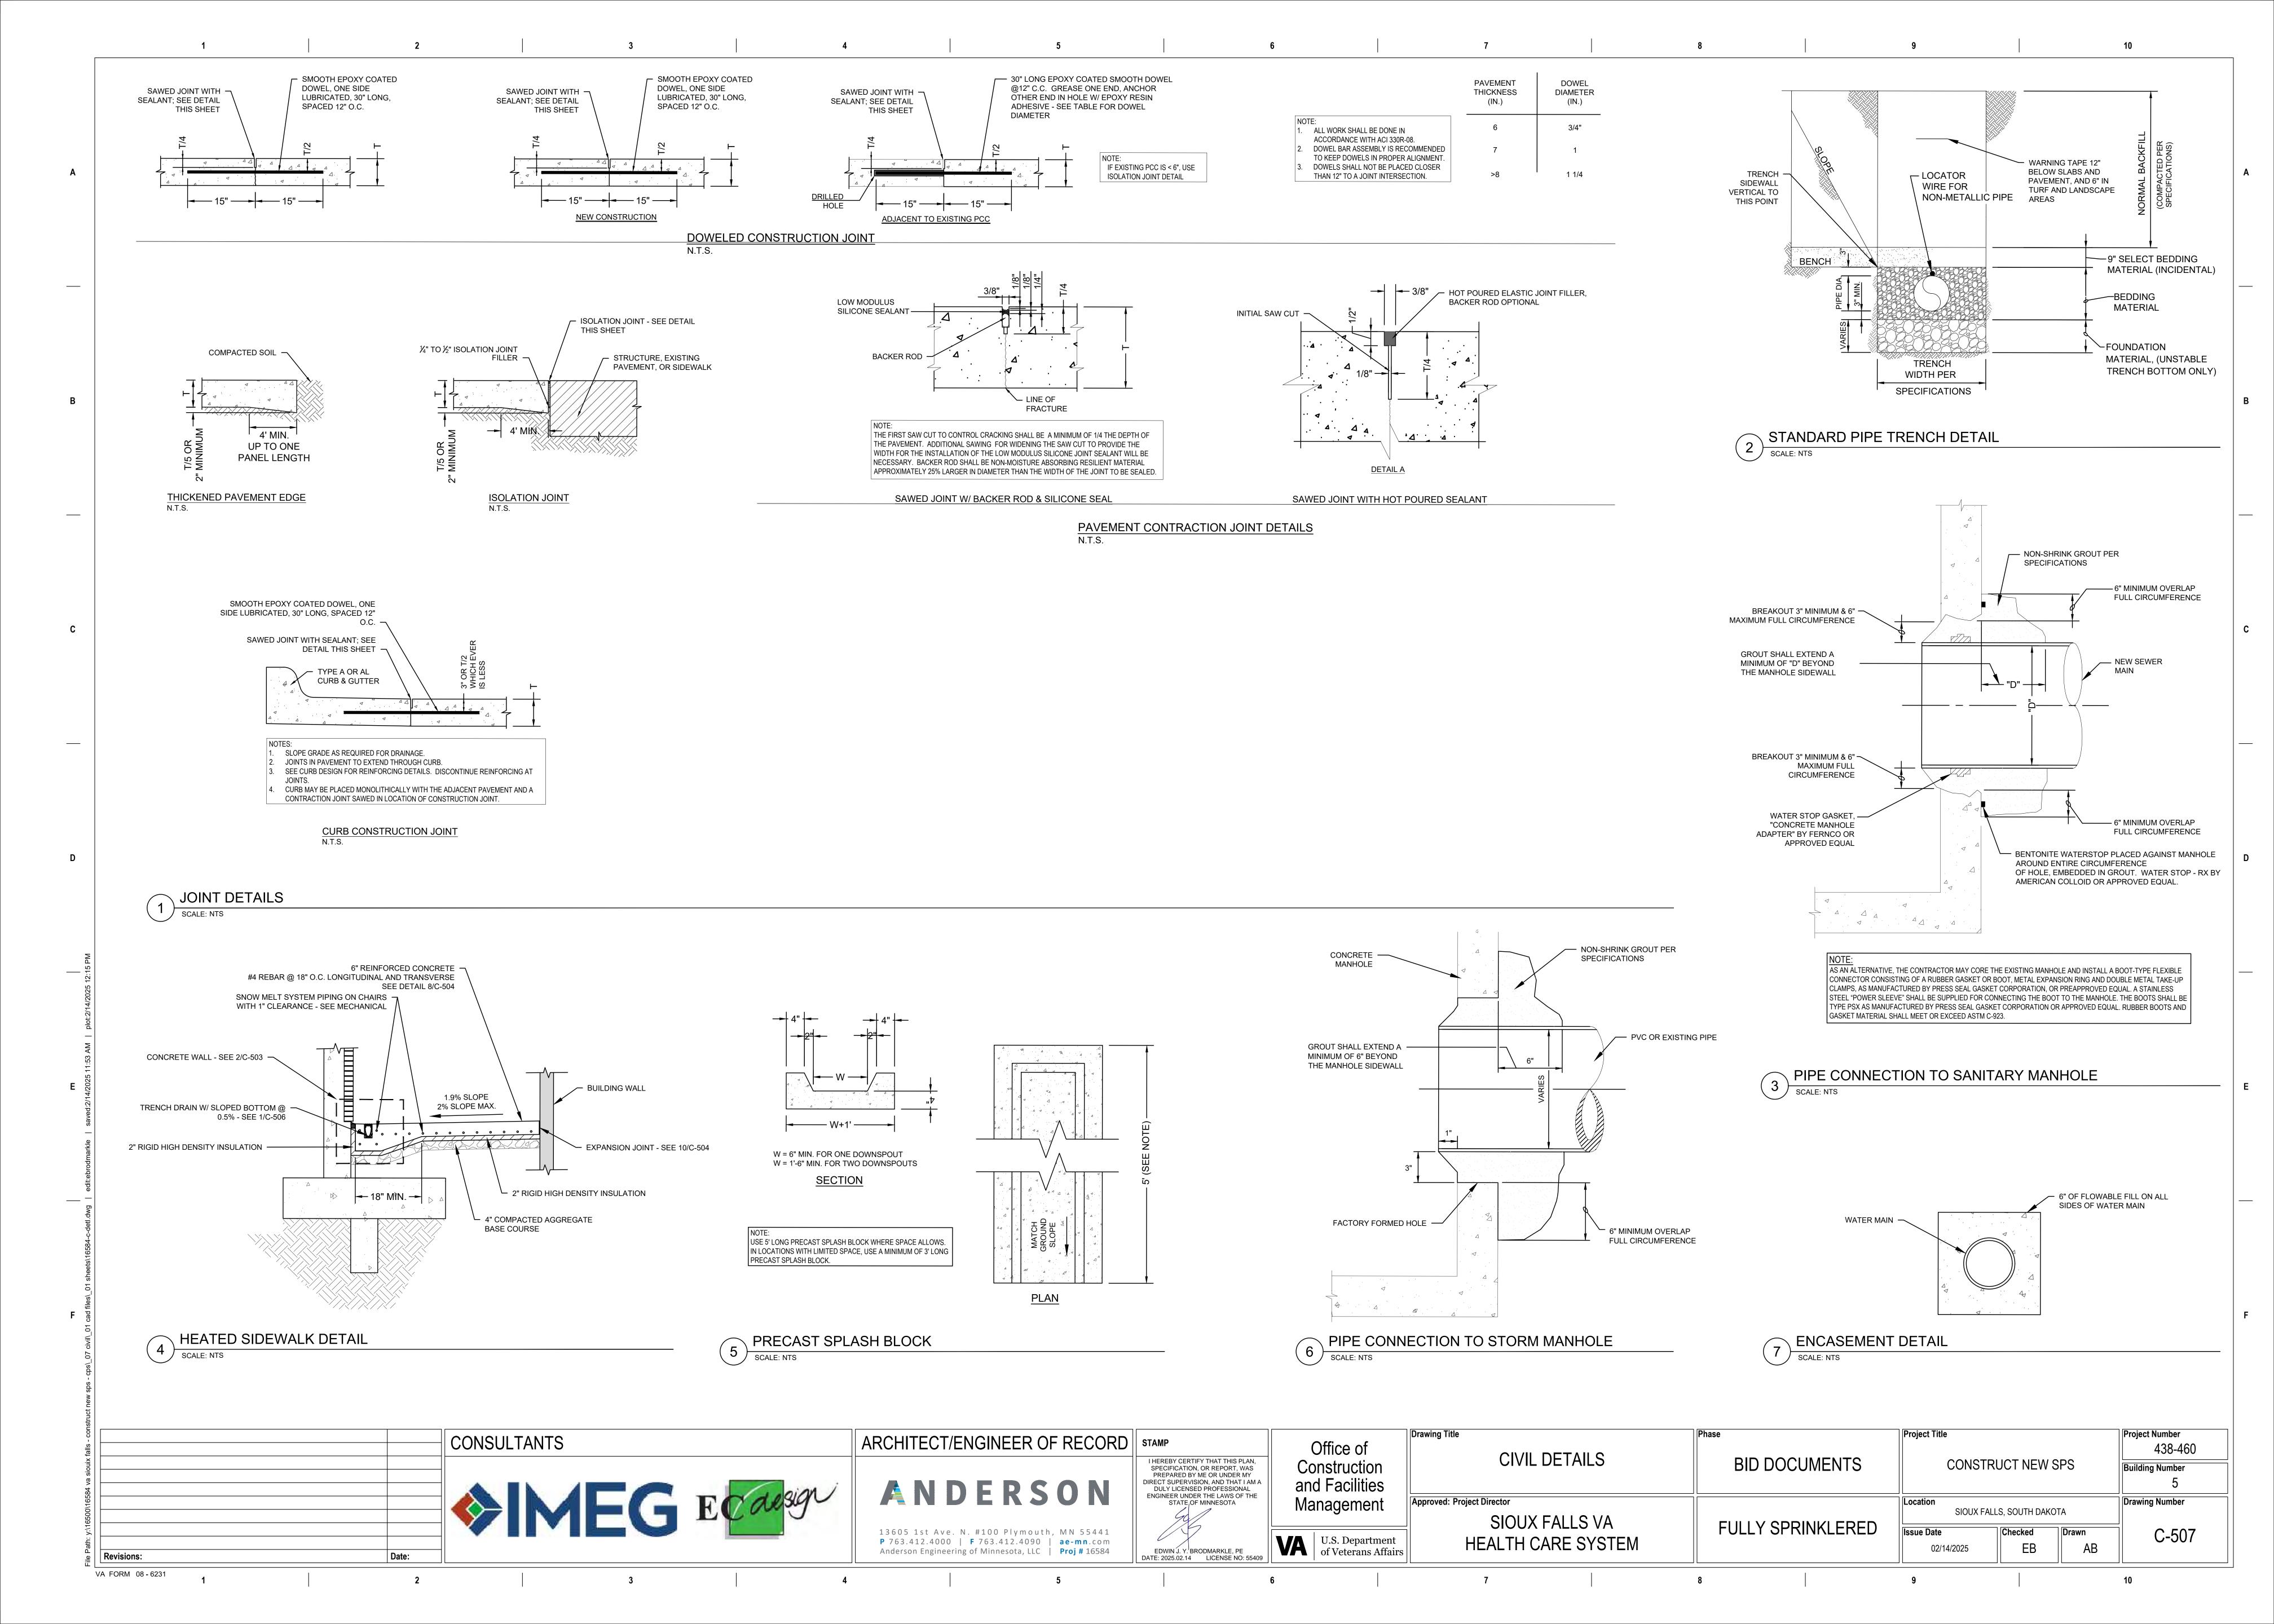


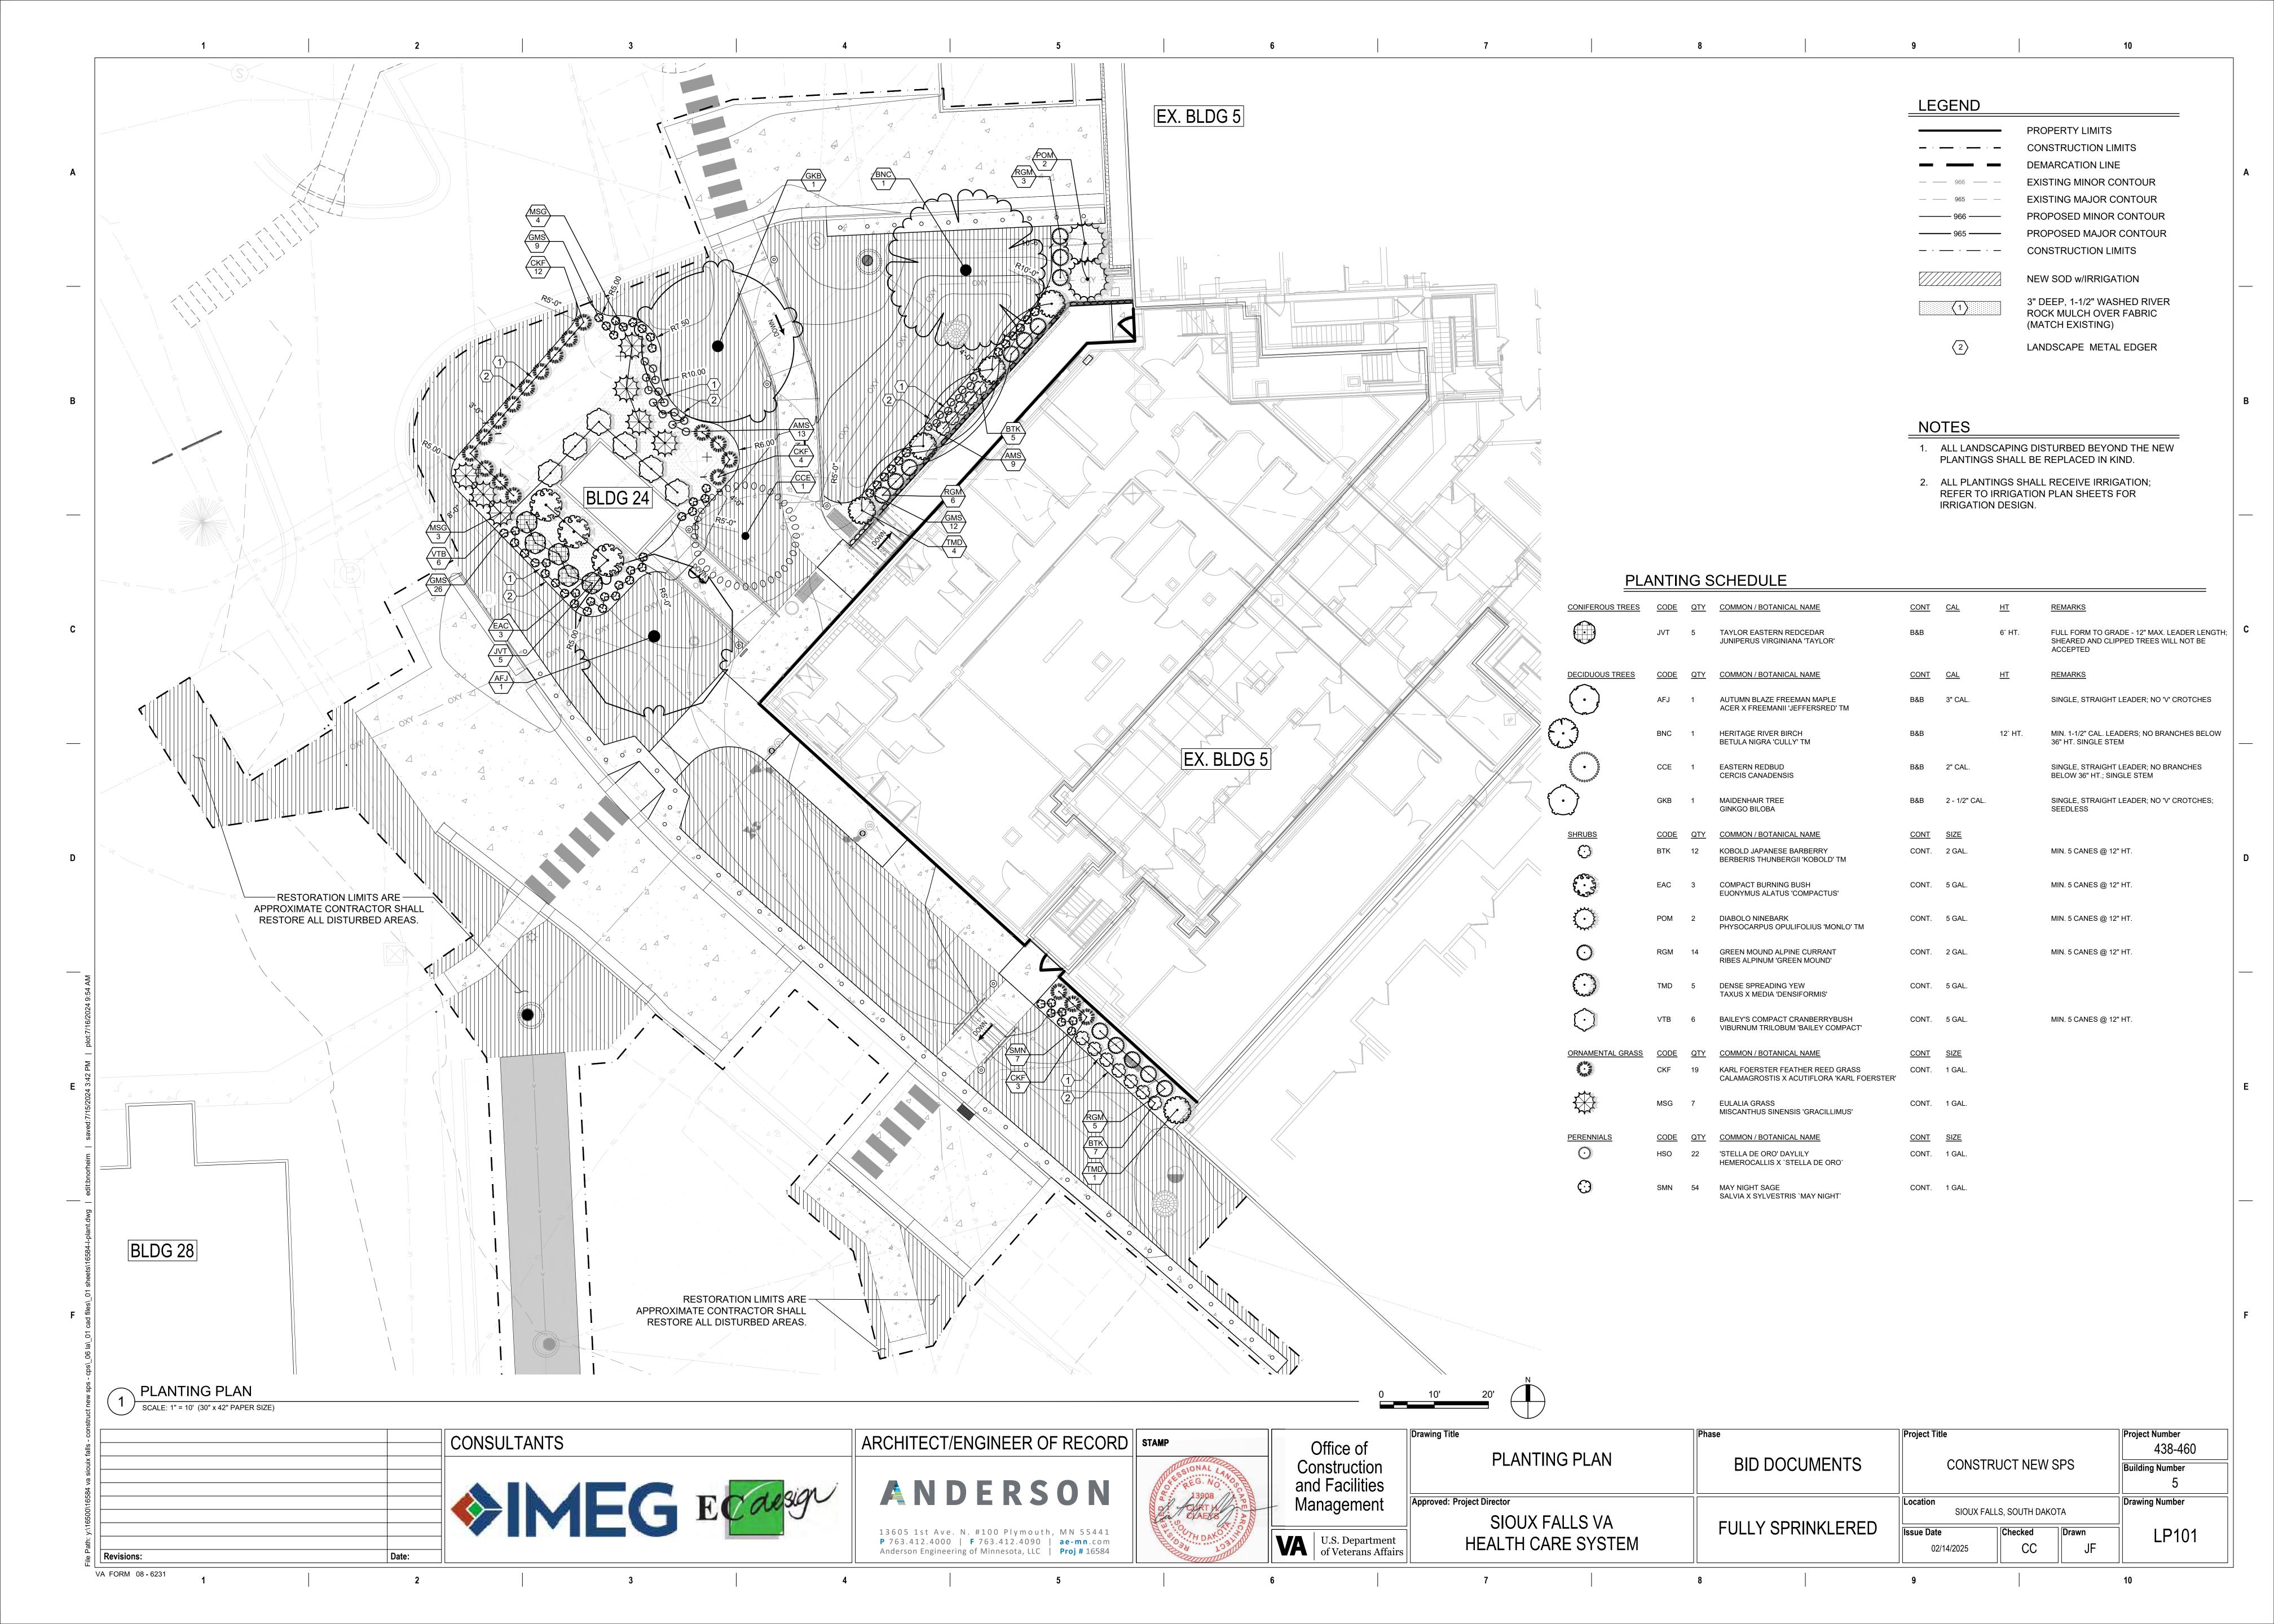


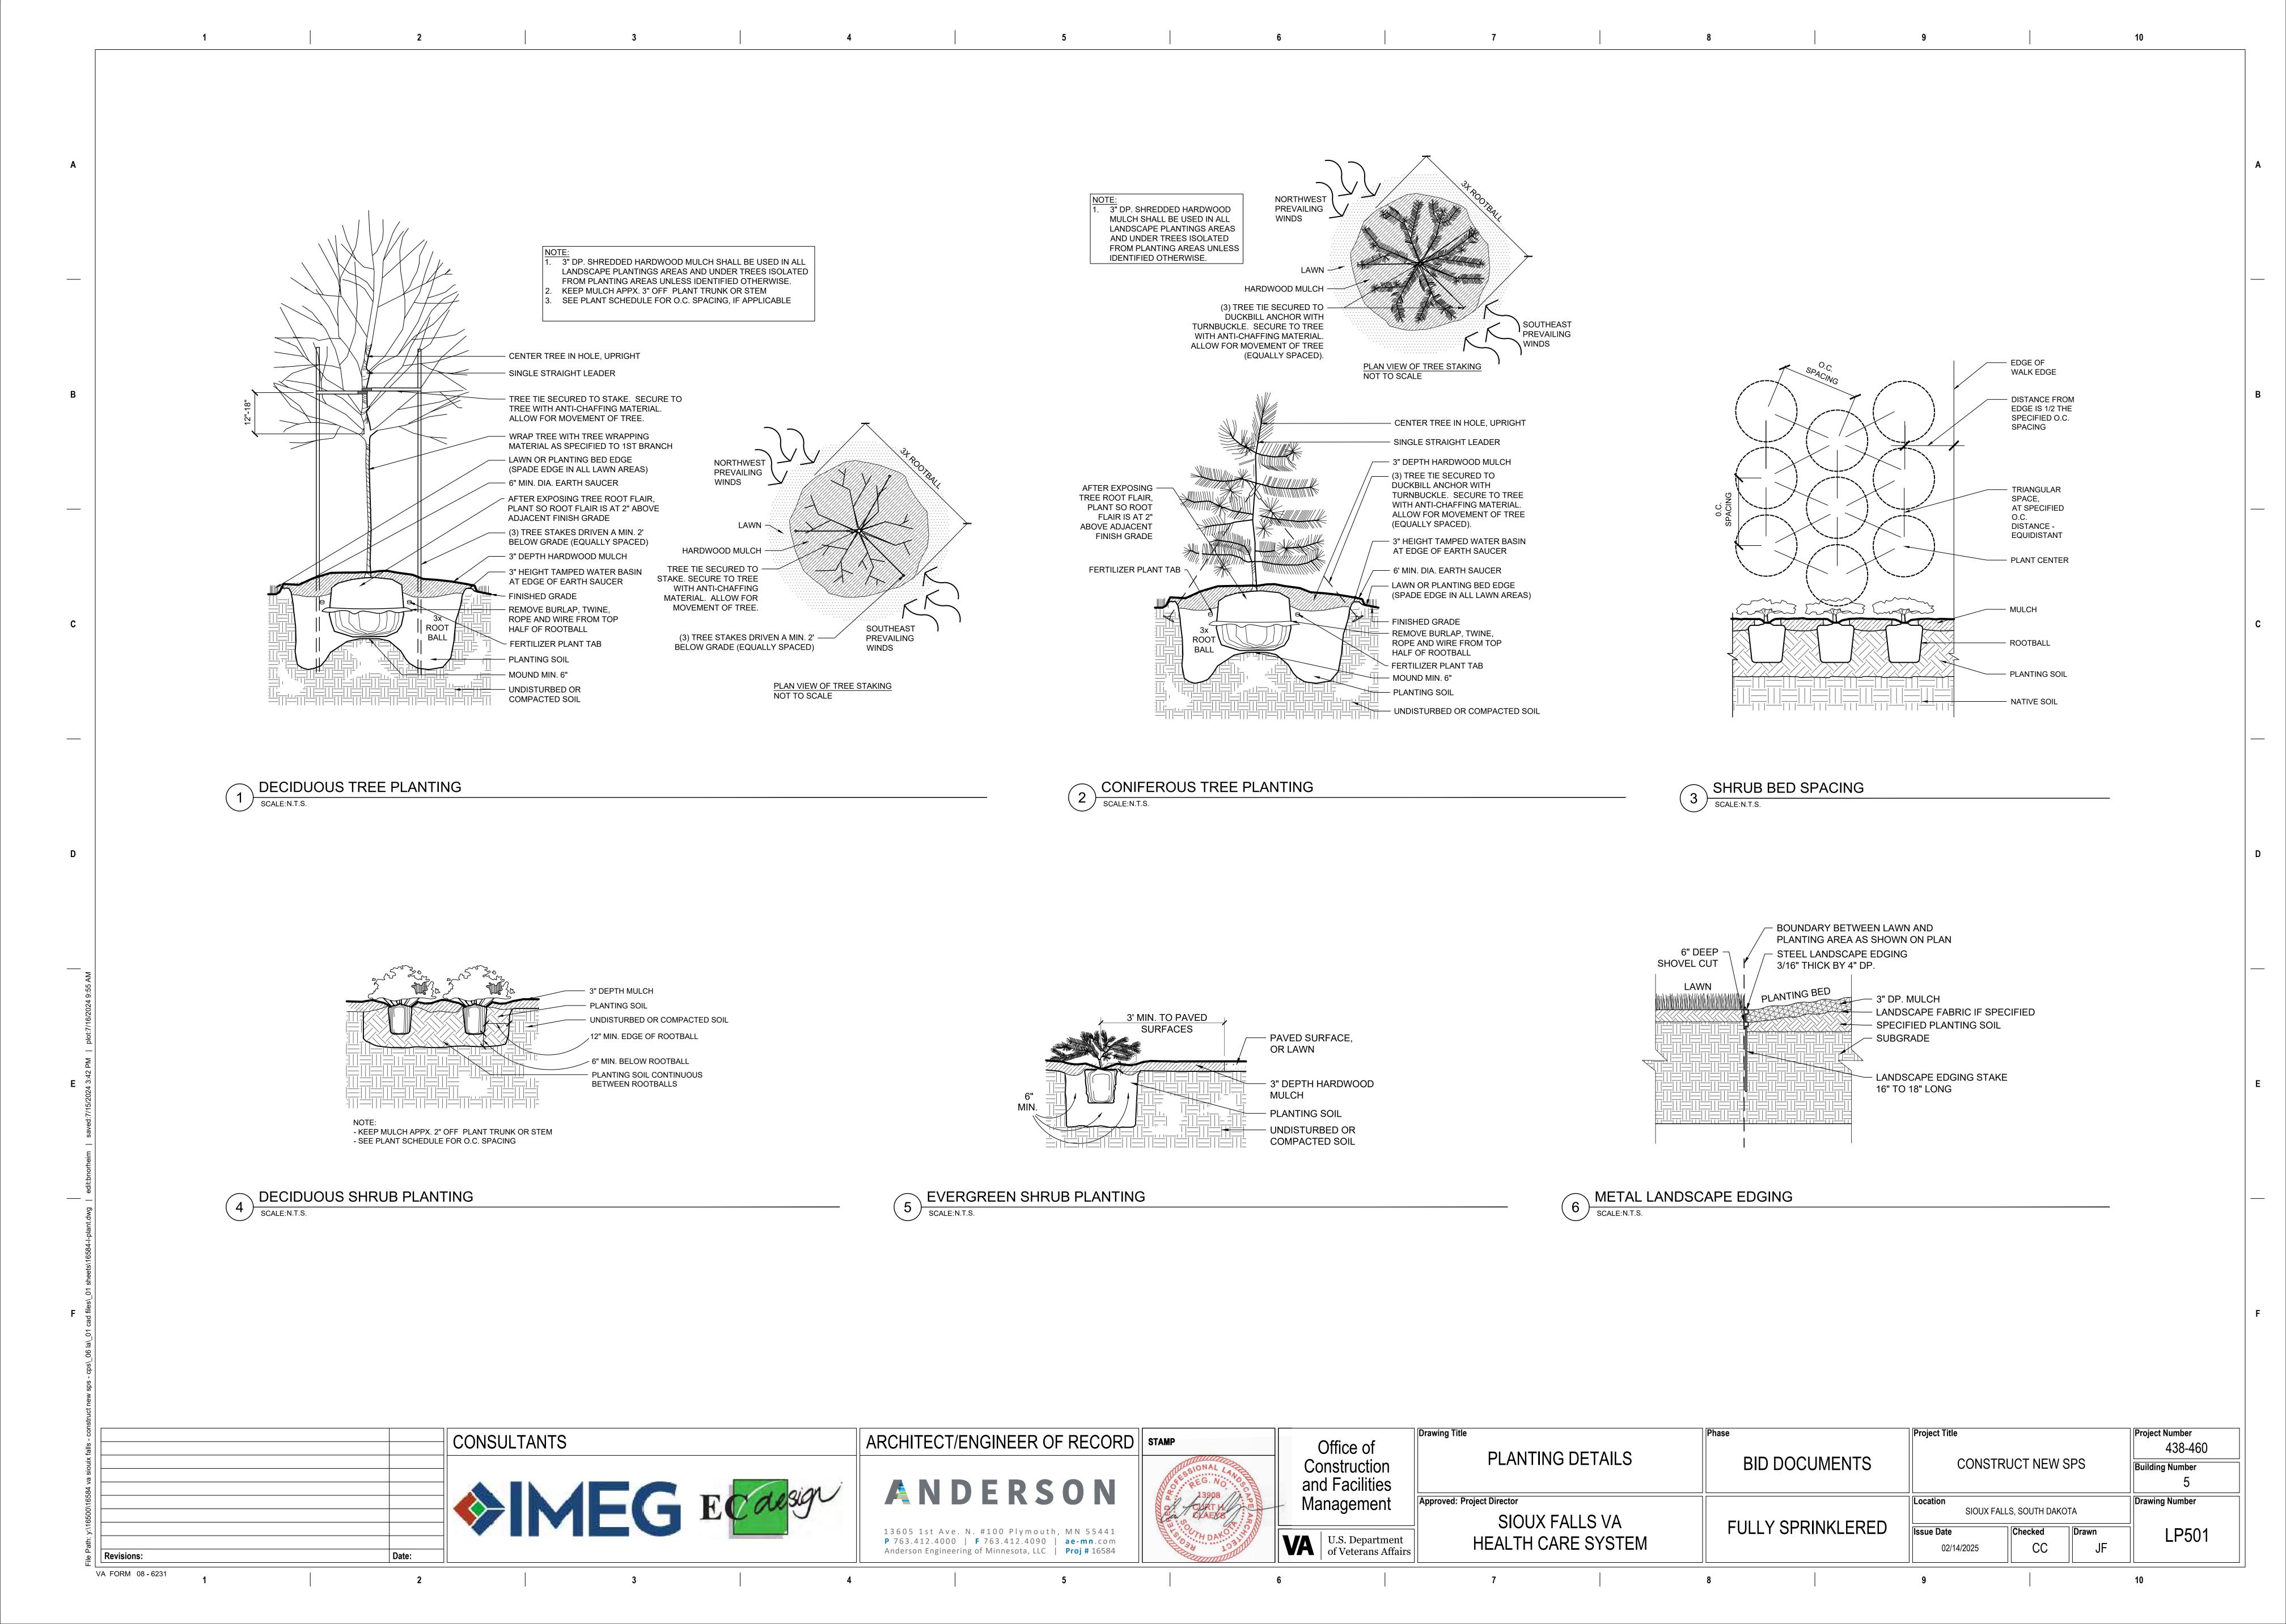


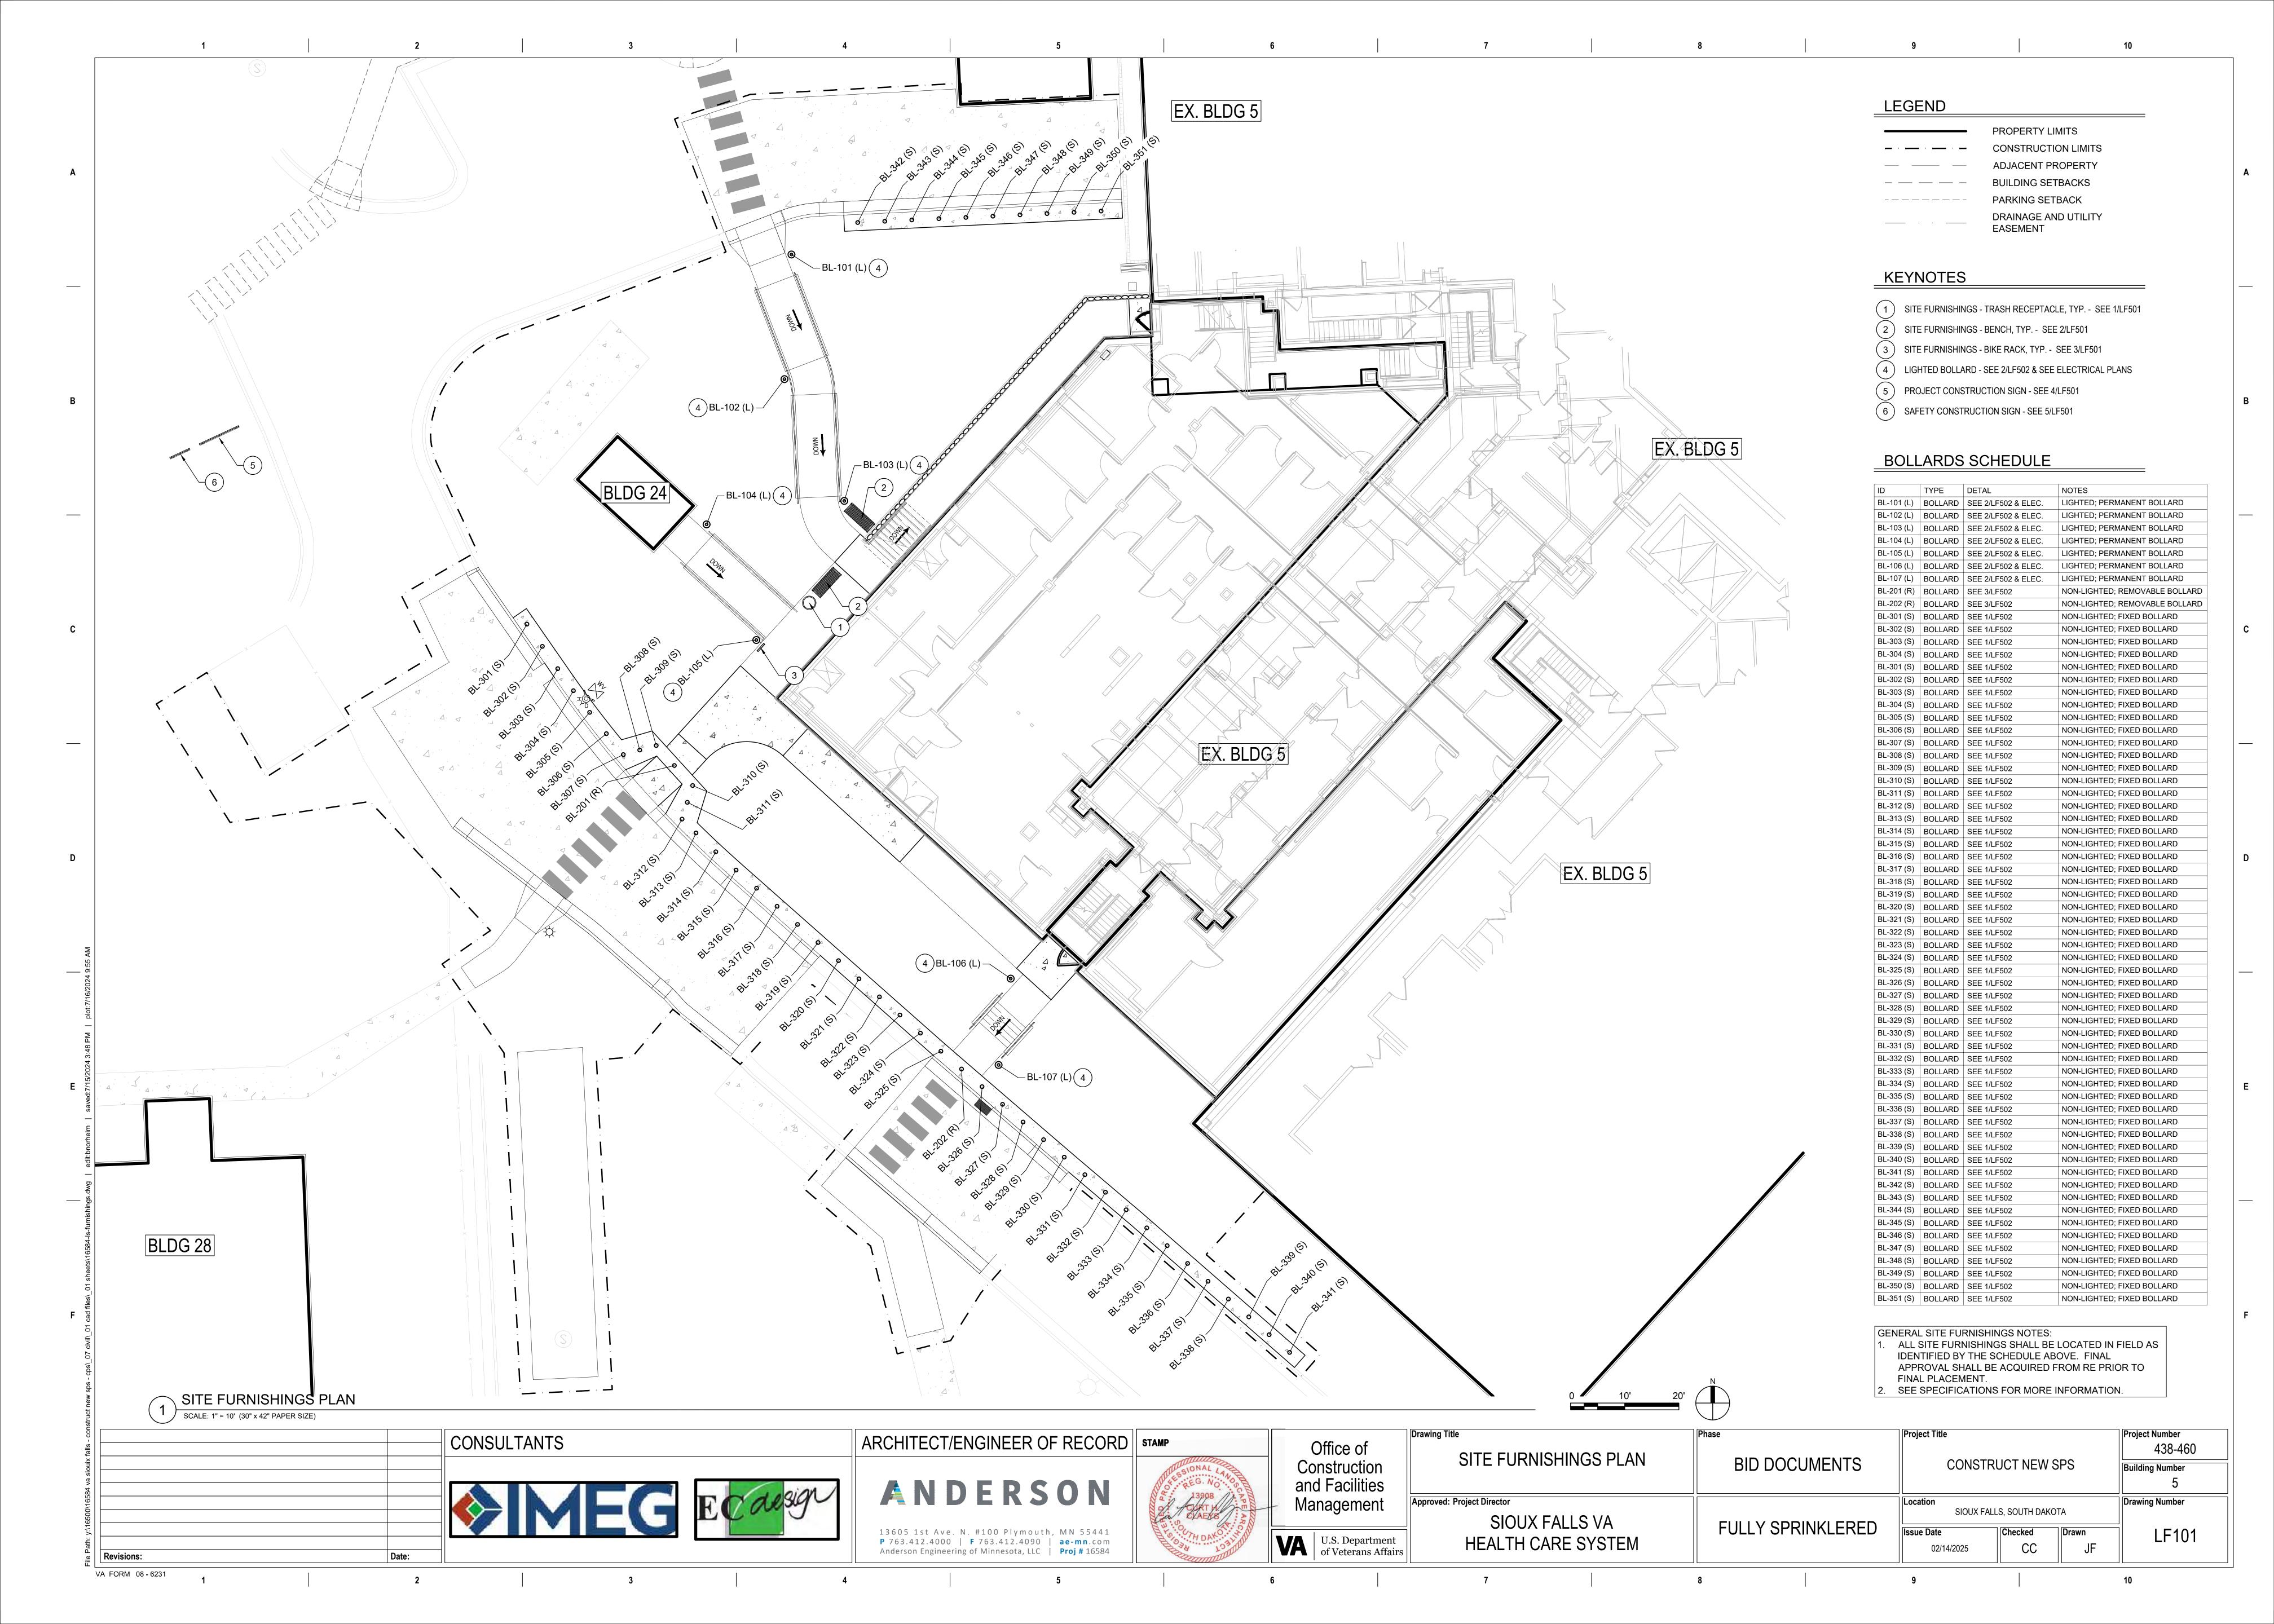

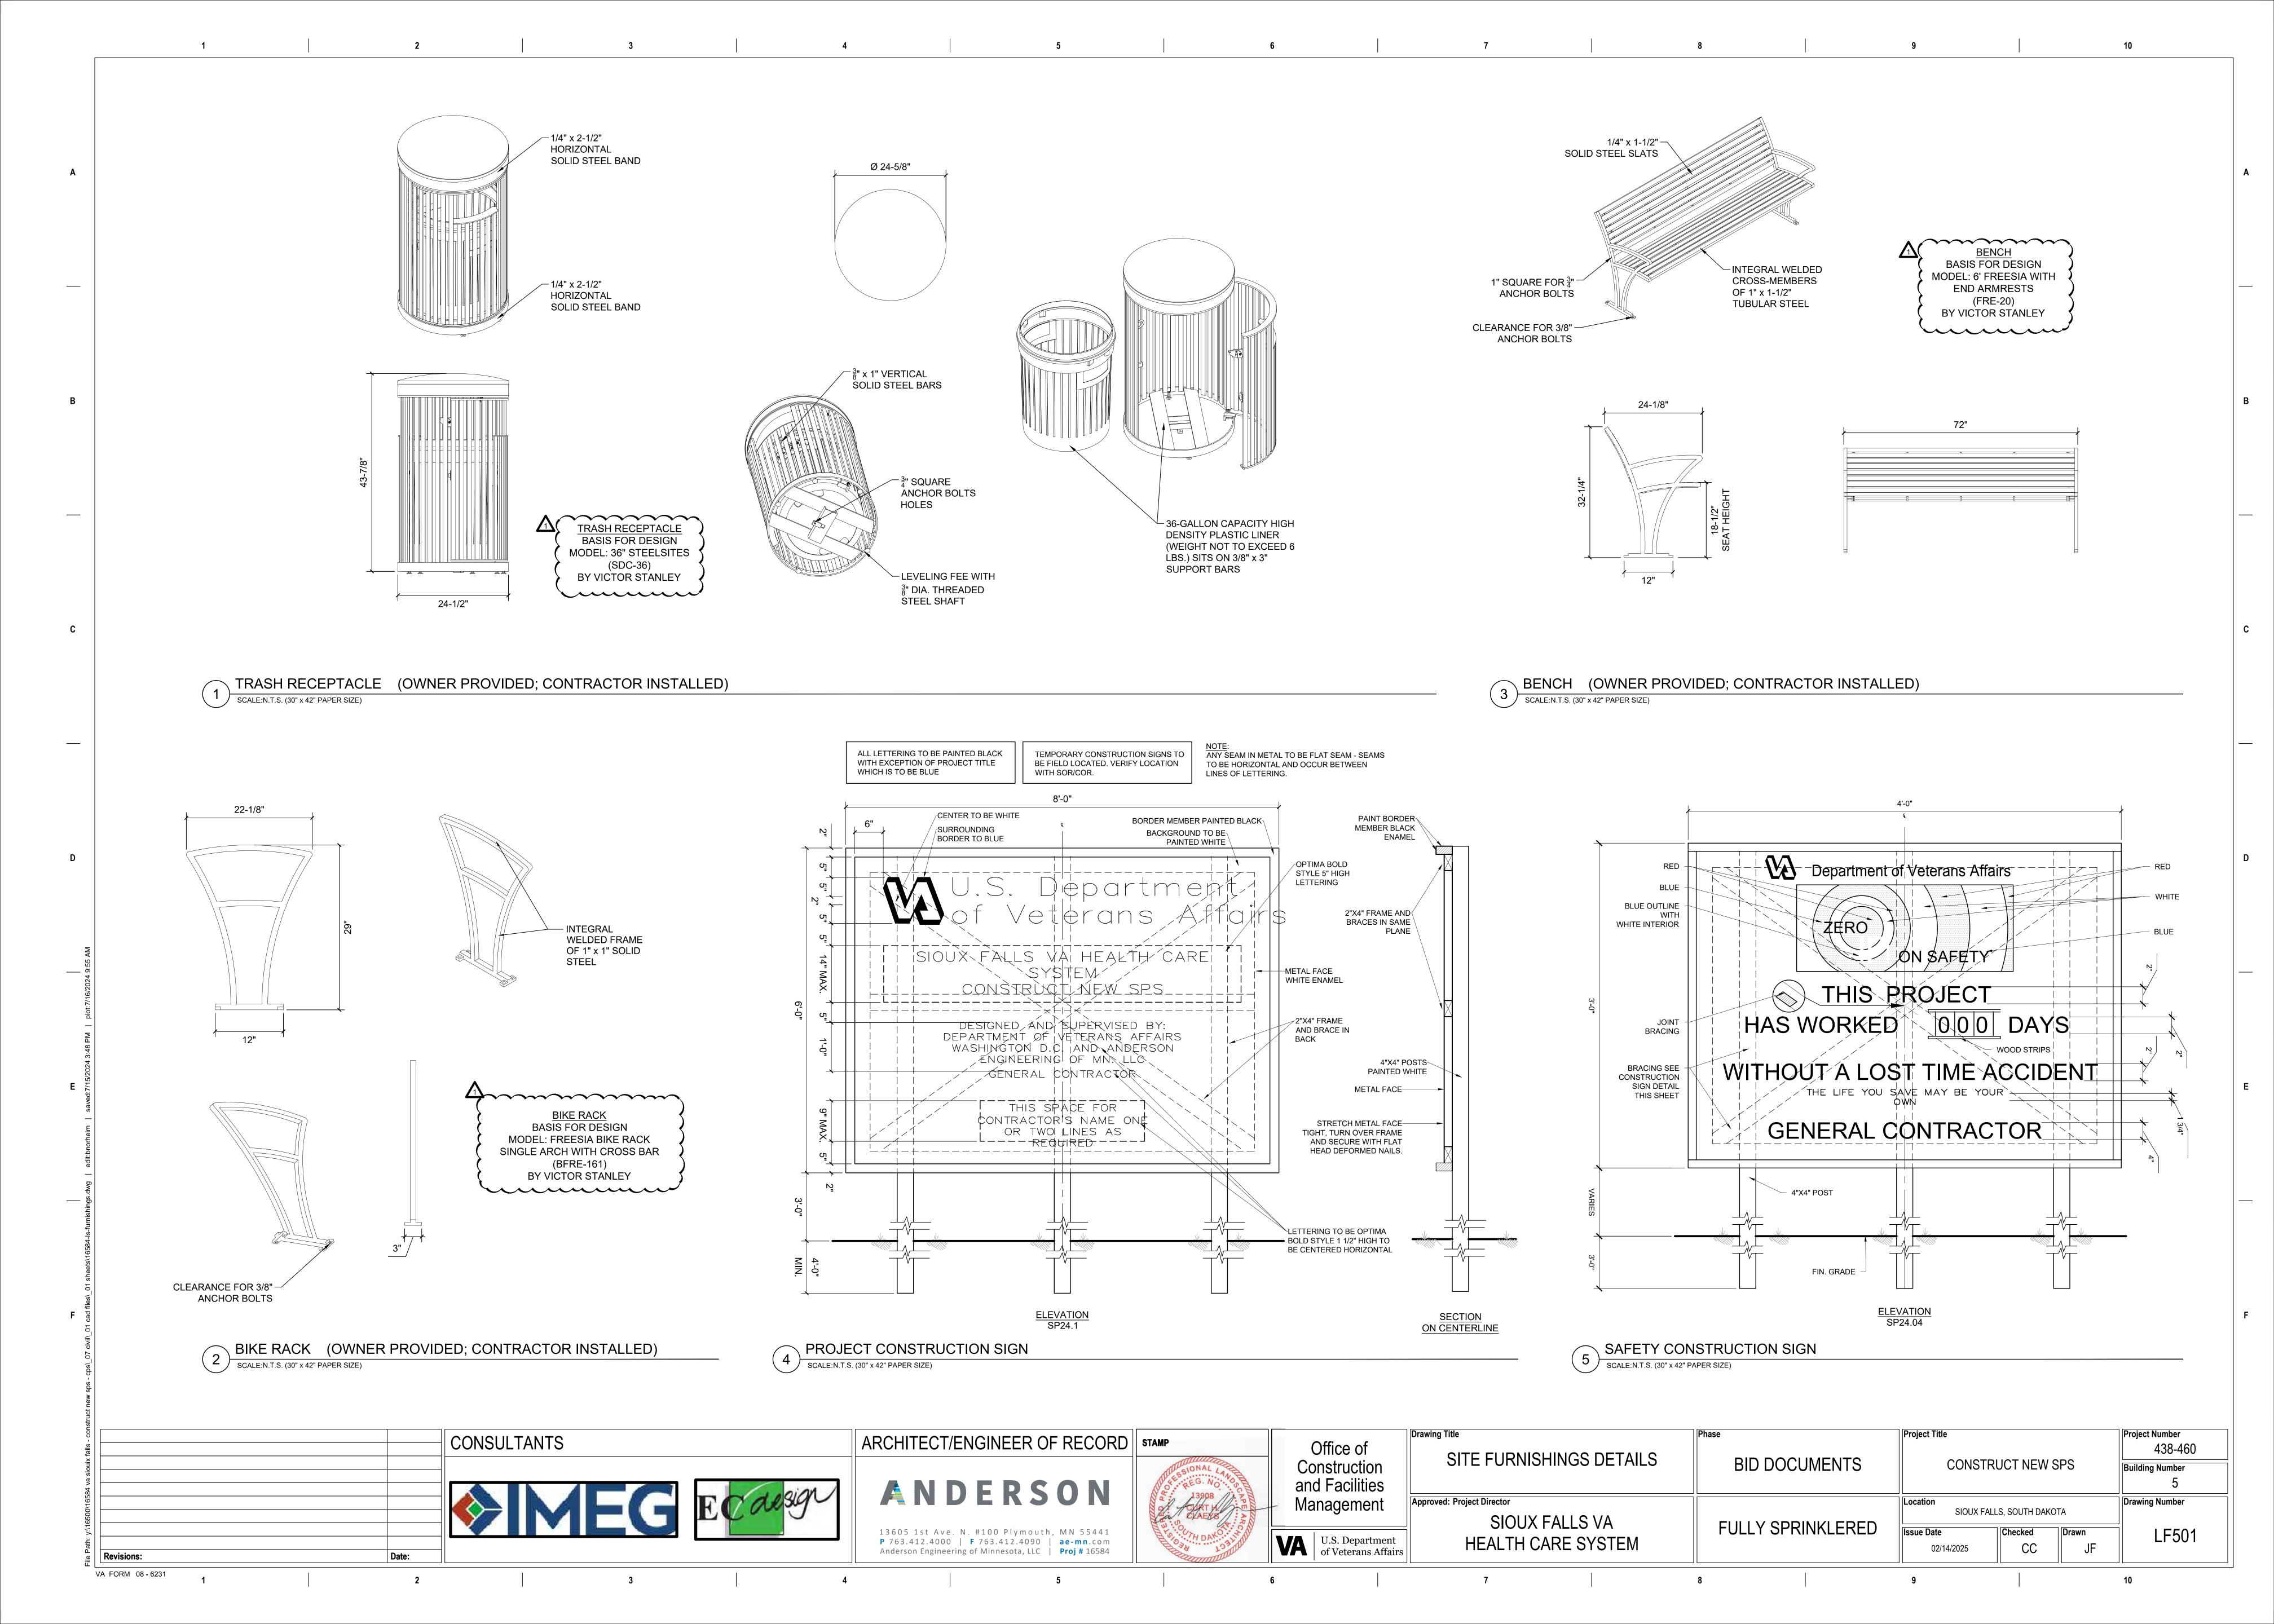


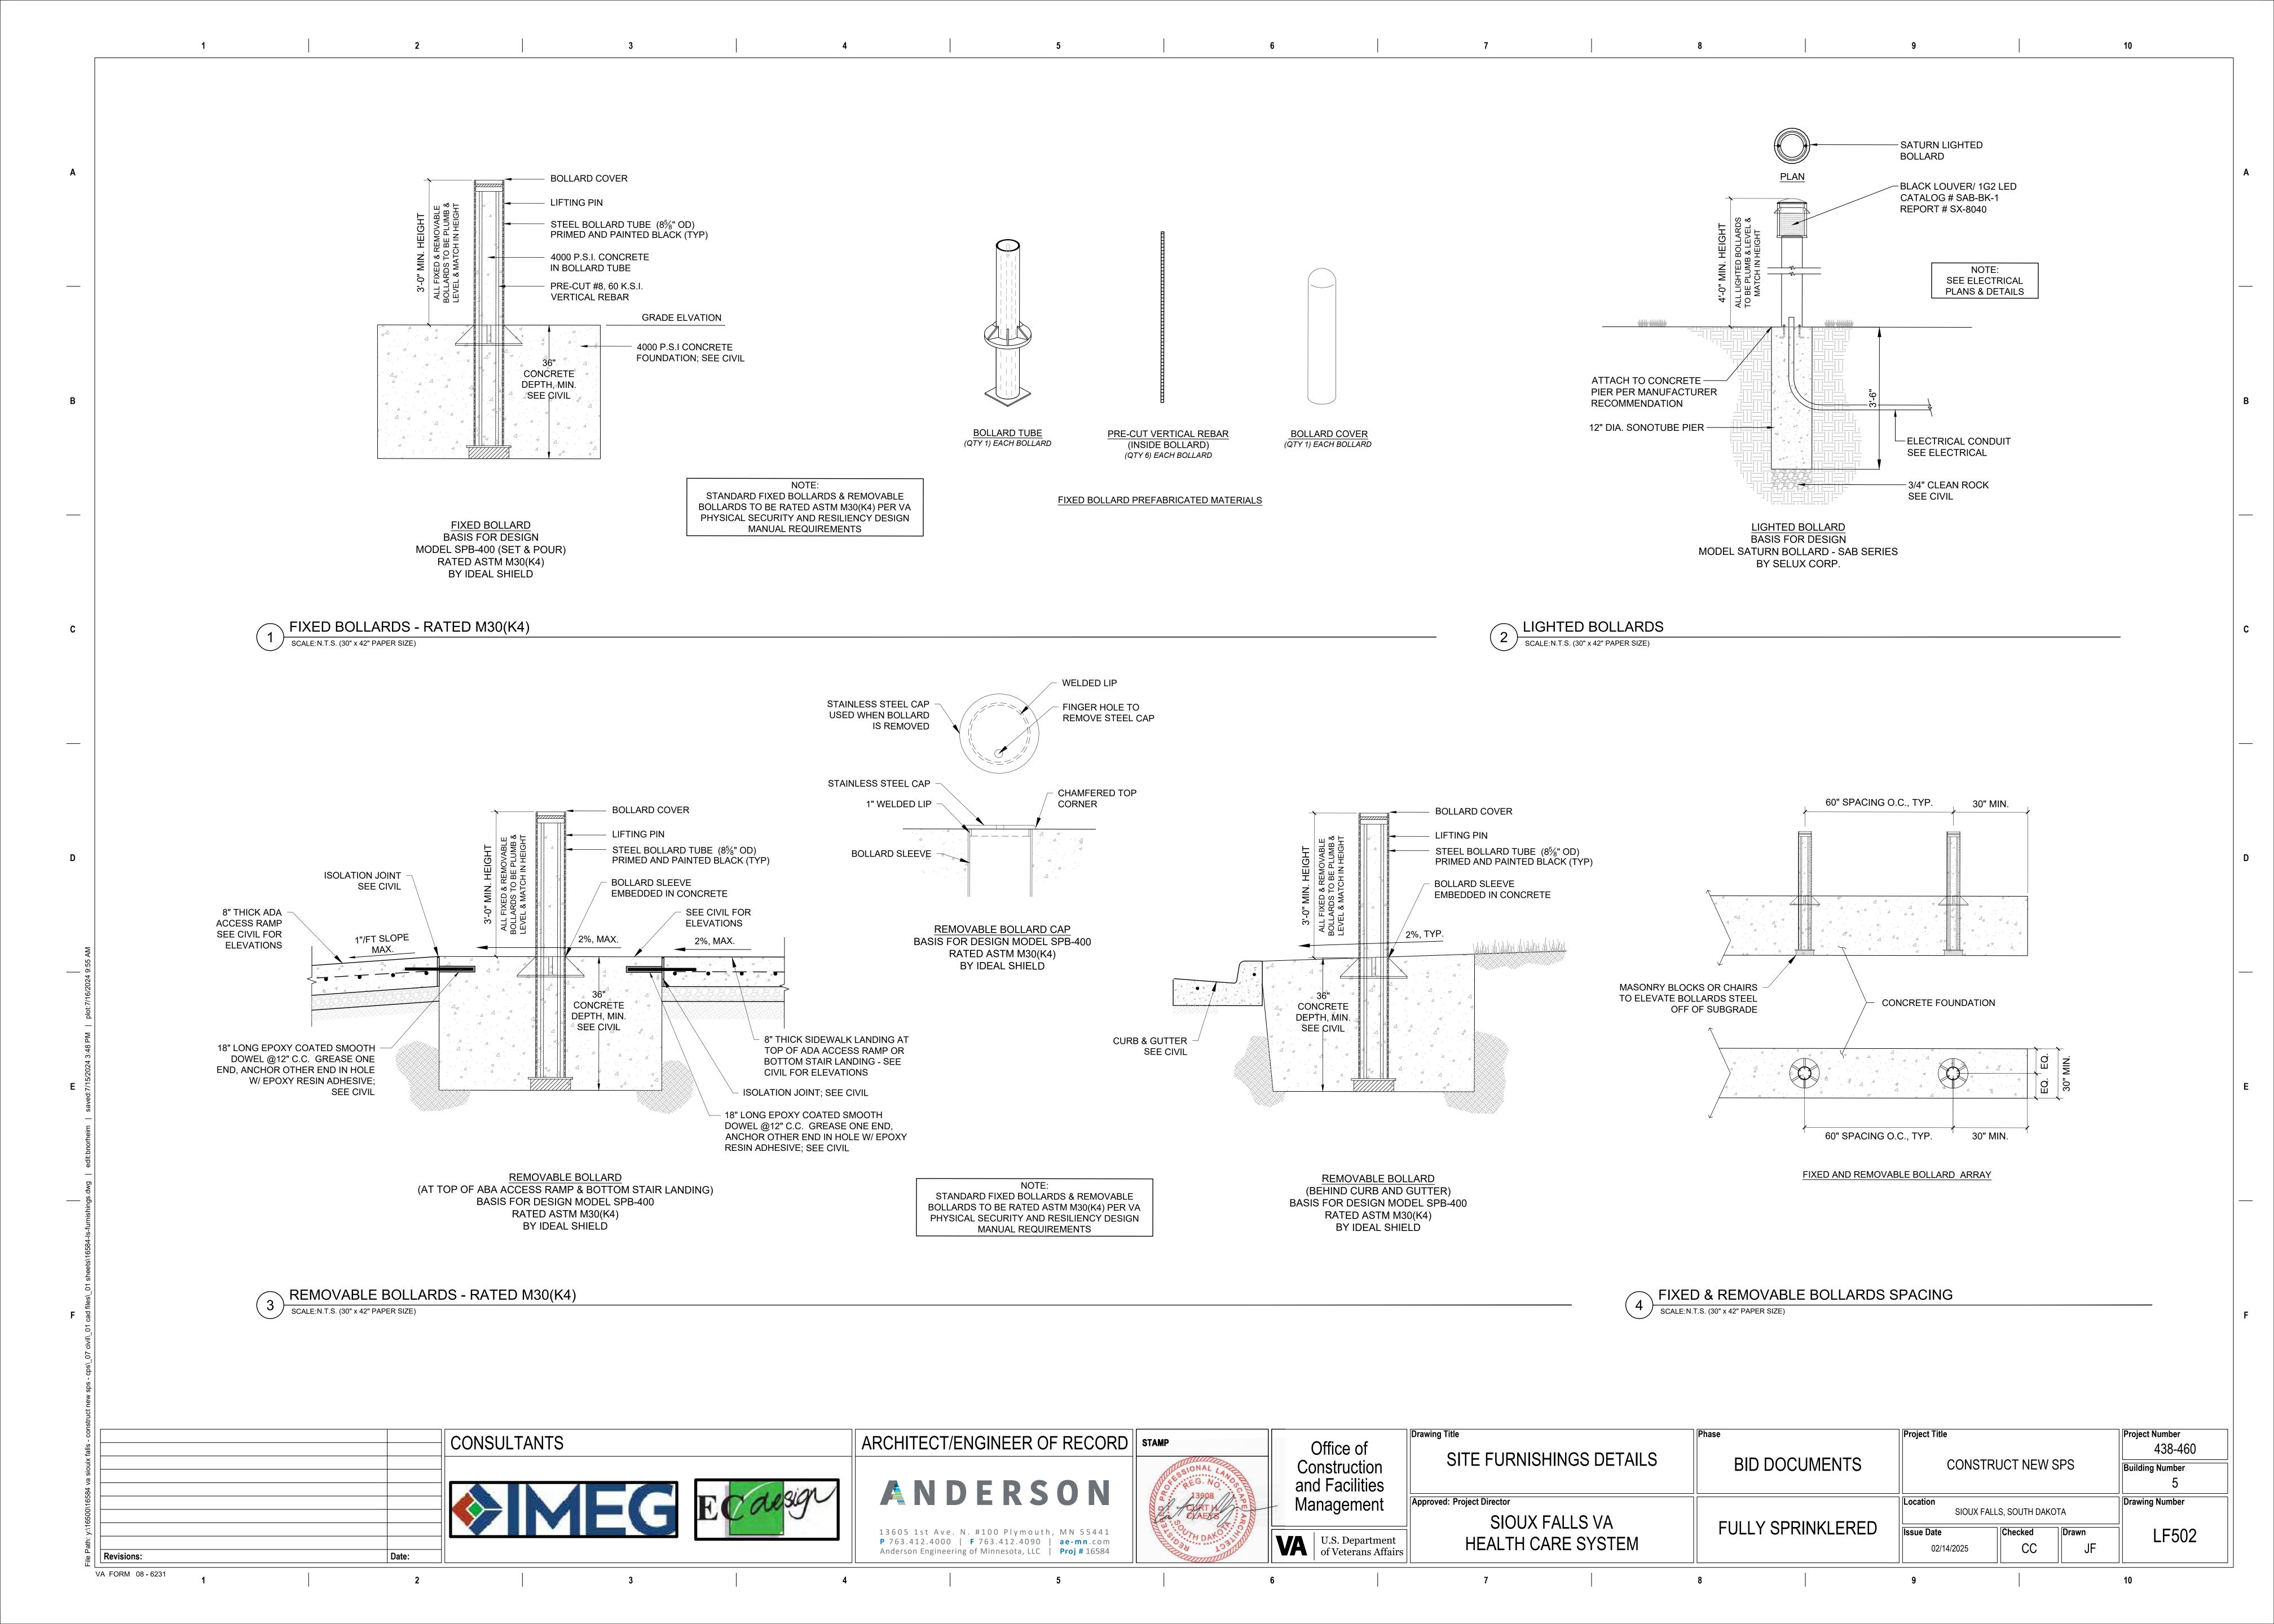

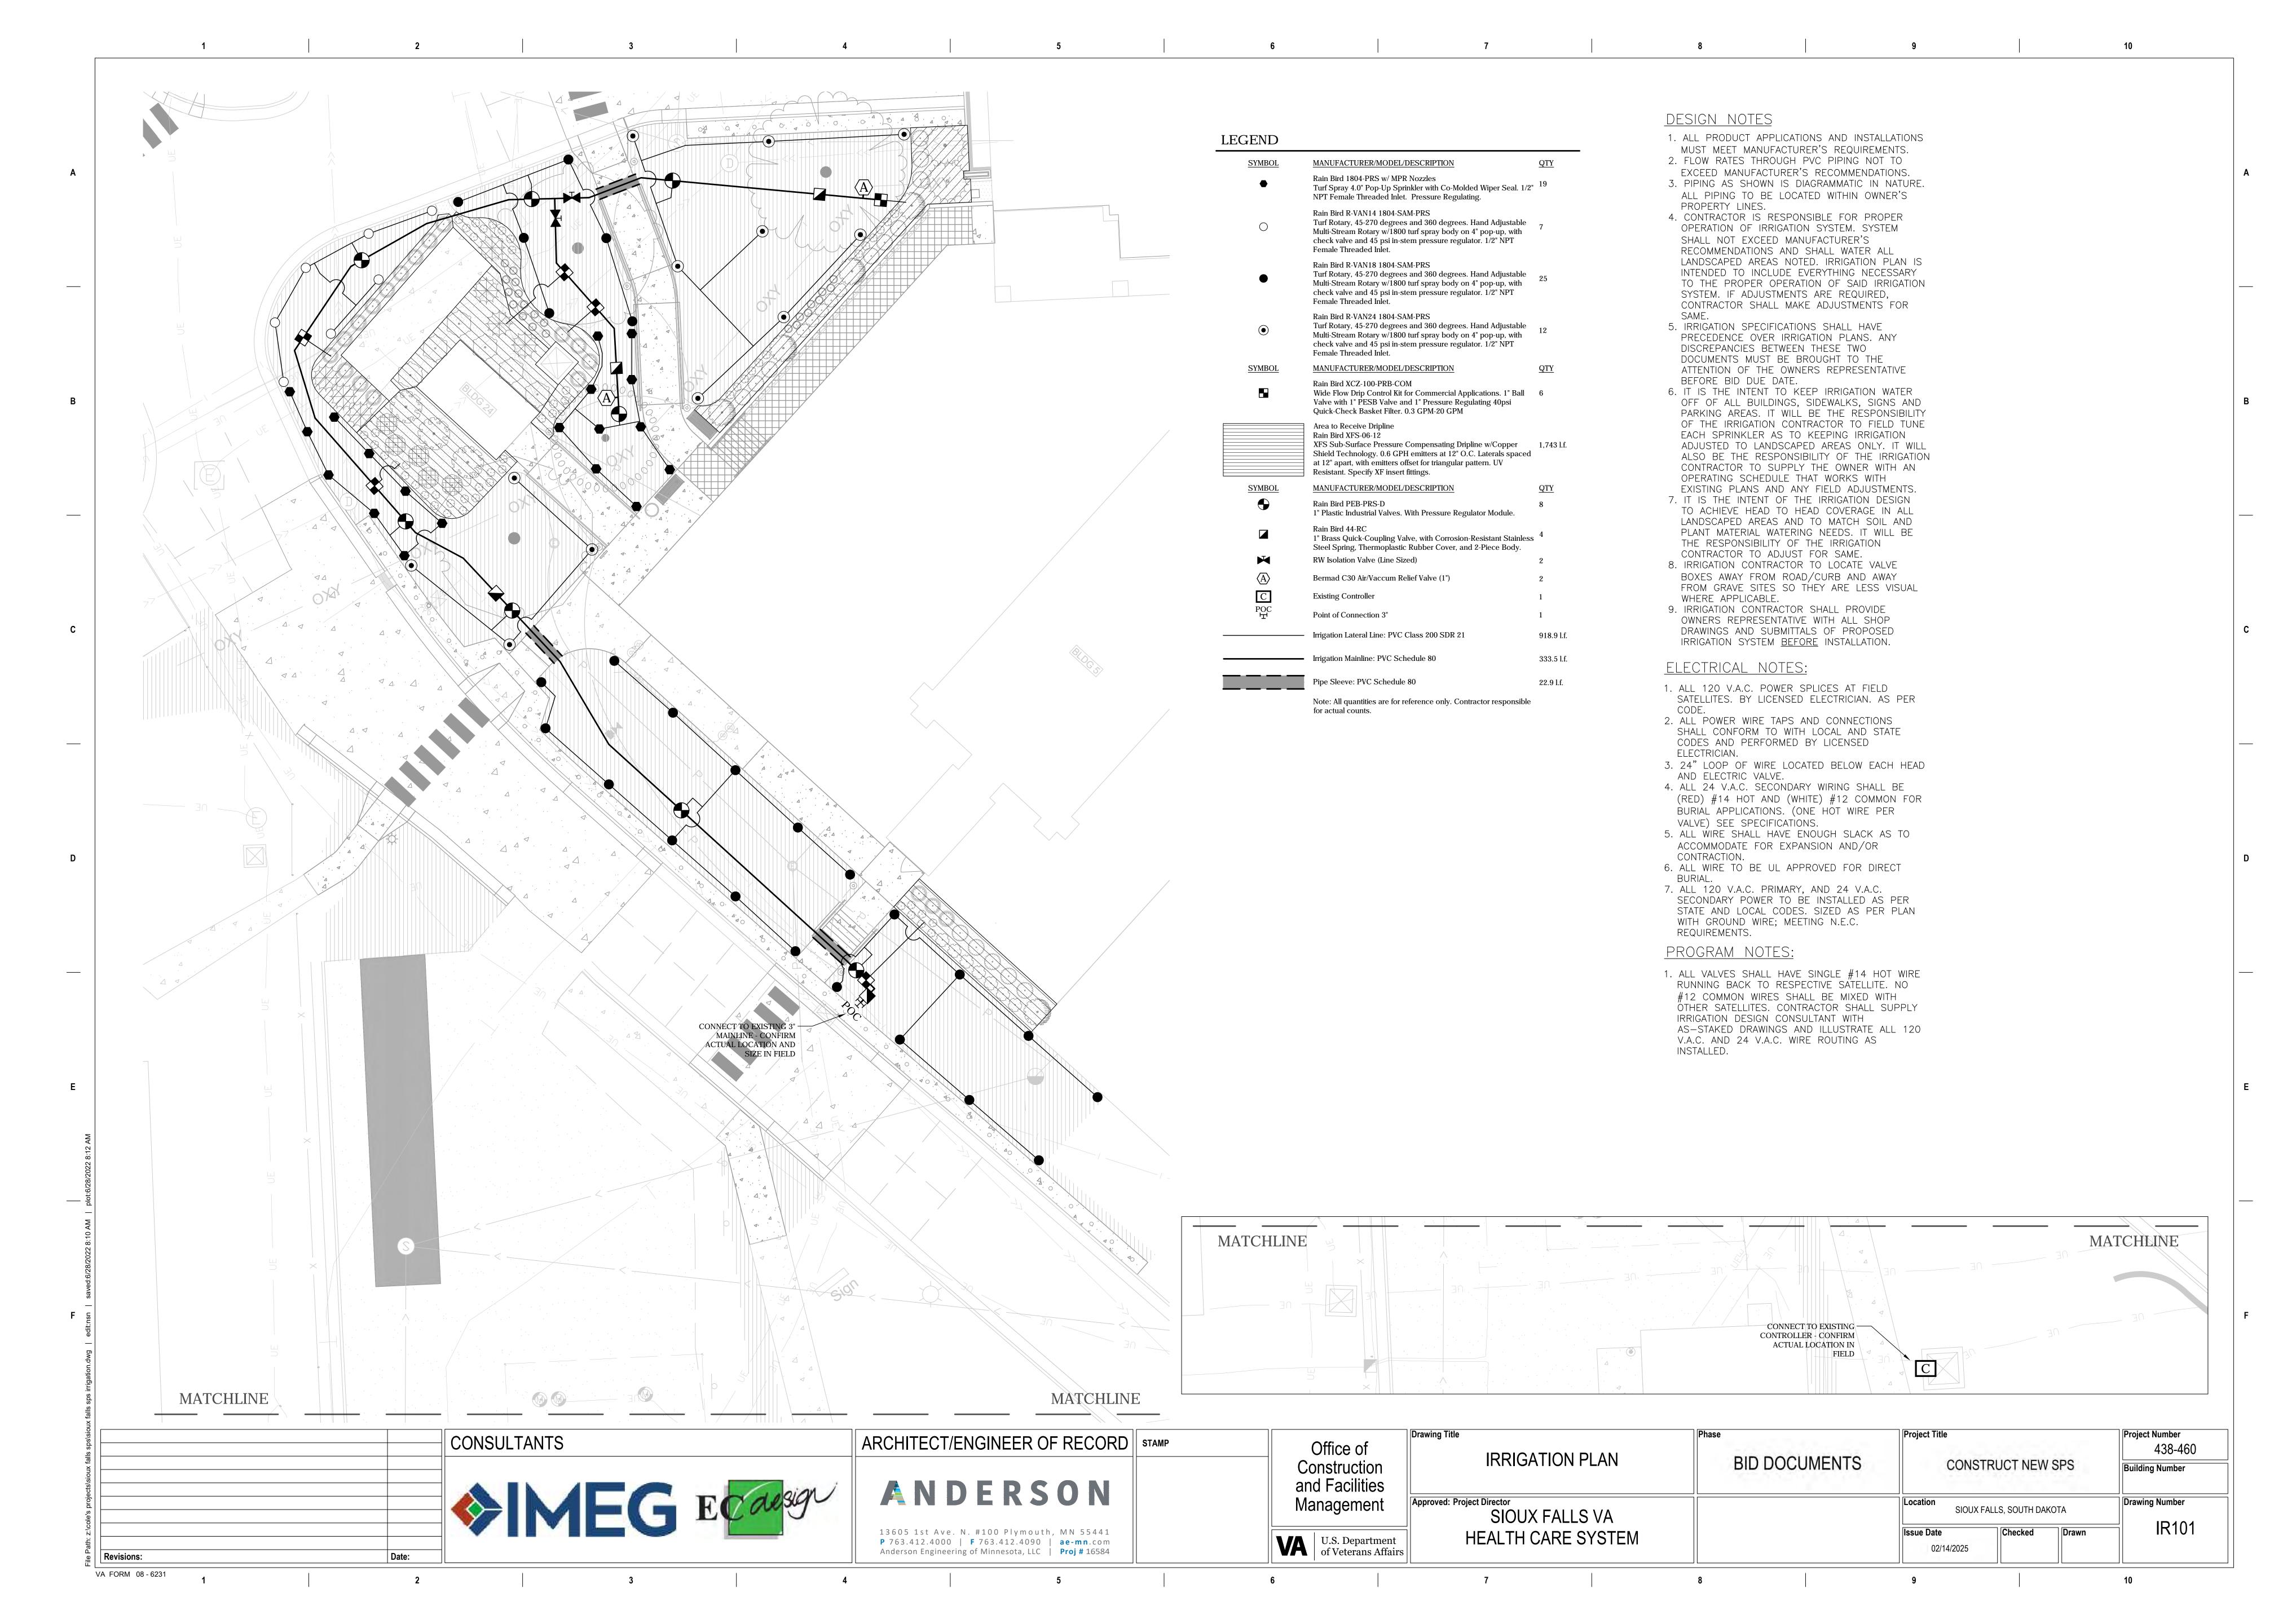


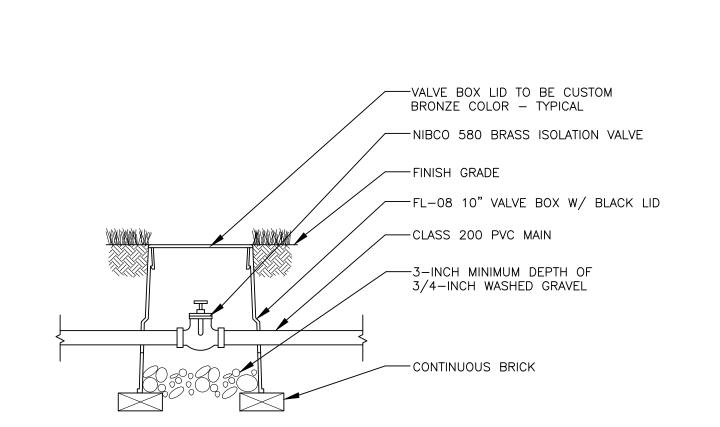


ISOLATION VALVE WITH BOX

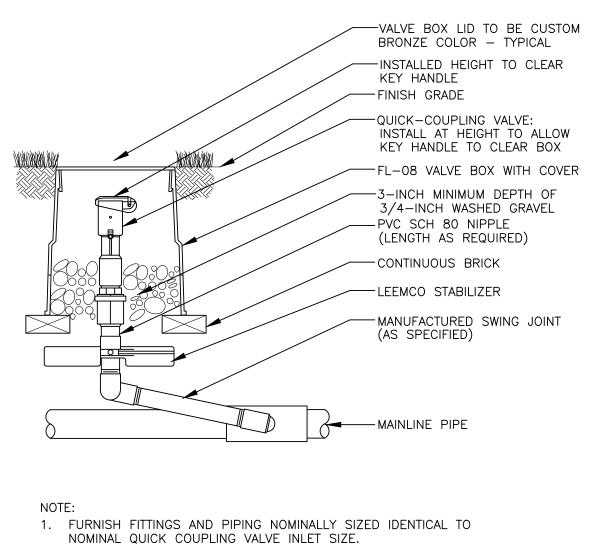

QUICK-COUPLING VALVE WITH STABILIZER

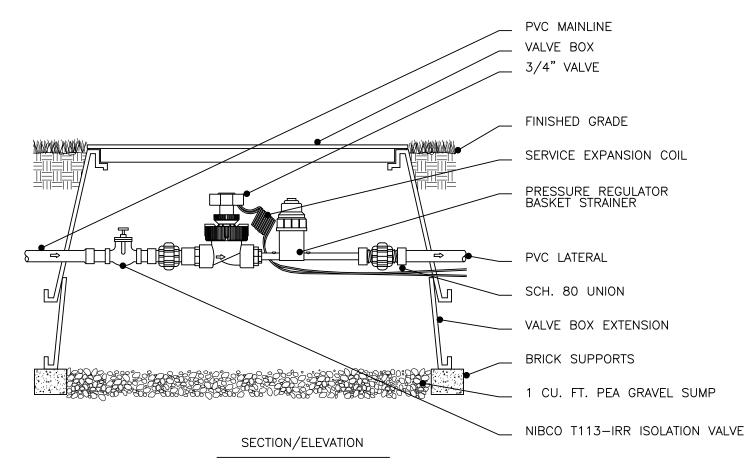

REMOTE CONTROL VALVE, PRESSURE REGULATOR & FILTER SCALE: NONE

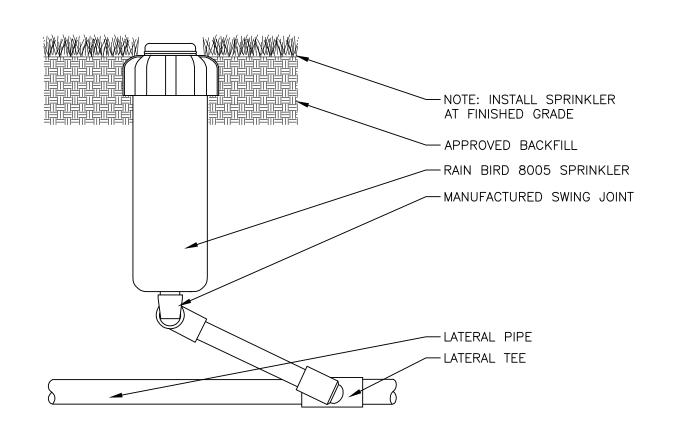

TURF ROTOR

SCALE: NONE

FIXED-SPRAY SPRINKLER

- MPR PLUS NOZZLES

---- NOTE: INSTALL SPRINKLER AT FINISHED GRADE

- NIPPLE OR SWING PIPE

(SIZE PER PLAN)


APPROVED BACKFILL

----- SPRINKLER

LATERAL TEE


--- LATERAL PIPE

2 WITH ST

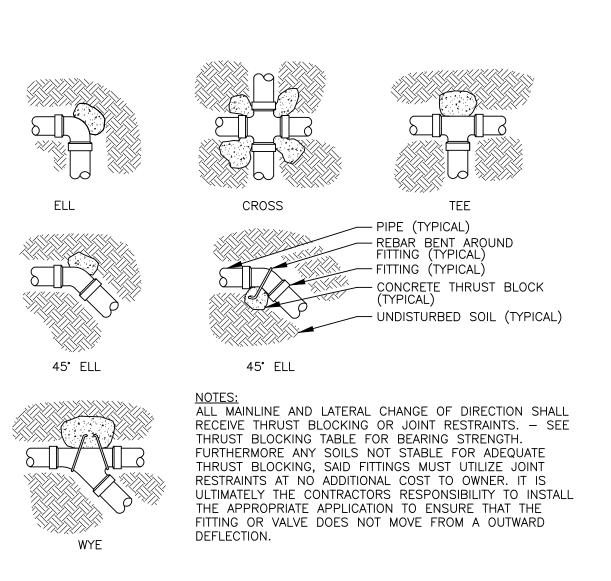



THRUST BLOCKING SIDE THRUST ON CURVES STEP 1. MULTIPLY THE PRESSURE LEVEL DESIRED AN OUTWARD PRESSURE EXISTS ON ALL DEFLECTIONS FROM A STRAIGHT LINE. GOOD SOIL, PROPERLY TAMPED, IS SUFFICIENT TO HOLD SIDE THRUST — FOR TESTING BY THE APPROPRIATE VALUE SHOWN IN THE FOLLOWING TABLE: UNLESS SOIL CONDITIONS ARE UNSTABLE. IN THAT CASE, TO ANCHOR AGAINST THIS SIDE THRUST, THE PIPE DEAD END 90° 45° 22.5° SIZE OR TEE ELBOW ELBOW ELBOW BLOCKING SHOULD BE PLACED AGAINST THE PIPE ON EACH SIDE OF THE COUPLING. DO NOT THRUST BLOCK 1.5" 2.94 4.16 2.25 1.15 THE COUPLING ITSELF. 4.56 6.45 3.50 1.78 PIPE SIZE SIDE THRUST 2.5" 6.65 9.40 5.10 2.60 POUNDS PER DEGREE INCHES 3" 9.80 13.9 7.51 3.82 1.5" 3.5" 12.8 18.1 9.81 4.99 7.9 16.2 23.0 12.4 6.31 11.6 5" 24.7 35.0 18.9 9.63 17.1 6" 34.8 49.2 26.7 13.6 22.4 28.3 BASED ON POUNDS PER PSI WORKING PRESSURE. 43.1 60.8 STEP 2. DETERMINE THE BEARING STRENGTH OF THE SOIL FROM THE TABLE BELOW: BASED ON SIDE THRUST PER 100 LBS/SQUARE INCH BEARING STRENGTH OF SOILS PRESSURE PER DEGREE OF DEFLECTION SOILS AND SAFE BEARING LOADS LBS. SQ. FT. NOTE: MULTIPLY SIDE THRUST POUNDS BY DEGREES SOUND SHALE OF DEFLECTION TIMES POUNDS OF PRESSURE DIVIDED CEMENTED GRAVEL AND BY 100 TO OBTAIN TOTAL SIDE THRUST IN POUNDS. SAND-DIFFICULT TO PICK COARSE AND FINE COMPACT SAND MEDIUM CLAY -2,000 1,000 CAN BE SPADED SOFT CLAY MUCK STEP 3. DIVIDE THE TOTAL THRUST OBTAINED IN STEP 1 BY THE BEARING STRENGTH OF THE SOIL: THIS GIVES THE SQUARE FEET OF AREA NEEDED.

THRUST BLOCK DETAIL SCALE: NONE

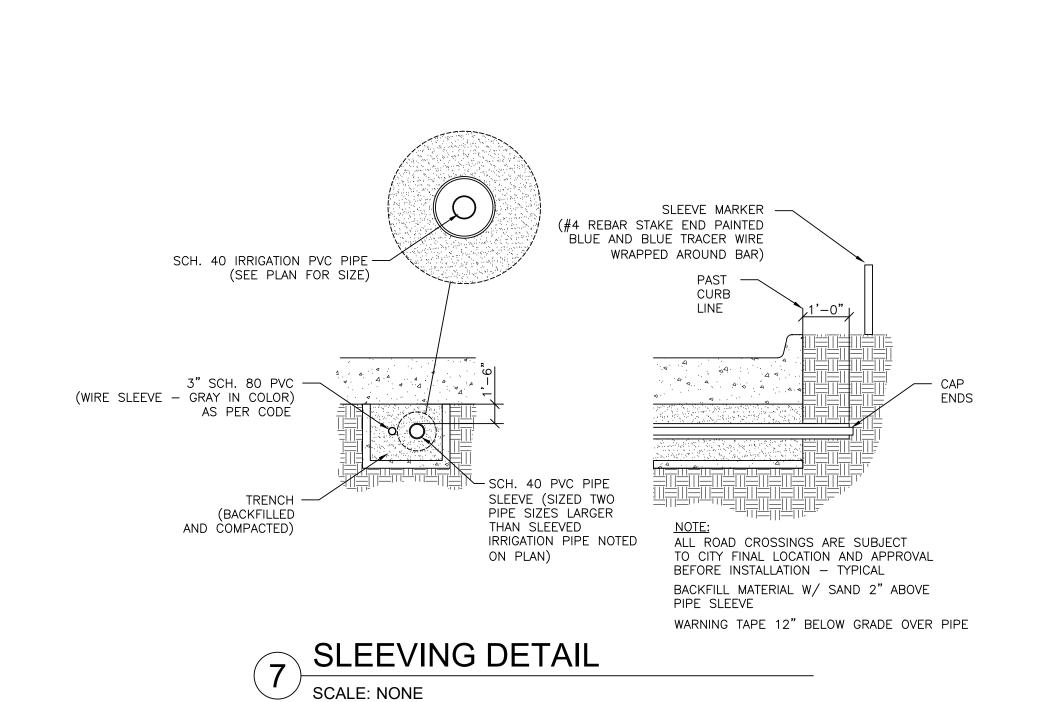

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s sps/sion	CONSULTANTS	ARCHITECT/ENGINEER OF RECORD	STAMP	Office of	Drawing Title	Phase	Project Title	Project Number 438-460
ts\sioux fal		ANDEDCON		Construction and Facilities	IRRIGATION DETAILS	BID DOCUMENTS	CONSTRUCT NEW SPS	Building Number
ole's project	Ecaesign	ANDERSON		Management	Approved: Project Director SIOUX FALLS VA		Location SIOUX FALLS, SOUTH DAKOTA	Drawing Number
Revisions: Date:		13605 1st Ave. N. #100 Plymouth, MN 55441 P 763.412.4000 F 763.412.4090 ae-mn.com Anderson Engineering of Minnesota, LLC Proj # 16584		U.S. Department of Veterans Affair	HEALTH CARE SYSTEM		Issue Date 02/14/2025 Checked Drawn	IR501

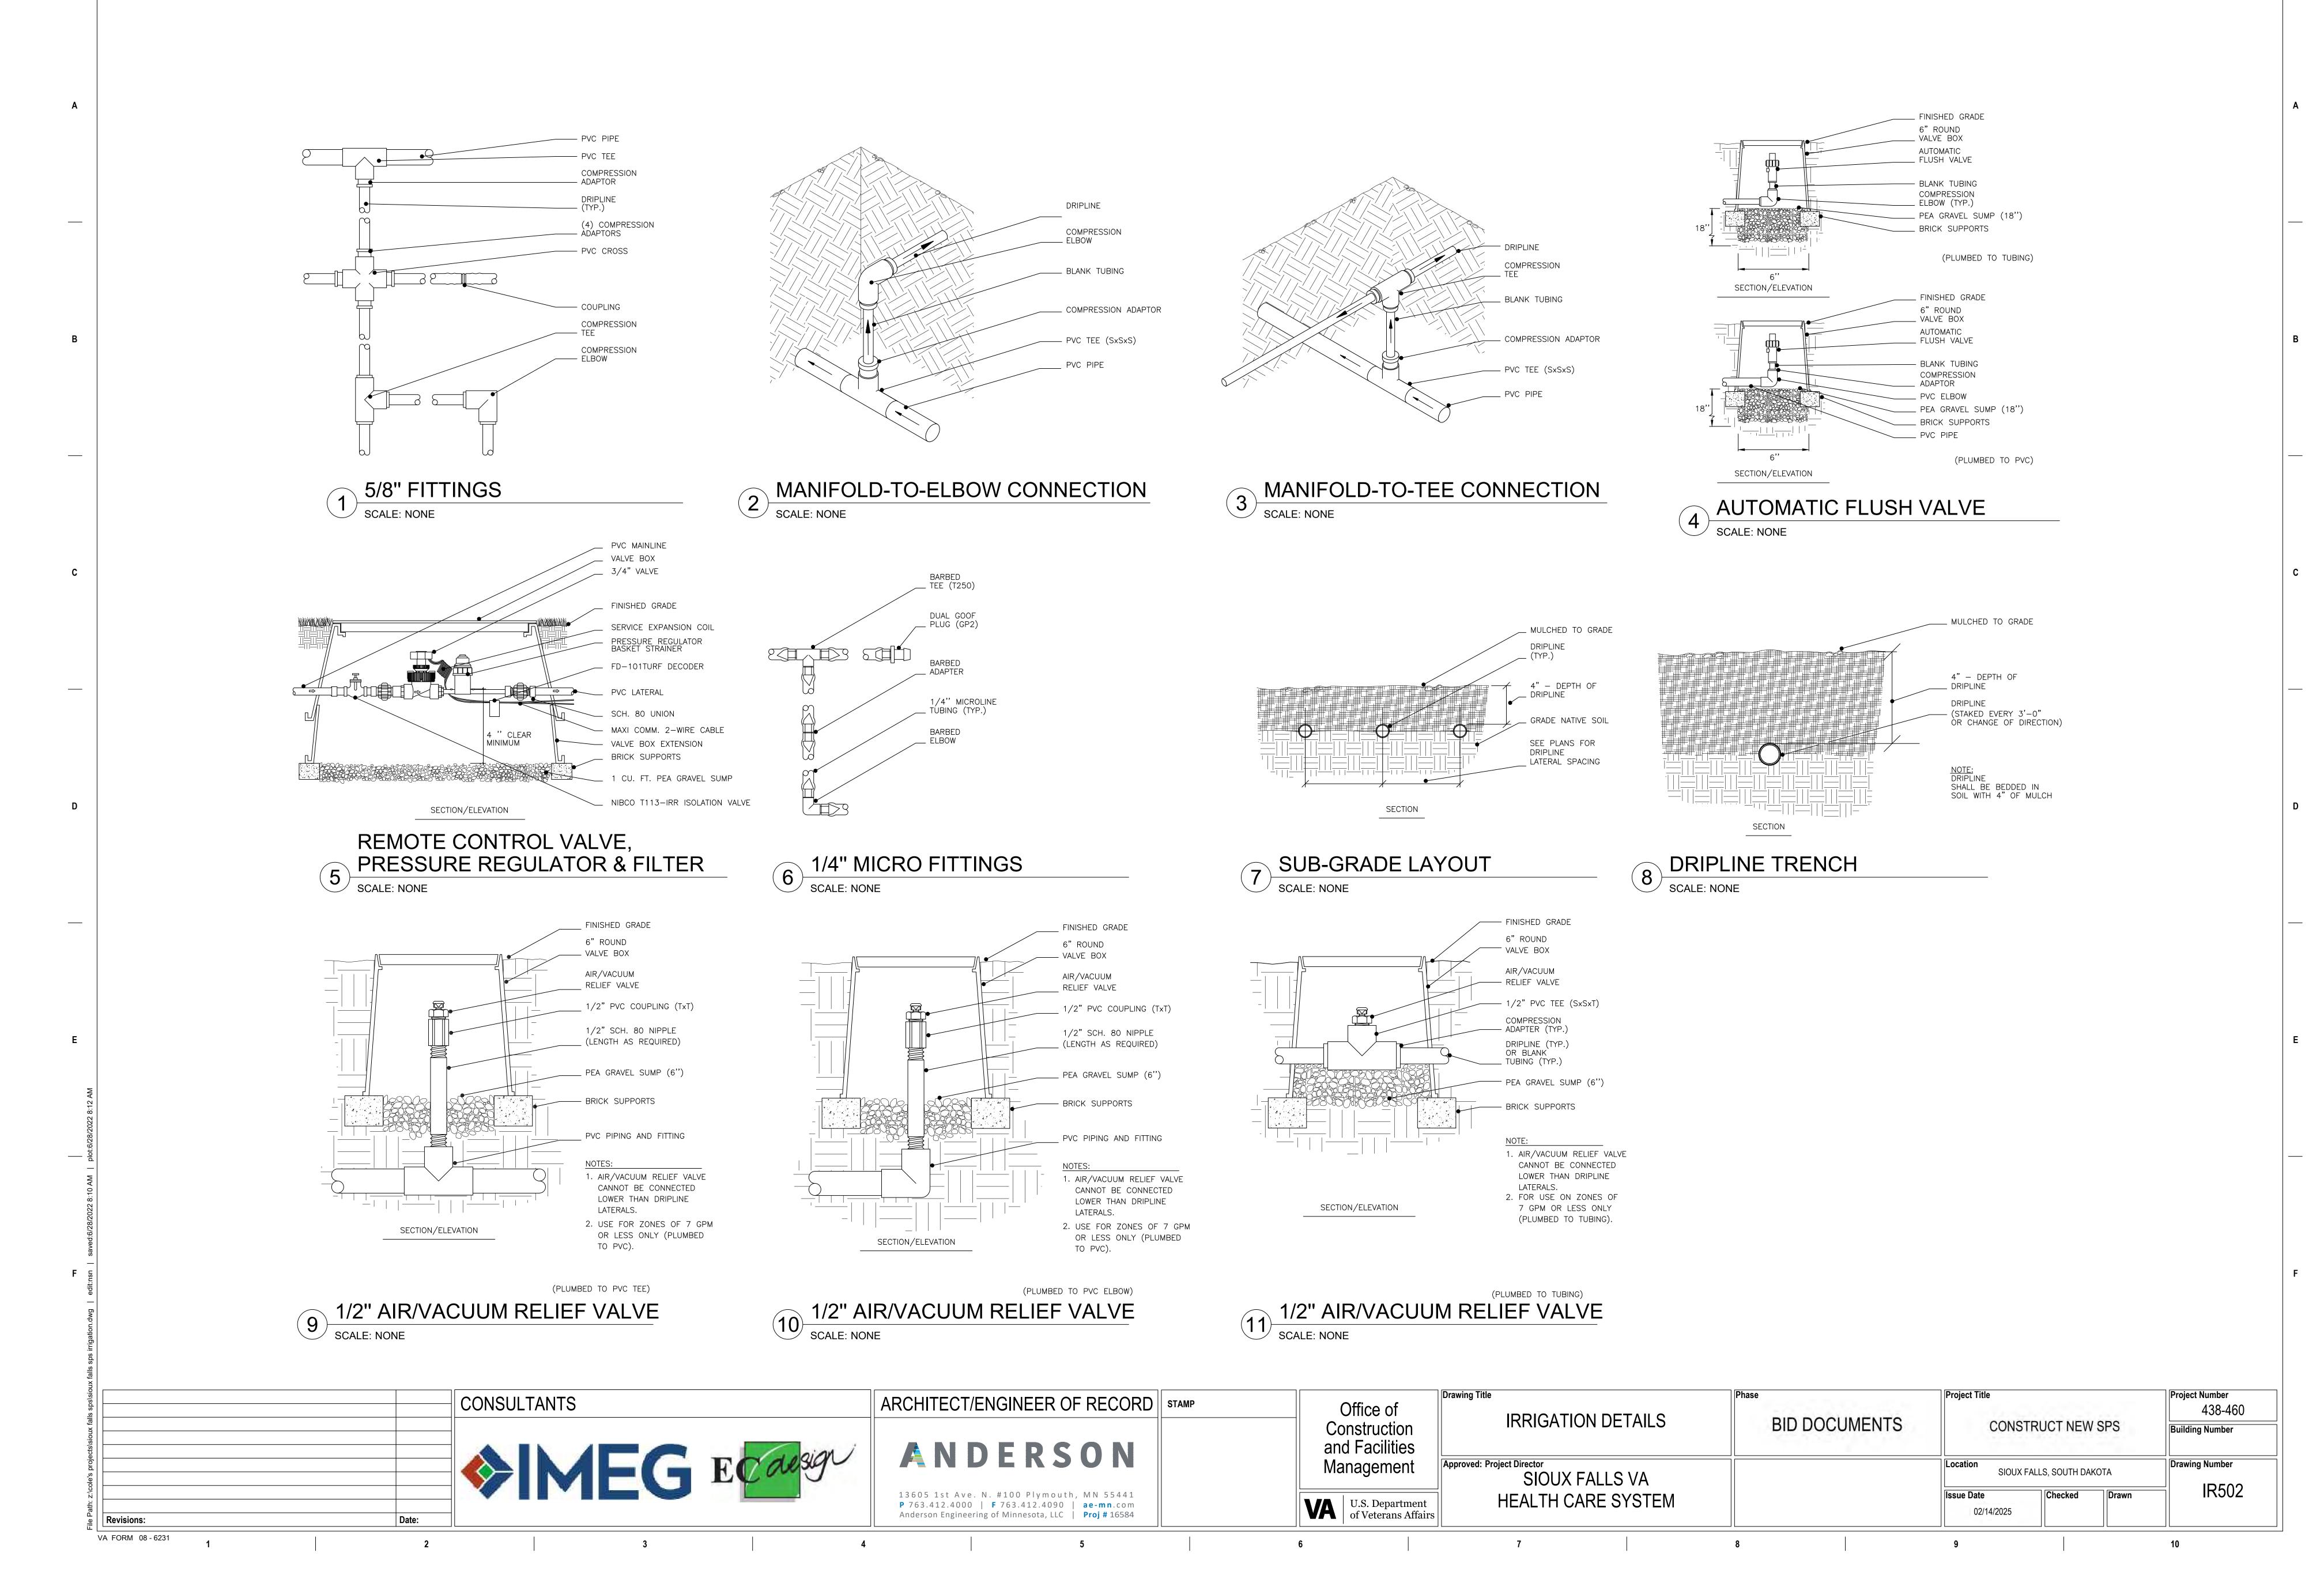

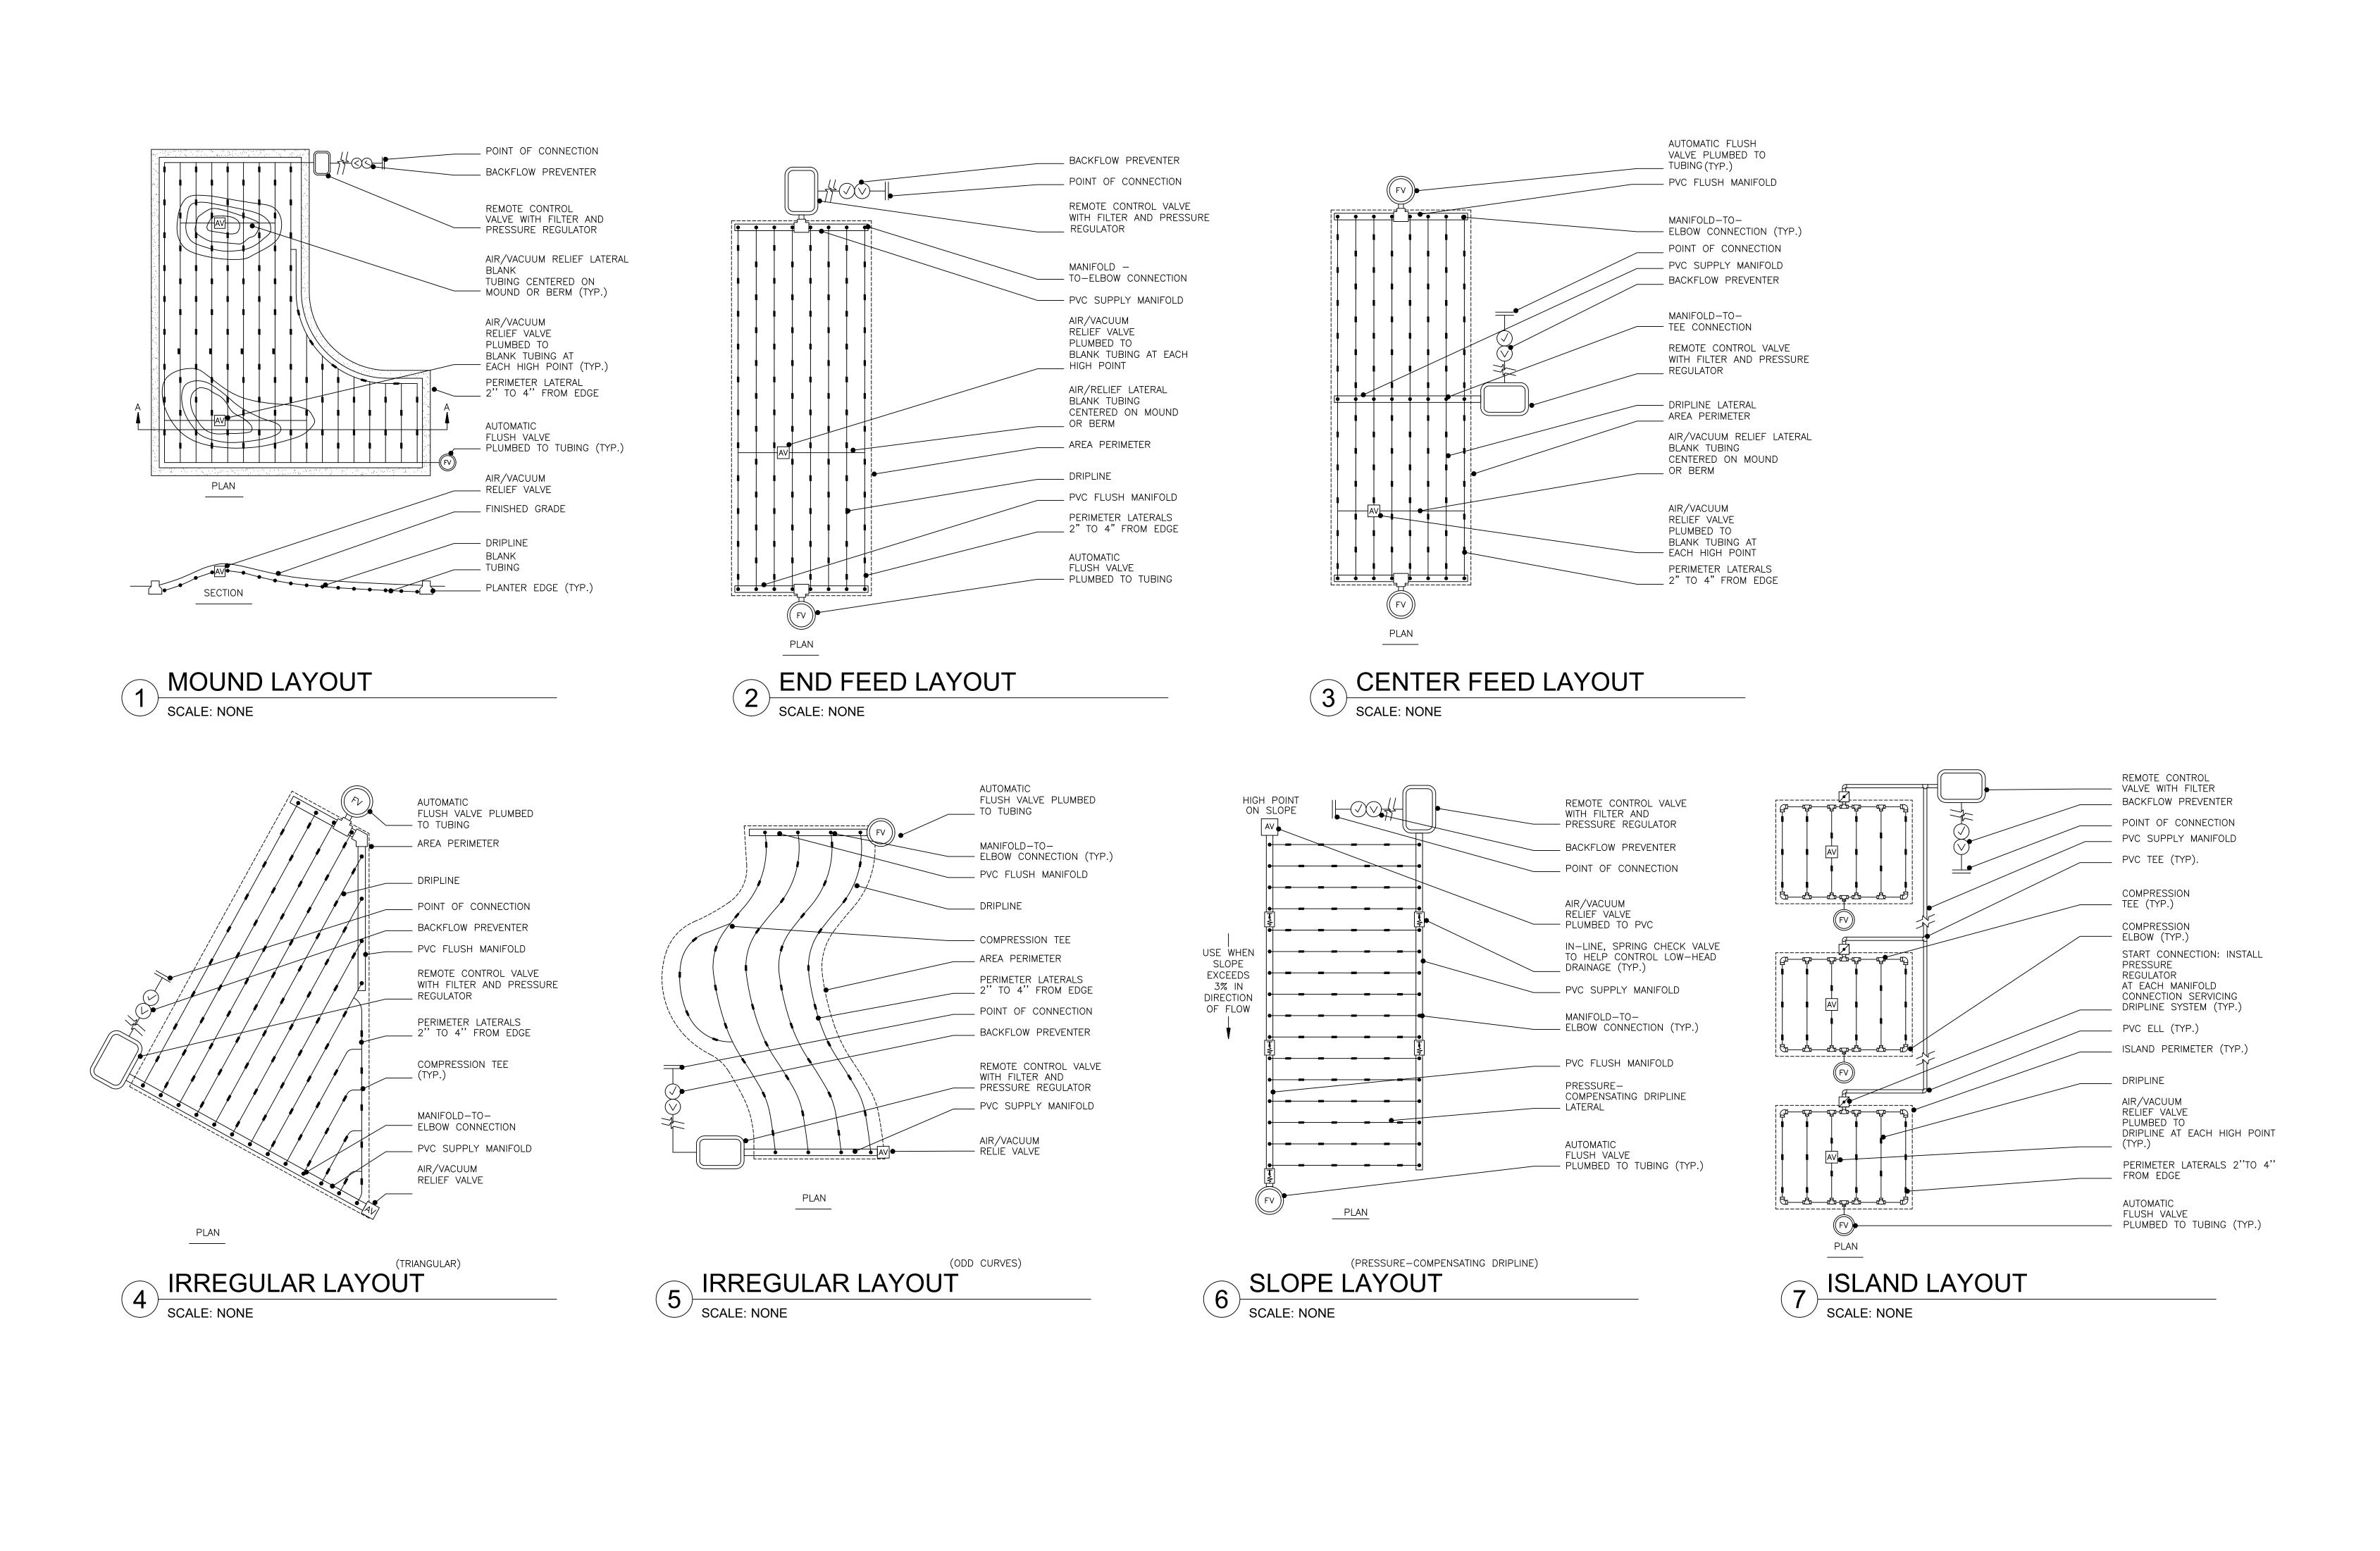

Drawing Title

Approved: Project Director

IRRIGATION DETAILS

SIOUX FALLS VA

HEALTH CARE SYSTEM

Office of

Construction

and Facilities

Management

U.S. Department of Veterans Affairs

Project Title

02/14/2025

CONSTRUCT NEW SPS

SIOUX FALLS, SOUTH DAKOTA

Checked

BID DOCUMENTS

Project Number

Building Number

Drawing Number

438-460

IR503

BARBED MICRO VALVE

ARCHITECT/ENGINEER OF RECORD | STAMP

ANDERSON

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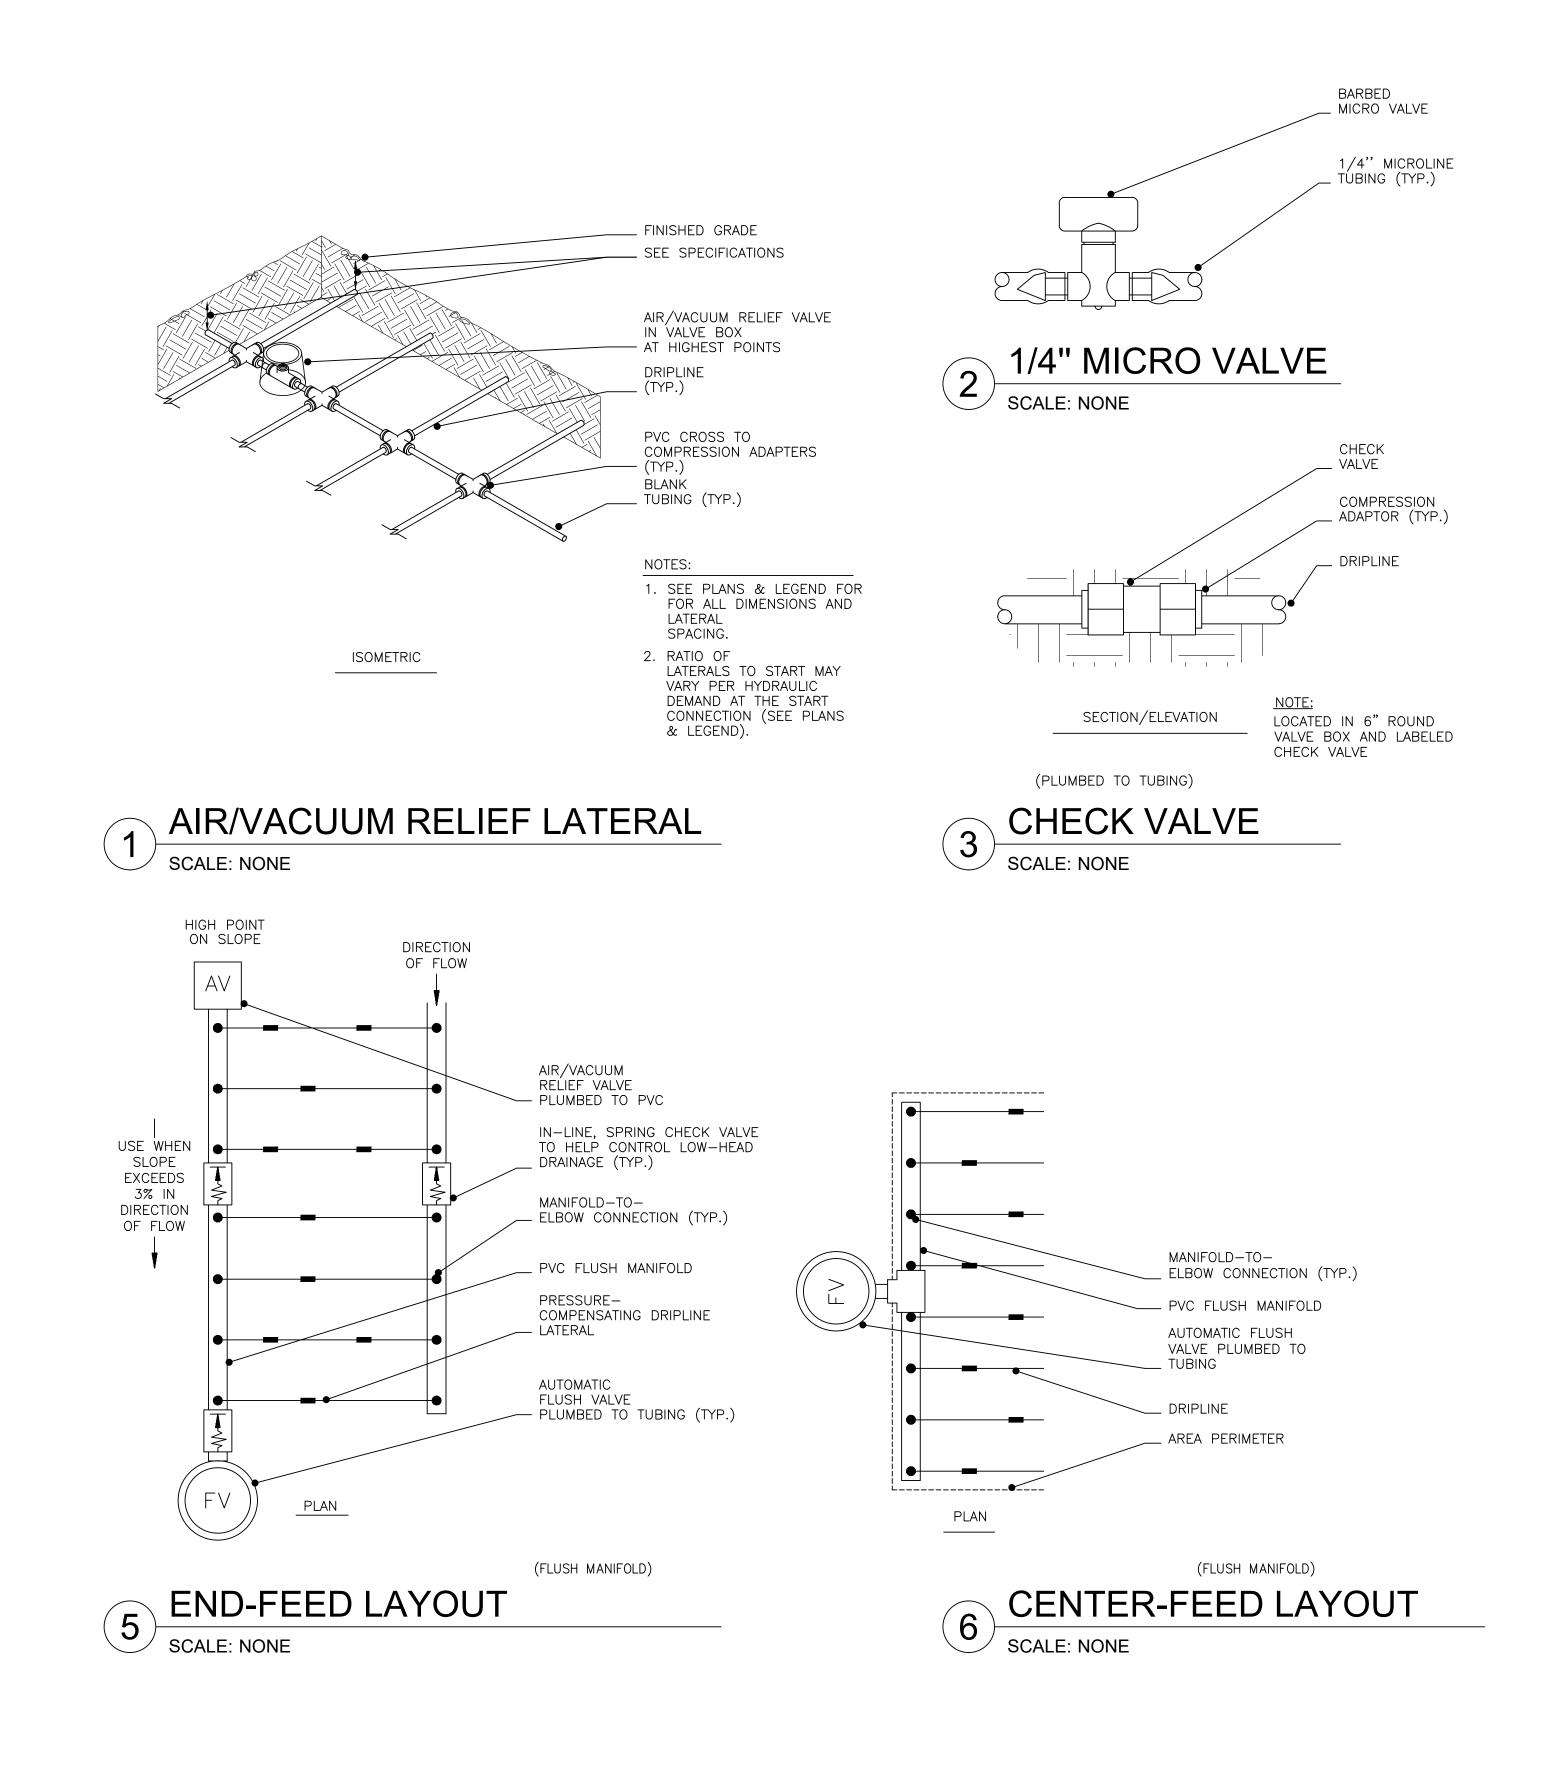
Anderson Engineering of Minnesota, LLC | Proj # 16584


Revisions:

VA FORM 08 - 6231

CONSULTANTS

EG Ecasion



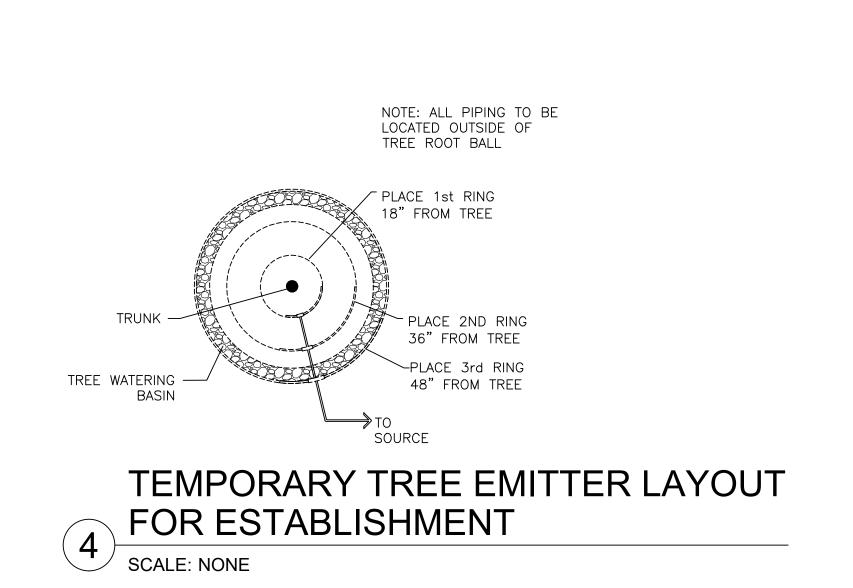

Project Title Drawing Title Project Number CONSULTANTS ARCHITECT/ENGINEER OF RECORD | STAMP Office of 438-460 IRRIGATION DETAILS BID DOCUMENTS CONSTRUCT NEW SPS Construction **Building Number** EG Ecaesign and Facilities ANDERSON Approved: Project Director Drawing Number Management SIOUX FALLS, SOUTH DAKOTA SIOUX FALLS VA IR504 Checked HEALTH CARE SYSTEM U.S. Department of Veterans Affairs P 763.412.4000 | F 763.412.4090 | ae-mn.com 02/14/2025 Anderson Engineering of Minnesota, LLC | Proj # 16584 Revisions: VA FORM 08 - 6231

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