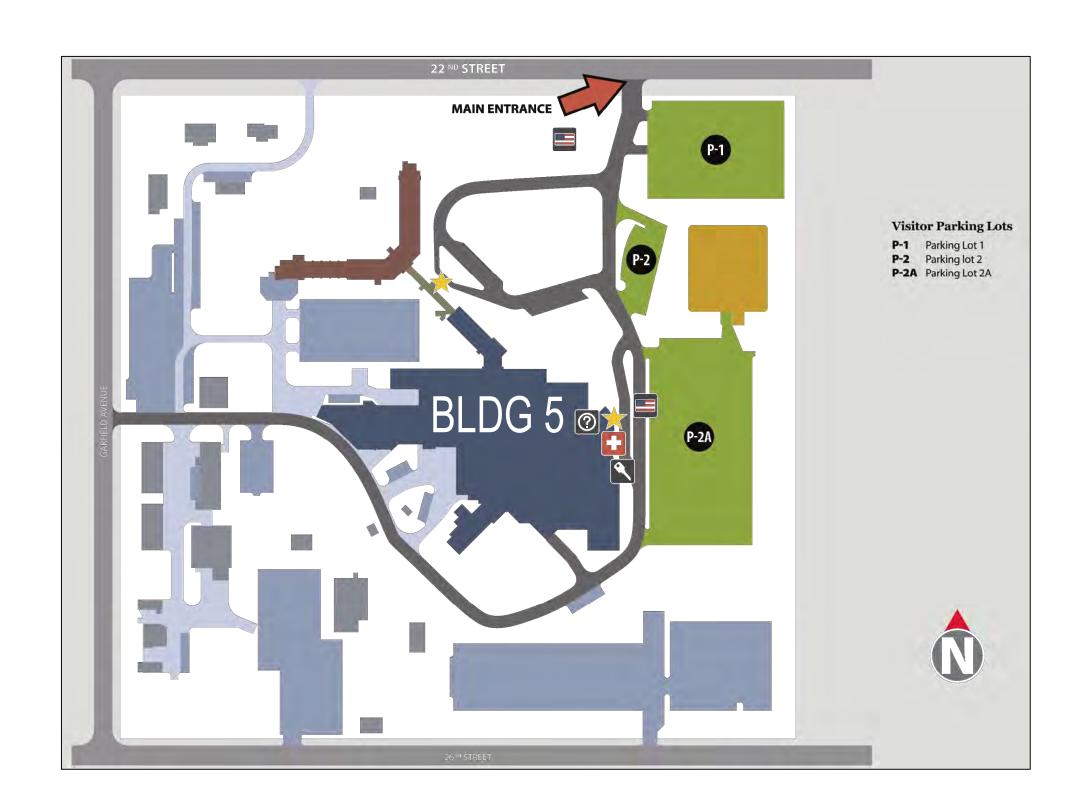
Sioux Fails VA Health Care System

Second CT Scanner Site Prep Design Project Number 438-18-103

2501 W. 22nd Street Sioux Falls, SD 57105



CAMPUS PLAN NOT TO SCALE

BUILDING 5 PLAN

1/64" = 1'-0"

IMPORTANT CONTRACTOR NOTES:

- ALL CONTRACTORS ARE RESPONSIBLE FOR REVIEWING ENTIRE SET OF DOCUMENTS TO DETERMINE THEIR FULL SCOPE OF WORK. CONTRACTOR SHALL NOT BE ALLOWED EXTRA COSTS DUE TO FAILURE TO REVIEW ENTIRE SET OF DOCUMENTS.
- COVER AND PROTECT ALL VA EQUIPMENT AND FURNITURE SO THAT THE FUNCTION AND APPEARANCE IS NOT AFFECTED BY CONSTRUCTION, THE CONTRACTOR, THEIR EQUIPMENT, MATERIALS, OR ANY INVOLVED ACTIONS.
- A 1 HR MINIMUM FIRE-RATED SEPARATION IS REQUIRED BETWEEN ALL OCCUPIED SPACE AND CONSTRUCTION AREAS. THIS PROTECTION INCLUDES ANY EXISTING PENETRATIONS AND OPENINGS.

FIRE PROOFING **GENERAL NOTES:**

- MAINTAIN FIRE RATED CONSTRUCTION AT WALL PENETRATIONS. (CONSTRUCTION TO CONFORM TO MANUFACTURER'S FIRE RATED/TEST ASSEMBLIES
- FIRE CAULK ALL SLEEVES AND PENETRATIONS AT FIRE WALLS/PARTITIONS AND FLOORS. CONFORM WITH THE TESTED/SUBMITTED FIRE RATED ASSEMBLY. USE RED FIRE CAULK AND LABEL WALL WITH U.L. DESIGN NUMBER AND ASTM. FIRE RATED WALLS SHOWN ON PLAN.
- PATCH AND REPAIR ALL EXISTING FIREPROOFING ON EXISTING STRUCTURAL MEMBERS, INCLUDING THAT WHICH IS UNCOVERED NEEDING REPAIR AND THAT WHICH IS DISTURBED DURING CONSTRUCTION.
- PATCH AND REPAIR ALL EXISTING FIRE CAULKING AT EXISTING RATED WALLS WHICH IS UNCOVERED NEEDING REPAIR AND THAT WHICH IS DISTURBED DURING CONSTRUCTION. RE-LABEL EXISTING WALL IF NECESSARY

HAZARDOUS MATERIAL:

1. IF THE CONTRACTOR ENCOUNTERS MATERIAL THAT COULD BE HAZARDOUS, THE CONTRACTOR SHAL STOP WORK AND NOTIFY THE OWNER IMMEDIATELY FOR DIRECTION.

CLH Architects

3705 N 200th St

(402) 291-6941

Tim Werner

Elkhorn, NE 68022

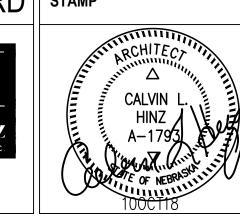
BID DOCUMENTS	10/10/2018
CONSTRUCTION DOCUMENTS 100% SUBMITTAL — UPDATE	9/28/2018
CONSTRUCTION DOCUMENTS 100% SUBMITTAL	9/7/2018
DESIGN DEVELOPMENT 90% SUBMITTAL	8/3/2018
SCHEMATIC DESIGN 36% SUBMITTAL 2	7/5/2018
SCHEMATIC DESIGN 35% SUBMITTAL	6/6/2018
Revisions:	Date:

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Structural Engineering: Shaffer & Stevens, P.C. 9910 N 48th Street Omaha, NE 68152 (402) 455-7698 Donn Shaffer





Office of Construction and Facilities Management

Drawing Title Cover Sheet Approved: Project Director U.S. Department of Veterans Affairs

Index of Drawings:

COVER SHEET/INDEX OF DRAWINGS ABBREVIATIONS, SYMBOLS, GENERAL & PHASING NOTES

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005	A101	FLOOR PLAN
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VENDOR DRAWINGS - SIEMENS VENDOR DRAWINGS - SIEMENS VENDOR DRAWINGS - SIEMENS VSM003 **VENDOR DRAWINGS - SIEMENS VENDOR DRAWINGS - SIEMENS VENDOR DRAWINGS - SIEMENS**

VSM007 **VENDOR DRAWINGS - SIEMENS VENDOR DRAWINGS - SIEMENS**

Project Title Project Number BID DOCUMENTS 438-18-103 Second CT Scanner Site Prep Design **Building Number Drawing Number** Sioux Falls, SD FULLY SPRINKLERED

October 10, 2018

Checked

CLH

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G001

VA FORM 08 - 6231

ABBREVIATIONS

FIRE ALARM RADIUS, RISER, RUBBER SHEATH ANCHOR BOLT, AUGER BORING FLOOR DRAIN, FIRE DAMPER RETURN AIR ACOUSTIC TILE FDN FOUNDATION RADIUS ACST ACOUSTIC FDR FEEDER RESILIENT VINYL BASE ADJUSTABLE FIRE EXTENGUISHER RCP REINFORCED CONCRETE PIPE, ABOVE FINISHED FLOOR REFLECTED CEILING PLAN FIRE EXTENGUISHER CABINET AIR HANDLING UNIT FFE FINISHED FLOOR ELEVATION ALTERNATE RECEPTACLE FIG **FIGURE** ALUMINUM REINF REINFORCEMENT ALCOVE REGULATOR, REGISTER FIN FINISH APPROX APPROXIMATE REQD REQUIRED FLOOR, FLASHING, FLOW LINE ARCHITECTURAL REVISION FLUOR FLUORESCENT ROOF, RETURN FAN AUTOMATIC TRANSFER SWITCH FRAME REHEAT COIL FTG FOOTING ROOM FXTR FIXTURE BUILDING REVOLUTIONS PER MINUTE BLOCK RESILIENT VINYL TILE GAGE BEAM GALV GALVANIZED SAN SANITARY SEWER воттом GROUND FAULT INTERRUPT SCHEDULE SCH BEARING GLASS SPLITTER DAMPER, STORM DRAIN BSMT BASEMENT GWB GYPSUM WALL BOARD SECT SECTION GYP SUPPLY GRILLE CELSIUS SHEET CAPACITY HEIGHT, HUMIDIFIER SIM SIMILAR CENTER TO CENTER HOSE BIBB HB SINGLE PHASE 1 PH CEILING DIFFUSER **SLOPE** HANDICAPPED CUBICAL CURTAIN TRACK HDW HARDWARE STATIC PRESSURE, SINGLE POLE CEM CEMENT HORIZONTAL SPDT SINGLE POLE, DOUBLE THROW CORNER GUARD HOUR, HAND RAIL SPEC SPECIFICATION CHILLER HSKP HOUSEKEEPING SINGLE POLE, SINGLE THROW CAST IRON, COURTYARD INLET SQUARE CAST IRON PIPE INT INTERIOR SUPPLY REGISTER CIRCULATING INSUL INSULATION, INSULATED SANITARY SEWER CONTROL JOINT INV INVERT STEAM, SINGLE THROW, STREET, STAFF CIRCUIT STA STATION CENTERLINE JUNCTION BOX STD STANDARD CLN CLEAN JANITOR CLOSET STEEL STL CEILING JUNCTION STRUCT STRUCTURAL JOINT SUPPORT SUP CORRUGATED METAL PIPE SUSP SUSPENDED CORRUGATED METAL PIPE ARCH SHEET VINYL KVA KILOVOLT-AMPERE CMU CONCRETE MASONRY UNITS SWITCH, SIDEWALK KILOWATT CONDUIT SWITCHBOARD CNDS CONDENSATE SWGR SWITCHGEAR LOUVER, LENGTH, LENGTH OF CURVE CLEANOUT LIGHT COL COLUMN TILE, TOP, TANGENT LAVATORY VERTICAL COMMUNICATION TOP AND BOTTOM CONCRETE METER, MEGA TELEPHONE CONDUCTOR MAS MASONRY TEMP TEMPERATURE, TEMPORARY CONNECTION MATL MATERIAL TERM TERMINAL CONSTRUCTION MAX MAXIMUM THREE CONDUCTOR CONTINUOUS MECH MECHANICAL THREE POLE CONVERTER MET/MTL METAL 3 WAY THREE WAY NONREINFORCED CONCRETE PIPE MANHOLE TOP OF CHAIR OR CRASH RAIL MINIMUM, MINUTE TRANS TRANSITION CONCRETE SEALER/SURFACE MISC MISCELLANEOUS TOP OF STEEL, TOP OF STONE, TOP OF SLAB CERAMIC TILE, CURRENT TRANSFORMER, MM,mm MILLIMETER COOLING TOWER MTD MOUNTED TELEVISION CENTER, COOLING TOWER RETURN MTG MOUNTING TOP OF WALL CTS COOLING TOWER SUPPLY MEMBRANE WATERPROOFING TYPICAL COLD WATER MULL MULLION UNIT HEATER CPT NOT APPLICABLE VENT, VOLT, VALVE NEC NATIONAL ELECTRIC CODE DET, DTL DETAIL VOLT AMPRE NEG NEGATIVE DIAMETER NEUT NEUTRAL VACUUM DIMENSION NOT IN CONTRACT VINYL COMPOSITION TILE NOM NOMINAL VENT VENTILATING NTS NOT TO SCALE VERTICAL VERT DISTRIBUTION PANEL VESTIBULE DOWNSPOUT, STORM DRAINAGE STRUCTURE ^{OA} OUTSIDE AIR ON CENTER DOMESTIC WATER VENT STACK OUTSIDE DIAMETER DRAWING VENT THRU ROOF VTR OVERFLOW DRAIN VINYL WALL COVERING OPNG OPENING EACH FACE, EXHAUST FAN OPPOSITE OPP WIDTH, WASTE, WATER, WATT, WEST, WIRE, EXHAUST GRILLE OVHD,OH OVERHEAD WATER LINE STRUCTURE EXPANSION JOINT ELEVATION PIPE, POLE WITH ELECTRIC, ELECTRICAL CLOSET PB PULL BOX WITHOUT **EMER** EMERGENCY POWDER ACTUATED FASTENER WATER CLOSET, WHEEL CHAIR ROOF MEMBRANE PIV POST INDICATOR VALVE WIDTH, WINDOW DIMENSION PLATE WALL GUARD EQUIPMENT PLYWD PLYWOOD WATERPROOF, WEATHERPROOF EACH WAY PANEL WASTE STACK, WATER SURFACE, WATERSTOP ELECTRIC WATER COOLER PNT PAINT EXHAUST PRELIM PRELIMINARY WELDED WIRE FABRIC EXISTING PRIM PRIMARY EXPANSION, EXPOSED

GENERAL ARCHITECTURAL NOTES:

- 1. THE CONTRACTOR SHALL INSPECT THE SITE, STUDY EXISTING CONDITIONS, REVIEW DRAWINGS AND SPECIFICATIONS. CONTRACTOR SHALL ADJUST FOR ACTUAL FIELD CONDITIONS AT NO ADDITIONAL EXPENSE TO THE OWNER.
- 2. CONTRACTOR SHALL TAKE ALL MEASUREMENTS FOR THE WORK AND BE RESPONSIBLE FOR SAME. COORDINATE THE WORK AND SHOP DRAWINGS WITH ALL OTHER TRADES AFFECTED AND MAKE ANY NECESSARY OFFSETS TO CONCEAL PIPING AND DUCTWORK AND TO CLEAR EQUIPMENT, STRUCTURAL MEMBERS AND OTHER
- 3. ALL UTILITIES AND SERVICES SHALL BE KEPT IN CONTINUOUS OPERATION UNLESS WRITTEN PERMISSION IS OTHERWISE GRANTED BY THE OWNER. 3.1. MINOR SHUTDOWNS OF LESS THAN 48 HOURS REQUIRE 7 TO 14 DAYS' NOTICE; 3.2. MAJOR SHUTDOWNS OF MORE THAN 48 HOURS REQUIRE 14 DAYS' NOTICE.
- 4. TEMPORARY ALTERATIONS AND CONNECTIONS REQUIRED BY THIS CONTRACT SHALL BE MADE SO THAT ALL BUILDING SERVICES ARE MAINTAINED WITH MINIMUM INTERRUPTION. SCHEDULE ALL ELECTRICAL/MECHANICAL OUTAGES 14 DAYS IN ADVANCE WITH THE OWNER.
- 5. PROTECT ALL WORK, MATERIALS AND EQUIPMENT. CAP OR PLUG TEMPORARY OPENINGS. DELIVER ALL WORK TO THE OWNER CLEAN AND IN GOOD CONDITION.

3.3. CONTRACTOR MUST CONTACT VA'S COR PRIOR TO ANY SHUTDOWNS.

- 6. WHEN DEMOLITION IS COMPLETE, NOTIFY ARCHITECT AND OWNER FOR A SCHEDULED MEETING TO REVIEW EXISTING CONDITIONS AND ANY CONCERNS REGARDING NEW WORK.
- 7. CUTTING AND PATCHING OF EXISTING WALLS, FLOORS OR CEILINGS REQUIRED BY NEW WORK SHALL BE INCLUDED AS WORK PROVIDED UNDER THIS CONTRACT.
- 8. CUTTING SHALL BE DONE WITH CARE SO AS NOT TO DAMAGE EXISTING EQUIPMENT, CONNECTIONS, CONTROLS, ETC.
- 9. DAMAGE CAUSED BY SUCH CUTTING SHALL BE REPLACES OR REPAIRED TO ORIGINAL CONDITION BY CONTRACTOR AT NO COST TO THE OWNER, UNLESS UNFORESEEN EXISTING CONDITIONS ARE DISCOVERED AND OWNER/ARCHITECT ARE NOTIFIED.
- 10. ALL OCCUPIED WORK AREAS, BUILDING CORRIDORS AND EXTERIOR AREAS SHALL BE KEPT CLEAR OF DEBRIS.
- 11. ALL MATERIALS AND EQUIPMENT SHALL BE NEW, OF THE BEST QUALITY AND FREE FROM
- 12. MANUFACTURER AND MODEL NUMBERS SPECIFIED ESTABLISH THE TYPE AND QUALITY REQUIRED,
- UNLESS OTHERWISE NOTED.
- 13. ALL WORK SHALL COMPLY WITH APPLICABLE REGULATIONS, CODES AND ORDINANCES. 14. THE CONTRACTOR SHALL PERFORM ALL TESTS AS SPECIFIED OR AS NECESSARY TO DEMONSTRATE
- 15. ALL EXPOSED PENETRATIONS MADE THROUGH EXISTING ROOFS, FLOORS, AND WALLS SHALL BE PATCHED WITH LIKE MATERIALS TO MATCH THE SURROUNDING AREAS, AND FILLED AS CLOSE AS POSSIBLE TO THE NEW PIPING OR DUCTWORK.

15.1. ALL EXPOSED PENETRATIONS MADE THROUGH EXISTING ROOFS ARE TO BE COORDINATED WITH

- 16. THE CONTRACTOR SHALL BE RESPONSIBLE FOR REPAIRING AND REPLACING ANY DAMAGE TO EXISTING MATERIALS RESULTING FROM WORK UNDER THIS CONTRACT AND SHALL RESTORE SUCH
- 17. INSTALL THE SPECIFIED FIRE STOPPING (SLEEVES, WRAP, CONDUIT, ETC.) AT RATED CONSTRUCTION: A. FIRE STOP ALL PENETRATIONS WHERE NEW DEVICES/LINES RELOCATING EXISTING DEVICES/LINES PENETRATING FLOORS, CEILINGS AND OTHER RATED BARRIERS B. FIRE STOP ALL NEWLY CREATED PENETRATIONS WHERE EXISTING DEVICES/LINES PENETRATE

TO ITS ORIGINAL CONDITION WITH NEW MATERIALS TO MATCH EXISTING.

OF WALL AND TO THE COLUMN GRID UNLESS OTHERWISE NOTED.

18. ALL METAL STUD AND GYPSUM WALLBOARD PARTITIONS ARE DIMENSIONED TO THE OUTSIDE FACE

FLOORS, CEILINGS AND OTHER RATED BARRIERS. USE FIRE APPROVED CAULKING AND FIRE

- 19. ALL GYPSUM BOARD SHALL BE TYPE 'X' FIRE CODE GYPSUM BOARD MOLD AND MOISTURE
- 20. PROVIDE WOOD BLOCKING OR 16 GA. SHEET METAL BACKING PLATES IN ALL WALLS TO RECEIVE WALL HUNG ACCESSORIES, SUCH AS EQUIPMENT, GRAB BARS, MILLWORK, COAT HOOKS, AND

DOOR STOPS, ETC. IF WOOD BLOCKING IS USED, PROVIDE AS FIRE-RESISTANT.

- 21. ALL ITEMS AND DEVICES, SUCH AS COVER PLATES, SWITCH PLATES. CONVENIENCE OUTLETS. DOOR STOPS, AND OTHER FINISH HARDWARE, ETC. SHALL BE REMOVED AND REINSTALLED AS PART OF THE REFINISHING OF EXISTING WALLS INDICATED TO REMAIN.
- 22. THE CONTRACTOR SHALL WORK WITH THE CONDITIONS AS THEY EXIST AT THE SITE. ALL ABOVE CEILING CONDITIONS SHALL BE REVIEWED, AND MODIFICATIONS IDENTIFIED, COORDINATED, AND INCORPORATED INTO THE SHOP DRAWING PROCESS. COORDINATE ALL ABOVE CEILING WORK TO ENSURE A COMPLETE AND OPERATIONAL SYSTEM AT NO ADDITIONAL COST TO THE OWNER. COORDINATION SHALL INCLUDE, BUT NOT BE LIMITED TO THE FOLLOWING:
 - B. THE CEILING SUPPORT SYSTEM. . THE MECHANICAL DUCTWORK SYSTEM.
- D. THE LIGHTING FIXTURES. . ELECTRICAL WIRING AND CONDUIT SYSTEMS.

A. THE OWNER'S EQUIPMENT REQUIREMENTS.

A COMPLETE AND SATISFACTORY INSTALLATION.

THE ROOFING WARRANTY CONTRACTOR.

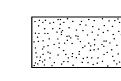
STOPS (SEE SPECIFICATIONS).

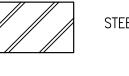
RESISTANT AT WALLS AND CEILINGS.

- THE PLUMBING AND PIPING SYSTEMS. G. THE COMMUNICATIONS SYSTEMS.
- 23. ALL CONTRACTORS ARE RESPONSIBLE FOR REVIEWING ENTIRE SET OF DOCUMENTS TO DETERMINE THEIR FULL SCOPE OF WORK. CONTRACTOR SHALL NOT BE ALLOWED EXTRA COSTS DUE TO FAILURE TO REVIEW ENTIRE SET OF DOCUMENTS.
- 24. ALL NEW STUD WALLS AND GYPSUM BOARD SHALL EXTEND TO STRUCTURE UNLESS NOTED OTHERWISE.
- 25. WHEN ALTERING THE BUILDING, IF STRUCTURAL INTEGRITY APPEARS TO BE IN QUESTION
- CONTRACTOR SHALL NOTIFY OWNER AND ARCHITECT IMMEDIATELY. 26. ALL NEW CONSTRUCTION IS INDICATED BOLD OR FULL TONE UNLESS NOTED OTHERWISE.
- 27. WHEN WALL PARTITIONS OF DIFFERENT FIRE RATING INTERSECT, THE HIGHEST RATED PARTITION TAKES PRECEDENT. MAINTAIN RATING BEHIND RECESSED AREAS IN WALLS.
- 28. ALL CORRIDOR WALLS ARE REQUIRED TO BE SMOKE TIGHT, WHETHER THEY ARE FIRE RATED OR NOT. REPAIR AND EXTEND AT LEAST THE CORRIDOR SIDE OF NON-RATED CORRIDOR WALLS TO STRUCTURE, UNLESS NOTED OTHERWISE, SEE WALL TYPES BELOW.
- 29. COORDINATE CONSTRUCTION REQUIREMENTS WITH MECHANICAL AND ELECTRICAL DRAWINGS.
- 30. REVIEW AREAS OF WORK WITH COR FOR INFECTION CONTROL REQUIREMENTS. AREAS REQUIRING CLASS I/CLASS II INFECTION CONTROL WILL REQUIRE APPROVAL BY THE COR PRIOR TO BEGINNING WORK. AREAS REQUIRING CLASS III/CLASS IV INFECTION CONTROL REQUIRE PERMITS FROM THE VA. SEE DIVISION 1 SPECIFICATION "SAFETY REQUIREMENTS-INFECTION CONTROL" FOR DETAILED INFORMATION.
- 31. CONTRACTOR TO PROVIDE STOCK OF NEW CEILING TILES TO BE INSTALLED, BASED UPON 20% OF TOTAL AREA OF EACH TYPE OF ACOUSTICAL TILE CEILINGS INDICATED TO BE REMOVED AND REINSTALLED, TO REPLACE EXISTING DAMAGED ACOUSTICAL CEILING TILE. STOCK OF NEW CEILING TILES WILL BE RETAINED BY THE MEDICAL CENTER, WITH THE CONTRACTOR DRAWING ON THE STOCK FOR REPLACEMENT TILES. NEW CEILING TILES NOT INCORPORATED INTO THE WORK SHALL BE RETAINED BY THE OWNER FOR USE BY THE MEDICAL CENTER. SHOULD THE AMOUNT OF TILE USED FOR REPLACEMENT EXCEED THE QUANTITY OF STOCK PURCHASED FOR AND PROVIDED TO THE MEDICAL CENTER. THE CONTRACTOR SHALL PROVIDE AND INSTALL ADDITIONAL ACOUSTICAL CEILING TILE AT AN ESTABLISHED UNIT PRICE PER FULL CASE OF CEILING TILE.
- 32. CONTRACTOR SHALL TURN OVER TO THE MEDICAL CENTER ALL UNDAMAGED CEILING TILE AND SUSPENSION GRID THAT HAS REMOVED AND BEEN DETERMINED BY THE MEDICAL CENTER TO BE SALVAGABLE FOR FUTURE REPLACEMENT USE AT THE MEDICAL CENTER.
- 33. REFER TO SPECIFICATIONS AND THE VA'S ROOM FINISH SCHEDULE DOCUMENT PG-18-14 FOR USE OF AT (SP) ACOUSTICAL CEILING TILE. AT (SP) TILE IS TYPICALLY USED IN (BUT NOT LIMITED TO) AREAS WHERE CEILINGS ARE SUBJECTED TO CLEANING, SUCH AS SPS. LABORATORIES, PHARMACY, KITCHENS AND OTHER FOOD PREPARATION AREAS. AT (SP)
- 34. CONTRACTOR SHALL OBSERVE WORK RESTRICTIONS NOTED IN PHASING REQUIREMENTS, ON DRAWINGS AND IN THE SPECIFICATIONS FOR AREAS THAT ARE A PART OF OR ADJACENT TO ADMINISTRATIVE, DIETARY, SUPPORT, IN-PATIENT, OUT-PATIENT AND CLINICAL AREAS.

MATERIAL SYMBOLS

CAST-IN-PLACE CONCRETE

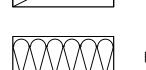




CONTINUOUS WOOD FRAMING

WOOD BLOCKING

GYPSUM BOARD



FIBROUS INSULATION

PHASING REQUIREMENTS

PHASING GENERAL NOTES:

PHASE 1 CONSISTS OF THE WORK ASSOCIATED WITH THE CT SCANNER ROOMS A83, A86 AND ADJACENT ROOMS AFFECTED BY THE WORK.

PHASE 2 CONSISTS OF THE WORK ASSOCIATED WITH THE NUCLEAR MEDICINE AREA ROOMS A02, A03, A03A, A03B, A03C, A04, A04A, AND

ARCHITEC1	TURAL SYMBOLS
NOTE: N	NOT ALL SYMBOLS USED
X	COLUMN GRID LINE (EXISTING BLDG)
X	COLUMN GRID LINE (EXIST — ADD'N)
	CENTER LINE
7'-2"	DIMENSION LINE
RNAME1 RNAME2 [RNUM]	- ROOM NAME ROOM NUMBER SYMBOL - ROOM NUMBER
D 000	DOOR NUMBER SYMBOL
NUM	— DETAIL NUMBER
SHEET	— SHEET DETAIL IS DRAWN ON
NUM	ARCHITECTURAL SECTION
NUMBER	ARCHITECTURAL ELEVATION — INTERIOR
	NOTE: N X X 7'-2" RNAME1 RNAME2 RNUM NUM SHEET NUM SHEET NUMBER

X	COLUMN GRID LINE (EXISTING BLDG)
X	COLUMN GRID LINE (EXIST - ADD'N)
	CENTER LINE
7'-2"	DIMENSION LINE
RNUM RC	DOM NAME DOM NUMBER SYMBOL DOM NUMBER
DC DC	OOR NUMBER SYMBOL
NUM DE	TAIL NUMBER
SHEET	HEET DETAIL IS DRAWN ON
NUM SHEET AR	CCHITECTURAL SECTION
NUMBER SHEET) AR	CCHITECTURAL ELEVATION — INTERIOR

Abbreviations and Notes	BID DOCUMENTS	Project Title Second CT Scanner Site Prep Design			Project Number 438-18-103 Building Number 5
Approved: Project Director	FULLY SPRINKLERED	Location Sioux Falls, SD Issue Date October 10, 2018	Checked CLH	Drawn TDW	Drawing Number G002

BID DOCUMENTS	10/10/2018
CONSTRUCTION DOCUMENTS 100% SUBMITTAL — UPDATE	9/28/2018
CONSTRUCTION DOCUMENTS 100% SUBMITTAL	9/7/2018
DESIGN DEVELOPMENT 90% SUBMITTAL	8/3/2018
SCHEMATIC DESIGN 36% SUBMITTAL 2	7/5/2018
SCHEMATIC DESIGN 35% SUBMITTAL	6/6/2018

PTN

PVMT

EXPANSION JOINT

POINT, POINT OF TANGENT

POINT OF VERTICAL CURVE, POLY VINYL CHLORIDE

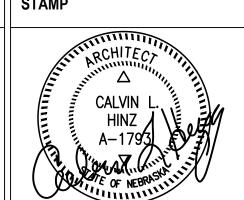
PARTITION

PAVEMENT

CONSULTANT Mechanical / Electrical Engineering: Structural Engineering: Shaffer & Stevens, P.C. Farris Engineering 12700 W Dodge Road 9910 N 48th Street **Omaha, NE 68154** Omaha, NE 68152 (402) 330-5900 (402) 455-7698 Donn Shaffer Robert Hotovy

<u>A/E:</u> **CLH Architects** 3705 N 200th St Elkhorn, NE 68022 (402) 291-6941 **Tim Werner**

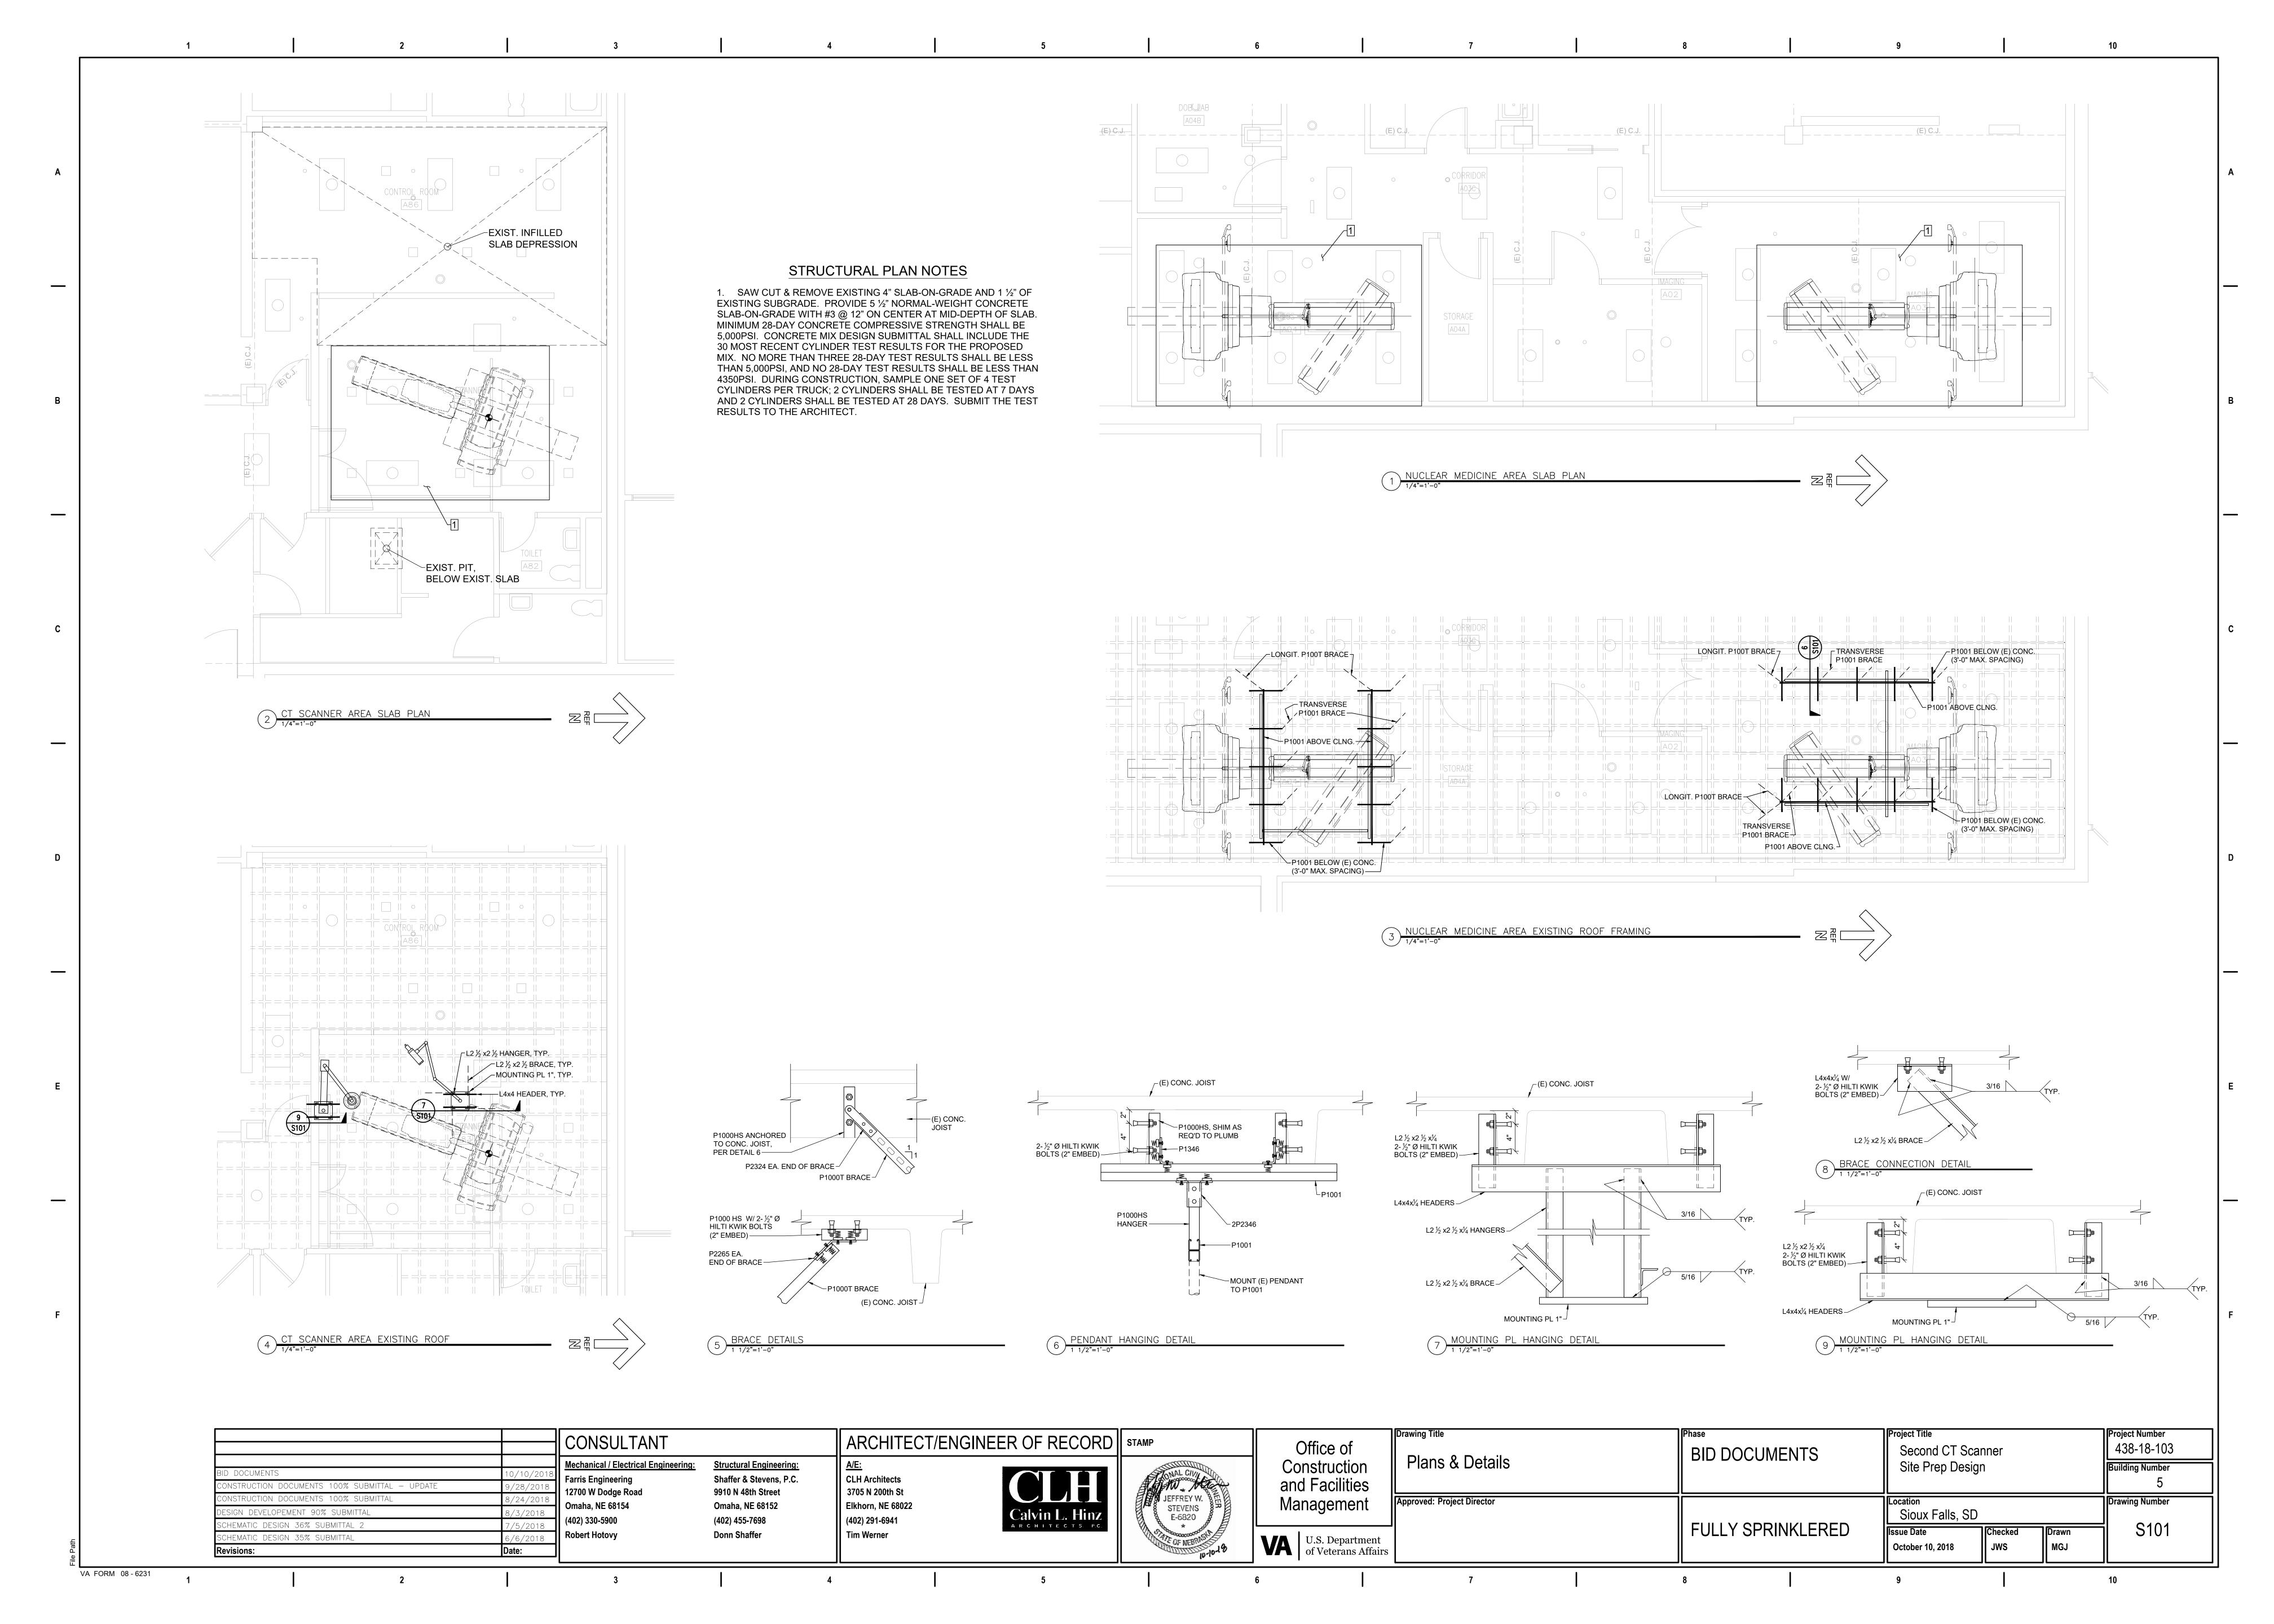


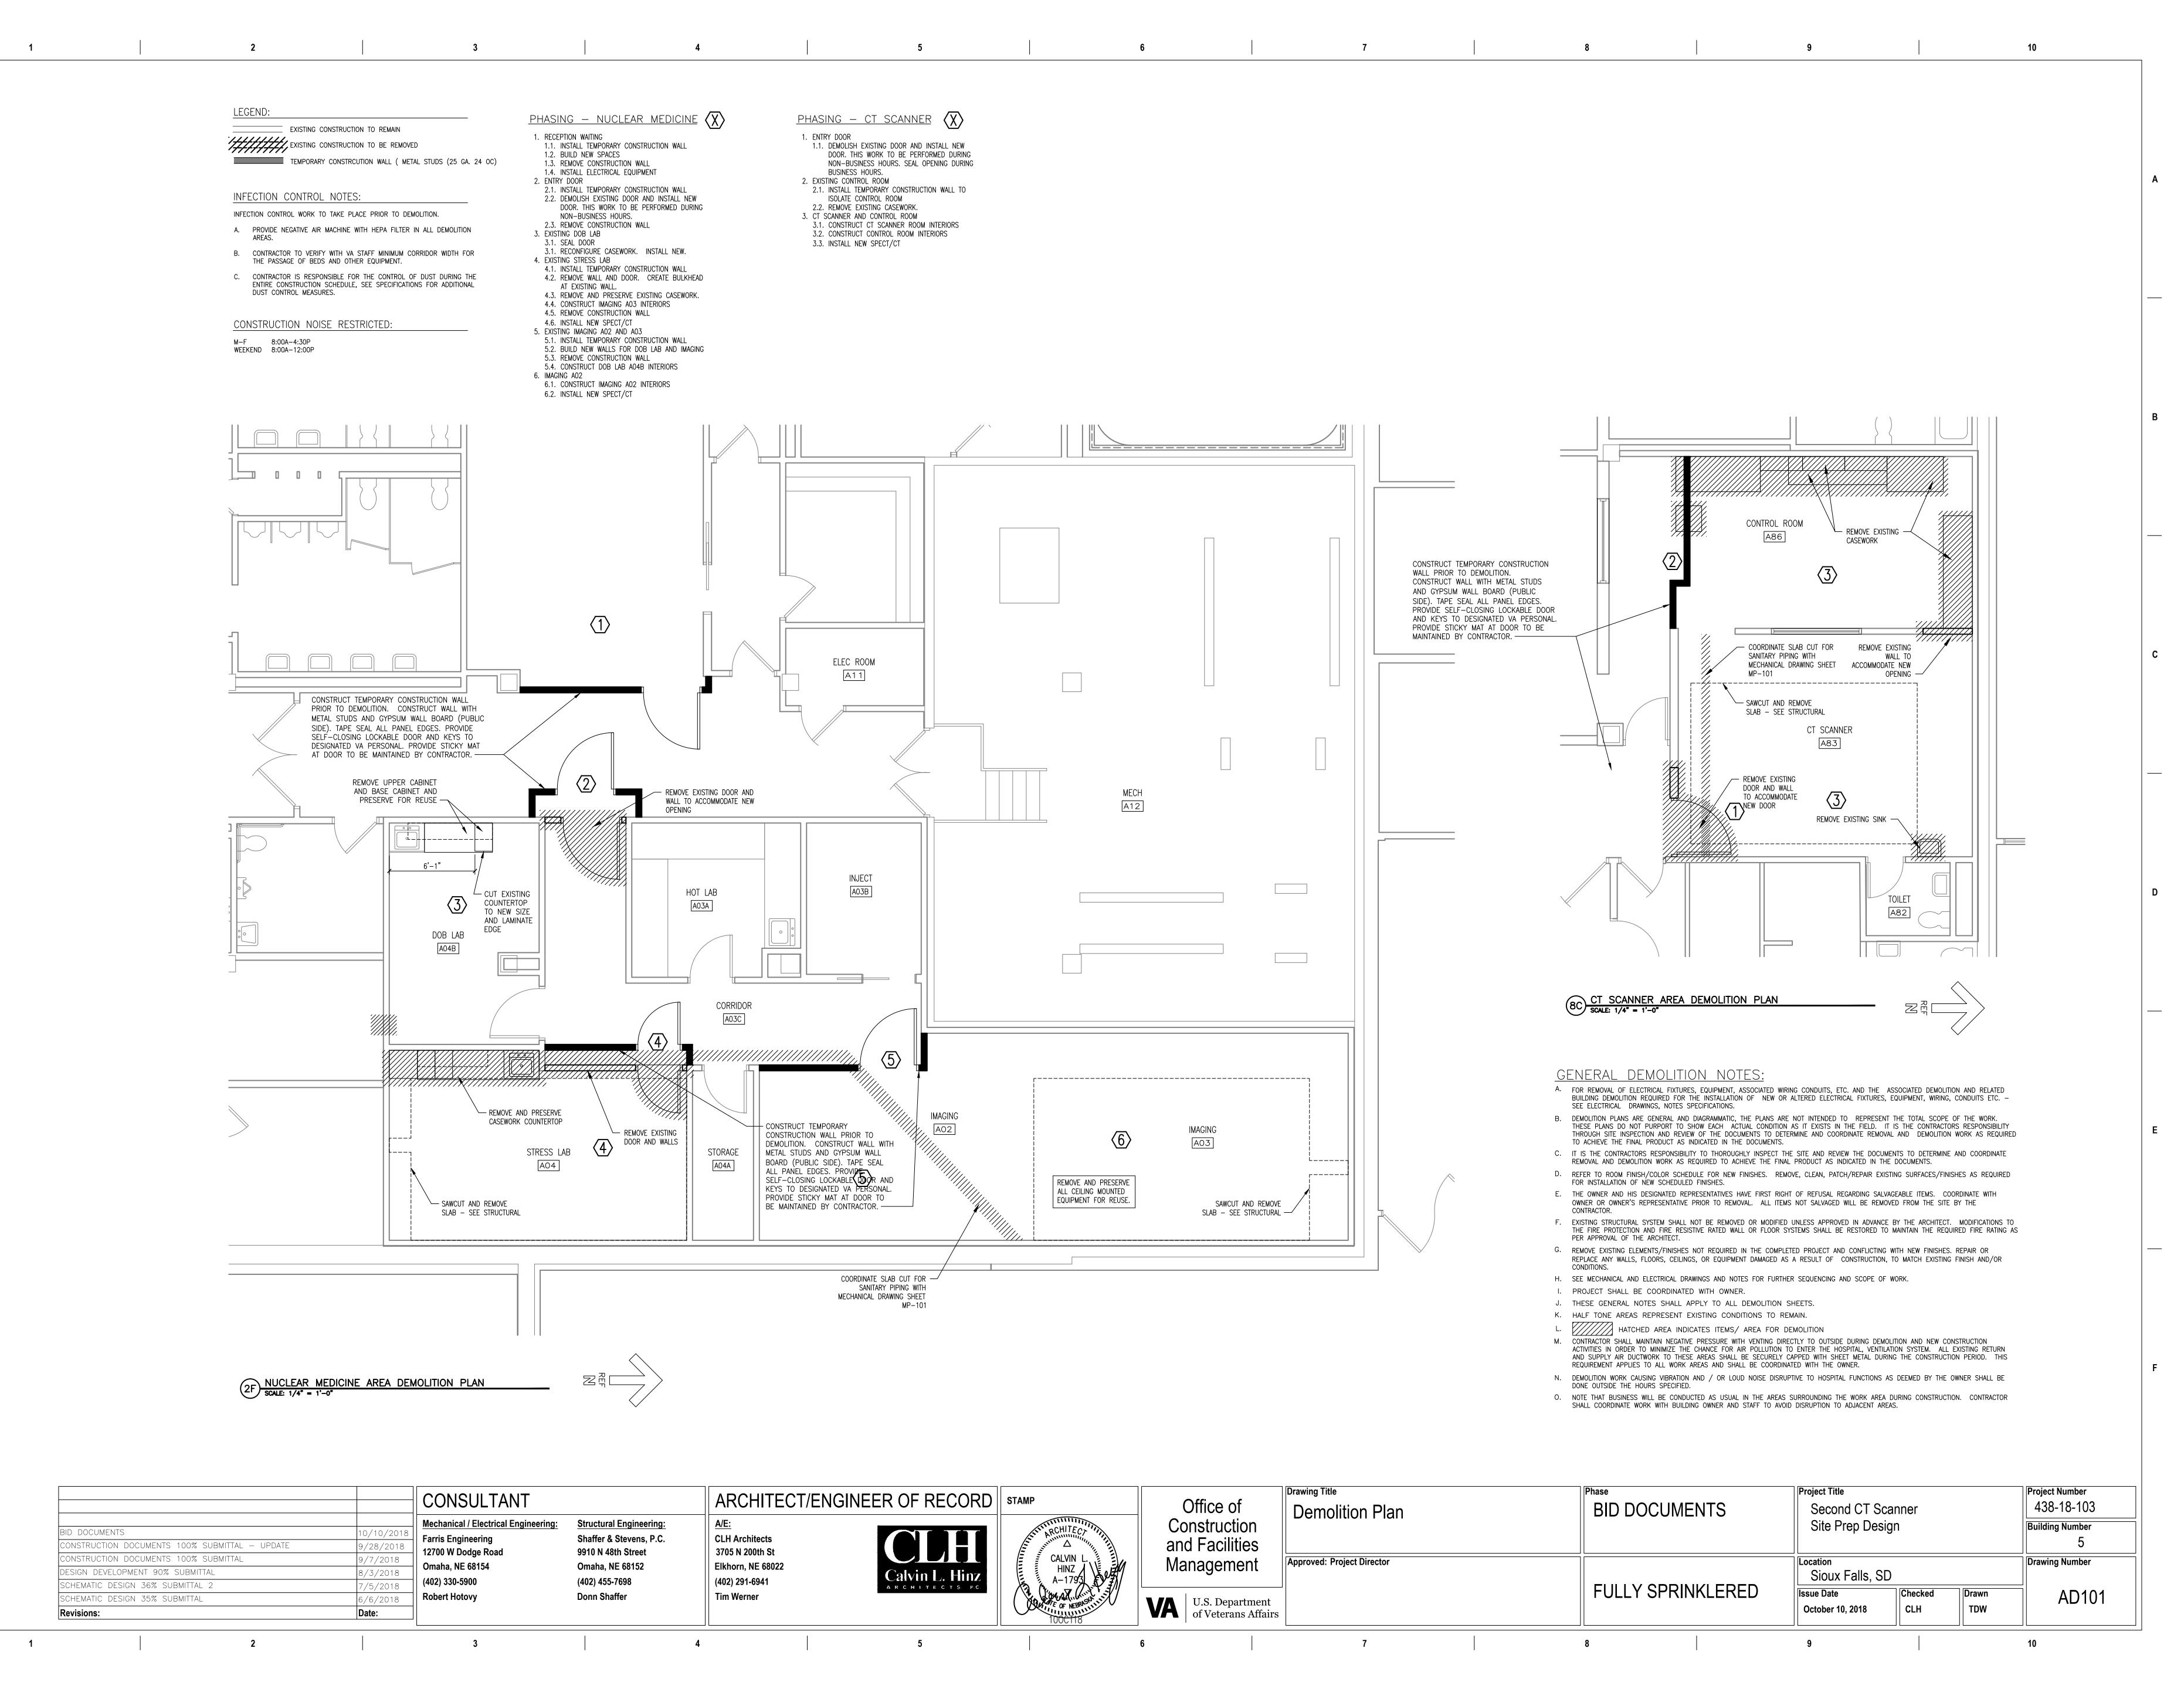


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U.S. Department of Veterans Affairs

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