

LOCATION: GENERATOR B66A VOLTS: 480/277 WYE MAINS TYPE: MCB **SUPPLY FROM:** NORMAL PHASES: 3 MCB/MLO RATING: 1600 A MCB OPTIONS: GFA, ERMS **BRANCH: GENERATOR** WIRES: 4 SERVICE RATED: No INTEGRAL SPD: Yes SECTIONS: 4 AVAILABLE SCC (kA): 17.7 OPT POLES RATING LOAD CIRCUIT REMARKS CIRCUIT DESCRIPTION 1 ATS-A SIDE 3 1200 A 847515 VA GFA, ERMS -- 3 400 A 0 VA GFA
-- 3 250 A 0 VA GFA
-- 3 400 A 0 VA GFA
-- 3 1600 A 0 VA GFA, ERMS 2 ATS-UPS 3 ATS-7 4 ATS-2 **Total VA:** 847515 VA **Total A:** 1019 A CONNECTED LOAD DEMAND FACTOR ESTIMATED DEMAND PANEL TOTALS LOAD CLASSIFICATION CONNECTED LOAD: 847515 VA 725799 VA CONNECTED CURRENT: 1019 A 111.30% 135476 VA **DEMAND LOAD:** 861275 VA DEMAND CURRENT: 1036 A **CONSIDER 125% DEMAND:** 1076593 A EQUIPMENT AMPS: 1600 A SPARE CAPACITY: 35 564 A CIRCUIT BREAKER OPTIONS SUFFIX: 'S' OR 'ST' - PROVIDE SHUNT TRIP CIRCUIT BREAKER / 'G' OR 'GFCI' - PROVIDE GFCI CIRCUIT BREAKER / 'GFP' - PROVIDE GFP CIRCUIT BREAKER / 'ERMS' - ENERGY REDUCING MAINTENANCE SWITCH / 'ZSI' - ZONE SELECTIVE INTERLOCKING / 'L' - PROVIDE CIRCUIT BREAKER WITH LOCKING PROVISIONS A. PANEL AIC (INTERRUPTING) RATING SHALL BE MINIMUM 120% OF THE AVAILABLE SCC (SHORT CIRCUIT CURRENT).


NEMA ENCLOSURE: 1			PHASES: WIRES: NTEGRAL SPD: ABLE SCC (kA):	4 Yes		MAINS TYPE: NCB MCB/MLO RATING: 100 A MCB OPTIONS: NONE SECTIONS: 1 PANEL POLES: 42							
C CIRCUIT DESCRIPTION	OPT	RATI	POL	Α	В		С	POL	RATI	OPT	CIRC	UIT DESCRIPTION	С
1 PWR-C TELECOMM B22 - RACK				1922									2
3 RECEPTACLE		20 A	3		1922 VA		1000) (4						4
5 7				1922			1922 VA						8
PWR-C TELECOMM B22 - RACK		20 A	3	1922	1922 VA								1
9 RECEPTACLE		20 A	3		1922 VA		1922 VA						1
13				1922			1022 77						1
PWR-C TELECOMM B22 - RACK		20 A	3		1922 VA					+ +			1
RECEPTACLE							1922 VA						1
19				0 VA									2
SPARE		20 A	3		0 VA								2
23							0 VA						2
SPARE		20 A	1	0 VA									2
27 SPARE		20 A	1		0 VA								2
29 SPARE		20 A	1				0 VA						3
REC TELECOMM B23		20 A	1	180 VA	400.1/4								3
REC TELECOMM B23 STATE LTG TELECOMM B23		20 A	1		180 VA		50.\/A						3
B5 LTG TELECOMM B23		20 A	ı				50 VA						3
39													4
11 ·													4
		TOTAL	LOAD:	5945 V	'A 5945 \	VA	5815 VA						
		TOTAL	AMPS:	50 A	50 A	4	48 A						
OAD CLASSIFICATION		СО	NNECT	ED LOAD	DEMAND FACT	ΓOR	ESTIMATED DEN	//AND			PANEL	TOTALS	
TG			50		125.00%		62 VA		CONNECTED LOAD:		TED LOAD:	17705 VA	
EC			360	VA	100.00%		360 VA		CONNECTED CURRENT		49 A		
WR-NC			1729	5 VA	78.91%		13648 VA			DEMA	AND LOAD:	14069 VA	
											CURRENT:		
											6 DEMAND:		
											ENT AMPS:	100 A	
									FE	EDER A	VAILABLE:	00 0/	
										SPARE	CAPACITY:	60 % 61 A	
												61 A	
PTIONS: IRCUIT BREAKER OPTIONS SUFFIX: ' IRCUIT BREAKER / 'ERMS' - ENERGY F ROVISIONS / 'R' - PROVIDE CIRCUIT	REDUCIN	G MAINT	ENANG	CE SWITCH									1
ENERAL REMARKS:													

	SUPPLY FROM:	CRITICAL No SURFACE	M B23			VOLTS: 208/ PHASES: 3 WIRES: 4 INTEGRAL SPD: Yes ABLE SCC (kA): 6.1	120 WYE		MCB/MI MCE	AINS TYPE: MCE LO RATING: 100 B OPTIONS: NON SECTIONS: 1 NEL POLES: 42	A	
C CIRCUI	T DESCRIPTION	ОРТ	RATI	POL	Α	В	С	POL	RATI	OPT CI	RCUIT DESCRIPTION	C.
1 PWR-C TELEC	OMM B22 - RACK				1922	1000 1/4						2
RECEPTACLE			20 A	3		1922 VA	1922 VA					6
7					1922		1922 VA					8
PWR-C TELEC	OMM B22 - RACK		20 A	3	1022	1922 VA						10
RECEPTACLE						1022 111	1922 VA					1:
13					1922							14
15 PWR-C TELEC	COMM B22 - RACK		20 A	3		1922 VA						1
17 RECEITAGEE							1922 VA					1
19 SSIU-B22/SSO	II-B22		30 A	2	1488							2
21						1488 VA						2:
23 SPARE			20 A	1			0 VA					2
25					0 VA	0.74						20
27 SPARE			20 A	3		0 VA	0.1/4					2
29 31 SPARE			20 A	1	0 VA		0 VA					3
33 SPARE			20 A	1	UVA	0 VA						3
35 SPARE			20 A	1		OVA	0 VA					3
37 REC TELECON	MM B23		20 A	1	180 VA		3 771					3
39 LTG TELECOM			20 A	1	100 171	50 VA						4
41												4
•			TOTAL	LOAD:			5765 VA	A	•			•
							_					
OAD CLASSIFICA	TION		CO		ED LOAD	DEMAND FACTOR	+				L TOTALS	
.TG				50		125.00%	62 V			ONNECTED LOA		
REC MTR				180		100.00% 124.00%	180 \		CONN	IECTED CURREN DEMAND LOA		
PWR-NC				2975 1729		78.91%	3689 Y			EMAND CURREN		
VVIX-INC				1729	3 VA	70.9170	13040			ER 125% DEMAN		
										EQUIPMENT AMP		
										EDER AVAILABL		
											51 %	
										SPARE CAPACIT	Y : 51 A	
OPTIONS:												
CIRCUIT BREAKER											/ 'GFP' - PROVIDE GFF AKER WITH LOCKING)

LOCATION: GENERAT SUPPLY FROM: T-B1 BRANCH: NORMAL SERVICE RATED: No	OR B66A	AV/		VOLTS: PHASES: WIRES: RAL SPD: SCC (kA):	4 Yes	MAINS TYPE: MCB MCB/MLO RATING: 500 A MCB OPTIONS: NONE SECTIONS: 1				
KT CIRCUIT D	ESCRIPTION	OPT	POLES	RATING	Load	CIRCU	IIT REMARKS			
1 B23-B			3	100 A	17705 VA					
2 H1-B			3	100 A	26040 VA					
3 A27-B			3	200 A	38719 VA					
4 1002-B			3	100 A	11940 VA					
5 1014-B			3	100 A	20863 VA					
6 111-B			3	100 A	18065 VA					
7 1026A-B			3	100 A	26586 VA					
8 226C-B			3	100 A	12432 VA					
9 330C-B			3	100 A	12070 VA					
10 433-B 11 SPARE			3	100 A 100 A	17885 VA 0 VA					
12 SPARE			3	100 A	0 VA					
13 SPARE		<u></u>	3	100 A	0 VA					
14 SPARE			3	100 A	0 VA					
15 SSIU-B66AA/SSOU-B66A	AA		2	30 A	2975 VA					
16				0071	20.0					
17										
18										
19										
20										
				Total VA:	205278 VA					
				Total A:	570 A					
OAD CLASSIFICATION	CONNECTED LOAD	DE	EMAND FACTOR		ESTIMATED DE	MAND	PANEL T	OTALS		
TG	743 VA		125.009	%	928 VA	CONNECTED LOAD		205278 VA		
REC	9720 VA		100.009	%	9720 VA		CONNECTED CURRENT:	570 A		
1TR	16095 VA		104.449	%	16809 VA	A DEMAND LOAD		121817 VA		
WR-NC	178720 VA		52.80%	6	94360 VA			338 A		
							CONSIDER 125% DEMAND:	152271 A		
							EQUIPMENT AMPS:	500 A		
							SPARE CAPACITY:	32		
							OI AIL OAI AOITT.	162 A		
PTIONS:										
	AKER / 'ERMS' - ENERGY RED						FCI' - PROVIDE GFCI CIRCUIT LECTIVE INTERLOCKING / 'L			


A1										
LOCATION: GENERATO	R B66A		VOLTS:	208/120 WYE	MAINS TYPE: MCB					
SUPPLY FROM:			PHASES:			MCB/MLO RATING: 600 A				
BRANCH: CRITICAL			WIRES:			MCB OPTIONS: NONE				
SERVICE RATED: No			RAL SPD:			SECTIONS: 1				
		AVAILABLE	SCC (kA):	15.1						
CKT CIRCUIT DES	SCRIPTION (OPT POLES		Load	CIRCU	IIT REMARKS				
1 B23-A		3	100 A	20500 VA						
2 H1-A		3	100 A	26220 VA						
3 A27-A		3	200 A	38539 VA	-					
4 CRE2.1 (1002-A) 5 1014-A		3	100 A 100 A	13970 VA 18068 VA						
6 111-A		3	100 A	21040 VA						
7 1026A-A		3	100 A	24024 VA						
8 UPS2 (226C-A)		3	100 A	13922 VA						
9 UPS3 (330C-A)		3	100 A	13920 VA						
10 433-A		3	100 A	21040 VA						
11 SPARE		3	100 A	0 VA						
12 SPARE		3	100 A	0 VA						
13 SPARE		3	100 A	0 VA						
14 SPARE		3	100 A	0 VA						
15 SSIU-B66AA/SSOU-B66AA	1	2	30 A	2975 VA						
16										
17										
18										
19 20					-					
20			Total VA	: 214215 VA						
			Total A							
LOAD CLASSIFICATION	CONNECTED LOAD	DEMAND FA		ESTIMATED DE	MAND	PANEL T	1			
_TG	520 VA	125.009		650 VA	CONNECTED LOAI					
REC	5760 VA	100.009		5760 VA		CONNECTED CURRENT:				
MTR	29215 VA	102.449		29929 VA	DEMAND CURRENT					
PWR-NC	178720 VA	52.80%	0	94360 VA		DEMAND CURRENT: CONSIDER 125% DEMAND:				
						EQUIPMENT AMPS:				
							39			
						SPARE CAPACITY:	237 A			
OPTIONS:										
CIRCUIT BREAKER OPTIONS S PROVIDE GFP CIRCUIT BREAK	(ER / 'ERMS' - ENERGY REDI									
BREAKER WITH LOCKING PRO	CNUICIV									
GENERAL REMARKS:	DATING CUALL SEASON	NA 4000/ CE T:::	_ ^\/^!! ^_	J E 000 (0) 10E	01001	IT OUDDEN'T'				
A PANEL AIC (INTERRITOTING) RATING SHALL BE MINIMU	м 120% OF THI	⊨ AVAILAB	LE SCC (SHORT	CIRCU	II CURRENT).				
A. I ANLE AIC (INTERROOT TING	,									

LOCATION: GENERATOR B66A SUPPLY FROM: ATS-A SIDE BRANCH: CRITICAL SERVICE RATED: No			AV		VOLTS: PHASES: WIRES: RAL SPD: SCC (kA):	4 Yes	MAINS TYPE: MCB MCB/MLO RATING: 1200 A MCB OPTIONS: GFA, ERMS SECTIONS: 1					
СКТ	KT CIRCUIT DESCRIPTION			POLES	RATING	LOAD	CIRCUIT REMARKS					
1	CRAC-1 MAIN SERVER ROO	OM 201		3	100 A	55038 VA						
2	CRAC-2 MAIN SERVER ROO	OM 201		3	100 A	55038 VA						
	ACCU-1			3	15 A	5820 VA						
	ACCU-2			3	15 A	5820 VA						
	MCR UPS A			3	400 A	241933 VA						
	UPS A1			3	400 A	241933 VA						
	UPS A2			3	400 A	241933 VA						
	SPARE			3	80 A	0 VA						
	SPARE			3	100 A	0 VA						
10	SPARE			3	400 A Total VA	0 VA : 847515 VA						
					Total A	: 1019 A	_					
	D CLASSIFICATION	CONNECTED LOAD	DE	MAND FA		ESTIMATED DE		PANEL T				
Spar		725799 VA		100.009		725799 VA		CONNECTED LOAD:				
MTR		121716 VA		111.309	%	135476 VA	4	CONNECTED CURRENT:				
								DEMAND LOAD:				
								DEMAND CURRENT:				
								CONSIDER 125% DEMAND:				
								EQUIPMENT AMPS:				
								SPARE CAPACITY:	13			
									164 A			
CIRO PRO		R / 'ERMS' - ENERGY RE						FCI' - PROVIDE GFCI CIRCUIT LECTIVE INTERLOCKING / 'L				
PRO BRE	VIDE GFP CIRCUIT BREAKE	ER / 'ERMS' - ENERGY RE /ISIONS	DUCING	MAINTE	NANCE SV	WITCH / 'ZSI' - ZC	ONE SEL	LECTIVE INTERLOCKING / 'L				

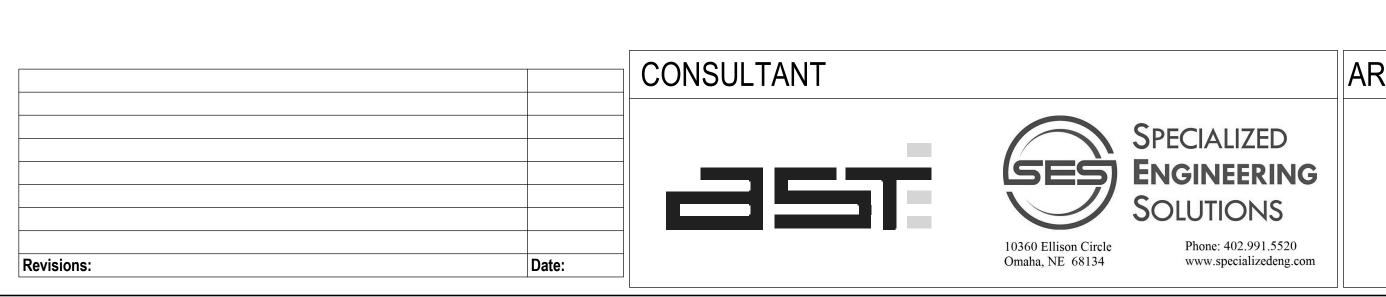


VA FORM 08 - 6231




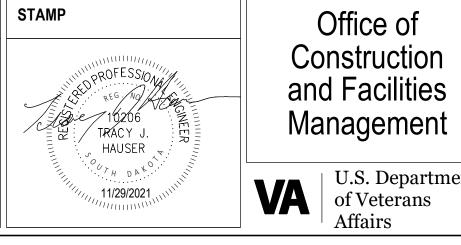

Office of Construction and Facilities Management
U.S. Departmen

Phase BID DOCUMENTS	Project Title VAMC SIOUX FA INFRASTRUCTU			Project Number 438-20-910 Building Number 5
FULLY SPRINKLERED	Location Sioux Falls, SD Issue Date 11/29/2021	Checked KSB	Drawn NMT	Drawing Number EE401-05-E

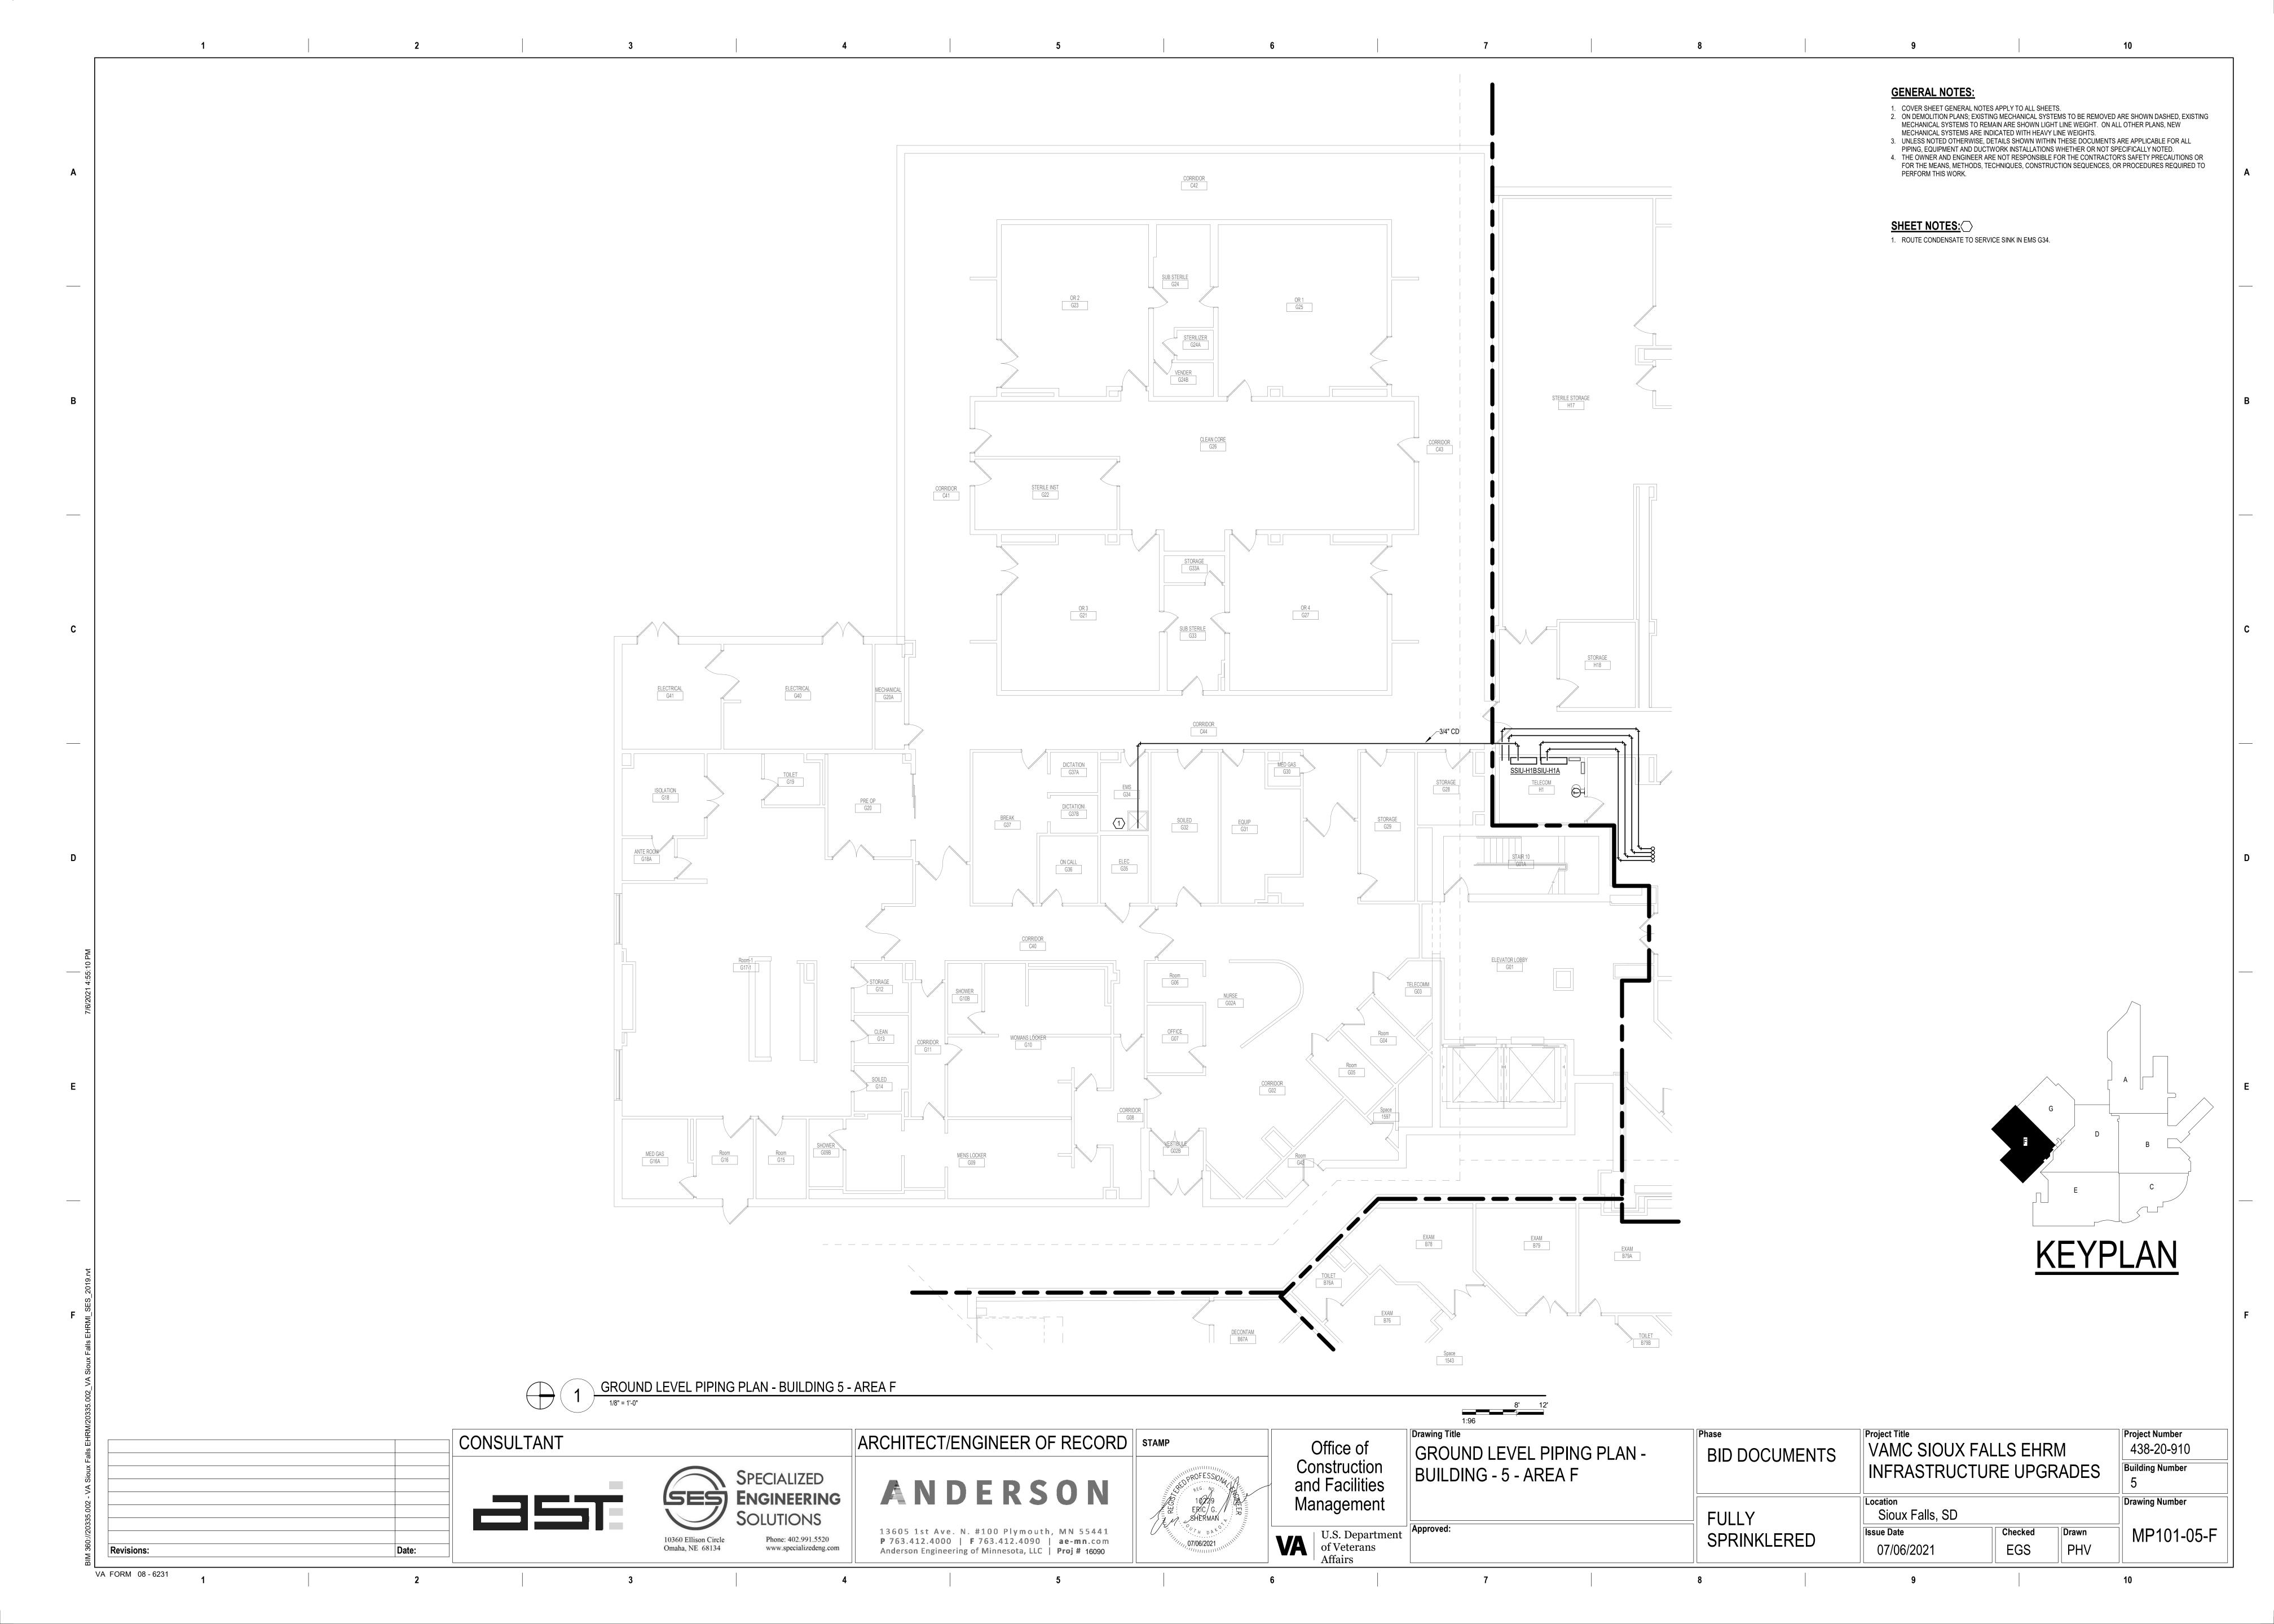

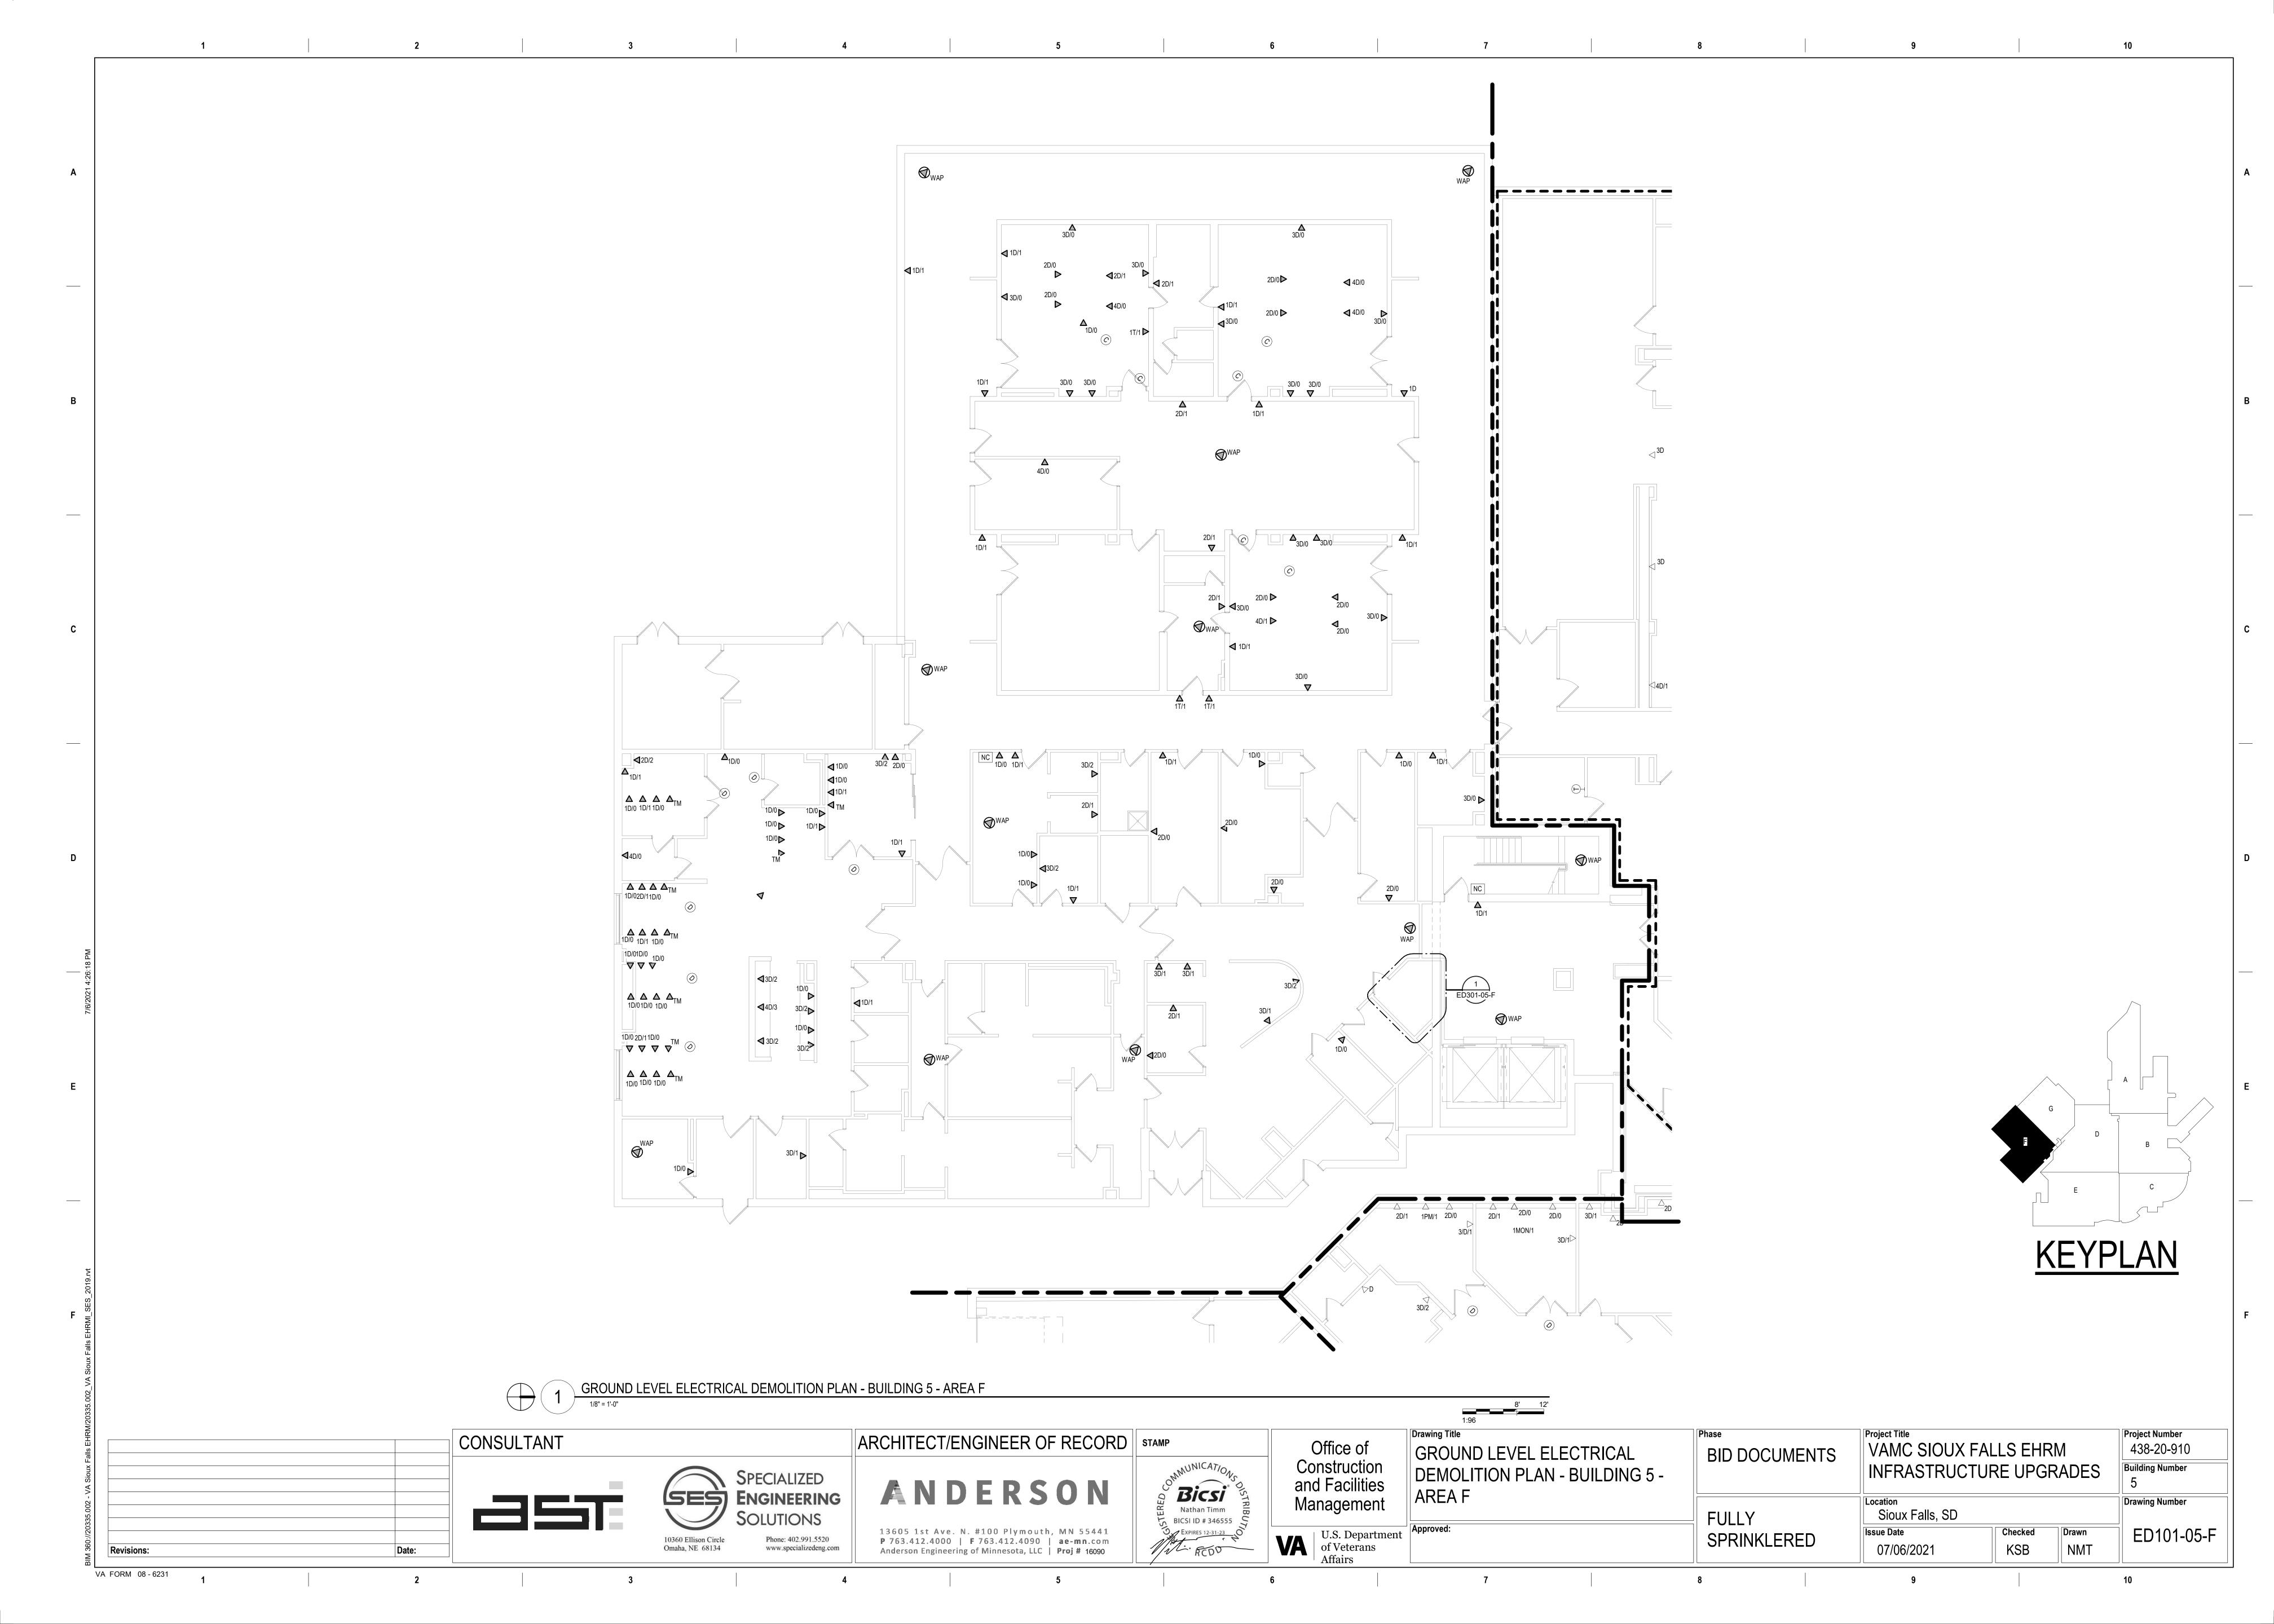

GROUND LEVEL ELECTRICAL DEMOLITION - BUILDING 5 - AREA F - ROOM G03

CABLING NOTES:

A. THE EXISTING CABLE COUNT ARE THE CABLES CURRENTLY PRESENT IN THE SPACE. THE CABLE RELOCATION COUNT ARE THE NEW OR RELOCATED CABLES TO BE FED FROM THE SPACE. THE FINAL CABLE COUNT ARE THE CABLES THAT WILL BE PRESENT IN THE SPACE AT THE COMPLETION OF THE PROJECT. REMOVE ALL UNUSED CABLING AT THE COMPLETION OF THE PROJECT.

1. ROOM G03

EXISTING CABLE COUNT DATA (CAT6): 336

DATA (CAT5): 0

PATIENT MONITORING: 8 COMMERCIAL WIRELESS: 0

CABLE RELOCATION COUNT DATA (CAT6): -336 TO ROOM H1

DATA (CAT5): 0 PATIENT MONITORING: -8 TO ROOM H1

COMMERCIAL WIRELESS: 0

EXISTING CABLE TO REMAIN DATA (CAT6): 0

PATIENT MONITORING: 0

COMMERCIAL WIRELESS: 0 FINAL CABLE COUNT

DATA (CAT6): 0 VIDEO: 0

PATIENT MONITORING: 0 COMMERCIAL WIRELESS: 0

SHEET NOTES:

1. EXISTING TELEPHONE WALL FIELD TO BE DEMOLISHED. NEW COPPER BACKBONE TO BE PROVIDED ON PATCH PANELS IN TELECOMMUNICATIONS RACK. REFER TO CABLING NOTES AND NEW WORK PLANS FOR ADDITIONAL REQUIREMENTS.

CONSULTANT Revisions:


VA FORM 08 - 6231

SPECIALIZED SES ENGINEERING 10360 Ellison Circle Phone: 402.991.5520 Omaha, NE 68134 www.specializedeng.com

ARCHITECT/ENGINEER OF RECORD | STAMP ANDERSON 13605 1st Ave. N. #100 Plymouth, MN 55441

P 763.412.4000 | F 763.412.4090 | ae-mn.com

Anderson Engineering of Minnesota, LLC | Proj # 16090

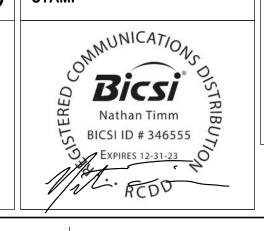

Office of Construction and Facilities Management U.S. Department of Veterans Affairs

GROUND LEVEL ELECTRICAL

DEMOLITION - BUILDING 5 -ENLARGED ROOMS - AREA F

Drawing Title

BID DOCUMENTS FULLY

VAMC SIOUX FALLS EHRM INFRASTRUCTURE UPGRADES

Sioux Falls, SD Checked SPRINKLERED KSB 07/06/2021

Project Title


ED301-05-F NMT


Drawn


Project Number


Building Number


Drawing Number

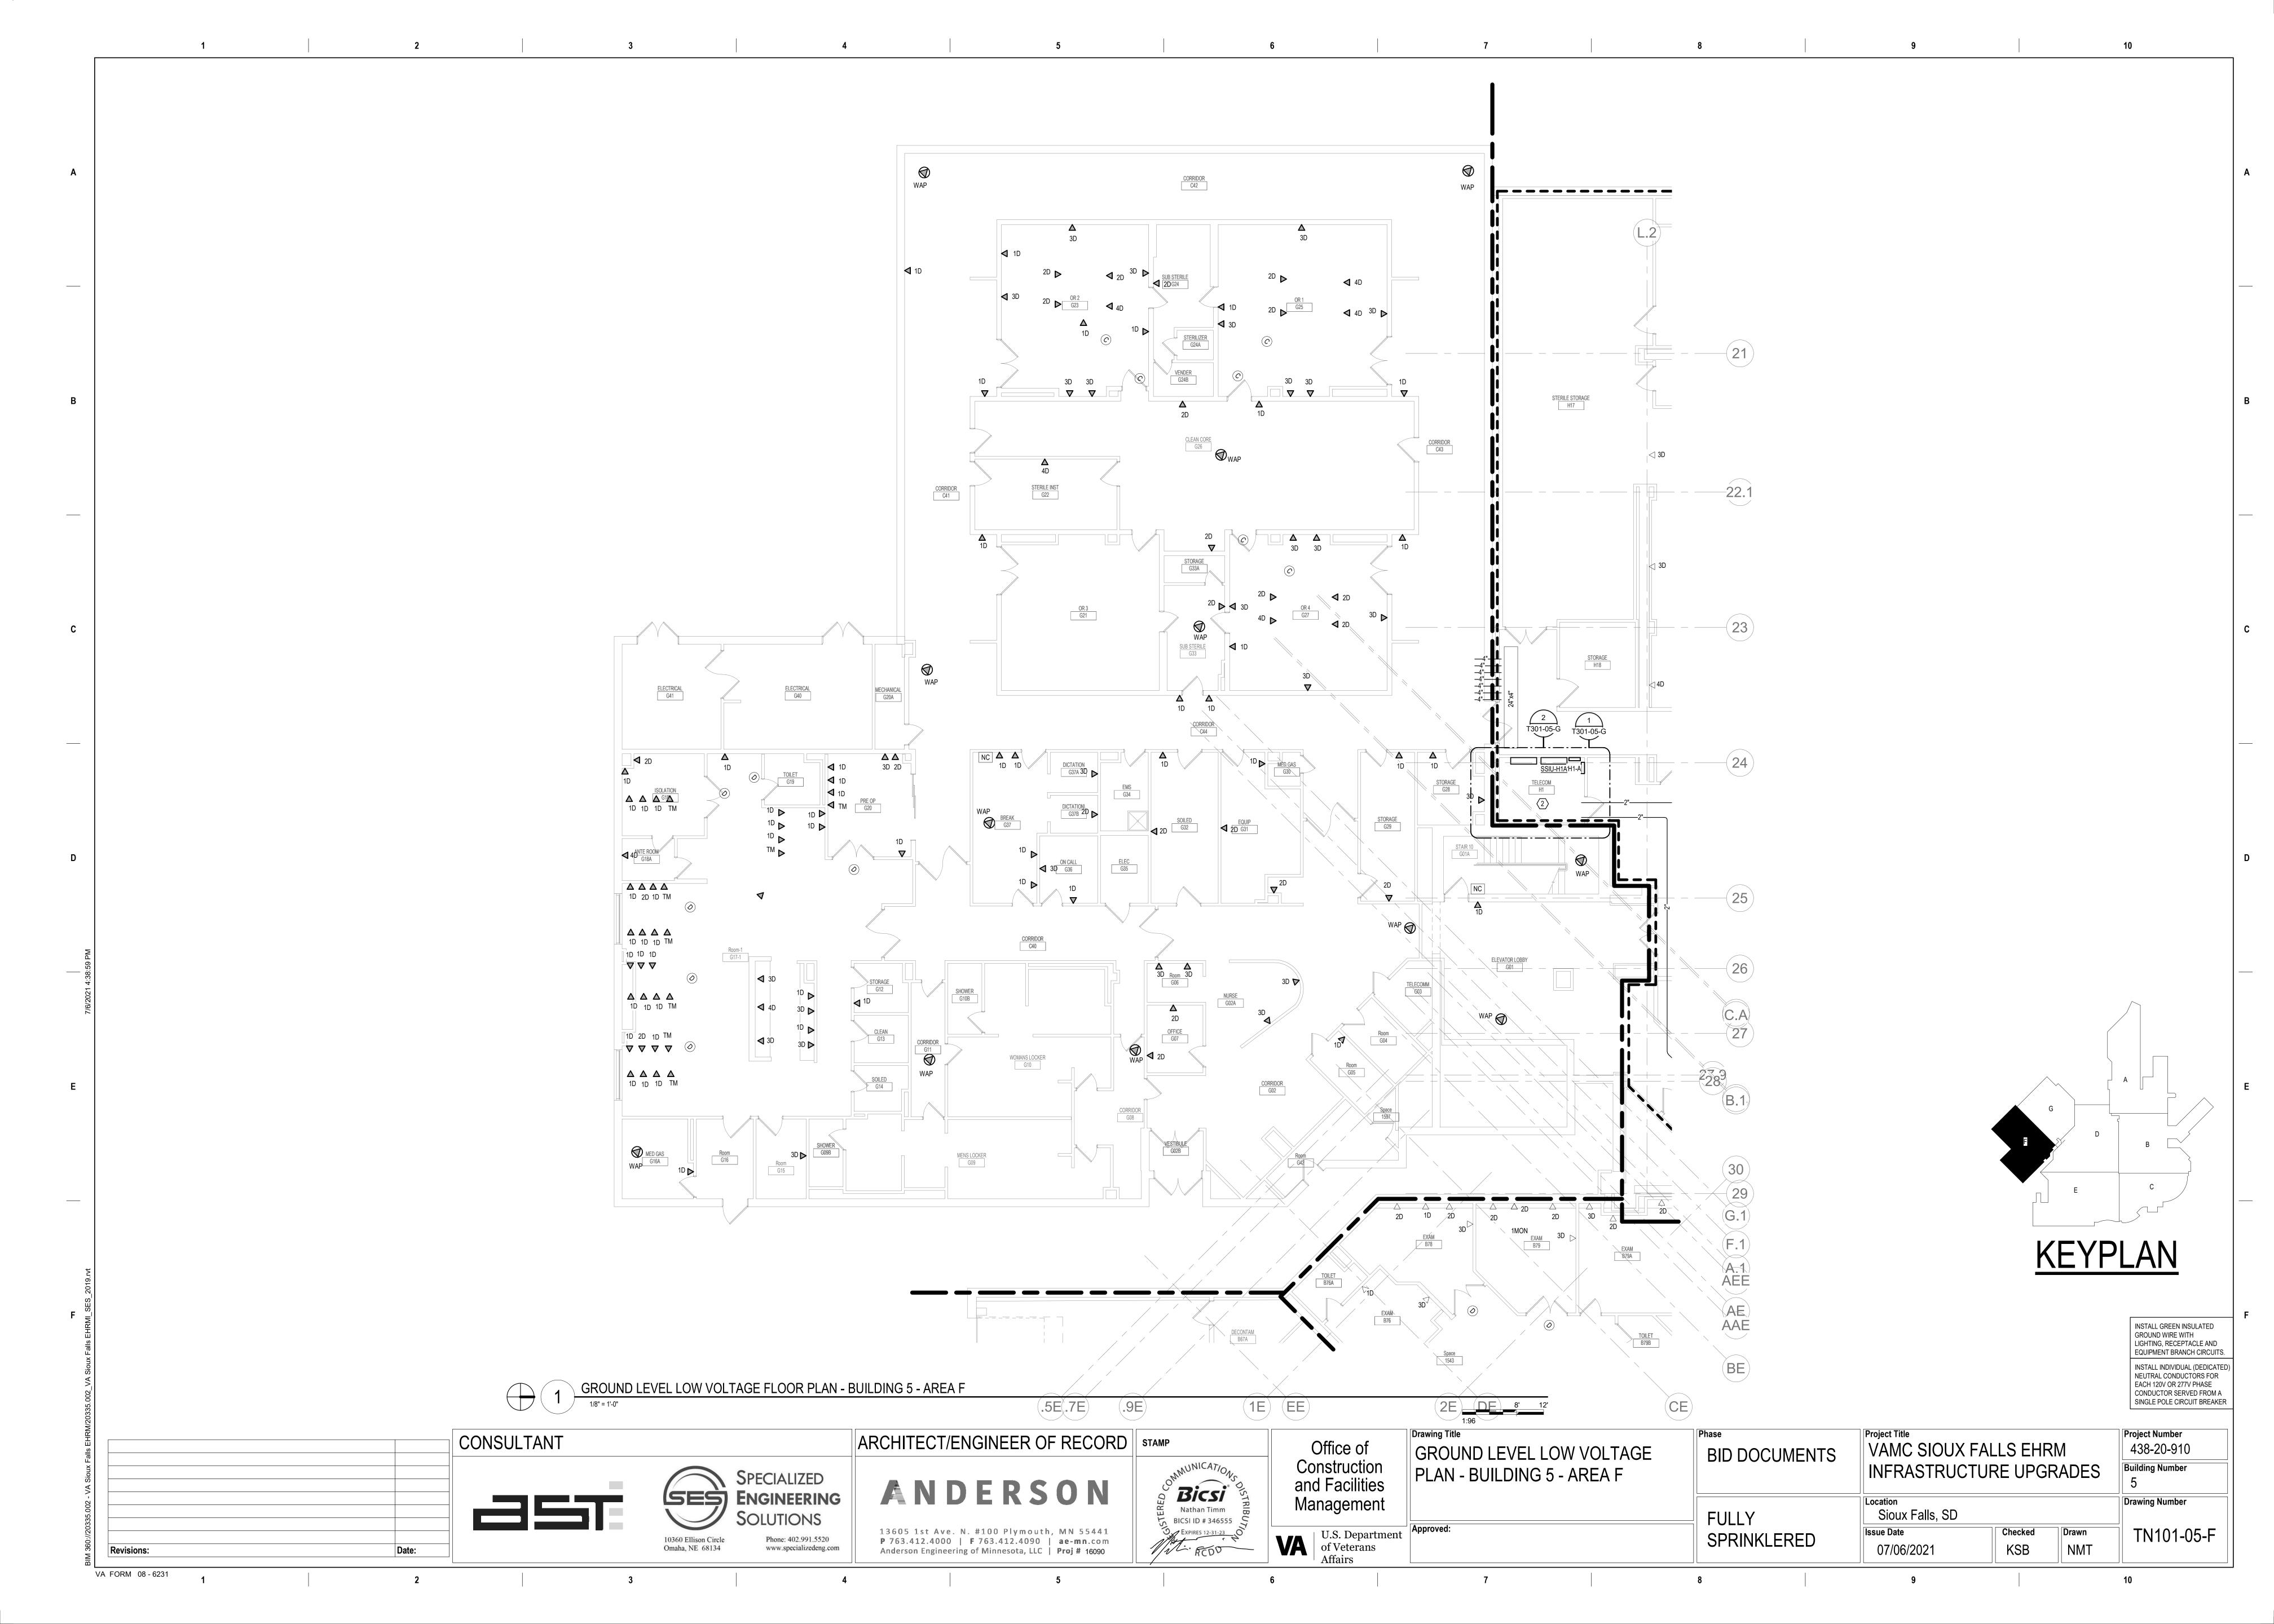

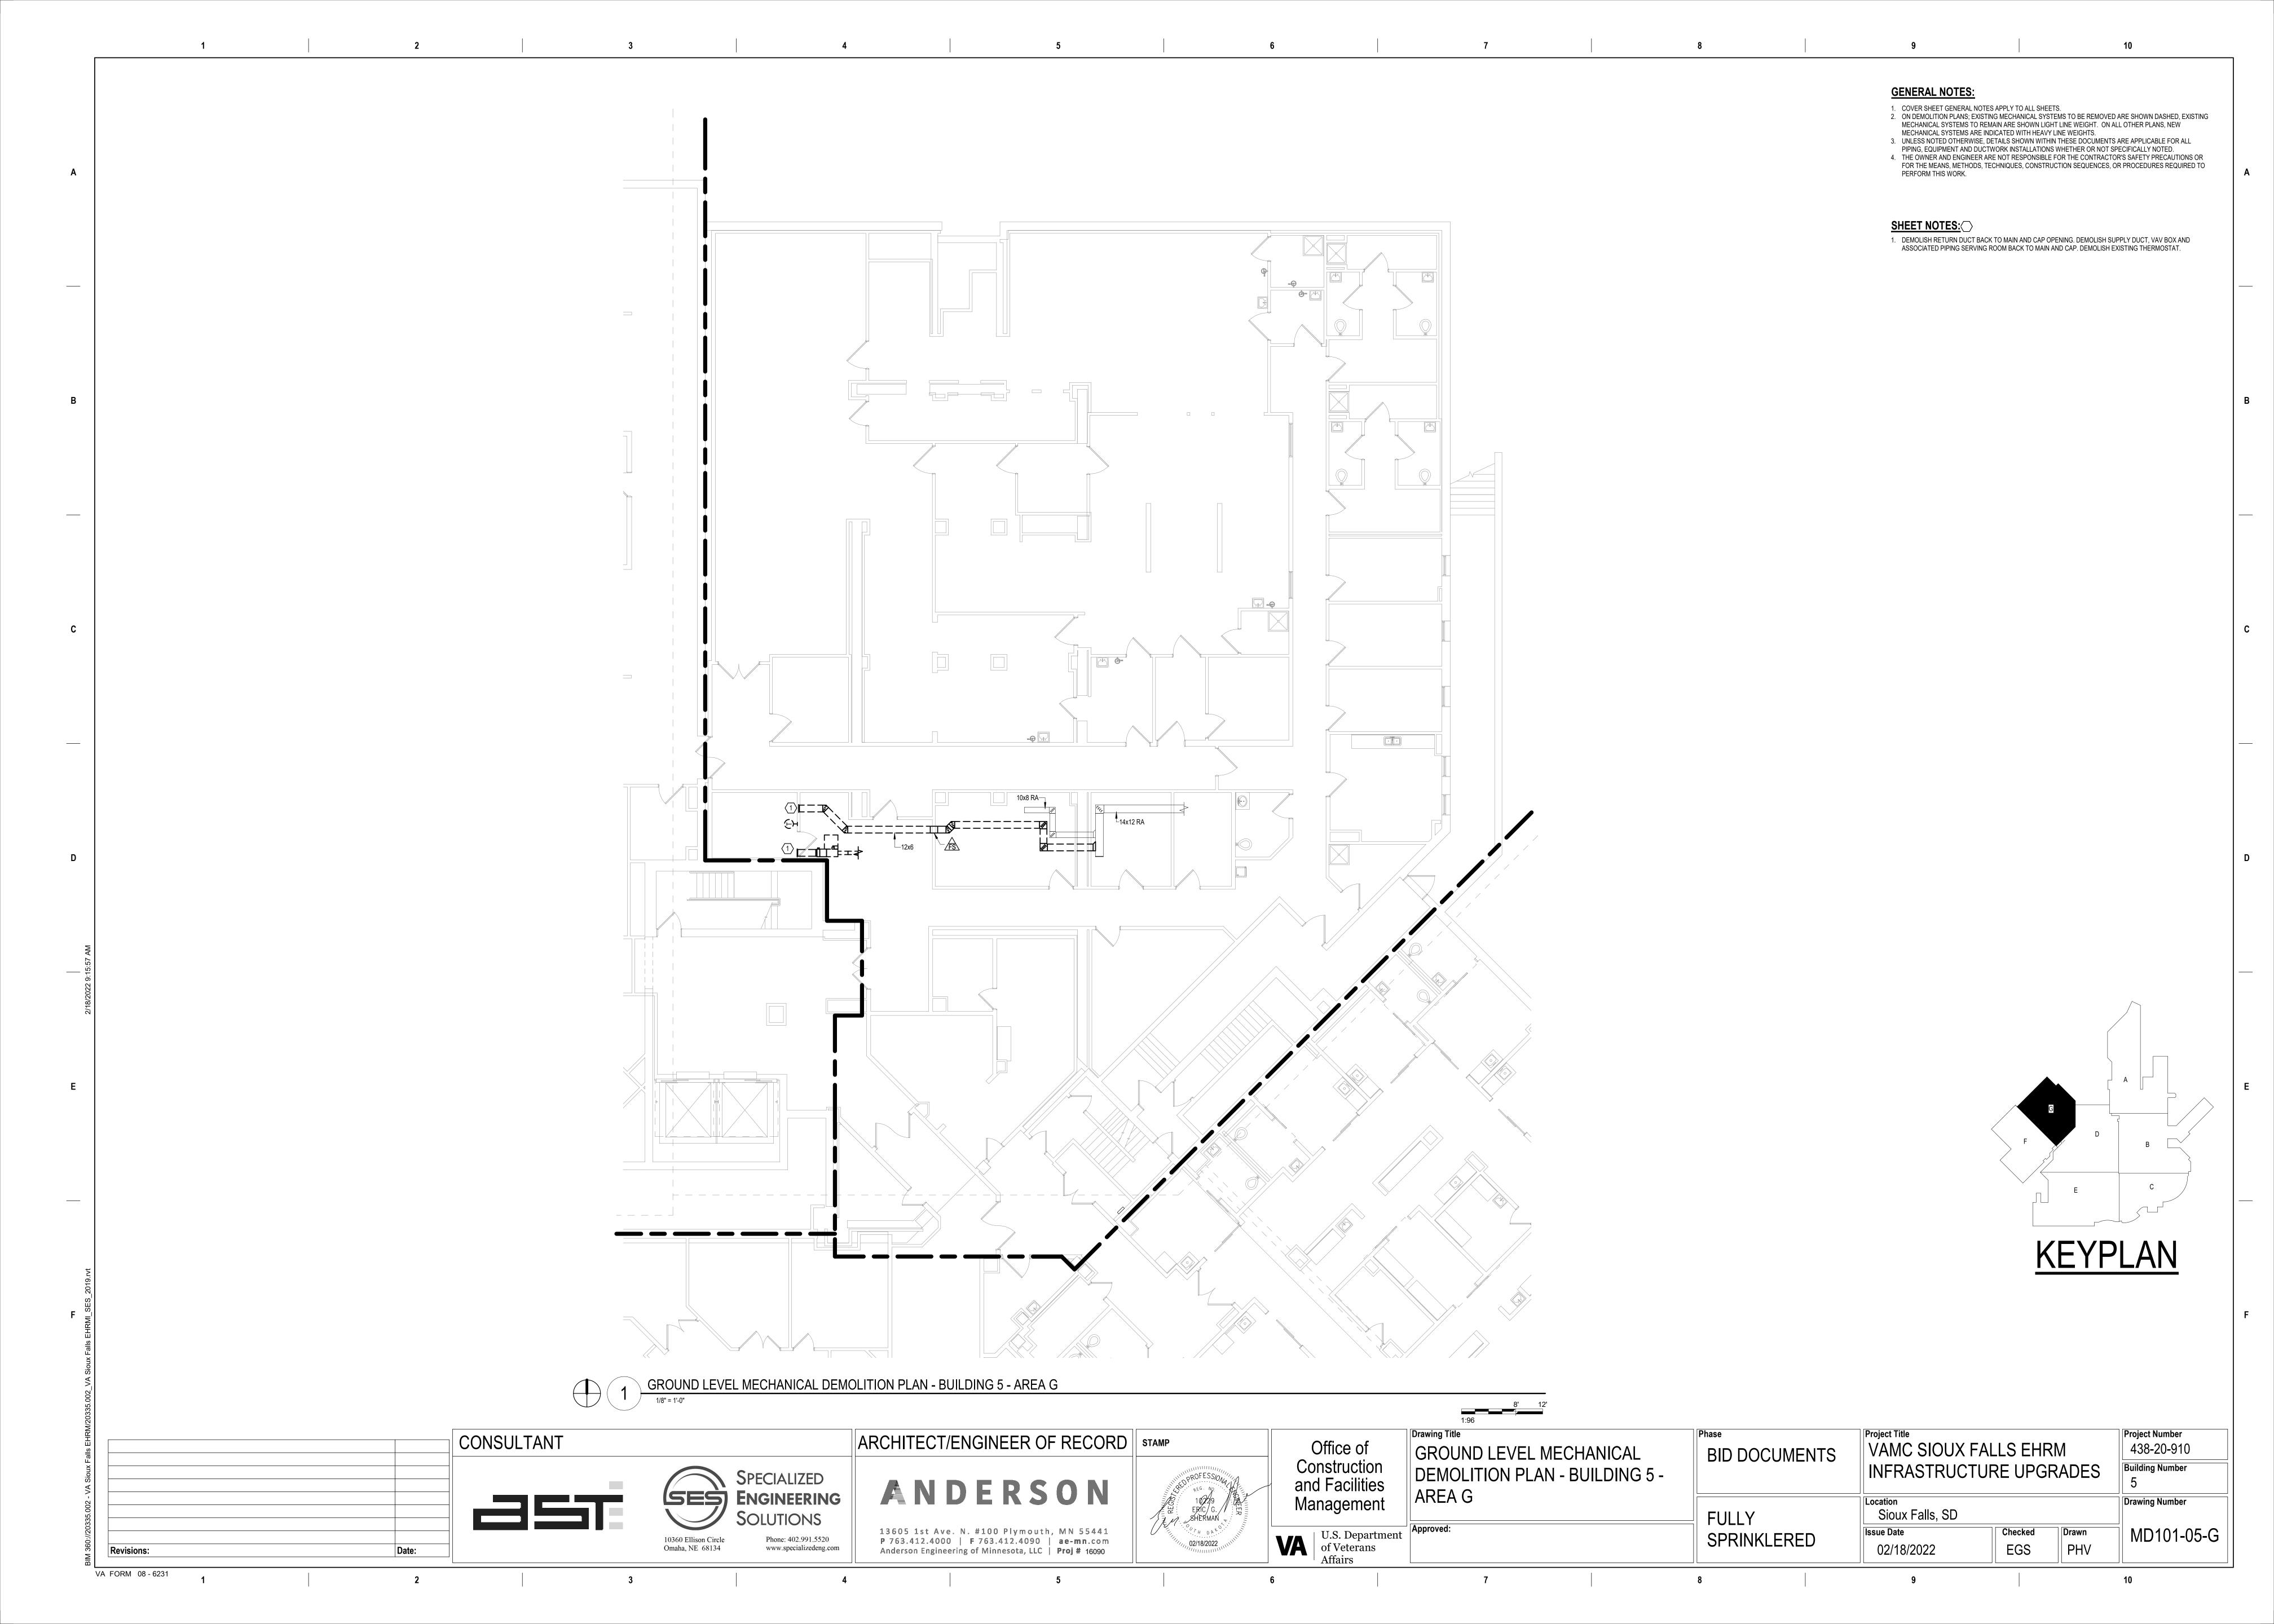

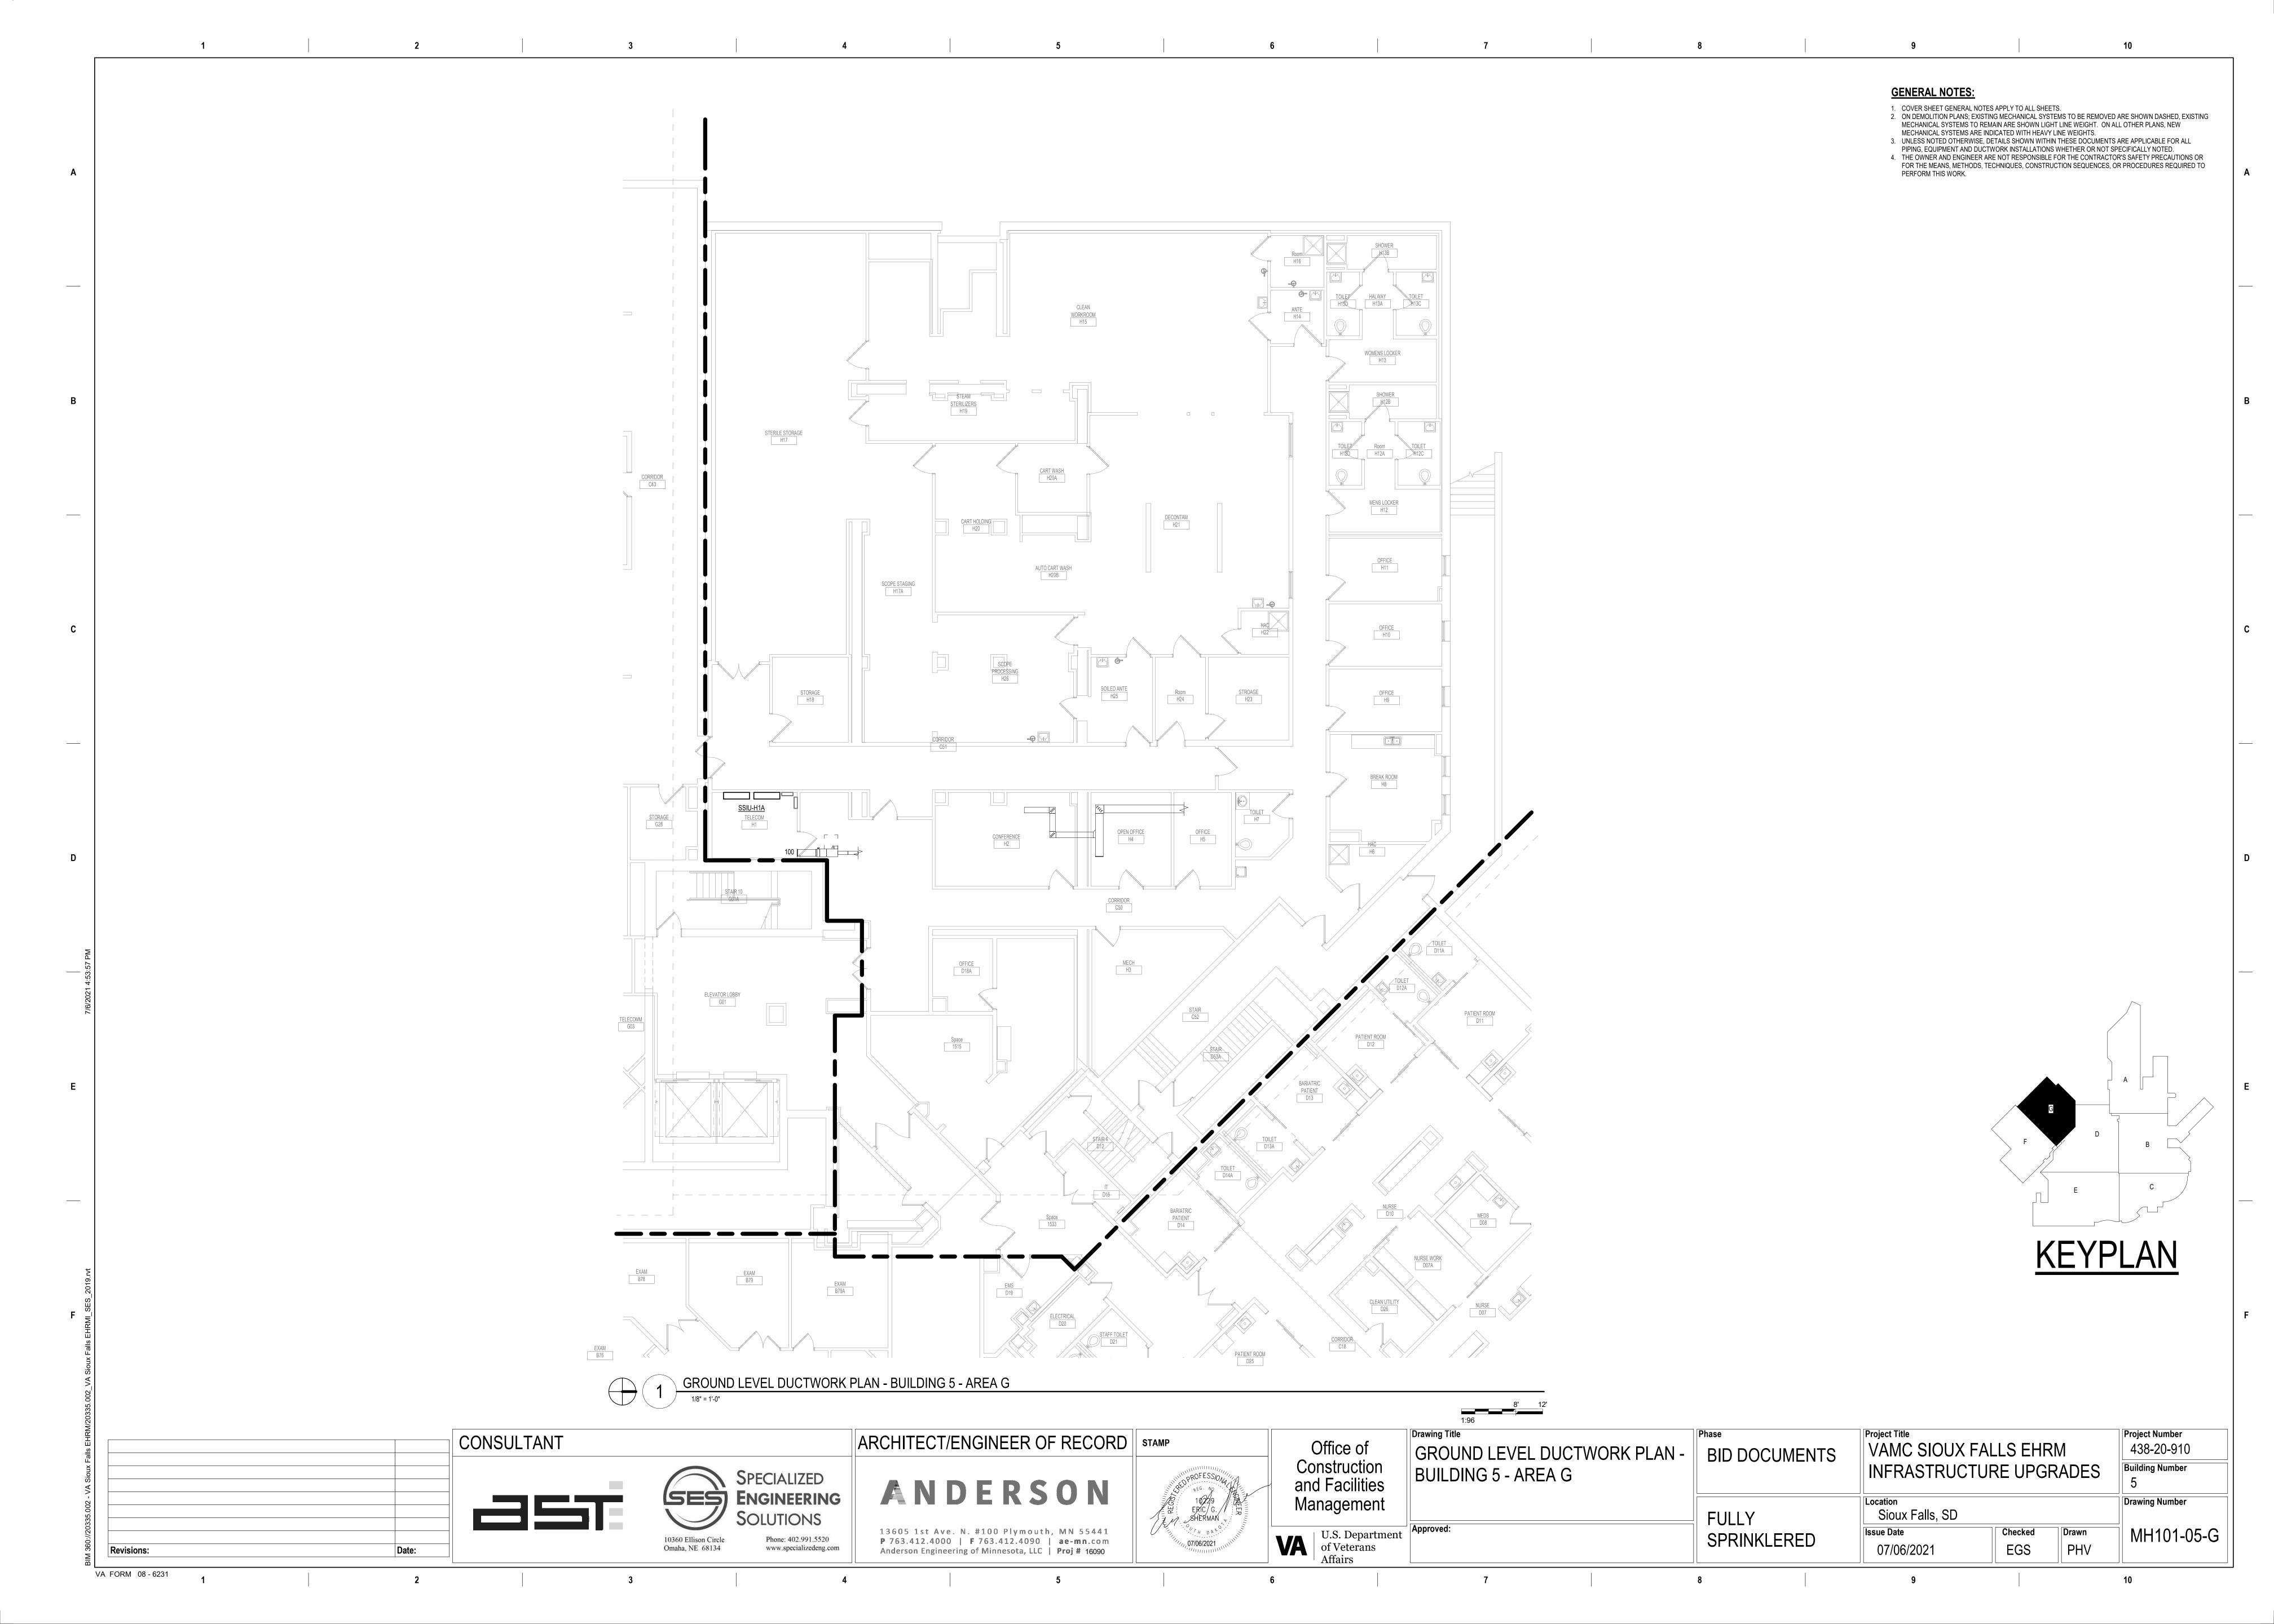

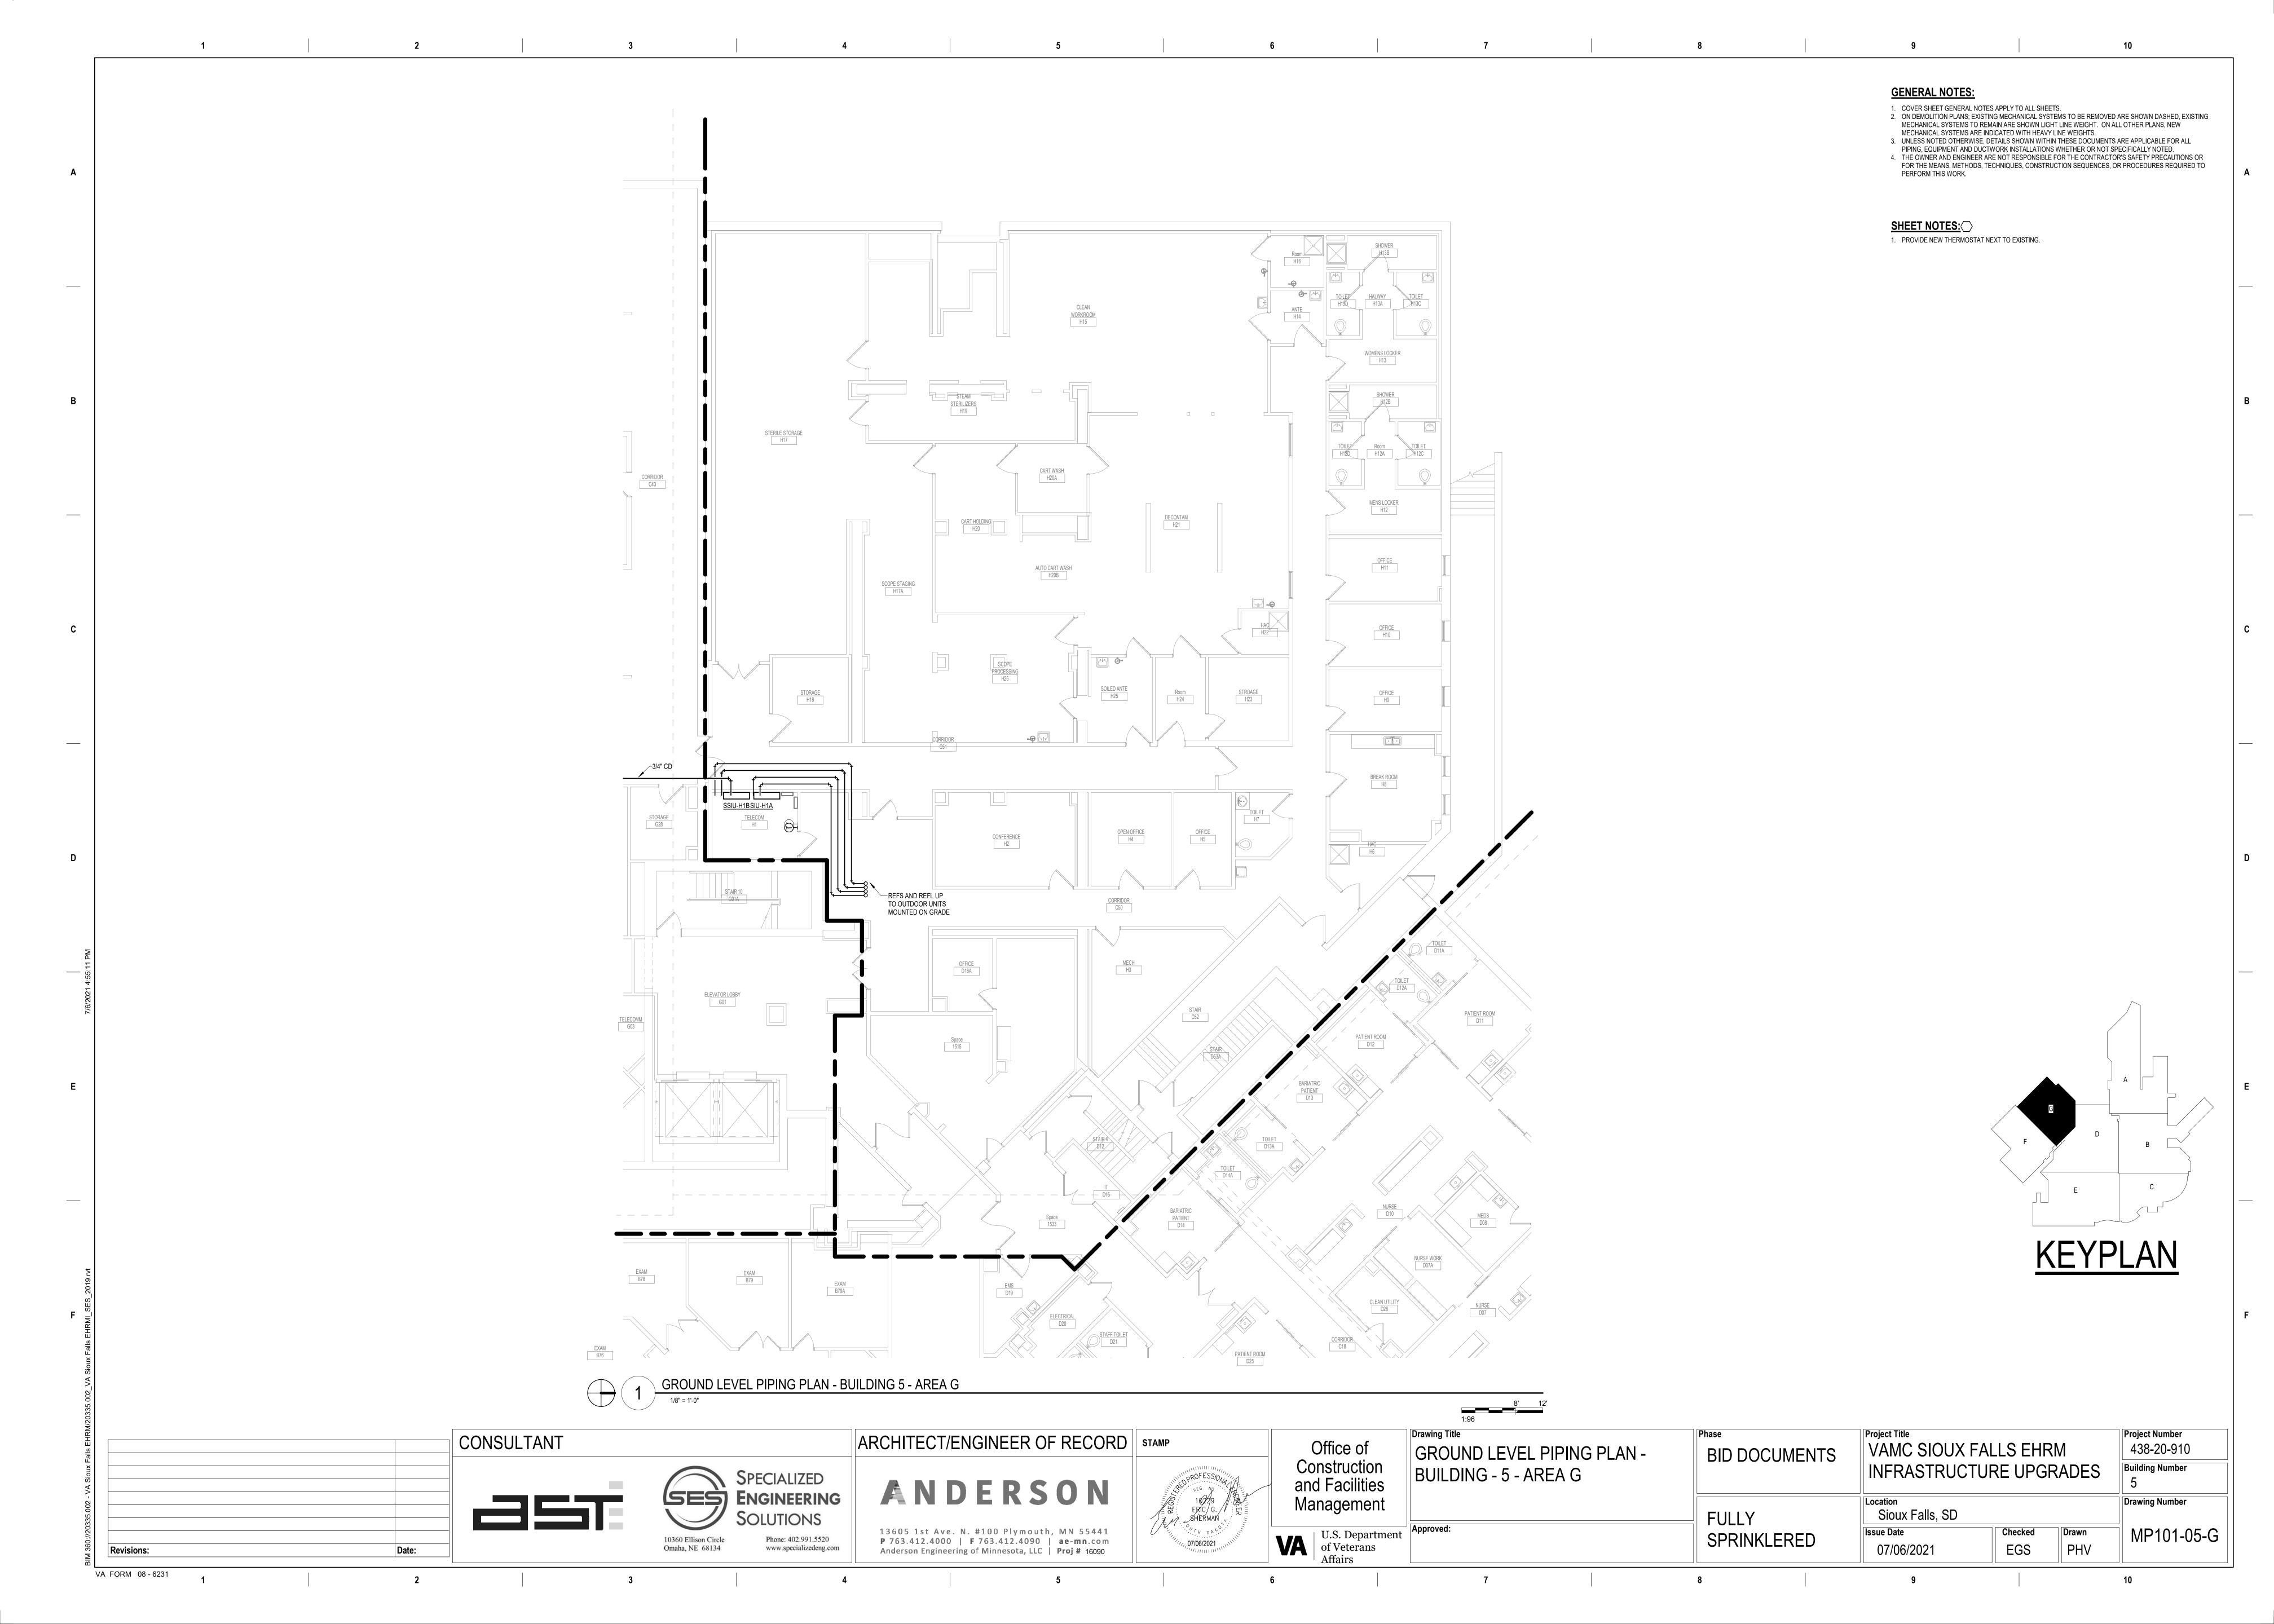

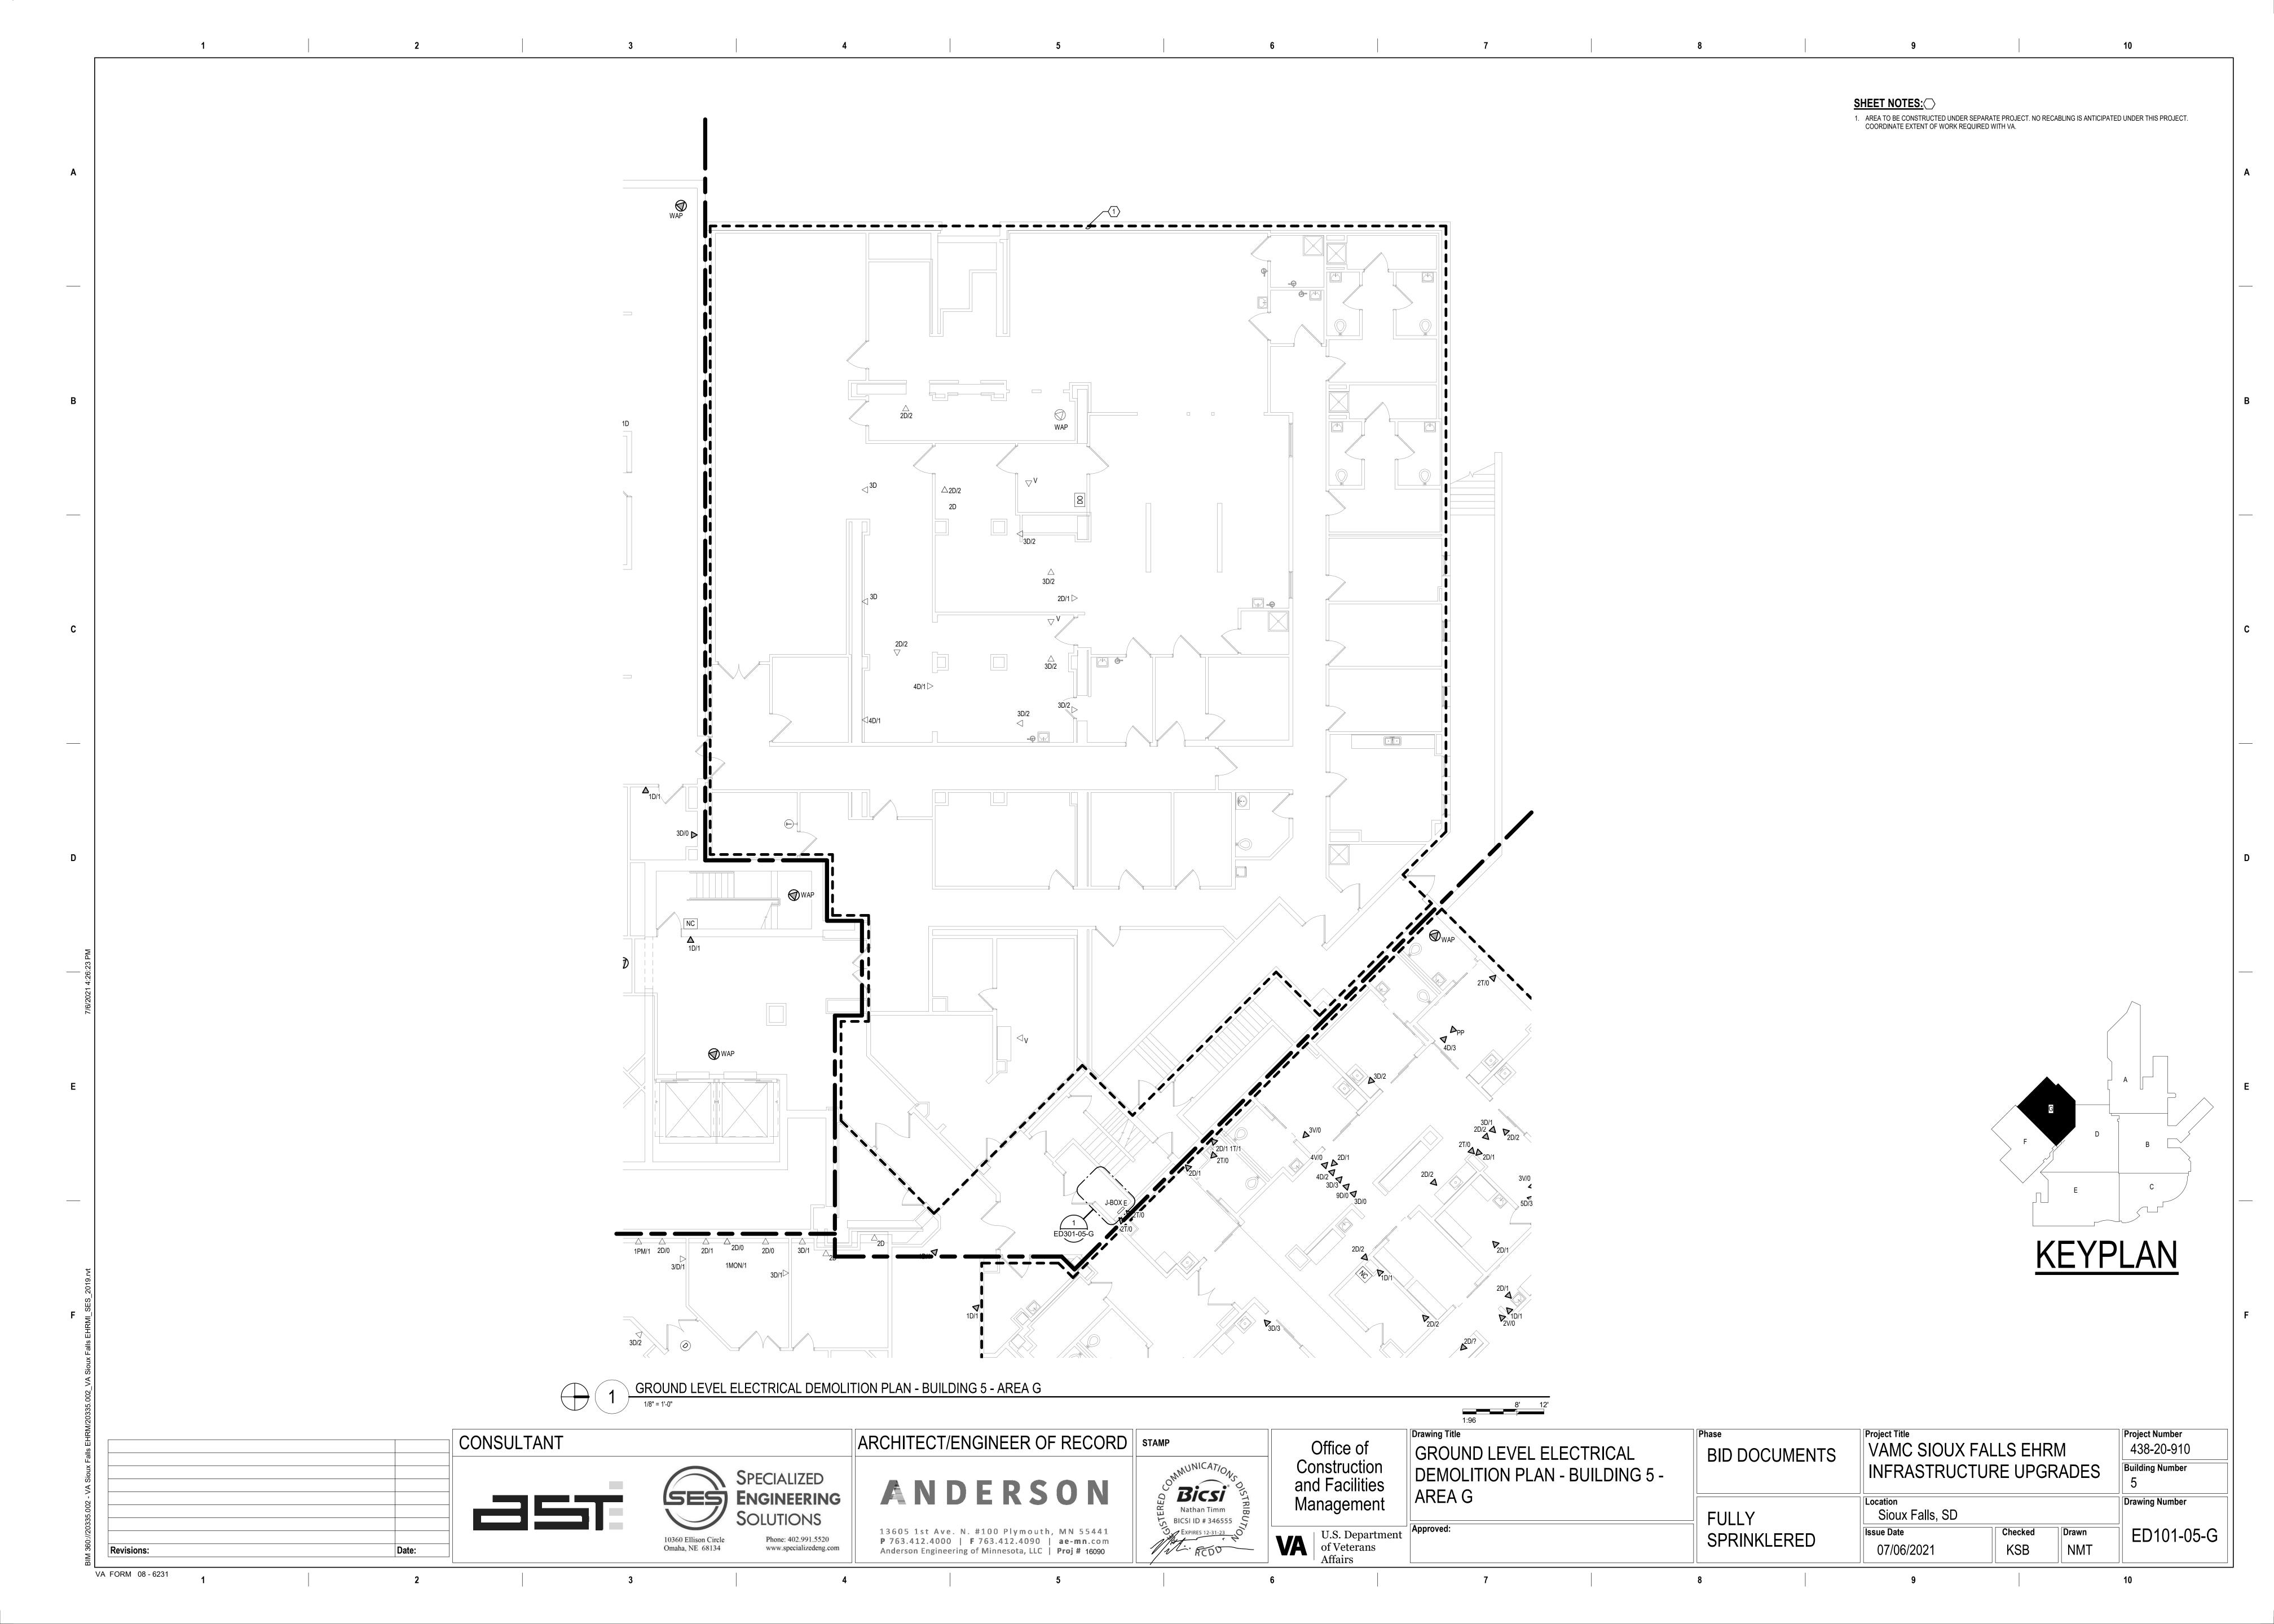

CABLING NOTES:

A. THE EXISTING CABLE COUNT ARE THE CABLES CURRENTLY PRESENT IN THE SPACE. THE CABLE RELOCATION COUNT ARE THE NEW OR RELOCATED CABLES TO BE FED FROM THE SPACE. THE FINAL CABLE COUNT ARE THE CABLES THAT WILL BE PRESENT IN THE SPACE AT THE COMPLETION OF THE PROJECT. REMOVE ALL UNUSED CABLING AT THE COMPLETION OF THE PROJECT.

1. ROOM D09

EXISTING CABLE COUNT DATA (CAT6): 34 DATA (CAT5): 48

PATIENT MONITORING: 8

COMMERCIAL WIRELESS: 0 CABLE RELOCATION COUNT DATA (CAT6): 34 TO ROOM H1

DATA (CAT5): 48 PATIENT MONITORING: -8 TO ROOM H1

COMMERCIAL WIRELESS: 0

EXISTING CABLE TO REMAIN DATA (CAT6): 0

PATIENT MONITORING: 0 COMMERCIAL WIRELESS: 0

FINAL CABLE COUNT

DATA (CAT6): 0


VIDEO: 0 PATIENT MONITORING: 0

COMMERCIAL WIRELESS: 0

SHEET NOTES:

1. EXISTING TELEPHONE WALL FIELD TO BE DEMOLISHED. NEW COPPER BACKBONE TO BE PROVIDED ON PATCH PANELS IN TELECOMMUNICATIONS RACK. REFER TO CABLING NOTES AND NEW WORK PLANS FOR ADDITIONAL

2. EXISTING FIBER ENCLOSURE TO BE DEMOLISHED. NEW FIBER BACKBONE TO BE TERMINATED IN NEW TELECOMMUNICATIONS RACK. REFER TO CABLING NOTES AND NEW WORK PLANS FOR ADDITIONAL REQUIREMENTS.

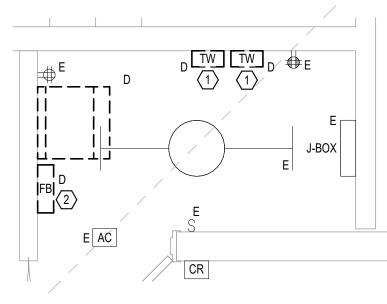

GROUND LEVEL ELECTRICAL DEMOLITION - BUILDING 5 - AREA G - ROOM D09

1/2" = 1'-0"

CONSULTANT SPECIALIZED SES ENGINEERING 10360 Ellison Circle Phone: 402.991.5520 Omaha, NE 68134 www.specializedeng.com Revisions:

VA FORM 08 - 6231

ARCHITECT/ENGINEER OF RECORD | STAMP ANDERSON 13605 1st Ave. N. #100 Plymouth, MN 55441

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Bicsi 5 BICSI ID # 346555 EXPIRES 12-31-23 NOT

Office of Construction and Facilities Management U.S. Department of Veterans Affairs

Drawing Title

GROUND LEVEL ELECTRICAL DEMOLITION - BUILDING 5 -ENLARGED ROOMS - AREA G

Project Title VAMC SIOUX FALLS EHRM **BID DOCUMENTS** INFRASTRUCTURE UPGRADES **FULLY**


Sioux Falls, SD Checked SPRINKLERED 07/06/2021


Drawn ED301-05-G KSB NMT

Project Number

Building Number

Drawing Number

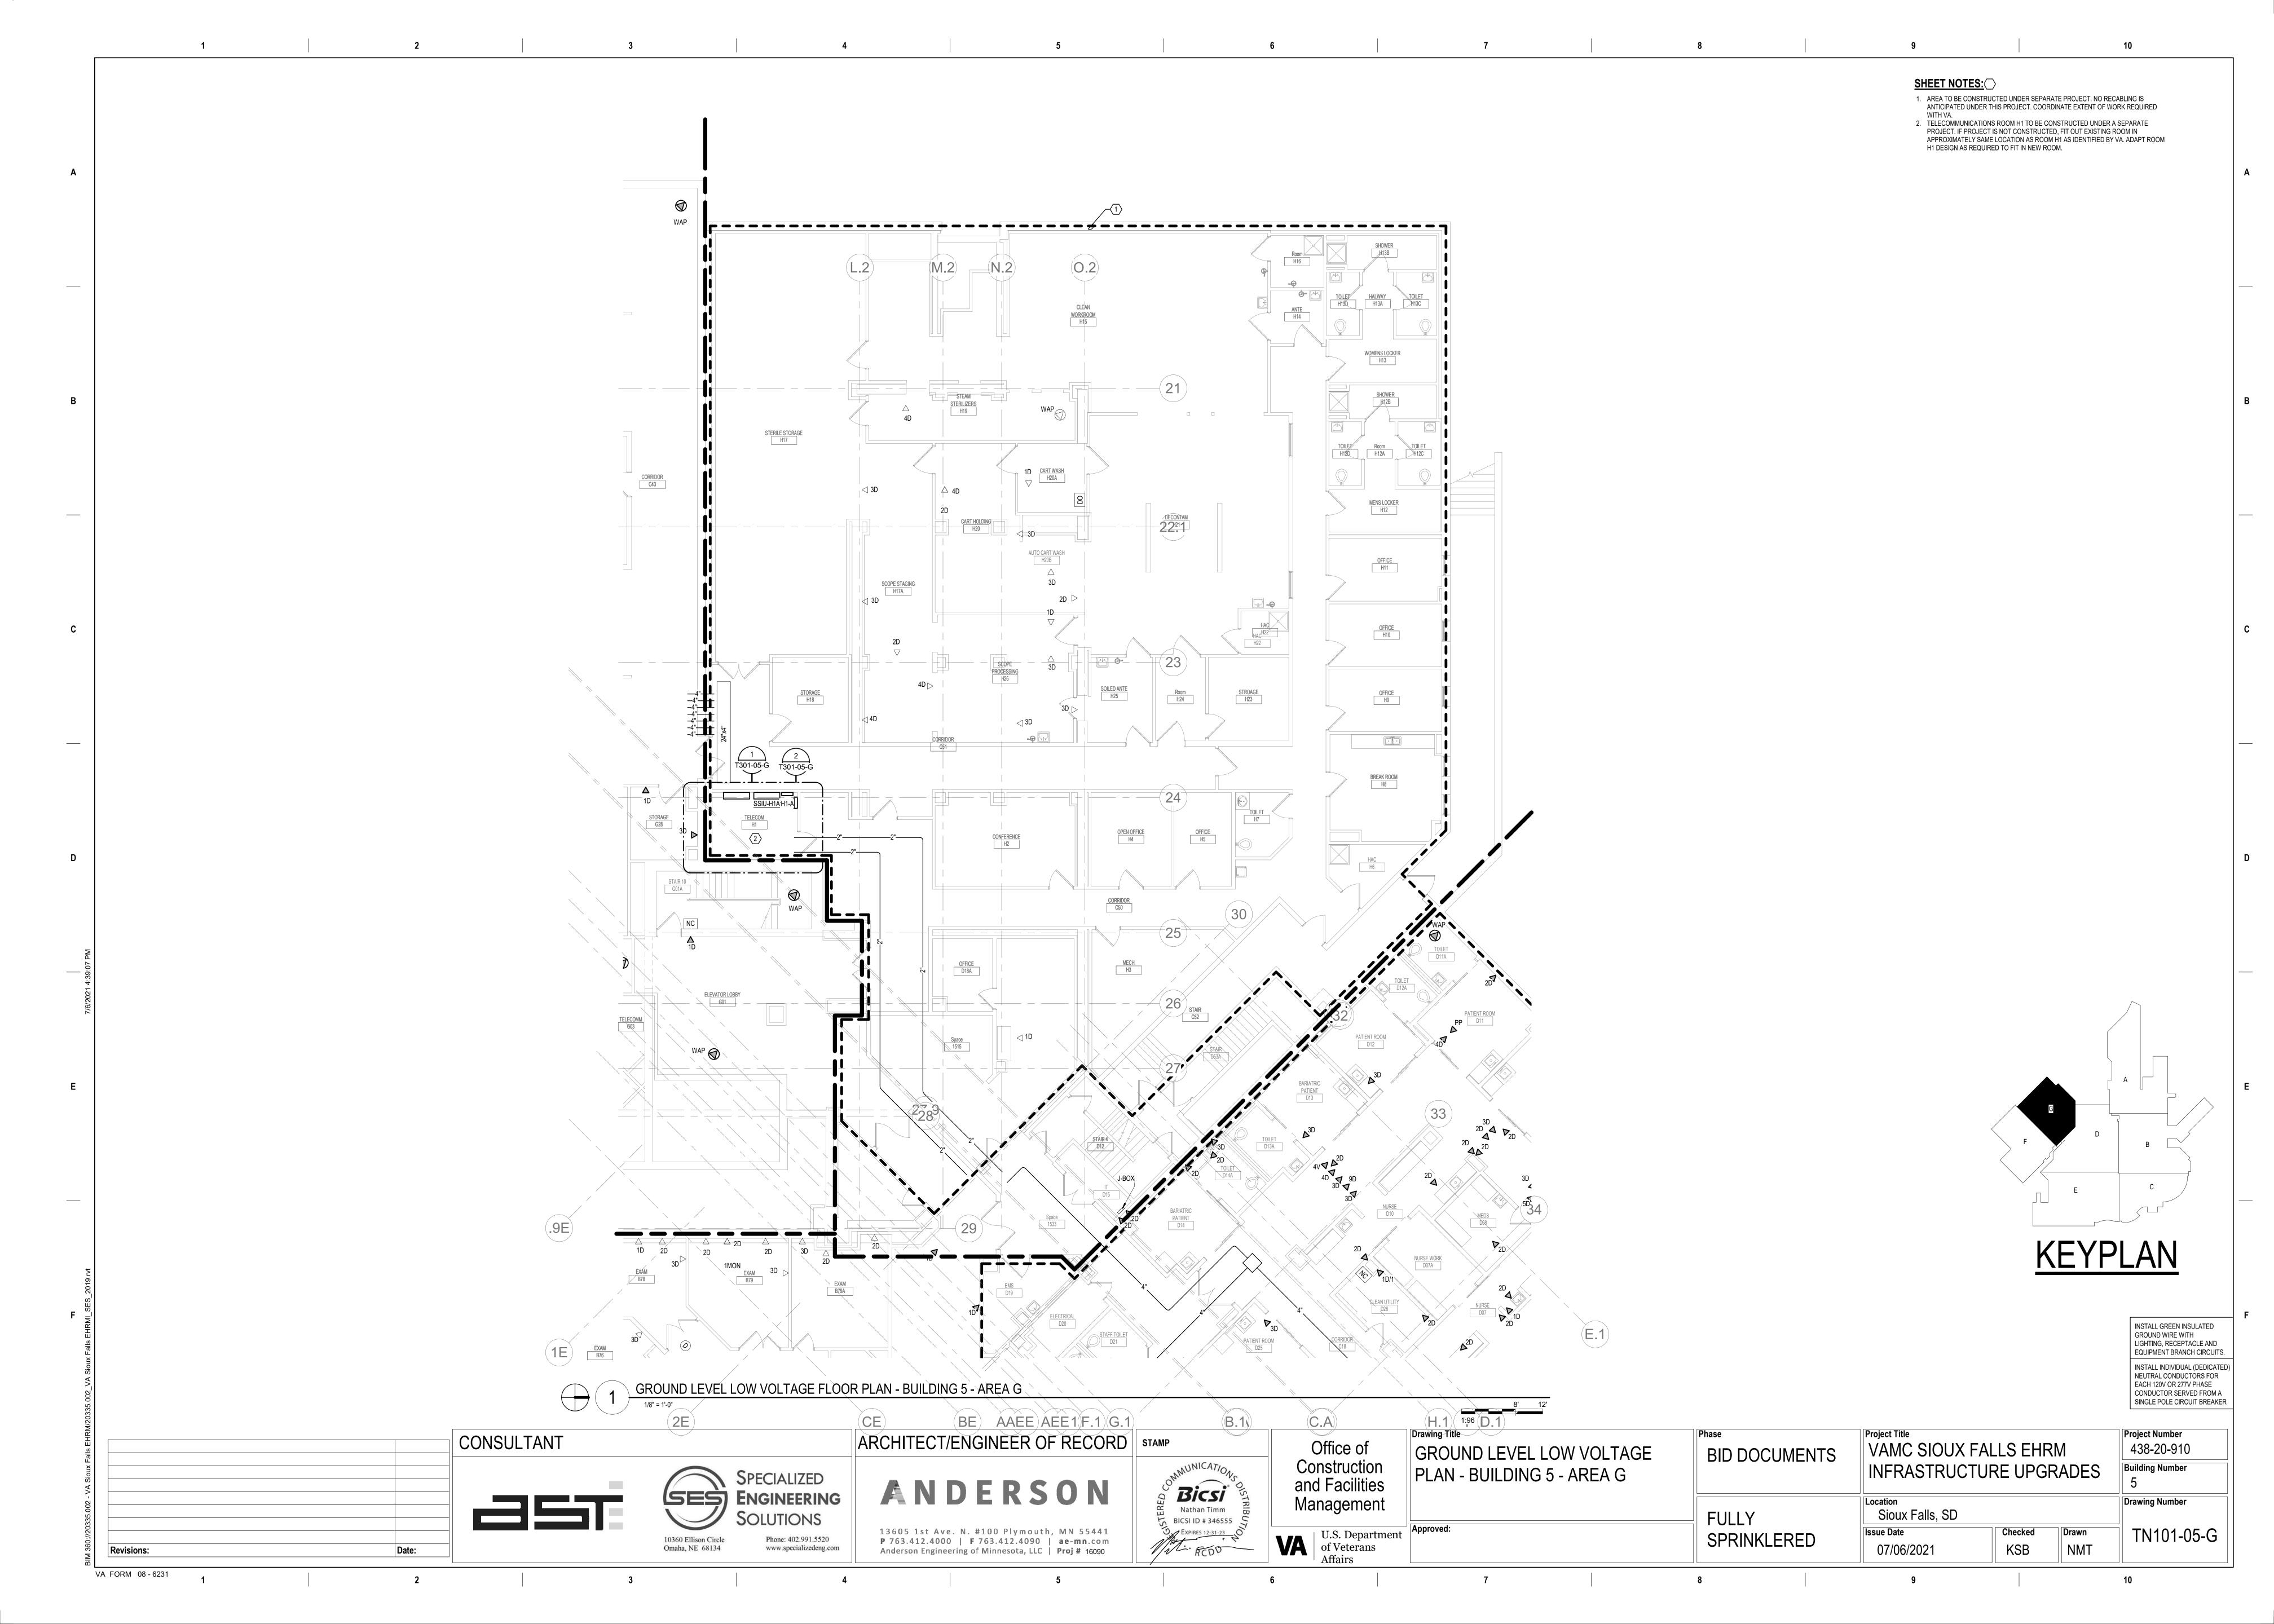

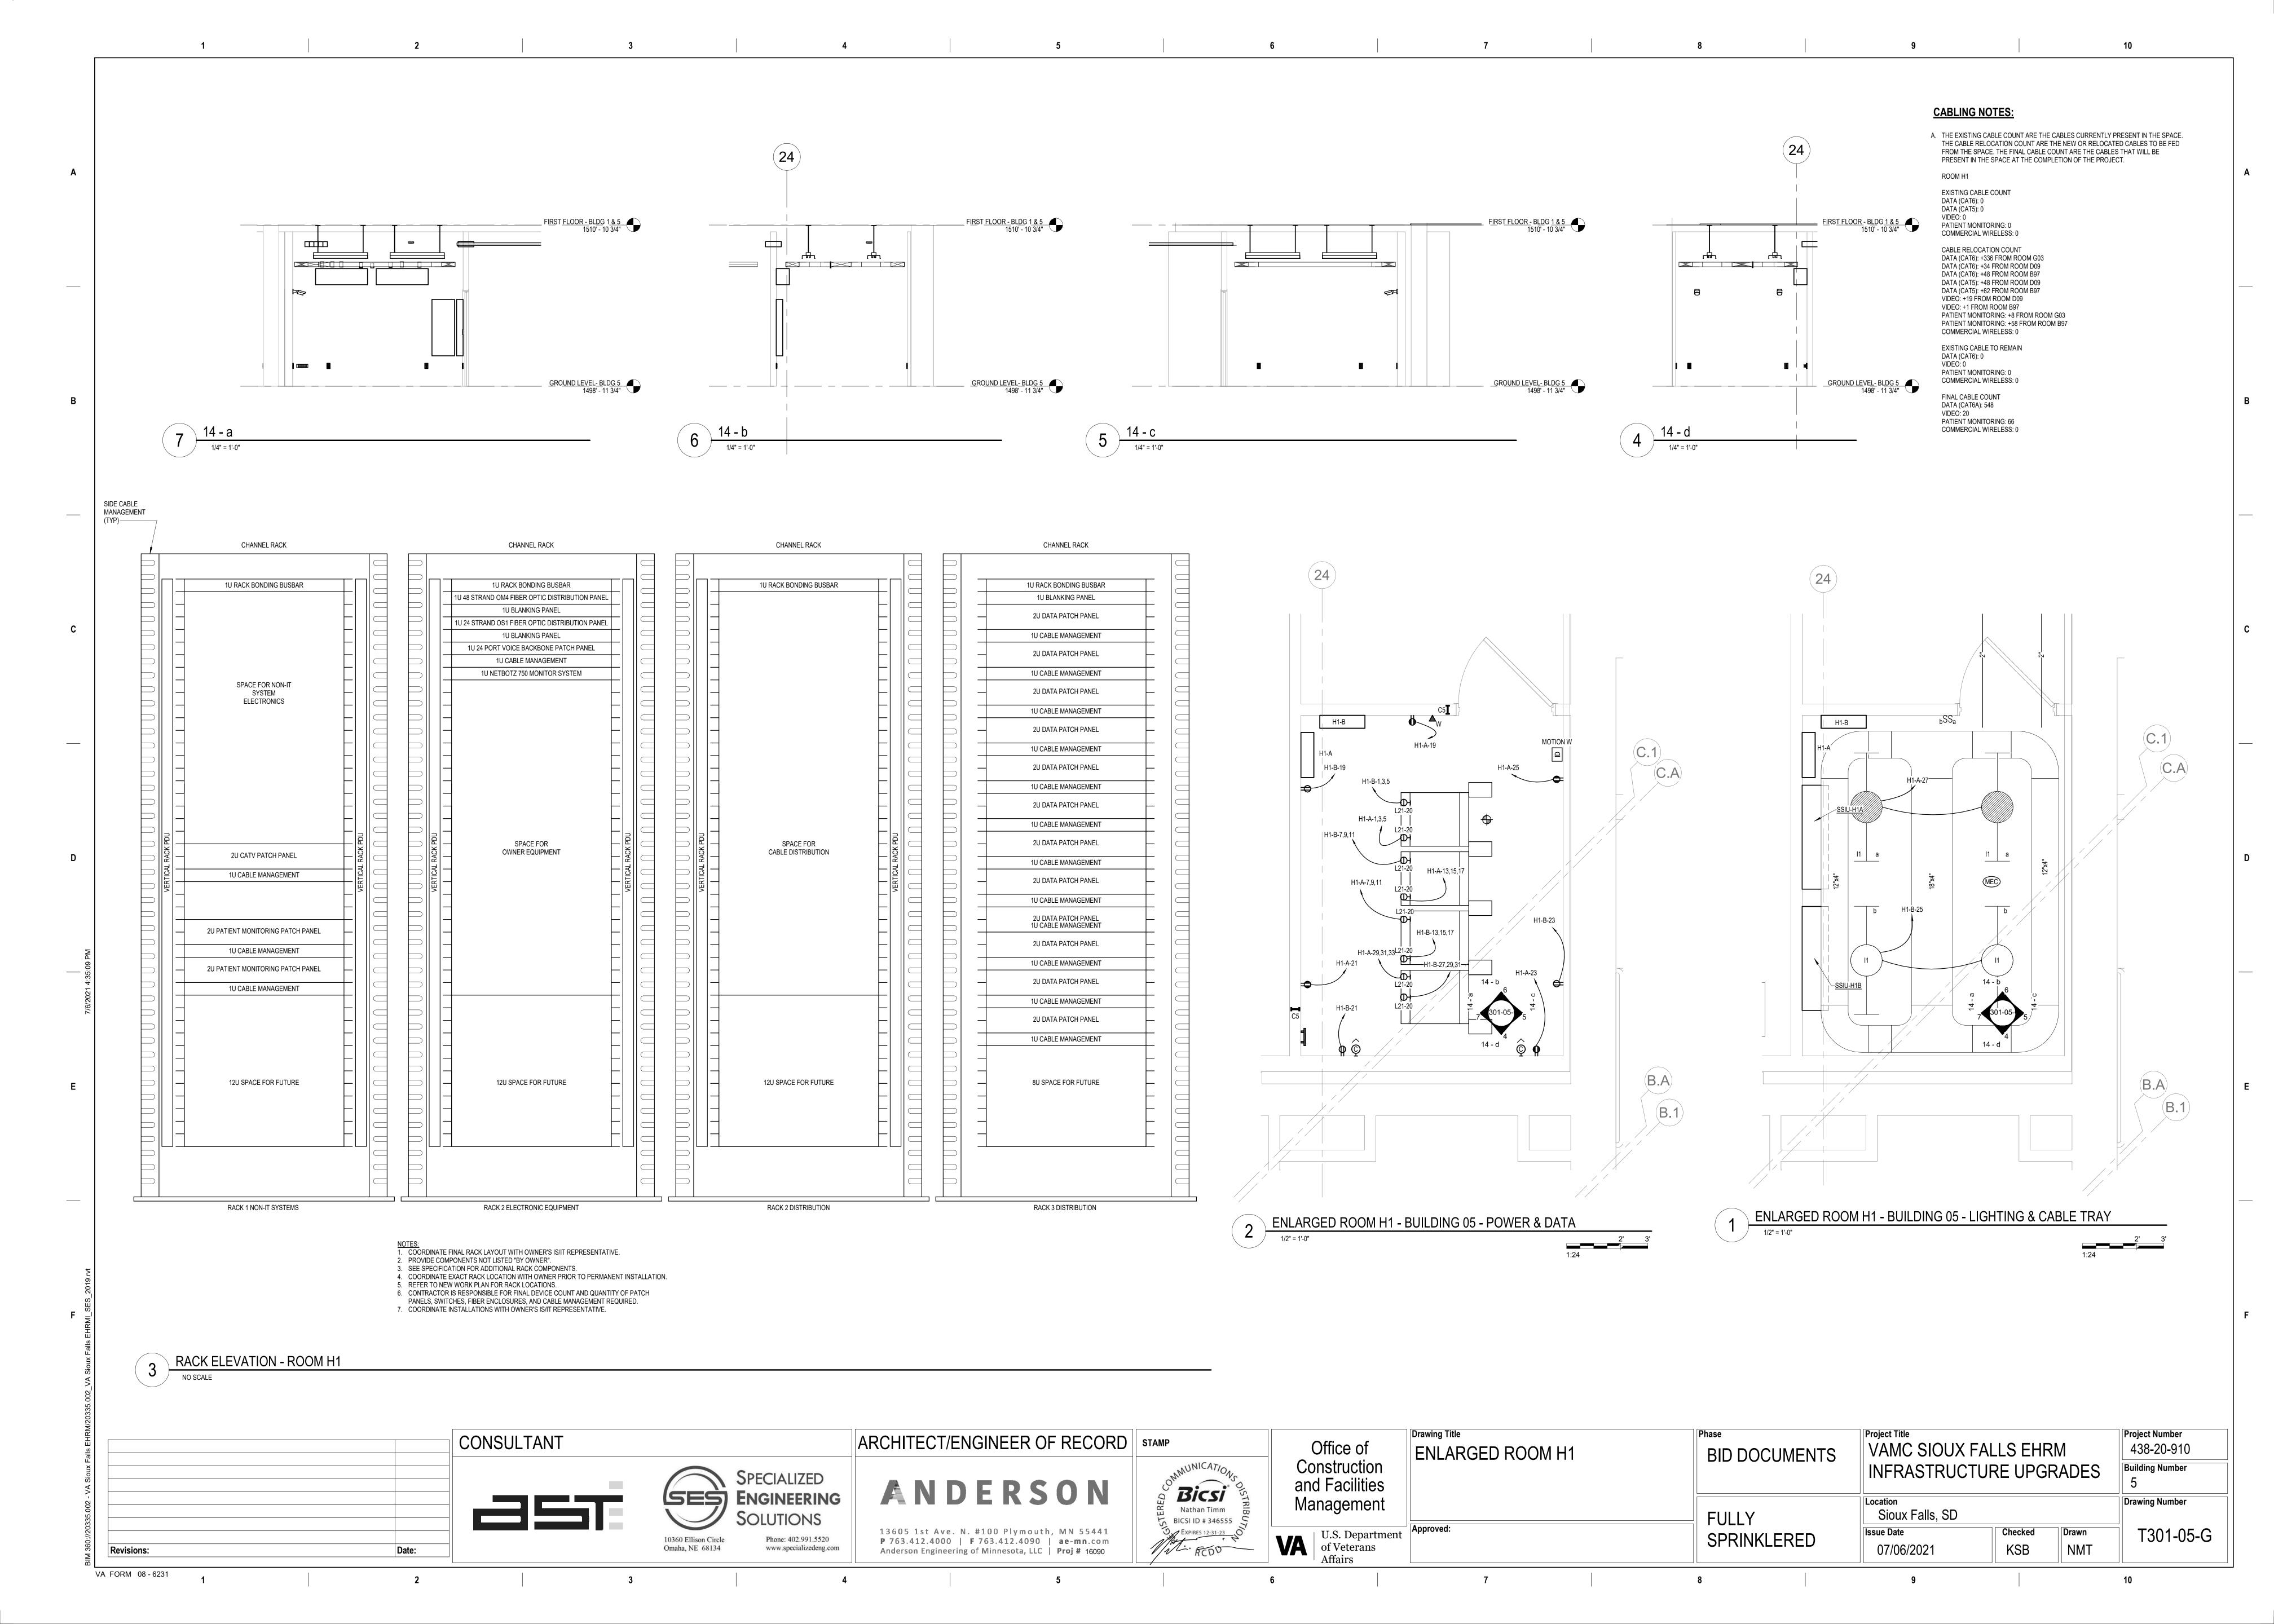

LIGHTING PANEL: H1-B MAINS TYPE: MCB **LOCATION:** TELECOM H1 **VOLTS:** 208/120 WYE SUPPLY FROM: B1 PHASES: 3 MCB/MLO RATING: 100 A **BRANCH: NORMAL** WIRES: 4 MCB OPTIONS: NONE SERVICE RATED: No INTEGRAL SPD: Yes SECTIONS: 1 **PANEL POLES**: 42 **MOUNTING:** SURFACE AVAILABLE SCC (kA): 2.1 **NEMA ENCLOSURE**: 1 CIRCUIT DESCRIPTION OPT RATI... POL... A B C POL... RATI... OPT CIRCUIT DESCRIPTION 1922... 0 VA 1922 VA 0 VA 1 20 A -- SPARE PWR-C TELECOM H1 - RACK 1 20 A -- SPARE RECEPTACLE 1922 VA 1195... 2 25 A SSIU-H1B/SSOU-H1B 1922... 1195 VA 1922 VA PWR-C TELECOM H1 - RACK 20 A 3 RECEPTACLE 1922 VA PWR-C TELECOM H1 - RACK 20 A 3 RECEPTACLE 19 REC TELECOM H1 20 A 1 180 VA 20 A 1 21 REC TELECOM H1 180 VA 23 REC TELECOM H1 20 A 1 20 A 1 50 VA 25 LTG TELECOM H1 1922 VA PWR-C TELECOM H1 - RACK 20 A 3 RECEPTACLE -- 20 A 1 -- 20 A 1 35 SPARE 0 VA 39 SPARE -- 20 A 3 0 VA **TOTAL LOAD:** 9111 VA 7867 VA 9062 VA TOTAL AMPS: 77 A LOAD CLASSIFICATION CONNECTED LOAD DEMAND FACTOR ESTIMATED DEMAND PANEL TOTALS 125.00% CONNECTED LOAD: 26040 VA 50 VA 62 VA CONNECTED CURRENT: 72 A 2390 VA 124.22% 2969 VA **DEMAND LOAD:** 20101 VA **DEMAND CURRENT**: 56 A 23060 VA 71.68% 16530 VA **CONSIDER 125% DEMAND:** 25126 A EQUIPMENT AMPS: 100 A FEEDER AVAILABLE: SPARE CAPACITY: 44 | 44 A CIRCUIT BREAKER OPTIONS SUFFIX: 'S' OR 'ST' - PROVIDE SHUNT TRIP CIRCUIT BREAKER / 'G' OR 'GFCI' - PROVIDE GFCI CIRCUIT BREAKER / 'GFP' - PROVIDE GFP CIRCUIT BREAKER / 'ERMS' - ENERGY REDUCING MAINTENANCE SWITCH / 'ZSI' - ZONE SELECTIVE INTERLOCKING / 'L' - PROVIDE CIRCUIT BREAKER WITH LOCKING PROVISIONS / 'R' - PROVIDE CIRCUIT BREAKER WITH RED MARKING A. PANEL AIC (INTERRUPTING) RATING SHALL BE MINIMUM 120% OF THE AVAILABLE SCC (SHORT CIRCUIT CURRENT).

LOCATION: TELECOM H1 SUPPLY FROM: A1 BRANCH: CRITICAL SERVICE RATED: No MOUNTING: SURFACE NEMA ENCLOSURE: 1					AVA		VOLTS PHASES WIRES RAL SPD SCC (kA)	: 3 : 4 : Yes	20 WYE		MAINS TYPE: MCB MCB/MLO RATING: 100 A MCB OPTIONS: NONE SECTIONS: 1 PANEL POLES: 42							
C	CIRCUIT DESCRIPTION	ОРТ	RATI	POL		A	Е	3	С	<u> </u>	POL	RATI	OPT	CIRC	UIT DESCRIPTION	C		
1 3 5	PWR-C TELECOM H1 - RACK RECEPTACLE		20 A	3	1922	0 VA	1922 VA	0 VA	1922 VA	0 VA	3	20 A		SPARE				
7	PWR-C TELECOM H1 - RACK RECEPTACLE		20 A	3	1922	1195 VA	1922 VA	1195 V <i>A</i>	Λ.		2	25 A		SSIU-H1A/S	SOU-H1A	1		
11	PWR-C TELECOM H1 - RACK		20.4	2	1922		1022.1/4		1922 VA							1		
15 17	RECEPTACLE REC TELECOM H1		20 A 20 A	3	180 VA		1922 VA		1922 VA							1 2		
21	REC TELECOM H1 REC TELECOM H1		20 A 20 A 20 A	1 1	100 VA		180 VA		180 VA							2		
25	REC TELECOM H1 LTG TELECOM H1		20 A 20 A	1 1	180 VA		50 VA									2		
29 31 33	PWR-C TELECOM H1 - RACK RECEPTACLE		20 A	3	1922		1922 VA		1922 VA							3		
35	SPARE SPARE		20 A 20 A	1	0 VA				0 VA							3		
	SPARE SPARE		20 A 20 A	1			0 VA		0 VA							4		
LOA LTG	D CLASSIFICATION		TOTAL	AMPS:	79 FED LOA	2 VA 9 A D DEM	9111 78 1AND FAC 125.00%	A CTOR	7867 66 ESTIMATE	A	IAND	C	ONNE	PANEL CTED LOAD:	TOTALS 26220 VA			
REC MTR PWF				720 2390 2306) VA		100.00% 124.22% 71.68%		296	0 VA 69 VA 30 VA		D	DEN EMANI	CURRENT: MAND LOAD: CURRENT:	20281 VA 56 A			
												CONSIDER 125% DEMAN EQUIPMENT AMP FEEDER AVAILABL						
													SPARE	CAPACITY:	43 % 44 A			
CIR(IONS: CUIT BREAKER OPTIONS SUFFIX: 'S CUIT BREAKER / 'ERMS' - ENERGY R OVISIONS / 'R' - PROVIDE CIRCUIT	EDUCIN	G MAINT	TENAN(CE SWIT													
	ERAL REMARKS:																	

CONSULTANT SPECIALIZED SES ENGINEERING Phone: 402.991.5520 10360 Ellison Circle www.specializedeng.com Omaha, NE 68134 Revisions:

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ANDERSON

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Anderson Engineering of Minnesota, LLC | Proj # 16090

ARCHITECT/ENGINEER OF RECORD | STAMP

Office of Construction and Facilities Management

Drawing Title PANEL SCHEDULES - BUILDING 5 -GROUND LEVEL - AREA G

Project Title **BID DOCUMENTS** Location **FULLY**

VAMC SIOUX FALLS EHRM 438-20-910 **Building Number** INFRASTRUCTURE UPGRADES Drawing Number Sioux Falls, SD Checked EE401-05-G Drawn 07/06/2021


U.S. Department of Veterans Affairs


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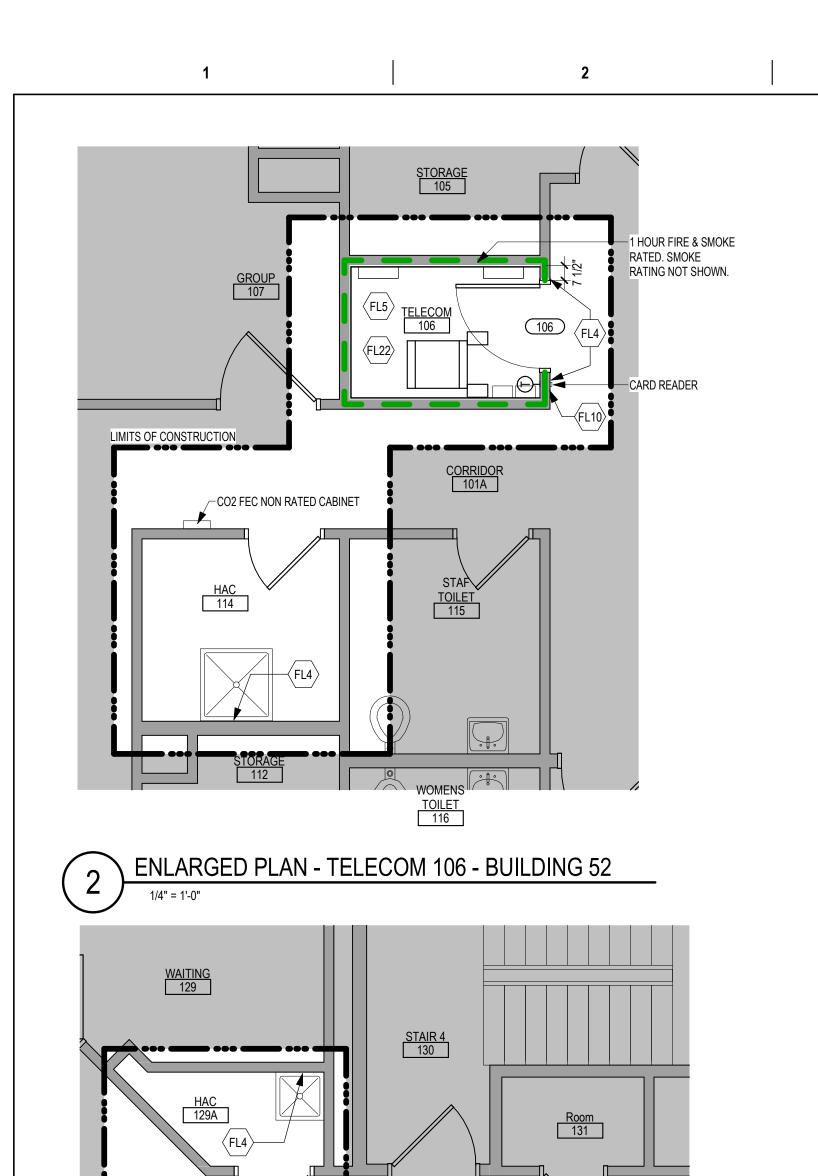
KSB

NMT

Project Number



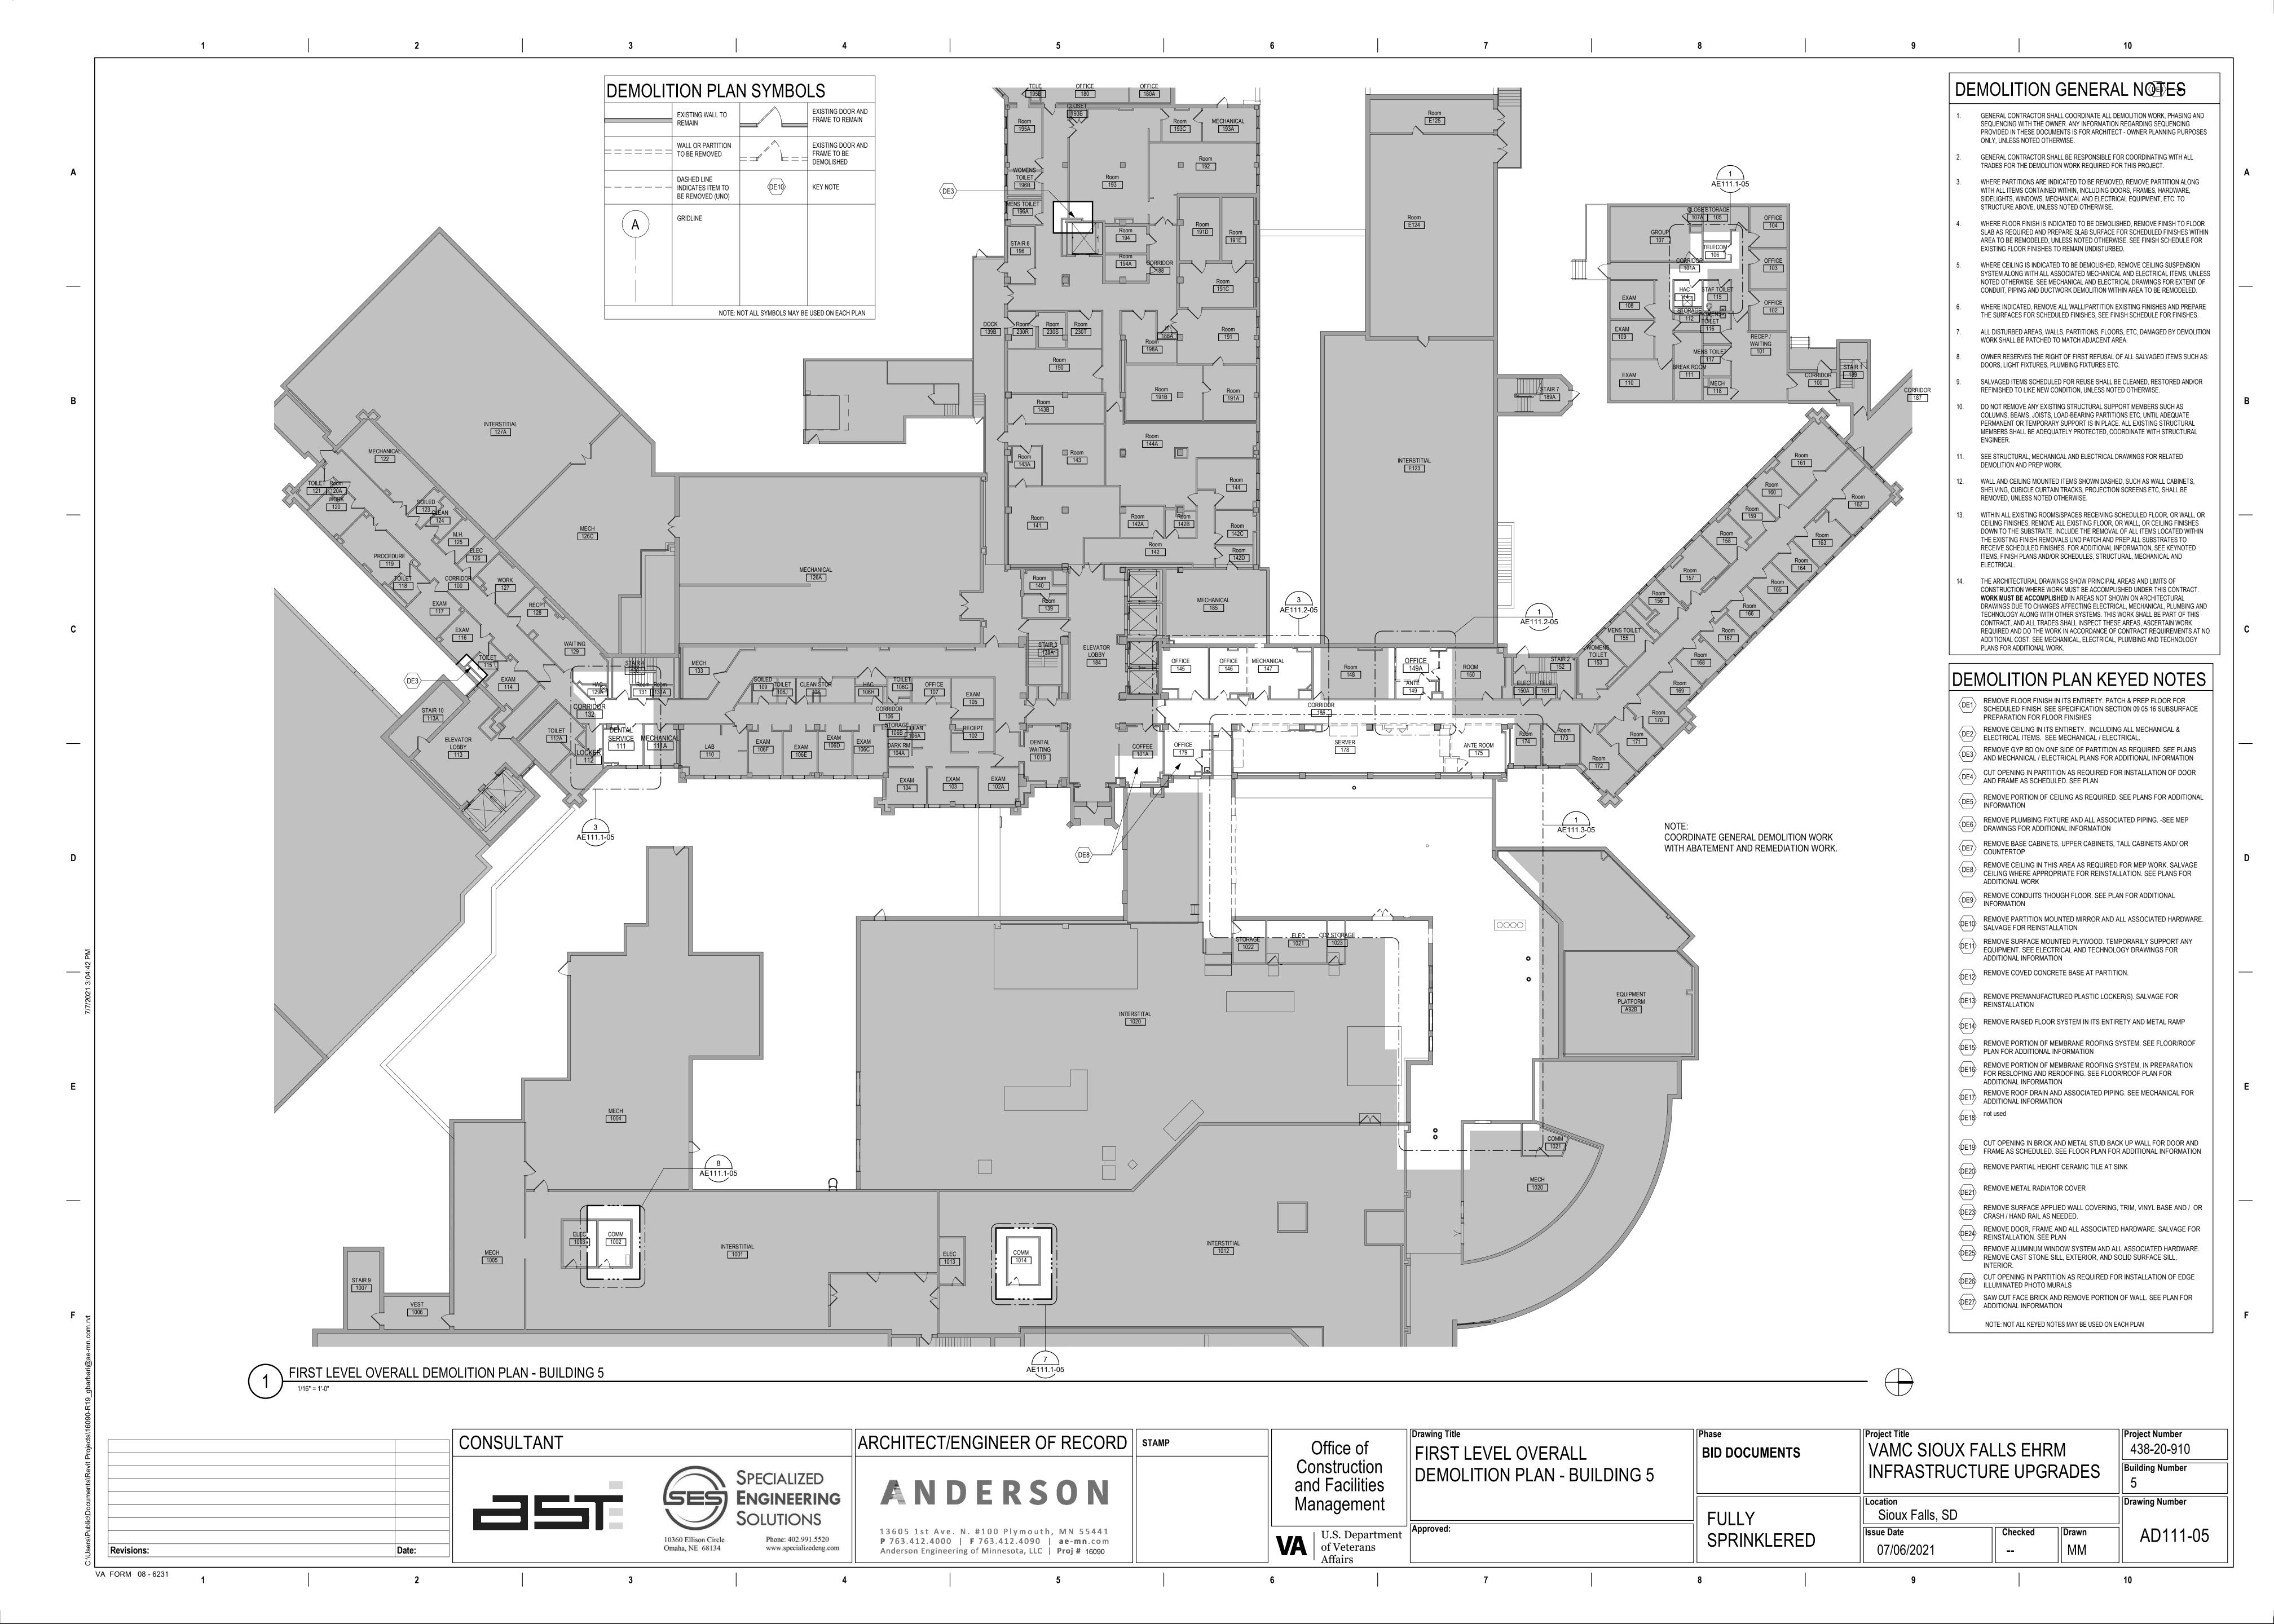

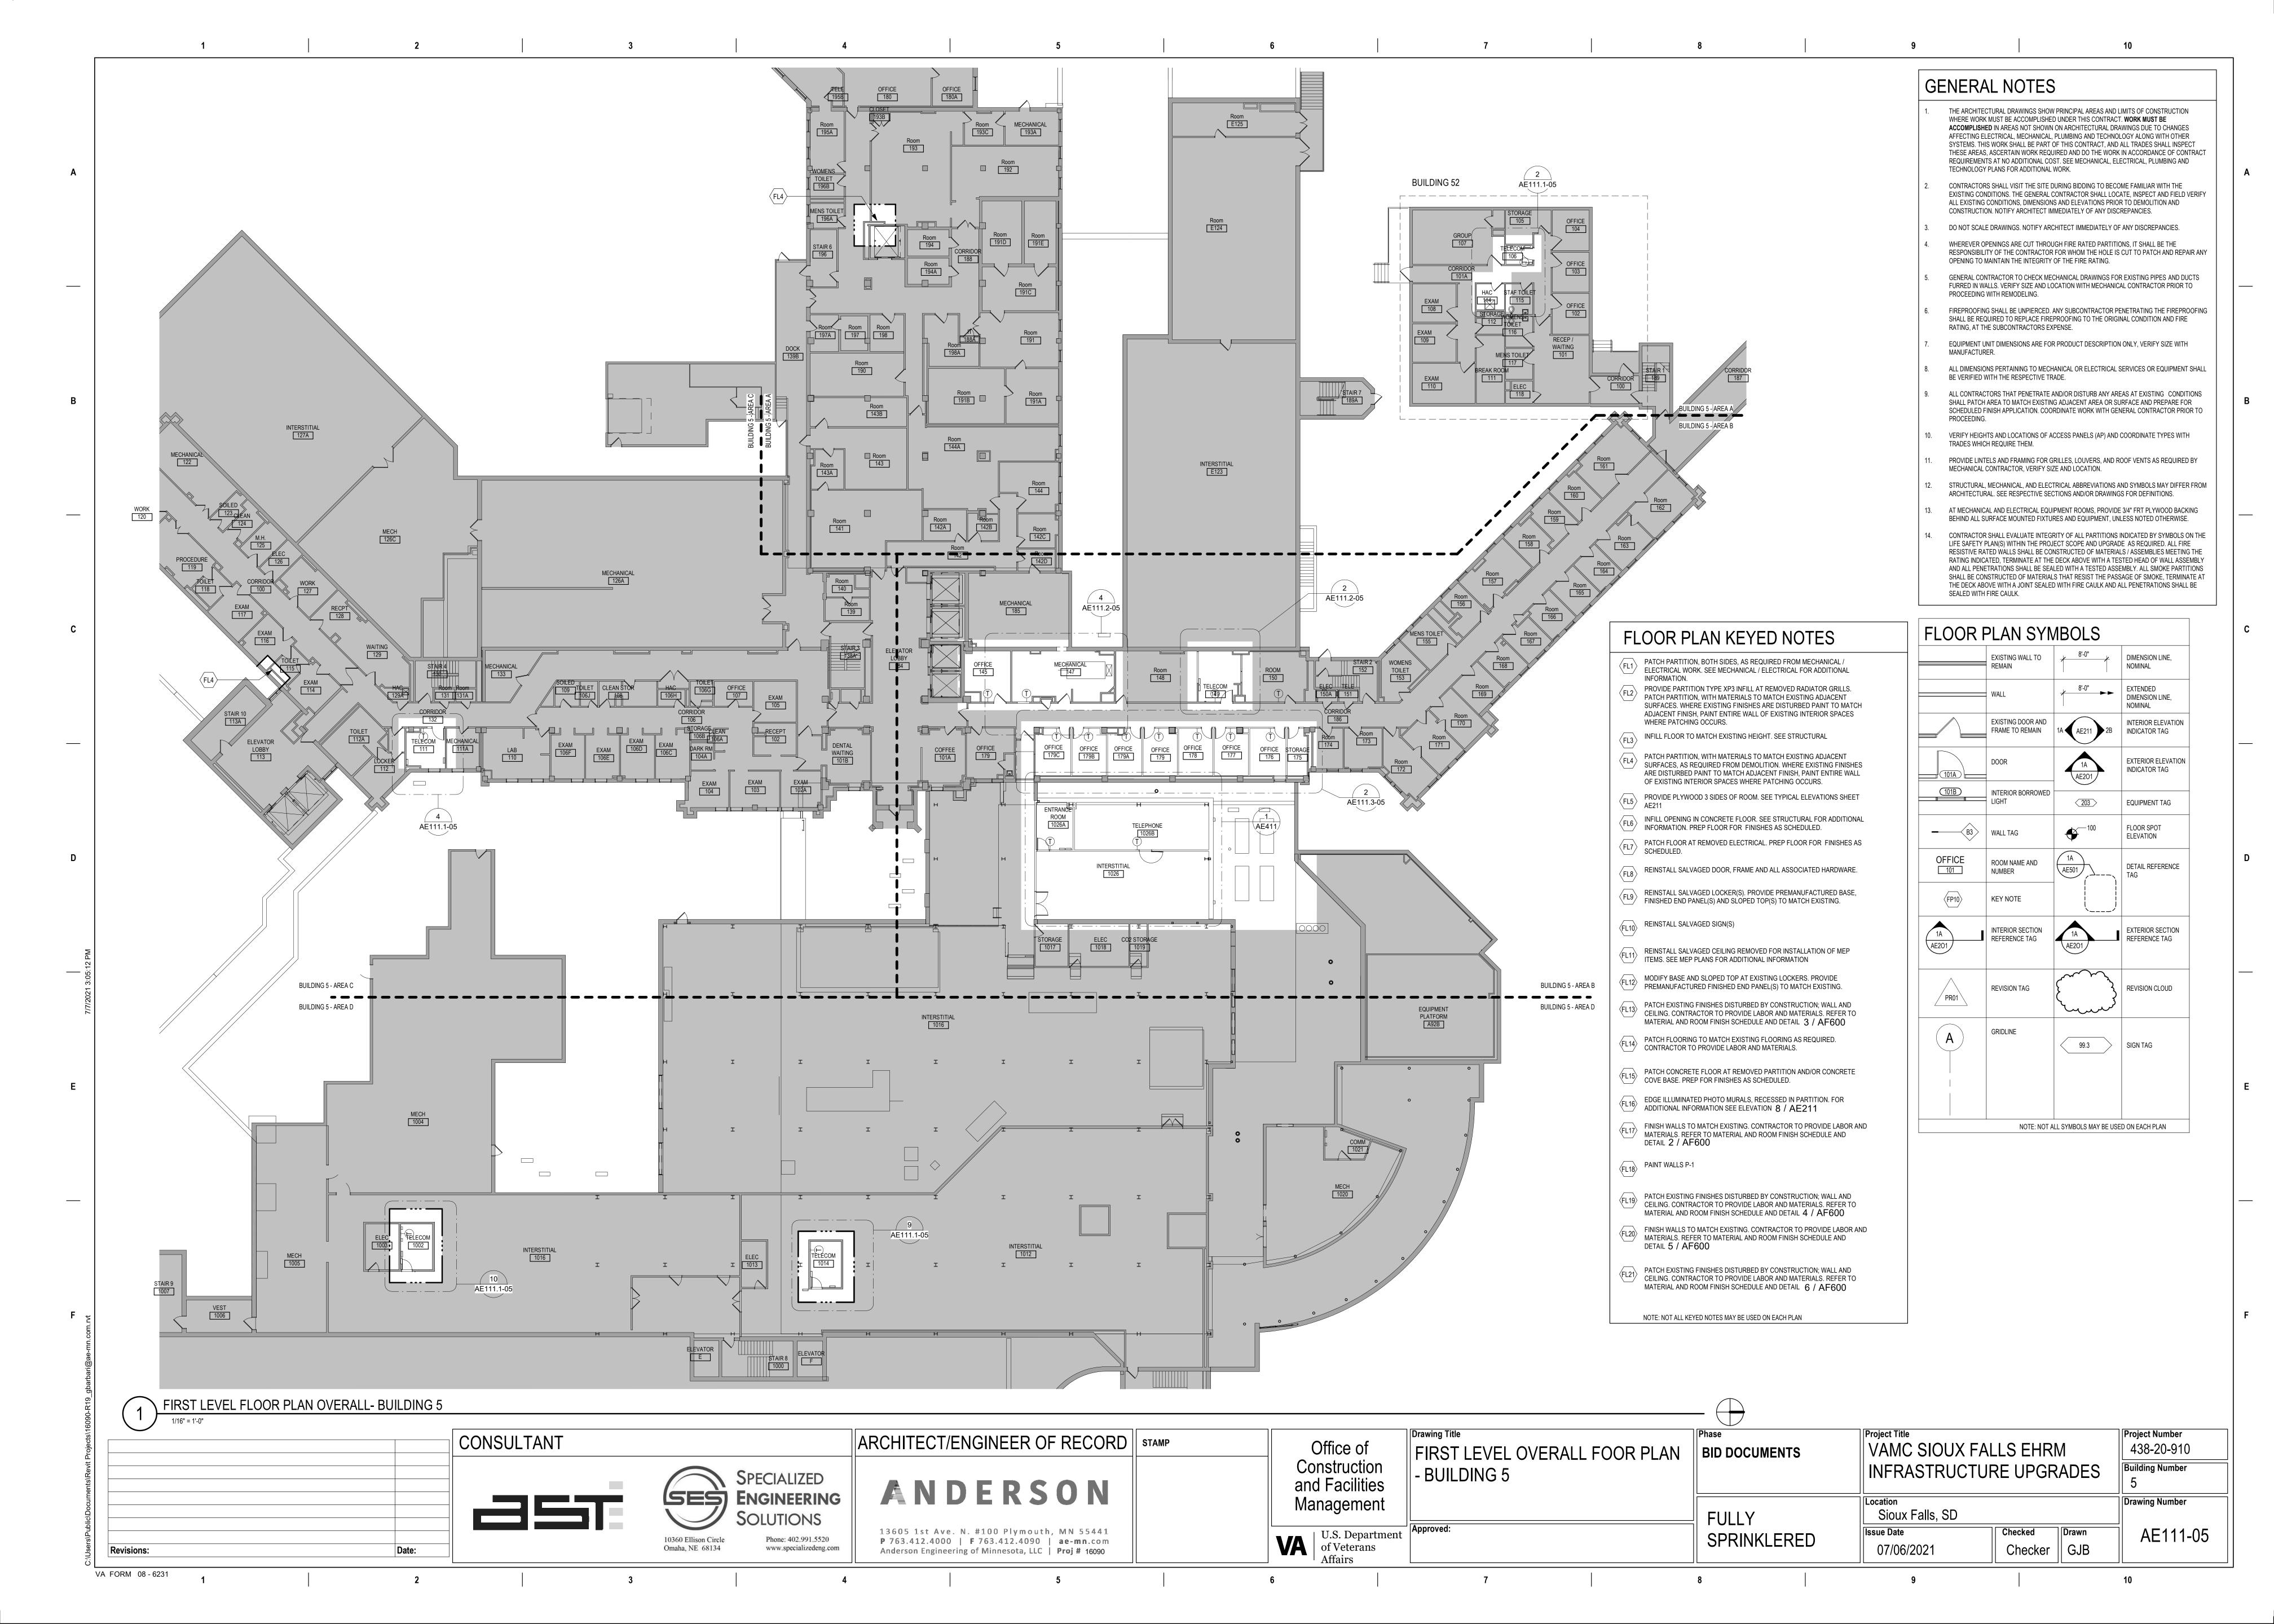

< 39.1 > CARD READER

-PROVIDE OPAQUE

-1 HOUR FIRE & SMOKE

RATED. SMOKE RATING

NOT SHOWN.

GENERAL NOTES THE ARCHITECTURAL DRAWINGS SHOW PRINCIPAL AREAS AND LIMITS OF CONSTRUCTION WHERE WORK MUST BE ACCOMPLISHED UNDER THIS CONTRACT. WORK MUST BE ACCOMPLISHED IN AREAS NOT SHOWN ON ARCHITECTURAL DRAWINGS DUE TO CHANGES AFFECTING ELECTRICAL, MECHANICAL, PLUMBING AND TECHNOLOGY ALONG WITH OTHER SYSTEMS. THIS WORK SHALL BE PART OF THIS CONTRACT, AND ALL TRADES SHALL INSPECT THESE AREAS, ASCERTAIN WORK REQUIRED AND DO THE WORK IN ACCORDANCE OF CONTRACT REQUIREMENTS AT NO ADDITIONAL COST. SEE MECHANICAL, ELECTRICAL, PLUMBING AND TECHNOLOGY PLANS FOR ADDITIONAL WORK.

CONTRACTORS SHALL VISIT THE SITE DURING BIDDING TO BECOME FAMILIAR WITH THE EXISTING CONDITIONS. THE GENERAL CONTRACTOR SHALL LOCATE, INSPECT AND FIELD VERIFY ALL EXISTING CONDITIONS, DIMENSIONS AND ELEVATIONS PRIOR TO DEMOLITION AND CONSTRUCTION. NOTIFY ARCHITECT IMMEDIATELY OF ANY DISCREPANCIES.

DO NOT SCALE DRAWINGS. NOTIFY ARCHITECT IMMEDIATELY OF ANY DISCREPANCIES.

WHEREVER OPENINGS ARE CUT THROUGH FIRE RATED PARTITIONS, IT SHALL BE THE RESPONSIBILITY OF THE CONTRACTOR FOR WHOM THE HOLE IS CUT TO PATCH AND REPAIR ANY OPENING TO MAINTAIN THE INTEGRITY OF THE FIRE RATING.

FURRED IN WALLS. VERIFY SIZE AND LOCATION WITH MECHANICAL CONTRACTOR PRIOR TO PROCEEDING WITH REMODELING. FIREPROOFING SHALL BE UNPIERCED. ANY SUBCONTRACTOR PENETRATING THE FIREPROOFING

GENERAL CONTRACTOR TO CHECK MECHANICAL DRAWINGS FOR EXISTING PIPES AND DUCTS

SHALL BE REQUIRED TO REPLACE FIREPROOFING TO THE ORIGINAL CONDITION AND FIRE RATING, AT THE SUBCONTRACTORS EXPENSE. EQUIPMENT UNIT DIMENSIONS ARE FOR PRODUCT DESCRIPTION ONLY, VERIFY SIZE WITH

MANUFACTURER. ALL DIMENSIONS PERTAINING TO MECHANICAL OR ELECTRICAL SERVICES OR EQUIPMENT SHALL BE VERIFIED WITH THE RESPECTIVE TRADE.

ALL CONTRACTORS THAT PENETRATE AND/OR DISTURB ANY AREAS AT EXISTING CONDITIONS SHALL PATCH AREA TO MATCH EXISTING ADJACENT AREA OR SURFACE AND PREPARE FOR SCHEDULED FINISH APPLICATION. COORDINATE WORK WITH GENERAL CONTRACTOR PRIOR TO


VERIFY HEIGHTS AND LOCATIONS OF ACCESS PANELS (AP) AND COORDINATE TYPES WITH TRADES WHICH REQUIRE THEM.


PROVIDE LINTELS AND FRAMING FOR GRILLES, LOUVERS, AND ROOF VENTS AS REQUIRED BY MECHANICAL CONTRACTOR, VERIFY SIZE AND LOCATION.

STRUCTURAL, MECHANICAL, AND ELECTRICAL ABBREVIATIONS AND SYMBOLS MAY DIFFER FROM ARCHITECTURAL. SEE RESPECTIVE SECTIONS AND/OR DRAWINGS FOR DEFINITIONS.

AT MECHANICAL AND ELECTRICAL EQUIPMENT ROOMS, PROVIDE 3/4" FRT PLYWOOD BACKING

BEHIND ALL SURFACE MOUNTED FIXTURES AND EQUIPMENT, UNLESS NOTED OTHERWISE. CONTRACTOR SHALL EVALUATE INTEGRITY OF ALL PARTITIONS INDICATED BY SYMBOLS ON THE LIFE SAFETY PLAN(S) WITHIN THE PROJECT SCOPE AND UPGRADE AS REQUIRED. ALL FIRE RESISTIVE RATED WALLS SHALL BE CONSTRUCTED OF MATERIALS / ASSEMBLIES MEETING THE RATING INDICATED, TERMINATE AT THE DECK ABOVE WITH A TESTED HEAD OF WALL ASSEMBLY AND ALL PENETRATIONS SHALL BE SEALED WITH A TESTED ASSEMBLY. ALL SMOKE PARTITIONS SHALL BE CONSTRUCTED OF MATERIALS THAT RESIST THE PASSAGE OF SMOKE, TERMINATE AT THE DECK ABOVE WITH A JOINT SEALED WITH FIRE CAULK AND ALL PENETRATIONS SHALL BE

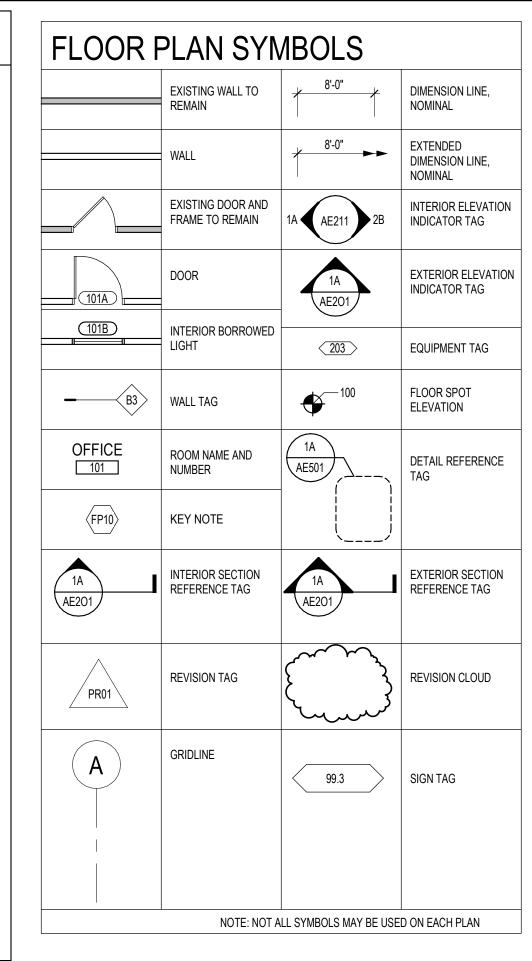


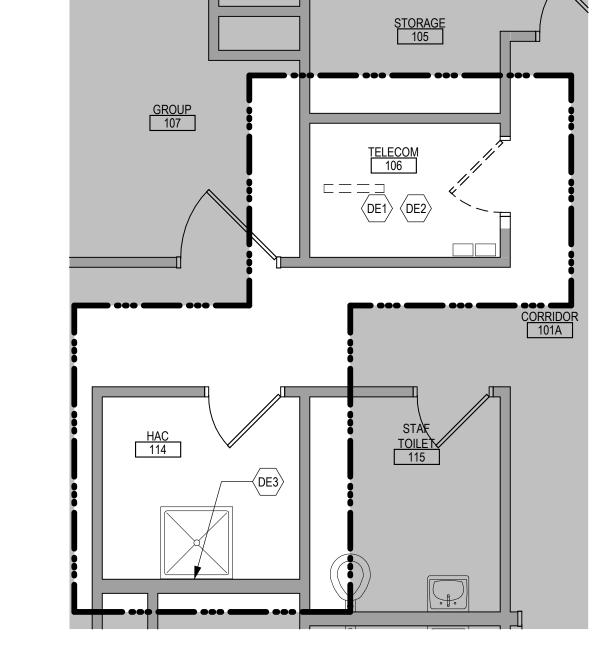

ENLARGED DEMOLITION PLAN - TELECOM 106 - BUILDING 52

Room 131

WAITING 129

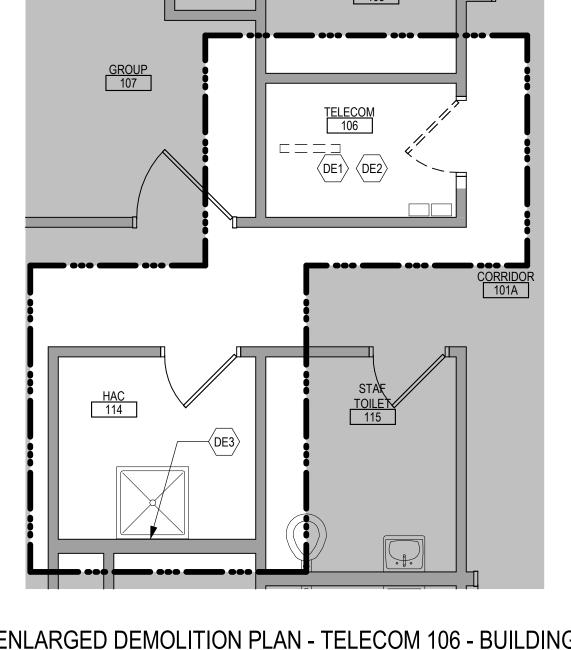


REMAIN **EXISTING DOOR AND** WALL OR PARTITION TO BE REMOVED FRAME TO BE DEMOLISHED DASHED LINE (DE10) _ _ _ _ _ _ _ KEY NOTE ─ INDICATES ITEM TO BE REMOVED (UNO) **GRIDLINE** NOTE: NOT ALL SYMBOLS MAY BE USED ON EACH PLAN

FRAME TO REMAIN

DEMOLITION PLAN SYMBOLS

EXISTING WALL TO

COORDINATE GENERAL DEMOLITION WORK WITH ABATEMENT AND REMEDIATION WORK.

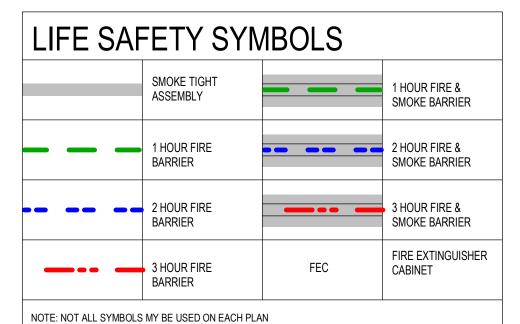

FLOOR PLAN KEYED NOTES

PATCH PARTITION, BOTH SIDES, AS REQUIRED FROM MECHANICAL / ELECTRICAL WORK, SEE MECHANICAL / ELECTRICAL FOR ADDITIONAL

PROVIDE PARTITION TYPE XP3 INFILL AT REMOVED RADIATOR GRILLS. PATCH PARTITION, WITH MATERIALS TO MATCH EXISTING ADJACENT SURFACES. WHERE EXISTING FINISHES ARE DISTURBED PAINT TO MATCH ADJACENT FINISH, PAINT ENTIRE WALL OF EXISTING INTERIOR SPACES WHERE PATCHING OCCURS.

\ INFILL FLOOR TO MATCH EXISTING HEIGHT. SEE STRUCTURAL

PATCH PARTITION, WITH MATERIALS TO MATCH EXISTING ADJACENT SURFACES, AS REQUIRED FROM DEMOLITION. WHERE EXISTING FINISHES ARE DISTURBED PAINT TO MATCH ADJACENT FINISH, PAINT ENTIRE WALL OF EXISTING INTERIOR SPACES WHERE PATCHING OCCURS.

FL5 PROVIDE PLYWOOD 3 SIDES OF ROOM. SEE TYPICAL ELEVATIONS SHEET

INFILL OPENING IN CONCRETE FLOOR. SEE STRUCTURAL FOR ADDITIONAL INFORMATION. PREP FLOOR FOR FINISHES AS SCHEDULED.

PATCH FLOOR AT REMOVED ELECTRICAL. PREP FLOOR FOR FINISHES AS

REINSTALL SALVAGED DOOR, FRAME AND ALL ASSOCIATED HARDWARE. REINSTALL SALVAGED LOCKER(S). PROVIDE PREMANUFACTURED BASE,

FINISHED END PANEL(S) AND SLOPED TOP(S) TO MATCH EXISTING. REINSTALL SALVAGED SIGN(S)

REINSTALL SALVAGED CEILING REMOVED FOR INSTALLATION OF MEP ITEMS. SEE MEP PLANS FOR ADDITIONAL INFORMATION

MODIFY BASE AND SLOPED TOP AT EXISTING LOCKERS. PROVIDE PREMANUFACTURED FINISHED END PANEL(S) TO MATCH EXISTING.

PATCH EXISTING FINISHES DISTURBED BY CONSTRUCTION; WALL AND CEILING. CONTRACTOR TO PROVIDE LABOR AND MATERIALS. REFER TO MATERIAL AND ROOM FINISH SCHEDULE AND DETAIL 3 / AF600

> PATCH FLOORING TO MATCH EXISTING FLOORING AS REQUIRED. CONTRACTOR TO PROVIDE LABOR AND MATERIALS.

PATCH CONCRETE FLOOR AT REMOVED PARTITION AND/OR CONCRETE

COVE BASE. PREP FOR FINISHES AS SCHEDULED. EDGE ILLUMINATED PHOTO MURALS, RECESSED IN PARTITION. FOR ADDITIONAL INFORMATION SEE ELEVATION 8 / AE211

FINISH WALLS TO MATCH EXISTING. CONTRACTOR TO PROVIDE LABOR AND MATERIALS. REFER TO MATERIAL AND ROOM FINISH SCHEDULE AND DETAIL 2 / AF600

PATCH EXISTING FINISHES DISTURBED BY CONSTRUCTION; WALL AND CEILING. CONTRACTOR TO PROVIDE LABOR AND MATERIALS. REFER TO

FINISH WALLS TO MATCH EXISTING. CONTRACTOR TO PROVIDE LABOR AND MATERIALS. REFER TO MATERIAL AND ROOM FINISH SCHEDULE AND DETAIL 5 / AF600


MATERIAL AND ROOM FINISH SCHEDULE AND DETAIL 4 / AF600

PATCH EXISTING FINISHES DISTURBED BY CONSTRUCTION; WALL AND CEILING. CONTRACTOR TO PROVIDE LABOR AND MATERIALS. REFER TO MATERIAL AND ROOM FINISH SCHEDULE AND DETAIL 6 / AF600

UPGRADE PARTITIONS TO 1 HOUR FIRE AND SMOKE BARRIER ALL SIDES OF ROOM. PROVIDE TESTED HEAD OF PARTITION ASSEMBLY WITH MATERIALS THAT RESIST THE PASSAGE OF SMOKE. SEAL JOINT AT HEAD OF PARTITION AND ALL PENETRATIONS WITH FIRE CAULK.

NOTE: NOT ALL KEYED NOTES MAY BE USED ON EACH PLAN

ENLARGED DEMOLITION PLAN - OFFICE 111 - BUILDING 5

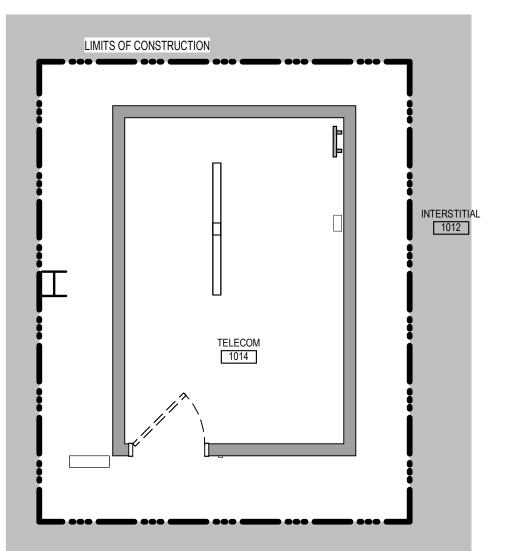

DEMOLITION PLAN KEYED NOTES

DEMOLITION GENERAL NOTES

ONLY, UNLESS NOTED OTHERWISE.

STRUCTURE ABOVE, UNLESS NOTED OTHERWISE.

EXISTING FLOOR FINISHES TO REMAIN UNDISTURBED.

WORK SHALL BE PATCHED TO MATCH ADJACENT AREA.

DOORS, LIGHT FIXTURES, PLUMBING FIXTURES ETC.

DEMOLITION AND PREP WORK.

PLANS FOR ADDITIONAL WORK.

REMOVED, UNLESS NOTED OTHERWISE.

GENERAL CONTRACTOR SHALL COORDINATE ALL DEMOLITION WORK, PHASING AND

PROVIDED IN THESE DOCUMENTS IS FOR ARCHITECT - OWNER PLANNING PURPOSES

SEQUENCING WITH THE OWNER. ANY INFORMATION REGARDING SEQUENCING

GENERAL CONTRACTOR SHALL BE RESPONSIBLE FOR COORDINATING WITH ALL

WHERE PARTITIONS ARE INDICATED TO BE REMOVED, REMOVE PARTITION ALONG

WHERE FLOOR FINISH IS INDICATED TO BE DEMOLISHED, REMOVE FINISH TO FLOOR

SLAB AS REQUIRED AND PREPARE SLAB SURFACE FOR SCHEDULED FINISHES WITHIN

AREA TO BE REMODELED, UNLESS NOTED OTHERWISE. SEE FINISH SCHEDULE FOR

WHERE CEILING IS INDICATED TO BE DEMOLISHED, REMOVE CEILING SUSPENSION

SYSTEM ALONG WITH ALL ASSOCIATED MECHANICAL AND ELECTRICAL ITEMS, UNLESS

NOTED OTHERWISE. SEE MECHANICAL AND ELECTRICAL DRAWINGS FOR EXTENT OF

WHERE INDICATED, REMOVE ALL WALL/PARTITION EXISTING FINISHES AND PREPARE

ALL DISTURBED AREAS, WALLS, PARTITIONS, FLOORS, ETC, DAMAGED BY DEMOLITION

OWNER RESERVES THE RIGHT OF FIRST REFUSAL OF ALL SALVAGED ITEMS SUCH AS:

SALVAGED ITEMS SCHEDULED FOR REUSE SHALL BE CLEANED, RESTORED AND/OR

MEMBERS SHALL BE ADEQUATELY PROTECTED, COORDINATE WITH STRUCTURAL

SEE STRUCTURAL, MECHANICAL AND ELECTRICAL DRAWINGS FOR RELATED

WALL AND CEILING MOUNTED ITEMS SHOWN DASHED, SUCH AS WALL CABINETS,

SHELVING, CUBICLE CURTAIN TRACKS, PROJECTION SCREENS ETC, SHALL BE

WITHIN ALL EXISTING ROOMS/SPACES RECEIVING SCHEDULED FLOOR, OR WALL, OR CEILING FINISHES, REMOVE ALL EXISTING FLOOR, OR WALL, OR CEILING FINISHES

DOWN TO THE SUBSTRATE. INCLUDE THE REMOVAL OF ALL ITEMS LOCATED WITHIN

THE EXISTING FINISH REMOVALS UNO PATCH AND PREP ALL SUBSTRATES TO

ITEMS, FINISH PLANS AND/OR SCHEDULES, STRUCTURAL, MECHANICAL AND

THE ARCHITECTURAL DRAWINGS SHOW PRINCIPAL AREAS AND LIMITS OF

RECEIVE SCHEDULED FINISHES. FOR ADDITIONAL INFORMATION, SEE KEYNOTED

CONSTRUCTION WHERE WORK MUST BE ACCOMPLISHED UNDER THIS CONTRACT WORK MUST BE ACCOMPLISHED IN AREAS NOT SHOWN ON ARCHITECTURAL

DRAWINGS DUE TO CHANGES AFFECTING ELECTRICAL, MECHANICAL, PLUMBING AND

REQUIRED AND DO THE WORK IN ACCORDANCE OF CONTRACT REQUIREMENTS AT NO ADDITIONAL COST. SEE MECHANICAL, ELECTRICAL, PLUMBING AND TECHNOLOGY

TECHNOLOGY ALONG WITH OTHER SYSTEMS. THIS WORK SHALL BE PART OF THIS

CONTRACT, AND ALL TRADES SHALL INSPECT THESE AREAS, ASCERTAIN WORK

REFINISHED TO LIKE NEW CONDITION, UNLESS NOTED OTHERWISE.

DO NOT REMOVE ANY EXISTING STRUCTURAL SUPPORT MEMBERS SUCH AS COLUMNS, BEAMS, JOISTS, LOAD-BEARING PARTITIONS ETC, UNTIL ADEQUATE PERMANENT OR TEMPORARY SUPPORT IS IN PLACE. ALL EXISTING STRUCTURAL

THE SURFACES FOR SCHEDULED FINISHES, SEE FINISH SCHEDULE FOR FINISHES.

CONDUIT, PIPING AND DUCTWORK DEMOLITION WITHIN AREA TO BE REMODELED.

WITH ALL ITEMS CONTAINED WITHIN, INCLUDING DOORS, FRAMES, HARDWARE,

SIDELIGHTS, WINDOWS, MECHANICAL AND ELECTRICAL EQUIPMENT, ETC. TO

TRADES FOR THE DEMOLITION WORK REQUIRED FOR THIS PROJECT.

REMOVE FLOOR FINISH IN ITS ENTIRETY. PATCH & PREP FLOOR FOR SCHEDULED FINISH. SEE SPECIFICATION SECTION 09 05 16 SUBSURFACE PREPARATION FOR FLOOR FINISHES

REMOVE CEILING IN ITS ENTIRETY. INCLUDING ALL MECHANICAL &

DE2 ELECTRICAL ITEMS. SEE MECHANICAL / ELECTRICAL. REMOVE GYP BD ON ONE SIDE OF PARTITION AS REQUIRED. SEE PLANS AND MECHANICAL / ELECTRICAL PLANS FOR ADDITIONAL INFORMATION

CUT OPENING IN PARTITION AS REQUIRED FOR INSTALLATION OF DOOR AND FRAME AS SCHEDULED SEE DIAM AND FRAME AS SCHEDULED. SEE PLAN

REMOVE PORTION OF CEILING AS REQUIRED. SEE PLANS FOR ADDITIONAL INFORMATION

REMOVE PLUMBING FIXTURE AND ALL ASSOCIATED PIPING. -SEE MEP DE6 DRAWINGS FOR ADDITIONAL INFORMATION

DE7 REMOVE BASE CABINETS, UPPER CABINETS, TALL CABINETS AND/ OR COUNTERTOP

REMOVE CEILING IN THIS AREA AS REQUIRED FOR MEP WORK. SALVAGE

CEILING WHERE APPROPRIATE FOR REINSTALLATION. SEE PLANS FOR

DE9 REMOVE CONDUITS THOUGH FLOOR. SEE PLAN FOR ADDITIONAL INFORMATION

REMOVE PARTITION MOUNTED MIRROR AND ALL ASSOCIATED HARDWARE.

DE10 SALVAGE FOR REINSTALLATION REMOVE SURFACE MOUNTED PLYWOOD. TEMPORARILY SUPPORT ANY DE11 EQUIPMENT. SEE ELECTRICAL AND TECHNOLOGY DRAWINGS FOR

ADDITIONAL INFORMATION DE12) REMOVE COVED CONCRETE BASE AT PARTITION.

REMOVE PREMANUFACTURED PLASTIC LOCKER(S). SALVAGE FOR

DE13 REINSTALLATION

DE14) REMOVE RAISED FLOOR SYSTEM IN ITS ENTIRETY AND METAL RAMP

REMOVE PORTION OF MEMBRANE ROOFING SYSTEM. SEE FLOOR/ROOF DE15 PLAN FOR ADDITIONAL INFORMATION

REMOVE PORTION OF MEMBRANE ROOFING SYSTEM, IN PREPARATION

FOR RESLOPING AND REROOFING. SEE FLOOR/ROOF PLAN FOR

ADDITIONAL INFORMATION

REMOVE ROOF DRAIN AND ASSOCIATED PIPING. SEE MECHANICAL FOR ADDITIONAL INFORMATION

REMOVE METAL LOUVER AND ALL ASSOCIATED MOUNTING HARDWARE.

SEE MECHANICAL FOR ADDITIONAL INFORMATION

CUT OPENING IN BRICK AND METAL STUD BACK UP WALL FOR DOOR AND FRAME AS SCHEDULED. SEE FLOOR PLAN FOR ADDITIONAL INFORMATION

DE20 REMOVE PARTIAL HEIGHT CERAMIC TILE AT SINK

(DE21) REMOVE METAL RADIATOR COVER

REMOVE SURFACE APPLIED WALL COVERING, TRIM, VINYL BASE AND / OR CRASH / HAND RAIL AS NEEDED.

REMOVE DOOR, FRAME AND ALL ASSOCIATED HARDWARE. SALVAGE FOR DE24 REINSTALLATION. SEE PLAN REMOVE ALUMINUM WINDOW SYSTEM AND ALL ASSOCIATED HARDWARE.

REMOVE CAST STONE SILL, EXTERIOR, AND SOLID SURFACE SILL,

DE26 CUT OPENING IN PARTITION AS REQUIRED FOR INSTALLATION OF EDGE ILLUMINATED PHOTO MURALS

SAW CUT FACE BRICK AND REMOVE PORTION OF WALL. SEE PLAN FOR


ADDITIONAL INFORMATION NOTE: NOT ALL KEYED NOTES MAY BE USED ON EACH PLAN

7 ENLARGED DEMOLITION PLAN - COMM 1014 - BUILDING 5

-CO2 FE SURFACE ENLARGED PLAN - TELECOM 1002 - BUILDING 5

ENLARGED PLAN - TELECOM 111 - BUILDING 5

-1 HOUR FIRE & SMOKE RATED. SMOKE RATING

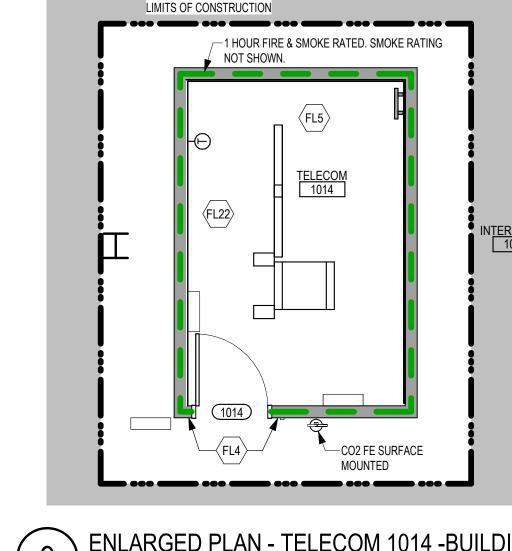

ENLARGED PLAN - TELECOM 1014 -BUILDING 5

CONSULTANT

SPECIALIZED **ENGINEERING** ARCHITECT/ENGINEER OF RECORD | STAMP

Office of Construction and Facilities Management

ENLARGED DEMOLITION PLAN - COMM 1002 - BUILDING 5

FIRST LEVEL ENLARGED BUILDING 5 & 52

Drawing Title

DEMOLITION & FLOOR PLAN -

VAMC SIOUX FALLS EHRM BID DOCUMENTS INFRASTRUCTURE UPGRADES

Sioux Falls, SD Checked Drawn 02/18/2022 Checker | Author

Revisions:

VA FORM 08 - 6231







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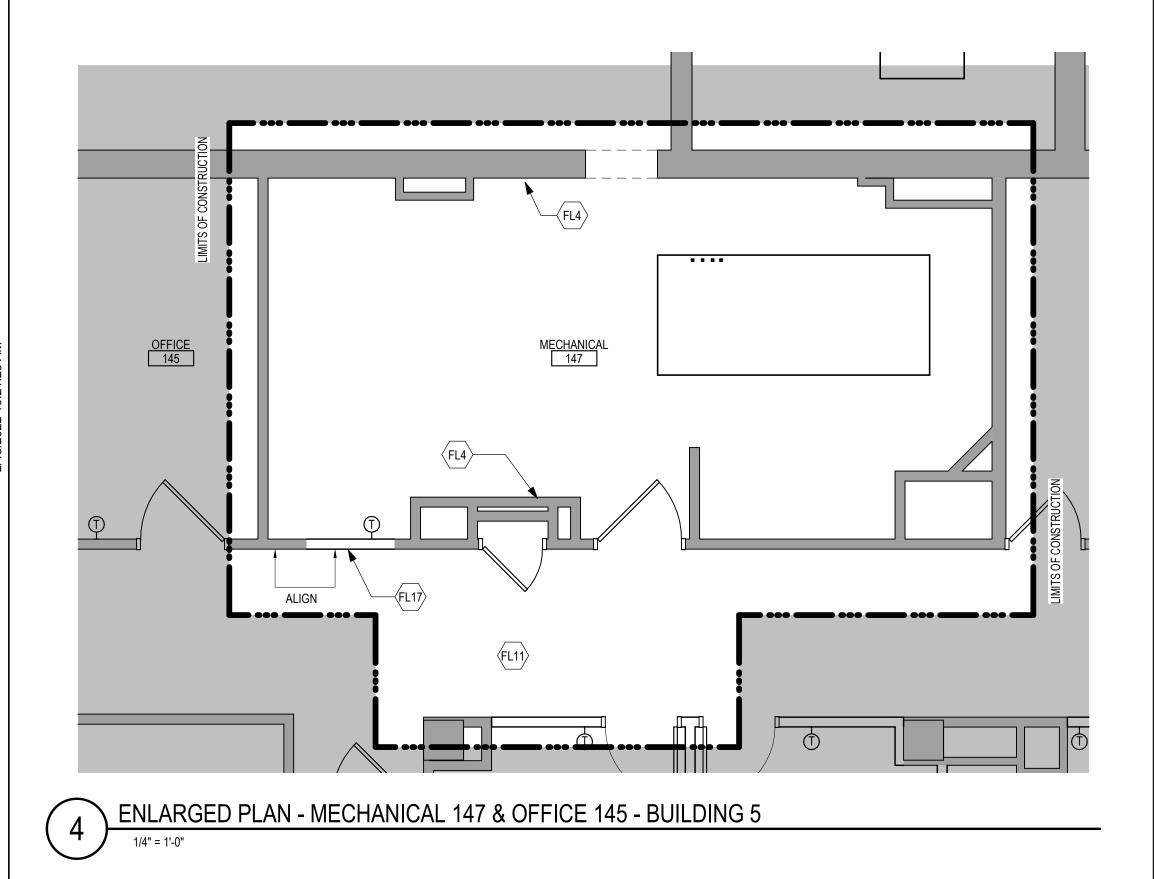
U.S. Department of Veterans

FULLY SPRINKLERED Project Number 438-20-910 **Building Number** Drawing Number AE111.1-05



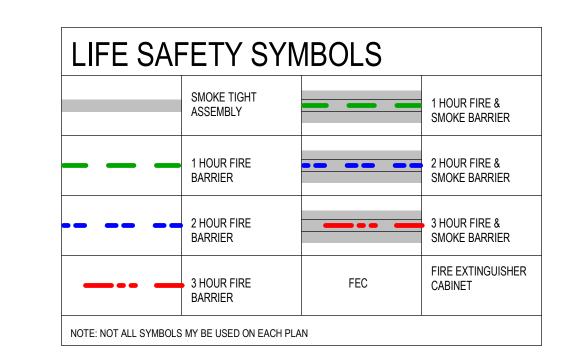

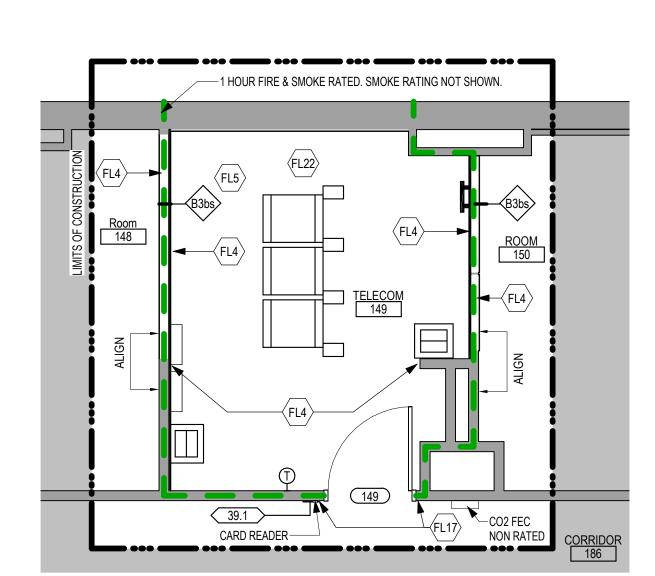2 ENLARGED PLAN - TELECOM 149 - BUILDING 5



FLOOR PLAN SYMBOLS EXISTING WALL TO DIMENSION LINE, NOMINAL --DIMENSION LINE, NOMINAL EXISTING DOOR AND INTERIOR ELEVATION FRAME TO REMAIN INDICATOR TAG EXTERIOR ELEVATION INDICATOR TAG INTERIOR BORROWED LIGHT 203 **EQUIPMENT TAG** ELEVATION ROOM NAME AND DETAIL REFERENCE NUMBER 〈FP10〉 KEY NOTE NTERIOR SECTION EXTERIOR SECTION REFERENCE TAG REFERENCE TAG **REVISION TAG** REVISION CLOUD **GRIDLINE** 99.3 SIGN TAG

FLOOR PLAN KEYED NOTES

NOTE: NOT ALL SYMBOLS MAY BE USED ON EACH PLAN

- PATCH PARTITION, BOTH SIDES, AS REQUIRED FROM MECHANICAL ELECTRICAL WORK. SEE MECHANICAL / ELECTRICAL FOR ADDITIONAL
- PROVIDE PARTITION TYPE XP3 INFILL AT REMOVED RADIATOR GRILLS. PATCH PARTITION, WITH MATERIALS TO MATCH EXISTING ADJACENT SURFACES. WHERE EXISTING FINISHES ARE DISTURBED PAINT TO MATCH ADJACENT FINISH, PAINT ENTIRE WALL OF EXISTING INTERIOR SPACES WHERE PATCHING OCCURS.
- INFILL FLOOR TO MATCH EXISTING HEIGHT. SEE STRUCTURAL
- PATCH PARTITION, WITH MATERIALS TO MATCH EXISTING ADJACENT SURFACES, AS REQUIRED FROM DEMOLITION. WHERE EXISTING FINISHES ARE DISTURBED PAINT TO MATCH ADJACENT FINISH, PAINT ENTIRE WALL OF EXISTING INTERIOR SPACES WHERE PATCHING OCCURS.
- PROVIDE PLYWOOD 3 SIDES OF ROOM. SEE TYPICAL ELEVATIONS SHEET
- INFILL OPENING IN CONCRETE FLOOR. SEE STRUCTURAL FOR ADDITIONAL INFORMATION. PREP FLOOR FOR FINISHES AS SCHEDULED.
- PATCH FLOOR AT REMOVED ELECTRICAL. PREP FLOOR FOR FINISHES AS
- REINSTALL SALVAGED DOOR, FRAME AND ALL ASSOCIATED HARDWARE.
- REINSTALL SALVAGED LOCKER(S). PROVIDE PREMANUFACTURED BASE,
- FINISHED END PANEL(S) AND SLOPED TOP(S) TO MATCH EXISTING.
- REINSTALL SALVAGED SIGN(S)
- REINSTALL SALVAGED CEILING REMOVED FOR INSTALLATION OF MEP ITEMS. SEE MEP PLANS FOR ADDITIONAL INFORMATION
- MODIFY BASE AND SLOPED TOP AT EXISTING LOCKERS. PROVIDE PREMANUFACTURED FINISHED END PANEL(S) TO MATCH EXISTING.
- PATCH EXISTING FINISHES DISTURBED BY CONSTRUCTION; WALL AND CEILING. CONTRACTOR TO PROVIDE LABOR AND MATERIALS. REFER TO MATERIAL AND ROOM FINISH SCHEDULE AND DETAIL 3 / AF600
- PATCH FLOORING TO MATCH EXISTING FLOORING AS REQUIRED. CONTRACTOR TO PROVIDE LABOR AND MATERIALS.
- PATCH CONCRETE FLOOR AT REMOVED PARTITION AND/OR CONCRETE
- FL15 COVE BASE. PREP FOR FINISHES AS SCHEDULED. EDGE ILLUMINATED PHOTO MURALS, RECESSED IN PARTITION. FOR


ADDITIONAL INFORMATION SEE ELEVATION 8 / AE211

- FINISH WALLS TO MATCH EXISTING. CONTRACTOR TO PROVIDE LABOR AND MATERIALS. REFER TO MATERIAL AND ROOM FINISH SCHEDULE AND DETAIL 2 / AF600
- PAINT WALLS P-1
- PATCH EXISTING FINISHES DISTURBED BY CONSTRUCTION; WALL AND CEILING. CONTRACTOR TO PROVIDE LABOR AND MATERIALS. REFER TO MATERIAL AND ROOM FINISH SCHEDULE AND DETAIL 4 / AF600
- FINISH WALLS TO MATCH EXISTING, CONTRACTOR TO PROVIDE LABOR AND MATERIALS. REFER TO MATERIAL AND ROOM FINISH SCHEDULE AND DETAIL 5 / AF600
- PATCH EXISTING FINISHES DISTURBED BY CONSTRUCTION; WALL AND CEILING. CONTRACTOR TO PROVIDE LABOR AND MATERIALS. REFER TO MATERIAL AND ROOM FINISH SCHEDULE AND DETAIL 6 / AF600
- UPGRADE PARTITIONS TO 1 HOUR FIRE AND SMOKE BARRIER ALL SIDES OF ROOM. PROVIDE TESTED HEAD OF PARTITION ASSEMBLY WITH MATERIALS THAT RESIST THE PASSAGE OF SMOKE. SEAL JOINT AT HEAD OF PARTITION AND ALL PENETRATIONS WITH FIRE CAULK.

NOTE: NOT ALL KEYED NOTES MAY BE USED ON EACH PLAN


GENERAL NOTES

- THE ARCHITECTURAL DRAWINGS SHOW PRINCIPAL AREAS AND LIMITS OF CONSTRUCTION WHERE WORK MUST BE ACCOMPLISHED UNDER THIS CONTRACT. WORK MUST BE **ACCOMPLISHED** IN AREAS NOT SHOWN ON ARCHITECTURAL DRAWINGS DUE TO CHANGES AFFECTING ELECTRICAL, MECHANICAL, PLUMBING AND TECHNOLOGY ALONG WITH OTHER SYSTEMS. THIS WORK SHALL BE PART OF THIS CONTRACT, AND ALL TRADES SHALL INSPECT THESE AREAS. ASCERTAIN WORK REQUIRED AND DO THE WORK IN ACCORDANCE OF CONTRACT REQUIREMENTS AT NO ADDITIONAL COST. SEE MECHANICAL, ELECTRICAL, PLUMBING AND TECHNOLOGY PLANS FOR ADDITIONAL WORK.
- CONTRACTORS SHALL VISIT THE SITE DURING BIDDING TO BECOME FAMILIAR WITH THE EXISTING CONDITIONS. THE GENERAL CONTRACTOR SHALL LOCATE, INSPECT AND FIELD VERIFY ALL EXISTING CONDITIONS, DIMENSIONS AND ELEVATIONS PRIOR TO DEMOLITION AND CONSTRUCTION. NOTIFY ARCHITECT IMMEDIATELY OF ANY DISCREPANCIES.
- DO NOT SCALE DRAWINGS. NOTIFY ARCHITECT IMMEDIATELY OF ANY DISCREPANCIES.
- WHEREVER OPENINGS ARE CUT THROUGH FIRE RATED PARTITIONS, IT SHALL BE THE RESPONSIBILITY OF THE CONTRACTOR FOR WHOM THE HOLE IS CUT TO PATCH AND REPAIR ANY OPENING TO MAINTAIN THE INTEGRITY OF THE FIRE RATING.
- GENERAL CONTRACTOR TO CHECK MECHANICAL DRAWINGS FOR EXISTING PIPES AND DUCTS FURRED IN WALLS. VERIFY SIZE AND LOCATION WITH MECHANICAL CONTRACTOR PRIOR TO PROCEEDING WITH REMODELING.
- FIREPROOFING SHALL BE UNPIERCED. ANY SUBCONTRACTOR PENETRATING THE FIREPROOFING SHALL BE REQUIRED TO REPLACE FIREPROOFING TO THE ORIGINAL CONDITION AND FIRE RATING, AT THE SUBCONTRACTORS EXPENSE.
- EQUIPMENT UNIT DIMENSIONS ARE FOR PRODUCT DESCRIPTION ONLY, VERIFY SIZE WITH MANUFACTURER.
- ALL DIMENSIONS PERTAINING TO MECHANICAL OR ELECTRICAL SERVICES OR EQUIPMENT SHALL BE VERIFIED WITH THE RESPECTIVE TRADE.
- ALL CONTRACTORS THAT PENETRATE AND/OR DISTURB ANY AREAS AT EXISTING CONDITIONS SHALL PATCH AREA TO MATCH EXISTING ADJACENT AREA OR SURFACE AND PREPARE FOR SCHEDULED FINISH APPLICATION. COORDINATE WORK WITH GENERAL CONTRACTOR PRIOR TO
- VERIFY HEIGHTS AND LOCATIONS OF ACCESS PANELS (AP) AND COORDINATE TYPES WITH TRADES WHICH REQUIRE THEM.
- PROVIDE LINTELS AND FRAMING FOR GRILLES, LOUVERS, AND ROOF VENTS AS REQUIRED BY MECHANICAL CONTRACTOR, VERIFY SIZE AND LOCATION.
- STRUCTURAL, MECHANICAL, AND ELECTRICAL ABBREVIATIONS AND SYMBOLS MAY DIFFER FROM ARCHITECTURAL. SEE RESPECTIVE SECTIONS AND/OR DRAWINGS FOR DEFINITIONS.
- AT MECHANICAL AND ELECTRICAL EQUIPMENT ROOMS, PROVIDE 3/4" FRT PLYWOOD BACKING BEHIND ALL SURFACE MOUNTED FIXTURES AND EQUIPMENT, UNLESS NOTED OTHERWISE.
- CONTRACTOR SHALL EVALUATE INTEGRITY OF ALL PARTITIONS INDICATED BY SYMBOLS ON THE LIFE SAFETY PLAN(S) WITHIN THE PROJECT SCOPE AND UPGRADE AS REQUIRED. ALL FIRE RESISTIVE RATED WALLS SHALL BE CONSTRUCTED OF MATERIALS / ASSEMBLIES MEETING THE RATING INDICATED. TERMINATE AT THE DECK ABOVE WITH A TESTED HEAD OF WALL ASSEMBLY AND ALL PENETRATIONS SHALL BE SEALED WITH A TESTED ASSEMBLY. ALL SMOKE PARTITIONS SHALL BE CONSTRUCTED OF MATERIALS THAT RESIST THE PASSAGE OF SMOKE, TERMINATE AT THE DECK ABOVE WITH A JOINT SEALED WITH FIRE CAULK AND ALL PENETRATIONS SHALL BE SEALED WITH FIRE CAULK.

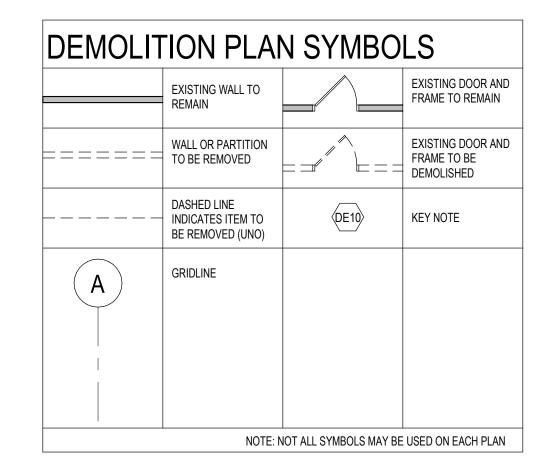

_____ - — — — — — — —



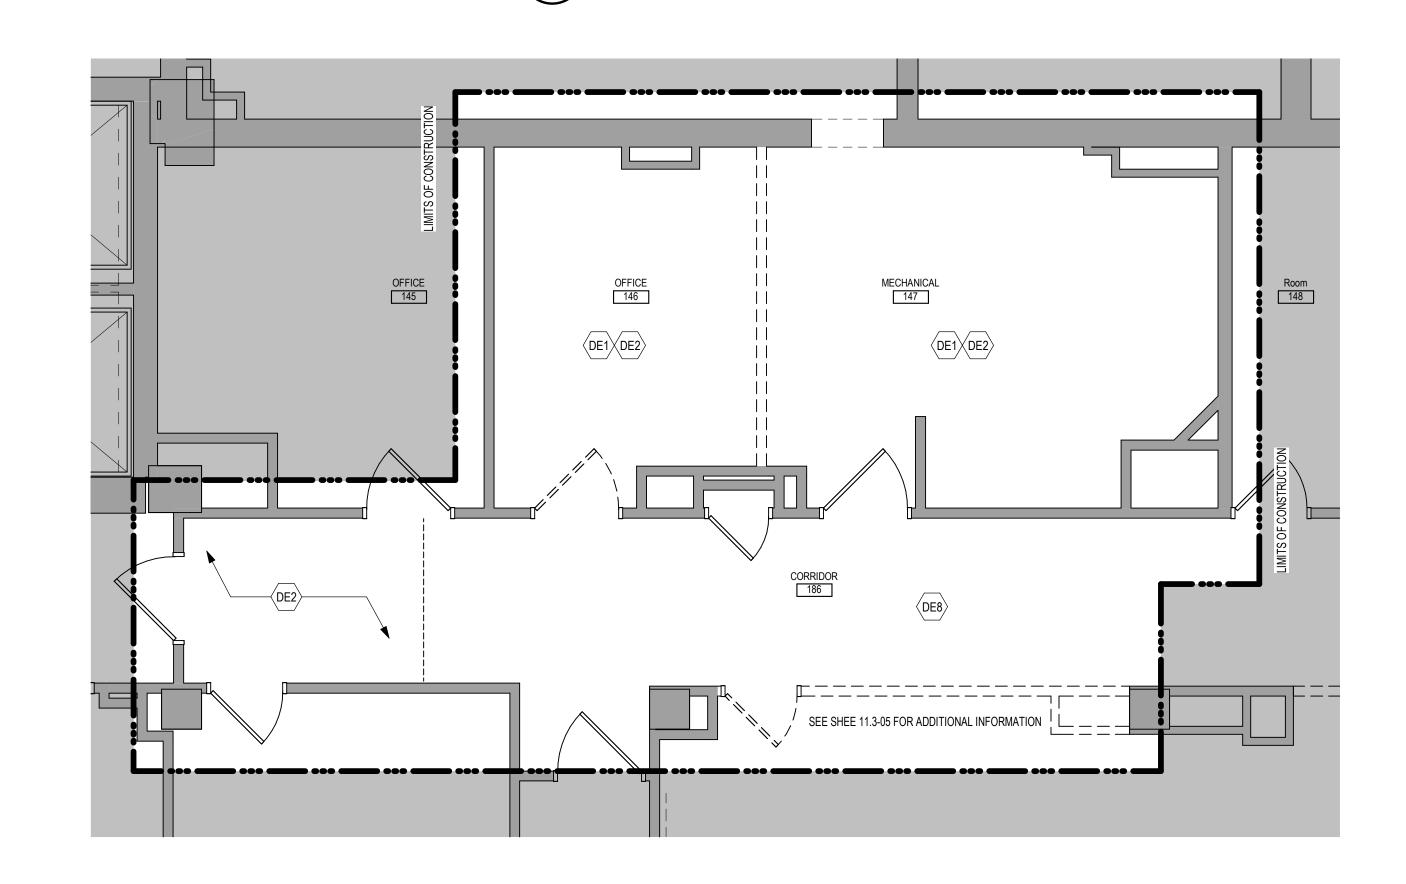

NENLARGED DEMOLITION PLAN - OFFICE 145 & 146, MECHANICAL 147 - BUILDING 5

DEMOLITION GENERAL NOTES

- GENERAL CONTRACTOR SHALL COORDINATE ALL DEMOLITION WORK, PHASING AND SEQUENCING WITH THE OWNER. ANY INFORMATION REGARDING SEQUENCING PROVIDED IN THESE DOCUMENTS IS FOR ARCHITECT - OWNER PLANNING PURPOSES
- ONLY, UNLESS NOTED OTHERWISE. GENERAL CONTRACTOR SHALL BE RESPONSIBLE FOR COORDINATING WITH ALL

TRADES FOR THE DEMOLITION WORK REQUIRED FOR THIS PROJECT.

- WHERE PARTITIONS ARE INDICATED TO BE REMOVED, REMOVE PARTITION ALONG WITH ALL ITEMS CONTAINED WITHIN, INCLUDING DOORS, FRAMES, HARDWARE, SIDELIGHTS, WINDOWS, MECHANICAL AND ELECTRICAL EQUIPMENT, ETC. TO STRUCTURE ABOVE, UNLESS NOTED OTHERWISE.
- WHERE FLOOR FINISH IS INDICATED TO BE DEMOLISHED, REMOVE FINISH TO FLOOR SLAB AS REQUIRED AND PREPARE SLAB SURFACE FOR SCHEDULED FINISHES WITHIN AREA TO BE REMODELED, UNLESS NOTED OTHERWISE. SEE FINISH SCHEDULE FOR EXISTING FLOOR FINISHES TO REMAIN UNDISTURBED.
- WHERE CEILING IS INDICATED TO BE DEMOLISHED, REMOVE CEILING SUSPENSION SYSTEM ALONG WITH ALL ASSOCIATED MECHANICAL AND ELECTRICAL ITEMS, UNLESS NOTED OTHERWISE. SEE MECHANICAL AND ELECTRICAL DRAWINGS FOR EXTENT OF
- CONDUIT, PIPING AND DUCTWORK DEMOLITION WITHIN AREA TO BE REMODELED. WHERE INDICATED, REMOVE ALL WALL/PARTITION EXISTING FINISHES AND PREPARE
- THE SURFACES FOR SCHEDULED FINISHES, SEE FINISH SCHEDULE FOR FINISHES. ALL DISTURBED AREAS, WALLS, PARTITIONS, FLOORS, ETC, DAMAGED BY DEMOLITION
- WORK SHALL BE PATCHED TO MATCH ADJACENT AREA.
- OWNER RESERVES THE RIGHT OF FIRST REFUSAL OF ALL SALVAGED ITEMS SUCH AS: DOORS, LIGHT FIXTURES, PLUMBING FIXTURES ETC.
- SALVAGED ITEMS SCHEDULED FOR REUSE SHALL BE CLEANED, RESTORED AND/OR REFINISHED TO LIKE NEW CONDITION, UNLESS NOTED OTHERWISE.
- DO NOT REMOVE ANY EXISTING STRUCTURAL SUPPORT MEMBERS SUCH AS COLUMNS, BEAMS, JOISTS, LOAD-BEARING PARTITIONS ETC, UNTIL ADEQUATE PERMANENT OR TEMPORARY SUPPORT IS IN PLACE. ALL EXISTING STRUCTURAL
- SEE STRUCTURAL, MECHANICAL AND ELECTRICAL DRAWINGS FOR RELATED DEMOLITION AND PREP WORK.

MEMBERS SHALL BE ADEQUATELY PROTECTED, COORDINATE WITH STRUCTURAL

- WALL AND CEILING MOUNTED ITEMS SHOWN DASHED, SUCH AS WALL CABINETS. SHELVING, CUBICLE CURTAIN TRACKS, PROJECTION SCREENS ETC, SHALL BE REMOVED, UNLESS NOTED OTHERWISE.
- WITHIN ALL EXISTING ROOMS/SPACES RECEIVING SCHEDULED FLOOR, OR WALL, OR CEILING FINISHES. REMOVE ALL EXISTING FLOOR. OR WALL. OR CEILING FINISHES DOWN TO THE SUBSTRATE. INCLUDE THE REMOVAL OF ALL ITEMS LOCATED WITHIN THE EXISTING FINISH REMOVALS UNO PATCH AND PREP ALL SUBSTRATES TO RECEIVE SCHEDULED FINISHES. FOR ADDITIONAL INFORMATION, SEE KEYNOTED ITEMS, FINISH PLANS AND/OR SCHEDULES, STRUCTURAL, MECHANICAL AND
- THE ARCHITECTURAL DRAWINGS SHOW PRINCIPAL AREAS AND LIMITS OF CONSTRUCTION WHERE WORK MUST BE ACCOMPLISHED UNDER THIS CONTRACT WORK MUST BE ACCOMPLISHED IN AREAS NOT SHOWN ON ARCHITECTURAL DRAWINGS DUE TO CHANGES AFFECTING ELECTRICAL, MECHANICAL, PLUMBING AND TECHNOLOGY ALONG WITH OTHER SYSTEMS. THIS WORK SHALL BE PART OF THIS CONTRACT, AND ALL TRADES SHALL INSPECT THESE AREAS, ASCERTAIN WORK REQUIRED AND DO THE WORK IN ACCORDANCE OF CONTRACT REQUIREMENTS AT NO ADDITIONAL COST. SEE MECHANICAL, ELECTRICAL, PLUMBING AND TECHNOLOGY PLANS FOR ADDITIONAL WORK


DEMOLITION PLAN KEYED NOTES


- REMOVE FLOOR FINISH IN ITS ENTIRETY. PATCH & PREP FLOOR FOR SCHEDULED FINISH. SEE SPECIFICATION SECTION 09 05 16 SUBSURFACE
- PREPARATION FOR FLOOR FINISHES REMOVE CEILING IN ITS ENTIRETY. INCLUDING ALL MECHANICAL & DE2 ELECTRICAL ITEMS. SEE MECHANICAL / ELECTRICAL.
- REMOVE GYP BD ON ONE SIDE OF PARTITION AS REQUIRED. SEE PLANS AND MECHANICAL / ELECTRICAL PLANS FOR ADDITIONAL INFORMATION
- CUT OPENING IN PARTITION AS REQUIRED FOR INSTALLATION OF DOOR AND FRAME AS SCHEDULED. SEE PLAN
- REMOVE PORTION OF CEILING AS REQUIRED. SEE PLANS FOR ADDITIONAL INFORMATION
- REMOVE PLUMBING FIXTURE AND ALL ASSOCIATED PIPING. -SEE MEP DE6 DRAWINGS FOR ADDITIONAL INFORMATION
- REMOVE BASE CABINETS, UPPER CABINETS, TALL CABINETS AND/ OR
- REMOVE CEILING IN THIS AREA AS REQUIRED FOR MEP WORK. SALVAGE CEILING WHERE APPROPRIATE FOR REINSTALLATION. SEE PLANS FOR
- ADDITIONAL WORK
- DE9 REMOVE CONDUITS THOUGH FLOOR. SEE PLAN FOR ADDITIONAL INFORMATION
- REMOVE PARTITION MOUNTED MIRROR AND ALL ASSOCIATED HARDWARE. ©E10 SALVAGE FOR REINSTALLATION
- REMOVE SURFACE MOUNTED PLYWOOD. TEMPORARILY SUPPORT ANY EQUIPMENT. SEE ELECTRICAL AND TECHNOLOGY DRAWINGS FOR ADDITIONAL INFORMATION
- (DE12) REMOVE COVED CONCRETE BASE AT PARTITION.
- REMOVE PREMANUFACTURED PLASTIC LOCKER(S). SALVAGE FOR
- REMOVE RAISED FLOOR SYSTEM IN ITS ENTIRETY AND METAL RAMP


REMOVE PORTION OF MEMBRANE ROOFING SYSTEM. SEE FLOOR/ROOF


- PLAN FOR ADDITIONAL INFORMATION REMOVE PORTION OF MEMBRANE ROOFING SYSTEM, IN PREPARATION
- FOR RESLOPING AND REROOFING. SEE FLOOR/ROOF PLAN FOR ADDITIONAL INFORMATION
- REMOVE ROOF DRAIN AND ASSOCIATED PIPING. SEE MECHANICAL FOR ADDITIONAL INFORMATION
- REMOVE METAL LOUVER AND ALL ASSOCIATED MOUNTING HARDWARE. SEE MECHANICAL FOR ADDITIONAL INFORMATION
- CUT OPENING IN BRICK AND METAL STUD BACK UP WALL FOR DOOR AND
- FRAME AS SCHEDULED. SEE FLOOR PLAN FOR ADDITIONAL INFORMATION (DE20) REMOVE PARTIAL HEIGHT CERAMIC TILE AT SINK
- (DE21) REMOVE METAL RADIATOR COVER
- REMOVE SURFACE APPLIED WALL COVERING, TRIM, VINYL BASE AND / OR CRASH / HAND RAIL AS NEEDED.
- REMOVE DOOR, FRAME AND ALL ASSOCIATED HARDWARE. SALVAGE FOR REINSTALLATION. SEE PLAN
- REMOVE ALUMINUM WINDOW SYSTEM AND ALL ASSOCIATED HARDWARE. REMOVE CAST STONE SILL, EXTERIOR, AND SOLID SURFACE SILL,
- CUT OPENING IN PARTITION AS REQUIRED FOR INSTALLATION OF EDGE ILLUMINATED PHOTO MURALS
- SAW CUT FACE BRICK AND REMOVE PORTION OF WALL. SEE PLAN FOR ADDITIONAL INFORMATION
 - NOTE: NOT ALL KEYED NOTES MAY BE USED ON EACH PLANORK WITH ABATEMENT AND REMEDIATION WORK.


Project Number Drawing Title ARCHITECT/ENGINEER OF RECORD | STAMP CONSULTANT Office of VAMC SIOUX FALLS EHRM 438-20-910 FIRST LEVEL ENLARGED BID DOCUMENTS Construction and Facilities **Building Number** INFRASTRUCTURE UPGRADES DEMOLITION & FLOOR PLAN -**S**PECIALIZED ANDERSON BUILDING 5 **ENGINEERING** Drawing Number Management Sioux Falls, SD **FULLY** Checked Drawn 13605 1st Ave. N. #100 Plymouth, MN 55441 U.S. Department of Veterans AE111.2-05 SPRINKLERED Phone: 402.991.5520 P 763.412.4000 | F 763.412.4090 | ae-mn.com 10360 Ellison Circle 02/18/2022 Checker | Author www.specializedeng.com Anderson Engineering of Minnesota, LLC | Proj # 16090 Revisions: VA FORM 08 - 6231

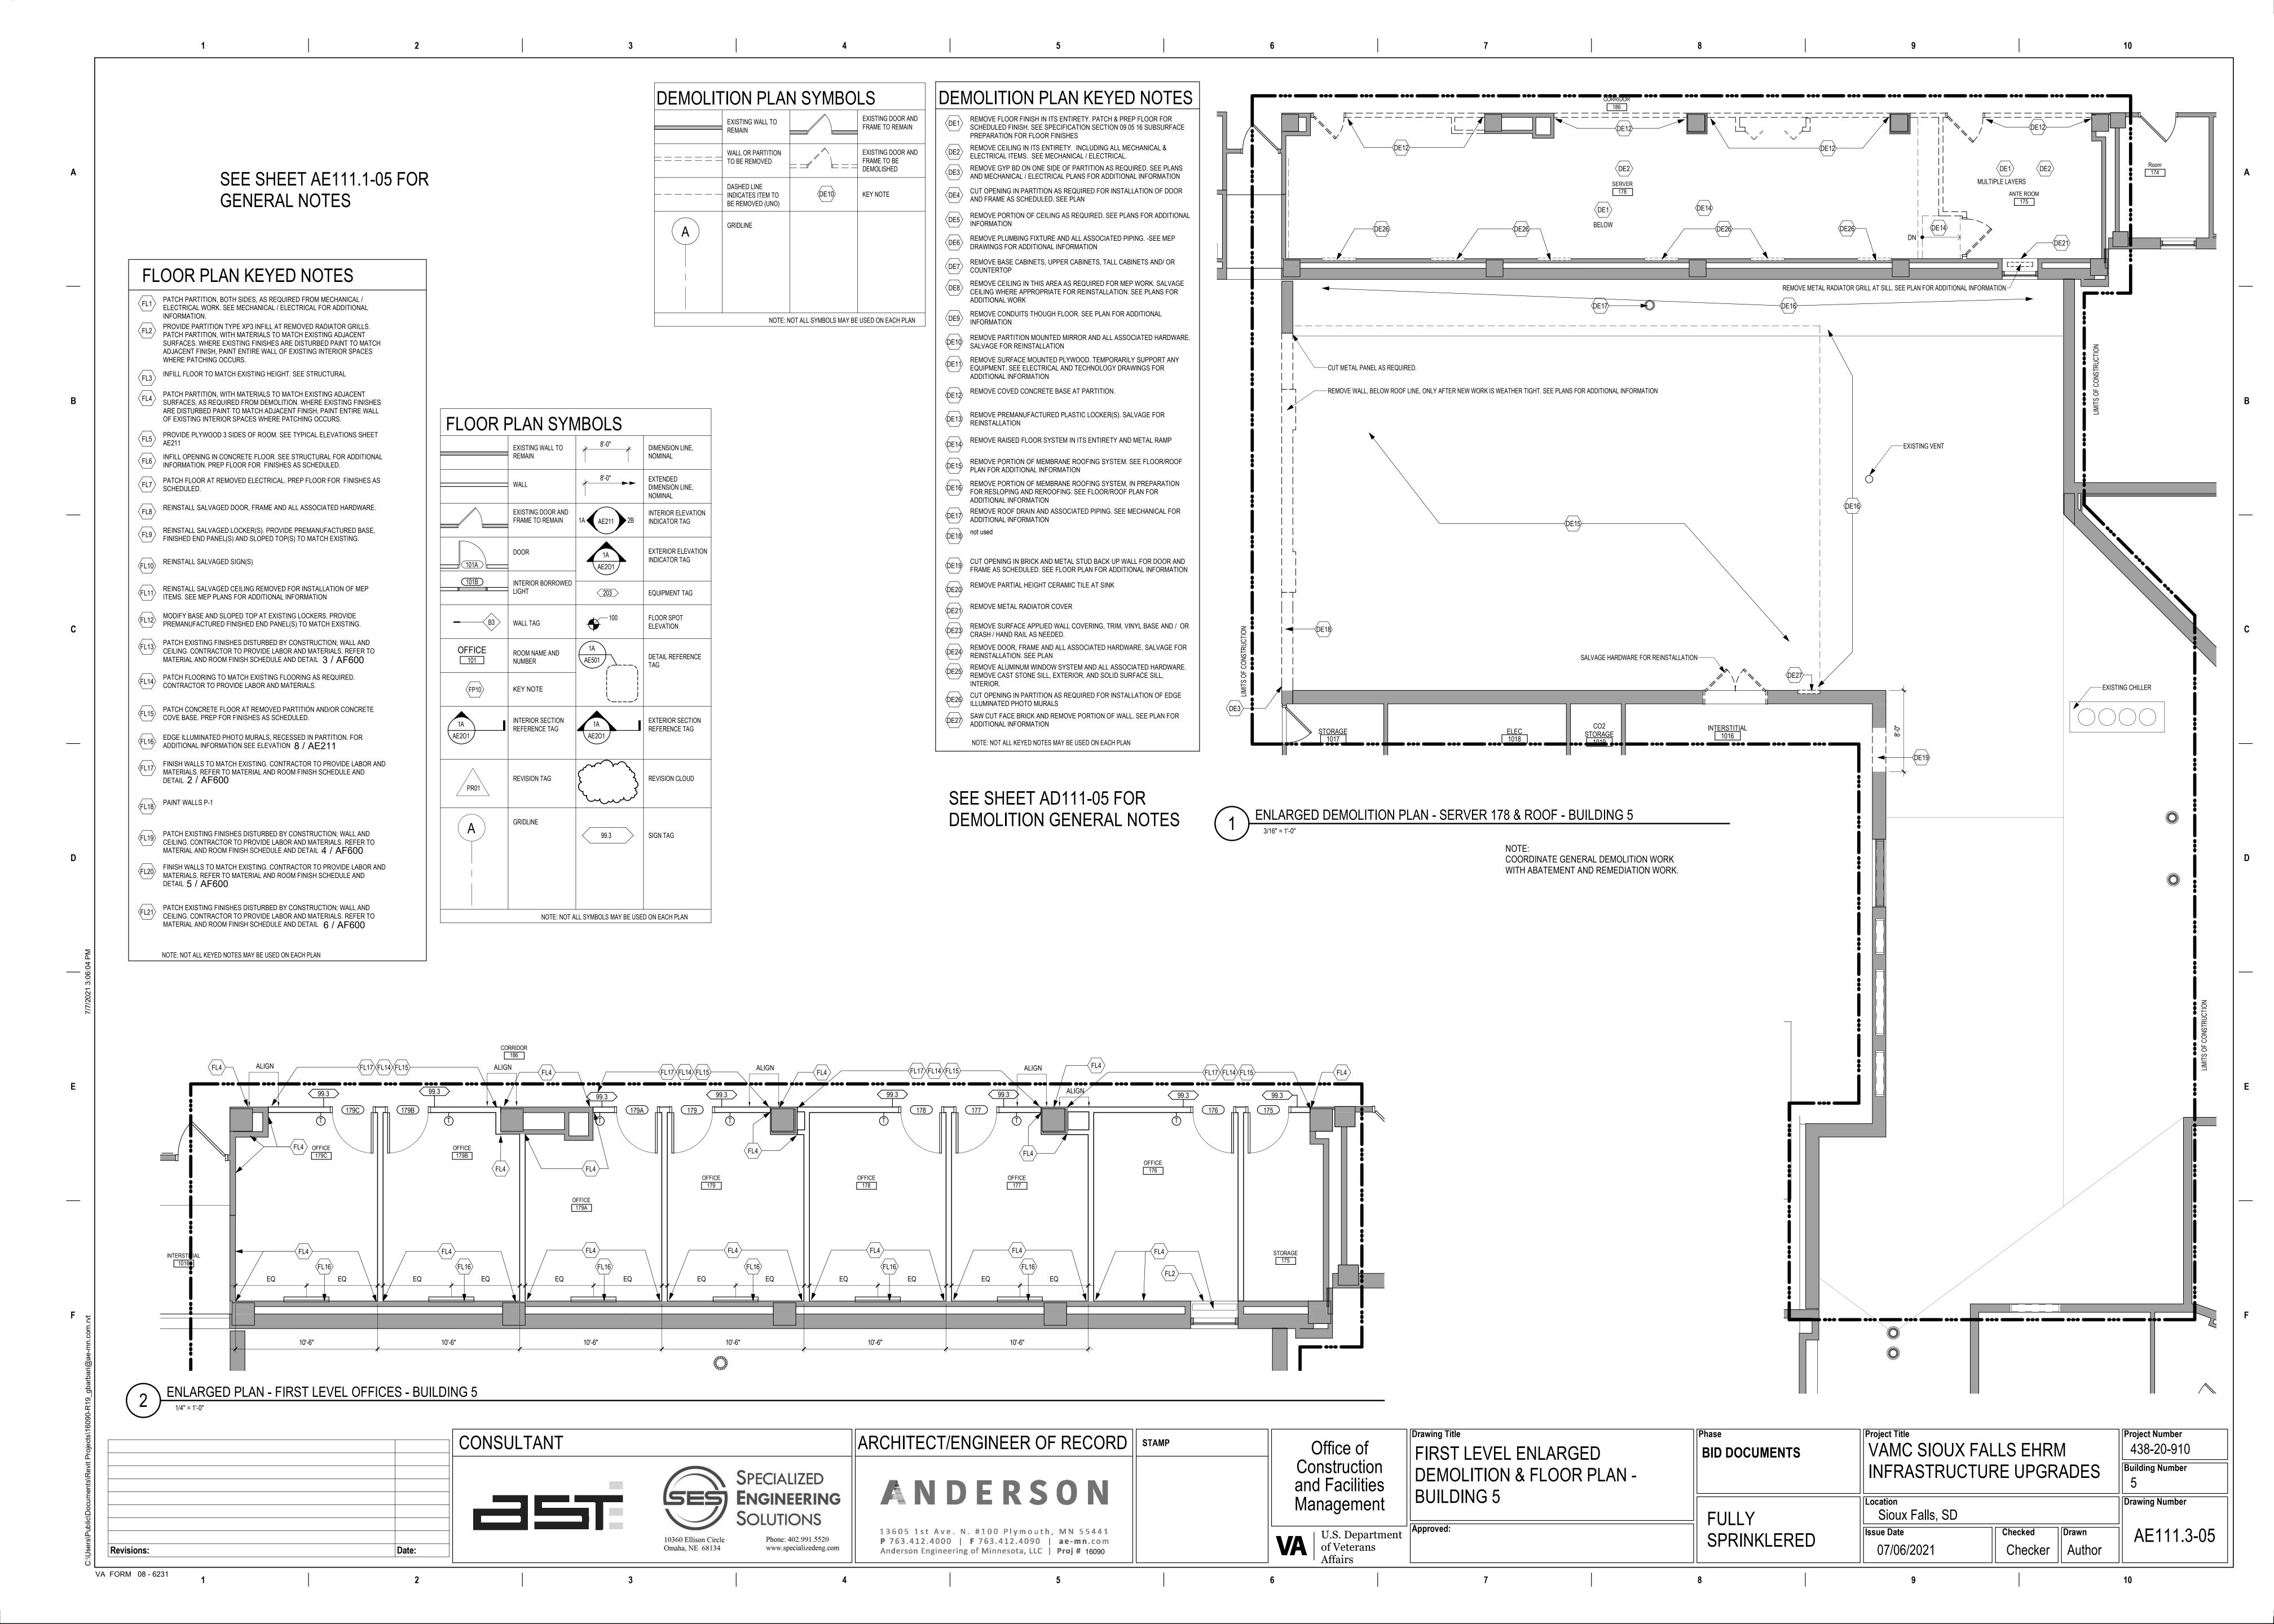

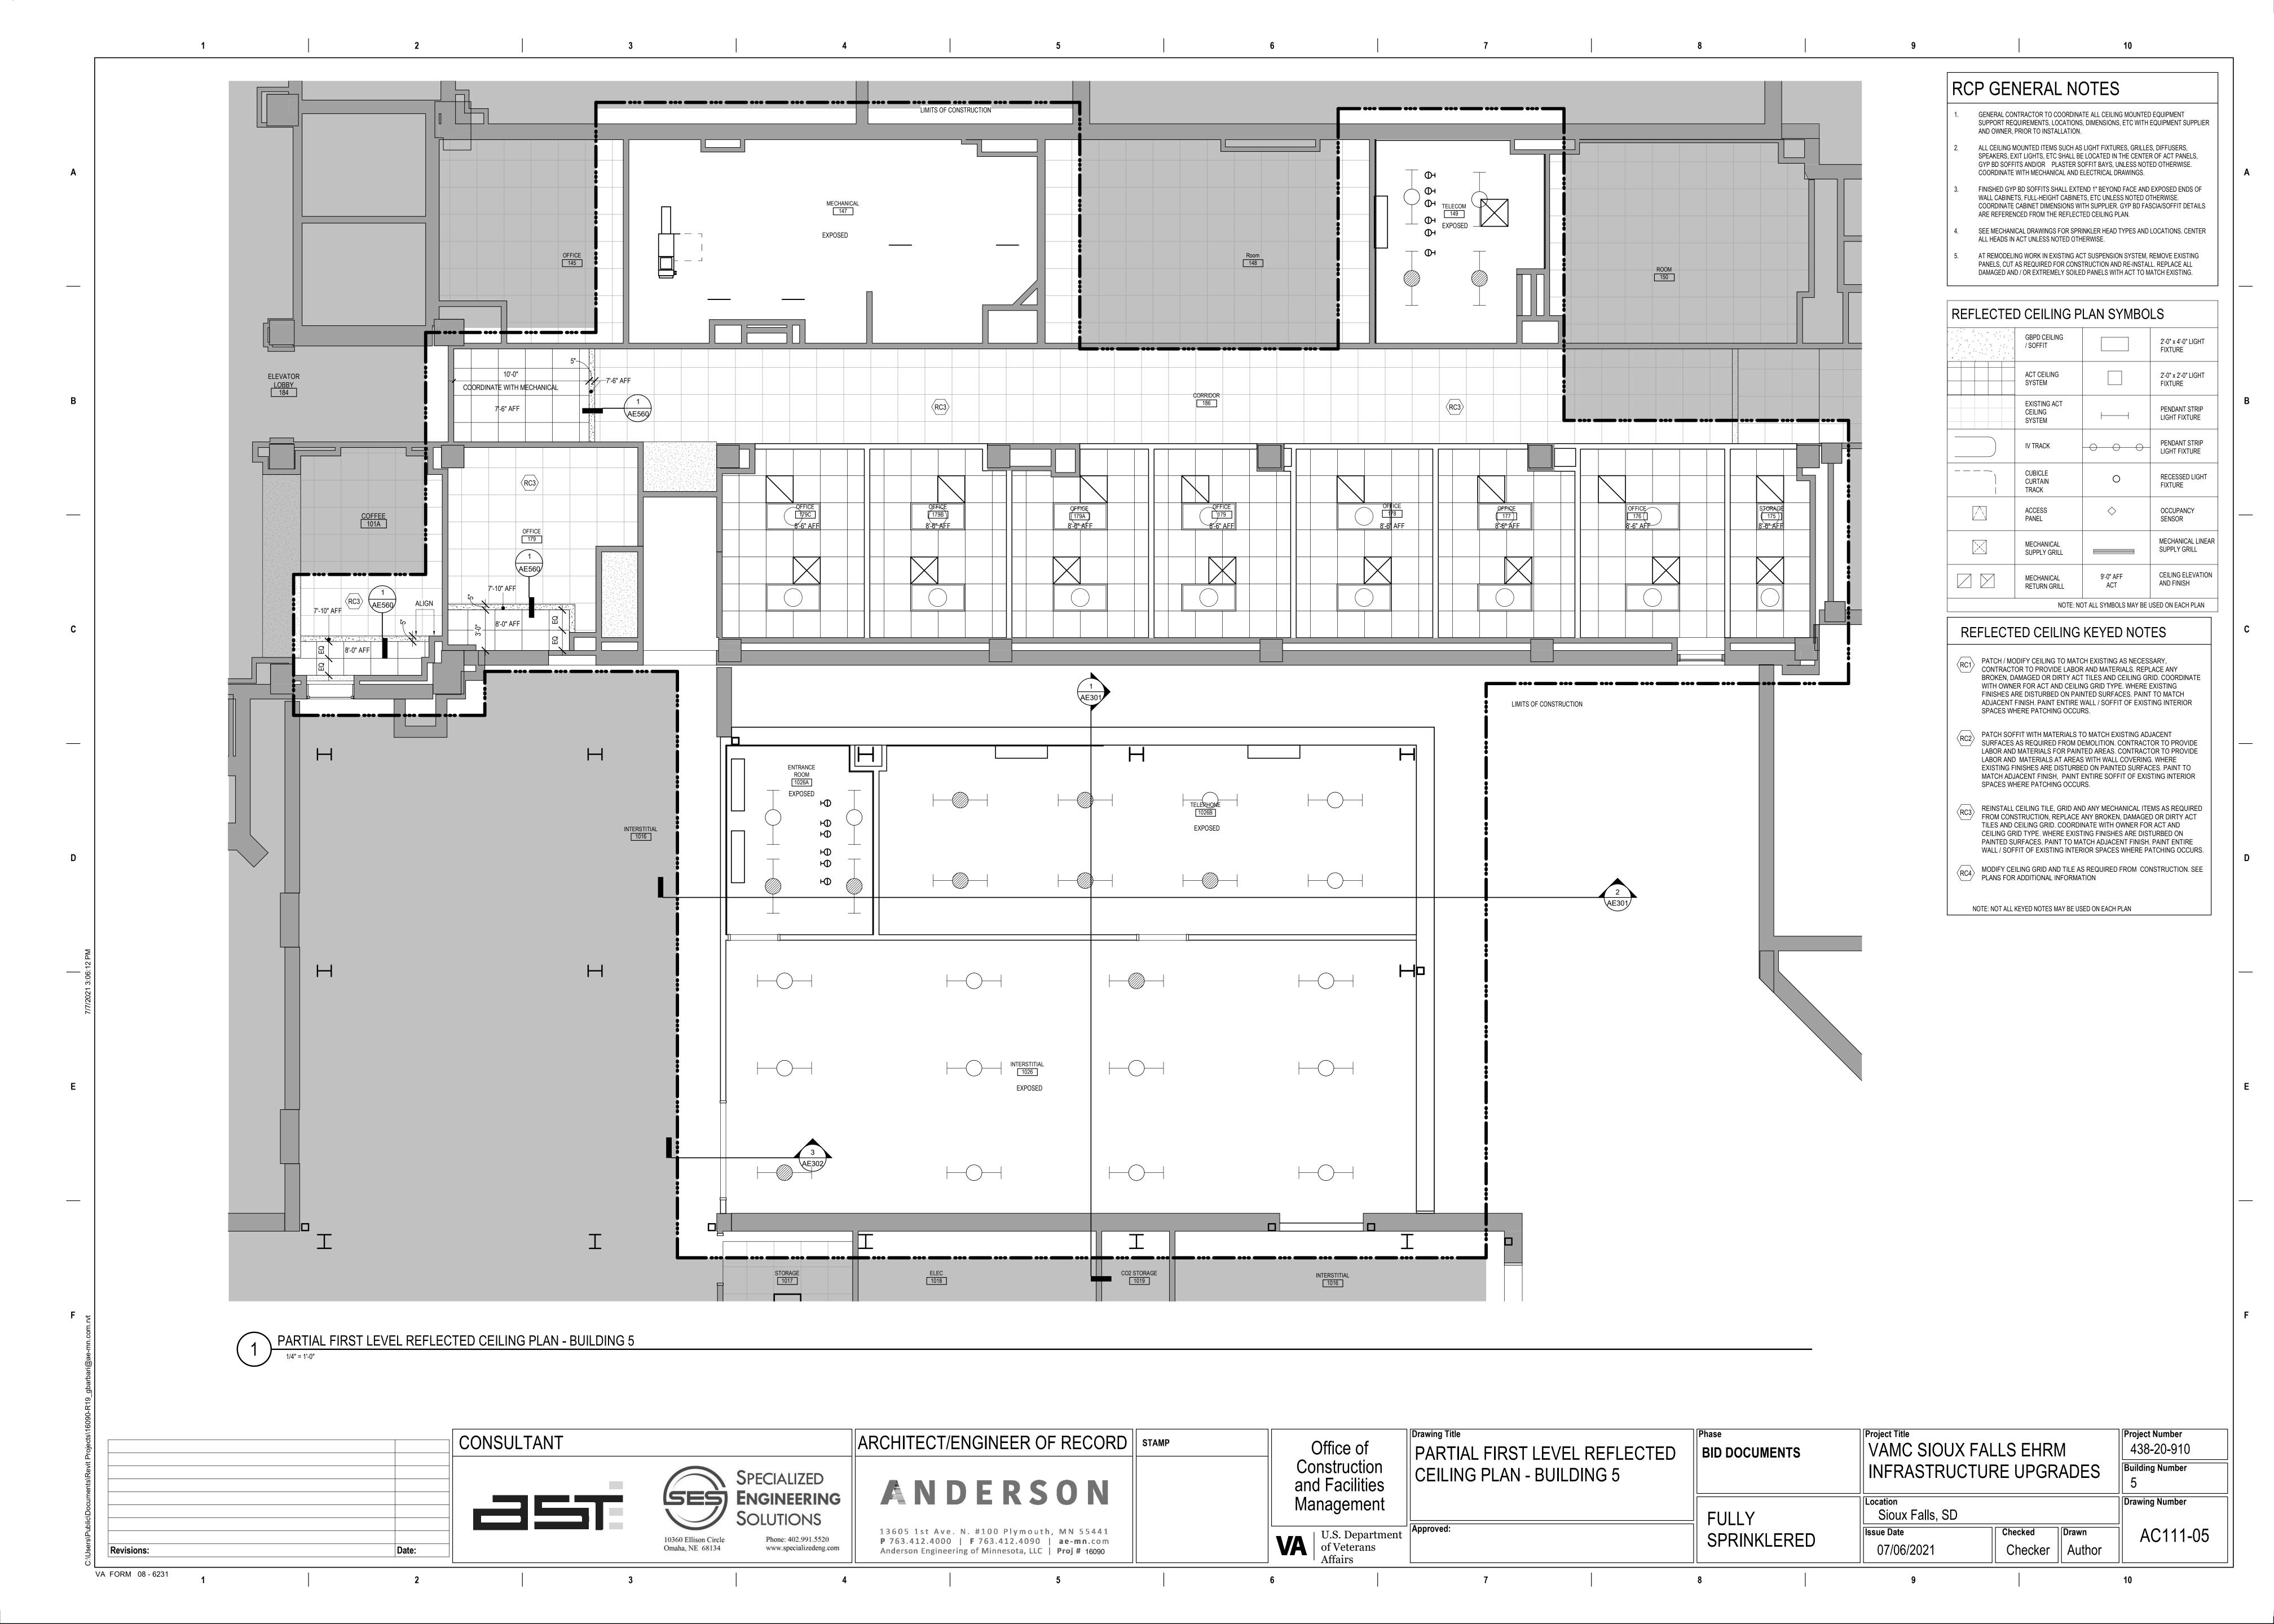

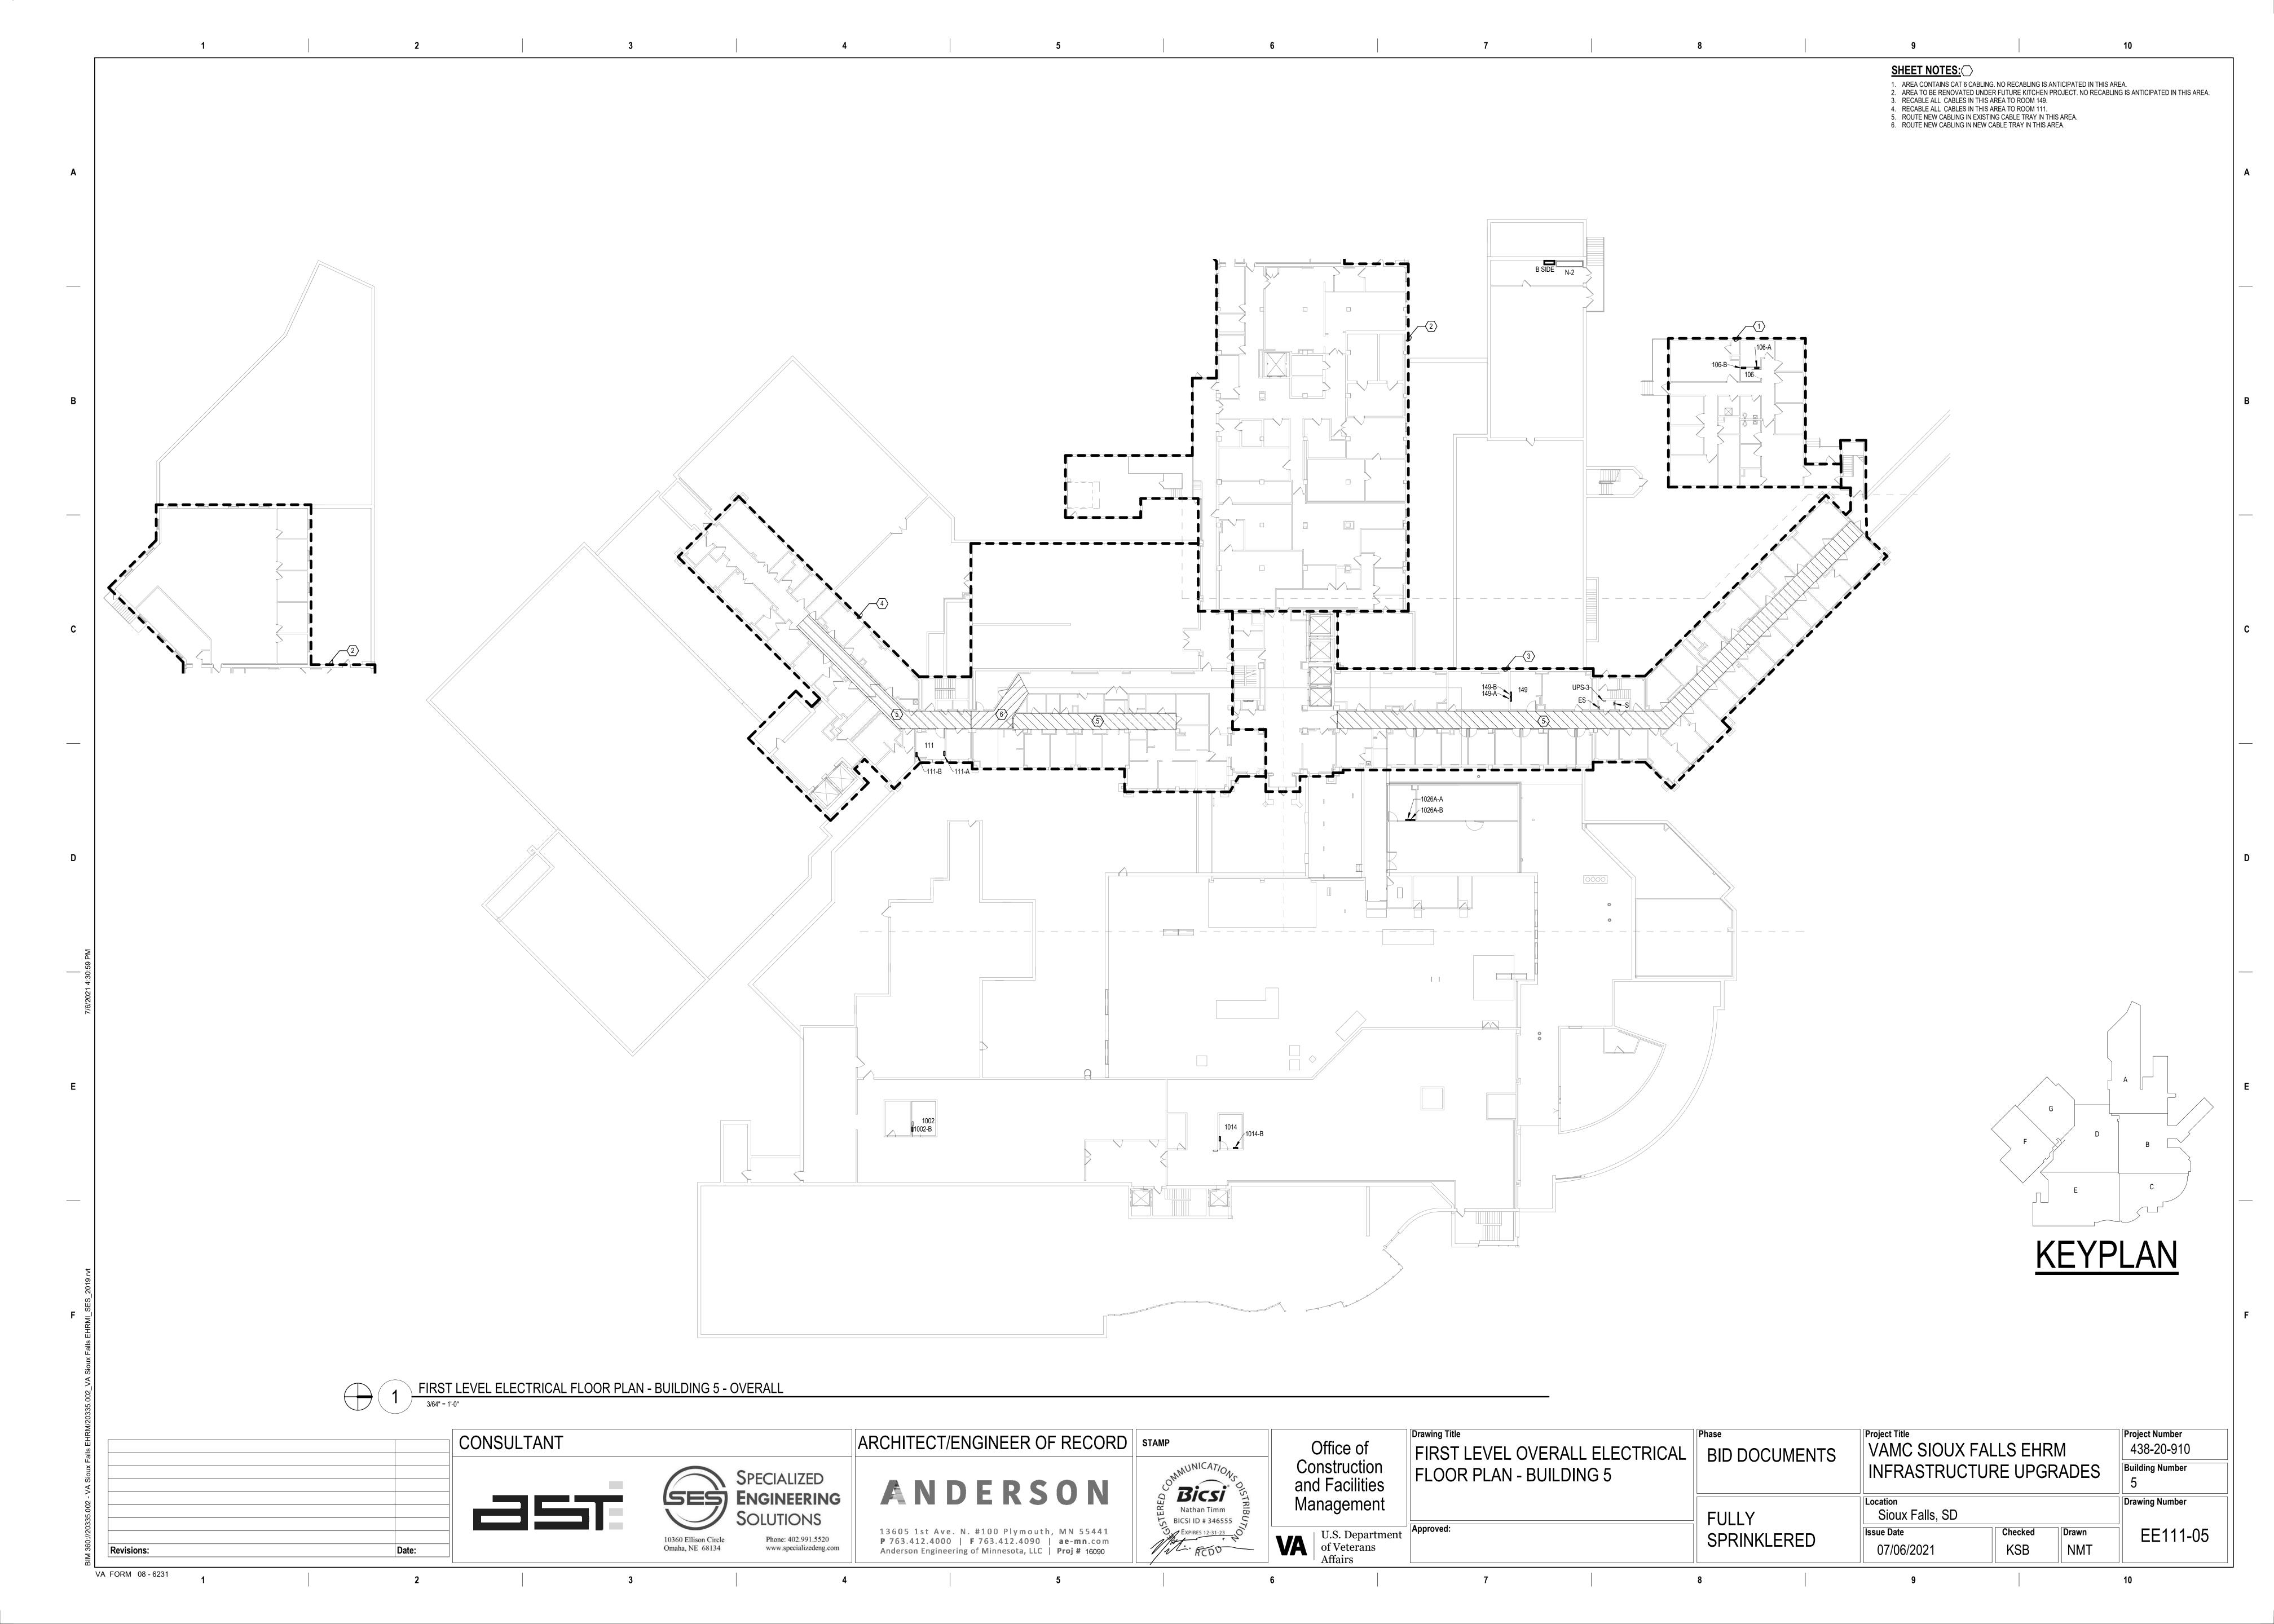

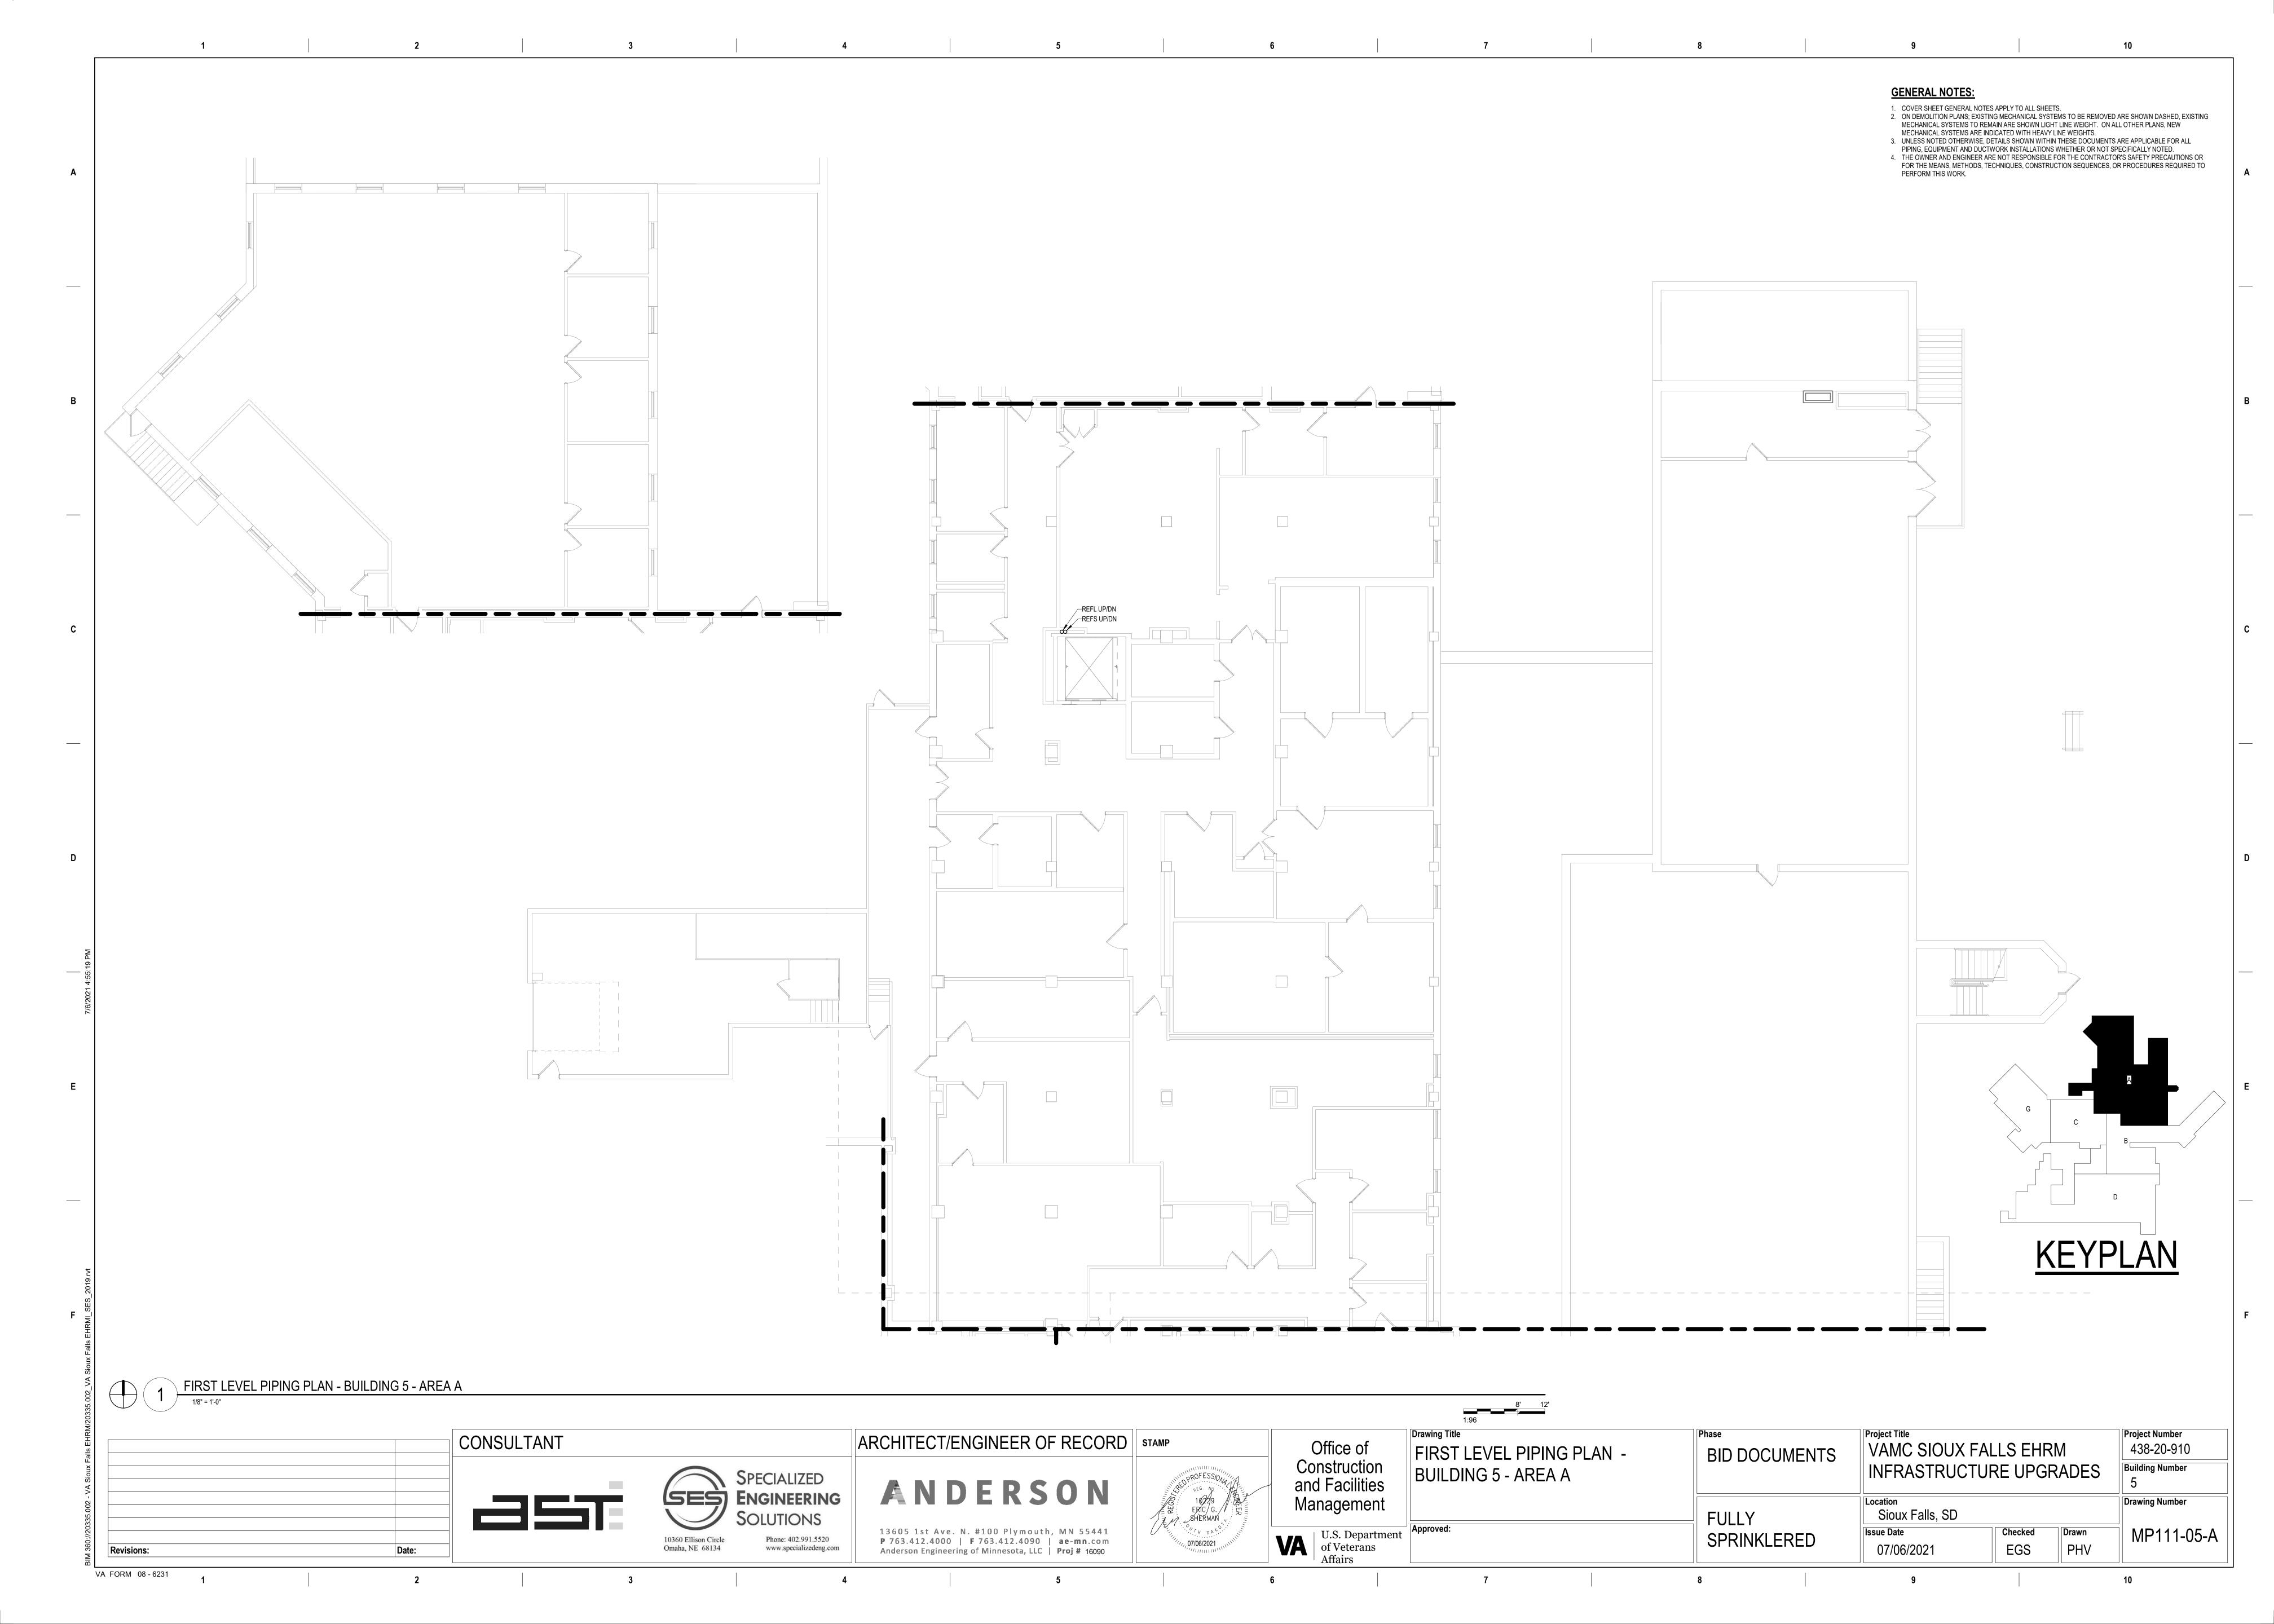


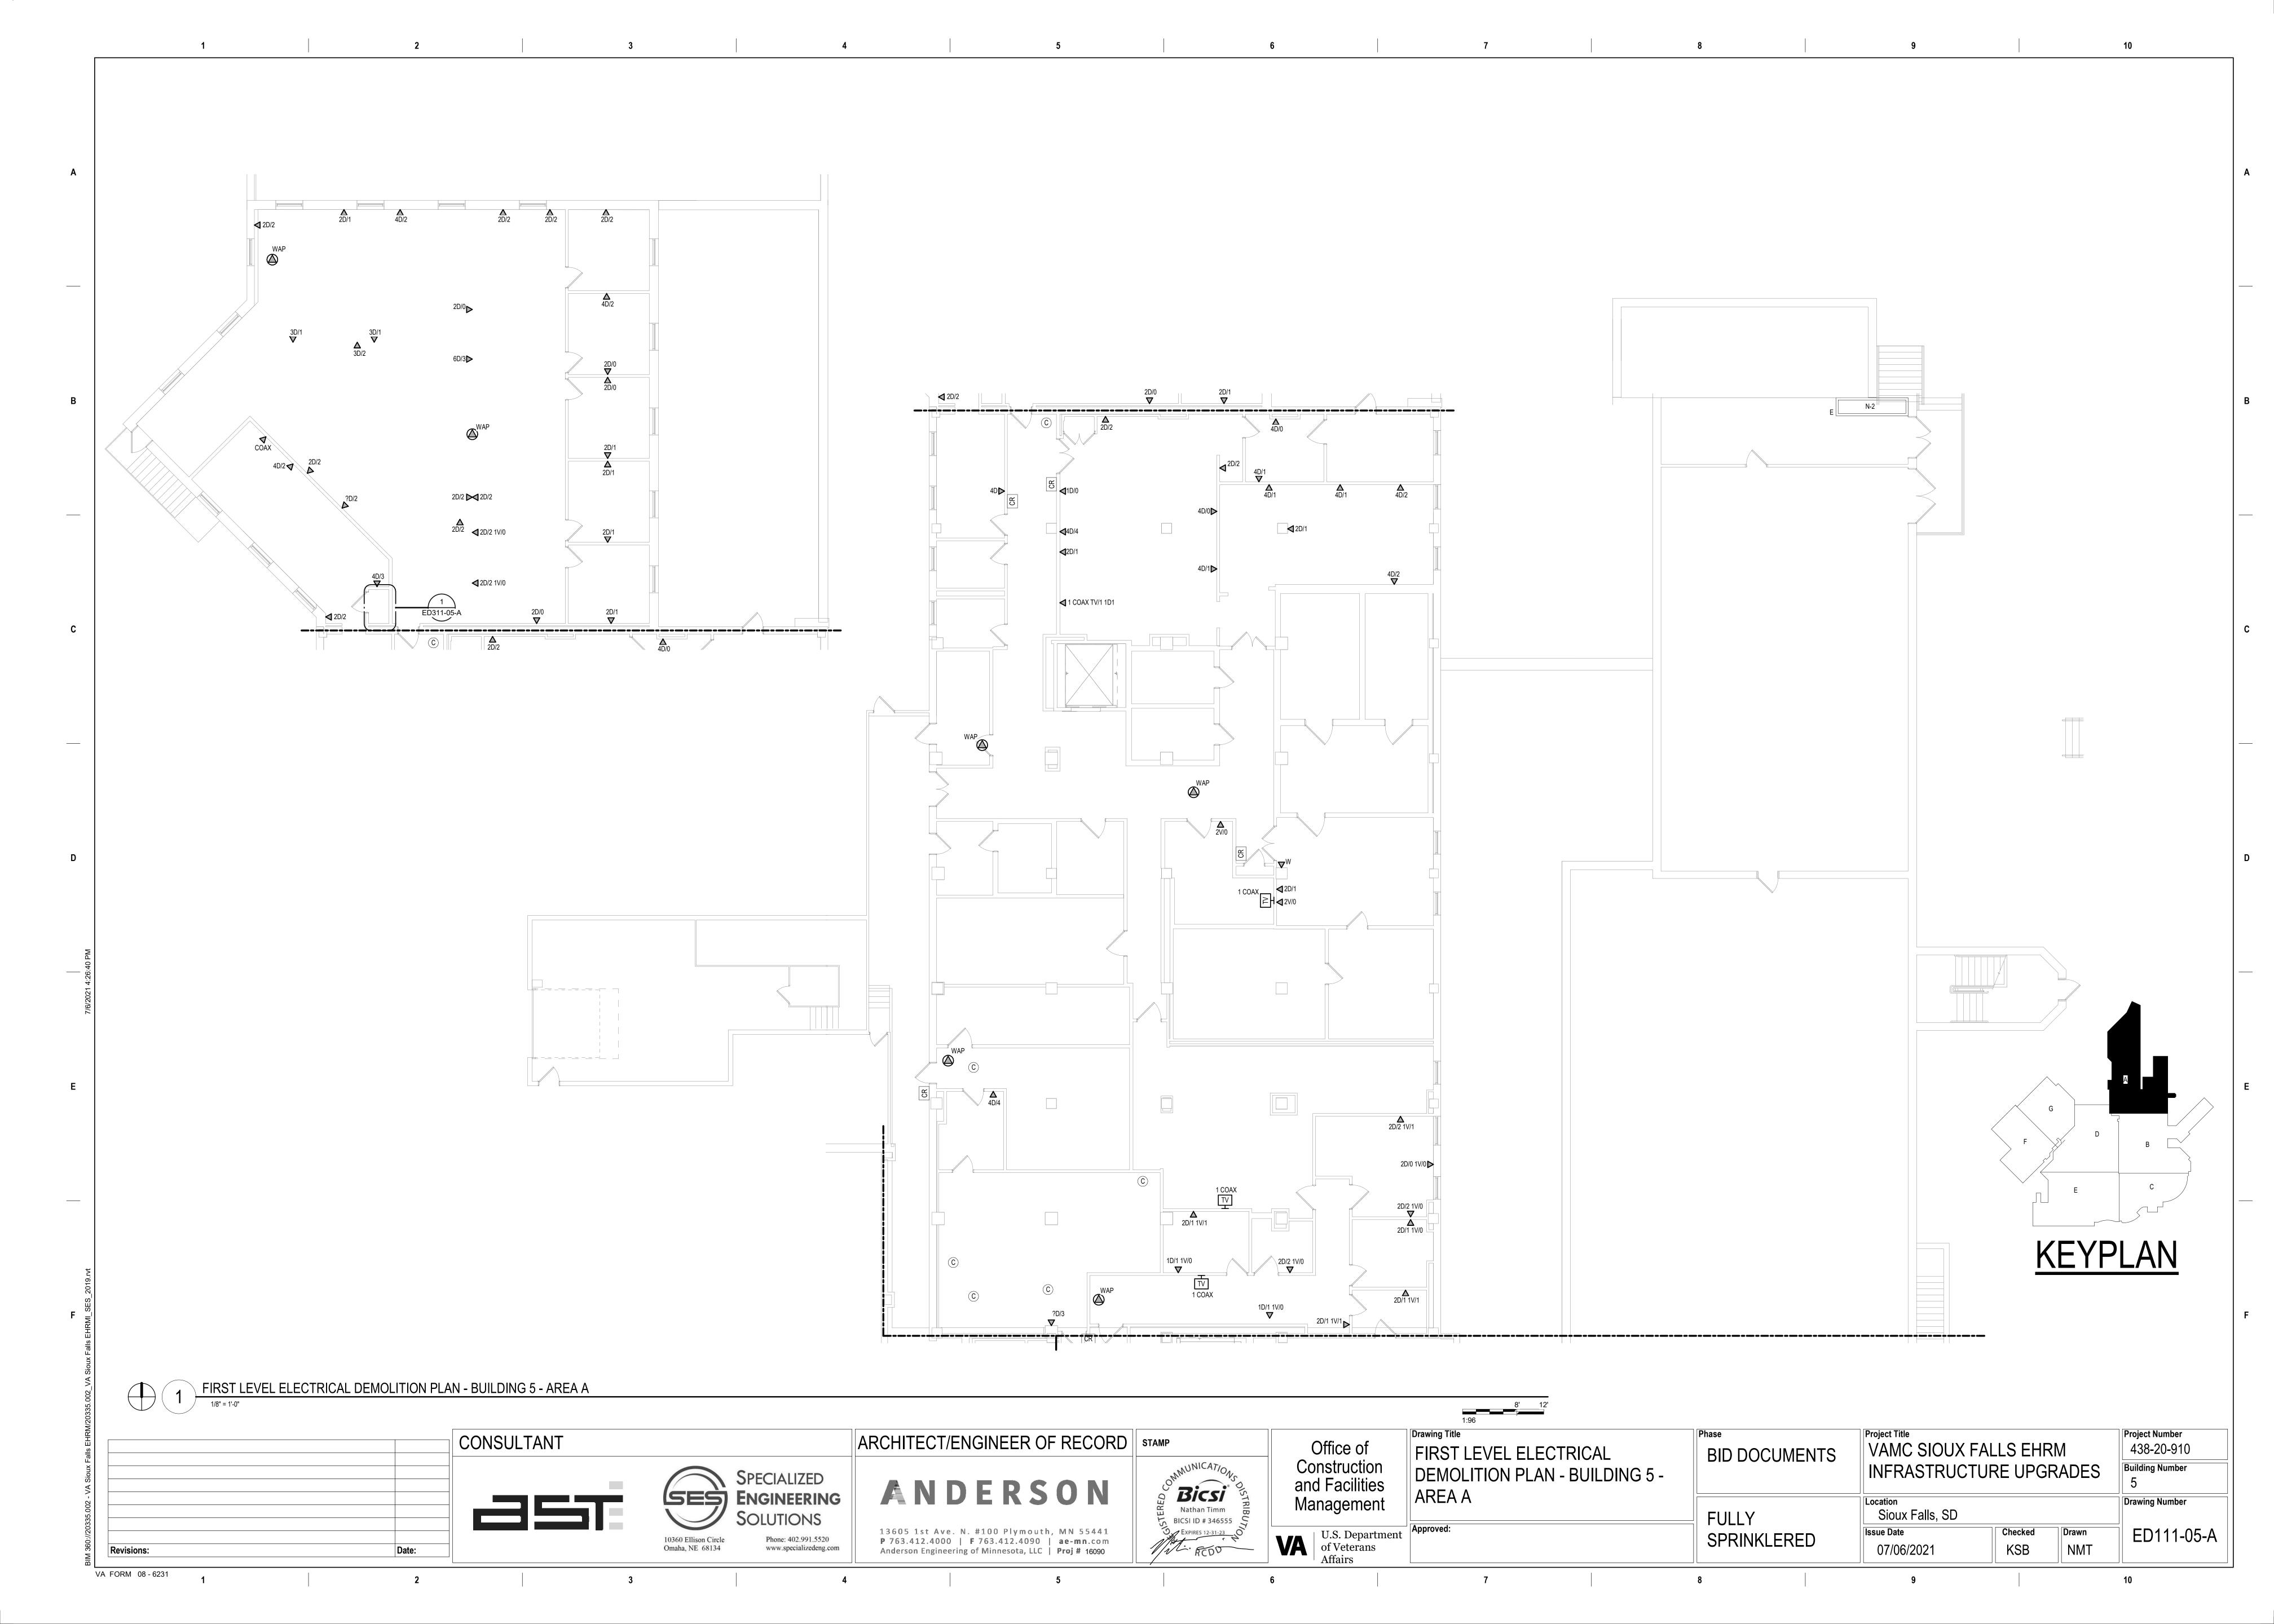

CABLING NOTES: A. THE EXISTING CABLE COUNT ARE THE CABLES CURRENTLY PRESENT IN THE SPACE. THE CABLE RELOCATION COUNT ARE THE NEW OR RELOCATED CABLES TO BE FED FROM THE SPACE. THE FINAL CABLE COUNT ARE THE CABLES THAT WILL BE PRESENT IN THE SPACE AT THE COMPLETION OF THE PROJECT. REMOVE ALL UNUSED CABLING AT THE COMPLETION OF THE PROJECT. 1. ROOM 195B EXISTING CABLE COUNT DATA (CAT6): 144 DATA (CAT5): 13 PATIENT MONITORING: 0 COMMERCIAL WIRELESS: 0 CABLE RELOCATION COUNT DATA (CAT6): -144 TO ROOM 296 DATA (CAT5): -13 TO ROOM 296 PATIENT MONITORING: 0 COMMERCIAL WIRELESS: 0 EXISTING CABLE TO REMAIN DATA (CAT6): 0 VIDEO: 0 PATIENT MONITORING: 0 COMMERCIAL WIRELESS: 0 FINAL CABLE COUNT DATA (CAT6): 0 PATIENT MONITORING: 0 COMMERCIAL WIRELESS: 0 SHEET NOTES: 1. EXISTING TELEPHONE WALL FIELD TO BE DEMOLISHED. NEW COPPER BACKBONE TO BE PROVIDED ON PATCH PANELS IN TELECOMMUNICATIONS RACK. REFER TO CABLING NOTES AND NEW WORK PLANS FOR ADDITIONAL REQUIREMENTS. FIRST LEVEL ELECTRICAL DEMOLITION - BUILDING 5 - AREA A - ROOM 195B Drawing Title Project Title Project Number CONSULTANT ARCHITECT/ENGINEER OF RECORD | STAMP Office of VAMC SIOUX FALLS EHRM 438-20-910 FIRST LEVEL ELECTRICAL **BID DOCUMENTS** Construction and Facilities **Building Number** INFRASTRUCTURE UPGRADES DEMOLITION - BUILDING 5 -SPECIALIZED Bicsi ANDERSON ENLARGED ROOMS - AREA A SES ENGINEERING Drawing Number Management Sioux Falls, SD **FULLY** 5 BICSI ID # 346555 13605 1st Ave. N. #100 Plymouth, MN 55441

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Anderson Engineering of Minnesota, LLC | Proj # 16090 EXPIRES 12-31-23 Checked Drawn U.S. Department of Veterans Affairs ED311-05-A SPRINKLERED 10360 Ellison Circle Phone: 402.991.5520 KSB 07/06/2021 NMT Omaha, NE 68134 www.specializedeng.com Revisions: VA FORM 08 - 6231

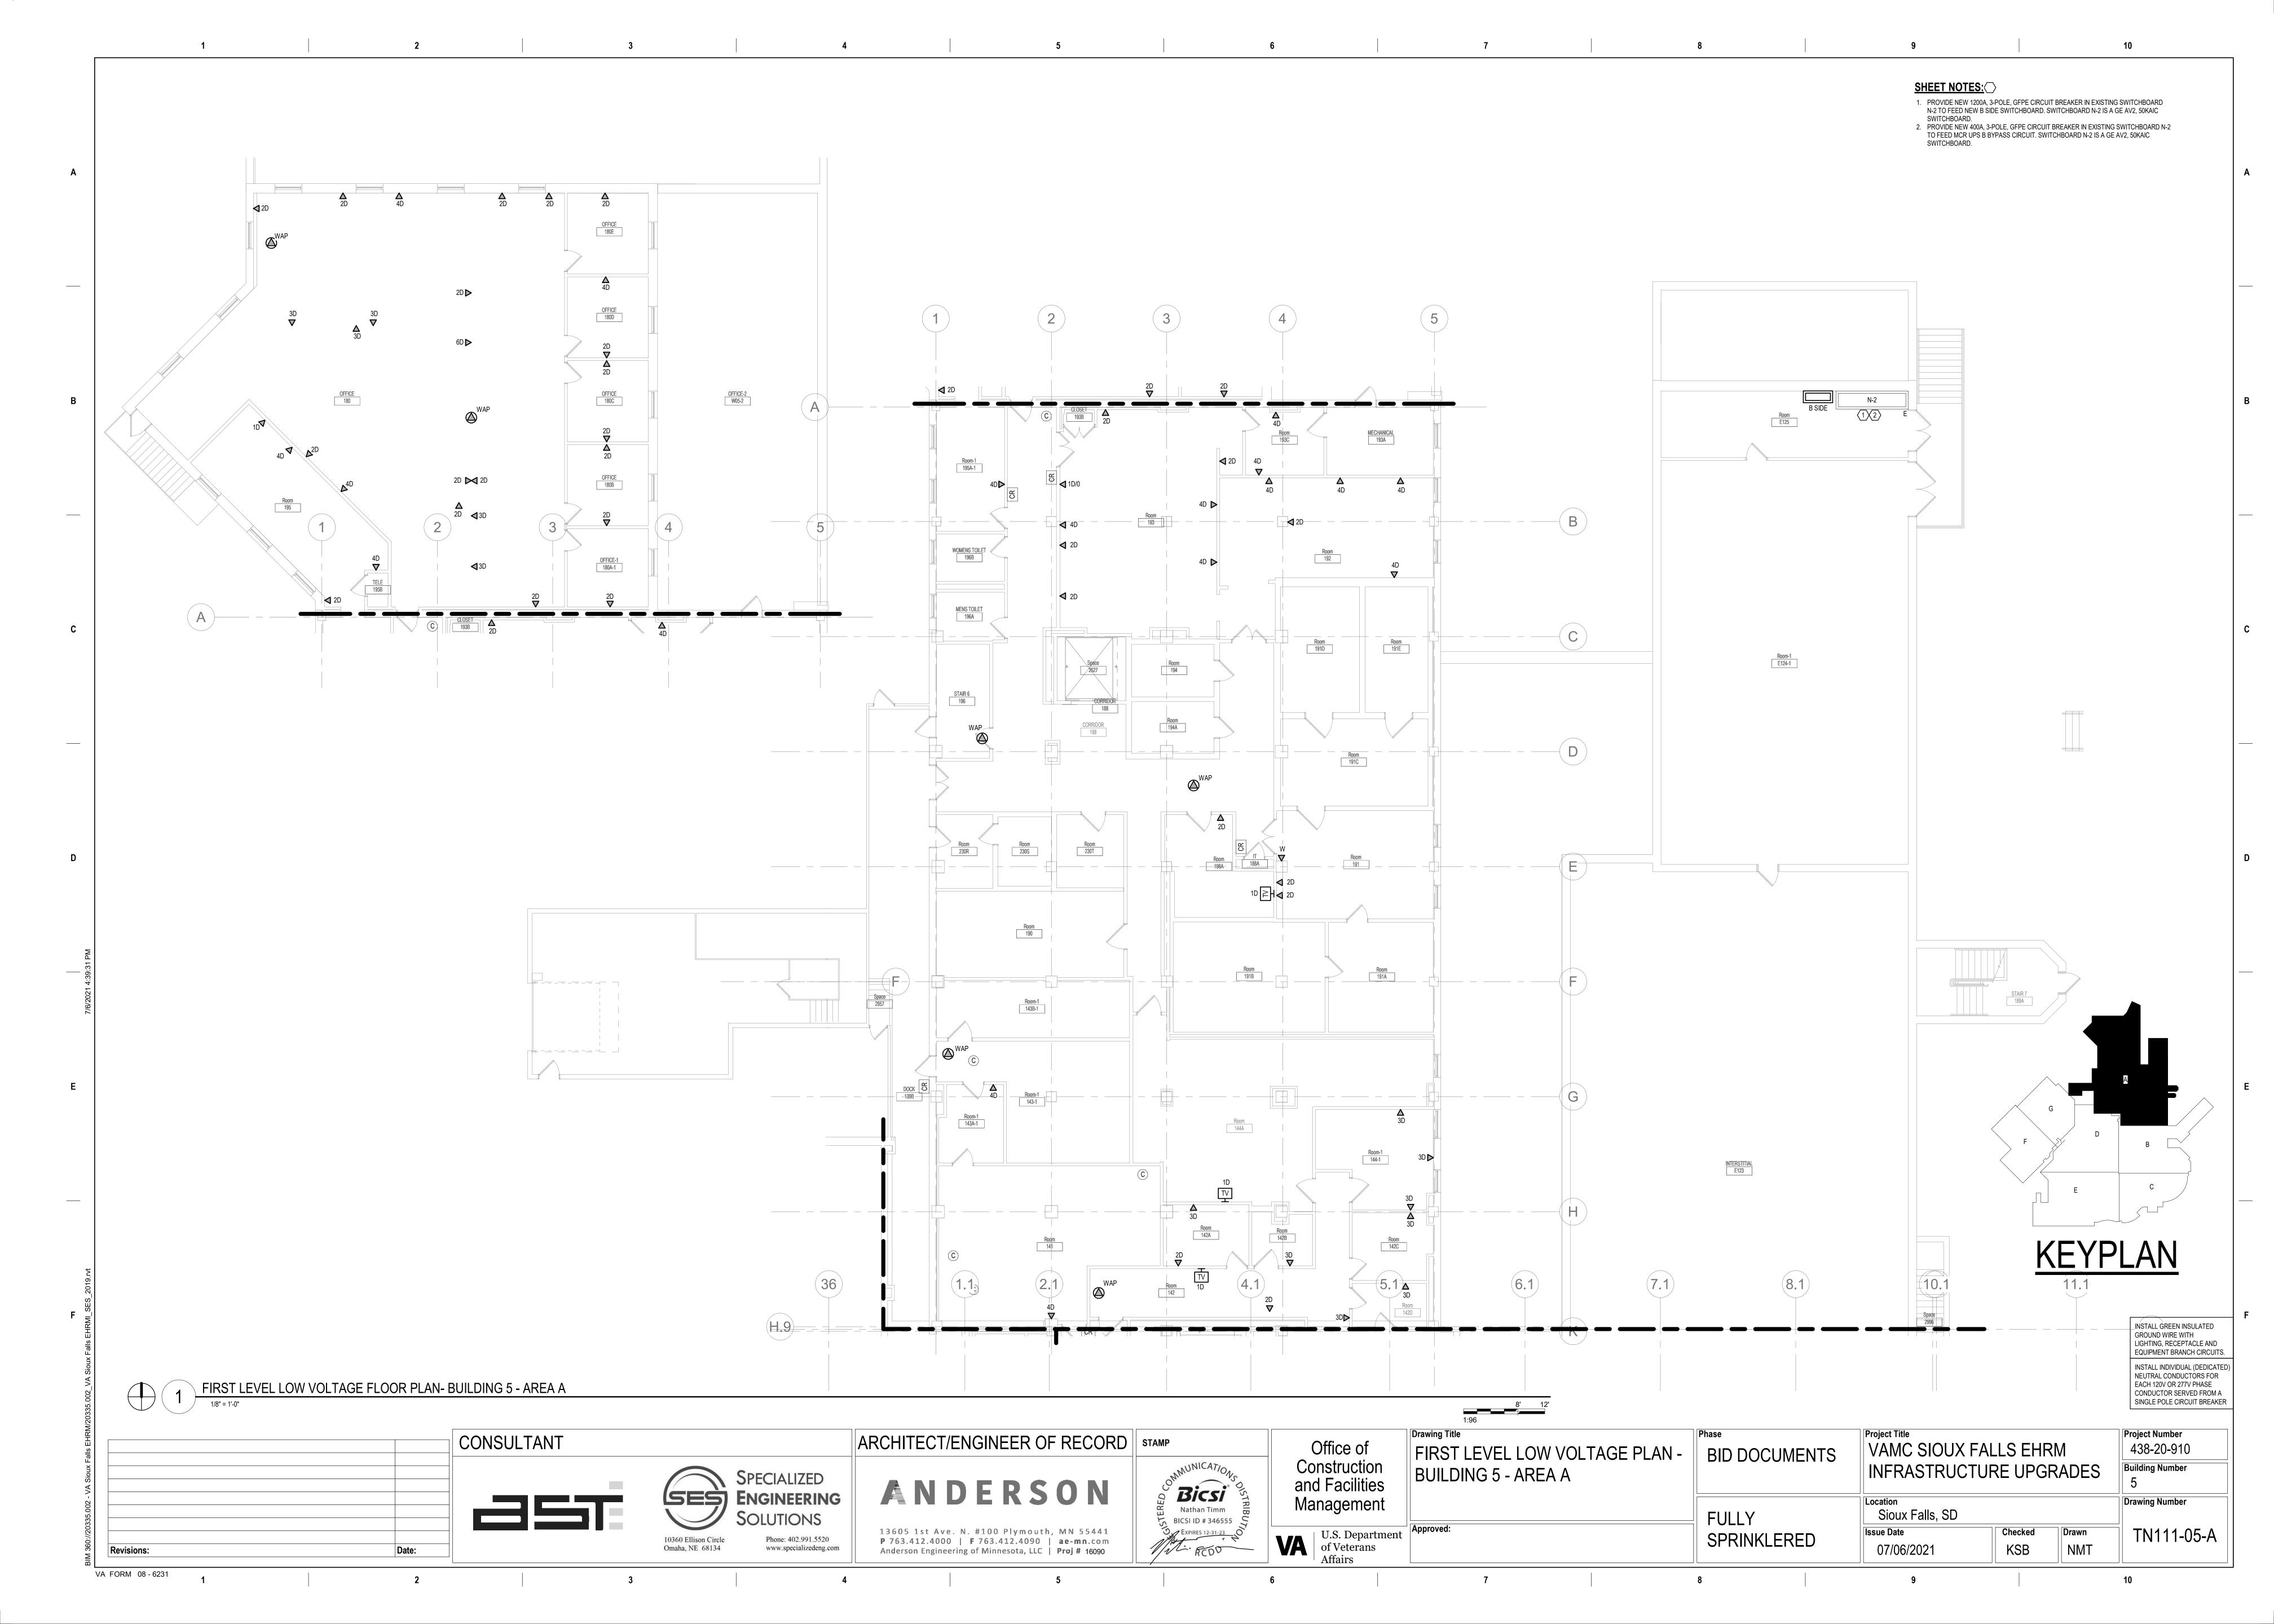

LOCATION: Room E125 **VOLTS:** 480/277 WYE MAINS TYPE: MCB SUPPLY FROM: N-2 PHASES: 3 MCB/MLO RATING: 1200 A **BRANCH:** NORMAL WIRES: 4 MCB OPTIONS: GFP, ERMS INTEGRAL SPD: Yes SERVICE RATED: No **AVAILABLE SCC (kA):** 48.9 CIRCUIT DESCRIPTION OPT POLES RATING LOAD CIRCUIT REMARKS 3 80 A 49799 VA 1 CRAC-3 MAIN SERVER ROOM 201 3 80 A 49799 VA 2 CRAC-4 MAIN SERVER ROOM 201 3 15 A 5820 VA 3 15 A 5820 VA 5 MCR UPS B -- 3 400 A 241933 VA 3 225 A 205278 VA 3 225 A 197047 VA 6 B1 VIA T-B1 7 B2 VIA T-B2 -- 3 80 A 0 VA -- 3 100 A 0 VA -- 3 400 A 0 VA **Total VA:** 755496 VA **Total A:** 909 A LOAD CLASSIFICATION CONNECTED LOAD DEMAND FACTOR ESTIMATED DEMAND PANEL TOTALS CONNECTED LOAD: 755496 VA 100.00% 241933 VA CONNECTED CURRENT: 909 A **DEMAND LOAD:** 588074 VA 79.24% 144563 VA **DEMAND CURRENT:** 707 A 132113 VA 109.42% 51.38% **CONSIDER 125% DEMAND:** 735093 A EQUIPMENT AMPS: 1200 A SPARE CAPACITY: 41 493 A CIRCUIT BREAKER OPTIONS SUFFIX: 'S' OR 'ST' - PROVIDE SHUNT TRIP CIRCUIT BREAKER / 'G' OR 'GFCI' - PROVIDE GFCI CIRCUIT BREAKER / 'GFP' -PROVIDE GFP CIRCUIT BREAKER / 'ERMS' - ENERGY REDUCING MAINTENANCE SWITCH / 'ZSI' - ZONE SELECTIVE INTERLOCKING / 'L' - PROVIDE CIRCUIT BREAKER WITH LOCKING PROVISIONS A. PANEL AIC (INTERRUPTING) RATING SHALL BE MINIMUM 120% OF THE AVAILABLE SCC (SHORT CIRCUIT CURRENT).

ARCHITECT/ENGINEER OF RECORD | STAMP ANDERSON 13605 1st Ave. N. #100 Plymouth, MN 55441 P 763.412.4000 | F 763.412.4090 | ae-mn.com

Office of Construction and Facilities Management

Drawing Title PANEL SCHEDULES - BUILDING 5 -FIRST LEVEL - AREA A

Project Title VAMC SIOUX FALLS EHRM **BID DOCUMENTS** INFRASTRUCTURE UPGRADES Location Sioux Falls, SD **FULLY**

Building Number Drawing Number Checked Drawn EE411-05-A KSB 07/06/2021 NMT

Revisions:

VA FORM 08 - 6231

Omaha, NE 68134 www.specializedeng.com

CONSULTANT

SPECIALIZED ENGINEERING

10360 Ellison Circle


Phone: 402.991.5520


Anderson Engineering of Minnesota, LLC | Proj # 16090


U.S. Department of Veterans Affairs


SPRINKLERED

Project Number

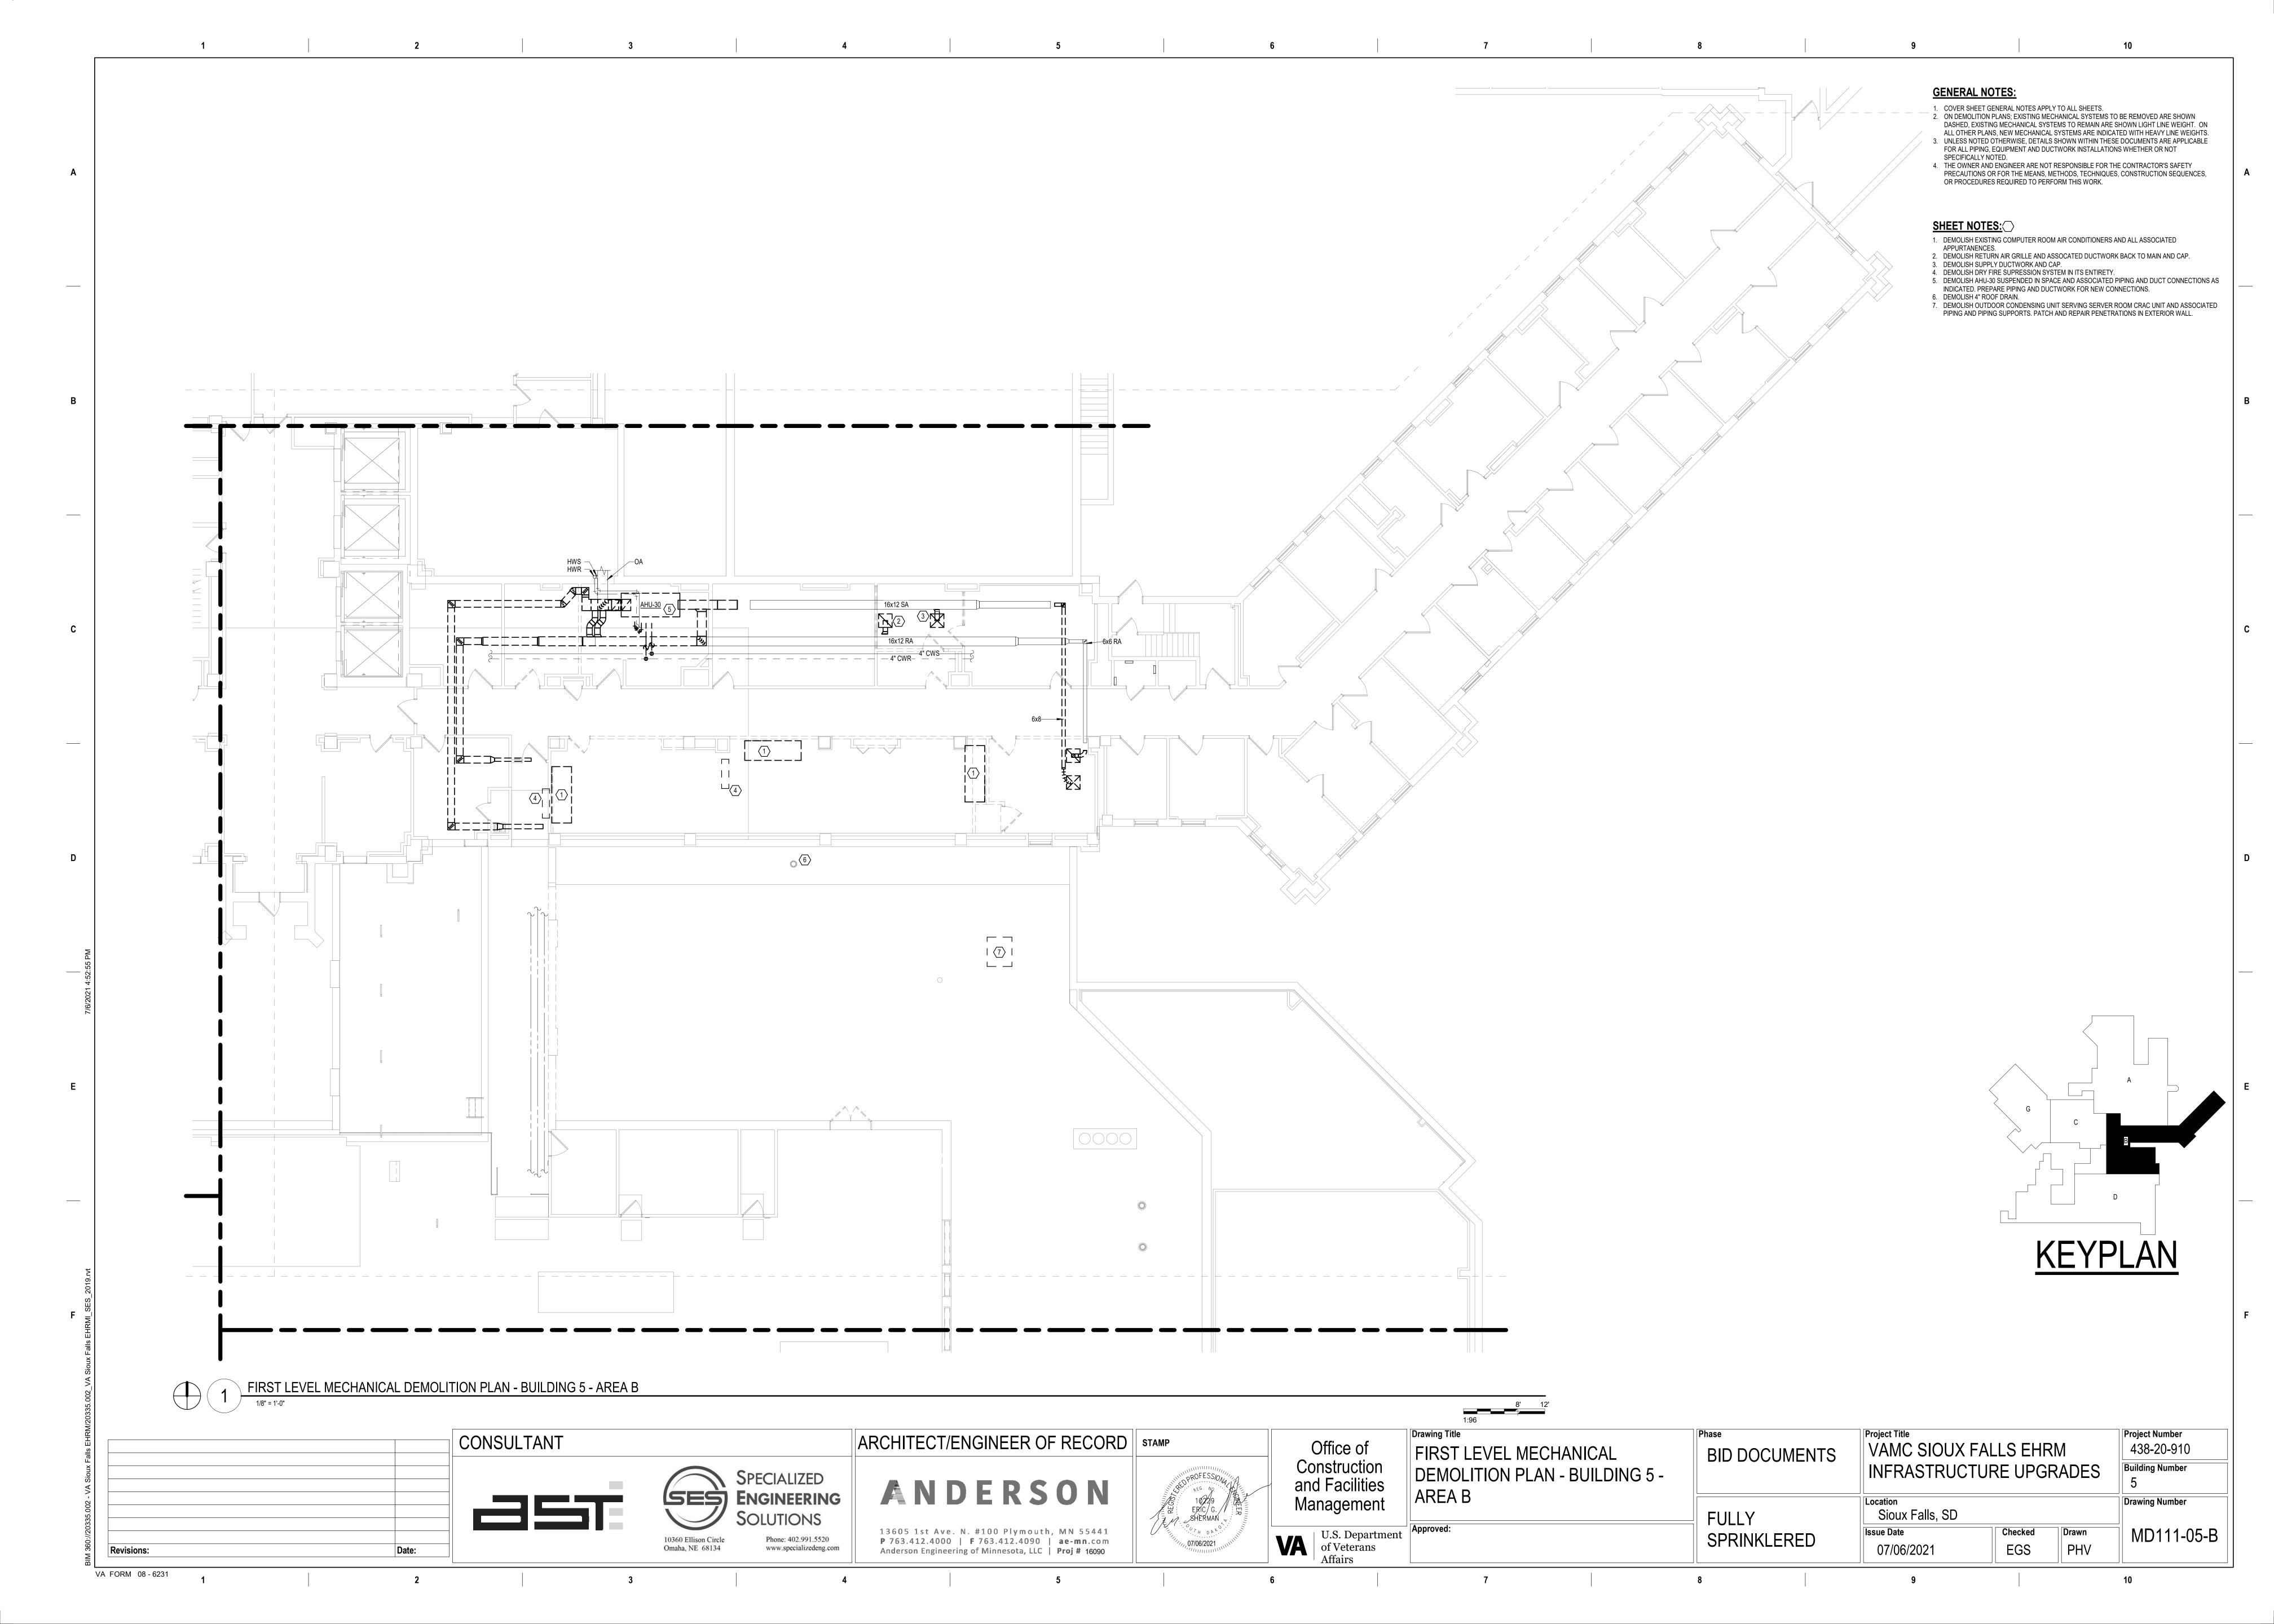

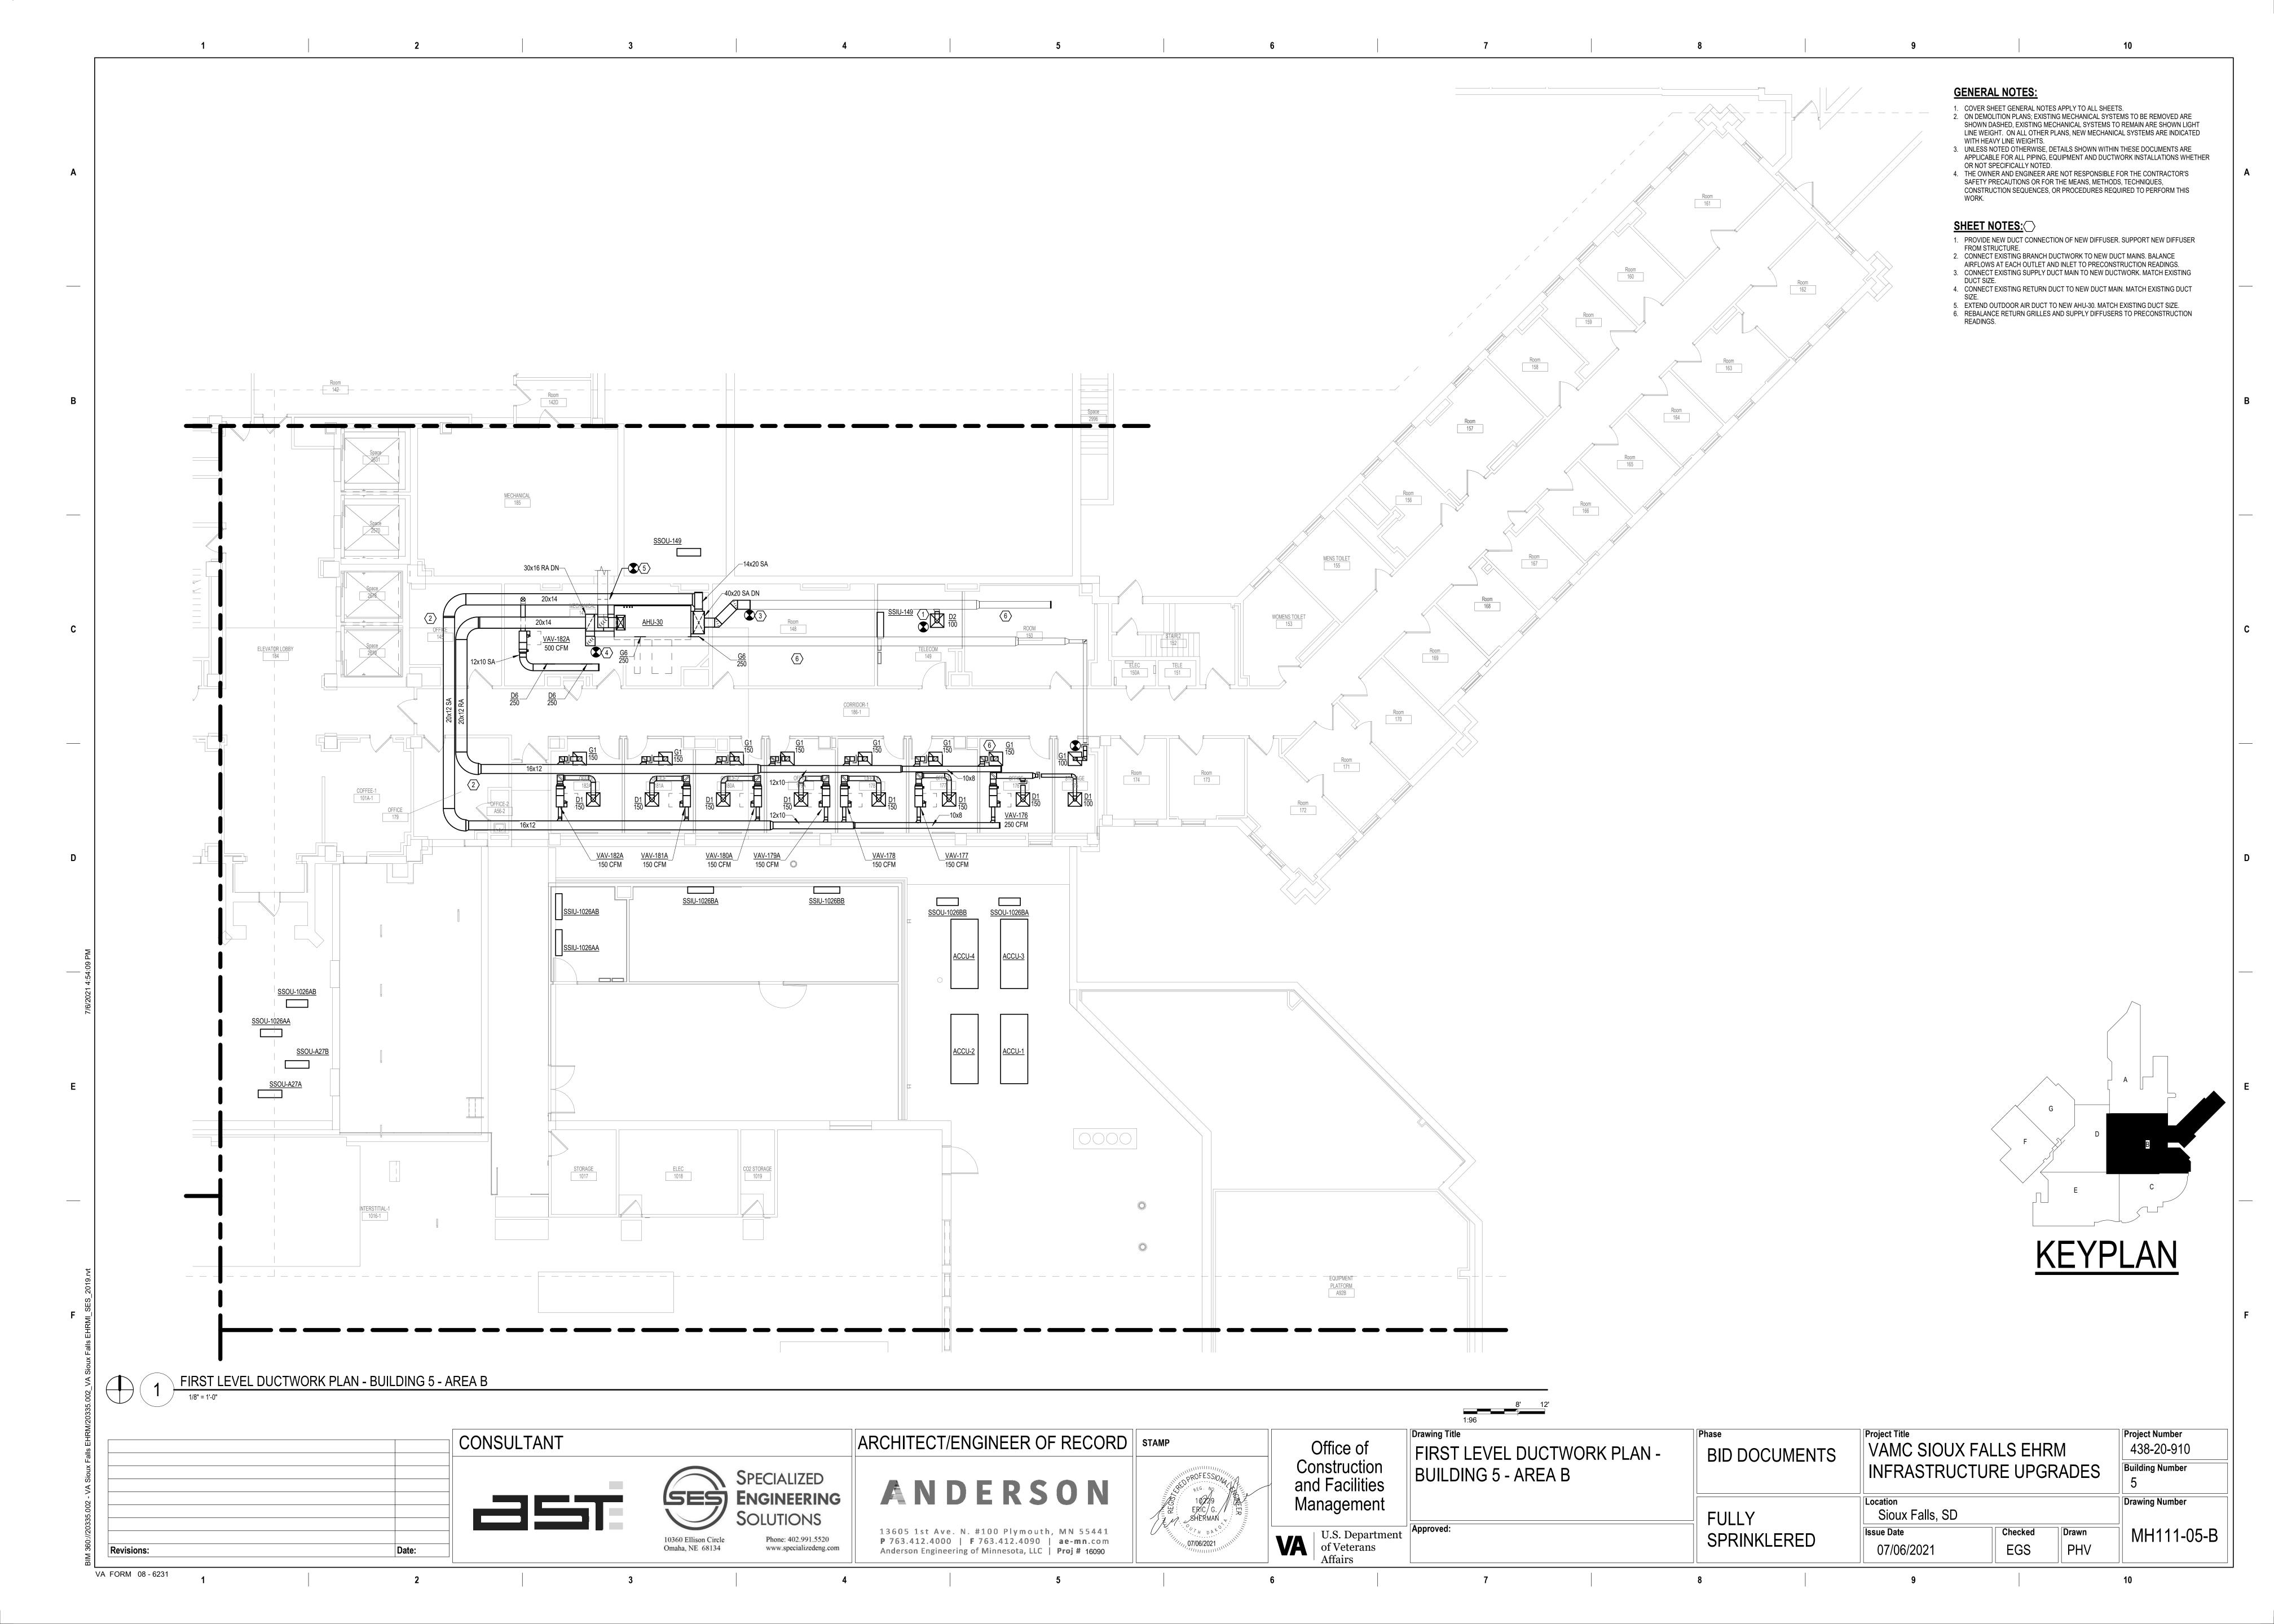

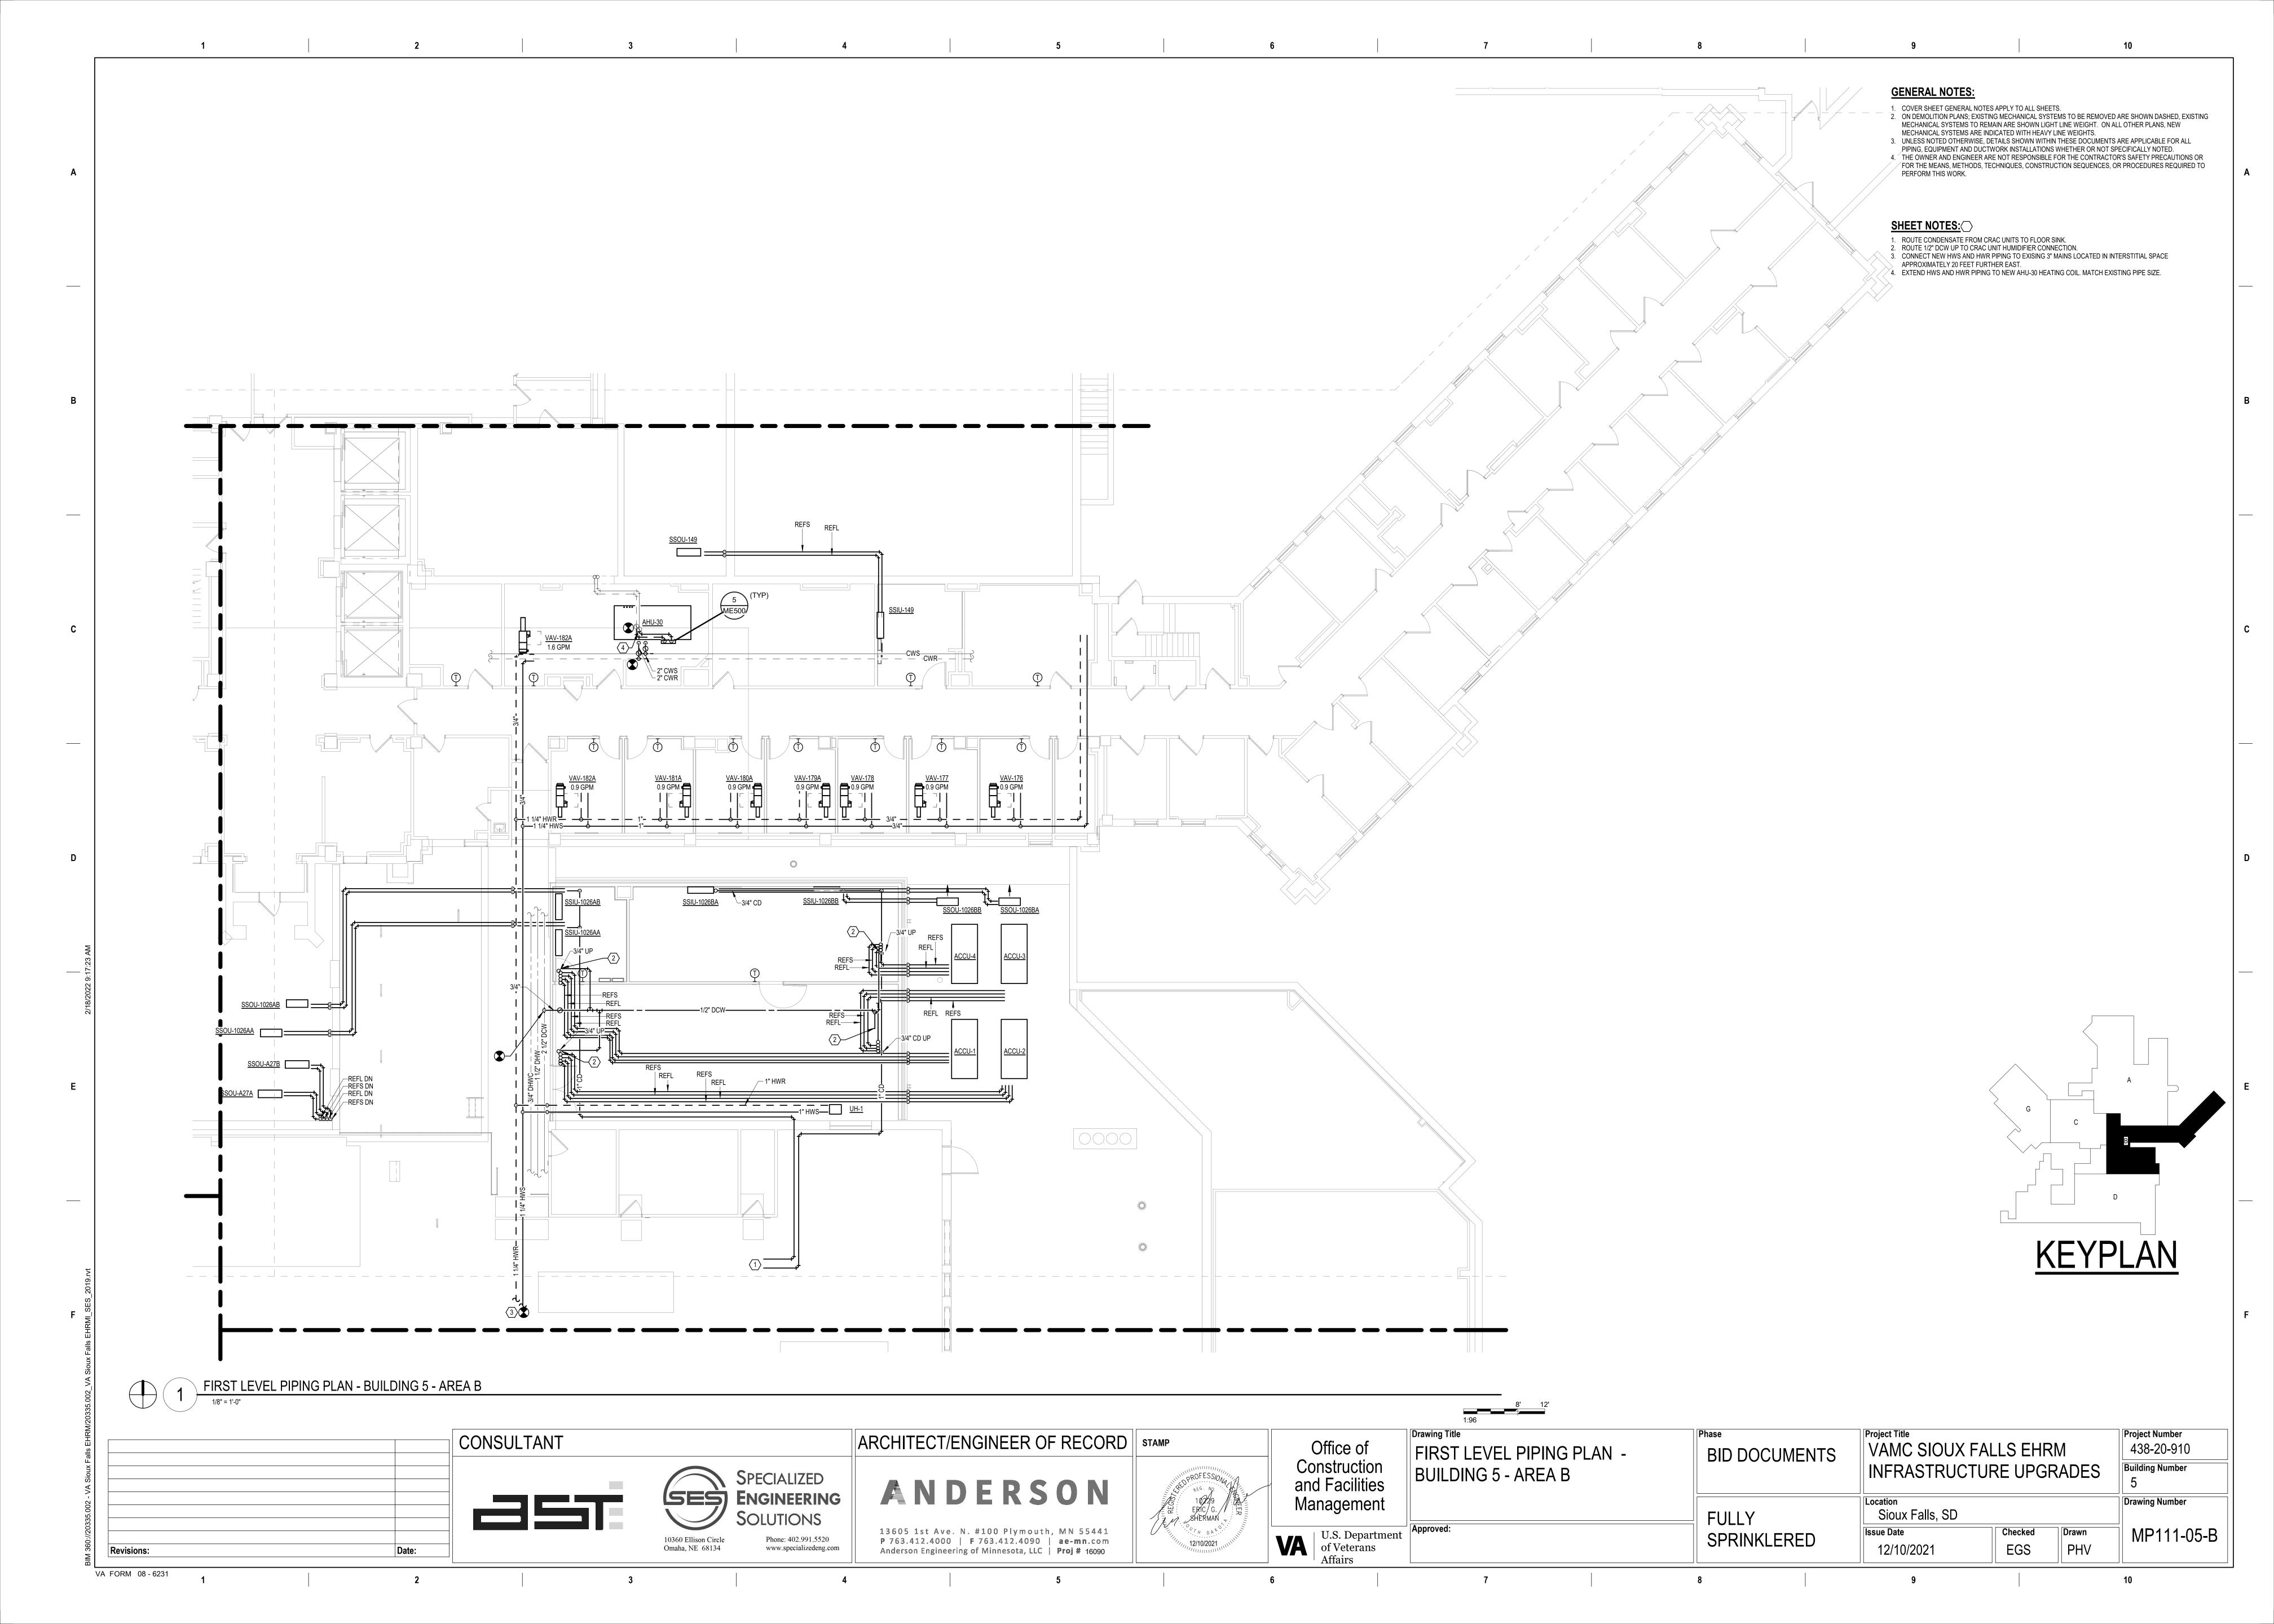

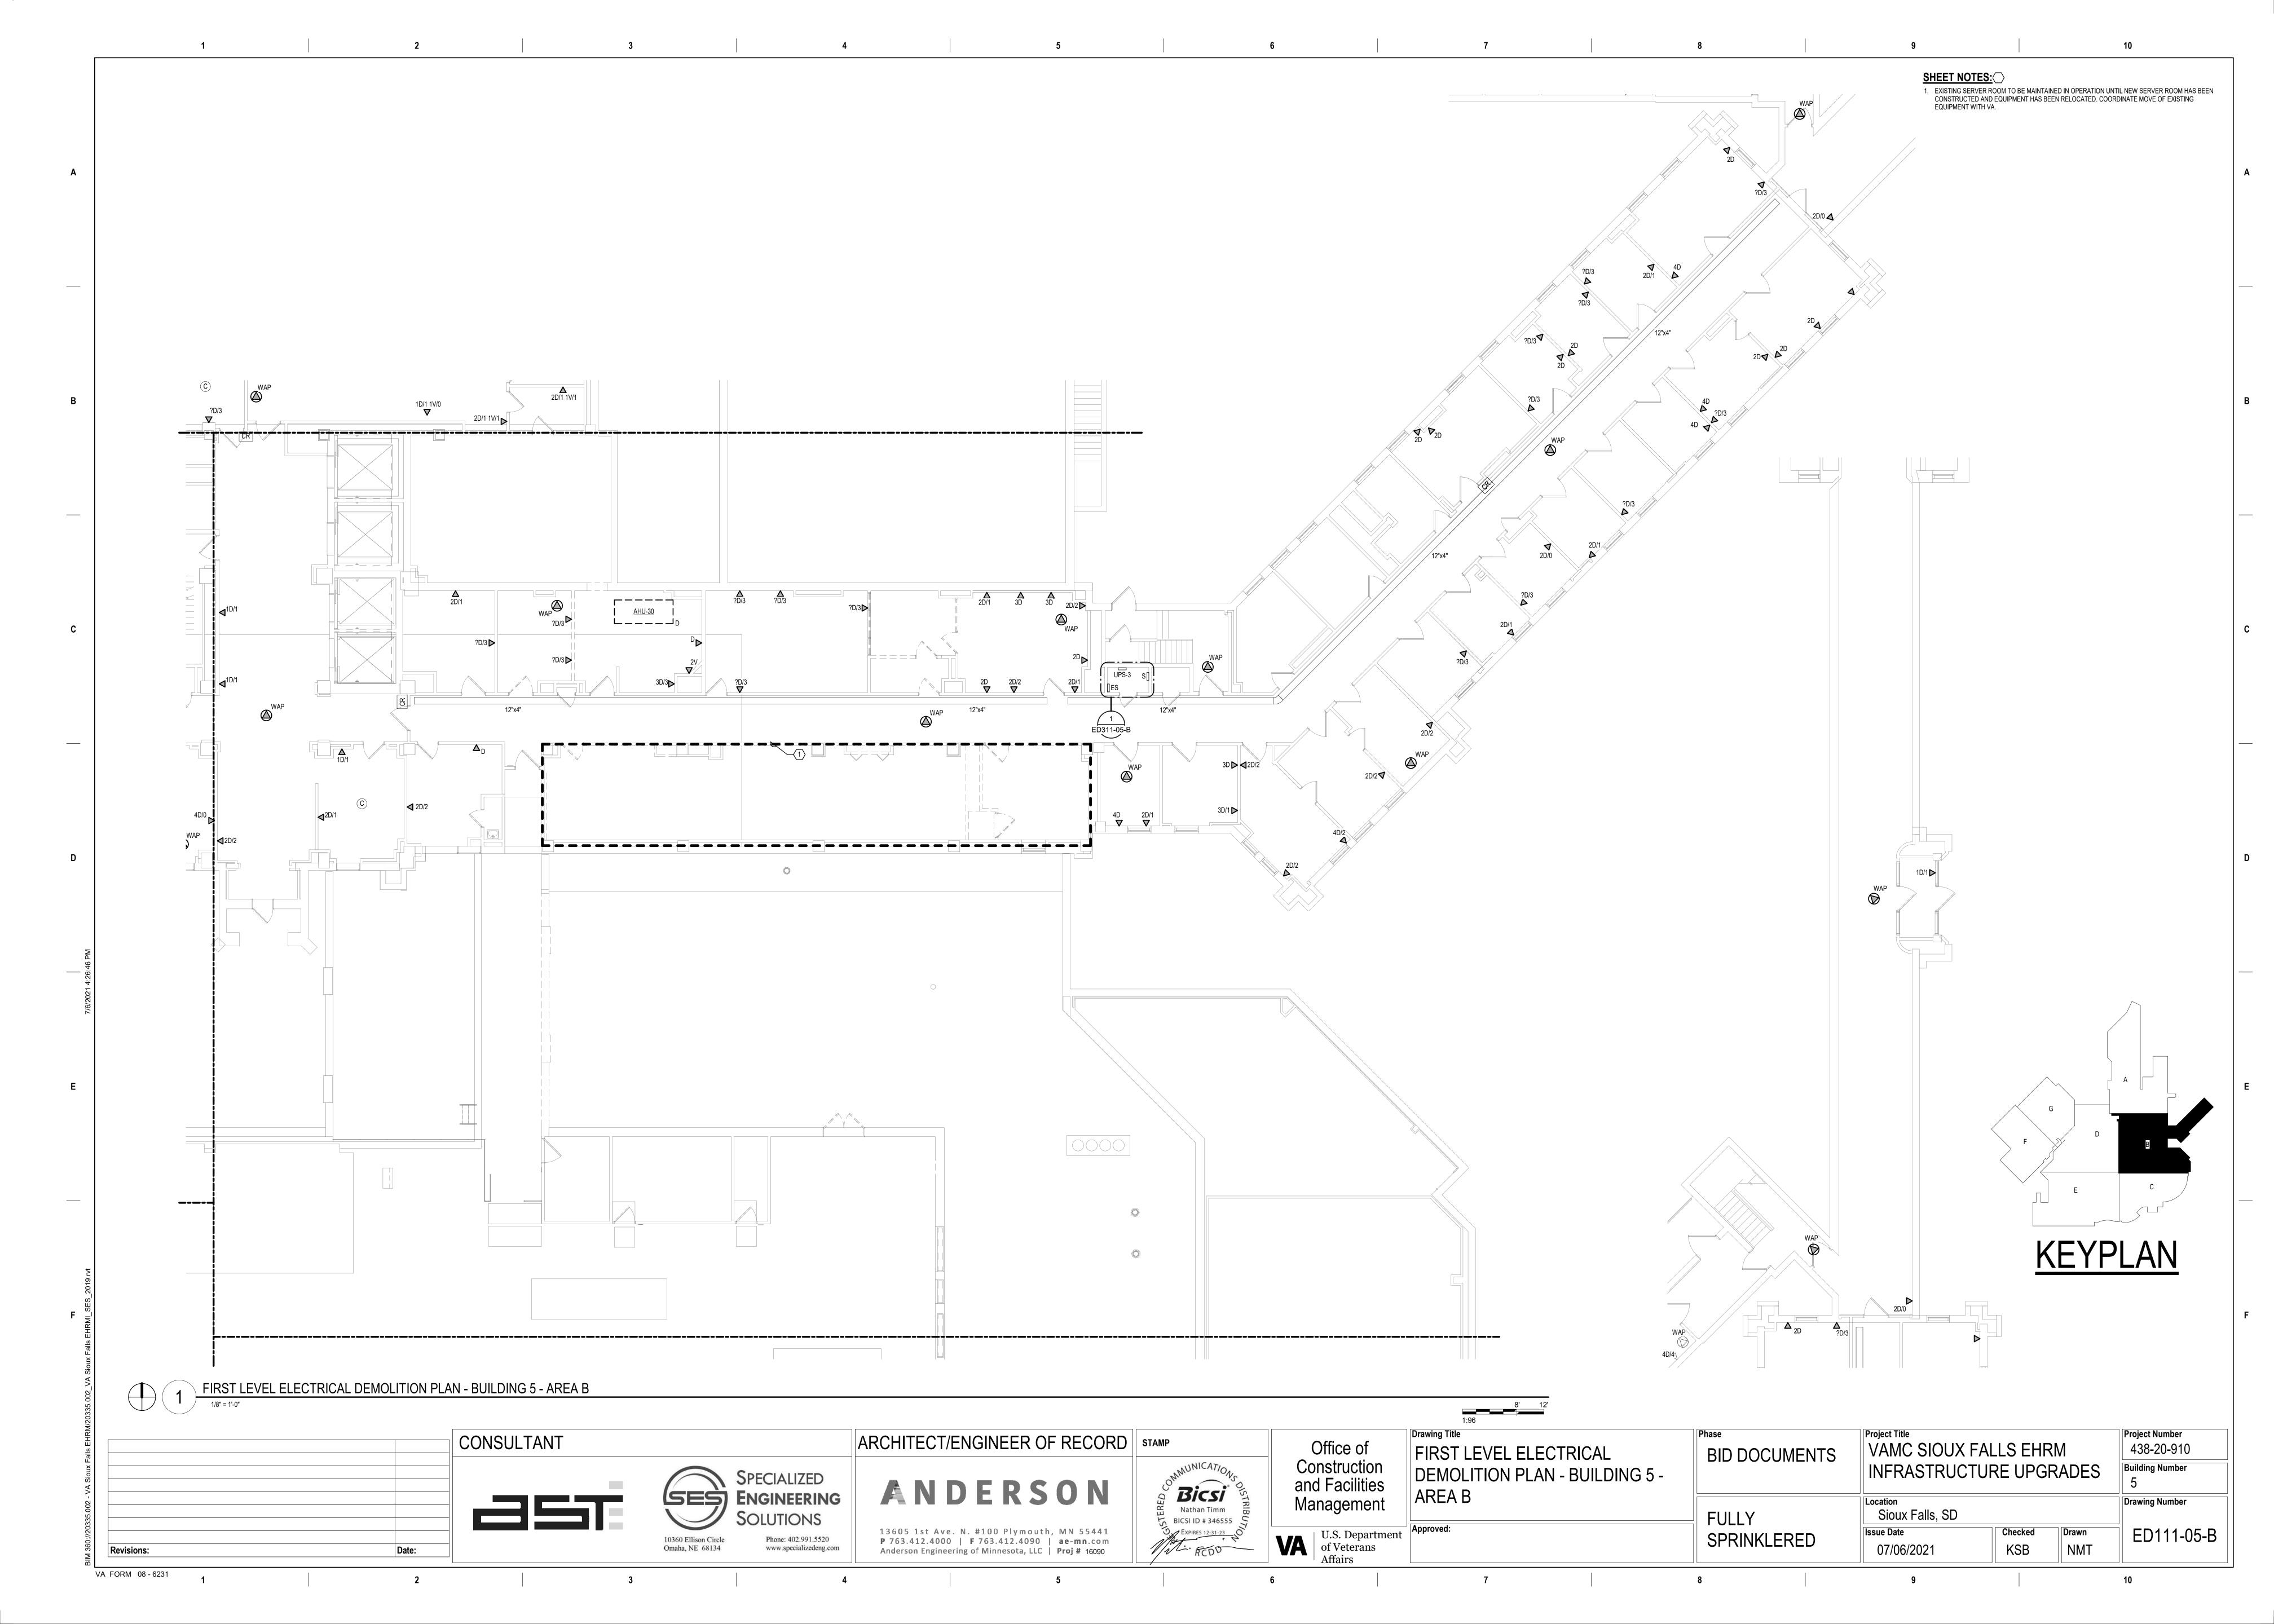

FIRST LEVEL ELECTRICAL DEMOLITION FLOOR PLAN - BUILDING 5 - AREA B - ROOM 150A

1/2" = 1'-0"

CABLING NOTES:

A. THE EXISTING CABLE COUNT ARE THE CABLES CURRENTLY PRESENT IN THE SPACE. THE CABLE RELOCATION COUNT ARE THE NEW OR RELOCATED CABLES TO BE FED FROM THE SPACE. THE FINAL CABLE COUNT ARE THE CABLES THAT WILL BE PRESENT IN THE SPACE AT THE COMPLETION OF THE PROJECT. REMOVE ALL UNUSED CABLING AT THE COMPLETION OF THE PROJECT.

1. ROOM 150A

EXISTING CABLE COUNT DATA (CAT6): 35

DATA (CAT5): 96 PATIENT MONITORING: 0

COMMERCIAL WIRELESS: 0 CABLE RELOCATION COUNT DATA (CAT6): -35 TO ROOM 149

DATA (CAT5): -96 TO ROOM 149 PATIENT MONITORING: 0

COMMERCIAL WIRELESS: 0 EXISTING CABLE TO REMAIN

DATA (CAT6): 0 VIDEO: 0 PATIENT MONITORING: 0

COMMERCIAL WIRELESS: 0

FINAL CABLE COUNT DATA (CAT6): 0

PATIENT MONITORING: 0 COMMERCIAL WIRELESS: 0

SHEET NOTES:

1. EXISTING TELEPHONE WALL FIELD TO BE DEMOLISHED. NEW COPPER BACKBONE TO BE PROVIDED ON PATCH PANELS IN TELECOMMUNICATIONS RACK. REFER TO CABLING NOTES AND NEW WORK PLANS FOR ADDITIONAL

2. EXISTING FIBER ENCLOSURE TO BE DEMOLISHED. NEW FIBER BACKBONE TO BE TERMINATED IN NEW TELECOMMUNICATIONS RACK. REFER TO CABLING NOTES

AND NEW WORK PLANS FOR ADDITIONAL REQUIREMENTS.

CONSULTANT SPECIALIZED SES ENGINEERING 10360 Ellison Circle Phone: 402.991.5520 Omaha, NE 68134 www.specializedeng.com

Revisions:

VA FORM 08 - 6231

ARCHITECT/ENGINEER OF RECORD | STAMP ANDERSON 13605 1st Ave. N. #100 Plymouth, MN 55441

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Anderson Engineering of Minnesota, LLC | Proj # 16090



Office of Construction and Facilities Management U.S. Department of Veterans Affairs

Drawing Title


FIRST LEVEL ELECTRICAL DEMOLITION - BUILDING 5 -ENLARGED ROOMS - AREA B


Project Title VAMC SIOUX FALLS EHRM **BID DOCUMENTS** INFRASTRUCTURE UPGRADES


Drawing Number Sioux Falls, SD **FULLY** Checked Drawn ED311-05-B SPRINKLERED KSB 07/06/2021 NMT


Project Number

Building Number

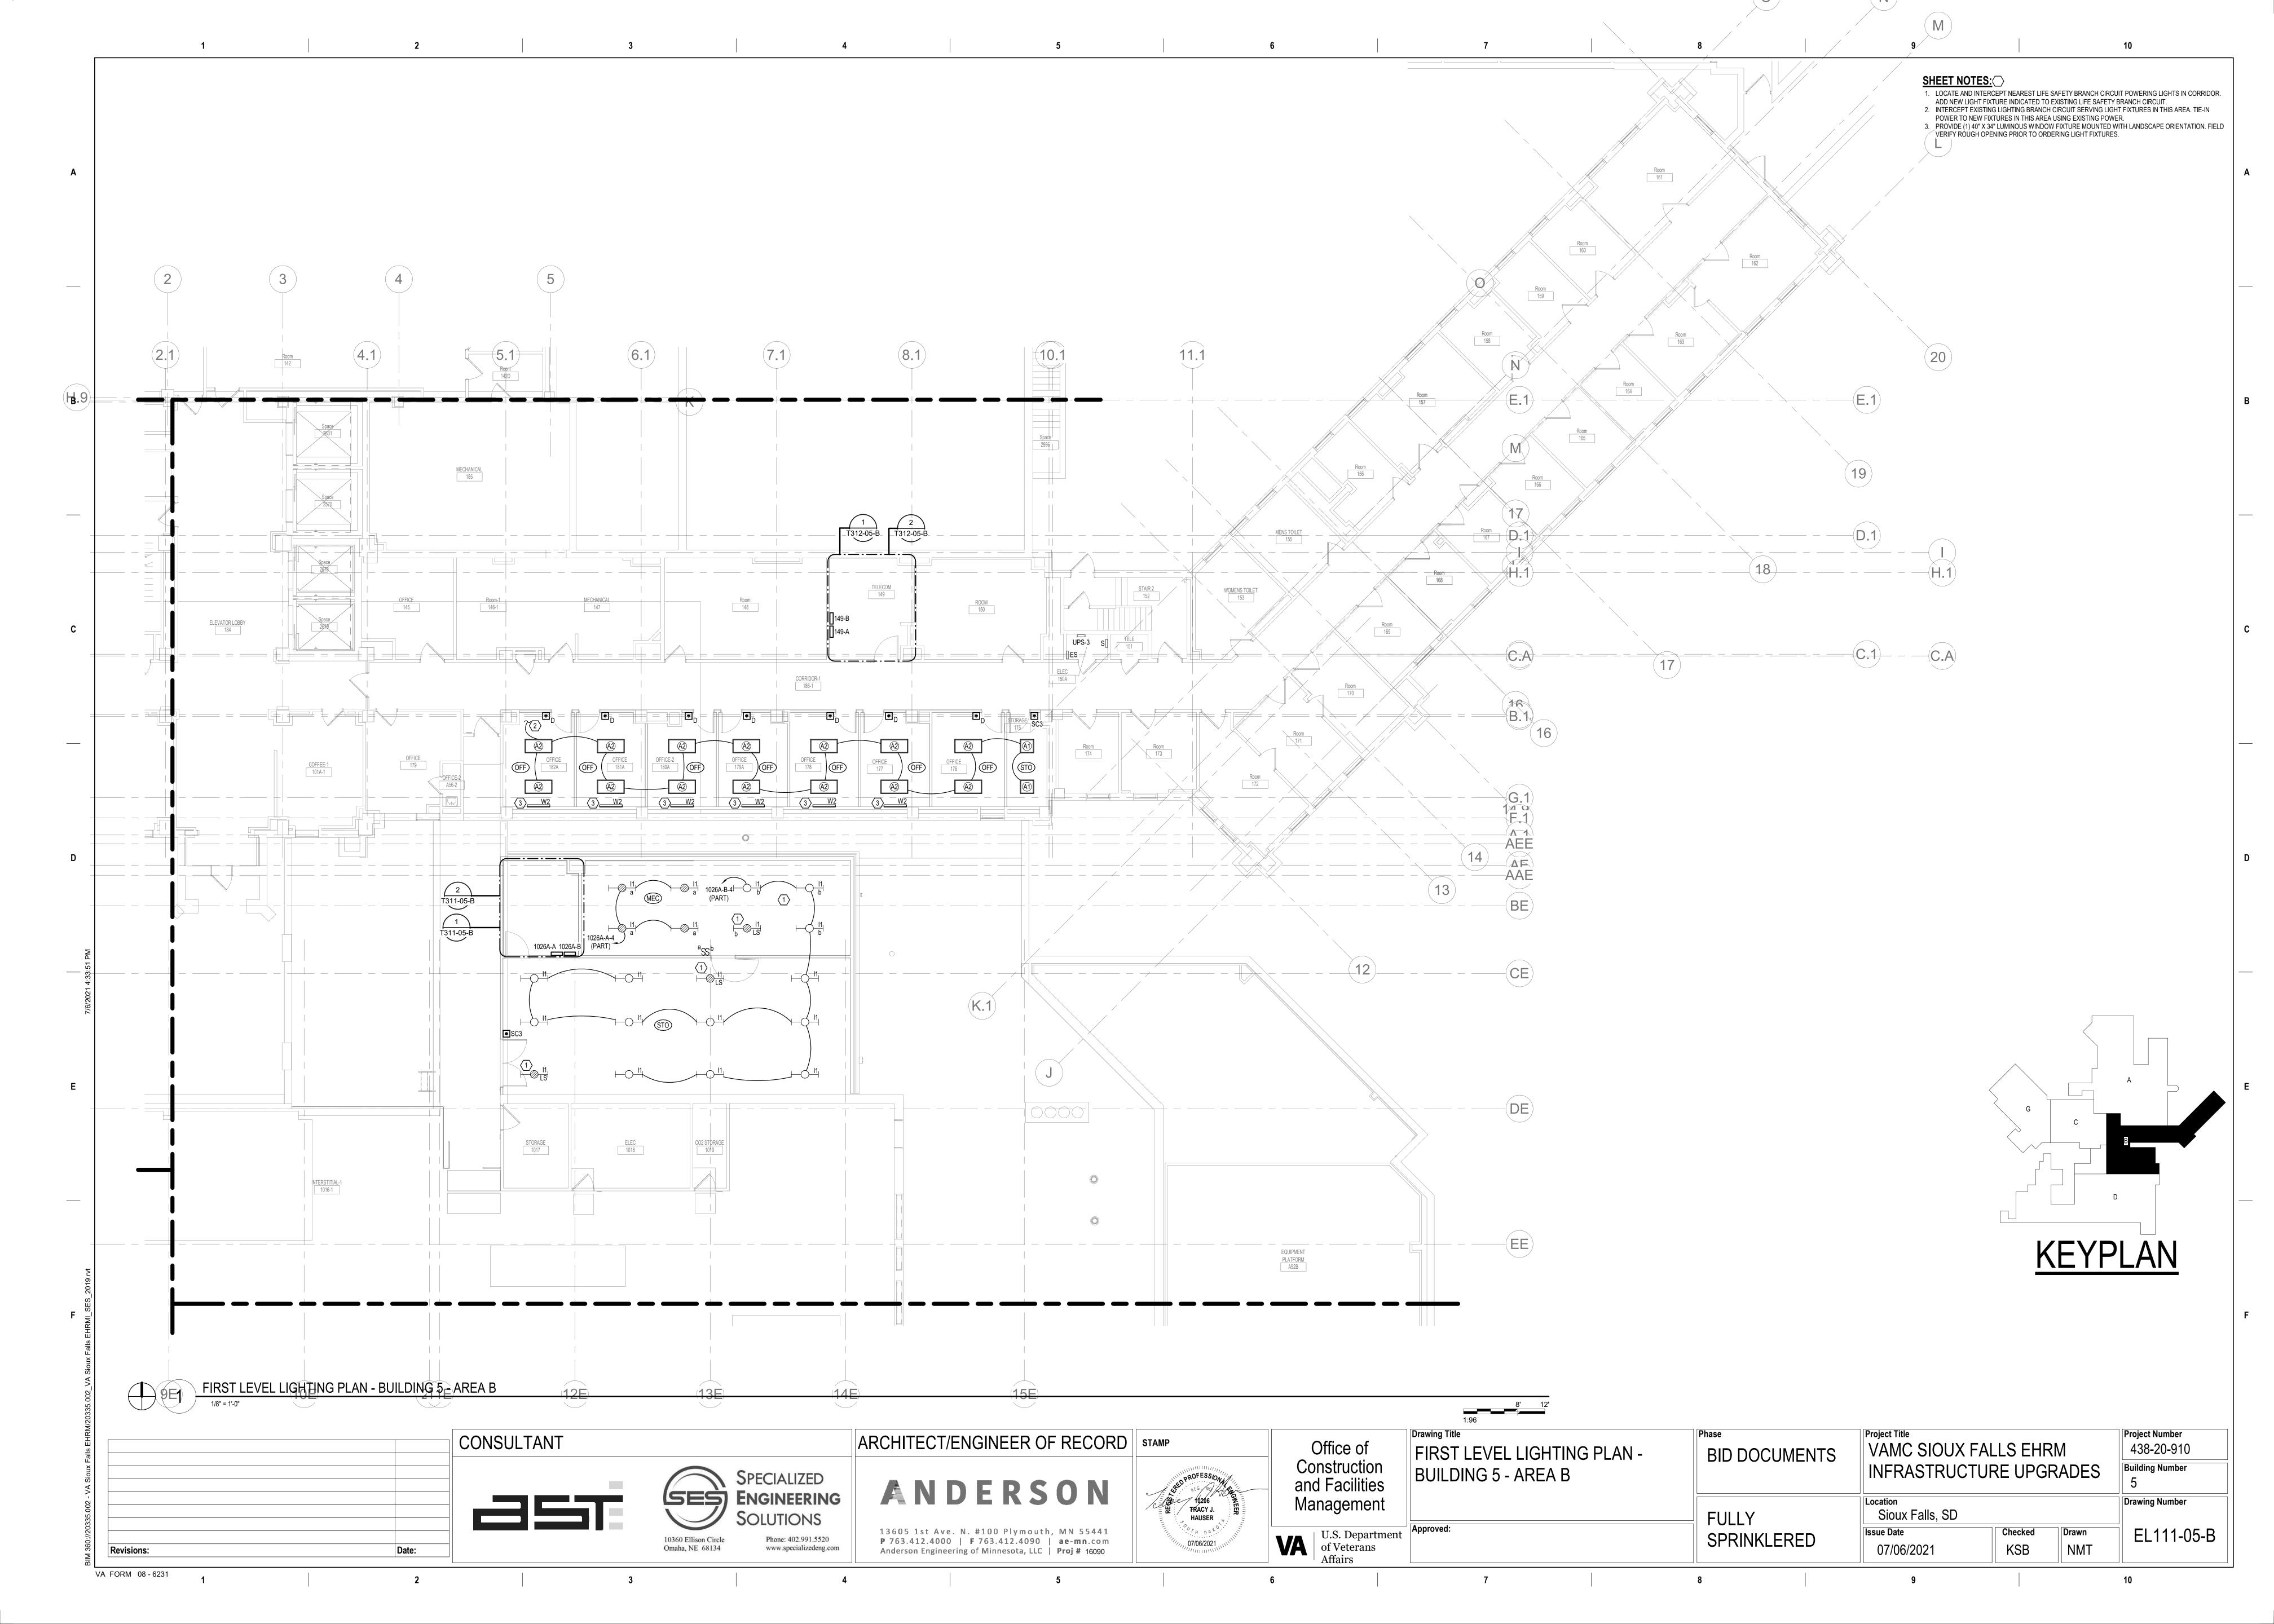

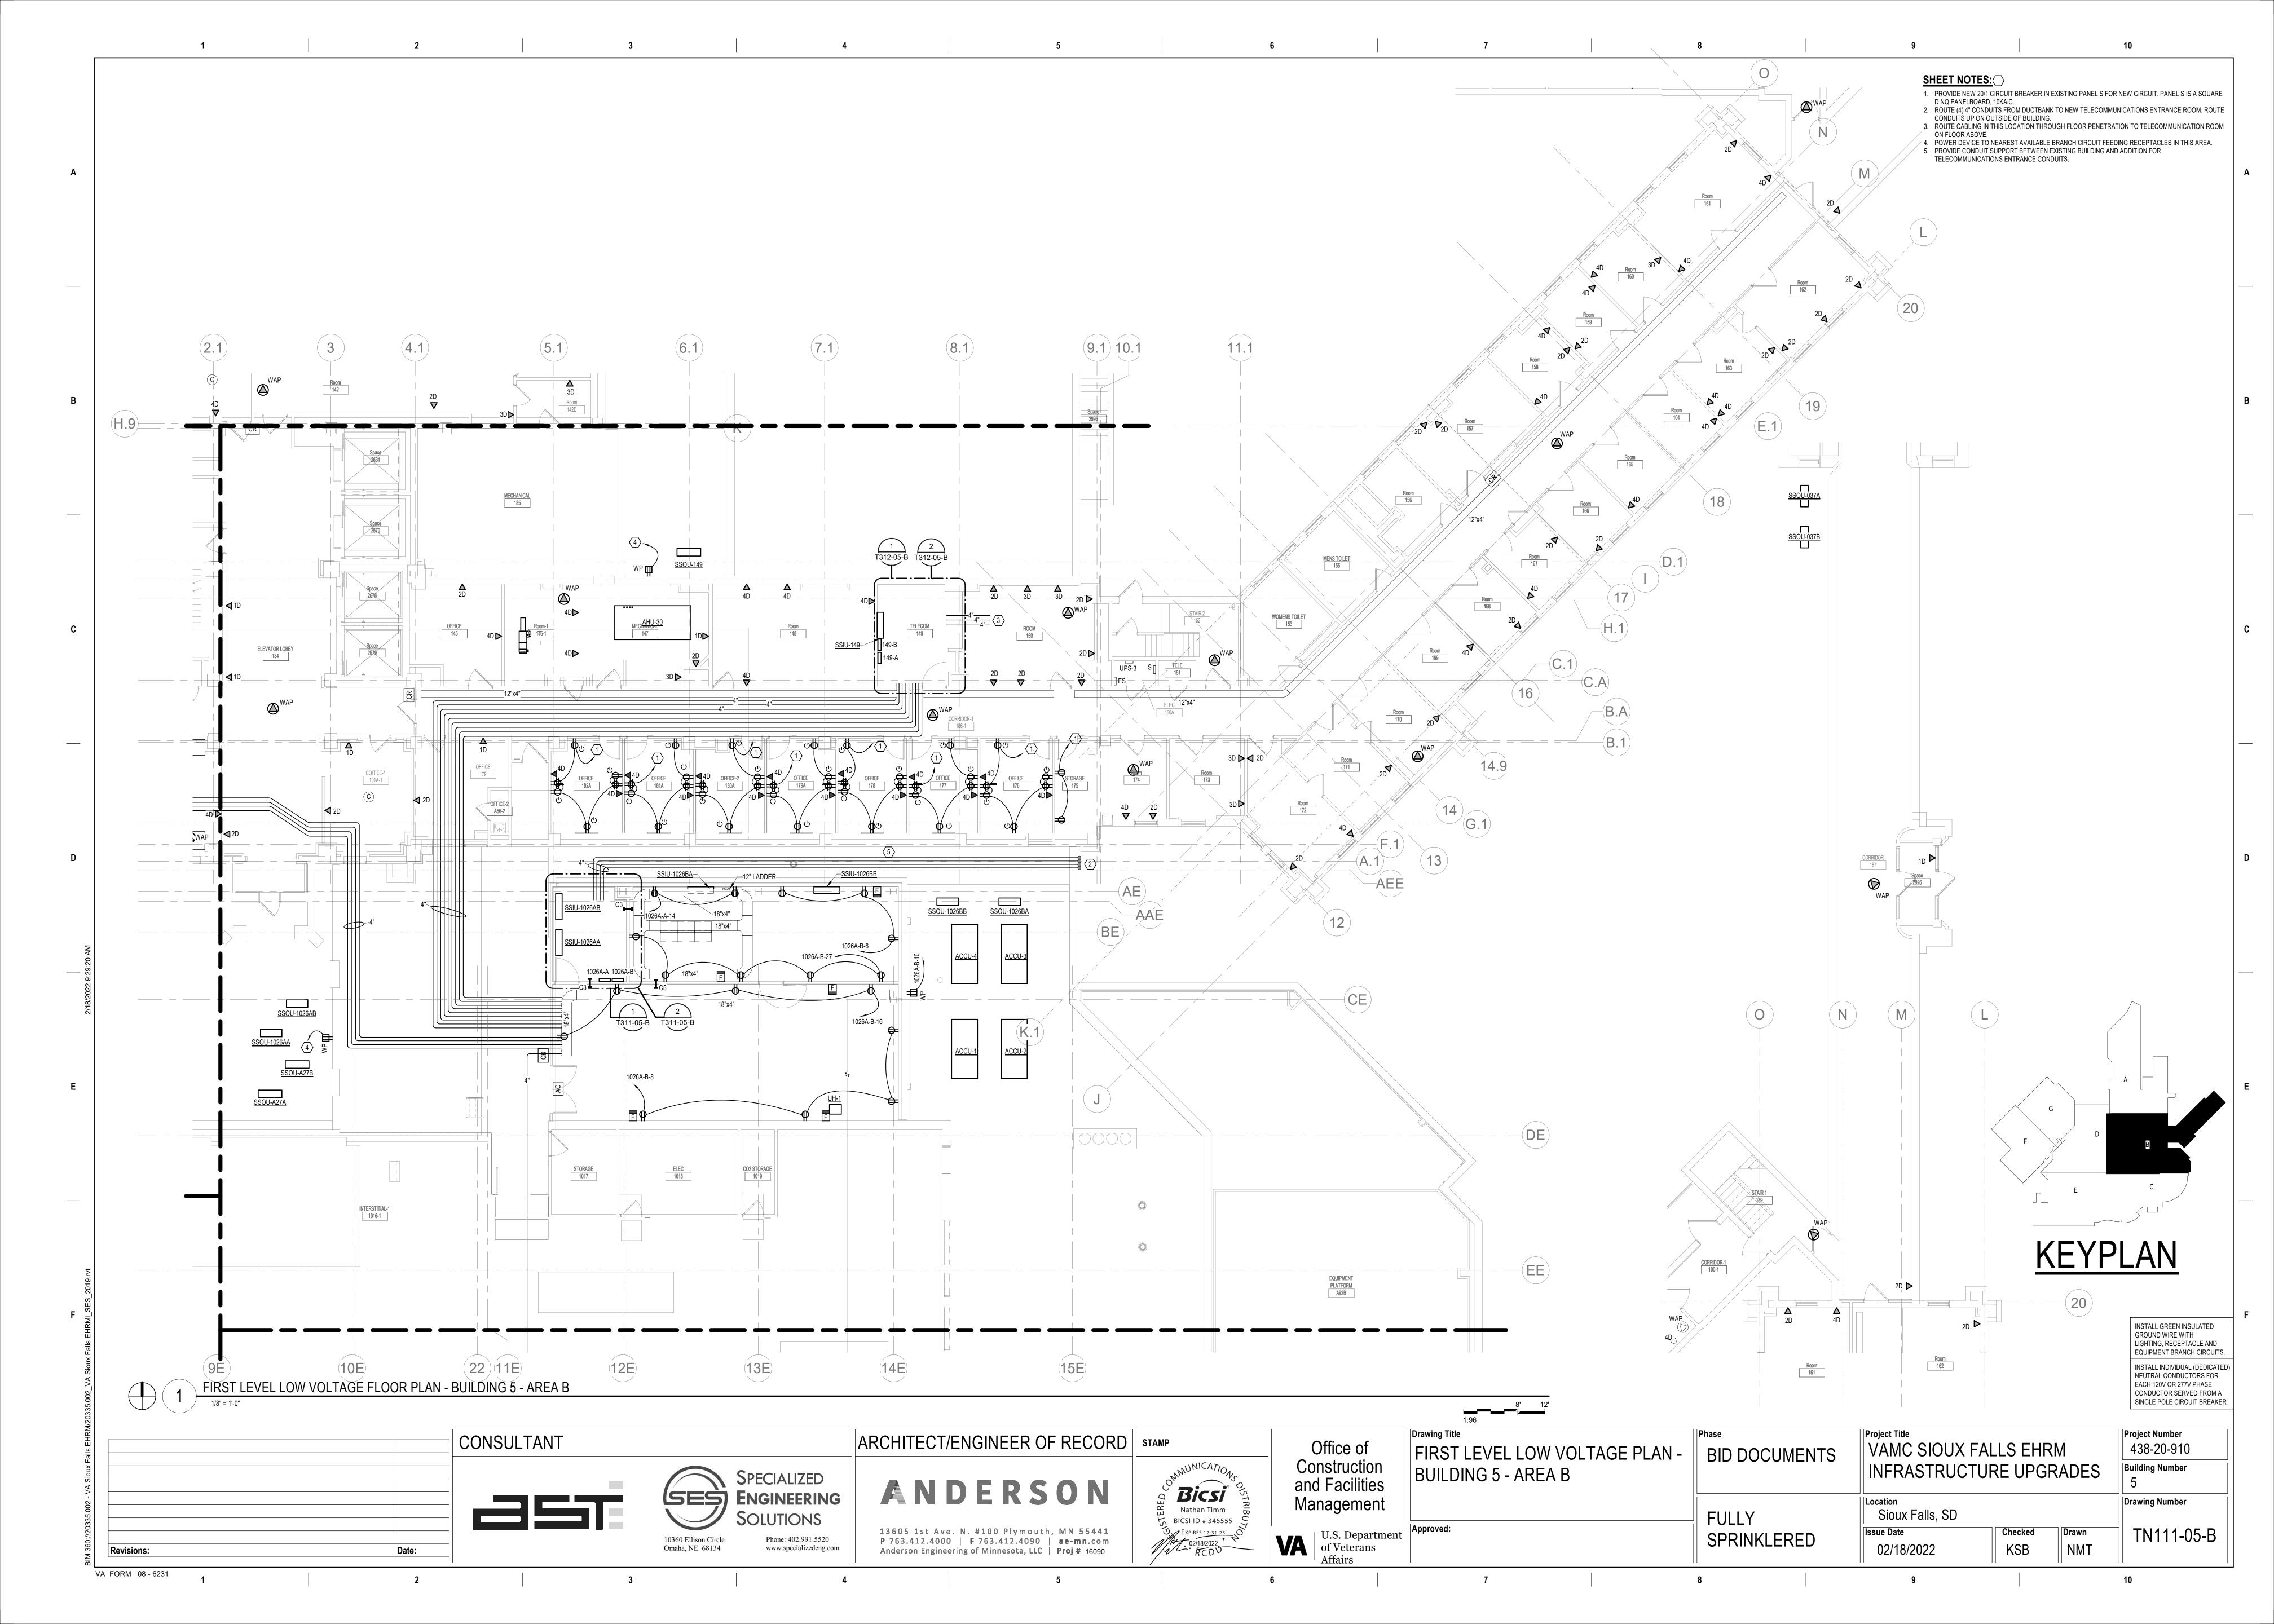

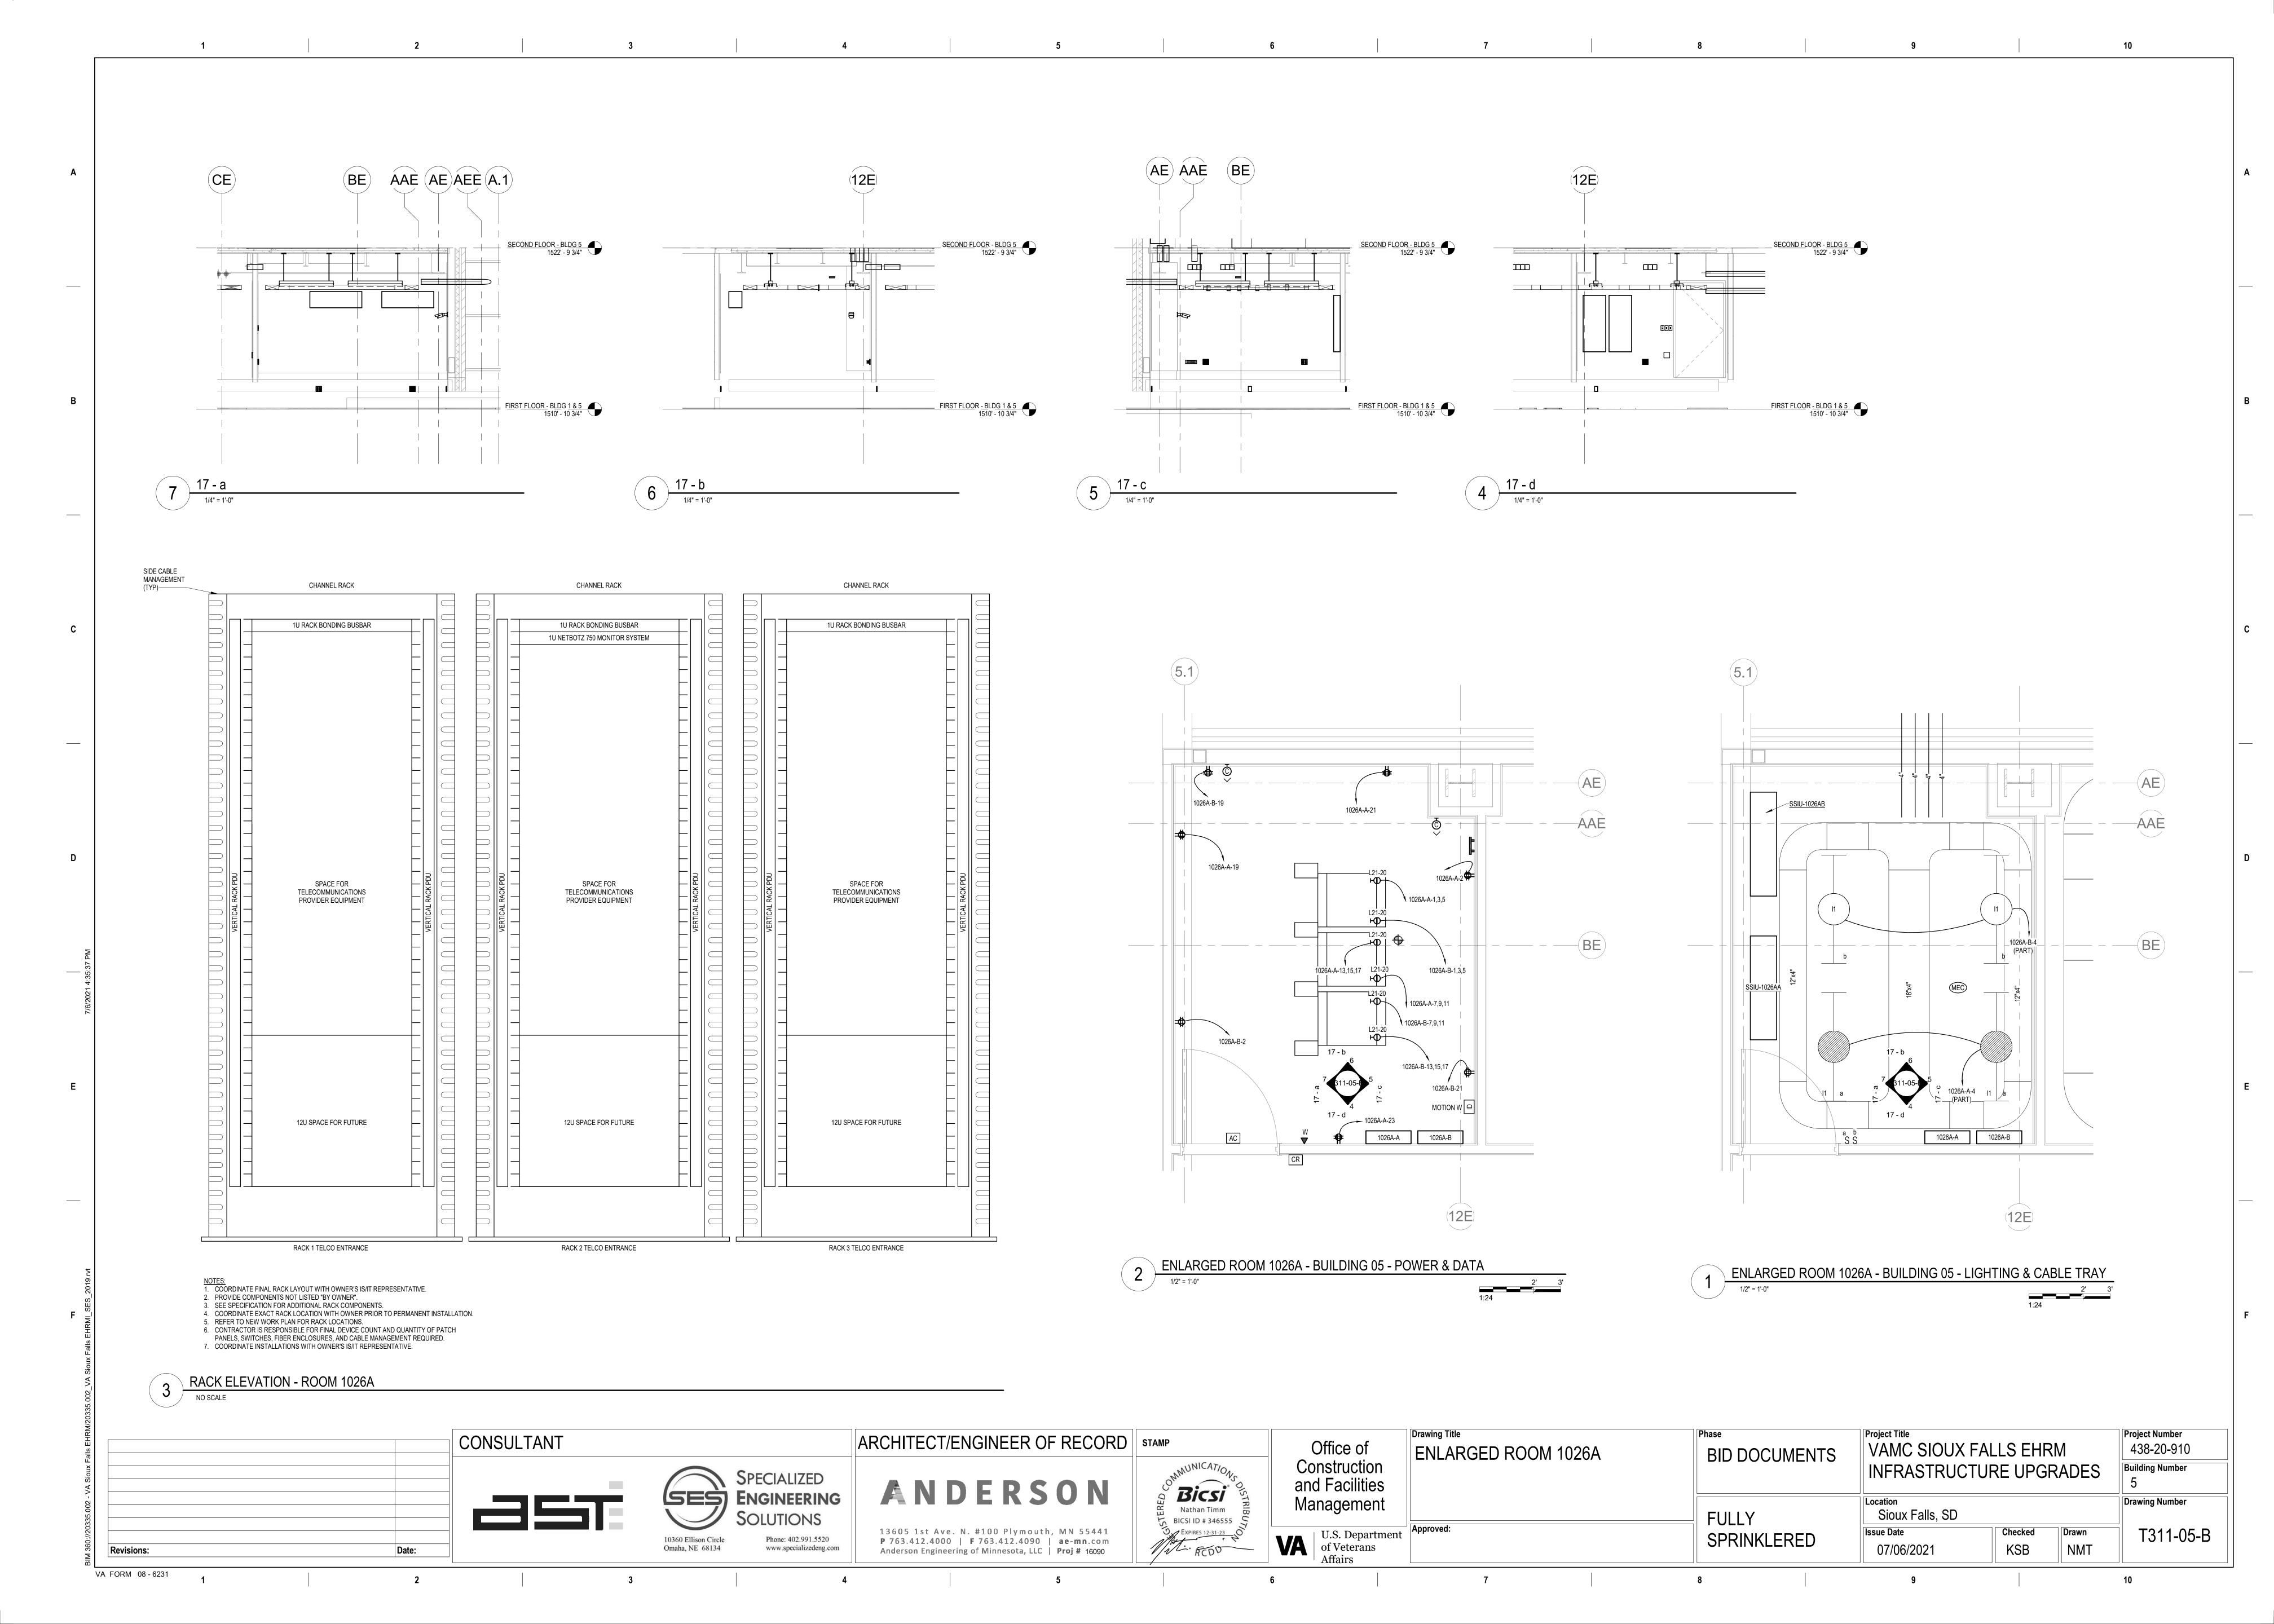

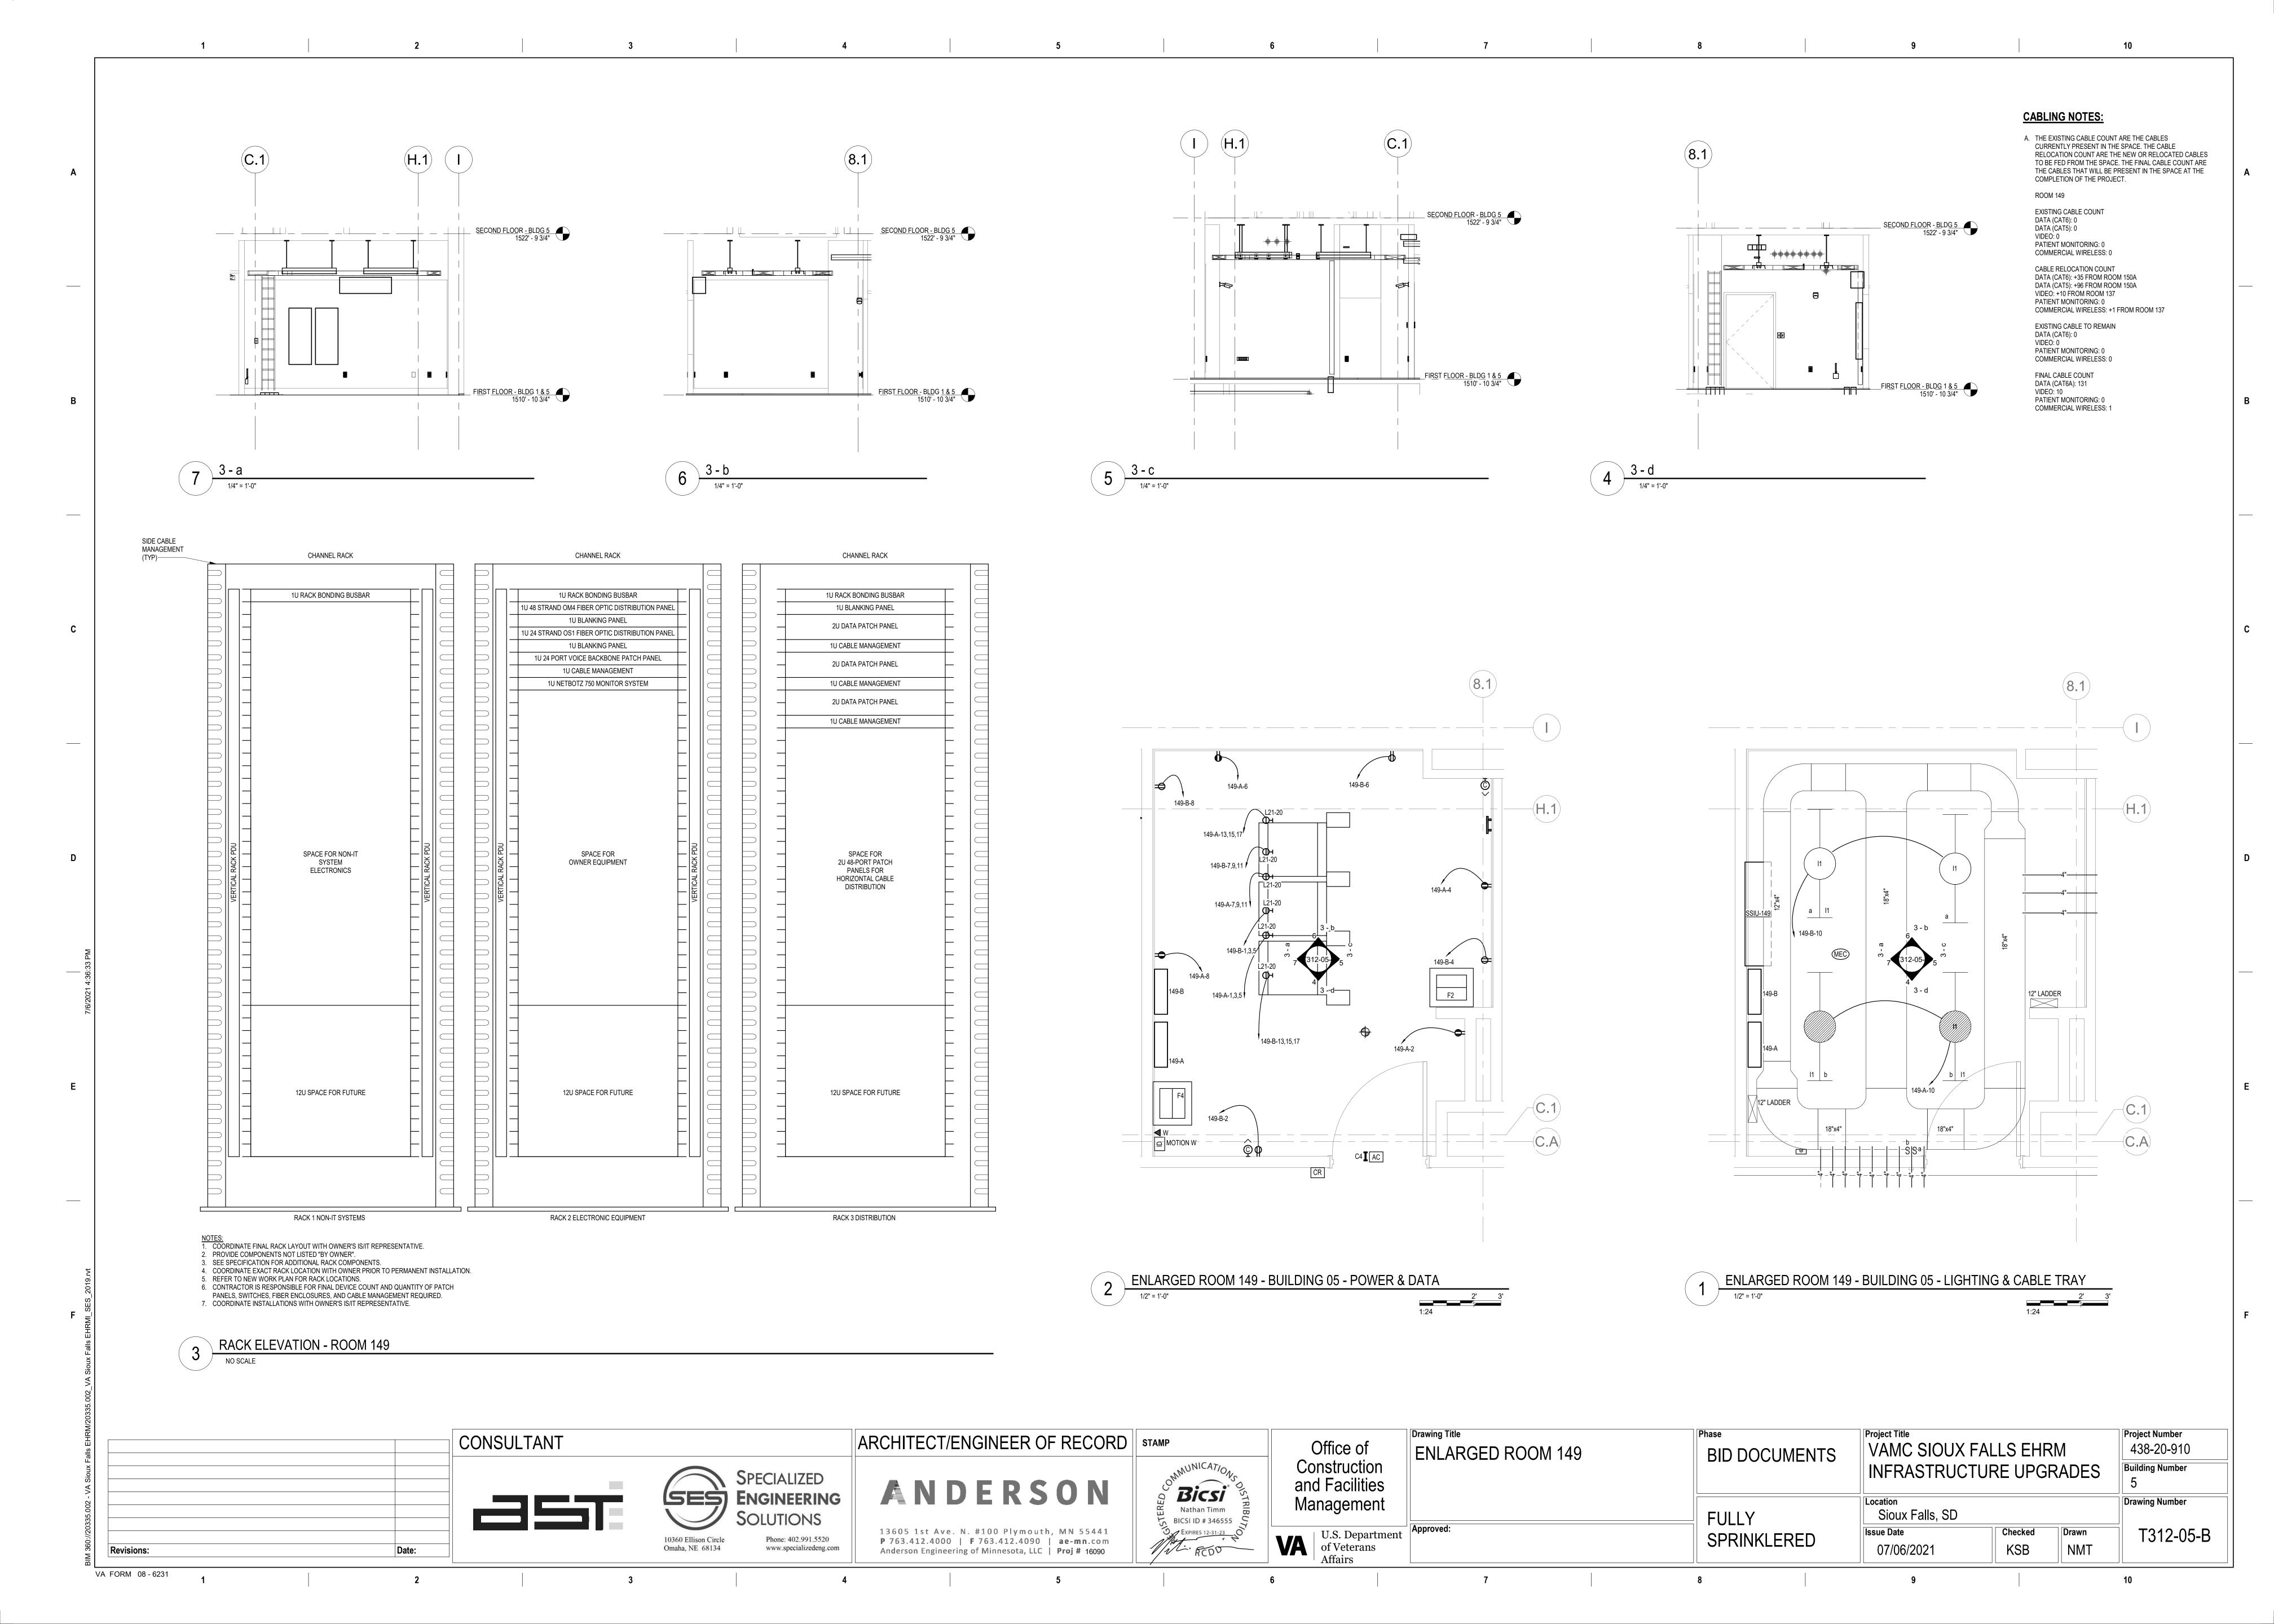


LIGHTING PANEL: 149-B VOLTS: 208/120 WYE **LOCATION:** EXAM A73 MAINS TYPE: MCB MCB/MLO RATING: 100 A PHASES: 3 **BRANCH:** NORMAL WIRES: 4 MCB OPTIONS: NONE **SERVICE RATED**: No **INTEGRAL SPD**: Yes SECTIONS: 1 **MOUNTING:** SURFACE AVAILABLE SCC (kA): 1.5 PANEL POLES: 42 **NEMA ENCLOSURE**: 1
 POL...
 RATI...
 OPT
 CIRCUIT DESCRIPTION

 1
 20 A
 REC TELECOM 149
 CIRCUIT DESCRIPTION OPT RATI... POL... 1922... 180 VA 1922 VA 180 VA PWR-C TELECOM 149 - RACK REC TELECOM 149 RECEPTACLE 1922 VA 180 VA 1 20 A REC TELECOM 149 REC TELECOM 149 1922... 180 VA PWR-C TELECOM 149 - RACK TELECOM LTG RECEPTACLE PWR-C TELECOM 149 - RACK RECEPTACLE 1922 VA 21 SPARE -- 20 A 3 0 VA | -- 20 A 1 29 SPARE -- 20 A 1 0 VA -- 20 A 1 0 VA 5995 VA TOTAL LOAD: 6125 VA TOTAL AMPS: 51 A 50 A CONNECTED LOAD | DEMAND FACTOR | ESTIMATED DEMAND LOAD CLASSIFICATION PANEL TOTALS CONNECTED LOAD: 18065 VA 720 VA 100.00% 720 VA CONNECTED CURRENT: 50 A 17295 VA **DEMAND LOAD:** 14429 VA **DEMAND CURRENT:** 40 A **CONSIDER 125% DEMAND:** 18037 A **EQUIPMENT AMPS:** 100 A FEEDER AVAILABLE: **SPARE CAPACITY:** | 59 % | 60 A CIRCUIT BREAKER OPTIONS SUFFIX: 'S' OR 'ST' - PROVIDE SHUNT TRIP CIRCUIT BREAKER / 'G' OR 'GFCI' - PROVIDE GFCI CIRCUIT BREAKER / 'GFP' - PROVIDE GFP CIRCUIT BREAKER / 'ERMS' - ENERGY REDUCING MAINTENANCE SWITCH / 'ZSI' - ZONE SELECTIVE INTERLOCKING / 'L' - PROVIDE CIRCUIT BREAKER WITH LOCKING PROVISIONS / 'R' - PROVIDE CIRCUIT BREAKER WITH RED MARKING A. PANEL AIC (INTERRUPTING) RATING SHALL BE MINIMUM 120% OF THE AVAILABLE SCC (SHORT CIRCUIT CURRENT).

	SUPPLY FROM: B1 BRANCH: NOI SERVICE RATED: No MOUNTING: SUF NEMA ENCLOSURE: 1	VOLTS: 208/120 WYE PHASES: 3 WIRES: 4 INTEGRAL SPD: Yes AVAILABLE SCC (kA): 1.6							MAINS TYPE: MCB MCB/MLO RATING: 100 A MCB OPTIONS: NONE SECTIONS: 1 PANEL POLES: 42							
	CIRCUIT DESCRIPTION	OPT	RATI	POL		4	E	3		<u> </u>	POL.	RATI	ОРТ	CIRC	JIT DESCRIPTION	
1	PWR-C TELECOMM 1026A - RACK				1922	360 VA					1	20 A			DMM-2 1026A	
<u>ا</u> ا	RECEPTACLE		20 A	3			1922 VA	371 VA			1	20 A			OMM 1026A, 1026B	
5									1922 VA	540 VA	1	20 A			OMM-2 1026A	
7	PWR-C TELECOMM 1026A - RACK				1922	720 VA	4000144	400.144			1	20 A		REC - INTER		
9 ∣ı	RECEPTACLE		20 A	3			1922 VA	180 VA	4000 \ / 4	4405	1	20 A		REC - EXTE	RIOR	
11					4000	4405 \ / A			1922 VA	1195	2	25 A		SSIU-1026BE	3/SSOU-1026BB	
	PWR-C TELECOMM 1026A - RACK		20.4	2	1922	1195 VA		720 \/^			1	20.4		REC - INTER	CTITIAI	
	RECEPTACLE		20 A	3			1922 VA	120 VA		264 VA	1	20 A			OTITIAL	
	REC TELECOMM-2 1026A		20 A	1	360 VA				1922 VA	∠04 VA	1	20 A		MEQ-C		
	REC TELECOMM-2 1026A		20 A	1	360 VA		360 VA									
23			20 A	1			300 VA		1195 VA							
25	SSIU-1026AB/SSOU-1026AB		25 A	2	1195				1133 VA							+
	REC TELECOMM-2 1026A		20 A	1	1100		900 VA									
	SPARE	+	20 A	1			300 77		0 VA							
	SPARE		20 A	1	0 VA											
	SPARE		20 A	1	0 171		0 VA									
	SPARE	-	20 A	1					0 VA							
37					0 VA											
	SPARE		20 A	3			0 VA									
41									0 VA							
			TOTAL			5 VA A		6 VA 9 A		9 VA 6 A]					
OAI	CLASSIFICATION		CC	NNECT	ED LOAI	DEN	IAND FA	CTOR	ESTIMAT	ED DEM	AND			PANEL 1	OTALS	
TG				371	VA		125.00%					С	ONNE	CTED LOAD:	26850 VA	
REC 4140					VA		100.00%	, D	4140 VA			CONN	IECTE	CURRENT:	75 A	
1TR				4780	VA		112.11%	Ď	53	59 VA			DEN	MAND LOAD:	23940 VA	
1EQ-				264	VA		125.00%	Ď	33	30 VA		D	EMANI	CURRENT:	66 A	
WR.	NC			17295 VA			78.91%			13648 VA		CONSIDER 125% DEMAND				
														MENT AMPS:	100 A	
												FE	EDER	AVAILABLE:		
													SPARE	- CAPACITY	33 %	
															34 A	
											[
		_		_									_			
PTI	ONS:															
IRC	UIT BREAKER OPTIONS SUFFIX: 'S UIT BREAKER / 'ERMS' - ENERGY RE /ISIONS / 'R' - PROVIDE CIRCUIT E	EDUCIN	G MAIN	TENANO	CE SWIT											•

LIGHTING PANEL: 149-A LOCATION: EXAM A73 SUPPLY FROM: A2 BRANCH: CRITICAL SERVICE RATED: No MOUNTING: SURFACE NEMA ENCLOSURE: 1			VOLTS: 208/120 WYE PHASES: 3 WIRES: 4 INTEGRAL SPD: Yes AVAILABLE SCC (kA): 1.5									MAINS TYPE: MCB MCB/MLO RATING: 100 A MCB OPTIONS: NONE SECTIONS: 1 PANEL POLES: 42					
C	CIRCUIT DESCRIPTION	OPT	RATI	POL		A		 3			POL	RATI	OPT	CIRC	JIT DESCRIPTION	С	
1					1922	180 VA					1	20 A		REC TELEC			
3	PWR-C TELECOM 149 - RACK RECEPTACLE		20 A	3			1922 VA	180 VA			1	20 A		REC TELEC	OM 149		
5	11001 111011								1922 VA	180 VA	1	20 A		REC TELEC	OM 149		
7	PWR-C TELECOM 149 - RACK				1922	180 VA					1	20 A		REC TELEC	OM 149		
	RECEPTACLE		20 A	3			1922 VA	50 VA			1	20 A		LTG TELECO	DM 149	1	
11									1922 VA							1	
13	PWR-C TELECOM 149 - RACK				1922		1000111									1	
15	RECEPTACLE		20 A	3			1922 VA		4000 \ / 4							•	
17					1400				1922 VA								
19 21	SSIU-149/SSOU-149		30 A	2	1488		1488 VA									2	
	SPARE		20 A	1			1400 VA		0 VA							2	
	SPARE		20 A	1	0 VA				UVA								
	SPARE		20 A	1	3 47		0 VA										
	SPARE		20 A	1			0 171		0 VA							;	
31	-····-			•	0 VA				U 111								
	SPARE		20 A	3			0 VA									;	
35									0 VA							(
37																(
39																4	
41																4	
			TOTAL	AMPS:	: 6	13 VA 5 A		I A	50	5 VA) A							
	O CLASSIFICATION		СО		TED LOA	DEN				ESTIMATED DEMAND							
LTG					VA		125.00%			62 VA			CONNECTED CURRENT: 59 A				
REC			720 VA 2975 VA				100.00%			720 VA 3689 VA			CONNECTED CURRENT: 58 A DEMAND LOAD: 18118 VA				
MTR PWR	NC				5 VA 95 VA		124.00%			13648 VA				CURRENT:			
r vvK	-INC			1729	J VA		78.91%		130	040 VA				% DEMAND:			
														MENT AMPS:			
														AVAILABLE:	10071		
															49 %		
												;	SPARE		50 A		
	ONE																
ODTI	ONS:			"DE 0			UT DDEAL	/ED /	'G' OR 'GI		OVIDE (GECL CIR	CUIT F	BREAKER /	'GFP' - PROVIDE GFP)	
CIRC	UIT BREAKER OPTIONS SUFFIX: 'S' UIT BREAKER / 'ERMS' - ENERGY RE /ISIONS / 'R' - PROVIDE CIRCUIT BI	DUCING	MAINT	ENANG	CE SWIT	CH / 'ZSI'											

	LOCATION: ENT SUPPLY FROM: A1 BRANCH: CRI SERVICE RATED: No MOUNTING: SUF NEMA ENCLOSURE: 1	VOLTS: 208/120 WYE PHASES: 3 WIRES: 4 INTEGRAL SPD: Yes AVAILABLE SCC (kA): 1.8							MAINS TYPE: MCB MCB/MLO RATING: 100 A MCB OPTIONS: NONE SECTIONS: 1 PANEL POLES: 42								
C	CIRCUIT DESCRIPTION	OPT	RATI	POL		A	E	3	(.	POL	RATI	ОРТ	CIRCUIT DESCRIPTION			
1	PWR-C TELECOMM 1026A - RACK				1922	360 VA					1	20 A		REC TELECOMM 1026A			
5	RECEPTACLE		20 A	3			1922 VA	149 VA	1922 VA	1195	1	20 A		LTG TELECOMM 1026A, 1026B			
7					1922	1195 VA			1022 171	1100	2	25 A		SSIU-1026AA/SSOU-1026AA			
9	PWR-C TELECOMM 1026A - RACK RECEPTACLE		20 A	3			1922 VA	1195 VA			2	25 A		SSIU-1026BA/SSOU-1026BA			
11									1922 VA	1195							
13	PWR-C TELECOMM 1026A - RACK		00.4		1922	360 VA	4000 \ / 4				1	20 A		REC - TELEPHONE 1026B			
15 17	RECEPTACLE		20 A	3			1922 VA		1922 VA								
	REC TELECOMM 1026A		20 A	1	360 VA				1022 VA								
	REC TELECOMM 1026A		20 A	1			360 VA										
23	REC TELECOMM 1026A		20 A	1					360 VA								
	SPARE		20 A	1	0 VA												
	SPARE		20 A	1			0 VA		23/4								
29 31	SPARE		20 A	1	0.1/4				0 VA						+		
	SPARE		20 A	3	0 VA		0 VA										
35	OF AIRE		20 A				OVA		0 VA								
	SPARE		20 A	1	0 VA				U 17 1								
39	SPARE		20 A	1			0 VA										
41			TOTAL			0 VA		9 VA	851								
	D CLASSIFICATION		CO	NNECT	TED LOA	D DEN	IAND FA		72 ESTIMAT	ED DEM	AND		ONNE	PANEL TOTALS			
LTG 149 REC 1800					VA) VA		125.00%			36 VA 00 VA		CONNECTED LOAD: 24024 VA CONNECTED CURRENT: 67 A					
MTR 4780							112.11%			59 VA		DEMAND LOAD: 20992 VA					
	R-NC			1729			78.91%			648 VA		D		D CURRENT: 58 A			
												CONSID	ER 125	5% DEMAND : 26240 A			
														MENT AMPS: 100 A			
												FE	EDER	AVAILABLE:			
													SPARE	E CAPACITY: 41 %			
						-								42 A			
ОРТ	IONS:																
CIR(CUIT BREAKER OPTIONS SUFFIX: 'S' CUIT BREAKER / 'ERMS' - ENERGY RE VISIONS / 'R' - PROVIDE CIRCUIT B	DUCIN	G MAIN	ΓΕΝΑΝ	CE SWIT)		
	ERAL REMARKS:																
GEN	LIVAL INLINIATING.																

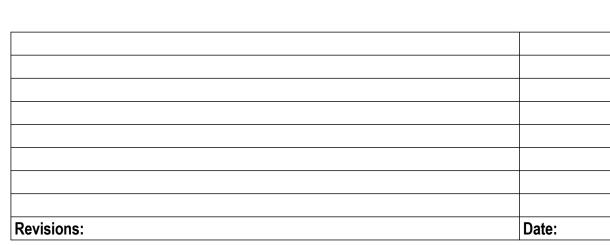


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CONSULTANT

ARCHITECT/ENGINEER OF RECORD | STAMP



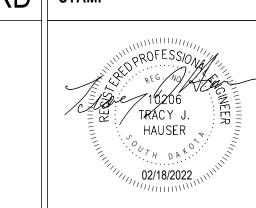

Office of Construction and Facilities Management

Drawing Title

PANEL SCHEDULES - BUILDING 5 -FIRST LEVEL - AREA B

BID DOCUMENTS

Project Title Project Number VAMC SIOUX FALLS EHRM 438-20-910 **Building Number** INFRASTRUCTURE UPGRADES Drawing Number Sioux Falls, SD Checked Drawn EE411-05-B


FULLY SPRINKLERED KSB NMT 02/18/2022


VA FORM 08 - 6231


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U.S. Department of Veterans Affairs






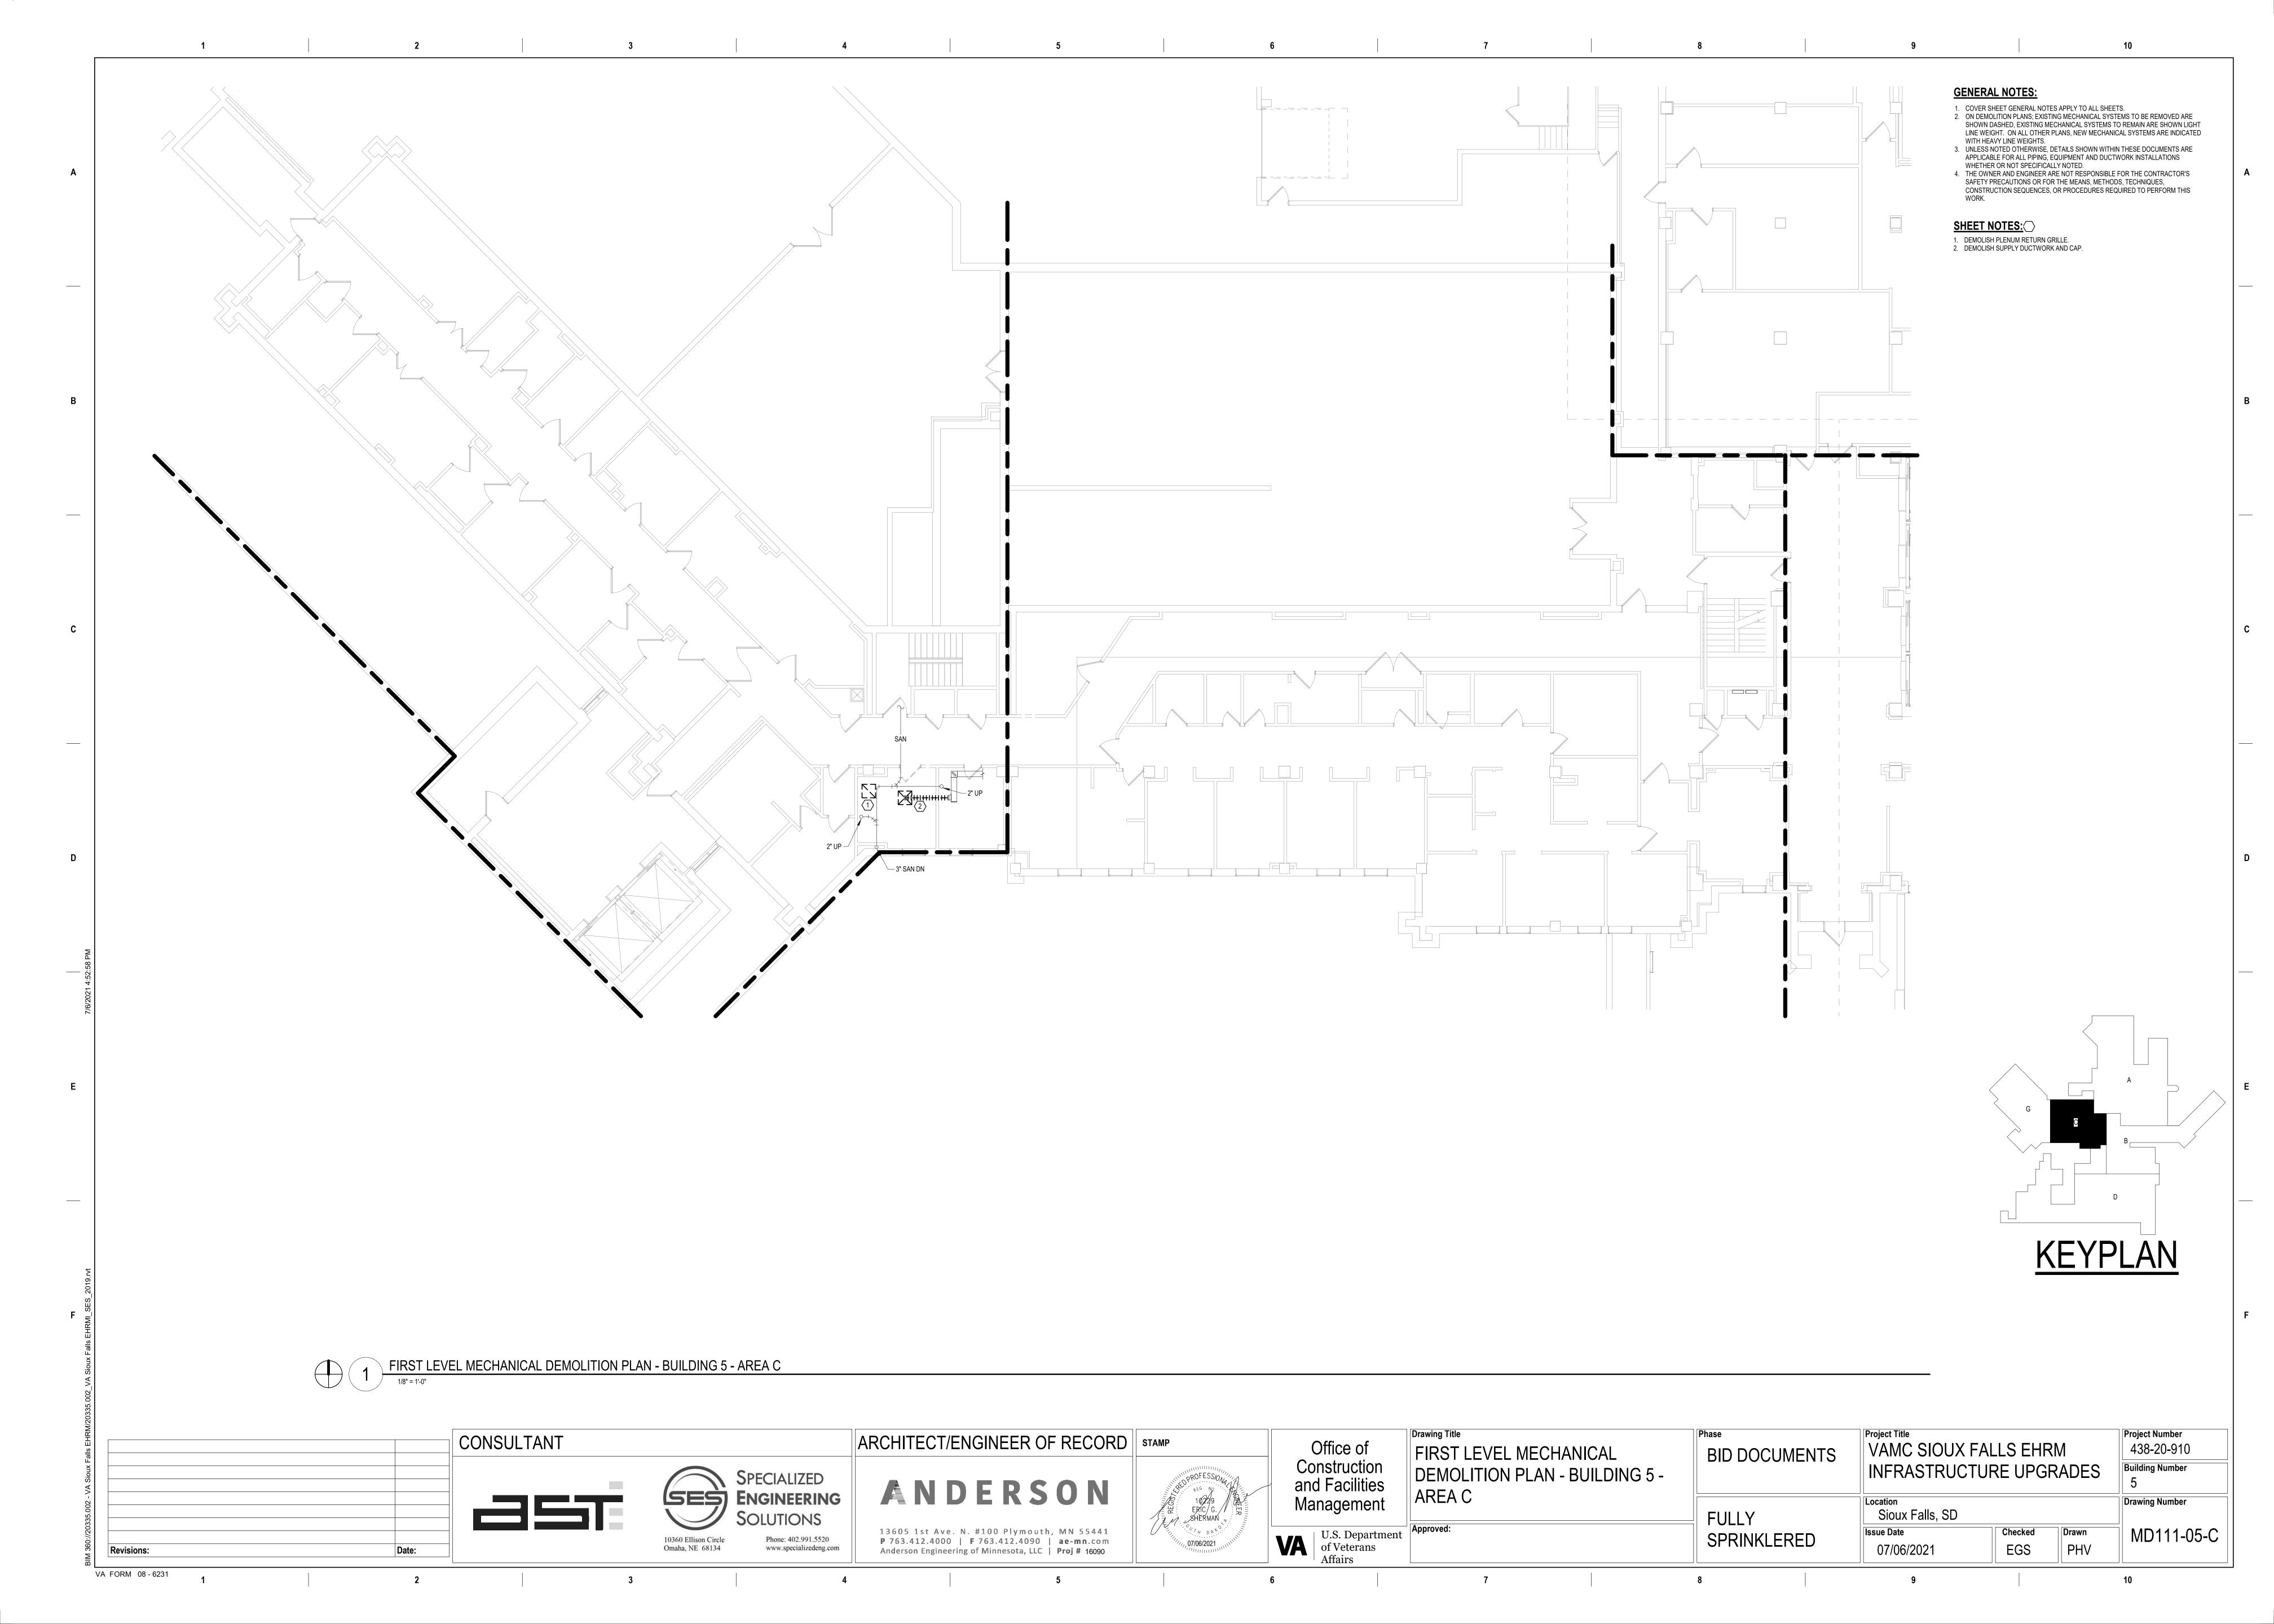


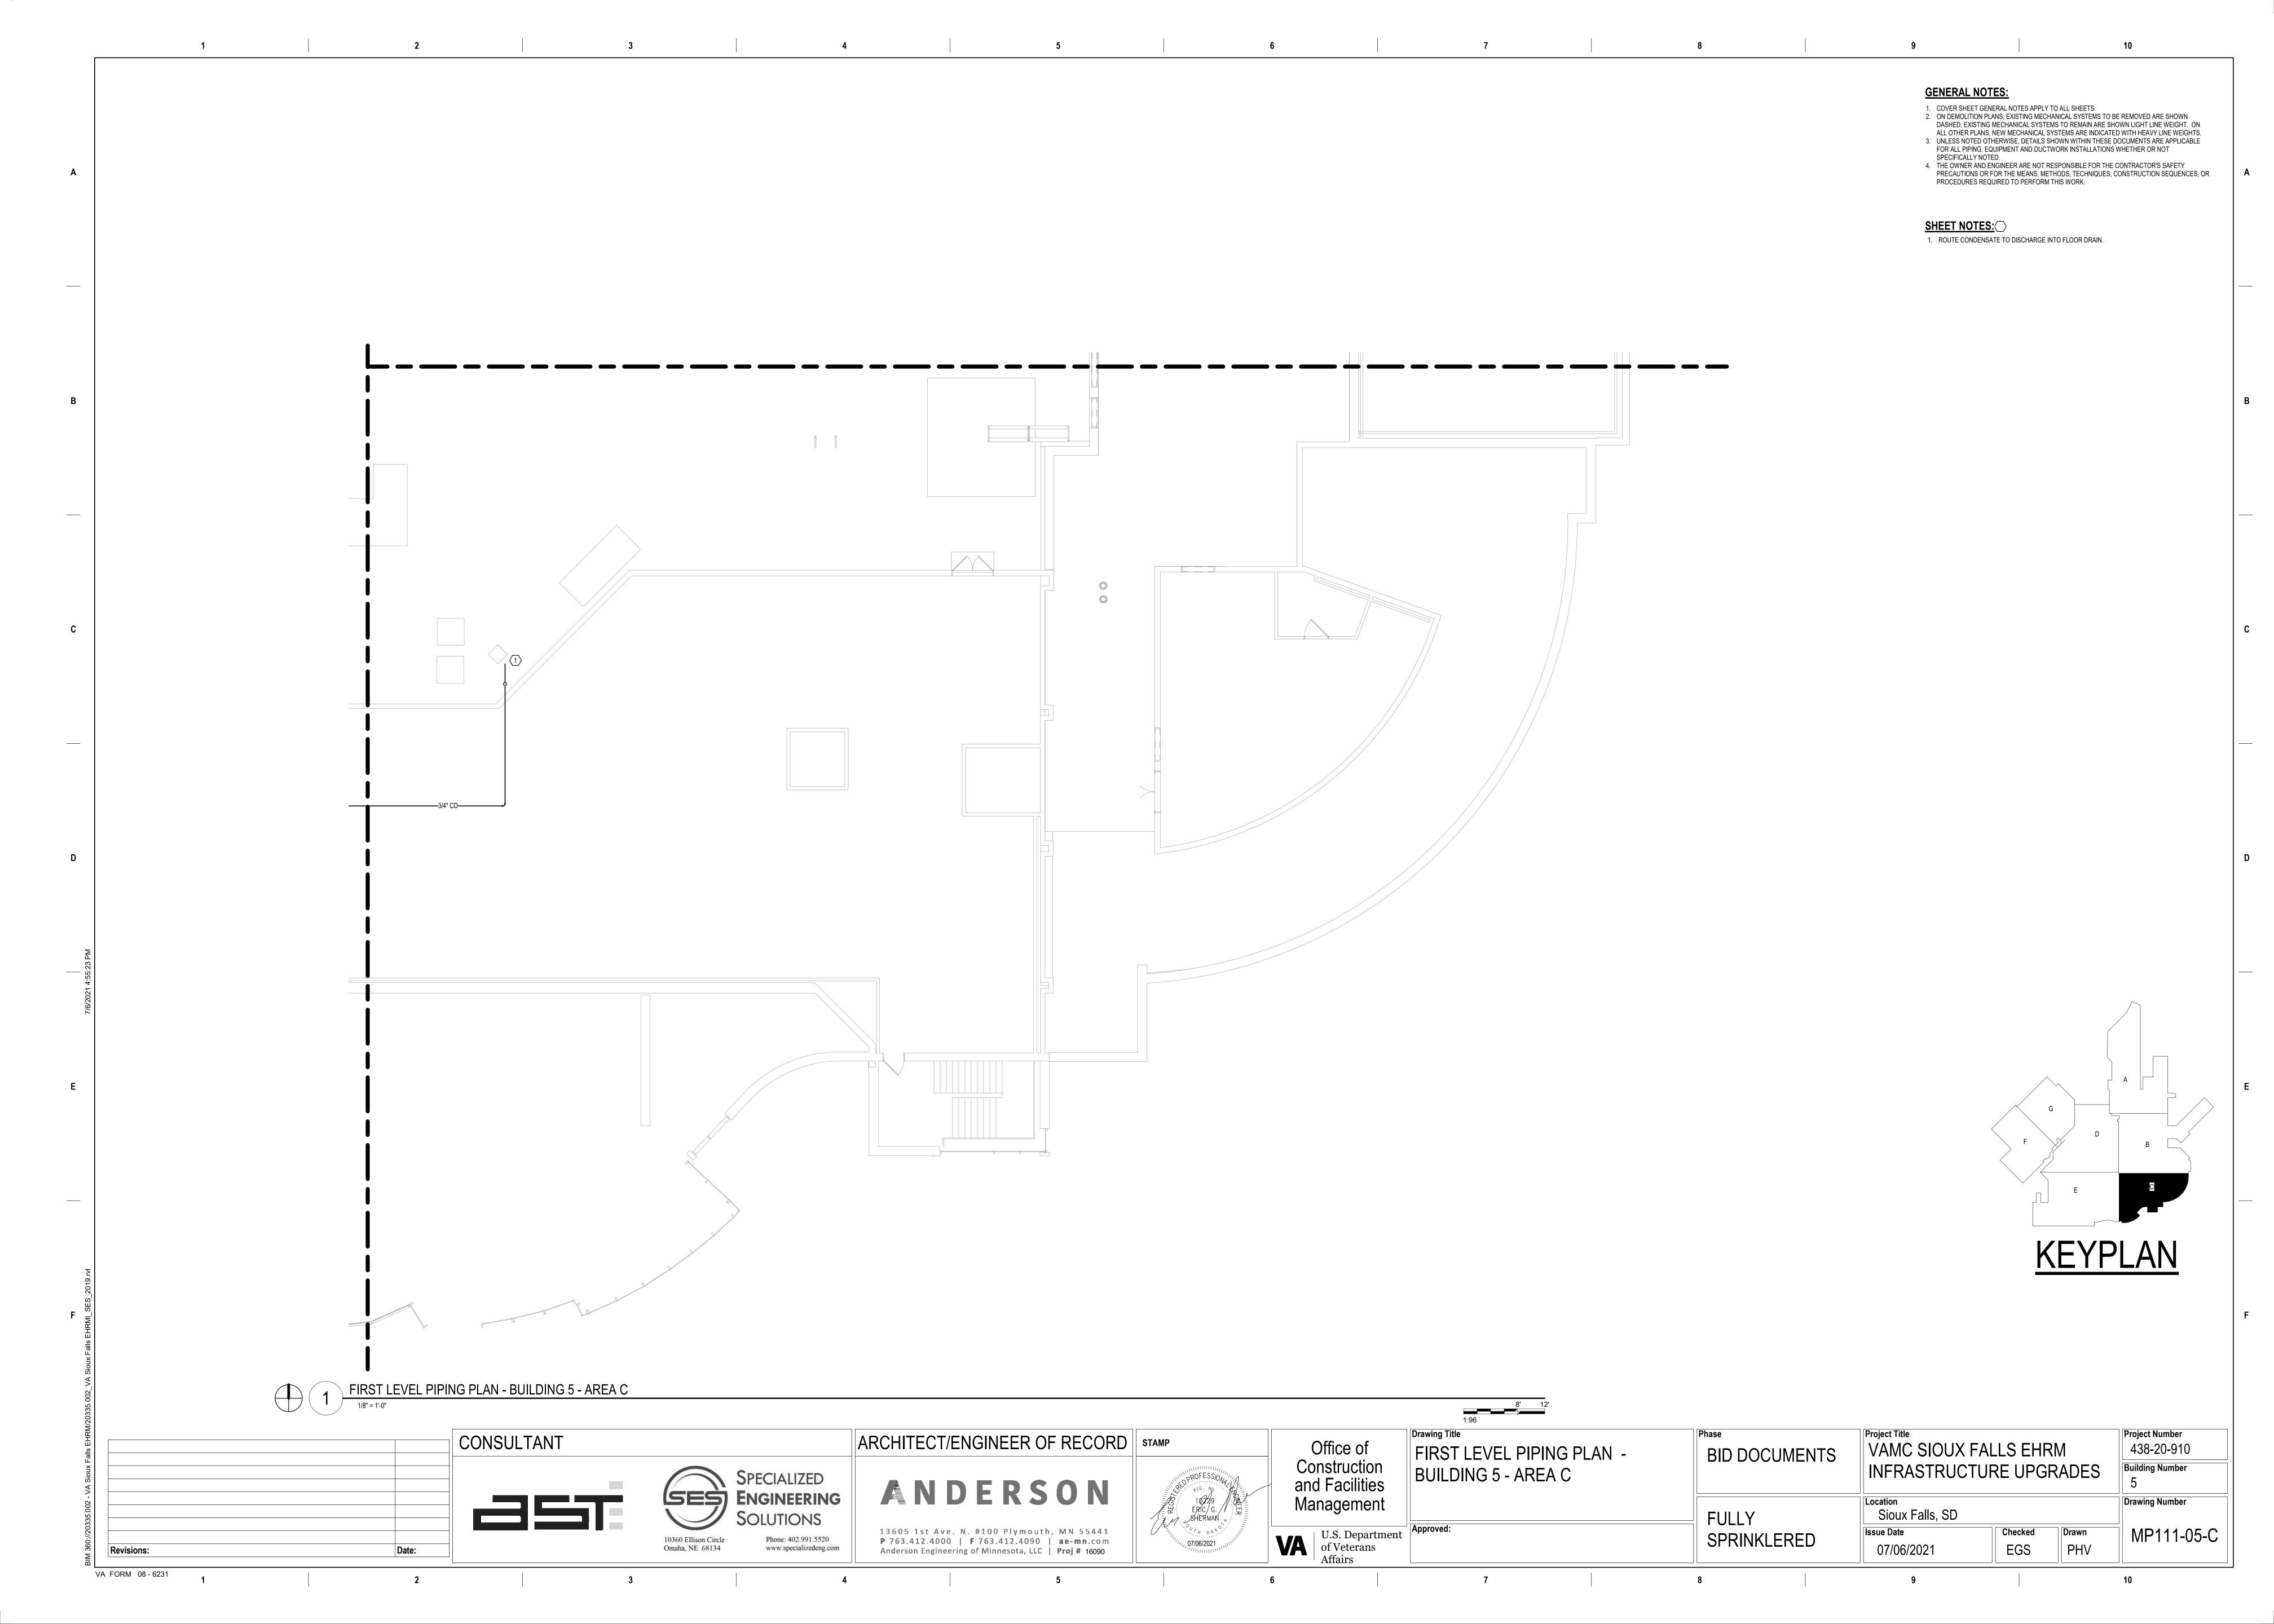
CABLING NOTES: A. THE EXISTING CABLE COUNT ARE THE CABLES CURRENTLY PRESENT IN THE SPACE. THE CABLE RELOCATION COUNT ARE THE NEW OR RELOCATED CABLES TO BE FED FROM THE SPACE. THE FINAL CABLE COUNT ARE THE CABLES THAT WILL BE PRESENT IN THE SPACE AT THE COMPLETION OF THE PROJECT. REMOVE ALL UNUSED CABLING AT THE COMPLETION OF THE PROJECT. 1. ROOM 1021 **EXISTING CABLE COUNT** DATA (CAT6): 174 DATA (CAT5): 0 PATIENT MONITORING: 0 COMMERCIAL WIRELESS: 0 CABLE RELOCATION COUNT DATA (CAT6): -174 TO ROOM A27 DATA (CAT5): 0 VIDEO: -1 TO ROOM A27 PATIENT MONITORING: 0 COMMERCIAL WIRELESS: 0 EXISTING CABLE TO REMAIN DATA (CAT6): 0 VIDEO: 0 PATIENT MONITORING: 0 COMMERCIAL WIRELESS: 0 FINAL CABLE COUNT DATA (CAT6): 0 VIDEO: 0 PATIENT MONITORING: 0 COMMERCIAL WIRELESS: 0 SHEET NOTES: EXISTING TELEPHONE WALL FIELD TO BE DEMOLISHED. NEW COPPER
BACKBONE TO BE PROVIDED ON PATCH PANELS IN TELECOMMUNICATIONS RACK. REFER TO CABLING NOTES AND NEW WORK PLANS FOR ADDITIONAL REQUIREMENTS. E FAPS FIRST LEVEL ELECTRICAL DEMOLITION - BUILDING 5 - AREA C - ROOM 1021 Drawing Title Project Title Project Number CONSULTANT ARCHITECT/ENGINEER OF RECORD | STAMP Office of VAMC SIOUX FALLS EHRM 438-20-910 FIRST LEVEL ELECTRICAL **BID DOCUMENTS** Construction and Facilities **Building Number** INFRASTRUCTURE UPGRADES DEMOLITION - BUILDING 5 -SPECIALIZED Bicsi ANDERSON ENLARGED ROOMS - AREA C SES ENGINEERING Drawing Number Management Sioux Falls, SD **FULLY** 5 BICSI ID # 346555 13605 1st Ave. N. #100 Plymouth, MN 55441
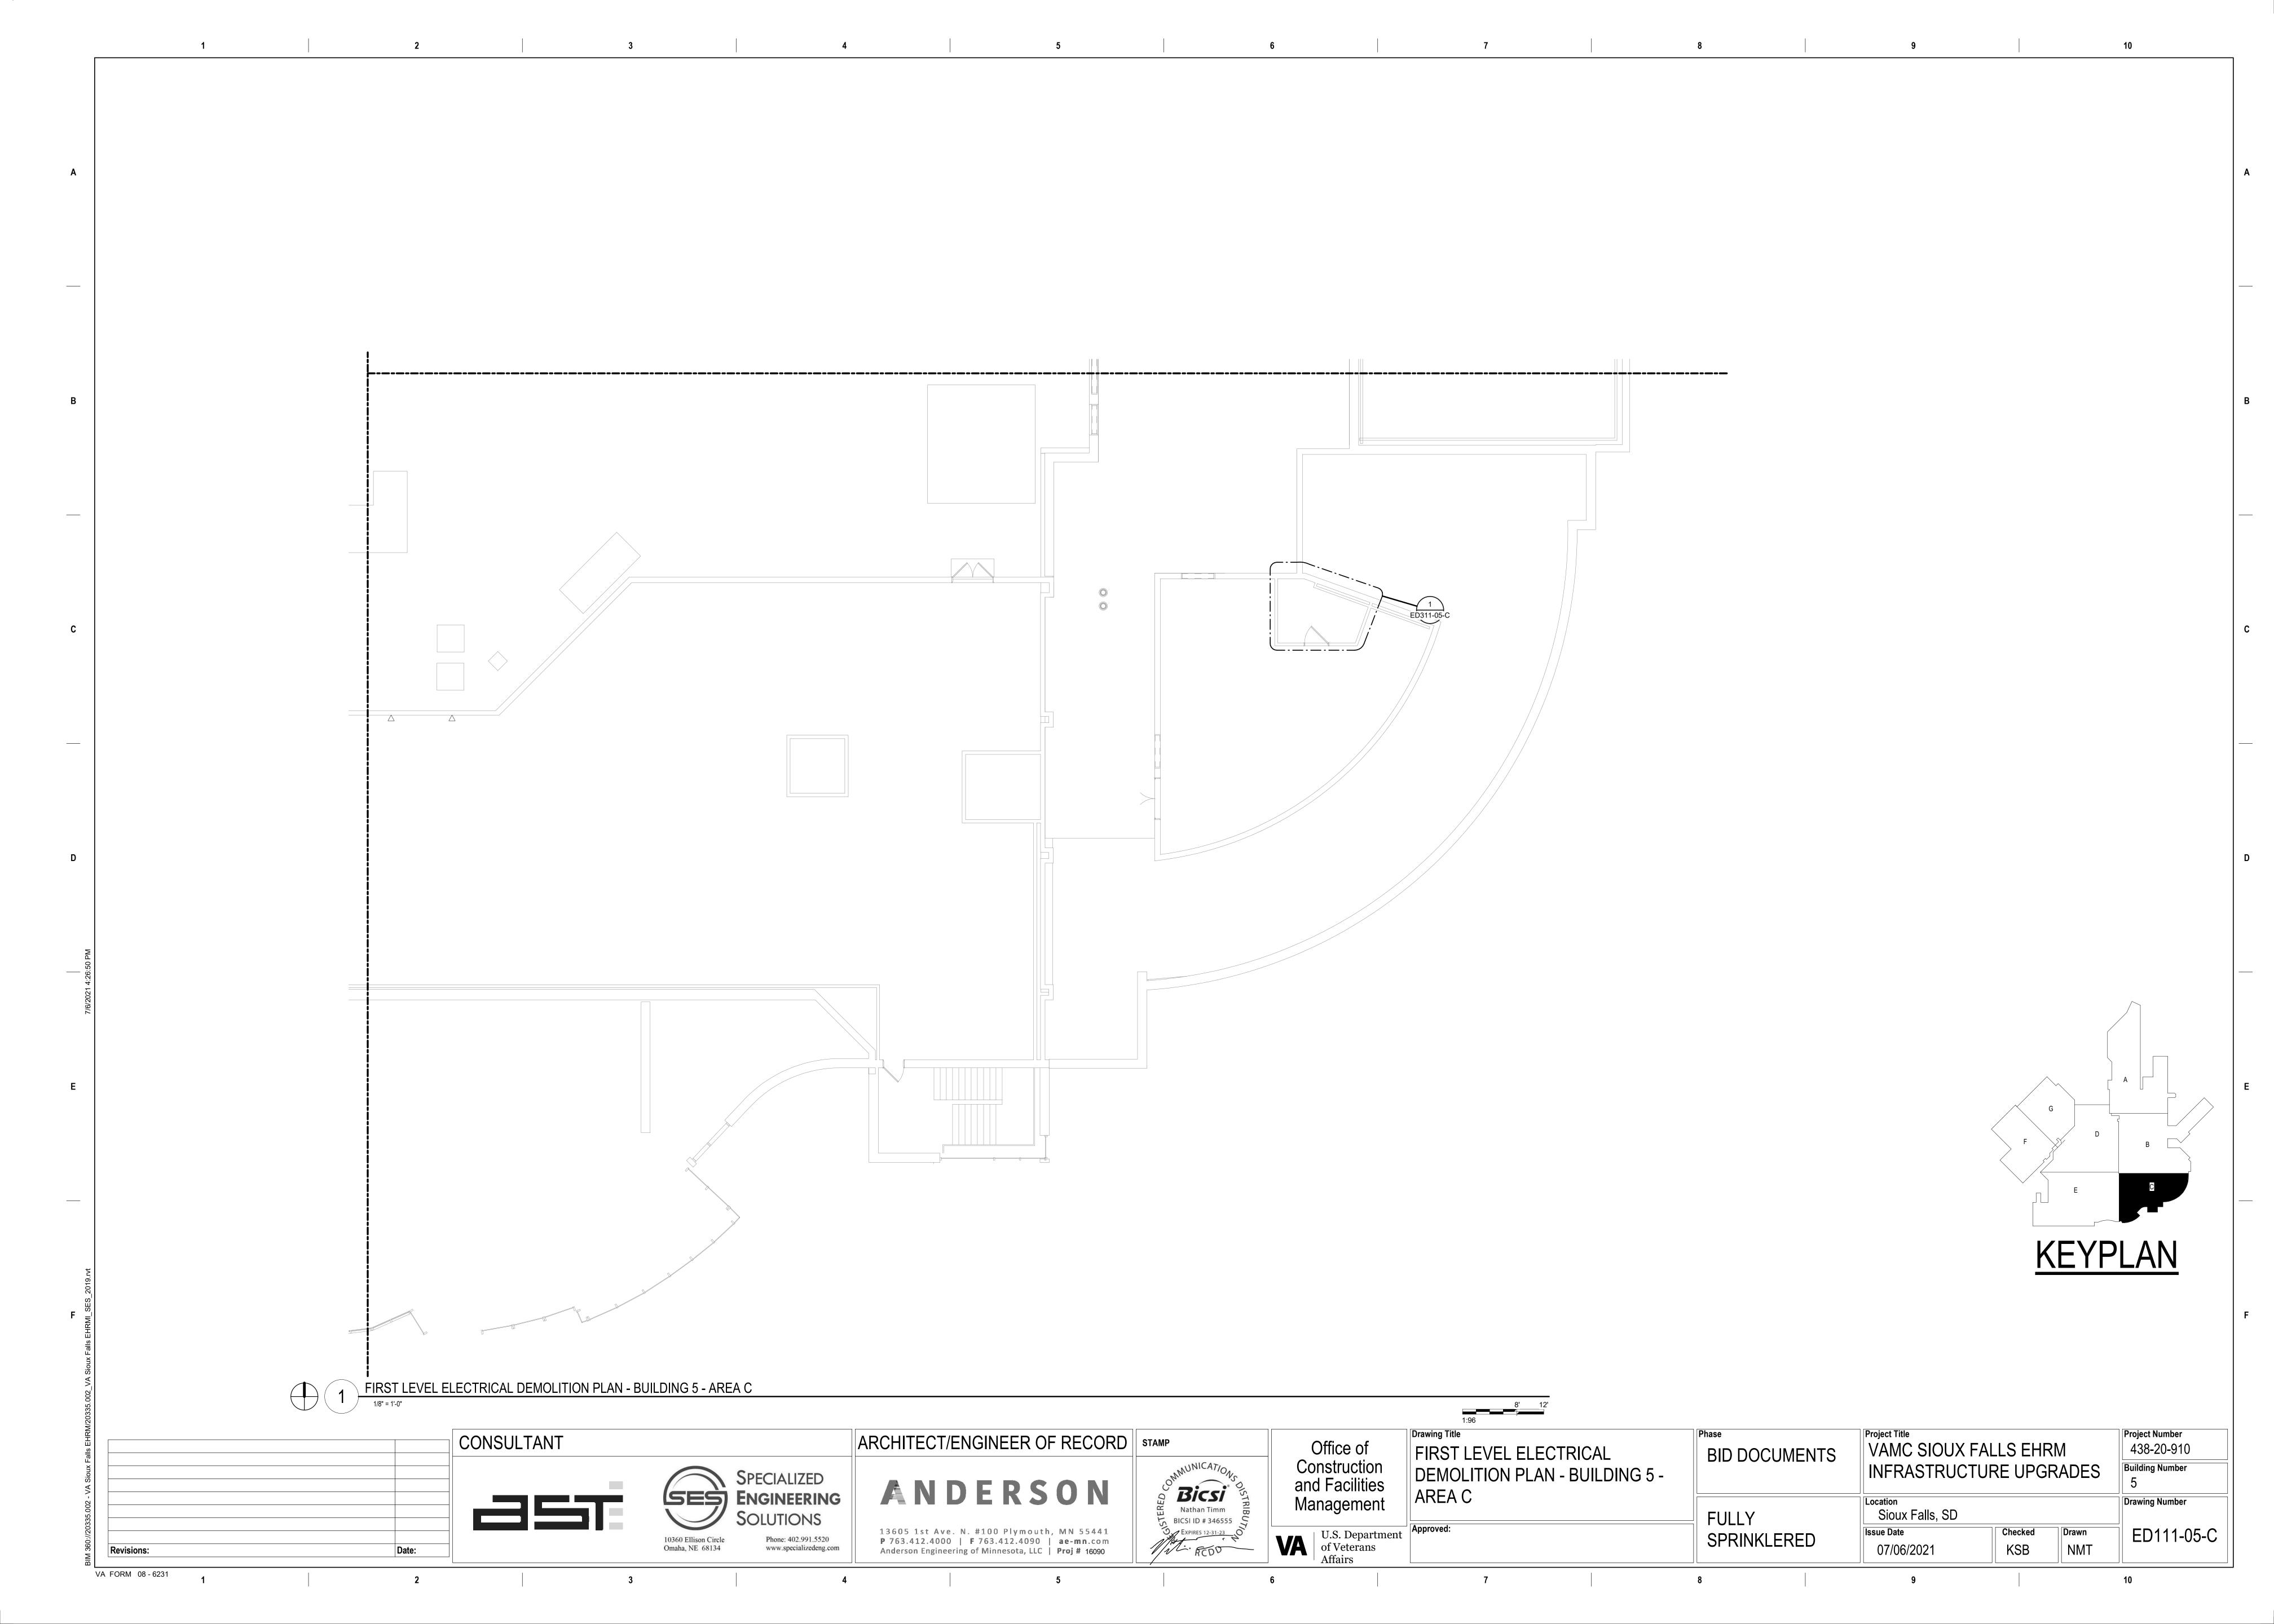
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Anderson Engineering of Minnesota, LLC | Proj # 16090 EXPIRES 12-31-23 NOT Checked Drawn U.S. Department of Veterans Affairs ED311-05-C SPRINKLERED 10360 Ellison Circle Phone: 402.991.5520 KSB NMT 07/06/2021 Omaha, NE 68134 www.specializedeng.com Revisions: VA FORM 08 - 6231



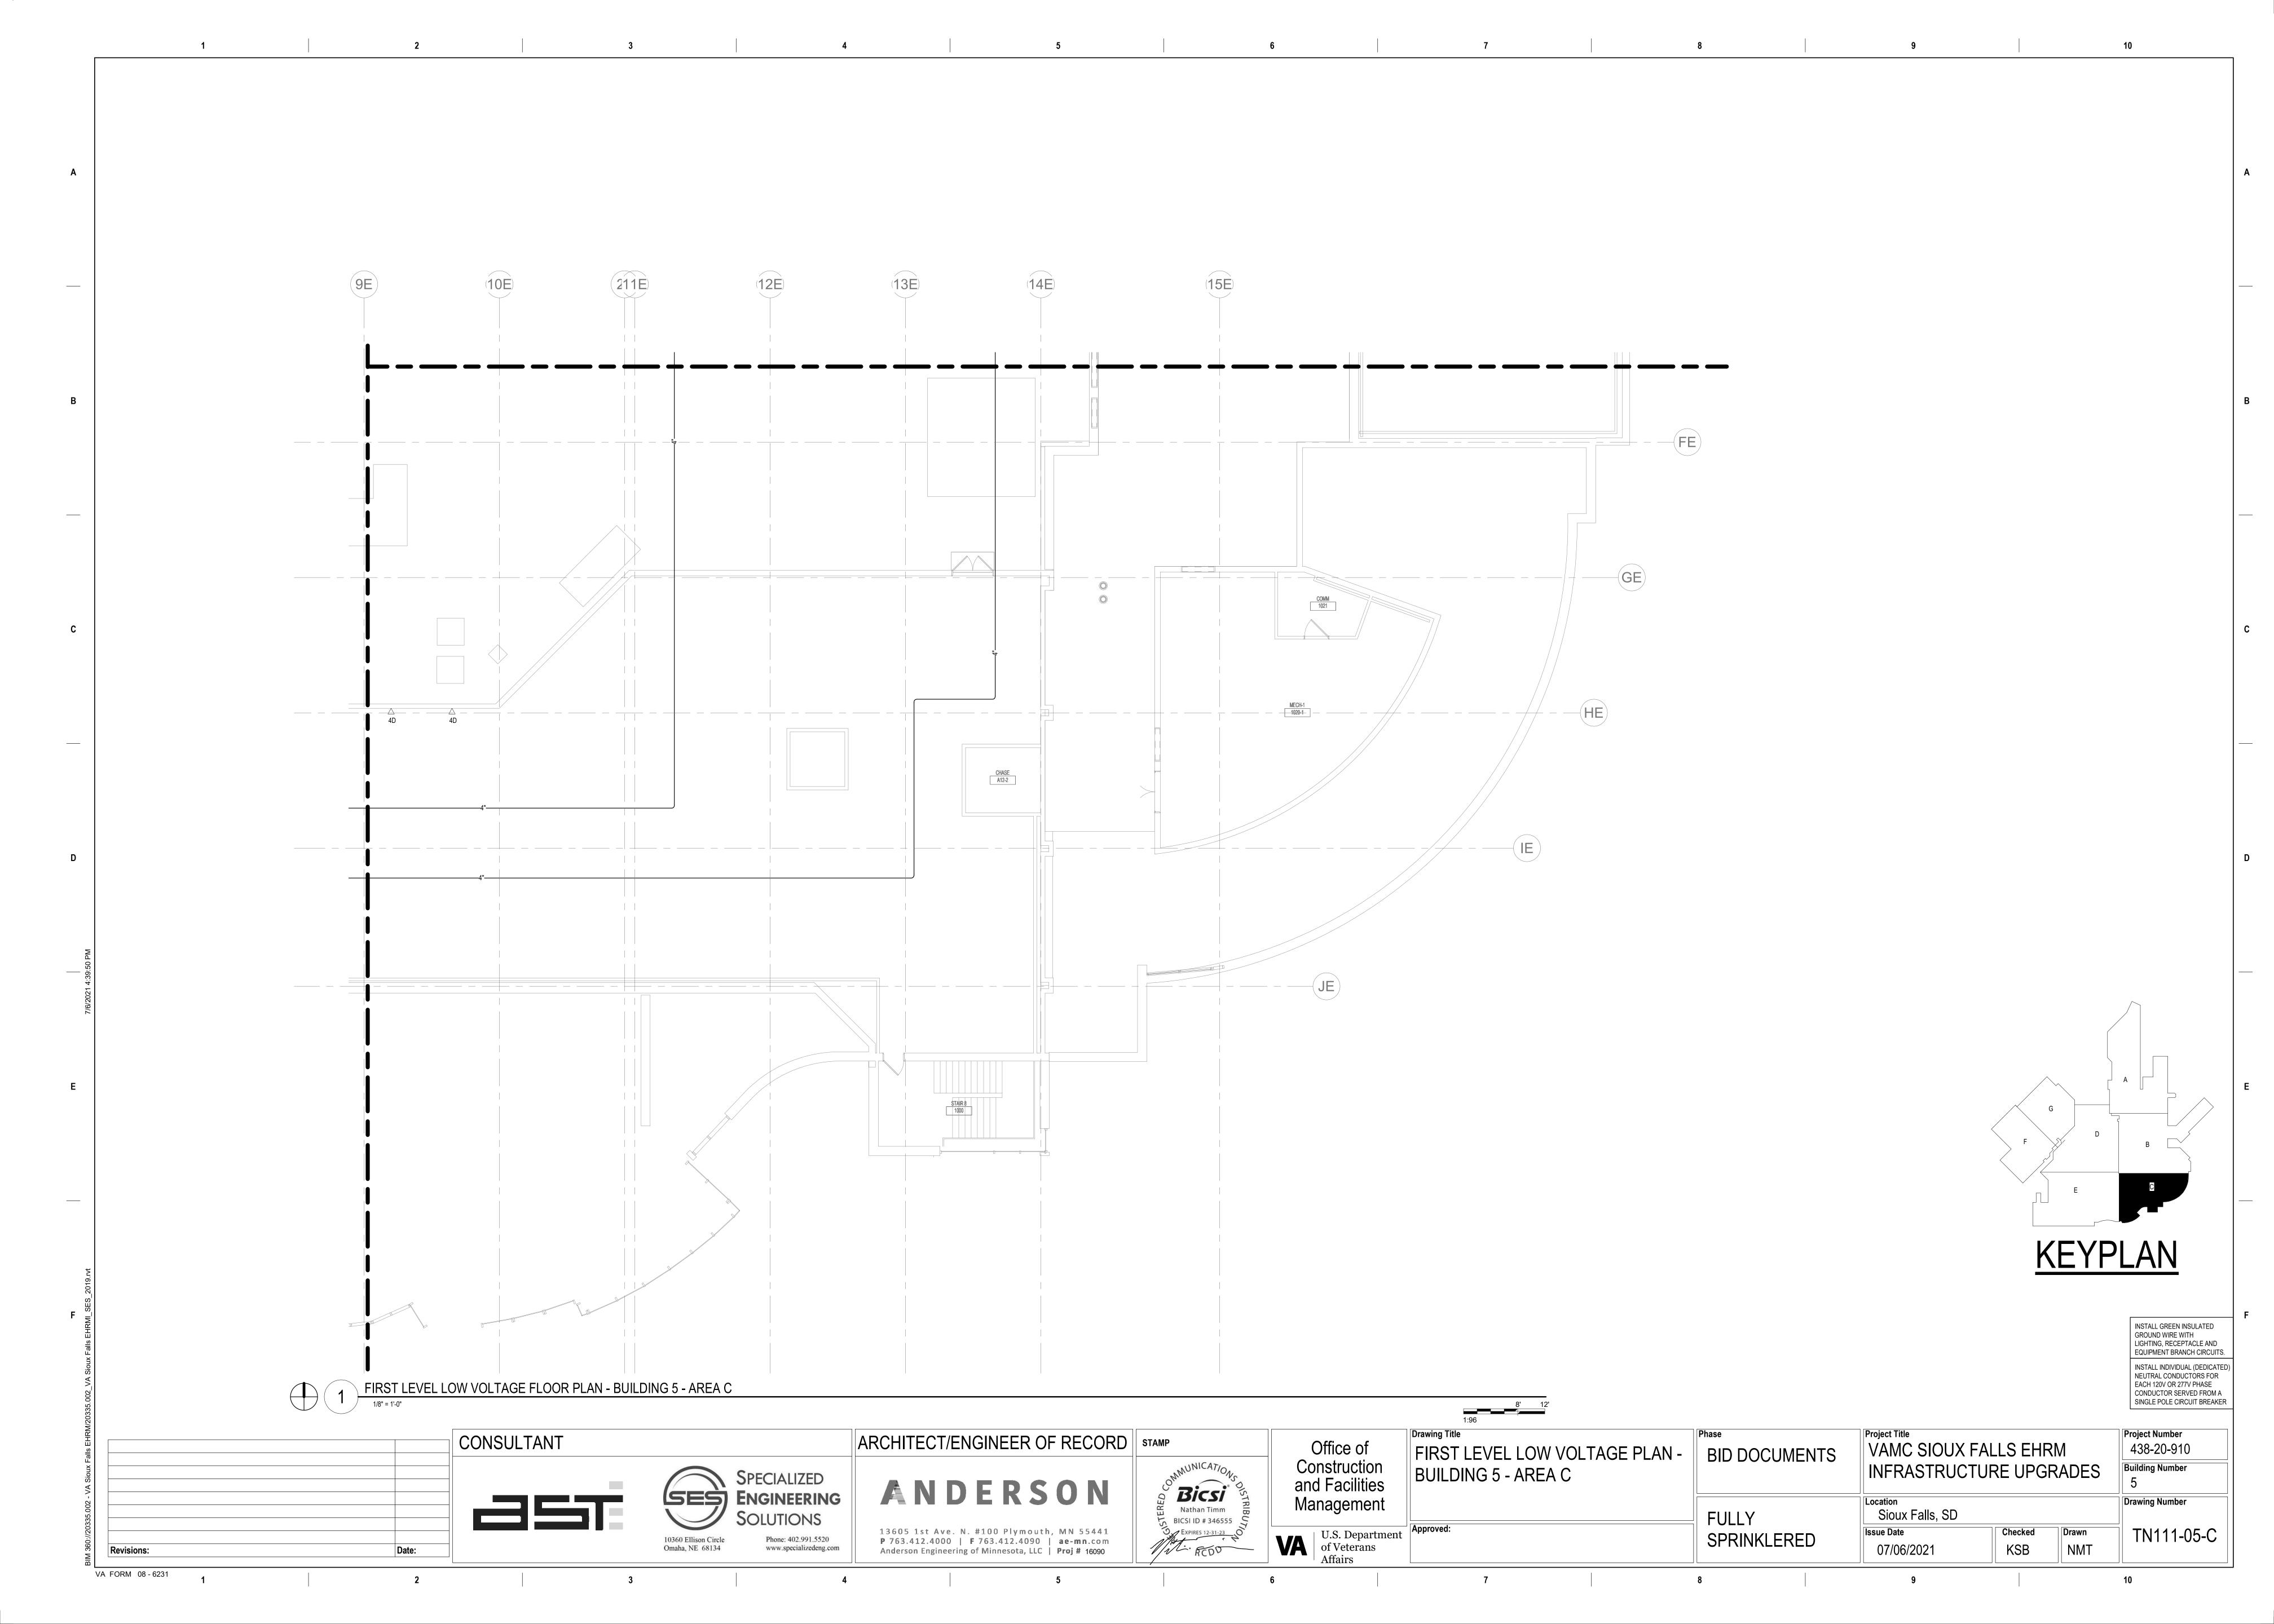

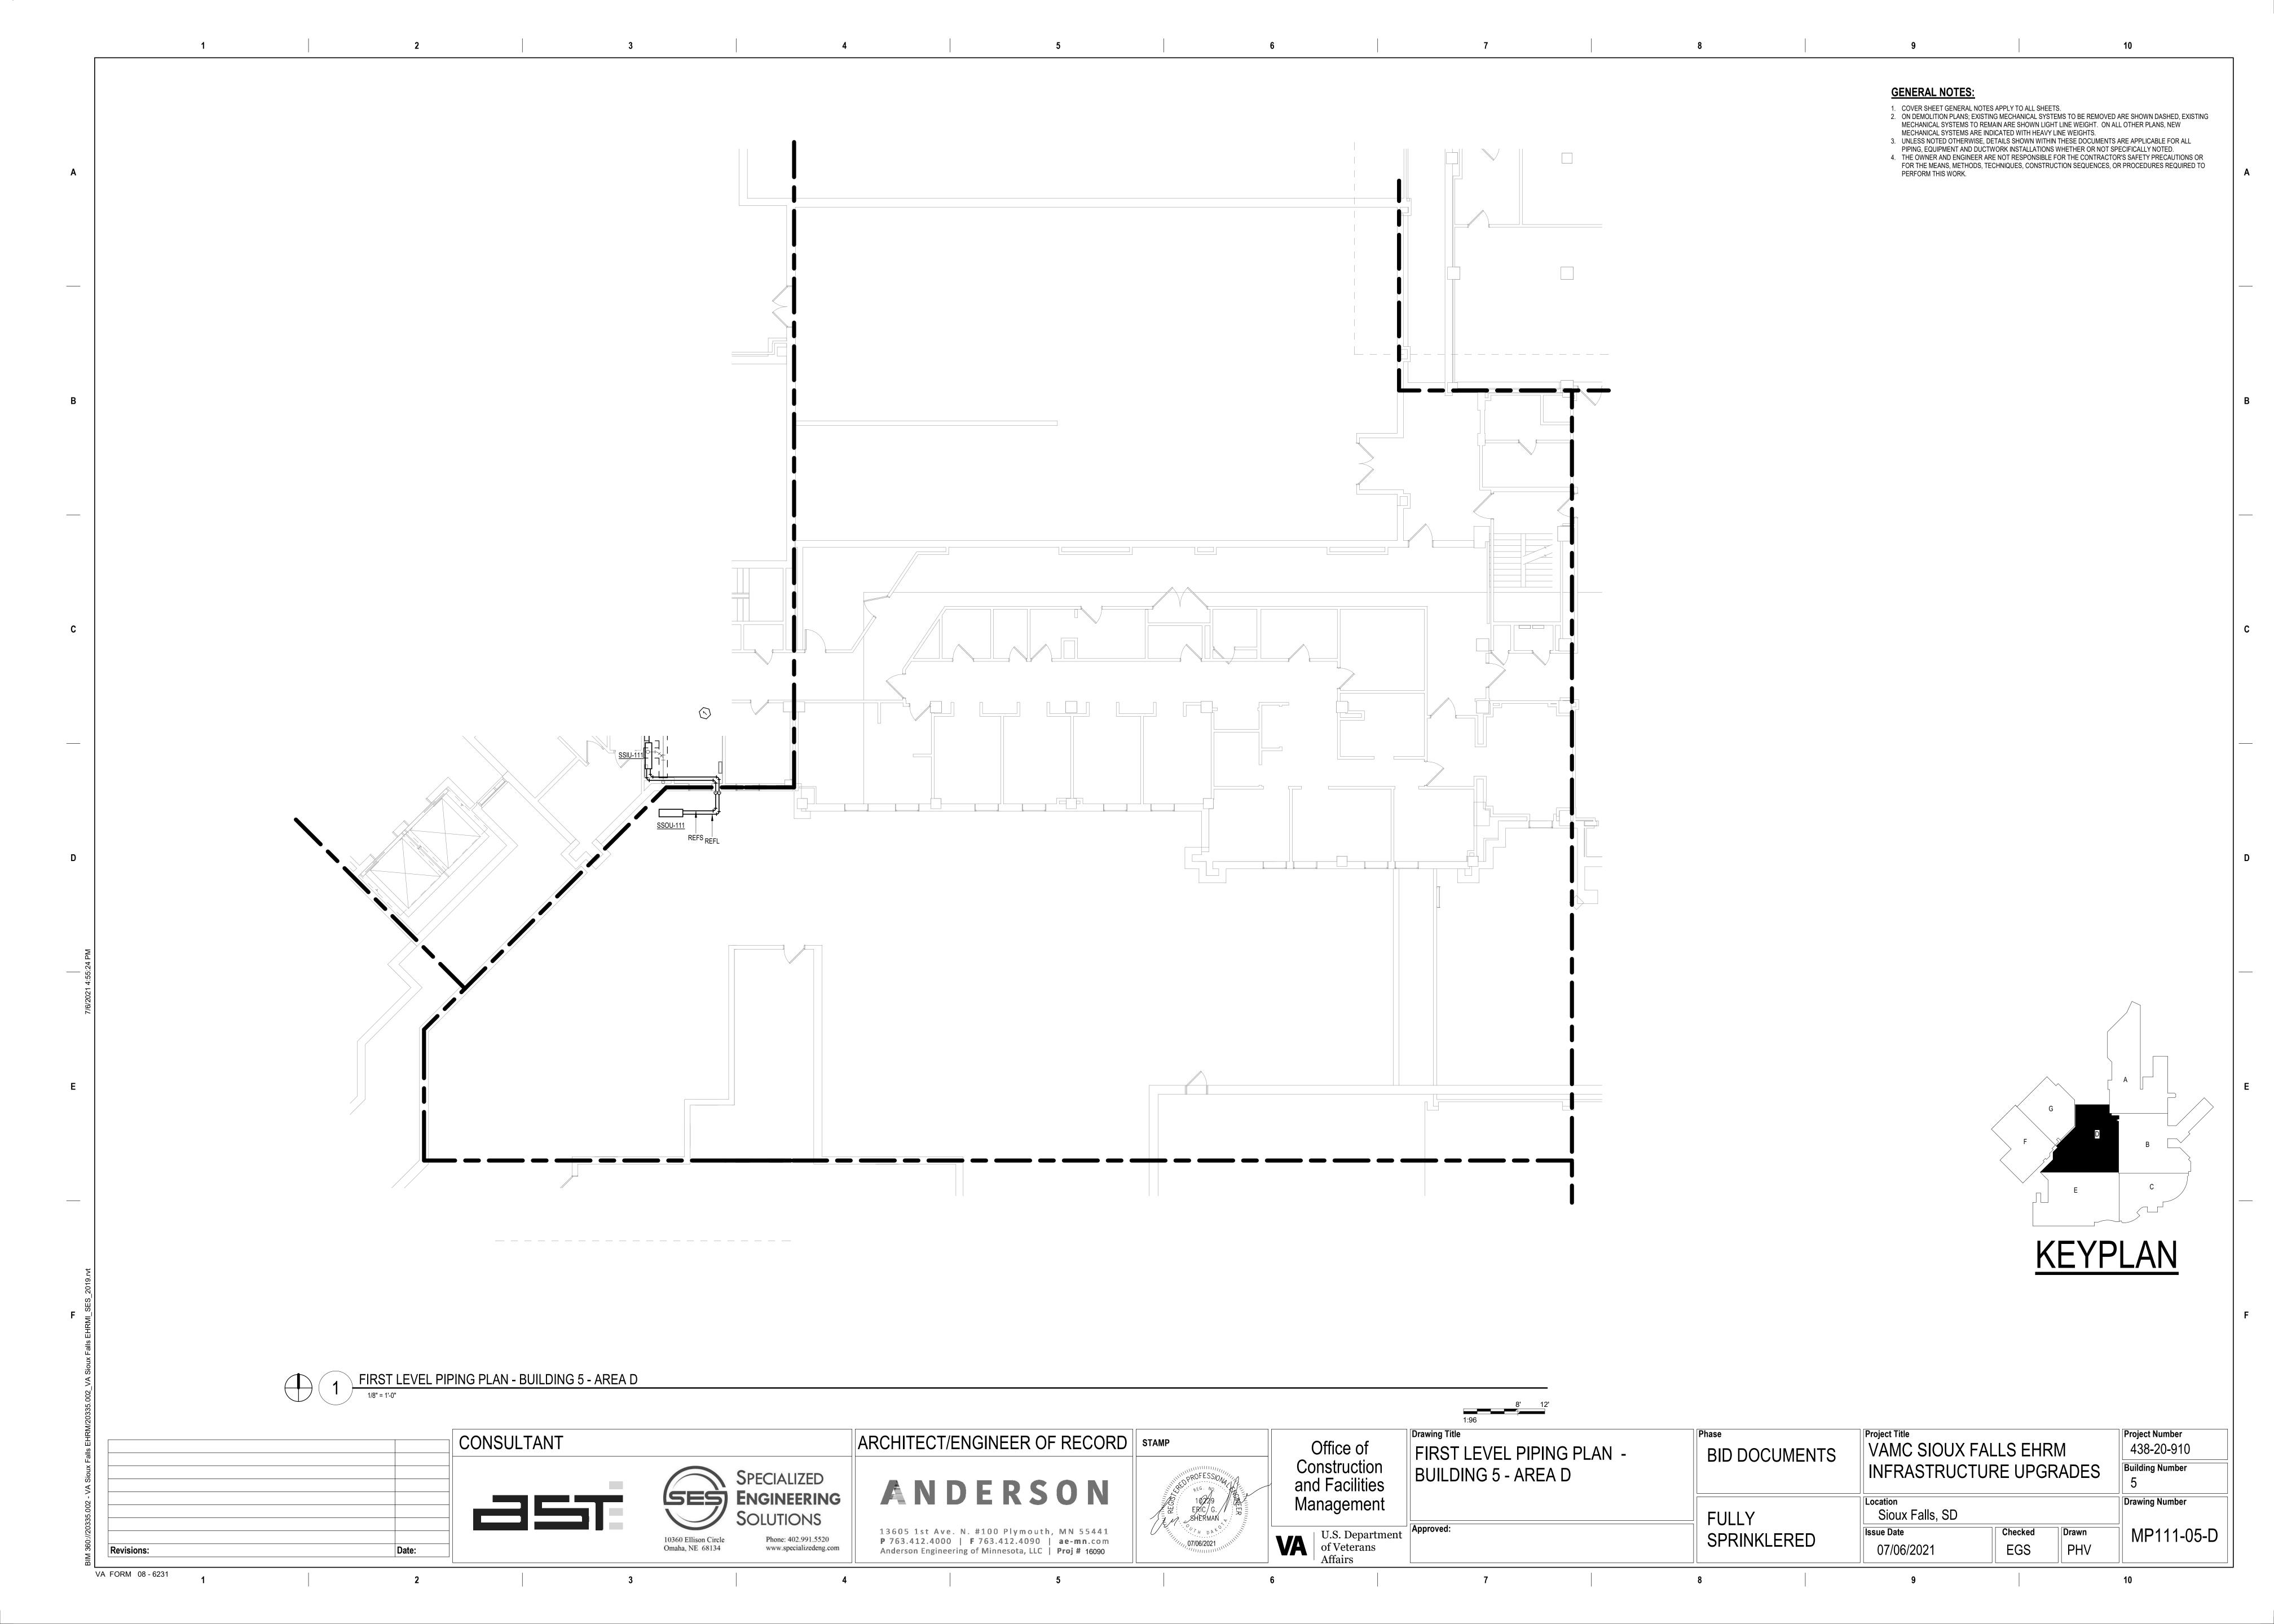

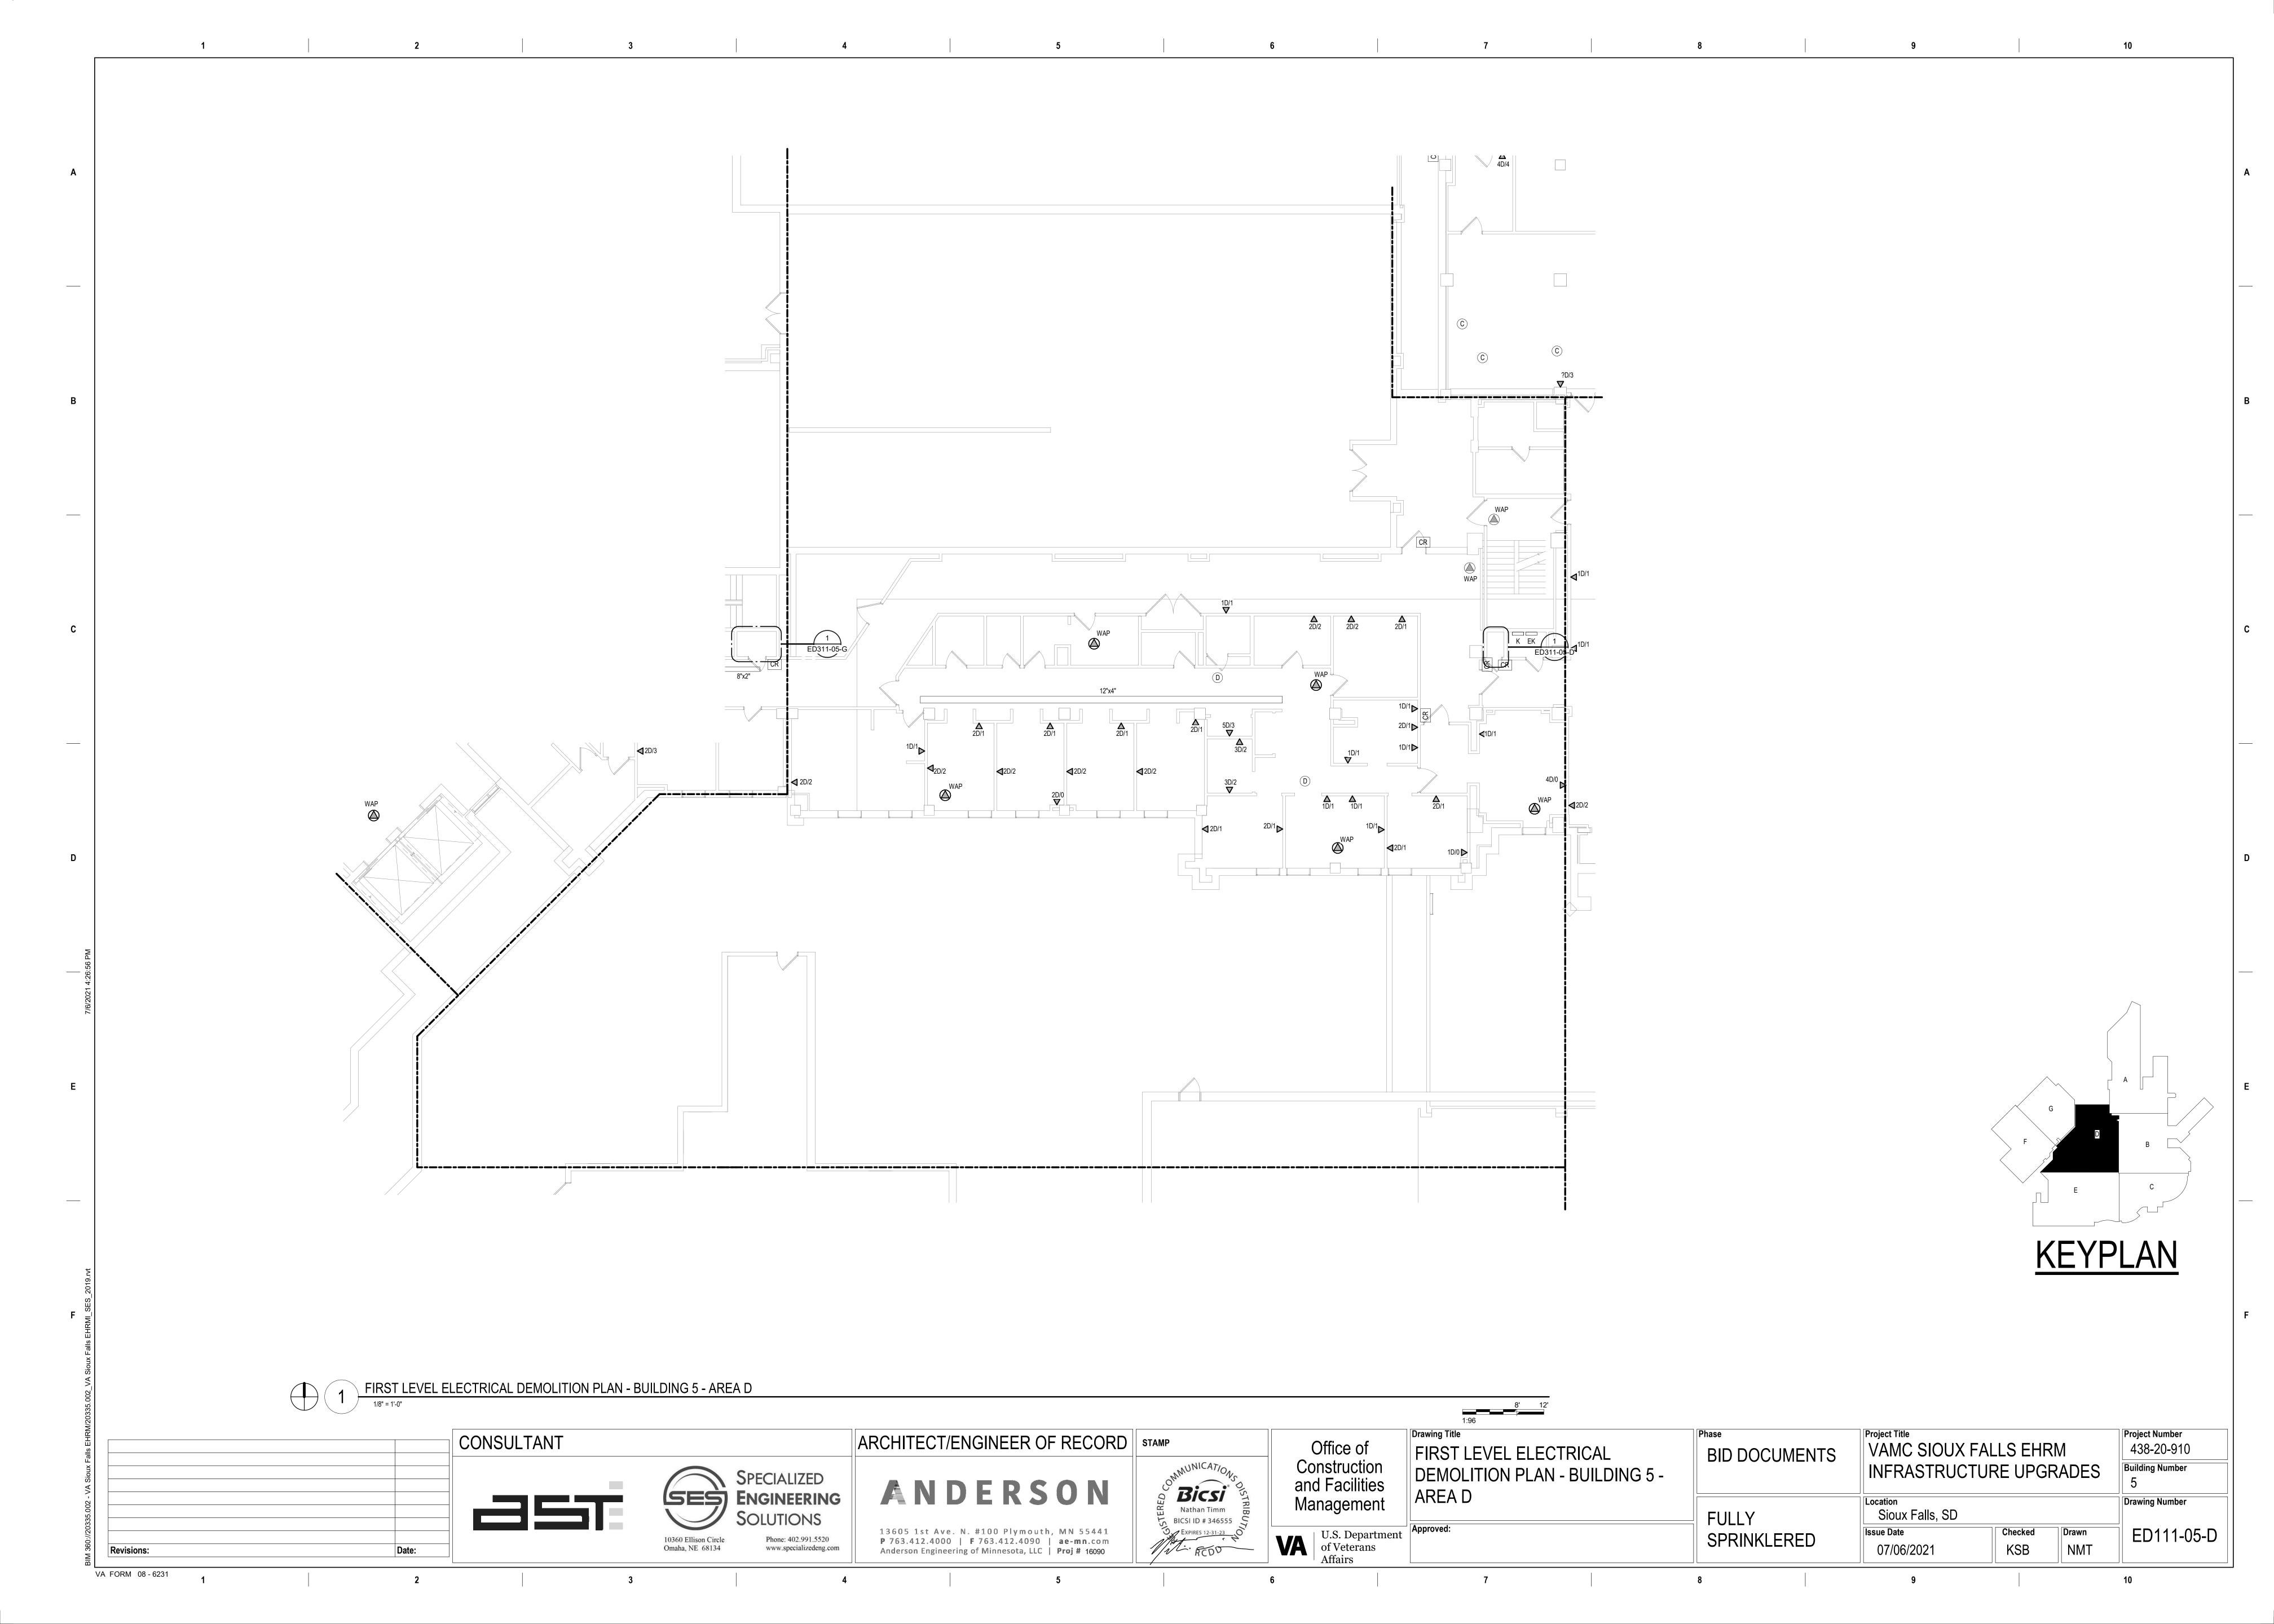FIRST LEVEL ELECTRICAL DEMOLITION - BUILDING 5 - AREA D - ROOM 137

CABLING NOTES:

A. THE EXISTING CABLE COUNT ARE THE CABLES CURRENTLY PRESENT IN THE SPACE. THE CABLE RELOCATION COUNT ARE THE NEW OR RELOCATED CABLES TO BE FED FROM THE SPACE. THE FINAL CABLE COUNT ARE THE CABLES THAT WILL BE PRESENT IN THE SPACE AT THE COMPLETION OF THE PROJECT. REMOVE ALL UNUSED CABLING AT THE COMPLETION OF THE PROJECT.

1. ROOM 137

EXISTING CABLE COUNT DATA (CAT6): 0 DATA (CAT5): 0

PATIENT MONITORING: 0 COMMERCIAL WIRELESS: 1

CABLE RELOCATION COUNT DATA (CAT6): 0 DATA (CAT5): 0 VIDEO: -10 TO ROOM 149

PATIENT MONITORING: 0 COMMERCIAL WIRELESS: -1 TO ROOM 149

EXISTING CABLE TO REMAIN DATA (CAT6): 0 VIDEO: 0

PATIENT MONITORING: 0 COMMERCIAL WIRELESS: 0

FINAL CABLE COUNT DATA (CAT6): 0

PATIENT MONITORING: 0 COMMERCIAL WIRELESS: 0

SHEET NOTES:

1. EXISTING TELEPHONE WALL FIELD TO BE DEMOLISHED. NEW COPPER BACKBONE TO BE PROVIDED ON PATCH PANELS IN TELECOMMUNICATIONS RACK. REFER TO CABLING NOTES AND NEW WORK PLANS FOR ADDITIONAL REQUIREMENTS.

CONSULTANT Revisions:


VA FORM 08 - 6231

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Office of Construction and Facilities Management U.S. Department of Veterans Affairs

Drawing Title

FIRST LEVEL ELECTRICAL DEMOLITION - BUILDING 5 -ENLARGED ROOMS - AREA D

Project Title **BID DOCUMENTS**

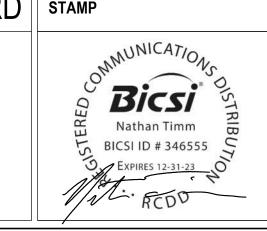VAMC SIOUX FALLS EHRM **Building Number** INFRASTRUCTURE UPGRADES


Project Number


438-20-910


ED311-05-D


FULLY SPRINKLERED


Drawing Number Sioux Falls, SD Checked Drawn KSB NMT 07/06/2021

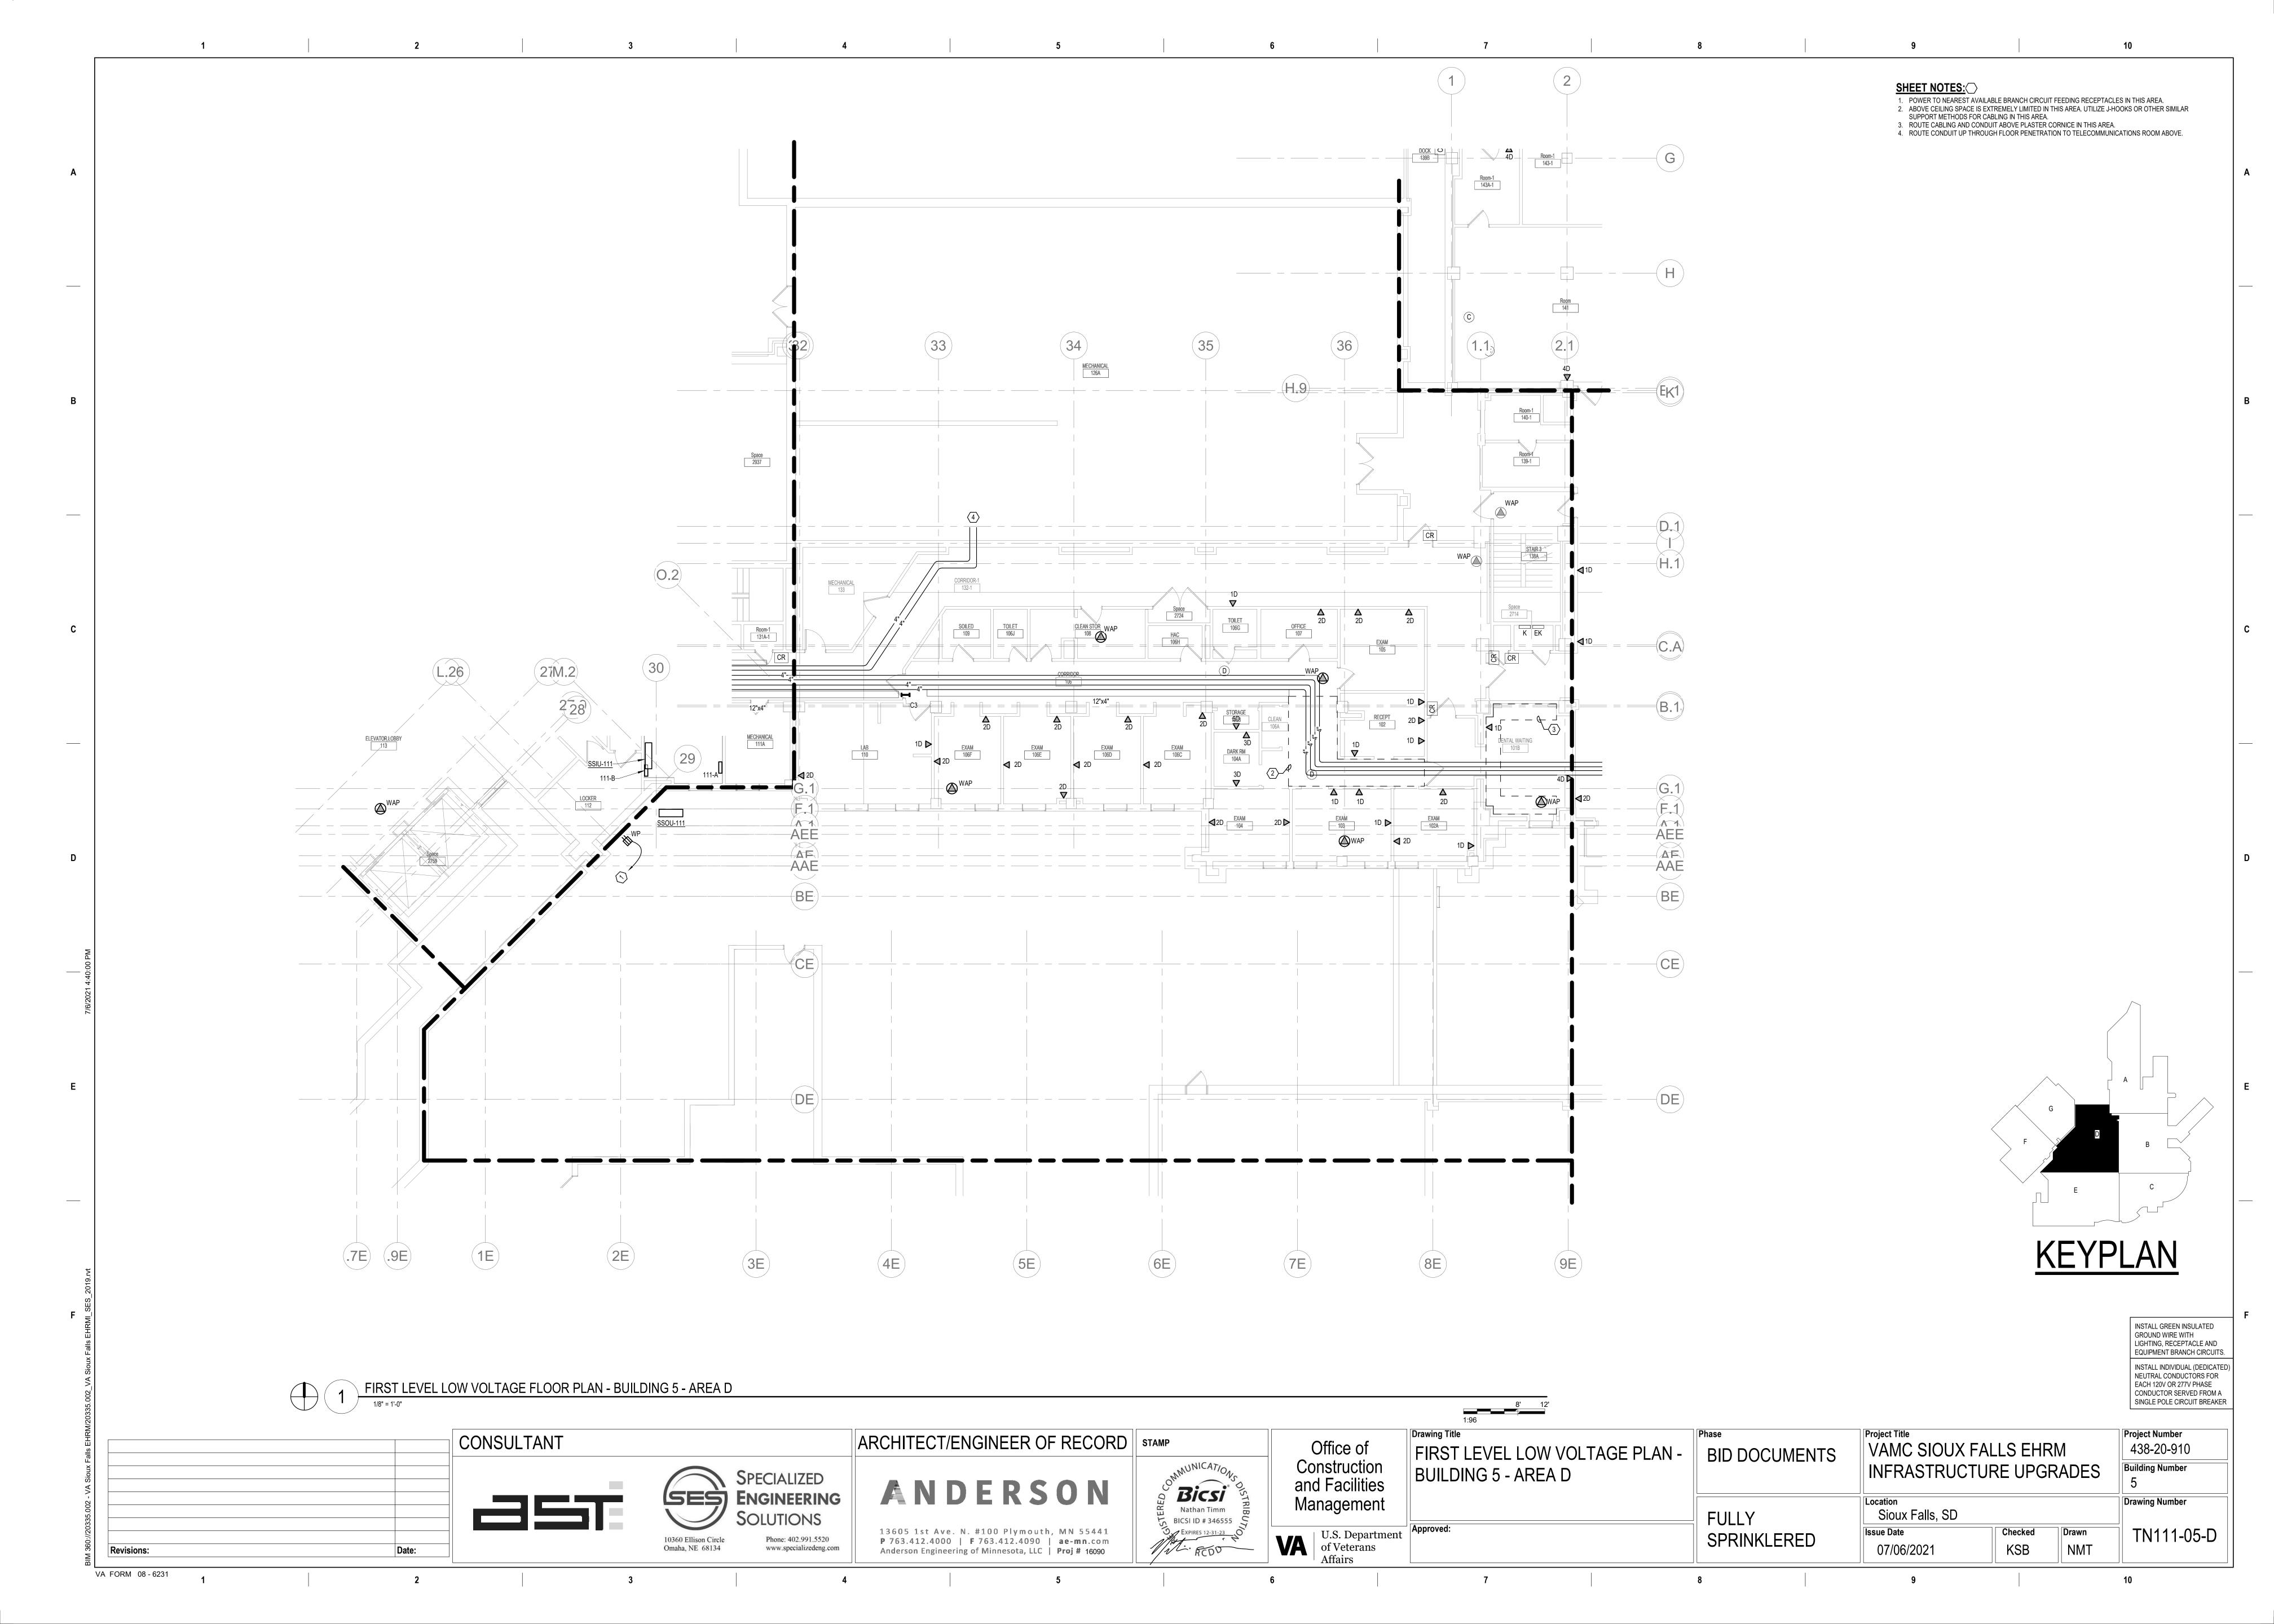

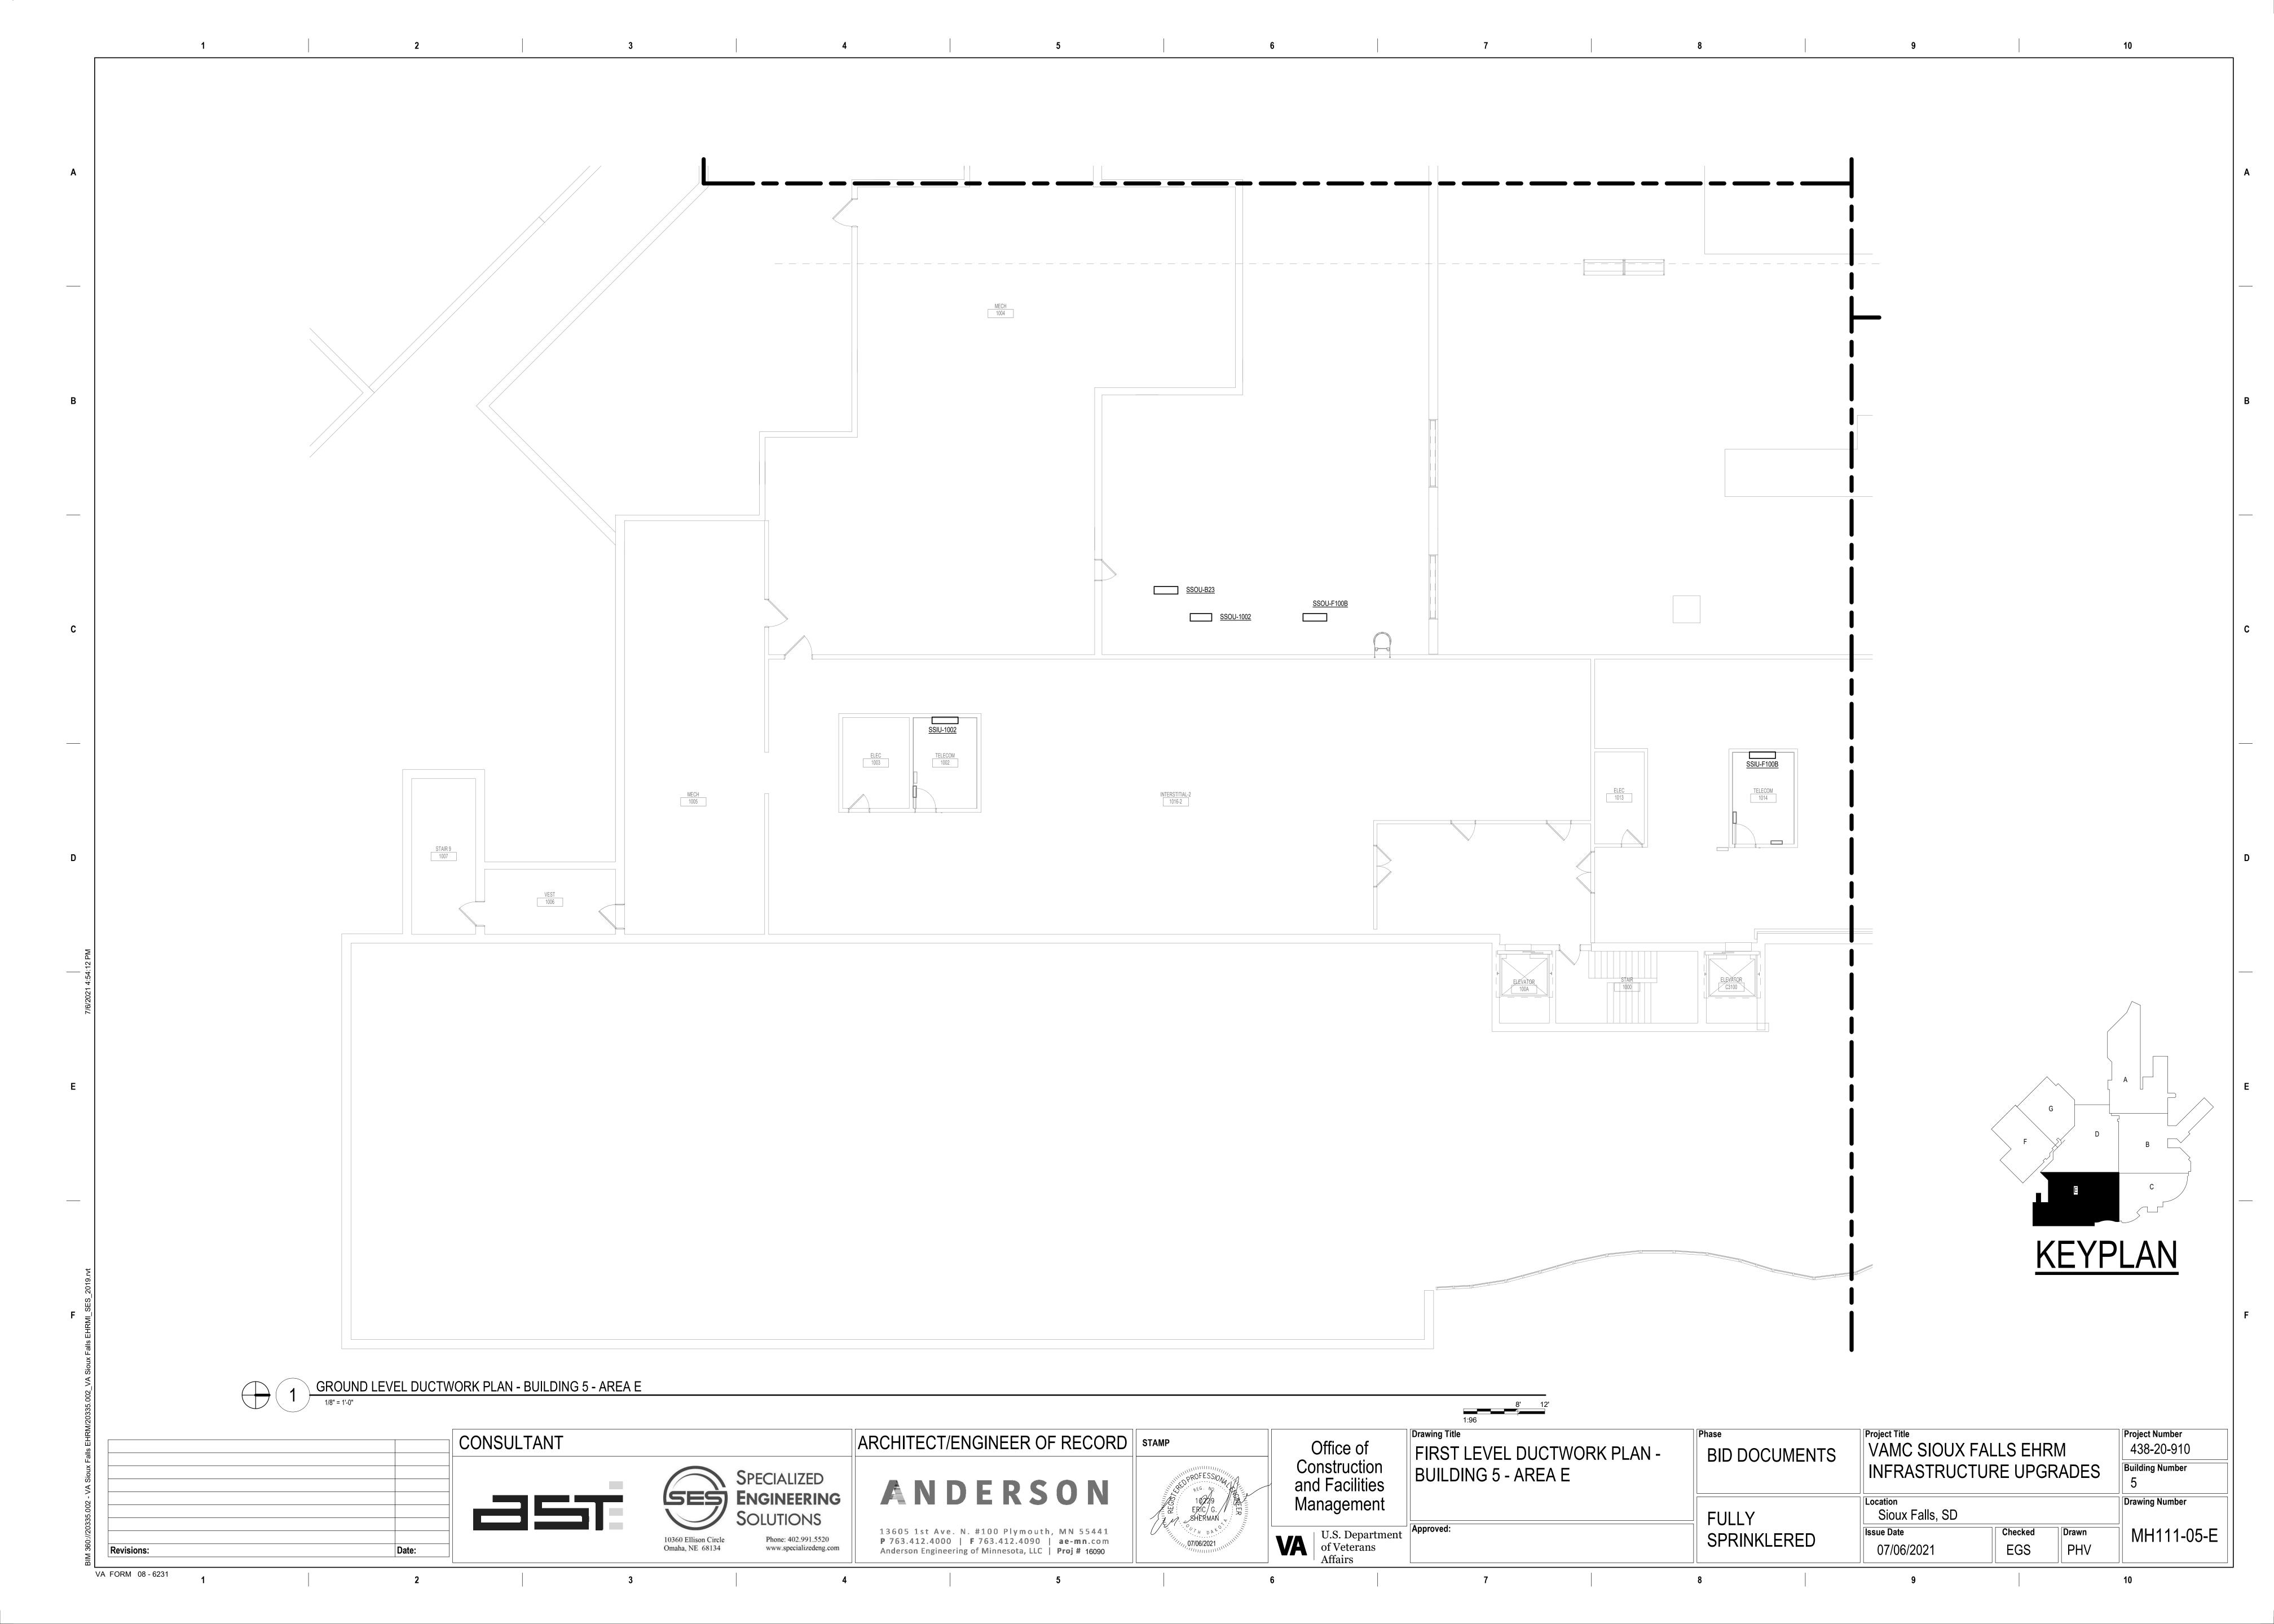

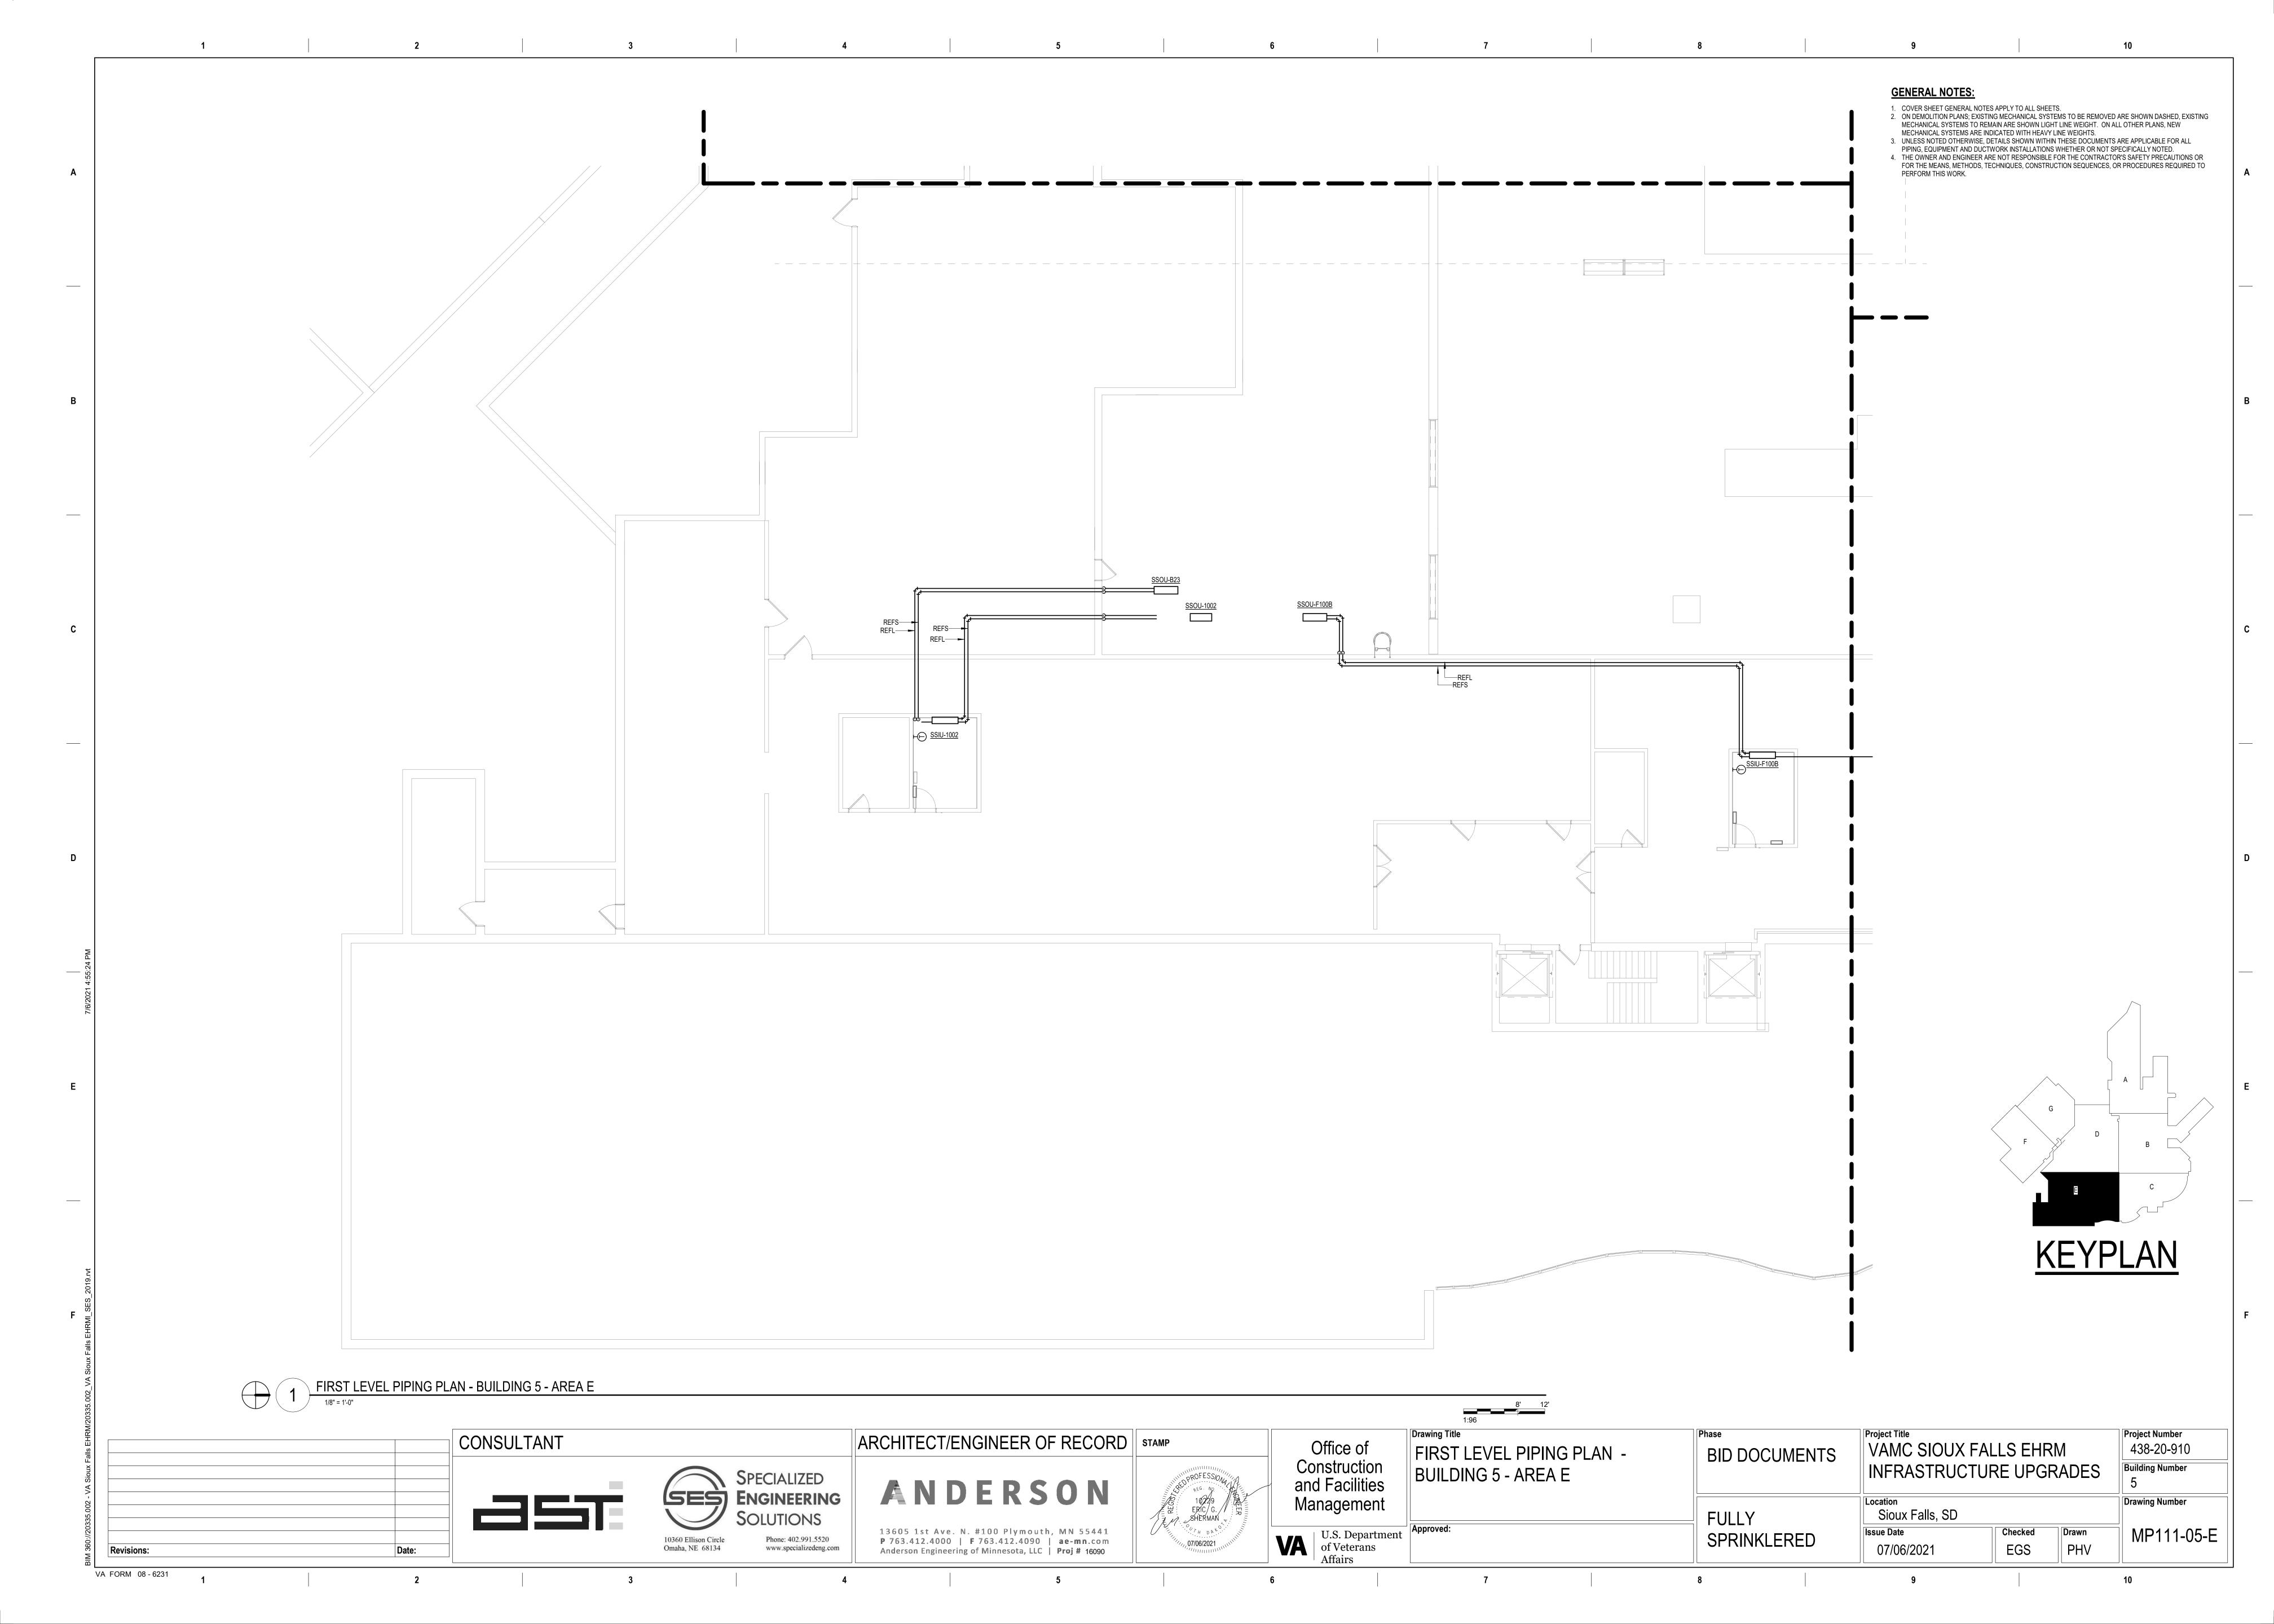

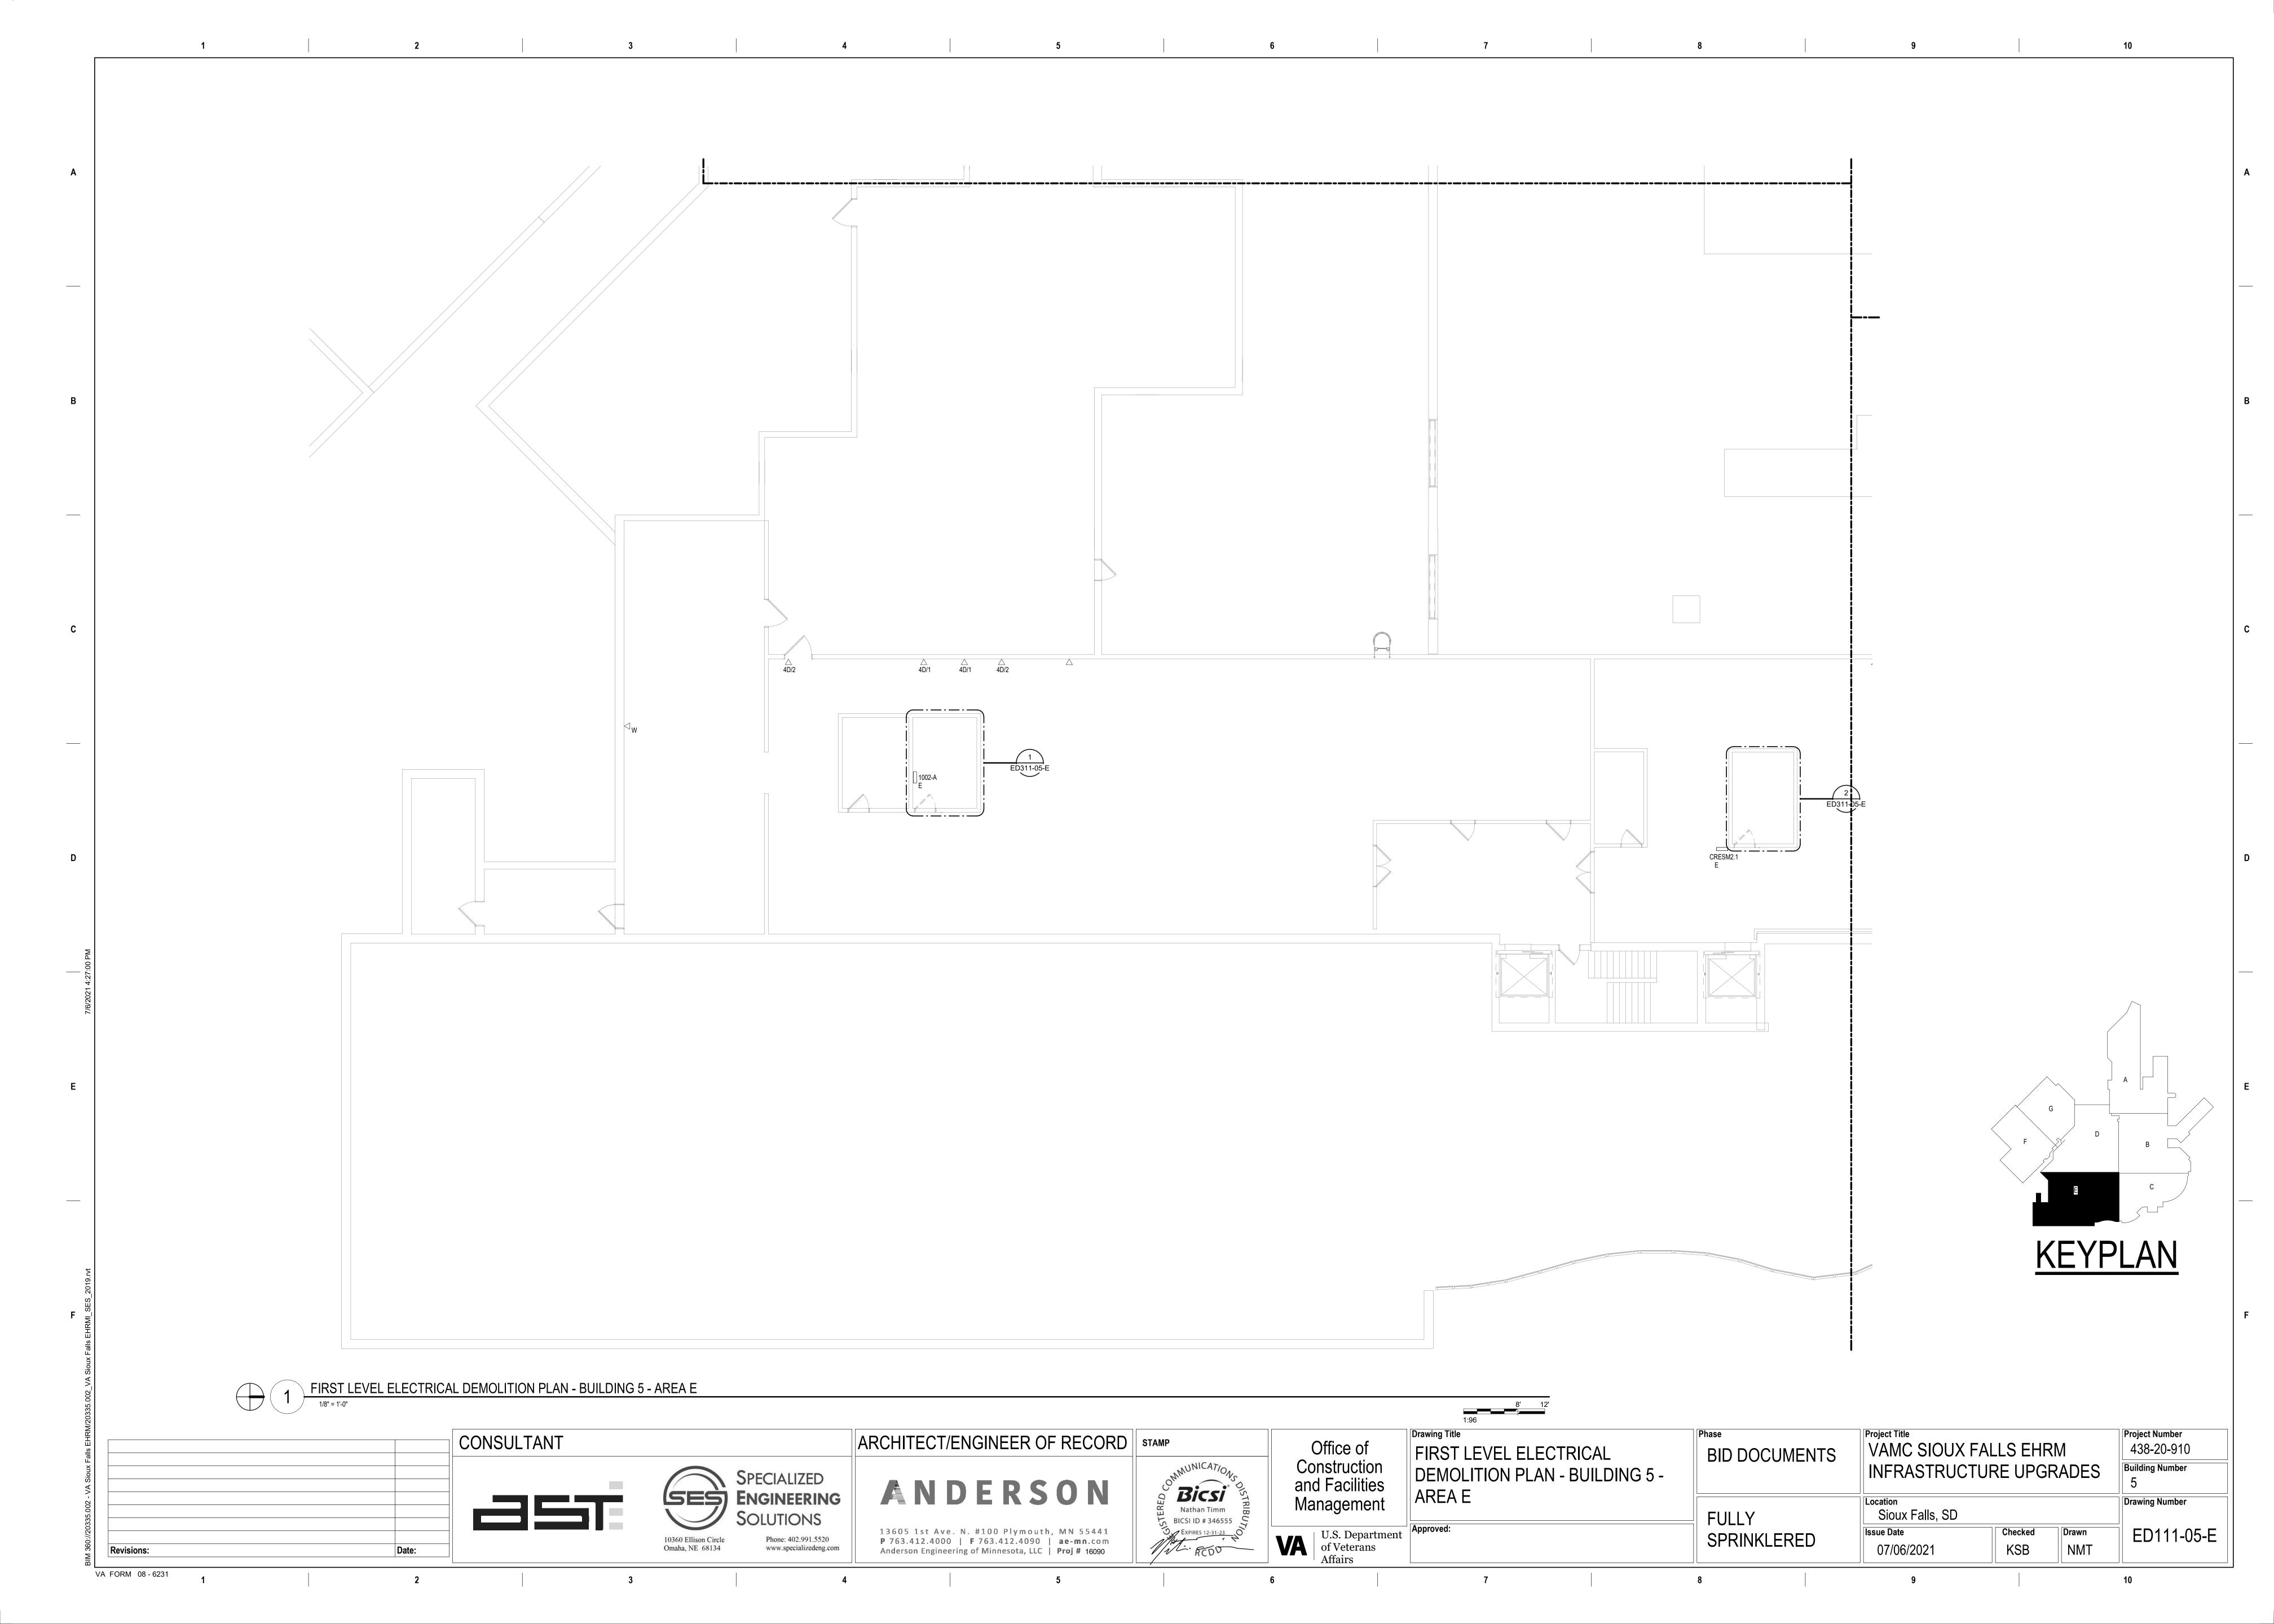


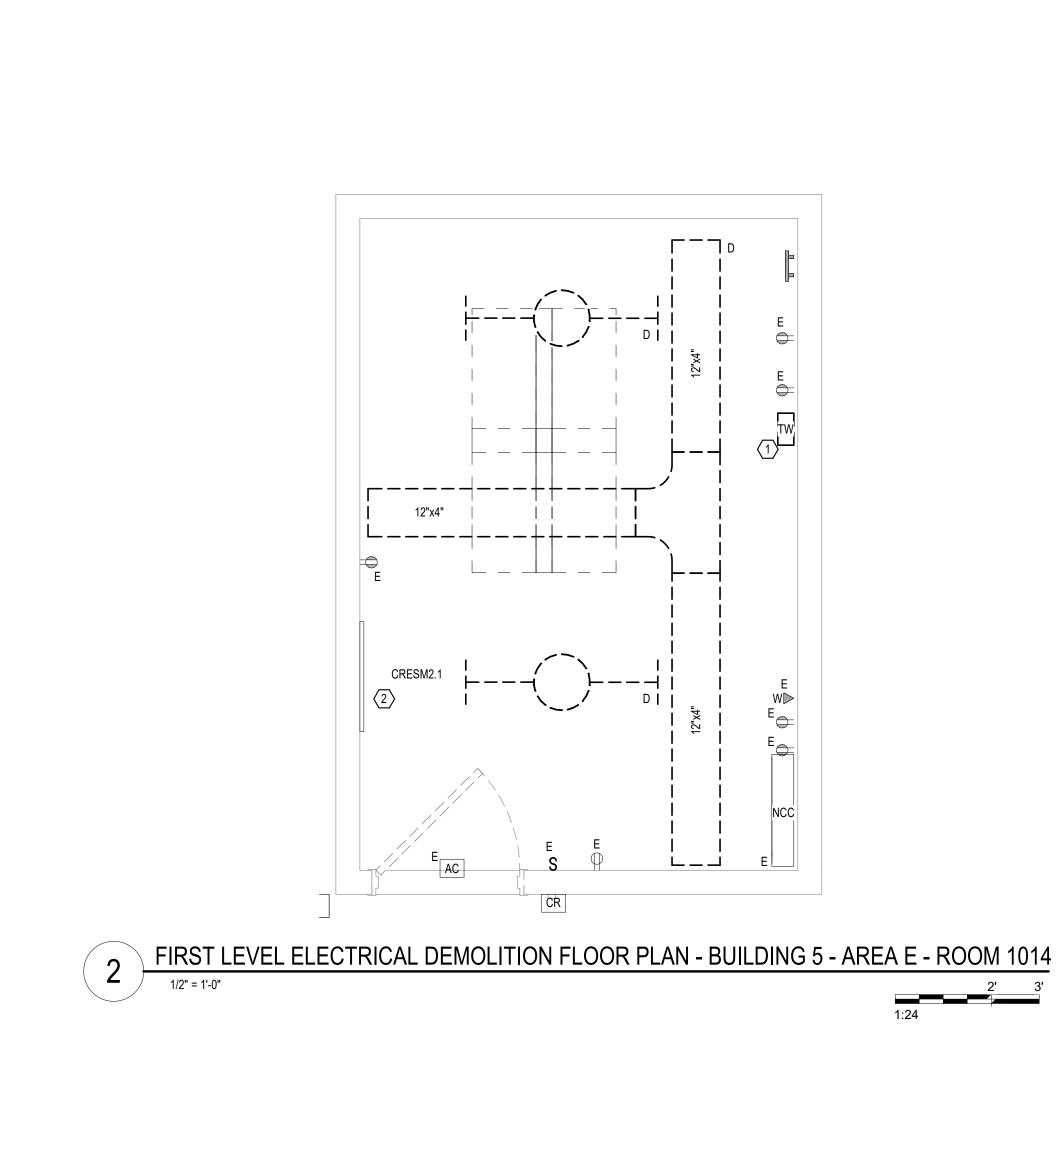

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FIRST LEVEL ELECTRICAL DEMOLITION - BUILDING 5 - AREA E - ROOM 1002

1/2" = 1'-0"

2' 3'

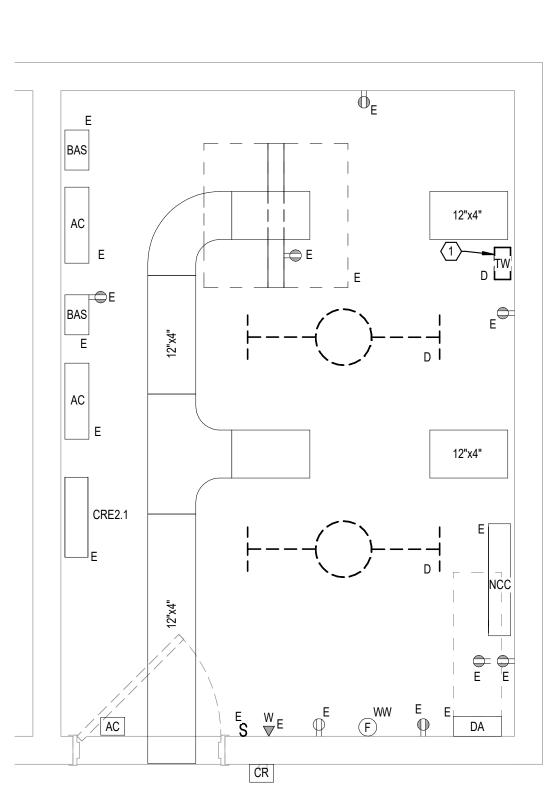CABLING NOTES:

- A. THE EXISTING CABLE COUNT ARE THE CABLES CURRENTLY PRESENT IN THE SPACE. THE CABLE RELOCATION COUNT ARE THE NEW OR RELOCATED CABLES TO BE FED FROM THE SPACE. THE FINAL CABLE COUNT ARE THE CABLES THAT WILL BE PRESENT IN THE SPACE AT THE COMPLETION OF THE PROJECT. REMOVE ALL UNUSED CABLING AT THE COMPLETION OF THE PROJECT.
- 1. ROOM 1002
- **EXISTING CABLE COUNT** DATA (CAT6): 156
- DATA (CAT5): 0 PATIENT MONITORING: 0
- CABLE RELOCATION COUNT

COMMERCIAL WIRELESS: 0

- DATA (CAT6): 0 DATA (CAT5): 0
- PATIENT MONITORING: 0
- COMMERCIAL WIRELESS: 0 EXISTING CABLE TO REMAIN
- DATA (CAT6): 156 PATIENT MONITORING: 0
- COMMERCIAL WIRELESS: 0
- FINAL CABLE COUNT DATA (CAT6): 156 VIDEO: 1
- PATIENT MONITORING: 0 COMMERCIAL WIRELESS: 0
- 2. ROOM 1014
- EXISTING CABLE COUNT DATA (CAT6): 281 DATA (CAT5): 0
- PATIENT MONITORING: 0 COMMERCIAL WIRELESS: 1
- CABLE RELOCATION COUNT DATA (CAT6): 0
- DATA (CAT5): 0 VIDEO: 0
- PATIENT MONITORING: 0 COMMERCIAL WIRELESS: 0
- EXISTING CABLE TO REMAIN DATA (CAT6): 281 VIDEO: 2
- PATIENT MONITORING: 0
- COMMERCIAL WIRELESS: 1
- FINAL CABLE COUNT DATA (CAT6): 281
- PATIENT MONITORING: 0 COMMERCIAL WIRELESS: 1


SHEET NOTES:

- EXISTING TELEPHONE WALL FIELD TO BE DEMOLISHED. NEW COPPER BACKBONE TO BE PROVIDED ON PATCH PANELS IN TELECOMMUNICATIONS RACK. REFER TO CABLING NOTES AND NEW WORK PLANS FOR ADDITIONAL
- ELECTRICAL PANEL INDICATED SHALL BE RELOCATED TO ACCOMMODATE NEW PANEL INSTALLATION IN CURRENT LOCATION. REFER TO NEW WORK ON NEW ENLARGED PLAN FOR ADDITIONAL INFORMATION.

CONSULTANT SES ENGINEERING 10360 Ellison Circle Omaha, NE 68134 Revisions:

VA FORM 08 - 6231

ARCHITECT/ENGINEER OF RECORD | STAMP ANDERSON 13605 1st Ave. N. #100 Plymouth, MN 55441 P 763.412.4000 | F 763.412.4090 | ae-mn.com Anderson Engineering of Minnesota, LLC | Proj # 16090

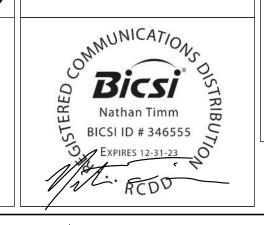

Office of Construction and Facilities Management

U.S. Department of Veterans Affairs

Drawing Title

FIRST LEVEL ELECTRICAL DEMOLITION - BUILDING 5 -ENLARGED ROOMS - AREA E


FULLY SPRINKLERED


Project Title Project Number VAMC SIOUX FALLS EHRM 438-20-910 **BID DOCUMENTS Building Number** INFRASTRUCTURE UPGRADES Drawing Number Sioux Falls, SD Checked Drawn ED311-05-E


07/06/2021

KSB

NMT

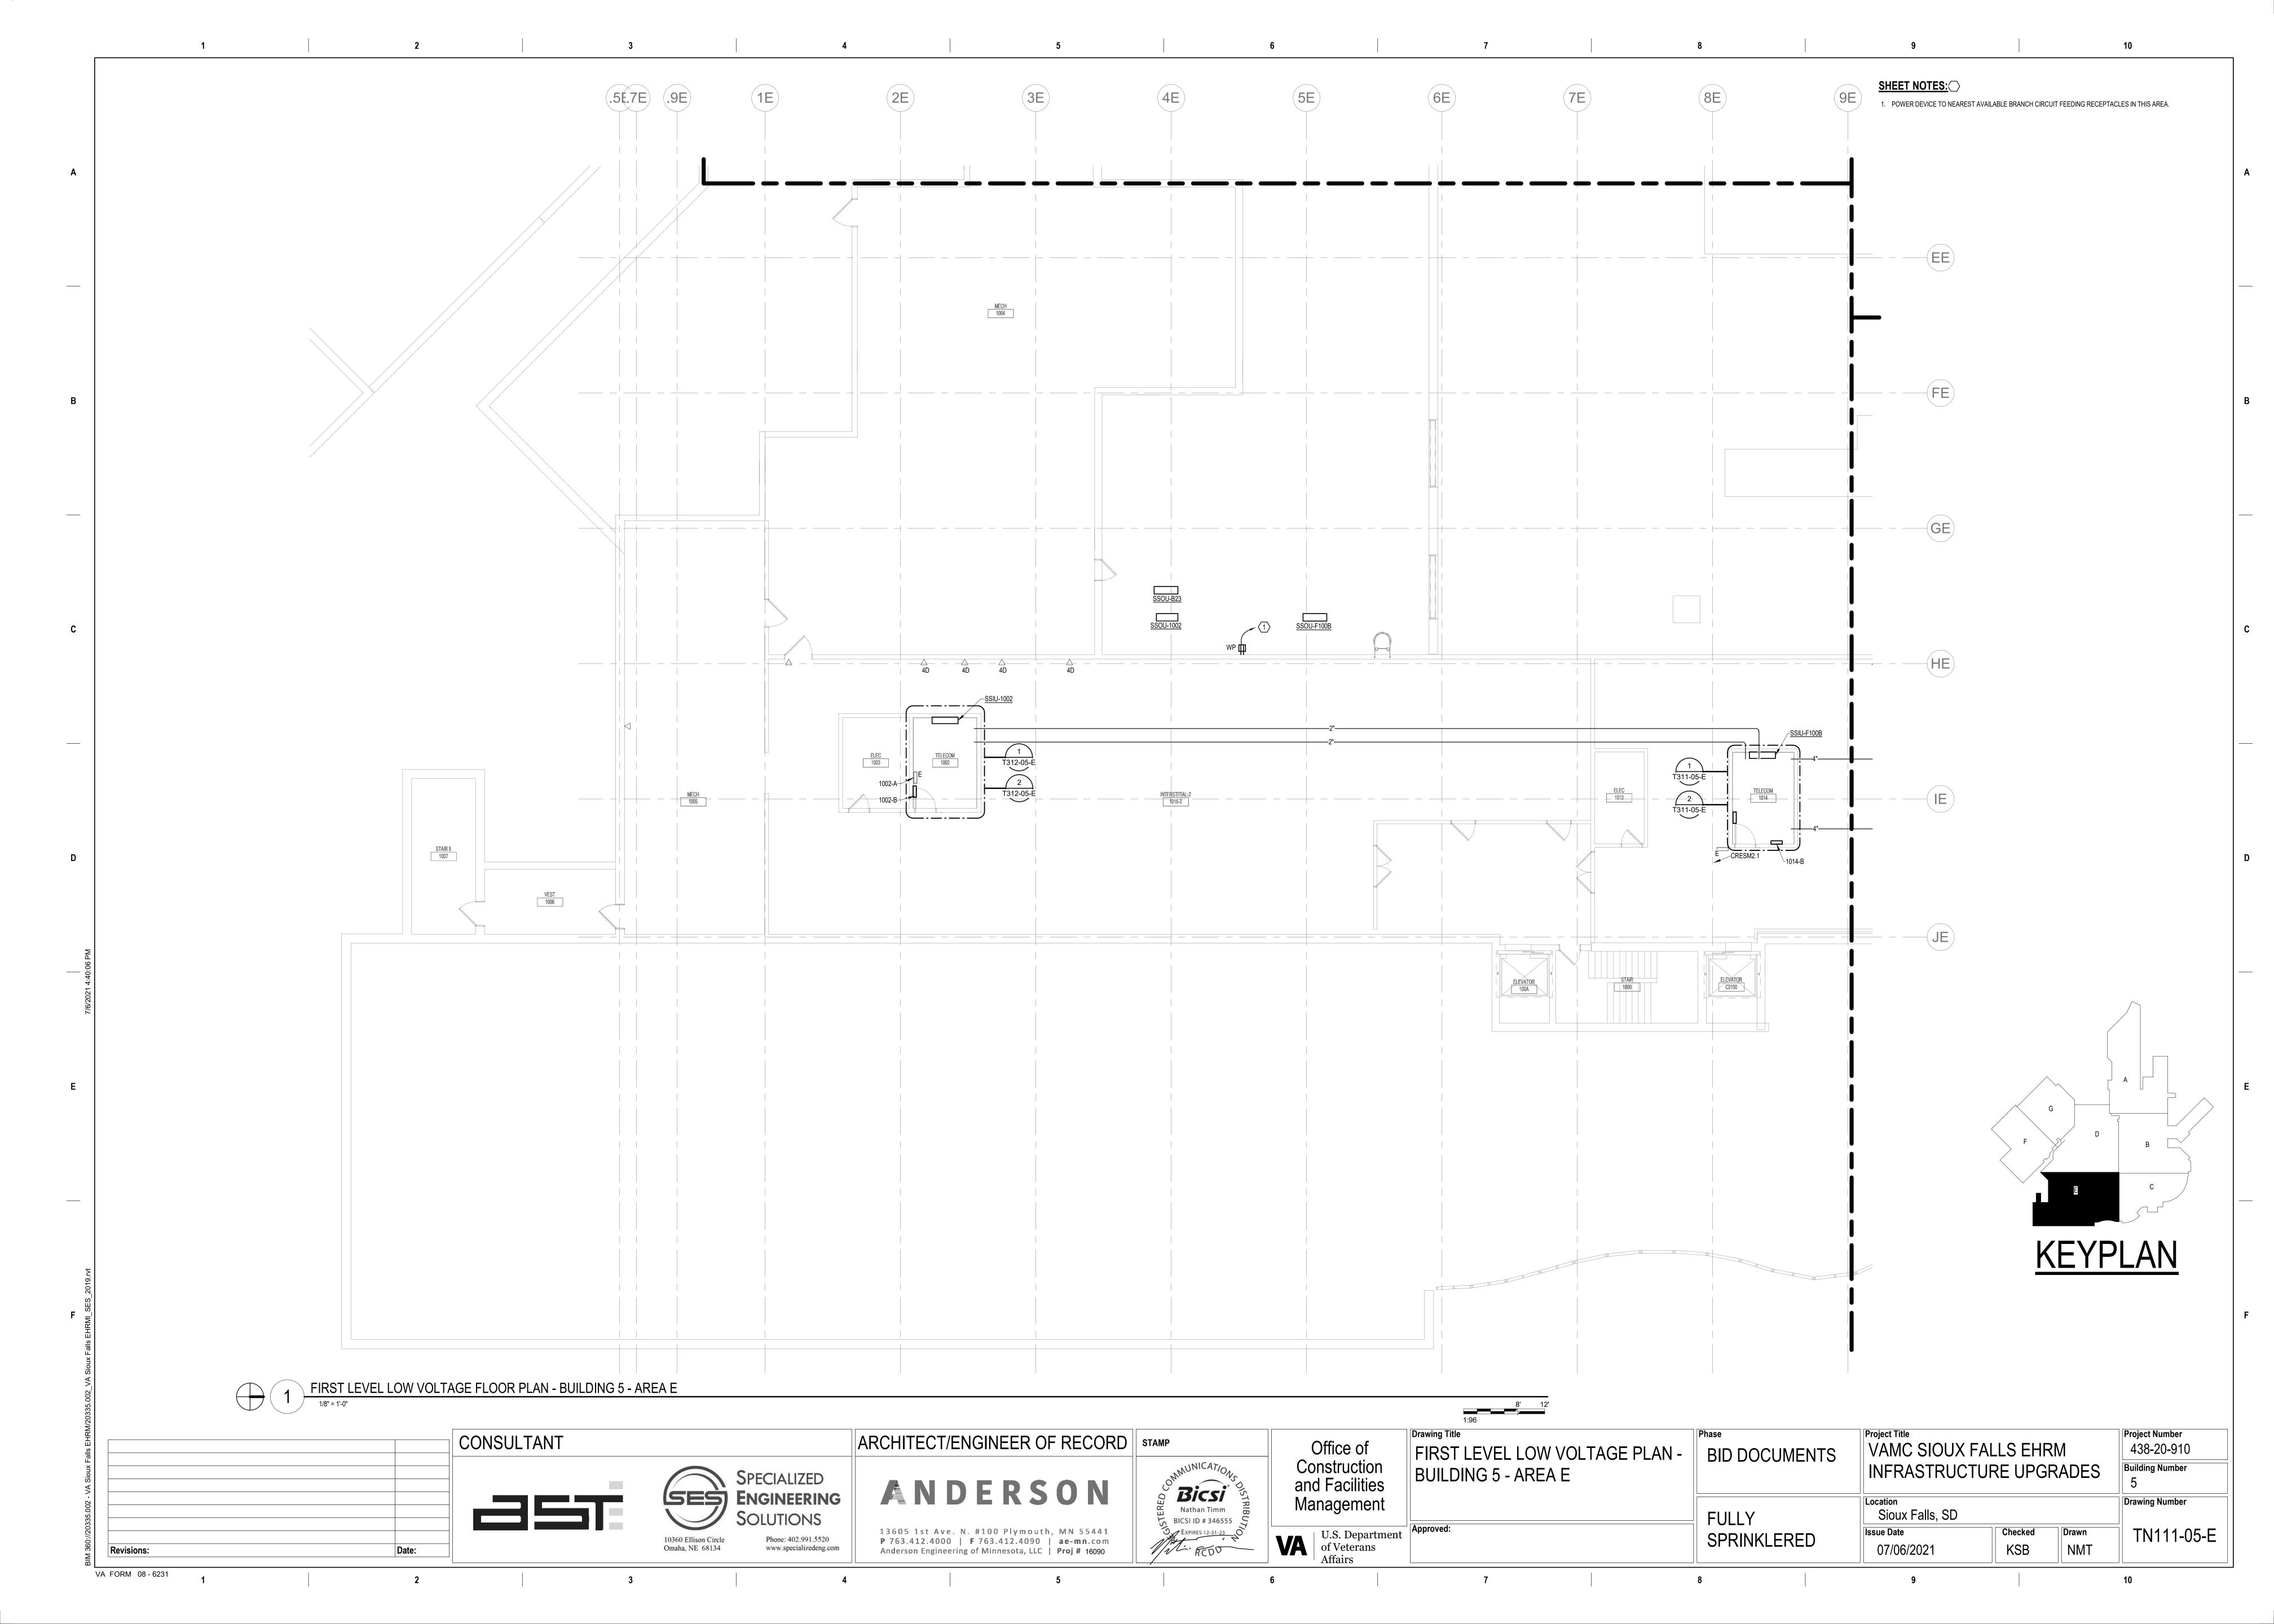

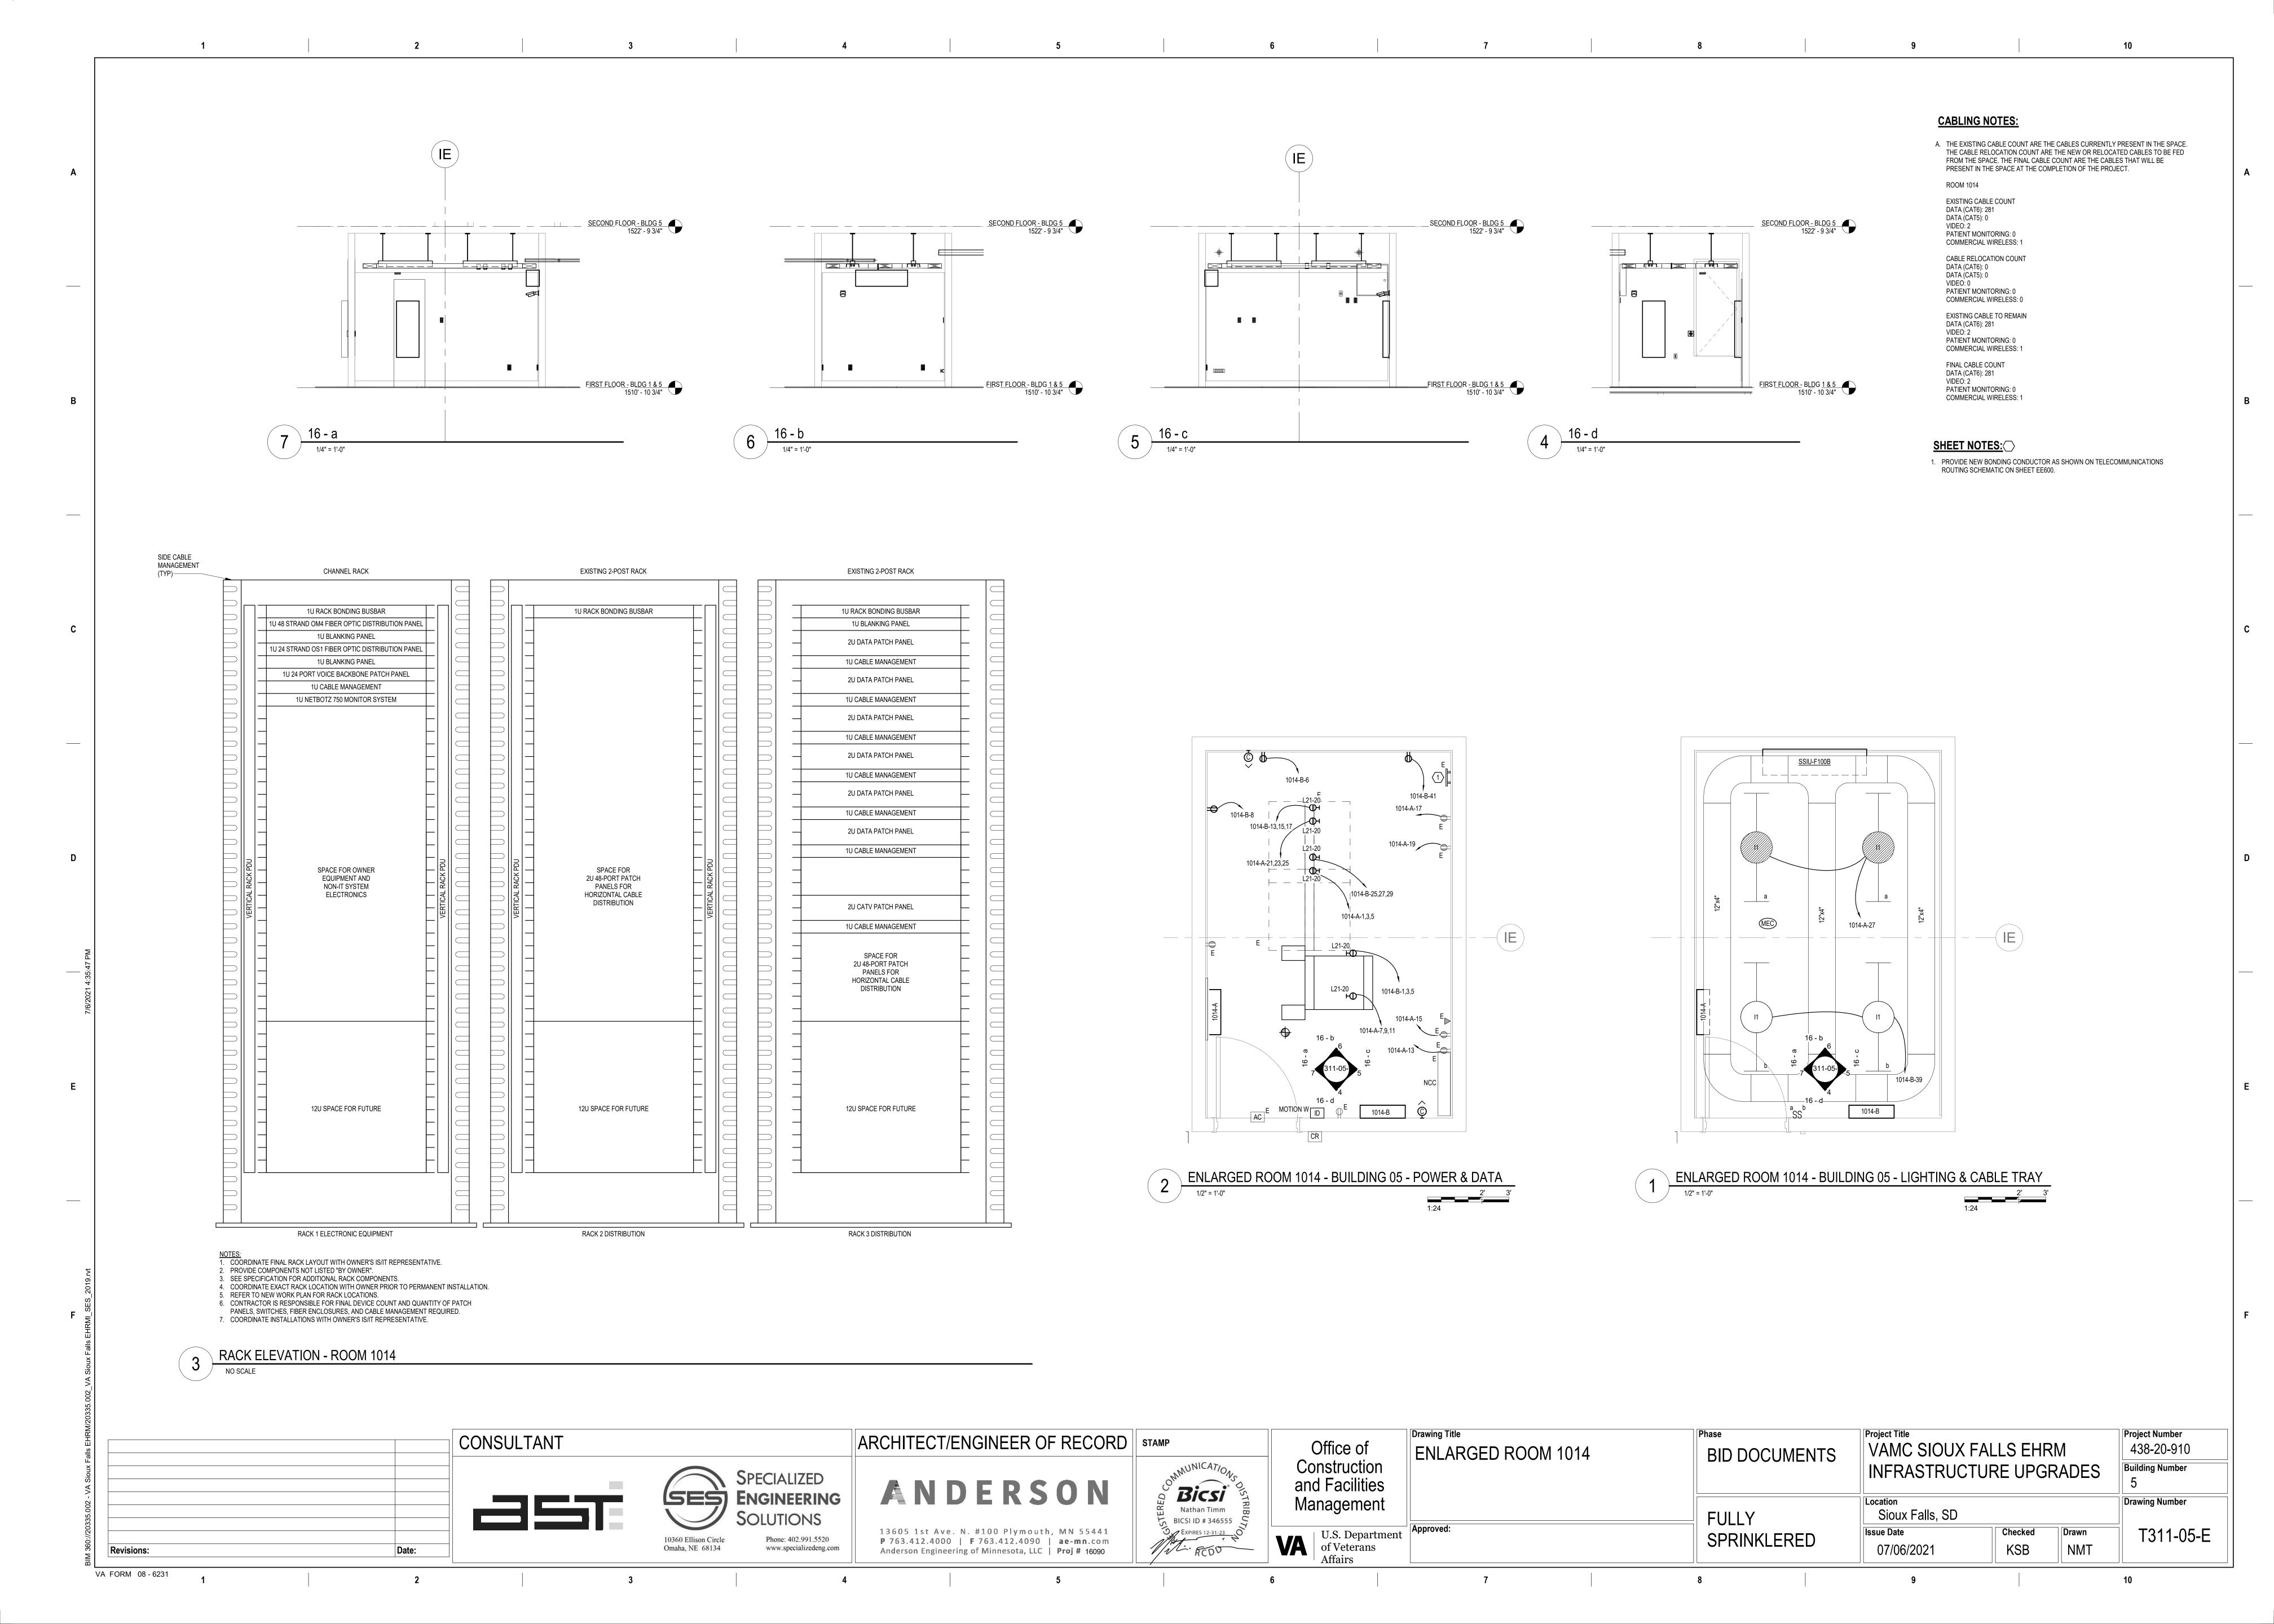

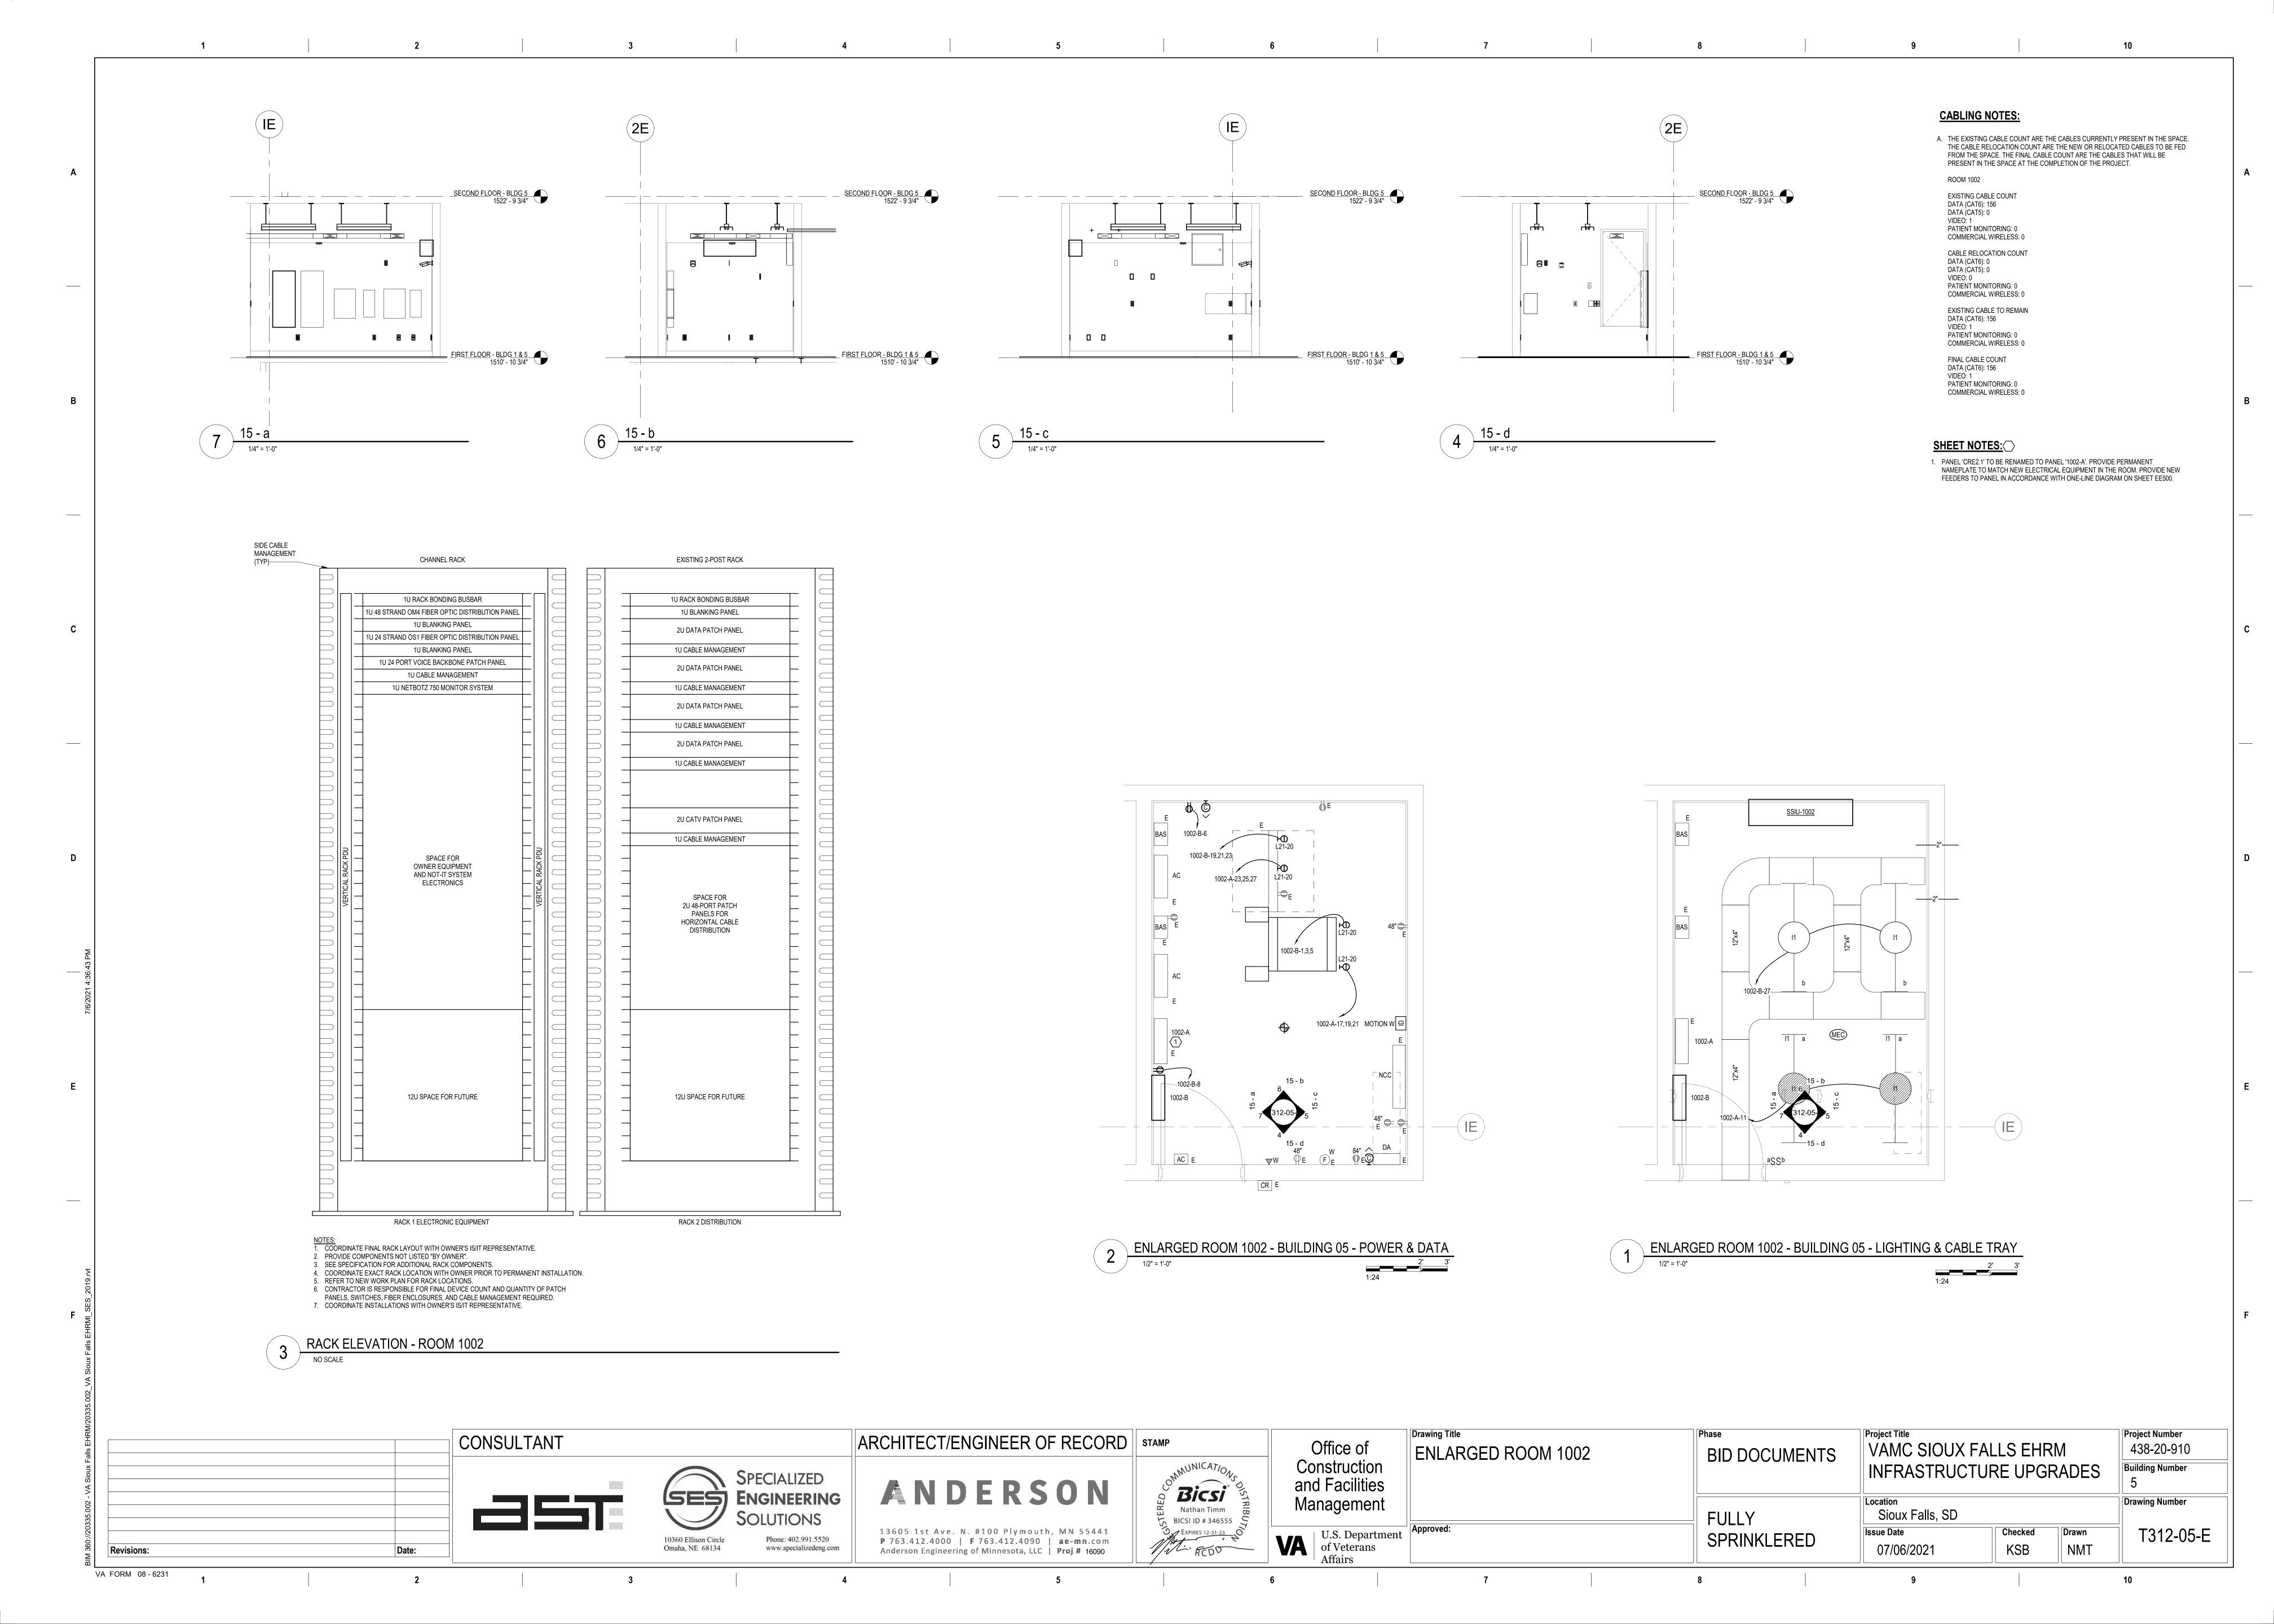

MCB OPTIONS: NONE **SERVICE RATED:** No INTEGRAL SPD: Yes SECTIONS: 1 MOUNTING: SURFACE AVAILABLE SCC (kA): 4.6 PANEL POLES: 42 NEMA ENCLOSURE: OPT RATI... POL... B C POL... RATI... OPT CIRCUIT DESCRIPTION CIRCUIT DESCRIPTION PWR-C TELECOMM 1002 - RACK 1922 VA RECEPTACLE REC LOCKER B28 21 PWR-C EXAM-2 B34-2 27 LTG TELECOM 1002 -- 20 A 1 0 VA -- 20 A 1 ____ 20 A 1 35 SPARE 0 VA | 39 SPARE TOTAL LOAD: 4023 VA 3893 VA 4023 VA TOTAL AMPS: 34 A LOAD CLASSIFICATION CONNECTED LOAD DEMAND FACTOR ESTIMATED DEMAND PANEL TOTALS 125.00% CONNECTED LOAD: 11940 VA CONNECTED CURRENT: 33 A 100.00% 360 VA 11530 VA 93.37% 10765 VA **DEMAND LOAD:** 11187 VA **DEMAND CURRENT:** 31 A **CONSIDER 125% DEMAND:** 13984 A **EQUIPMENT AMPS:** 100 A FEEDER AVAILABLE: SPARE CAPACITY: 69 A CIRCUIT BREAKER OPTIONS SUFFIX: 'S' OR 'ST' - PROVIDE SHUNT TRIP CIRCUIT BREAKER / 'G' OR 'GFCI' - PROVIDE GFCI CIRCUIT BREAKER / 'GFP' - PROVIDE GFP CIRCUIT BREAKER / 'ERMS' - ENERGY REDUCING MAINTENANCE SWITCH / 'ZSI' - ZONE SELECTIVE INTERLOCKING / 'L' - PROVIDE CIRCUIT BREAKER WITH LOCKING PROVISIONS / 'R' - PROVIDE CIRCUIT BREAKER WITH RED MARKING **GENERAL REMARKS:** A. PANEL AIC (INTERRUPTING) RATING SHALL BE MINIMUM 120% OF THE AVAILABLE SCC (SHORT CIRCUIT CURRENT). **LIGHTING PANEL: 1014-B LOCATION:** CORRIDOR C29 **VOLTS:** 208/120 WYE MAINS TYPE: MCB SUPPLY FROM: B1 PHASES: 3 MCB/MLO RATING: 100 A WIRES: 4 MCB OPTIONS: NONE **BRANCH:** NORMAL **SERVICE RATED:** No INTEGRAL SPD: Yes SECTIONS: 1 **MOUNTING:** SURFACE AVAILABLE SCC (kA): 2.8 PANEL POLES: 42 **NEMA ENCLOSURE**: 1 CIRCUIT DESCRIPTION OPT RATI... POL... A B C POL... RATI... OPT CIRCUIT DESCRIPTION 1922... 1488 VA PWR-C TELECOM 1014 RACK 2 30 A SSIU-1014/SSOU-1014 1922 VA 1488 VA RECEPTACLE REC TELECOM 1014 1 20 A REC TELECOM 1014 PWR-C TELECOM 1014 RACK 20 A 1922 VA PWR-C TELECOM 1014 RACK 20 A 3 1922 VA RECEPTACLE 39 LTG TELECOM 1014 41 REC TELECOM 1014 180 VA **TOTAL LOAD:** 7434 VA 7303 VA 6126 VA TOTAL AMPS: 63 A 62 A LOAD CLASSIFICATION CONNECTED LOAD DEMAND FACTOR ESTIMATED DEMAND PANEL TOTALS 50 VA 125.00% CONNECTED LOAD: 20863 VA 62 VA CONNECTED CURRENT: 58 A 100.00% 540 VA 2975 VA 3689 VA **DEMAND LOAD:** 17940 VA 124.00% 17298 VA **DEMAND CURRENT**: 50 A 78.91% 13649 VA **CONSIDER 125% DEMAND:** 22425 A **EQUIPMENT AMPS:** 100 A **FEEDER AVAILABLE:** SPARE CAPACITY: 50 A CIRCUIT BREAKER OPTIONS SUFFIX: 'S' OR 'ST' - PROVIDE SHUNT TRIP CIRCUIT BREAKER / 'G' OR 'GFCI' - PROVIDE GFC I CIRCUIT BREAKER / 'GFP' - PROVIDE GFP CIRCUIT BREAKER / 'ERMS' - ENERGY REDUCING MAINTENANCE SWITCH / 'ZSI' - ZONE SELECTIVE INTERLOCKING / 'L' - PROVIDE CIRCUIT BREAKER WITH LOCKING PROVISIONS / 'R' - PROVIDE CIRCUIT BREAKER WITH RED MARKING **GENERAL REMARKS:**

VOLTS: 208/120 WYE

PHASES: 3

MAINS TYPE: MCB


MCB/MLO RATING: 100 A

LIGHTING PANEL: 1002-B

SUPPLY FROM: B1

LOCATION: LOCKER B28

LIGHTING PANEL: 1014-A MAINS TYPE: MCB **VOLTS**: 208/120 WYE PHASES: 3 MCB/MLO RATING: 100 A SUPPLY FROM: B1 WIRES: 4 MCB OPTIONS: NONE **BRANCH:** CRITICAL **SERVICE RATED**: No INTEGRAL SPD: Yes SECTIONS: 1 **MOUNTING:** SURFACE AVAILABLE SCC (kA): 3.3 PANEL POLES: 42 **NEMA ENCLOSURE**: NEMA 1 OPT RATI... POL... C POL... RATI... OPT CIRCUIT DESCRIPTION CIRCUIT DESCRIPTION 1922... 0 VA PWR-C TELECOM 1014 RACK 1922 VA 0 VA RECEPTACLE 1922 VA 0 VA 1 20 A -- SPARE | 1922... | 0 VA | 1 20 A -- SPARE PWR-C TELECOM 1014 RACK 1922 VA 0 VA RECEPTACLE 1922 VA 0 VA 1 20 A -- SPARE 19 REC 20 A | 1 | 180 VA | PWR-C TELECOM 1014 RACK RECEPTACLE 27 LTG TELECOM 1014 TOTAL LOAD: 6126 VA 5996 VA 5946 VA TOTAL AMPS: 51 A LOAD CLASSIFICATION CONNECTED LOAD | DEMAND FACTOR | ESTIMATED DEMAND CONNECTED LOAD: 18068 VA 125.00% 100.00% CONNECTED CURRENT: 50 A 17298 VA 78.91% 13649 VA **DEMAND LOAD:** 14431 VA **DEMAND CURRENT:** 40 A **CONSIDER 125% DEMAND:** 18039 A **EQUIPMENT AMPS:** 100 A FEEDER AVAILABLE: SPARE CAPACITY: 60 A CIRCUIT BREAKER OPTIONS SUFFIX: 'S' OR 'ST' - PROVIDE SHUNT TRIP CIRCUIT BREAKER / 'G' OR 'GFCI' - PROVIDE GFCI CIRCUIT BREAKER / 'GFP' - PROVIDE GFP CIRCUIT BREAKER / 'ERMS' - ENERGY REDUCING MAINTENANCE SWITCH / 'ZSI' - ZONE SELECTIVE INTERLOCKING / 'L' - PROVIDE CIRCUIT BREAKER WITH LOCKING PROVISIONS / 'R' - PROVIDE CIRCUIT BREAKER WITH RED MARKING **GENERAL REMARKS:** A. PANEL AIC (INTERRUPTING) RATING SHALL BE MINIMUM 120% OF THE AVAILABLE SCC (SHORT CIRCUIT CURRENT).

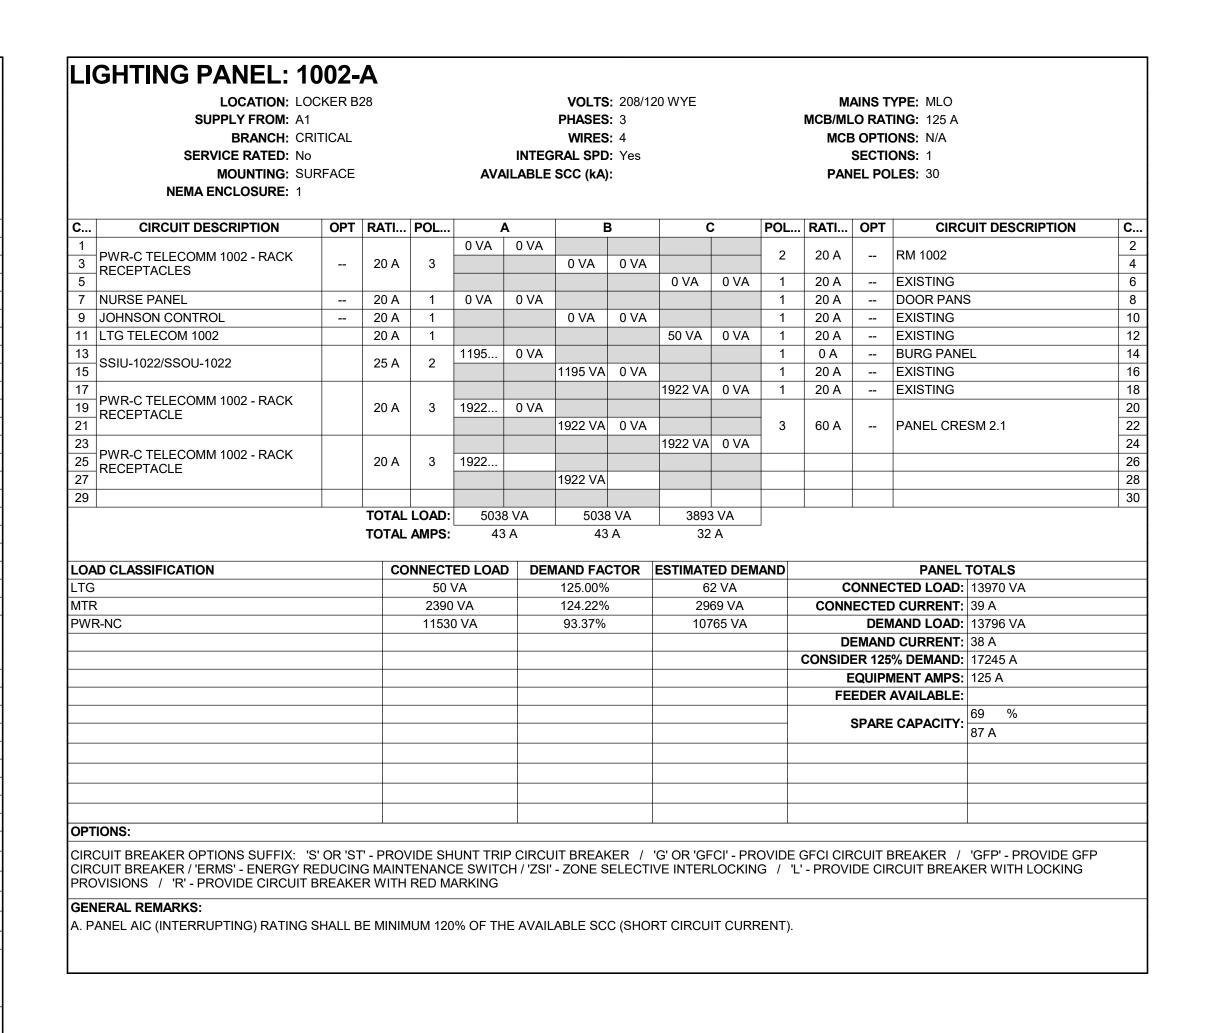




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A. PANEL AIC (INTERRUPTING) RATING SHALL BE MINIMUM 120% OF THE AVAILABLE SCC (SHORT CIRCUIT CURRENT).



Office of Construction and Facilities Management U.S. Department

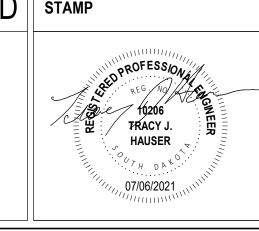
Drawing Title PANEL SCHEDULES - BUILDING 5 -FIRST LEVEL-AREA E


Project Title **Project Number** VAMC SIOUX FALLS EHRM 438-20-910 BID DOCUMENTS **Building Number** INFRASTRUCTURE UPGRADES **Drawing Number** Location Sioux Falls, SD **FULLY** Checked EE411-05-E Drawn SPRINKLERED KSB


07/06/2021

U.S. Department of Veterans

NMT

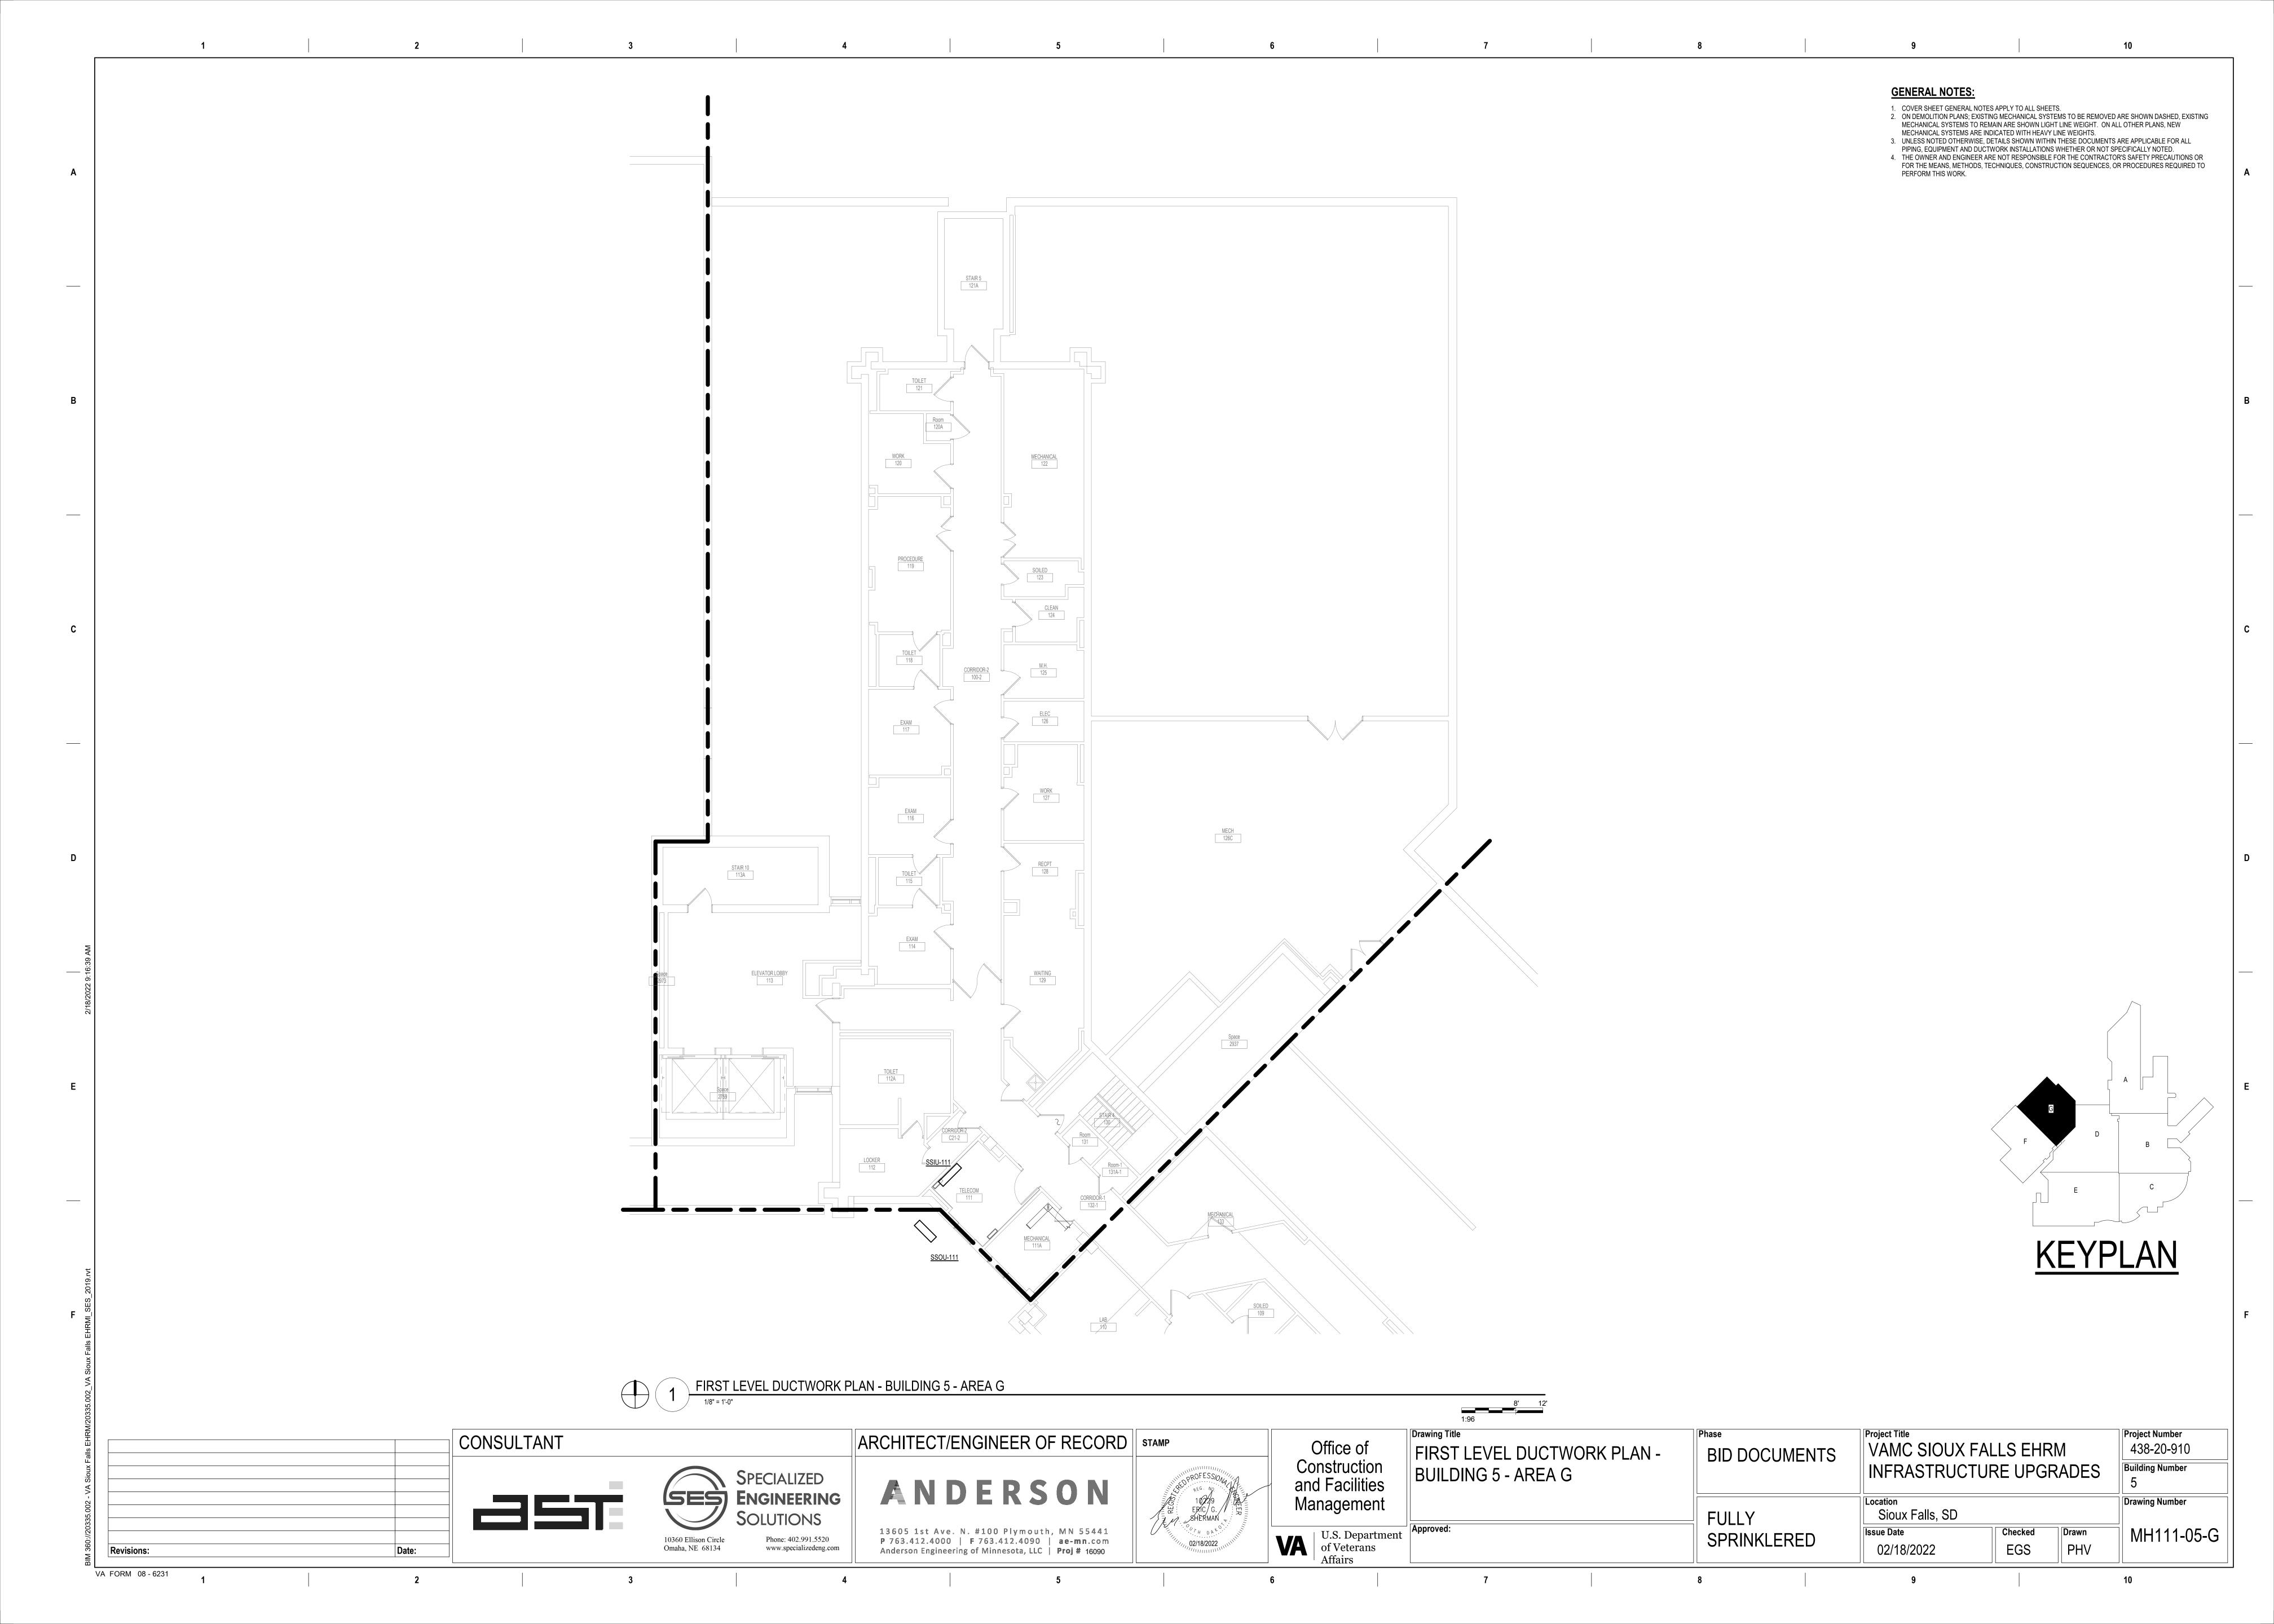

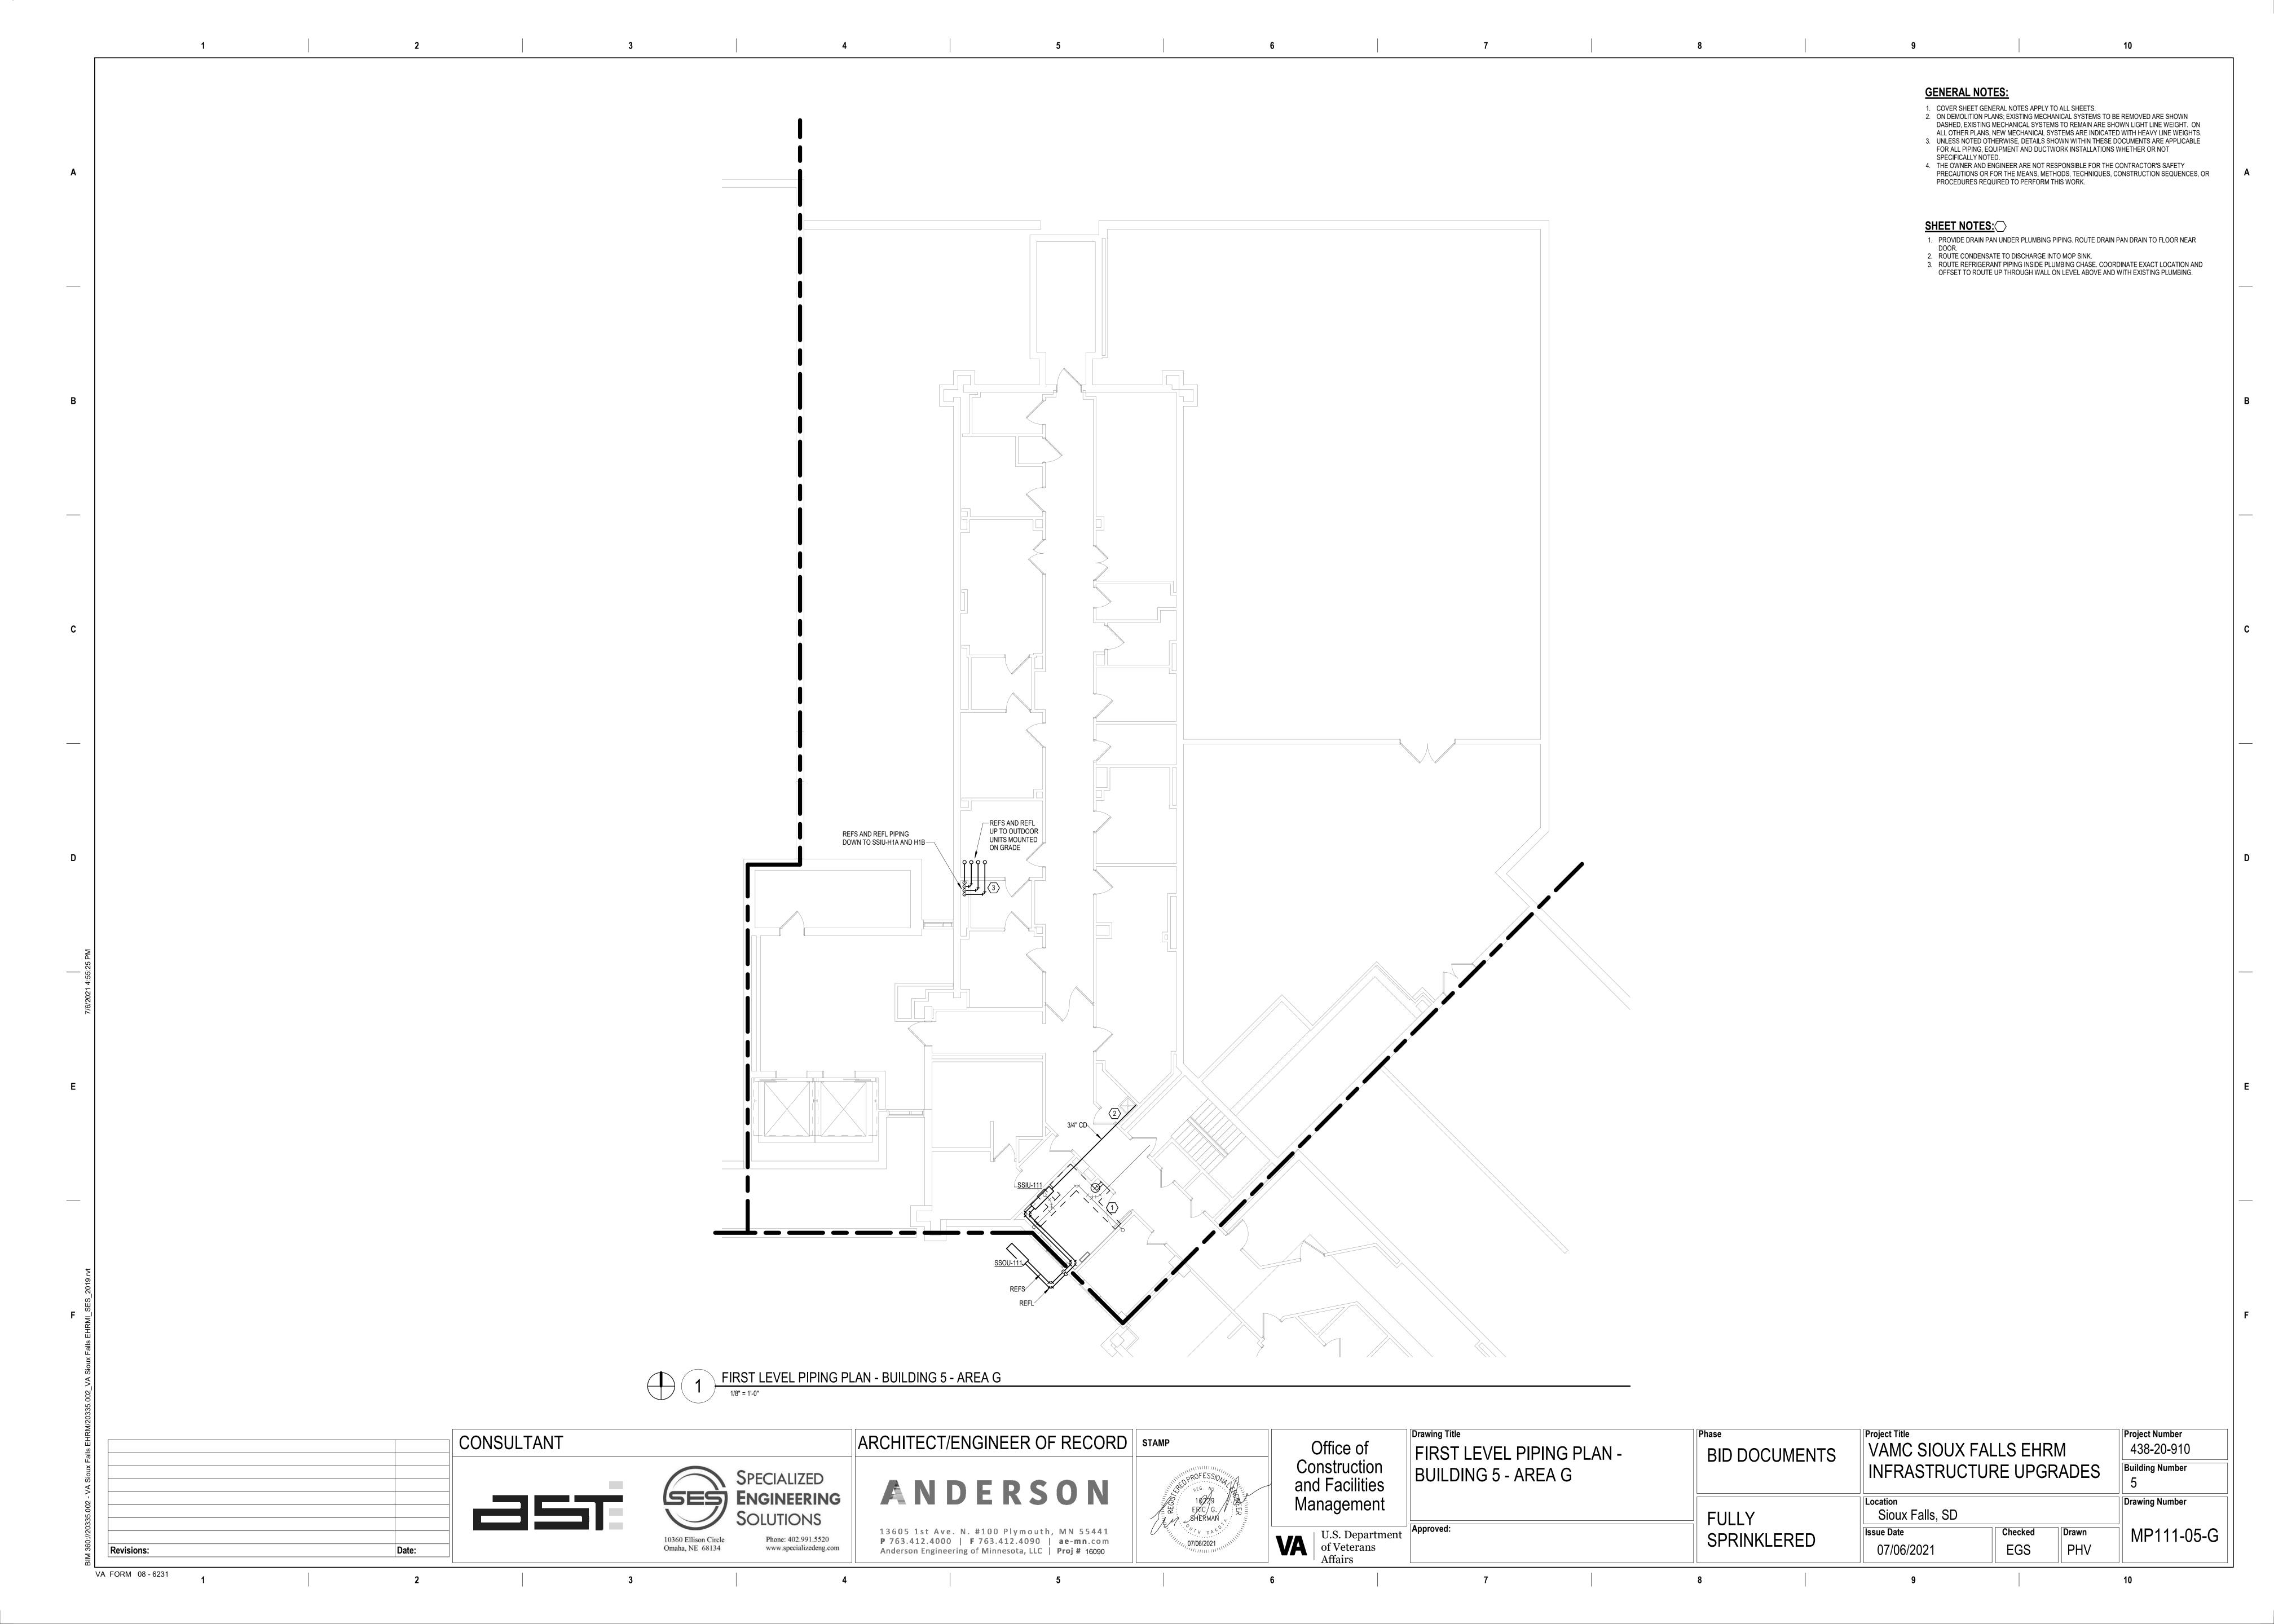

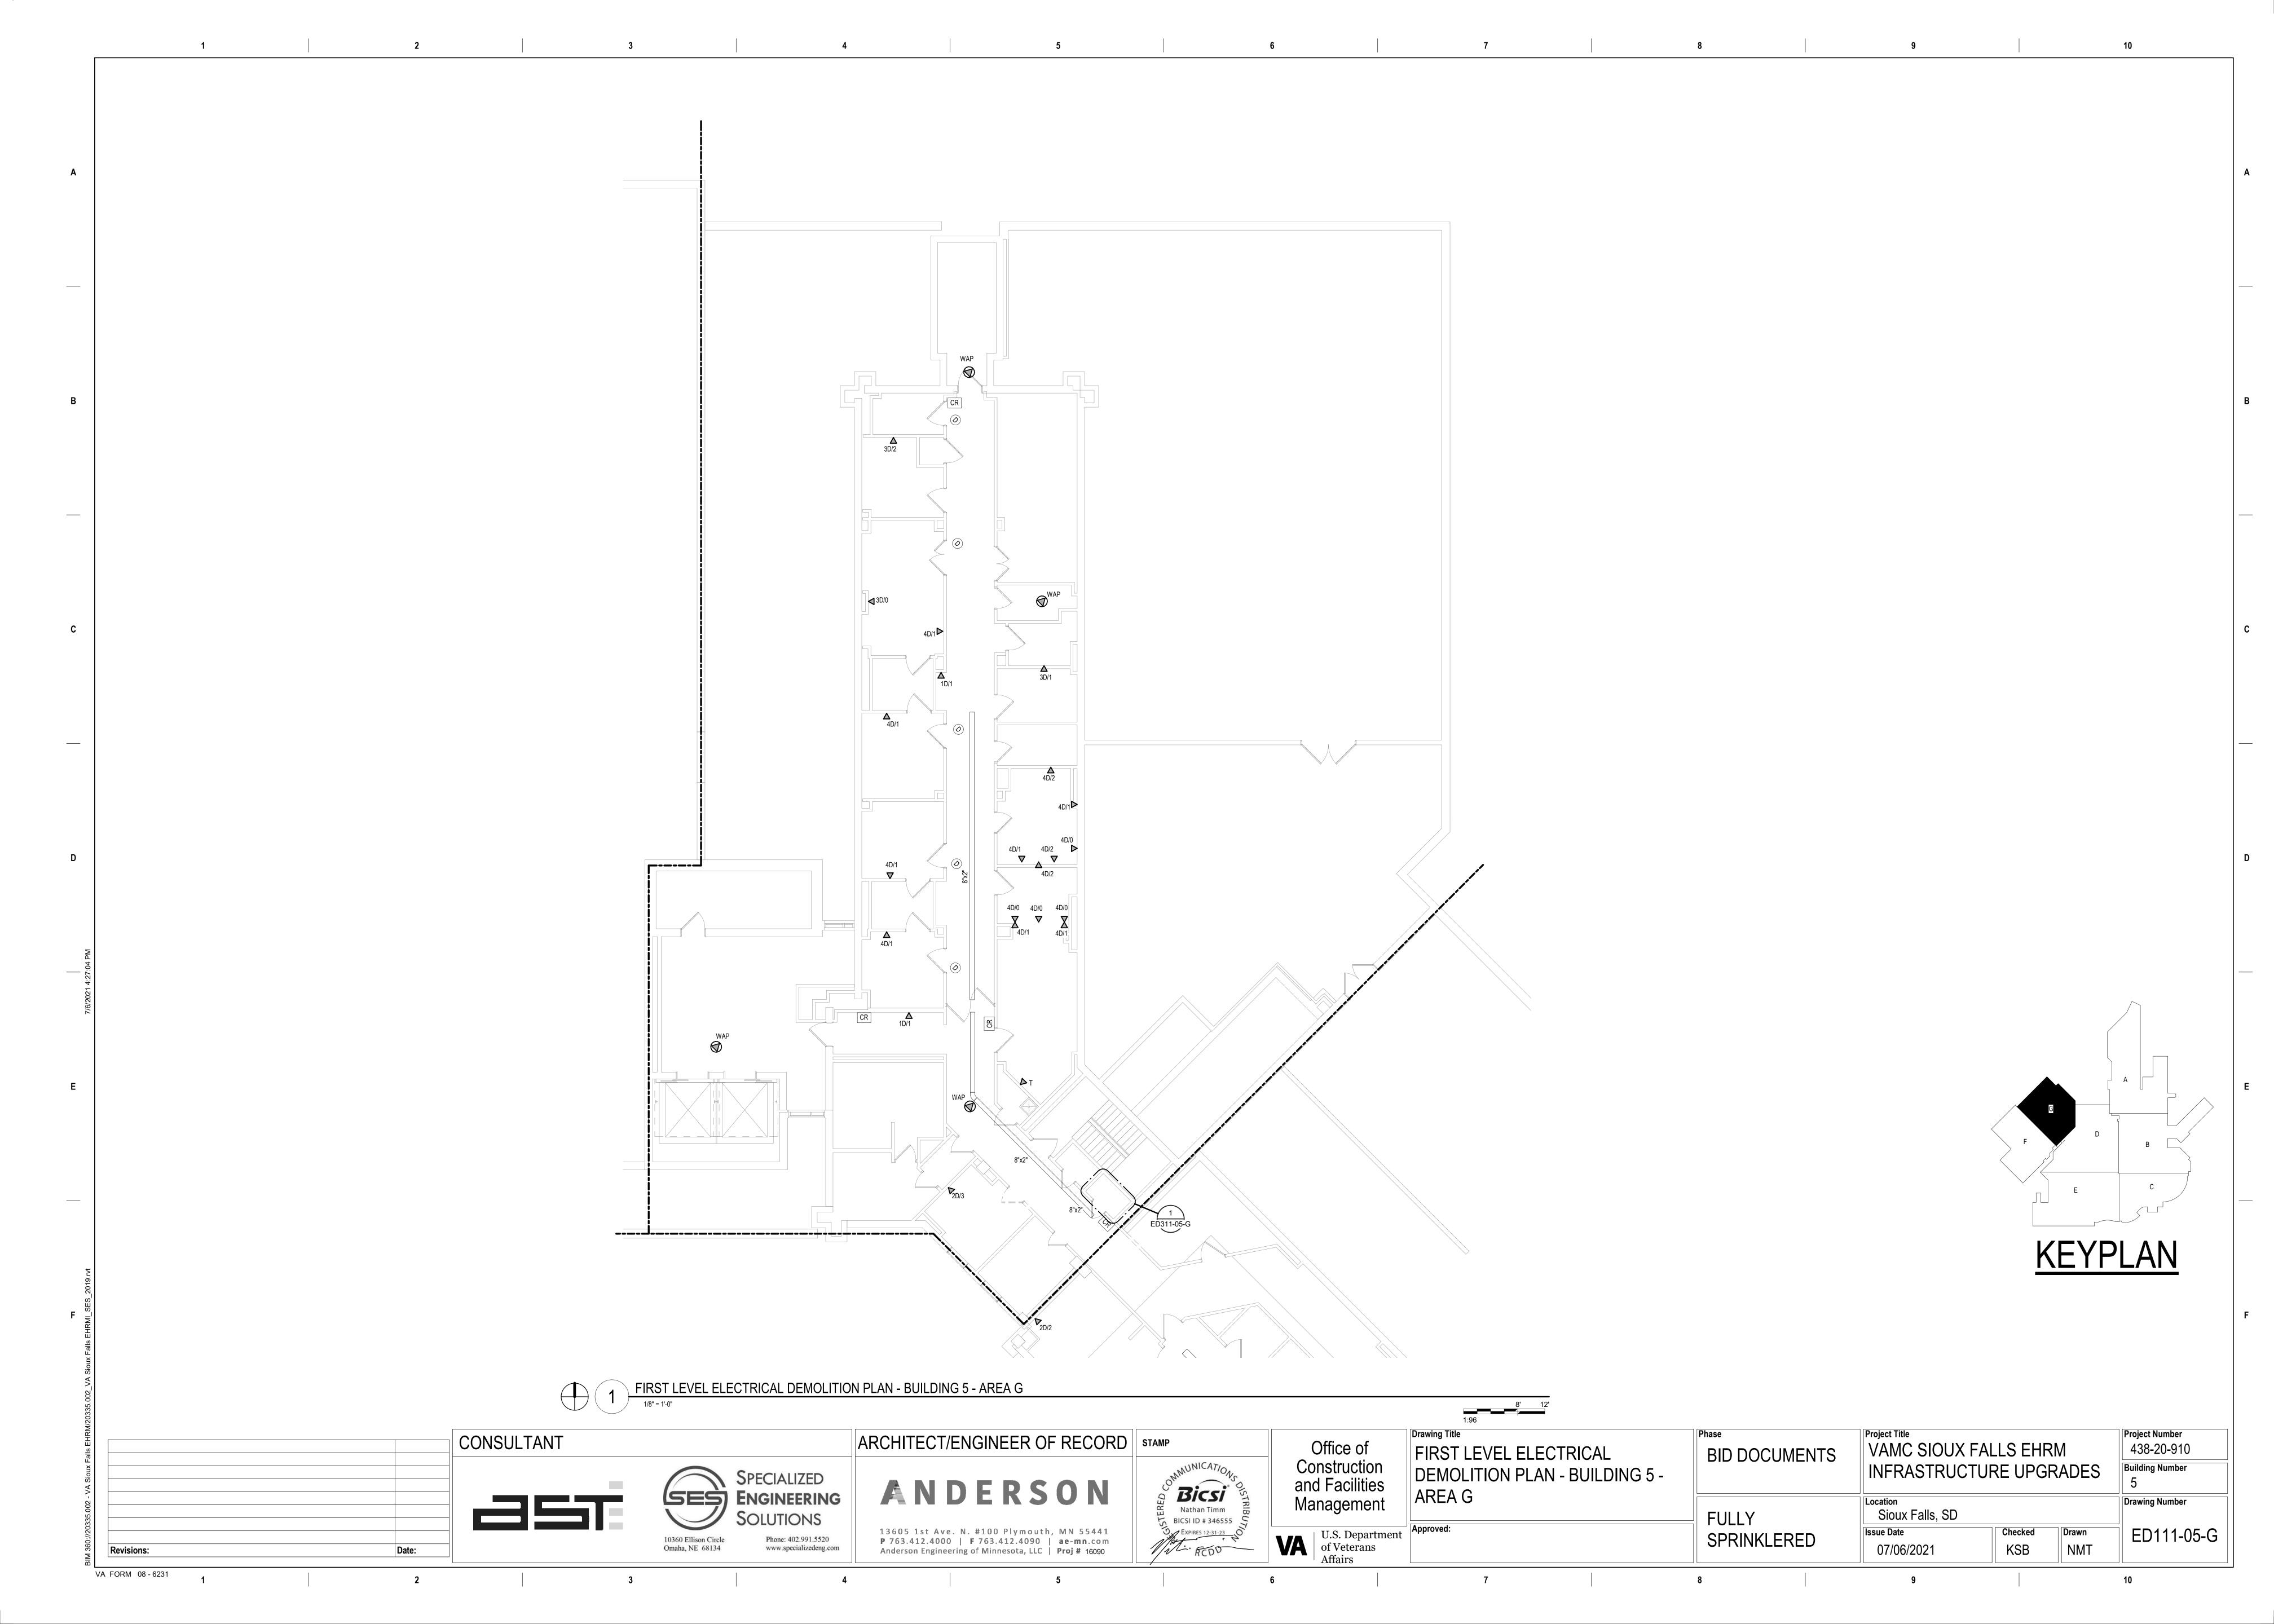

FIRST LEVEL ELECTRICAL DEMOLITION - BUILDING 5 - AREA G - ROOM 131A

1/2" = 1'-0"

CABLING NOTES:

A. THE EXISTING CABLE COUNT ARE THE CABLES CURRENTLY PRESENT IN THE SPACE. THE CABLE RELOCATION COUNT ARE THE NEW OR RELOCATED CABLES TO BE FED FROM THE SPACE. THE FINAL CABLE COUNT ARE THE CABLES THAT WILL BE PRESENT IN THE SPACE AT THE COMPLETION OF THE PROJECT. REMOVE ALL UNUSED CABLING AT THE COMPLETION OF THE PROJECT.

1. ROOM 131A

EXISTING CABLE COUNT DATA (CAT6): 120

DATA (CAT5): 24 PATIENT MONITORING: 6

COMMERCIAL WIRELESS: 3 CABLE RELOCATION COUNT DATA (CAT6): -120 TO ROOM 111

DATA (CAT5): -24 TO ROOM 111 VIDEO: -2 TÓ ROOM 111 PATIENT MONITORING: -6 TO ROOM 111

COMMERCIAL WIRELESS: -3 TO ROOM 111 EXISTING CABLE TO REMAIN DATA (CAT6): 0

VIDEO: 0 PATIENT MONITORING: 0

COMMERCIAL WIRELESS: 0 FINAL CABLE COUNT

DATA (CAT6): 0 PATIENT MONITORING: 0 COMMERCIAL WIRELESS: 0

SHEET NOTES:

 NOT USED 2. EXISTING FIBER ENCLOSURE TO BE DEMOLISHED. NEW FIBER BACKBONE TO BE TERMINATED IN NEW TELECOMMUNICATIONS RACK. REFER TO CABLING NOTES AND NEW WORK PLANS FOR ADDITIONAL REQUIREMENTS.

CONSULTANT SPECIALIZED SES ENGINEERING 10360 Ellison Circle Phone: 402.991.5520


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Office of Construction and Facilities Management U.S. Department of Veterans Affairs

Drawing Title FIRST LEVEL ELECTRICAL DEMOLITION - BUILDING 5 -ENLARGED ROOMS - AREA G

Project Title **BID DOCUMENTS FULLY**

VAMC SIOUX FALLS EHRM 438-20-910 **Building Number** INFRASTRUCTURE UPGRADES Drawing Number Sioux Falls, SD ED311-05-G

Project Number

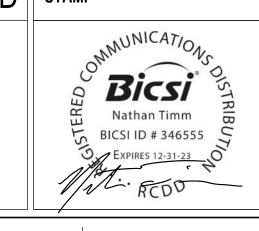Checked Drawn SPRINKLERED KSB NMT 07/06/2021

VA FORM 08 - 6231

Revisions: