


SHEET NOTES: 1. POWER DEVICE TO NEAREST AVAILABLE BRANCH CIRCUIT FEEDING RECEPTACLES IN THIS AREA. COMPUTER TRAINING 116 STORAGE 124B 1 FIRST LEVEL LOW VOLTAGE FLOOR PLAN - BUILDING 1 - AREA B KEYPLAN Drawing Title Project Title Project Number CONSULTANT ARCHITECT/ENGINEER OF RECORD | STAMP Office of VAMC SIOUX FALLS EHRM 438-20-910 FIRST LEVEL LOW VOLTAGE FLOOR | BID DOCUMENTS Construction and Facilities **Building Number** INFRASTRUCTURE UPGRADES PLAN - BUILDING 1 - AREA B SPECIALIZED Bicsi ANDERSON SES ENGINEERING Management Drawing Number Sioux Falls, SD **FULLY** 5 BICSI ID # 346555 13605 1st Ave. N. #100 Plymouth, MN 55441

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Anderson Engineering of Minnesota, LLC | Proj # 16090 EXPIRES 12-31-23 NOT Checked Drawn U.S. Department of Veterans Affairs TN111-01-B SPRINKLERED 10360 Ellison Circle Phone: 402.991.5520 KSB 07/06/2021 NMT Omaha, NE 68134 www.specializedeng.com Revisions: VA FORM 08 - 6231

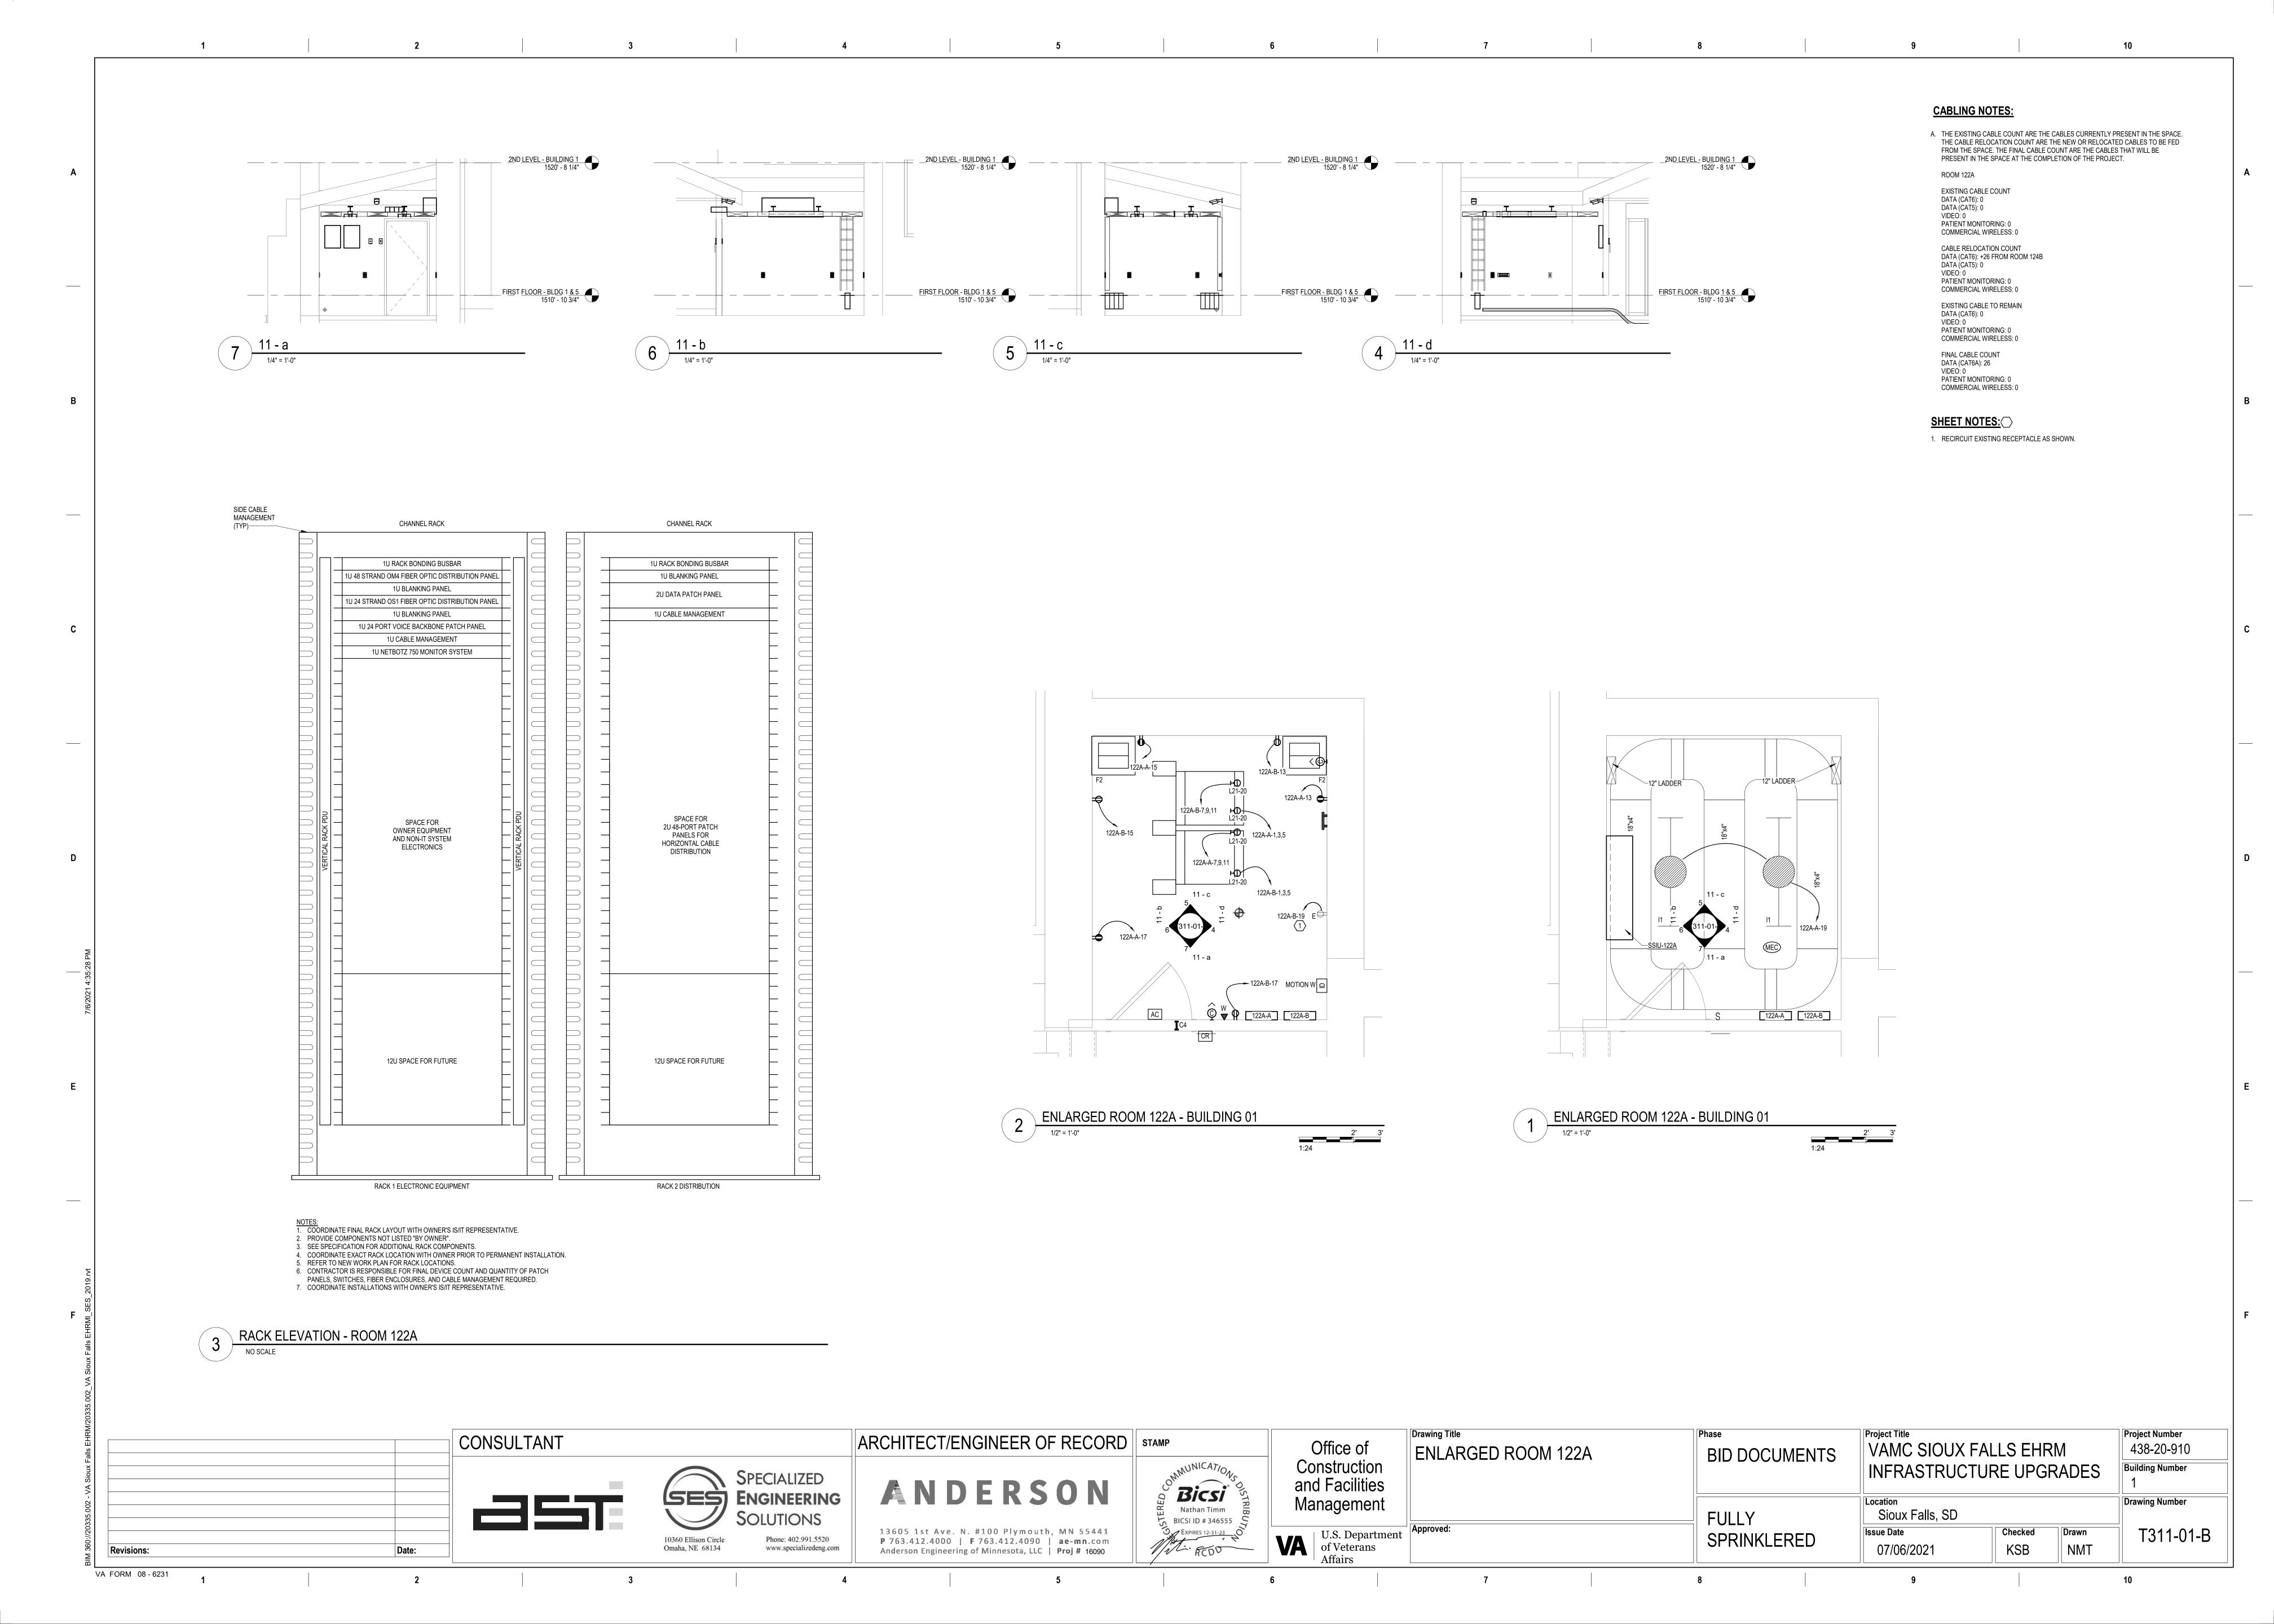

LIGHTING PANEL: 122A-B VOLTS: 208/120 WYE MAINS TYPE: MCB **LOCATION**: COMM 122A SUPPLY FROM: B2 PHASES: 3 MCB/MLO RATING: 100 A **BRANCH: NORMAL** MCB OPTIONS: NONE SERVICE RATED: No INTEGRAL SPD: Yes SECTIONS: 1 **MOUNTING:** SURFACE AVAILABLE SCC (kA): 1.0 PANEL POLES: 42 **NEMA ENCLOSURE**: 1 OPT RATI... POL... A B C POL... RATI... OPT CIRCUIT DESCRIPTION CIRCUIT DESCRIPTION
 PT
 RATI...
 POL...
 A
 B
 C
 POL...
 RATI...
 OPT
 CIRC

 20 A
 3
 1922...
 0 VA
 3
 20 A
 - SPARE

 20 A
 3
 1922...
 0 VA
 1
 20 A
 - SPARE

 20 A
 1
 1922 VA
 0 VA
 1
 20 A
 - SPARE

 20 A
 1
 180 VA
 0 VA
 1
 20 A
 - SPARE

 20 A
 1
 180 VA
 0 VA
 1
 20 A
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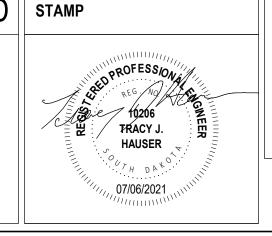
 20 A
 1
 180 VA
 0 VA
 1
 20 A
 - SPARE

 20 A
 1
 180 VA
 0 VA
 1
 20 A
 - SPARE
 PWR-C COMM 122A - RACK __RECEPTACLE PWR-C COMM 122A - RACK RECEPTACLE 13 REC COMM 122A 15 REC COMM 122A 17 REC COMM 122A 0 A 1 180 VA **TOTAL LOAD:** 4204 VA 4024 VA 4024 VA TOTAL AMPS: 35 A LOAD CLASSIFICATION CONNECTED LOAD | DEMAND FACTOR | ESTIMATED DEMAND PANEL TOTALS 100.00% 720 VA CONNECTED LOAD: 12252 VA 11532 VA 10766 VA CONNECTED CURRENT: 34 A **DEMAND LOAD:** 11486 VA **DEMAND CURRENT:** 32 A **CONSIDER 125% DEMAND:** 14358 A EQUIPMENT AMPS: 100 A FEEDER AVAILABLE: **SPARE CAPACITY:** 68 % 68 A CIRCUIT BREAKER OPTIONS SUFFIX: 'S' OR 'ST' - PROVIDE SHUNT TRIP CIRCUIT BREAKER / 'G' OR 'GFCI' - PROVIDE GFCI CIRCUIT BREAKER / 'GFP' - PROVIDE GFP CIRCUIT BREAKER / 'ERMS' - ENERGY REDUCING MAINTENANCE SWITCH / 'ZSI' - ZONE SELECTIVE INTERLOCKING / 'L' - PROVIDE CIRCUIT BREAKER WITH LOCKING PROVISIONS / 'R' - PROVIDE CIRCUIT BREAKER WITH RED MARKING A. PANEL AIC (INTERRUPTING) RATING SHALL BE MINIMUM 120% OF THE AVAILABLE SCC (SHORT CIRCUIT CURRENT).

	LOCATION: CO SUPPLY FROM: A2 BRANCH: CF SERVICE RATED: NO MOUNTING: SU	2 RITICAL D			AVA		VOLTS PHASES WIRES GRAL SPD SCC (kA)	: 3 : 4 : Yes	20 WYE			MCB/ML MCE	LO RAT B OPTION SECTION	YPE: MCB ING: 100 A ONS: NONE ONS: 1 LES: 42		
C	NEMA ENCLOSURE: 1 CIRCUIT DESCRIPTION	ОРТ	RATI	POL		A	E	<u> </u>		<u> </u>	POL	RATI	ОРТ	CIRC	UIT DESCRIPTION	(
1	PWR-C COMM 122A - RACK RECEPTACLE		20 A	3	1922	0 VA	1922 VA				3	20 A		SPARE		
	PWR-C COMM 122A - RACK		20 A	3	1922	0 VA	1922 VA	0 VA	1922 VA	0 VA	1 1	20 A 20 A		SPARE SPARE		
11	RECEPTACLE REC COMM 122A		20 A	1	180 VA	0 VA			1922 VA	0 VA	1	20 A 20 A		SPARE SPARE		
15	REC COMM 122A		20 A	1	100 VA	UVA	180 VA	0 VA	400.14	0.1/2	1	20 A		SPARE		
	REC COMM 122A LTG COMM 122A		20 A 20 A	1	50 VA		1195 VA		180 VA	0 VA	1	20 A		SPARE		
23 25	SSIU-122/SSOU-122		25 A	2			1195 VA		1195 VA							
27 29																
31																
35 37																
39 41																
			TOTAL TOTAL			4 VA I A	5219 45		5219 45							
	O CLASSIFICATION		СО		ED LOAI	D DEN	MAND FAC		ESTIMATI		AND				TOTALS	
LTG REC				50 ` 540			125.00% 100.00%			2 VA .0 VA				CTED LOAD: CURRENT:		
MTR PWR				2390 1153			124.22% 93.36%			69 VA 66 VA		D		MAND LOAD: CURRENT:		
IVVIX	-110			1100	2 VA		93.3070		107	00 VA	(% DEMAND:		
														MENT AMPS:	100 A	
														AVAILABLE:	60 %	
													SPARE	CAPACITY:	60 A	
OPTI	ONS:															
	UIT BREAKER OPTIONS SUFFIX:														'GFP' - PROVIDE GFP ER WITH LOCKING)

CONSULTANT SPECIALIZED SES ENGINEERING Phone: 402.991.5520 10360 Ellison Circle www.specializedeng.com Omaha, NE 68134 Revisions:

ARCHITECT/ENGINEER OF RECORD | STAMP ANDERSON 13605 1st Ave. N. #100 Plymouth, MN 55441 P 763.412.4000 | F 763.412.4090 | ae-mn.com Anderson Engineering of Minnesota, LLC | Proj # 16090



Office of Construction and Facilities Management U.S. Department of Veterans Affairs

Drawing Title PANEL SCHEDULES - BUILDING 1 -FIRST LEVEL - AREA B

Project Title Project Number VAMC SIOUX FALLS EHRM 438-20-910 **BID DOCUMENTS Building Number** INFRASTRUCTURE UPGRADES Drawing Number Location Sioux Falls, SD **FULLY** Checked Drawn


KSB NMT


VA FORM 08 - 6231

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07/06/2021

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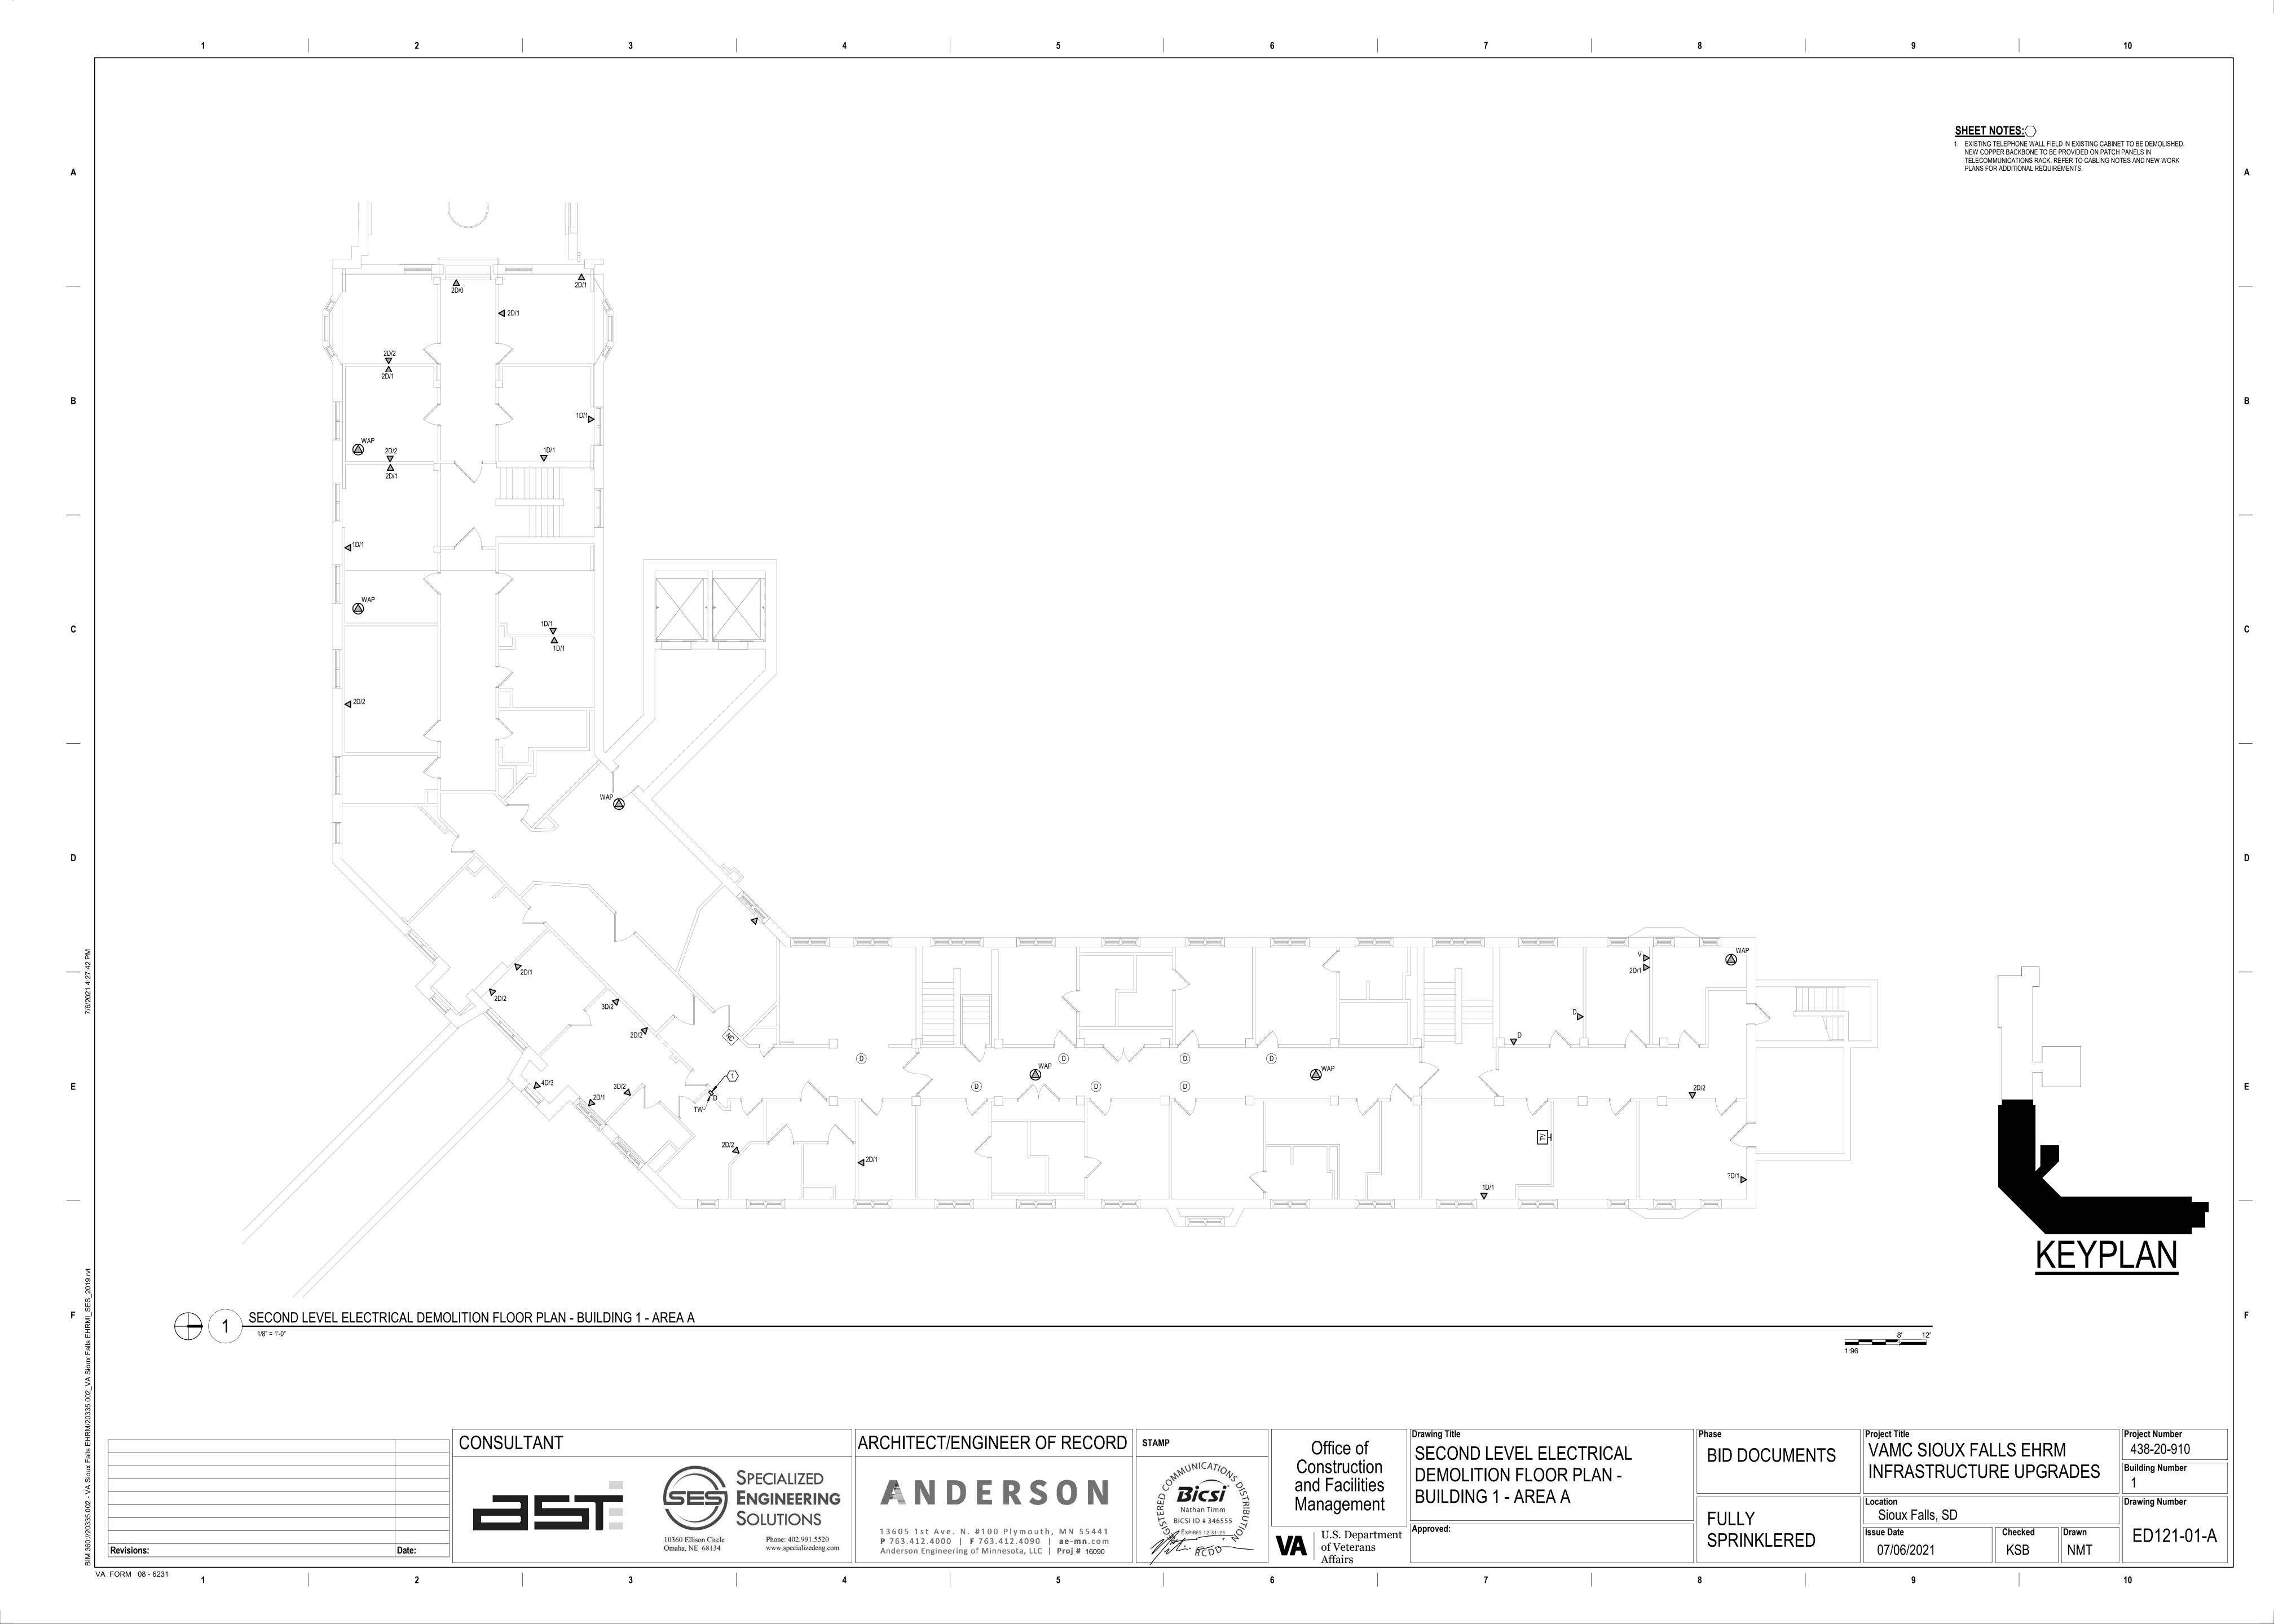
SHEET NOTES: AREA IS RECENTLY RENOVATED AND FED FROM ROOM 122A. NO RECABLING IS ANTICIPATED IN THIS AREA.
 RECABLE ALL CAT 5E AND LOWER CABLES TO ROOM 313 IN FLOOR ABOVE. 3. EXIT STAIR ENCLOSURE. DO NOT ROUTE NEW CABLING THROUGH THIS SPACE. 4. ROUTE NEW CABLING IN J-HOOKS IN THIS AREA. ROUTE NEW CABLING EXISTING CONDUITS IN THIS AREA TO ROOM 313 IN FLOOR ABOVE. CEILINGS IN THIS
AREA ARE GYPSUM BOARD CEILINGS. **KEYPLAN** 1 SECOND LEVEL ELECTRICAL FLOOR PLAN - BUILDING 1 - OVERALL


1/16" = 1'-0" Drawing Title Project Number CONSULTANT ARCHITECT/ENGINEER OF RECORD | STAMP Office of VAMC SIOUX FALLS EHRM 438-20-910 SECOND LEVEL FLOOR PLAN -**BID DOCUMENTS** Construction and Facilities **Building Number** INFRASTRUCTURE UPGRADES SPECIALIZED ENGINEERING BUILDING 1 Bicsi
Nathan Timm ANDERSON Management Drawing Number Sioux Falls, SD **FULLY** BICSI ID # 346555 13605 1st Ave. N. #100 Plymouth, MN 55441

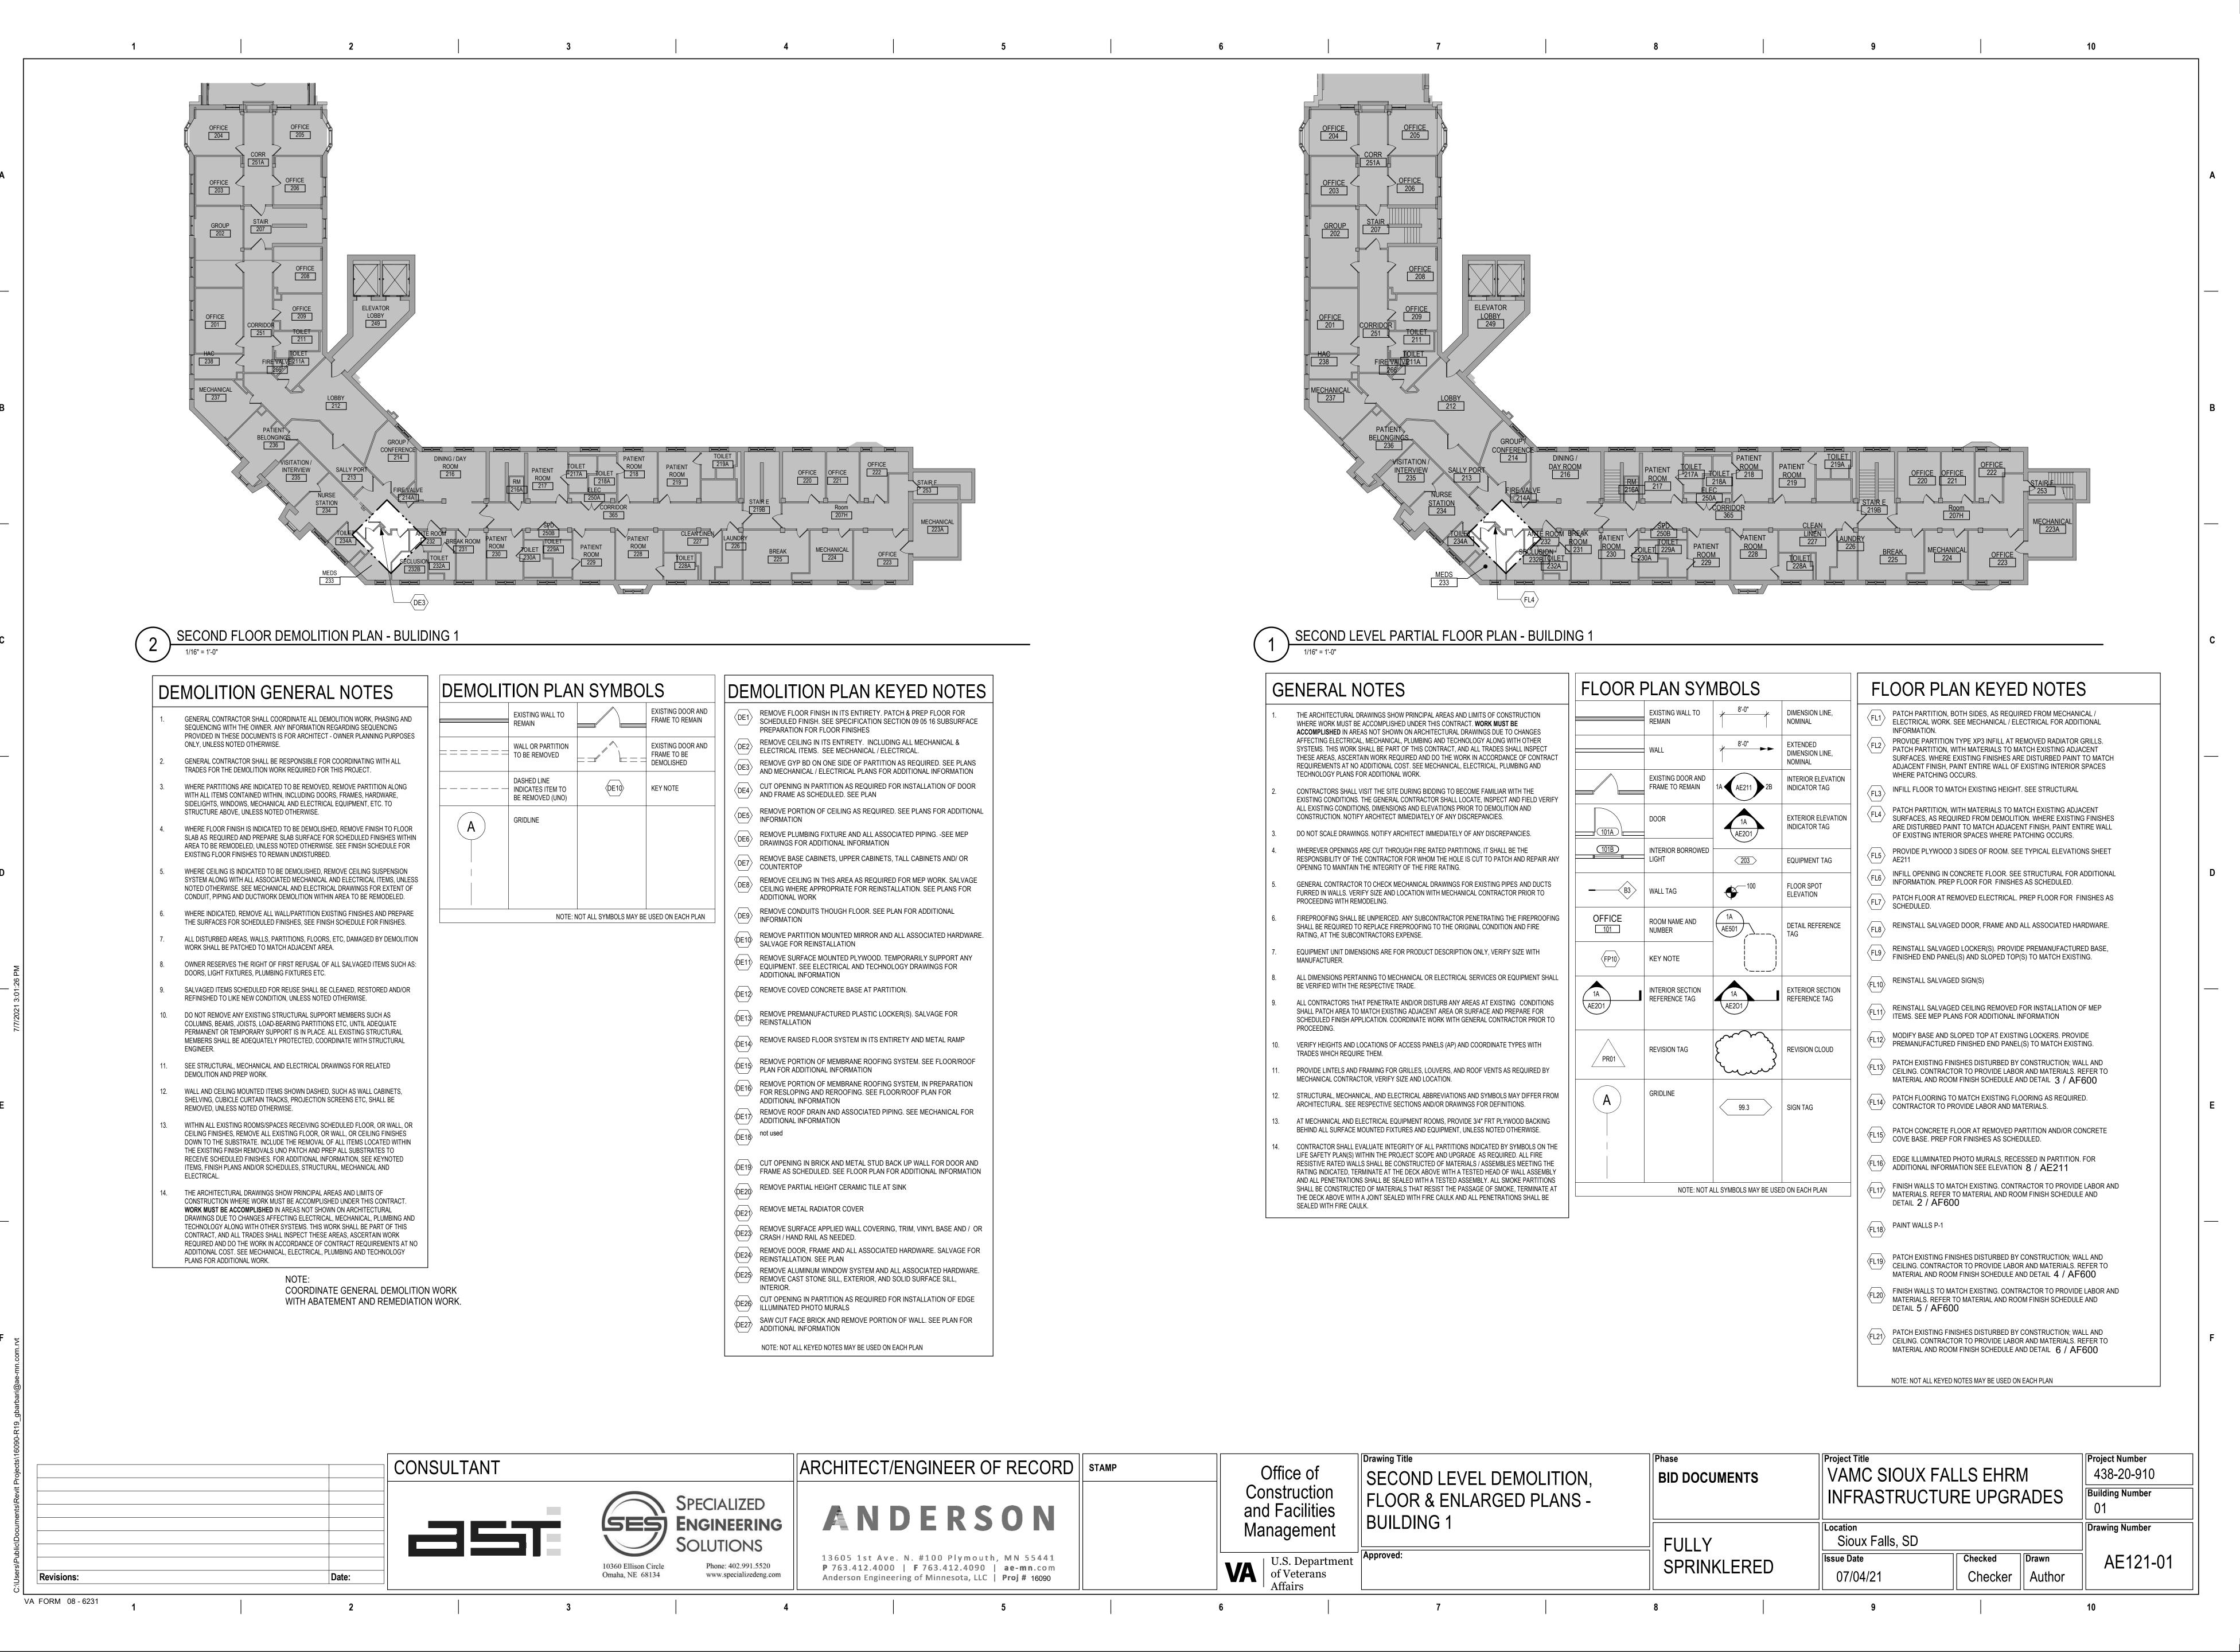
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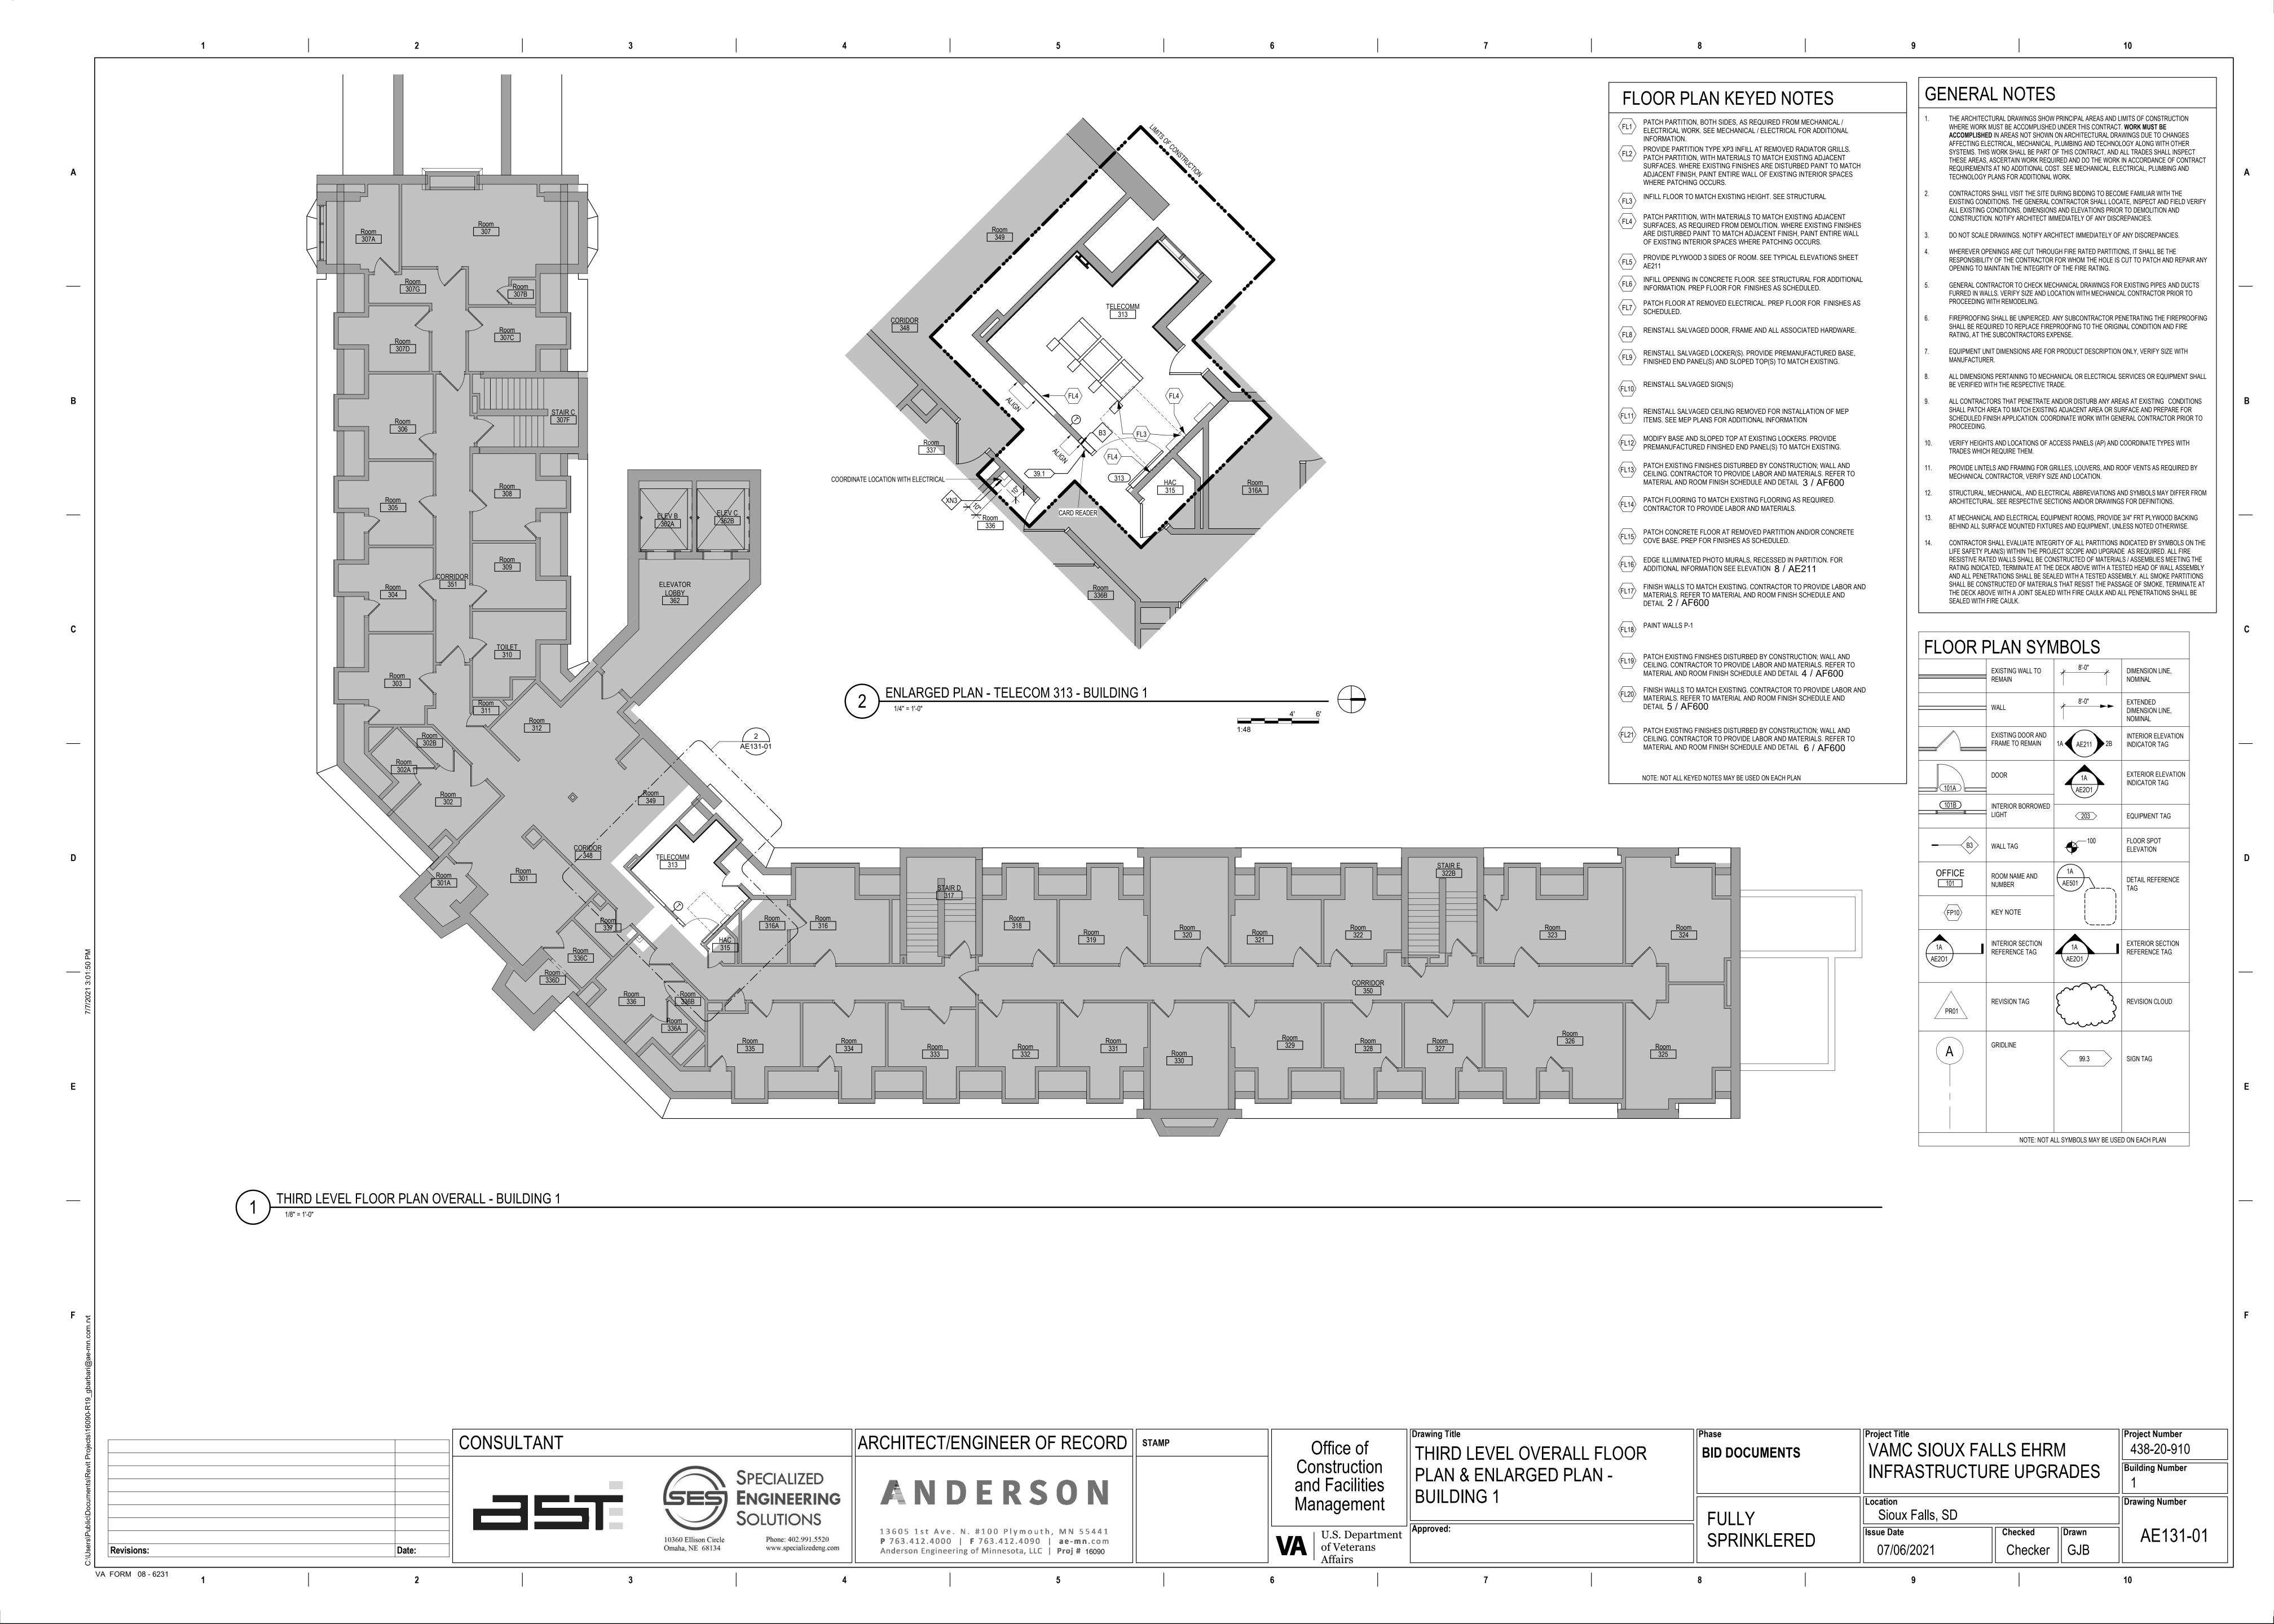
Anderson Engineering of Minnesota, LLC | Proj # 16090 EXPIRES 12-31-23

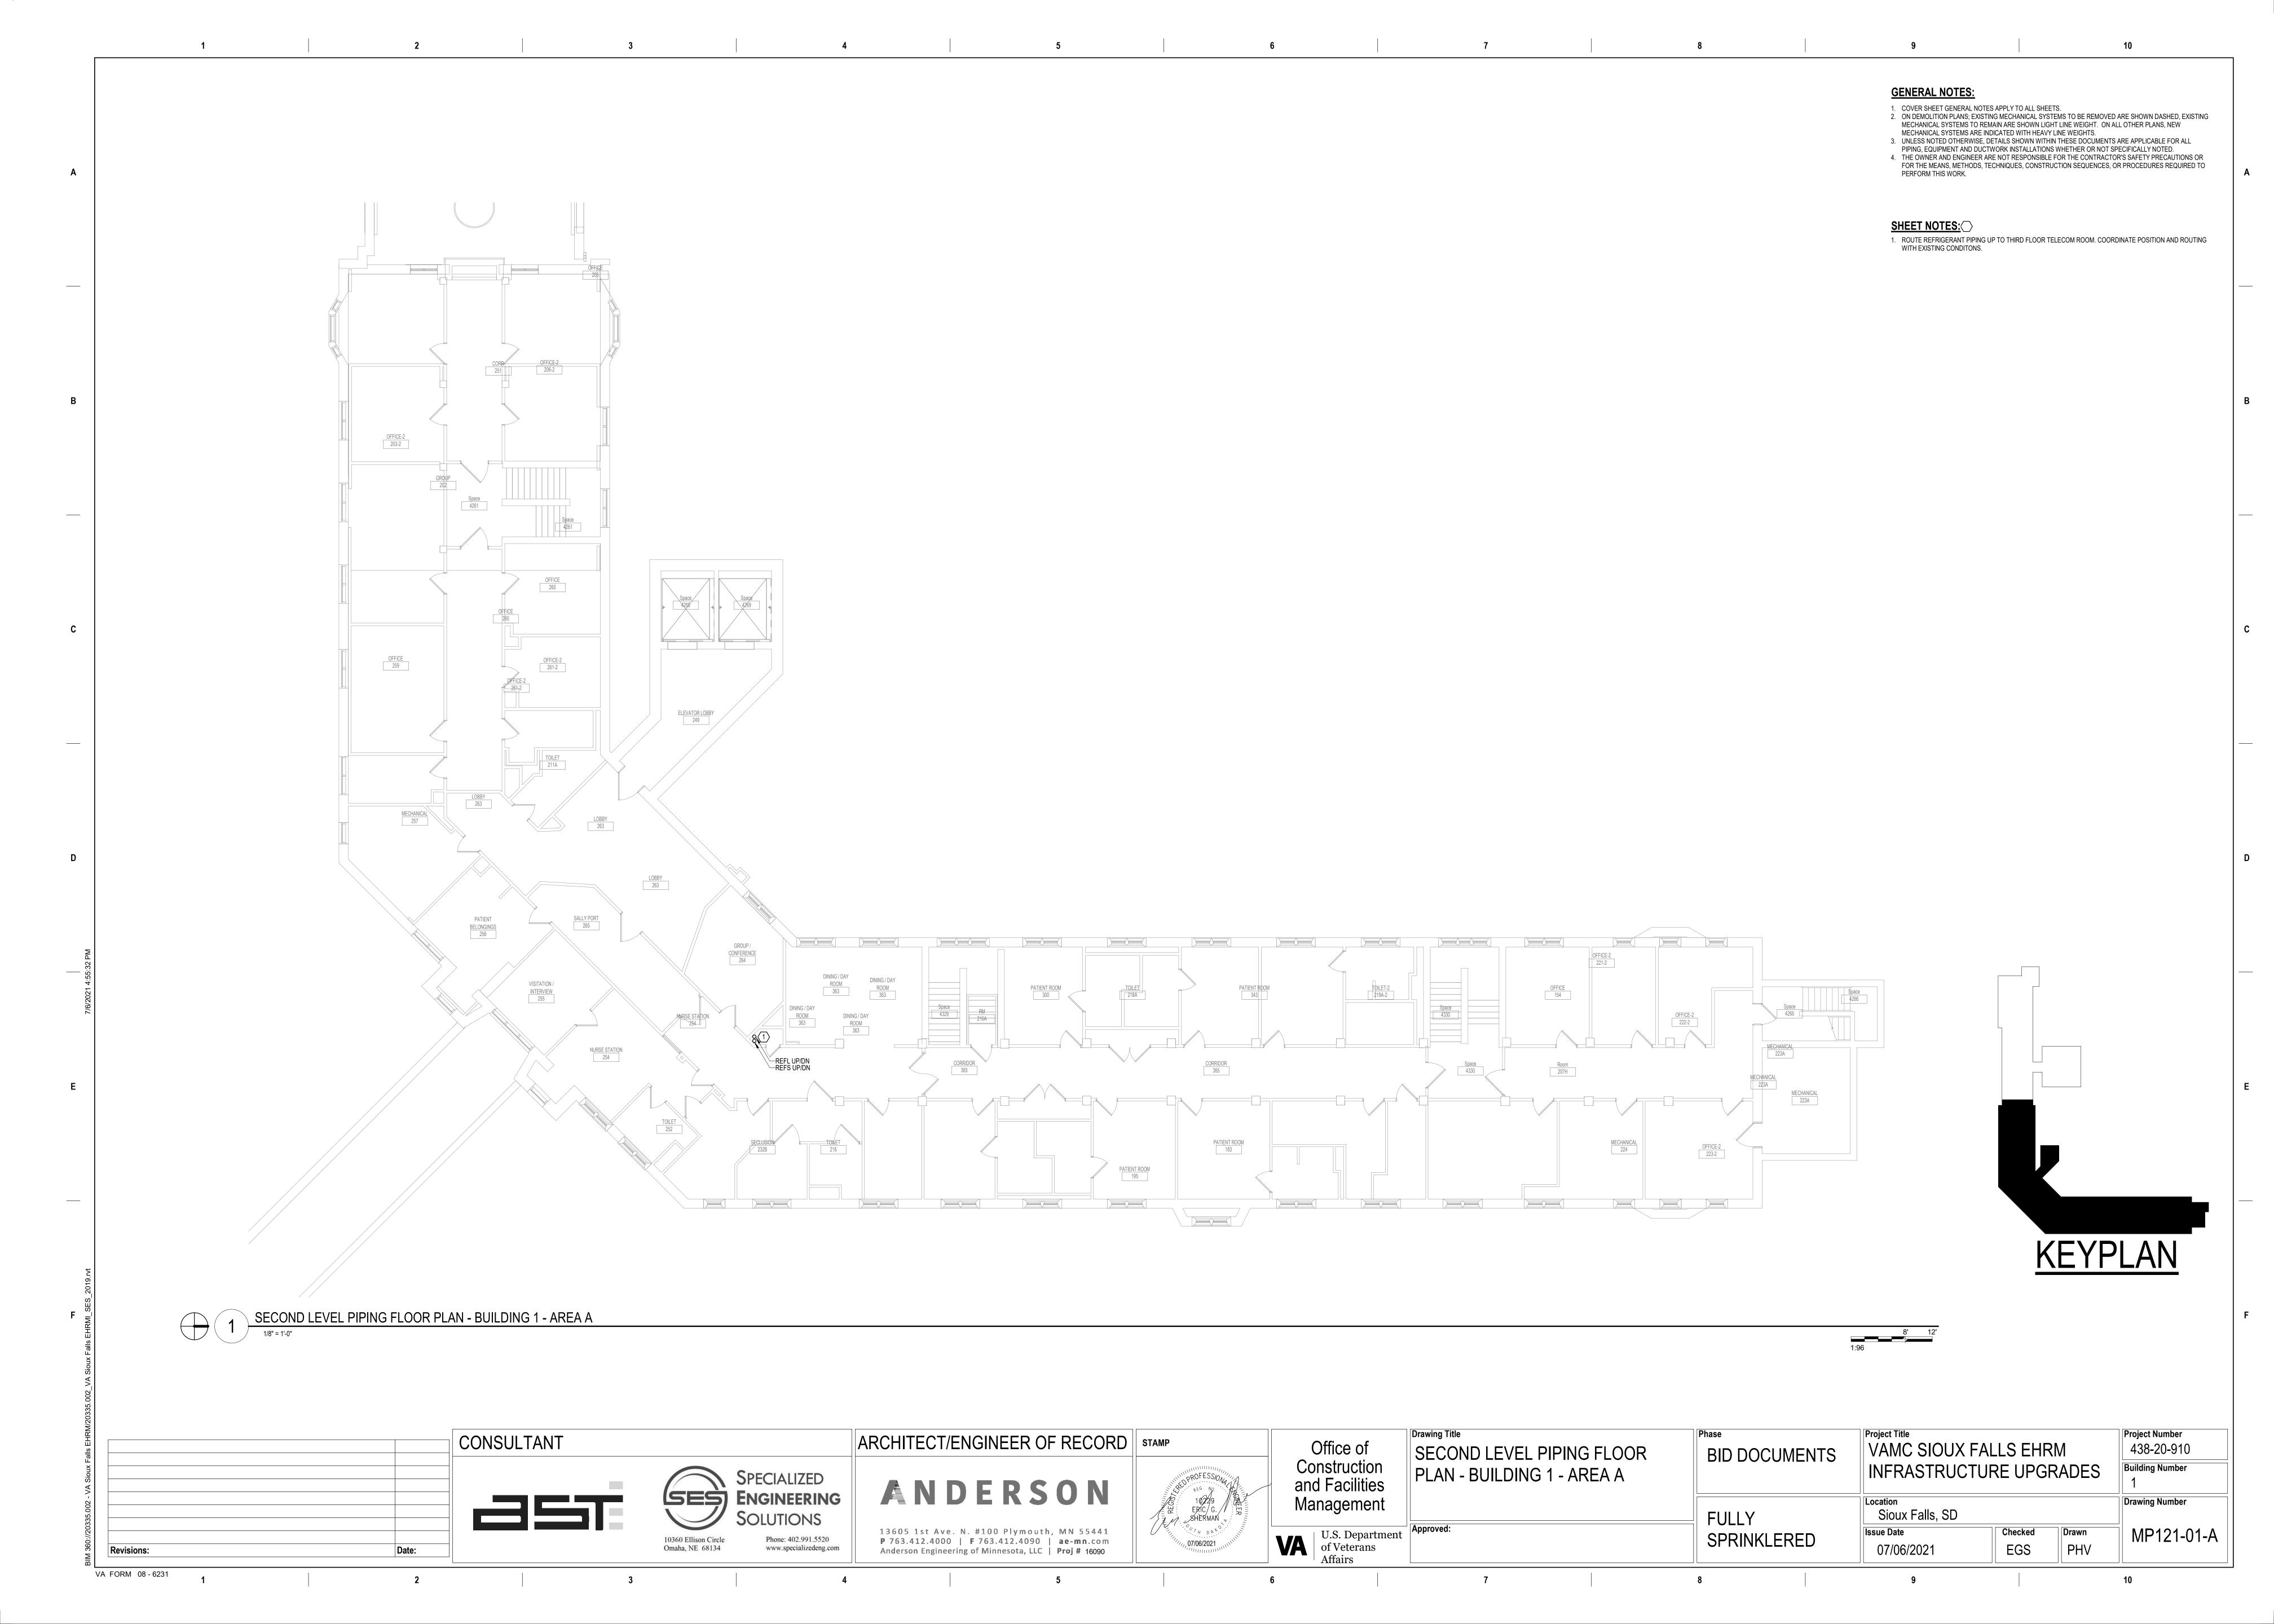
RCDO Checked Drawn VA U.S. Department of Veterans Affairs EE121-01 SPRINKLERED Phone: 402.991.5520 www.specializedeng.com 10360 Ellison Circle KSB NMT 07/06/2021 Revisions: VA FORM 08 - 6231







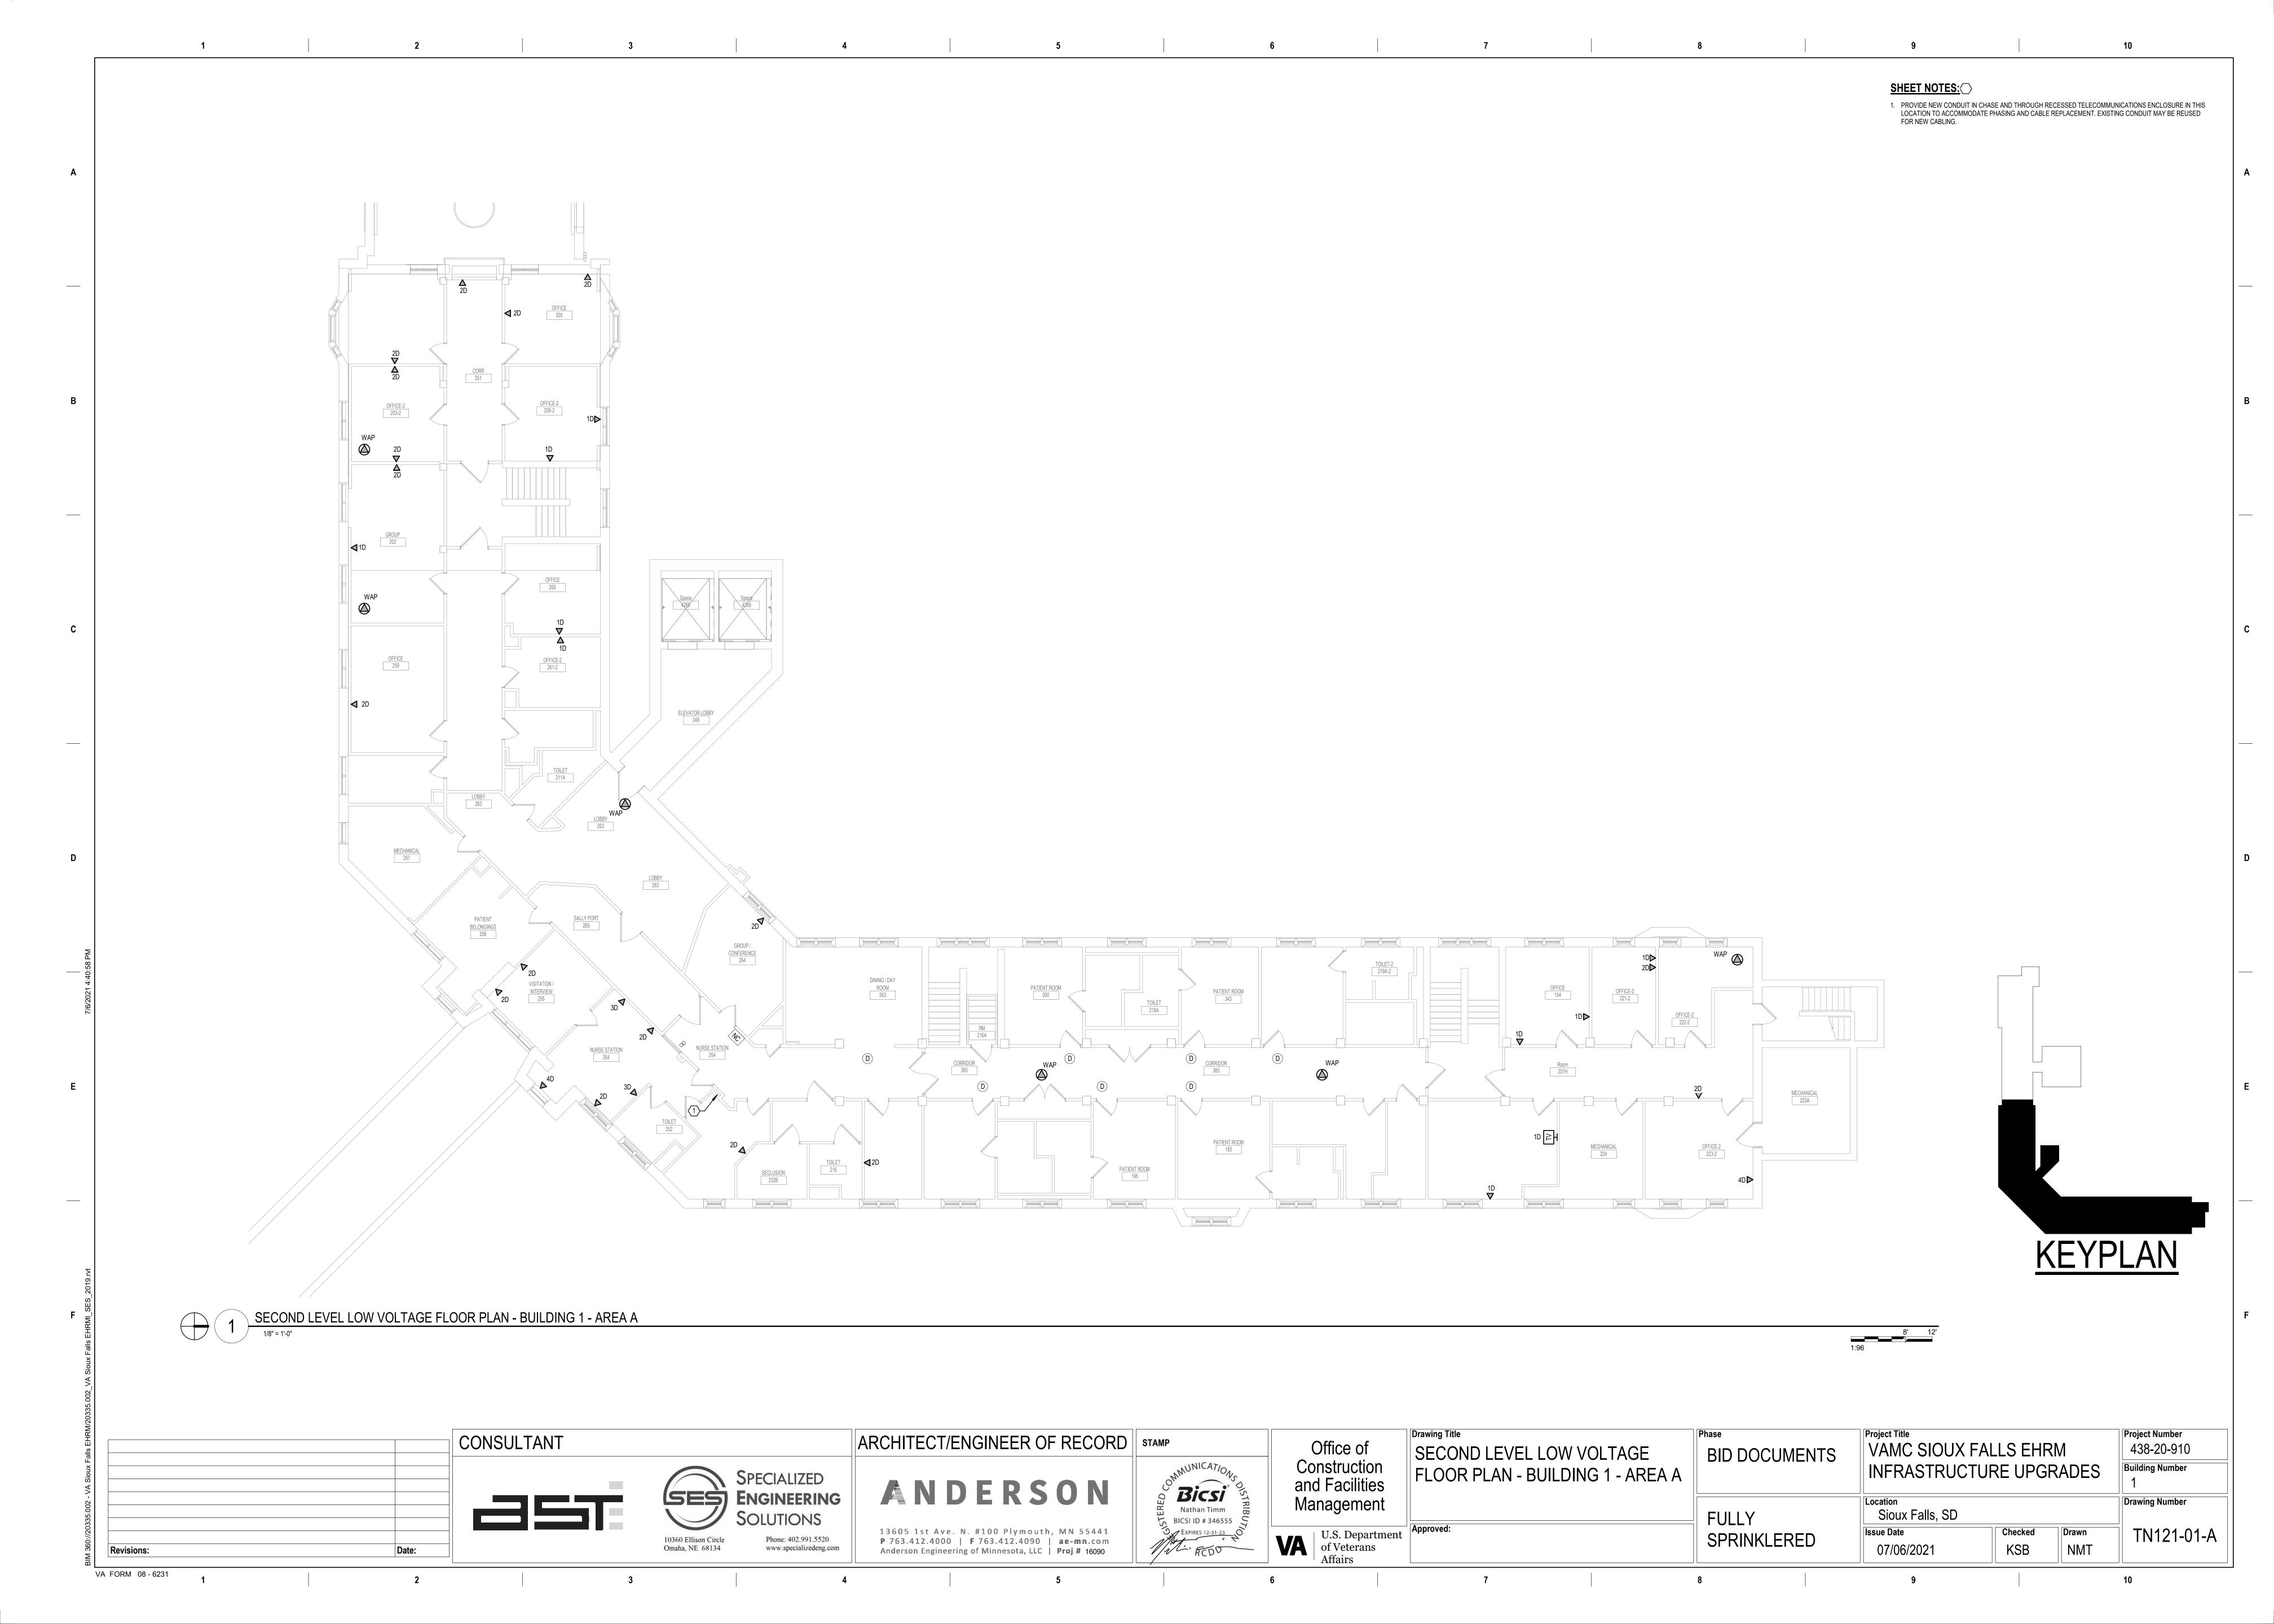

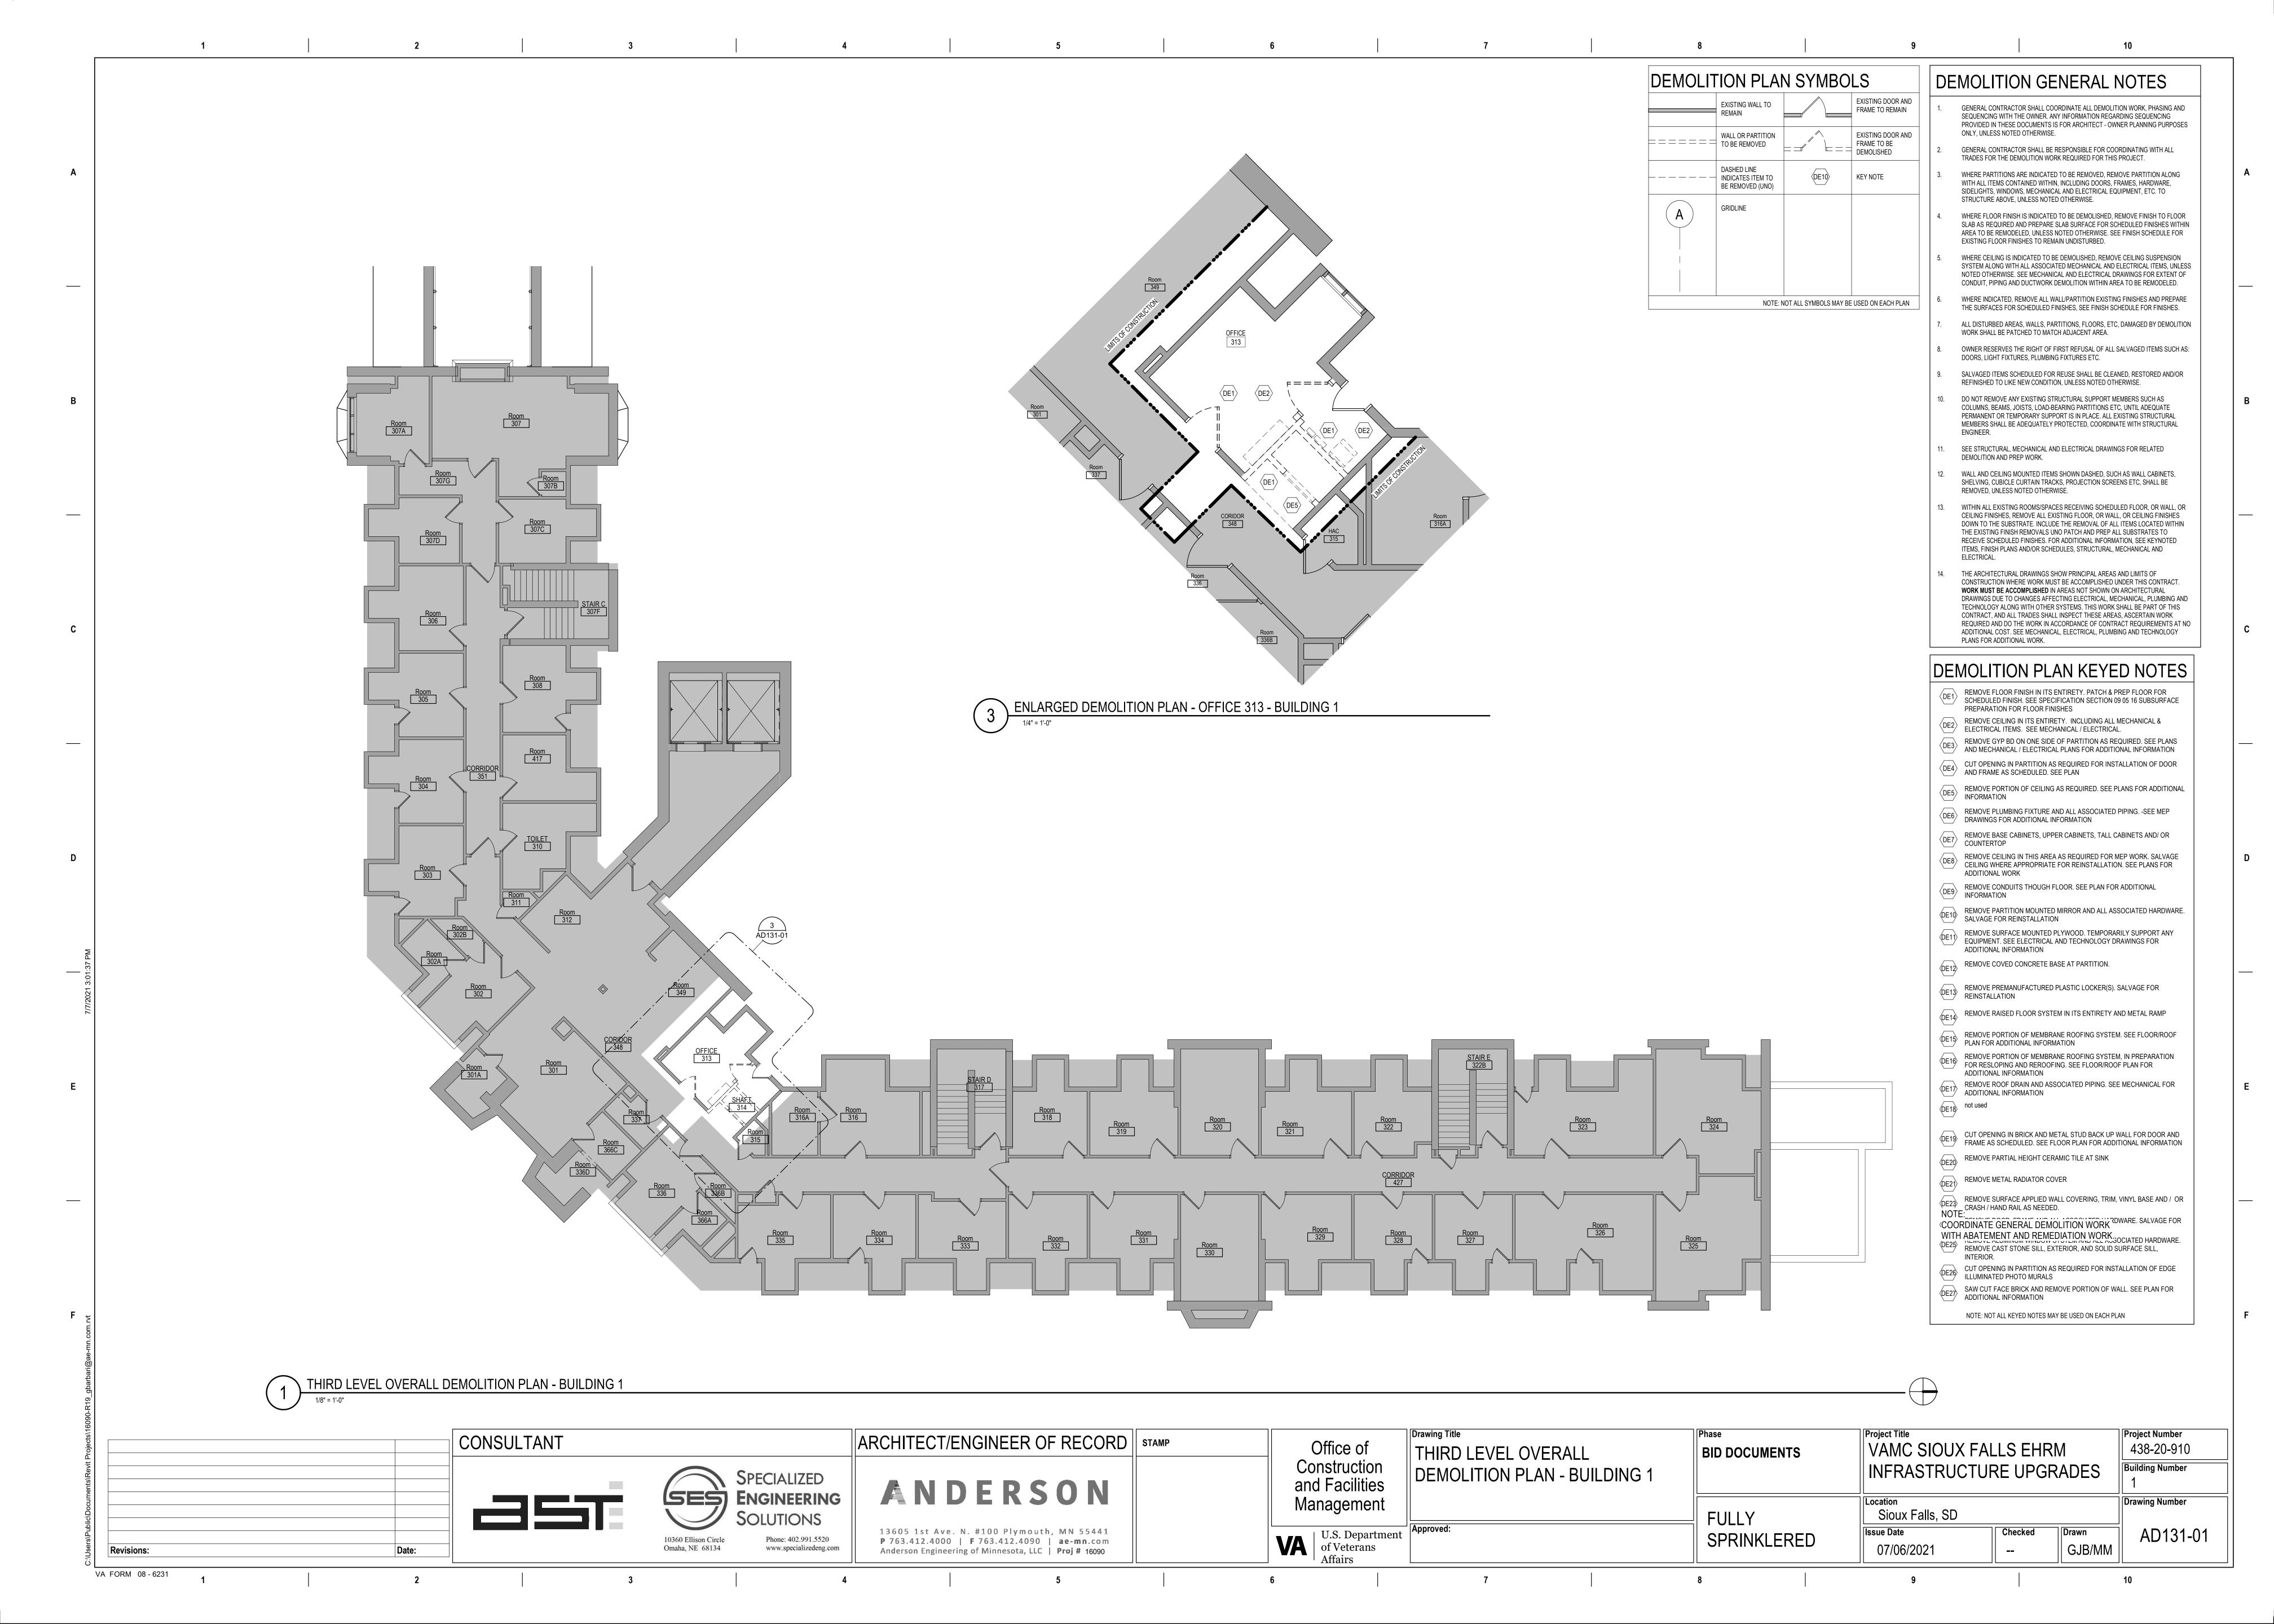

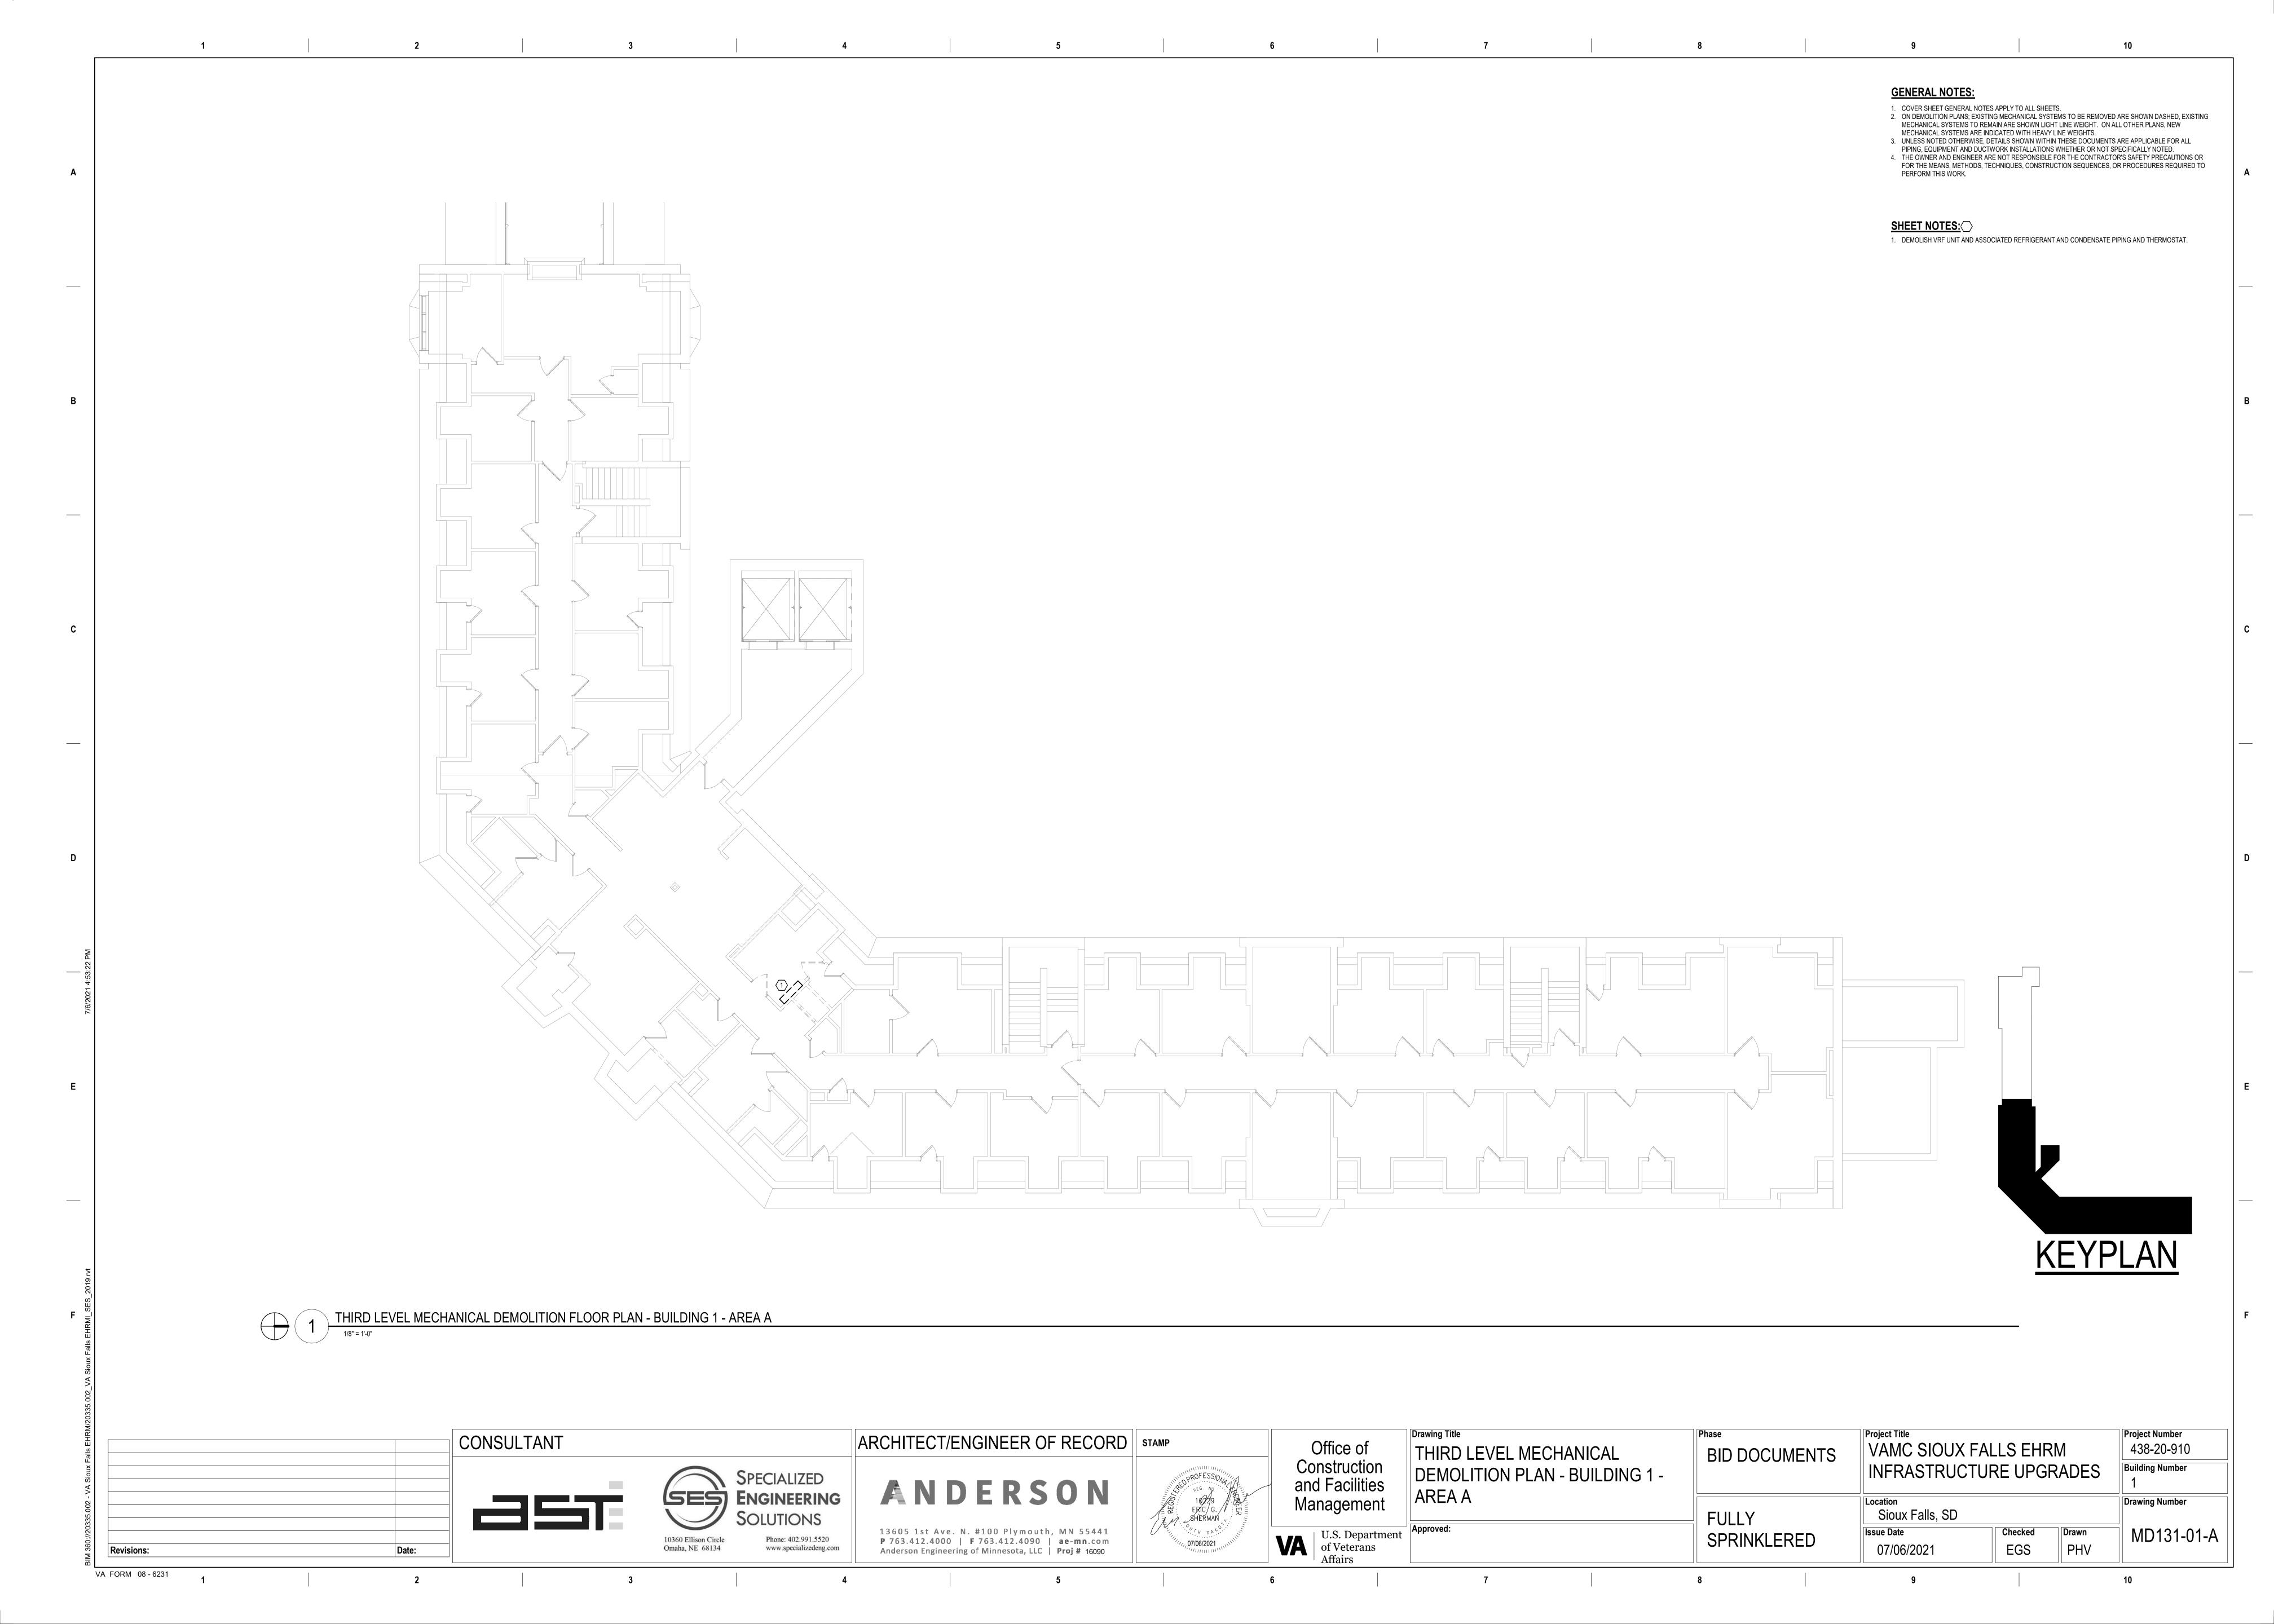

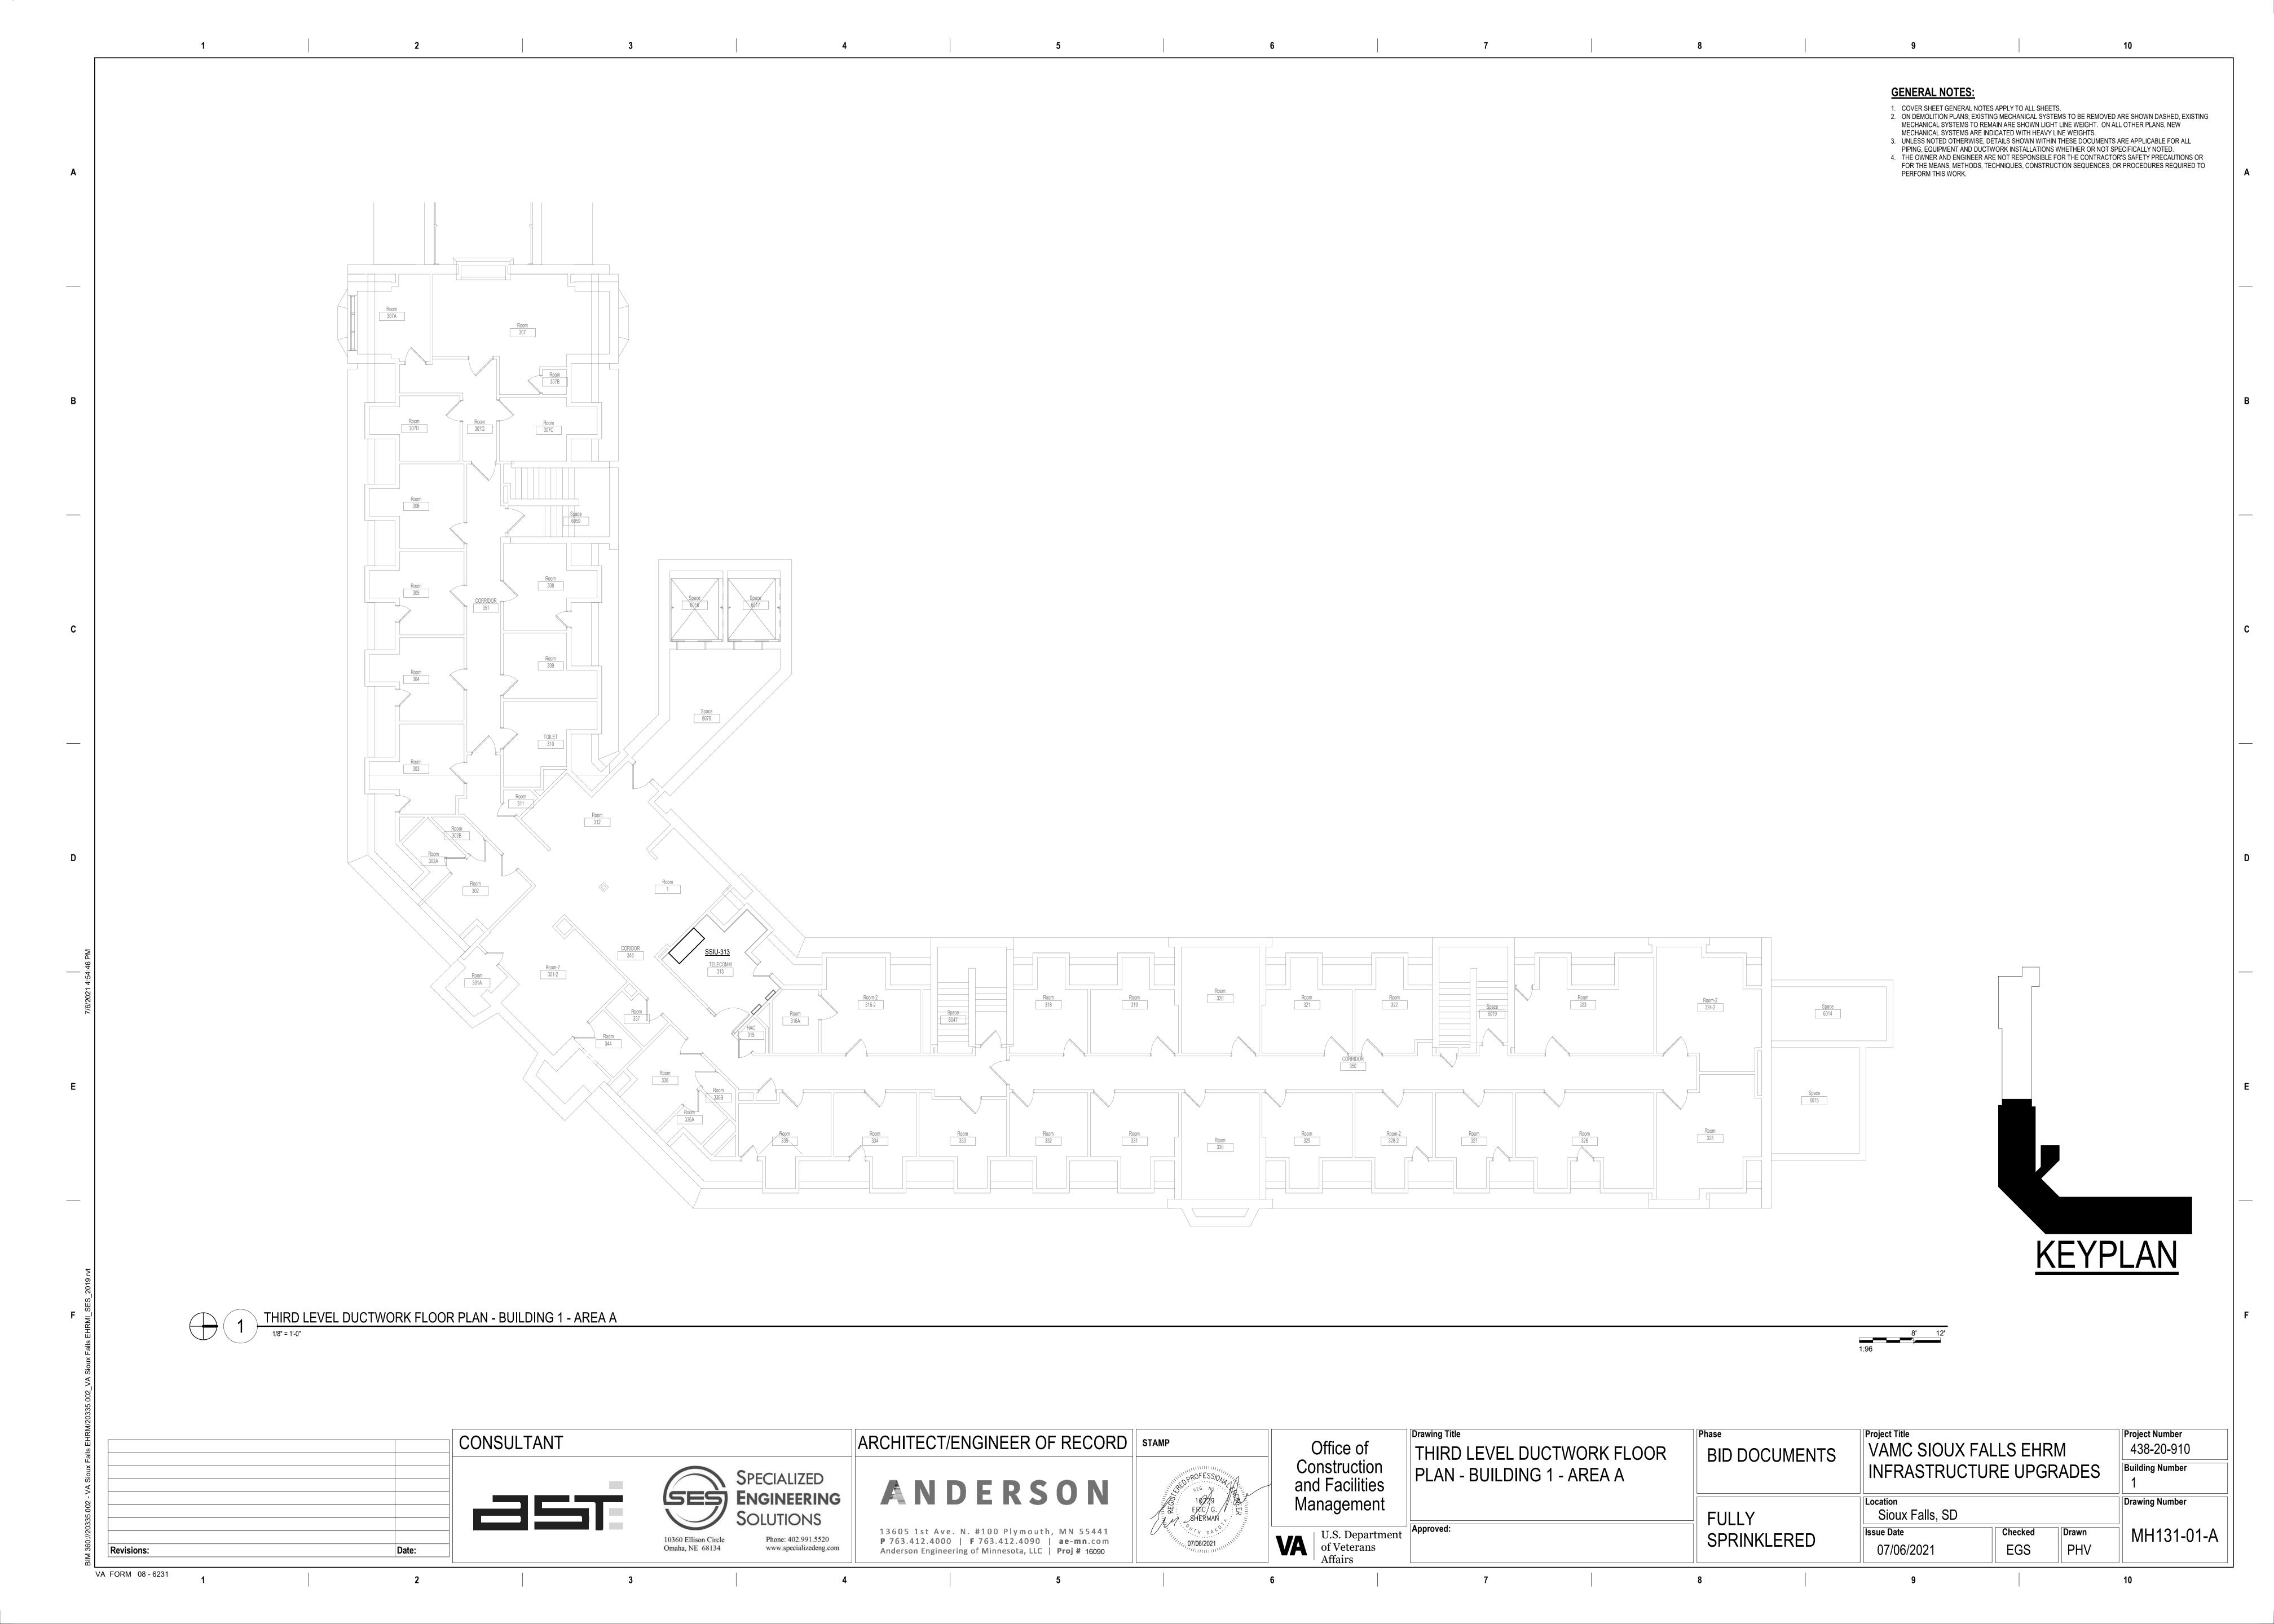

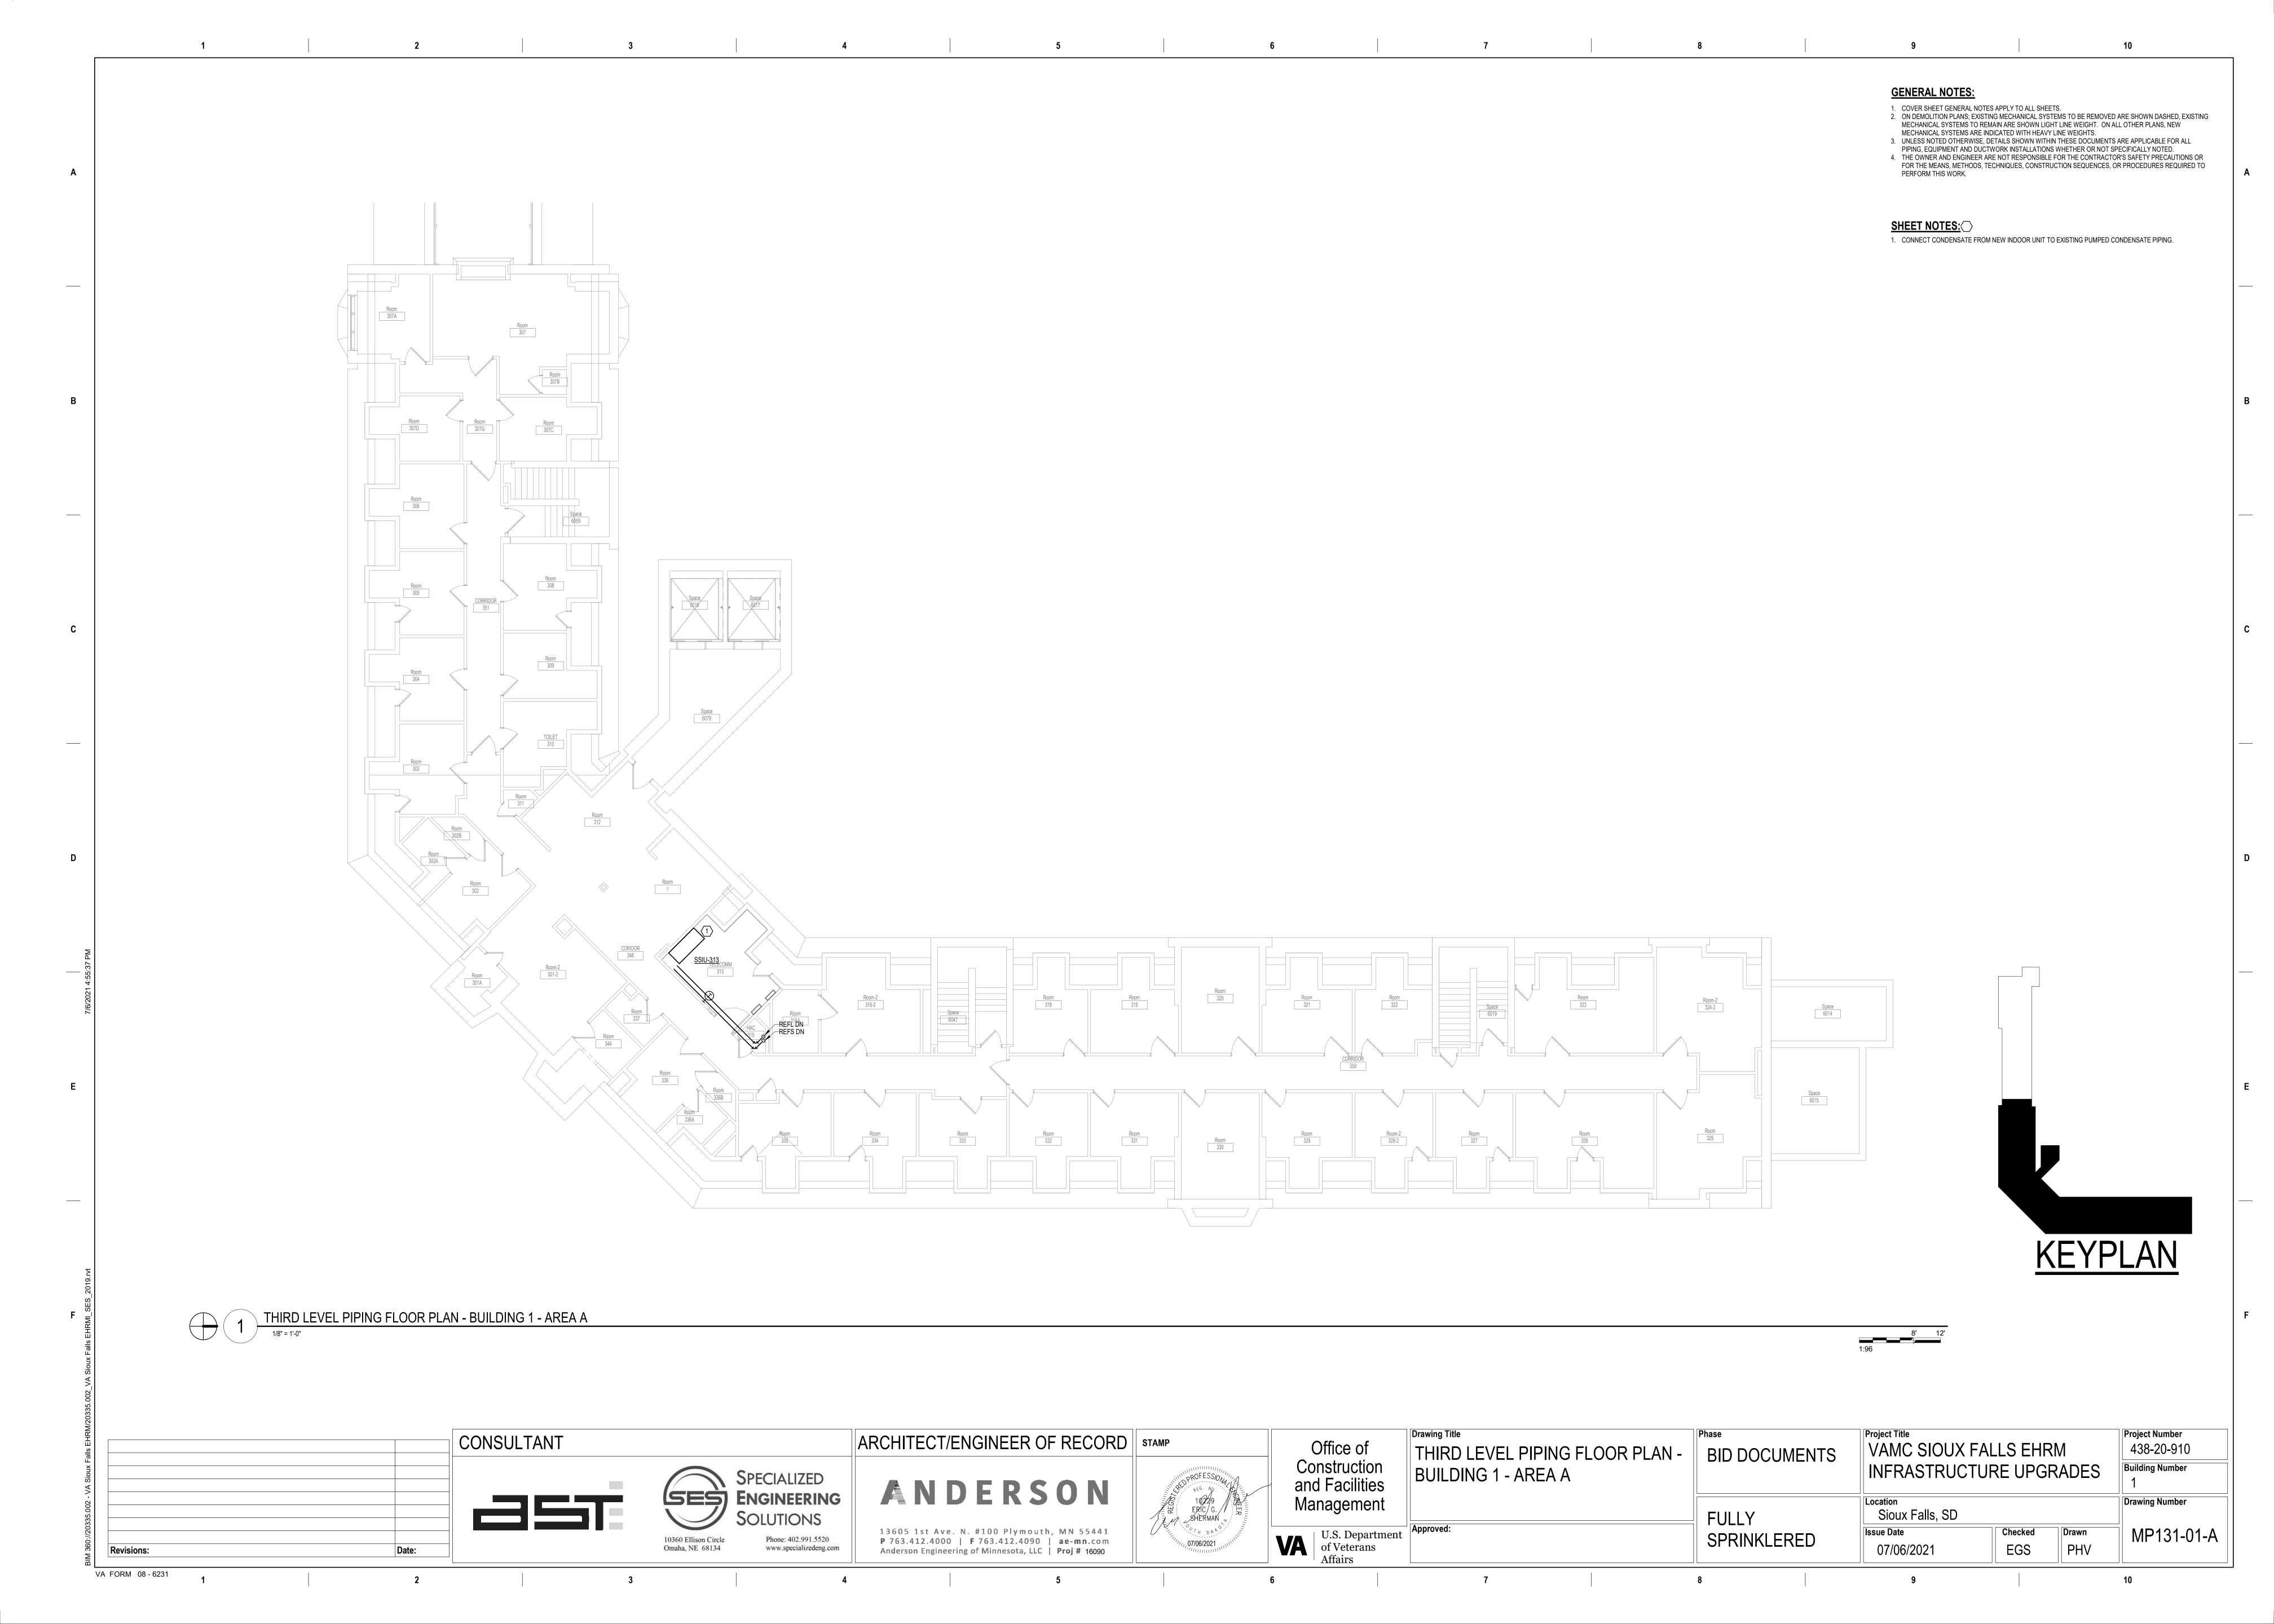


SHEET NOTES: AREA IS RECENTLY RENOVATED AND FED FROM ROOM 122A. NO RECABLING IS ANTICIPATED IN THIS AREA.
 RECABLE ALL CAT 5E AND LOWER CABLES TO ROOM 313.
 EXIT STAIR ENCLOSURE. DO NOT ROUTE NEW CABLING THROUGH THIS SPACE.
 ROUTE NEW CABLING IN EXISTING CABLE TRAY IN THIS AREA. THIRD LEVEL ELECTRICAL FLOOR PLAN - BUILDING 1 - OVERALL

1/16" = 1'-0" KEYPLAN Drawing Title Project Title Project Number CONSULTANT ARCHITECT/ENGINEER OF RECORD | STAMP Office of VAMC SIOUX FALLS EHRM 438-20-910 THIRD LEVEL OVERALL FLOOR **BID DOCUMENTS** Construction and Facilities **Building Number** INFRASTRUCTURE UPGRADES PLAN - BUILDING 1 SPECIALIZED ENGINEERING Bicsi ANDERSON Management Drawing Number Location Sioux Falls, SD **FULLY** 5 BICSI ID # 346555 13605 1st Ave. N. #100 Plymouth, MN 55441

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1 THIRD LEVEL ELECTRICAL DEMOLITION - BUILDING 1 - AREA A - ROOM 313

CABLING NOTES:

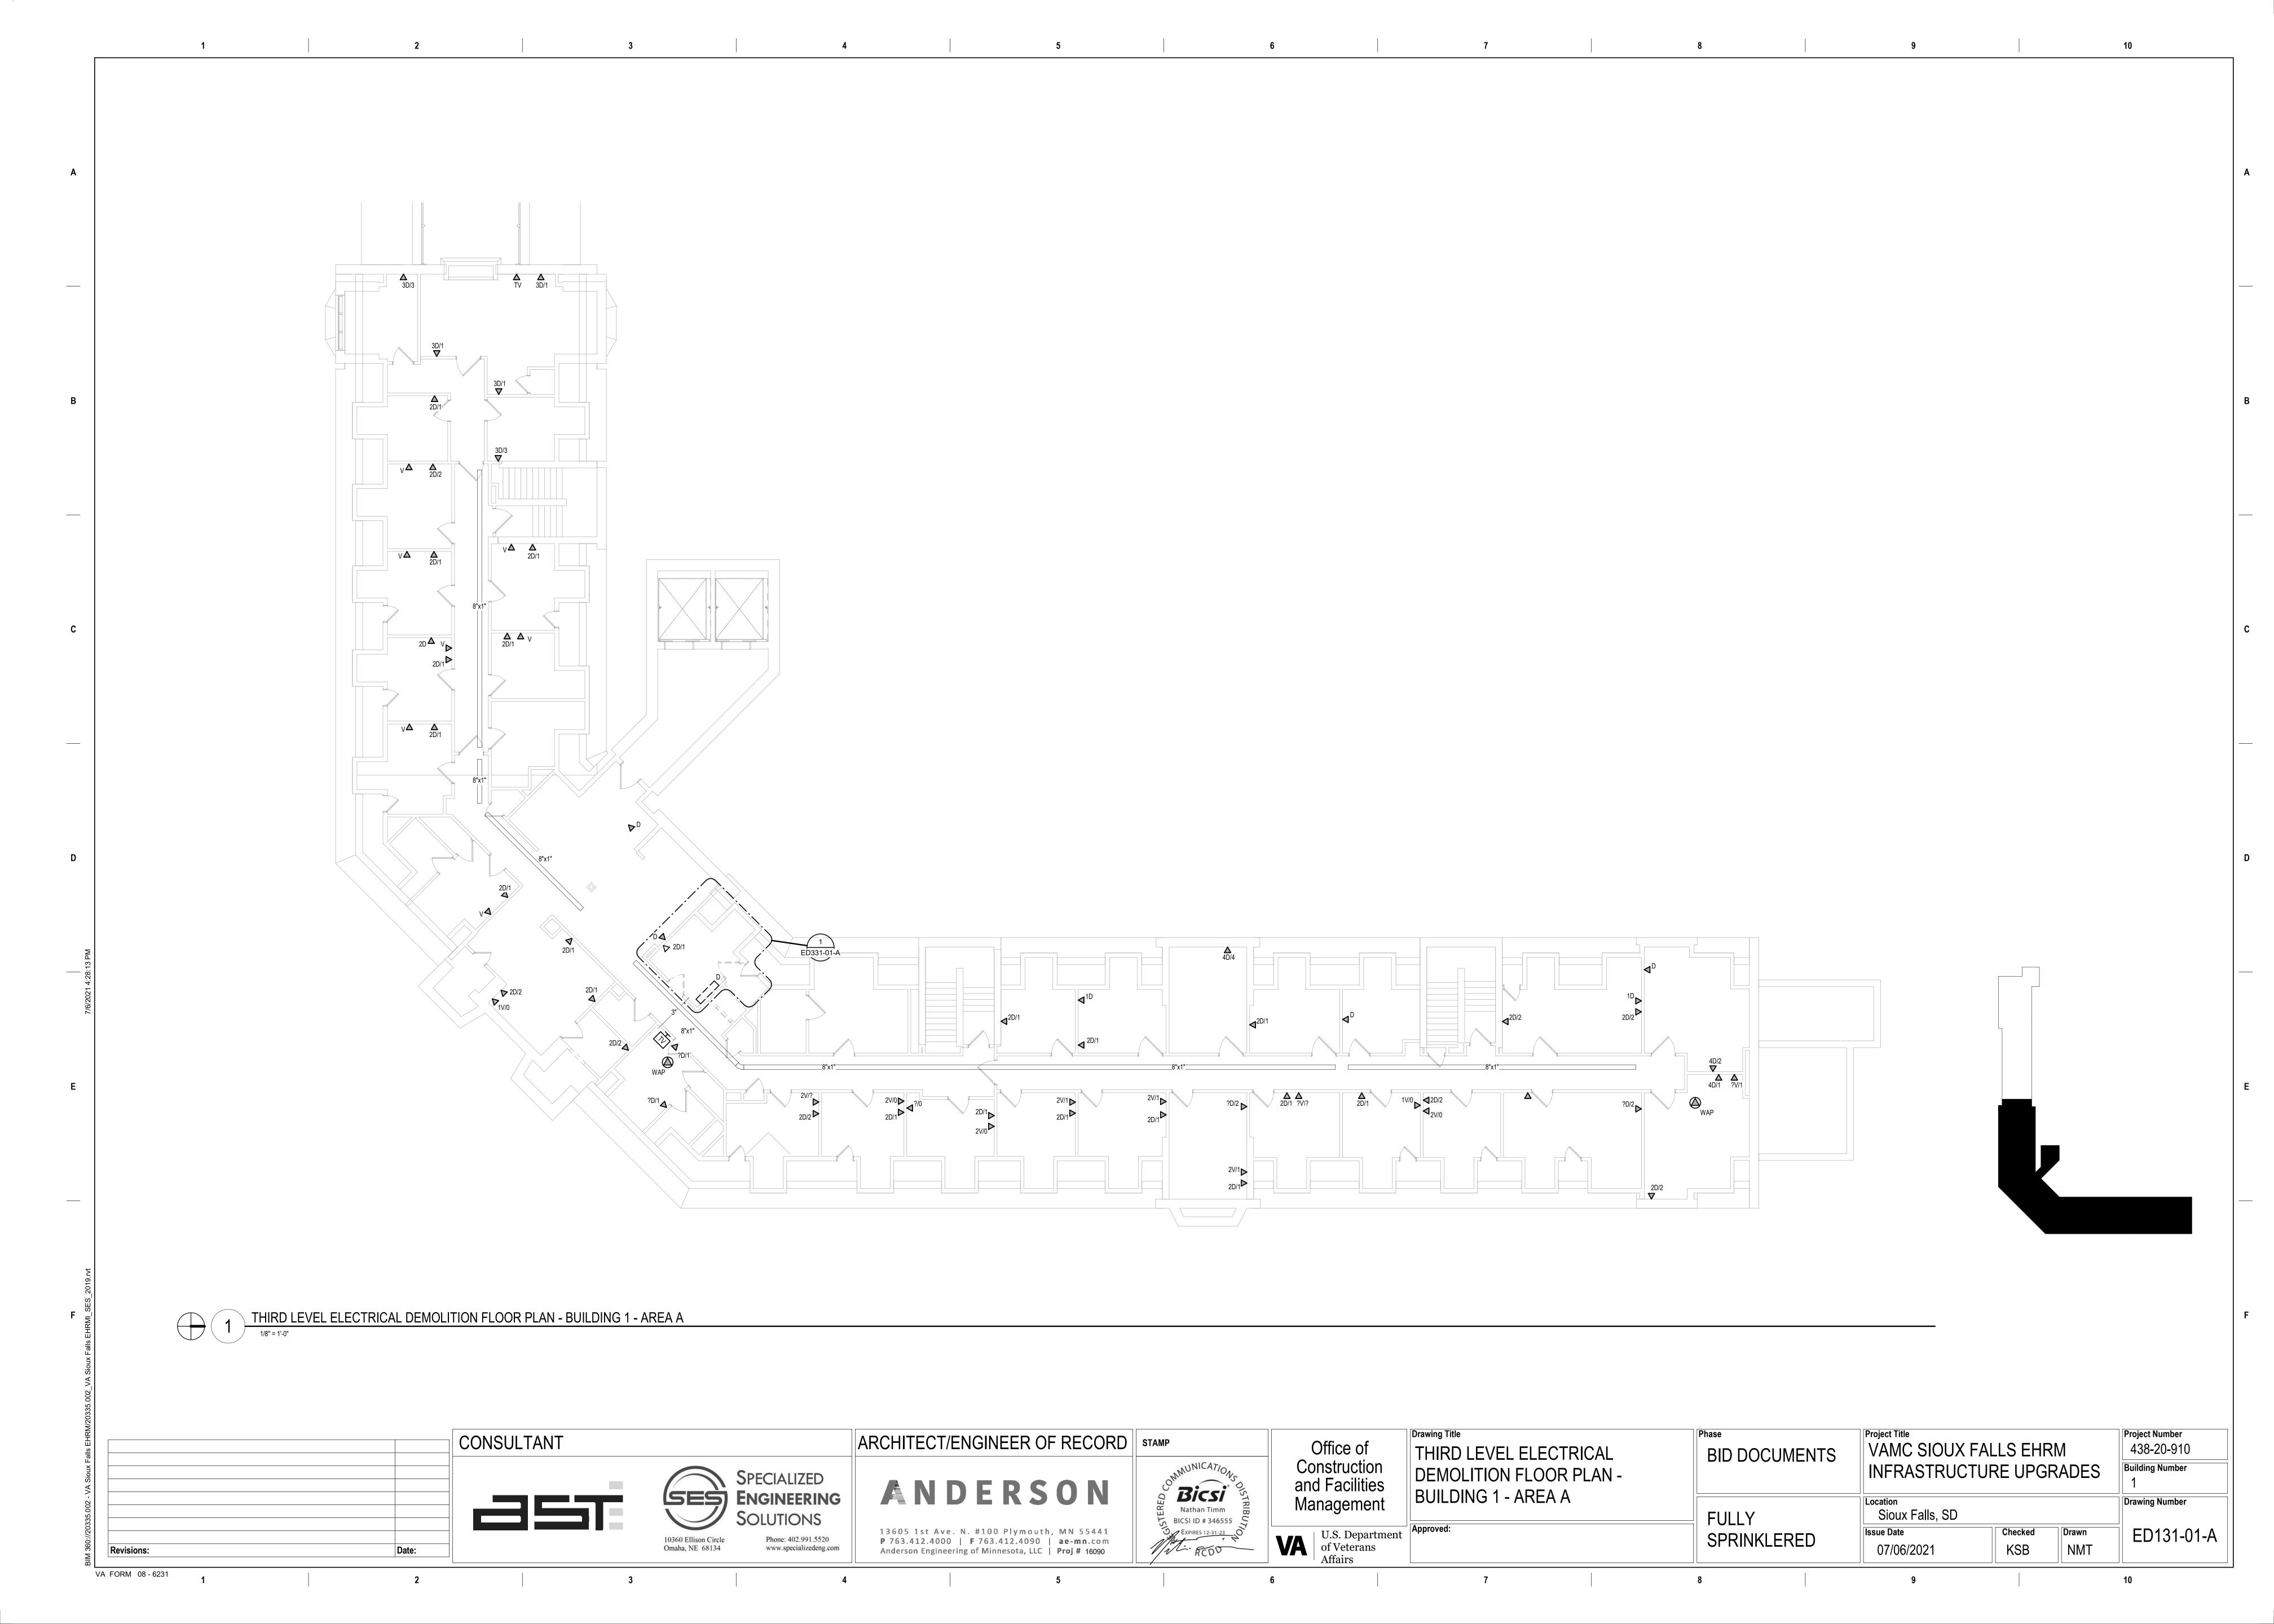- A. THE EXISTING CABLE COUNT ARE THE CABLES CURRENTLY PRESENT IN THE SPACE. THE CABLE RELOCATION COUNT ARE THE NEW OR RELOCATED CABLES TO BE FED FROM THE SPACE. THE FINAL CABLE COUNT ARE THE CABLES THAT WILL BE PRESENT IN THE SPACE AT THE COMPLETION OF THE PROJECT. REMOVE ALL UNUSED CABLING AT THE COMPLETION OF THE PROJECT.
- 1. ROOM 313

EXISTING CABLE COUNT DATA (CAT6): 76

DATA (CAT5): 144

PATIENT MONITORING: 0 COMMERCIAL WIRELESS: 0

CABLE RELOCATION COUNT DATA (CAT6): 0 DATA (CAT5): 0

PATIENT MONITORING: 0 COMMERCIAL WIRELESS: 0

EXISTING CABLE TO REMAIN DATA (CAT6): 76

VIDEO: 24 PATIENT MONITORING: 0

COMMERCIAL WIRELESS: 0

FINAL CABLE COUNT DATA (CAT6): 76 DATA (CAT6A): 144

VIDEO: 24 PATIENT MONITORING: 0 COMMERCIAL WIRELESS: 0

SHEET NOTES:

- 1. EXISTING TELEPHONE WALL FIELD TO BE DEMOLISHED. NEW COPPER BACKBONE TO BE PROVIDED ON PATCH PANELS IN TELECOMMUNICATIONS RACK. REFER TO CABLING NOTES AND NEW WORK PLANS FOR
- ADDITIONAL REQUIREMENTS. 2. EXISTING FIBER ENCLOSURE TO BE DEMOLISHED. NEW FIBER BACKBONE TO BE TERMINATED IN NEW TELECOMMUNICATIONS RACK. REFER TO CABLING NOTES AND NEW WORK PLANS FOR ADDITIONAL

CONSULTANT Revisions:

VA FORM 08 - 6231

SPECIALIZED SES ENGINEERING 10360 Ellison Circle Omaha, NE 68134

Phone: 402.991.5520

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Anderson Engineering of Minnesota, LLC | Proj # 16090 EXPIRES 12-31-23 NOT

Office of Construction and Facilities Management

U.S. Department of Veterans Affairs

Drawing Title

DEMOLITION - BUILDING 1 -ENLARGED ROOMS - AREA A

THIRD LEVEL ELECTRICAL

Project Title VAMC SIOUX FALLS EHRM **BID DOCUMENTS** INFRASTRUCTURE UPGRADES


Sioux Falls, SD **FULLY** SPRINKLERED


Drawing Number Checked Drawn ED331-01-A KSB 07/06/2021 NMT

Project Number

Building Number

438-20-910

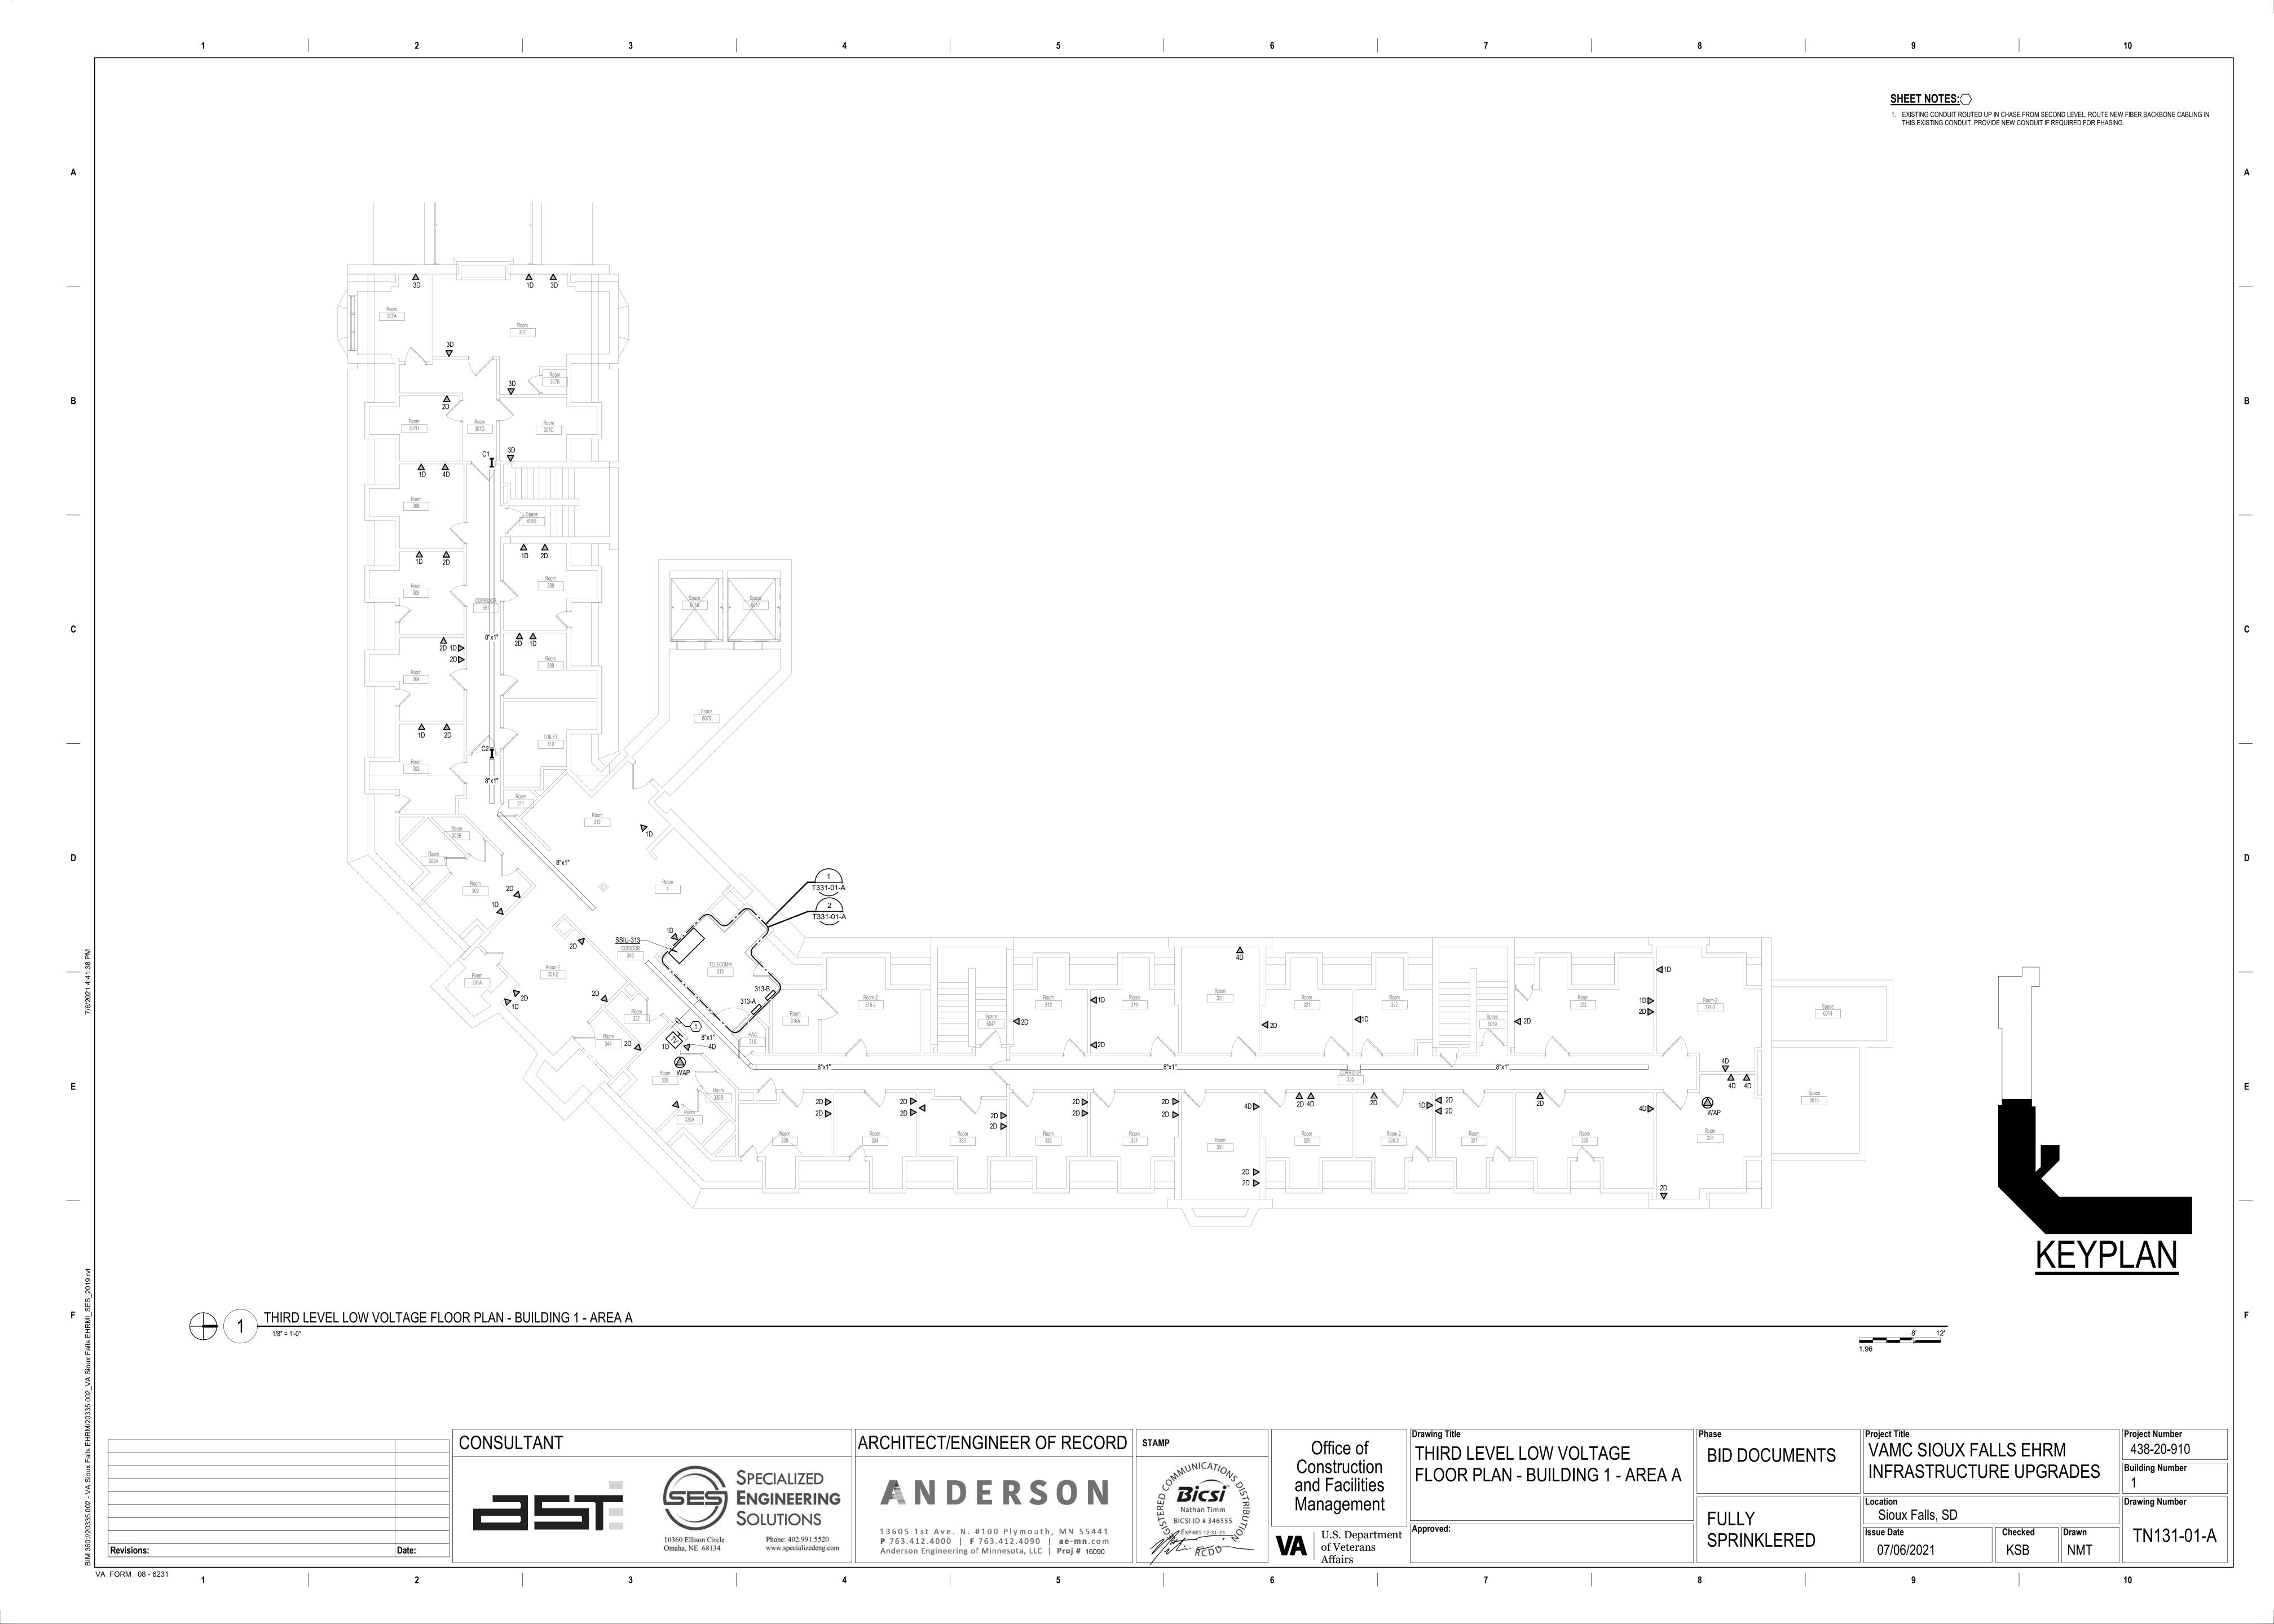

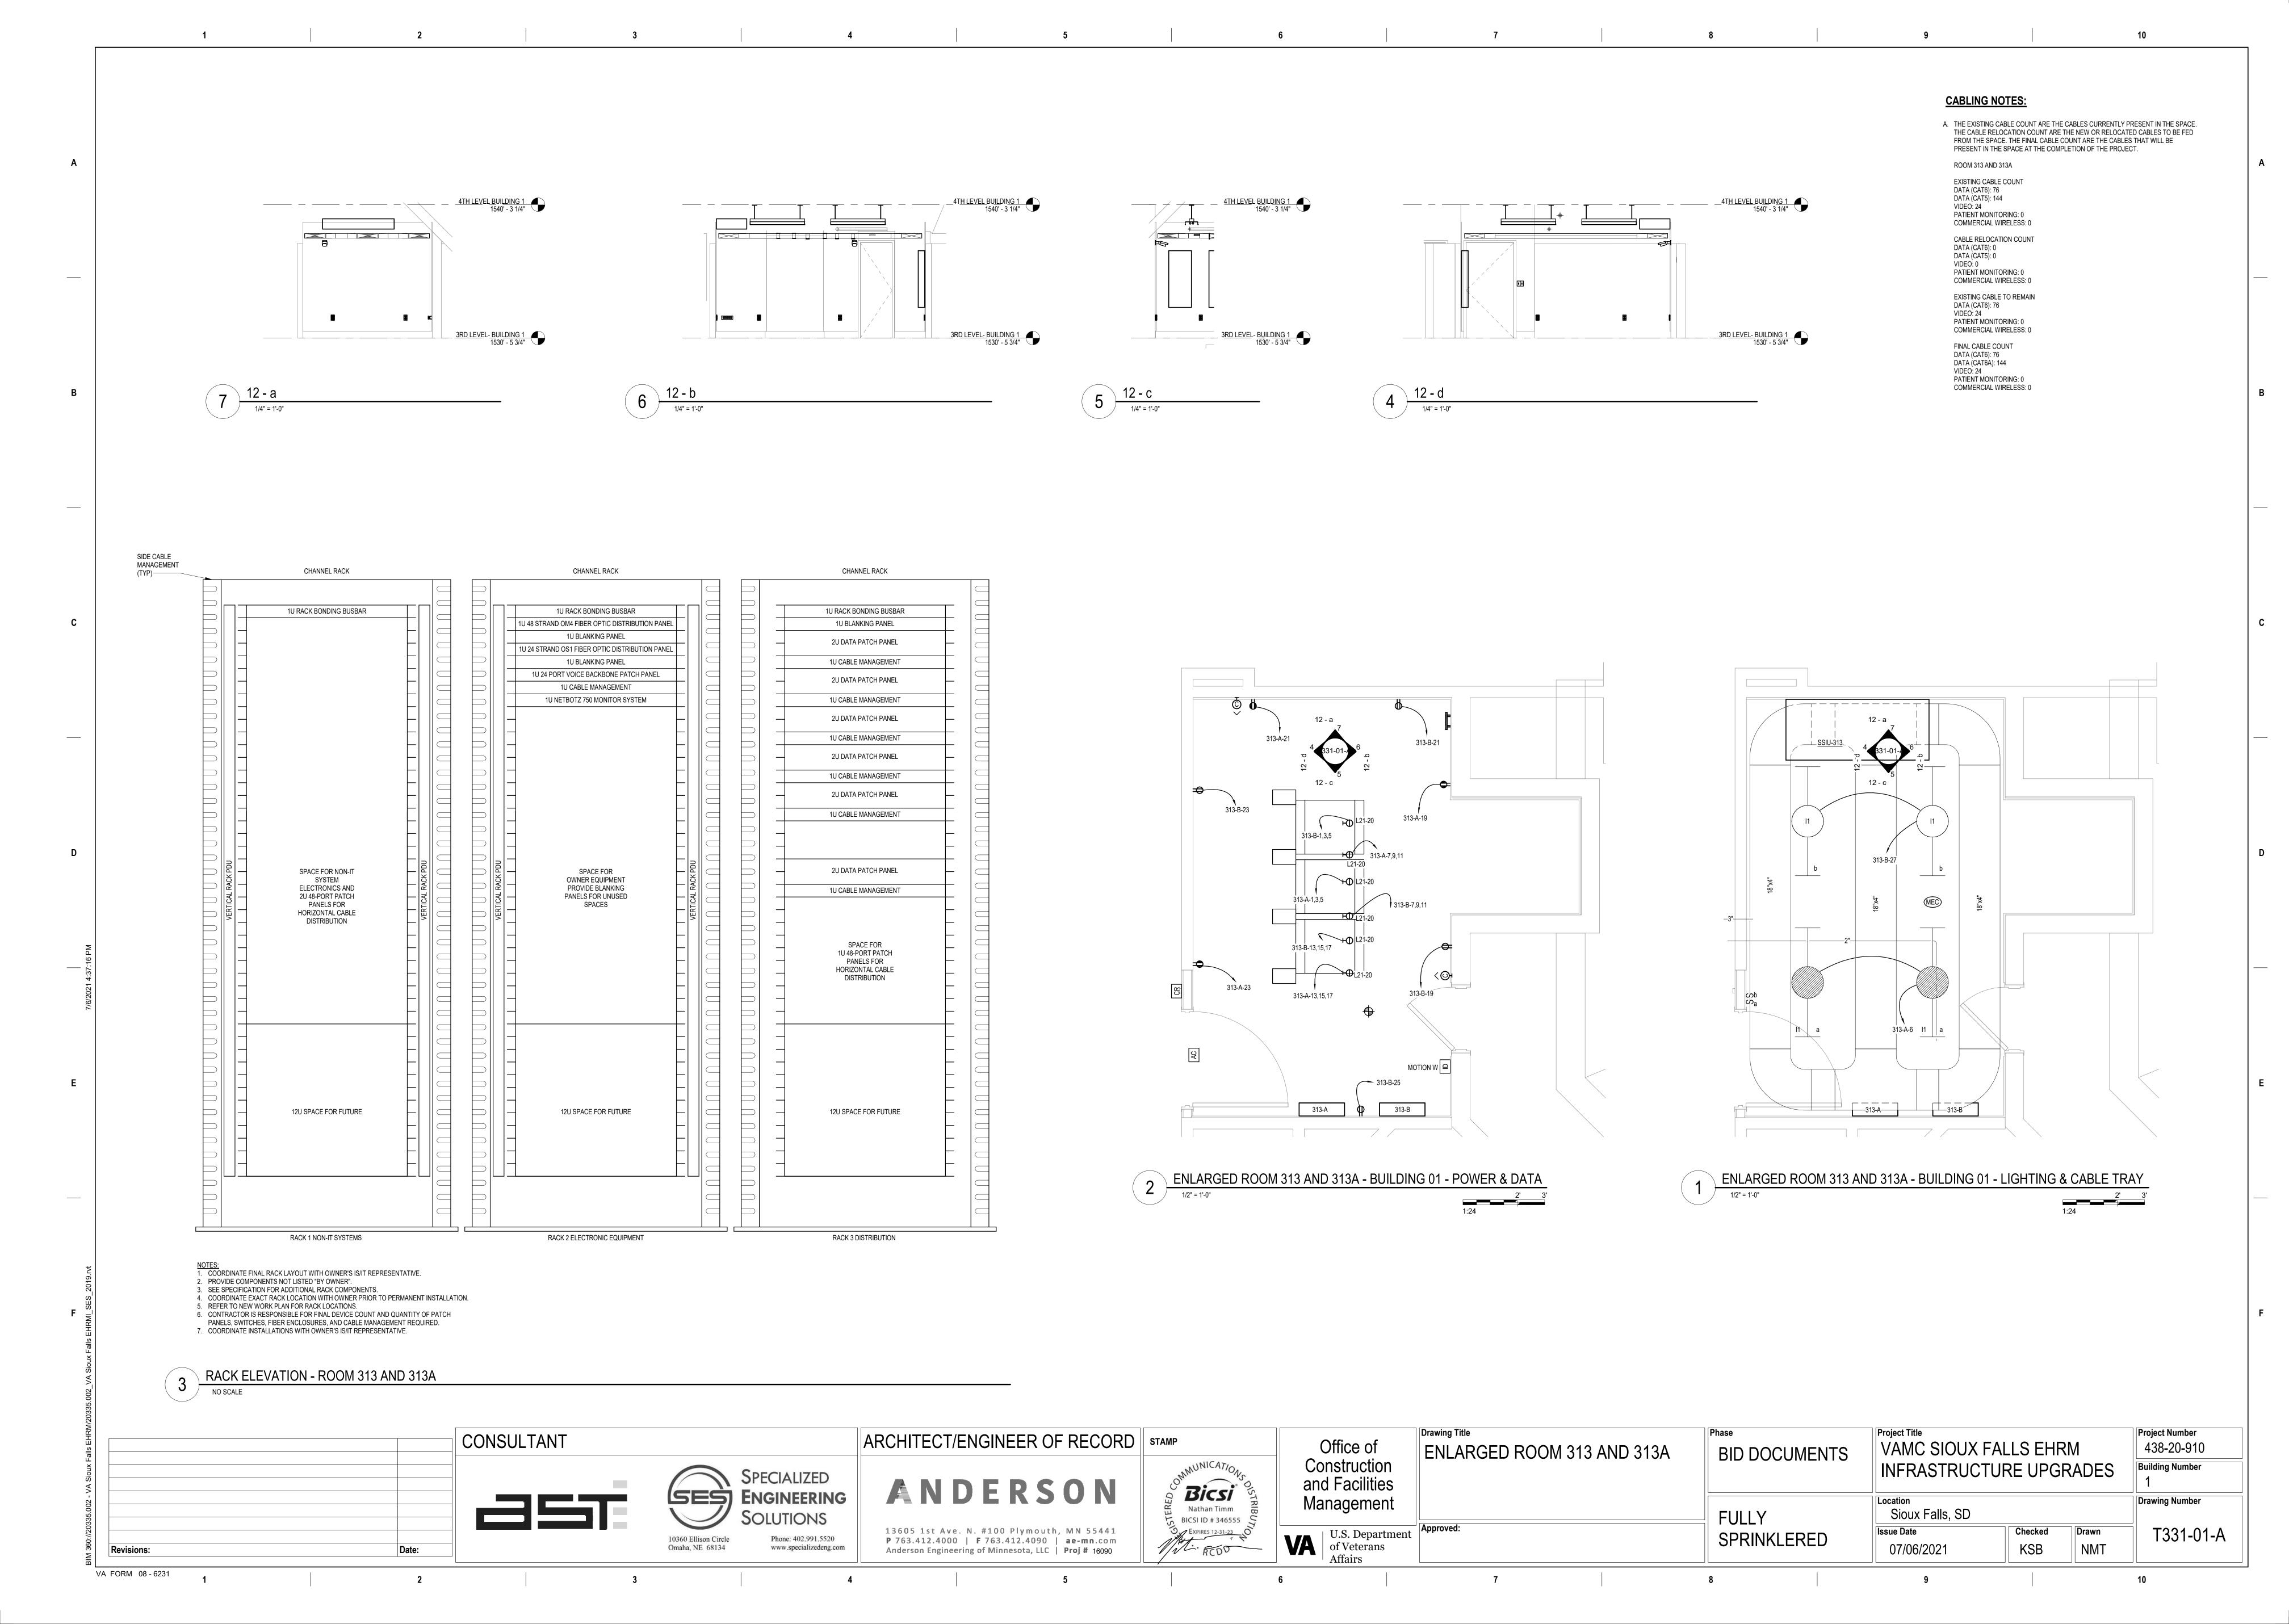

LIGHTING PANEL: 313-B LOCATION: TELECOMM 313 MAINS TYPE: MCB **VOLTS**: 208/120 WYE SUPPLY FROM: B2 PHASES: 3 MCB/MLO RATING: 100 A **BRANCH: NORMAL** WIRES: 4 MCB OPTIONS: NONE **SERVICE RATED**: No INTEGRAL SPD: Yes SECTIONS: 1 **MOUNTING:** SURFACE AVAILABLE SCC (kA): 1.0 PANEL POLES: 42 **NEMA ENCLOSURE**: 1 CIRCUIT DESCRIPTION OPT RATI... POL... B C POL... RATI... OPT CIRCUIT DESCRIPTION PWR-C TELECOMM 313 - RACK 20 A 3 1922 VA PWR-C TELECOMM 313 - RACK RECEPTACLE PWR-C TELECOMM 313 - RACK 20 A 3 1922 VA RECEPTACLE 19 REC TELECOMM 313-313A 20 A 1 21 REC TELECOMM 313-313A 180 VA 23 REC TELECOMM 313-313A 20 A 1 180 VA 25 REC TELECOMM 313-313A 20 A | 1 | 180 VA | 20 A 1 27 LTG TELECOMM-2 313-313A 29 SPARE 20 A 1 20 A 1 0 VA 33 SPARE 20 A 1 35 SPARE -- 20 A 1 39 SPARE 20 A 3 0 VA 0 VA **TOTAL LOAD:** 6125 VA 5995 VA TOTAL AMPS: 51 A 50 A LOAD CLASSIFICATION CONNECTED LOAD | DEMAND FACTOR | ESTIMATED DEMAND PANEL TOTALS 50 VA 125.00% 62 VA CONNECTED LOAD: 18065 VA CONNECTED CURRENT: 50 A 100.00% 720 VA 17295 VA 78.91% 13648 VA **DEMAND LOAD:** 14429 VA **DEMAND CURRENT:** 40 A **CONSIDER 125% DEMAND:** 18037 A EQUIPMENT AMPS: 100 A FEEDER AVAILABLE: SPARE CAPACITY: 60 A CIRCUIT BREAKER OPTIONS SUFFIX: 'S' OR 'ST' - PROVIDE SHUNT TRIP CIRCUIT BREAKER / 'G' OR 'GFCI' - PROVIDE GFCI CIRCUIT BREAKER / 'GFP' - PROVIDE GFP CIRCUIT BREAKER / 'ERMS' - ENERGY REDUCING MAINTENANCE SWITCH / 'ZSI' - ZONE SELECTIVE INTERLOCKING / 'L' - PROVIDE CIRCUIT BREAKER WITH LOCKING PROVISIONS / 'R' - PROVIDE CIRCUIT BREAKER WITH RED MARKING A. PANEL AIC (INTERRUPTING) RATING SHALL BE MINIMUM 120% OF THE AVAILABLE SCC (SHORT CIRCUIT CURRENT).

LIGHTING PANEL: 313-A LOCATION: TELECOMM 313 SUPPLY FROM: A2 BRANCH: CRITICAL SERVICE RATED: No MOUNTING: SURFACE NEMA ENCLOSURE: 1			VOLTS: 208/120 WYE PHASES: 3 WIRES: 4 INTEGRAL SPD: Yes AVAILABLE SCC (kA): 1.0						MAINS TYPE: MCB MCB/MLO RATING: 100 A MCB OPTIONS: NONE SECTIONS: 1 PANEL POLES: 42							
C	CIRCUIT DESCRIPTION	ОРТ	RATI	POL		A	В	<u> </u>		.	POL	RATI	ОРТ	CIRC	UIT DESCRIPTION	(
1	PWR-C TELECOMM 313 - RACK				1922	1488 VA					2	30 A		SSIU-313/SS	SOU-313	
3 5	RECEPTACLE		20 A	3			1922 VA	1488 V <i>F</i>	1922 VA	50 VA	1	20 A		LTG TELEC	OMM 313-313A	
7					1922	0 VA			1922 VA	30 VA	1	20 A		SPARE	JIVIIVI 313-313A	
9	PWR-C TELECOMM 313 - RACK		20 A	3		5 VA	1922 VA	0 VA			1	20 A		SPARE		
11	RECEPTACLE		-0,,				==		1922 VA	0 VA	1	20 A		SPARE		
13	DIMP O TELECOMMONS SACIO				1922	0 VA					1	20 A		SPARE		
15	PWR-C TELECOMM 313 - RACK RECEPTACLE		20 A	3			1922 VA	0 VA			1	20 A		SPARE		
17									1922 VA	0 VA						
	REC TELECOMM 313-313A		20 A	1	180 VA	0 VA					3	20 A		SPARE		:
	REC TELECOMM 313-313A		20 A	1			180 VA	0 VA	400.1/4							- :
23 25	REC TELECOMM 313-313A	-	20 A	1					180 VA							
25 27		+									-					
<u>27</u> 29																
31																'
33																
35																;
37																;
39																
41																
			TOTAL TOTAL		7433 64		7433 64		5998 50							
.OA	D CLASSIFICATION		СО	NNECT	ED LOAD	DEN	MAND FAC	TOR	ESTIMAT	ED DEM	AND			PANEL T	TOTALS	
TG				50 \	/A		125.00%		6	2 VA		С	ONNE	CTED LOAD:	20860 VA	
REC				540	VA		100.00%		54	10 VA		CONN	IECTE	CURRENT:	58 A	
/ITR				2975	VA		124.00%		36	89 VA			DEN	MAND LOAD:	17938 VA	
PWF	-NC			1729	5 VA		78.91%		136	648 VA				CURRENT:		
														% DEMAND:		
														MENT AMPS:	100 A	
												FE	EDER	AVAILABLE:	50 %	
													SPARE	: CADACITY:	50 % 50 A	
															50 A	
IRC	ONS: CUIT BREAKER OPTIONS SUFFIX: 'S CUIT BREAKER / 'ERMS' - ENERGY R VISIONS / 'R' - PROVIDE CIRCUIT	EDUCIN	G MAINT	TENANC	E SWITC											:P
	ERAL REMARKS: ANEL AIC (INTERRUPTING) RATING	CUAII D	E MININ	U IM 120	0/ OF TU	IE A\/AII	ADI E SCO	C (CHOI			DENIT)					


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VA FORM 08 - 6231

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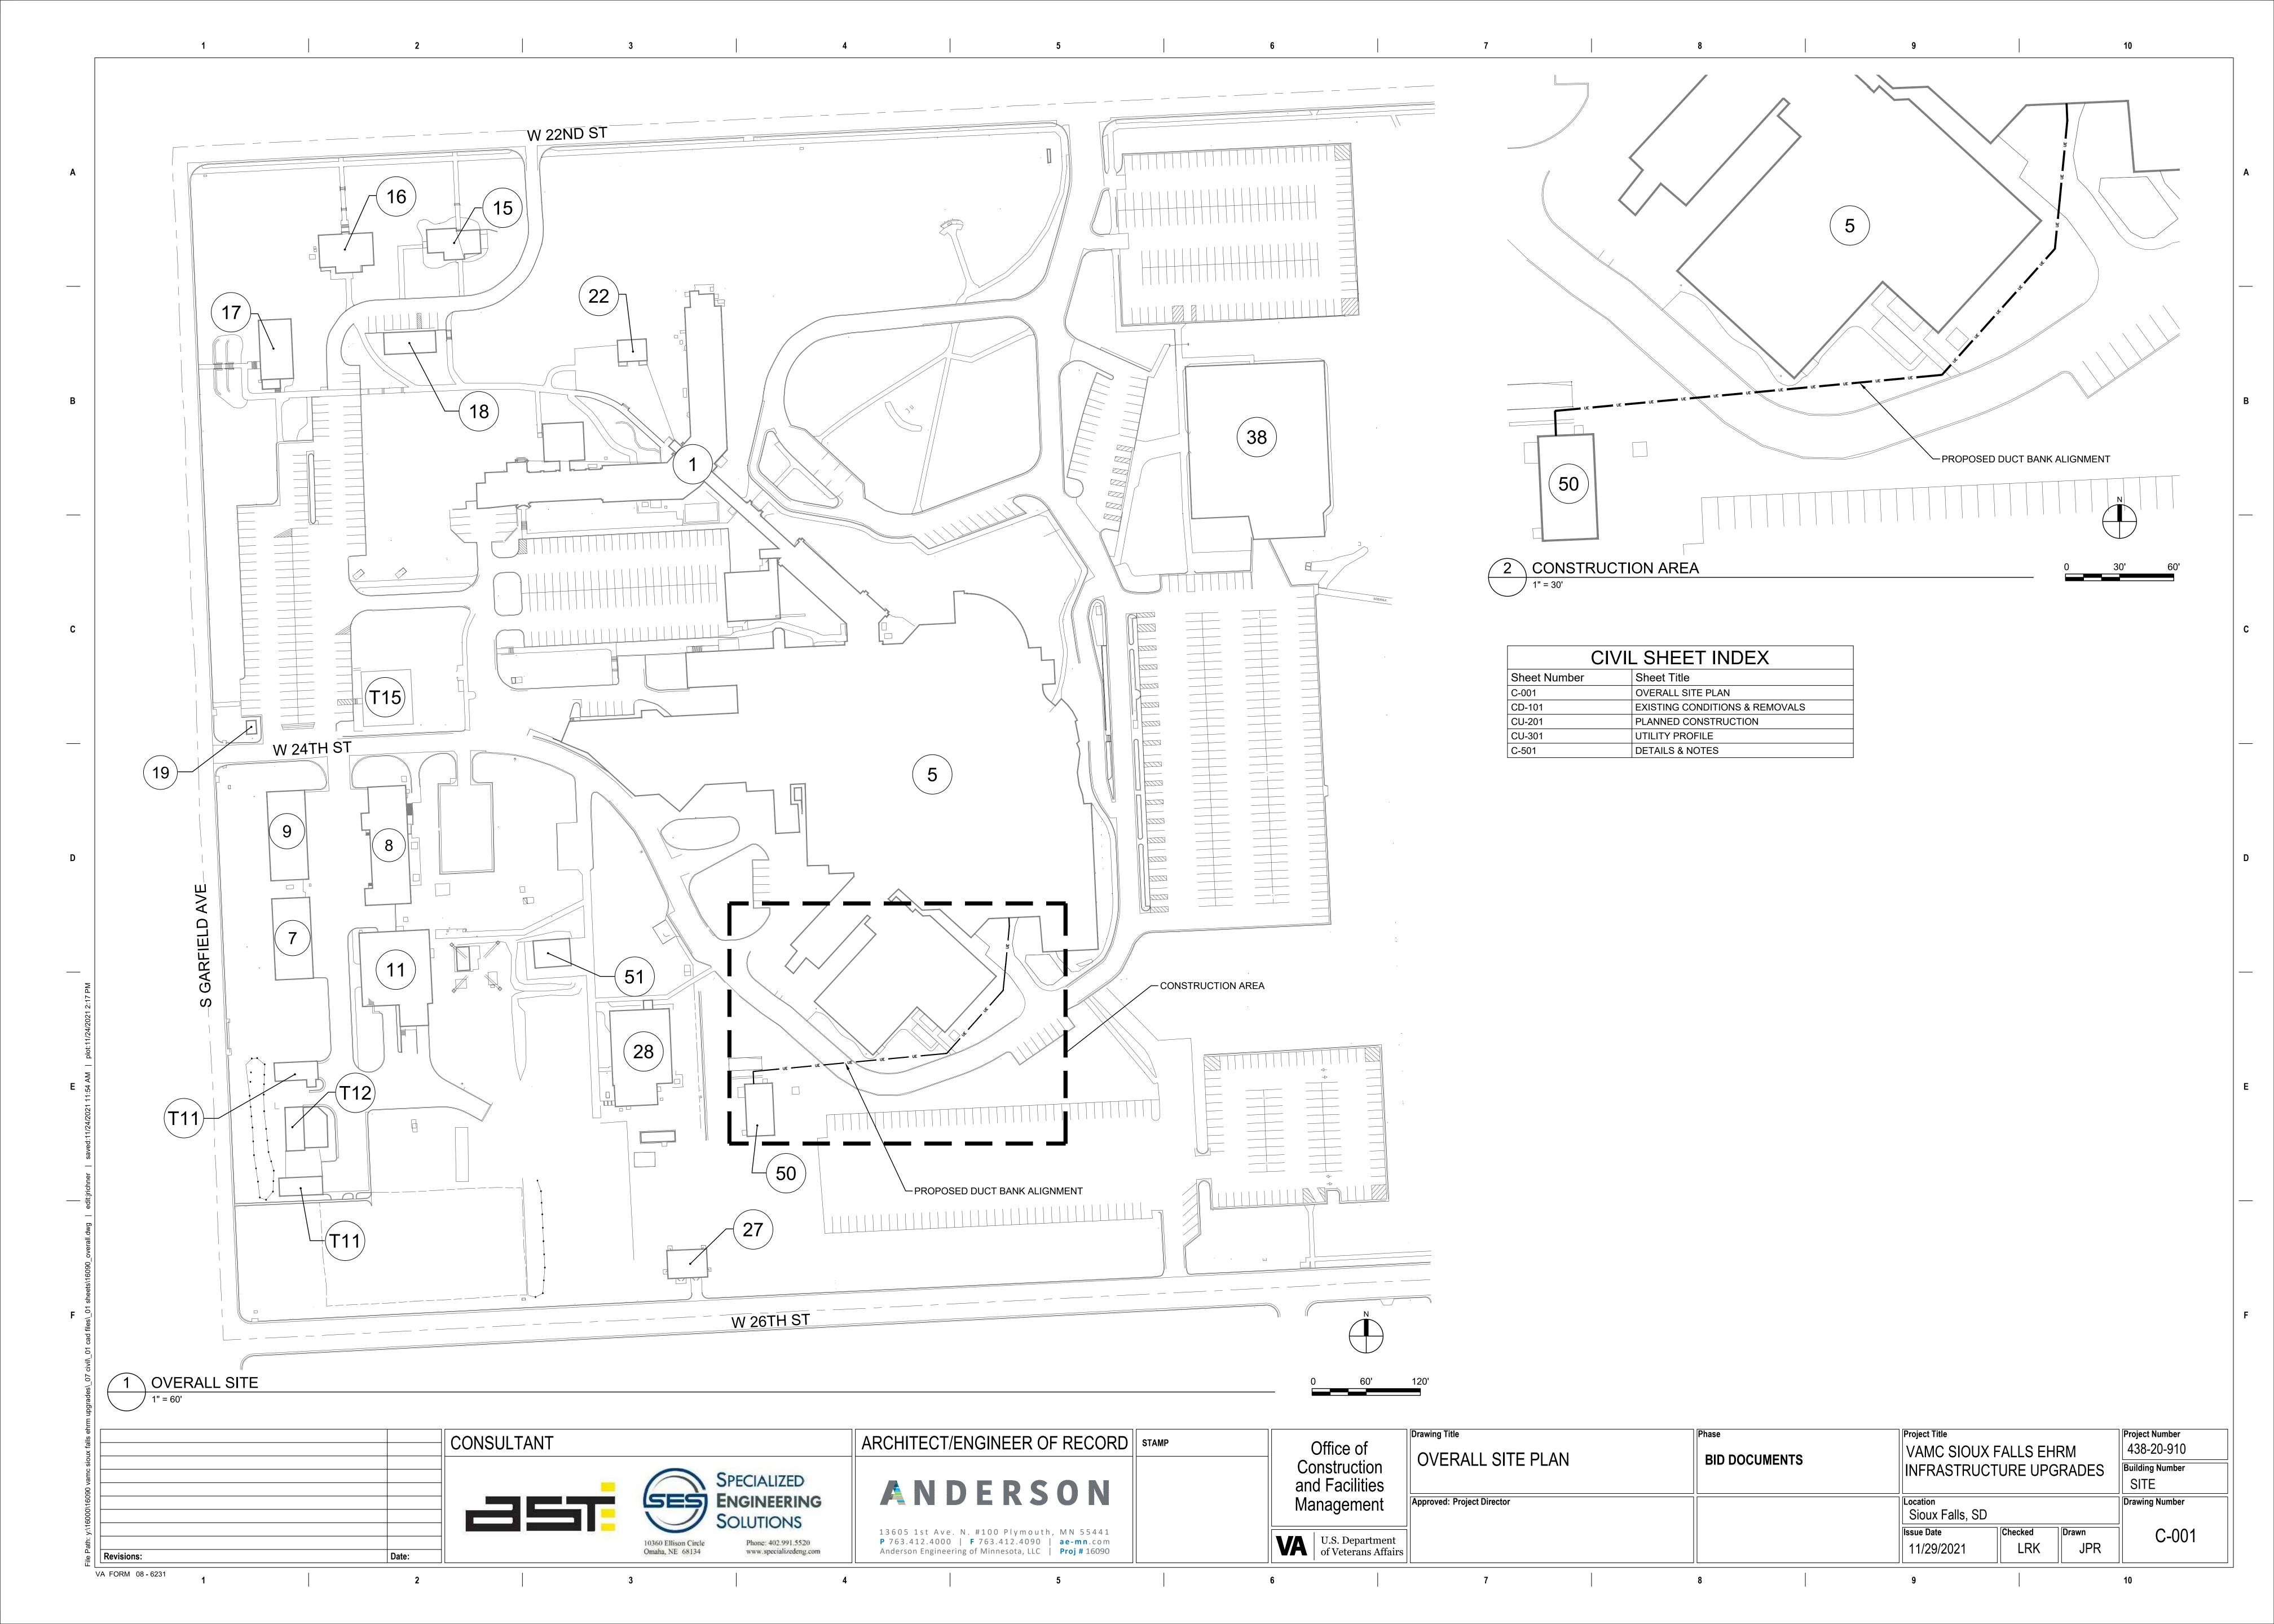



Office of Construction and Facilities Management U.S. Department of Veterans Affairs


Drawing Title PANEL SCHEDULES - BUILDING 1 -THIRD LEVEL - AREA A


Project Title Project Number VAMC SIOUX FALLS EHRM 438-20-910 **BID DOCUMENTS Building Number** INFRASTRUCTURE UPGRADES Drawing Number Location Sioux Falls, SD **FULLY** Checked Drawn EE431-01-A SPRINKLERED

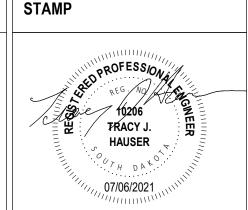
KSB 07/06/2021 NMT



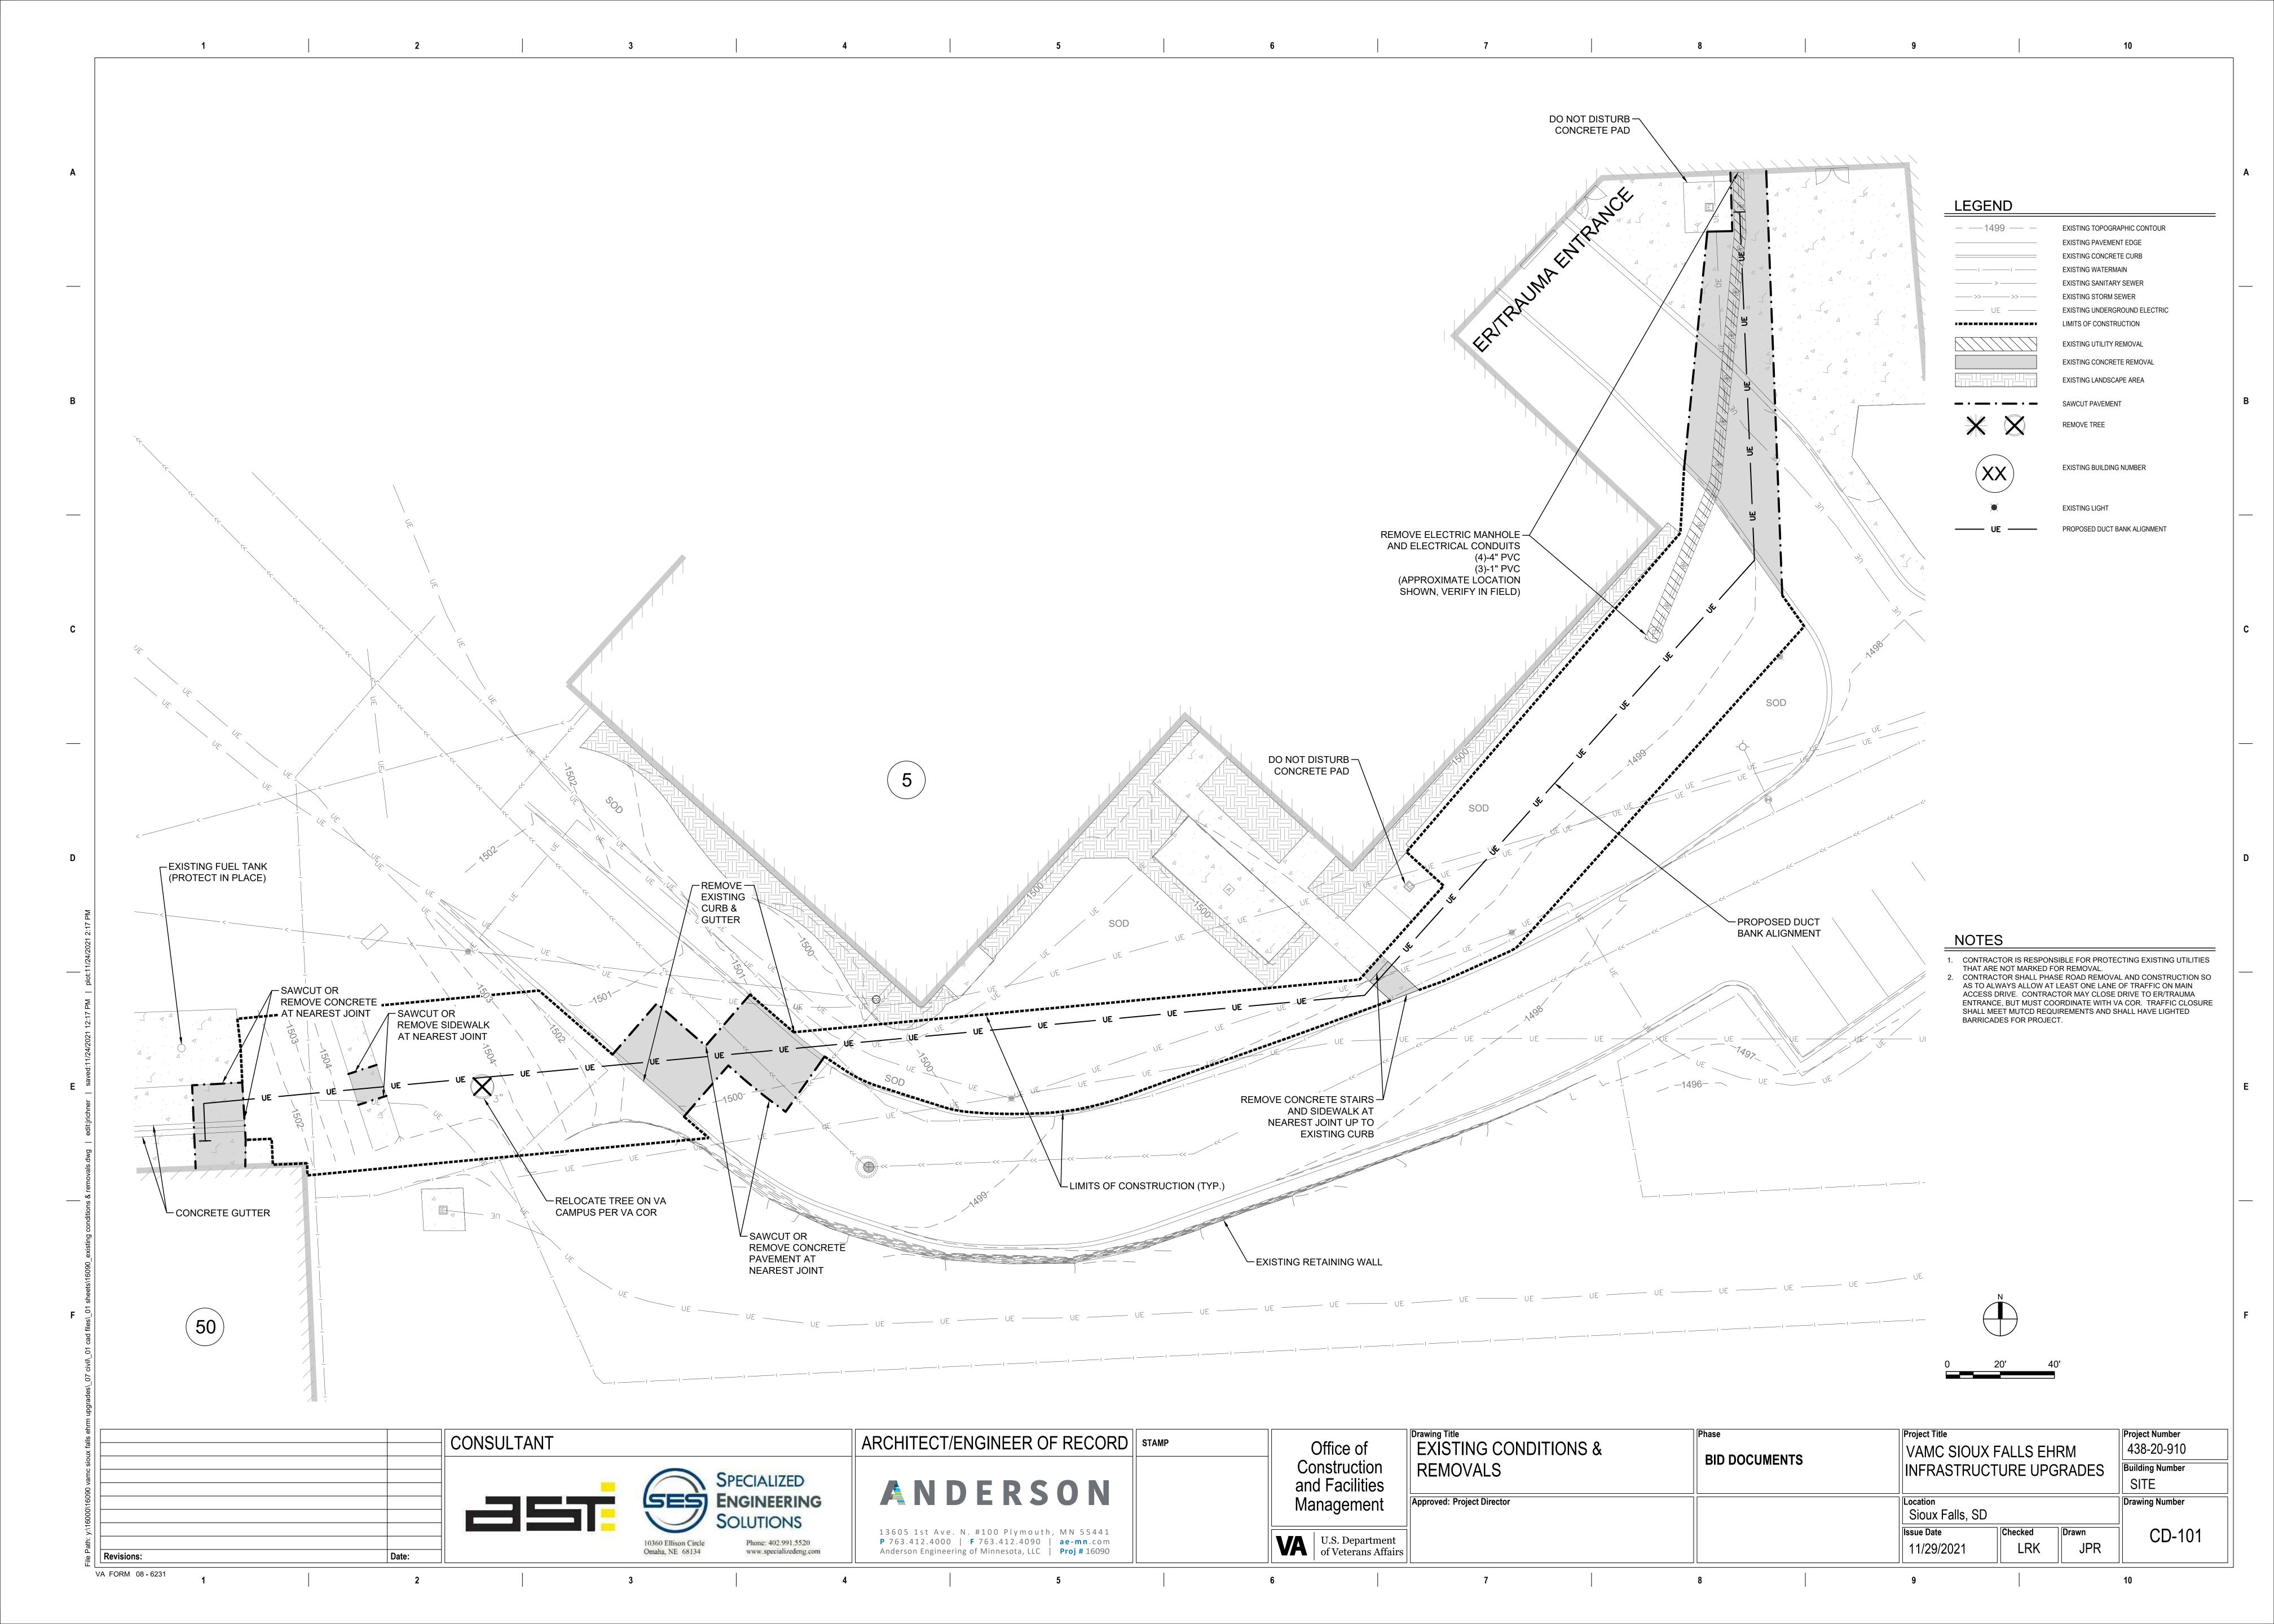

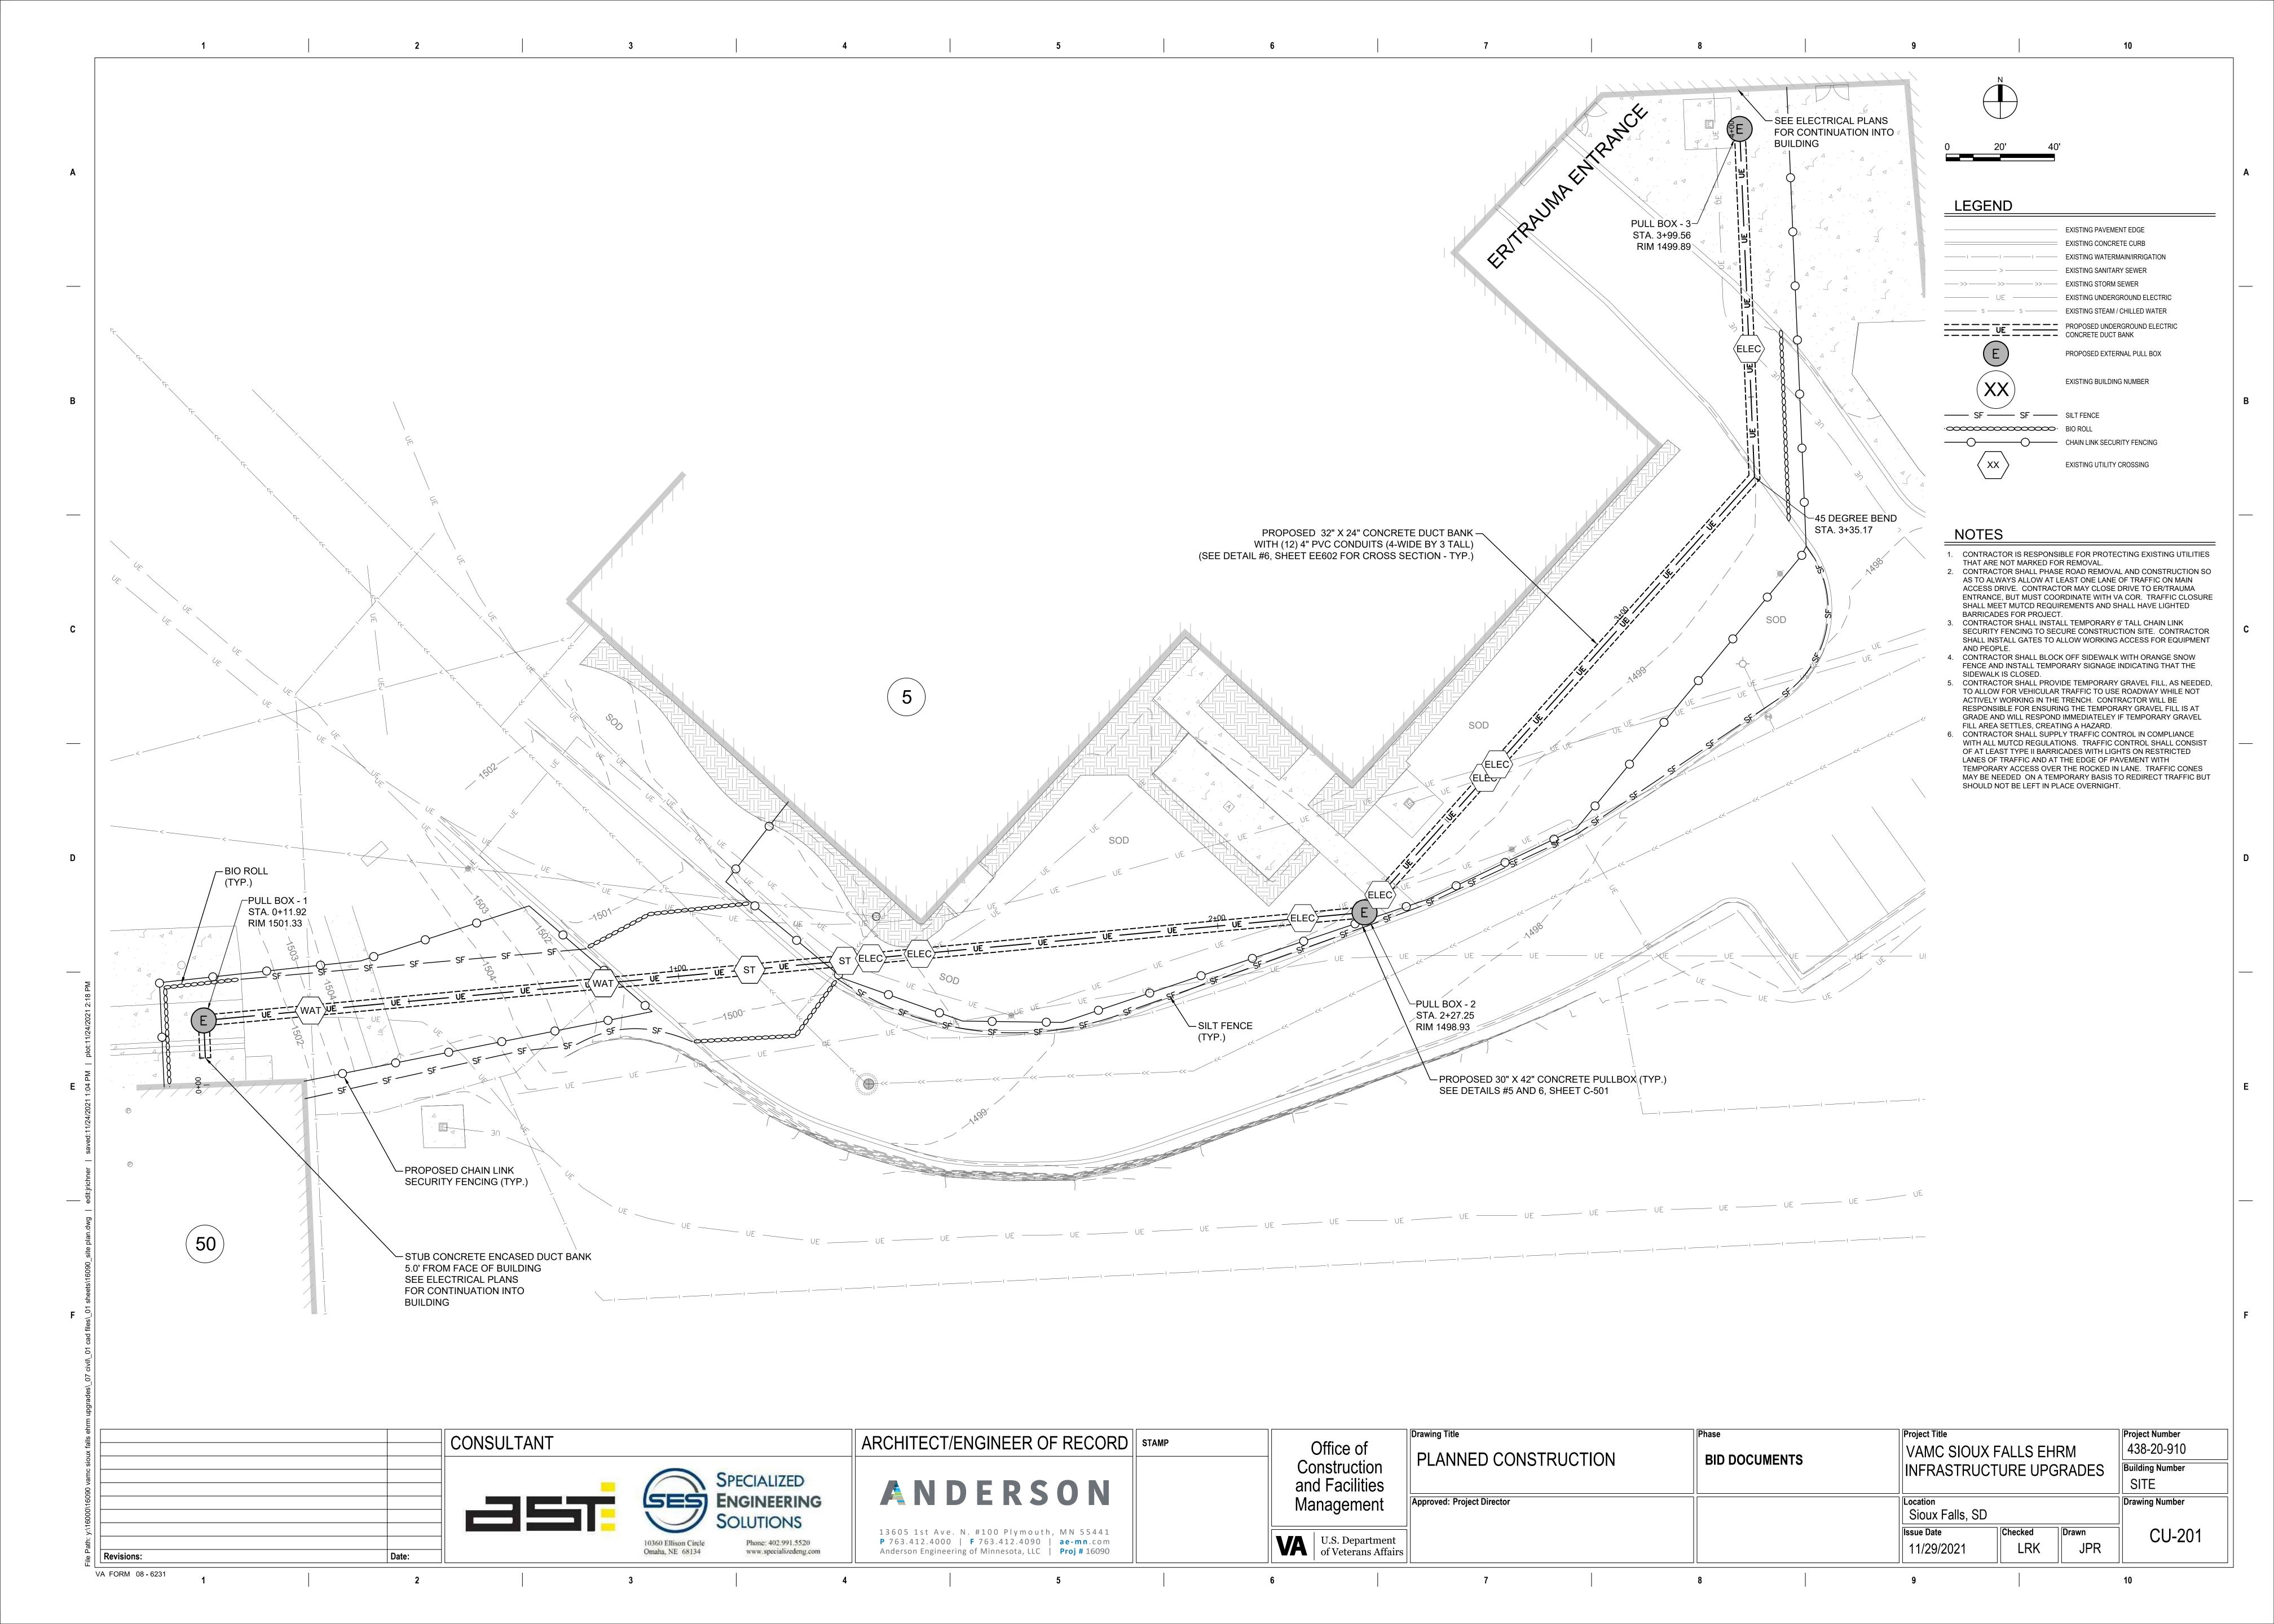

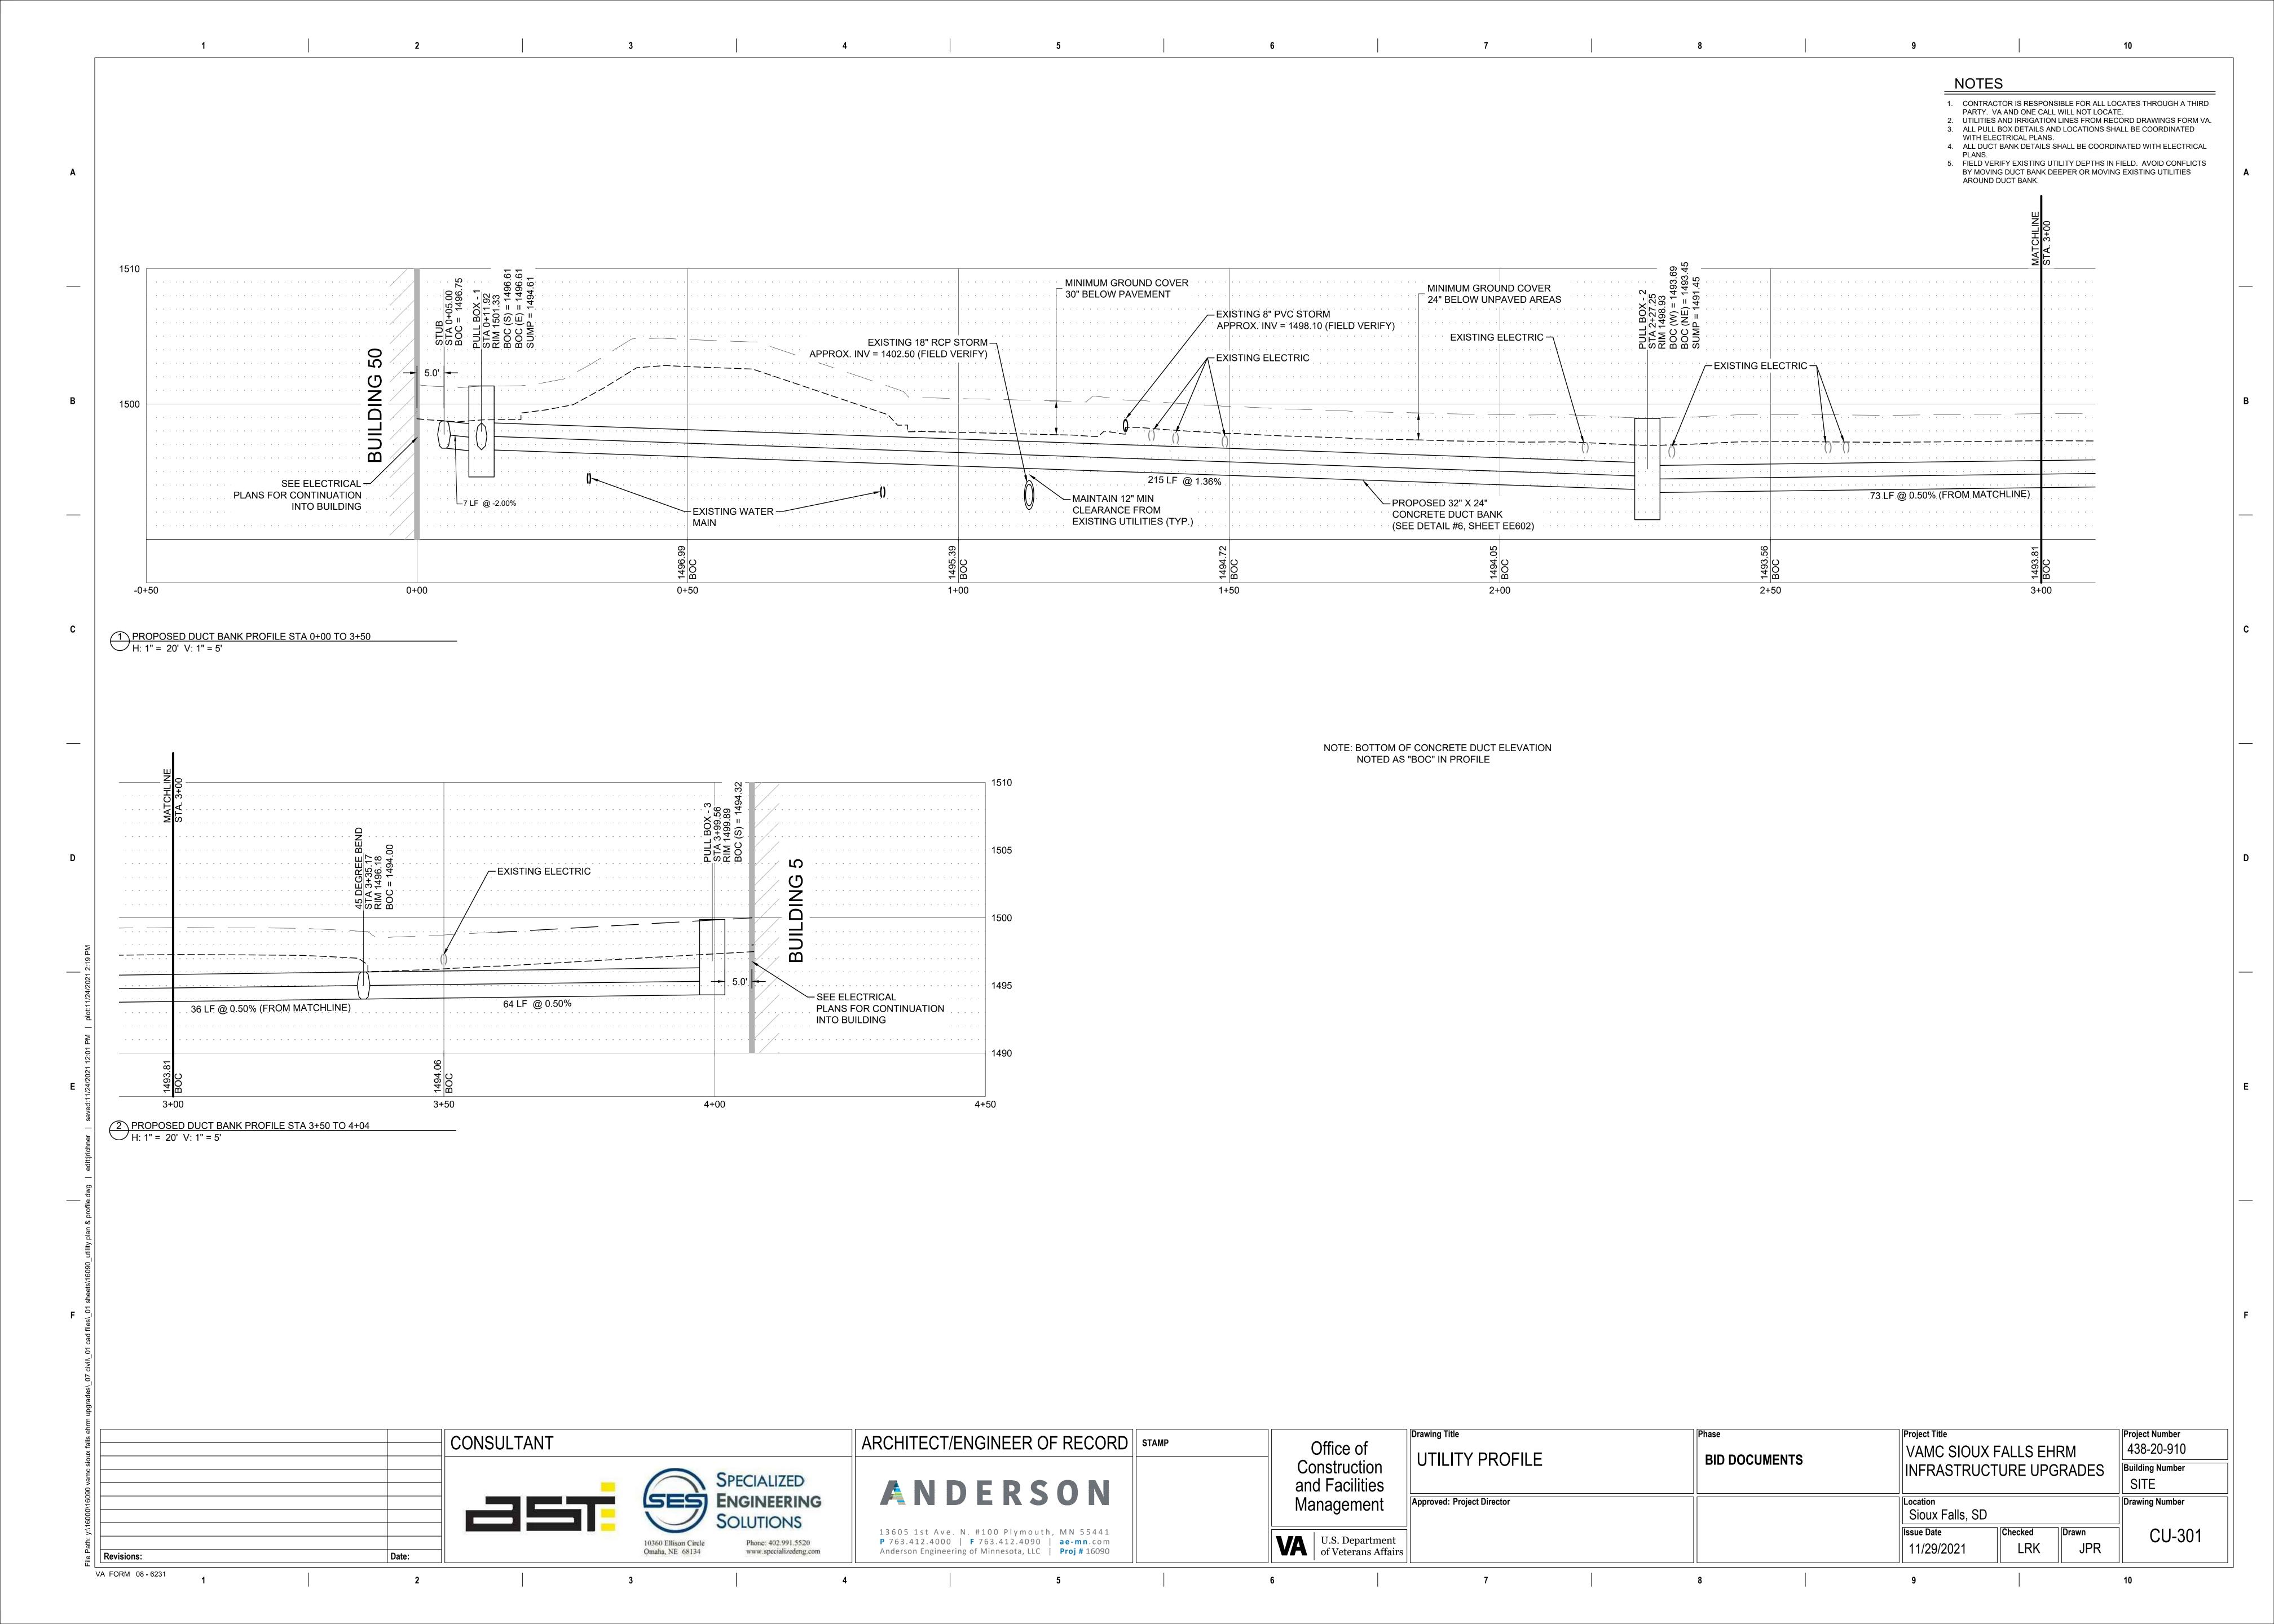

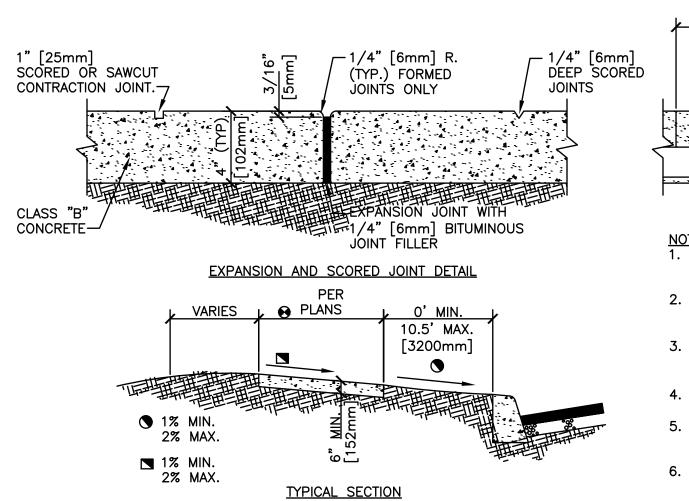

CONCRETE SIDEWALK

TACK COAT (TYP.)

PAVEMENT (TYP)-

EXISTING


Revisions:

VA FORM 08 - 6231

18288mm 18288mm] EXPANSION JOINT TO EXPANSION JOINT EXPANSION JOINT TO EXPANSION JOINT and a control of the first of the following or a control of the first of the first of the first of the first of

EXPANSION JOINTS SHALL BE LOCATED WHERE SIDEWALK ABUTS CONCRETE DRIVEWAYS, CURB OR OTHER ADJACENT STRUCTURES.

- ONE-HALF INCH BITUMINOUS JOINT FILLER SHALL BE INSTALLED AT EXPANSION JOINT LOCATIONS AND SHALL EXTEND THE FULL DEPTH OF THE CONCRETE.
- 3. 1" DEEP CONTRACTION JOINTS SHALL BE PLACED AT INTERVALS OF APPROXIMATELY 15' [4572mm] OR AT A SPACING THAT MATCHES THE ADJACENT CURB.
- 4. FORMED CONTRACTION JOINTS SHALL BE FINISHED WITH A TOOL HAVING A 1/4" [6mm] RADIUS.
- SCORED JOINTS SHALL BE 1/4" [6mm] DEEP AND PLACED AT THE SPACING INDICATED FOR THE WIDTH OF SIDEWALK OR MATCH SCORED JOINTS OF ADJACENT CURB.
- CONCRETE SHALL BE FINISHED BY MEANS OF A FLOAT, STEEL TROWELLED AND BROOMED WITH A FINE BRUSH IN A TRANSVERSE DIRECTION.
- 7. 1/4" DEEP SCORED JOINTS (TYP) SPACED AT 6' [1829mm] OR EQUAL TO SIDEWALK WIDTH.

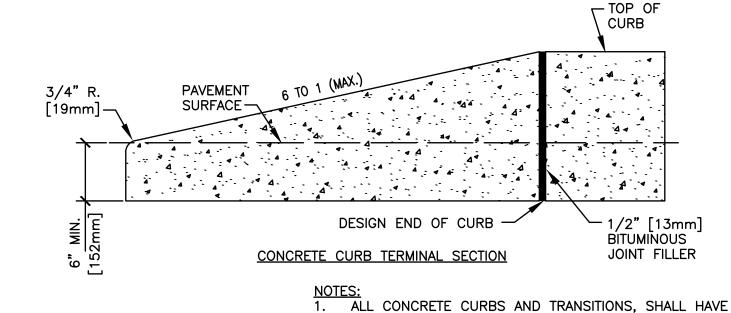

A MINIMUM COMPRESSIVE STRENGTH OF 2,500 PSI. 2. MAXIMUM SPACING ON SCORED JOINTS SHALL BE 15' [4572mm]. 1/2" [13mm] THICK EXPANSION JOINTS SHALL BE LOCATED AT TANGENT POINTS IN CURB RETURNS, TRANSITIONS, AND AT A MAXIMUM OF 60' [1828.8cm] INTERVALS. EXPANSION MATERIAL SHALL ALSO BE

PLACED BETWEEN CURBS AND ADJACENT STRUCTURES, SIDEWALKS, DRIVEWAYS AND CURB ACCESS RAMPS. FORMS OR MAY BE SLIP FORMED. H=DESIGN REVEAL [241mm NOTE ' [254mm

THE 1/2" [13mm] JOINT FILLER SHALL EXTEND THE FULL DEPTH OF THE CONCRETE. CONCRETE SHALL BE FINISHED WITH A STEEL TROWEL FOLLOWED BY BRUSHING WITH A FINE BRUSH ALONG THE LENGTH OF THE CURB OR CURB AND GUTTER. SINGLE CURB MAY BE CONSTRUCTED BY THE USE OF

6. ALL EXPOSED EDGES AND HAND TOOLED JOINTS SHALL BE FINISHED WITH A TOOL HAVING A 1/4" [6mm] RADIUS UNLESS A LARGER RADIUS IS INDICATED BY THE APPLICABLE STANDARD DETAIL OR PROJECT

CONCRETE VERTICAL CURB FOR REVEALS OF 6" [152mm] TO LESS THAN 8"

8. FOR REVEALS OF 8" [203mm] TO 10" [254mm].

SCALE: NOT TO SCALE

CONCRETE CURB AND TERMINAL SECTION

- CONCRETE PULLBOXES SHALL BE MONOLITHICALLY-POURED REINFORCED
- CONCRETE COVERS SHALL HAVE MOLDED LETTERING, FIBER OPTIC.
- PULLBOXES SHALL COMPLY WITH THE REQUIREMENTS OF ANSI 77 LOADING
- REQUIREMENTS AS FOLLOWS: 3.1. LIGHT DUTY: NON-PAVED AREAS
- TIER 8: SIDEWALK LOCATIONS NOT CROSSING DRIVEWAYS
- AASHTO H-20: PARKING LOTS, ROADWAYS, OR ACCESS DRIVES 4. MAXIMUM SPACING BETWEEN PULLBOXES SHALL BE 300 LF. MEASURED ALONG
- THE HORIZONTAL ALIGNMENT.

GALVANIZED DROP IN BOLT DOWN COVER ASSEMBLIES COVER MARKED "TELEPHONE" FRAME ASSEMBLY > 18 HOLE CABLE RACK 2 PER SIDE WALL 4 TOTAL CONCRETE KNOCKOUT 1 VARIES BY DUCT SIZE 2 EACH SIDE WALL KNOCKOUT GALVANIZED **PULLING IRONS 2**

NOTE: SEE PLANNED CONSTRUCTION PROFILE SHEETS FOR INDIVIDUAL STRUCTURE DEPTHS AND KNOCKOUT INVERTS AND LOCATIONS

EXTERIOR PULL BOX (30"X48")

TOTAL

GENERAL NOTES

- 1. ALL IMPROVEMENTS SHOWN ON THESE ENGINEERING PLANS SHALL COMPLY WITH THE CITY OF SIOUX FALLS DESIGN AND SPECIFICATIONS. LATEST EDITION. AND THE STANDARDS OF THE SOUTH DAKOTA DEPARTMENT OF NATURAL RESOURCES, LATEST EDITION.
- 2. UNDERGROUND FACILITIES, STRUCTURES AND UTILITIES HAVE BEEN PLOTTED FROM AVAILABLE SURVEYS, RECORDS, AND FIELD INVESTIGATION. THEIR LOCATIONS MUST BE CONSIDERED APPROXIMATE ONLY. IT IS POSSIBLE THERE MAY BE OTHERS, THE EXISTENCE OF WHICH PRESENTLY NOT KNOWN OR SHOWN. IT IS THE CONTRACTOR'S RESPONSIBILITY TO DETERMINE THEIR EXISTENCE AND EXACT LOCATION AND TO AVOID DAMAGE THERETO.
- 3. ALL DEBRIS RESULTING FROM CONSTRUCTION OPERATIONS SHALL BE

PROPERLY DISPOSED OF OFF-SITE UNLESS NOTED.

- 4. THE CONTRACTOR SHALL EXERCISE PROPER CAUTION TO PROTECT THE EXISTING IMPROVEMENTS. THE CONTRACTOR SHALL BE RESPONSIBLE FOR REPAIRING ANY DAMAGE.
- 5. PORTLAND CEMENT CONCRETE. CONCRETE SHALL HAVE THE FOLLOWING PROPERTIES. COMPRESSING STRENGTH SHALL BE 4000PSI IN 14 DAYS, AIR ENTRAINMENT SHALL BE BETWEEN 5 % AND 8% AND SLUMP SHALL BE 4 INCHES OR LESS ALL AS MEASURED BY THE APPROPRIATE ASTM METHODS. REINFORCING STEEL SHALL BE ASTM CERTIFIED 60KSI TENSILE STRENGTH. REINFORCING STEEL SHALL BE #4 SIZE UNLESS OTHERWISE SPECIFIED. HANDRAILS, BOLLARDS, AND OTHER APPURTENANCES SHALL BE INSTALLED PER PLAN AND MEET JURISDICTIONAL REQUIREMENTS.
- 6. CLEANUP AND FINAL INSPECTION. WORK BROKEN OR DAMAGED BY CONTRACTOR ACTIVITY SHALL BE REPAIRED OR REPLACED AT THE CONTRACTOR'S EXPENSE. ALL WASTE MATERIAL, CONCRETE WASHOUT, LANDSCAPE WASTE AND BUILDING MATERIAL SHALL BE REMOVED. SOIL SHALL BE REMOVED FROM PAVED AREAS AND THE PROJECT SHALL BE LEFT IN A CLEAN AND WORKMANLIKE MANNER.
- 7. MATERIAL AND COMPACTION REQUIREMENTS FOR PIPE BEDDING/SHADING SHALL BE IN ACCORDANCE WITH THE SPECIFICATIONS FOR THE APPLICABLE UTILITY PIPE.
- 8. TRENCH BACKFILL SHALL COMMENCE 1 FOOT ABOVE THE TOP OF PIPE AND SHALL BE PER SECTION XXX.
- 9. BACKFILL COMPACTION REQUIREMENTS SHALL BE PER SECTION XXX.

OF SECTION XXX FOR THE TYPE SPECIFIED.

- 10. ASPHALTIC TACK MATERIAL SHALL BE IN ACCORDANCE WITH THE REQUIREMENTS OF SECTION XXX.
- 11. ASPHALTIC CONCRETE SHALL BE IN ACCORDANCE WITH THE REQUIREMENTS
- 12. LOAD TRANSFER DOWELS FOR JOINTS TRANSVERSE TO THE ROADWAY CENTERLINE SHALL BE SMOOTH STEEL DOWELS IN ACCORDANCE WITH THE REQUIREMENTS OF SECTION XXX. DOWELS SHALL BE SPACED AS FOLLOWS:

CCP THICKNESS	DOWEL SIZE	DOWEL LENGTH	DOWEL SPACING
6"	#5	12"	18"
7"	#6	15"	15"
8"	#8	15"	12"
10"	#10	15"	12"

SEALANT-JOINT $\frac{1}{4}$ " MIN. WIDE BY $\frac{3}{8}$ " PVC CONDUIT PENETRATIONS TERMINATE PVC CONDUIT WITHIN MAINTENANCE HOLE (INSERT TAPERED PLUG FOR USED CONDUITS OR CAP FOR UNUSED CONDUITS) — ESCUTCHEON (TYP.) PLYWOOD BACKER FOR CAST IN PLACE EXTERIOR -JUNCTION BOARD. CONCRETE DUCT BANK PER DETAIL 1

PULLBOX PENETRATION DETAIL

EROSION CONTROL NOTES

- EROSION CONTROL SHALL BE INSTALLED PRIOR TO ANY GRADING OPERATIONS WHERE POSSIBLE.
- CONSTRUCTION ENTRANCE SHALL BE MAINTAINED TO PREVENT OFF-SITE TRACKING OF SEDIMENT ONTO PUBLIC ROADWAYS. ANY SEDIMENT DEPOSITED ON PUBLIC ROADS SHALL BE REMOVED BY SHOVELING OR STREET CLEANING BEFORE THE END OF EACH WORKING DAY.
- SHOWN LOCATION OF SILTATION CONTROL IS APPROXIMATE. ACTUAL LOCATIONS TO BE DETERMINED IN THE FIELD AT THE TIME OF

CONSTRUCTION.

- 4. WATER PUMPED DURING CONSTRUCTION OPERATIONS SHALL BE FILTERED.
- ONICE CONSTRUCTION HAS BEEN COMPLETED, OR TEMPORARILY SUSPENDED FOR LONGER THAN 14 DAYS (SUCH AS WINTER SHUTDOWN), THE CONTRACTOR SHALL INITIATE SEEDING ON ALL AREAS DISTURBED IMMEDIATELY OF THE LAST DISTURBANCE. EROSION CONTROL DEVICES SHALL REMAIN IN PLACE AND BE MAINTAINED UNTIL THE CONTRACTOR ESTABLISHES A GOOD STAND OF GRASS OF UNIFORM COLOR AND DENSITY TO THE SATISFACTION OF THE ENGINEER.
- CONTRACTOR SHALL ADHERE TO THE SOUTH DAKOTA CONSTRUCTION SITE **EROSION CONTROL MANUAL.**
- ALL EROSION CONTROL MEASURES MUST BE INSTALLED (WHERE POSSIBLE) PRIOR TO THE COMMENCEMENT OF ANY EARTH DISTURBING OPERATIONS. THE REMAINING EROSION CONTROL MEASURES SHALL BE INSTALLED AS SOON AS REASONABLY POSSIBLE AFTER GRADING OPERATIONS BEGIN. WHERE THE PRESENCE OF SILT FENCE WILL INTERFERE WITH ACTIVITIES, DIVERSION DITCHES AND SMALL TEMPORARY SEDIMENT TRAPS SHALL BE UTILIZED UNTIL SILT FENCE OR OTHER MEASURES MAY BE INSTALLED AND VEGETATION ESTABLISHED.
- EROSION CONTROL MEASURES SHALL BE INSPECTED WEEKLY AND AFTER EACH PRECIPITATION EVENT AND REPLACED OR REPAIRED AS NECESSARY.
- SILT FENCE AND SEDIMENT BASIN SHALL BE CLEANED OR REPLACED WHEN SILT BUILDS UP TO WITHIN ONE FOOT OF THE TOP OF THE SILT FENCE.
- PROJECT WILL BE COVERED BY A GENERAL PERMIT REGULATING RUNOFF FROM CONSTRUCTION SITES. IT IS THE CONTRACTOR'S RESPONSIBILITY TO PERFORM THE REQUIRED MONITORING, INSPECTION AND MAINTENANCE AS REQUIRED BY THE PERMIT.
- 11. CONCRETE WASHOUT DEBRIS SHOULD BE HAULED OFF-SITE. WASHOUT SHOULD BE FILLED IN AND SEEDED.
- ALL AREAS DISTURBED BEYOND LIMITS SHOWN SHOULD BE SEEDED WITH ADJACENT SEED MIXTURE OR IN-KIND.
- THERE ARE NO EXPECTED DOWNSTREAM IMPACTS OTHER THAN THOSE ALLOWED PER ORDINANCE (2 YEAR, PRE-DEVELOPED RATE OF RELEASE)

UTILITY NOTES

- 1. IT SHALL BE THE RESPONSIBILITY OF THE CONTRACTOR TO PROTECT ALL EXISTING UTILITIES AND PAVED STREETS, INCLUDING ANY NOT SHOWN ON THESE DRAWINGS. THE CONTRACTOR SHALL VERIFY ALL EXISTING UTILITIES PRIOR TO CONSTRUCTION AND NOTIFY THE ENGINEER IF ANY CONFLICTS WITH THE DRAWINGS OCCUR. ANY DAMAGE TO EXISTING UTILITIES AND/OR PAVED STREETS CAUSED BY TRENCHING AND GRADING OPERATIONS SHALL BE REPAIRED AT THE CONTRACTOR'S EXPENSE. EXISTING UTILITY LOCATIONS SHOWN ON THE DRAWINGS ARE APPROXIMATE.
- 2. ALL EXISTING UNDERGROUND UTILITIES SHOWN WERE LOCATED PARTIALLY IN THE FIELD AND PARTIALLY FROM REVIEW OF EXISTING PUBLIC RECORDS. IT IS THE RESPONSIBILITY OF THE CONTRACTOR TO CONTACT EACH UTILITY COMPANY FOR THE FIELD LOCATION OF THEIR EXISTING LINES IN OR NEARBY THE CONSTRUCTION AREA PRIOR TO BEGINNING ANY CONSTRUCTION.
- 3. THE CONTRACTOR SHALL EXERCISE PROPER CAUTION TO PROTECT THE EXISTING IMPROVEMENTS. THE CONTRACTOR SHALL BE RESPONSIBLE FOR REPAIRING ANY DAMAGE.
- 4. THE LOCATIONS OF THOSE BURIED AND ABOVE GROUND UTILITIES SHOWN ARE APPROXIMATE, ARE SHOWN FOR CONTRACTOR INFORMATIONAL USE ONLY, AND ARE NOT TO BE REFERENCED FOR CONSTRUCTION PURPOSES. THE IMPLIED PRESENCE OR ABSENCE OF UTILITIES IS NOT TO BE CONSTRUED BY THE OWNER, ENGINEER, CONTRACTOR, OR SUBCONTRACTORS TO BE AN ACCURATE AND COMPLETE REPRESENTATION OF UTILITIES THAT MAY OR MAY NOT EXIST ON THE CONSTRUCTION SITE. BURIED AND ABOVE GROUND UTILITY LOCATION, IDENTIFICATION, AND MARKING ARE THE SOLE RESPONSIBILITY OF THE CONTRACTOR, REROUTING, DISCONNECTION, PROTECTION, ETC. OF ANY UTILITY MUST BE COORDINATED BETWEEN THE CONTRACTOR, UTILITY COMPANY AND OWNER. SITE SAFETY, INCLUDING THE AVOIDANCE OF HAZARDS ASSOCIATED WITH BURIED AND ABOVEGROUND UTILITIES, REMAINS THE SOLE RESPONSIBILITY OF THE CONTRACTOR.
- 5. UTILITY PIPING. ALL WORK SHALL BE PERFORMED IN CONFORMANCE WITH THE PIPE MANUFACTURER'S RECOMMENDATIONS FOR INSTALLATION METHODS INCLUDING BACKFILL MATERIAL AND MATERIAL DEPTHS. PIPE MATERIAL SHALL BE AS SPECIFIED ON THE PLANS. ALL MATERIAL SHALL MEET THE REQUIREMENTS OF THE LOCAL JURISDICTION FOR STRENGTH, MATERIAL TYPE AND CONFORMITY WITH THE EXISTING SYSTEM. SEWER LINES SHALL BE CONSTRUCTED STRAIGHT TO THE SPECIFIED LINE AND GRADES. MANHOLES, STORM INLETS, VALVE BOXES AND APPURTENANCES SHALL BE ADJUSTED TO GRADE OR PER PLAN PRIOR TO SEEDING/LANDSCAPING ACTIVITIES.

GRADING NOTES

- 1. ALL EARTHWORK OPERATIONS SHALL BE IN ACCORDANCE WITH THE GEOTECHNICAL REPORT.
- 2. ALL ELEVATIONS SHOWN ARE TO FLOWLINE FINISHED GRADE OR TOP OF PAVEMENT UNLESS OTHERWISE STATED.
- 3. PROVIDE POSITIVE DRAINAGE AT ALL TIMES WITHIN THE CONSTRUCTION AREAS. DO NOT ALLOW WATER TO POND ON PROPERTY.
- 4. PRIOR TO PLACEMENT OF ANY FILL, THE STRIPPED SITE SHALL BE SCARIFIED TO A DEPTH OF 9 INCHES AND RE-COMPACTED TO 95% DENSITY. ANY UNSUITABLE SOILS FOUND AT THIS TIME SHALL BE DRIED AND RECOMPACTED OR REMOVED IF REQUIRED COMPACTION CANNOT BE OBTAINED. CUT AREAS SHALL ALSO BE SCARIFIED TO A DEPTH OF 9 INCHES AND RE-COMPACTED TO 95% DENSITY.
- 5. ALL FILL MATERIAL SHALL CONSIST OF APPROVED, SUITABLE SOILS PLACED IN LOOSE LIFTS OF 9 INCHES OR LESS AND COMPACTED TO AT LEAST 95% OF THE MATERIAL'S MAXIMUM STANDARD PROCTOR DRY DENSITY (ASTM D-698) IN ALL PAVEMENT, BUILDING ADDITION AND ATHLETIC FIELD AREAS, THE COMPACTION WILL BE FIELD TESTED BY A SOILS ENGINEERING CONSULTANT REPRESENTING THE OWNER.
- 6. PROJECT WILL BE COVERED BY A GENERAL PERMIT REGULATING RUNOFF FROM CONSTRUCTION SITES. IT IS THE CONTRACTOR'S RESPONSIBILITY TO PERFORM THE REQUIRED MONITORING, INSPECTION AND MAINTENANCE AS REQUIRED BY THE PERMIT
- 7. ALL DISTURBED EMBANKMENTS GREATER THAN 3:1 SLOPES SHALL BE SEEDED ACCORDING TO A RECOMMENDED SEEDING MIX BY THE LANDSCAPER AND COVERED WITH EROSION CONTROL BLANKETS OR AS DIRECTED BY PLAN DOCUMENTS.
- 3. CONTRACTOR SHALL ADHERE TO THE CITY OF SIOUX FALLS EROSION AND SEDIMENT CONTROL REGULATIONS AND THE STATE OF SOUTH DAKOTA CONSTRUCTION SITE EROSION CONTROL MANUAL.
- 9. ALL AREAS TO BE GREENSPACE AT PROJECT COMPLETION SHALL BE LEFT WITH 9 INCHES OF TOPSOIL WHEN MASS GRADING ACTIVITIES ARE COMPLETE

Checked

LRK

Drawn

JPR

Project Number

438-20-910

Building Number

Drawing Number

C-501

Drawing Title **Project Title** ARCHITECT/ENGINEER OF RECORD | STAMP CONSULTANT Office of VAMC SIOUX FALLS EHRM **DETAILS & NOTES BID DOCUMENTS** Construction INFRASTRUCTURE UPGRADES SPECIALIZED and Facilities ANDERSON ENGINEERING **Approved: Project Director** Management Sioux Falls, SD U.S. Department of Veterans Affairs P 763.412.4000 | F 763.412.4090 | ae-mn.com 11/29/2021 Anderson Engineering of Minnesota, LLC | Proj # 16090 www.specializedeng.com

. CLASS S CONCRETE i f'c=3000 PSI CONCRETE PAVEMENT (TYP) 4'−0" MAX. 🕢 FOR TRENCH WIDTHS EXCEEDING 4' [1219mm] DELETE LOAD

-LOAD TRANSFER DOWELS.

REFER TO VA STANDARD

FOR PLACEMENT DETAILS

DETAIL 32 12 16-04

ASPHALT FULL DEPTH

-SAW CUT EXISTING.

BOTH SIDES

2" [50mm] MINIMUM OR THICKNESS OF EXISTING PAVEMENT WHICHEVER IS GREATER.


TRENCH PAVEMENT PATCH NOTES".

- BITUMINOUS SURFACE TREATMENT (CHIPSEAL) REQUIRED ONLY FOR
- LONGITUDINAL TRENCHES WITH WIDTHS GREATER THAN 6' [1829mm]. ■ REFER TO NOTE 13 ON VA STANDARD DETAIL 32 12 16-04 "UTILITY

REFER TO VA STANDARD DETAIL 32 12 16-04 "UTILITY TRENCH PAVEMENT PATCH NOTES" FOR ADDITIONAL INFORMATION.

Date:

TYPE 3 UTILITY TRENCH PATCH SCALE: NOT TO SCALE

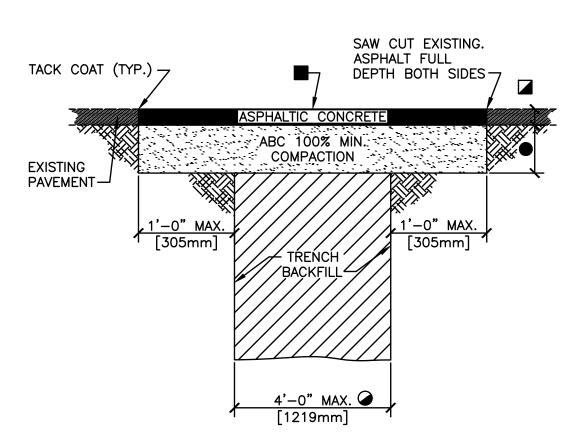

- 2" [50mm] MINIMUM OR THICKNESS OF EXISTING PAVEMENT
- 4" [100mm] MINIMUM ABC OR THICKNESS OF EXISTING GRANULAR BASE COURSE MATERIALS (E.G. ABC & SELECT MATERIAL) WHICHEVER

REFER TO VA STANDARD DETAIL 32 12 16-04 "UTILITY TRENCH

TYPE 1 UTILITY TRENCH PATCH


FOR TRENCH WIDTHS EXCEEDING 4' [1219mm] REFER TO VA STANDARD DETAIL 32 12 16-02 "TYPE 2 UTILITY TRENCH PATCH". FOR TRENCH WHERE PORTLAND CEMENT CONCRETE (PCC) PAVEMENT


EXISTS, REFER TO 32 12 16-03 "TYPE 3 UTILITY TRENCH PATCH".


WHICHEVER IS GREATER.

BITUMINOUS SURFACE TREATMENT (CHIPSEAL) REQUIRED ONLY FOR LONGITUDINAL TRENCHES WITH WIDTHS GREATER THAN 6' [1829mm].


PAVEMENT PATCH NOTES" FOR ADDITIONAL INFORMATION.

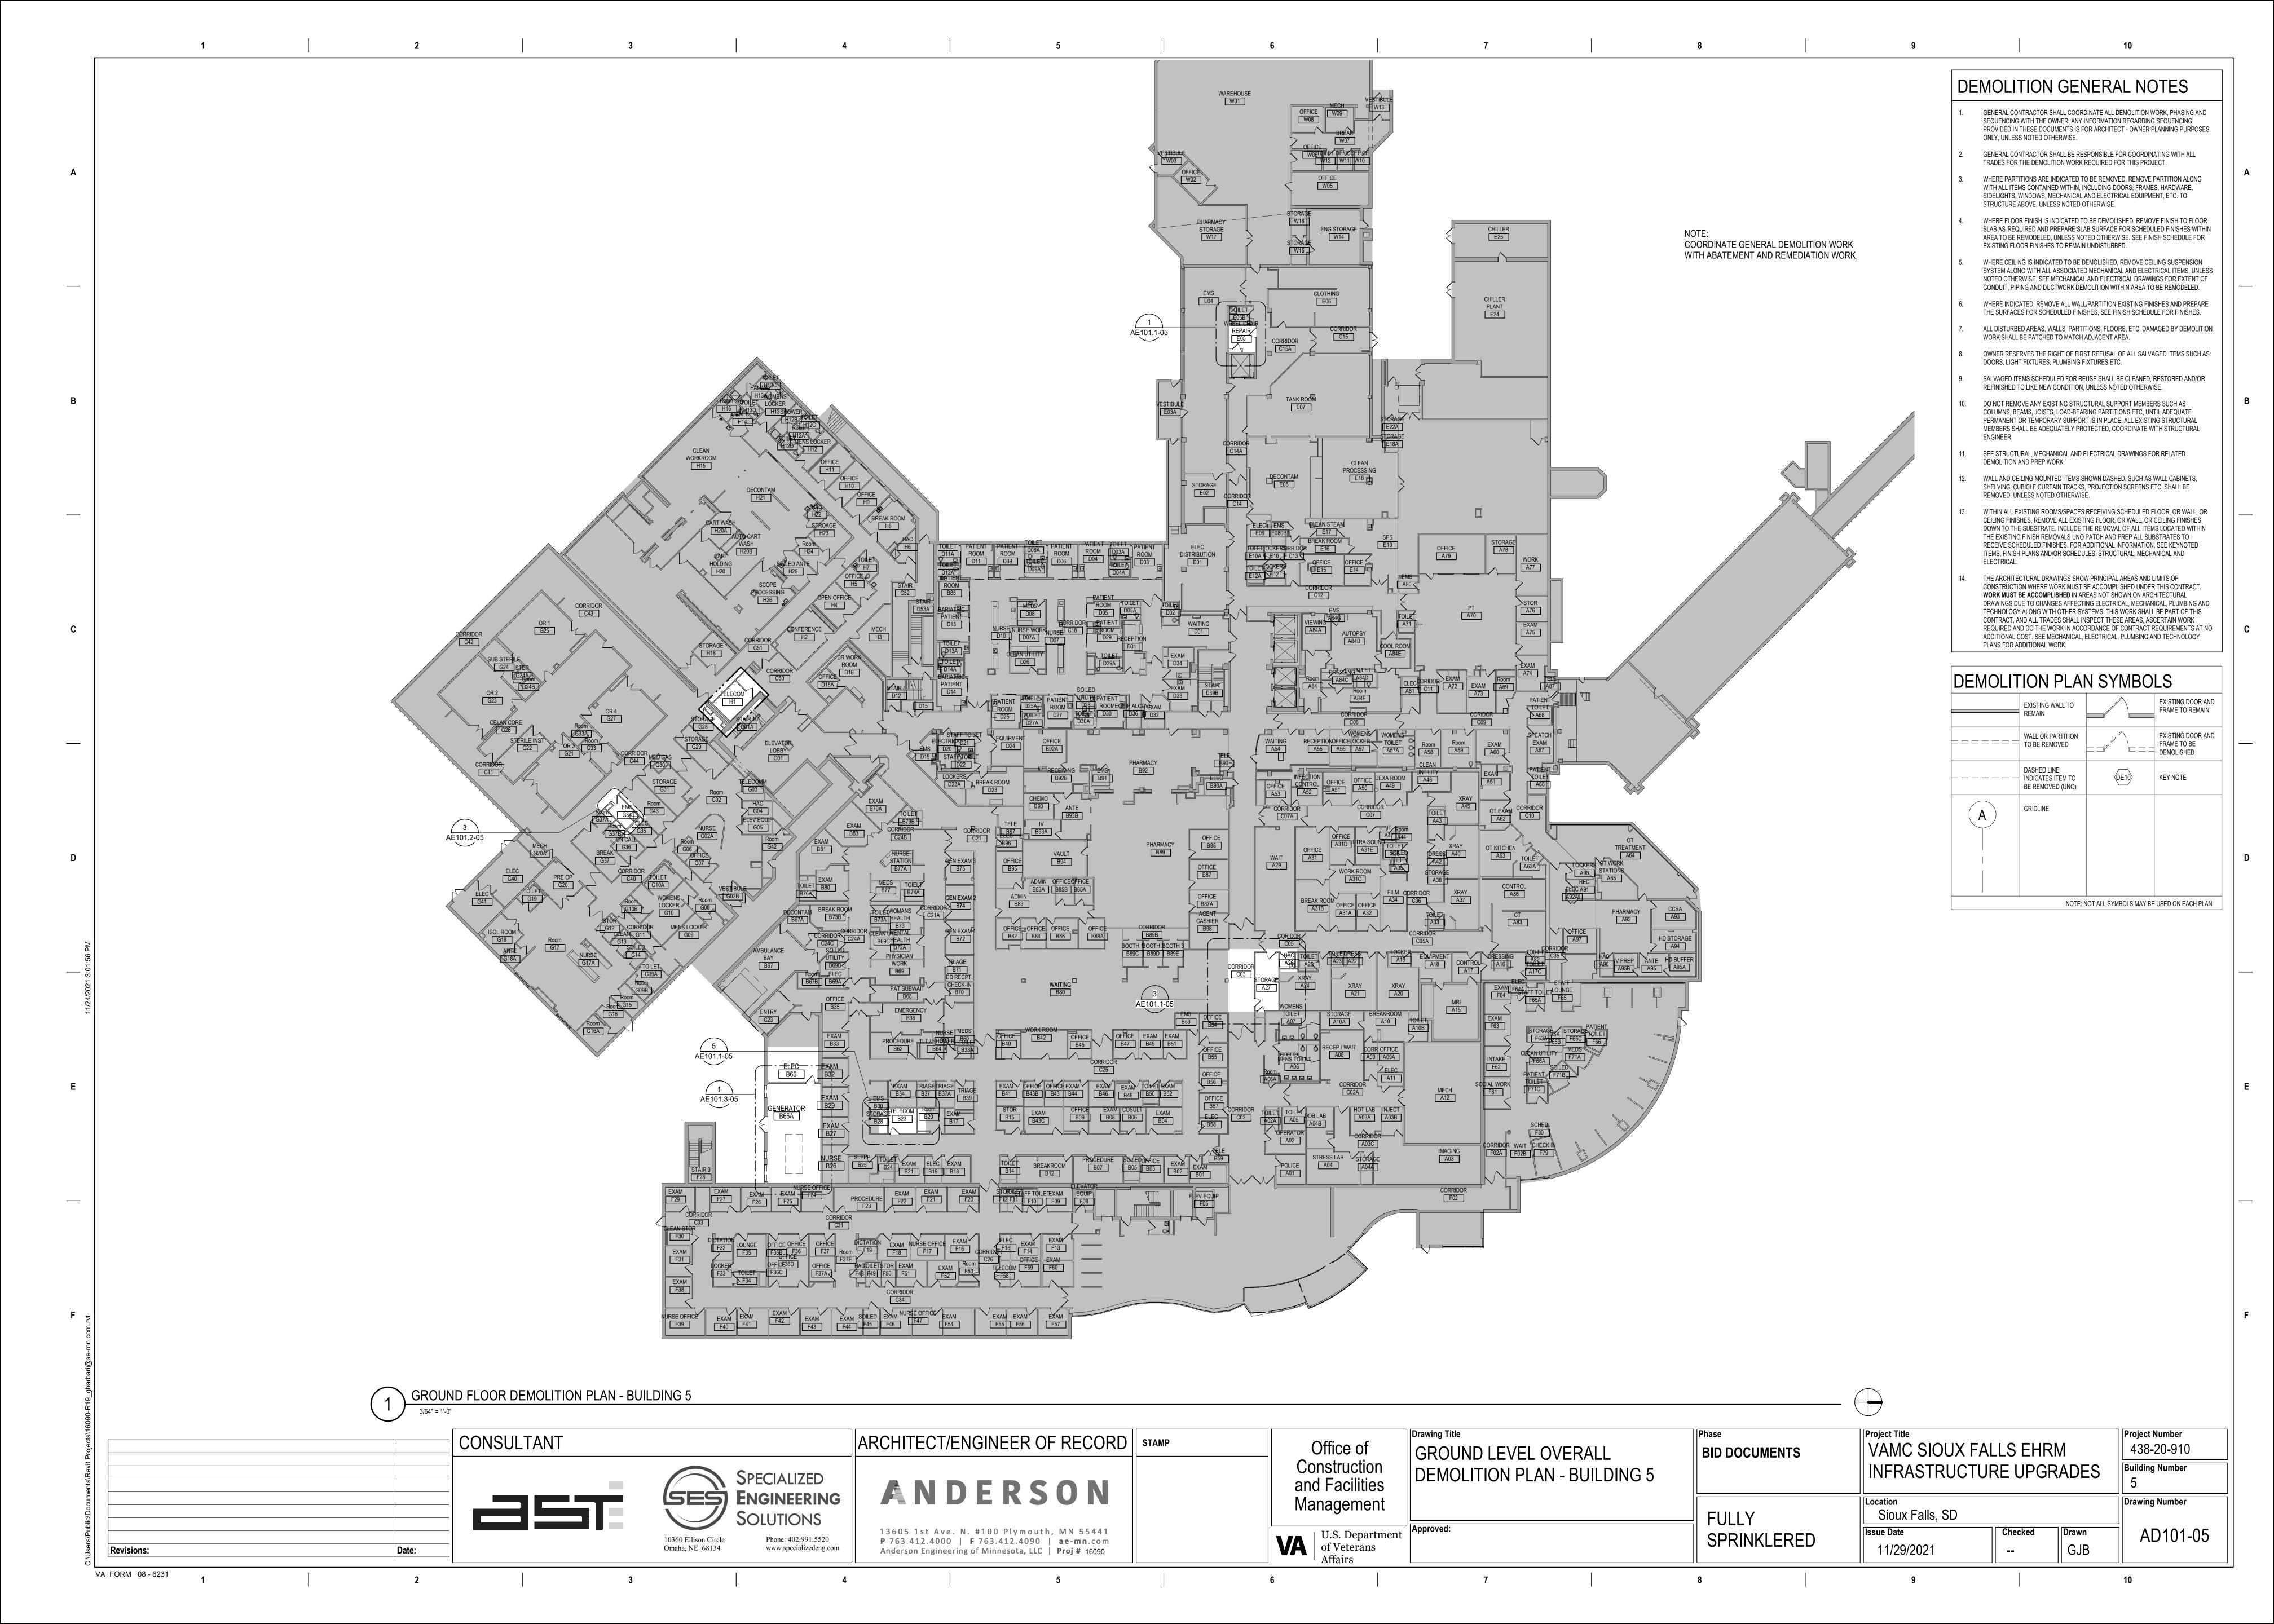

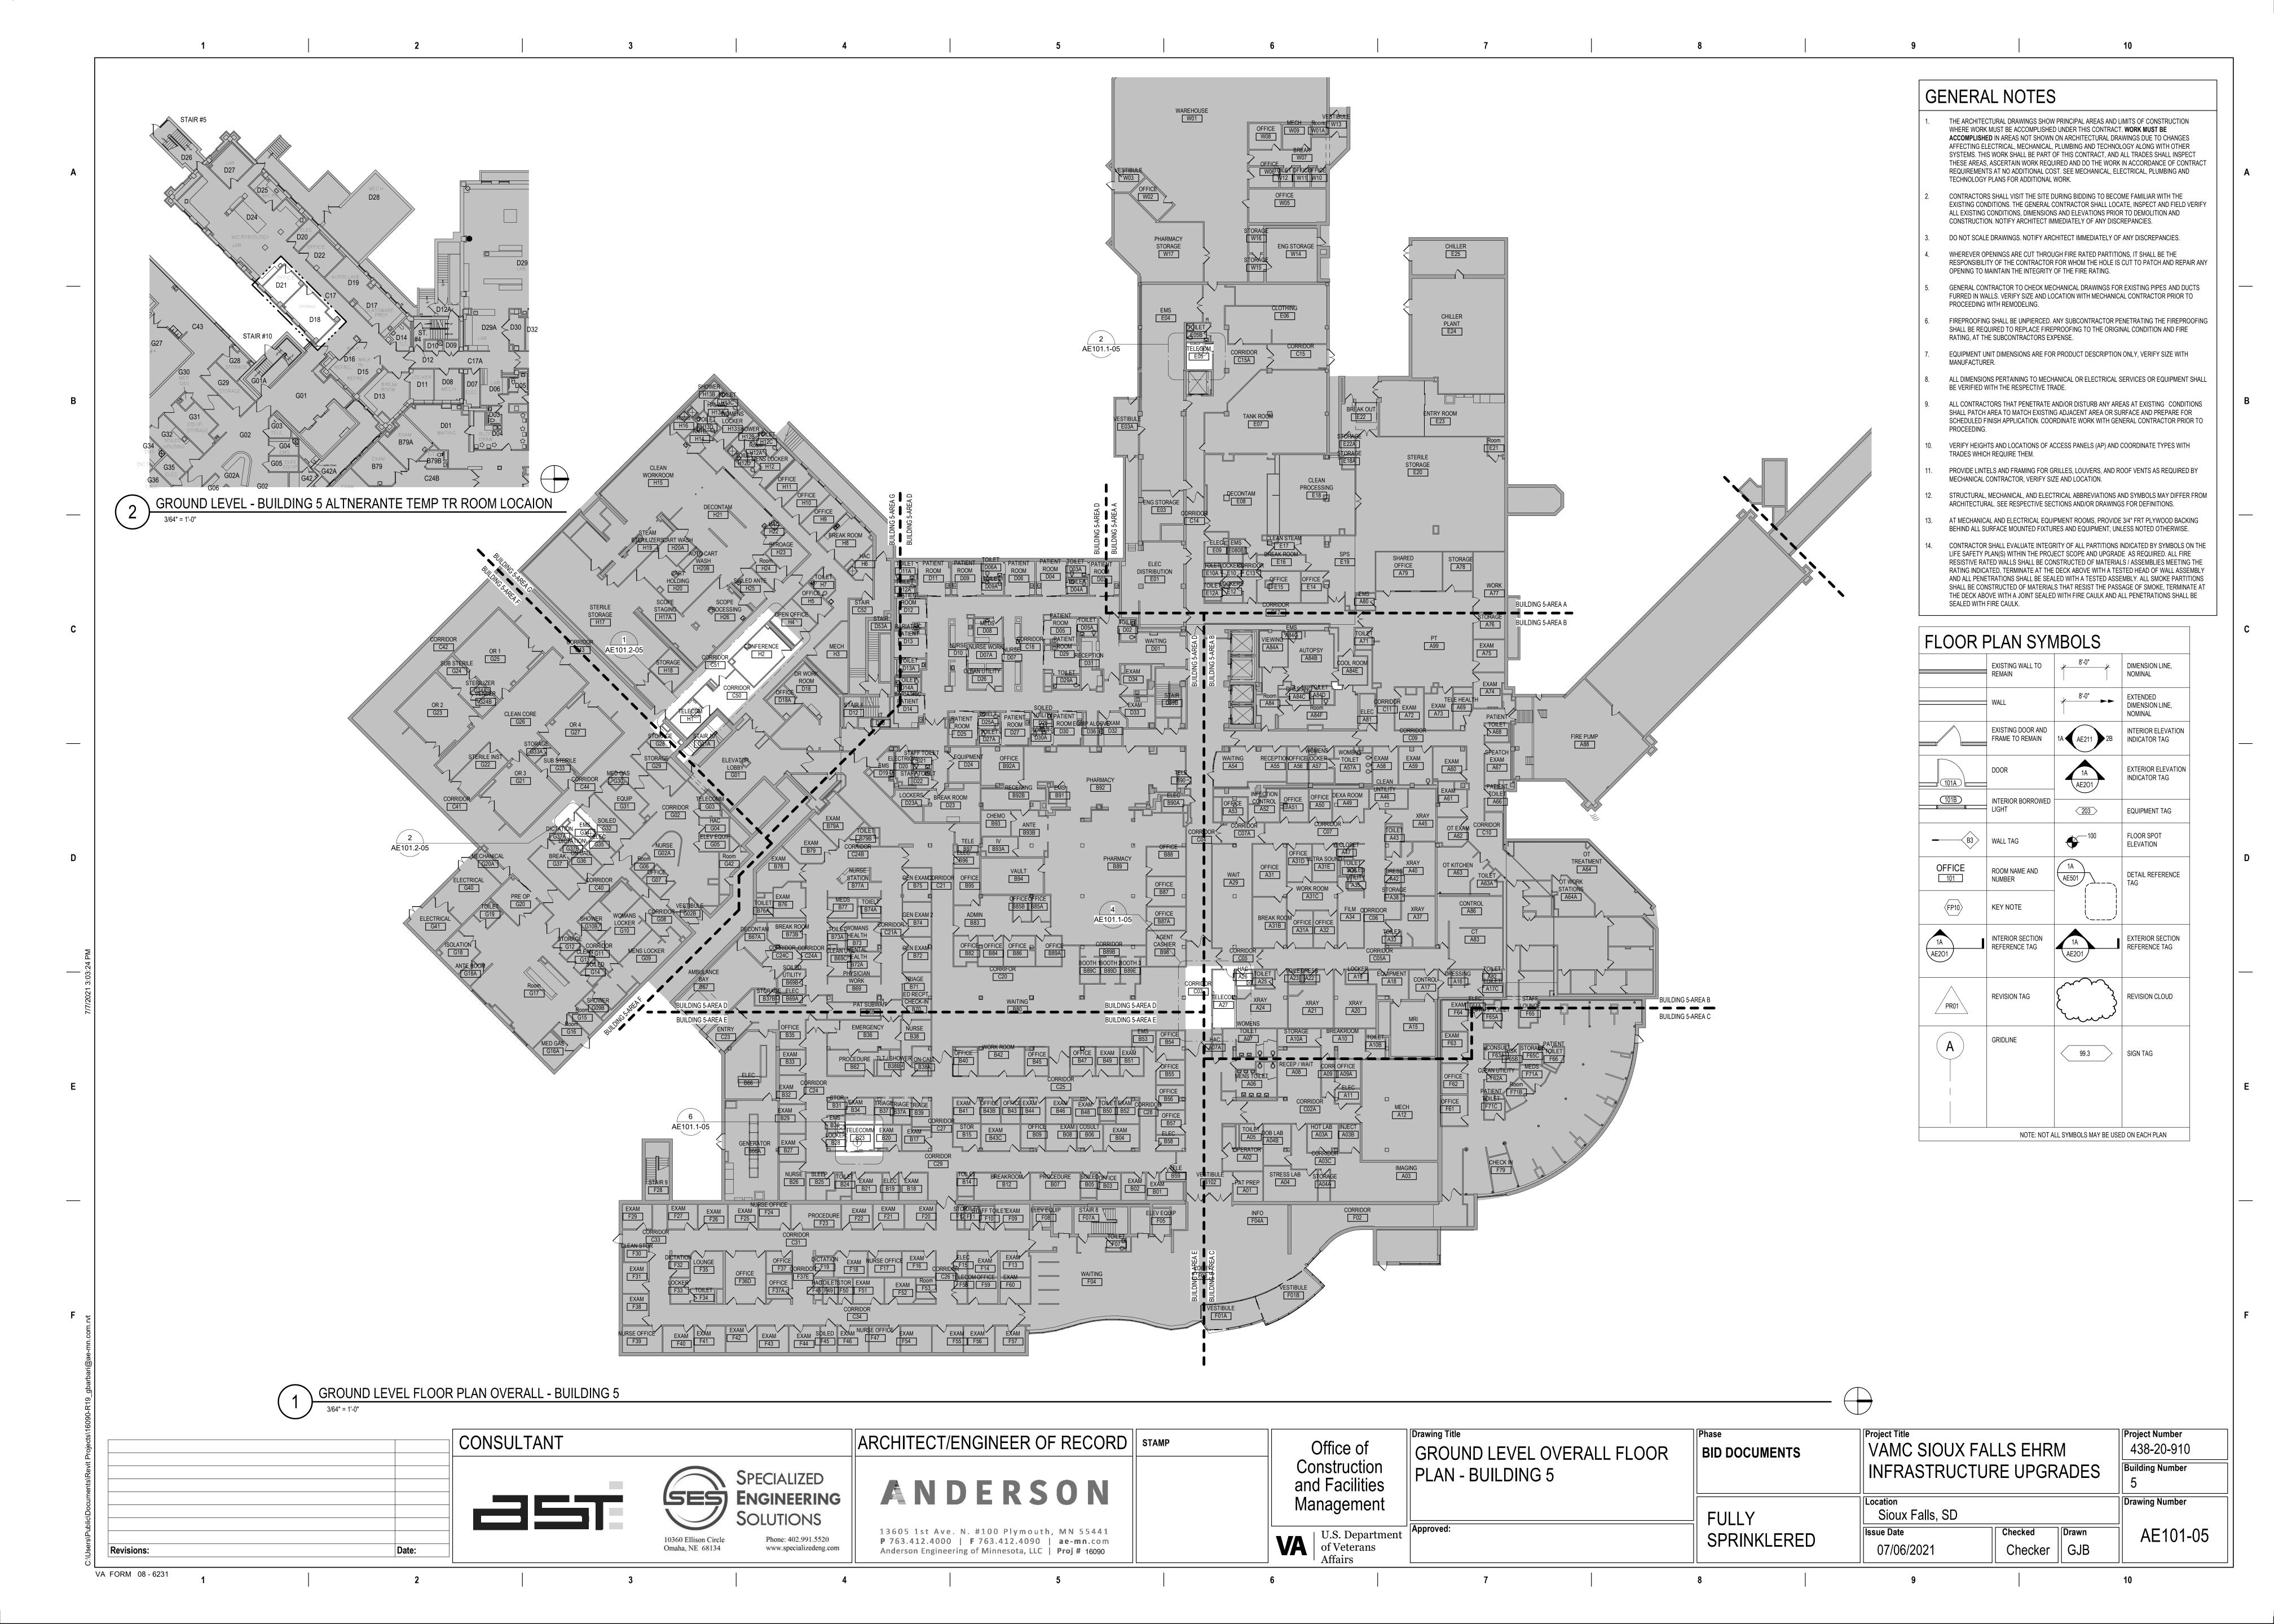


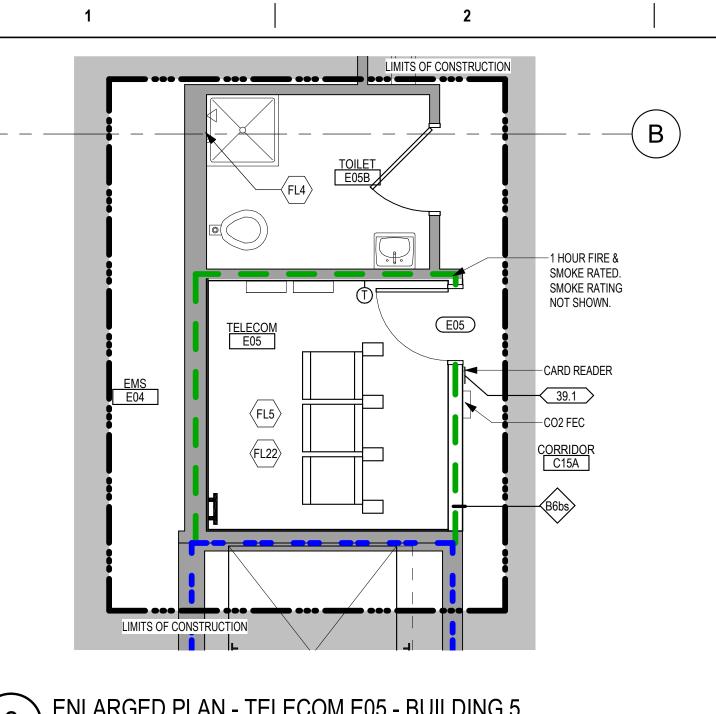

ENLARGED PLAN - TELECOM E05 - BUILDING 5

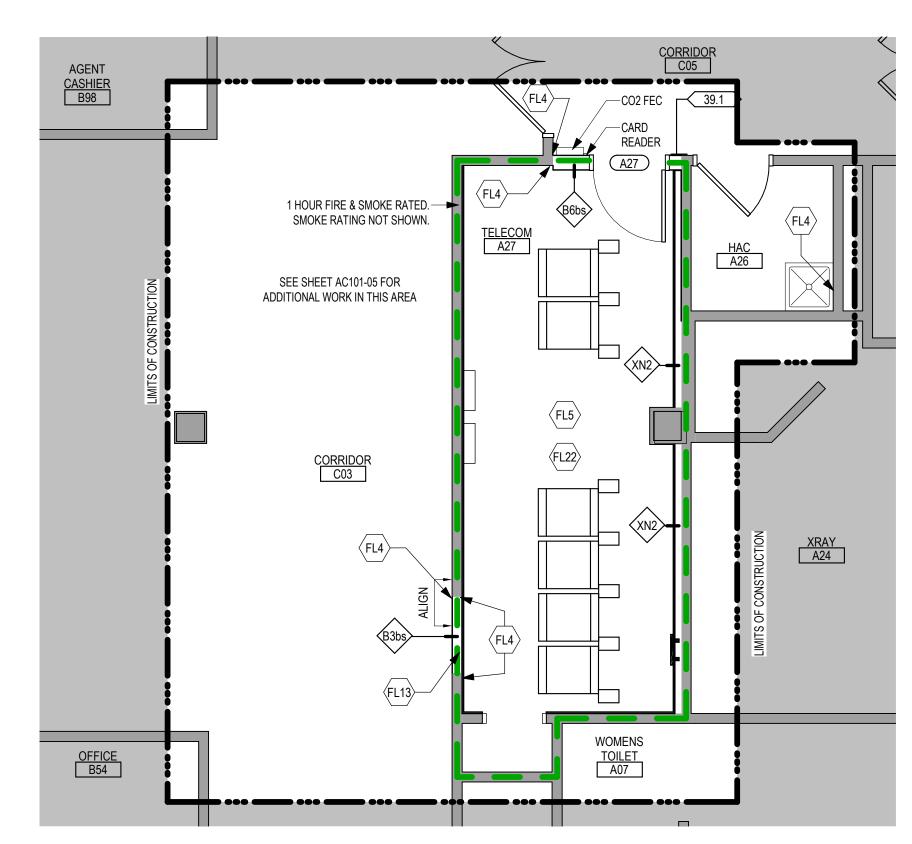

ENLARGED PLAN - TELECOM A27 - BUILDING 5

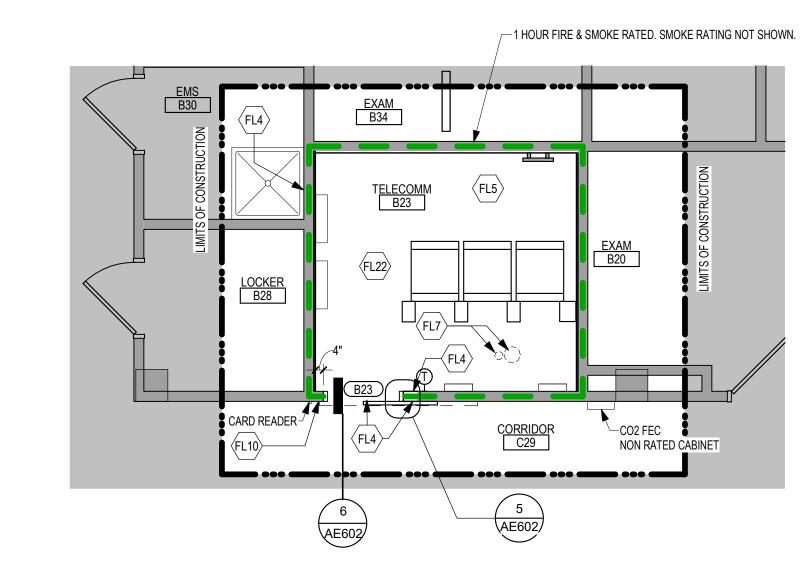

ENLARGED PLAN - TELECOM B23 - BUILDING 5 1/4" = 1'-0"

FLOOR PLAN KEYED NOTES

- PATCH PARTITION, BOTH SIDES, AS REQUIRED FROM MECHANICAL / ELECTRICAL WORK. SEE MECHANICAL / ELECTRICAL FOR ADDITIONAL
- PROVIDE PARTITION TYPE XP3 INFILL AT REMOVED RADIATOR GRILLS. PATCH PARTITION, WITH MATERIALS TO MATCH EXISTING ADJACENT SURFACES. WHERE EXISTING FINISHES ARE DISTURBED PAINT TO MATCH ADJACENT FINISH, PAINT ENTIRE WALL OF EXISTING INTERIOR SPACES WHERE PATCHING OCCURS.
- $\langle FL3 \rangle$ INFILL FLOOR TO MATCH EXISTING HEIGHT. SEE STRUCTURAL
- PATCH PARTITION, WITH MATERIALS TO MATCH EXISTING ADJACENT SURFACES, AS REQUIRED FROM DEMOLITION. WHERE EXISTING FINISHES ARE DISTURBED PAINT TO MATCH ADJACENT FINISH, PAINT ENTIRE WALL OF EXISTING INTERIOR SPACES WHERE PATCHING OCCURS.
- PROVIDE PLYWOOD 3 SIDES OF ROOM. SEE TYPICAL ELEVATIONS SHEET AE211
- FL6 INFILL OPENING IN CONCRETE FLOOR. SEE STRUCTURAL FOR ADDITIONAL INFORMATION. PREP FLOOR FOR FINISHES AS SCHEDULED.
- PATCH FLOOR AT REMOVED ELECTRICAL. PREP FLOOR FOR FINISHES AS SCHEDULED. FL8 REINSTALL SALVAGED DOOR, FRAME AND ALL ASSOCIATED HARDWARE.
- REINSTALL SALVAGED LOCKER(S). PROVIDE PREMANUFACTURED BASE, FINISHED END PANEL(S) AND SLOPED TOP(S) TO MATCH EXISTING.
- FL10 REINSTALL SALVAGED SIGN(S)
- REINSTALL SALVAGED CEILING REMOVED FOR INSTALLATION OF MEP ITEMS. SEE MEP PLANS FOR ADDITIONAL INFORMATION
- MODIFY BASE AND SLOPED TOP AT EXISTING LOCKERS. PROVIDE
- PREMANUFACTURED FINISHED END PANEL(S) TO MATCH EXISTING. PATCH EXISTING FINISHES DISTURBED BY CONSTRUCTION; WALL AND CEILING CONTRACTOR TO PROVIDE LATER
- PATCH FLOORING TO MATCH EXISTING FLOORING AS REQUIRED. CONTRACTOR TO PROVIDE LABOR AND MATERIALS.
- PATCH CONCRETE FLOOR AT REMOVED PARTITION AND/OR CONCRETE COVE BASE. PREP FOR FINISHES AS SCHEDULED.

CEILING. CONTRACTOR TO PROVIDE LABOR AND MATERIALS. REFER TO

MATERIAL AND ROOM FINISH SCHEDULE AND DETAIL 3 / AF600

- EDGE ILLUMINATED PHOTO MURALS, RECESSED IN PARTITION. FOR ADDITIONAL INFORMATION SEE ELEVATION 8 / AE211
- FINISH WALLS TO MATCH EXISTING. CONTRACTOR TO PROVIDE LABOR AND MATERIALS. REFER TO MATERIAL AND ROOM FINISH SCHEDULE AND
- PAINT WALLS P-1

DETAIL 2 / AF600

DETAIL 5 / AF600

- PATCH EXISTING FINISHES DISTURBED BY CONSTRUCTION; WALL AND CEILING. CONTRACTOR TO PROVIDE LABOR AND MATERIALS. REFER TO
- MATERIAL AND ROOM FINISH SCHEDULE AND DETAIL 4 / AF600 FINISH WALLS TO MATCH EXISTING. CONTRACTOR TO PROVIDE LABOR AND MATERIALS. REFER TO MATERIAL AND ROOM FINISH SCHEDULE AND
- PATCH EXISTING FINISHES DISTURBED BY CONSTRUCTION; WALL AND CEILING. CONTRACTOR TO PROVIDE LABOR AND MATERIALS. REFER TO MATERIAL AND ROOM FINISH SCHEDULE AND DETAIL 6 / AF600
- UPGRADE PARTITIONS TO 1 HOUR FIRE AND SMOKE BARRIER ALL SIDES OF ROOM. PROVIDE TESTED HEAD OF PARTITION ASSEMBLY WITH MATERIALS THAT RESIST THE PASSAGE OF SMOKE. SEAL JOINT AT HEAD OF PARTITION AND ALL PENETRATIONS WITH FIRE CAULK.


NOTE: NOT ALL KEYED NOTES MAY BE USED ON EACH PLAN


GENERAL NOTES


- THE ARCHITECTURAL DRAWINGS SHOW PRINCIPAL AREAS AND LIMITS OF CONSTRUCTION WHERE WORK MUST BE ACCOMPLISHED UNDER THIS CONTRACT. WORK MUST BE ACCOMPLISHED IN AREAS NOT SHOWN ON ARCHITECTURAL DRAWINGS DUE TO CHANGES AFFECTING ELECTRICAL, MECHANICAL, PLUMBING AND TECHNOLOGY ALONG WITH OTHER SYSTEMS. THIS WORK SHALL BE PART OF THIS CONTRACT, AND ALL TRADES SHALL INSPECT THESE AREAS, ASCERTAIN WORK REQUIRED AND DO THE WORK IN ACCORDANCE OF CONTRACT REQUIREMENTS AT NO ADDITIONAL COST. SEE MECHANICAL, ELECTRICAL, PLUMBING AND TECHNOLOGY PLANS FOR ADDITIONAL WORK.
- CONTRACTORS SHALL VISIT THE SITE DURING BIDDING TO BECOME FAMILIAR WITH THE EXISTING CONDITIONS. THE GENERAL CONTRACTOR SHALL LOCATE, INSPECT AND FIELD VERIFY ALL EXISTING CONDITIONS, DIMENSIONS AND ELEVATIONS PRIOR TO DEMOLITION AND CONSTRUCTION. NOTIFY ARCHITECT IMMEDIATELY OF ANY DISCREPANCIES.
- DO NOT SCALE DRAWINGS. NOTIFY ARCHITECT IMMEDIATELY OF ANY DISCREPANCIES.
- WHEREVER OPENINGS ARE CUT THROUGH FIRE RATED PARTITIONS, IT SHALL BE THE RESPONSIBILITY OF THE CONTRACTOR FOR WHOM THE HOLE IS CUT TO PATCH AND REPAIR ANY OPENING TO MAINTAIN THE INTEGRITY OF THE FIRE RATING.
- GENERAL CONTRACTOR TO CHECK MECHANICAL DRAWINGS FOR EXISTING PIPES AND DUCTS FURRED IN WALLS. VERIFY SIZE AND LOCATION WITH MECHANICAL CONTRACTOR PRIOR TO PROCEEDING WITH REMODELING.
- FIREPROOFING SHALL BE UNPIERCED. ANY SUBCONTRACTOR PENETRATING THE FIREPROOFING SHALL BE REQUIRED TO REPLACE FIREPROOFING TO THE ORIGINAL CONDITION AND FIRE RATING, AT THE SUBCONTRACTORS EXPENSE.
- EQUIPMENT UNIT DIMENSIONS ARE FOR PRODUCT DESCRIPTION ONLY, VERIFY SIZE WITH MANUFACTURER.
- ALL DIMENSIONS PERTAINING TO MECHANICAL OR ELECTRICAL SERVICES OR EQUIPMENT SHALL BE VERIFIED WITH THE RESPECTIVE TRADE.
- ALL CONTRACTORS THAT PENETRATE AND/OR DISTURB ANY AREAS AT EXISTING CONDITIONS SHALL PATCH AREA TO MATCH EXISTING ADJACENT AREA OR SURFACE AND PREPARE FOR SCHEDULED FINISH APPLICATION. COORDINATE WORK WITH GENERAL CONTRACTOR PRIOR TO
- VERIFY HEIGHTS AND LOCATIONS OF ACCESS PANELS (AP) AND COORDINATE TYPES WITH TRADES WHICH REQUIRE THEM.
- PROVIDE LINTELS AND FRAMING FOR GRILLES, LOUVERS, AND ROOF VENTS AS REQUIRED BY MECHANICAL CONTRACTOR, VERIFY SIZE AND LOCATION.
- STRUCTURAL, MECHANICAL, AND ELECTRICAL ABBREVIATIONS AND SYMBOLS MAY DIFFER FROM ARCHITECTURAL. SEE RESPECTIVE SECTIONS AND/OR DRAWINGS FOR DEFINITIONS.
- AT MECHANICAL AND ELECTRICAL EQUIPMENT ROOMS, PROVIDE 3/4" FRT PLYWOOD BACKING BEHIND ALL SURFACE MOUNTED FIXTURES AND EQUIPMENT, UNLESS NOTED OTHERWISE.

SEALED WITH FIRE CAULK.


CONTRACTOR SHALL EVALUATE INTEGRITY OF ALL PARTITIONS INDICATED BY SYMBOLS ON THE LIFE SAFETY PLAN(S) WITHIN THE PROJECT SCOPE AND UPGRADE AS REQUIRED. ALL FIRE RESISTIVE RATED WALLS SHALL BE CONSTRUCTED OF MATERIALS / ASSEMBLIES MEETING THE RATING INDICATED, TERMINATE AT THE DECK ABOVE WITH A TESTED HEAD OF WALL ASSEMBLY AND ALL PENETRATIONS SHALL BE SEALED WITH A TESTED ASSEMBLY. ALL SMOKE PARTITIONS SHALL BE CONSTRUCTED OF MATERIALS THAT RESIST THE PASSAGE OF SMOKE, TERMINATE AT THE DECK ABOVE WITH A JOINT SEALED WITH FIRE CAULK AND ALL PENETRATIONS SHALL BE

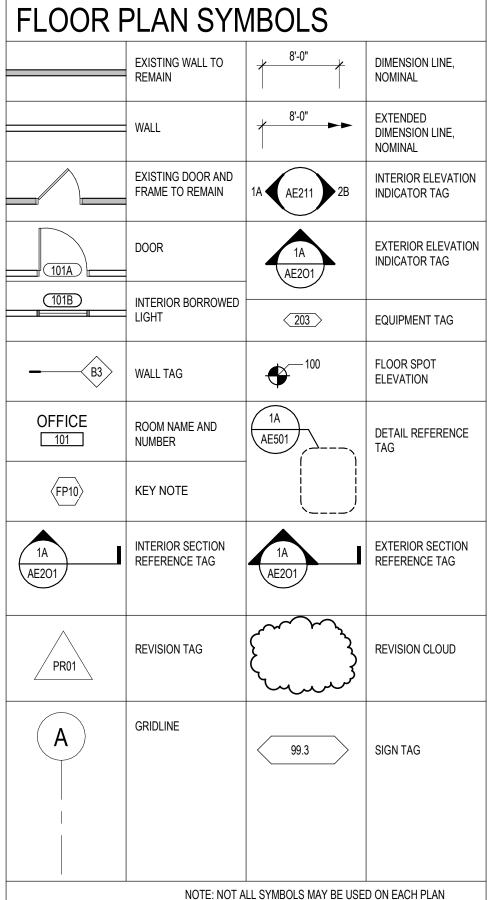

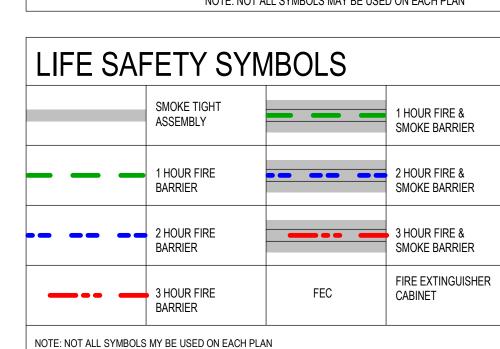


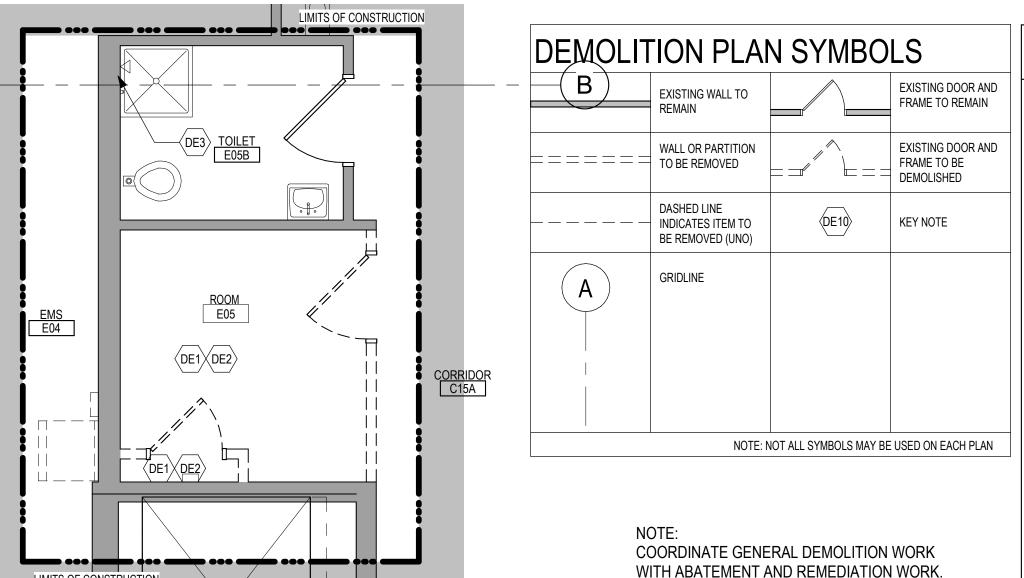

ENLARGED DEMOLITION PLAN - ROOM E05 - BUILDING 5

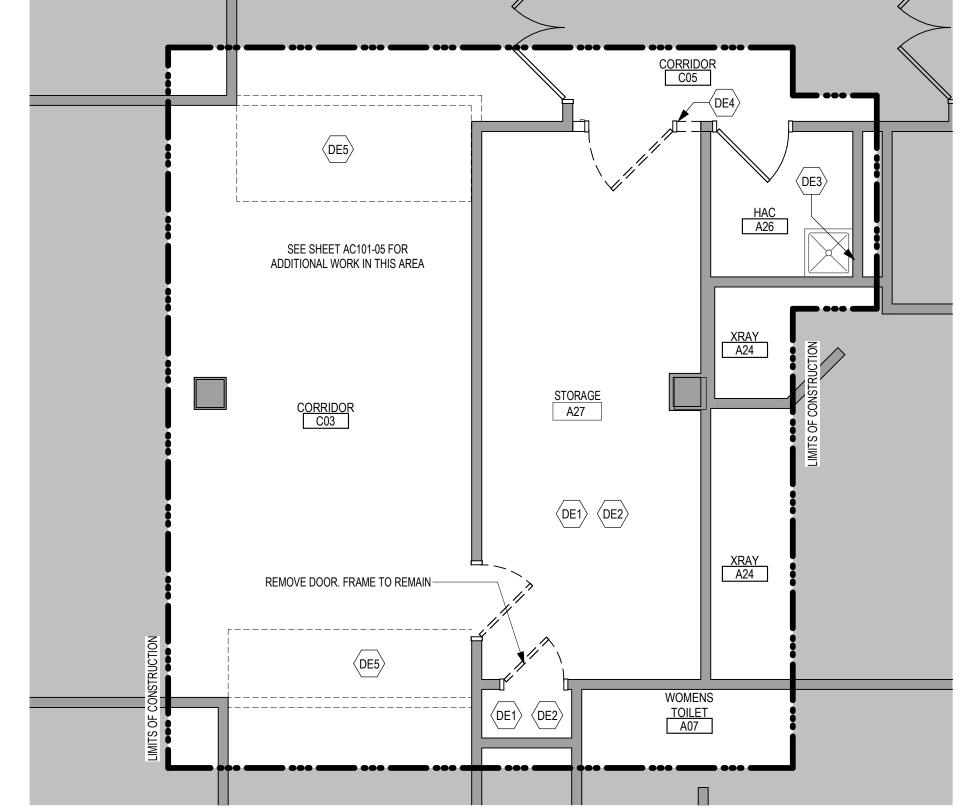

ENLARGED DEMOLITION PLAN - STORAGE A27 - BUILDING 5

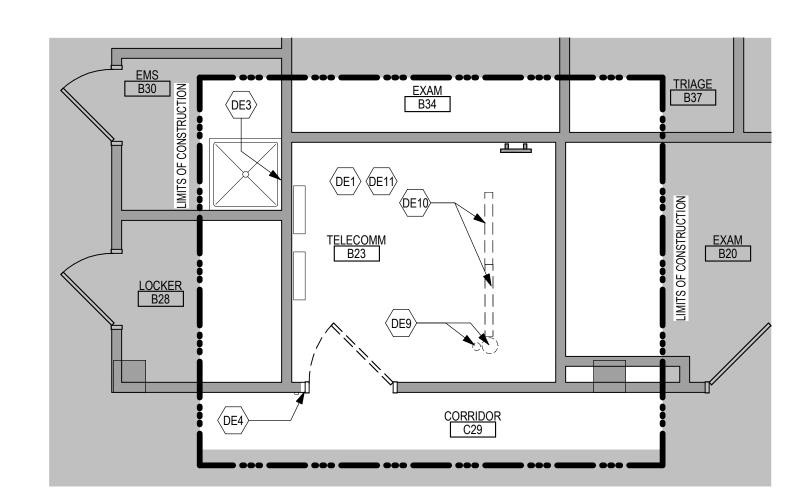

ENLARGED DEMOLITION PLAN - TELECOM B23 - BUILDING 5

DEMOLITION GENERAL NOTES

- GENERAL CONTRACTOR SHALL COORDINATE ALL DEMOLITION WORK, PHASING AND SEQUENCING WITH THE OWNER. ANY INFORMATION REGARDING SEQUENCING PROVIDED IN THESE DOCUMENTS IS FOR ARCHITECT - OWNER PLANNING PURPOSES ONLY, UNLESS NOTED OTHERWISE.
- GENERAL CONTRACTOR SHALL BE RESPONSIBLE FOR COORDINATING WITH ALL

STRUCTURE ABOVE, UNLESS NOTED OTHERWISE.

- TRADES FOR THE DEMOLITION WORK REQUIRED FOR THIS PROJECT. WHERE PARTITIONS ARE INDICATED TO BE REMOVED. REMOVE PARTITION ALONG WITH ALL ITEMS CONTAINED WITHIN, INCLUDING DOORS, FRAMES, HARDWARE, SIDELIGHTS, WINDOWS, MECHANICAL AND ELECTRICAL EQUIPMENT, ETC. TO
- WHERE FLOOR FINISH IS INDICATED TO BE DEMOLISHED, REMOVE FINISH TO FLOOR SLAB AS REQUIRED AND PREPARE SLAB SURFACE FOR SCHEDULED FINISHES WITHIN AREA TO BE REMODELED, UNLESS NOTED OTHERWISE. SEE FINISH SCHEDULE FOR EXISTING FLOOR FINISHES TO REMAIN UNDISTURBED.
- WHERE CEILING IS INDICATED TO BE DEMOLISHED, REMOVE CEILING SUSPENSION SYSTEM ALONG WITH ALL ASSOCIATED MECHANICAL AND ELECTRICAL ITEMS, UNLESS NOTED OTHERWISE. SEE MECHANICAL AND ELECTRICAL DRAWINGS FOR EXTENT OF CONDUIT, PIPING AND DUCTWORK DEMOLITION WITHIN AREA TO BE REMODELED.
- WHERE INDICATED, REMOVE ALL WALL/PARTITION EXISTING FINISHES AND PREPARE THE SURFACES FOR SCHEDULED FINISHES, SEE FINISH SCHEDULE FOR FINISHES.
- ALL DISTURBED AREAS, WALLS, PARTITIONS, FLOORS, ETC, DAMAGED BY DEMOLITION
- WORK SHALL BE PATCHED TO MATCH ADJACENT AREA. OWNER RESERVES THE RIGHT OF FIRST REFUSAL OF ALL SALVAGED ITEMS SUCH AS:
- DOORS, LIGHT FIXTURES, PLUMBING FIXTURES ETC.
- SALVAGED ITEMS SCHEDULED FOR REUSE SHALL BE CLEANED, RESTORED AND/OR REFINISHED TO LIKE NEW CONDITION, UNLESS NOTED OTHERWISE.
- DO NOT REMOVE ANY EXISTING STRUCTURAL SUPPORT MEMBERS SUCH AS

COLUMNS, BEAMS, JOISTS, LOAD-BEARING PARTITIONS ETC, UNTIL ADEQUATE

PERMANENT OR TEMPORARY SUPPORT IS IN PLACE. ALL EXISTING STRUCTURAL


- MEMBERS SHALL BE ADEQUATELY PROTECTED, COORDINATE WITH STRUCTURAL
- SEE STRUCTURAL, MECHANICAL AND ELECTRICAL DRAWINGS FOR RELATED DEMOLITION AND PREP WORK.
- WALL AND CEILING MOUNTED ITEMS SHOWN DASHED, SUCH AS WALL CABINETS, SHELVING, CUBICLE CURTAIN TRACKS, PROJECTION SCREENS ETC, SHALL BE REMOVED, UNLESS NOTED OTHERWISE.
- WITHIN ALL EXISTING ROOMS/SPACES RECEIVING SCHEDULED FLOOR, OR WALL, OR CEILING FINISHES. REMOVE ALL EXISTING FLOOR, OR WALL, OR CEILING FINISHES DOWN TO THE SUBSTRATE. INCLUDE THE REMOVAL OF ALL ITEMS LOCATED WITHIN THE EXISTING FINISH REMOVALS UNO PATCH AND PREP ALL SUBSTRATES TO RECEIVE SCHEDULED FINISHES. FOR ADDITIONAL INFORMATION, SEE KEYNOTED ITEMS, FINISH PLANS AND/OR SCHEDULES, STRUCTURAL, MECHANICAL AND ELECTRICAL.
- THE ARCHITECTURAL DRAWINGS SHOW PRINCIPAL AREAS AND LIMITS OF CONSTRUCTION WHERE WORK MUST BE ACCOMPLISHED UNDER THIS CONTRACT. WORK MUST BE ACCOMPLISHED IN AREAS NOT SHOWN ON ARCHITECTURAL DRAWINGS DUE TO CHANGES AFFECTING ELECTRICAL, MECHANICAL, PLUMBING AND TECHNOLOGY ALONG WITH OTHER SYSTEMS. THIS WORK SHALL BE PART OF THIS CONTRACT, AND ALL TRADES SHALL INSPECT THESE AREAS, ASCERTAIN WORK REQUIRED AND DO THE WORK IN ACCORDANCE OF CONTRACT REQUIREMENTS AT NO ADDITIONAL COST. SEE MECHANICAL, ELECTRICAL, PLUMBING AND TECHNOLOGY PLANS FOR ADDITIONAL WORK.

DEMOLITION PLAN KEYED NOTES

- REMOVE FLOOR FINISH IN ITS ENTIRETY. PATCH & PREP FLOOR FOR SCHEDULED FINISH. SEE SPECIFICATION SECTION 09 05 16 SUBSURFACE
- REMOVE CEILING IN ITS ENTIRETY. INCLUDING ALL MECHANICAL & DE2 ELECTRICAL ITEMS. SEE MECHANICAL / ELECTRICAL.
- REMOVE GYP BD ON ONE SIDE OF PARTITION AS REQUIRED. SEE PLANS AND MECHANICAL / ELECTRICAL PLANS FOR ADDITIONAL INFORMATION
- CUT OPENING IN PARTITION AS REQUIRED FOR INSTALLATION OF DOOR AND FRAME AS SCHEDULED. SEE PLAN
- REMOVE PORTION OF CEILING AS REQUIRED. SEE PLANS FOR ADDITIONAL
- REMOVE PLUMBING FIXTURE AND ALL ASSOCIATED PIPING. -SEE MEP DRAWINGS FOR ADDITIONAL INFORMATION
- REMOVE BASE CABINETS, UPPER CABINETS, TALL CABINETS AND/ OR COUNTERTOP
- REMOVE CEILING IN THIS AREA AS REQUIRED FOR MEP WORK. SALVAGE CEILING WHERE APPROPRIATE FOR REINSTALLATION. SEE PLANS FOR
- REMOVE CONDUITS THOUGH FLOOR. SEE PLAN FOR ADDITIONAL DE9 INFORMATION
- REMOVE PARTITION MOUNTED MIRROR AND ALL ASSOCIATED HARDWARE.
- (DE10) SALVAGE FOR REINSTALLATION REMOVE SURFACE MOUNTED PLYWOOD. TEMPORARILY SUPPORT ANY
- EQUIPMENT. SEE ELECTRICAL AND TECHNOLOGY DRAWINGS FOR ADDITIONAL INFORMATION
- REMOVE COVED CONCRETE BASE AT PARTITION.
- REMOVE PREMANUFACTURED PLASTIC LOCKER(S). SALVAGE FOR DE13 REINSTALLATION
- REMOVE RAISED FLOOR SYSTEM IN ITS ENTIRETY AND METAL RAMP
- REMOVE PORTION OF MEMBRANE ROOFING SYSTEM. SEE FLOOR/ROOF
- PLAN FOR ADDITIONAL INFORMATION
- REMOVE PORTION OF MEMBRANE ROOFING SYSTEM, IN PREPARATION FOR RESLOPING AND REROOFING. SEE FLOOR/ROOF PLAN FOR
- ADDITIONAL INFORMATION REMOVE ROOF DRAIN AND ASSOCIATED PIPING. SEE MECHANICAL FOR ADDITIONAL INFORMATION
- REMOVE METAL LOUVER AND ALL ASSOCIATED MOUNTING HARDWARE. SEE MECHANICAL FOR ADDITIONAL INFORMATION
- CUT OPENING IN BRICK AND METAL STUD BACK UP WALL FOR DOOR AND
- FRAME AS SCHEDULED. SEE FLOOR PLAN FOR ADDITIONAL INFORMATION
- REMOVE PARTIAL HEIGHT CERAMIC TILE AT SINK

REMOVE METAL RADIATOR COVER

- REMOVE SURFACE APPLIED WALL COVERING, TRIM, VINYL BASE AND / OR
- REMOVE DOOR, FRAME AND ALL ASSOCIATED HARDWARE. SALVAGE FOR DE24 REINSTALLATION. SEE PLAN
- REMOVE ALUMINUM WINDOW SYSTEM AND ALL ASSOCIATED HARDWARE. REMOVE CAST STONE SILL, EXTERIOR, AND SOLID SURFACE SILL,
- CUT OPENING IN PARTITION AS REQUIRED FOR INSTALLATION OF EDGE
- DE26 ILLUMINATED PHOTO MURALS SAW CUT FACE BRICK AND REMOVE PORTION OF WALL. SEE PLAN FOR
- ADDITIONAL INFORMATION NOTE: NOT ALL KEYED NOTES MAY BE USED ON EACH PLAN

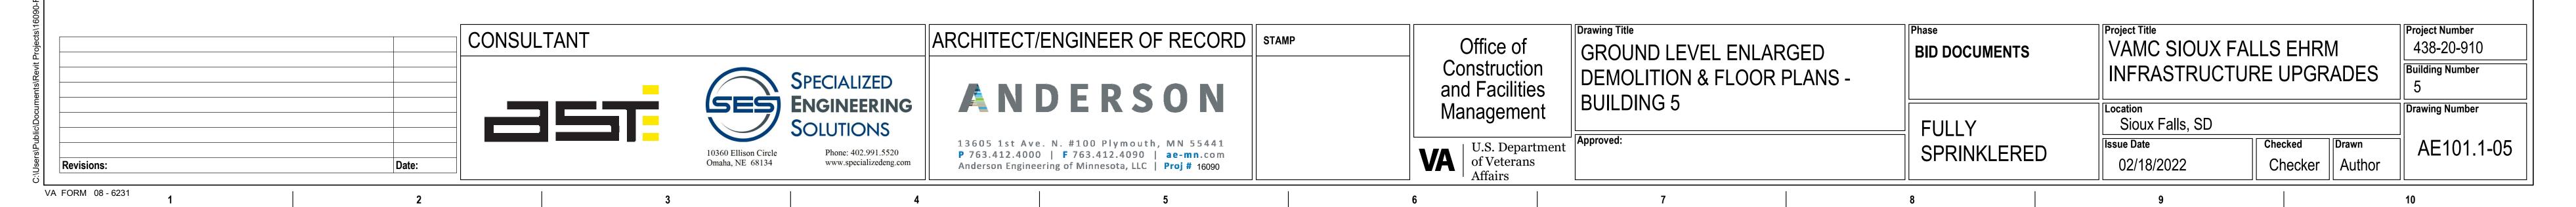

DEMOLITION GENERAL NOTES

- GENERAL CONTRACTOR SHALL COORDINATE ALL DEMOLITION WORK, PHASING AND SEQUENCING WITH THE OWNER. ANY INFORMATION REGARDING SEQUENCING PROVIDED IN THESE DOCUMENTS IS FOR ARCHITECT - OWNER PLANNING PURPOSES
- ONLY, UNLESS NOTED OTHERWISE.
- GENERAL CONTRACTOR SHALL BE RESPONSIBLE FOR COORDINATING WITH ALL TRADES FOR THE DEMOLITION WORK REQUIRED FOR THIS PROJECT. WHERE PARTITIONS ARE INDICATED TO BE REMOVED, REMOVE PARTITION ALONG

STRUCTURE ABOVE, UNLESS NOTED OTHERWISE.

WHERE FLOOR FINISH IS INDICATED TO BE DEMOLISHED, REMOVE FINISH TO FLOOR SLAB AS REQUIRED AND PREPARE SLAB SURFACE FOR SCHEDULED FINISHES WITHIN AREA TO BE REMODELED, UNLESS NOTED OTHERWISE. SEE FINISH SCHEDULE FOR EXISTING FLOOR FINISHES TO REMAIN UNDISTURBED.


WITH ALL ITEMS CONTAINED WITHIN, INCLUDING DOORS, FRAMES, HARDWARE,

SIDELIGHTS, WINDOWS, MECHANICAL AND ELECTRICAL EQUIPMENT, ETC. TO

- WHERE CEILING IS INDICATED TO BE DEMOLISHED, REMOVE CEILING SUSPENSION SYSTEM ALONG WITH ALL ASSOCIATED MECHANICAL AND ELECTRICAL ITEMS, UNLESS NOTED OTHERWISE. SEE MECHANICAL AND ELECTRICAL DRAWINGS FOR EXTENT OF
- CONDUIT, PIPING AND DUCTWORK DEMOLITION WITHIN AREA TO BE REMODELED. WHERE INDICATED, REMOVE ALL WALL/PARTITION EXISTING FINISHES AND PREPARE
- THE SURFACES FOR SCHEDULED FINISHES, SEE FINISH SCHEDULE FOR FINISHES. ALL DISTURBED AREAS, WALLS, PARTITIONS, FLOORS, ETC, DAMAGED BY DEMOLITION WORK SHALL BE PATCHED TO MATCH ADJACENT AREA.
- OWNER RESERVES THE RIGHT OF FIRST REFUSAL OF ALL SALVAGED ITEMS SUCH AS: DOORS, LIGHT FIXTURES, PLUMBING FIXTURES ETC.
- SALVAGED ITEMS SCHEDULED FOR REUSE SHALL BE CLEANED, RESTORED AND/OR
- REFINISHED TO LIKE NEW CONDITION, UNLESS NOTED OTHERWISE.
- DO NOT REMOVE ANY EXISTING STRUCTURAL SUPPORT MEMBERS SUCH AS COLUMNS, BEAMS, JOISTS, LOAD-BEARING PARTITIONS ETC. UNTIL ADEQUATE PERMANENT OR TEMPORARY SUPPORT IS IN PLACE. ALL EXISTING STRUCTURAL MEMBERS SHALL BE ADEQUATELY PROTECTED, COORDINATE WITH STRUCTURAL
- SEE STRUCTURAL, MECHANICAL AND ELECTRICAL DRAWINGS FOR RELATED DEMOLITION AND PREP WORK.
- WALL AND CEILING MOUNTED ITEMS SHOWN DASHED, SUCH AS WALL CABINETS, SHELVING, CUBICLE CURTAIN TRACKS, PROJECTION SCREENS ETC, SHALL BE

REMOVED, UNLESS NOTED OTHERWISE.

- WITHIN ALL EXISTING ROOMS/SPACES RECEIVING SCHEDULED FLOOR, OR WALL, OR CEILING FINISHES, REMOVE ALL EXISTING FLOOR, OR WALL, OR CEILING FINISHES DOWN TO THE SUBSTRATE. INCLUDE THE REMOVAL OF ALL ITEMS LOCATED WITHIN THE EXISTING FINISH REMOVALS UNO PATCH AND PREP ALL SUBSTRATES TO RECEIVE SCHEDULED FINISHES. FOR ADDITIONAL INFORMATION, SEE KEYNOTED ITEMS, FINISH PLANS AND/OR SCHEDULES, STRUCTURAL, MECHANICAL AND ELECTRICAL.
- THE ARCHITECTURAL DRAWINGS SHOW PRINCIPAL AREAS AND LIMITS OF CONSTRUCTION WHERE WORK MUST BE ACCOMPLISHED UNDER THIS CONTRACT. WORK MUST BE ACCOMPLISHED IN AREAS NOT SHOWN ON ARCHITECTURAL DRAWINGS DUE TO CHANGES AFFECTING ELECTRICAL, MECHANICAL, PLUMBING AND TECHNOLOGY ALONG WITH OTHER SYSTEMS. THIS WORK SHALL BE PART OF THIS CONTRACT, AND ALL TRADES SHALL INSPECT THESE AREAS, ASCERTAIN WORK REQUIRED AND DO THE WORK IN ACCORDANCE OF CONTRACT REQUIREMENTS AT NO ADDITIONAL COST. SEE MECHANICAL, ELECTRICAL, PLUMBING AND TECHNOLOGY PLANS FOR ADDITIONAL WORK.

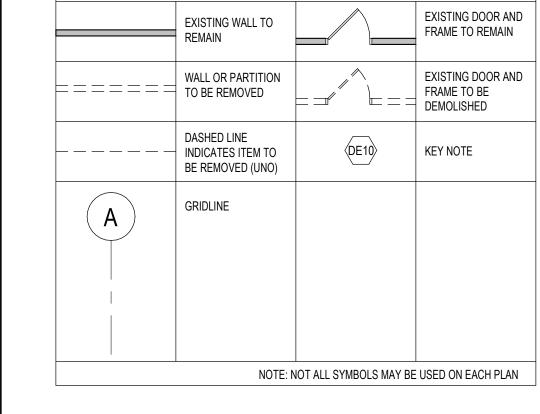

DEMOLITION PLAN KEYED NOTES

- REMOVE FLOOR FINISH IN ITS ENTIRETY. PATCH & PREP FLOOR FOR SCHEDULED FINISH. SEE SPECIFICATION SECTION 09 05 16 SUBSURFACE
- PREPARATION FOR FLOOR FINISHES REMOVE CEILING IN ITS ENTIRETY. INCLUDING ALL MECHANICAL &
- ELECTRICAL ITEMS. SEE MECHANICAL / ELECTRICAL. REMOVE GYP BD ON ONE SIDE OF PARTITION AS REQUIRED. SEE PLANS AND MECHANICAL / ELECTRICAL PLANS FOR ADDITIONAL INFORMATION
- DE4 CUT OPENING IN PARTITION AS REQUIRED FOR INSTALLATION OF DOOR AND FRAME AS SCHEDULED. SEE PLAN
- DE5 REMOVE PORTION OF CEILING AS REQUIRED. SEE PLANS FOR ADDITIONAL INFORMATION
- INFORMATION REMOVE PLUMBING FIXTURE AND ALL ASSOCIATED PIPING. -SEE MEP
- DE6 REMOVE PLUMBING FIXTURE AND ALL ASSOCIATION DRAWINGS FOR ADDITIONAL INFORMATION DET REMOVE BASE CABINETS, UPPER CABINETS, TALL CABINETS AND/ OR COUNTERTOP
- REMOVE CEILING IN THIS AREA AS REQUIRED FOR MEP WORK. SALVAGE CEILING WHERE APPROPRIATE FOR REINSTALLATION. SEE PLANS FOR
- ADDITIONAL WORK DE9 REMOVE CONDUITS THOUGH FLOOR. SEE PLAN FOR ADDITIONAL INFORMATION
- REMOVE PARTITION SALVAGE FOR REINSTALLATION REMOVE PARTITION MOUNTED MIRROR AND ALL ASSOCIATED HARDWARE.
- REMOVE SURFACE MOUNTED PLYWOOD. TEMPORARILY SUPPORT ANY EQUIPMENT. SEE ELECTRICAL AND TECHNOLOGY DRAWINGS FOR ADDITIONAL INFORMATION
- (DE12) REMOVE COVED CONCRETE BASE AT PARTITION.
- DE13 REMOVE PREMANUFACTURED PLASTIC LOCKER(S). SALVAGE FOR REINSTALLATION
- REMOVE RAISED FLOOR SYSTEM IN ITS ENTIRETY AND METAL RAMP
- REMOVE PORTION OF MEMBRANE ROOFING SYSTEM. SEE FLOOR/ROOF PLAN FOR ADDITIONAL INFORMATION
- REMOVE PORTION OF MEMBRANE ROOFING SYSTEM, IN PREPARATION FOR RESLOPING AND REROOFING. SEE FLOOR/ROOF PLAN FOR
- ADDITIONAL INFORMATION REMOVE ROOF DRAIN AND ASSOCIATED PIPING. SEE MECHANICAL FOR ADDITIONAL INFORMATION
- DE18 not used
- ©E19 CUT OPENING IN BRICK AND METAL STUD BACK UP WALL FOR DOOR AND FRAME AS SCHEDULED. SEE FLOOR PLAN FOR ADDITIONAL INFORMATION
- DE20 REMOVE PARTIAL HEIGHT CERAMIC TILE AT SINK
- (DE21) REMOVE METAL RADIATOR COVER
- REMOVE SURFACE APPLIED WALL COVERING, TRIM, VINYL BASE AND / OR CRASH / HAND RAIL AS NEEDED. REMOVE DOOR, FRAME AND ALL ASSOCIATED HARDWARE. SALVAGE FOR
- REINSTALLATION. SEE PLAN REMOVE ALUMINUM WINDOW SYSTEM AND ALL ASSOCIATED HARDWARE.
- REMOVE CAST STONE SILL, EXTERIOR, AND SOLID SURFACE SILL,
- CUT OPENING IN PARTITION AS REQUIRED FOR INSTALLATION OF EDGE ILLUMINATED PHOTO MURALS
- SAW CUT FACE BRICK AND REMOVE PORTION OF WALL. SEE PLAN FOR ADDITIONAL INFORMATION

NOTE: NOT ALL KEYED NOTES MAY BE USED ON EACH PLAN

FLOOR PLAN KEYED NOTES

- PATCH PARTITION, BOTH SIDES, AS REQUIRED FROM MECHANICAL / ELECTRICAL WORK. SEE MECHANICAL / ELECTRICAL FOR ADDITIONAL
- PROVIDE PARTITION TYPE XP3 INFILL AT REMOVED RADIATOR GRILLS. PATCH PARTITION, WITH MATERIALS TO MATCH EXISTING ADJACENT
- WHERE PATCHING OCCURS. INFILL FLOOR TO MATCH EXISTING HEIGHT. SEE STRUCTURAL
- PATCH PARTITION, WITH MATERIALS TO MATCH EXISTING ADJACENT SURFACES, AS REQUIRED FROM DEMOLITION. WHERE EXISTING FINISHES ARE DISTURBED PAINT TO MATCH ADJACENT FINISH, PAINT ENTIRE WALL OF EXISTING INTERIOR SPACES WHERE PATCHING OCCURS.

SURFACES. WHERE EXISTING FINISHES ARE DISTURBED PAINT TO MATCH

ADJACENT FINISH, PAINT ENTIRE WALL OF EXISTING INTERIOR SPACES

- PROVIDE PLYWOOD 3 SIDES OF ROOM. SEE TYPICAL ELEVATIONS SHEET
- INFILL OPENING IN CONCRETE FLOOR. SEE STRUCTURAL FOR ADDITIONAL / INFORMATION. PREP FLOOR FOR FINISHES AS SCHEDULED.
- PATCH FLOOR AT REMOVED ELECTRICAL. PREP FLOOR FOR FINISHES AS SCHEDULED.
- FL8 REINSTALL SALVAGED DOOR, FRAME AND ALL ASSOCIATED HARDWARE.
- REINSTALL SALVAGED LOCKER(S). PROVIDE PREMANUFACTURED BASE, FINISHED END PANEL(S) AND SLOPED TOP(S) TO MATCH EXISTING.
- FL10 REINSTALL SALVAGED SIGN(S)
- REINSTALL SALVAGED CEILING REMOVED FOR INSTALLATION OF MEP ITEMS. SEE MEP PLANS FOR ADDITIONAL INFORMATION
- MODIFY BASE AND SLOPED TOP AT EXISTING LOCKERS. PROVIDE PREMANUFACTURED FINISHED END PANEL(S) TO MATCH EXISTING.
- PATCH EXISTING FINISHES DISTURBED BY CONSTRUCTION; WALL AND CEILING. CONTRACTOR TO PROVIDE LABOR AND MATERIALS. REFER TO
- PATCH FLOORING TO MATCH EXISTING FLOORING AS REQUIRED.

CONTRACTOR TO PROVIDE LABOR AND MATERIALS.

PATCH CONCRETE FLOOR AT REMOVED PARTITION AND/OR CONCRETE COVE BASE. PREP FOR FINISHES AS SCHEDULED.

MATERIAL AND ROOM FINISH SCHEDULE AND DETAIL 3 / AF600

FL16 EDGE ILLUMINATED PHOTO MURALS, RECESSED IN PARTITION. FOR ADDITIONAL INFORMATION SEE ELEVATION 8 / AE211 FL17 FINISH WALLS TO MATCH EXISTING. CONTRACTOR TO PROVIDE LABOR AND

MATERIALS. REFER TO MATERIAL AND ROOM FINISH SCHEDULE AND

FL18 PAINT WALLS P-1

DETAIL 2 / AF600

- > PATCH EXISTING FINISHES DISTURBED BY CONSTRUCTION: WALL AND $\langle -119 \rangle$ CEILING. CONTRACTOR TO PROVIDE LABOR AND MATERIALS. REFER TO
- FINISH WALLS TO MATCH EXISTING. CONTRACTOR TO PROVIDE LABOR AND MATERIALS. REFER TO MATERIAL AND ROOM FINISH SCHEDULE AND DETAIL 5 / AF600

MATERIAL AND ROOM FINISH SCHEDULE AND DETAIL 4 / AF600

PATCH EXISTING FINISHES DISTURBED BY CONSTRUCTION; WALL AND CEILING. CONTRACTOR TO PROVIDE LABOR AND MATERIALS. REFER TO MATERIAL AND ROOM FINISH SCHEDULE AND DETAIL 6 / AF600

NOTE: NOT ALL KEYED NOTES MAY BE USED ON EACH PLAN

GENERAL NOTES

- THE ARCHITECTURAL DRAWINGS SHOW PRINCIPAL AREAS AND LIMITS OF CONSTRUCTION WHERE WORK MUST BE ACCOMPLISHED UNDER THIS CONTRACT. WORK MUST BE ACCOMPLISHED IN AREAS NOT SHOWN ON ARCHITECTURAL DRAWINGS DUE TO CHANGES AFFECTING ELECTRICAL, MECHANICAL, PLUMBING AND TECHNOLOGY ALONG WITH OTHER SYSTEMS. THIS WORK SHALL BE PART OF THIS CONTRACT, AND ALL TRADES SHALL INSPECT THESE AREAS, ASCERTAIN WORK REQUIRED AND DO THE WORK IN ACCORDANCE OF CONTRACT REQUIREMENTS AT NO ADDITIONAL COST. SEE MECHANICAL, ELECTRICAL, PLUMBING AND TECHNOLOGY PLANS FOR ADDITIONAL WORK.
- CONTRACTORS SHALL VISIT THE SITE DURING BIDDING TO BECOME FAMILIAR WITH THE EXISTING CONDITIONS. THE GENERAL CONTRACTOR SHALL LOCATE, INSPECT AND FIELD VERIFY ALL EXISTING CONDITIONS, DIMENSIONS AND ELEVATIONS PRIOR TO DEMOLITION AND CONSTRUCTION. NOTIFY ARCHITECT IMMEDIATELY OF ANY DISCREPANCIES.
 - DO NOT SCALE DRAWINGS. NOTIFY ARCHITECT IMMEDIATELY OF ANY DISCREPANCIES.
- WHEREVER OPENINGS ARE CUT THROUGH FIRE RATED PARTITIONS, IT SHALL BE THE RESPONSIBILITY OF THE CONTRACTOR FOR WHOM THE HOLE IS CUT TO PATCH AND REPAIR ANY OPENING TO MAINTAIN THE INTEGRITY OF THE FIRE RATING.
- GENERAL CONTRACTOR TO CHECK MECHANICAL DRAWINGS FOR EXISTING PIPES AND DUCTS FURRED IN WALLS. VERIFY SIZE AND LOCATION WITH MECHANICAL CONTRACTOR PRIOR TO PROCEEDING WITH REMODELING.
- FIREPROOFING SHALL BE UNPIERCED. ANY SUBCONTRACTOR PENETRATING THE FIREPROOFING SHALL BE REQUIRED TO REPLACE FIREPROOFING TO THE ORIGINAL CONDITION AND FIRE
- RATING, AT THE SUBCONTRACTORS EXPENSE.
- EQUIPMENT UNIT DIMENSIONS ARE FOR PRODUCT DESCRIPTION ONLY, VERIFY SIZE WITH
- ALL DIMENSIONS PERTAINING TO MECHANICAL OR ELECTRICAL SERVICES OR EQUIPMENT SHALL
- BE VERIFIED WITH THE RESPECTIVE TRADE.
- ALL CONTRACTORS THAT PENETRATE AND/OR DISTURB ANY AREAS AT EXISTING CONDITIONS SHALL PATCH AREA TO MATCH EXISTING ADJACENT AREA OR SURFACE AND PREPARE FOR SCHEDULED FINISH APPLICATION. COORDINATE WORK WITH GENERAL CONTRACTOR PRIOR TO
- VERIFY HEIGHTS AND LOCATIONS OF ACCESS PANELS (AP) AND COORDINATE TYPES WITH TRADES WHICH REQUIRE THEM.
- PROVIDE LINTELS AND FRAMING FOR GRILLES, LOUVERS, AND ROOF VENTS AS REQUIRED BY MECHANICAL CONTRACTOR, VERIFY SIZE AND LOCATION.
- STRUCTURAL, MECHANICAL, AND ELECTRICAL ABBREVIATIONS AND SYMBOLS MAY DIFFER FROM
- ARCHITECTURAL. SEE RESPECTIVE SECTIONS AND/OR DRAWINGS FOR DEFINITIONS. AT MECHANICAL AND ELECTRICAL EQUIPMENT ROOMS, PROVIDE 3/4" FRT PLYWOOD BACKING

BEHIND ALL SURFACE MOUNTED FIXTURES AND EQUIPMENT, UNLESS NOTED OTHERWISE.

CONTRACTOR SHALL EVALUATE INTEGRITY OF ALL PARTITIONS INDICATED BY SYMBOLS ON THE LIFE SAFETY PLAN(S) WITHIN THE PROJECT SCOPE AND UPGRADE AS REQUIRED. ALL FIRE RESISTIVE RATED WALLS SHALL BE CONSTRUCTED OF MATERIALS / ASSEMBLIES MEETING THE RATING INDICATED, TERMINATE AT THE DECK ABOVE WITH A TESTED HEAD OF WALL ASSEMBLY AND ALL PENETRATIONS SHALL BE SEALED WITH A TESTED ASSEMBLY. ALL SMOKE PARTITIONS SHALL BE CONSTRUCTED OF MATERIALS THAT RESIST THE PASSAGE OF SMOKE, TERMINATE AT THE DECK ABOVE WITH A JOINT SEALED WITH FIRE CAULK AND ALL PENETRATIONS SHALL BE


SEALED WITH FIRE CAULK.

FLOOR PLAN SYMBOLS DIMENSION LINE, REMAIN DIMENSION LINE, EXISTING DOOR AND INTERIOR ELEVATION INDICATOR TAG EXTERIOR ELEVATION INDICATOR TAG INTERIOR BORROWED LIGHT **EQUIPMENT TAG** ROOM NAME AND DETAIL REFERENCE 101 (FP10) KEY NOTE INTERIOR SECTION EXTERIOR SECTION REFERENCE TAG REFERENCE TAG **REVISION TAG** REVISION CLOUD / PR01 $^{\setminus}$ 99.3 SIGN TAG NOTE: NOT ALL SYMBOLS MAY BE USED ON EACH PLAN



Drawing Title

ENLARGED PLAN - EMS G34 - BUILDING 5

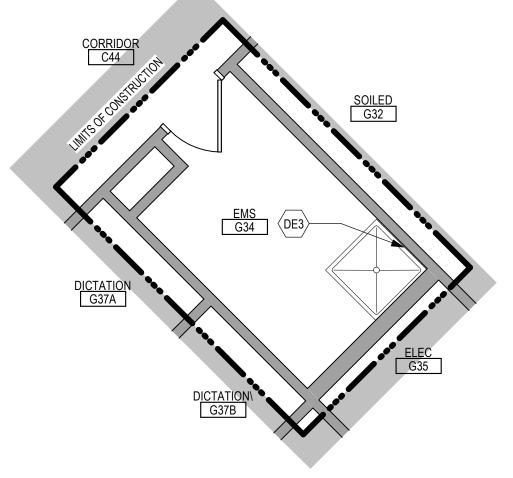

ENLARGED DEMOLITION PLAN - EMS G34 - BUILDING 5

Revisions:

CONSULTANT

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ENLARGED PLAN - TELECOM H1 - CONFERENCE H2 - BUILDING 5

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Office of Construction and Facilities Management

U.S. Department of Veterans

DEMOLITION & FLOOR PLANS -BUILDING 5

GROUND LEVEL ENLARGED

FULLY

SPRINKLERED

VAMC SIOUX FALLS EHRM BID DOCUMENTS INFRASTRUCTURE UPGRADES

Drawing Number Sioux Falls, SD Checked Drawn 07/06/2021 Checker | Author


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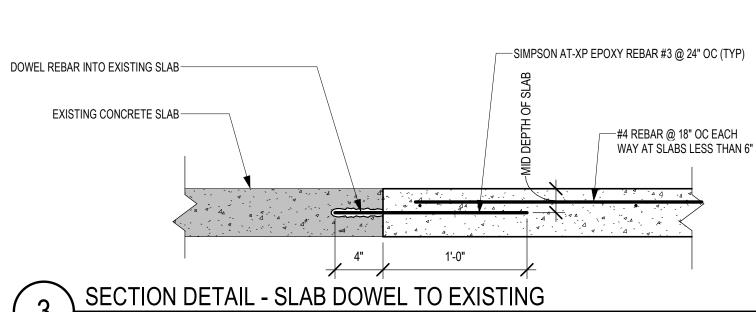
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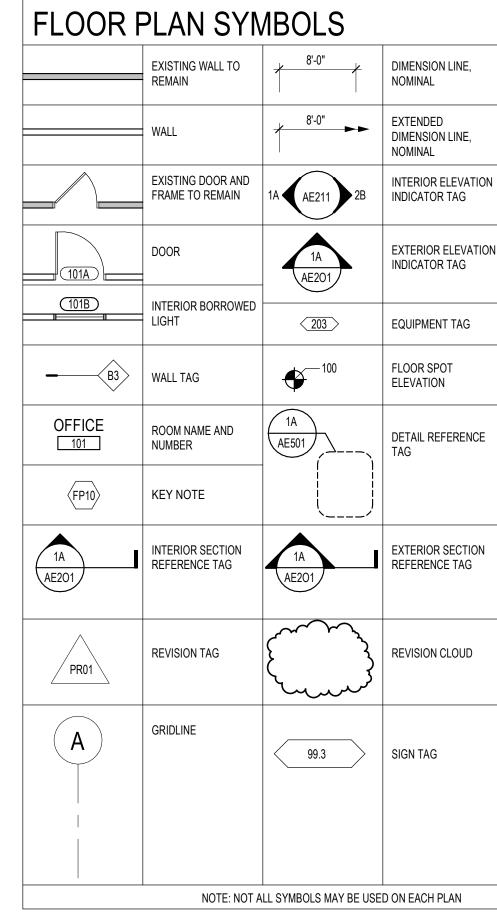
Building Number

438-20-910

VA FORM 08 - 6231





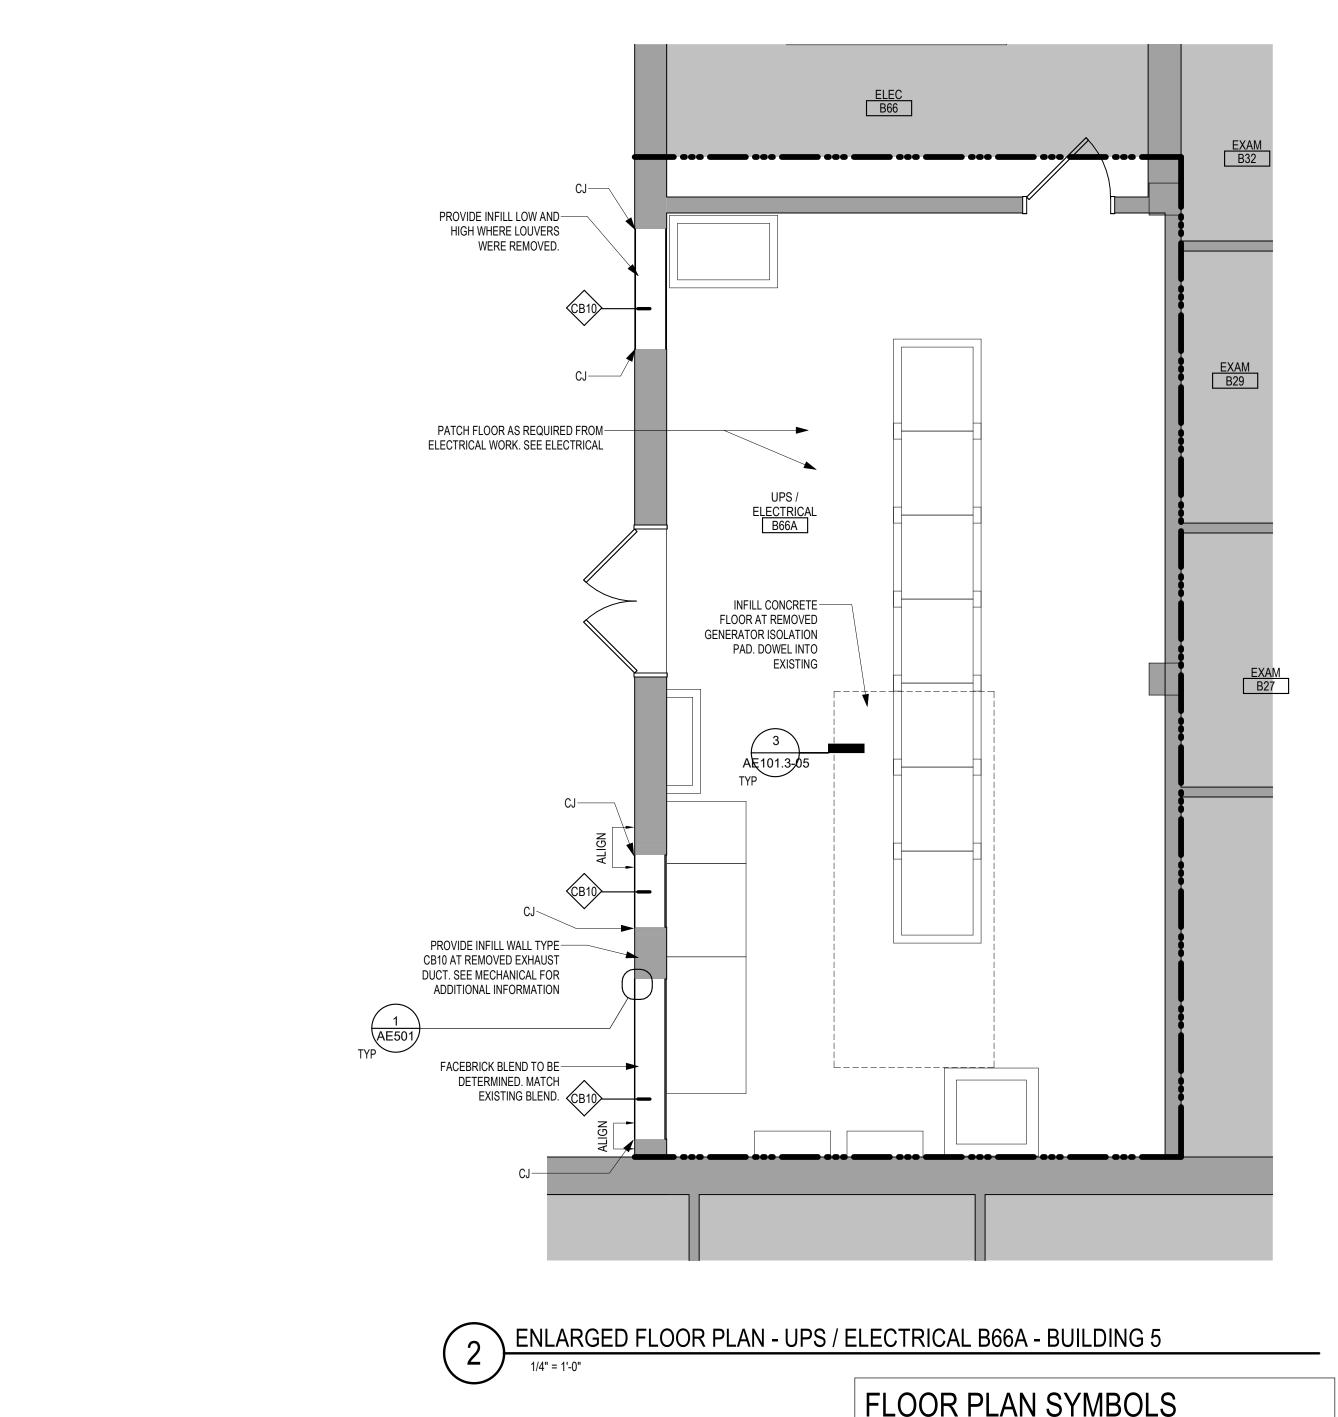

GENERAL NOTES

- THE ARCHITECTURAL DRAWINGS SHOW PRINCIPAL AREAS AND LIMITS OF CONSTRUCTION WHERE WORK MUST BE ACCOMPLISHED UNDER THIS CONTRACT. WORK MUST BE ACCOMPLISHED IN AREAS NOT SHOWN ON ARCHITECTURAL DRAWINGS DUE TO CHANGES AFFECTING ELECTRICAL, MECHANICAL, PLUMBING AND TECHNOLOGY ALONG WITH OTHER SYSTEMS. THIS WORK SHALL BE PART OF THIS CONTRACT, AND ALL TRADES SHALL INSPECT THESE AREAS, ASCERTAIN WORK REQUIRED AND DO THE WORK IN ACCORDANCE OF CONTRACT REQUIREMENTS AT NO ADDITIONAL COST. SEE MECHANICAL, ELECTRICAL, PLUMBING AND TECHNOLOGY PLANS FOR ADDITIONAL WORK.
- CONTRACTORS SHALL VISIT THE SITE DURING BIDDING TO BECOME FAMILIAR WITH THE EXISTING CONDITIONS. THE GENERAL CONTRACTOR SHALL LOCATE, INSPECT AND FIELD VERIFY

ALL EXISTING CONDITIONS, DIMENSIONS AND ELEVATIONS PRIOR TO DEMOLITION AND

- CONSTRUCTION. NOTIFY ARCHITECT IMMEDIATELY OF ANY DISCREPANCIES. DO NOT SCALE DRAWINGS. NOTIFY ARCHITECT IMMEDIATELY OF ANY DISCREPANCIES.
- WHEREVER OPENINGS ARE CUT THROUGH FIRE RATED PARTITIONS, IT SHALL BE THE RESPONSIBILITY OF THE CONTRACTOR FOR WHOM THE HOLE IS CUT TO PATCH AND REPAIR ANY OPENING TO MAINTAIN THE INTEGRITY OF THE FIRE RATING.
- GENERAL CONTRACTOR TO CHECK MECHANICAL DRAWINGS FOR EXISTING PIPES AND DUCTS FURRED IN WALLS. VERIFY SIZE AND LOCATION WITH MECHANICAL CONTRACTOR PRIOR TO PROCEEDING WITH REMODELING.
- FIREPROOFING SHALL BE UNPIERCED. ANY SUBCONTRACTOR PENETRATING THE FIREPROOFING SHALL BE REQUIRED TO REPLACE FIREPROOFING TO THE ORIGINAL CONDITION AND FIRE

RATING, AT THE SUBCONTRACTORS EXPENSE.

- EQUIPMENT UNIT DIMENSIONS ARE FOR PRODUCT DESCRIPTION ONLY, VERIFY SIZE WITH MANUFACTURER.
- ALL DIMENSIONS PERTAINING TO MECHANICAL OR ELECTRICAL SERVICES OR EQUIPMENT SHALL BE VERIFIED WITH THE RESPECTIVE TRADE.
- ALL CONTRACTORS THAT PENETRATE AND/OR DISTURB ANY AREAS AT EXISTING CONDITIONS SHALL PATCH AREA TO MATCH EXISTING ADJACENT AREA OR SURFACE AND PREPARE FOR SCHEDULED FINISH APPLICATION. COORDINATE WORK WITH GENERAL CONTRACTOR PRIOR TO
- VERIFY HEIGHTS AND LOCATIONS OF ACCESS PANELS (AP) AND COORDINATE TYPES WITH TRADES WHICH REQUIRE THEM.
- PROVIDE LINTELS AND FRAMING FOR GRILLES, LOUVERS, AND ROOF VENTS AS REQUIRED BY MECHANICAL CONTRACTOR, VERIFY SIZE AND LOCATION.
- STRUCTURAL, MECHANICAL, AND ELECTRICAL ABBREVIATIONS AND SYMBOLS MAY DIFFER FROM ARCHITECTURAL. SEE RESPECTIVE SECTIONS AND/OR DRAWINGS FOR DEFINITIONS.
- AT MECHANICAL AND ELECTRICAL EQUIPMENT ROOMS, PROVIDE 3/4" FRT PLYWOOD BACKING

BEHIND ALL SURFACE MOUNTED FIXTURES AND EQUIPMENT, UNLESS NOTED OTHERWISE.

CONTRACTOR SHALL EVALUATE INTEGRITY OF ALL PARTITIONS INDICATED BY SYMBOLS ON THE LIFE SAFETY PLAN(S) WITHIN THE PROJECT SCOPE AND UPGRADE AS REQUIRED. ALL FIRE RESISTIVE RATED WALLS SHALL BE CONSTRUCTED OF MATERIALS / ASSEMBLIES MEETING THE RATING INDICATED, TERMINATE AT THE DECK ABOVE WITH A TESTED HEAD OF WALL ASSEMBLY AND ALL PENETRATIONS SHALL BE SEALED WITH A TESTED ASSEMBLY. ALL SMOKE PARTITIONS SHALL BE CONSTRUCTED OF MATERIALS THAT RESIST THE PASSAGE OF SMOKE, TERMINATE AT THE DECK ABOVE WITH A JOINT SEALED WITH FIRE CAULK AND ALL PENETRATIONS SHALL BE SEALED WITH FIRE CAULK.


FLOOR PLAN KEYED NOTES

- PATCH PARTITION, BOTH SIDES, AS REQUIRED FROM MECHANICAL ELECTRICAL WORK. SEE MECHANICAL / ELECTRICAL FOR ADDITIONAL
- PROVIDE PARTITION TYPE XP3 INFILL AT REMOVED RADIATOR GRILLS. PATCH PARTITION, WITH MATERIALS TO MATCH EXISTING ADJACENT SURFACES. WHERE EXISTING FINISHES ARE DISTURBED PAINT TO MATCH ADJACENT FINISH, PAINT ENTIRE WALL OF EXISTING INTERIOR SPACES
- WHERE PATCHING OCCURS. INFILL FLOOR TO MATCH EXISTING HEIGHT. SEE STRUCTURAL
- PATCH PARTITION, WITH MATERIALS TO MATCH EXISTING ADJACENT SURFACES, AS REQUIRED FROM DEMOLITION. WHERE EXISTING FINISHES ARE DISTURBED PAINT TO MATCH ADJACENT FINISH, PAINT ENTIRE WALL OF EXISTING INTERIOR SPACES WHERE PATCHING OCCURS.
- PROVIDE PLYWOOD 3 SIDES OF ROOM. SEE TYPICAL ELEVATIONS SHEET
- INFILL OPENING IN CONCRETE FLOOR. SEE STRUCTURAL FOR ADDITIONAL INFORMATION. PREP FLOOR FOR FINISHES AS SCHEDULED.

PATCH FLOOR AT REMOVED ELECTRICAL. PREP FLOOR FOR FINISHES AS

- REINSTALL SALVAGED DOOR, FRAME AND ALL ASSOCIATED HARDWARE.
- REINSTALL SALVAGED LOCKER(S). PROVIDE PREMANUFACTURED BASE, FL9 FINISHED END PANEL(S) AND SLOPED TOP(S) TO MATCH EXISTING.
- (FL10) REINSTALL SALVAGED SIGN(S)
- REINSTALL SALVAGED CEILING REMOVED FOR INSTALLATION OF MEP ITEMS. SEE MEP PLANS FOR ADDITIONAL INFORMATION
- MODIFY BASE AND SLOPED TOP AT EXISTING LOCKERS. PROVIDE PREMANUFACTURED FINISHED END PANEL(S) TO MATCH EXISTING.
- PATCH EXISTING FINISHES DISTURBED BY CONSTRUCTION; WALL AND CEILING. CONTRACTOR TO PROVIDE LABOR AND MATERIALS. REFER TO MATERIAL AND ROOM FINISH SCHEDULE AND DETAIL 3 / AF600
- PATCH FLOORING TO MATCH EXISTING FLOORING AS REQUIRED. CONTRACTOR TO PROVIDE LABOR AND MATERIALS.
- PATCH CONCRETE FLOOR AT REMOVED PARTITION AND/OR CONCRETE COVE BASE. PREP FOR FINISHES AS SCHEDULED.
- EDGE ILLUMINATED PHOTO MURALS, RECESSED IN PARTITION. FOR
- ADDITIONAL INFORMATION SEE ELEVATION 8 / AE211
- FINISH WALLS TO MATCH EXISTING. CONTRACTOR TO PROVIDE LABOR AND MATERIALS: REFER TO MATERIAL AND ROOM FINISH SCHEDULE AND DETAIL 2 / AF600
- PAINT WALLS P-1
- PATCH EXISTING FINISHES DISTURBED BY CONSTRUCTION; WALL AND CEILING. CONTRACTOR TO PROVIDE LABOR AND MATERIALS. REFER TO MATERIAL AND ROOM FINISH SCHEDULE AND DETAIL 4 / AF600
- FINISH WALLS TO MATCH EXISTING. CONTRACTOR TO PROVIDE LABOR AND MATERIALS. REFER TO MATERIAL AND ROOM FINISH SCHEDULE AND DETAIL 5 / AF600
- PATCH EXISTING FINISHES DISTURBED BY CONSTRUCTION; WALL AND CEILING. CONTRACTOR TO PROVIDE LABOR AND MATERIALS. REFER TO MATERIAL AND ROOM FINISH SCHEDULE AND DETAIL 6 / AF600

NOTE: NOT ALL KEYED NOTES MAY BE USED ON EACH PLAN

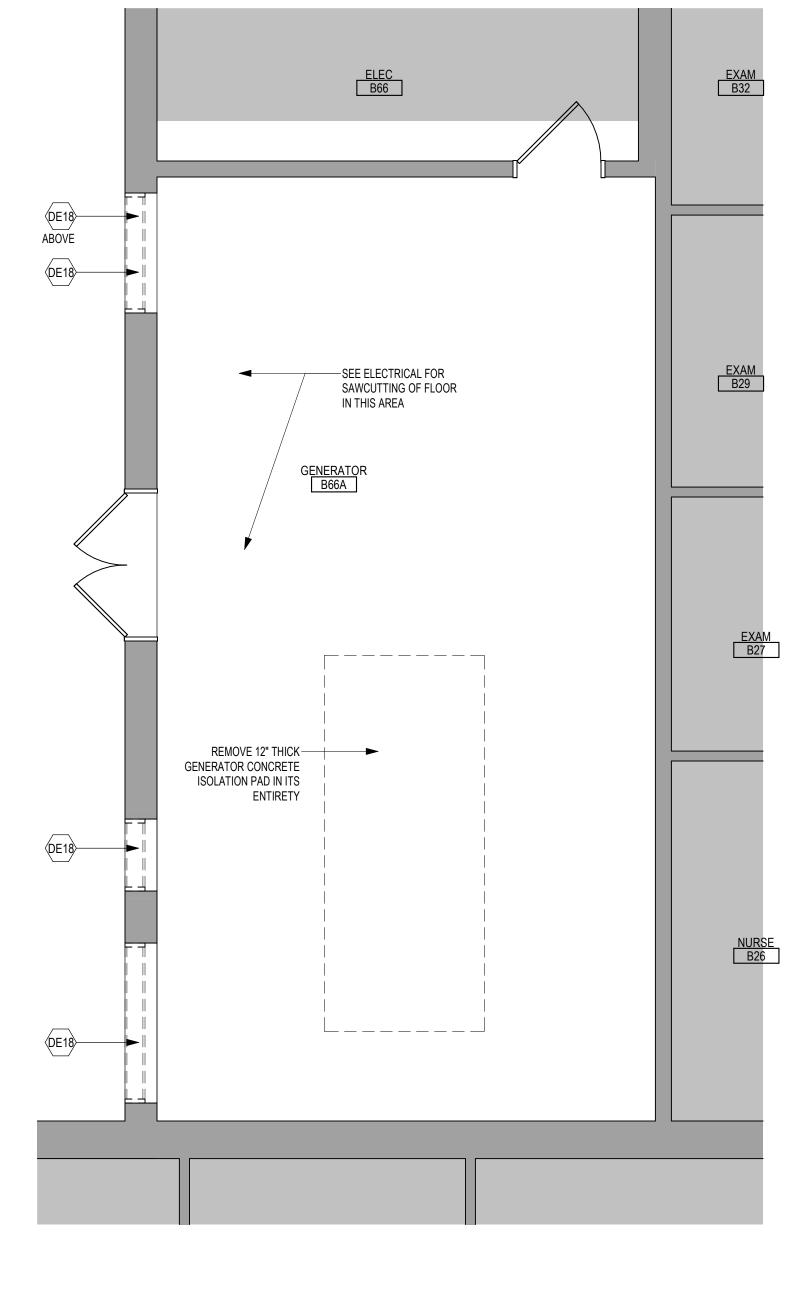

ENLARGED DEMOLITION PLAN - GENERATOR B66A - BUILDING 5

DEMOLITION PLAN SYMBOLS FRAME TO REMAIN RFMAIN EXISTING DOOR AND WALL OR PARTITION = = = = = = = TO BE REMOVED FRAME TO BE DEMOLISHED DASHED LINE (DE10) KEY NOTE ---- INDICATES ITEM TO BE REMOVED (UNO) NOTE: NOT ALL SYMBOLS MAY BE USED ON EACH PLAN

DEMOLITION GENERAL NOTES

- GENERAL CONTRACTOR SHALL COORDINATE ALL DEMOLITION WORK, PHASING AND SEQUENCING WITH THE OWNER. ANY INFORMATION REGARDING SEQUENCING PROVIDED IN THESE DOCUMENTS IS FOR ARCHITECT - OWNER PLANNING PURPOSES ONLY, UNLESS NOTED OTHERWISE.
- GENERAL CONTRACTOR SHALL BE RESPONSIBLE FOR COORDINATING WITH ALL
- TRADES FOR THE DEMOLITION WORK REQUIRED FOR THIS PROJECT. WHERE PARTITIONS ARE INDICATED TO BE REMOVED, REMOVE PARTITION ALONG WITH ALL ITEMS CONTAINED WITHIN, INCLUDING DOORS, FRAMES, HARDWARE,

SIDELIGHTS, WINDOWS, MECHANICAL AND ELECTRICAL EQUIPMENT, ETC. TO

STRUCTURE ABOVE, UNLESS NOTED OTHERWISE. WHERE FLOOR FINISH IS INDICATED TO BE DEMOLISHED, REMOVE FINISH TO FLOOR SLAB AS REQUIRED AND PREPARE SLAB SURFACE FOR SCHEDULED FINISHES WITHIN AREA TO BE REMODELED, UNLESS NOTED OTHERWISE. SEE FINISH SCHEDULE FOR

EXISTING FLOOR FINISHES TO REMAIN UNDISTURBED.

- WHERE CEILING IS INDICATED TO BE DEMOLISHED, REMOVE CEILING SUSPENSION SYSTEM ALONG WITH ALL ASSOCIATED MECHANICAL AND ELECTRICAL ITEMS, UNLESS NOTED OTHERWISE. SEE MECHANICAL AND ELECTRICAL DRAWINGS FOR EXTENT OF
- CONDUIT, PIPING AND DUCTWORK DEMOLITION WITHIN AREA TO BE REMODELED.
- THE SURFACES FOR SCHEDULED FINISHES, SEE FINISH SCHEDULE FOR FINISHES.

WHERE INDICATED, REMOVE ALL WALL/PARTITION EXISTING FINISHES AND PREPARE

- ALL DISTURBED AREAS, WALLS, PARTITIONS, FLOORS, ETC, DAMAGED BY DEMOLITION WORK SHALL BE PATCHED TO MATCH ADJACENT AREA.
- OWNER RESERVES THE RIGHT OF FIRST REFUSAL OF ALL SALVAGED ITEMS SUCH AS: DOORS, LIGHT FIXTURES, PLUMBING FIXTURES ETC.

COLUMNS, BEAMS, JOISTS, LOAD-BEARING PARTITIONS ETC, UNTIL ADEQUATE

PERMANENT OR TEMPORARY SUPPORT IS IN PLACE. ALL EXISTING STRUCTURAL

MEMBERS SHALL BE ADEQUATELY PROTECTED, COORDINATE WITH STRUCTURAL

- SALVAGED ITEMS SCHEDULED FOR REUSE SHALL BE CLEANED. RESTORED AND/OR REFINISHED TO LIKE NEW CONDITION, UNLESS NOTED OTHERWISE.
- DO NOT REMOVE ANY EXISTING STRUCTURAL SUPPORT MEMBERS SUCH AS
- SEE STRUCTURAL, MECHANICAL AND ELECTRICAL DRAWINGS FOR RELATED

DEMOLITION AND PREP WORK.

PLANS FOR ADDITIONAL WORK.

REMOVED, UNLESS NOTED OTHERWISE.

- WALL AND CEILING MOUNTED ITEMS SHOWN DASHED, SUCH AS WALL CABINETS, SHELVING, CUBICLE CURTAIN TRACKS, PROJECTION SCREENS ETC, SHALL BE
- WITHIN ALL EXISTING ROOMS/SPACES RECEIVING SCHEDULED FLOOR, OR WALL, OR CEILING FINISHES, REMOVE ALL EXISTING FLOOR, OR WALL, OR CEILING FINISHES DOWN TO THE SUBSTRATE. INCLUDE THE REMOVAL OF ALL ITEMS LOCATED WITHIN THE EXISTING FINISH REMOVALS UNO PATCH AND PREP ALL SUBSTRATES TO RECEIVE SCHEDULED FINISHES. FOR ADDITIONAL INFORMATION, SEE KEYNOTED ITEMS, FINISH PLANS AND/OR SCHEDULES, STRUCTURAL, MECHANICAL AND
- THE ARCHITECTURAL DRAWINGS SHOW PRINCIPAL AREAS AND LIMITS OF CONSTRUCTION WHERE WORK MUST BE ACCOMPLISHED UNDER THIS CONTRACT. WORK MUST BE ACCOMPLISHED IN AREAS NOT SHOWN ON ARCHITECTURAL DRAWINGS DUE TO CHANGES AFFECTING ELECTRICAL, MECHANICAL, PLUMBING AND TECHNOLOGY ALONG WITH OTHER SYSTEMS. THIS WORK SHALL BE PART OF THIS CONTRACT, AND ALL TRADES SHALL INSPECT THESE AREAS, ASCERTAIN WORK REQUIRED AND DO THE WORK IN ACCORDANCE OF CONTRACT REQUIREMENTS AT NO ADDITIONAL COST. SEE MECHANICAL, ELECTRICAL, PLUMBING AND TECHNOLOGY


DEMOLITION PLAN KEYED NOTES


- REMOVE FLOOR FINISH IN ITS ENTIRETY. PATCH & PREP FLOOR FOR SCHEDULED FINISH. SEE SPECIFICATION SECTION 09 05 16 SUBSURFACE
- PREPARATION FOR FLOOR FINISHES REMOVE CEILING IN ITS ENTIRETY. INCLUDING ALL MECHANICAL & ELECTRICAL ITEMS. SEE MECHANICAL / ELECTRICAL.
- REMOVE GYP BD ON ONE SIDE OF PARTITION AS REQUIRED. SEE PLANS AND MECHANICAL / ELECTRICAL PLANS FOR ADDITIONAL INFORMATION
- CUT OPENING IN PARTITION AS REQUIRED FOR INSTALLATION OF DOOR AND FRAME AS SCHEDULED. SEE PLAN
- REMOVE PORTION OF CEILING AS REQUIRED. SEE PLANS FOR ADDITIONAL INFORMATION
- REMOVE PLUMBING FIXTURE AND ALL ASSOCIATED PIPING. -SEE MEP DRAWINGS FOR ADDITIONAL INFORMATION
- REMOVE BASE CABINETS, UPPER CABINETS, TALL CABINETS AND/ OR COUNTERTOP
- REMOVE CEILING IN THIS AREA AS REQUIRED FOR MEP WORK. SALVAGE CEILING WHERE APPROPRIATE FOR REINSTALLATION. SEE PLANS FOR
- REMOVE CONDUITS THOUGH FLOOR. SEE PLAN FOR ADDITIONAL
- INFORMATION REMOVE PARTITION MOUNTED MIRROR AND ALL ASSOCIATED HARDWARE
- REMOVE SURFACE MOUNTED PLYWOOD. TEMPORARILY SUPPORT ANY EQUIPMENT. SEE ELECTRICAL AND TECHNOLOGY DRAWINGS FOR
- ADDITIONAL INFORMATION REMOVE COVED CONCRETE BASE AT PARTITION.

SALVAGE FOR REINSTALLATION

- REMOVE PREMANUFACTURED PLASTIC LOCKER(S). SALVAGE FOR DE13 REINSTALLATION
- REMOVE RAISED FLOOR SYSTEM IN ITS ENTIRETY AND METAL RAMP
- REMOVE PORTION OF MEMBRANE ROOFING SYSTEM. SEE FLOOR/ROOF PLAN FOR ADDITIONAL INFORMATION
- REMOVE PORTION OF MEMBRANE ROOFING SYSTEM, IN PREPARATION FOR RESLOPING AND REROOFING. SEE FLOOR/ROOF PLAN FOR
- ADDITIONAL INFORMATION REMOVE ROOF DRAIN AND ASSOCIATED PIPING. SEE MECHANICAL FOR
- ADDITIONAL INFORMATION
- REMOVE METAL LOUVER AND ALL ASSOCIATED MOUNTING HARDWARE. SEE MECHANICAL FOR ADDITIONAL INFORMATION
- CUT OPENING IN BRICK AND METAL STUD BACK UP WALL FOR DOOR AND DE19 FRAME AS SCHEDULED. SEE FLOOR PLAN FOR ADDITIONAL INFORMATION
- REMOVE PARTIAL HEIGHT CERAMIC TILE AT SINK
- REMOVE METAL RADIATOR COVER
- REMOVE SURFACE APPLIED WALL COVERING, TRIM, VINYL BASE AND / OR CRASH / HAND RAIL AS NEEDED.
- REMOVE DOOR, FRAME AND ALL ASSOCIATED HARDWARE. SALVAGE FOR REINSTALLATION. SEE PLAN
- REMOVE ALUMINUM WINDOW SYSTEM AND ALL ASSOCIATED HARDWARE. REMOVE CAST STONE SILL, EXTERIOR, AND SOLID SURFACE SILL,
- CUT OPENING IN PARTITION AS REQUIRED FOR INSTALLATION OF EDGE ILLUMINATED PHOTO MURALS
- SAW CUT FACE BRICK AND REMOVE PORTION OF WALL. SEE PLAN FOR ADDITIONAL INFORMATION

NOTE: NOT ALL KEYED NOTES MAY BE USED ON EACH PLAN

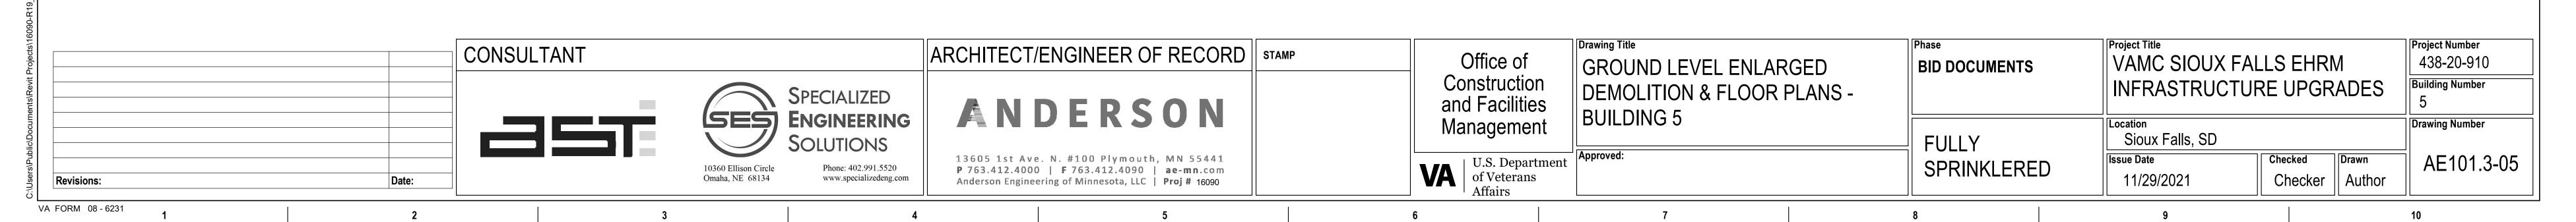

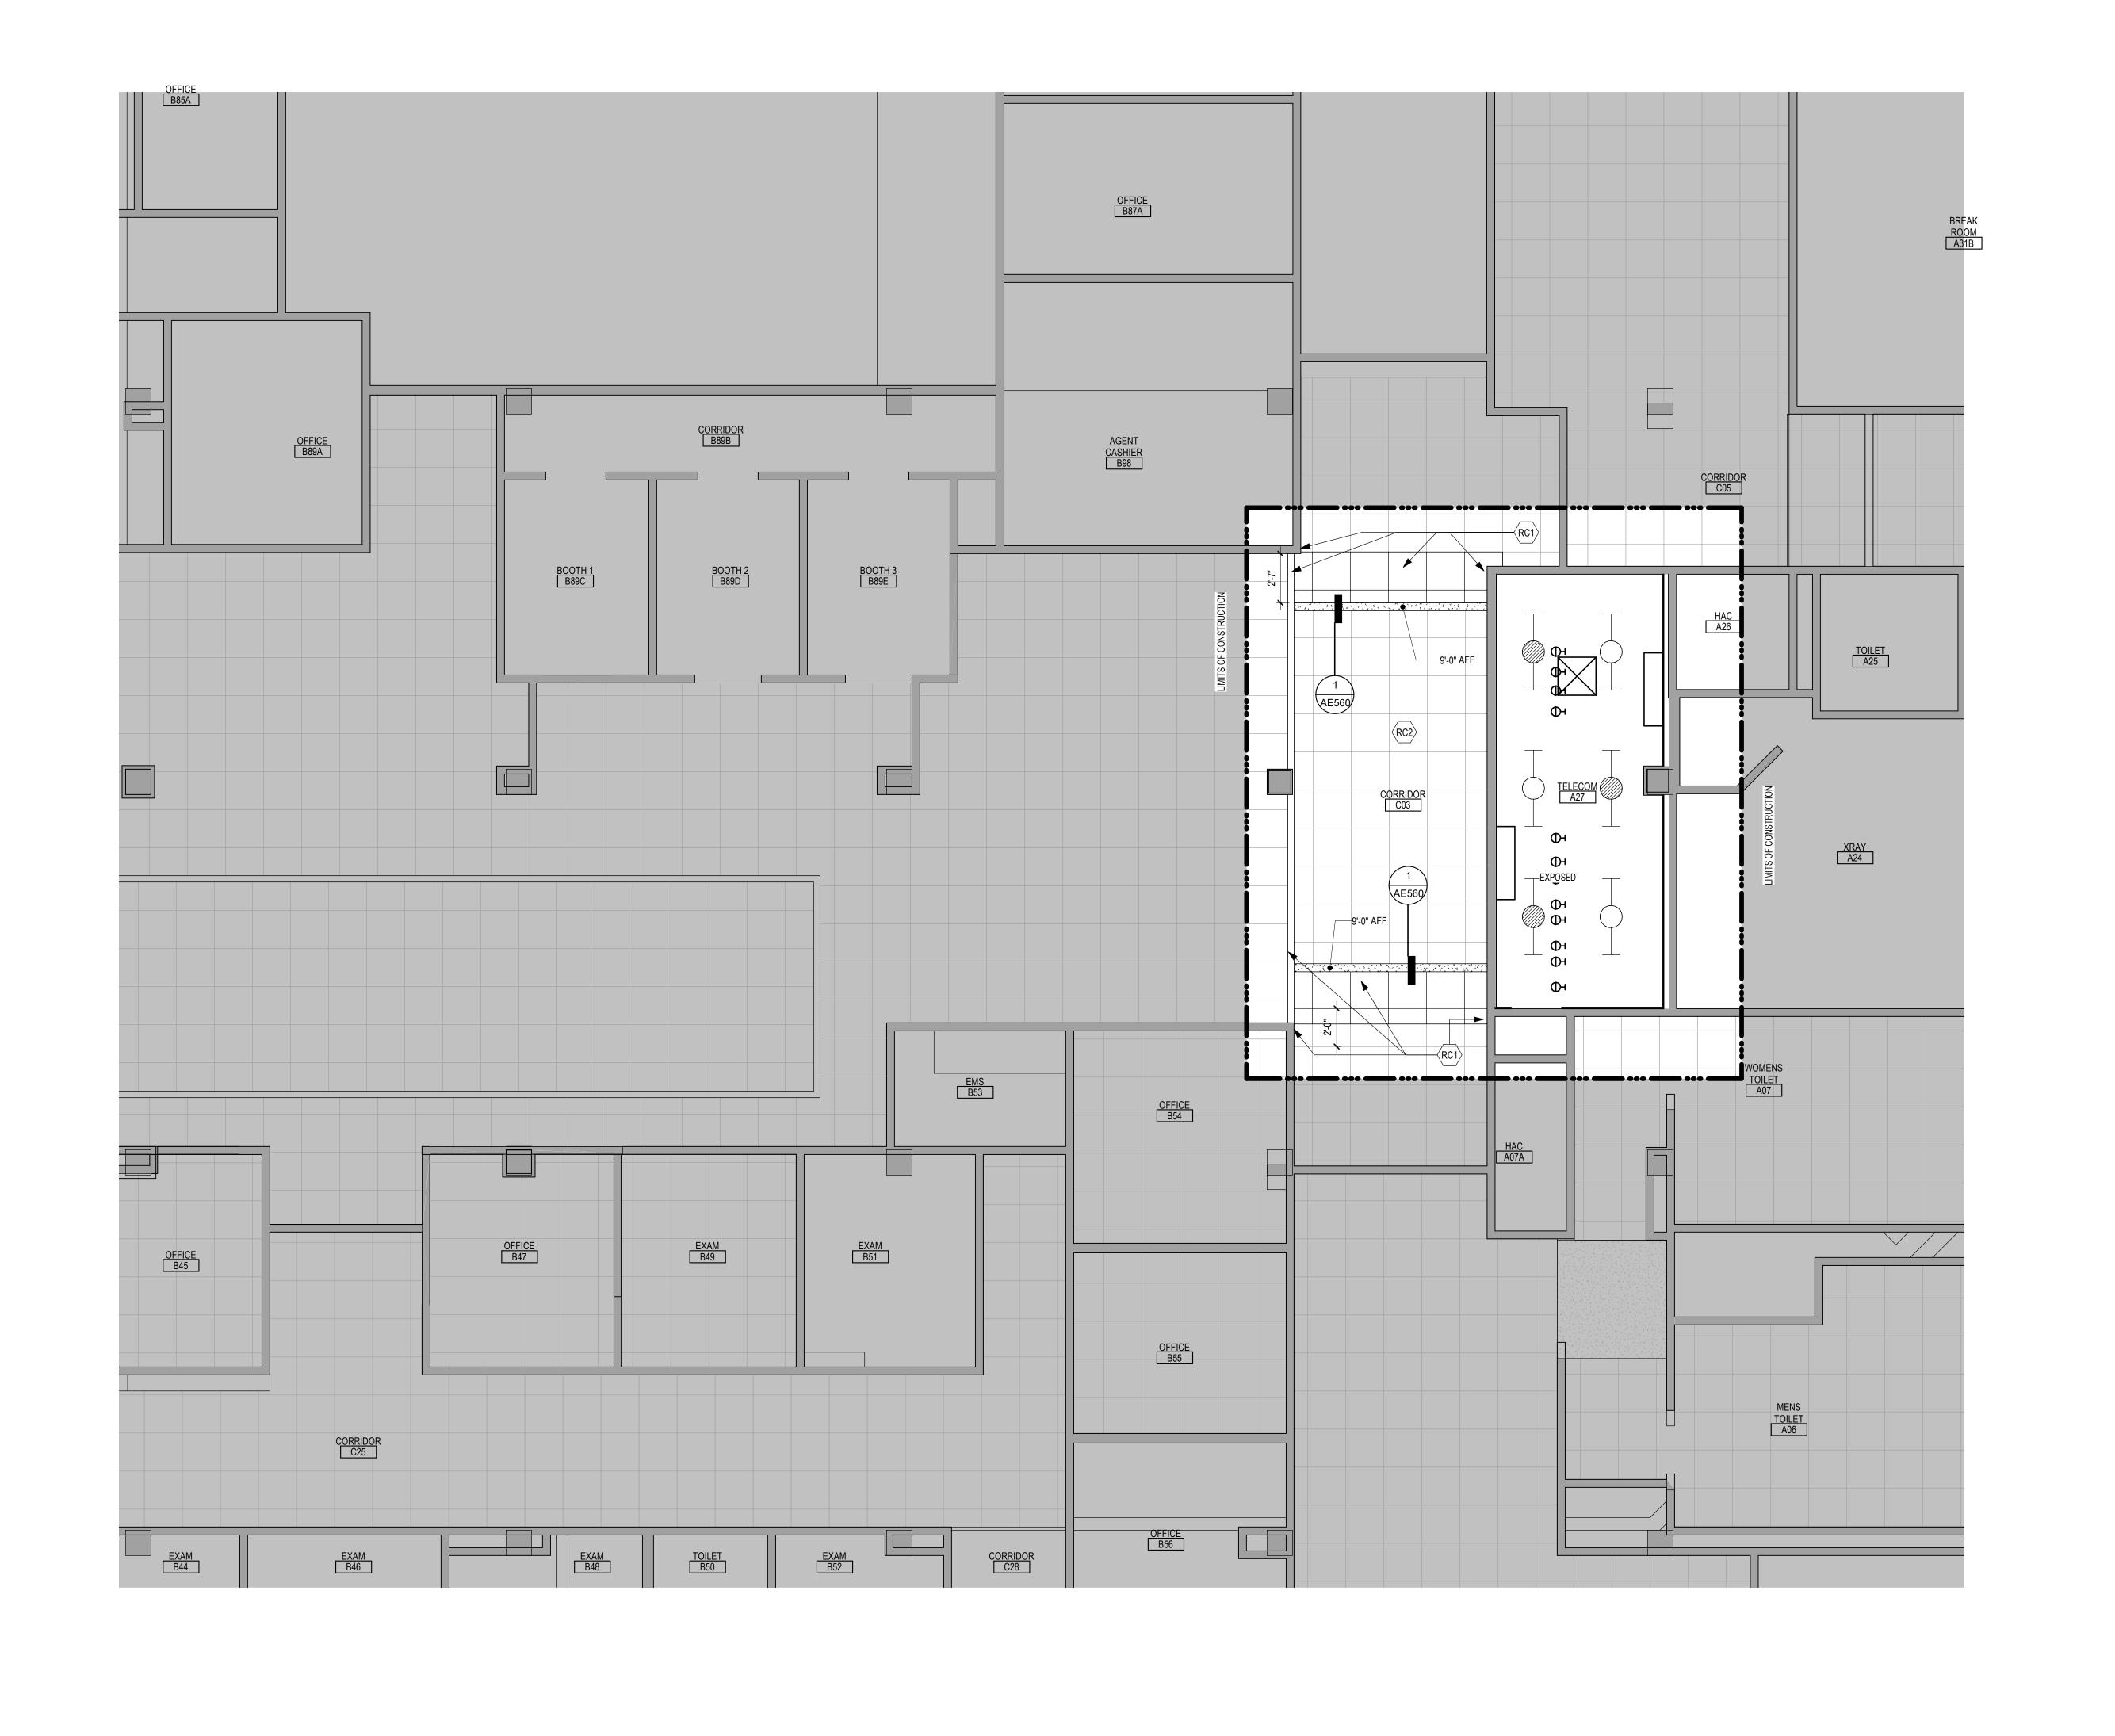

RCP GENERAL NOTES

GENERAL CONTRACTOR TO COORDINATE ALL CEILING MOUNTED EQUIPMENT SUPPORT REQUIREMENTS, LOCATIONS, DIMENSIONS, ETC WITH EQUIPMENT SUPPLIER AND OWNER, PRIOR TO INSTALLATION.


- ALL CEILING MOUNTED ITEMS SUCH AS LIGHT FIXTURES, GRILLES, DIFFUSERS, SPEAKERS, EXIT LIGHTS, ETC SHALL BE LOCATED IN THE CENTER OF ACT PANELS,
- GYP BD SOFFITS AND/OR PLASTER SOFFIT BAYS, UNLESS NOTED OTHERWISE. COORDINATE WITH MECHANICAL AND ELECTRICAL DRAWINGS. FINISHED GYP BD SOFFITS SHALL EXTEND 1" BEYOND FACE AND EXPOSED ENDS OF WALL CABINETS, FULL-HEIGHT CABINETS, ETC UNLESS NOTED OTHERWISE.
- SEE MECHANICAL DRAWINGS FOR SPRINKLER HEAD TYPES AND LOCATIONS. CENTER ALL HEADS IN ACT UNLESS NOTED OTHERWISE.

ARE REFERENCED FROM THE REFLECTED CEILING PLAN.

AT REMODELING WORK IN EXISTING ACT SUSPENSION SYSTEM, REMOVE EXISTING

PANELS, CUT AS REQUIRED FOR CONSTRUCTION AND RE-INSTALL. REPLACE ALL DAMAGED AND / OR EXTREMELY SOILED PANELS WITH ACT TO MATCH EXISTING.


COORDINATE CABINET DIMENSIONS WITH SUPPLIER. GYP BD FASCIA/SOFFIT DETAILS

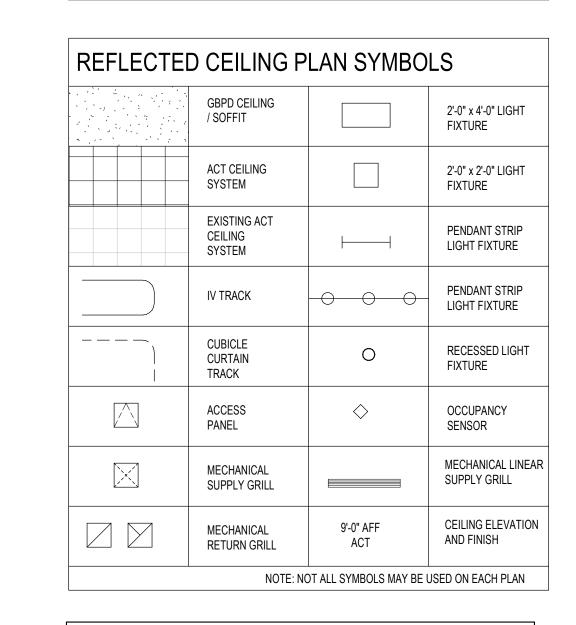


REFLECTED CEILING KEYED NOTES


- PATCH / MODIFY CEILING TO MATCH EXISTING AS NECESSARY, CONTRACTOR TO PROVIDE LABOR AND MATERIALS. REPLACE ANY BROKEN, DAMAGED OR DIRTY ACT TILES AND CEILING GRID. COORDINATE WITH OWNER FOR ACT AND CEILING GRID TYPE. WHERE EXISTING FINISHES ARE DISTURBED ON PAINTED SURFACES. PAINT TO MATCH ADJACENT FINISH. PAINT ENTIRE WALL / SOFFIT OF EXISTING INTERIOR SPACES WHERE PATCHING OCCURS.
- RC2 PATCH SOFFIT WITH MATERIALS TO MATCH EXISTING ADJACENT SURFACES AS REQUIRED FROM DEMOLITION. CONTRACTOR TO PROVIDE LABOR AND MATERIALS FOR PAINTED AREAS. CONTRACTOR TO PROVIDE LABOR AND MATERIALS AT AREAS WITH WALL COVERING. WHERE EXISTING FINISHES ARE DISTURBED ON PAINTED SURFACES. PAINT TO MATCH ADJACENT FINISH, PAINT ENTIRE SOFFIT OF EXISTING INTERIOR SPACES WHERE PATCHING OCCURS.
- REINSTALL CEILING TILE, GRID AND ANY MECHANICAL ITEMS AS REQUIRED FROM CONSTRUCTION, REPLACE ANY BROKEN, DAMAGED OR DIRTY ACT TILES AND CEILING GRID. COORDINATE WITH OWNER FOR ACT AND CEILING GRID TYPE. WHERE EXISTING FINISHES ARE DISTURBED ON PAINTED SURFACES. PAINT TO MATCH ADJACENT FINISH. PAINT ENTIRE WALL / SOFFIT OF EXISTING INTERIOR SPACES WHERE PATCHING OCCURS.
- MODIFY CEILING GRID AND TILE AS REQUIRED FROM CONSTRUCTION. SEE PLANS FOR ADDITIONAL INFORMATION


NOTE: NOT ALL KEYED NOTES MAY BE USED ON EACH PLAN

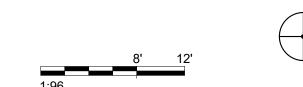



Project Number Drawing Title CONSULTANT ARCHITECT/ENGINEER OF RECORD | STAMP Office of VAMC SIOUX FALLS EHRM 438-20-910 PARTIAL GROUND LEVEL BID DOCUMENTS Construction and Facilities **Building Number** INFRASTRUCTURE UPGRADES REFLECTED CEILING PLAN -SPECIALIZED ANDERSON BUILDING 5 SES ENGINEERING Management Drawing Number Sioux Falls, SD **FULLY** Checked Drawn 13605 1st Ave. N. #100 Plymouth, MN 55441 P 763.412.4000 | F 763.412.4090 | ae-mn.com VA U.S. Department of Veterans Affairs AC101-05 SPRINKLERED PARTIAL GROUND LEVEL REFLECTED CIELING PLAN - BUILDING 854 Phone: 402.991.5520 07/06/2021 Checker GJB www.specializedeng.com Revisions: Anderson Engineering of Minnesota, LLC | Proj # 16090 VA FORM 08 - 6231

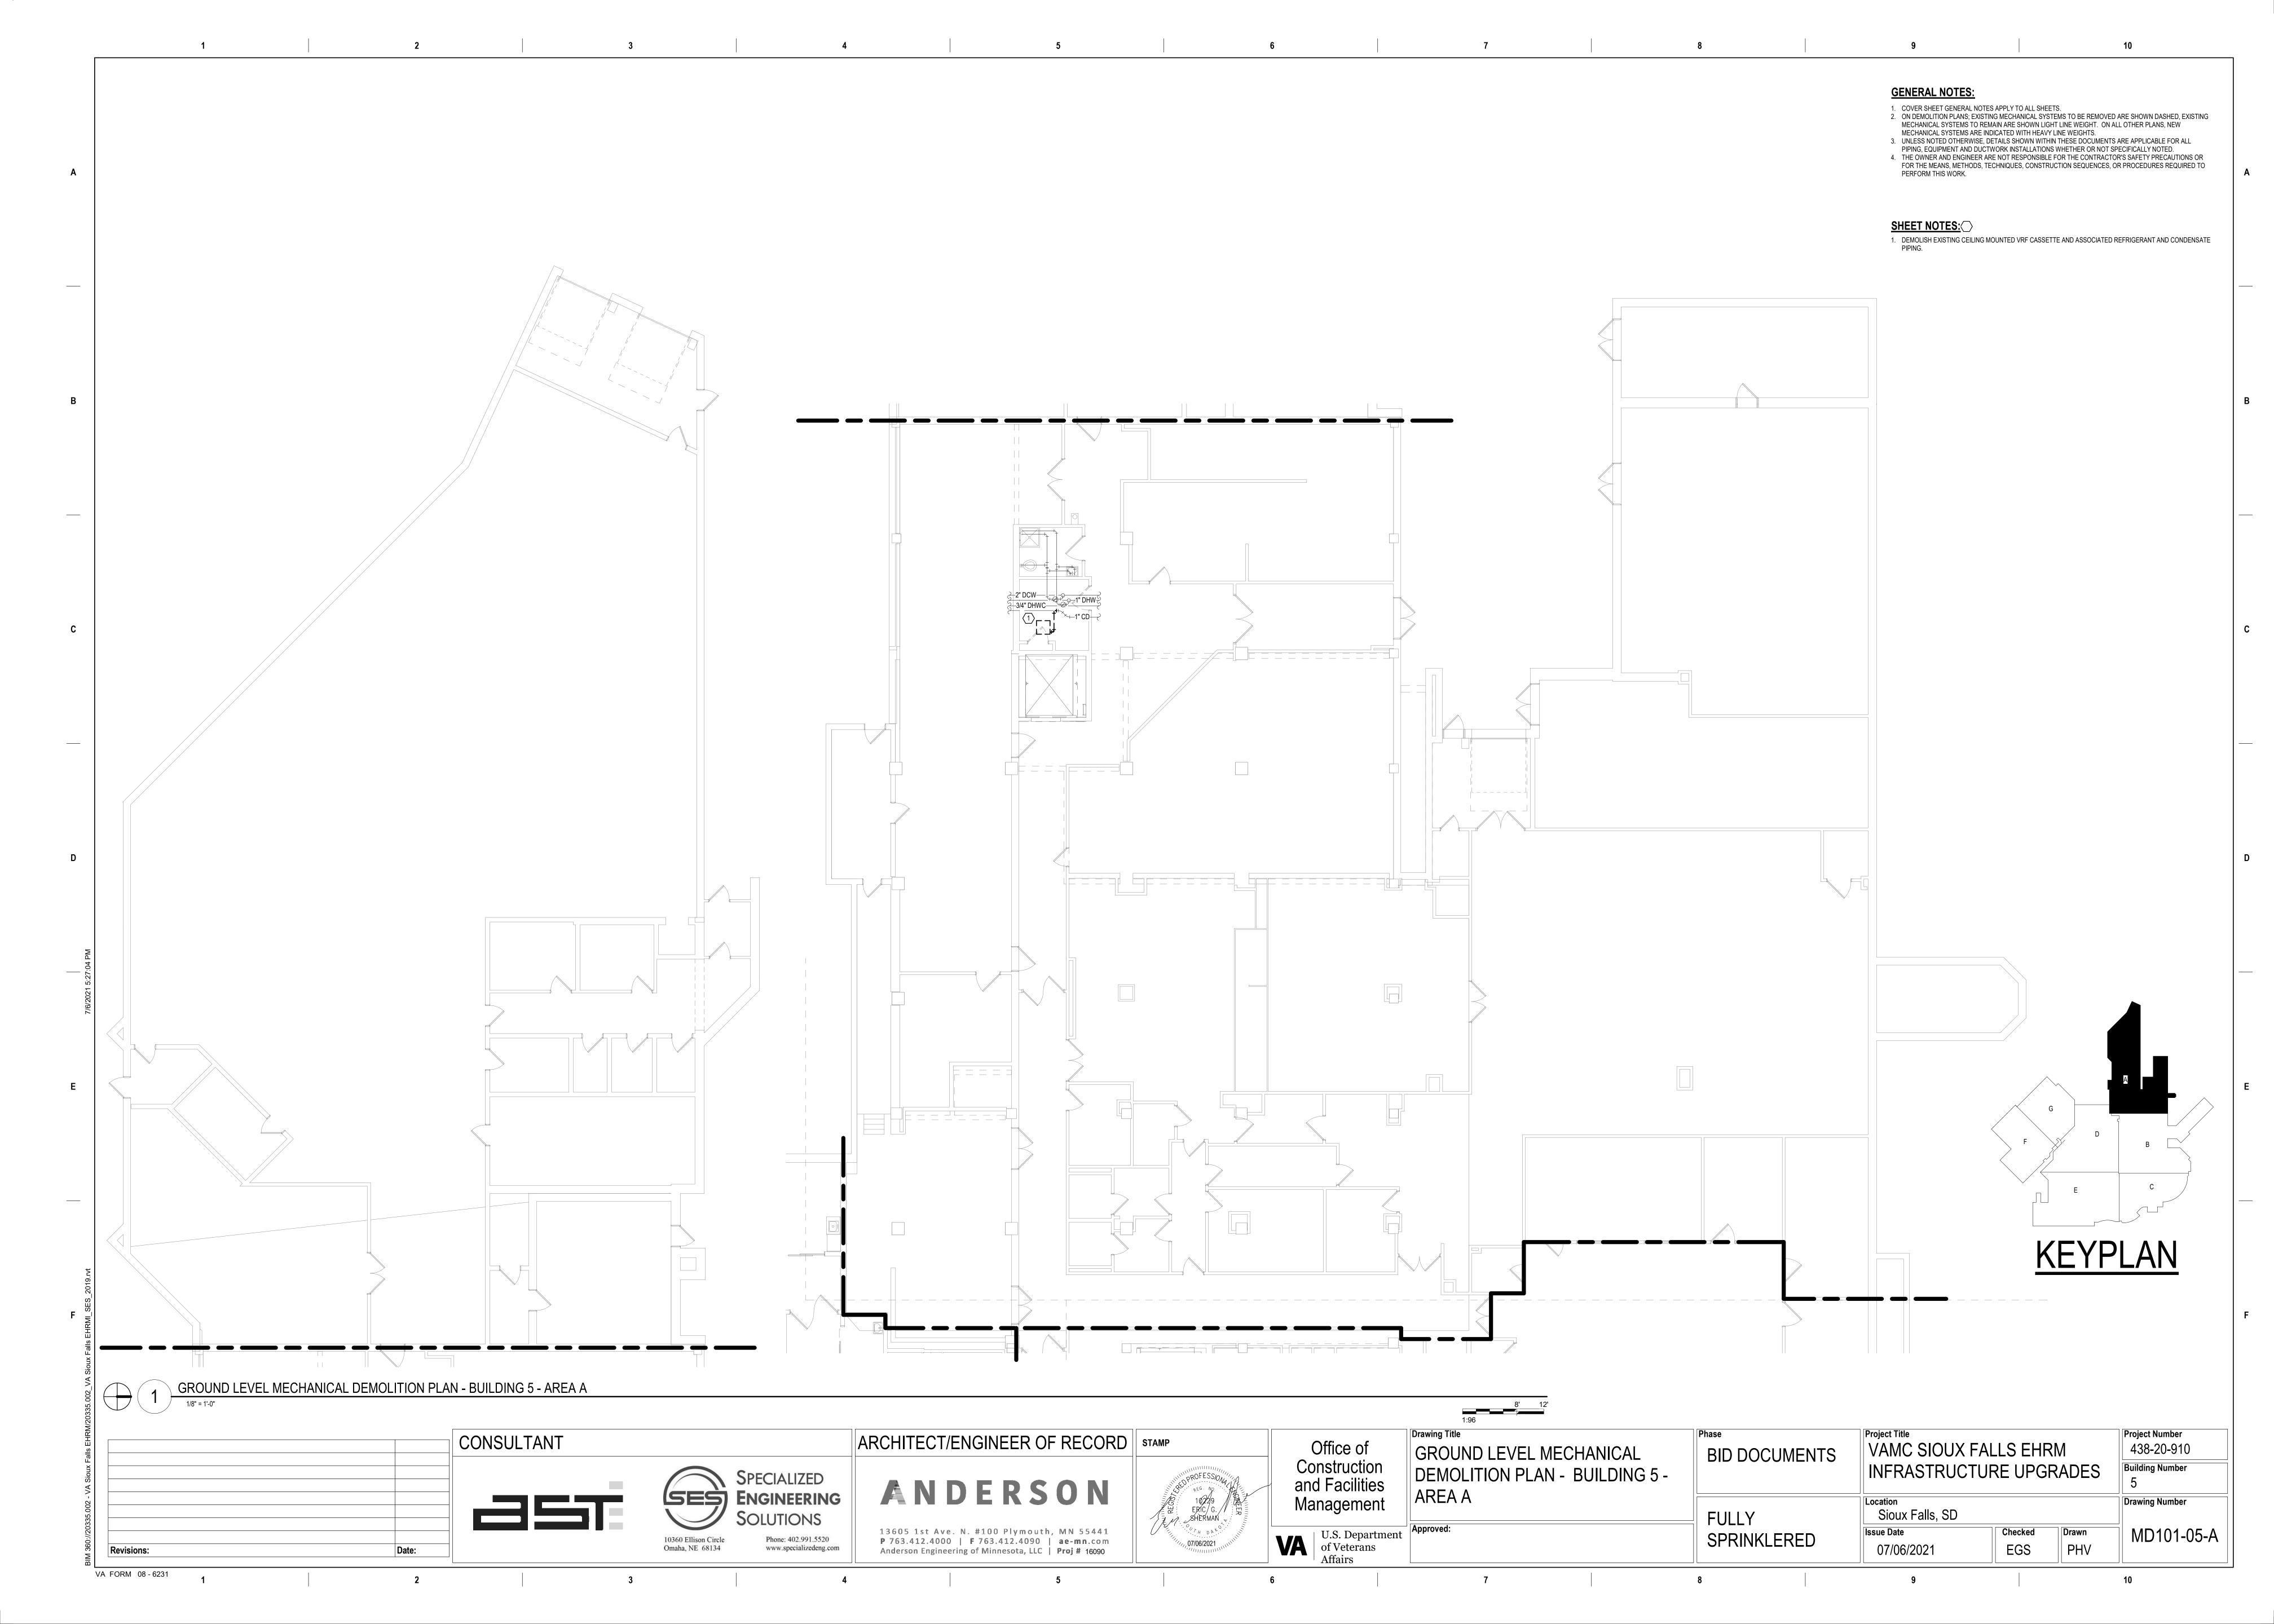

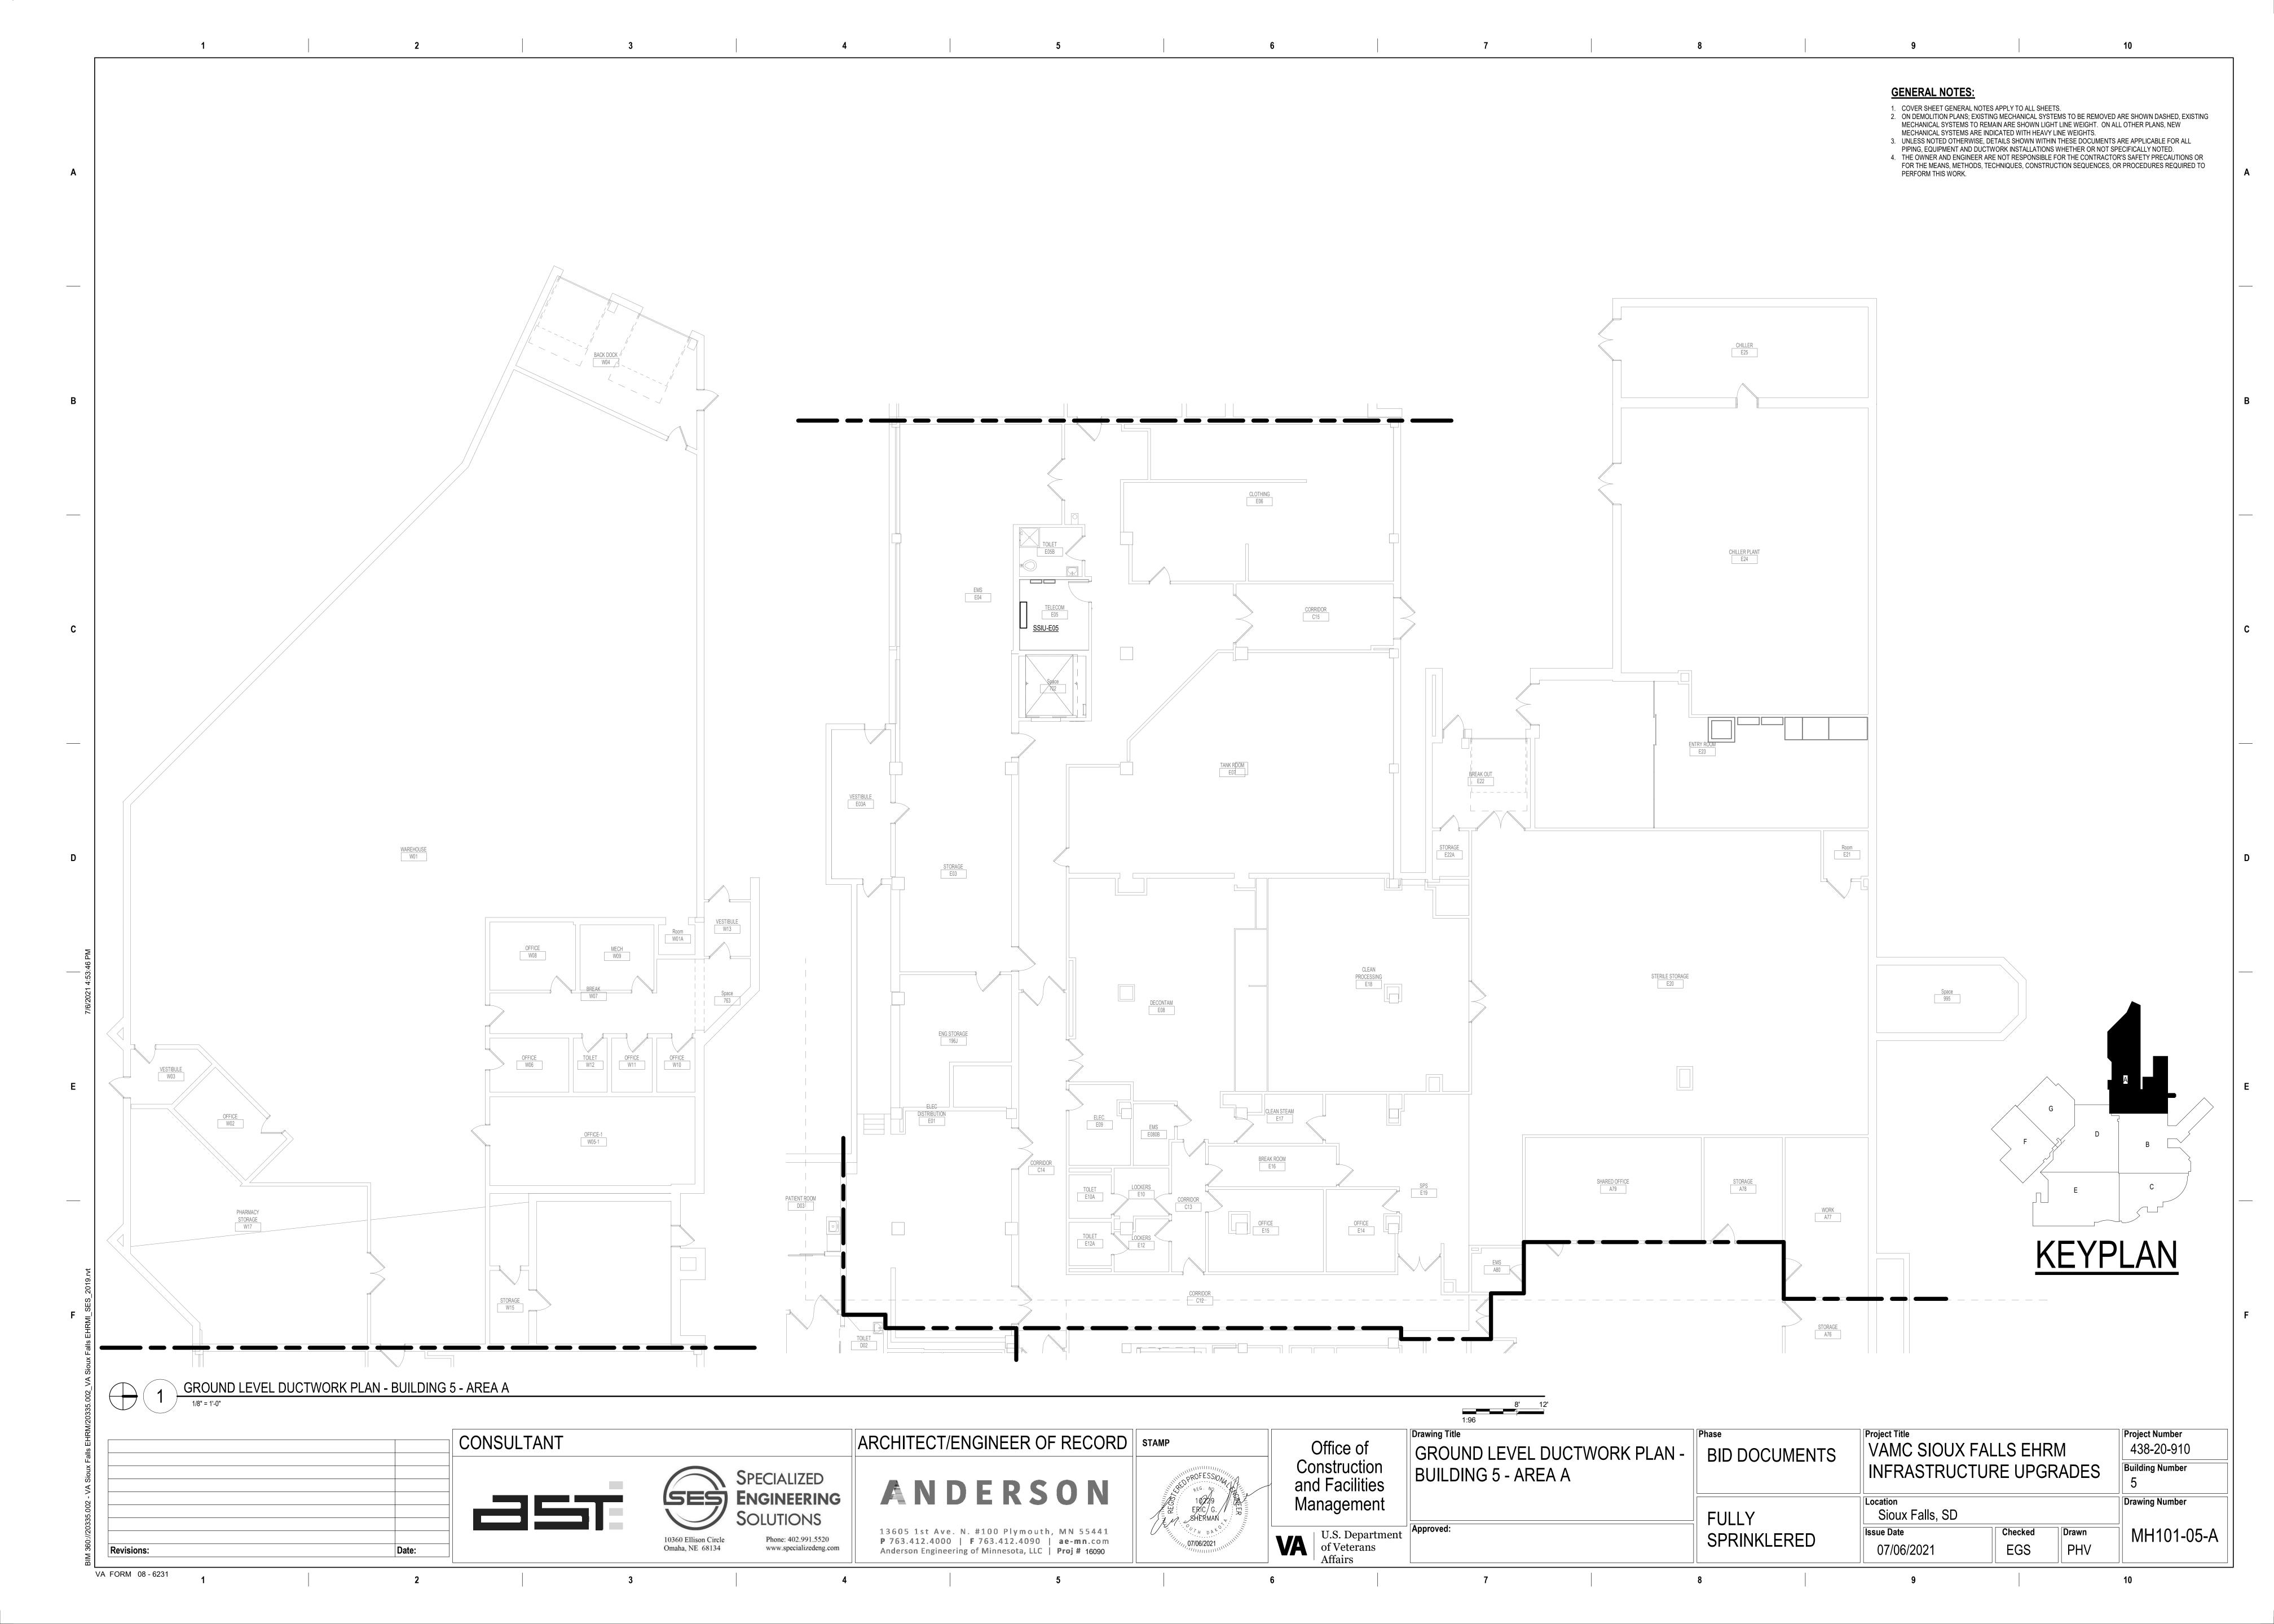

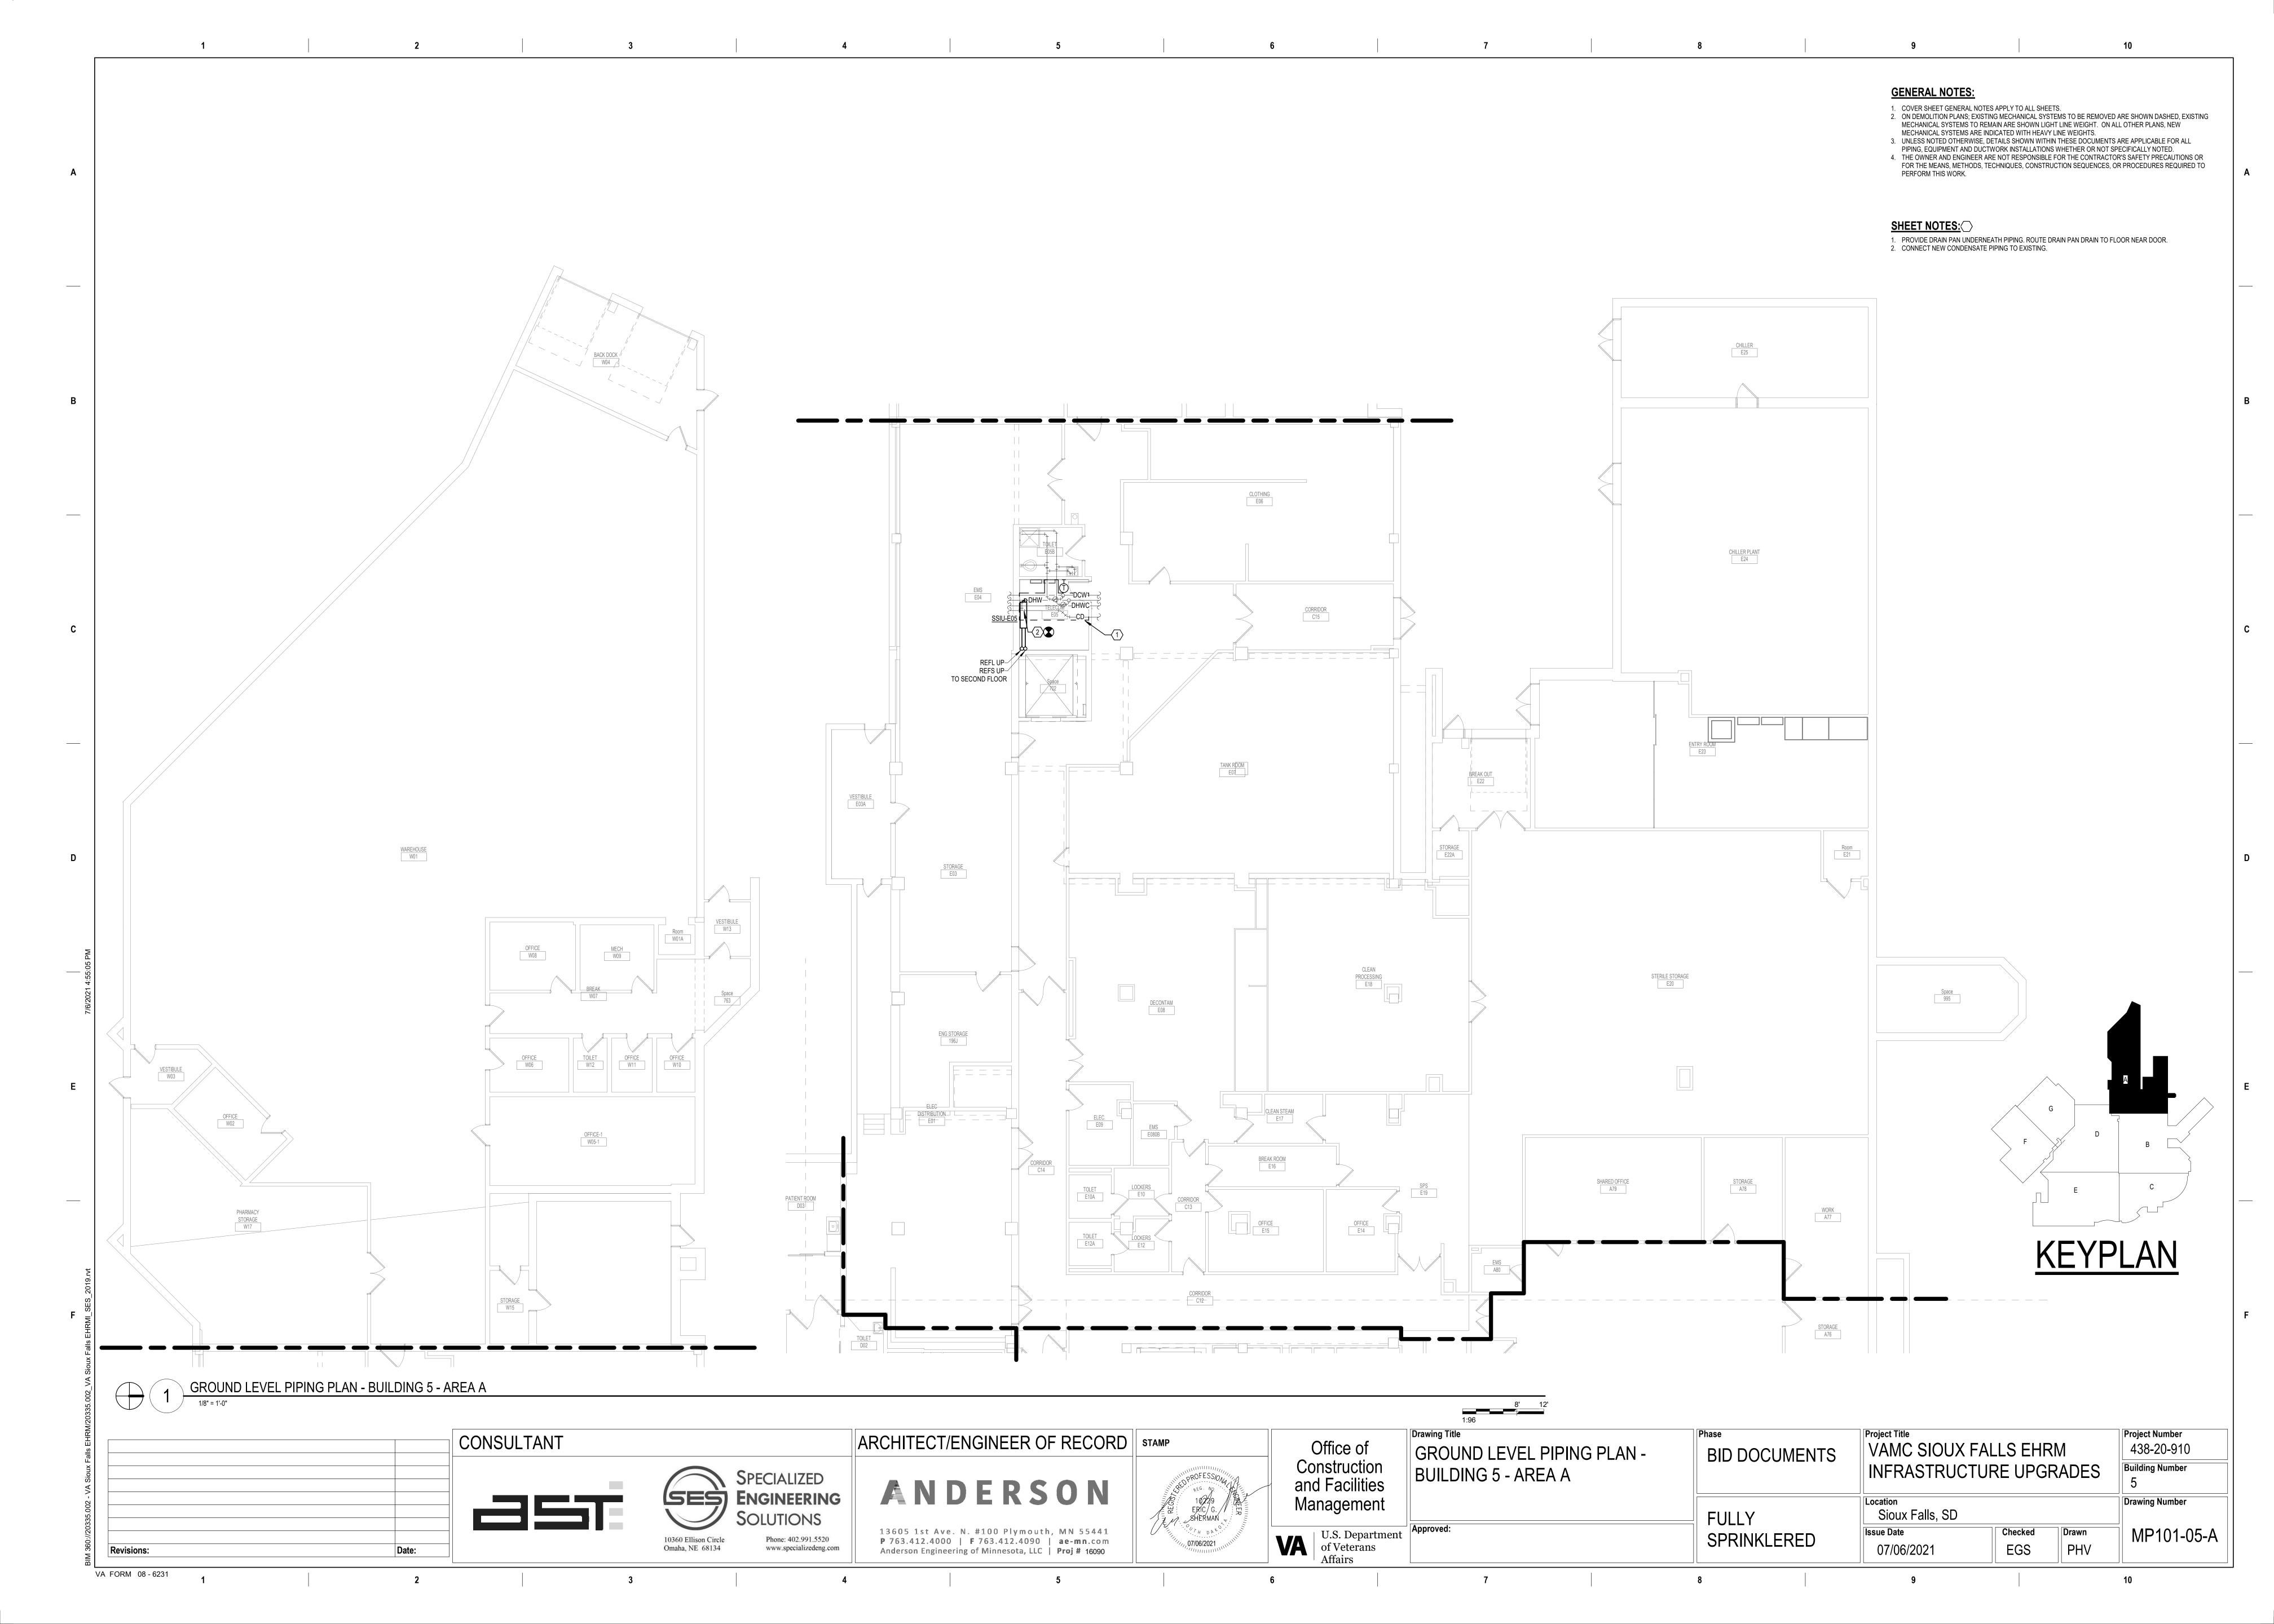

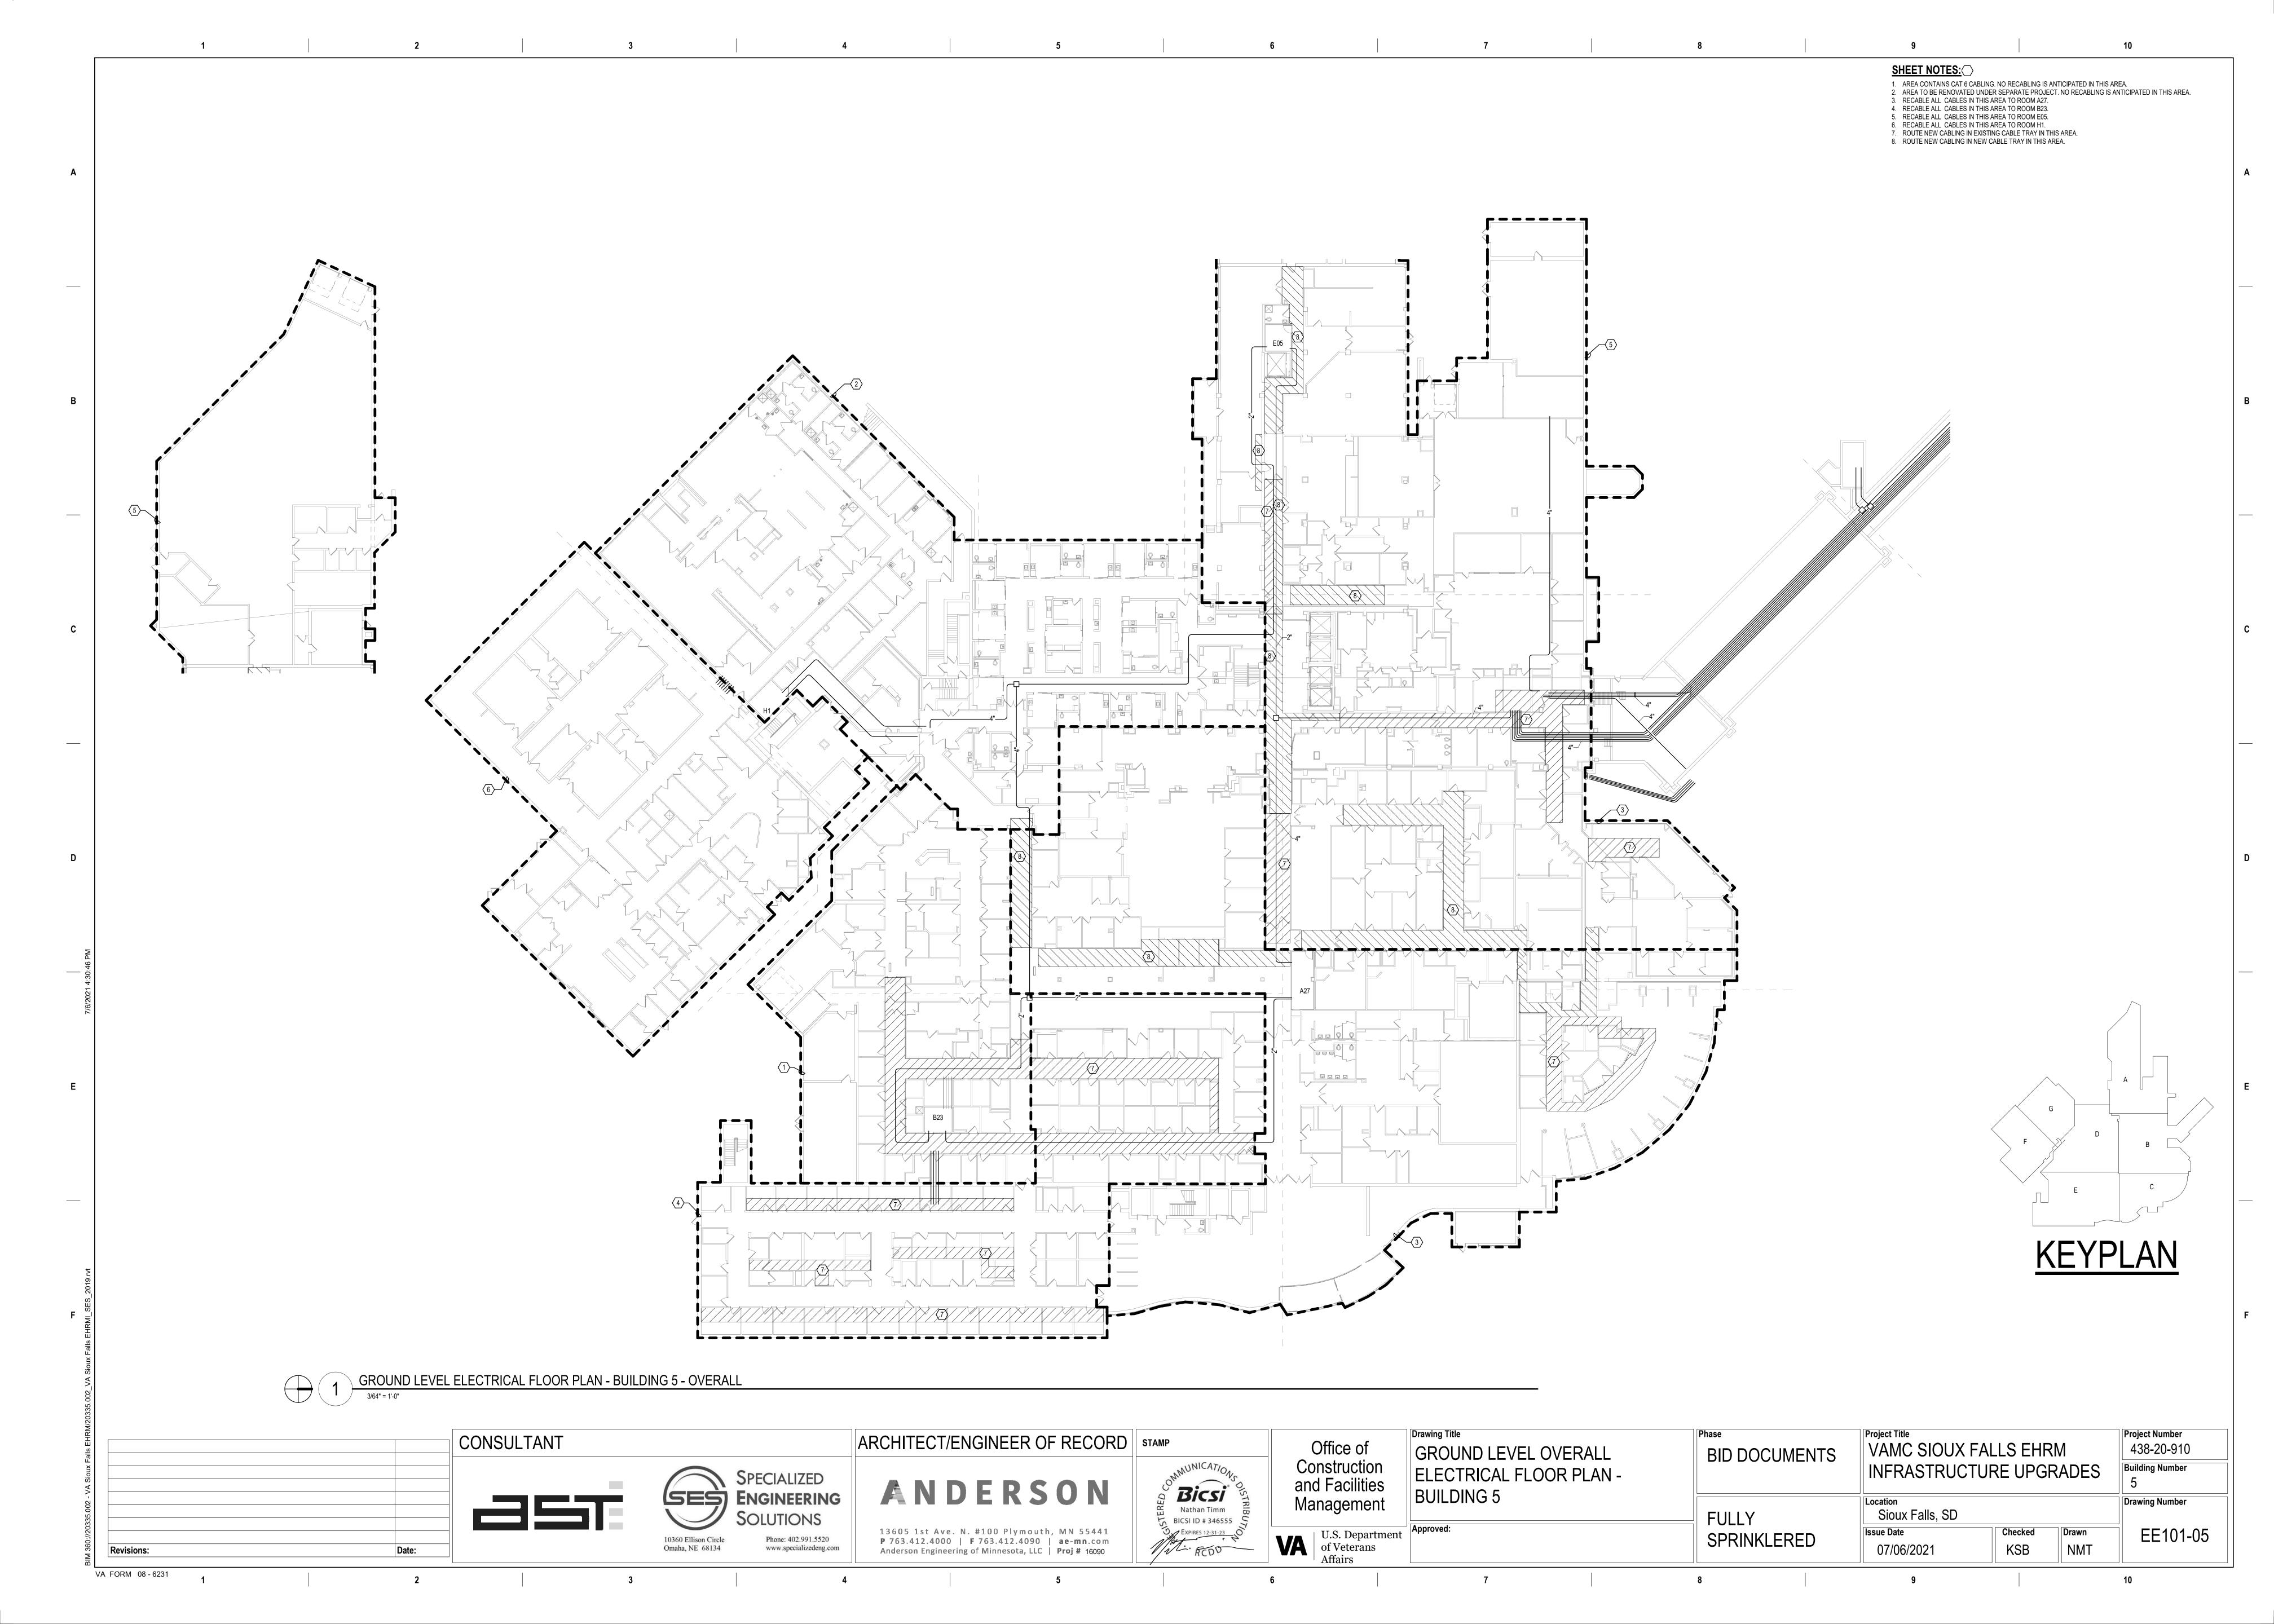

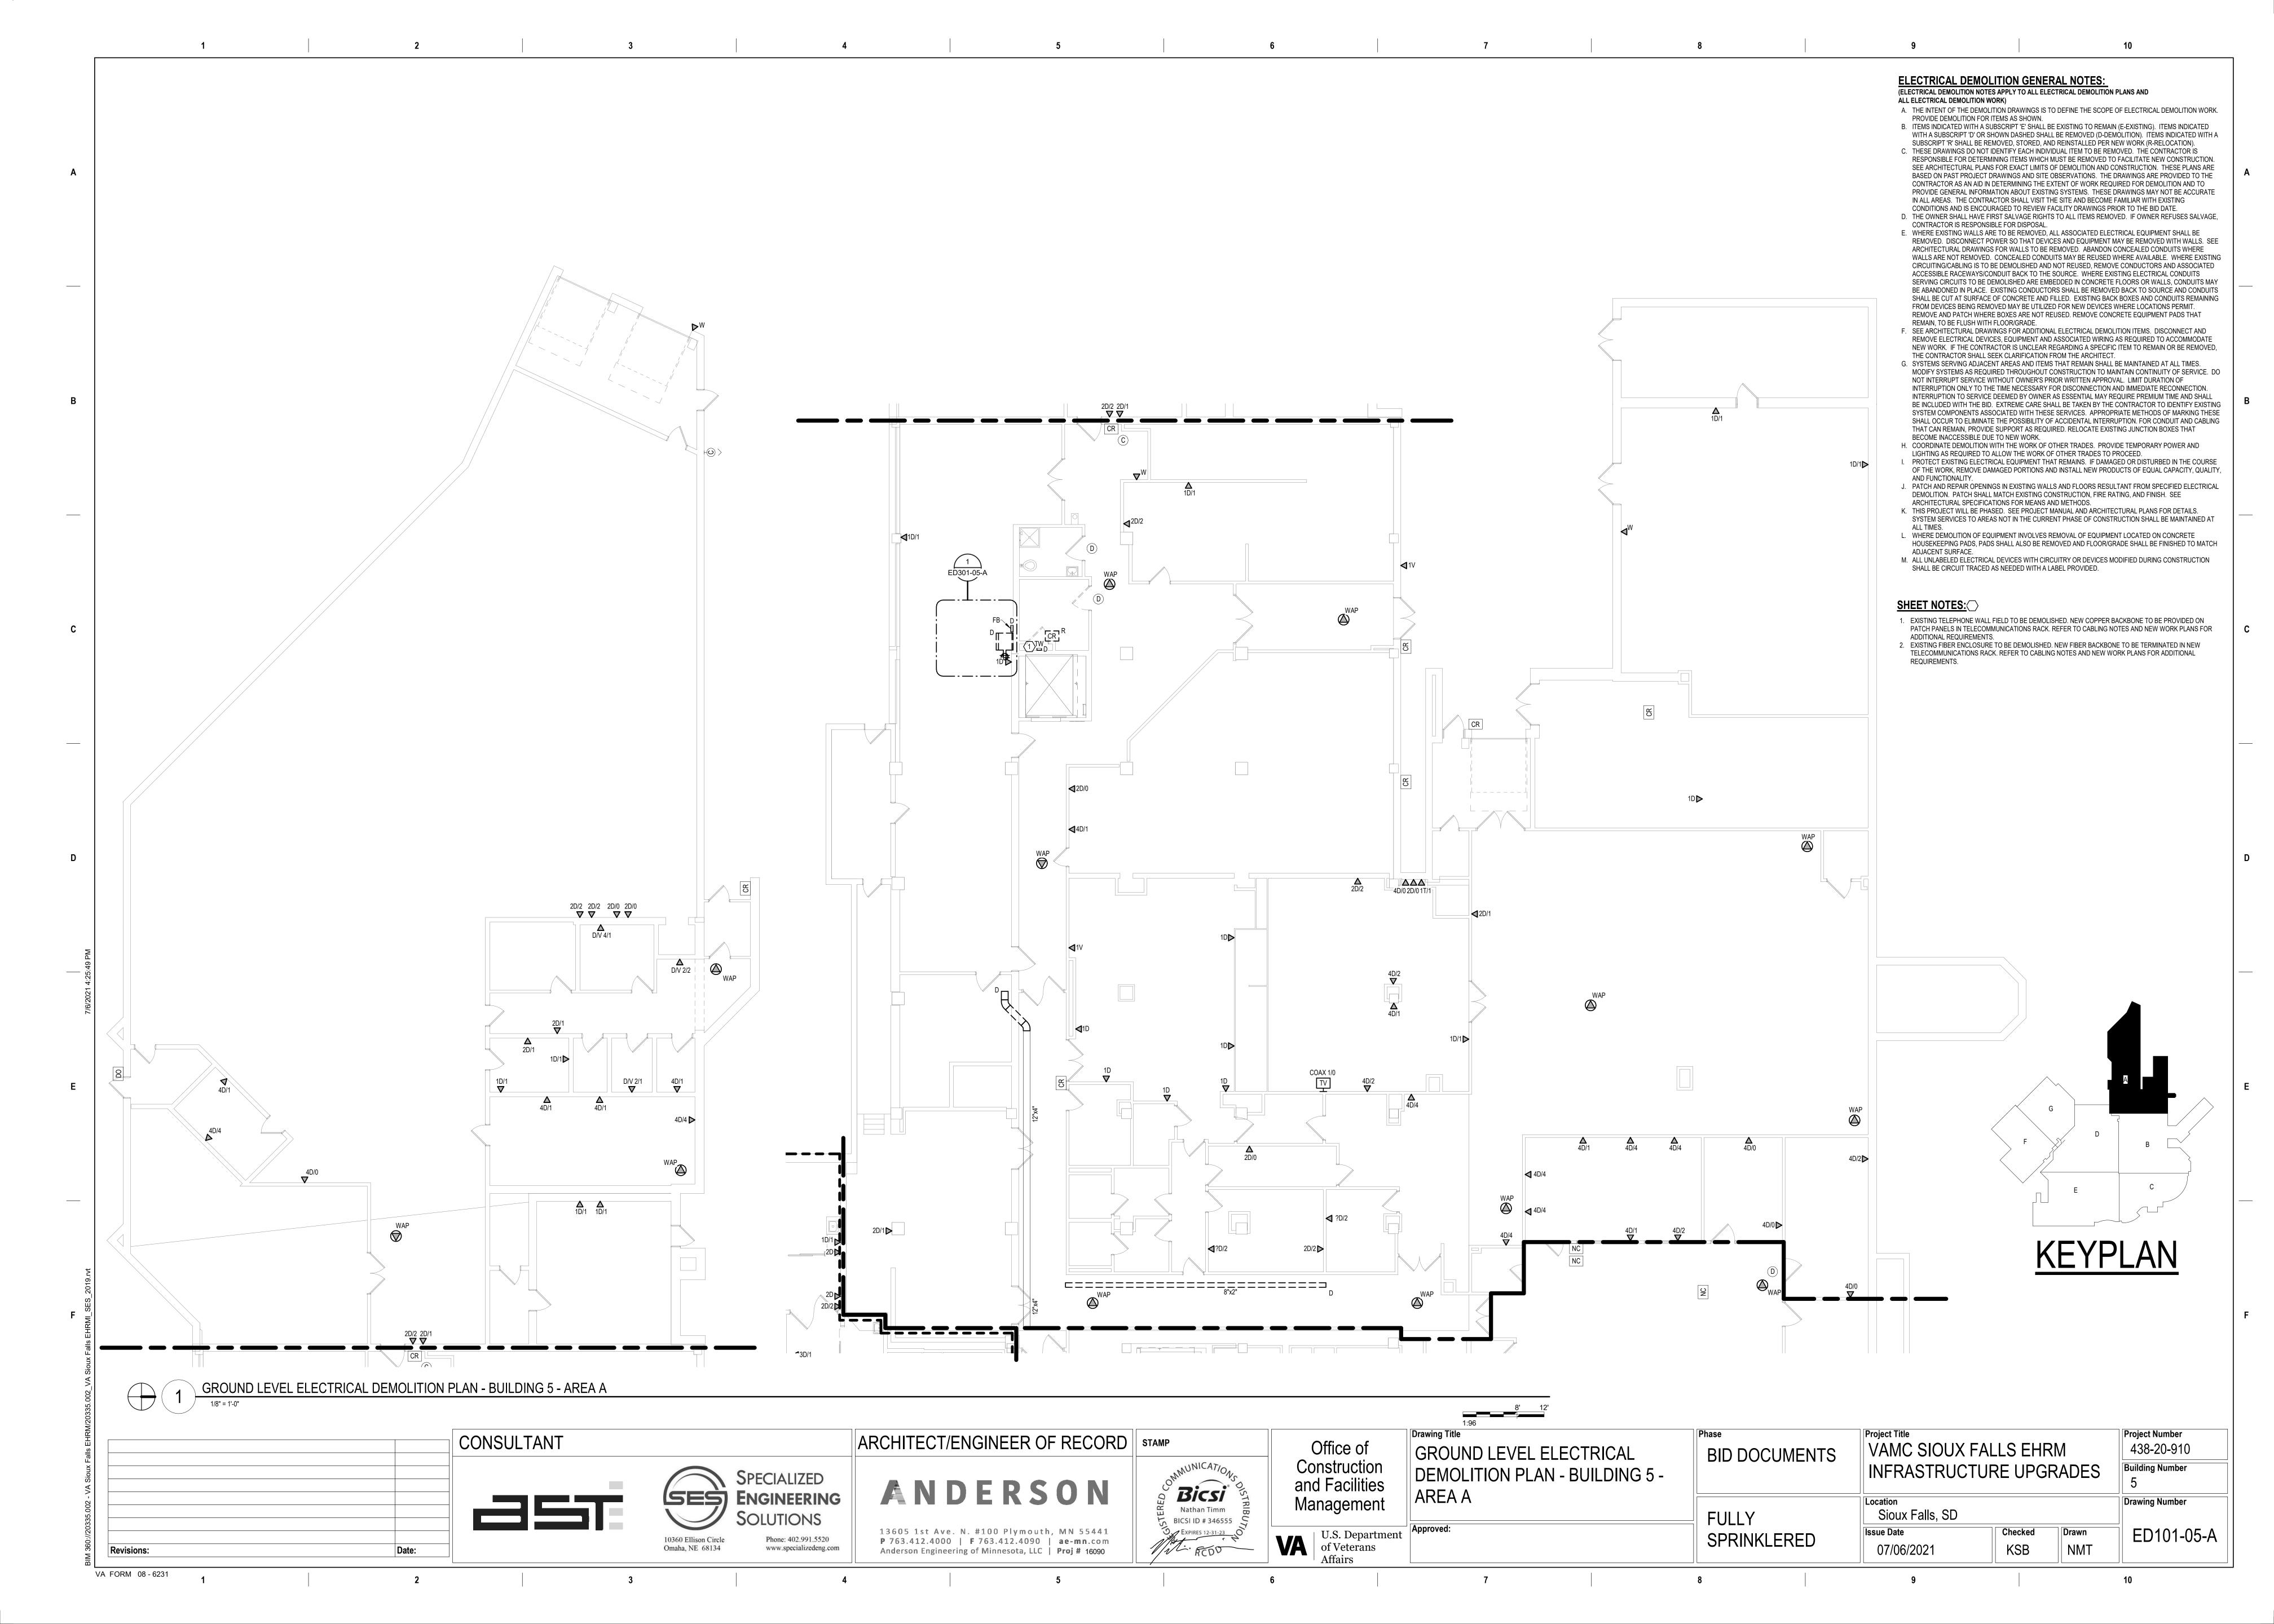



CABLING NOTES: A. THE EXISTING CABLE COUNT ARE THE CABLES CURRENTLY PRESENT IN THE SPACE. THE CABLE RELOCATION COUNT ARE THE NEW OR RELOCATED CABLES TO BE FED FROM THE SPACE. THE FINAL CABLE COUNT ARE THE CABLES THAT WILL BE PRESENT IN THE SPACE AT THE COMPLETION OF THE PROJECT. REMOVE ALL UNUSED CABLING AT THE COMPLETION OF THE PROJECT. 1. ROOM E04 EXISTING CABLE COUNT DATA (CAT6): 86 DATA (CAT5): 96 PATIENT MONITORING: 0 COMMERCIAL WIRELESS: 0 CABLE RELOCATION COUNT DATA (CAT6): -86 FROM ROOM E04 DATA (CAT5): -96 FROM ROOM E04 VIDEO: -1 TO ROOM E04 PATIENT MONITORING: 0 COMMERCIAL WIRELESS: 0 EXISTING CABLE TO REMAIN DATA (CAT6): 0 PATIENT MONITORING: 0 COMMERCIAL WIRELESS: 0 FINAL CABLE COUNT DATA (CAT6): 0 VIDEO: 0 PATIENT MONITORING: 0 COMMERCIAL WIRELESS: 0 SHEET NOTES: 2. EXISTING FIBER ENCLOSURE TO BE DEMOLISHED. NEW FIBER BACKBONE TO BE TERMINATED IN NEW TELECOMMUNICATIONS RACK. REFER TO CABLING NOTES AND NEW WORK PLANS FOR ADDITIONAL REQUIREMENTS. GROUND LEVEL ELECTRICAL DEMOLITION PLAN - BUILDING 5 - AREA A - ROOM E04

1/2" = 1'-0" Drawing Title Project Title Project Number CONSULTANT ARCHITECT/ENGINEER OF RECORD | STAMP Office of VAMC SIOUX FALLS EHRM 438-20-910 GROUND LEVEL ELECTRICAL **BID DOCUMENTS** Construction and Facilities **Building Number** INFRASTRUCTURE UPGRADES DEMOLITION - BUILDING 5 -SPECIALIZED Bicsi ANDERSON ENLARGED ROOMS - AREA A SES ENGINEERING Drawing Number Management Sioux Falls, SD **FULLY** 5 BICSI ID # 346555 13605 1st Ave. N. #100 Plymouth, MN 55441

P 763.412.4000 | F 763.412.4090 | ae-mn.com

Anderson Engineering of Minnesota, LLC | Proj # 16090 EXPIRES 12-31-23 NOT Checked Drawn U.S. Department of Veterans Affairs ED301-05-A SPRINKLERED 10360 Ellison Circle Phone: 402.991.5520 KSB NMT 07/06/2021 Omaha, NE 68134 www.specializedeng.com Revisions: VA FORM 08 - 6231

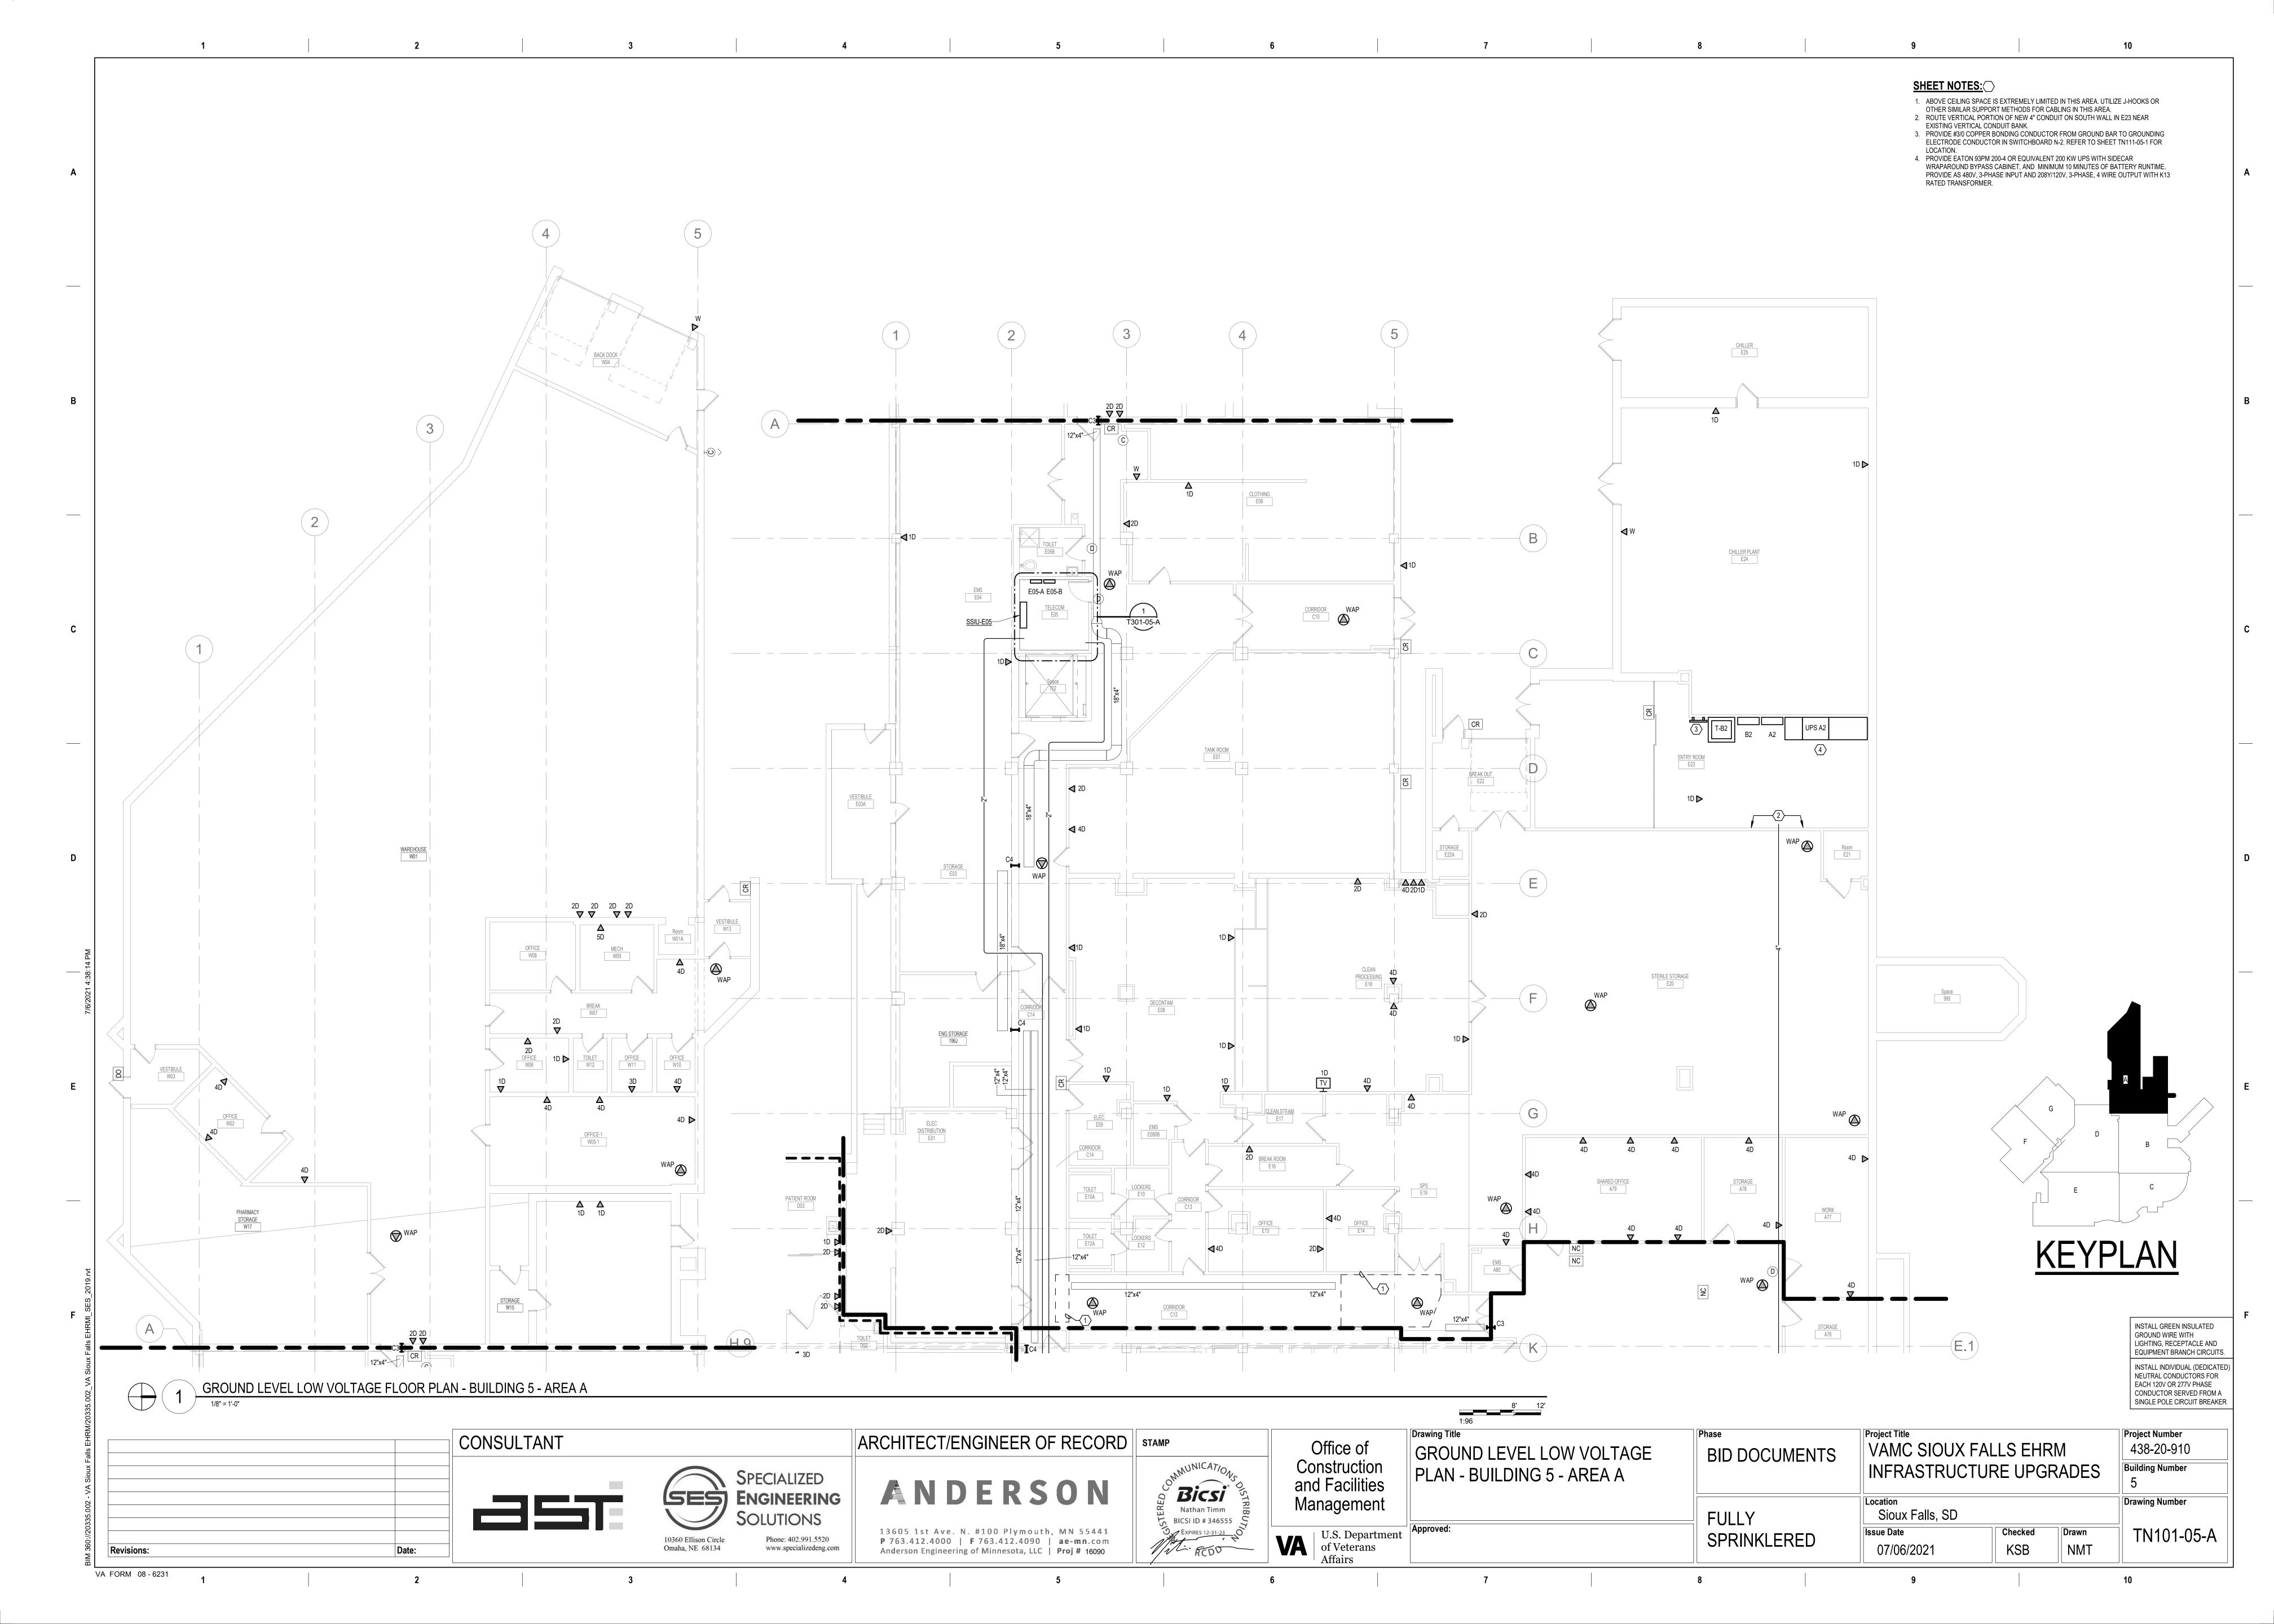


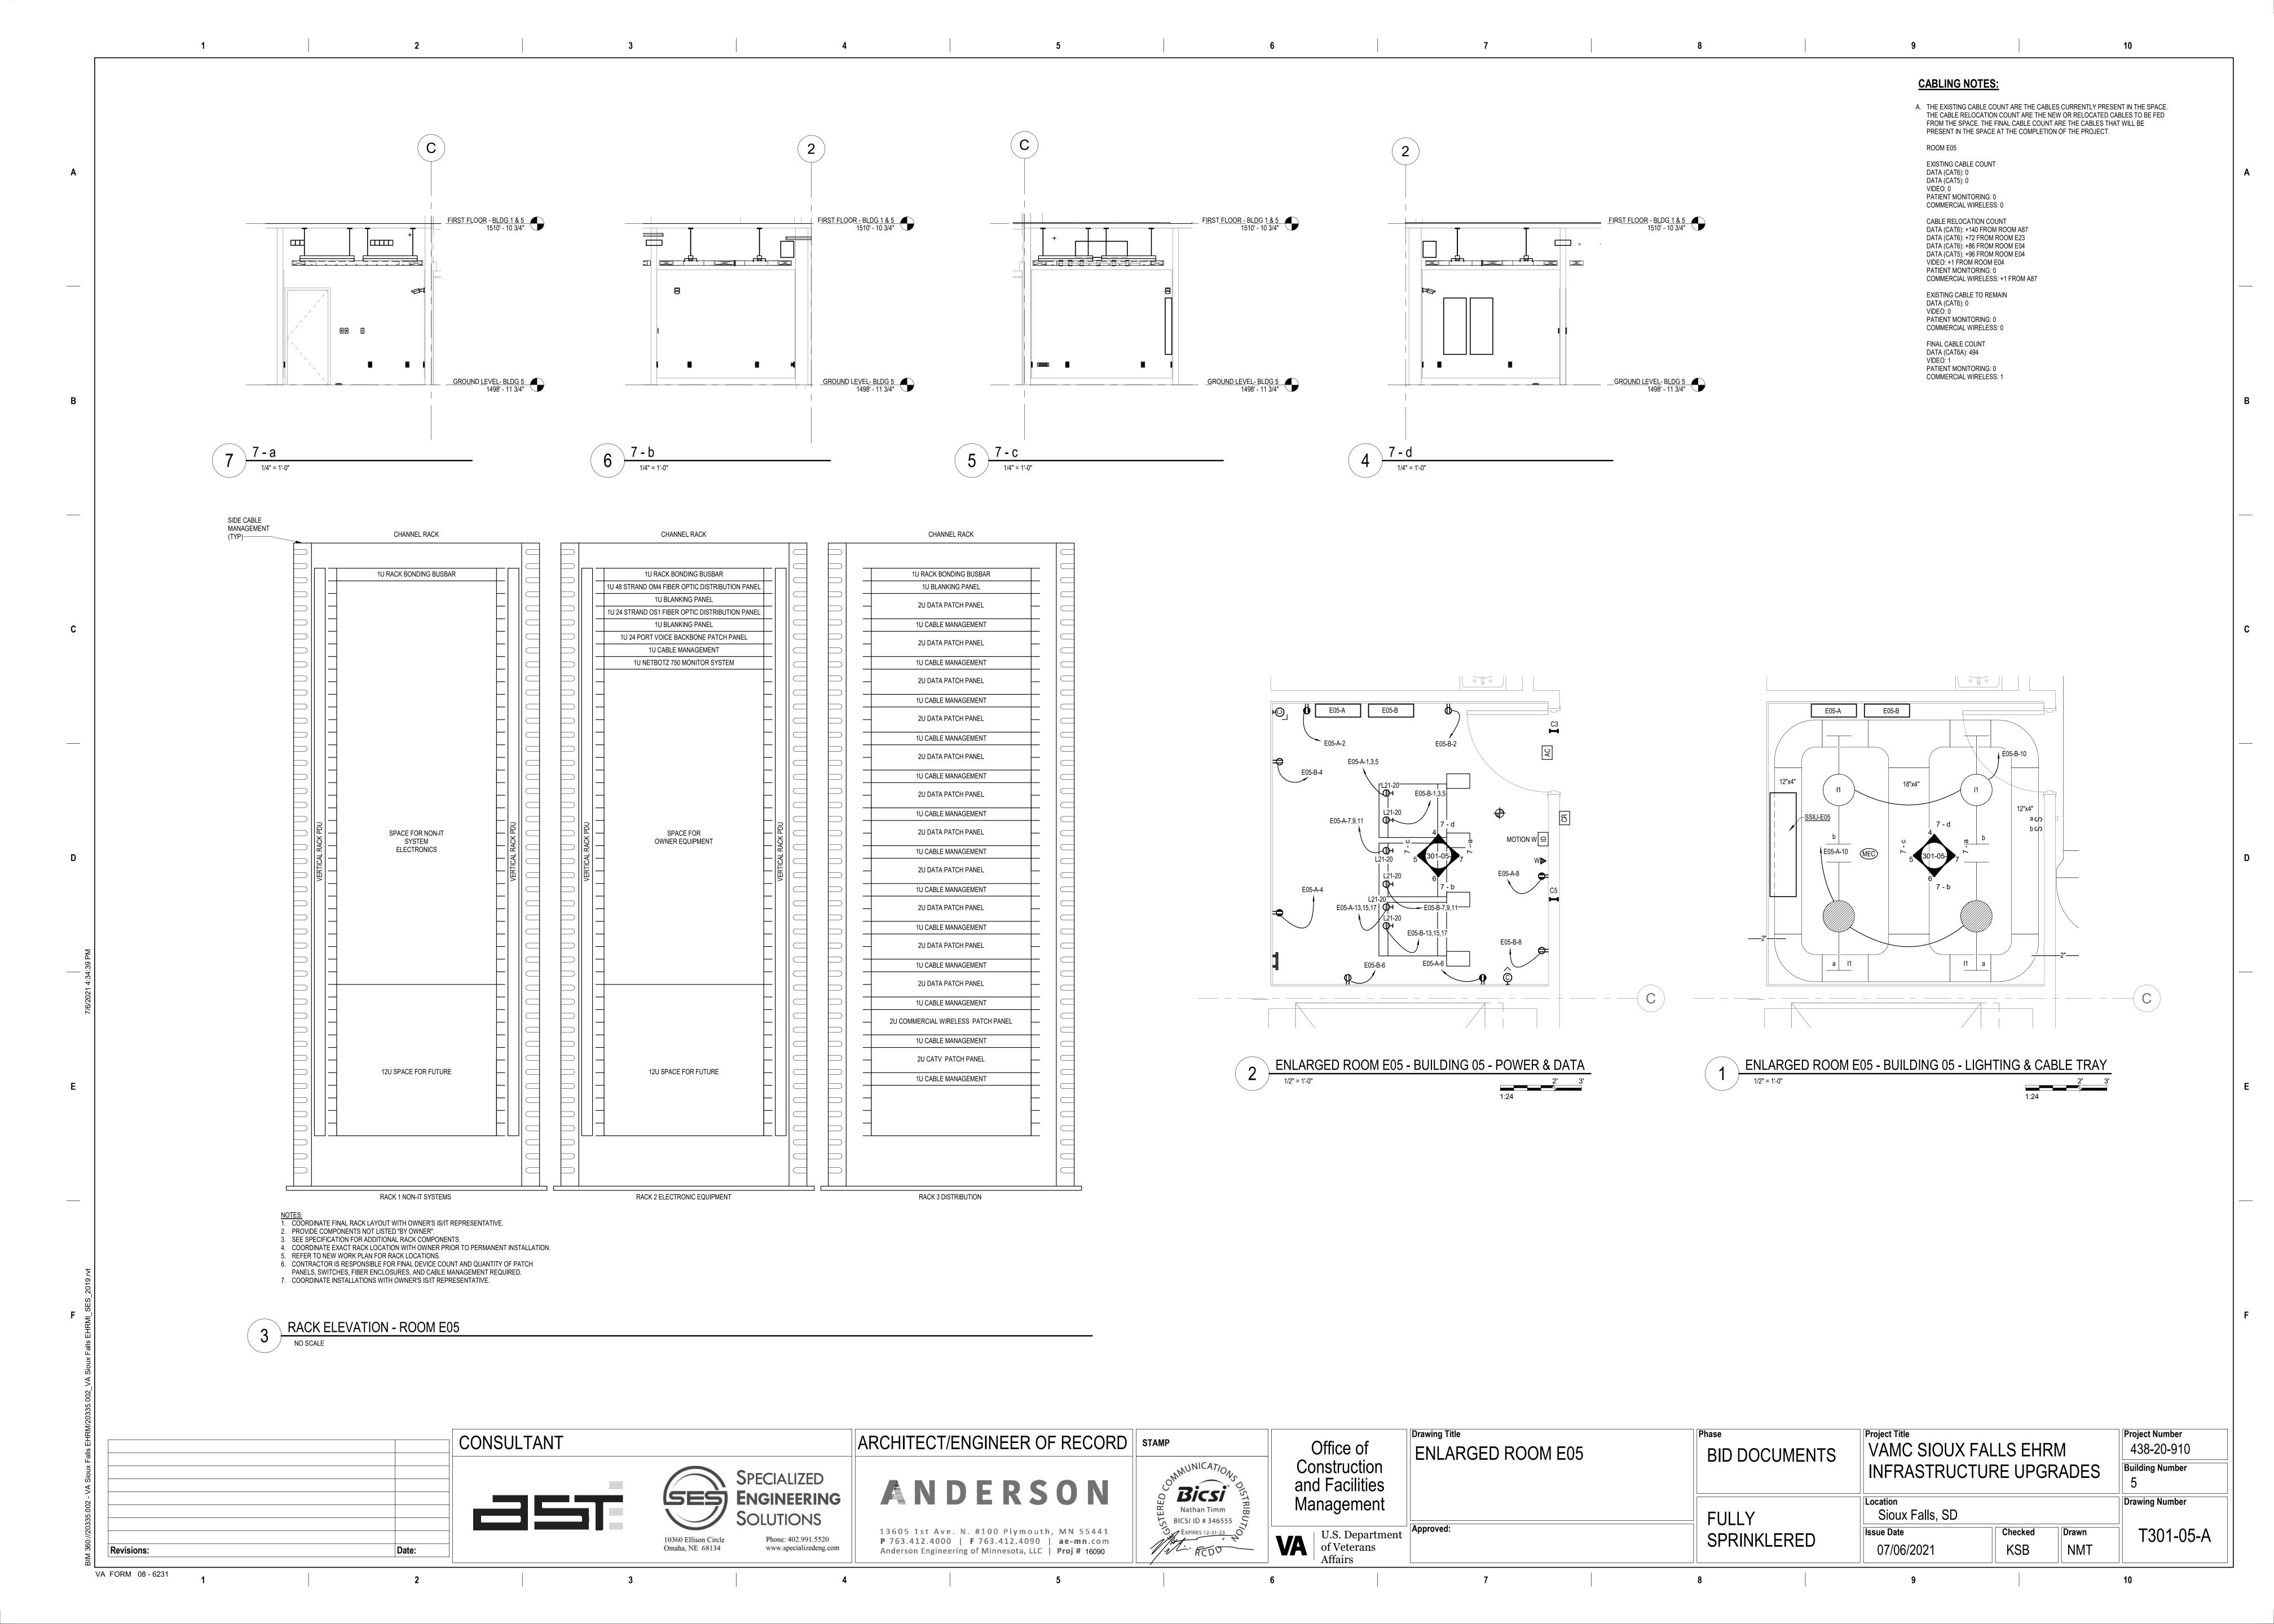


MAINS TYPE: MCB **LOCATION:** ENTRY ROOM E23 **VOLTS:** 208/120 WYE **SUPPLY FROM**: T-B2 PHASES: 3 MCB/MLO RATING: 500 A MCB OPTIONS: NONE **BRANCH:** NORMAL WIRES: 4 SERVICE RATED: No SECTIONS: 1 INTEGRAL SPD: Yes AVAILABLE SCC (kA): 7.7 CIRCUIT DESCRIPTION OPT POLES RATING Load CIRCUIT REMARKS 3 100 A 31450 VA 2 122A-B 3 100 A 12252 VA 3 313-B 3 100 A 18065 VA 4 E05-B 3 100 A 18068 VA 3 100 A 18065 VA 5 149-B 6 106-B 3 100 A 6126 VA 7 296C-B 3 100 A 26040 VA 3 100 A 18065 VA 8 268-B 3 100 A 17885 VA 9 370-B 3 100 A 17885 VA 10 451-B 3 100 A 13150 VA -- 3 100 A 0 VA -- 3 100 A 0 VA -- 3 100 A 0 VA 12 SPARE 3 SPARE 14 SPARE **Total VA:** 197047 VA LOAD CLASSIFICATION CONNECTED LOAD DEMAND FACTOR ESTIMATED DEMAND PANEL TOTALS 495 VA CONNECTED LOAD: 197047 VA 396 VA 125.00% **CONNECTED CURRENT:** 547 A 7380 VA 100.00% 7380 VA **DEMAND LOAD:** 110479 VA 4780 VA 112.11% 5359 VA 184491 VA 52.71% 97246 VA **DEMAND CURRENT:** 307 A **CONSIDER 125% DEMAND:** 138099 A **EQUIPMENT AMPS:** 500 A SPARE CAPACITY: 38 193 A CIRCUIT BREAKER OPTIONS SUFFIX: 'S' OR 'ST' - PROVIDE SHUNT TRIP CIRCUIT BREAKER / 'G' OR 'GFCI' - PROVIDE GFCI CIRCUIT BREAKER / 'GFP' -PROVIDE GFP CIRCUIT BREAKER / 'ERMS' - ENERGY REDUCING MAINTENANCE SWITCH / 'ZSI' - ZONE SELECTIVE INTERLOCKING / 'L' - PROVIDE CIRCUIT BREAKER WITH LOCKING PROVISIONS **GENERAL REMARKS:** A. PANEL AIC (INTERRUPTING) RATING SHALL BE MINIMUM 120% OF THE AVAILABLE SCC (SHORT CIRCUIT CURRENT).

LOCATION: ENTRY RO SUPPLY FROM: BRANCH: CRITICAL SERVICE RATED: No	OOM E23	INTEG AVAILABLE	PHASES: WIRES: RAL SPD:	4 Yes	MAINS TYPE: MCB MCB/MLO RATING: 600 A MCB OPTIONS: NONE SECTIONS: 1	
CKT CIRCUIT DE	ESCRIPTION	OPT POLES	RATING	Load (CIRCUIT REMARKS	
1 037-A		3	100 A	33258 VA		
2 122A-A		3	100 A	14512 VA		
3 313-A		3	100 A	20860 VA		
4 E05-A		3	100 A	21043 VA		
5 149-A		3	100 A	21040 VA		
6 106-A		3	100 A	8566 VA		
7 296C-A		3	100 A	26040 VA		
8 268-A		3	100 A	21040 VA		
9 370-A		3	100 A	21040 VA		
10 451-A 11 546-A		3	100 A	21040 VA		
11 546-A 12 SPARE		- 3 3	100 A 100 A	14690 VA 0 VA		
13 SPARE		3	100 A	0 VA		
14 SPARE		3	100 A	0 VA		
15			10071	0 771		
16						
17						
18						
19						
20						
			Total VA:			
OAD CLASSIFICATION	CONNECTED LOAD	DEMAND FA	ACTOR	ESTIMATED DEM	AND PANEL T	OTALS
.TG	545 VA	125.00	%	681 VA	CONNECTED LOAD:	223124 VA
REC	6660 VA	100.00	%	6660 VA	CONNECTED CURRENT:	619 A
MTR	31428 VA	102.27	%	32142 VA	DEMAND LOAD:	136728 VA
PWR-NC	184491 VA	52.71%	6	97246 VA	DEMAND CURRENT:	380 A
					CONSIDER 125% DEMAND:	170910 A
					EQUIPMENT AMPS:	600 A
					SPARE CAPACITY:	36
					017112 07117101111	220 A
			II.			
		_				
OPTIONS:						
PROVIDE GFP CIRCUIT BREA	KER / 'ERMS' - ENERGY RED				OR 'GFCI' - PROVIDE GFCI CIRCUIT IE SELECTIVE INTERLOCKING / 'L	
CIRCUIT BREAKER OPTIONS	KER / 'ERMS' - ENERGY RED					

	LOCATION: TE SUPPLY FROM: B2 BRANCH: NO SERVICE RATED: NO MOUNTING: SU NEMA ENCLOSURE: 1	2 ORMAL O			AV		VOLTS PHASES WIRES GRAL SPD SCC (kA)	6: 4 6: Yes	0 WYE			MCB/ML MCE	O RAT OPTION	YPE: MCB ING: 100 A ONS: NONE ONS: 1 LES: 42		
C	CIRCUIT DESCRIPTION	OPT	RATI	POL		Α	E	3		<u> </u>	POL	RATI	ОРТ	CIRC	UIT DESCRIPTION	(
1 .	PWR-C TELECOM E05 - RACK				1922	180 VA					1	20 A		REC TELEC	OM E05	
I	RECEPTACLE		20 A	3			1922 VA	180 VA			1	20 A		REC TELEC		
5					1000	1001/4			1922 VA	180 VA	1	20 A		REC TELEC		
7 0	PWR-C TELECOM E05 - RACK		00.4		1922	180 VA	4000 \ / 4	50.)/4			1	20 A		REC TELEC		
_9 F	RECEPTACLE		20 A	3			1922 VA	50 VA	4000 \/A		1	20 A		LTG TELEC	JM E05	
11					1022				1922 VA							
	PWR-C TELECOM E05 - RACK		20.4	2	1922		1022 \/A									
15 17	RECEPTACLE		20 A	3			1922 VA		1922 VA							
19			+		0 VA				1922 VA							
	SPARE		20 A	3	UVA		0 VA									
23	O. , u.L		207				UVA		0 VA							
	SPARE		20 A	1	0 VA				3 1/1							
	SPARE		20 A	1	3 7/1		0 VA									
	SPARE		20 A	1			3 .71		0 VA							
	SPARE		20 A	1	0 VA											
33																
35																
37																
39																
41																
_OAE	O CLASSIFICATION		TOTAL		: 5 ΓED LOA	1 A DEN	50 MAND FAC		50 ESTIMAT	ED DEM	AND			PANEL	TOTALS	
_TG					VA		125.00%)		2 VA				CTED LOAD:		
REC					VA		100.00%			20 VA		CONN	ECTE	CURRENT:	50 A	
PWR-	-NC			1729	8 VA		78.91%		136	649 VA				MAND LOAD:		
														CURRENT:	-	
														% DEMAND:		
														MENT AMPS:	100 A	
												FE	EDER .	AVAILABLE:	50 0/	
													SPARE	CAPACITY:	59 %	
															60 A	
CIRC	ONS: UIT BREAKER OPTIONS SUFFIX: ' UIT BREAKER / 'ERMS' - ENERGY F /ISIONS / 'R' - PROVIDE CIRCUIT	REDUCIN	IG MAINT	ENAN	CE SWIT	CH / 'ZSI')

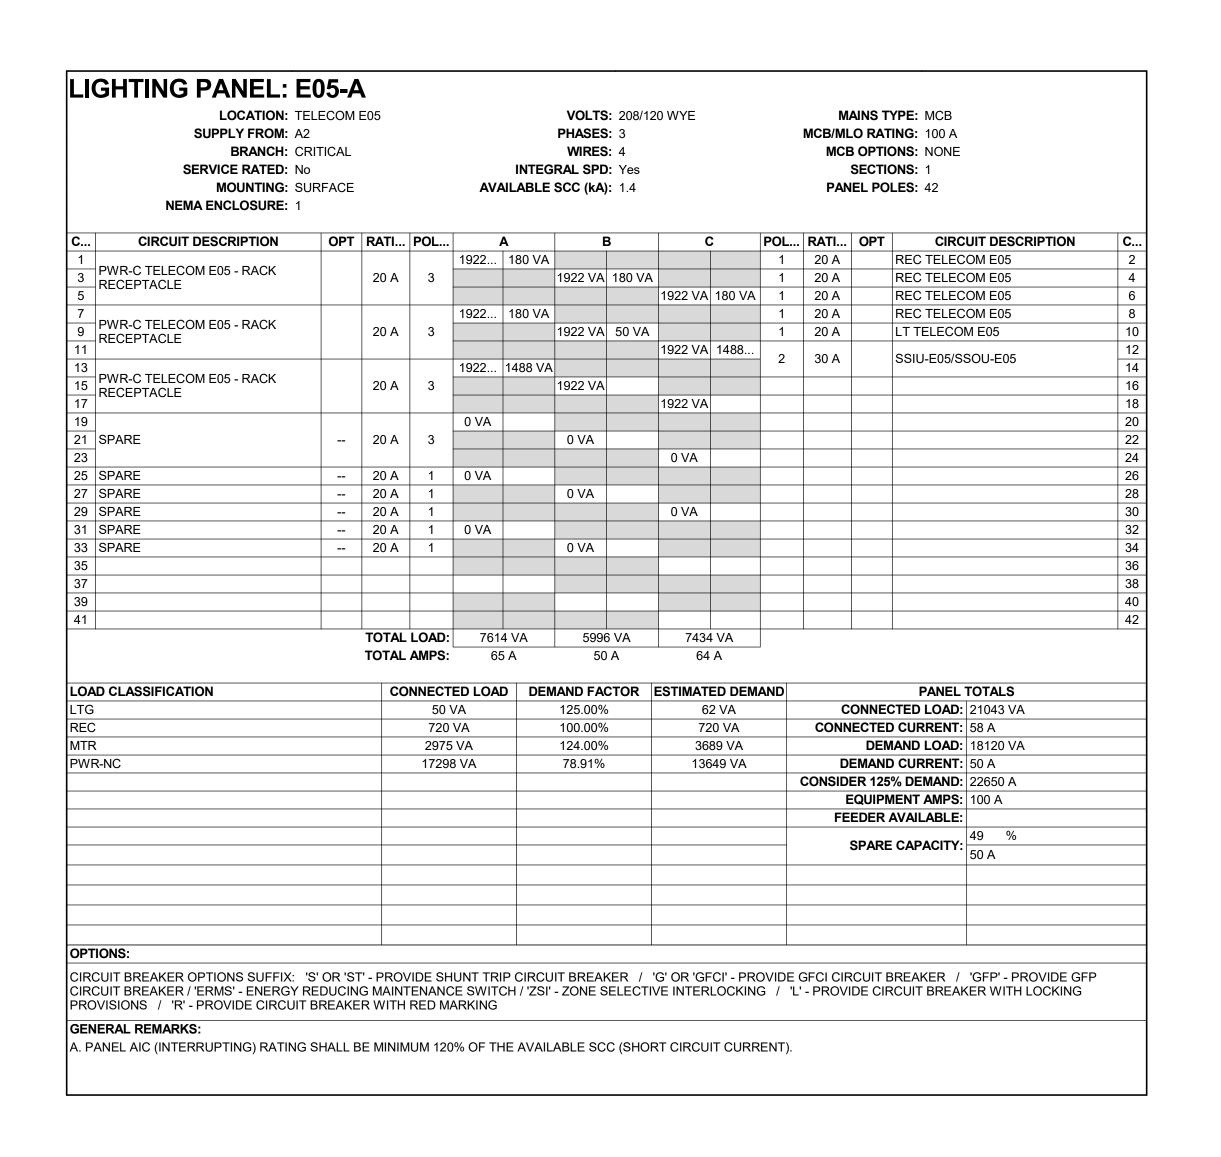

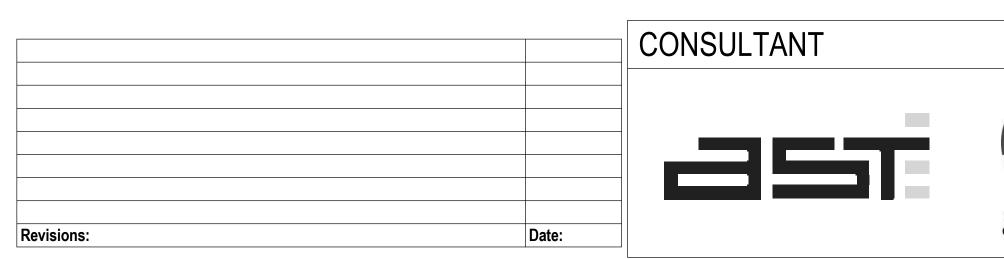

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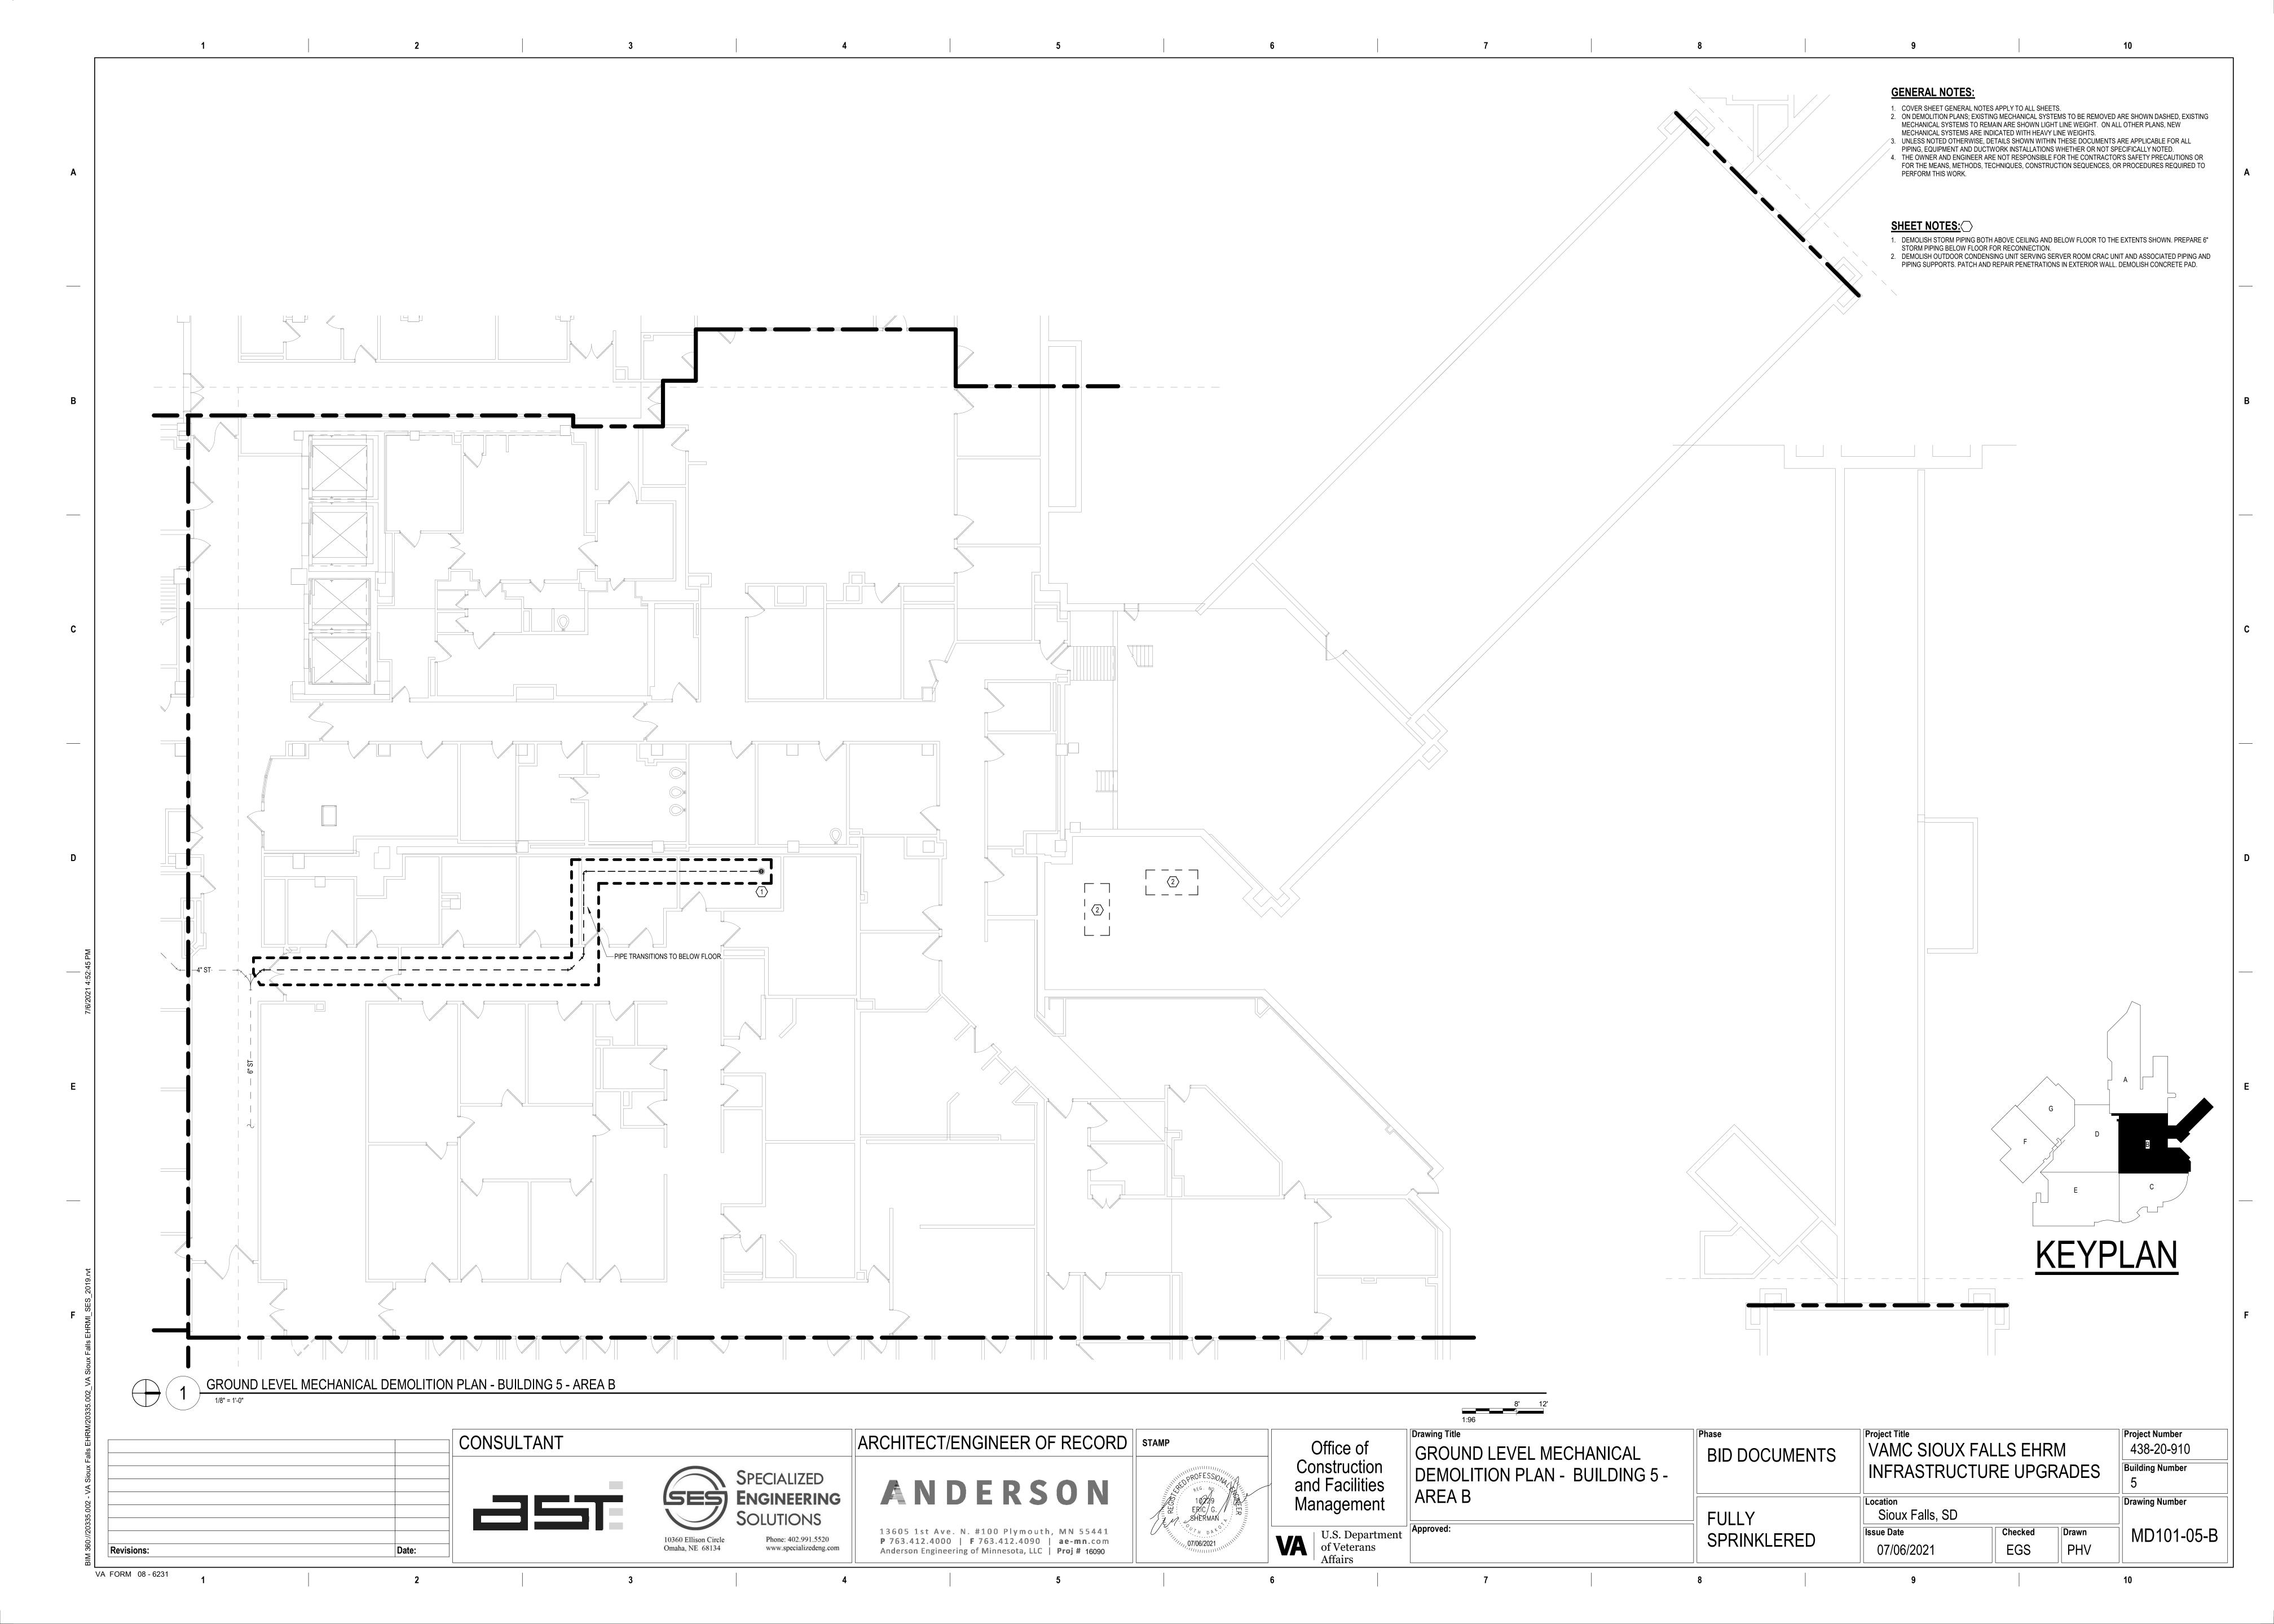






Co	Office of onstruction d Facilities inagement
VA	U.S. Department of Veterans Affairs


Drawing Title
PANEL SCHEDULES - BUILDING 5 -
GROUND LEVEL - AREA A
 Approved:


Phase BID DOCUMENTS	Project Title VAMC SIOUX INFRASTRUC			Project Number 438-20-910 Building Number 5
FULLY SPRINKLERED	Location Sioux Falls, SD Issue Date 07/06/2021	Checked KSB	Drawn NMT	Drawing Number EE401-05-A




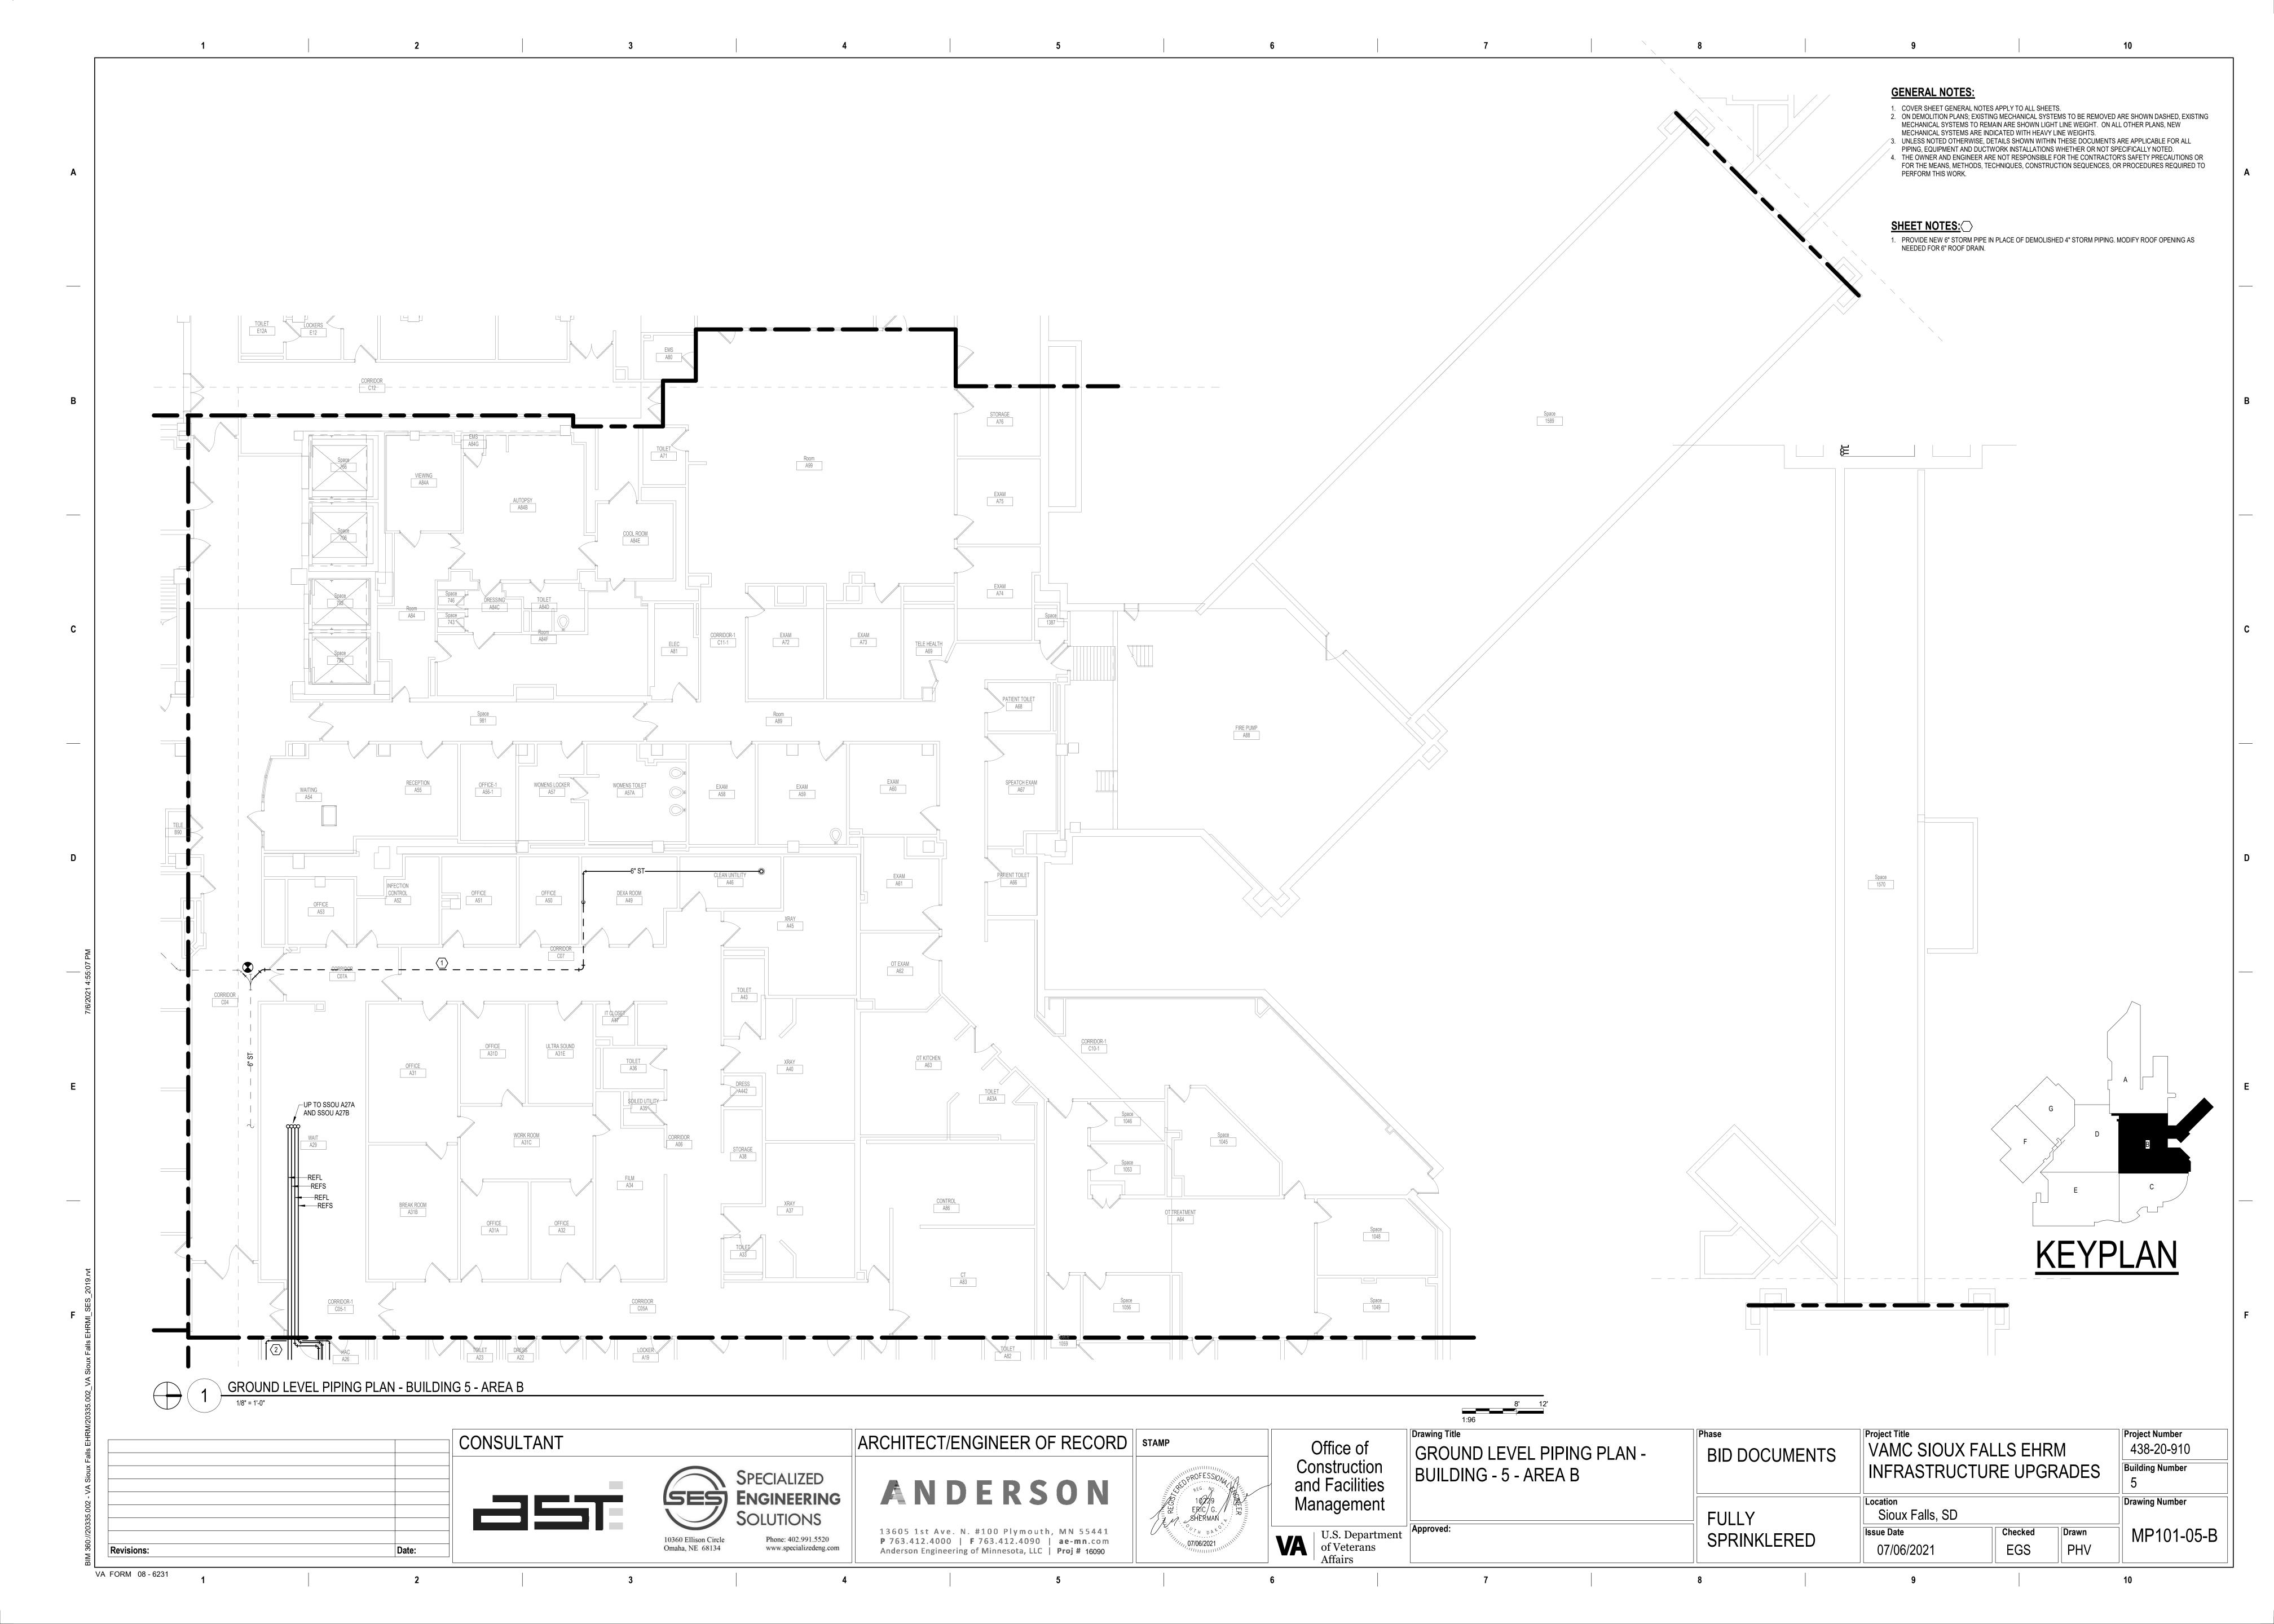


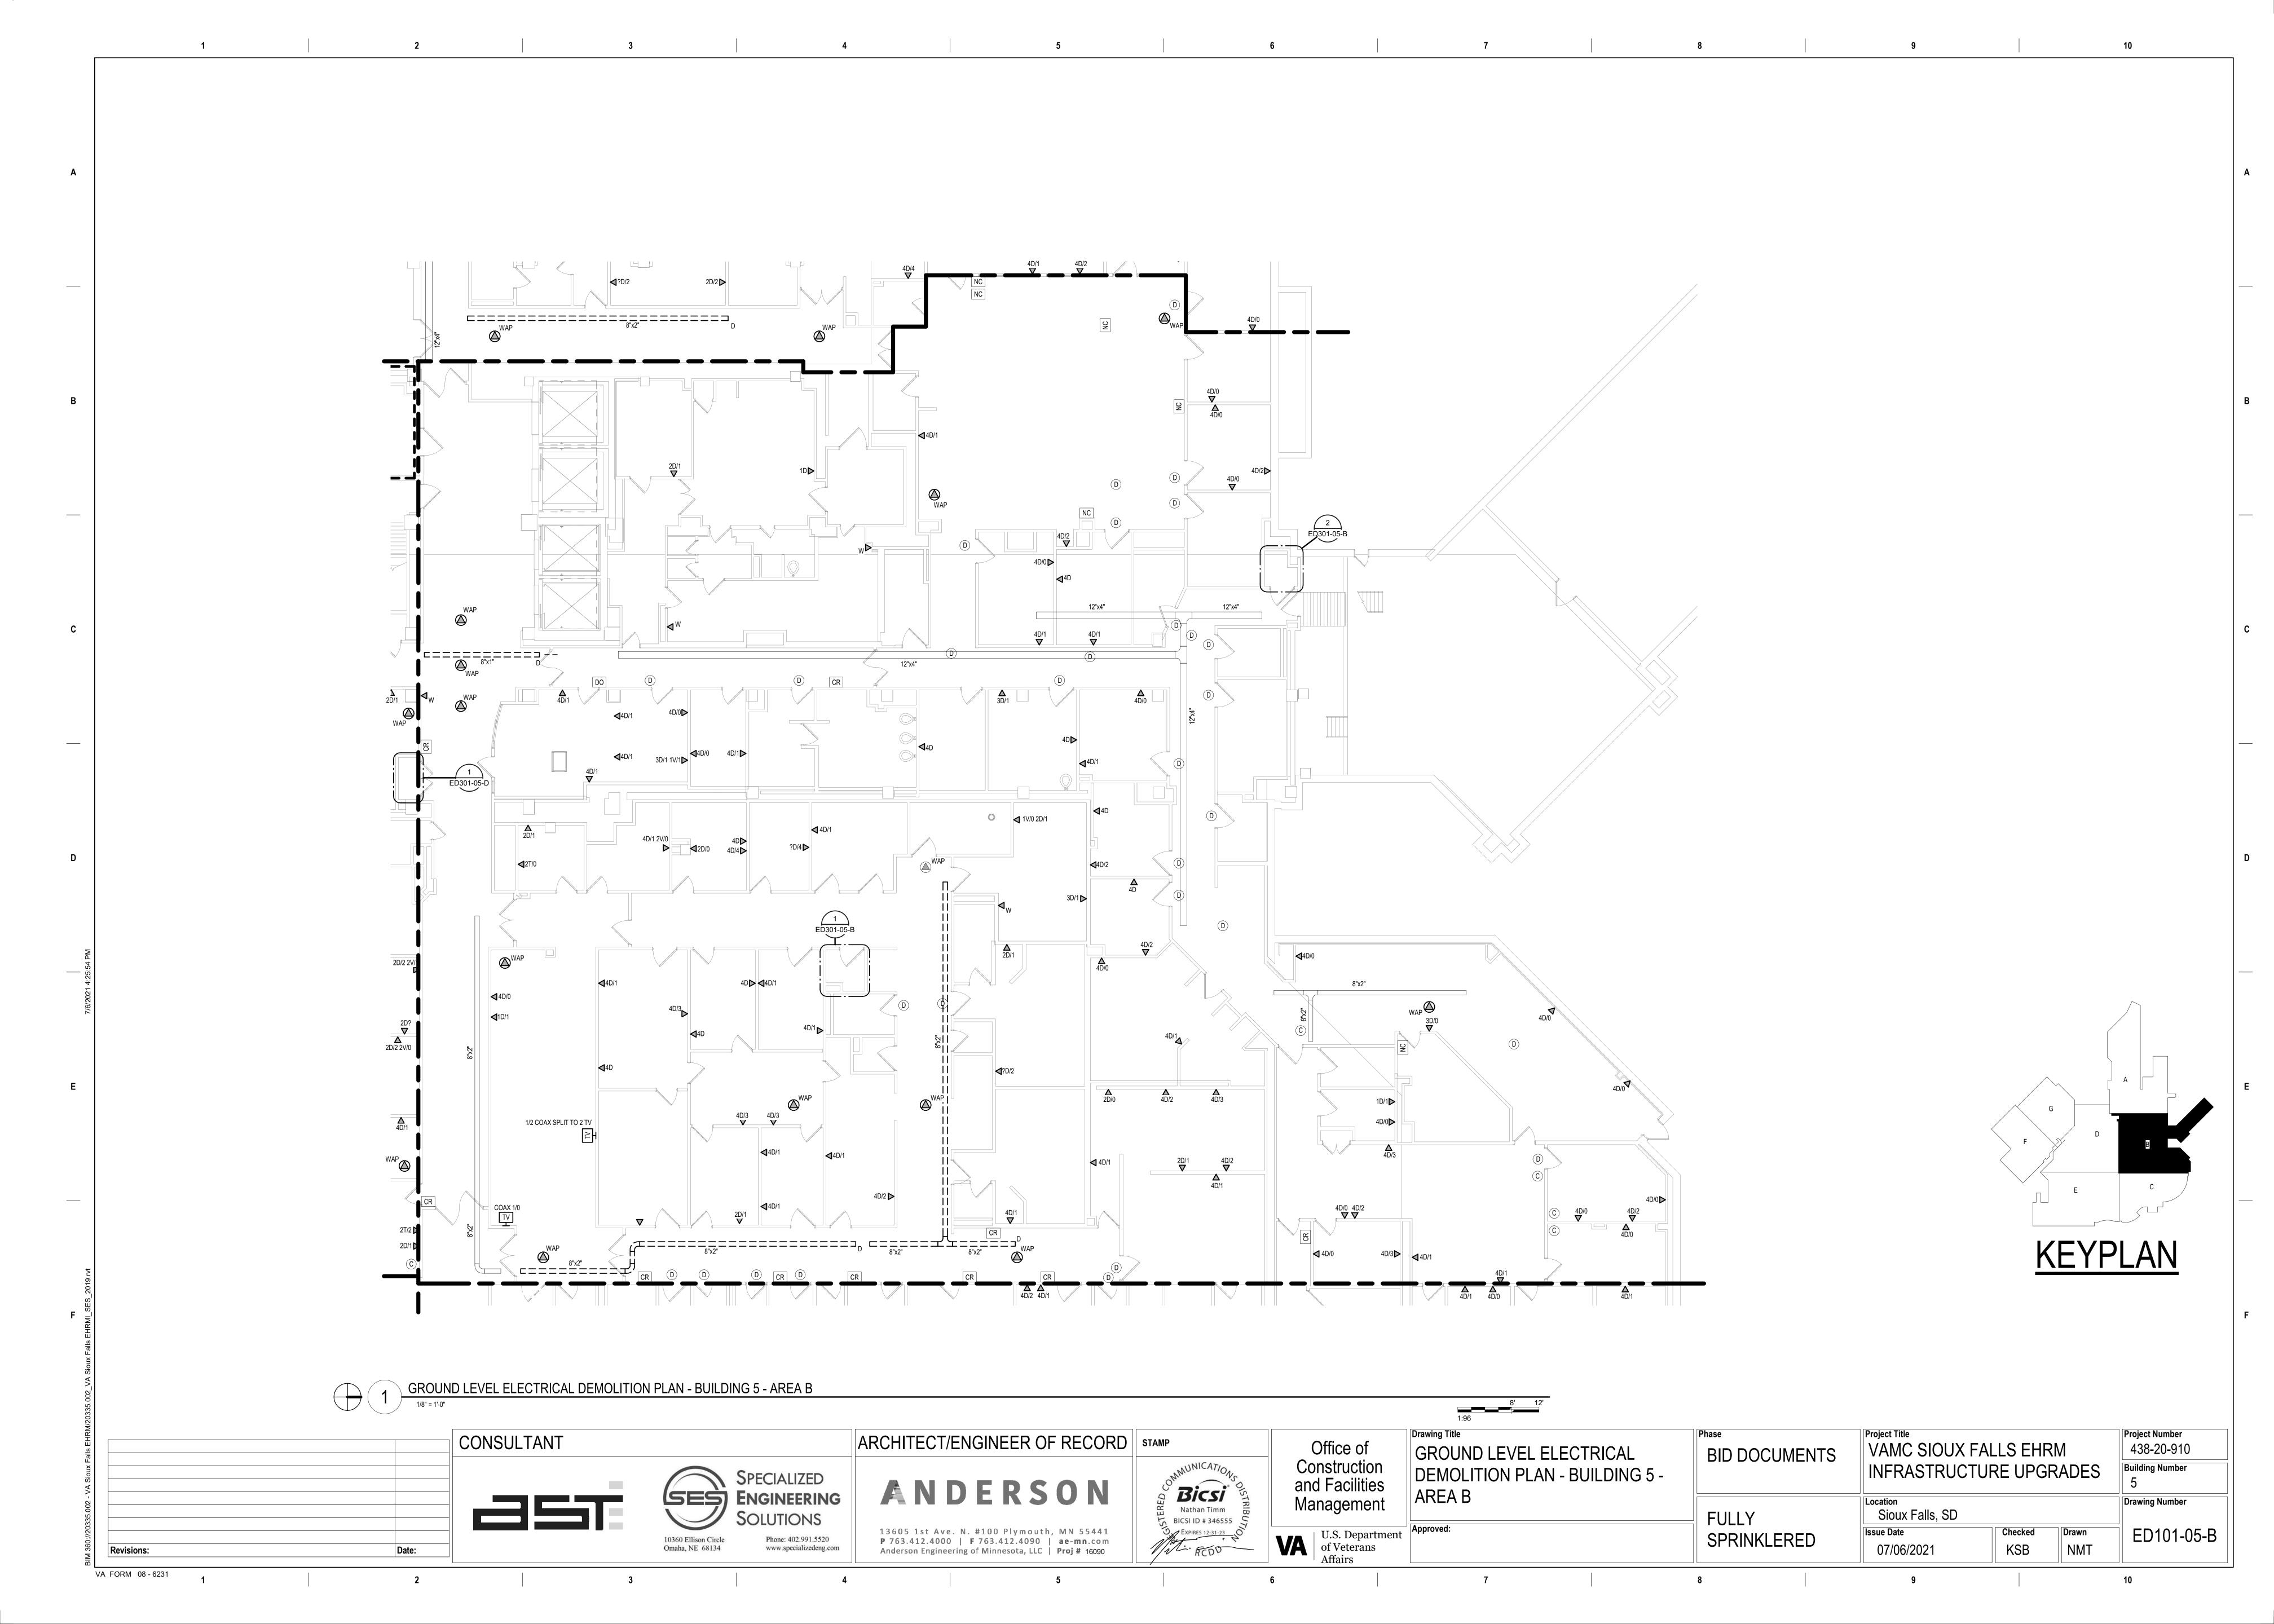


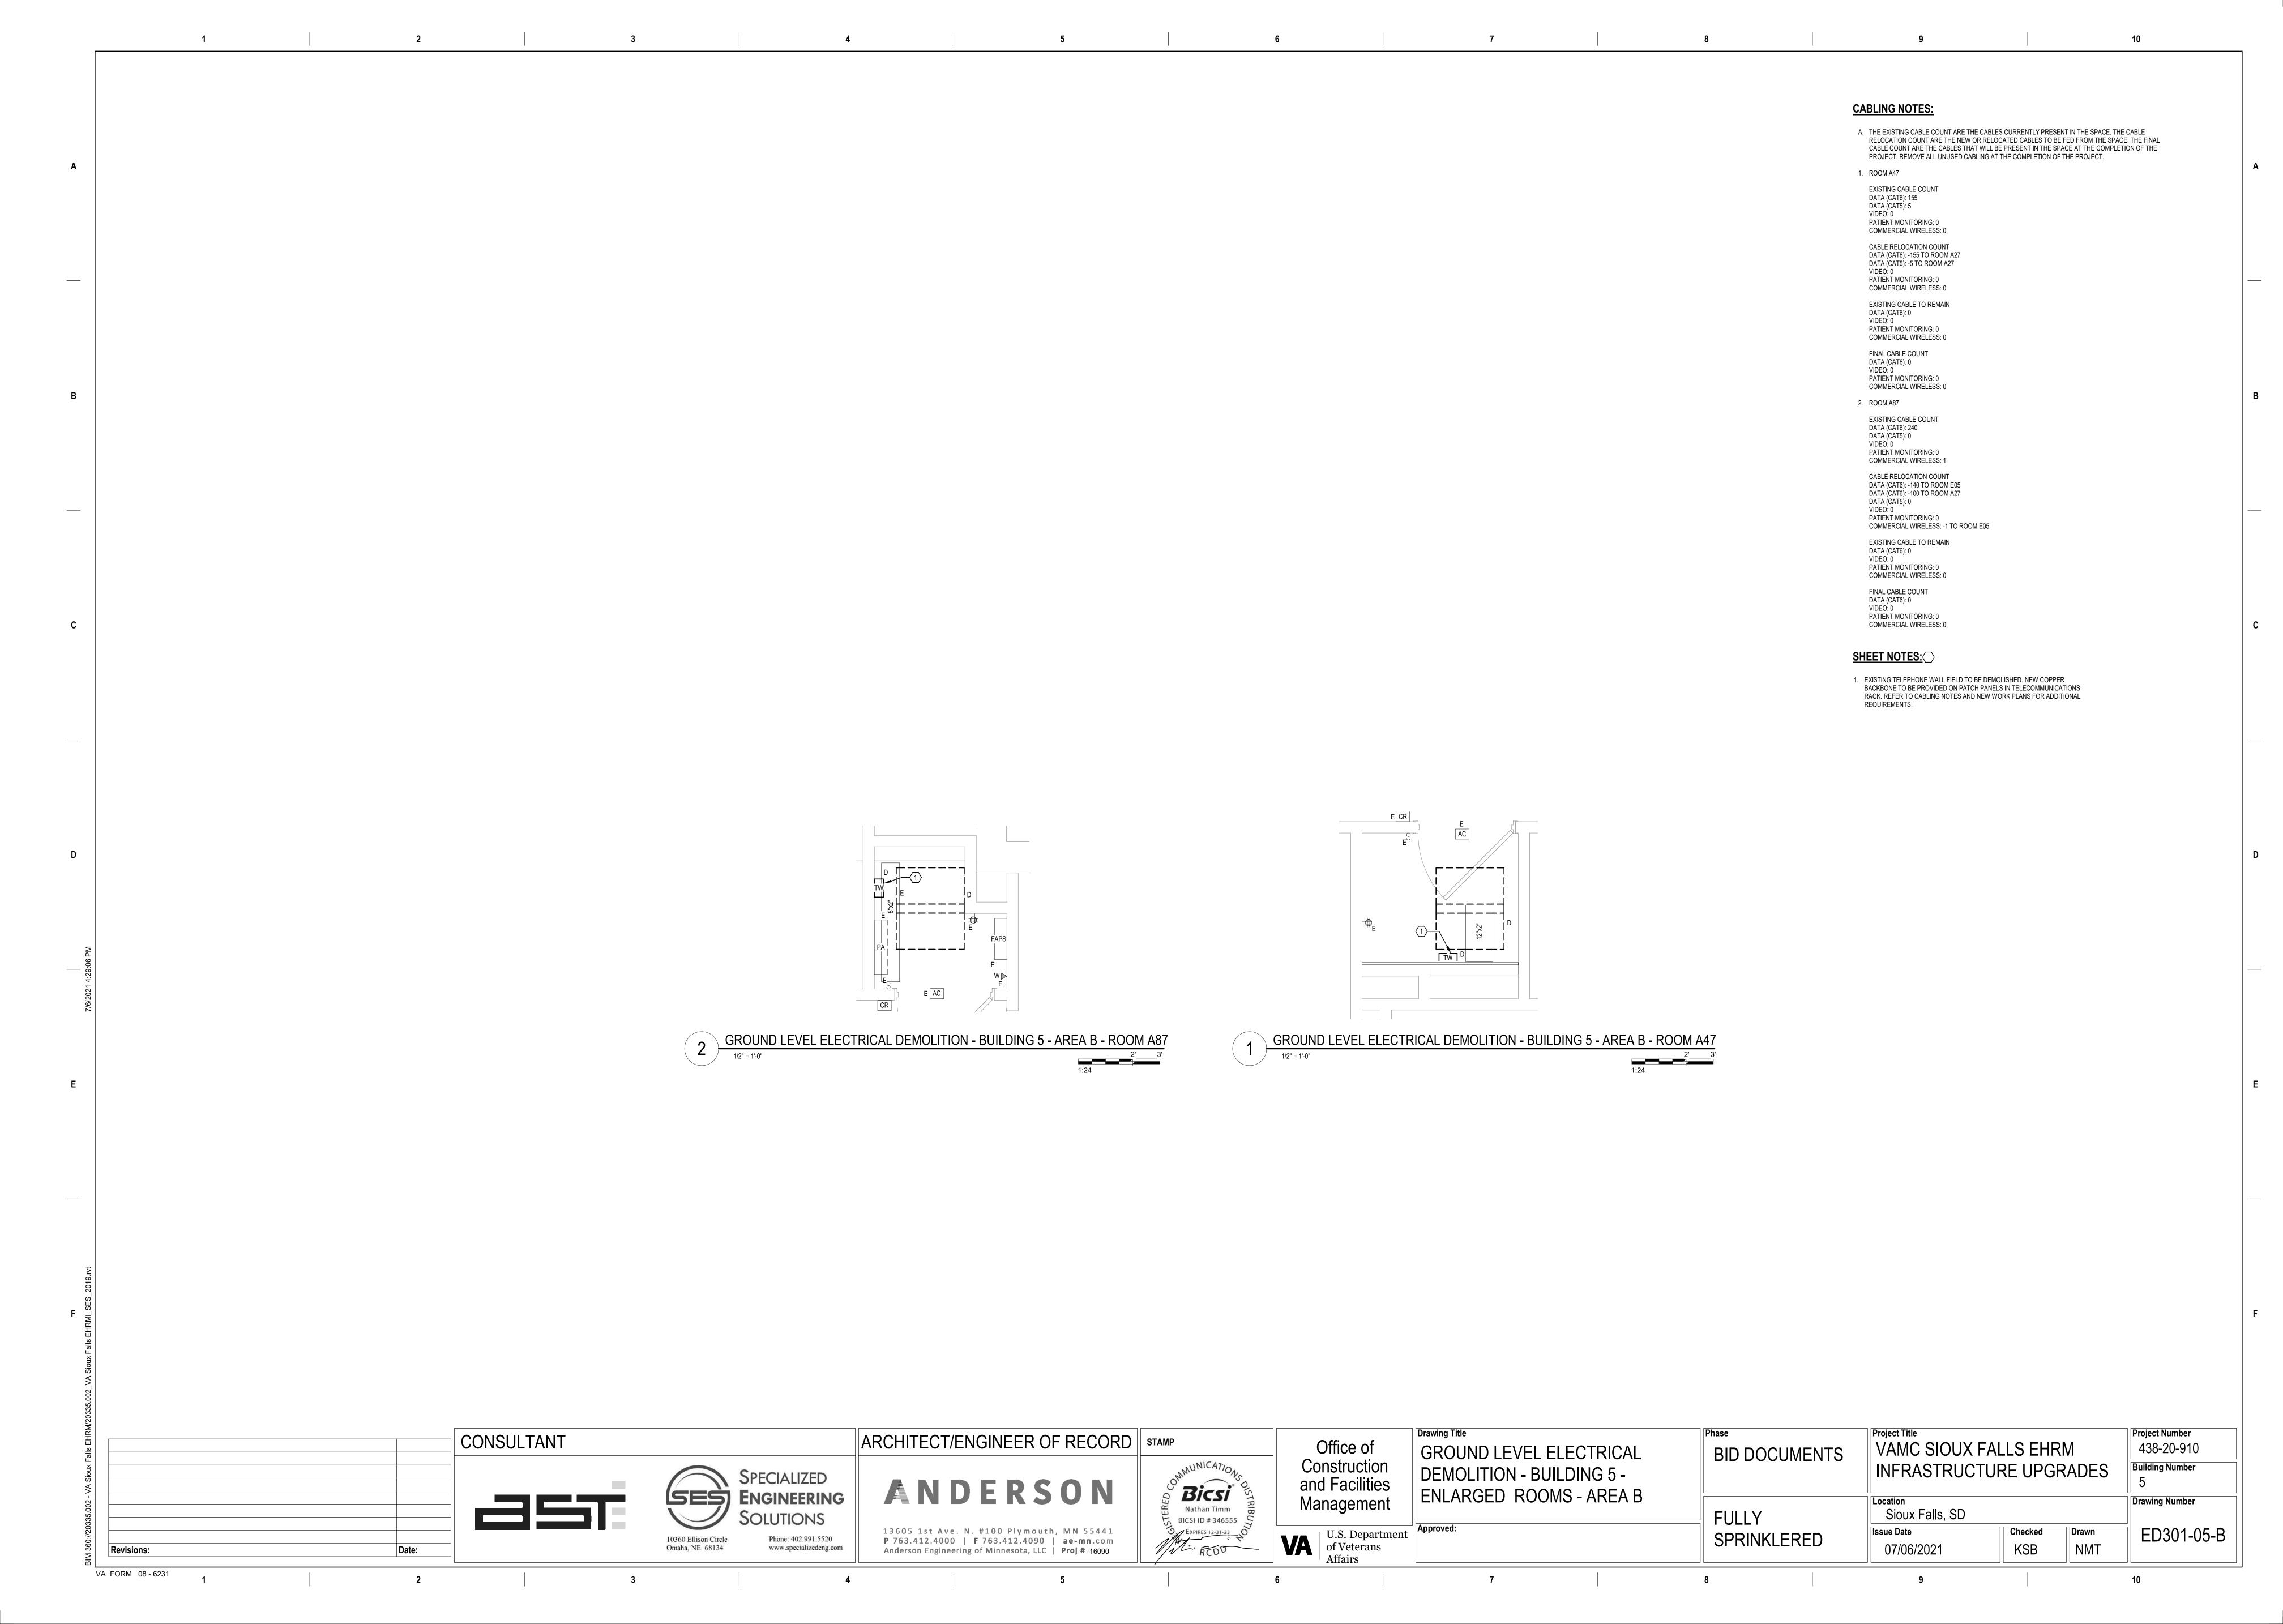


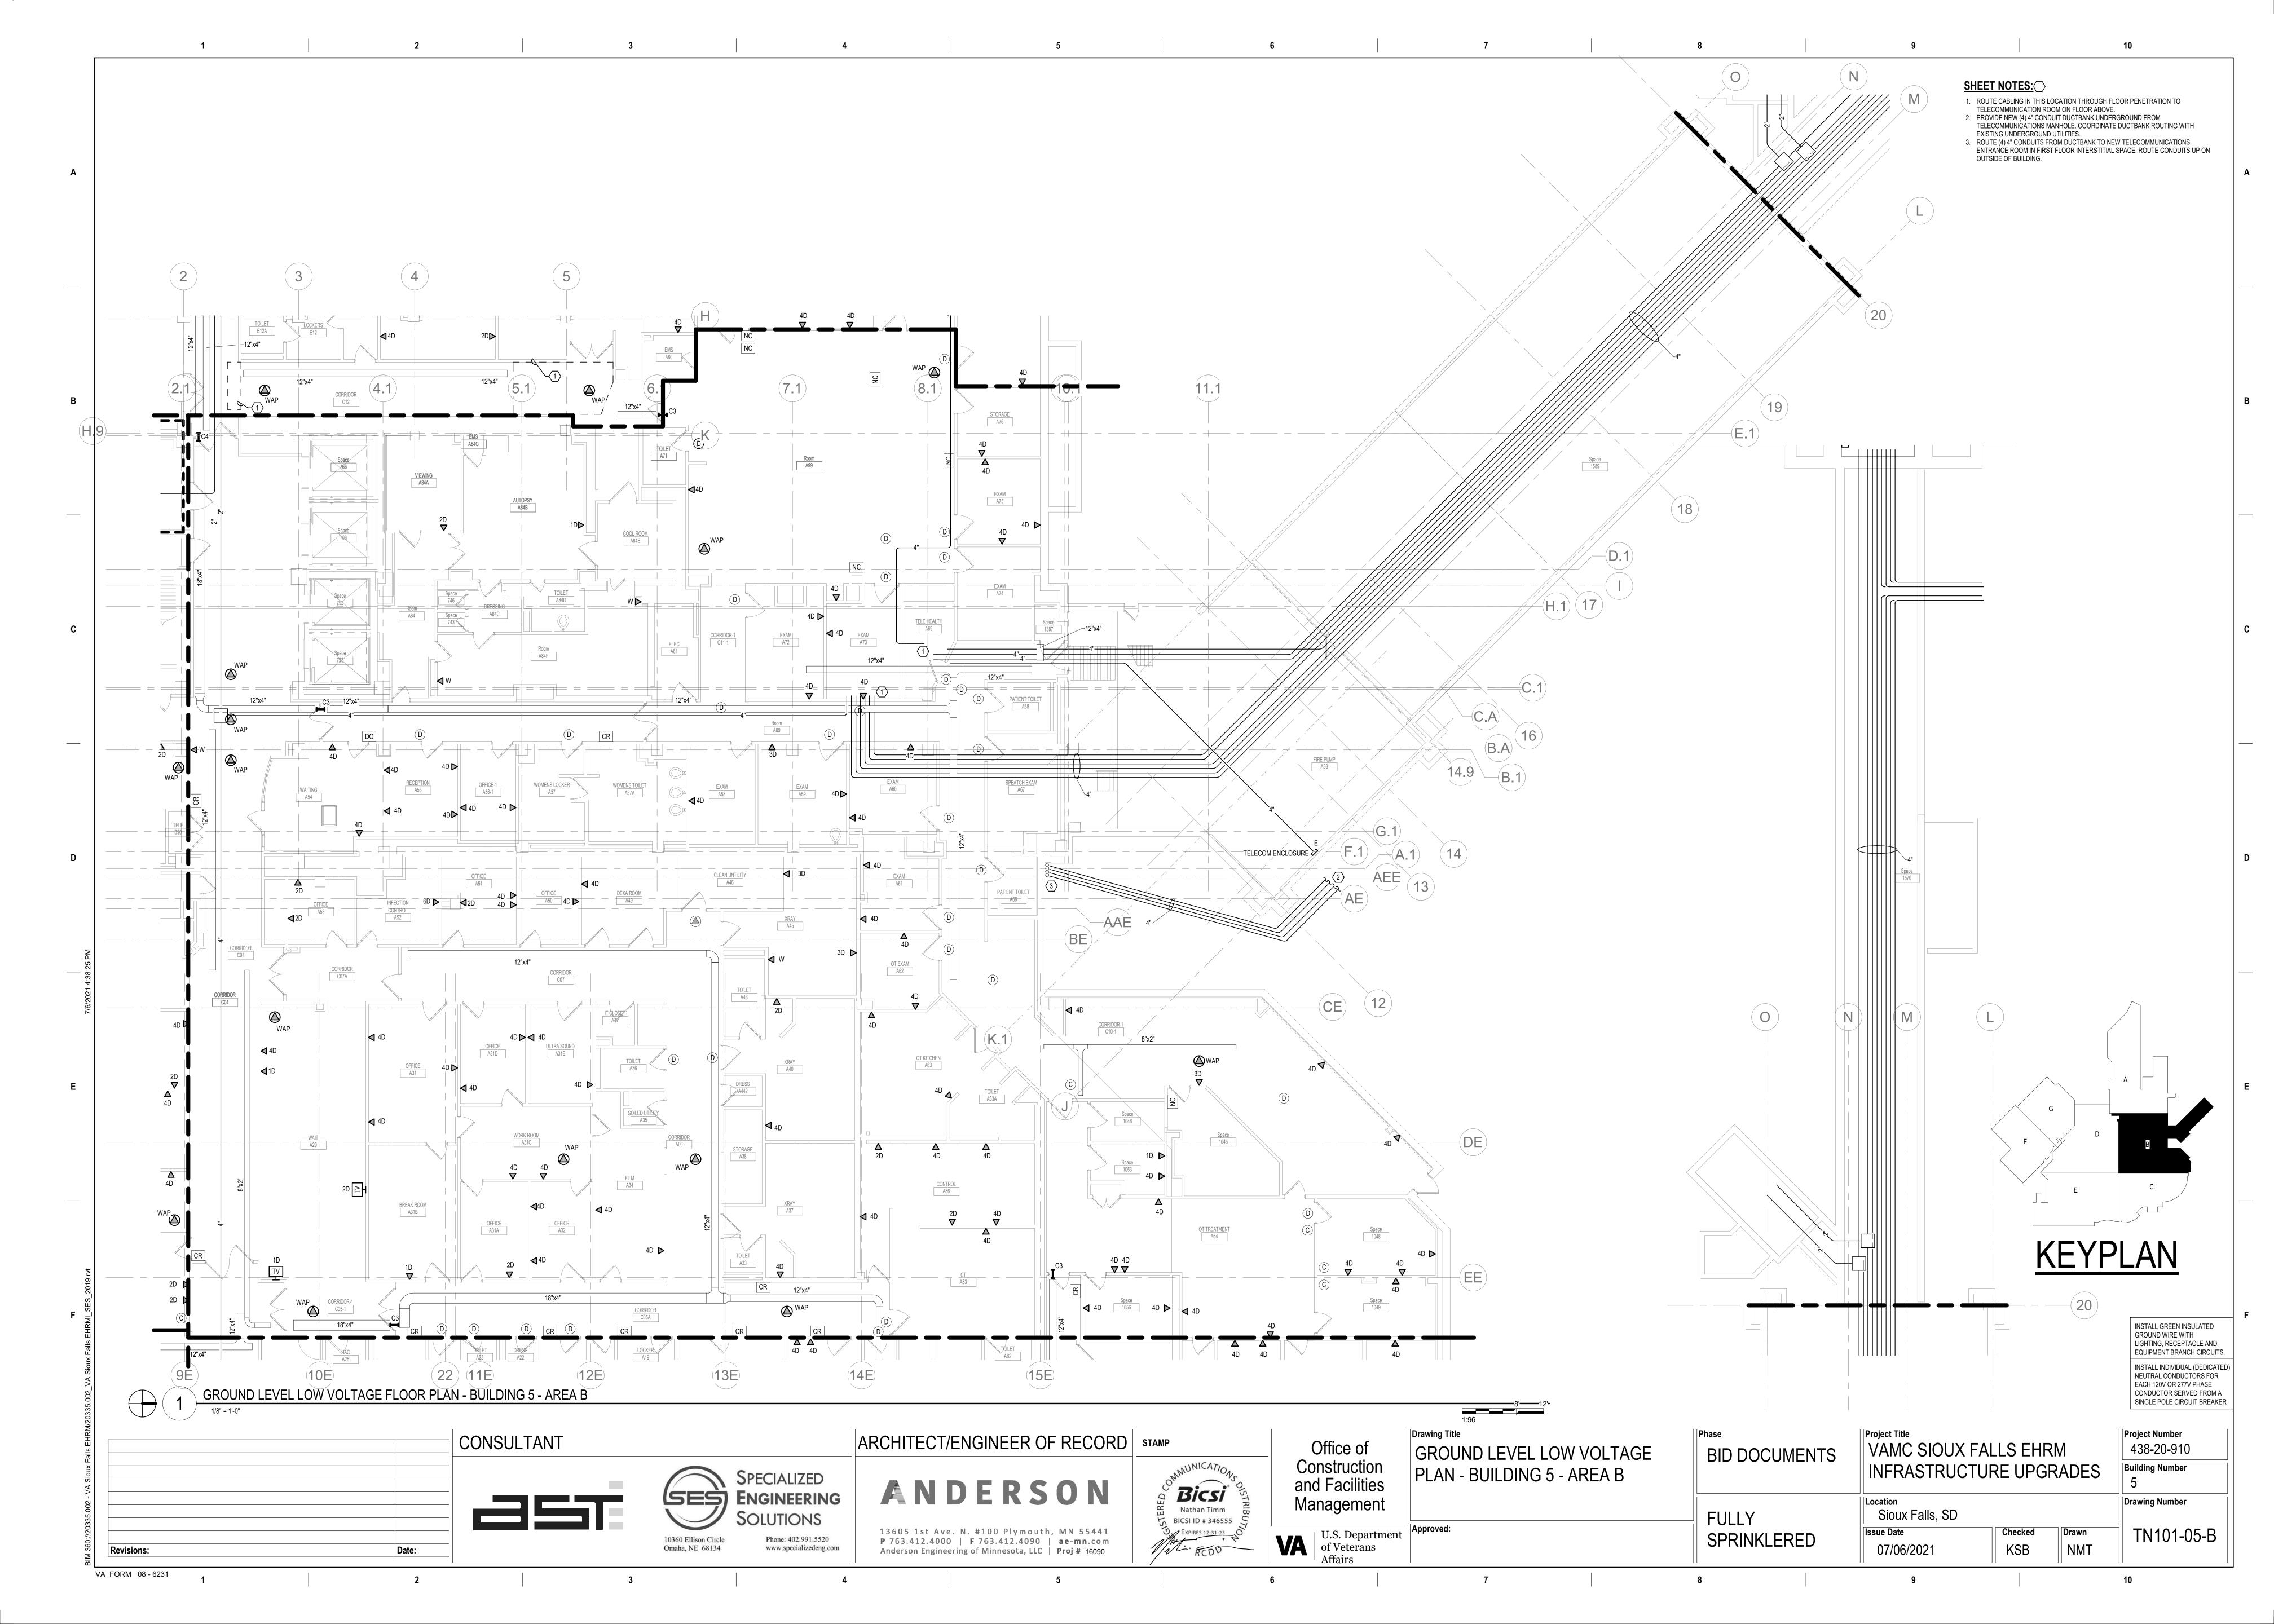


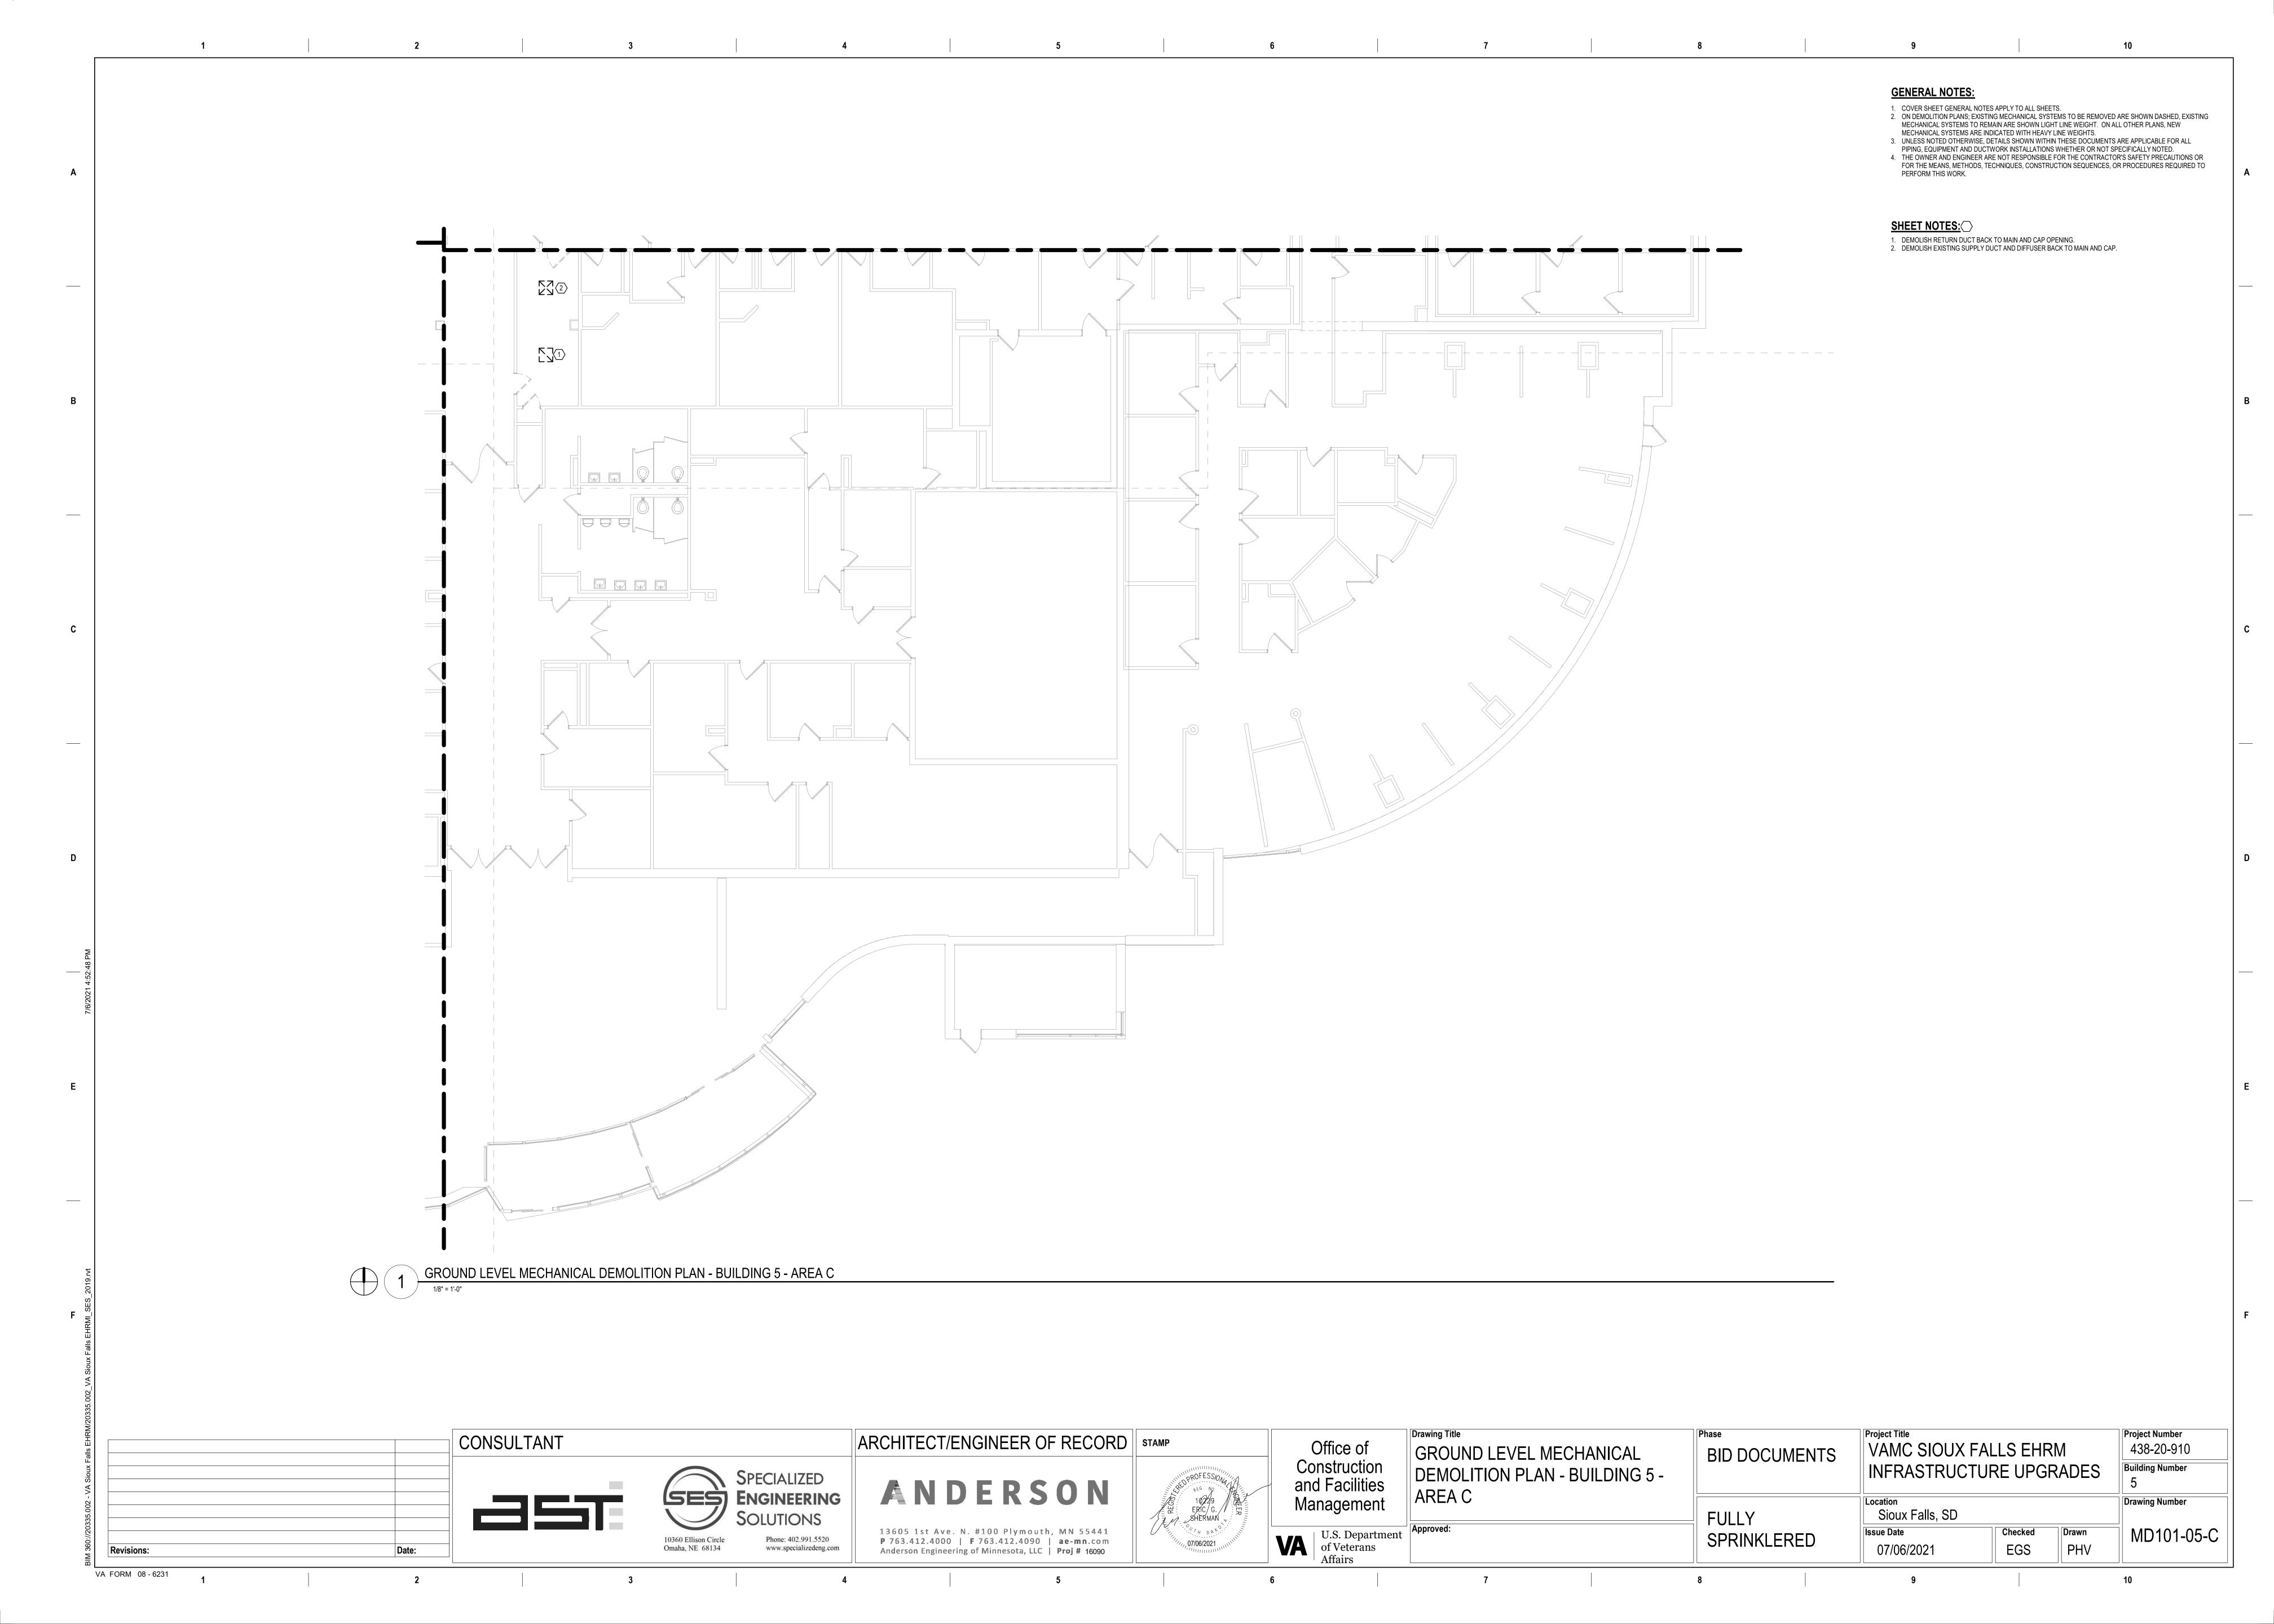


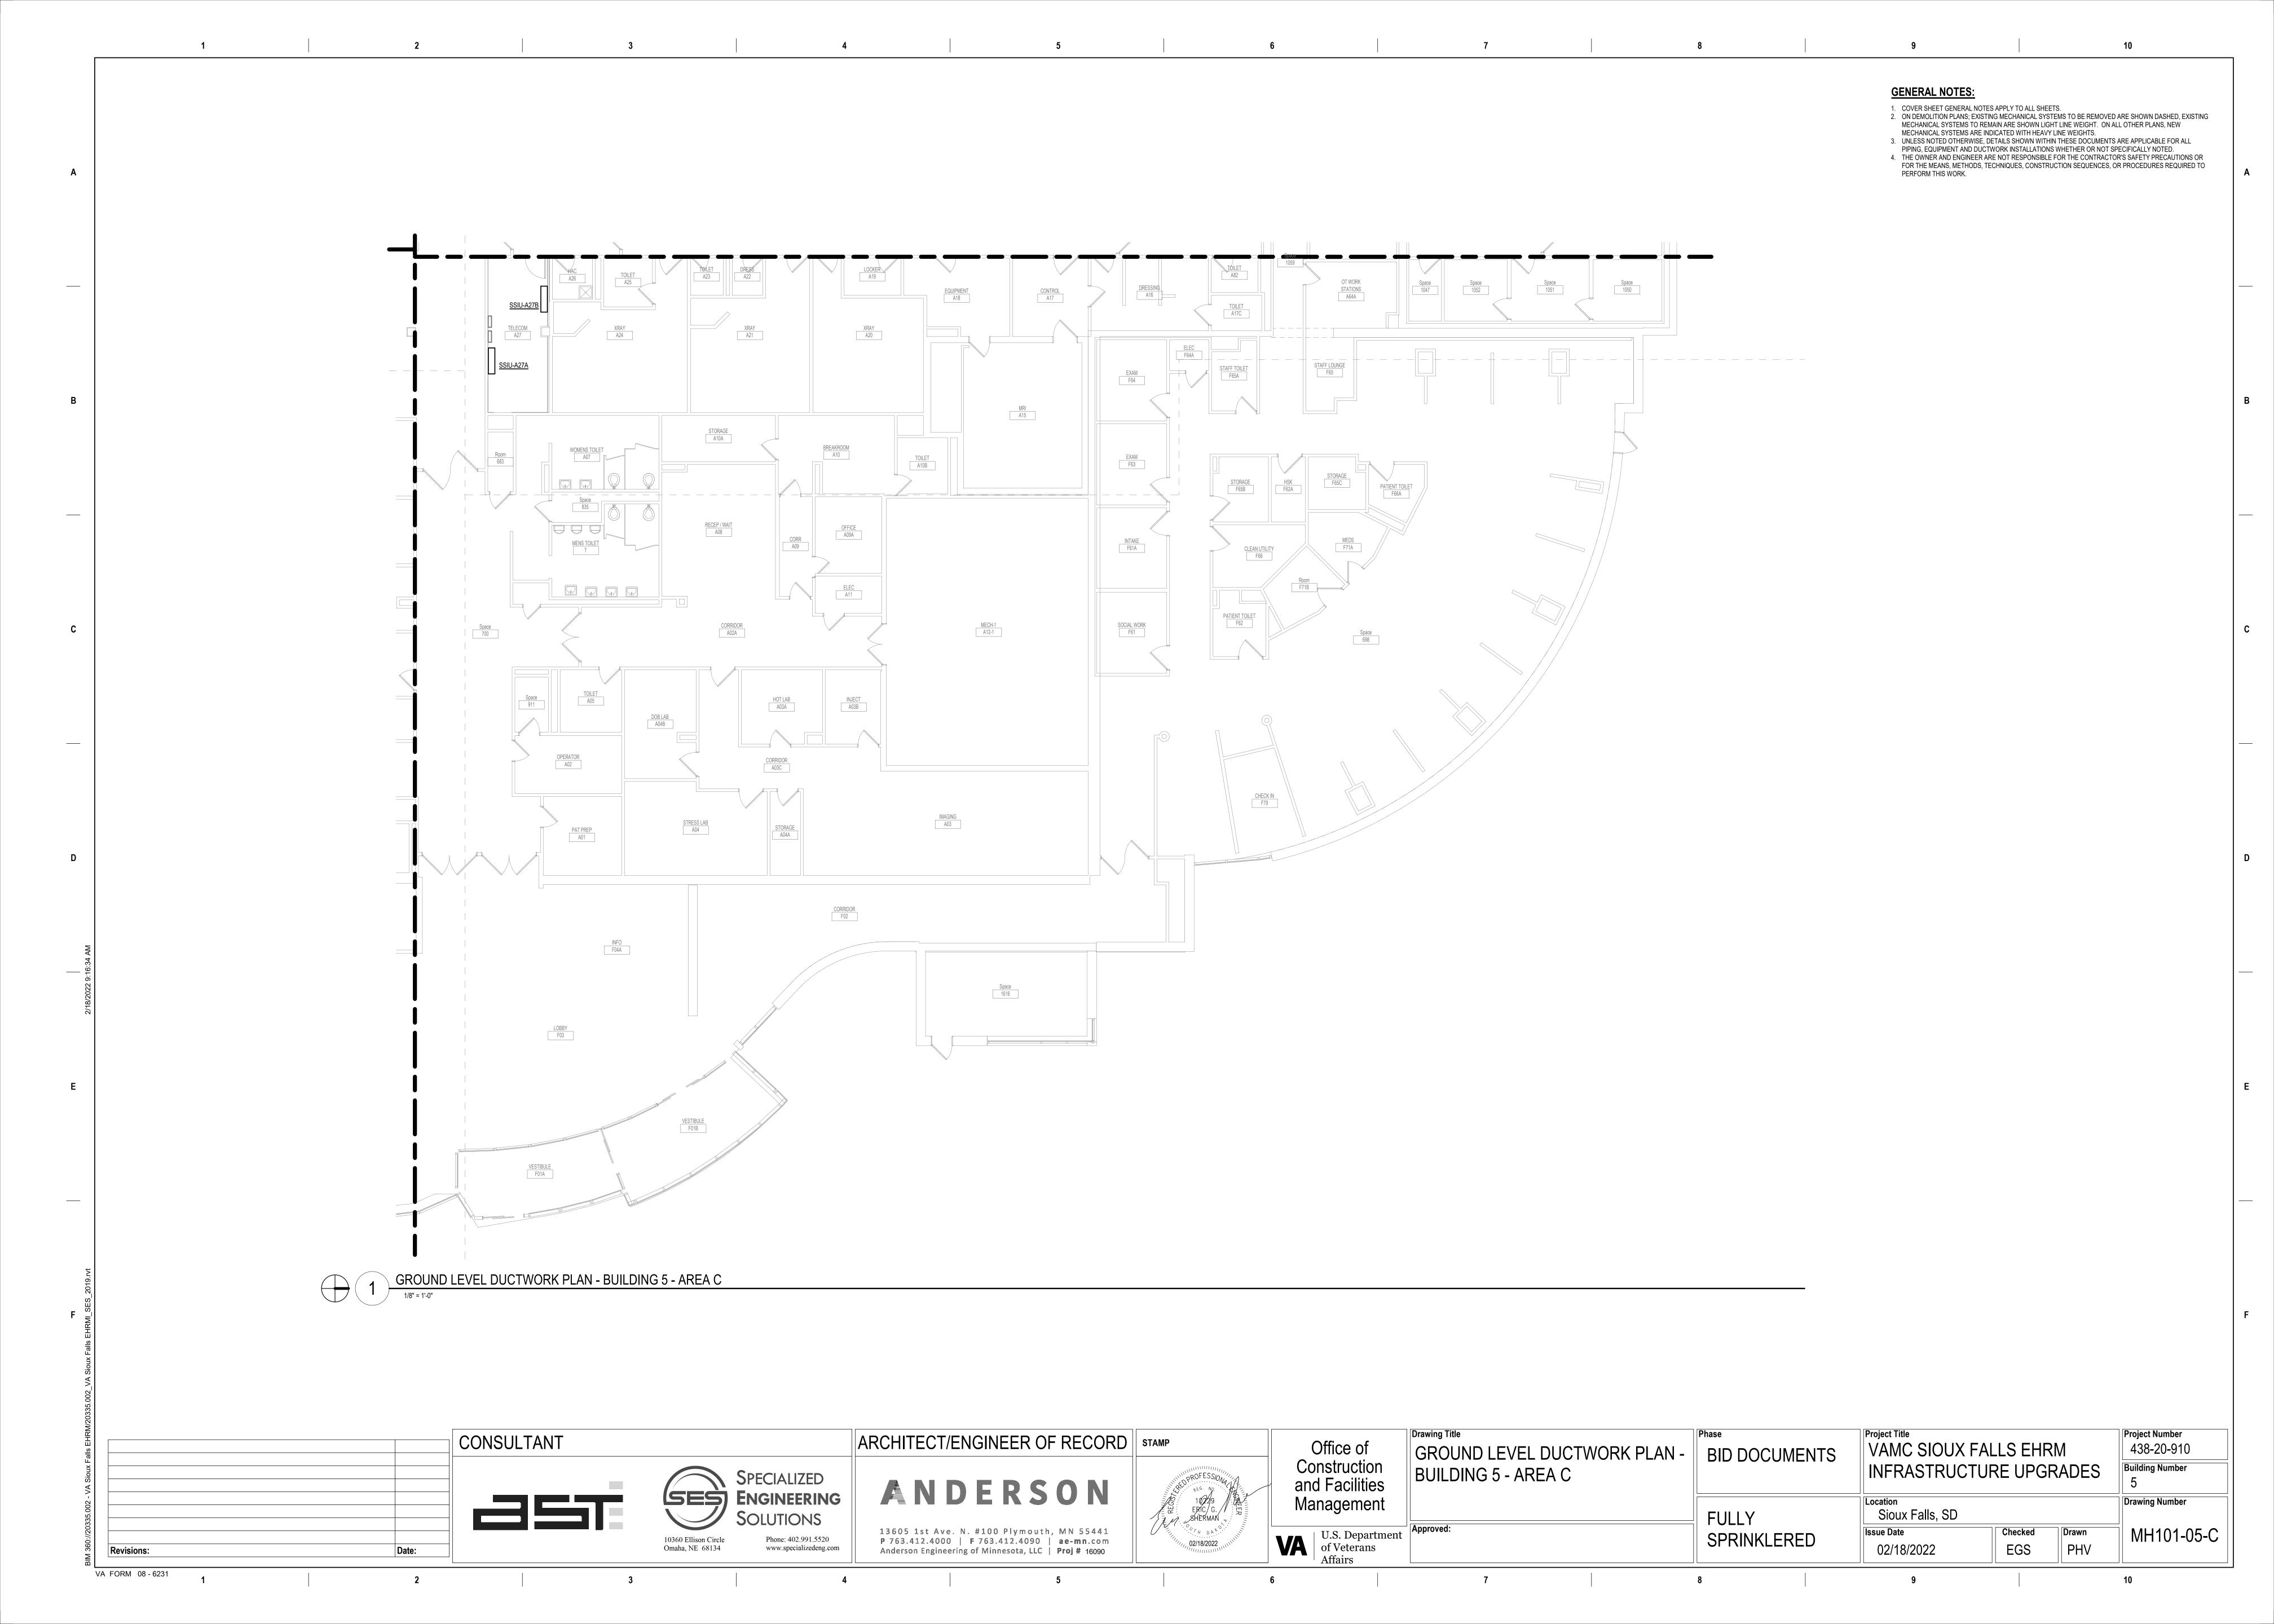

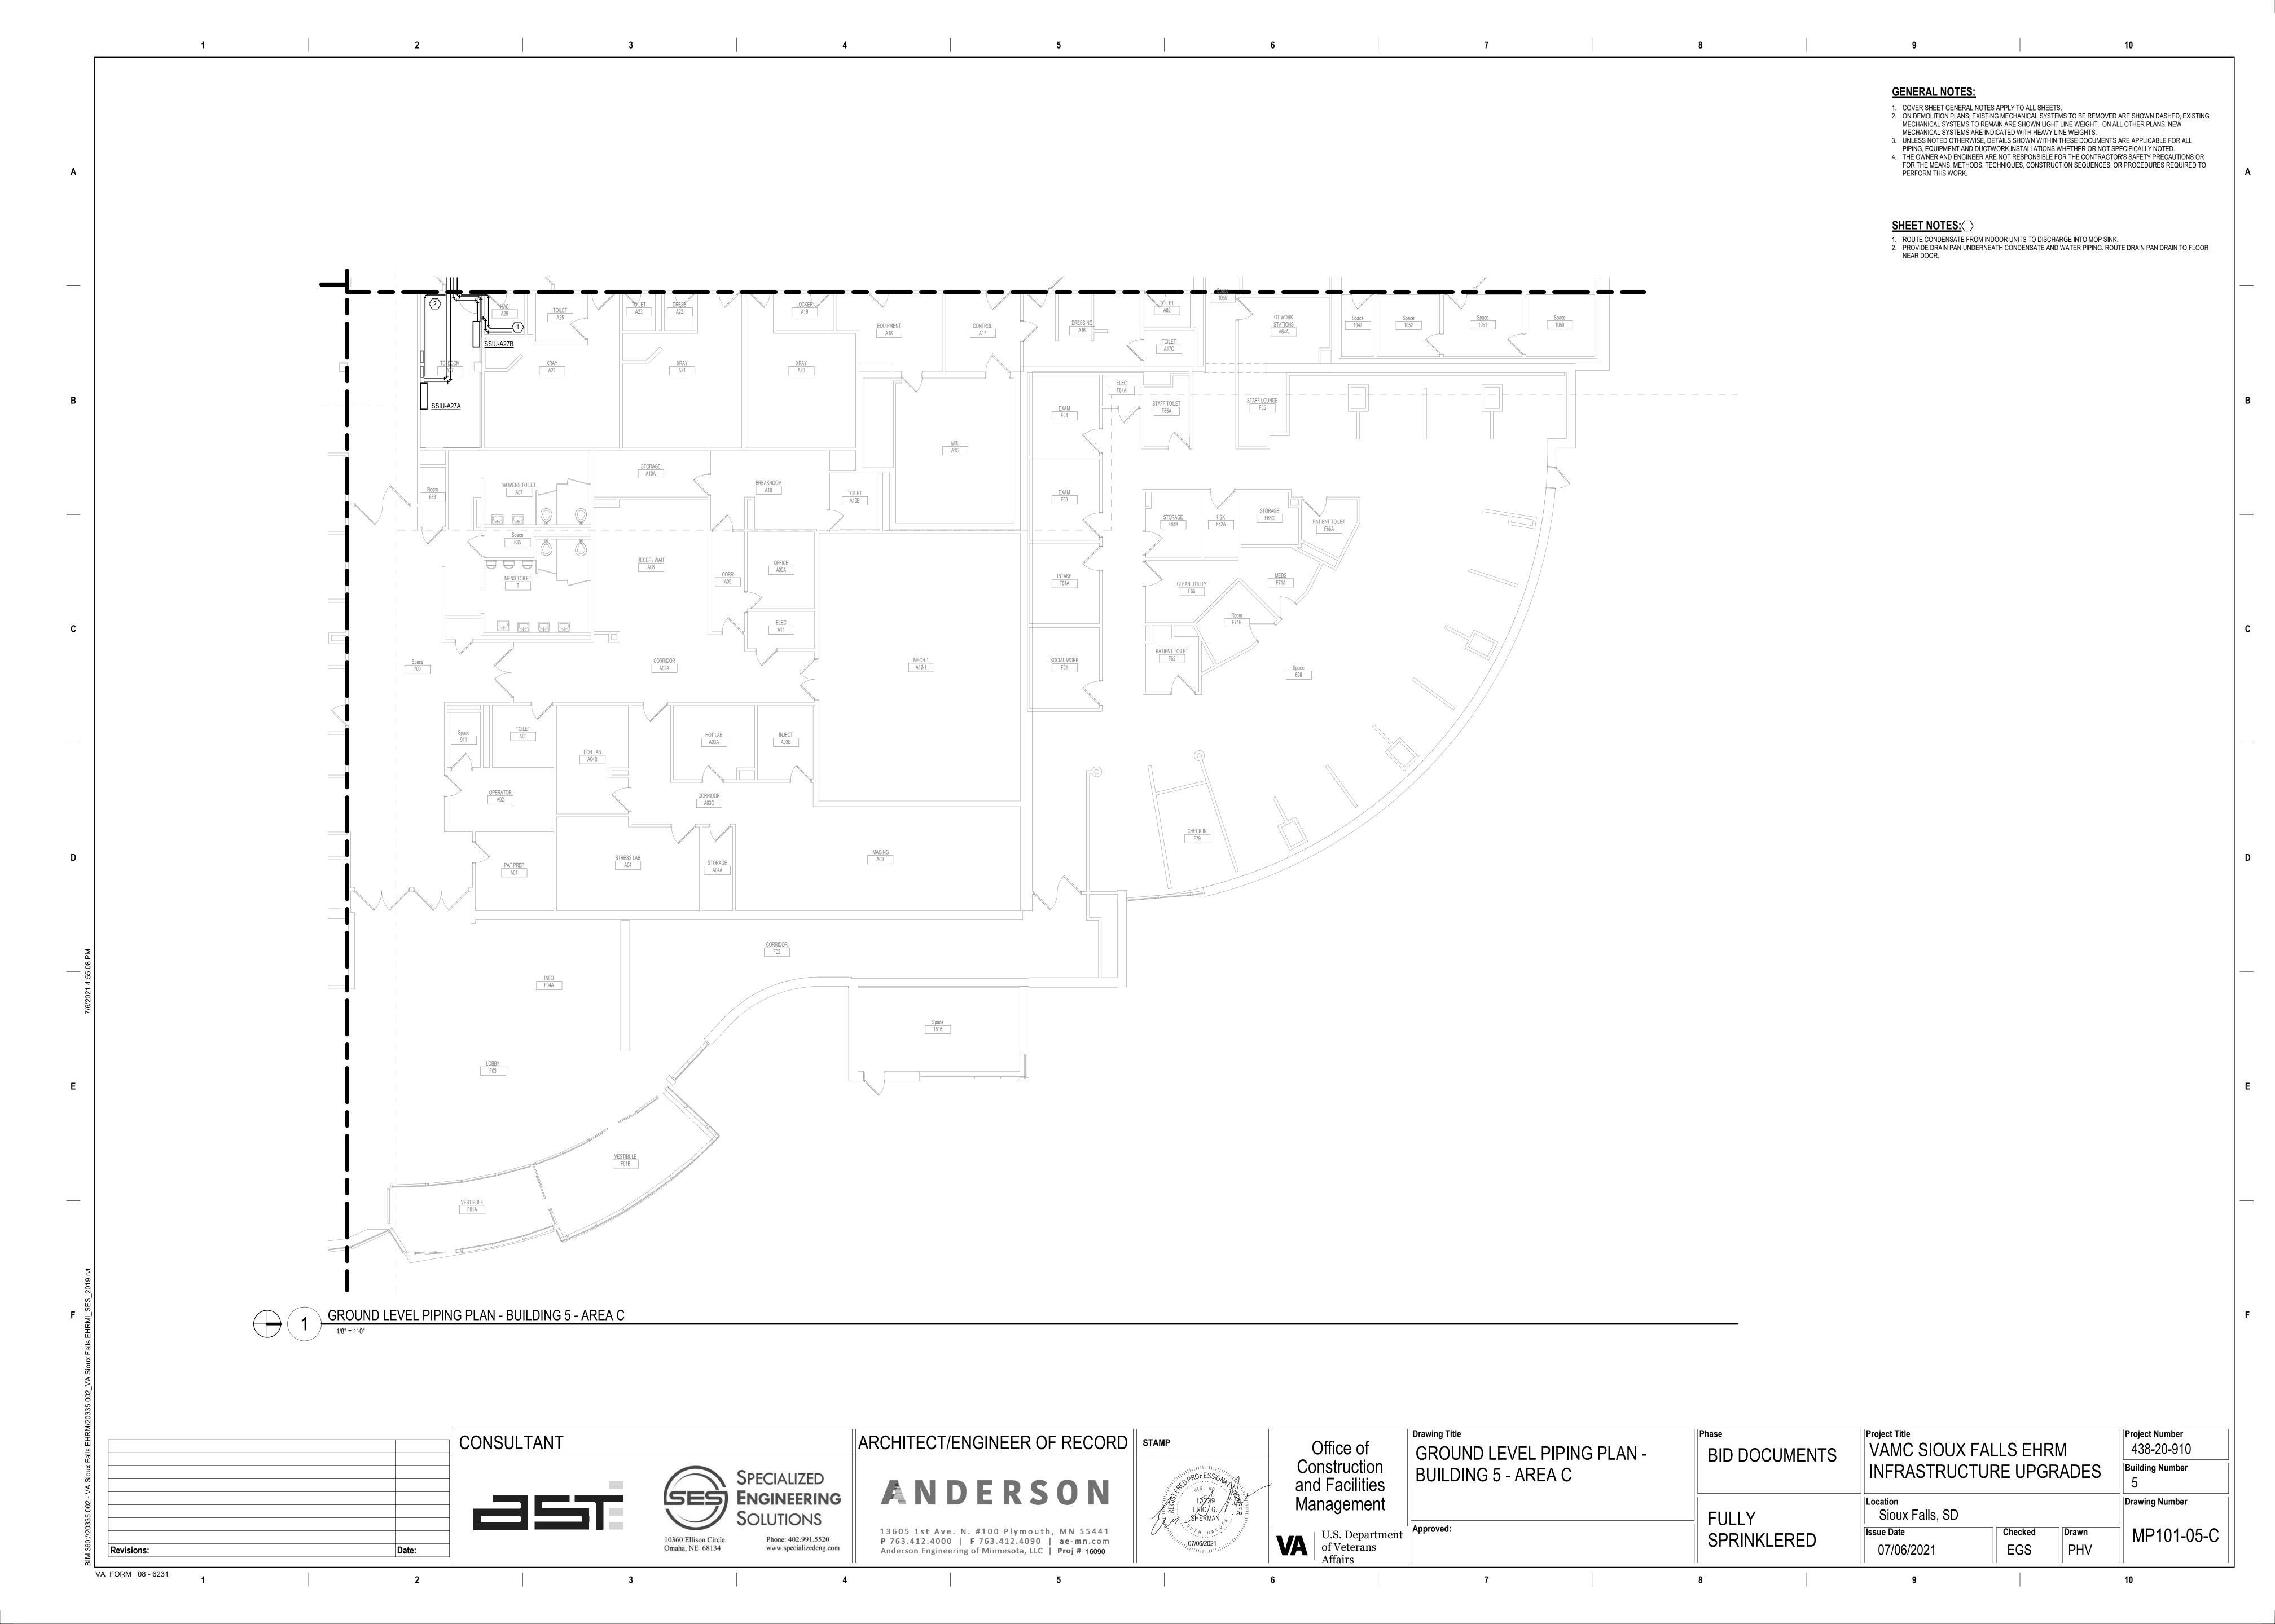

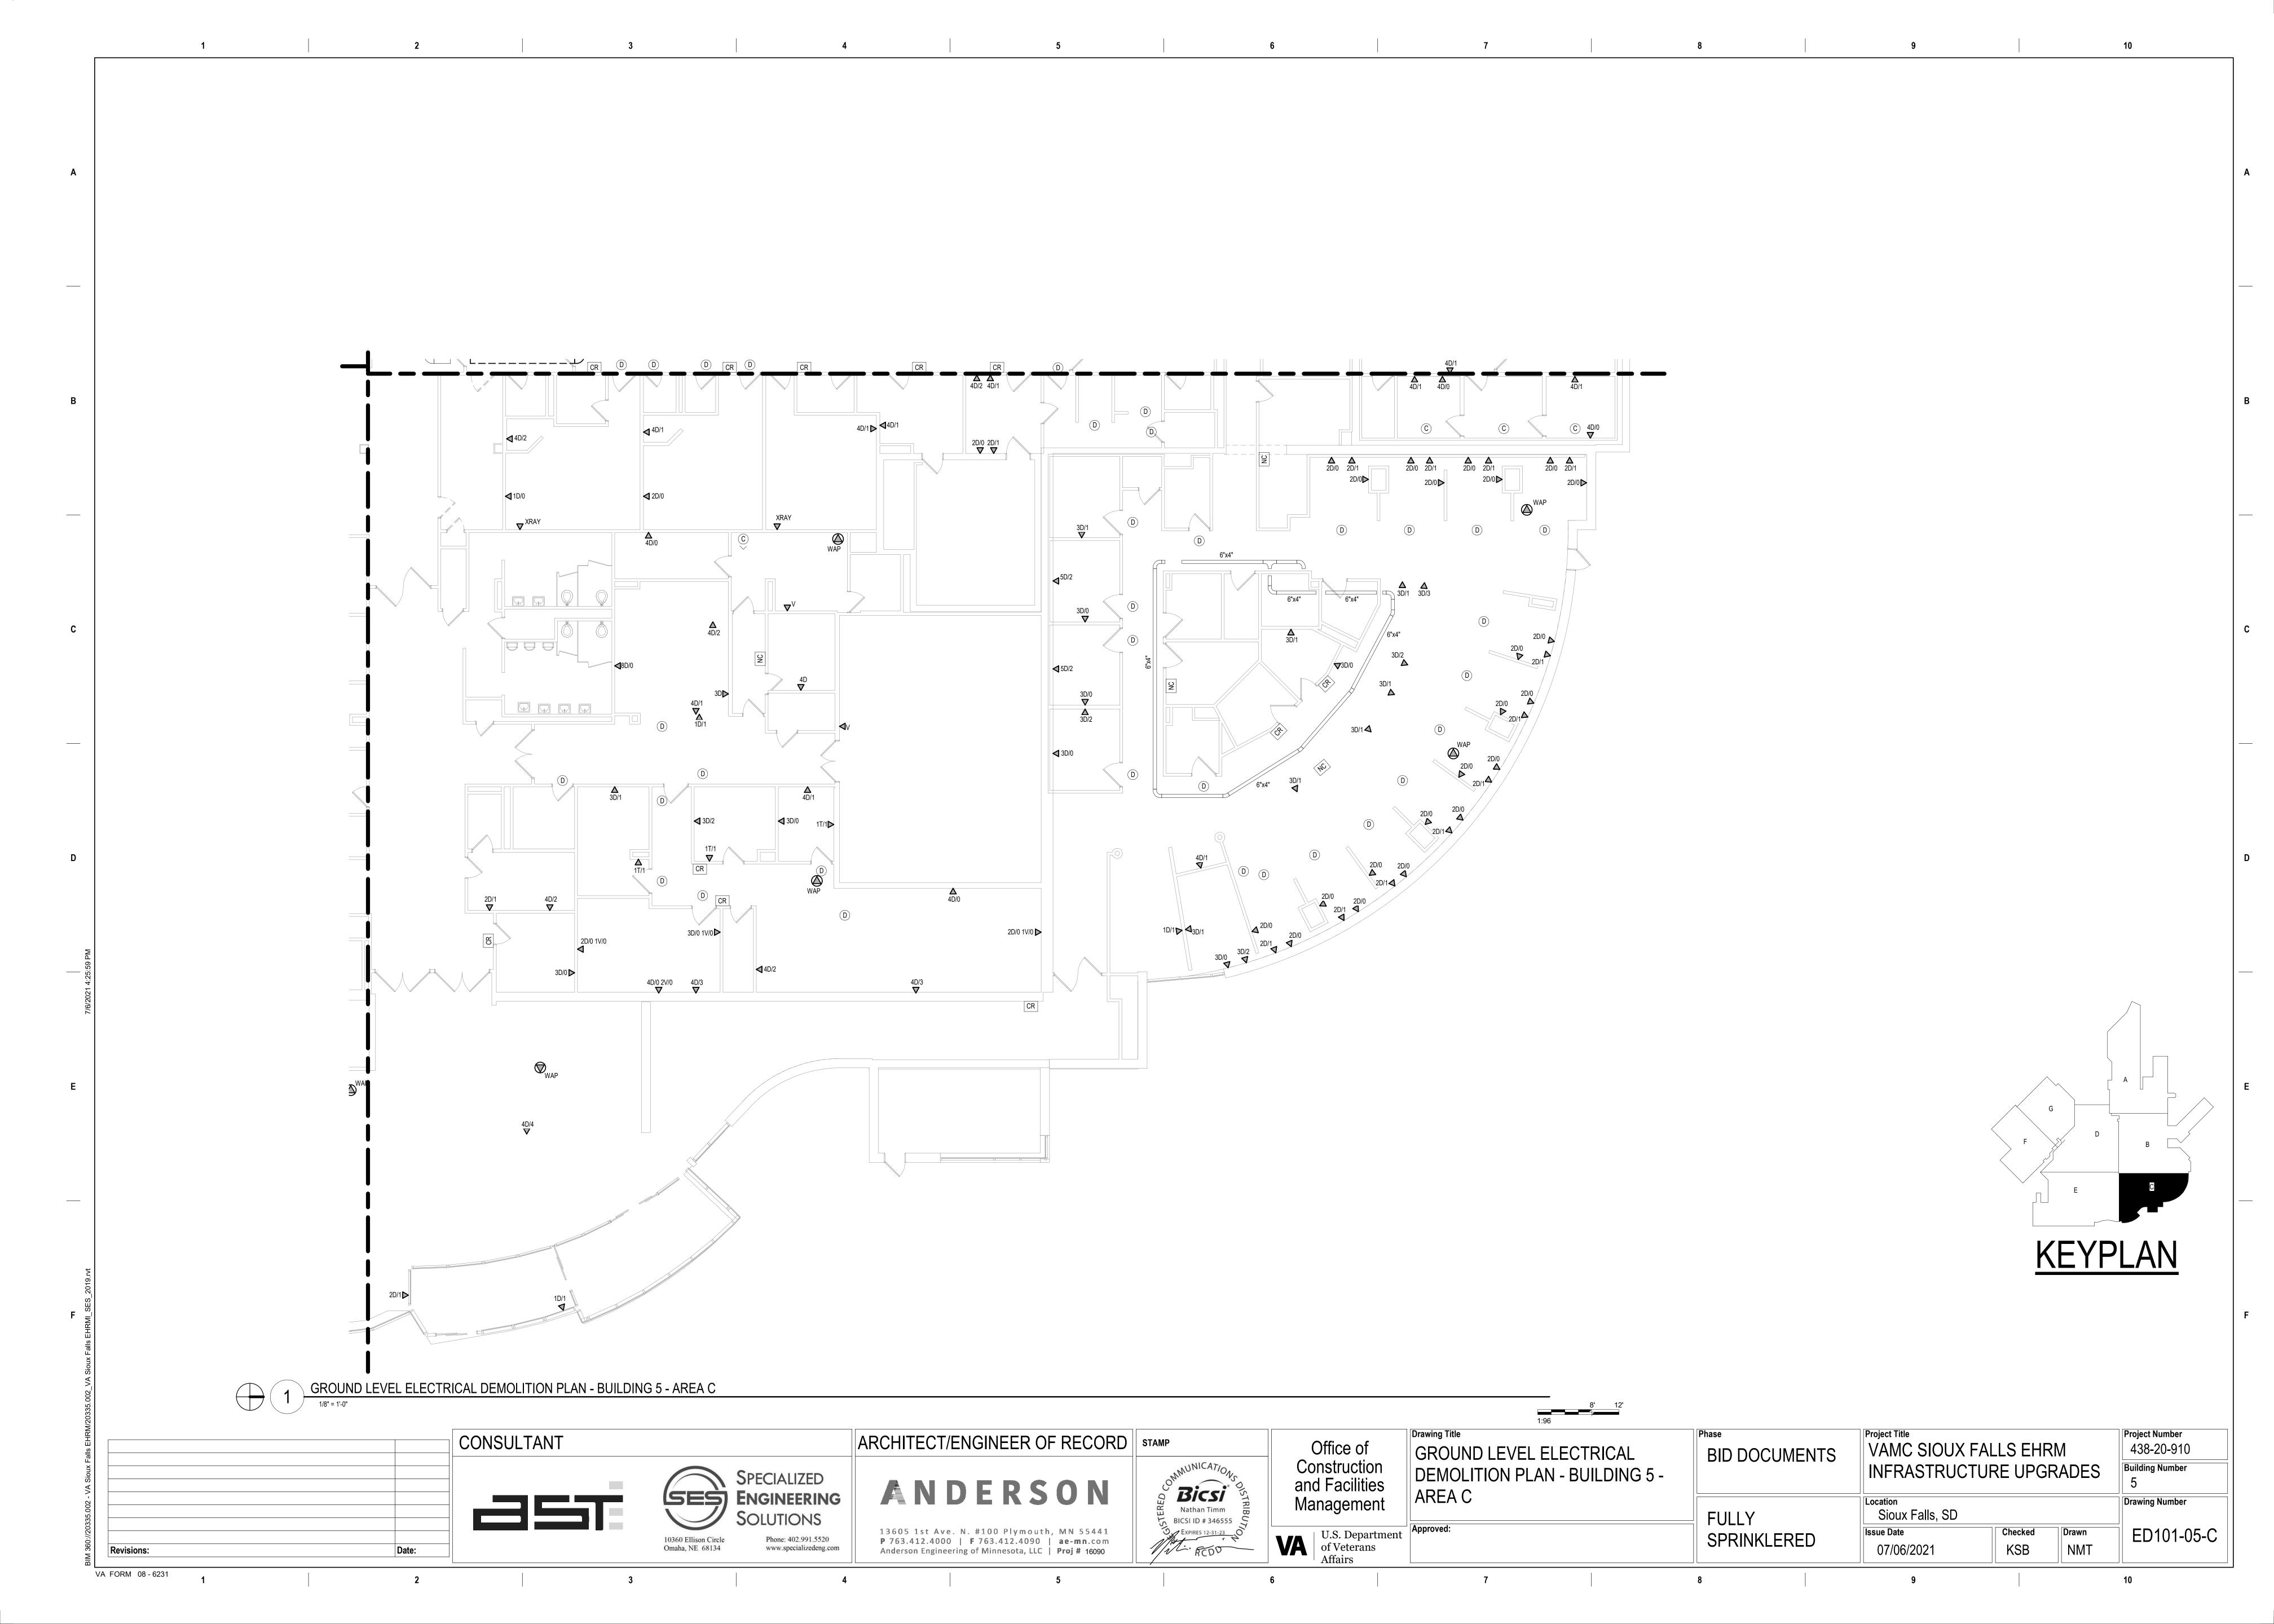

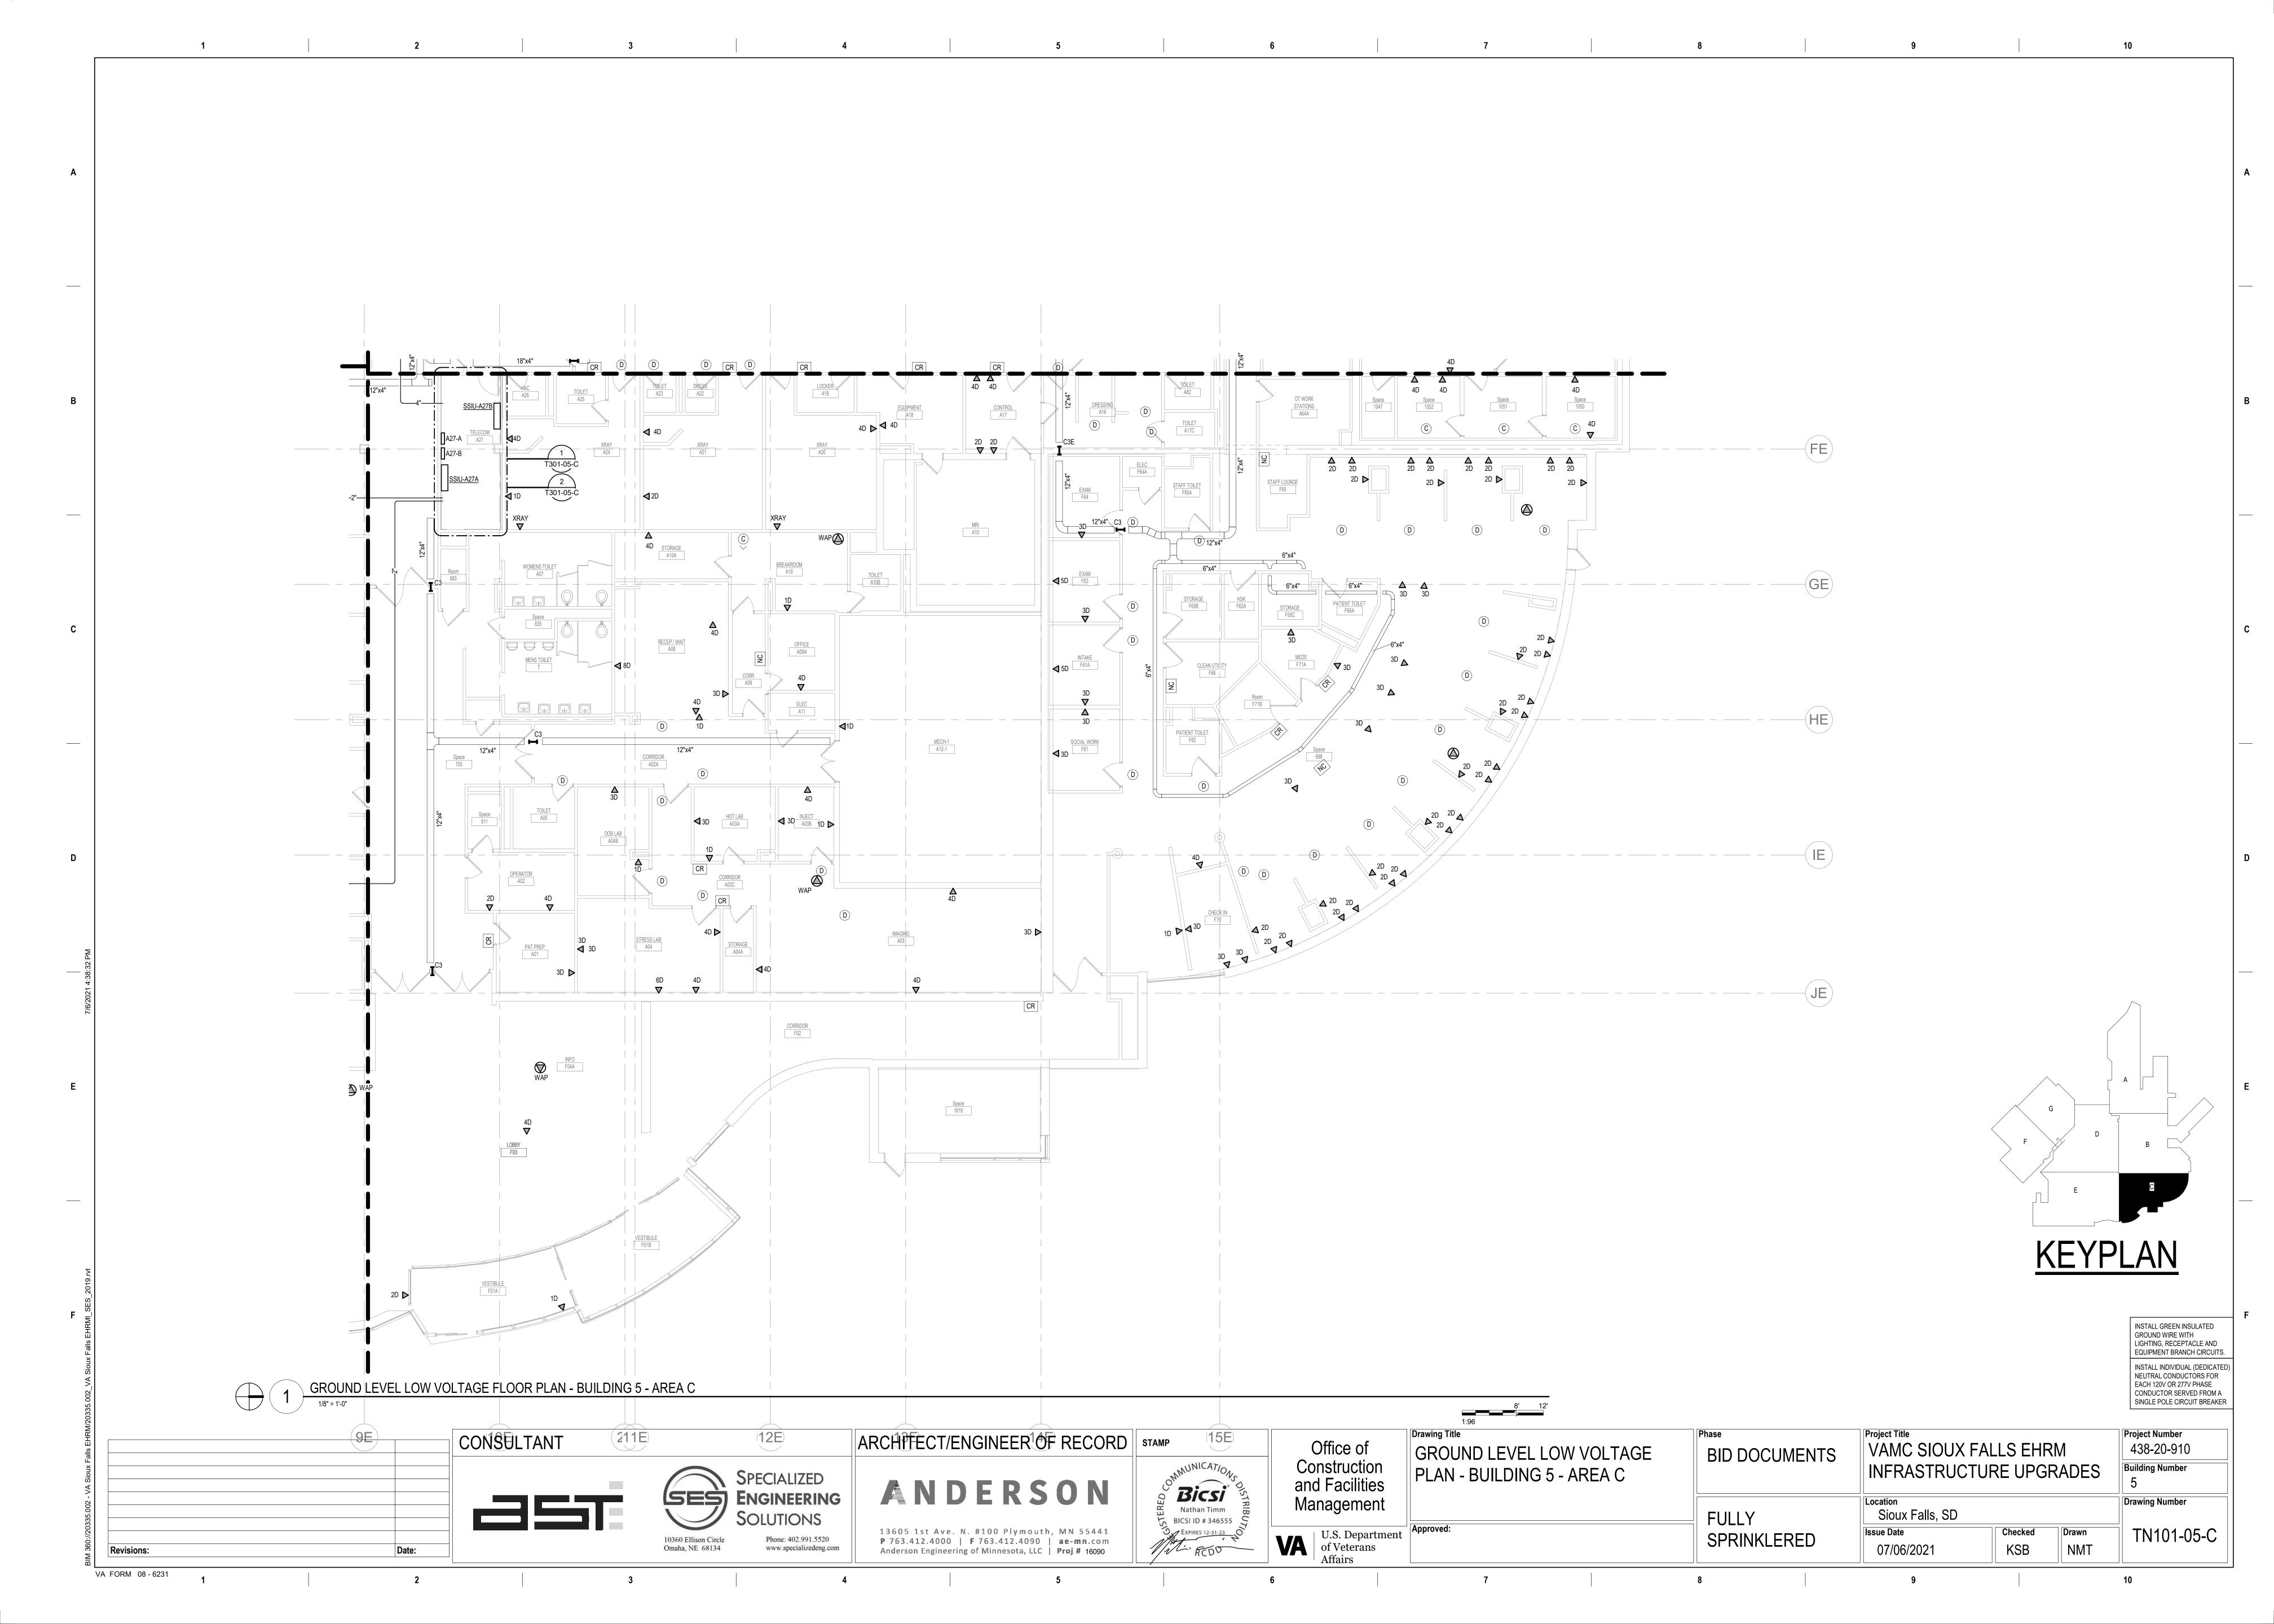

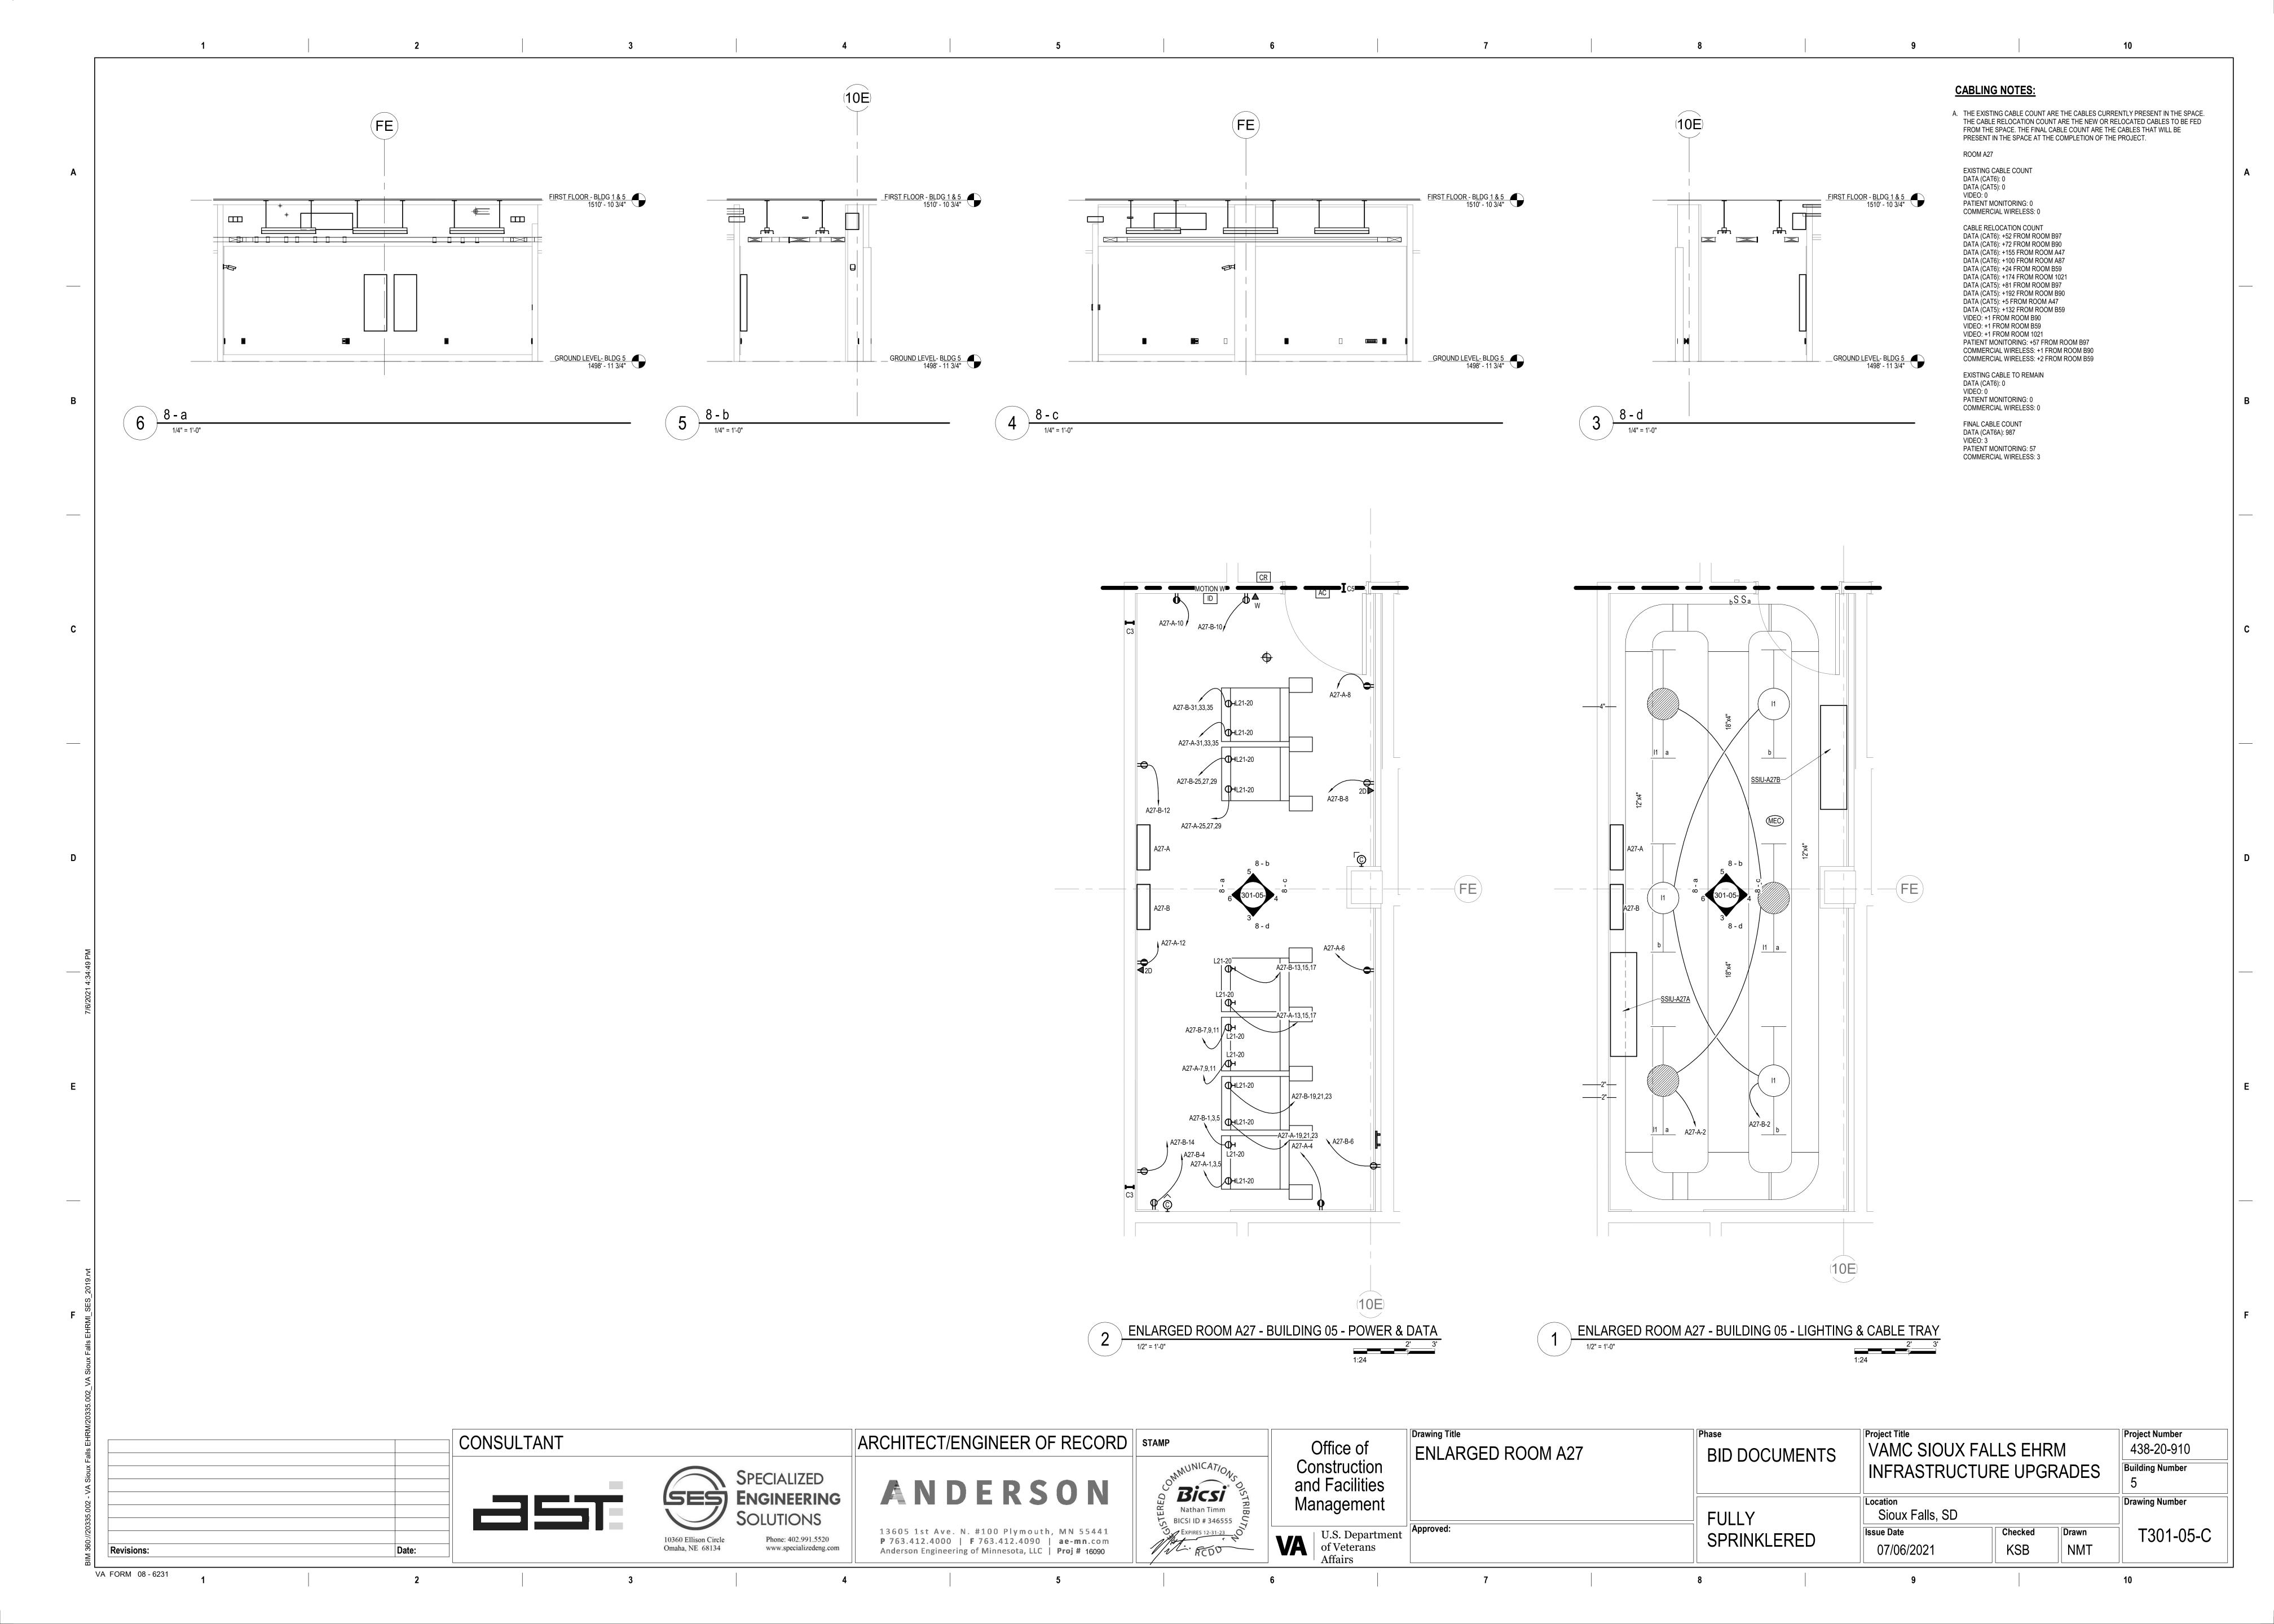

NOTES:

1. COORDINATE FINAL RACK LAYOUT WITH OWNER'S IS/IT REPRESENTATIVE. PROVIDE COMPONENTS NOT LISTED "BY OWNER". 3. SEE SPECIFICATION FOR ADDITIONAL RACK COMPONENTS. 4. COORDINATE EXACT RACK LOCATION WITH OWNER PRIOR TO PERMANENT INSTALLATION. 5. REFER TO NEW WORK PLAN FOR RACK LOCATIONS. 6. CONTRACTOR IS RESPONSIBLE FOR FINAL DEVICE COUNT AND QUANTITY OF PATCH PANELS, SWITCHES, FIBER ENCLOSURES, AND CABLE MANAGEMENT REQUIRED. 7. COORDINATE INSTALLATIONS WITH OWNER'S IS/IT REPRESENTATIVE. MANAGEMENT CHANNEL RACK CHANNEL RACK CHANNEL RACK CHANNEL RACK CHANNEL RACK CHANNEL RACK 1U RACK BONDING BUSBAR 1U 48 STRAND OM4 FIBER OPTIC DISTRIBUTION PANEL **1U BLANKING PANEL 1U BLANKING PANEL** 1U BLANKING PANEL 2U DATA PATCH PANEL 2U DATA PATCH PANEL 1U 24 STRAND OS1 FIBER OPTIC DISTRIBUTION PANEL **1U CABLE MANAGEMENT 1U BLANKING PANEL 1U CABLE MANAGEMENT** 1U 24 PORT VOICE BACKBONE PATCH PANEL 2U DATA PATCH PANEL 2U DATA PATCH PANEL 1U CABLE MANAGEMENT 1U CABLE MANAGEMENT 1U NETBOTZ 750 MONITOR SYSTEM **1U CABLE MANAGEMENT** 2U DATA PATCH PANEL 2U DATA PATCH PANEL **1U CABLE MANAGEMENT 1U CABLE MANAGEMENT** 2U DATA PATCH PANEL 2U DATA PATCH PANEL **1U CABLE MANAGEMENT 1U CABLE MANAGEMENT 2U DATA PATCH PANEL 2U DATA PATCH PANEL 1U CABLE MANAGEMENT 1U CABLE MANAGEMENT 2U DATA PATCH PANEL 2U DATA PATCH PANEL 1U CABLE MANAGEMENT 1U CABLE MANAGEMENT** SPACE FOR NON-IT 2U DATA PATCH PANEL 2U DATA PATCH PANEL SPACE FOR SPACE FOR 2U 48-PORT PATCH 2U 48-PORT PATCH OWNER EQUIPMENT PANELS FOR ELECTRONICS PANELS FOR 1U CABLE MANAGEMENT HORIZONTAL CABLE HORIZONTAL CABLE DISTRIBUTION DISTRIBUTION 2U DATA PATCH PANEL 2U DATA PATCH PANEL 1U CABLE MANAGEMENT 1U CABLE MANAGEMENT 2U DATA PATCH PANEL **2U DATA PATCH PANEL** 1U CABLE MANAGEMENT 1U CABLE MANAGEMENT 2U DATA PATCH PANEL **1U CABLE MANAGEMENT** 12U SPACE FOR FUTURE RACK 2 NON-IT SYSTEMS RACK 3 DISTRIBUTION **RACK 4 DISTRIBUTION** RACK 5 ELECTRONIC EQUIPMENT **RACK 1 DISTRIBUTION RACK 6 DISTRIBUTION** RACK ELEVATION - ROOM A27 Drawing Title Project Title Project Number CONSULTANT ARCHITECT/ENGINEER OF RECORD | STAMP Office of VAMC SIOUX FALLS EHRM 438-20-910 **ENLARGED ROOM A27 BID DOCUMENTS** Construction and Facilities **Building Number** INFRASTRUCTURE UPGRADES SPECIALIZED

Bicsi

BICSI ID # 346555

EXPIRES 12-31-23 OF RCDO

Management

U.S. Department of Veterans Affairs

Drawing Number

T302-05-C

Location

FULLY

SPRINKLERED

Sioux Falls, SD

07/06/2021

Checked

KSB

Drawn

NMT

ANDERSON

13605 1st Ave. N. #100 Plymouth, MN 55441 P 763.412.4000 | F 763.412.4090 | ae-mn.com

Anderson Engineering of Minnesota, LLC | Proj # 16090

SES ENGINEERING

10360 Ellison Circle

Omaha, NE 68134

Revisions:

VA FORM 08 - 6231

Phone: 402.991.5520

www.specializedeng.com

LIGHTING PANEL: A27-B LOCATION: TELECOM A27 MAINS TYPE: MCB **VOLTS:** 208/120 WYE **SUPPLY FROM**: B1 PHASES: 3 MCB/MLO RATING: 200 A **BRANCH:** NORMAL WIRES: 4 MCB OPTIONS: NONE SERVICE RATED: No INTEGRAL SPD: Yes SECTIONS: 1 PANEL POLES: 42 **MOUNTING:** SURFACE AVAILABLE SCC (kA): 2.1 **NEMA ENCLOSURE**: 1 A B C POL... RATI... OPT CIRCUIT DESCRIPTION OPT RATI... POL... CIRCUIT DESCRIPTION 1922... 74 VA 1922 VA 180 VA 1 20 A 1 20 A LTG TELECOMM A27 PWR-C TELECOMM A27 - RACK 20 A 3 1922 VA 180 VA 1922 VA 180 VA 1 20 A 1922 VA 180 VA 1 20 A REC TELECOMM A27 RECEPTACLE REC TELECOMM A27 20 A 3 1922... 180 VA 1 20 A REC TELE
20 A 3 1922 VA 180 VA 1 20 A REC TELE
20 A 3 1922... 180 VA 1 20 A REC TELE
20 A 3 1922 VA 0 VA 1 20 A REC TELE
20 A 3 1922 VA 0 VA 1 20 A SPARE
20 A 3 1922... 0 VA 1 20 A SPARE REC TELECOMM A27 PWR-C TELECOMM A27 - RACK REC TELECOMM A27 RECEPTACLE REC TELECOMM A27 REC TELECOMM A27 PWR-C TELECOMM A27 - RACK RECEPTACLE 20 A 3 1922... 0 VA 3 1922 VA 0 VA 3 20 A -- SPARE 1922 VA 0 VA 1 20 A -- SPARE 20 A 3 1922 VA 0 VA 1 20 A -- SPARE PWR-C TELECOMM A27 - RACK RECEPTACLE PWR-C TELECOMM A27 - RACK _ RECEPTACLE PWR-C TELECOMM A27 - RACK RECEPTACLE SSIU-A27B/SSOU-A27B 1488 VA 41 SPARE **TOTAL LOAD:** 13452 VA 13378 VA 11890 VA TOTAL AMPS: 114 A 113 A LOAD CLASSIFICATION CONNECTED LOAD | DEMAND FACTOR | ESTIMATED DEMAND PANEL TOTALS 74 VA 125.00% 93 VA CONNECTED LOAD: 38719 VA CONNECTED CURRENT: 107 A 1080 VA 100.00% 1080 VA 2975 VA 124.00% 3689 VA **DEMAND LOAD**: 27157 VA **DEMAND CURRENT**: 75 A 34590 VA 22295 VA 64.46% **CONSIDER 125% DEMAND:** 33946 A **EQUIPMENT AMPS**: 200 A FEEDER AVAILABLE: **SPARE CAPACITY:** 62 % 125 A CIRCUIT BREAKER OPTIONS SUFFIX: 'S' OR 'ST' - PROVIDE SHUNT TRIP CIRCUIT BREAKER / 'G' OR 'GFCI' - PROVIDE GFCI CIRCUIT BREAKER / 'GFP' - PROVIDE GFP CIRCUIT BREAKER / 'ERMS' - ENERGY REDUCING MAINTENANCE SWITCH / 'ZSI' - ZONE SELECTIVE INTERLOCKING / 'L' - PROVIDE CIRCUIT BREAKER WITH LOCKING PROVISIONS / 'R' - PROVIDE CIRCUIT BREAKER WITH RED MARKING A. PANEL AIC (INTERRUPTING) RATING SHALL BE MINIMUM 120% OF THE AVAILABLE SCC (SHORT CIRCUIT CURRENT).

C. GIRCUIT DESCRIPTION OPT RATI OPL A B C POW RATI OPT CIRCUIT DESCRIPTION	LOCATION: TEI SUPPLY FROM: A1 BRANCH: CR SERVICE RATED: No MOUNTING: SUI NEMA ENCLOSURE: 1	ITICAL			AV.		VOLTS PHASES WIRES GRAL SPD SCC (kA)	: 4 : Yes	0 WYE			MCB/ML MCE	O RAT OPTIONS SECTIONS	YPE: MCB ING: 200 A ONS: NONE ONS: 1 LES: 42		
Receptage	C CIRCUIT DESCRIPTION	OPT RA	ATI	POL		A	E	3	C	;	POL	RATI	OPT	CIRC	UIT DESCRIPTION	(
Second Color					1922	74 VA					1	20 A		LTG TELEC	DMM A27	
5 PWR.C TELECOMM A27 - RACK RECEPTACLE 20 A 3 1922 180 VA 1 10 20 A 1 10		2	0 A	3			1922 VA	180 VA			1	20 A		REC TELEC	OMM A27	
Part	5								1922 VA	180 VA	1	20 A		REC TELEC	OMM A27	
PARCE	7 DWD C TELECOMM A27 DACK				1922	180 VA					1	20 A		REC TELEC	OMM A27	
11 15		2	0 A	3			1922 VA	180 VA			1	20 A		REC TELEC	OMM A27	
15	11								1922 VA	180 VA	1	20 A		REC TELEC	OMM A27	
10	13 DWB C TELECOMM A37 BACK				1922	0 VA					1	20 A		SPARE		
17		2	0 A	3			1922 VA	0 VA			1	20 A		SPARE		
21 RecEPTACLE	17								1922 VA	0 VA						
Total Load:	19				1922	0 VA					3	20 A		SPARE		
1922 VA	·)1	2	0 A	3			1922 VA	0 VA								
1922 VA 1922	23								1922 VA	0 VA	1	20 A		SPARE		
1922 VA	25				1922	0 VA					1	20 A		SPARE		
1922 1922		2	0 A	3			1922 VA									
33 RECEPTACLE 20 A 3 1922 VA 1922	29 RECEPTAGLE								1922 VA							
STATE	31				1922											
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SPARE	35 RECEPTABLE								1922 VA							
SSIU-A2/A/SSUU-A2/A 30 A 2	37				1488											
TOTAL LAOR: 13272 VA 13378 VA 11890 VA		3	υ Α	2			1488 VA									١.
TOTAL LOAD: 13272 VA 13378 VA 11890 VA		2	0 A	1					0 VA							
TOTAL AMPS: 112 A		TC	TAL	LOAD:	1327	72 VA	1337	8 VA	1189	0 VA						
### 100.00% 900 VA CONNECTED CURRENT: 107 A 100.00% 100.00% 3689 VA DEMAND LOAD: 26977 VA 200.00% 3689 VA DEMAND LOAD: 26977 VA 200.00% 26977			COI			D DEN					AND					
MTR																
PWR-NC 34590 VA 64.46% 22295 VA DEMAND CURRENT: 75 A CONSIDER 125% DEMAND: 33721 A EQUIPMENT AMPS: 200 A FEEDER AVAILABLE: SPARE CAPACITY: 62 % 125 A OPTIONS: CIRCUIT BREAKER OPTIONS SUFFIX: 'S' OR 'ST' - PROVIDE SHUNT TRIP CIRCUIT BREAKER / 'G' OR 'GFCI' - PROVIDE GFCI CIRCUIT BREAKER / 'GFP' - PROVIDE GFP CIRCUIT BREAKER / 'ERMS' - ENERGY REDUCING MAINTENANCE SWITCH / 'ZSI' - ZONE SELECTIVE INTERLOCKING / 'L' - PROVIDE CIRCUIT BREAKER WITH LOCKING PROVISIONS / 'R' - PROVIDE CIRCUIT BREAKER WITH RED MARKING GENERAL REMARKS:												CONN				
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PROVISIONS / 'R' - PROVIDE CIRCUIT BREAKER WITH RED MARKING EQUIPMENT AMPS: 200 A FEEDER AVAILABLE: SPARE CAPACITY: 62 % 125 A 125 A 125 A 126 CIRCUIT BREAKER OPTIONS SUFFIX: 'S' OR 'ST' - PROVIDE SHUNT TRIP CIRCUIT BREAKER / 'G' OR 'GFCI' - PROVIDE GFCI CIRCUIT BREAKER / 'GFP' - PROVIDE GFP CIRCUIT BREAKER / 'ERMS' - ENERGY REDUCING MAINTENANCE SWITCH / 'ZSI' - ZONE SELECTIVE INTERLOCKING / 'L' - PROVIDE CIRCUIT BREAKER WITH LOCKING PROVISIONS / 'R' - PROVIDE CIRCUIT BREAKER WITH RED MARKING GENERAL REMARKS:	PWR-NC			34590	O VA		64.46%		222	295 VA						
FEEDER AVAILABLE: SPARE CAPACITY: 62 % 125 A OPTIONS: CIRCUIT BREAKER OPTIONS SUFFIX: 'S' OR 'ST' - PROVIDE SHUNT TRIP CIRCUIT BREAKER / 'G' OR 'GFCI' - PROVIDE GFCI CIRCUIT BREAKER / 'GFP' - PROVIDE GFP CIRCUIT BREAKER / 'ERMS' - ENERGY REDUCING MAINTENANCE SWITCH / 'ZSI' - ZONE SELECTIVE INTERLOCKING / 'L' - PROVIDE CIRCUIT BREAKER WITH LOCKING PROVISIONS / 'R' - PROVIDE CIRCUIT BREAKER WITH RED MARKING GENERAL REMARKS:																
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CIRCUIT BREAKER OPTIONS SUFFIX: 'S' OR 'ST' - PROVIDE SHUNT TRIP CIRCUIT BREAKER / 'G' OR 'GFCI' - PROVIDE GFCI CIRCUIT BREAKER / 'GFP' - PROVIDE GFP CIRCUIT BREAKER / 'ERMS' - ENERGY REDUCING MAINTENANCE SWITCH / 'ZSI' - ZONE SELECTIVE INTERLOCKING / 'L' - PROVIDE CIRCUIT BREAKER WITH LOCKING PROVISIONS / 'R' - PROVIDE CIRCUIT BREAKER WITH RED MARKING GENERAL REMARKS:																
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GENERAL REMARKS:	CIRCUIT BREAKER OPTIONS SUFFIX: 'S CIRCUIT BREAKER / 'ERMS' - ENERGY RI	EDUCING M	IAINT	ENANC	E SWIT											ı
A. PANEL AIC (INTERRUPTING) RATING SHALL BE MINIMUM 120% OF THE AVAILABLE SCC (SHORT CIRCUIT CURRENT).		DIIAI - DE -	AIN	111.4.400	0/ OF T	IE 4374	ADI = 00	0 (0) 10=	T 01501	IT 01 155	- N : - ' '					
	A. PANEL AIC (INTERRUPTING) RATING S	SHALL BE M	/IINIM	UM 120	% OF Th	₁L AVAIL	ABLE SC	C (SHOR	CIRCU	II CURR	⊨NT).					

CONSULTANT SPECIALIZED SES ENGINEERING Phone: 402.991.5520 10360 Ellison Circle www.specializedeng.com Omaha, NE 68134 Revisions:

VA FORM 08 - 6231

ANDERSON 13605 1st Ave. N. #100 Plymouth, MN 55441 P 763.412.4000 | F 763.412.4090 | ae-mn.com

Anderson Engineering of Minnesota, LLC | Proj # 16090




Office of Construction and Facilities Management

U.S. Department of Veterans Affairs

Drawing Title PANEL SCHEDULES - BUILDING 5 -GROUND LEVEL - AREA C

Project Title Project Number VAMC SIOUX FALLS EHRM 438-20-910 **BID DOCUMENTS Building Number** INFRASTRUCTURE UPGRADES Drawing Number Location Sioux Falls, SD **FULLY**

Checked Drawn EE401-05-C SPRINKLERED KSB 07/06/2021 NMT

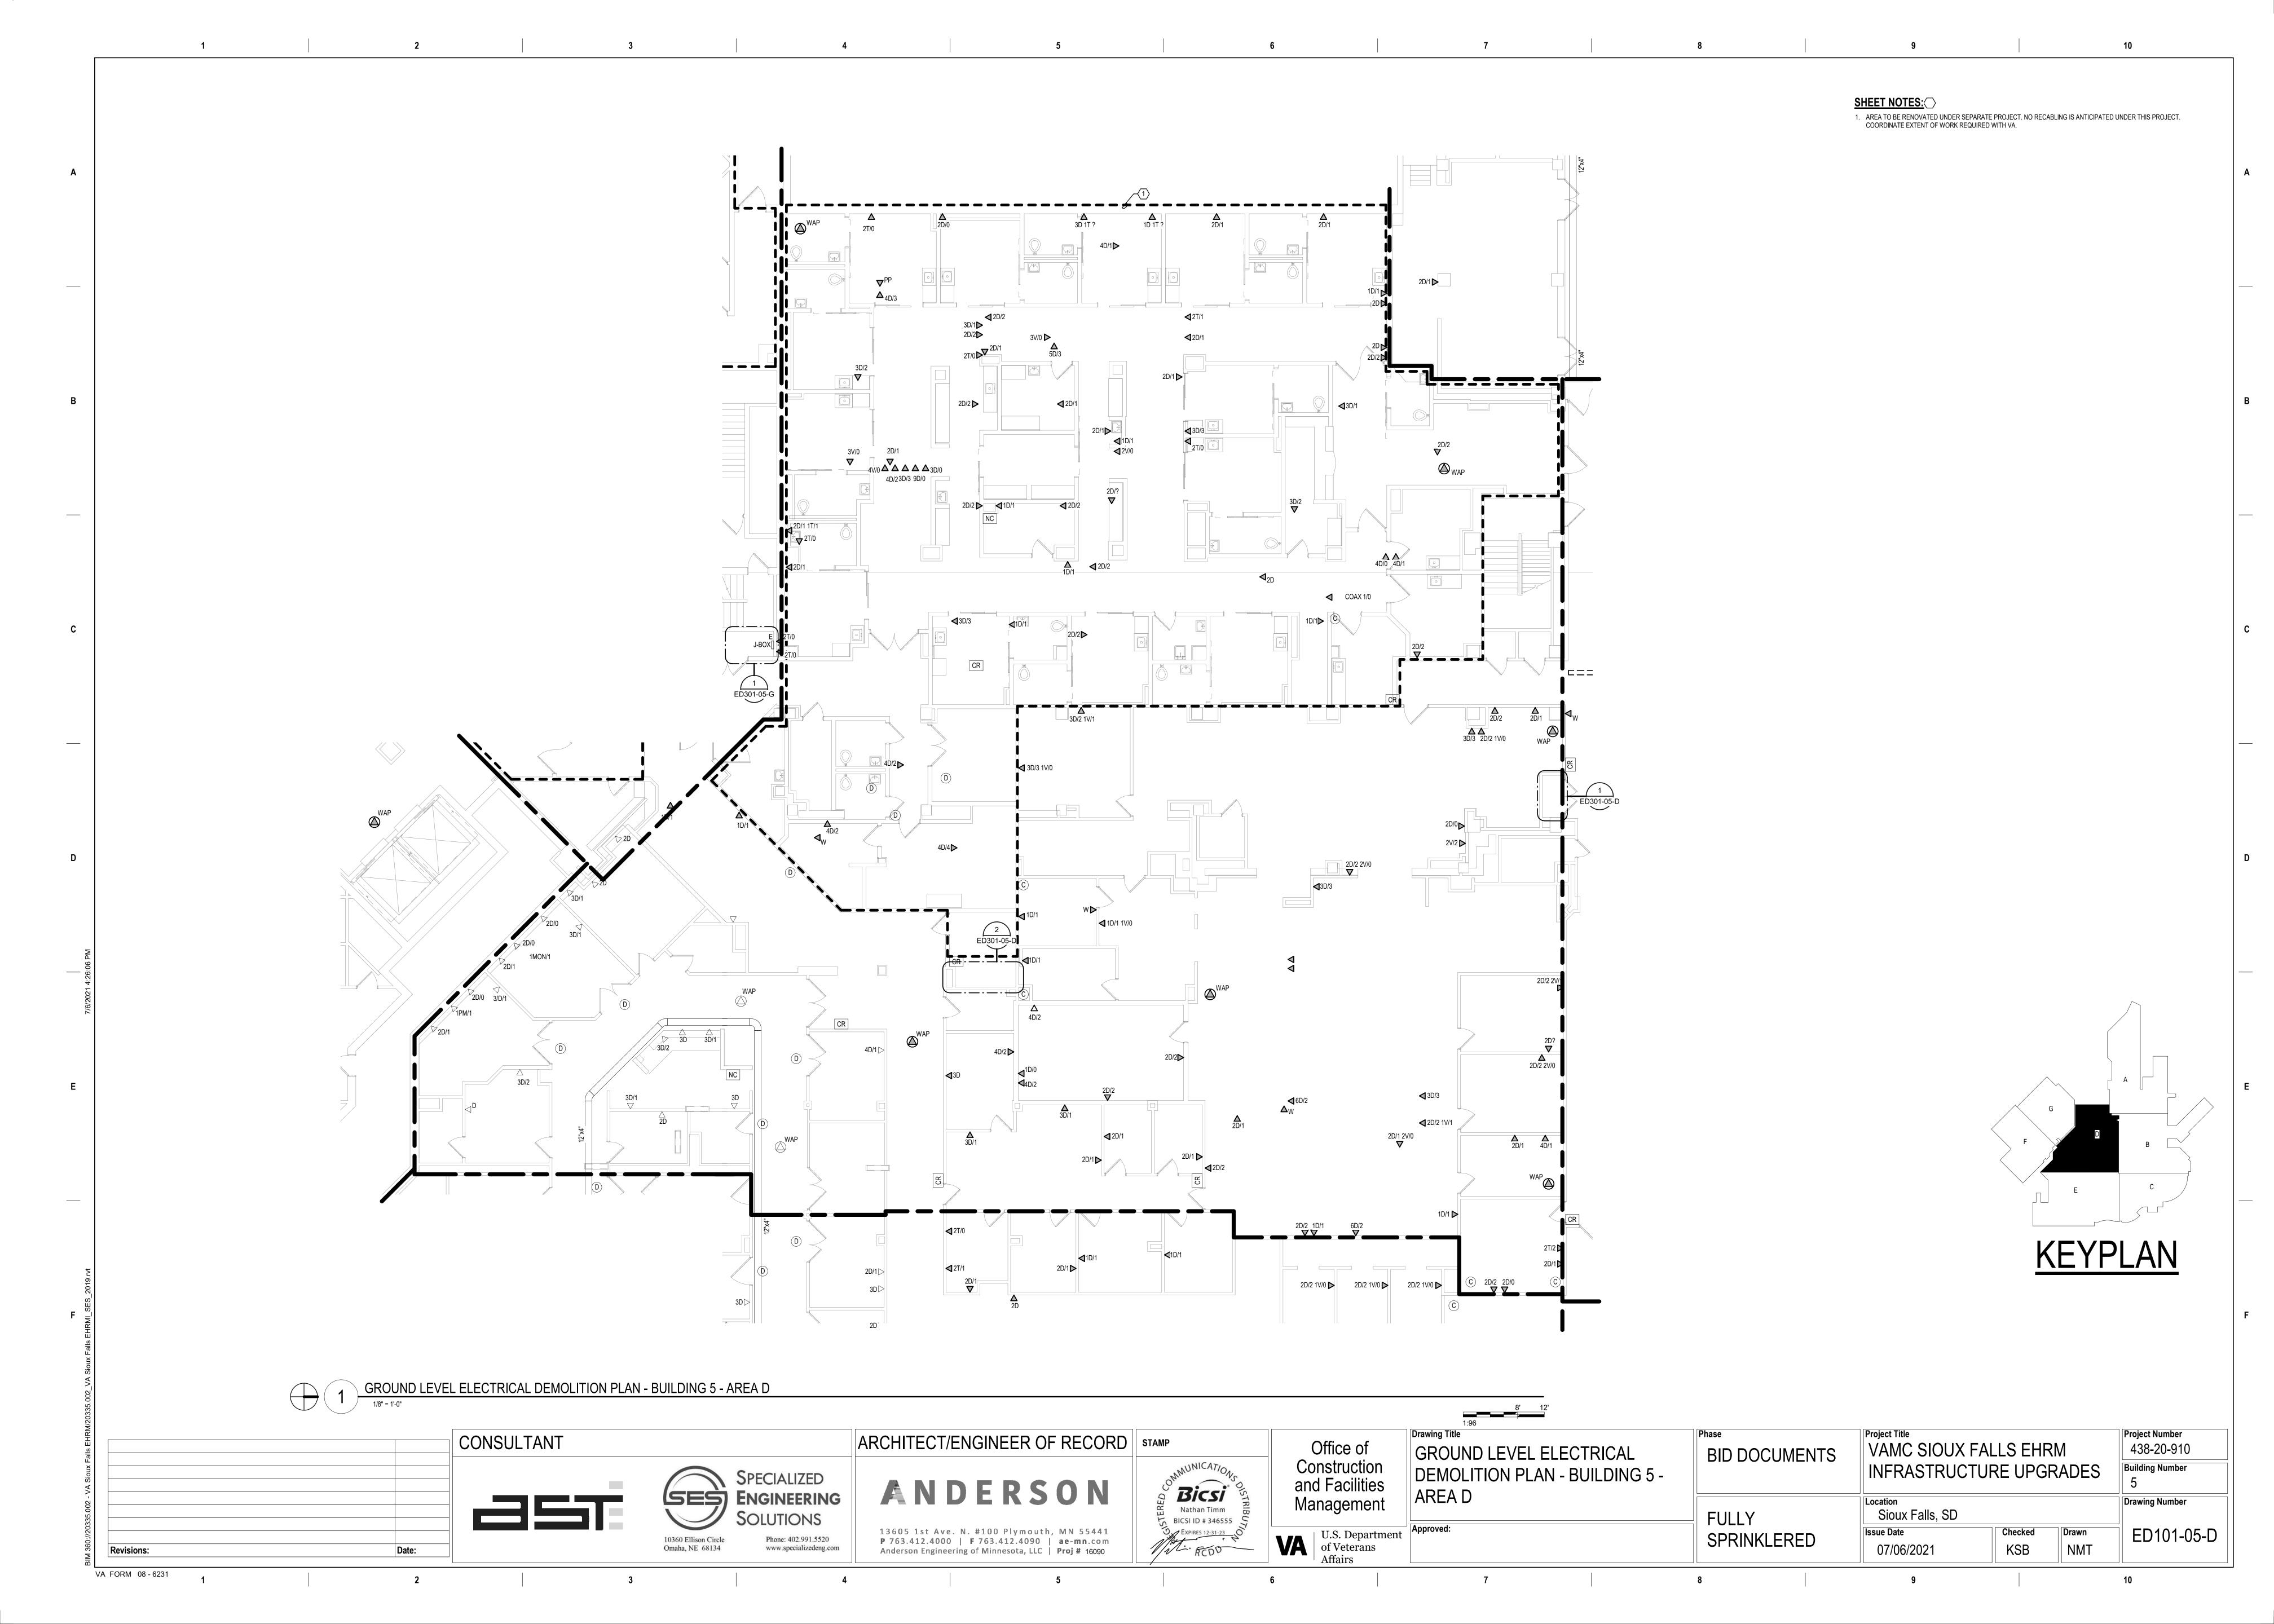

CABLING NOTES: A. THE EXISTING CABLE COUNT ARE THE CABLES CURRENTLY PRESENT IN THE SPACE. THE CABLE RELOCATION COUNT ARE THE NEW OR RELOCATED CABLES TO BE FED FROM THE SPACE. THE FINAL CABLE COUNT ARE THE CABLES THAT WILL BE PRESENT IN THE SPACE AT THE COMPLETION OF THE PROJECT. REMOVE ALL UNUSED CABLING AT THE COMPLETION OF THE PROJECT. 1. ROOM B90 EXISTING CABLE COUNT DATA (CAT6): 72 DATA (CAT5): 192 PATIENT MONITORING: 0 COMMERCIAL WIRELESS: 1 CABLE RELOCATION COUNT DATA (CAT6): -72 TO ROOM A27 DATA (CAT5): -192 TO ROOM A27 PATIENT MONITORING: 0 COMMERCIAL WIRELESS: -1 TO ROOM A27 EXISTING CABLE TO REMAIN DATA (CAT6): 0 PATIENT MONITORING: 0 COMMERCIAL WIRELESS: 0 FINAL CABLE COUNT DATA (CAT6): 0 VIDEO: 0 PATIENT MONITORING: 0 COMMERCIAL WIRELESS: 0 2. ROOM B97 EXISTING CABLE COUNT DATA (CAT6): 100 DATA (CAT5): 163 PATIENT MONITORING: 115 COMMERCIAL WIRELESS: 2 CABLE RELOCATION COUNT DATA (CAT6): -52 TO ROOM A27 DATA (CAT6): -48 TO ROOM H1 DATA (CAT5): -81 TO ROOM A27 DATA (CAT5): -82 TO ROOM H1 VIDEO: -1 TÓ ROOM A27 PATIENT MONITORING: -57 TO ROOM A27 PATIENT MONITORING: -58 TO ROOM H1 COMMERCIAL WIRELESS: -2 TO ROOM A27 EXISTING CABLE TO REMAIN DATA (CAT6): 0 PATIENT MONITORING: 0 COMMERCIAL WIRELESS: 0 FINAL CABLE COUNT DATA (CAT6): 0 VIDEO: 0 PATIENT MONITORING: 0 COMMERCIAL WIRELESS: 0 SHEET NOTES: 1. EXISTING TELEPHONE WALL FIELD TO BE DEMOLISHED. NEW COPPER BACKBONE TO BE PROVIDED ON PATCH PANELS IN TELECOMMUNICATIONS RACK. REFER TO CABLING NOTES AND NEW WORK PLANS FOR ADDITIONAL REQUIREMENTS. EXISTING FIBER ENCLOSURE TO BE DEMOLISHED. NEW FIBER BACKBONE TO BE TERMINATED IN NEW TELECOMMUNICATIONS RACK. REFER TO CABLING NOTES AND NEW WORK PLANS FOR ADDITIONAL REQUIREMENTS. GROUND LEVEL ELECTRICAL DEMOLITION - BUILDING 5 - AREA D - ROOM B90 GROUND LEVEL ELECTRICAL DEMOLITION - BUILDING 5 - AREA D - ROOM B97 Drawing Title Project Title Project Number CONSULTANT ARCHITECT/ENGINEER OF RECORD | STAMP Office of VAMC SIOUX FALLS EHRM 438-20-910 GROUND LEVEL ELECTRICAL **BID DOCUMENTS** Construction and Facilities **Building Number** INFRASTRUCTURE UPGRADES DEMOLITION - BUILDING 5 -SPECIALIZED Bicsi ANDERSON ENLARGED ROOMS - AREA D SES ENGINEERING Drawing Number Management Sioux Falls, SD **FULLY** BICSI ID # 346555 EXPIRES 12-31-23 O Checked Drawn 13605 1st Ave. N. #100 Plymouth, MN 55441 P 763.412.4000 | F 763.412.4090 | ae-mn.com ED301-05-D U.S. Department of Veterans Affairs SPRINKLERED Phone: 402.991.5520 10360 Ellison Circle KSB 07/06/2021 NMT www.specializedeng.com Omaha, NE 68134 Anderson Engineering of Minnesota, LLC | Proj # 16090 Revisions: VA FORM 08 - 6231

