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GENERAL ELECTRICAL DEMOLITION NOTES:  
(APPLICABLE TO ALL ED SHEETS)

1. ELECTRICAL DEMOLITION SHEET KEYED NOTES AND PHOTOS ARE INCLUDED TO DEPICT EXISTING CONDITIONS FOR CLARITY AND BIDDABILITY.
  2. THE CONTRACTOR SHALL BE RESPONSIBLE FOR FIELD VERIFYING EXISTING CONDITIONS.
  3. REFERENCES TO "HANGAR BAY" SHALL BE UNDERSTOOD TO INCLUDE 101 HANGAR (WASH) BAY AND 102 NOSE AREA.
  4. ALL SWITCHGEAR, PANELBOARDS, CIRCUIT BREAKERS, DRY-TYPE TRANSFORMERS, AND FIRE ALARM COMPONENTS IDENTIFIED FOR REMOVAL SHALL BE PROTECTED AND TURNED OVER TO MINOT AFB CIVIL ENGINEERING SQUADRON.
  5. THIS FACILITY CONTAINS ASBESTOS AND LEAD-CONTAINING MATERIALS AS DESCRIBED IN THE HAZARDOUS MATERIAL SURVEY DATED DECEMBER 2016. THE CONTRACTOR SHALL BE RESPONSIBLE FOR ABATEMENT AND REMOVAL OF SUCH ITEMS WHEN REQUIRED BY DEMOLITION ACTIVITIES DESCRIBED IN THE DESIGN DOCUMENTS. ABATEMENT AND REMOVAL ACTIVITIES SHALL BE CONDUCTED IN COMPLIANCE WITH THE APPROPRIATE SPECIFICATIONS AND THEIR REFERENCES.
  6. EXISTING COMMUNICATIONS BACKBONE CABLES AND CONDUIT TO BE DISCONNECTED FROM EXISTING CABINET IN 109AA COMM AND REMOVED. DISCONNECTION OF CABLES FROM EQUIPMENT SHALL BE PERFORMED BY MINOT AFB CIVIL ENGINEERING SQUADRON (5 CES)/COMMUNICATIONS SQUADRON (5 CS). COORDINATE DISCONNECTION WITH 5 CES/5 CS. NEW BACKBONE CABLES TO BE PROVIDED, SEE SHEET TN601.
  7. THE FOLLOWING SYSTEMS SHALL REMAIN UNTOUCHED IN PLACE UNLESS SPECIFICALLY IDENTIFIED OTHERWISE:
    - a) FIRE PUMP CONTROLLERS AND POWER SYSTEMS CONNECTED TO THE FIRE PUMP CONTROLLERS.
    - b) JOCKEY PUMP CONTROLLER, UNLESS REQUIRED TO MOVE TO FIT ALL EQUIPMENT ON 030 PLAN WEST WALL.
    - c) SERVICE TRANSFORMERS OTHER THAN TERMINATIONS OF CONDUCTORS TO THE SECONDARY SPADES.
    - d) TELECOMMUNICATIONS SERVICE FROM OUTSIDE PLANT TO ENTRANCE FACILITY IN 010 WASH EQUIPMENT ROOM.
    - e) ALL GROUNDING SYSTEMS OTHER THAN DISCONNECTING FROM EQUIPMENT TO BE REMOVED AND RECONNECTING TO NEW EQUIPMENT.
    - f) EQUIPMENT CONTROLS IN 010 WASH EQUIPMENT ROOM AND USER CONTROLS IN HANGAR BAY FOR THE POWER WASH UNITS (XWU-1/2/3/4).
  8. THE FOLLOWING SYSTEMS SHALL BE REMOVED UNLESS SPECIFICALLY IDENTIFIED OTHERWISE:
    - a) POWER SYSTEMS EXCEPT AS DESCRIBED IN NOTE 7(c).
    - b) LIGHTING FIXTURES.
    - c) LIGHTING CONTROLS, CONTACTORS, AND OTHER CONTROL COMPONENTS.
    - d) TELEPHONES AND OTHER COMMUNICATIONS DROPS ON THE USER SIDE OF THE COMMUNICATIONS ENTRANCE FACILITY EXCEPT AS DESCRIBED IN NOTE 7(d).
    - e) FOAM DETECTION AND NOTIFICATION, FIRE ALARM DETECTION AND NOTIFICATION, AND MASS NOTIFICATION SYSTEMS, EXCEPT AS DESCRIBED IN NOTE 7(a).
    - f) ELECTRICAL SUPPORT (CONTROLS, STARTERS, DISCONNECTS, CONDUCTORS, AND CONDUIT) ASSOCIATED WITH HVAC EQUIPMENT REMOVED AS IDENTIFIED ON SHEET MD101, EXCEPT AS DESCRIBED IN NOTE 7(f).
    - g) EXIT SIGNS.
- REMOVAL SHALL INCLUDE ASSOCIATED CONTROLS, CONDUCTORS, AND CONDUIT SHALL BE REMOVED IN ALL SPACES UNLESS OTHERWISE NOTED.
- SEE SHEET CD101 FOR EXTERIOR ELECTRICAL DEMOLITION, ABANDONMENT, AND REMOVAL.
9. ANY CONDUIT ASSOCIATED WITH DEMOLITION NOTE 8 WHICH ROUTES UNDERGROUND SHALL BE CUT TO FLOOR LEVEL AND PLUGGED WITH CONCRETE UNLESS OTHERWISE NOTED. ANY CONDUIT ASSOCIATED WITH DEMOLITION NOTE 8 WHICH ROUTES ABOVE GROUND SHALL BE REMOVED UNLESS OTHERWISE NOTED.
  10. HIGH BAY LIGHTING SHOWN IN PHOTOS IS FROM BEFORE A RECENT FIXTURE REPLACEMENT. SEE EL SHEETS FOR RELOCATION OF NOW-EXISTING FIXTURES.

# KEYED ELECTRICAL DEMOLITION NOTES:  
(APPLICABLE TO ALL ED PLANS)

1. EXISTING BUILDING TRANSFORMER TO REMAIN IN PLACE. TRANSFORMER SECONDARY CONDUCTORS TO BUILDING EQUIPMENT IDENTIFIED FOR REMOVAL TO BE REMOVED. TRANSFORMER SECONDARY CONDUCTORS TO EQUIPMENT IDENTIFIED FOR RETENTION TO REMAIN IN PLACE (IE 25KVA TRANSFORMER, FIRE PUMP CONTROLLERS, AIRFIELD FLOOD LIGHTS). SEE SITE DEMO SHEET(S) FOR ADDITIONAL DEMOLITION AND ABANDON REQUIREMENTS.
2. EXISTING GROUNDING POINT TO REMAIN IN PLACE.
3. EXISTING POWER SERVICE ENTRANCE. CONDUIT AND CONDUCTORS TO BE REMOVED BACK TO EXISTING TRANSFORMER.
4. EXISTING FIRE ALARM ANTENNA TO BE REMOVED AND REPLACED.
5. EXISTING PANEL DOOR OPERATOR, MOTOR, COUNTERBALANCE, AND PULLING MECHANISM TO BE REMOVED AND REPLACED PER SECTION 08 33 23.
6. EXISTING PANELBOARD TO BE REMOVED.
7. EXISTING POWER SERVICE ENTRANCE. CONDUCTORS TO BE REMOVED BACK TO EXISTING TRANSFORMER.



**US Army Corps  
of Engineers®  
Omaha District**

MARK	DESCRIPTION	DATE

US ARMY CORPS OF ENGINEERS OMAHA DISTRICT 1616 CAPITOL AVE OMAHA, NE 68102	DESIGNED BY: S. LINDREN	ISSUE DATE: 02/19/2020
	CHECKED BY: S. OTT	SOLICITATION NO.: 91286-20R-0026
SUBMITTED BY: STEVEN L. OTT, P.E.	CONTRACT NO.:	FILE NUMBER:
ANSID FILE NAME:	SIZE:	FILE NAME:

REPAIR B-52 MAINTENANCE DOCK 5  
(BUILDING 837)  
MINOT AFB, NORTH DAKOTA

**ELECTRICAL EXISTING CONDITION AND  
DEMOLITION NOTES**

**SHEET ID**

**ED001**

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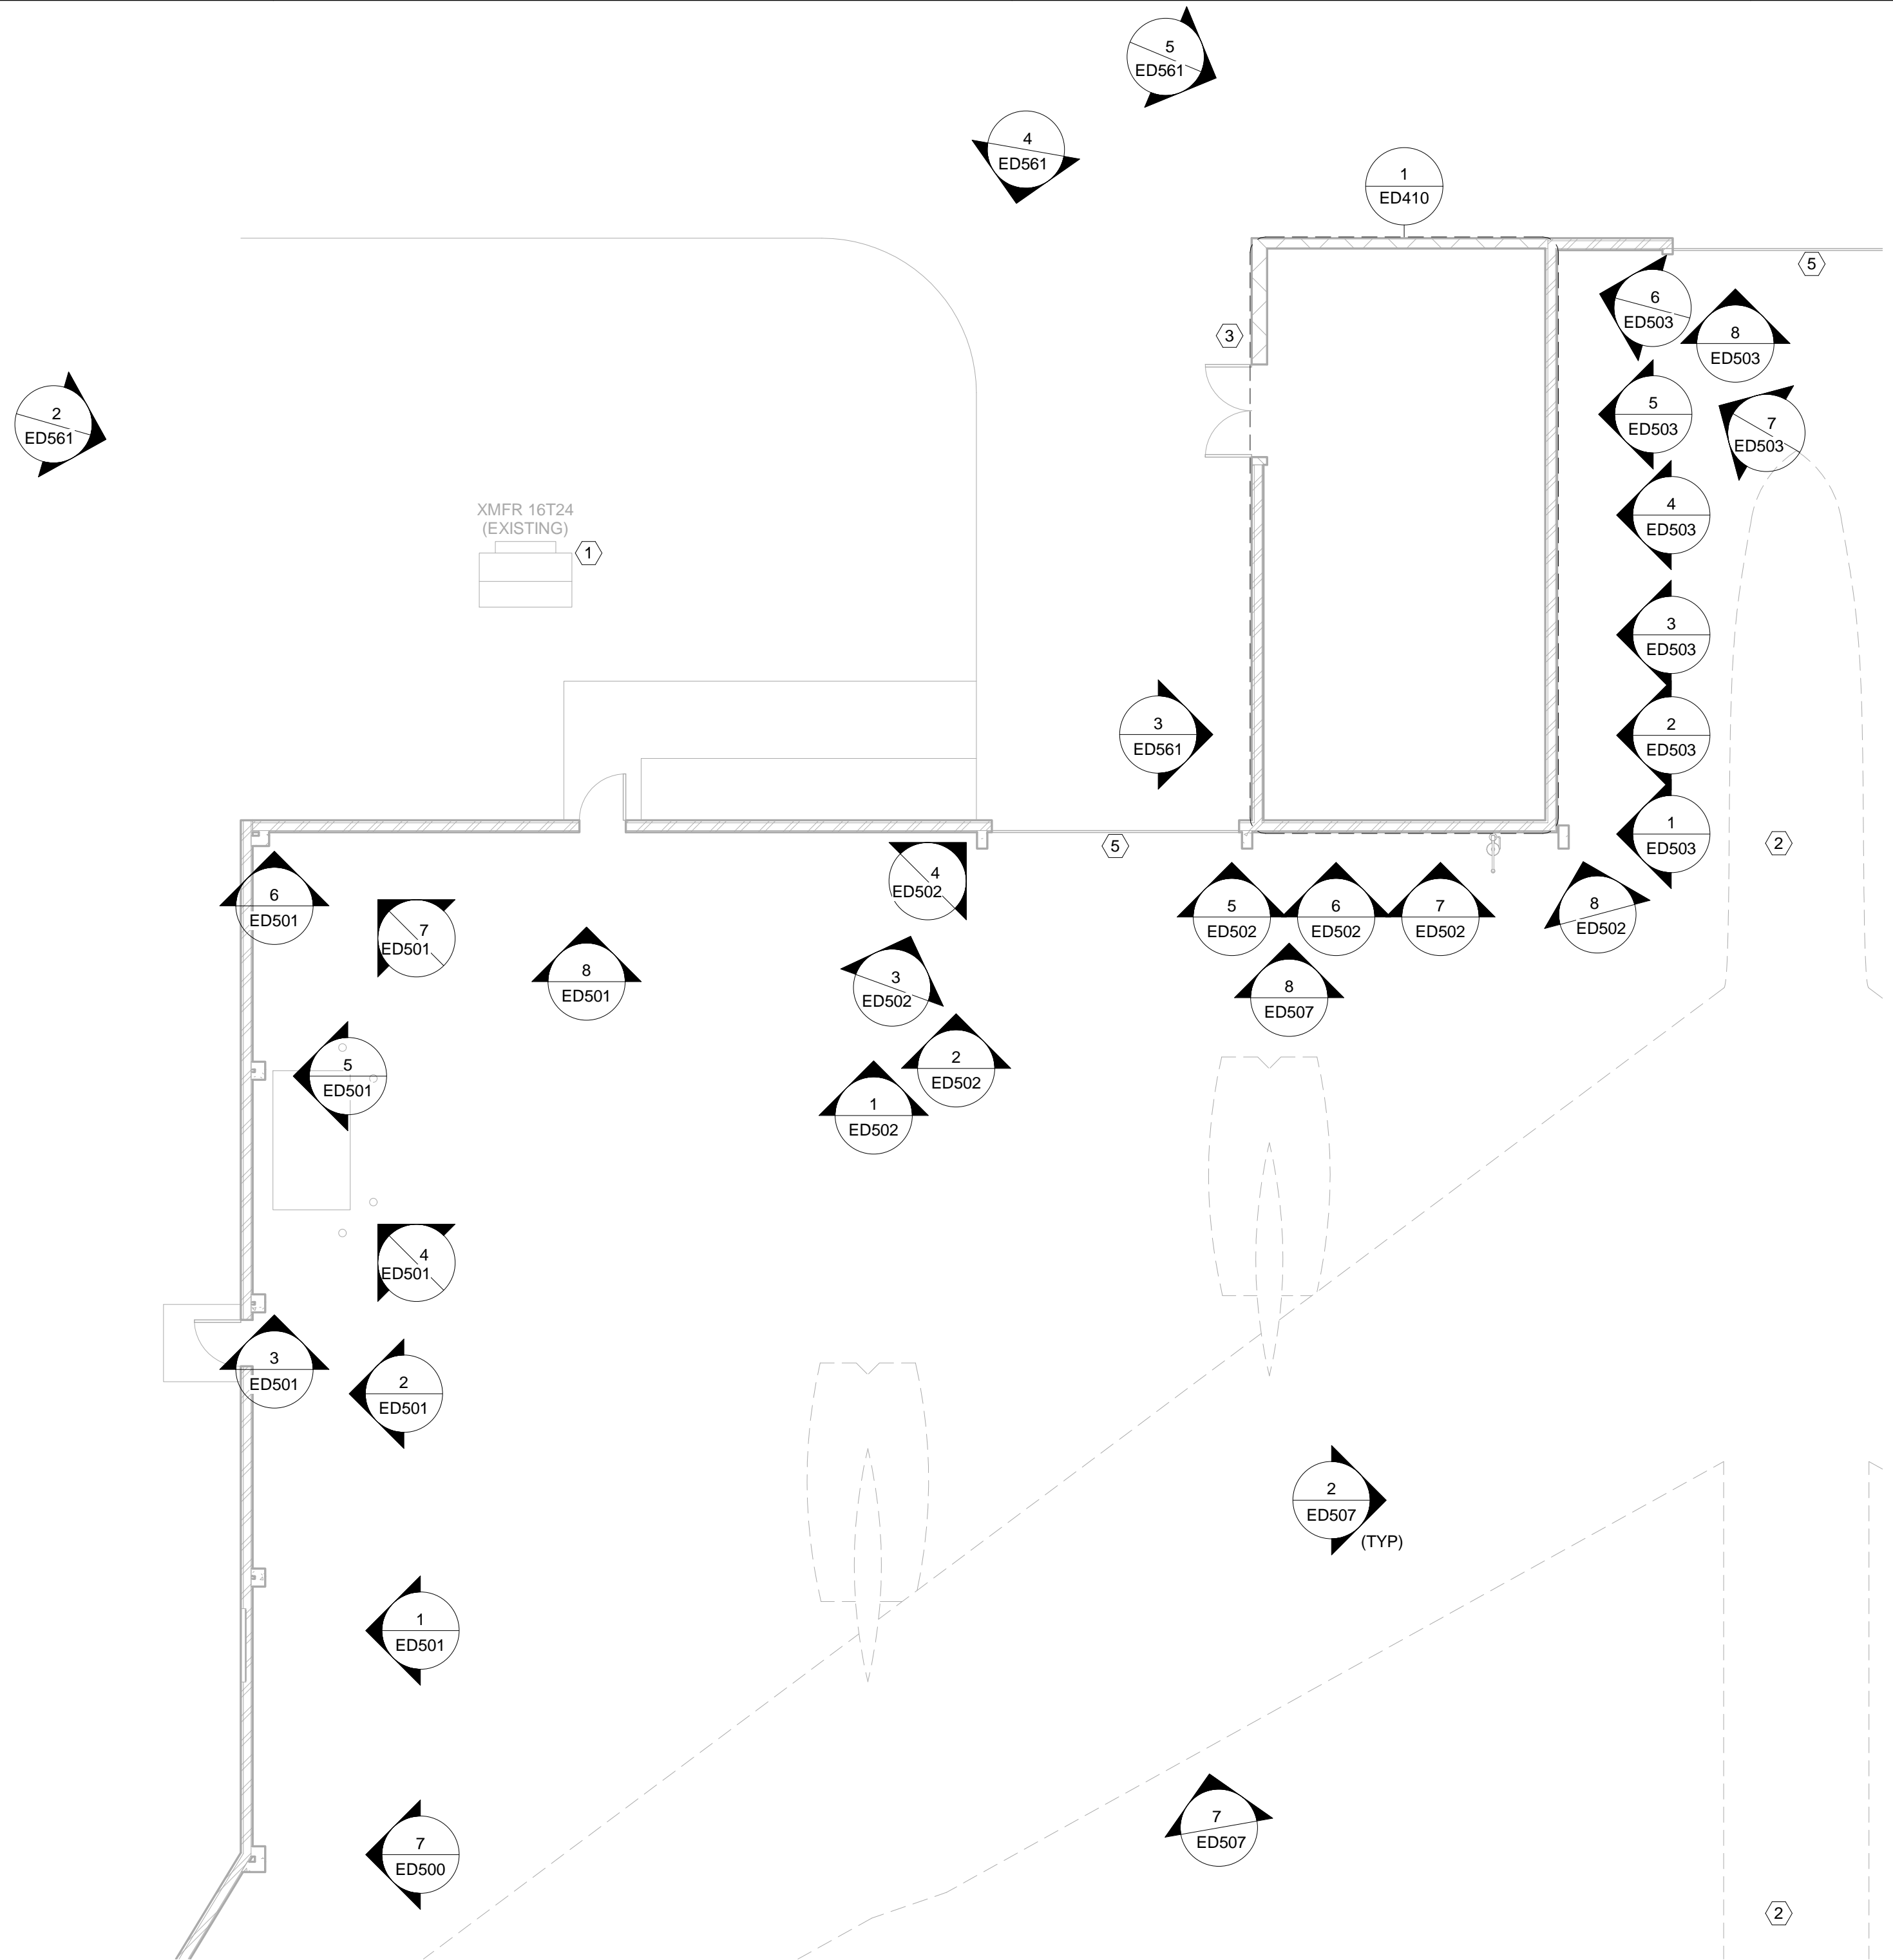
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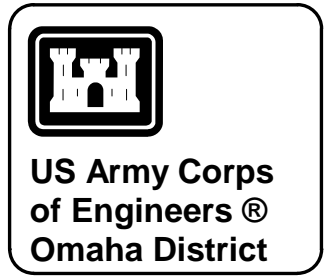
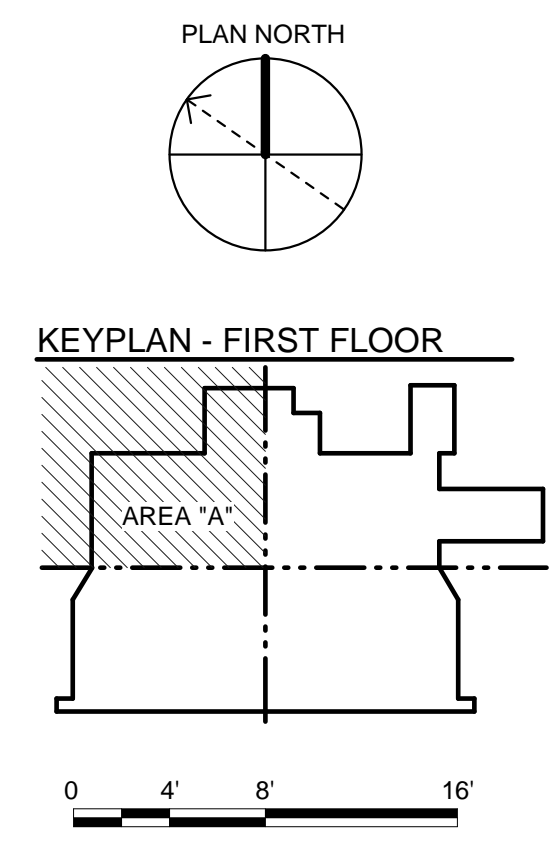


GENERAL ELECTRICAL DEMOLITION NOTES:  
SEE GENERAL NOTES ON SHEET ED001.

# KEYED ELECTRICAL DEMOLITION NOTES:  
SEE KEYED NOTES ON SHEET ED001.

1 ED111 1/8" = 1'-0"

**ELECTRICAL EXISTING CONDITIONS/DEMOLITION PLAN - AREA A**



MARK	DESCRIPTION	DATE

DESIGNED BY: S. LEINDREN	ISSUE DATE: 02/19/2020
DRAWN BY: S. LEINDREN	SOLICITATION NO.:
CHECKED BY: S. OTT	9128-22R-0026
SUBMITTED BY: STEVEN L. OTT, P.E.	CONTRACT NO.:
ANSI D FILE NAME:	FILE NUMBER:
US ARMY CORPS OF ENGINEERS	OMAHA DISTRICT
1616 CAPITOL AVE	OMAHA, NE 68102

REPAIR B-52 MAINTENANCE DOCK 5  
(BUILDING 837)  
MINOT AFB, NORTH DAKOTA

**ELECTRICAL EXISTING CONDITIONS/DEMOLITION PLAN AREA A**

SHEET ID


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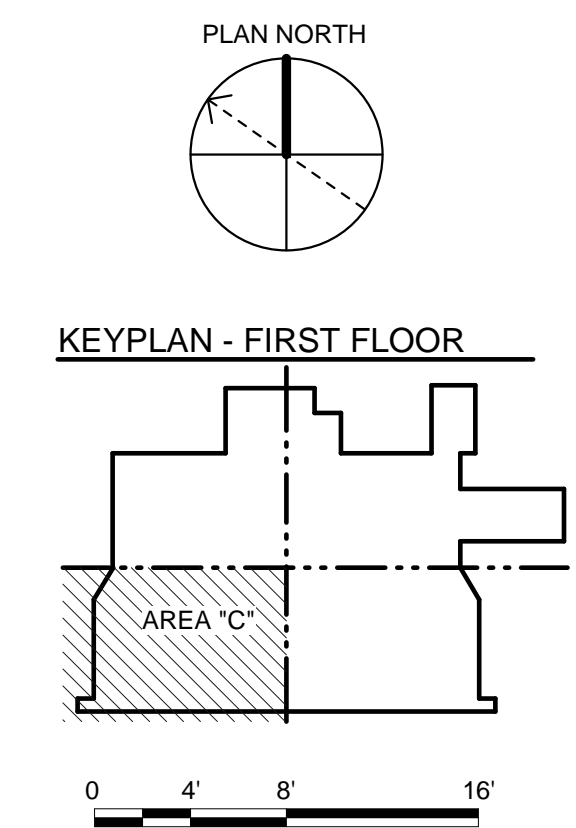
GENERAL ELECTRICAL DEMOLITION NOTES:  
SEE GENERAL NOTES ON SHEET ED001.

# KEYED ELECTRICAL DEMOLITION NOTES:  
SEE KEYED NOTES ON SHEET ED001.

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A



**1 ED113 1/8" = 1'-0"**  
**ELECTRICAL EXISTING CONDITIONS/DEMOLITION PLAN - AREA C**

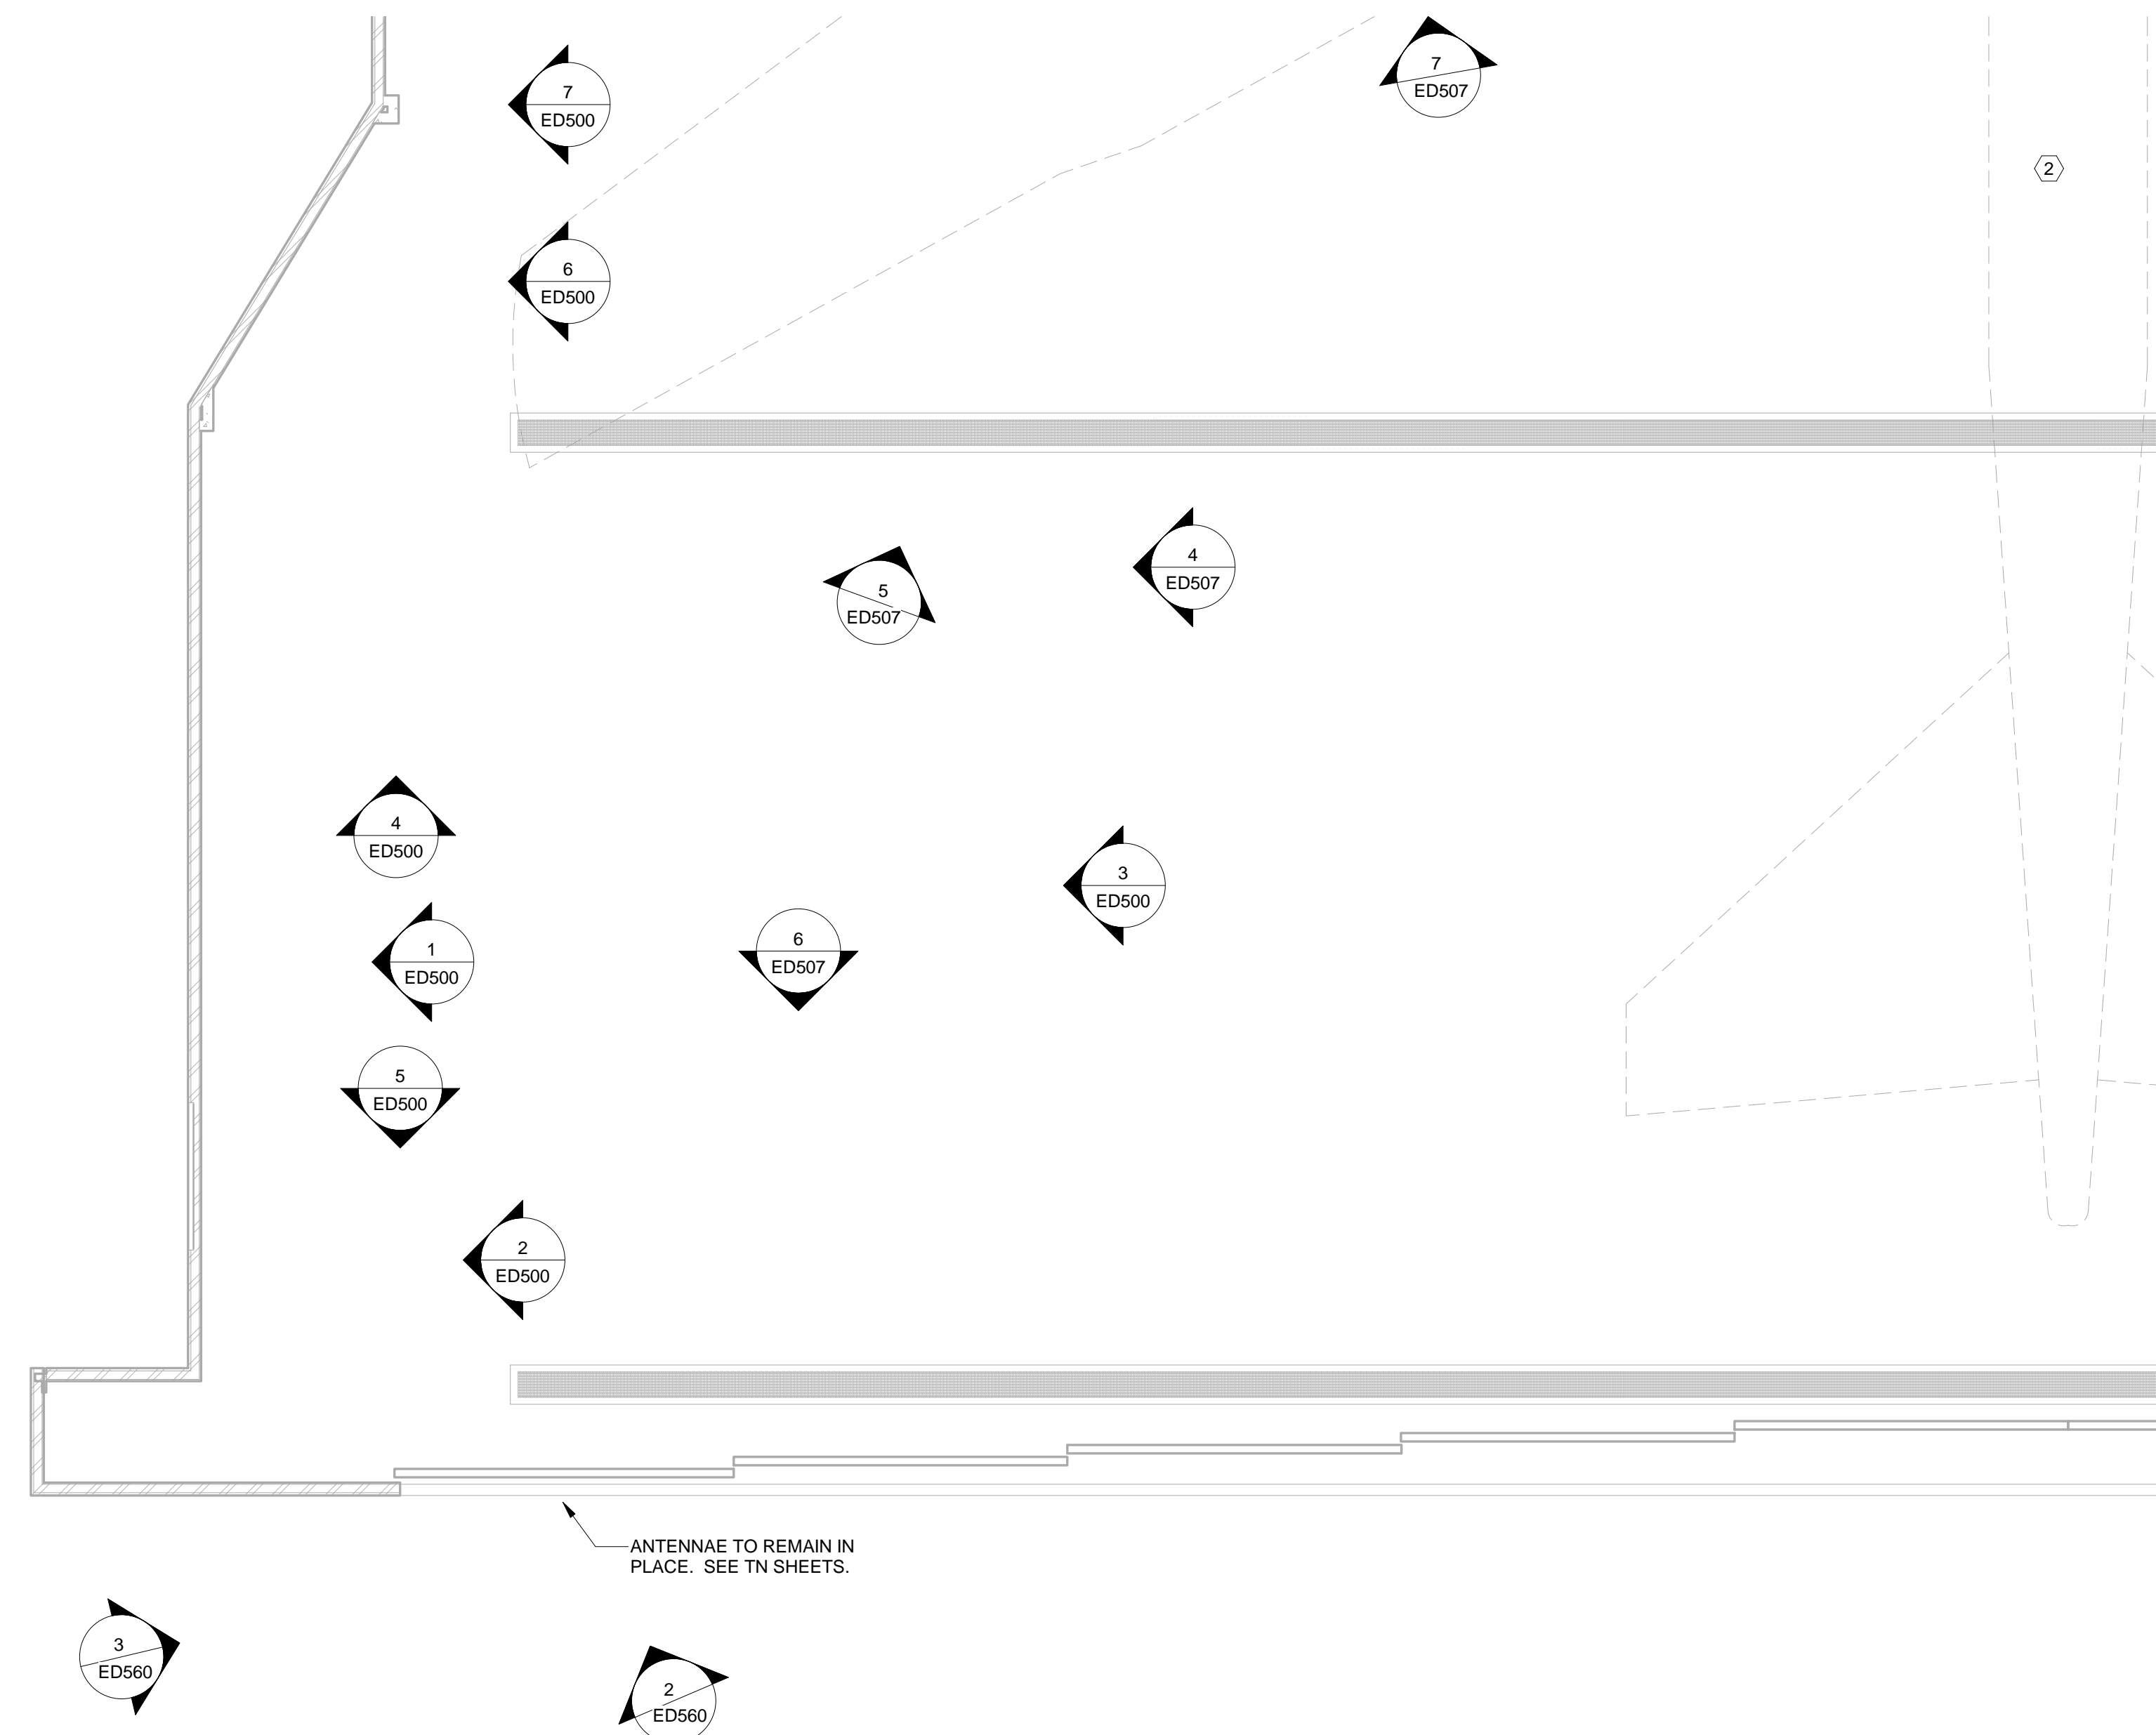

US Army Corps  
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Omaha District

MARK	DESCRIPTION	DATE

DESIGNED BY: SEUNDREN S.O.T.T.	OMAHA DISTRICT OMAHA DISTRICT 1616 CAPITOL AVE OMAHA, NE 68102	ISSUE DATE: 02/19/2020
CHECKED BY: S.O.T.T.	US ARMY CORPS OF ENGINEERS	SOLICITATION NO.:
SUBMITTED BY: STEVEN L. OTT, P.E.		91286-20R-0026
SIZE: ANSI D		CONTRACT NO.:
FILE NAME:		FILE NUMBER:

REPAIR B-52 MAINTENANCE DOCK 5  
(BUILDING 837)  
MINOT AFB, NORTH DAKOTA

ELECTRICAL EXISTING CONDITIONS/DEMOLITION  
PLAN  
AREA C

SHEET ID  
**ED113**

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GENERAL ELECTRICAL DEMOLITION NOTES:  
SEE GENERAL NOTES ON SHEET ED001.

# KEYED ELECTRICAL DEMOLITION NOTES:  
SEE KEYED NOTES ON SHEET ED001.

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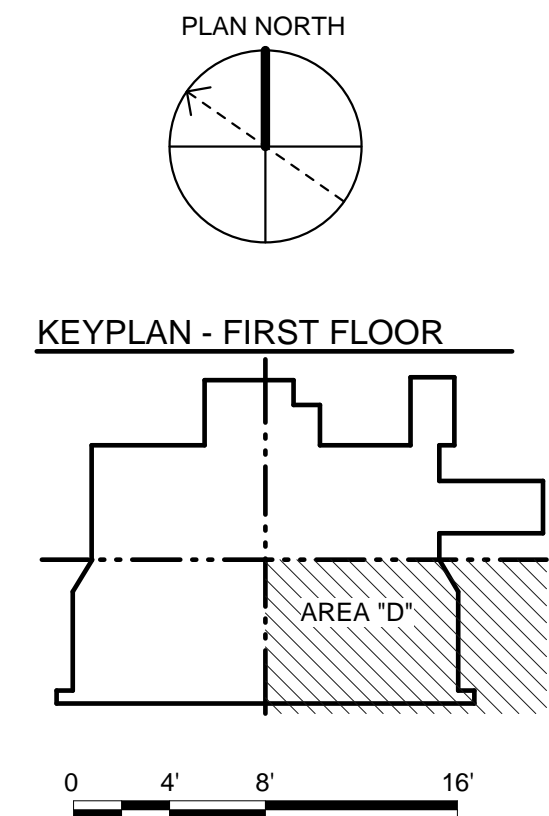
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ED114  
1/8" = 1'-0"

### ELECTRICAL EXISTING CONDITIONS/DEMOLITION PLAN - AREA D



**US Army Corps  
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MARK	DESCRIPTION	DATE

DESIGNED BY: S. LEIDREN	ISSUE DATE: 02/19/2020
DRAWN BY: S. LEIDREN	SOLICITATION NO.: 91286-20R-0026
CHECKED BY: S. OTT	CONTRACT NO.:
SUBMITTED BY: STEVEN L. OTT, P.E.	FILE NUMBER:
SIZE: ANSI D	FILE NAME:
US ARMY CORPS OF ENGINEERS OMAHA DISTRICT 1616 CAPITOL AVE OMAHA, NE 68102	


REPAIR B-52 MAINTENANCE DOCK 5  
(BUILDING 837)  
MINOT AFB, NORTH DAKOTA

#### ELECTRICAL EXISTING CONDITIONS/DEMOLITION PLAN

AREA D

SHEET ID

## ED114

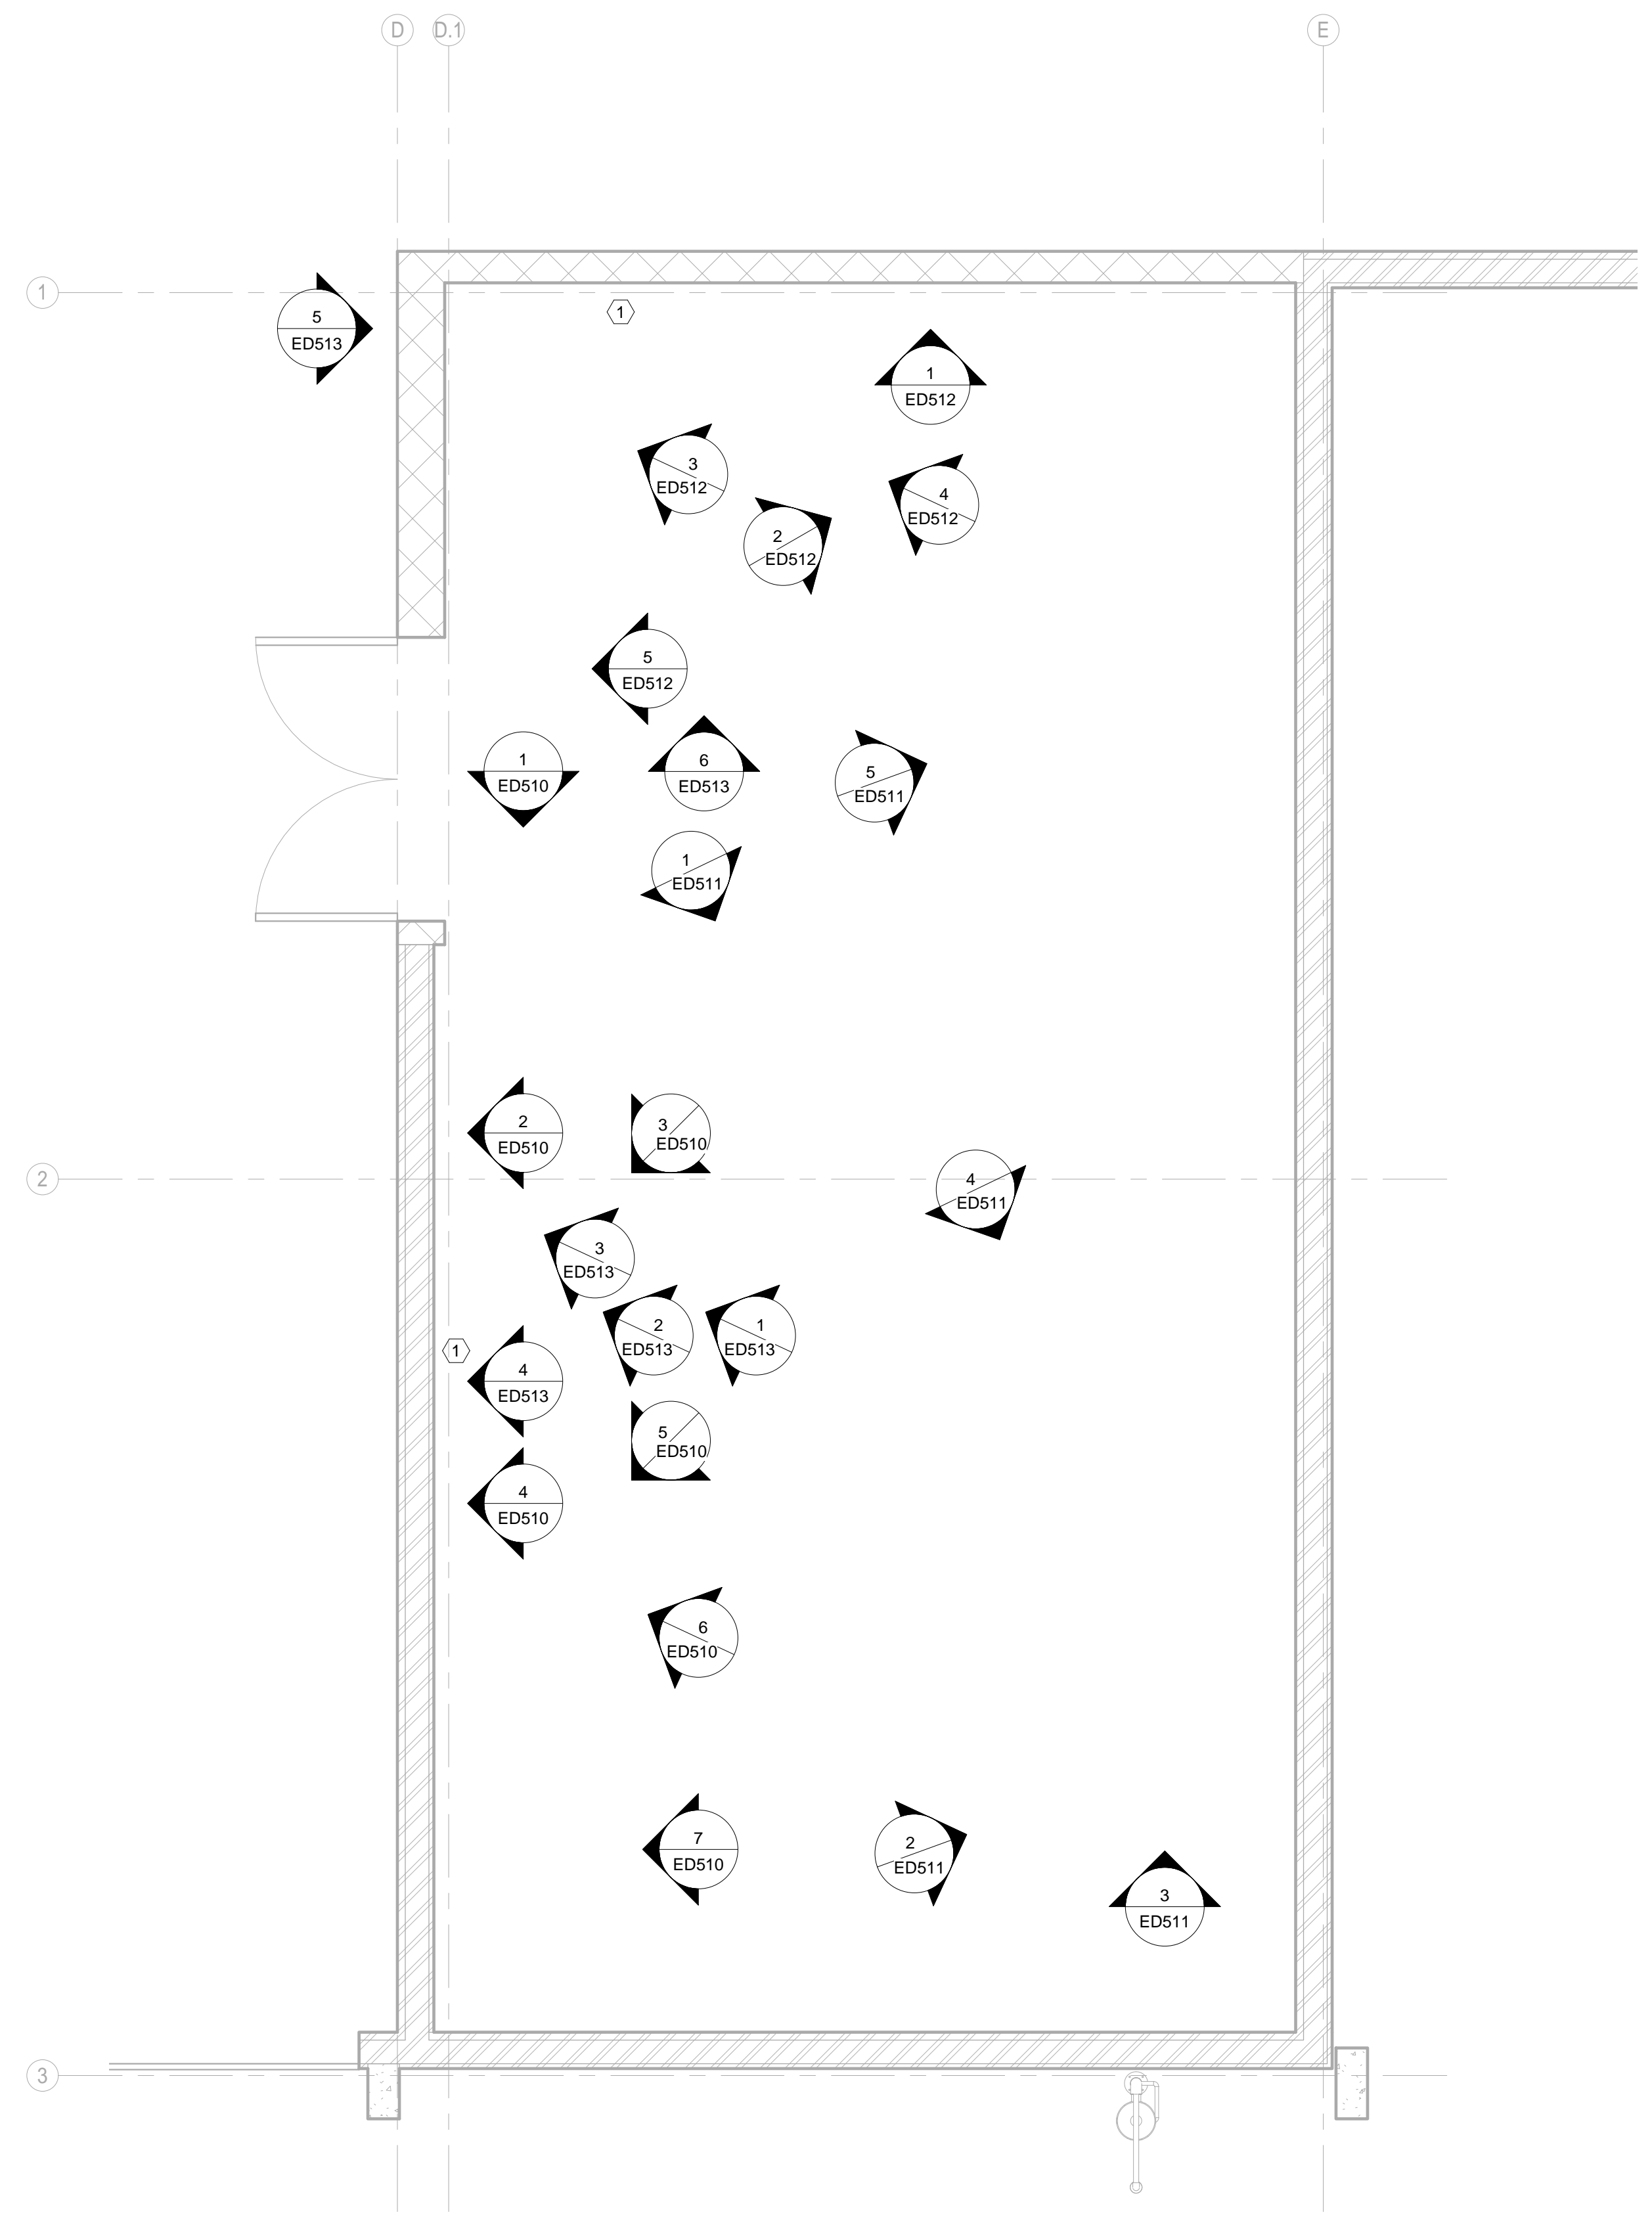


GENERAL ELECTRICAL DEMOLITION NOTES:  
 SEE GENERAL NOTES ON SHEET ED001.  
 COORDINATE WITH 'MD' SERIES SHEETS.  
 CONVENIENCE RECEPTACLES, LIGHT FIXTURES, LIGHT SWITCHES, AND SUPPORTING INFRASTRUCTURE TO BE REMOVED.

# KEYED ELECTRICAL DEMOLITION NOTES:  
 1. EXISTING COMMUNICATIONS SERVICE ENTRANCE TO BE UNTOUCHED BY THIS PROJECT.

**ELECTRICAL EXISTING/DEMOLITION PLAN  
 WASH EQUIPMENT ROOM ENLARGED PLAN**

1  
ED410

3/8" = 1'-0"

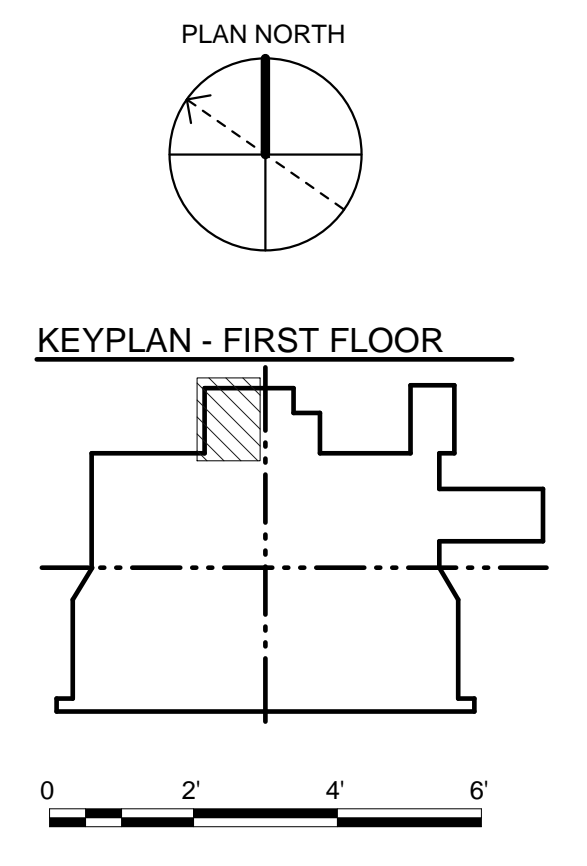

MARK	DESCRIPTION	DATE

<b>DESIGNED BY:</b> SLINDREN TYNOR	<b>ISSUE DATE:</b> 02/19/2020
<b>CHECKED BY:</b> S. OTT	<b>SOLICITATION NO.:</b> 91286-20R-0026
<b>SUBMITTED BY:</b> STEVEN L. OTT, P.E.	<b>CONTRACT NO.:</b>
<b>SIZE:</b> ANSI D	<b>FILE NUMBER:</b>
<b>FILE NAME:</b>	
<b>US ARMY CORPS OF ENGINEERS</b> OMAHA DISTRICT 1616 CAPITOL AVE OMAHA, NE 68102	

REPAIR B-52 MAINTENANCE DOCK 5  
 (BUILDING 837)  
 MINOT AFB, NORTH DAKOTA

**ELECTRICAL EXISTING/DEMOLITION PLAN**  
**WASH EQUIPMENT ROOM ENLARGED PLAN**

**SHEET ID**  
**ED410**

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GENERAL ELECTRICAL DEMOLITION NOTES:  
 SEE GENERAL NOTES ON SHEET ED001.  
 COORDINATE WITH 'MD' SERIES SHEETS.  
 CONVENIENCE RECEPTACLES, LIGHT FIXTURES, LIGHT SWITCHES, AND SUPPORTING INFRASTRUCTURE TO BE REMOVED.



# KEYED ELECTRICAL DEMOLITION NOTES:  
 1. ALL OF SUB-AREA IS TO BE DEMOLISHED (EXCEPT PERIMETER AND HANGAR WALLS..)

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**ELECTRICAL EXISTING/DEMOLITION PLAN  
 EQUIPMENT ROOM ENLARGED PLAN**

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 ED420  
 3/8" = 1'-0"



**US Army Corps  
 of Engineers®  
 Omaha District**

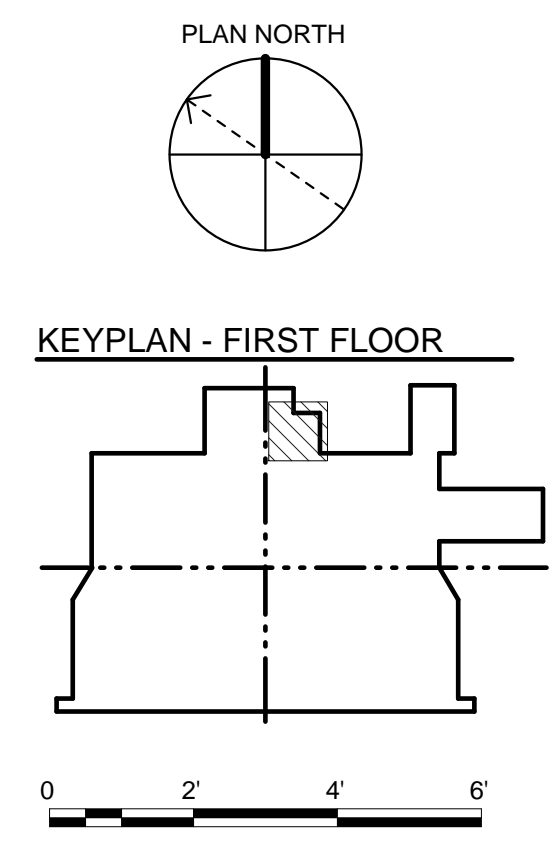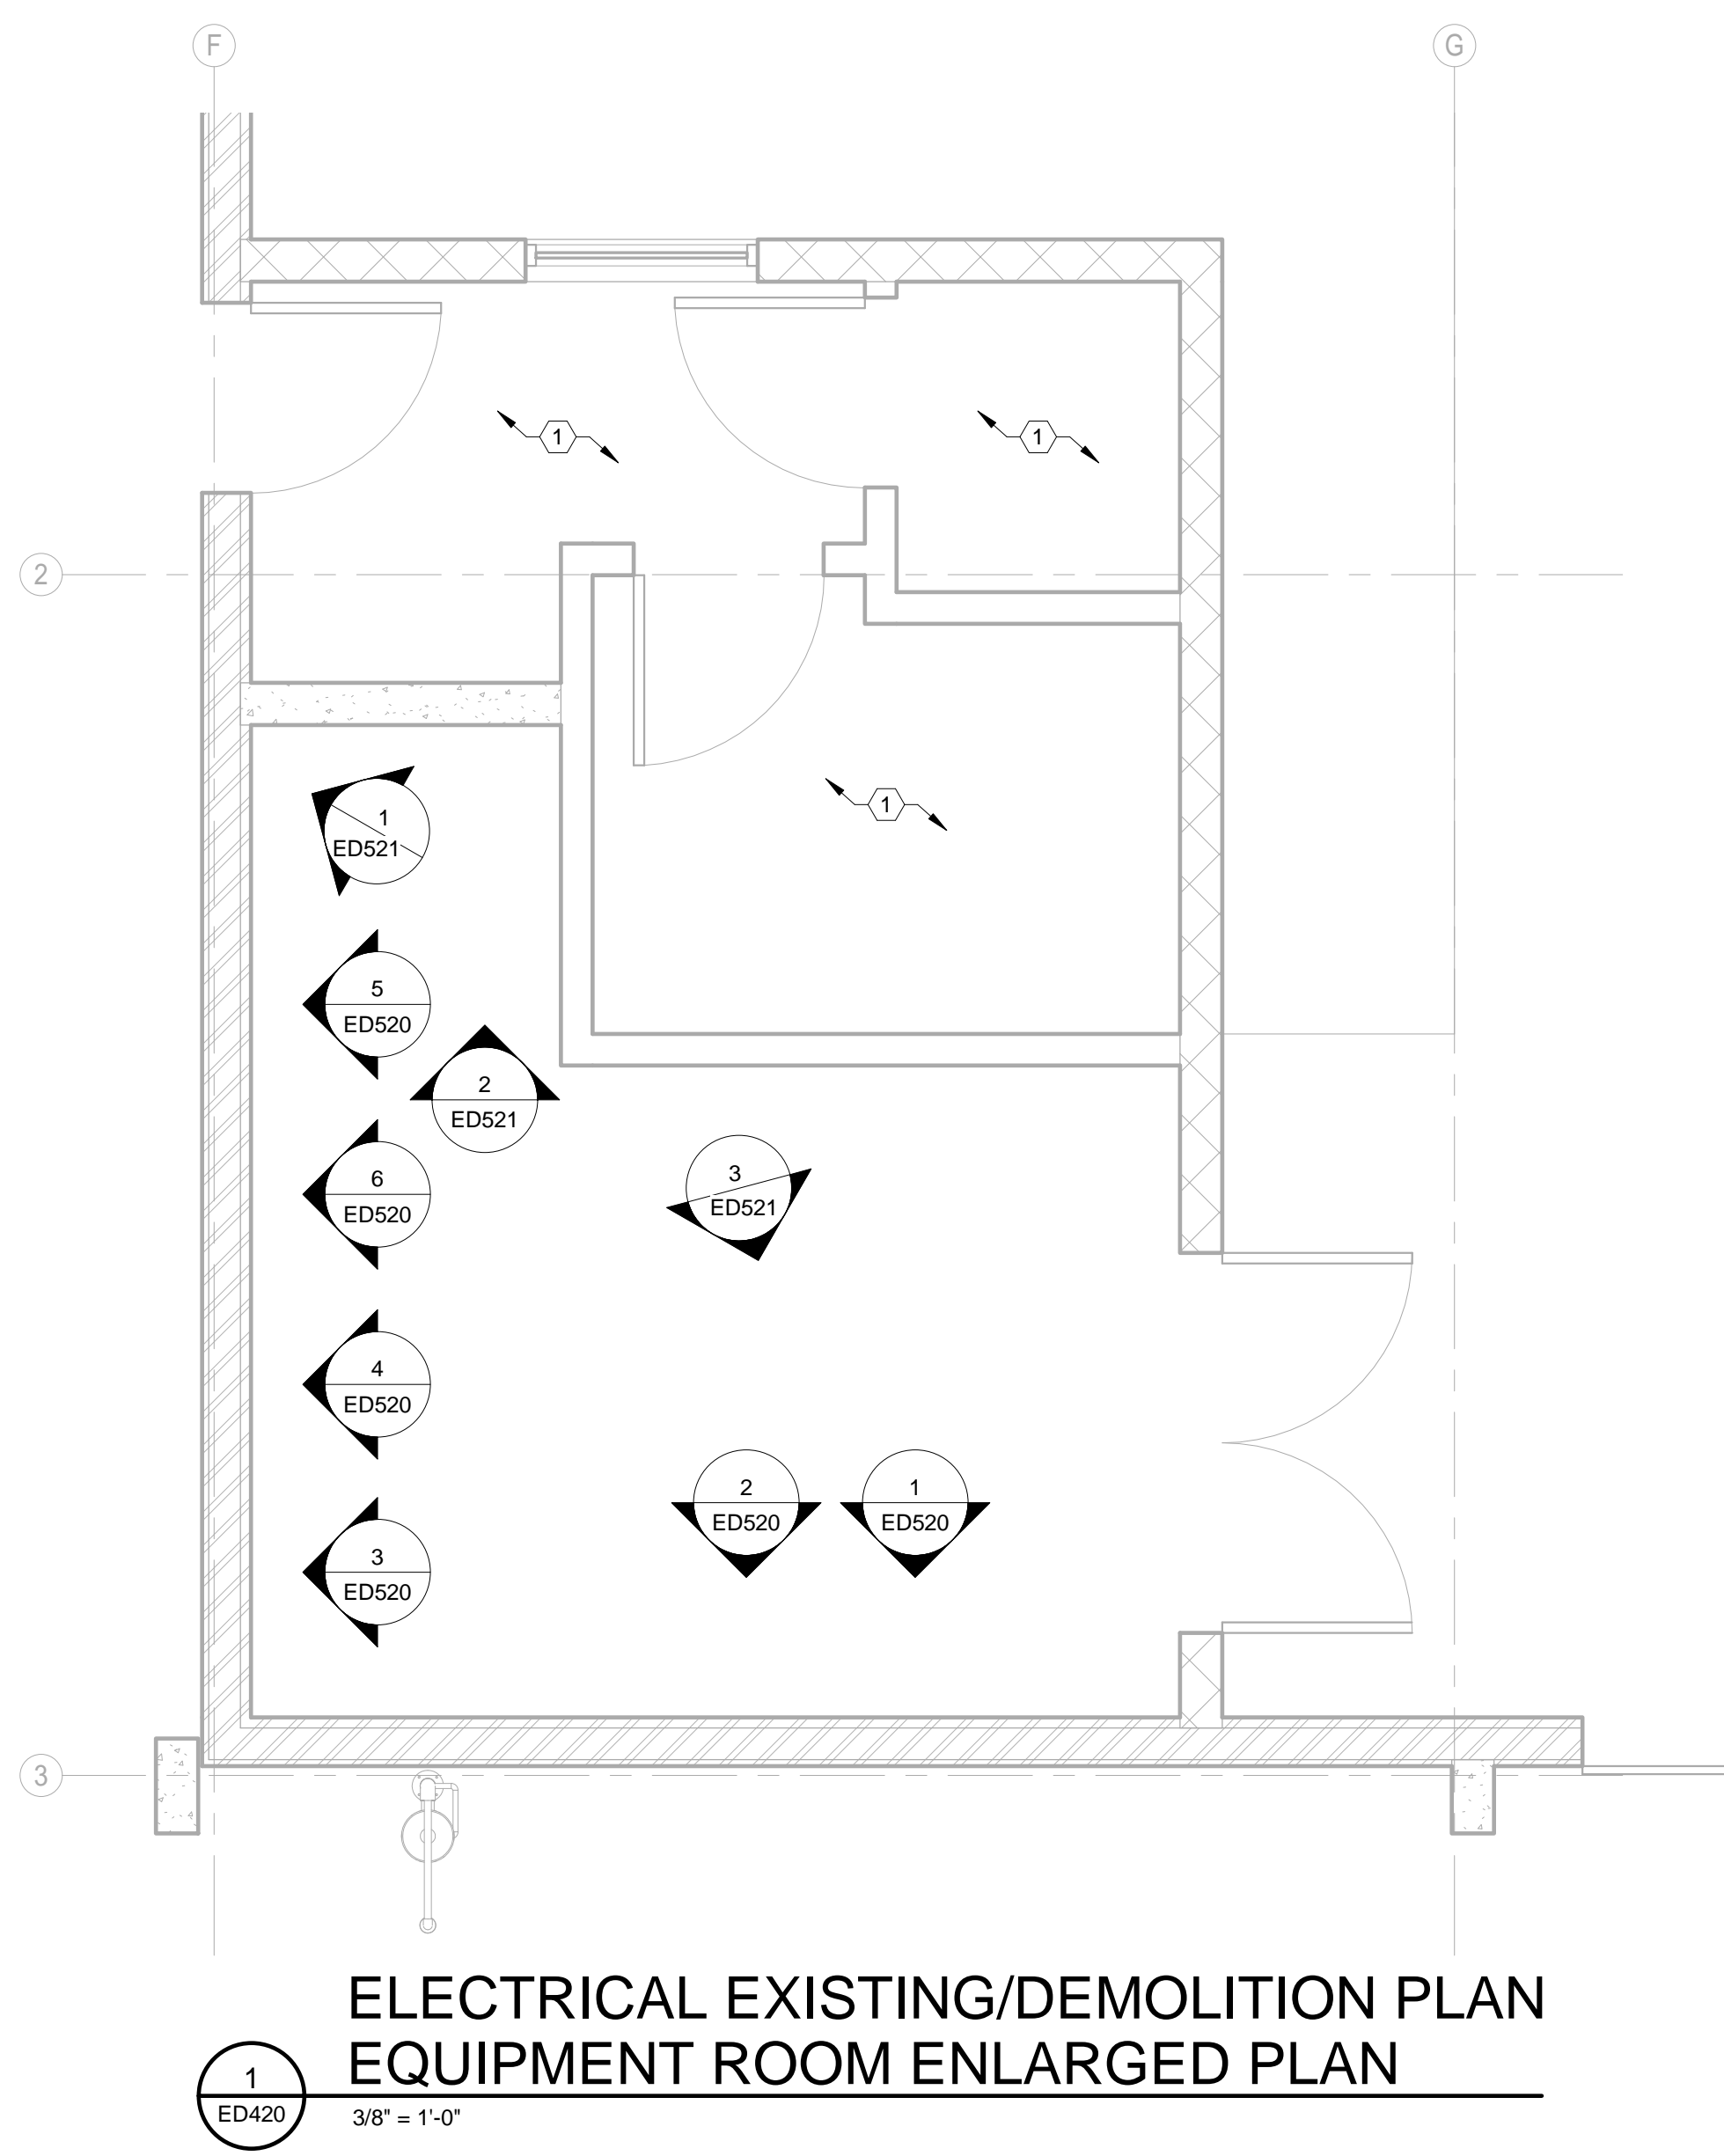DATE	DESCRIPTION	MARK

DESIGNED BY:	ISSUE DATE:
SLINDREN	02/19/2020
STANDREN	SOLICITATION NO.:
STANDREN	91286-20R-0026
STANDREN	CONTRACT NO.:
STANDREN	
STANDREN	FILE NUMBER:
STANDREN	
STANDREN	FILE NAME:
STANDREN	
STANDREN	ANSI'D

US ARMY CORPS OF ENGINEERS  
 OMAHA DISTRICT  
 1616 CAPITOL AVE  
 OMAHA, NE 68102

REPAIR B-52 MAINTENANCE DOCK 5  
 (BUILDING 837)  
 MINOT AFB, NORTH DAKOTA

**ELECTRICAL EXISTING/DEMOLITION PLAN  
 EQUIPMENT ROOM ENLARGED PLAN**

**SHEET ID**

**ED420**

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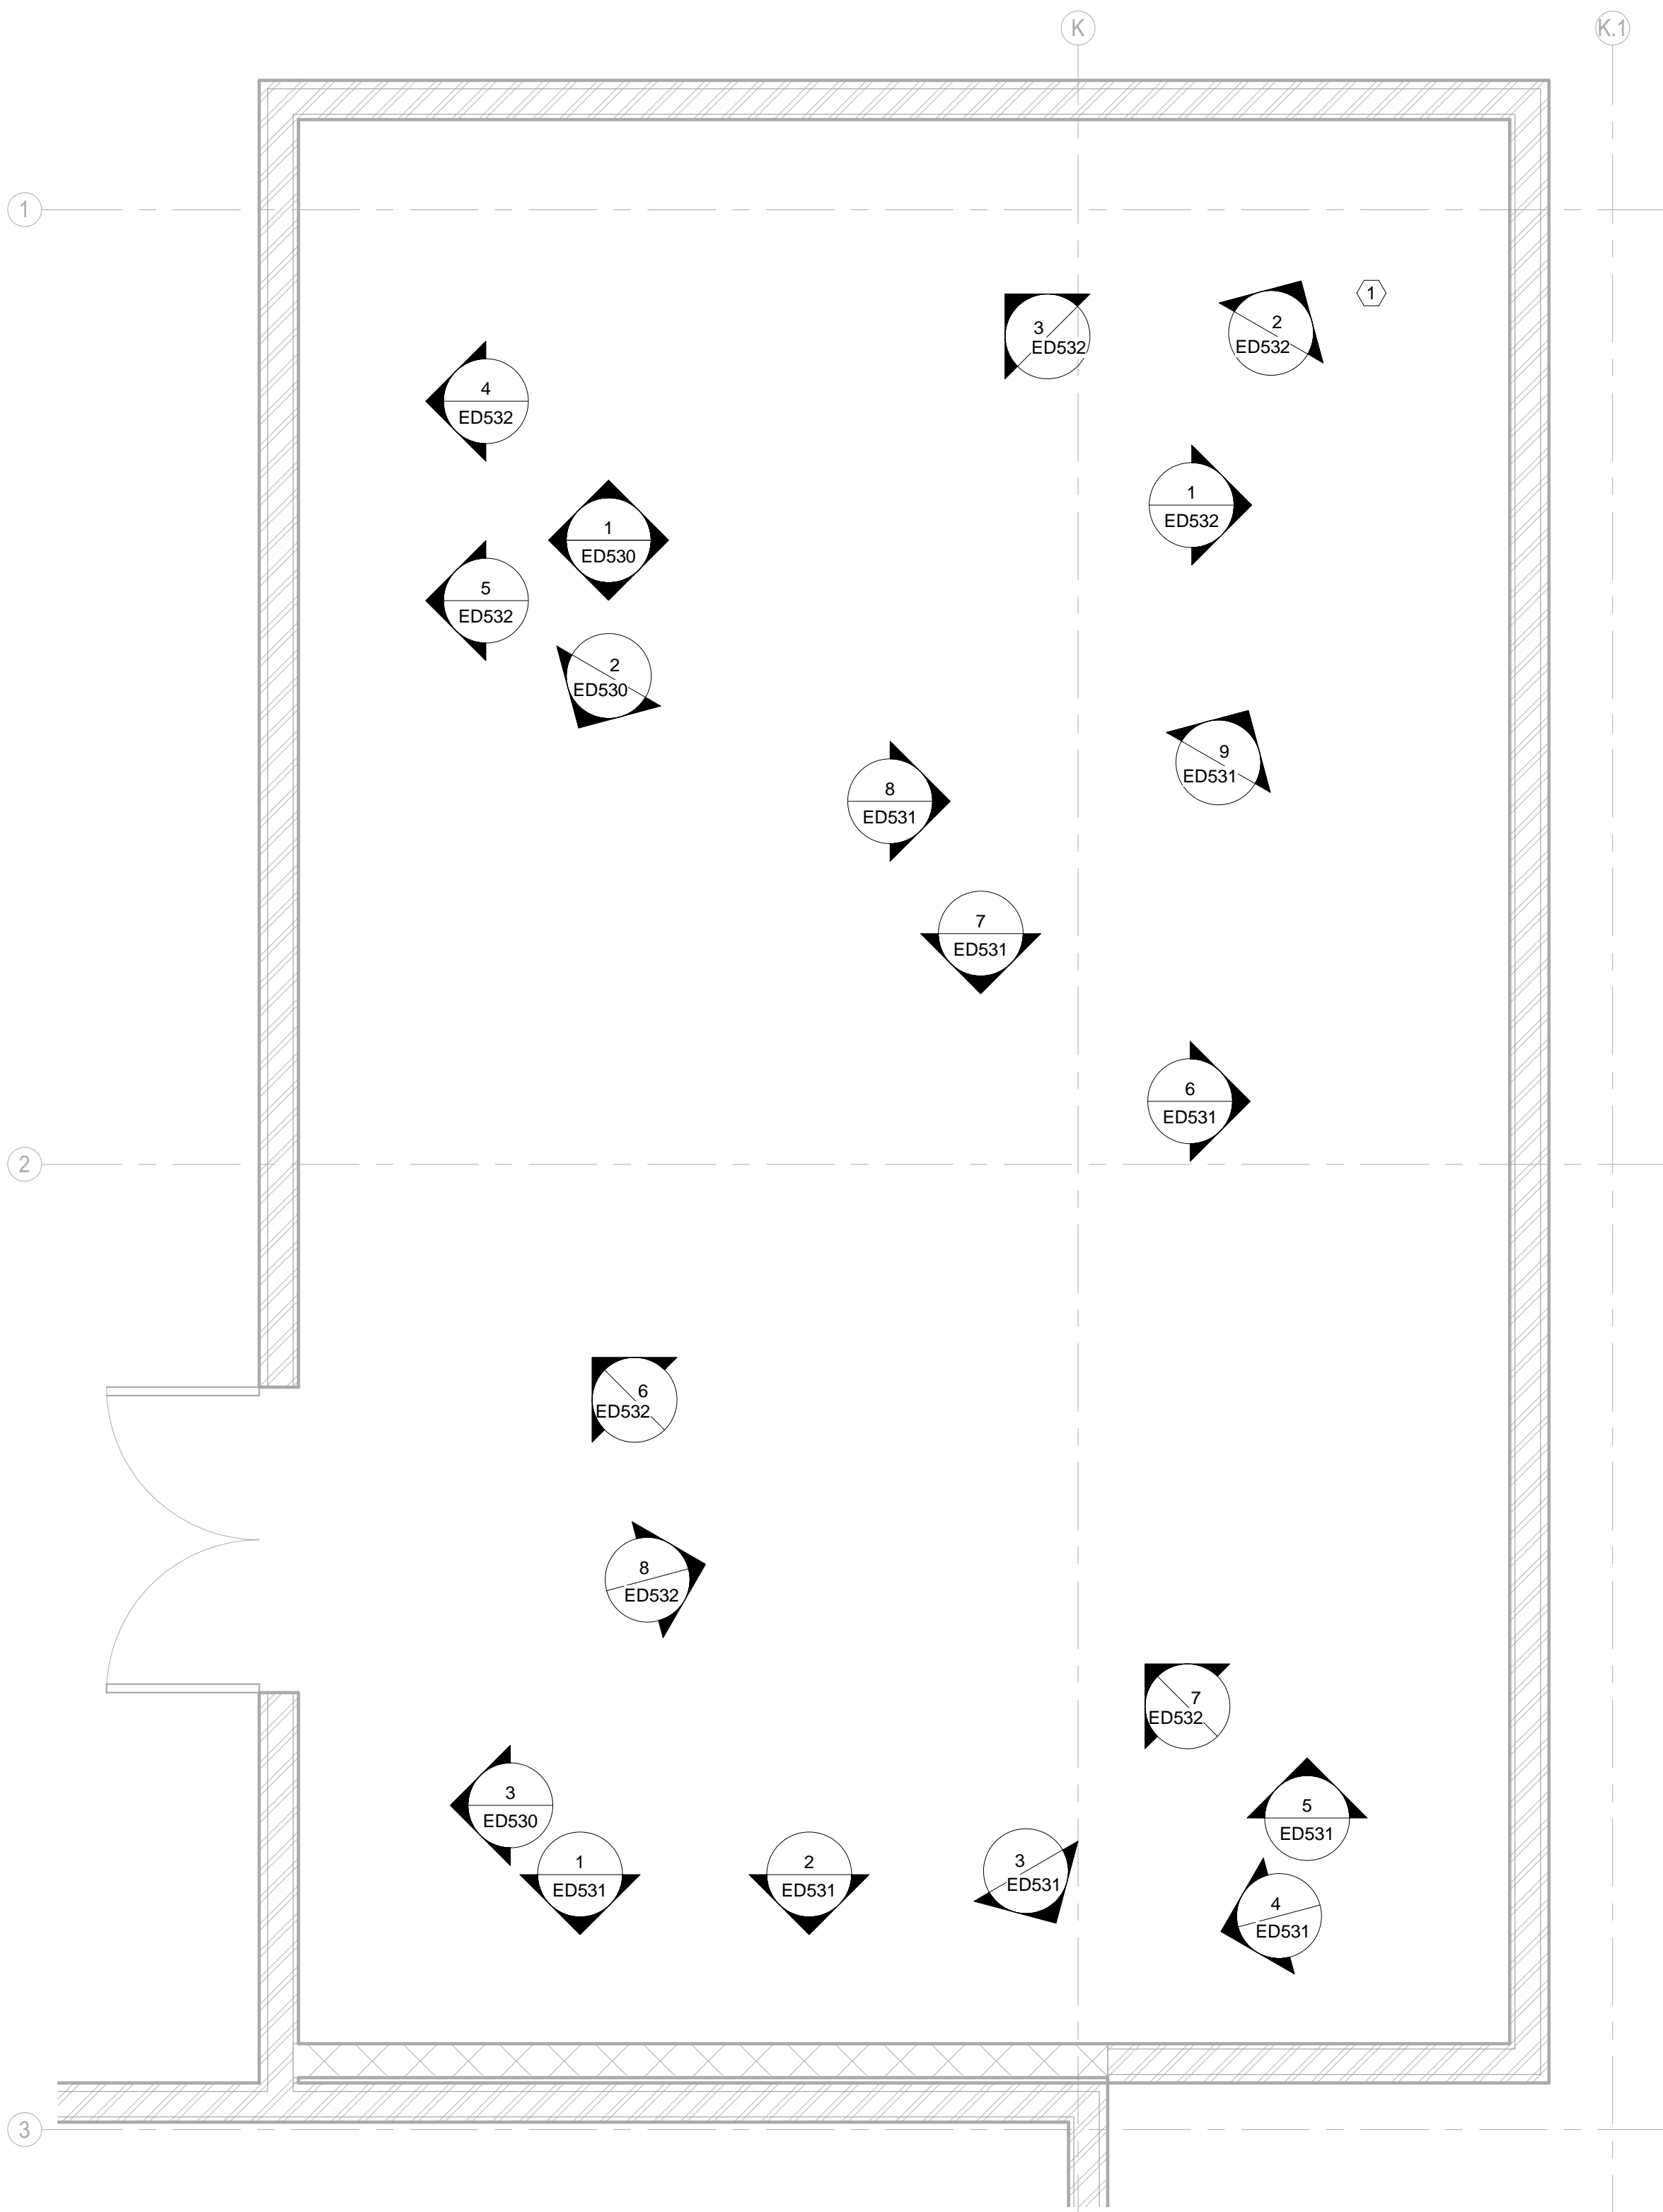
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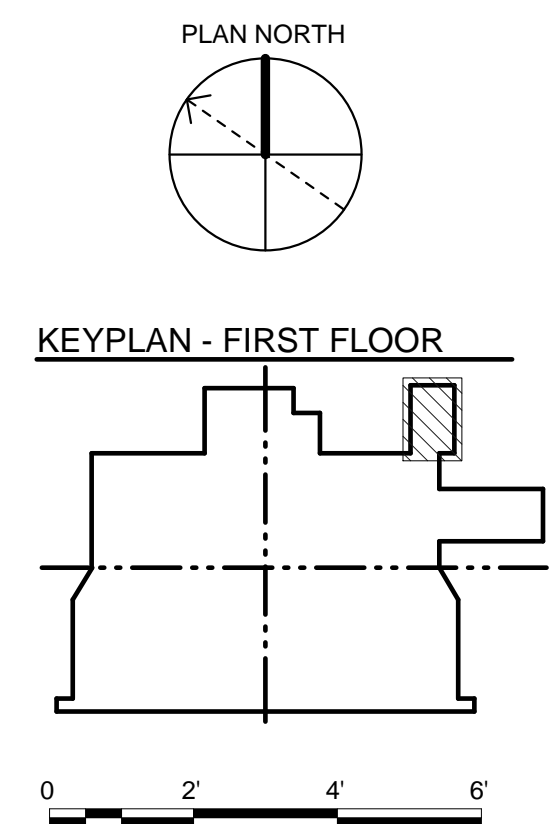


GENERAL ELECTRICAL DEMOLITION NOTES:  
 SEE GENERAL NOTES ON SHEET ED001.  
 COORDINATE WITH 'FD' SERIES SHEETS.  
 CONVENIENCE RECEPTACLES, LIGHT FIXTURES, LIGHT SWITCHES, AND SUPPORTING INFRASTRUCTURE TO BE REMOVED.

# KEYED ELECTRICAL DEMOLITION NOTES:  
 1. JOCKEY PUMP SHALL REMAIN IN PLACE AND SHALL REMAIN CONNECTED TO EXISTING JOCKEY PUMP CONTROLLER (JPCP). COORDINATE WITH FA SHEETS FOR NEW JPCP LOCATION.

**ELECTRICAL EXISTING/DEMOLITION PLAN  
 FIRE SUPPRESSION EQUIPMENT ROOM ENLARGED PLAN**

1  
 ED430  
 3/8" = 1'-0"



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DESIGNED BY: S. LINDREN	ISSUE DATE: 02/19/2020
CHECKED BY: S. LINDREN	SOLICITATION NO.:
SUBMITTED BY: STEVEN L. OTT, P.E.	93786-20R-0026
FILE NAME: ANSI'D	CONTRACT NO.:
	FILE NUMBER:

REPAIR B-52 MAINTENANCE DOCK 5  
 (BUILDING 837)  
 MINOT AFB, NORTH DAKOTA

**ELECTRICAL EXISTING/DEMOLITION PLAN  
 FIRE SUPPRESSION EQUIPMENT ROOM  
 ENLARGED PLAN**

SHEET ID  
**ED430**



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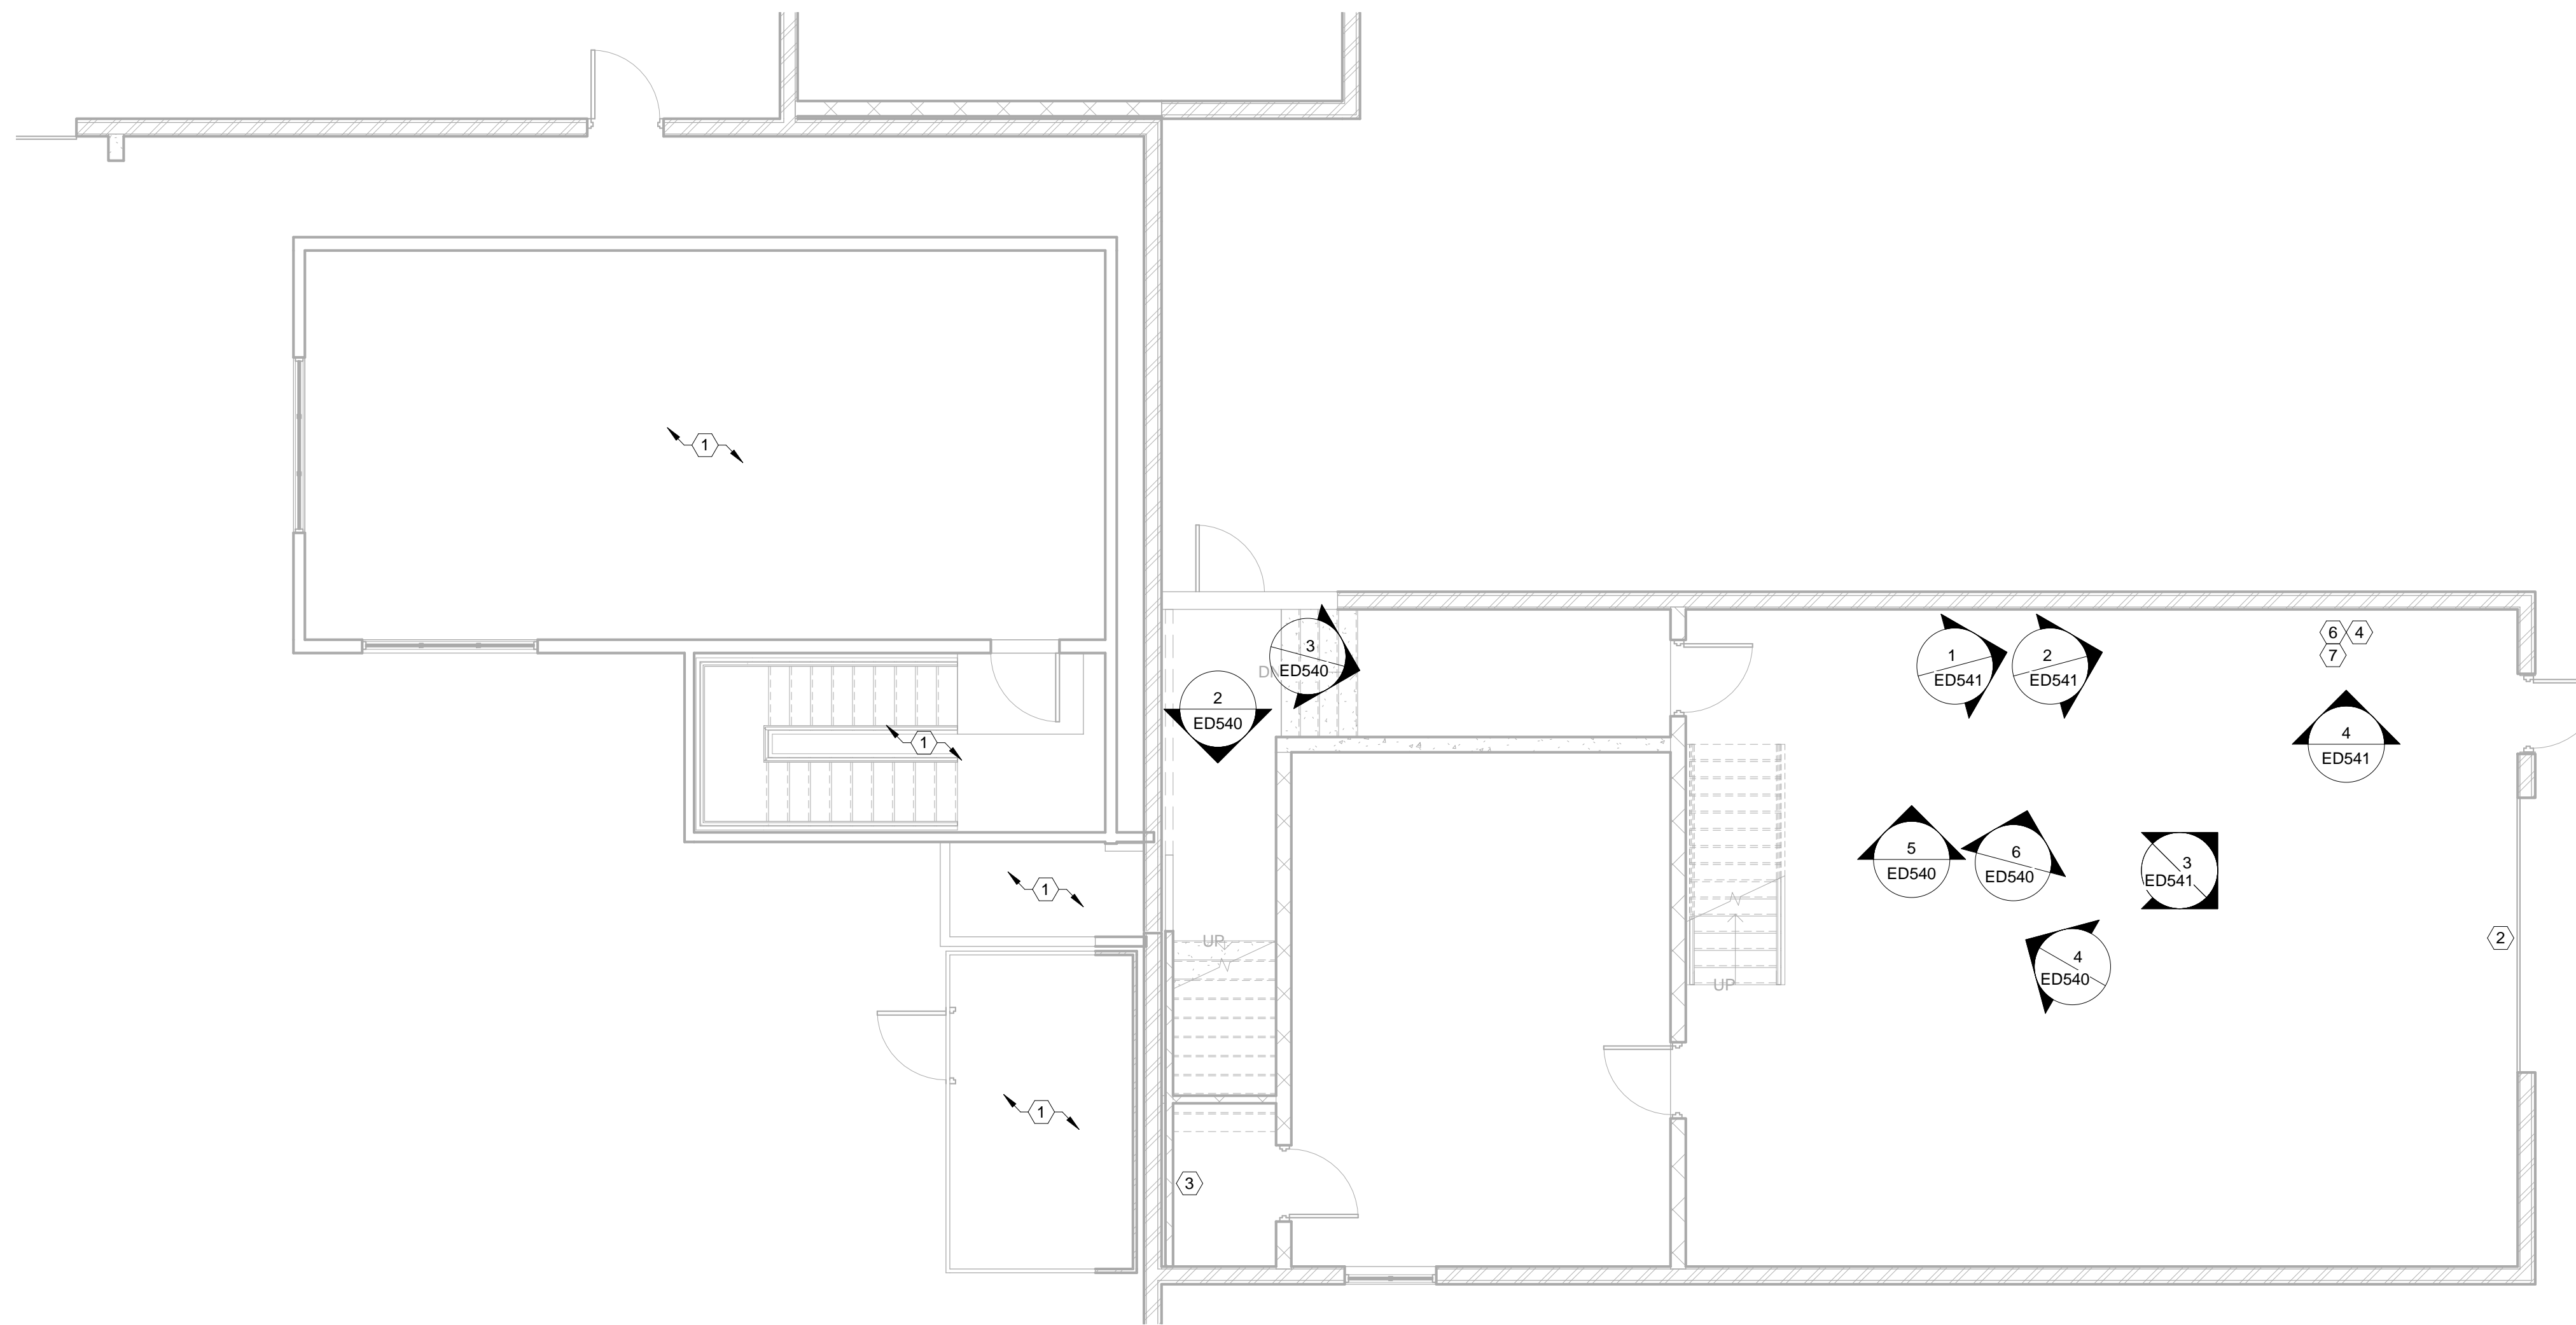
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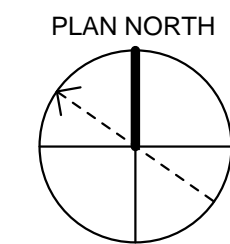
1  
ED440

**ELECTRICAL DEMOLITION GROUND LEVEL PLAN**


3/16" = 1'-0"

**GENERAL ELECTRICAL DEMOLITION NOTES:**  
 SEE GENERAL NOTES ON SHEET ED001.  
 CONVENIENCE RECEPTACLES, LIGHT FIXTURES, LIGHT SWITCHES, AND SUPPORTING INFRASTRUCTURE TO BE REMOVED EXCEPT AS IDENTIFIED ON SHEET ED001 GENERAL NOTES.

- KEYED ELECTRICAL DEMOLITION NOTES:**
- 1. ALL OF SUB-AREA IS TO BE DEMOLISHED.
  - 2. EXISTING PANEL DOOR OPERATOR, MOTOR, COUNTERBALANCE, AND PULLING MECHANISM TO BE REMOVED AND REPLACED PER SECTION 08 33 23.
  - 3. LOCATION OF TELECOMMUNICATIONS WALL-MOUNTED RACK. SEE ED001 GENERAL NOTES AND TN SHEETS FOR INSTRUCTIONS.
  - 4. DEMOLISH POWER ENTRANCE CONDUIT TO FLOOR. CONDUIT SHALL BE CUT TO FLOOR LEVEL AND PLUGGED WITH CONCRETE.



KEYPLAN - FIRST FLOOR

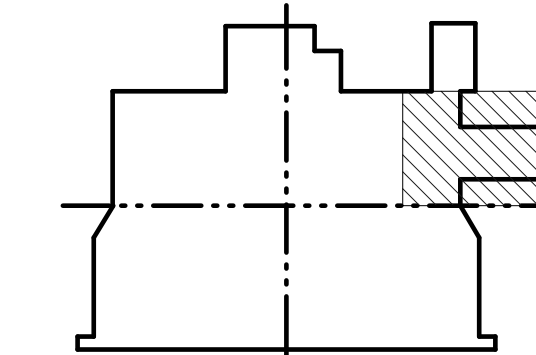

0 4' 8' 12'



DATE	DESCRIPTION	MARK

DESIGNED BY: S. LEINDREN	ISSUE DATE: 02/19/2020
DRAWN BY: S. LEINDREN	SOLICITATION NO.: 91285-20R-0026
CHECKED BY: S. OTT	CONTRACT NO.:
SUBMITTED BY: STEVEN L. OTT, P.E.	FILE NUMBER:
SIZE: ANSI D	FILE NAME:
US ARMY CORPS OF ENGINEERS OMAHA DISTRICT 1616 CAPITOL AVE OMAHA, NE 68102	


REPAIR B-52 MAINTENANCE DOCK 5  
 (BUILDING 837)  
 MINOT AFB, NORTH DAKOTA

ELECTRICAL EXISTING/DEMOLITION PLAN  
 HANGAR OFFICE/POD CENTER GROUND LEVEL  
 ENLARGED PLAN

SHEET ID  
**ED440**

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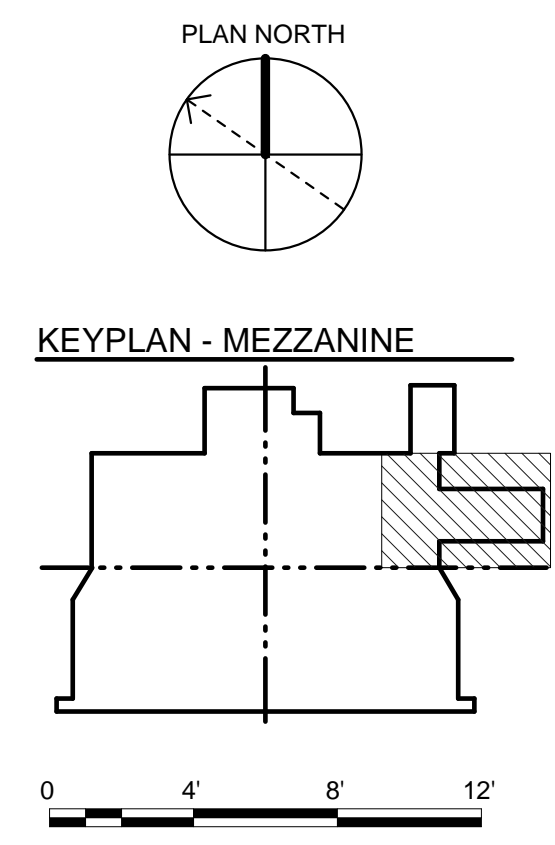
1  
ED450

# ELECTRICAL DEMOLITION MEZZANINE PLAN

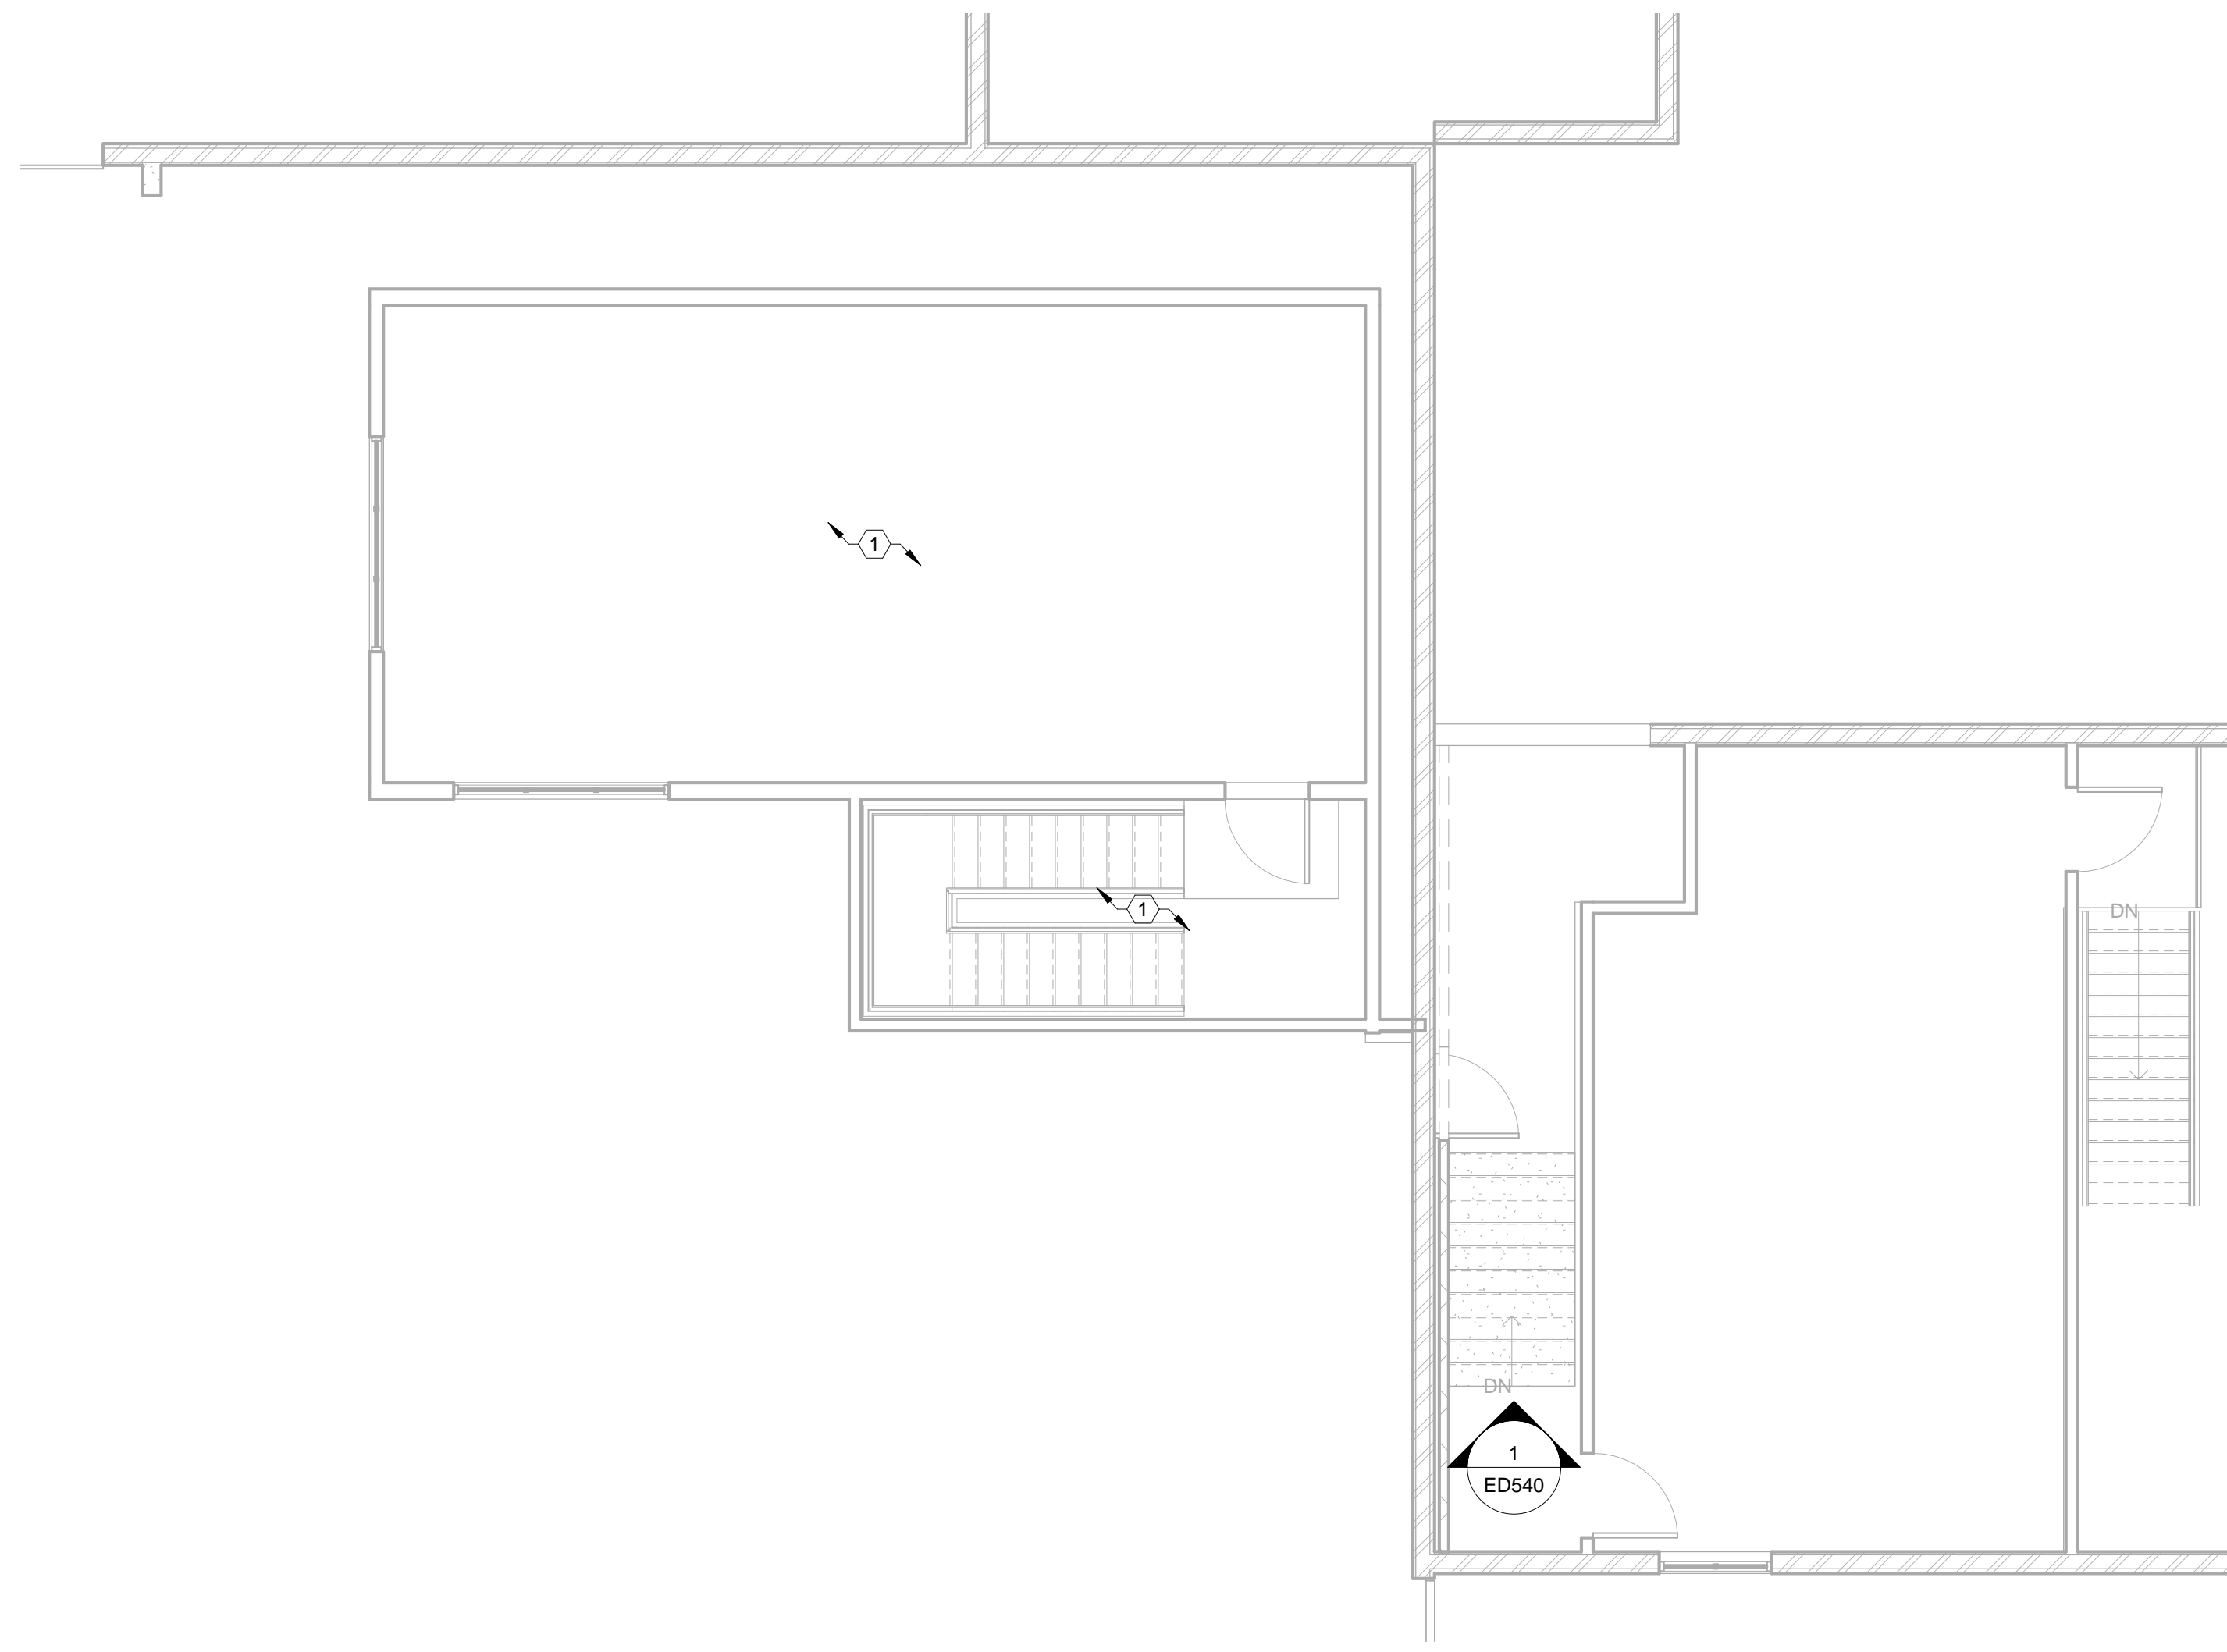3/16" = 1'-0"

**GENERAL ELECTRICAL DEMOLITION NOTES:**  
 SEE GENERAL NOTES ON SHEET ED001.  
 CONVENIENCE RECEPTACLES, LIGHT FIXTURES, LIGHT SWITCHES, AND SUPPORTING INFRASTRUCTURE TO BE REMOVED EXCEPT AS IDENTIFIED ON SHEET ED001 GENERAL NOTES.

**KEYED ELECTRICAL DEMOLITION NOTES:**  
 1. ALL OF SUB-AREA IS TO BE DEMOLISHED.



US Army Corps  
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Omaha District

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DESIGNED BY: S. LEINDREN	ISSUE DATE: 02/19/2020
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SUBMITTED BY: STEVEN L. OTT, P.E.	FILE NUMBER: 
SIZE: ANSI D	FILE NAME: 

US ARMY CORPS OF ENGINEERS  
 OMAHA DISTRICT  
 1616 CAPITOL AVE  
 OMAHA, NE 68102

REPAIR B-52 MAINTENANCE DOCK 5  
 (BUILDING 837)  
 MINOT AFB, NORTH DAKOTA

ELECTRICAL EXISTING/DEMOLITION PLAN  
 HANGAR OFFICE/POD CENTER MEZZANINE  
 ENLARGED PLAN

SHEET ID  
**ED450**

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RETAIN SIGN AND REINSTALL ADJACENT TO NEW CONTROL

REMOVE TAIL DOOR CONTROL AND REPLACE AS DESCRIBED IN SECTION 08 33 23.

REMOVE SIGN AND REPLACE WITH NEW SIGN FOR OPERATING PROCEDURES OF NEW TAIL DOOR CONTROL (SECTION 08 33 23).



**1 HANGAR BAY: TAIL DOOR CTRLS**  
ED500 N.T.S.

REMOVE FIRE ALARM AND FOAM INDICATORS (TYP).

REMOVE FIRE ALARM AND FOAM STATIONS AND REPLACE AS IDENTIFIED ON FA SHEETS.

RETAIN SIGN




**2 HANGAR BAY: PLAN SOUTHWEST**  
ED500 N.T.S.

NOTE: HIGH BAY LIGHTING FIXTURES HAVE BEEN REPLACED SINCE PHOTOS WERE TAKEN. SEE EL SHEETS FOR UPDATED INFORMATION AND RELOCATIONS/ADDITIONS.



**3 HANGAR BAY: PLAN SOUTHWEST**  
ED500 N.T.S.

COORDINATE WITH MECHANICAL SHEETS FOR REMOVAL. REMOVE ASSOCIATED ELECTRICAL SUPPORT. (TYP)

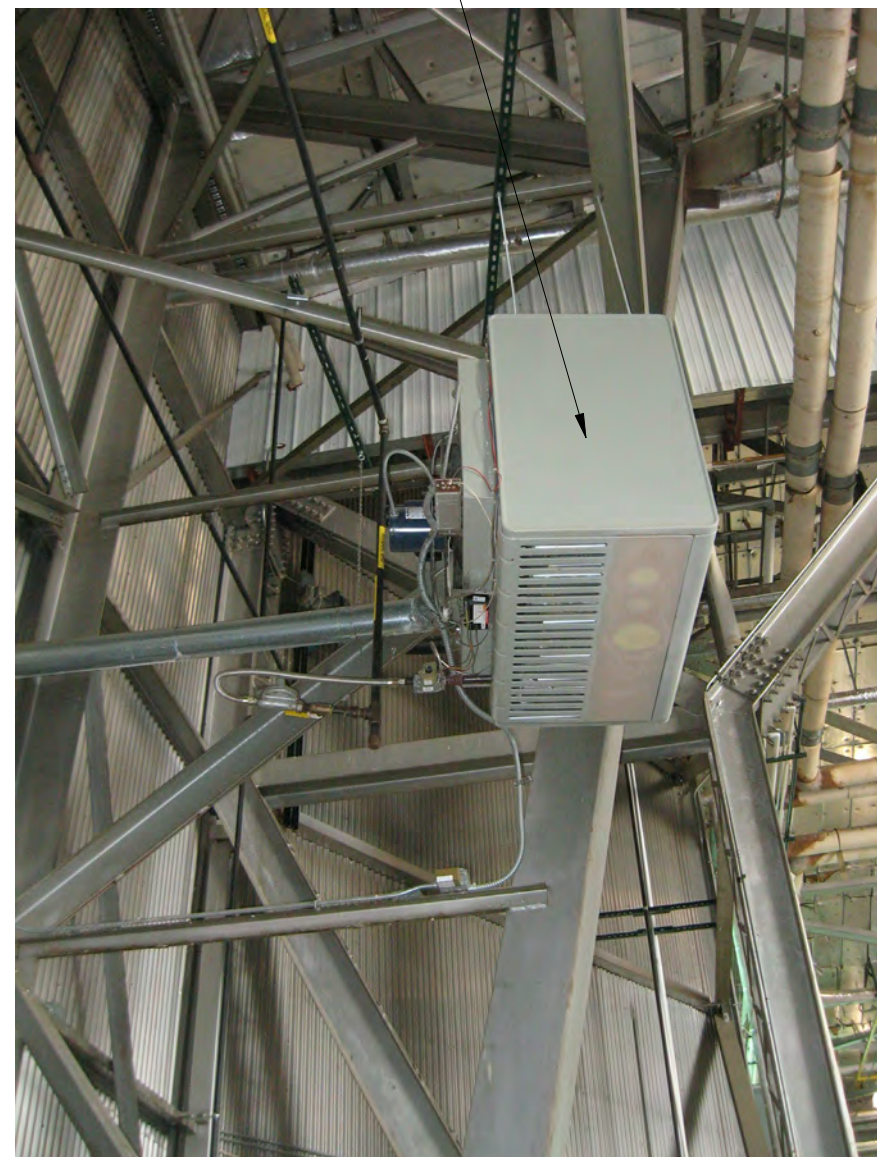


**4 HANGAR BAY: PLAN WEST**  
ED500 N.T.S.



**5 HANGAR BAY: PLAN SOUTHWEST**  
ED500 N.T.S.

WASH STAND TO REMAIN. RECONNECT CONTROL SYSTEM TO EXISTING WASH UNITS (XWU) AS NECESSARY TO MAINTAIN FUNCTIONALITY AFTER RENOVATION.

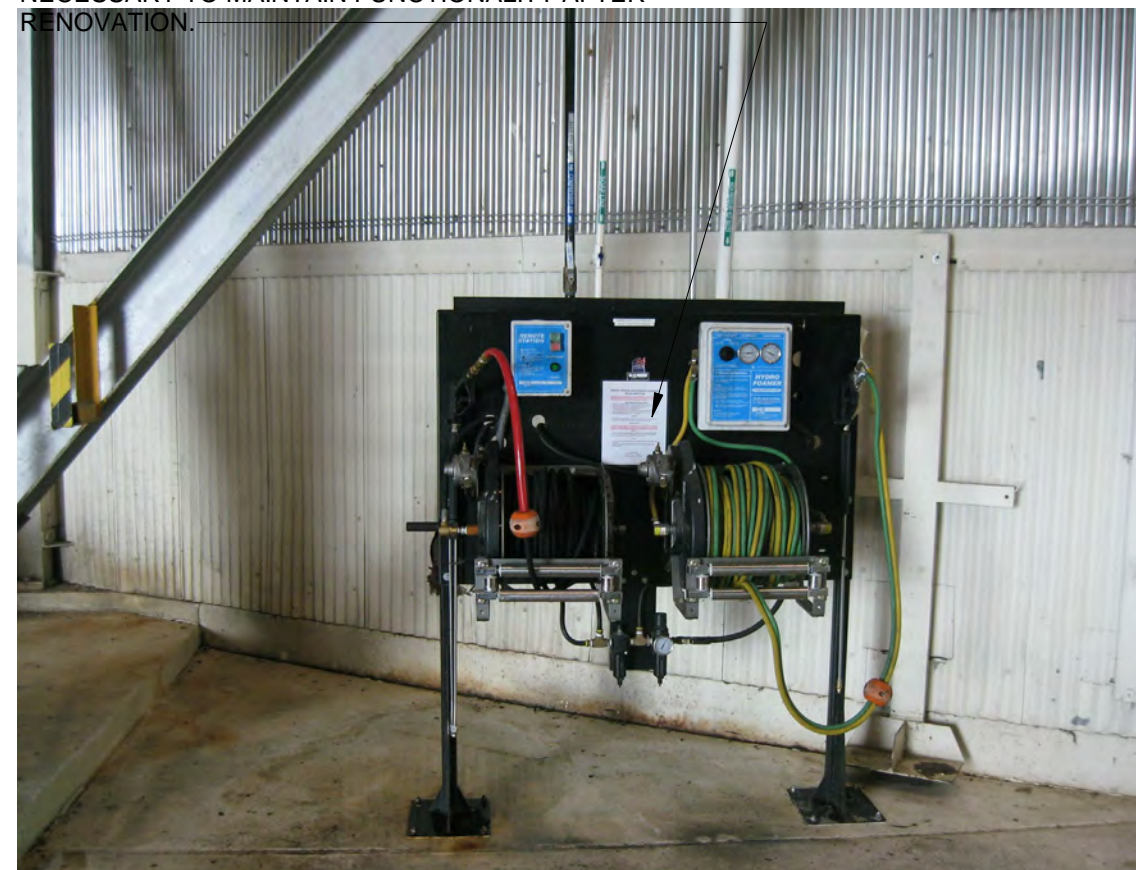


**6 HANGAR BAY: WEST WASH STAND**  
ED500 N.T.S.

SPEAKER RECEPTACLE. REMOVE AND REPLACE AS INDICATED ON EP SHEETS.

REMOVE FIRE ALARM AND FOAM INDICATORS (TYP).

REMOVE RECEPTACLES (TYP)

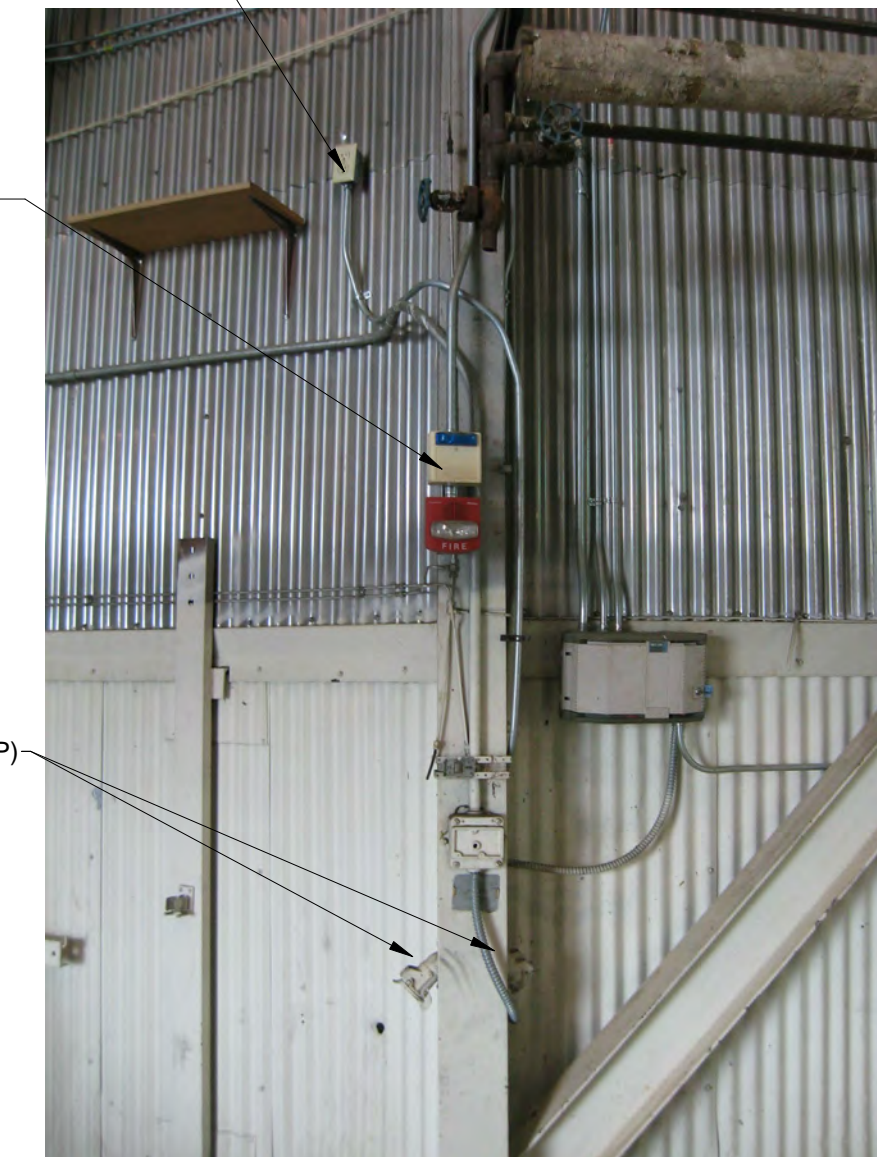

**7 HANGAR BAY: PLAN WEST**  
ED500 N.T.S.



US Army Corps of Engineers  
of Engineers @ Omaha District

MARK	DESCRIPTION	DATE

DESIGNED BY: SLINDREN	ISSUE DATE: 02/19/2020
DRAWN BY: SLINDREN	SOLICITATION NO.:
CHECKED BY: S.OTT	91728-20R-0026
SUBMITTED BY: STEVEN L. OTT, P.E.	CONTRACT NO.:
SIZE: FILE NAME:	FILE NUMBER:
ANSI 'D'	

US ARMY CORPS OF ENGINEERS  
OMAHA DISTRICT  
1616 CAPITOL AVE  
OMAHA, NE 68102

REPAIR B-52 MAINTENANCE DOCK 5  
(BUILDING 837)  
MINOT AFB, NORTH DAKOTA

ELECTRICAL EXISTING CONDITIONS PHOTOS  
HANGAR BAY

SHEET ID  
**ED500**

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REMOVE HVAC SHUTDOWN CONTROL AND LABEL (TYP)

REMOVE FIRE ALARM AND FOAM STATIONS AND REPLACE AS IDENTIFIED ON FA SHEETS.



OIL/WATER SEPARATOR, SEE ARCHITECTURAL SHEETS FOR DEMOLITION.



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1 HANGAR BAY: PLAN WEST  
ED501 N.T.S.

2 HANGAR BAY: PLAN WEST  
ED501 N.T.S.

3 HANGAR BAY: PLAN WEST  
ED501 N.T.S.

4 HANGAR BAY: PLAN NORTHWEST  
ED501 N.T.S.

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REMOVE RECEPTACLES (TYP)



COORDINATE WITH MECHANICAL SHEETS FOR REMOVAL. REMOVE ASSOCIATED ELECTRICAL SUPPORT. (TYP)



REMOVE EXIT SIGN (TYP)

REMOVE FIRE ALARM AND FOAM STATIONS AND REPLACE AS IDENTIFIED ON FA SHEETS (TYP).



5 HANGAR BAY: PLAN NORTHWEST  
ED501 N.T.S.

6 HANGAR BAY: PLAN NORTHWEST  
ED501 N.T.S.

7 HANGAR BAY: PLAN NORTHWEST  
ED501 N.T.S.

8 HANGAR BAY: PLAN NORTHWEST  
ED501 N.T.S.



US Army Corps  
of Engineers ®  
Omaha District

DATE	DESCRIPTION	MARK

DESIGNED BY: S. LINDREN T. LINDREN S. LINDREN	ISSUE DATE: 02/19/2020
CHECKED BY: S. OTT	SOLICITATION NO.: 91246-20R-0026
SUBMITTED BY: STEVEN L. OTT, P.E.	CONTRACT NO.:
ANSI D FILE NAME:	FILE NUMBER:
US ARMY CORPS OF ENGINEERS OMAHA DISTRICT 1616 CAPITOL AVE OMAHA, NE 68102	

REPAIR B-52 MAINTENANCE DOCK 5  
(BUILDING 837)  
MINOT AFB, NORTH DAKOTA  
ELECTRICAL EXISTING CONDITIONS PHOTOS  
HANGAR BAY

SHEET ID  
ED501


D

C

B

A

BRIDGE CRANE "XBC-W" TO REMAIN, SEE EP602 FOR SUPPORTING INFRASTRUCTURE REPLACEMENT.

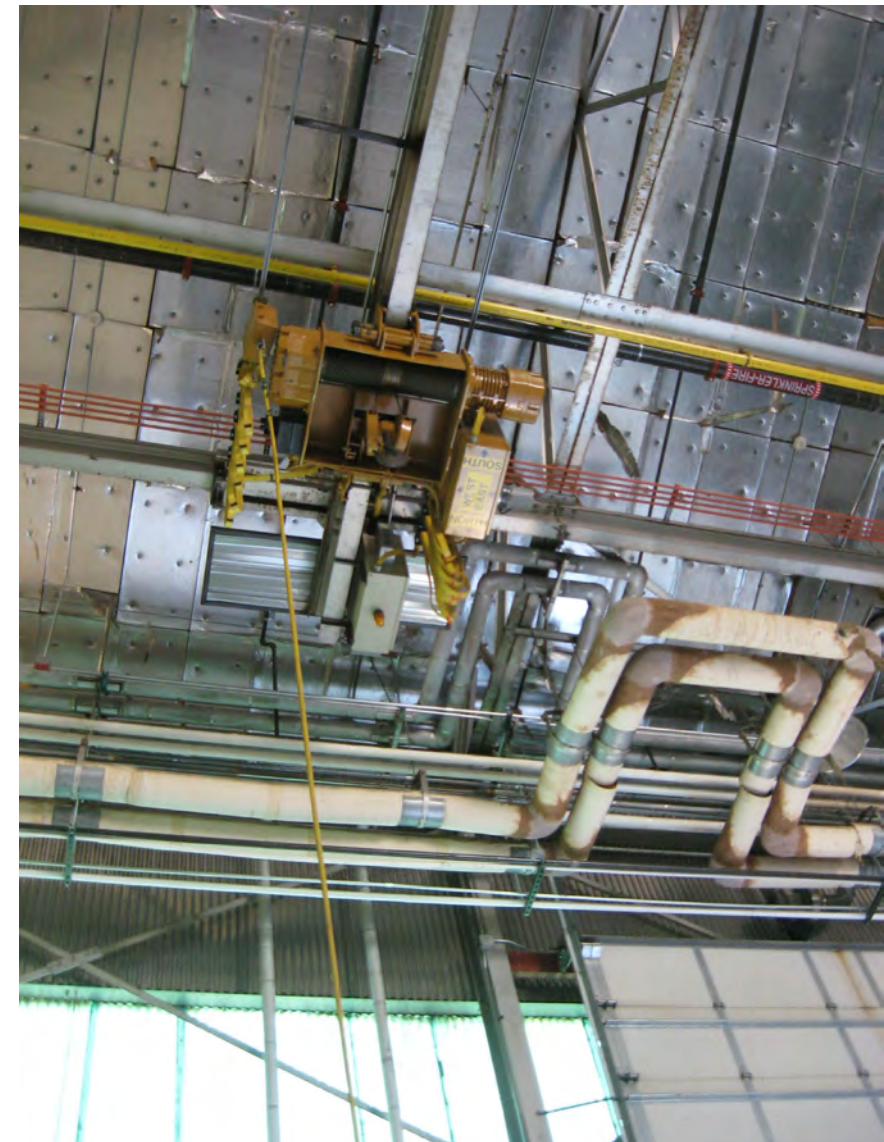

**1 HANGAR BAY: WEST CRANE**  
ED502 N.T.S.

XBC-W OPERATOR CONTROLS. SEE PHOTO 1/ED502.



**2 HANGAR BAY: WEST CRANE**  
ED502 N.T.S.



REMOVE RECEPTACLES (TYP)  
REMOVE PAINT BOOTH CONTROLS

**3 HANGAR BAY: PLAN NORTHWEST**  
ED502 N.T.S.

REMOVE PAINT BOOTH SUPPORTING INFRASTRUCTURE. SEE PHOTO 2/ED502 AND ED001 GENERAL NOTES



**4 HANGAR BAY: PLAN NORTHWEST**  
ED502 N.T.S.

XBC-W DISCONNECT. SEE PHOTO 1/ED502.



OVERHEAD PANEL DOOR CONTROL. REMOVE AND REPLACE PER SECTION 08 33 23. (TYP) ALSO REMOVE AND REPLACE OPERATOR (TYP). SEE PHOTO 1/ED504.  
REMOVE RECEPTACLE (TYP)

**5 HANGAR BAY: WEST CRANE**  
ED502 N.T.S.

REMOVE HIGH BAY LIGHTING CONTROLS, INDICATOR, AND INSTRUCTIONS



**6 HANGAR BAY: PLAN NORTHWEST**  
ED502 N.T.S.

WASH STAND TO REMAIN. SEE PHOTO 6/ED500.



**7 HANGAR BAY: NORTHWEST WASH STAND**  
ED502 N.T.S.

COORDINATE REMOVAL AND REPLACEMENT OF EMERGENCY SHOWER AND SUPPORTING INFRASTRUCTURE WITH PLUMBING SHEETS.



**8 HANGAR BAY: NOSE SOUTHWEST**  
ED502 N.T.S.



MARK	DESCRIPTION	DATE

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SIZE: ANSI D	FILE NAME:

US ARMY CORPS OF ENGINEERS  
OMAHA DISTRICT  
1616 CAPITOL AVE  
OMAHA, NE 68102

REPAIR B-52 MAINTENANCE DOCK 5  
(BUILDING 837)  
MINOT AFB, NORTH DAKOTA

ELECTRICAL EXISTING CONDITIONS PHOTOS  
HANGAR BAY

SHEET ID  
**ED502**

1

2

3

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REMOVE CONTROL

1 HANGAR BAY: NOSE SOUTHWEST  
ED503 N.T.S.



REMOVE RECEPTACLE (TYP)

2 HANGAR BAY: NOSE SOUTHWEST  
ED503 N.T.S.



REMOVE RECEPTACLE AND CABLE REEL AND REPLACE PER EP SHEETS (TYP)

3 HANGAR BAY: NOSE WEST  
ED503 N.T.S.



REMOVE FIRE ALARM AND FOAM INDICATORS (TYP)

REMOVE FOAM STATION AND REPLACE AS IDENTIFIED ON FA SHEETS.

4 HANGAR BAY: NOSE WEST  
ED503 N.T.S.




REMOVE FIRE ALARM STATION AND REPLACE AS IDENTIFIED ON FA SHEETS.

5 HANGAR BAY: NOSE NORTHWEST  
ED503 N.T.S.



COORDINATE WITH MECHANICAL SHEETS FOR REMOVAL. REMOVE ASSOCIATED ELECTRICAL SUPPORT. (TYP)

6 HANGAR BAY: NOSE NORTHWEST  
ED503 N.T.S.

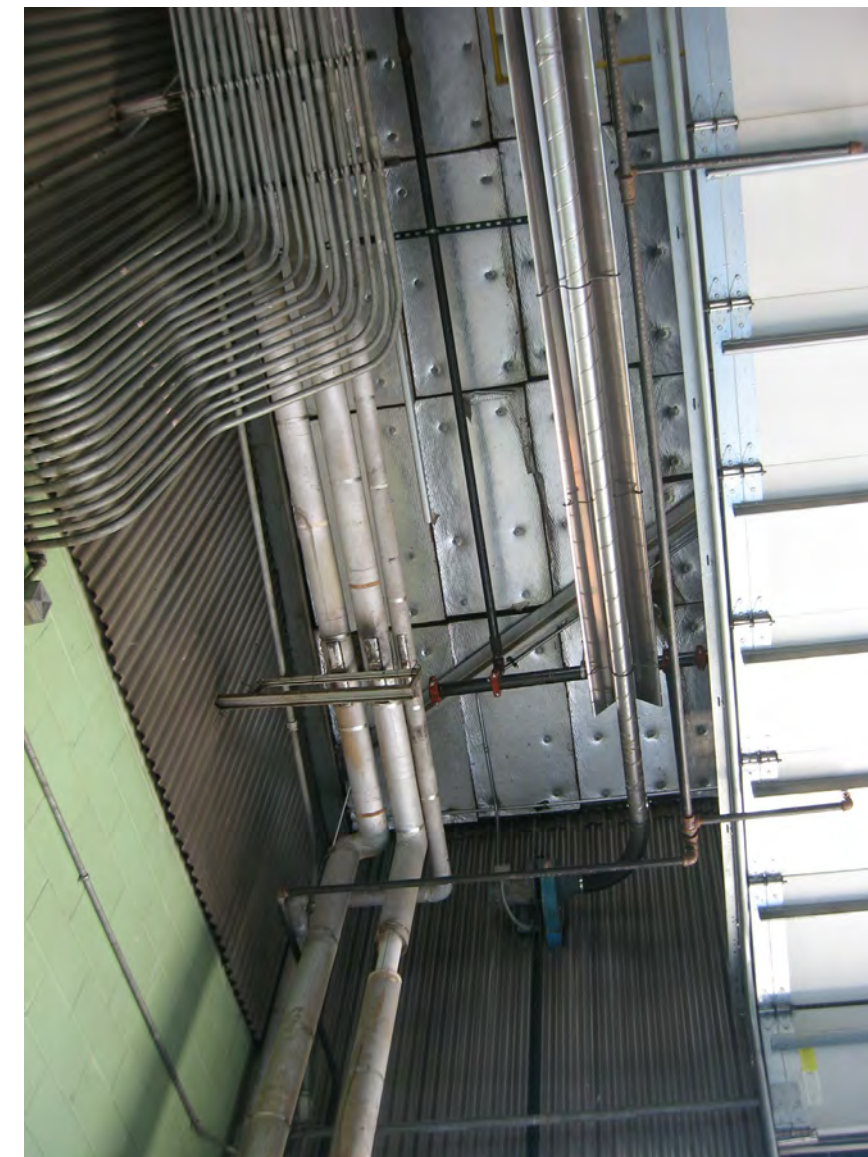

7 HANGAR BAY: NOSE NORTHWEST  
ED503 N.T.S.

RADIANT HEATER VACUUM PUMP. COORDINATE WITH MECHANICAL SHEETS FOR REMOVAL. REMOVE ASSOCIATED ELECTRICAL SUPPORT. (TYP)



8 HANGAR BAY: NOSE NORTHWEST  
ED503 N.T.S.



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SUBMITTED BY: STEVEN L. OTT, P.E.	FILE NUMBER:
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US ARMY CORPS OF ENGINEERS  
OMAHA DISTRICT  
1616 CAPITOL AVE  
OMAHA, NE 68102

REPAIR B-52 MAINTENANCE DOCK 5  
(BUILDING 837)  
MINOT AFB, NORTH DAKOTA

ELECTRICAL EXISTING CONDITIONS PHOTOS  
HANGAR BAY

SHEET ID  
**ED503**

D

OVERHEAD PANEL DOOR OPERATOR. REMOVE AND REPLACE AS DESCRIBED IN SECTION 08 33 23. (TYP)



1 HANGAR BAY: NOSE NORTHEAST  
ED504 N.T.S.

2

OVERHEAD PANEL DOOR CONTROL. REMOVE AND REPLACE AS DESCRIBED IN SECTION 08 33 23. (TYP)



2 HANGAR BAY:  
NOSE NORTHEAST  
ED504 N.T.S.

3


REMOVE RECEPTACLE (TYP)



3 HANGAR BAY: NOSE EAST  
ED504 N.T.S.

4

REMOVE RECEPTACLE AND CABLE REEL AND REPLACE PER EP SHEETS (TYP)

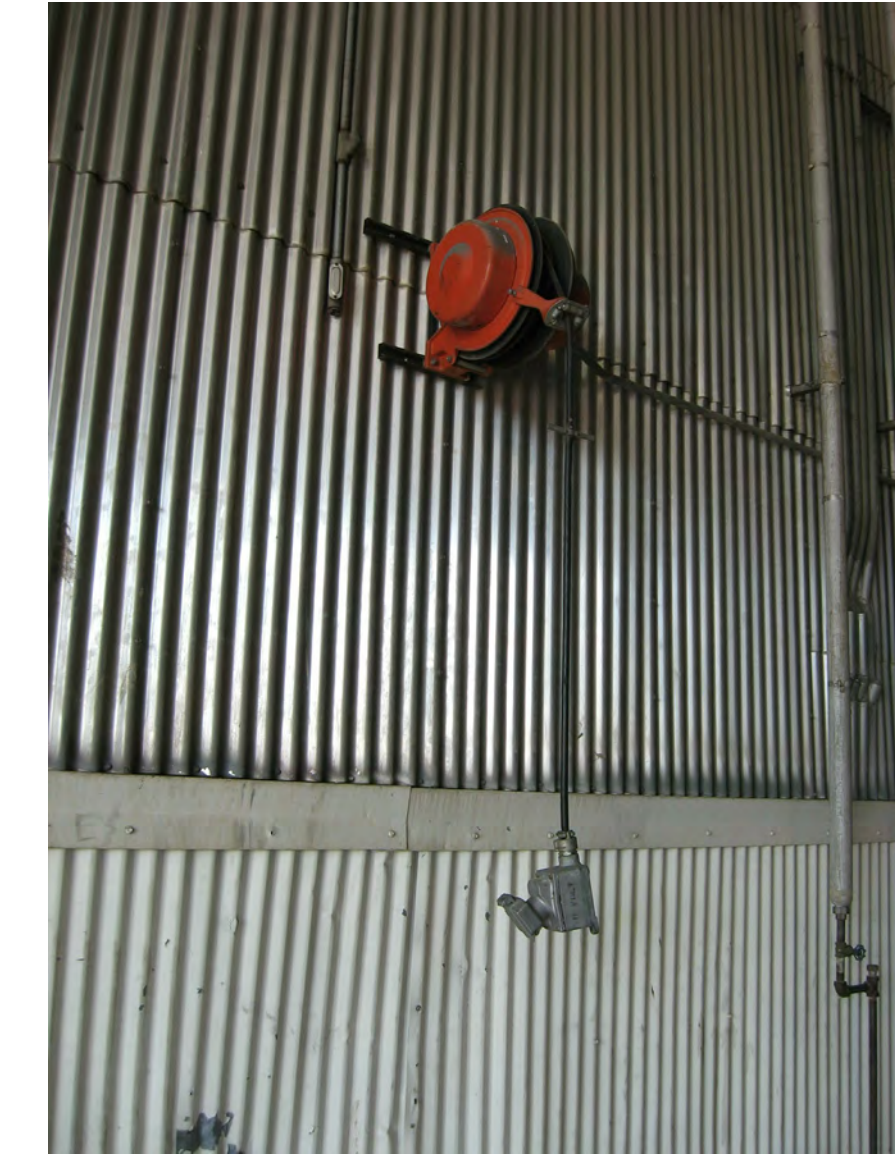

4 HANGAR BAY: NOSE EAST  
ED504 N.T.S.

C

COORDINATE REMOVAL AND REPLACEMENT OF EMERGENCY SHOWER AND SUPPORTING INFRASTRUCTURE WITH PLUMBING SHEETS.



5 HANGAR BAY:  
NOSE SOUTHEAST  
ED504 N.T.S.

B

WASH STAND TO REMAIN. SEE PHOTO



6 HANGAR BAY:  
NORTHWEST WASH STAND  
ED504 N.T.S.

A

REMOVE RECEPTACLE (TYP)




7 HANGAR BAY:  
PLAN NORTHEAST  
ED504 N.T.S.

OVERHEAD PANEL DOOR CONTROL. REMOVE AND REPLACE PER SECTION 08 33 23. (TYP) ALSO REMOVE AND REPLACE OPERATOR (TYP). SEE PHOTO 1/ED504.

XBC-E DISCONNECT. SEE PHOTO 1/ED502.



8 HANGAR BAY: EAST CRANE  
ED504 N.T.S.

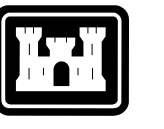

US Army Corps of Engineers  
of Engineers  
of Omaha District

MARK	DESCRIPTION	DATE

DESIGNED BY: S. JORDEN	ISSUE DATE: 02/19/2020
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CHECKED BY: S. OTT	91266-21R-0026
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FILE NUMBER:	FILE NAME:
ANSI D	

US ARMY CORPS OF ENGINEERS  
OMAHA DISTRICT  
1616 CAPITOL AVE  
OMAHA, NE 68102

REPAIR B-52 MAINTENANCE DOCK 5  
(BUILDING 837)  
MINOT AFB, NORTH DAKOTA

ELECTRICAL EXISTING CONDITIONS PHOTOS  
HANGAR BAY

SHEET ID  
**ED504**

D



REMOVE RECEPTACLES (TYP)  
XBC-E CONTROL. SEE PHOTO 1/ED502.

1 HANGAR BAY: PLAN NORTHEAST  
ED505 N.T.S.



RETAIN TAMPER SWITCH AND CONNECT TO NEW FIRE ALARM SYSTEM (TYP). COORDINATE WITH FA SHEETS.  
FIRE SUPPRESSION TEST HEADER

2 HANGAR BAY: PLAN NORTHEAST  
ED505 N.T.S.

REMOVE EXIT SIGN.  
REMOVE FIRE ALARM AND FOAM STATIONS AND REPLACE AS IDENTIFIED ON FA SHEETS.




3 HANGAR BAY: PLAN NORTHEAST  
ED505 N.T.S.

B



RETAIN ELEVATED TAMPER SWITCH AND CONNECT TO NEW FIRE ALARM SYSTEM (TYP). COORDINATE WITH FA SHEETS.

4 HANGAR BAY: PLAN NORTHEAST  
ED505 N.T.S.

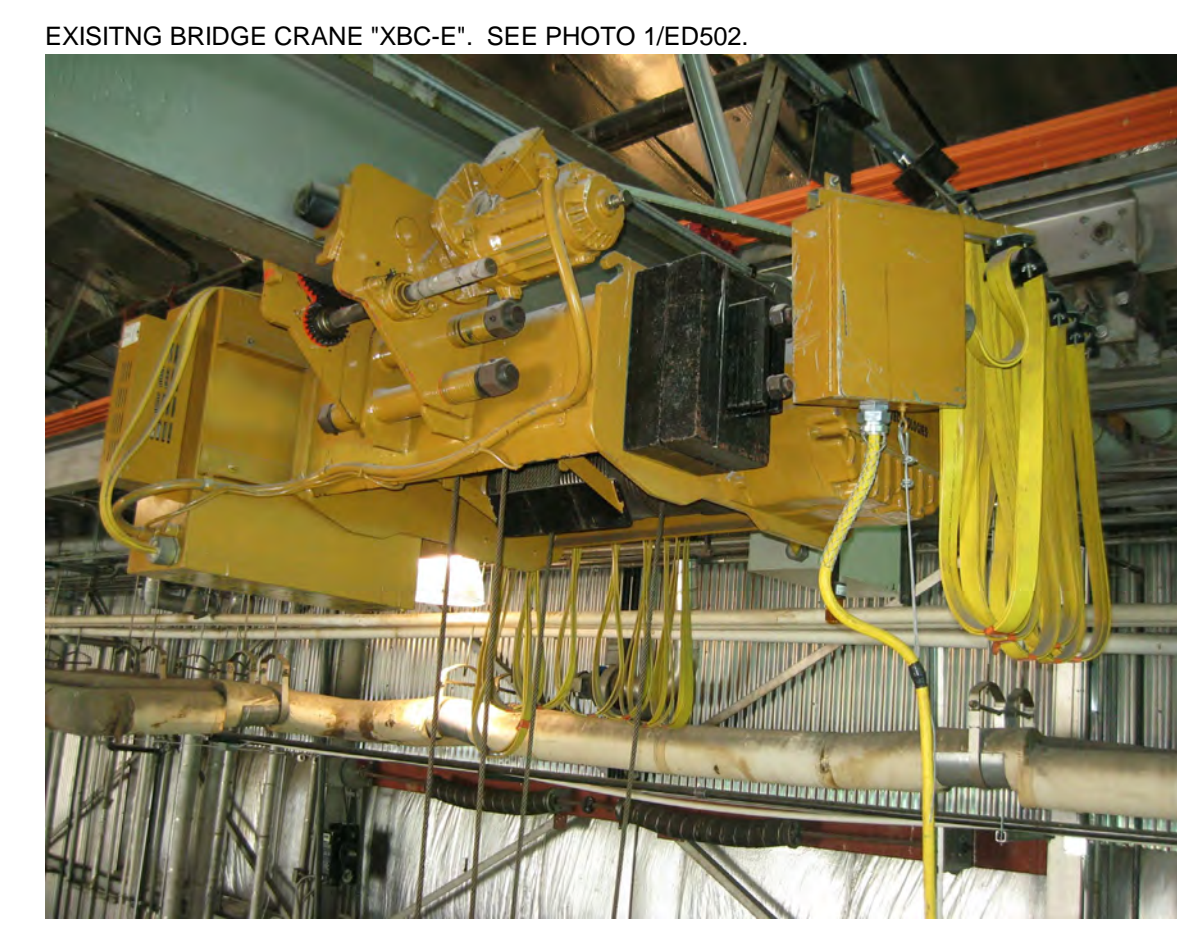


EXISTING BRIDGE CRANE "XBC-E". SEE PHOTO 1/ED502.

5 HANGAR BAY: EAST CRANE  
ED505 N.T.S.



MECHANICAL MEZZANINE. COORDINATE WITH MECHANICAL DEMOLITION SHEETS. REMOVE DATA CABLING.

6 HANGAR BAY: MECH MEZZ  
ED505 N.T.S.

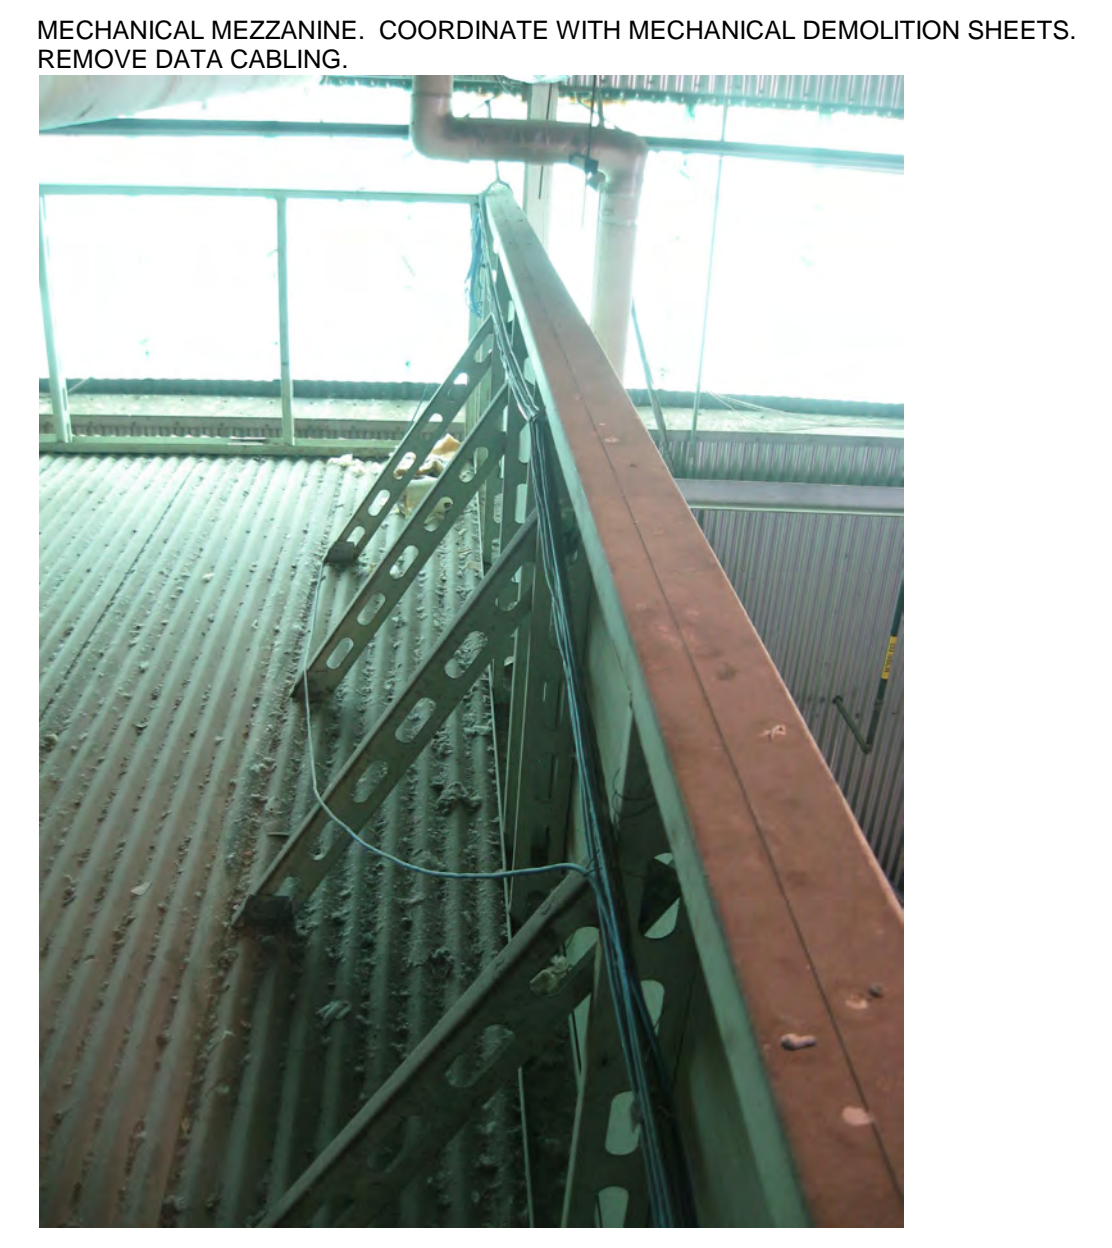

MECHANICAL MEZZANINE. COORDINATE WITH MECHANICAL DEMOLITION SHEETS. REMOVE DATA CABLING.

7 HANGAR BAY: MECH MEZZ  
ED505 N.T.S.

A


DATE	DESCRIPTION	MARK

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SIZE: ANSI D	FILE NAME:

US ARMY CORPS OF ENGINEERS  
OMAHA DISTRICT  
1616 CAPITOL AVE  
OMAHA, NE 68102  
  
REPAIR B-52 MAINTENANCE DOCK 5  
(BUILDING 837)  
MINOT AFB, NORTH DAKOTA  
  
ELECTRICAL EXISTING CONDITIONS PHOTOS  
HANGAR BAY



1  
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REMOVE FIRE ALARM AND FOAM INDICATORS (TYP).

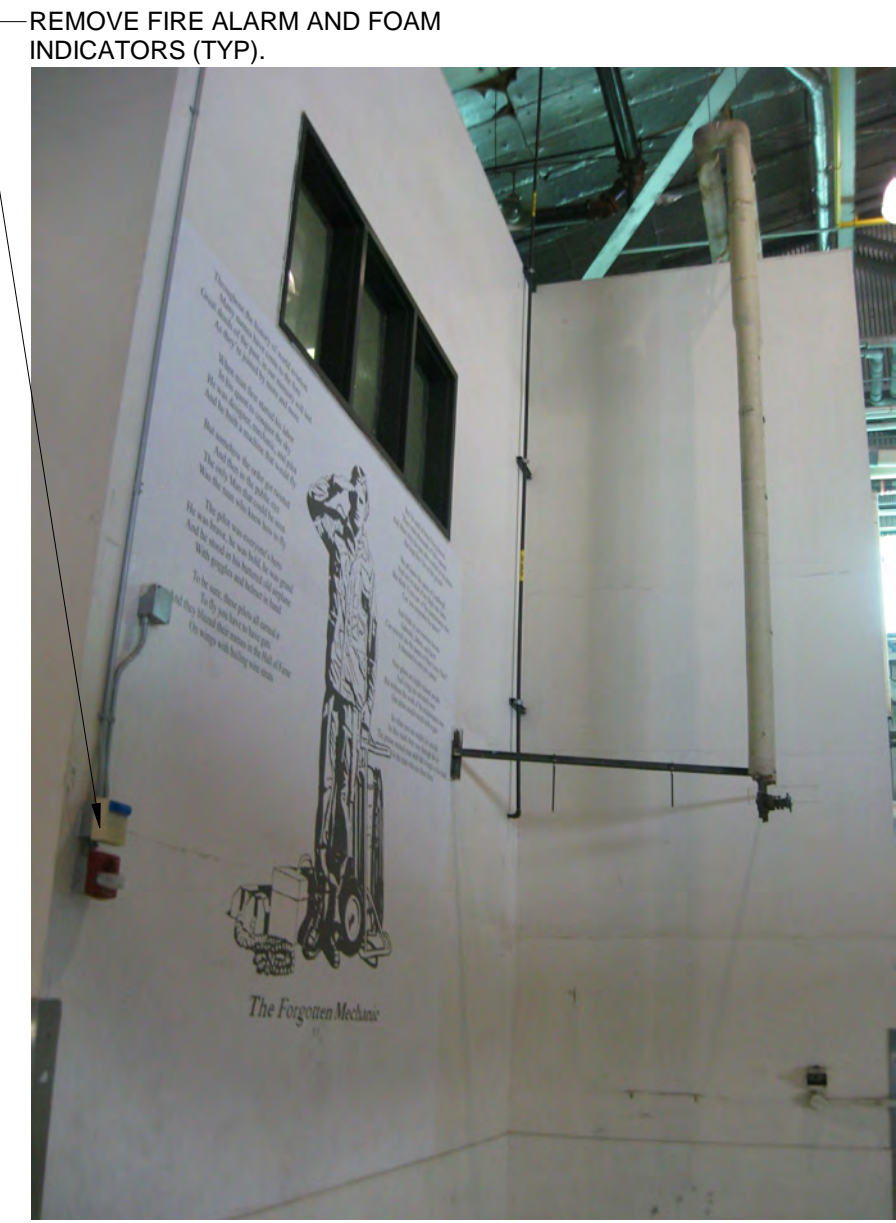1 HANGAR BAY: PLAN NORTHEAST  
ED506 N.T.S.



REMOVE DATA CABLING AND SUPPORTS.

2 ED506 N.T.S.

HANGAR BAY: PLAN NORTHEAST STORAGE CAGE



REMOVE EXHAUST FAN DISCONNECT

3 HANGAR BAY: PLAN EAST  
ED506 N.T.S.



4 HANGAR BAY: PLAN EAST  
ED506 N.T.S.



REMOVE FIRE ALARM AND FOAM INDICATORS (TYP).

5 HANGAR BAY: PLAN EAST  
ED506 N.T.S.

REMOVE RECEPTACLES (TYP)



WASH STAND TO REMAIN. SEE PHOTO 6/ED500.

6 HANGAR BAY: EAST WASH STAND  
ED506 N.T.S.



COORDINATE WITH MECHANICAL SHEETS FOR REMOVAL. REMOVE ASSOCIATED ELECTRICAL SUPPORT. (TYP)

7 HANGAR BAY: PLAN EAST  
ED506 N.T.S.



REMOVE FIRE ALARM AND FOAM INDICATORS (TYP). REMOVE FIRE ALARM AND FOAM STATIONS AND REPLACE AS IDENTIFIED ON FA SHEETS. RETAIN SIGN

8 HANGAR BAY: PLAN SOUTHEAST  
ED506 N.T.S.



US Army Corps of Engineers @ Omaha District

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SIZE: ANSI D	FILE NAME:

US ARMY CORPS OF ENGINEERS  
OMAHA DISTRICT  
1616 CAPITOL AVE  
OMAHA, NE 68102

REPAIR B-52 MAINTENANCE DOCK 5  
(BUILDING 837)  
MINOT AFB, NORTH DAKOTA

ELECTRICAL EXISTING CONDITIONS PHOTOS  
HANGAR BAY

SHEET ID  
**ED506**

D



1 HANGAR BAY: PLAN SOUTHEAST  
ED507 N.T.S.

C

WIRELESS ACCESS POINT (TYP). REMOVE, TURN OVER TO GOVERNMENT FOR REINSTALLATION AFTER RENOVATION.



2 HANGAR BAY: CENTER WAP  
ED507 N.T.S.

PENETRATION FOR HANGAR FACE ANTENNA. COORDINATE WITH EP AND TN SHEETS FOR ADDITIONAL WORK.



3 HANGAR BAY: PLAN SE ANTENNA  
ED507 N.T.S.

B

HANGAR FACE PENETRATION ASSOCIATED WITH PHOTOS 4/ED507 AND 5/ED507. COORDINATE WITH EP AND TN SHEETS FOR ADDITIONAL WORK.

ANTENNA REPEATER COMM BOX, AND GROUNDING TO REMAIN IN PLACE. COORDINATE WITH EP AND TN SHEETS FOR ADDITIONAL WORK.



4 HANGAR BAY: PLAN SOUTHWEST ANTENNA JUNCTION BOX  
ED507 N.T.S.



5 HANGAR BAY: PLAN SOUTHWEST ANTENNA JUNCTION BOX  
ED507 N.T.S.

A



6 HANGAR BAY: PLAN SOUTHWEST ANTENNA HANGAR FACE PENETRATION  
ED507 N.T.S.

TRUSS-HUNG CABLE REELS. REMOVE AND REPLACE PER EP SHEETS. (TYP)



7 HANGAR BAY: CENTER CABLE REELS  
ED507 N.T.S.

REMOVE HORN



8 HANGAR BAY: PLAN NORTHWEST HORN  
ED507 N.T.S.



US Army Corps of Engineers @ Omaha District

MARK	DESCRIPTION	DATE

DESIGNED BY: S. J. ANDERSON	ISSUE DATE: 02/19/2020
CHECKED BY: S. J. ANDERSON	SOLICITATION NO.: 91286-23R-0026
SUBMITTED BY: STEVEN L. OTT, P.E.	CONTRACT NO.:
ANSI'D FILE NAME:	FILE NUMBER:
US ARMY CORPS OF ENGINEERS OMAHA DISTRICT 1616 CAPITOL AVE OMAHA, NE 68102	

REPAIR B-52 MAINTENANCE DOCK 5 (BUILDING 837) MINOT AFB, NORTH DAKOTA  
ELECTRICAL EXISTING CONDITIONS PHOTOS HANGAR BAY

SHEET ID  
ED507

D



1 WASH EQUIPMENT ROOM: PLAN WEST  
ED510 N.T.S.



REMOVE XWU DISCONNECTS AND REPLACE PER EP SHEETS  
2 WASH EQUIPMENT ROOM: XWU-1,2 DISCONNECTS  
ED510 N.T.S.



XWUs TO REMAIN. SEE PHOTO 5/ED500.  
3 WASH EQUIPMENT ROOM: XWU-1,2  
ED510 N.T.S.



REMOVE XWU DISCONNECTS AND REPLACE PER EP SHEETS  
4 WASH EQUIPMENT ROOM: XWU-3,4 DISCONNECTS  
ED510 N.T.S.

C

B

A



XWUs TO REMAIN. SEE PHOTO 5/ED500.  
5 WASH EQUIPMENT ROOM: XWU-3,4  
ED510 N.T.S.



XWUs TO REMAIN. SEE PHOTO 5/ED500.  
6 WASH EQUIPMENT ROOM: XWU-3,4  
ED510 N.T.S.



REMOVE ALL EQUIPMENT, INFRASTRUCTURE, AND BACKBOARDS SHOWN IN THIS PHOTO.  
7 WASH EQUIPMENT ROOM: HEATER STARTERS  
ED510 N.T.S.



US Army Corps  
of Engineers  
@ Omaha District

MARK	DESCRIPTION	DATE

DESIGNED BY: SLINDREN	ISSUE DATE: 02/19/2020
DESIGNED BY: SLINDREN	SOLICITATION NO.: 91296-20R-0026
CHECKED BY: S.OTT	CONTRACT NO.:
SUBMITTED BY: STEVEN L. OTT, P.E.	FILE NUMBER:
SIZE: ANSI D	FILE NAME:

US ARMY CORPS OF ENGINEERS  
OMAHA DISTRICT  
1616 CAPITOL AVE  
OMAHA, NE 68102

REPAIR B-52 MAINTENANCE DOCK 5 (BUILDING 837) MINOT AFB, NORTH DAKOTA  
ELECTRICAL EXISTING CONDITIONS PHOTOS  
WASH EQUIPMENT ROOM

SHEET ID  
ED510



REMOVE XAC-1 AND XAD-1 SUPPORTING ELECTRICAL INFRASTRUCTURE AND REPLACE PER EP SHEETS. AIR COMPRESSOR AND AIR DRYER TO REMAIN.



**2**  
ED511 WASH EQUIPMENT ROOM: XAC-1 AND XAD-1  
N.T.S.

**3**  
ED511 WASH EQUIPMENT ROOM: PLAN EAST  
N.T.S.

D

C



**1**  
ED511 WASH EQUIPMENT ROOM: PLAN SOUTH  
N.T.S.

MIXING TANK TO REMAIN. REMOVE SUPPORTING ELECTRICAL INFRASTRUCTURE AND REPLACE PER EP SHEETS.



**4**  
ED511 WASH EQUIPMENT ROOM: XMT-1  
N.T.S.

REMOVE ALL ELECTRICAL EQUIPMENT AND INFRASTRUCTURE SHOWN IN THESE PHOTOS.



**5**  
ED511 WASH EQUIPMENT ROOM: PLAN NORTHEAST  
N.T.S.

B

A



**US Army Corps  
of Engineers @  
Omaha District**

MARK	DATE
DESCRIPTION	

DESIGNED BY: S. LINDREN	ISSUE DATE: 02/19/2020
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CHECKED BY: S. OTT	91286-20R-0026
SUBMITTED BY: STEVEN L. OTT, P.E.	CONTRACT NO.:
SIZE: ANSI 'D'	FILE NUMBER:
FILE NAME:	
US ARMY CORPS OF ENGINEERS OMAHA DISTRICT 1616 CAPITOL AVE OMAHA, NE 68102	

REPAIR B-52 MAINTENANCE DOCK 5  
(BUILDING 837)  
MINOT AFB, NORTH DAKOTA

ELECTRICAL EXISTING CONDITIONS PHOTOS  
WASH EQUIPMENT ROOM

SHEET ID  
**ED511**

REMOVE



1 WASH EQUIPMENT ROOM: EMPTY BOX  
ED512 N.T.S.



2 WASH EQUIPMENT ROOM:  
GAS AND WATER SERVICE  
ED512 N.T.S.

COORDINATE REMOVAL WITH FD/FX SHEETS.



3 WASH EQUIPMENT ROOM:  
FIRE WATER RISER  
ED512 N.T.S.

FIBER ENTRANCE INSTALLED AFTER THIS PHOTO WAS TAKEN. SEE SHEET ED513.



FIBER ENTRANCE INSTALLED AFTER THIS PHOTO WAS TAKEN. SEE SHEET ED513.

4 WASH EQUIPMENT ROOM:  
HEATER, WATER, AND FIRE WATER  
ED512 N.T.S.



5 WASH EQUIPMENT ROOM:  
EXHAUST DAMPER  
ED512 N.T.S.



US Army Corps  
of Engineers ®  
Omaha District

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<b>DESIGNED BY:</b> S. LINDREN	<b>ISSUE DATE:</b> 02/19/2020
<b>CHECKED BY:</b> S. OTT	<b>SOLICITATION NO.:</b> 9128F20R-0026
<b>SUBMITTED BY:</b> STEVEN L. OTT, P.E.	<b>CONTRACT NO.:</b>
<b>FILE NUMBER:</b> ANSD	<b>FILE NAME:</b>
<b>US ARMY CORPS OF ENGINEERS</b> OMAHA DISTRICT 1616 CAPITOL AVE OMAHA, NE 68102	

REPAIR B-52 MAINTENANCE DOCK 5  
(BUILDING 837)  
MINOT AFB, NORTH DAKOTA

ELECTRICAL EXISTING CONDITIONS PHOTOS  
WASH EQUIPMENT ROOM

SHEET ID

**ED512**

D

C

B

A

EQUIPMENT TO REMAIN IN PLACE. COORDINATE WITH TN SHEETS.



REMOVE EXISTING BONDING CONDUCTOR AND PROVIDE NEW BONDING CONDUCTOR FROM FIBER ENTRANCE TO NEW TMGB. BOND COPPER ENTRANCE EQUIPMENT TO NEW TMGB.

WASH EQUIPMENT ROOM: COPPER COMM ENTRANCE

1 ED513 N.T.S.

EQUIPMENT TO REMAIN IN PLACE. COORDINATE WITH TN SHEETS.



WASH EQUIPMENT ROOM: COPPER COMM ENTRANCE

2 ED513 N.T.S.


EQUIPMENT TO REMAIN IN PLACE. COORDINATE WITH TN SHEETS.



WASH EQUIPMENT ROOM: COPPER COMM ENTRANCE

3 ED513 N.T.S.

EQUIPMENT TO REMAIN IN PLACE. COORDINATE WITH TN SHEETS.

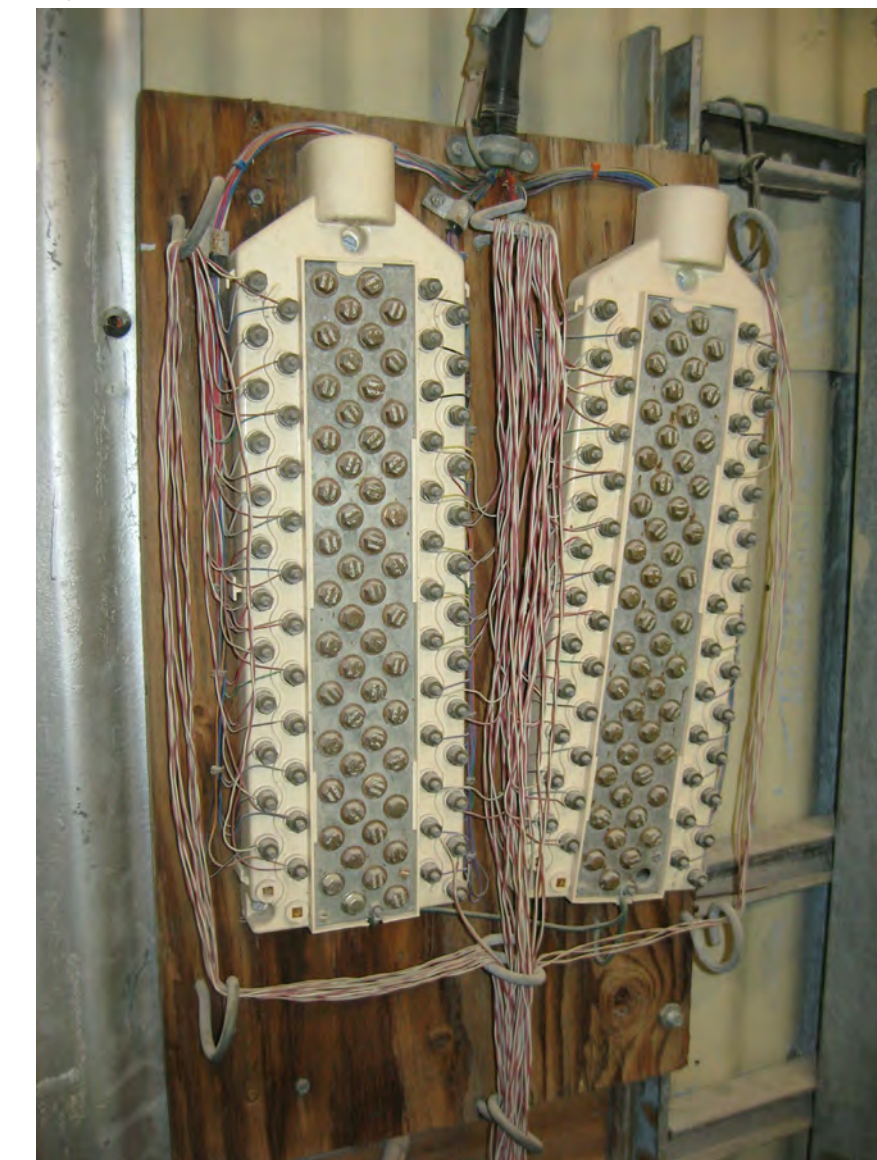

WASH EQUIPMENT ROOM: COPPER COMM ENTRANCE

4 ED513 N.T.S.

FIBER EQUIPMENT TO REMAIN IN PLACE. COORDINATE WITH TN SHEETS.



WASH EQUIPMENT ROOM: FIBER COMM ENTRANCE

5 ED513 N.T.S.

FIBER EQUIPMENT TO REMAIN IN PLACE. COORDINATE WITH TN SHEETS.



SEE PHOTO 1/ED513 REGARDING BONDING CONDUCTOR.

WASH EQUIPMENT ROOM: FIBER COMM ENTRANCE

6 ED513 N.T.S.



US Army Corps of Engineers @ Omaha District

MARK	DESCRIPTION	DATE

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US ARMY CORPS OF ENGINEERS  
OMAHA DISTRICT  
1616 CAPITOL AVE  
OMAHA, NE 68102

REPAIR B-52 MAINTENANCE DOCK 5 (BUILDING 837) MINOT AFB, NORTH DAKOTA  
ELECTRICAL EXISTING CONDITIONS PHOTOS WASH EQUIPMENT ROOM - TELECOM ENTRANCES

SHEET ID  
ED513

REMOVE ALL.



WASH EQUIPMENT ROOM:  
PLAN SOUTH

1  
ED520

N.T.S.

D

C

B

A

REMOVE ALL.



EQUIPMENT ROOM:  
PLAN SOUTH TRANSFORMER

2  
ED520

N.T.S.

REMOVE ALL.



EQUIPMENT ROOM: PLAN SOUTHEAST

3  
ED520

N.T.S.

REMOVE ALL.



REMOVE ALL.



EQUIPMENT ROOM:  
PLAN EAST

6  
ED520

N.T.S.

REMOVE ALL.



EQUIPMENT ROOM:  
PLAN NORTHEAST

5  
ED520

N.T.S.

REMOVE ALL.



EQUIPMENT ROOM:  
PLAN EAST

4  
ED520

N.T.S.



US Army Corps  
of Engineers ®  
Omaha District

MARK	DESCRIPTION	DATE

DESIGNED BY: S. LINDREN	US ARMY CORPS OF ENGINEERS OMAHA DISTRICT 1616 CAPITOL AVE OMAHA, NE 68102	ISSUE DATE: 02/19/2020
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REPAIR B-52 MAINTENANCE DOCK 5  
(BUILDING 837)  
MINOT AFB, NORTH DAKOTA  
ELECTRICAL EXISTING CONDITIONS PHOTOS  
EQUIPMENT ROOM

SHEET ID  
ED520

