



Date

Revisions

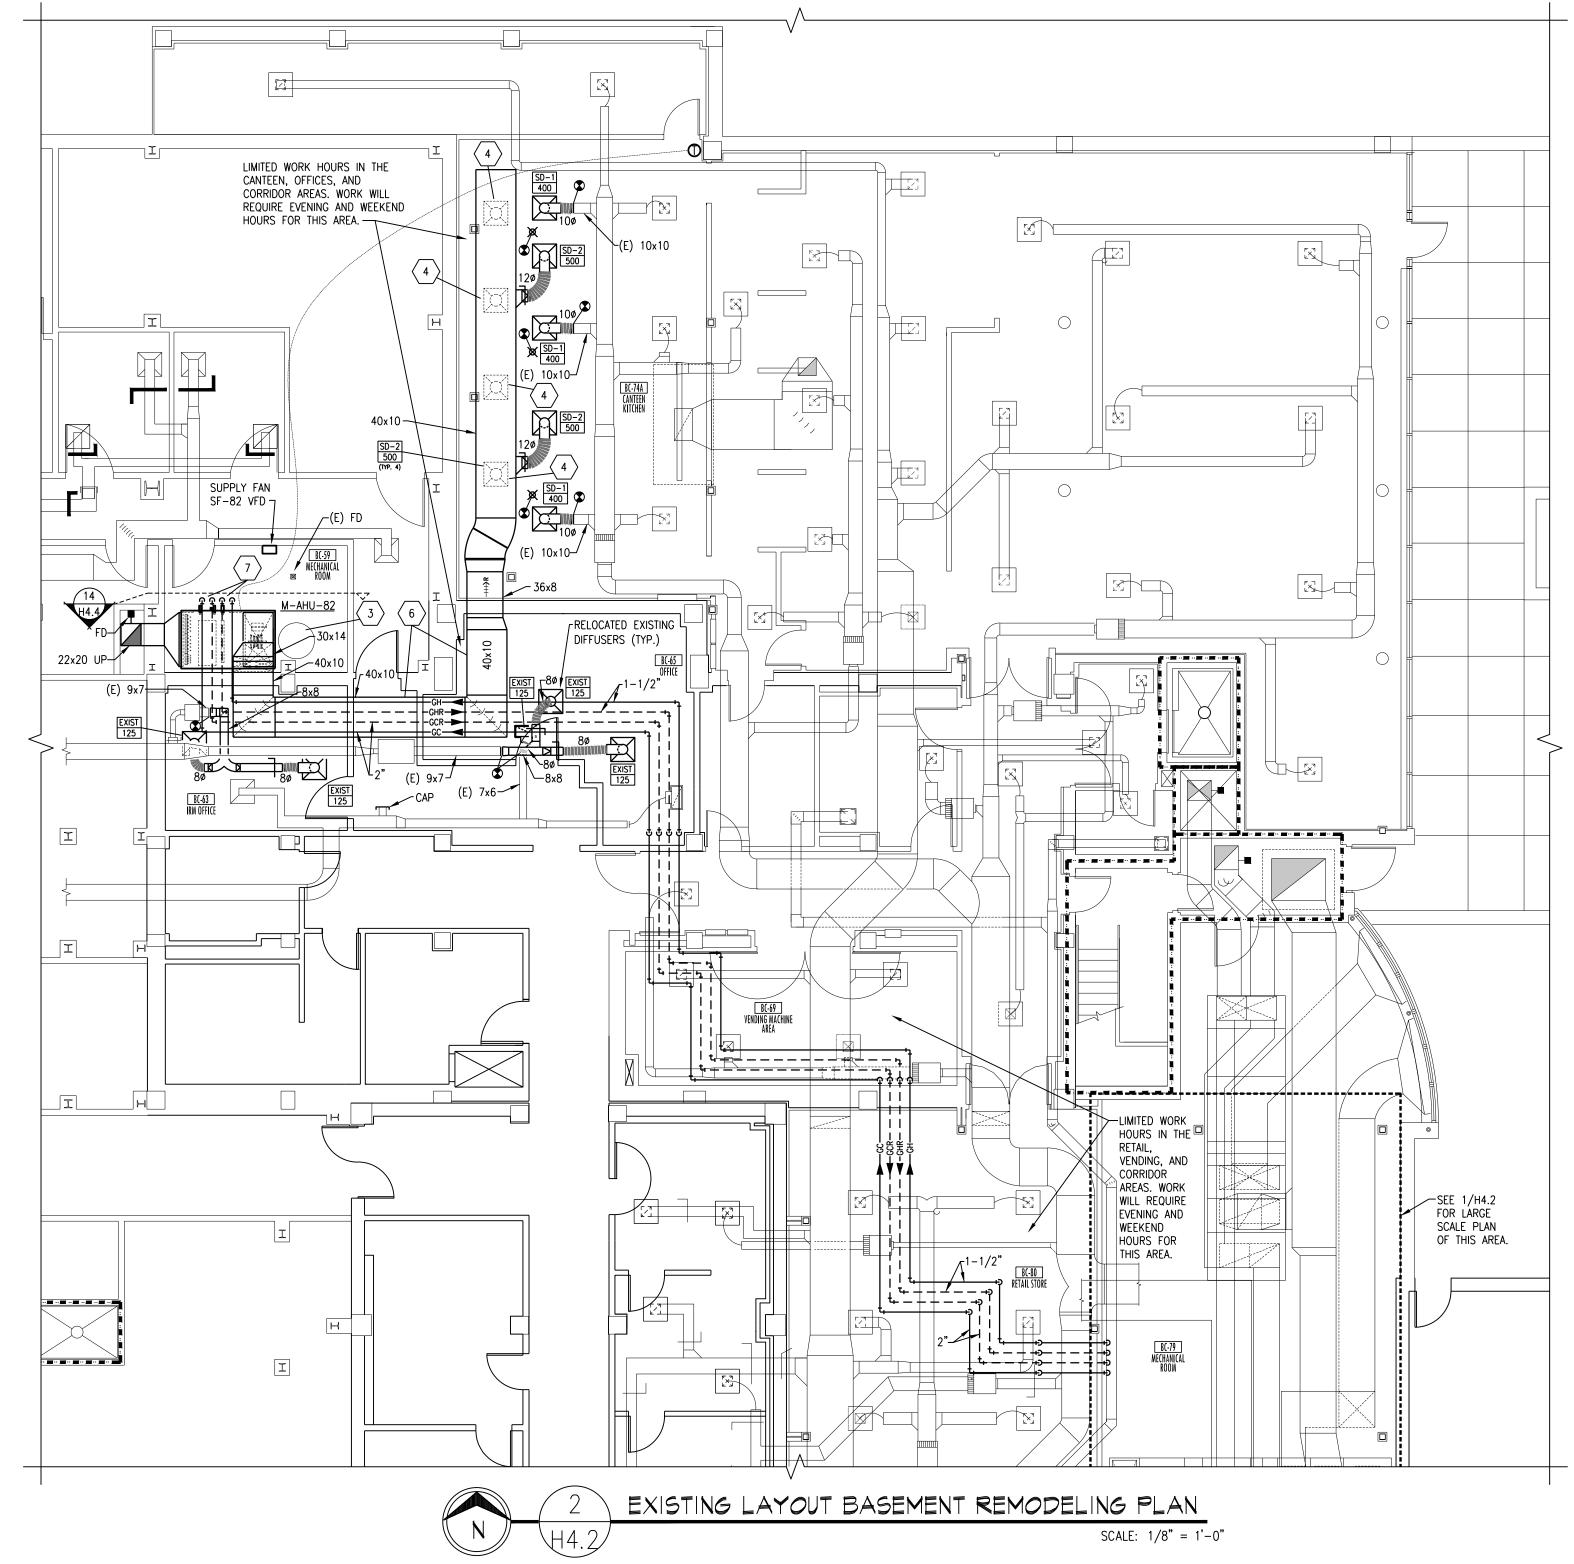

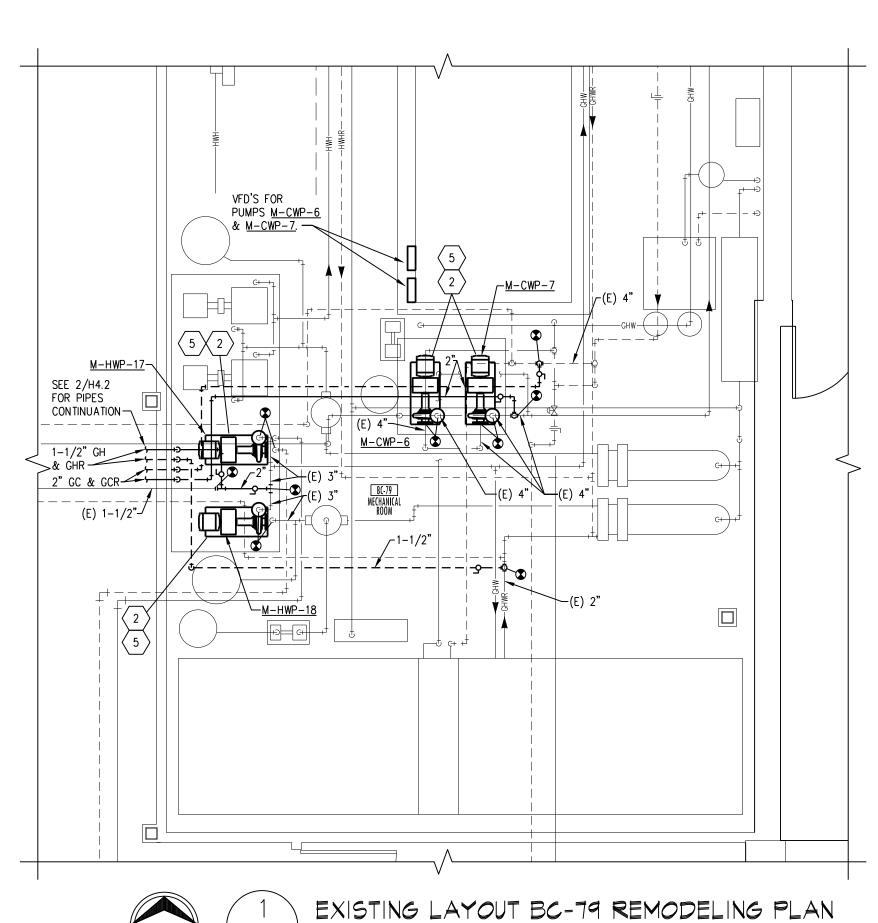

CANTEEN PHASING NOTES: COMPLETE ALL WORK IN THE CANTEEN DURING EVENING, OVERTIME, OR WEEKEND HOURS IN CAREFUL COORDINATION WITH THE OWNER.

THE SPACES IN THE CANTEEN SHALL BE CLEANED AND READY FOR NORMAL OPERATION EACH MORNING AFTER EVENING WORK IS COMPLETE. COORDINATE START OF WORK A MINIMUM OF 2 WEEKS AHEAD OF TIME WITH OWNER. SHALL TAKE PLACE IN THE COOLING MONTHS AND HEATING MONTHS. RESPECTIVELY. ONLY REPLACE ONE HEATING PUMP AT A TIME IN ORDER TO MINIMIZE DOWNTIME OF HEATING SYSTEM.

MECHANICAL NOTES: CONTRACTOR SHALL VERIFY ALL EXISTING CONDITIONS PRIOR TO BEGINNING WORK AND NOTIFY THE ARCHITECT/ENGINEER OF ANY DISCREPANCIES BETWEEN

THE "AS-BUILT" CONDITIONS AND THESE DRAWINGS. COORDINATE ALL HVAC PIPING AND DUCTWORK INSTALLATION WITH GENERAL, PLUMBING, FIRE PROTECTION, AND ELECTRICAL CONTRACTORS. INSTALL ALL HVAC PIPING AND DUCTWORK AS HIGH AS POSSIBLE. PROVIDE ALL NECESSARY OFFSETS (DROPS AND RISES) TO KEEP HVAC PIPING AND DUCTWORK TIGHT TO THE STRUCTURE ABOVE AND INSTALLATION BY ALL TRADES. OFFSET HVAC PIPING AND DUCTWORK TO

AVOID BEAMS. THIS CONTRACTOR SHALL OPEN ALL EXISTING WALLS AND/OR CEILINGS FOR INSTALLATION OF NEW HVAC PIPING AND VENTILATION DUCTWORK, EQUIPMENT, ETC AS REQUIRED. PATCH WALLS AND/OR CEILINGS TO

MATCH EXISTING. MAINTAIN 3'-0" CLEAR SPACE IN FRONT OF ALL ELECTRICAL, CONTROL, AND ACCESS PANELS FOR

ACCESSIBILITY. ALL SHUT-OFF VALVES, CONTROL VALVES, STRAINERS DAMPERS, ETC... SHALL BE INSTALLED IN ACCESSIBLE CEILINGS. VALVES SHALL BE LOCATED NOT MORE THAN

2 FEET ABOVE ACOUSTICAL CEILINGS. PROVIDE 1/2" DRAIN VALVE AT ALL LOW POINTS OF EACH SYSTEM TO ENABLE COMPLETE DRAINAGE. PROVIDE 1/2" VENT VALVES AT ALL HIGH POINTS OF EACH SYSTEM TO ENABLE COMPLETE VENTING.

. ALL OPEN ENDS OF DUCTS SHALL BE CAPPED AT THE END OF CONSTRUCTION EACH DAY. H. ALL NEW PIPING SHALL BE INSTALLED AS HIGH AS POSSIBLE TO AVOID TRIPPING HAZARDS IN WALKWAYS BUT AT A HEIGHT TO REMAIN ACCESSIBLE. KEEP ALL EQUIPMENT ACCESS PATHS CLEAR.

ALL EXISTING DIFFUSERS, GRILLES, AND FLEX DUCTS AFFECTED BY CEILING REMOVAL AND RE-INSTALLATION SHALL BE TEMPORARILY SUPPORTED DURING CONSTRUCTION AND RE-INSTALLED AFTER CEILING WORK IS COMPLETE. ALL SPRINKLER ESCUTCHEONS SHALL BE REMOVED AND REINSTALLED AS REQUIRED FOR CEILING WORK. 1 PROVIDE DDC CONTROL INTERFACE FOR EXISTING

- AERCO WATER HEATERS FOR CONNECTION TO EXISTING BAS FOR REMOTE INDICATION OF ALARMS AND MONITORING. REPLACE EXISTING STEAM VALVE WITH NEW ELECTRONIC VALVE AND ACTUATOR. PROVIDE PROTONODE CARD FOR EACH MECHANICAL ROOM FOR BACNET ACCESS TO WATER HEATER INFORMATION. PROVIDE SENSORS IN RECIRCULATION PIPING FOR MONITORING PURPOSES. UPGRADE ONE WATER HEATER AT A TIME DURING NON-PEAK HOURS (I.E. NIGHTS AND WEEKENDS) FOR PHASING PURPOSES. REFER TO CONTROLS SHEÉT FOR CONTROL DIAGRAM.

2 REPLACE EXISTING PUMPS AND RECONNECT TO $^{-\!\!\!/}$ Existing Piping. Provide Piping modifications and ENLARGED CONCRETE PUMP PAD AS REQUIRED FOR REPLACEMENT PUMPS.


3 > RELOCATE EXISTING FIRE PROTECTION TANKS, PIPING, - AND ACCESSORIES AS REQUIRED TO MAKE ROOM FOR NEW AIR HANDLER, DUCTWORK, AND NEW PIPING. MINIMIZE DOWNTIME AND CAREFULLY COORDINATE RELOCATION OF EQUIPMENT WITH THE OWNER. WORK


TELEPHONE SPACES DURING SYSTEM SHUTDOWN. 4 >PROVIDE HIGH EFFICIENCY TAKEOFF FROM THE BOTTOM OF THE DUCT WITH VOLUME DAMPER. PROVIDE FLEX DUCT DOWN TO THE SUPPLY DIFFUSER. 5 RECONNECT EXISTING PUMP CONTROLS AS REQUIRED FOR PUMP REPLACEMENT. RELOCATE SENSORS AND


WILL REQUIRE FIRE WATCH OF EXISTING IT AND

WIRING AS REQUIRED. RE-BALANCE EXISTING SYSTEM SERVED BY PUMPS. SEE DETAILS SHEET FOR SCHEMATIC INFORMATION. 6 SPLIT NEW 40x10 DUCT INTO TWO 20x10 DUCTS AS REQUIRED TO INSTALL ABOVE CEILING.

7 PROVIDE 2-WAY CONTROL VALVES FOR HEATING AND COOLING COILS.

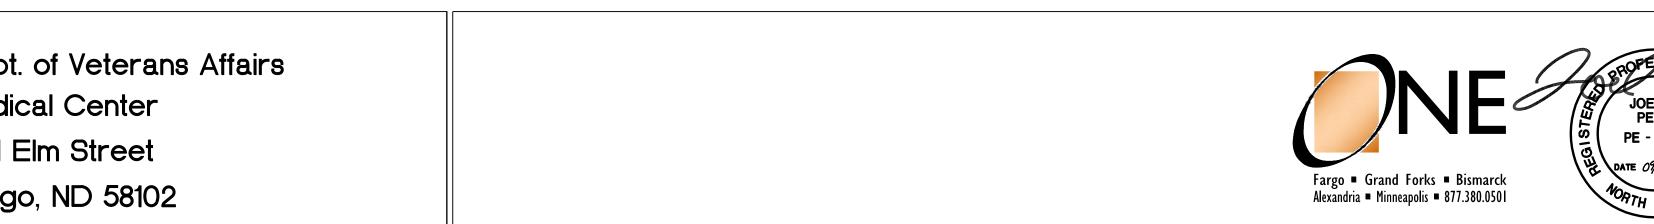

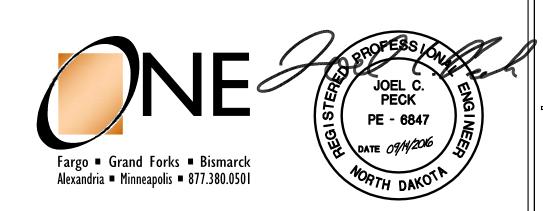

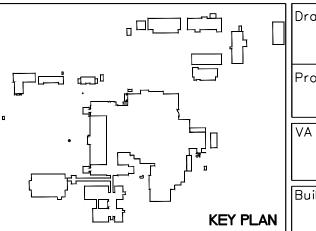

owing Title BASEMENT, FIRST FLOOR, SECOND FLOOR, AND PENTHOUSE LARGE SCALE REMODELING PLANS		Project Title REP
oject Phase		
PHASE 4		
Project No.	Contract No. VA263-P-1218	Designed By
	VA203-7-1216	l ID

VAMC CAMPUS

SCALE: 1/4" = 1'-0"

VA263-C-

2012273-PH4.2.DWG

AutoCAD File Name

oject Title REPLACE OR UPGRADE HVAC SYSTEM COMPONENTS

||Checked By

FARGO VA HEALTH CARE SYSTEM

FARGO, NORTH DAKOTA

||Drawn By

SEPT. 14, 2016 **AS SHOWN**

rawing No.

Dwg. 45 of 66

