

AIR HANDLER PHASING NOTES: ALL AIR HANDLER REPLACEMENTS SHALL BE PERFORMED IN APRIL/MAY OR SEPTEMBER/OCTOBER MONTHS IN CAREFUL COORDINATION WITH THE OWNER.

BEGINNING WORK.

. FOR TEMPORARY AIR HANDLER OPERATION, PROVIDE A TEMPORARY FAN EQUAL TO THE UNIT AIRFLOW/HORSE POWER, AND HEPA FILTER TO BE MOUNTED TO THE SUPPLY DUCTWORK PRIOR TO REMOVING UNIT. REFER TO FLOOR PLANS FOR SUGGESTED TEMPORARY SUPPLY FAN LOCATION. FAN SHALL RUN CONTINUOUSLY. MAINTAIN THE MECHANICAL ROOM TEMPERATURE AT A MINIMUM OF 55 DEGREES AND MAXIMUM OF 70 DEGREES DURING AHU CHANGE OUT USING EXISTING HEATING UNITS OR TEMPORARY COOLING/HEATING UNITS. OUTSIDE AIR, RETURN AIR, RELIEF AIR, AND SUPPLY AIR DUCTS SHALL BE LEFT OPEN TO USE THE MECHANICAL ROOM AS A PLENUM.

PROVIDE A MINIMUM OF 2 WEEKS NOTICE PRIOR TO

ALL UNIT SHUTDOWN WORK SHALL BE COMPLETED DURING WEEKEND AND EVENING HOURS. REPLACEMENT OF UNIT SHALL BE COMPLETED AS QUICKLY AS POSSIBLE WITH MULTIPLE SHIFTS REQUIRED TO EXPEDITE WORK. ALL CONTROLS WORK THAT CAN BE COMPLETED BEFORE AND SHALL BE COORDINATED. WORK SHALL BE COMPLETED DURING SPRING, FALL, OR WINTER MONTHS.

DISASSEMBLE NEW AIR HANDLERS TO THEIR SMALLEST COMPONENTS AS REQUIRED TO FIT THROUGH EXISTING DOORS. TEMPORARILY REMOVE EXISTING MECHANICAL ROOM DOORS AS NECESSARY.

AIR HANDLER CONTROLS & HUMIDIFIER RELOCATION PHASING NOTES:

MECHANICAL CONTRACTOR SHALL INSTALL ALL NEW CONTROLS DEVICES, PANEL, WIRING, CONDUIT, ETC. AS MUCH AS POSSIBLE BEFORE SYSTEM SWITCHOVER TO NEW CONTROLS SYSTEM. 2. ALL CONTROLS SYSTEM SWITCHOVERS SHALL BE CAREFULLY COORDINATED WITH THE VA AND SHALL OCCUR DURING EVENING OR WEEKEND HOURS AND SHALL BE KEPT TO A MINIMUM AMOUNT OF TIME. PROVIDE A MINIMUM OF 2 WEEKS OF ADVANCE NOTICE BEFORE STARTING WORK. SWITCHOVERS SHALL OCCUR

AT THE BEGINNING OF THE WEEK AND THE UNIT SHALL BE MONITORED ALL WEEK LONG TO PREVENT ISSUES WITH TEMPERATURE CONTROL. . INSTALL ALL NEW VALVES, PIPING, CONTROLS, ETC. AS MUCH AS POSSIBLE PRIOR TO RELOCATING EXISTING

HUMIDIFIERS. 4. ALL WORK TO RELOCATE THE HUMIDIFIERS OR ATTENUATORS SHALL TAKE PLACE DURING EVENING OR WEEKEND HOURS WITH A MINIMUM 2 WEEK NOTICE GIVEN TO THE OWNER BEFORE STARTING WORK AND SHALL BE KEPT TO A MINIMUM AMOUNT OF TIME. OBTAIN ALL FIELD MEASUREMENTS AND FABRICATE DUCTWORK PRIOR TO DEMOLITION TO MINIMIZE DOWNTIME. WORK TO OCCUR DURING NON-HEATING

5. FOR ALL AIR HANDLERS SERVING AREAS THAT OPERATE 24/7, PROVIDE TEMPORARY DUCTWORK TOO KEEP THE UNIT OPERATIONAL DURING HUMIDIFIER AND DUCTWORK MODIFICATIONS.

MECHANICAL NOTES: A. CONTRACTOR SHALL VERIFY ALL EXISTING CONDITIONS PRIOR TO BEGINNING WORK AND NOTIFY THE ARCHITECT/ENGINEER OF ANY DISCREPANCIES BETWEEN THE "AS-BUILT" CONDITIONS AND THESE DRAWINGS. B. COORDINATE ALL HVAC PIPING AND DUCTWORK

INSTALLATION WITH GENERAL, PLUMBING, FIRE PROTECTION, AND ELECTRICAL CONTRACTORS. INSTALL ALL HVAC PIPING AND DUCTWORK AS HIGH AS POSSIBLE. PROVIDE ALL NECESSARY OFFSETS (DROPS AND RISES) TO KEEP HVAC PIPING AND DUCTWORK TIGHT TO THE STRUCTURE ABOVE AND INSTALLATION BY ALL TRADES. OFFSET HVAC PIPING AND DUCTWORK TO AVOID BEAMS. C. THIS CONTRACTOR SHALL OPEN ALL EXISTING WALLS AND/OR CEILINGS FOR INSTALLATION OF NEW HVAC

PIPING AND VENTILATION DUCTWORK, EQUIPMENT, ETC.

AS REQUIRED. PATCH WALLS AND/OR CEILINGS TO MATCH EXISTING. . MAINTAIN 3'-0" CLEAR SPACE IN FRONT OF ALL ELECTRICAL, CONTROL, AND ACCESS PANELS FOR

ACCESSIBILITY. E. ALL SHUT-OFF VALVES, CONTROL VALVES, STRAINERS, DAMPERS, ETC... SHALL BE INSTALLED IN ACCESSIBLE CEILINGS. VALVES SHALL BE LOCATED NOT MORE THAN 2 FEET ABOVE ACOUSTICAL CEILINGS. PROVIDE 1/2" DRAIN VALVE AT ALL LOW POINTS OF

EACH SYSTEM TO ENABLE COMPLETE DRAINAGE. PROVIDE 1/2" VENT VALVES AT ALL HIGH POINTS OF EACH SYSTEM TO ENABLE COMPLETE VENTING. G. ALL OPEN ENDS OF DUCTS SHALL BE CAPPED AT THE END OF CONSTRUCTION EACH DAY. REFER TO HVAC PIPING DETAILS ON SHEET H# FOR ADDITIONAL INFORMATION ON INDIVIDUAL TERMINAL DEVICES, COILS

AND PIPE PENETRATIONS. H. ALL NEW PIPING SHALL BE INSTALLED AS HIGH AS POSSIBLE TO AVOID TRIPPING HAZARDS IN WALKWAYS BUT AT A HEIGHT TO REMAIN ACCESSIBLE. KEEP ALL EQUIPMENT ACCESS PATHS CLEAR.

REFER TO SPEC SECTION 23 09 23 FOR AHU SAFETY WIRING FOR VFD'S.

1 >INSTALL NEW HEATING COIL CONTROL VALVE. \langle 2 \rangle INSTALL NEW COOLING COIL CONTROL VALVE. PROVIDE UNISTRUT SUPPORTS TO MOUNT NEW CONTROL PANELS.


4 RELOCATE EXISTING HIGH LIMIT HUMIDITY SENSOR ON SUPPLY DUCT AS REQUIRED TO MAINTAIN 10-FEET FROM NEW HUMIDIFIER LOCATION INCLUDING ALL WIRING, CONDUITS, ETC. PATCH AND INSULATE EXISTING DUCTWORK WHERE SENSORS ARE REMOVED AND AT NEW SENSOR LOCATION.

2101 Elm Street Fargo, ND 58102

Date

Revisions




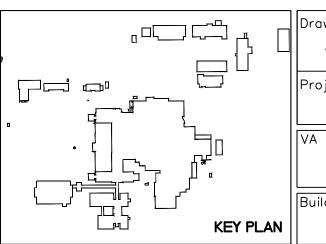

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ATTIC SPACE LARGE SCALE REMODELING PLANS		
ect Phase		
PHASE 1		
Project No.	Contract No. VA263-P-1218	Design
437-13-111	VA263-C-	
ing No.	AutoCAD File Name	Locatio

2012273-PH1.4.DWG

Project Title REPLACE OR UPGRADE HVAC SYSTEM COMPONENTS		Date SEPT. 14, 2016
		Scale: AS SHOWN
Designed By JP Checked By JP	Drawn By JF	Drawing No. H1_4
FARGO VA HEALTH CARE SYSTEM FARGO, NORTH DAKOTA		Dwg. 23 of 66

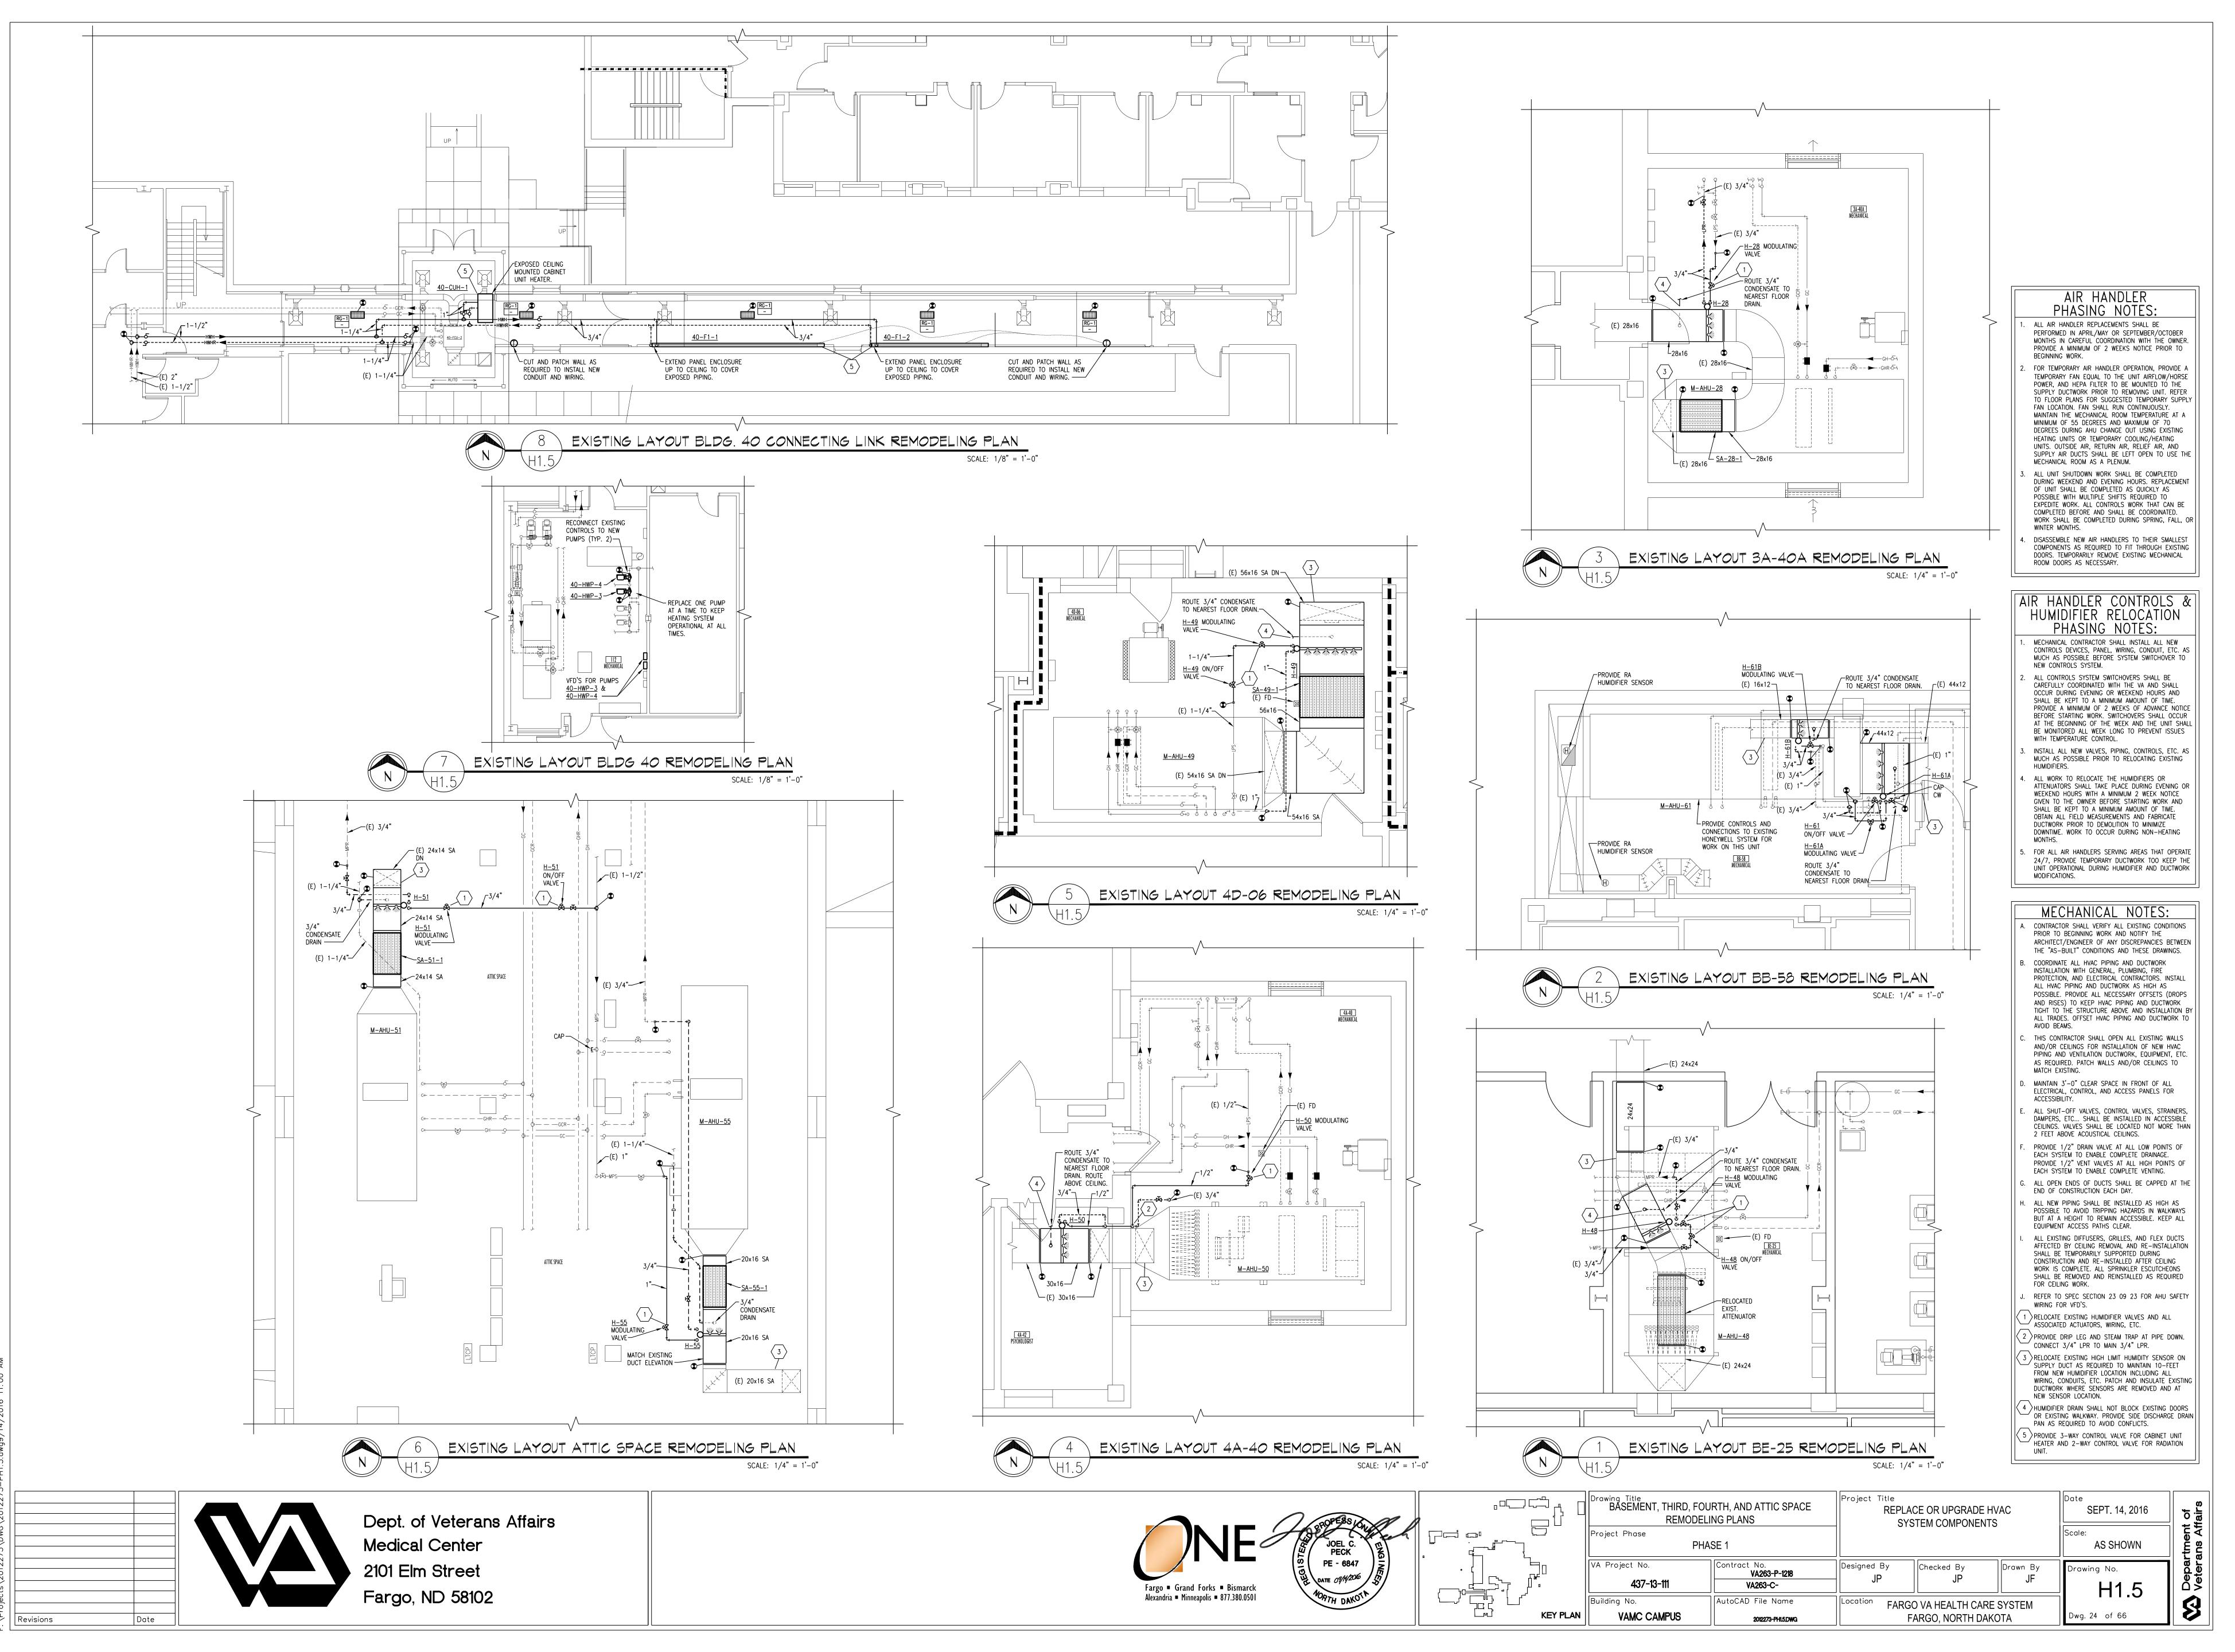

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