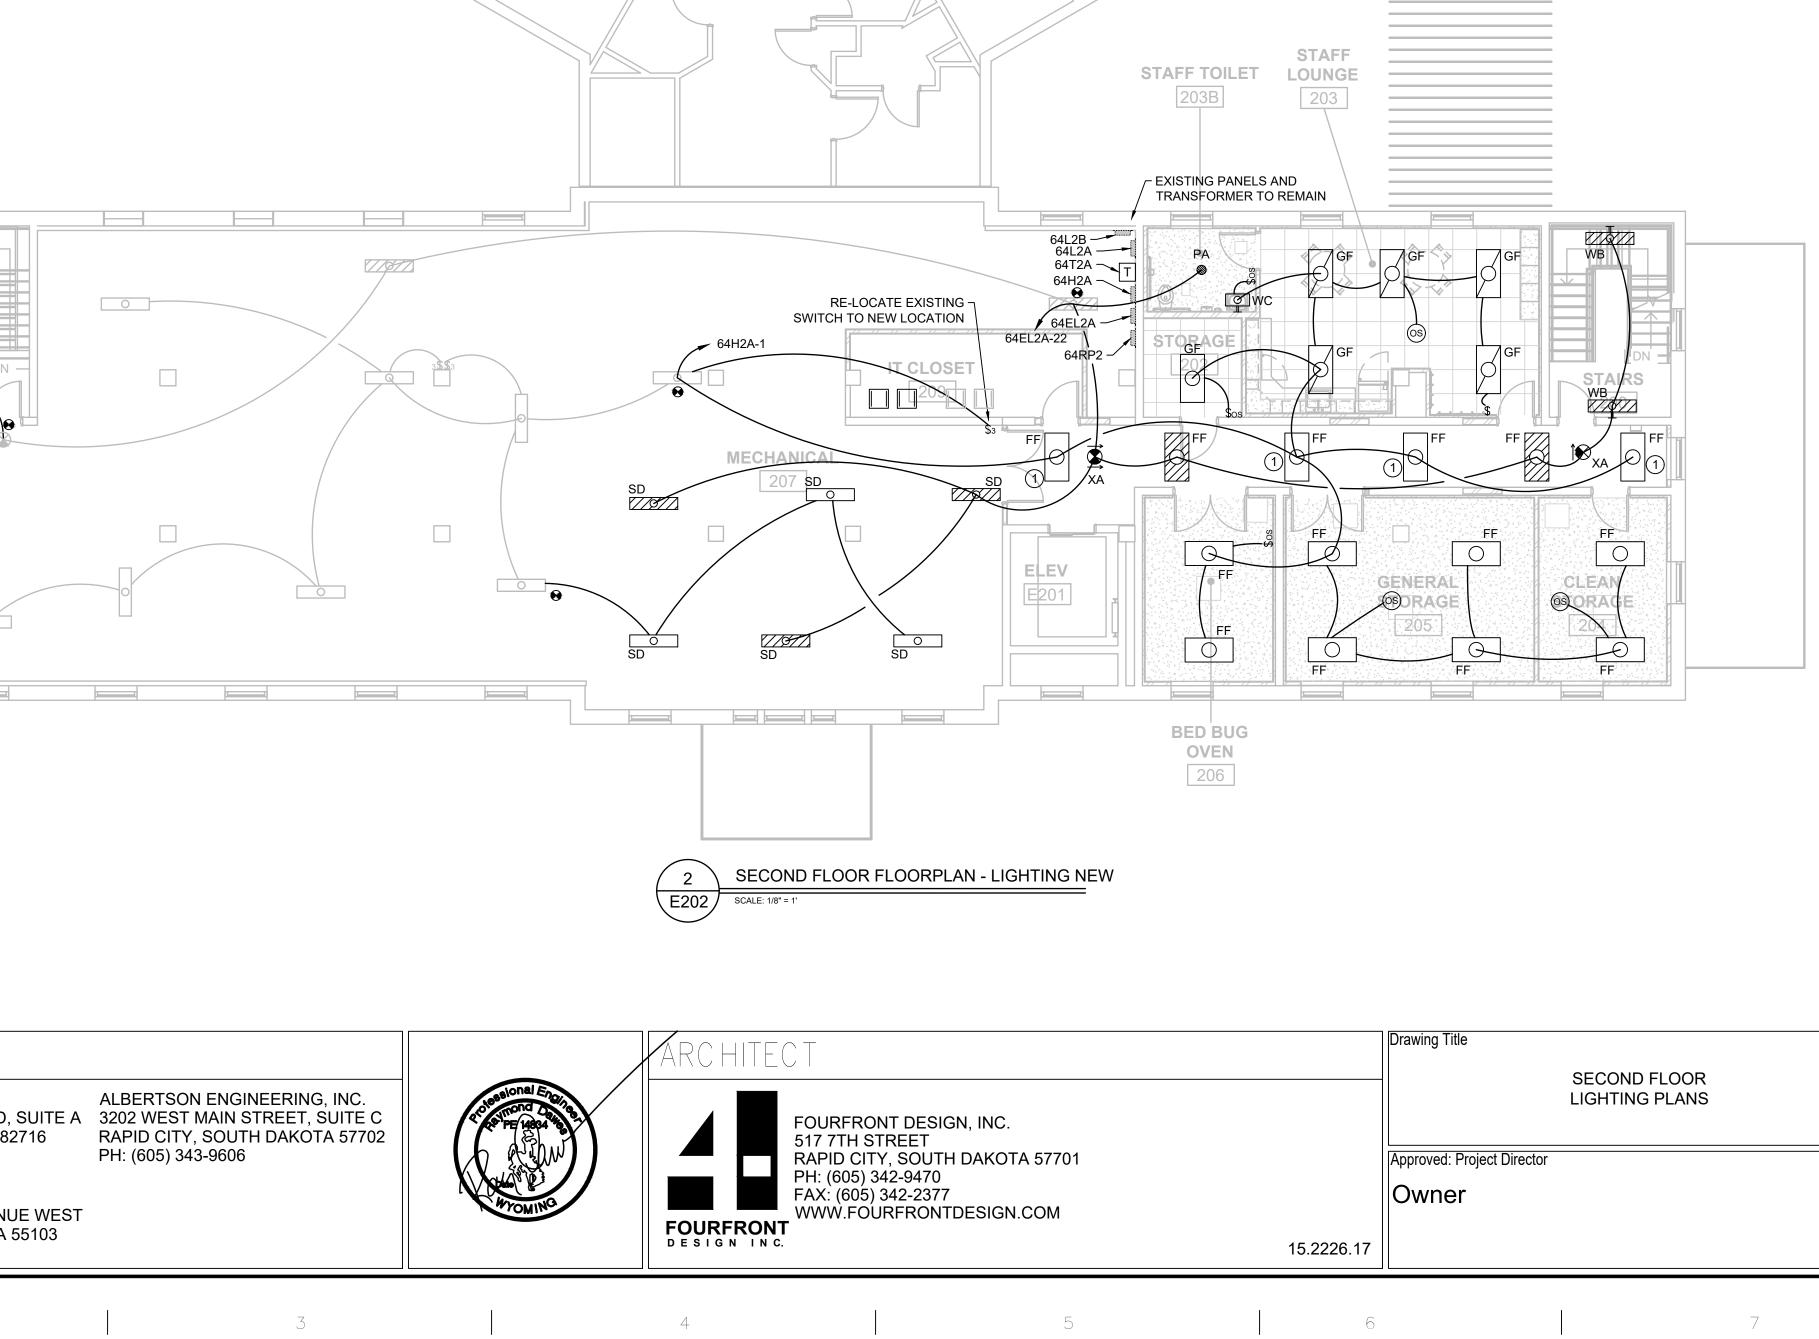
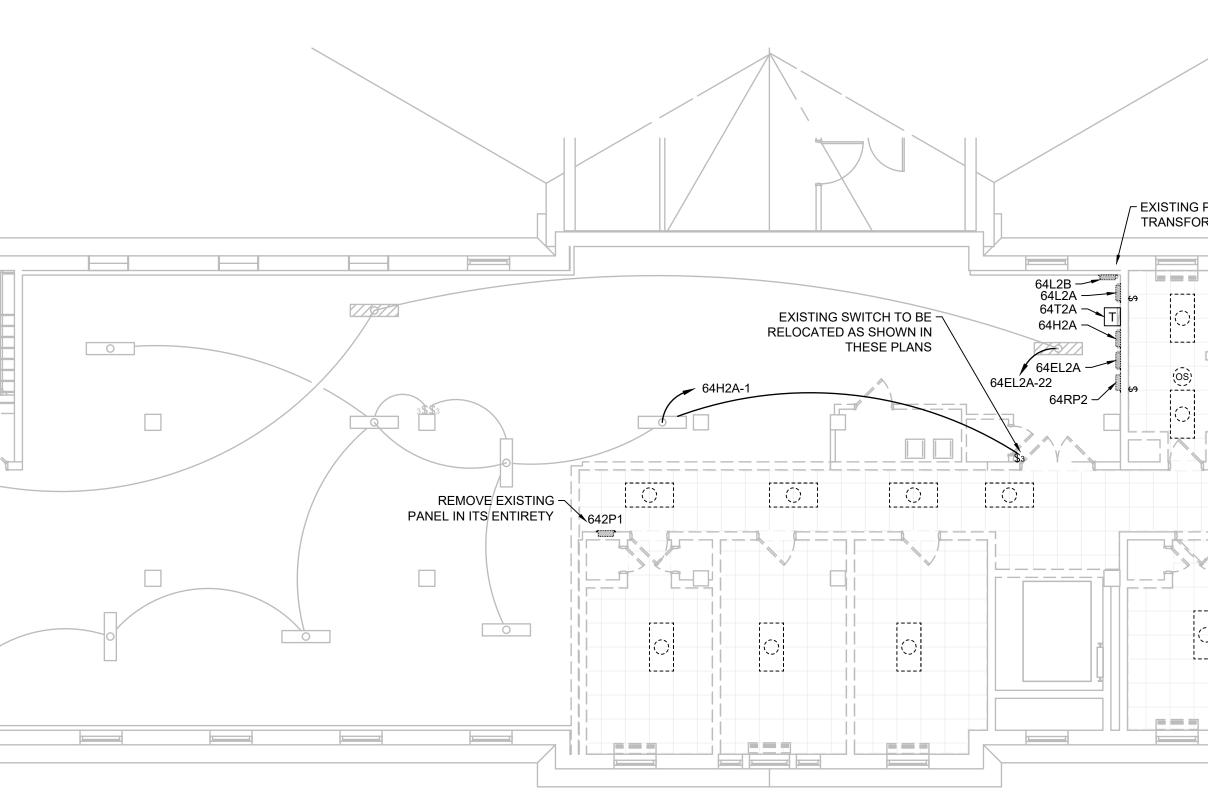
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A	one floate inches = one foot					
 В	one and one half inches =					
 С	ers inch = one foot one inch = one foot					
 D	e half inch = one foot three quarters					
E	t three eighths inch = one foot one					
F	one foot one quarter inch = one foot 16 0 4 8 16 0 16 16 10 16 10 10 10 10 10 10 10 10 10 10 10 10 10			CONSULTANTS		
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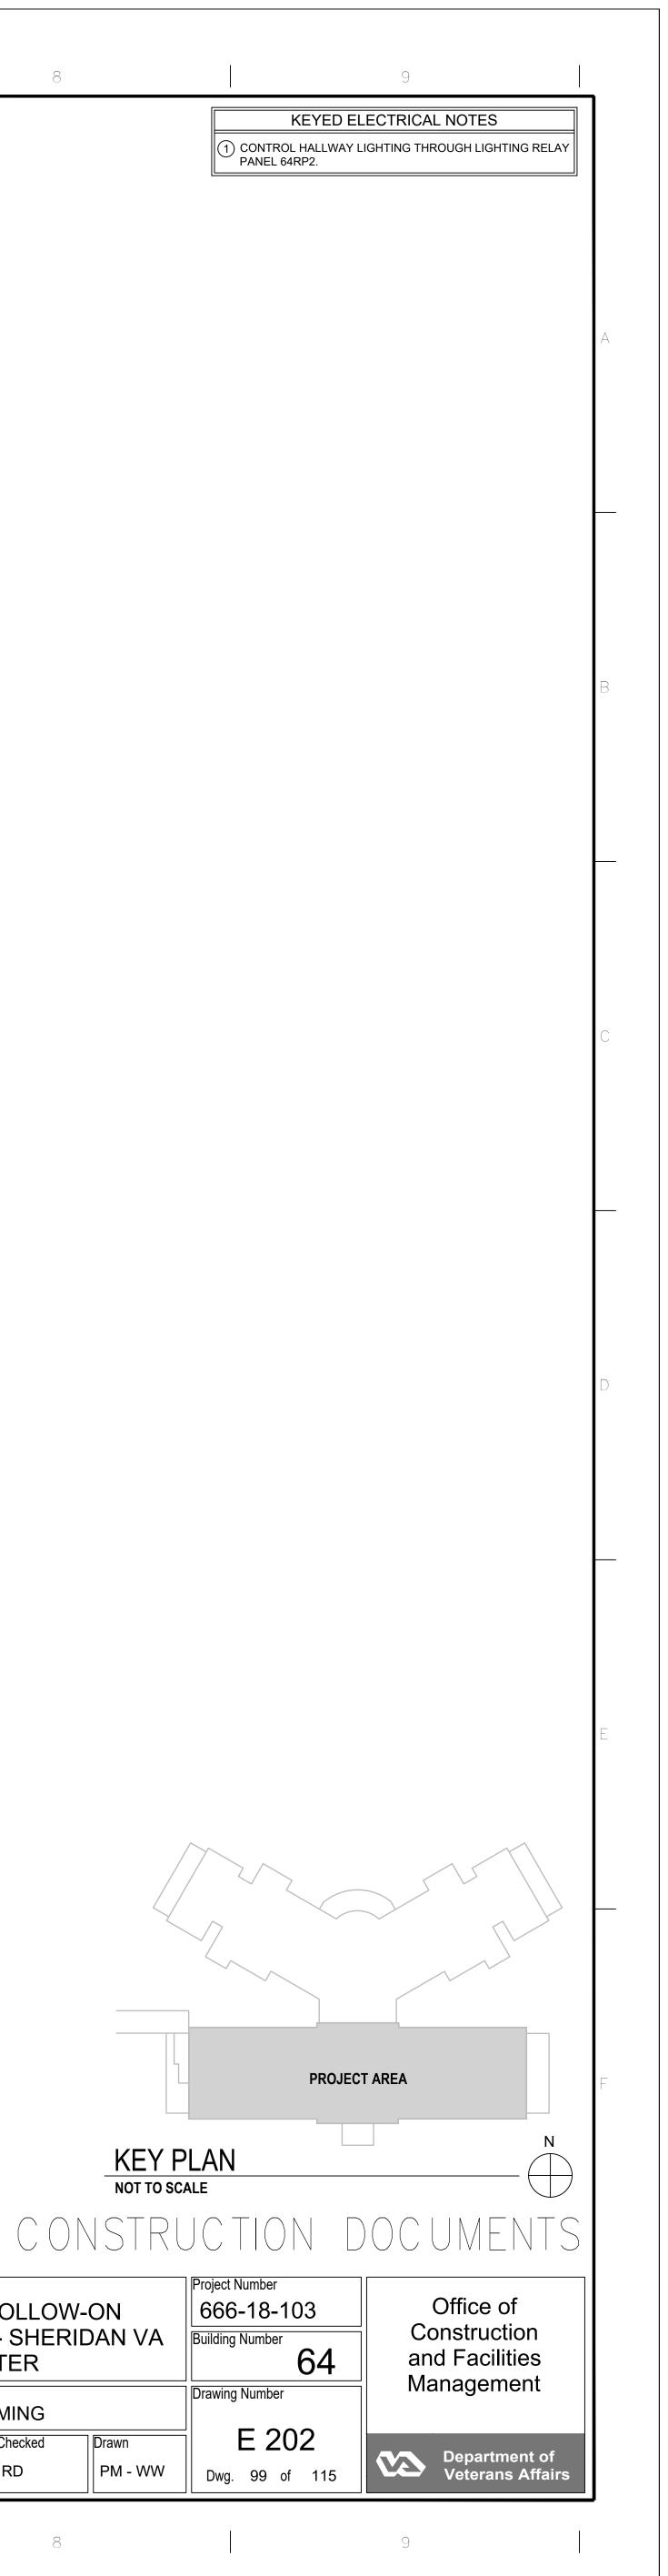


SECOND FLOOR FLOORPLAN - LIGHTING DEMOLITION E202 SCALE: 1/8" = 1'

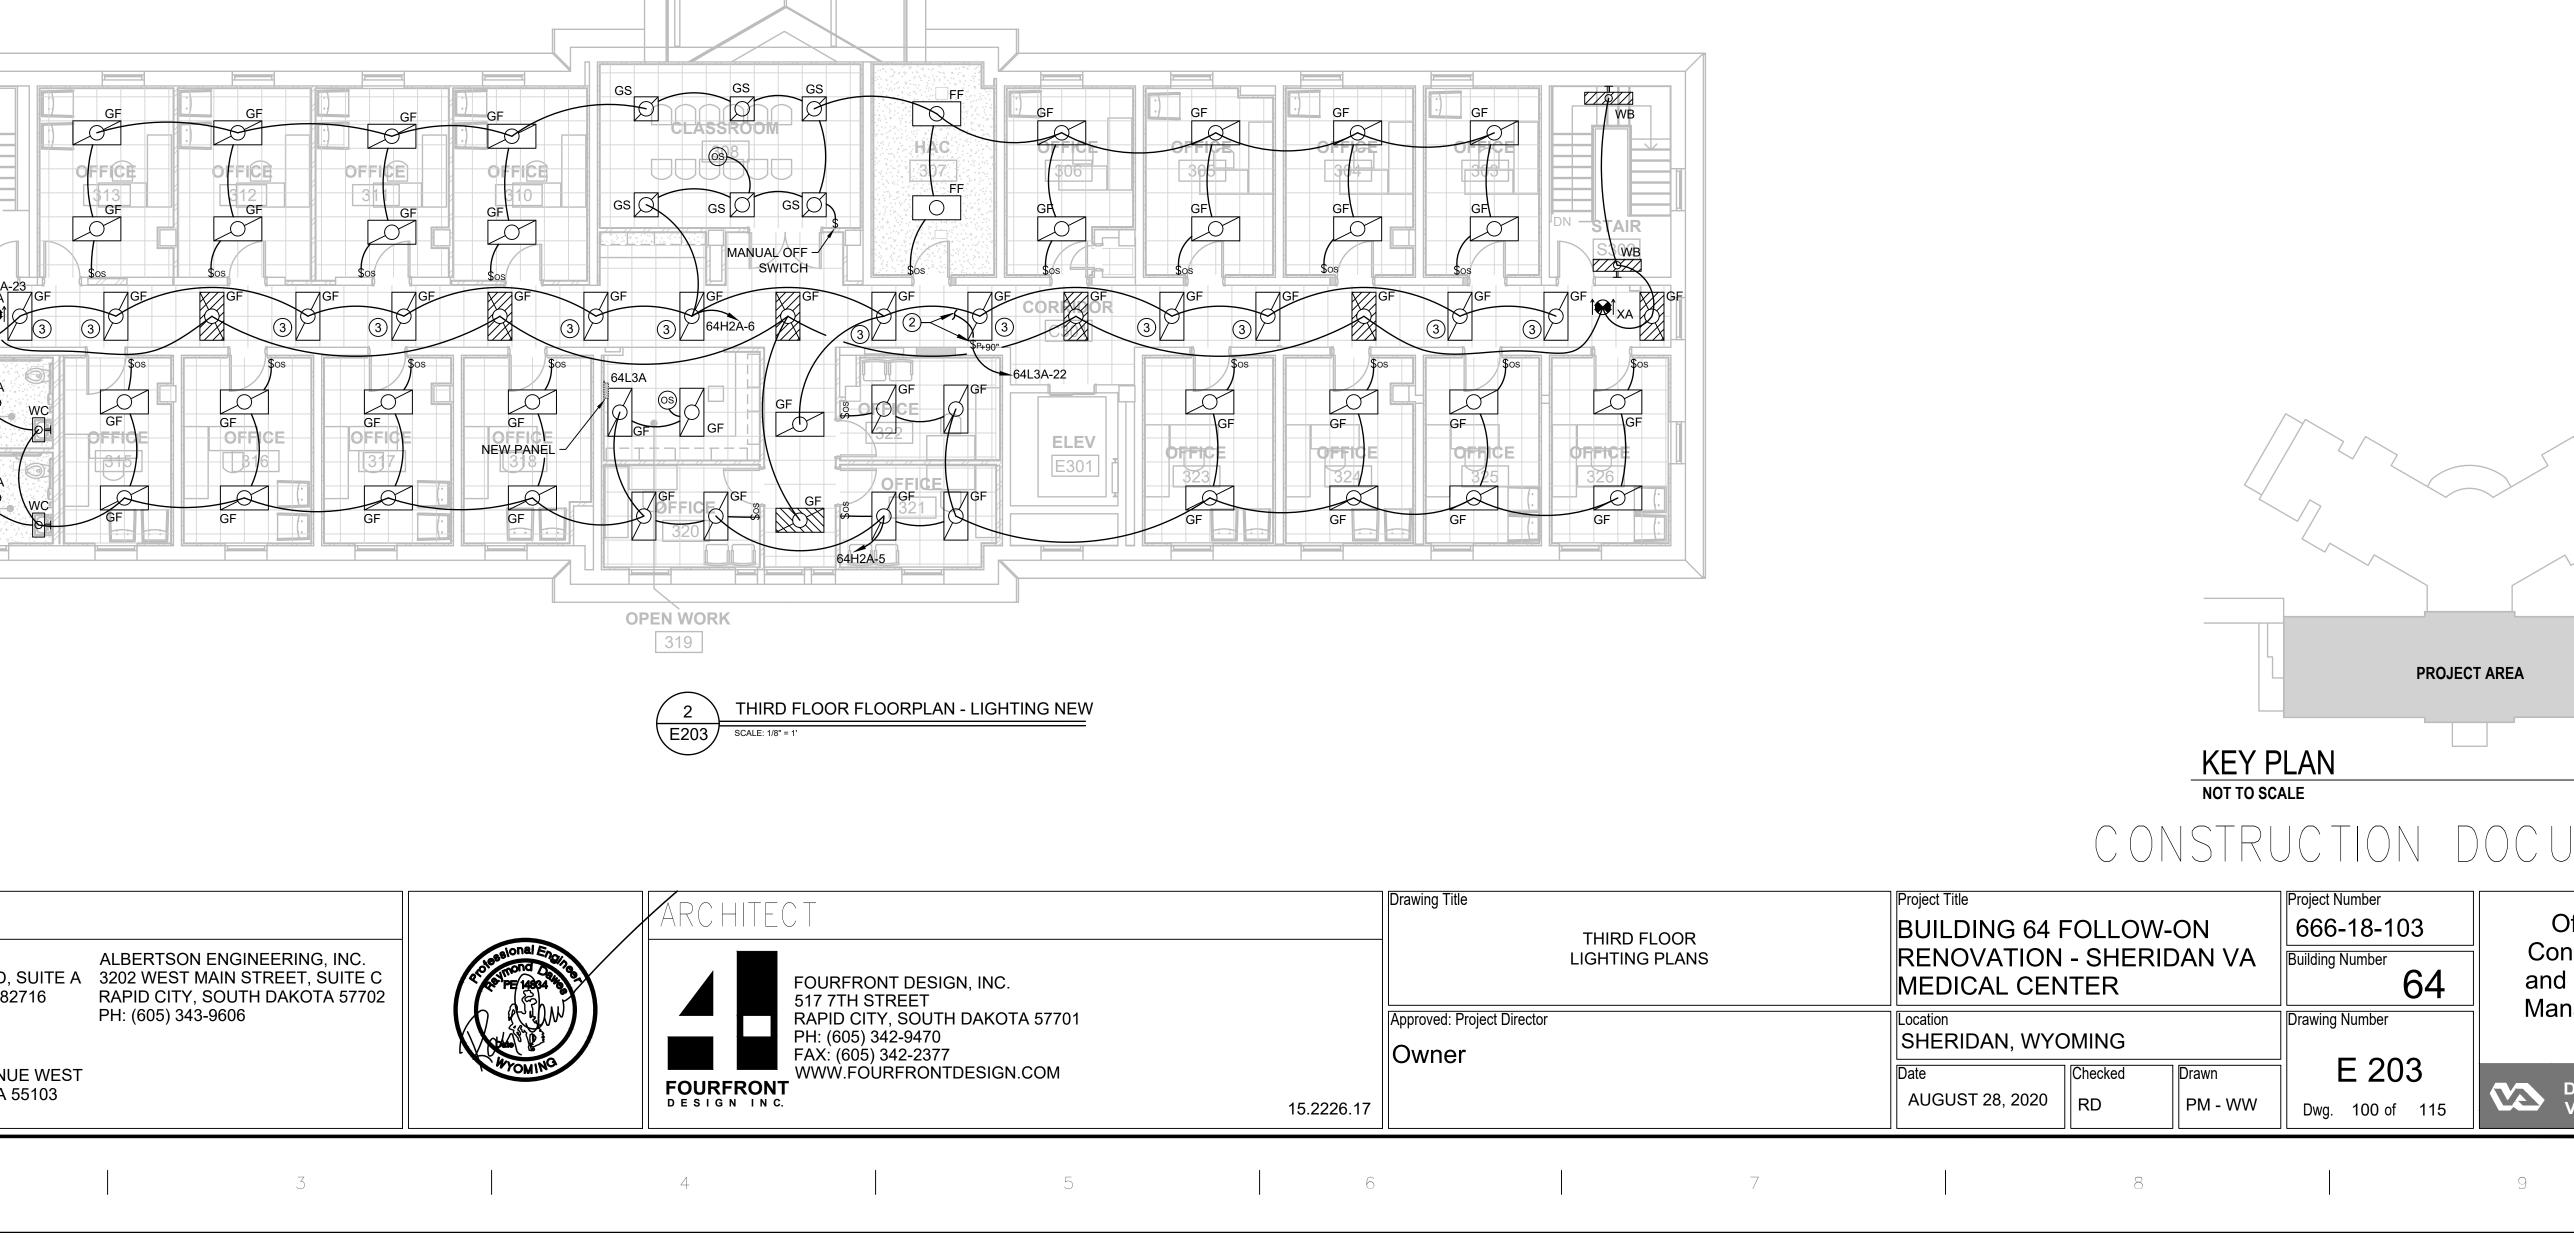


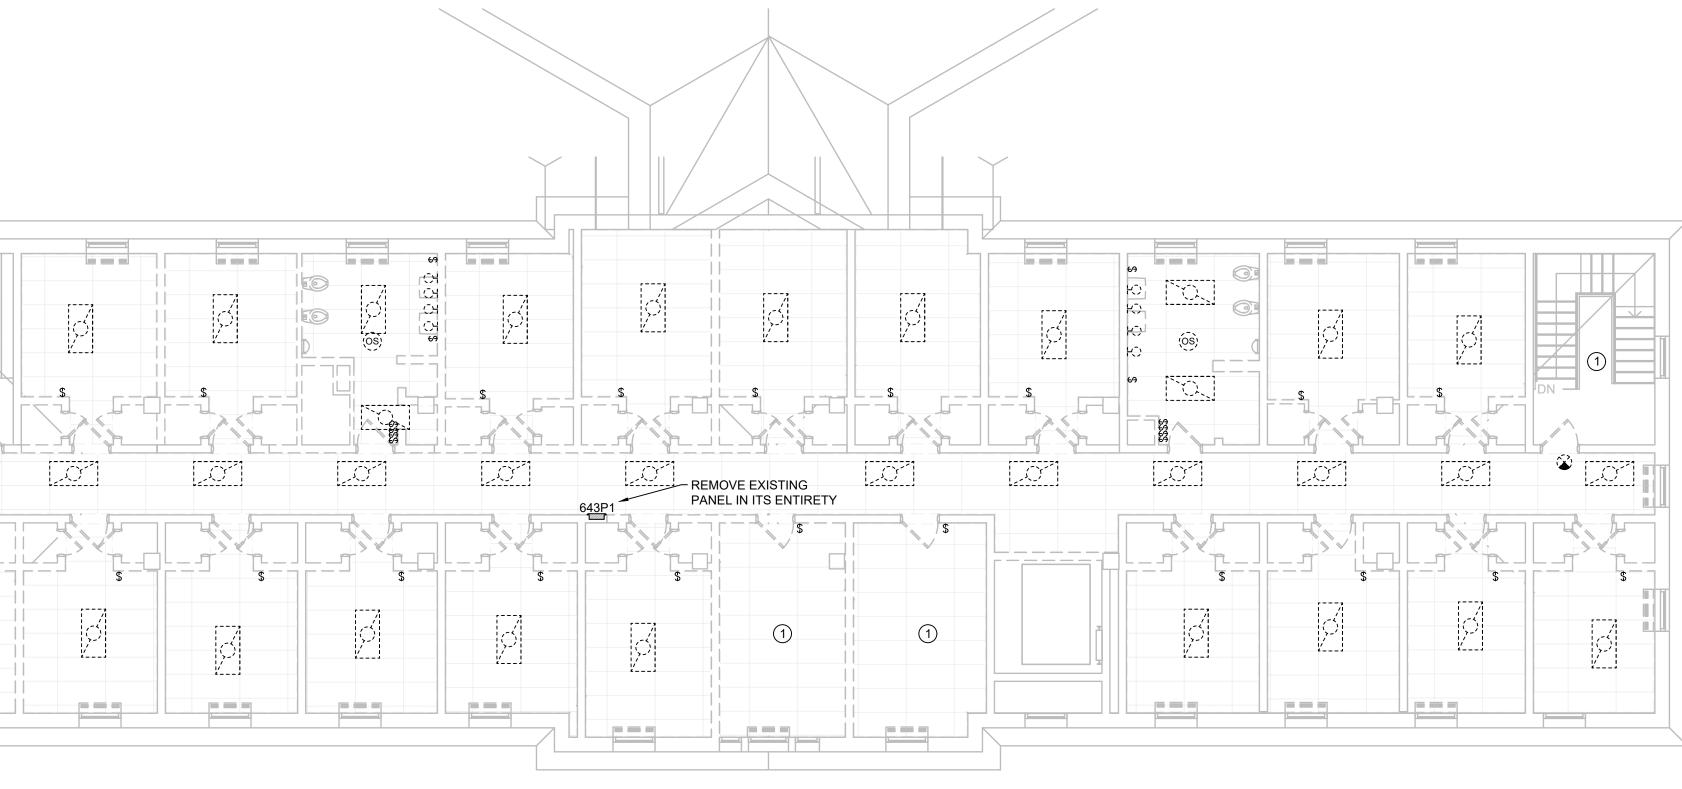
C EXISTING PANELS AND

IGN, INC.	Drav	wing Title SECOND FLOOR LIGHTING PLANS	Project Title BUILDING 64 RENOVATION MEDICAL CEN	- SHERIE		Project Number 666-18-103 Building Number 64
TH DAKOTA 57701 7 ITDESIGN.COM		oroved: Project Director WNEr	Location SHERIDAN, WYO Date AUGUST 28, 2020	DMING Checked RD	Drawn PM - WW	Drawing Number E 202 Dwg. 99 of 1
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e floote inches = one foot				
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1/3/2020 11:41:20 AM one eighth inch = one foot $\begin{pmatrix} 0 & 4 & 8 \\ 0 & 4 & 8 \\ 0 & 4 & 8 \\ 0 & 4 & 8 \\ 0 & 16 \\ 0 & 16 \\ 0 & 16 \\ 0 & 16 \\ 0 & 16 \\ 0 & 0$	Revisions: VA FORM 08-6231	Date	CONSULTANTS TERRASITE DESIGN 1635 DEADWOOD AVENUI RAPID CITY, SOUTH DAKO PH: (605) 791-1736 DAWES ENGINEERING & DESIGN CO. 46 HIBBARD HELENA, MONTANA 59601 PH: (406) 441-4000	MORRISON-MAIERLE 2200 FOOTHILLS BLVD, DTA 57702 GILLETTE, WYOMING 82 PH: (307) 685-3780 SUMMIT COMPANIES 575 MINNEHAHA AVENU
	VATUININ UO-UZJI		1	2





E203 SCALE: 1/8" = 1'

THIRD FLOOR FLOORPLAN - LIGHTING DEMOLITION

3

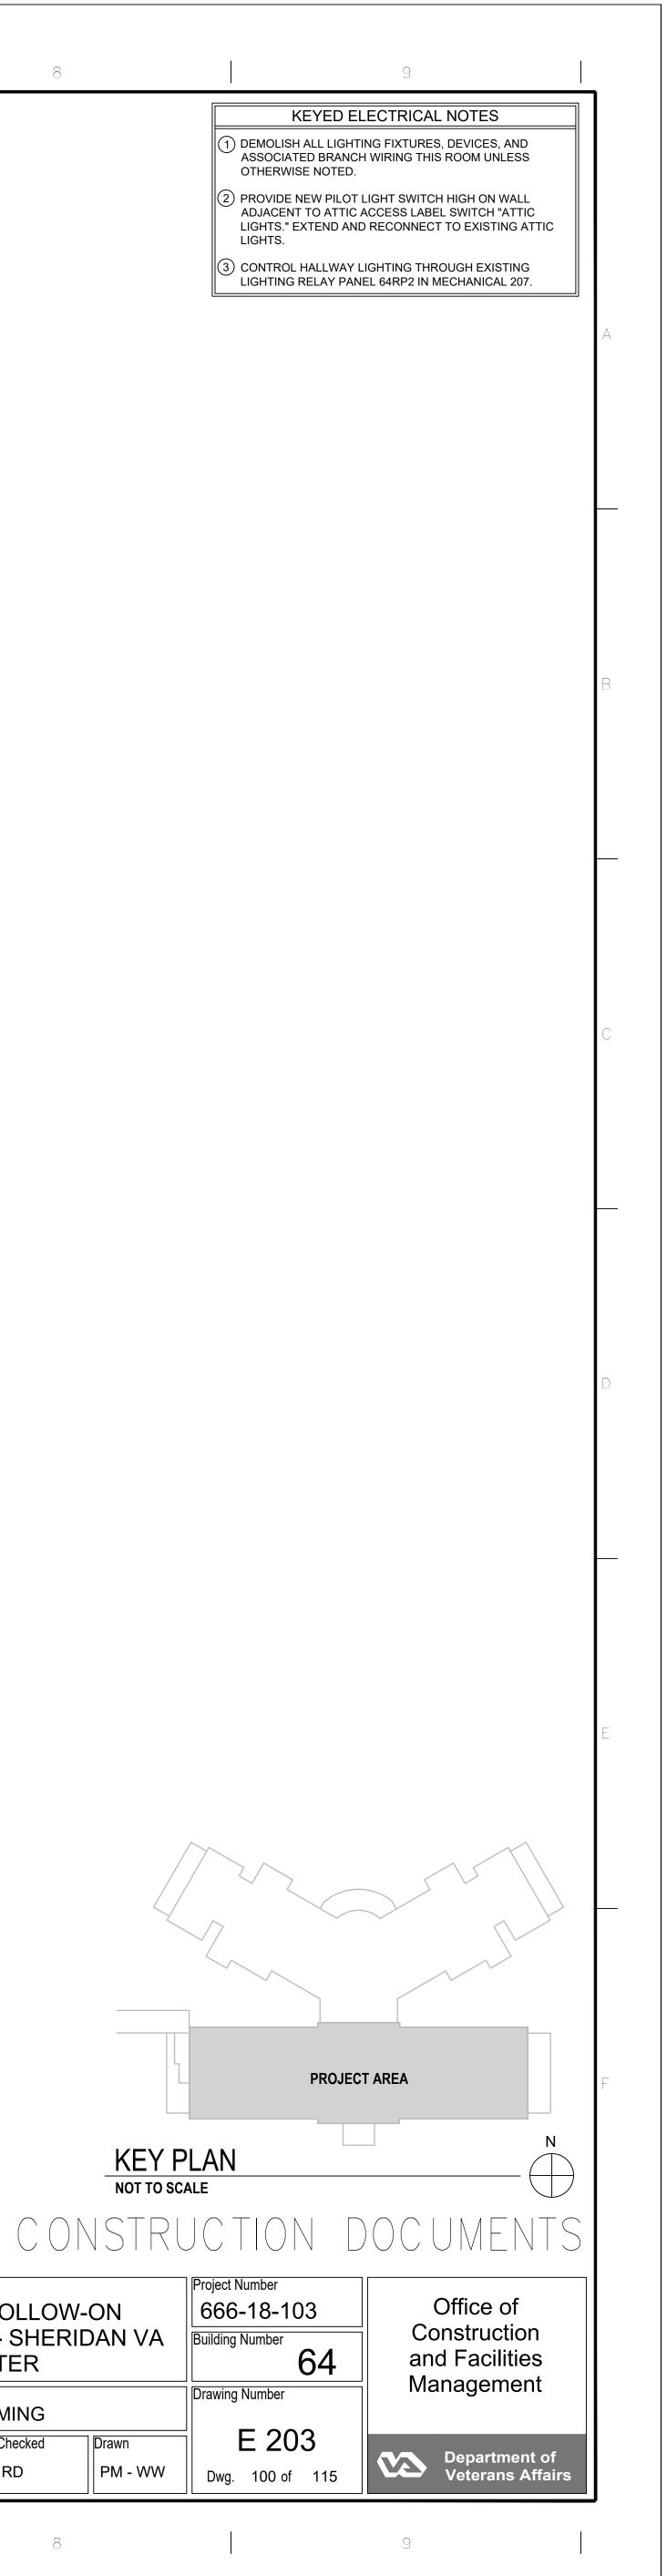
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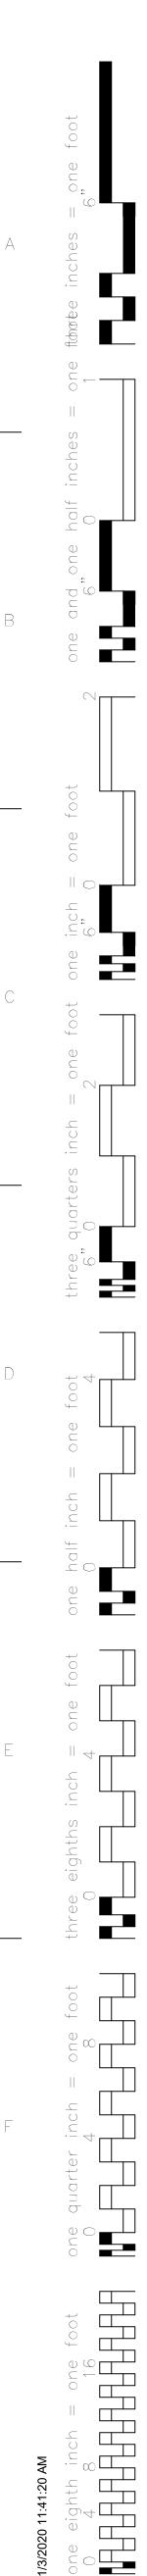
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OTHERWISE NOTED. LIGHTS.

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3 GF	GF	3 GF 3	GF TRI XA
\$os	\$os	\$os GF	\$os GF
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	GF	GF	GF

	Drawing Title THIRD FLOOR LIGHTING PLANS	Project Title BUILDING 64 RENOVATION MEDICAL CEN	I - SHER		Project Number 666-18-103 Building Number 64
	Approved: Project Director Owner	Location SHERIDAN, WY	OMING		Drawing Number
		Date	Checked	Drawn	E 203
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G	~7		0		





√**___**

SYMBOL	*VOICE/DATA DESCRIPTION DATA OUTLET (SUB-SCRIPT REPRESENTS NUMBER OF OUTLETS IN FACEPLATE)	MOUNTING HEIGHT T CENTER LINE
⊲x ∢x	DESCRIPTION DATA OUTLET	
⊲x ∢x	DATA OUTLET	MOUNTING HEIGHT TO CENTER LINE
₹x		
·		18" AFF OR MATCH POW OUTLET
1v	VOICE / DATA OUTLET (SUB-SCRIPT REPRESENTS NUMBER OF OUTLETS IN FACEPLATE)	18" AFF OR MATCH POW OUTLET
⊲+x	DATA OUTLET (SPECIAL MOUNTING HEIGHT) (SUB-SCRIPT REPRESENTS NUMBER OF OUTLETS IN FACEPLATE)	SMH AS NOTED, OR PER ARCH. ELEVATION
₹x	VOICE / DATA OUTLET (SPECIAL MOUNTING HEIGHT) (SUB-SCRIPT REPRESENTS NUMBER OF OUTLETS IN FACEPLATE)	SMH AS NOTED, OR PER ARCH. ELEVATION
⊲x	DATA OUTLET (FLOOR - FLUSH OR BELOW FLOOR) (SUB-SCRIPT REPRESENTS NUMBER OF OUTLETS IN FACEPLATE)	FLUSH FLOOR OR SURFACE MOUNT BO
X	DATA OUTLET (CEILING - FLUSH OR ABOVE CEILING) (SUB-SCRIPT REPRESENTS NUMBER OF OUTLETS IN FACEPLATE)	FLUSH CEILING OR ABOVE CEILING (AC)
	WIRELESS ACCESS POINT CONNECTION	WALL, CEILING OR ABO CEILING
-0-	DIRECTIONAL ANTENNA	WALL, CEILING OR ABC
-0-	OMNI-DIRECTIONAL ANTENNA - PURPLE CABLING	WALL, CEILING OR ABC
-(T)-	TELEMETRY ANTENNA	CEILING OR ABOVE CEILING
 ◀ w	WALL PHONE VOICE OUTLET	+54" AFF OR PER ARCH. ELEVATION
TGB	TELECOMMUNICATIONS GROUNDING BAR (ELEVATION VIEW)	WALL MOUNTED OR AS VENDOR SPECIFIE
⊲та	DATA OUTLET (SPECIAL MOUNTING HEIGHT) (TIME AND ATTENDANCE)	SMH AS NOTED, OR PER ARCH. ELEVATION
<₽	DICTATION OUTLET - SMH	SMH AS NOTED, OR PER ARCH. ELEVATION
⊲D	DICTATION OUTLET	18" AFF OR MATCH POW OUTLET
¢еwв	ELECTRONIC WHITE BOARD	SMH AS NOTED, OR PER ARCH. ELEVATION
	* CLOCKS	
SYMBOL	DESCRIPTION	MOUNTING HEIGHT TO CENTER LINE
(C)IL	INTERVAL TIMER	CEILING OR WALL;PE ARCH. ELEVATIONS
© _{DM}	DIGITAL MASTER CLOCK SINGLE FACE	CEILING OR WALL;PE ARCH. ELEVATIONS
C AM	ANALOG MASTER CLOCK SINGLE FACE	CEILING OR WALL;PE ARCH. ELEVATIONS
© _{MM}	MILITARY MASTER CLOCK SINGLE FACE	CEILING OR WALL;PE ARCH. ELEVATIONS
C2 _{DM}	DIGITAL MASTER CLOCK DOUBLE FACE	CEILING OR WALL;PE ARCH. ELEVATIONS
C2 _{AM}	ANALOG MASTER CLOCK DOUBLE FACE	CEILING OR WALL;PE ARCH. ELEVATIONS
	MILITARY MASTER CLOCK DOUBLE FACE	CEILING OR WALL;PE ARCH. ELEVATIONS
ET	ELAPSED TIMER CONTROL	WALL MOUNTED AT 44
	*AUDIO/VISUAL	
SYMBOL	DESCRIPTION	MOUNTING HEIGHT T
AP	AMPLIFIER	SHELF OR RACK MOUNT

AP	AMPLIFIER	SHELF OR RACK MOUNTED			
AV	AUDIO/VISUAL WALL INTERFACE (CONFIGURATION DETERMINED BY OWNER)	WALL OR FLOOR			
DV	DVD PLAYER	SHELF OR AS SPECIFIED			
М	MICROPHONE JACK	WALL, CEILING, OR AS SPECIFIED			
MS	MUSIC SOURCE INTERFACE	WALL OR PER OWNER DIRECTION			
Pd	OVERHEAD PROJECTOR	CEILING			
RA	REGISTRAR AVAILABLE ANNUNCIATOR	DESK OR WALL			
RB	REGISTRAR AVAILABLE PUSHBUTTON	DESK OR WALL			
S	MUSIC/LOCAL SPEAKER	CEILING OR WALL			
\square	SATELLITE ANTENNA	ROOF			
SM	COMBINATION SPEAKER/MICROPHONE	CEILING OR WALL			
V	VOLUME CONTROL	46" AFF OR PER ARCHITECT WALL ELEVATION			
МС	MEDIA CONTROLLER	WALL			
* TELEVISION					
SYMBOL	DESCRIPTION	MOUNTING HEIGHT TO CENTER LINE			
		+18" AFF. MATCH POWER.			

TV	TV OUTLET	+18" AFF, MATCH POWER, OR PER ARCH. ELEVATIONS
TV D	COMBINATION TV / DATA OUTLET	+18" AFF, MATCH POWER, OR PER ARCH. ELEVATIONS
TV _{ND}	COMBINATION TV / DATA / NURSE CALL INTERFACE OUTLET	+18" AFF, MATCH POWER, OR PER ARCH. ELEVATIONS
ΗTV	TV OUTLET (SMH)	SMH AS NOTED OR PER ARCH. ELEVATIONS
HTV D	COMBINATION TV / DATA OUTLET (SMH)	SMH AS NOTED OR PER ARCH. ELEVATIONS
HTV ND	COMBINATION TV / DATA / NURSE CALL INTERFACE OUTLET (SMH)	SMH AS NOTED OR PER ARCH. ELEVATIONS

CONSULTANTS:
TERRASITE DESIGN 1635 DEADWOOD AVENUE RAPID CITY, SOUTH DAKOTA 57702 PH: (605) 791-1736 MORRISON-MAIERLE 2200 FOOTHILLS BLVD GILLETTE, WYOMING 8 PH: (307) 685-3780
DAWES ENGINEERING & DESIGN CO. 46 HIBBARD WAY HELENA, MONTANA 59601 PH: (406) 441-4000SUMMIT COMPANIES 575 MINNEHAHA AVEN ST. PAUL, MINNESOTA PH: (651) 251-1880

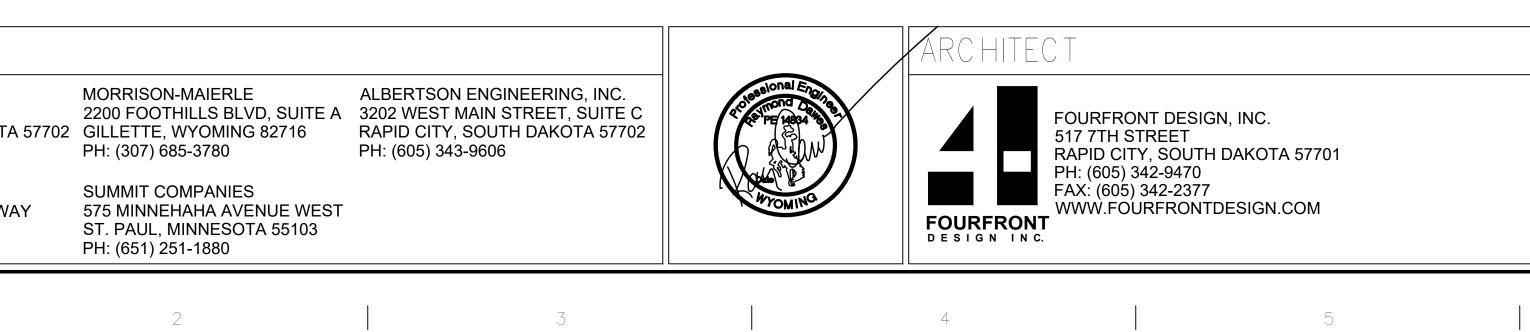
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	*PATHWAY						
SYMBOL	DESCRIPTION	MOUNTING HEIGHT TO CENTER LINE					
J	COMMUNICATIONS JUNCTION BOX	18" AFF, ABOVE CEILING (AC), OR AS NOTED					
нĴ	COMMUNICATIONS JUNCTION BOX - WALL MOUNTED	SMH AS NOTED OR PER ARCH. ELEVATIONS					
	데 1 - 그 1" CONDUIT SLEEVE	ABOVE CEILING THRU WALL					
	E-2-∃ 2" CONDUIT SLEEVE	ABOVE CEILING THRU WALL					
	E— 3 → 3" CONDUIT SLEEVE	ABOVE CEILING THRU WALL					
	E-4-3 4" CONDUIT SLEEVE	ABOVE CEILING THRU WALL					
	\square_1^2 2" MANUFACTURED SLEEVE (ROUND OR SQUARE)						
	\square_{1}^{\perp} 4" MANUFACTURED SLEEVE (ROUND OR SQUARE)						
	MAIN WIRE MANAGEMENT PATHWAY	AS NOTED OR SEE SPECIFICATIONS					
0	CONDUIT UP						
•	CONDUIT DOWN						
\frown	CABLING ENCLOSED IN CONDUIT IN WALL OR CEILING						
\frown	CABLING ENCLOSED IN CONDUIT IN SLAB OR BELOW GRADE						

	PAGING SYSTEM	
SYMBOL	DESCRIPTION	MOUNTING HEIGHT TO CENTER LINE
PS	PAGING SPEAKER	CEILING
V	VOLUME CONTROL	46" AFF OR PER ARCHITECT WALL ELEVATION
V H	PAGING HORN	WALL MOUNTED
	SECURITY	
SYMBOL	DESCRIPTION	MOUNTING HEIGHT TO
CR	SECURITY CARD READER	CENTER LINE 42" AFF OR PER ARCH.
KP	SECURITY KEY PAD	42" AFF OR PER ARCH.
EC	EMERGENCY CALL PHONE	WALL ELEVATION PER VENDOR SHOP
	SECURITY DOOR RELEASE BUTTON	DRAWINGS WALL OR CASEWORK,
	SECURITY DOOR CONTACT	OWNER DIRECTION
BR	BIOMETRIC READER	42" AFF OR PER ARCH.
ws	WINDOW POSITION SENSOR	WALL ELEVATION PER MANUFACTURER
PB	SECURITY PANIC BUTTON	SPECIFICATIONS WALL OR CASEWORK,
PA	PANIC BUTTON ANNUNCIATOR	OWNER DIRECTION PER MANUFACTURER
SP	SECURITY CONTROL PANEL	SPECIFICATIONS 42" AFF OR PER ARCH.
	AUDIBLE ALARM	42" AFF OR PER ARCH.
BC	BELL CHIME	42" AFF OR PER ARCH.
СК		42" AFF OR PER ARCH.
	DOORBELL PUSH BUTTON	42" AFF OR PER ARCH.
EE E	EMERGENCY EXIT BUTTON	42" AFF OR PER ARCH.
GB	GLASS BREAK SENSOR	42" AFF OR PER ARCH.
KS KS	CARD READER KEY SWITCH	42" AFF OR PER ARCH.
MD	MOTION DETECTOR	42" AFF OR PER ARCH.
		CEILING MOUNTED
		CEILING MOUNTED
	INFANT PROTECTION CONTROL UNIT	18" AFF OR PER ARCH.
		42" AFF OR PER ARCH.
RX		WALL ELEVATION
SM		CEILING MOUNTED
	SECURITY CCTV CAMERA - PAN / TILT / ZOOM - CEILING MOUNT	WALL MOUNTED
	SECURITY CCTV CAMERA - PAN / TILT / ZOOM - WALL MOUNT	WALL MOONTED
	SECURITY CCTV CAMERA - PAN / TILT / ZOOM, WEATHER PROOF SECURITY CCTV CAMERA - FIXED - CEILING MOUNT	PARAPET
	SECURITY CCTV CAMERA - FIXED - VALL MOUNT	WALL MOUNTED
		WALL MOONTED
	SECURITY CCTV CAMERA - FIXED, WEATHER PROOF	PÁRAPET WALL, POLE, PARAPET,
		OR CEILING
	360° SECURITY CCTV CAMERA	CEILING MOUNTED
	ABBREVIATIONS	
SYMBOL ABC	DESCRIPTION ABOVE COUNTER	
AC	ABOVE CEILING	
AFF	ABOVE FINISHED FLOOR	
CLG	FLUSH CEILING	
FBO	FUSH CEILING	
FBO FLR	FLOOR	
MF	MODULAR FURNITURE	
	ON CENTER	
PACS	PICTURE ARCHIVE AND COMMUNICATION SYSTEM	
PTZ		
RIO		
SMH		
TA		
UON		
W	WALL MOUNTED	
WP	WEATHER PROOF (EXTERIOR APPLICATION)	
+72"	ABOVE FINISHED FLOOR TO CENTER LINE	



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IG SYSTEM	IG	SYS	ГЕМ	
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TELECOMMUNICATIONS / LOW VOLTAGE SYSTEMS GENERAL CONSTRUCTION NOTES

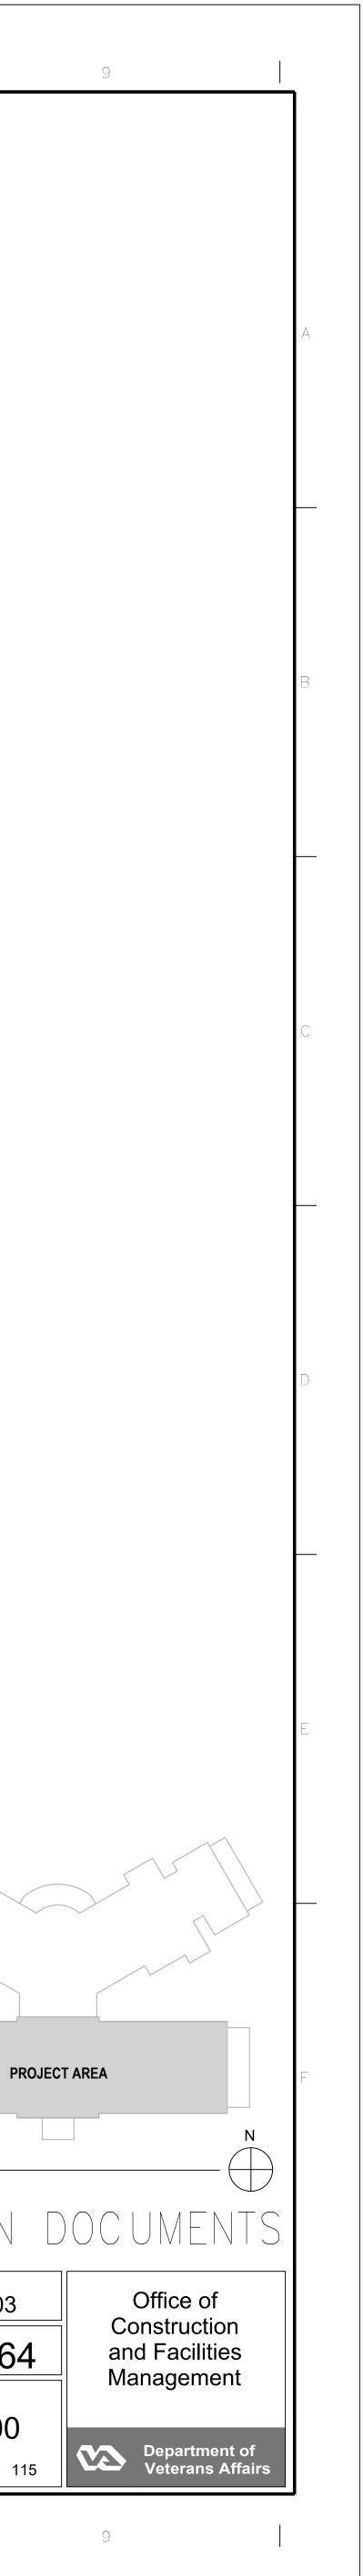
- G1. COORDINATE LOCATION AND MOUNTING REQUIREMENTS OF ALL CEILING MOUNTED OR ABOVE CEILING MOUNTED DEVICES WITH REFLECTED CEILING PLAN, LIGHTING LAYOUT, AND OTHER CEILING OR ABOVE CEILING MOUNTED EQUIPMENT.
- G2. ALL ABOVE CEILING WORK IN EXISTING FACILITY IS TO BE CONDUCTED IN ACCORDANCE WITH FACILITY I.C.R.A. POLICIES.
- G3. REFER TO SHEET 1-T-101 FOR ALL FACE PLATE, BACK BOX, AND CONDUIT SIZE REQUIREMENTS. G4. PATIENT ROOM HEADWALL DEVICES - PRIOR TO ROUGH-IN, COORDINATE
- EXACT DEVICE LOCATIONS, BACKBOX, AND CONDUIT REQUIREMENTS WITH ARCHITECTURAL HEADWALL ELEVATIONS AND OWNER FURNISHED PRE-FABRICATED HEADWALL REQUIREMENTS.
- G5. DEVICES MOUNTED IN/ADJACENT TO CASEWORK PRIOR TO ROUGH-IN, COORDINATE EXACT DEVICE LOCATIONS WITH ARCHITECTURAL CASEWORK ELEVATIONS. COORDINATE WITH CASEWORK SHOP DRAWINGS FOR CABLING PATHWAY AND ROUGH-IN REQUIREMENTS.
- G6. TELEVISION OUTLETS COORDINATE EXACT DEVICE LOCATION WITH TV BRACKET/MOUNTING LOCATION AND ADJACENT TO POWER OUTLET AS INDICATED ON ARCHITECTURAL FLOOR PLANS, ARCHITECTURAL WALL ELEVATIONS, AND ELECTRICAL POWER DRAWINGS.
- G7. DRAWINGS ARE SCHEMATIC IN NATURE AND ARE NOT DRAWN TO SCALE. CONTRACTOR IS RESPONSIBLE FOR COORDINATING EXACT ROUTING OF ALL SERVICES AND DISTANCES WITH EXISTING CONDITIONS AND WITH ALL OTHER TRADES.
- G8. CONDUITS ARE TO HAVE A MAXIMUM 40% FILL RATIO. G9. IN THE INSTALLATION OF THIS WORK, THE CONTRACTOR IS TO COMPLY WITH THE REQUIREMENTS OF LOCAL LAWS AND ORDINANCES, THE LAWS OF THE STATE OF WYOMING, THE NATIONAL BOARD OF FIRE UNDERWRITERS, AND THE NATIONAL ELECTRIC CODE.
- G10. CAREFULLY EXAMINE THE PREMISES TO DETERMINE THE EXTENT OF WORK AND THE CONDITION UNDER WHICH IT MUST BE DONE. IF THERE ARE ANY QUESTIONS REGARDING THE PROJECT, THE CONTRACTOR IS RESPONSIBLE FOR OBTAINING CLARIFICATIONS FROM THE ENGINEER OR DESIGNATED REPRESENTATIVE BEFORE PROCEEDING WITH WORK OR RELATED WORK IN QUESTION.
- G11. ANY DISCREPANCIES BETWEEN THE PLANS AND ACTUAL FIELD CONDITIONS MUST BE BROUGHT TO THE IMMEDIATE ATTENTION OF THE ENGINEER OR DESIGNATED REPRESENTATIVE FOR CLARIFICATION.
- G12. ALL WORK IS TO BE DONE IN A THOROUGH AND PROFESSIONAL MANNER ACCORDING TO INDUSTRY AND MANUFACTURERS' STANDARDS AND WILL BE SUBJECT TO INSPECTION AND ACCEPTANCE. WORK THAT IS DEEMED SUB-STANDARD WILL BE SUBJECT TO REPLACEMENT OR REPAIR AT NO ADDITIONAL COST TO THE OWNER OR GENERAL CONTRACTOR.
- G13. THE CONTRACTOR IS REQUIRED TO PROPERLY FIRE-STOP ANY WALL OR FLOOR PENETRATIONS UTILIZED FOR THE PLACEMENT OF COMMUNICATIONS CABLING WITH APPROVED FIRE-STOPPING COMPOUND AND ACCORDING TO LOCAL AND NATIONAL CODES.
- G14. ANY DISCREPANCIES BETWEEN THE PLANS AND ACTUAL PROJECT SPECIFICATIONS MUST BE BROUGHT TO THE IMMEDIATE ATTENTION OF THE ENGINEER OR DESIGNATED REPRESENTATIVE FOR CLARIFICATION.
- G15. ALL PENETRATED STRUCTURES ARE TO BE RETURNED TO ORIGINAL CONDITION AND FIRE RATING.
- G16. REPRESENTATION OF OUTSIDE PLANT CABLE, PATHWAY, AND FACILITIES IS APPROXIMATE AND SCHEMATIC IN NATURE. DO NOT RELY ON PLANS FOR DETERMINATION AND COORDINATION OF EXACT LOCATIONS. VERIFY ALL PERTINENT CONDITIONS AND LOCATIONS WITH THE CIVIL ENGINEER AND UTILITY LOCATION SERVICES PRIOR TO PERFORMING WORK.

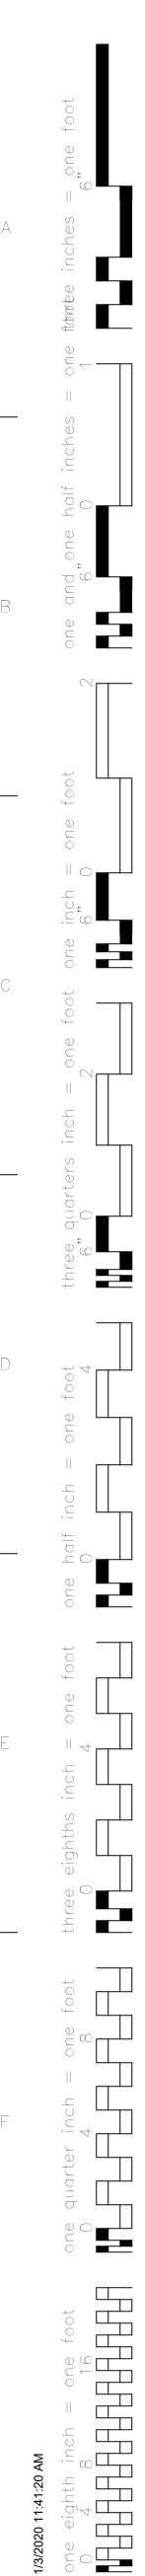
TELECOMMUNICATIONS / LOW VOLTAGE SYSTEMS GENERAL DEMOLITION NOTES

- D1. DEMOLITION REQUIREMENTS INCLUDE ONLY THE SCOPE OF COMMUNICATION/ LOW VOLTAGE WORK ON THESE DRAWINGS. REFER TO ELECTRICAL DRAWINGS FOR ADDITIONAL COMMUNICATIONS/LOW VOLTAGE DEMOLITION REQUIREMENTS.
- D2. BEFORE DEMOLITION OF ANY CONDUIT OR CABLING, VERIFY ALL DEVICES AND SYSTEMS BEING SERVED OUTSIDE CONSTRUCTION AREA. VERIFY WITH OWNER OR DEPARTMENT SUPERVISOR BEFORE DISRUPTING ANY SERVICES AFFECTED OUTSIDE THE CONSTRUCTION AREA. ANY EXISTING DEVICES AND SYSTEMS DISRUPTED BY DEMOLITION ARE TO BE RESTORED TO OPERATION IMMEDIATELY OR WITHIN TIME AGREED UPON WITH OWNER.
- D3. ALL DEVICES LOCATED IN WALLS, CEILINGS, AND ON OR IN FURNITURE INDICATED BY THE ARCHITECT TO BE REMOVED ARE LIKEWISE TO BE REMOVED. REMOVE ALL CABLING BACK TO POINT OF ORIGIN. REMOVED DEVICES ARE TO BE OFFERED FIRST TO OWNER PRIOR TO DISPOSAL. CONSULT WITH OWNER FOR STORAGE LOCATION AND REQUIREMENTS OF DEVICES RETAINED FOR FUTURE USE.
- D4. EXISTING DEVICES TO REMAIN OR TO BE REUSED ARE TO BE THOROUGHLY CLEANED AND TESTED FOR PROPER OPERATION.
- D5. EXISTING CONDUITS TO BE REUSED ARE TO BE CLEANED OUT BEFORE INSTALLATION OF NEW CABLING.
- D6. AREAS WHERE LOW VOLTAGE DEVICES OR CONDUITS ARE REMOVED ARE TO BE REPAIRED TO MATCH EXISTING FINISHES. CONSULT WITH GENERAL CONTRACTOR FOR REPAIRS TO BE MADE BY APPROPRIATE TRADES.
- D7. ALL EXISTING LOW VOLTAGE CABLING IS TO BE INDEPENDENTLY SUSPENDED ABOVE NEW CEILING IN ACCORDANCE WITH INDUSTRY STANDARDS AND CLEARANCES. NO CABLING IS TO BE TIED TO STRUCTURE, CONDUITS, PIPING, DUCTS, OR ANY ABOVE CEILING EQUIPMENT.
- D8. ALL LOW VOLTAGE CABLING QUANTIFIED IN DRAWING ARE APPROXIMATE. EXACT QUANTITIES, POINT OF ORIGIN AND TERMINATION ARE TO BE FIELD VERIFIED. COORDINATE WITH OWNER BEFORE CUTTING, REPLACING OR REROUTING ANY LOW VOLTAGE CABLING.
- D9. ALL ABANDONED LOW VOLTAGE CABLING IS TO BE REMOVED.

		SHEET	SHEET -	TITLE			-
		NUMBER	COMMUNICATIONS CODES AND F				
		T 000	COMMUNICATIONS CODES AND F		-1	KEY P	
		T 002	COMMUNICATIONS DETAILS		-1		
		T 100	BASEMENT AND FIRST FLOOR CA	ABLE PATHWAY PLANS	1	NOT TO SC	ALE
		T 101	SECOND AND THIRD FLOOR CAB	LE PATHWAY PLANS			
		T 200	BASEMENT AND FIRST FLOOR DA	ATA PLANS		$\langle C D $	
		T 201	SECOND AND THIRD FLOOR DAT	A PLANS		$V \supset I \mid V \subset V$	
	-						
Dr	awing Title			Project Title			Project Number
	C	OMMUNICATIC		BUILDING 64 F	OLLOW	-ON	666-18-10
	CODES AND REQUIREMENTS			RENOVATION - SHERIDAN VA		DAN VA	Building Number
		NEQUINEMENT	15	MEDICAL CEN	TER		6
	oproved: Project Director			Location			Drawing Number
	Dwner			SHERIDAN, WYC	MING		
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Sheet List Table





	CONDUIT REQUIREMENTS	
SYMBOL	BACK BOX AND PLASTER RING SIZE	CONDUIT SIZE
⊲x	4" x 4" x 2 1/2" WITH SINGLE GANG MUD RING	1"
∢x	4" x 4" x 2 1/2" WITH SINGLE GANG MUD RING	1"
<¦×	4" x 4" x 2 1/2" WITH SINGLE GANG MUD RING	1"
√x	4" x 4" x 2 1/2" WITH SINGLE GANG MUD RING	1"
\bigcirc	4" x 4" x 2 1/2" WITH SINGLE GANG MUD RING	1"
$\overline{\bigcirc}$	4" x 4" x 2 1/2" WITH SINGLE GANG MUD RING	1"
- - -	4" x 4" x 2 1/2" IF WALL MOUNTED	1"
-0-	4" x 4" x 2 1/2" IF WALL MOUNTED	1"
- <u></u>	4" x 4" x 2 1/2" IF WALL MOUNTED	1"
-Ū-	N/A	N/A
↓ ↓ w	4" x 4" x 2 1/2"	1"
TGB	N/A	N/A
⊲-та	4" x 4" x 2 1/2"	1"
<₽	4" x 4" x 2 1/2"	1"
QD	4" x 4" x 2 1/2"	1"
¢еwв	4" x 4" x 2 1/2"	1"
	4" x 4" x 2 1/2" WITH SINGLE GANG MUD RING 4" x 4" x 2 1/2" WITH SINGLE GANG MUD RING 4" x 4" x 2 1/2" WITH SINGLE GANG MUD RING	1" 1" 1"
SYMBOL	AUDIO / VISUAL BACK BOX & CONDUIT REQUIREMENTS BACK BOX AND PLASTER RING SIZE	CONDUIT SIZE
AP	N/A	N/A
AV	3 GANG	
DV		1 1/4"
	4" x 4" x 2 1/2" WITH SINGLE GANG MUD RING	1 1/4"
Μ	4" x 4" x 2 1/2" WITH SINGLE GANG MUD RING4" x 4" x 2 1/2" WITH SINGLE GANG MUD RING	
M		1 1/4"
	4" x 4" x 2 1/2" WITH SINGLE GANG MUD RING	1 1/4"
MS	4" x 4" x 2 1/2" WITH SINGLE GANG MUD RING 4" x 4" x 2 1/2" WITH SINGLE GANG MUD RING	1 1/4" 1" 1"
	4" x 4" x 2 1/2" WITH SINGLE GANG MUD RING 4" x 4" x 2 1/2" WITH SINGLE GANG MUD RING N/A	1 1/4" 1" 1" N/A
MS PQ RA	4" x 4" x 2 1/2" WITH SINGLE GANG MUD RING 4" x 4" x 2 1/2" WITH SINGLE GANG MUD RING N/A 4" x 4" x 2 1/2" WITH SINGLE GANG MUD RING	1 1/4" 1" 1" N/A 1" 1"
MS P√ RA RB	4" x 4" x 2 1/2" WITH SINGLE GANG MUD RING 4" x 4" x 2 1/2" WITH SINGLE GANG MUD RING N/A 4" x 4" x 2 1/2" WITH SINGLE GANG MUD RING 4" x 4" x 2 1/2" WITH SINGLE GANG MUD RING 4" x 4" x 2 1/2" WITH SINGLE GANG MUD RING	1 1/4" 1" 1" N/A 1" 1"
MS P↓ RA RB S	4" x 4" x 2 1/2" WITH SINGLE GANG MUD RING 4" x 4" x 2 1/2" WITH SINGLE GANG MUD RING N/A 4" x 4" x 2 1/2" WITH SINGLE GANG MUD RING 4" x 4" x 2 1/2" WITH SINGLE GANG MUD RING 4" x 4" x 2 1/2" WITH SINGLE GANG MUD RING 4" x 4" x 2 1/2" WITH SINGLE GANG MUD RING 4" x 4" x 2 1/2" WITH SINGLE GANG MUD RING	1 1/4" 1" 1" N/A 1" 1" 1" 1" IF WALL MOUNTE 1"
MS PV RA RB S	4" x 4" x 2 1/2" WITH SINGLE GANG MUD RING 4" x 4" x 2 1/2" WITH SINGLE GANG MUD RING N/A 4" x 4" x 2 1/2" WITH SINGLE GANG MUD RING 4" x 4" x 2 1/2" WITH SINGLE GANG MUD RING 4" x 4" x 2 1/2" WITH SINGLE GANG MUD RING 4" x 4" x 2 1/2" WITH SINGLE GANG MUD RING 4" x 4" x 2 1/2" WITH SINGLE GANG MUD RING 4" x 4" x 2 1/2" WITH SINGLE GANG MUD RING 4" x 4" x 2 1/2" WITH SINGLE GANG MUD RING N/A	1 1/4" 1" 1" N/A 1" 1" 1" 1" IT WALL MOUNTE 1"
MS P√ RA RB S SM SM	4" x 4" x 2 1/2" WITH SINGLE GANG MUD RING 4" x 4" x 2 1/2" WITH SINGLE GANG MUD RING N/A 4" x 4" x 2 1/2" WITH SINGLE GANG MUD RING 4" x 4" x 2 1/2" WITH SINGLE GANG MUD RING 4" x 4" x 2 1/2" WITH SINGLE GANG MUD RING 4" x 4" x 2 1/2" WITH SINGLE GANG MUD RING 4" x 4" x 2 1/2" WITH SINGLE GANG MUD RING IF WALL MOUNTED N/A 4" x 4" x 2 1/2" WITH SINGLE GANG MUD RING IF WALL MOUNTED 4" x 4" x 2 1/2" WITH SINGLE GANG MUD RING IF WALL MOUNTED 4" x 4" x 2 1/2" WITH SINGLE GANG MUD RING IF WALL MOUNTED 4" x 4" x 2 1/2" WITH SINGLE GANG MUD RING IF WALL MOUNTED 4" x 4" x 2 1/2" WITH SINGLE GANG MUD RING IF WALL MOUNTED	1 1/4" 1" 1" N/A 1" 1" 1" 1" IF WALL MOUNTE 1" 1" IF WALL MOUNTE
MS P√ RA RB S SM SM	4" x 4" x 2 1/2" WITH SINGLE GANG MUD RING 4" x 4" x 2 1/2" WITH SINGLE GANG MUD RING N/A 4" x 4" x 2 1/2" WITH SINGLE GANG MUD RING 4" x 4" x 2 1/2" WITH SINGLE GANG MUD RING 4" x 4" x 2 1/2" WITH SINGLE GANG MUD RING 4" x 4" x 2 1/2" WITH SINGLE GANG MUD RING 4" x 4" x 2 1/2" WITH SINGLE GANG MUD RING IF WALL MOUNTED N/A 4" x 4" x 2 1/2" WITH SINGLE GANG MUD RING IF WALL MOUNTED 4" x 4" x 2 1/2" WITH SINGLE GANG MUD RING IF WALL MOUNTED 4" x 4" x 2 1/2" WITH SINGLE GANG MUD RING IF WALL MOUNTED	1 1/4" 1" 1" N/A 1" 1" 1" 1" IF WALL MOUNTE 1" 1" IF WALL MOUNTE
MS P√ RA RB S SM V	4" x 4" x 2 1/2" WITH SINGLE GANG MUD RING 4" x 4" x 2 1/2" WITH SINGLE GANG MUD RING N/A 4" x 4" x 2 1/2" WITH SINGLE GANG MUD RING 4" x 4" x 2 1/2" WITH SINGLE GANG MUD RING 4" x 4" x 2 1/2" WITH SINGLE GANG MUD RING IF WALL MOUNTED N/A 4" x 4" x 2 1/2" WITH SINGLE GANG MUD RING IF WALL MOUNTED 4" x 4" x 2 1/2" WITH SINGLE GANG MUD RING IF WALL MOUNTED 4" x 4" x 2 1/2" WITH SINGLE GANG MUD RING IF WALL MOUNTED INTERCOM BACK BOX & CONDUIT REQUIREMENTS	1 1/4" 1" 1" N/A 1" 1" 1" 1" 1" 1" 1" 1" 1" 1" 1" 1" 1"
MS P RA RB S S S S S S S S S C C C C C C C C C C C C C	4" x 4" x 2 1/2" WITH SINGLE GANG MUD RING 4" x 4" x 2 1/2" WITH SINGLE GANG MUD RING N/A 4" x 4" x 2 1/2" WITH SINGLE GANG MUD RING 4" x 4" x 2 1/2" WITH SINGLE GANG MUD RING 4" x 4" x 2 1/2" WITH SINGLE GANG MUD RING IF WALL MOUNTED N/A 4" x 4" x 2 1/2" WITH SINGLE GANG MUD RING IF WALL MOUNTED A" x 4" x 2 1/2" WITH SINGLE GANG MUD RING IF WALL MOUNTED 4" x 4" x 2 1/2" WITH SINGLE GANG MUD RING IF WALL MOUNTED A" x 4" x 2 1/2" WITH SINGLE GANG MUD RING IF WALL MOUNTED AT X 4" x 2 1/2" WITH SINGLE GANG MUD RING IF WALL MOUNTED AT X 4" x 2 1/2" WITH SINGLE GANG MUD RING IF WALL MOUNTED AT X 4" x 2 1/2" WITH SINGLE GANG MUD RING IF WALL MOUNTED AT X 4" x 2 1/2" WITH SINGLE GANG MUD RING IF WALL MOUNTED AT X 4" X 2 1/2" WITH SINGLE GANG MUD RING AT X 4" X 2 1/2" WITH SINGLE GANG MUD RING IF WALL MOUNTED AT X 4" X 2 1/2" WITH SINGLE GANG MUD RING AT X 4" X 2 1/2" WITH SINGLE GANG MUD RING AT X 4" X 2 1/2" WITH SINGLE GANG MUD RING AT X 4" X 2 1/2" WITH SINGLE GANG MUD RING AT X 4" X 2 1/2" WITH SINGLE GANG MUD RING AT X 4" X 2 1/2" WITH SINGLE GANG MUD RING AT X 4" X 2 1/2" WITH SINGLE GANG MUD RING AT X 4" X 2 1/2" WITH SINGLE GANG MUD RING AT X 4" X 2 1/2" WITH SINGLE GANG MUD RING AT X 4" X 2 1/2" WITH SINGLE GANG MUD RING AT X 4" X 2 1/2" WITH SINGLE GANG MUD RING AT X 4" X 2 1/2" WITH SINGLE GANG MUD RING AT X 4" X 2 1/2" WITH SINGLE GANG MUD RING AT X 4" X 2 1/2" WITH SINGLE GANG MUD RING AT X 4" X 2 1/2" WITH SINGLE GANG MUD RING AT X 4" X 2 1/2" WITH SINGLE GANG MUD RING AT X 4" X 2 1/2" WITH SINGLE GANG MUD RING AT X 4" X 4" X 2 1/2" WITH SINGLE GANG MUD RING AT X 4" X 4" X 2 1/2" WITH SINGLE GANG MUD RING AT X 4" X 4" X 2 1/2" WITH SINGLE GANG MUD RING AT X 4" X 4" X 2 1/2" WITH SINGLE GANG MUD RING AT X 4" X 4" X 4 X 4 X 4 X 4 X 4 X 4 X 4 X	1 1/4" 1" 1" 1" N/A 1" 1" 1" 1" 1" 1" 1" 1" 1" 1" 1" 1" 1"
MS P RA RB S SM V SM V SM SM V SM V SM V C C C C C C C C C C C C C	4" x 4" x 2 1/2" WITH SINGLE GANG MUD RING 4" x 4" x 2 1/2" WITH SINGLE GANG MUD RING N/A 4" x 4" x 2 1/2" WITH SINGLE GANG MUD RING 4" x 4" x 2 1/2" WITH SINGLE GANG MUD RING 4" x 4" x 2 1/2" WITH SINGLE GANG MUD RING IF WALL MOUNTED N/A 4" x 4" x 2 1/2" WITH SINGLE GANG MUD RING IF WALL MOUNTED 4" x 4" x 2 1/2" WITH SINGLE GANG MUD RING IF WALL MOUNTED 4" x 4" x 2 1/2" WITH SINGLE GANG MUD RING IF WALL MOUNTED AT X 4" x 2 1/2" WITH SINGLE GANG MUD RING IF WALL MOUNTED 4" x 4" x 2 1/2" WITH SINGLE GANG MUD RING AT X 4" x 2 1/2" WITH SINGLE GANG MUD RING AT X 4" x 2 1/2" WITH SINGLE GANG MUD RING AT X 4" x 2 1/2" WITH SINGLE GANG MUD RING AT X 4" x 2 1/2" WITH SINGLE GANG MUD RING AT X 4" x 2 1/2" WITH SINGLE GANG MUD RING AT X 4" x 2 1/2" WITH SINGLE GANG MUD RING	1 1/4" 1" 1" 1" N/A 1" 1" 1" 1" 1" 1" 1" 1" 1" 1" 1" 1" 1"
MS PV RA RB S SM V SM V SYMBOL (D)	4" x 4" x 2 1/2" WITH SINGLE GANG MUD RING 4" x 4" x 2 1/2" WITH SINGLE GANG MUD RING N/A 4" x 4" x 2 1/2" WITH SINGLE GANG MUD RING 4" x 4" x 2 1/2" WITH SINGLE GANG MUD RING 4" x 4" x 2 1/2" WITH SINGLE GANG MUD RING 4" x 4" x 2 1/2" WITH SINGLE GANG MUD RING 4" x 4" x 2 1/2" WITH SINGLE GANG MUD RING IF WALL MOUNTED N/A 4" x 4" x 2 1/2" WITH SINGLE GANG MUD RING IF WALL MOUNTED 4" x 4" x 2 1/2" WITH SINGLE GANG MUD RING INTERCOM BACK BOX & CONDUIT REQUIREMENTS BACK BOX AND PLASTER RING SIZE 4" x 4" x 2 1/2" WITH SINGLE GANG MUD RING 4" x 4" x 2 1/2" WITH SINGLE GANG MUD RING	1 1/4" 1" 1" 1" N/A 1" 1" 1" 1" 1" 1" 1" 1" 1" 1" 1" 1" 1"
MS P RA RB S S S S M V S S M V S M V N C C C C C C C C C C C C C	4" x 4" x 2 1/2" WITH SINGLE GANG MUD RING 4" x 4" x 2 1/2" WITH SINGLE GANG MUD RING N/A 4" x 4" x 2 1/2" WITH SINGLE GANG MUD RING 4" x 4" x 2 1/2" WITH SINGLE GANG MUD RING 4" x 4" x 2 1/2" WITH SINGLE GANG MUD RING IF WALL MOUNTED N/A 4" x 4" x 2 1/2" WITH SINGLE GANG MUD RING IF WALL MOUNTED 4" x 4" x 2 1/2" WITH SINGLE GANG MUD RING IF WALL MOUNTED 4" x 4" x 2 1/2" WITH SINGLE GANG MUD RING IF WALL MOUNTED 4" x 4" x 2 1/2" WITH SINGLE GANG MUD RING EXAMPLE AND PLASTER RING SIZE 4" x 4" x 2 1/2" WITH SINGLE GANG MUD RING 4" x 4" x 2 1/2" WITH SINGLE GANG MUD RING 4" x 4" x 2 1/2" WITH SINGLE GANG MUD RING 4" x 4" x 2 1/2" WITH SINGLE GANG MUD RING 4" x 4" x 2 1/2" WITH SINGLE GANG MUD RING 4" x 4" x 2 1/2" WITH SINGLE GANG MUD RING 4" x 4" x 2 1/2" WITH SINGLE GANG MUD RING	1 1/4" 1" 1" 1" N/A 1" N/A 1" 1" 1" 1" 1" 1" 1" 1" 1" 1" 1" 1" 1"
	4" x 4" x 2 1/2" WITH SINGLE GANG MUD RING 4" x 4" x 2 1/2" WITH SINGLE GANG MUD RING N/A 4" x 4" x 2 1/2" WITH SINGLE GANG MUD RING 4" x 4" x 2 1/2" WITH SINGLE GANG MUD RING 4" x 4" x 2 1/2" WITH SINGLE GANG MUD RING IF WALL MOUNTED N/A 4" x 4" x 2 1/2" WITH SINGLE GANG MUD RING IF WALL MOUNTED 4" x 4" x 2 1/2" WITH SINGLE GANG MUD RING IF WALL MOUNTED 4" x 4" x 2 1/2" WITH SINGLE GANG MUD RING IF WALL MOUNTED 4" x 4" x 2 1/2" WITH SINGLE GANG MUD RING 4" x 4" x 2 1/2" WITH SINGLE GANG MUD RING 4" x 4" x 2 1/2" WITH SINGLE GANG MUD RING 4" x 4" x 2 1/2" WITH SINGLE GANG MUD RING 4" x 4" x 2 1/2" WITH SINGLE GANG MUD RING 4" x 4" x 2 1/2" WITH SINGLE GANG MUD RING 4" x 4" x 2 1/2" WITH SINGLE GANG MUD RING 4" x 4" x 2 1/2" WITH SINGLE GANG MUD RING 4" x 4" x 2 1/2" WITH SINGLE GANG MUD RING 4" x 4" x 2 1/2" WITH SINGLE GANG MUD RING	1 1/4" 1" 1" 1" N/A 1" 1" 1" 1" 1" 1" 1" 1" 1" 1" 1" 1" 1"

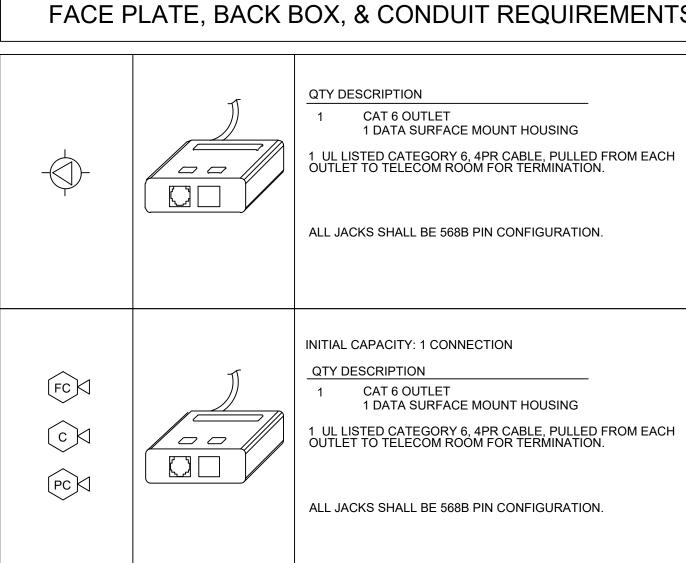
		- CONSULTANTS:	
		TERRASITE DESIGN 1635 DEADWOOD AVENUE RAPID CITY, SOUTH DAKOTA 57702 PH: (605) 791-1736	MORRISON-MAIERLE 2200 FOOTHILLS BLVD GILLETTE, WYOMING 8 PH: (307) 685-3780
Revisions:	Date	DAWES ENGINEERING & DESIGN CO. 46 HIBBARD WAY HELENA, MONTANA 59601 PH: (406) 441-4000	SUMMIT COMPANIES 575 MINNEHAHA AVEN ST. PAUL, MINNESOTA PH: (651) 251-1880

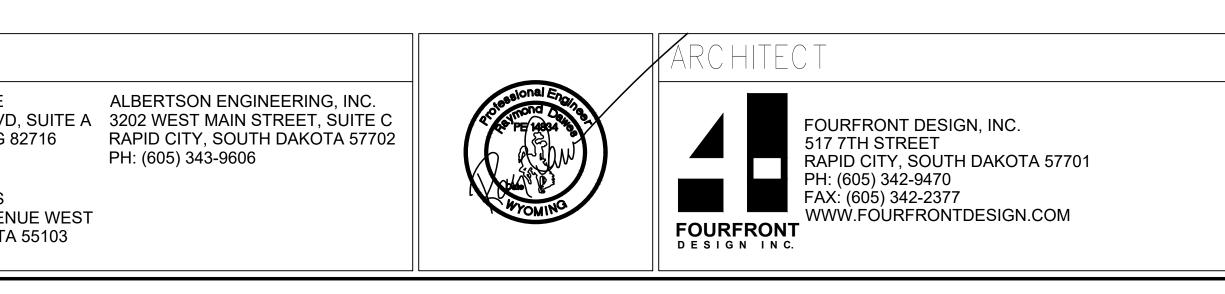
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	TELEVISION BACK BOX & CONDUIT REQUIREMENTS	
SYMBOL	BACK BOX AND PLASTER RING SIZE	CONDUIT SIZE
TV	4" x 4" x 2 1/2" WITH SINGLE GANG MUD RING	1"
TV D	4" x 4" x 2 1/2" WITH SINGLE GANG MUD RING	1"
TV _{ND}	4" x 4" x 2 1/2" WITH SINGLE GANG MUD RING	1"
ΗTV	4" x 4" x 2 1/2" WITH SINGLE GANG MUD RING	1"
^μ TV _D	4" x 4" x 2 1/2" WITH SINGLE GANG MUD RING	1"
	PATHWAY BACK BOX & CONDUIT REQUIREMENTS	
SYMBOL	BACK BOX AND PLASTER RING SIZE	CONDUIT SIZE
J	4" x 4" x 2 1/2" WITH SINGLE GANG MUD RING	N/A
۴Ĵ	4" x 4" x 2 1/2" WITH SINGLE GANG MUD RING	1"
	PAGING SYSTEM BACK BOX & CONDUIT REQUIREMENTS	
SYMBOL	BACK BOX AND PLASTER RING SIZE	CONDUIT SIZE
PS	VENDOR PROVIDED	N/A
V	4" x 4" x 2 1/2" WITH SINGLE GANG MUD RING	1"
∇ H	4" x 4" x 2 1/2" WITH SINGLE GANG MUD RING	1"
	RADIO BACK BOX & CONDUIT REQUIREMENTS	
SYMBOL	DESCRIPTION	MOUNTING HEIGHT TO CENTER LINE
EMS	4" x 4" x 2 1/2" WITH SINGLE GANG MUD BOX	1"
HAM	4" x 4" x 2 1/2" WITH SINGLE GANG MUD BOX	1"

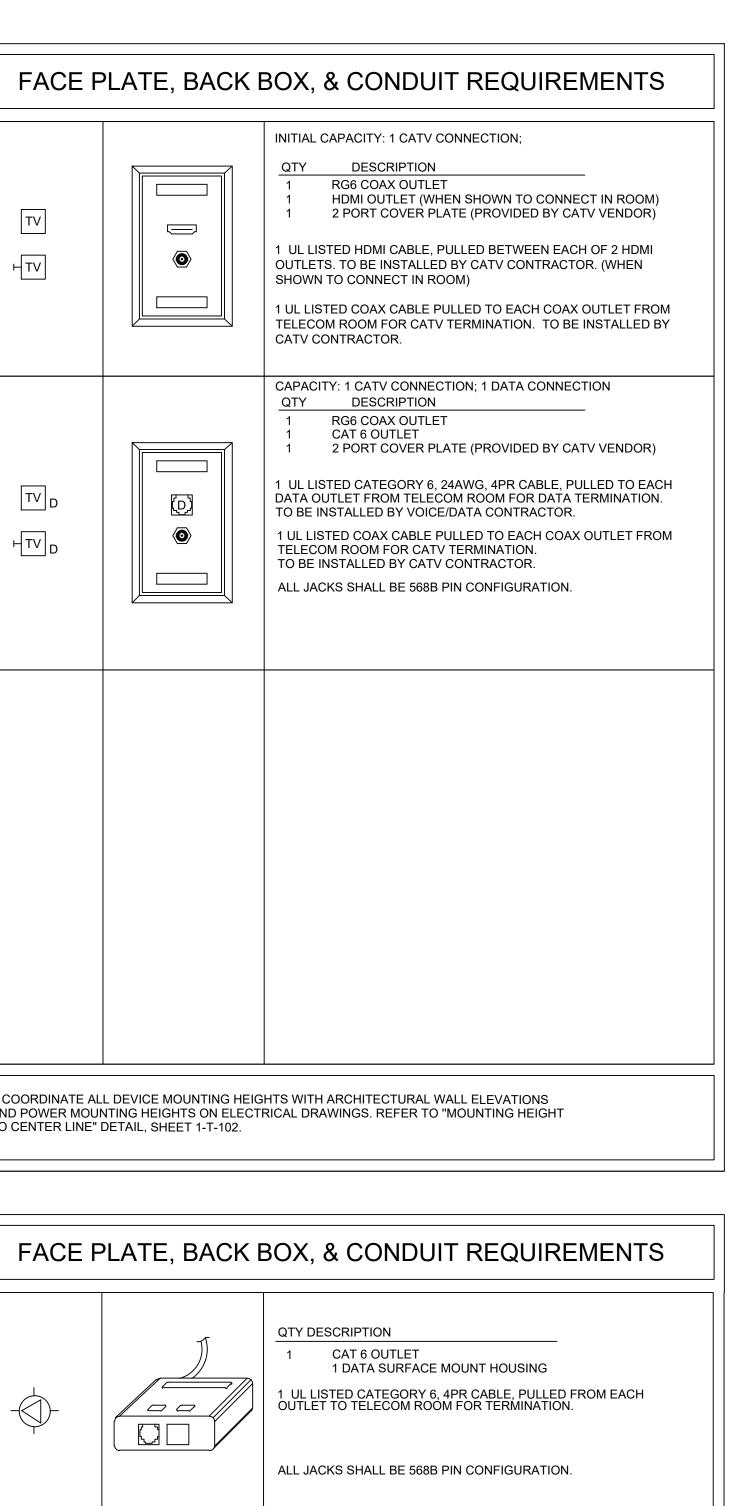
	SECURITY BACK BOX & CONDUIT REQUIREMENTS	
SYMBOL	BACK BOX AND PLASTER RING SIZE	CONDUIT SIZE
CR	4" x 4" x 2 1/2" WITH SINGLE GANG MUD RING	1"
KP	4" x 4" x 2 1/2" WITH SINGLE GANG MUD RING	1"
EC	PER VENDOR SHOP DRAWINGS	2 - 1"
DR	4" x 4" x 2 1/2" WITH SINGLE GANG MUD RING	1"
DC	N/A	N/A
BR	4" x 4" x 2 1/2" WITH SINGLE GANG MUD RING	1"
WS	N/A	N/A
РВ	4" x 4" x 2 1/2" WITH SINGLE GANG MUD RING	1"
PA	4" x 4" x 2 1/2" WITH SINGLE GANG MUD RING	1"
SP	N/A	N/A
AA	4" x 4" x 2 1/2" WITH SINGLE GANG MUD RING	1"
BC	4" x 4" x 2 1/2" WITH SINGLE GANG MUD RING	1"
СК	4" x 4" x 2 1/2" WITH SINGLE GANG MUD RING	1"
DB	N/A	1"
EE	4" x 4" x 2 1/2" WITH SINGLE GANG MUD RING	1"
GB	4" x 4" x 2 1/2" WITH SINGLE GANG MUD RING	1"
KS	4" x 4" x 2 1/2" WITH SINGLE GANG MUD RING	1"
MD	N/A	N/A
ND	N/A	N/A
NI	N/A	N/A
NU	4" x 4" x 2 1/2" WITH SINGLE GANG MUD RING	1"
RX	4" x 4" x 2 1/2" WITH SINGLE GANG MUD RING	1"
SM	4" x 4" x 2 1/2" WITH SINGLE GANG MUD RING	1"
€¢⊄c	N/A	N/A
PCM W	4" x 4" x 2 1/2" WITH SINGLE GANG MUD RING	1"
PCM WP	4" x 4" x 2 1/2" WITH SINGLE GANG MUD RING	1"
FCA C	N/A	N/A
FCM W	4" x 4" x 2 1/2" WITH SINGLE GANG MUD RING	1"
FCM WP	4" x 4" x 2 1/2" WITH SINGLE GANG MUD RING	1"
C) م	4" x 4" x 2 1/2" WITH SINGLE GANG MUD RING	1"
NC N	N/A	N/A

FACE F	PLATE, BACK E	30
TV HTV		INI Q 1 1 1 1 U SH 1 U TE CA
TV D HTV D		CA Q 1 1 1 DA TO 1 U TO 1 U TE TC AL
AND POWER MOUN	L DEVICE MOUNTING HEIG NTING HEIGHTS ON ELECTI DETAIL, SHEET 1-T-102.	
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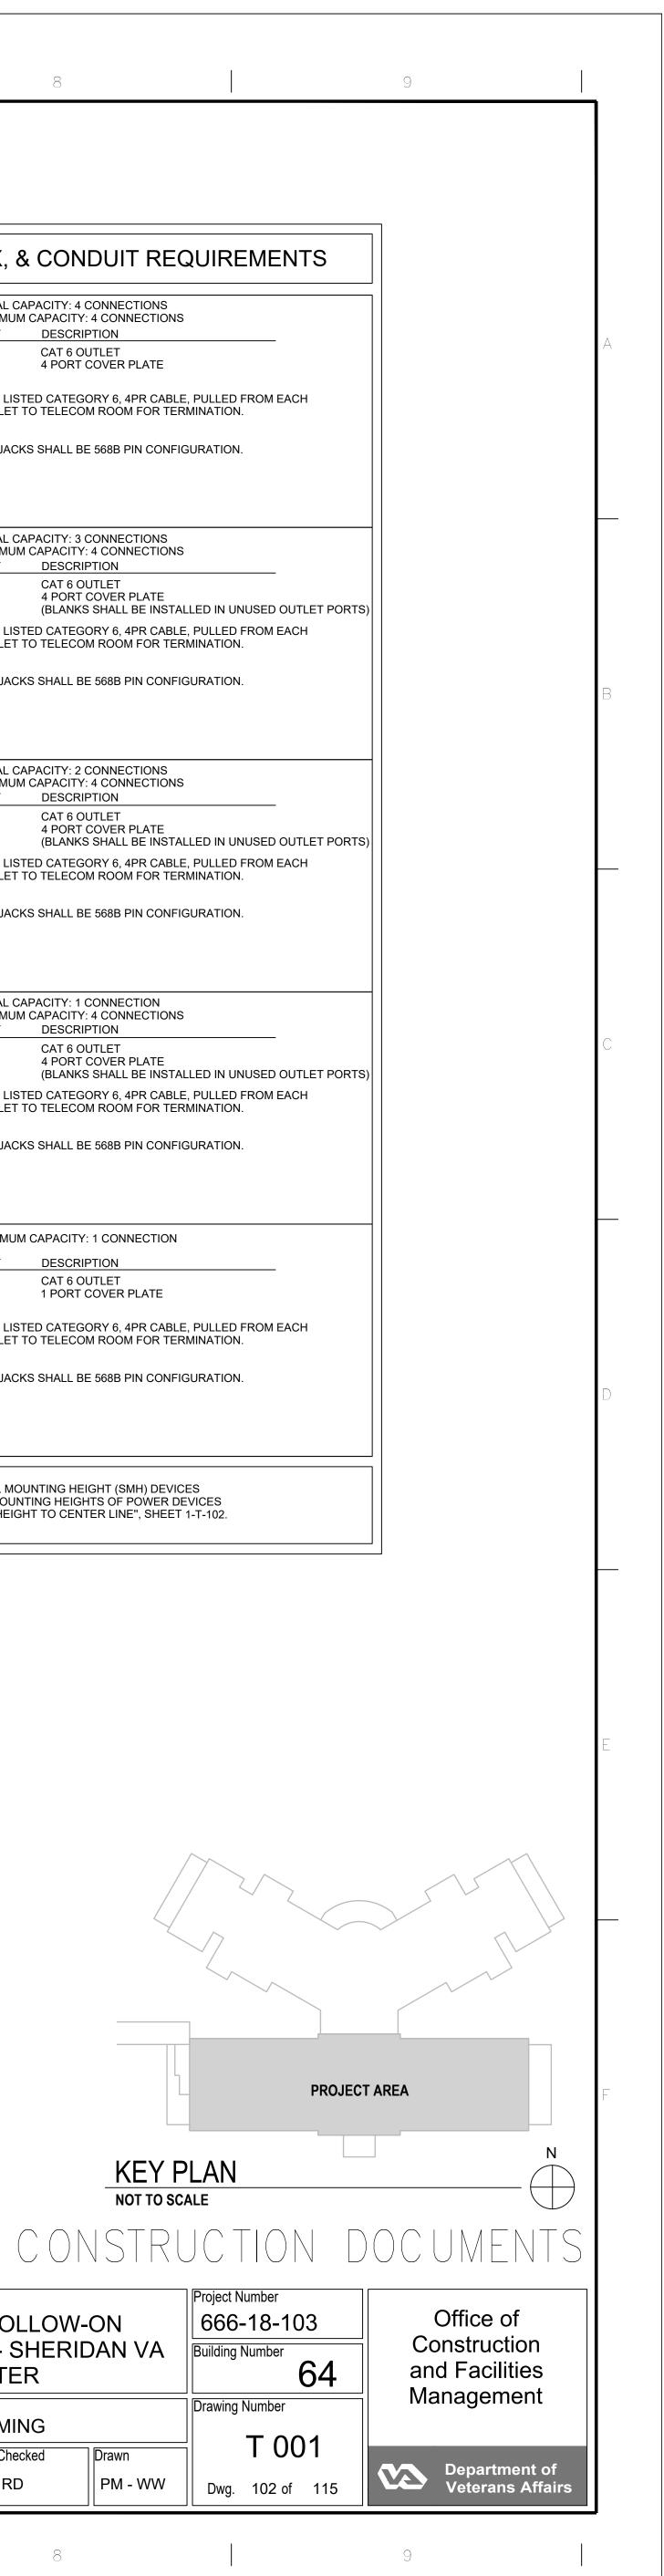
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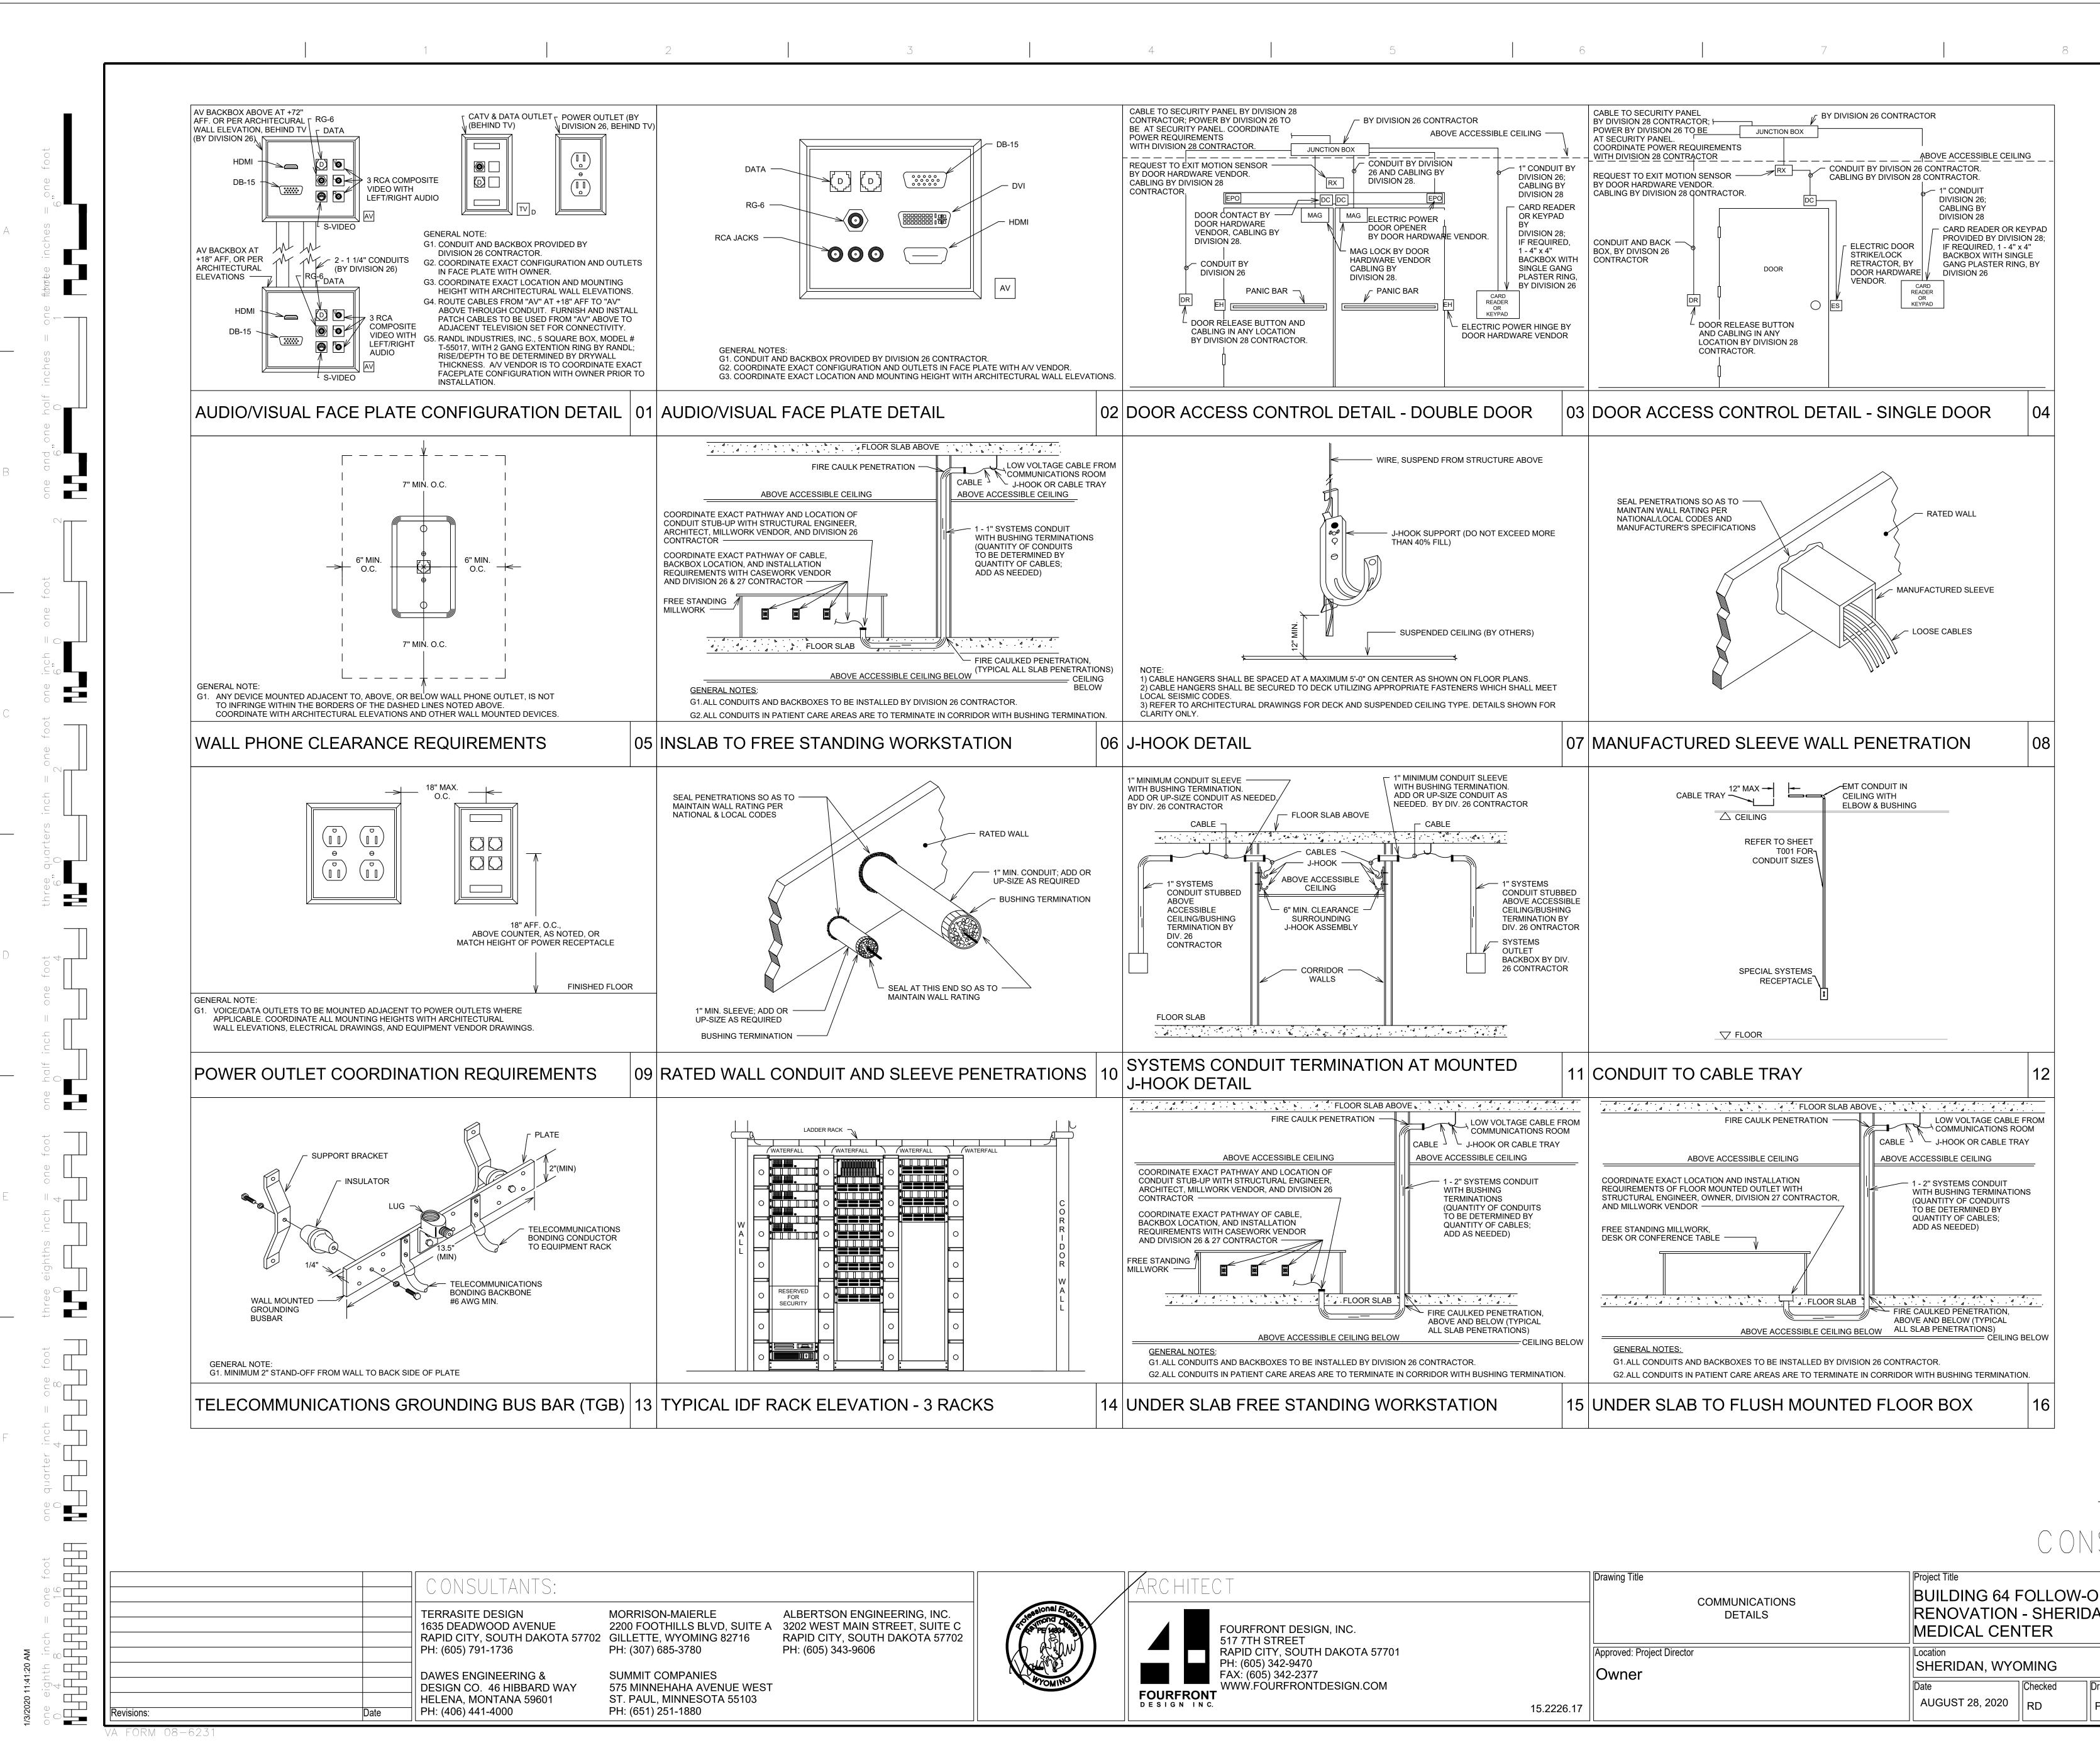
1 DATA SURFACE MOUNT HOUSING

6

	INITIAL CAPACITY: 4 CONNECTIONS MAXIMUM CAPACITY: 4 CONNECTIONS
4	QTYDESCRIPTION4CAT 6 OUTLET14 PORT COVER PLATE
	1 UL LISTED CATEGORY 6, 4PR CABLE, PULLED FROM EACH OUTLET TO TELECOM ROOM FOR TERMINATION.
SMH - 4	ALL JACKS SHALL BE 568B PIN CONFIGURATION.
(INITIAL CAPACITY: 3 CONNECTIONS MAXIMUM CAPACITY: 4 CONNECTIONS QTY DESCRIPTION
3	3 CAT 6 OUTLET 1 4 PORT COVER PLATE (BLANKS SHALL BE INSTALLED IN UNUSED OUT
3	1 UL LISTED CATEGORY 6, 4PR CABLE, PULLED FROM EACH OUTLET TO TELECOM ROOM FOR TERMINATION.
< ≤ 3 3 3 3	ALL JACKS SHALL BE 568B PIN CONFIGURATION.
	INITIAL CAPACITY: 2 CONNECTIONS MAXIMUM CAPACITY: 4 CONNECTIONS QTY DESCRIPTION
	2 CAT 6 OUTLET 1 4 PORT COVER PLATE (BLANKS SHALL BE INSTALLED IN UNUSED OUT
2	1 UL LISTED CATEGORY 6, 4PR CABLE, PULLED FROM EACH OUTLET TO TELECOM ROOM FOR TERMINATION.
SMH -2	ALL JACKS SHALL BE 568B PIN CONFIGURATION.
	INITIAL CAPACITY: 1 CONNECTION MAXIMUM CAPACITY: 4 CONNECTIONS QTY DESCRIPTION
$\boxed{1}_{1}$	1 CAT 6 OUTLET 1 4 PORT COVER PLATE (BLANKS SHALL BE INSTALLED IN UNUSED OUT
1 1 1	1 UL LISTED CATEGORY 6, 4PR CABLE, PULLED FROM EACH OUTLET TO TELECOM ROOM FOR TERMINATION.
	ALL JACKS SHALL BE 568B PIN CONFIGURATION.
<- EWB	MAXIMUM CAPACITY: 1 CONNECTION
	QTYDESCRIPTION1CAT 6 OUTLET11 PORT COVER PLATE
∢ w	1 UL LISTED CATEGORY 6, 4PR CABLE, PULLED FROM EACH OUTLET TO TELECOM ROOM FOR TERMINATION.
	ALL JACKS SHALL BE 568B PIN CONFIGURATION.



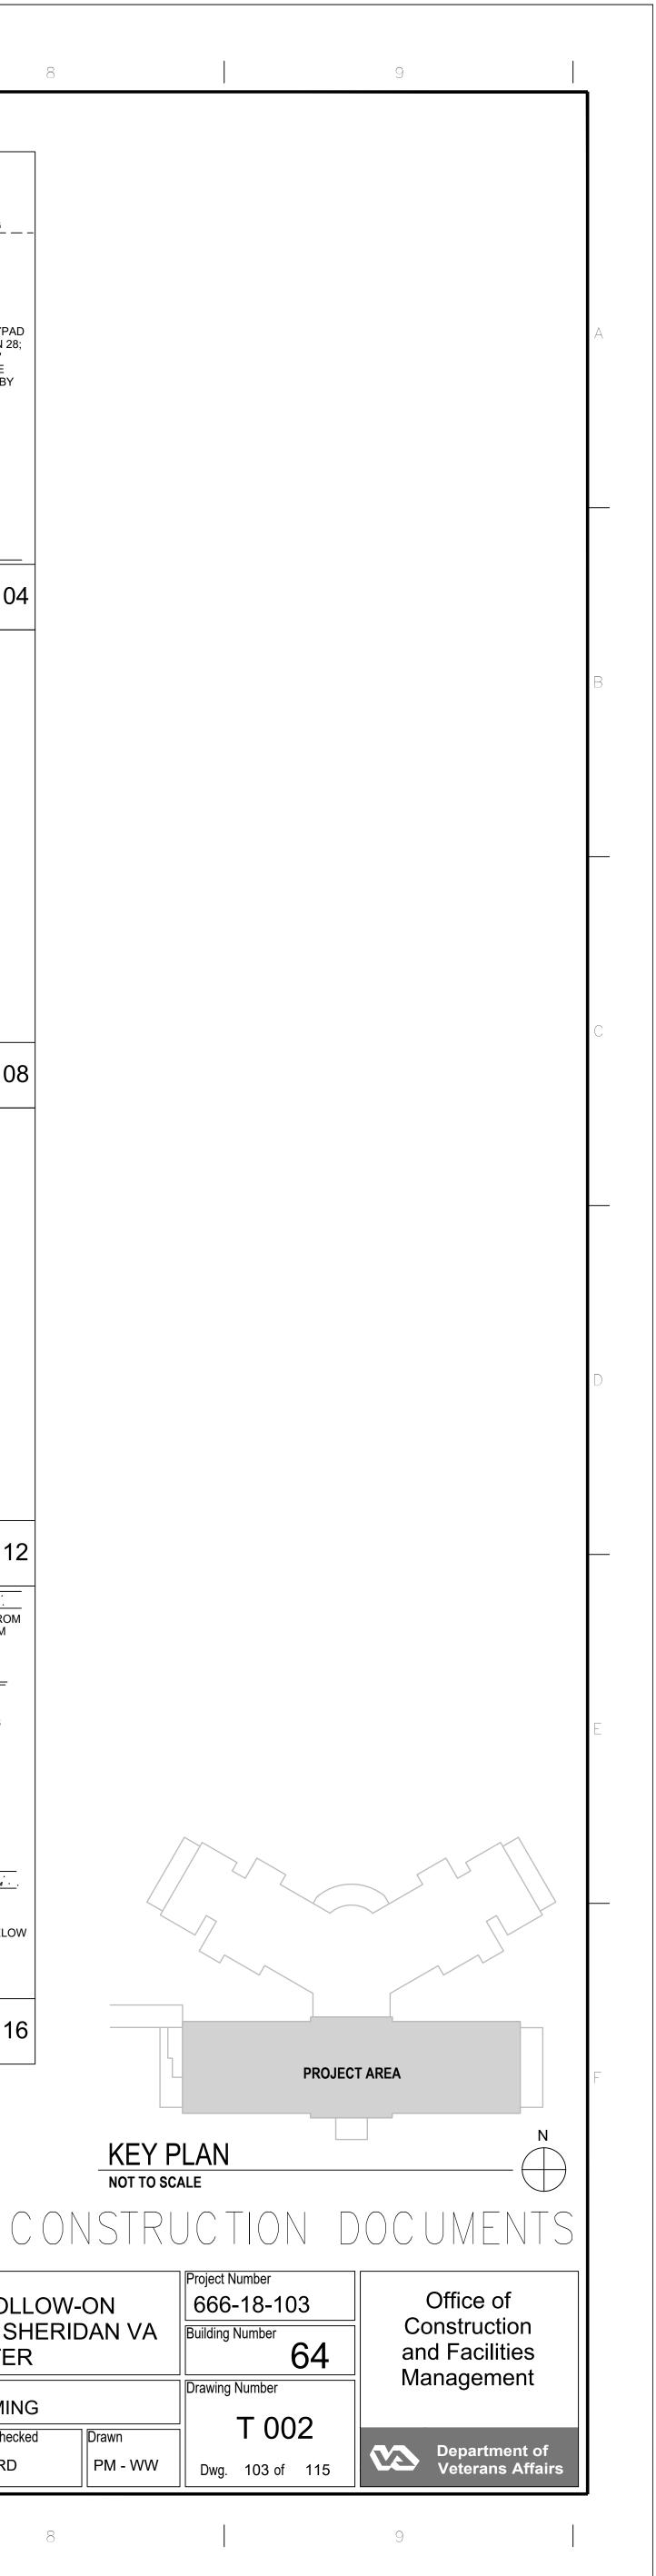
).		Drawing Title COMMUNICATIONS CODES AND REQUIREMENTS CONTINUED	RENOVATION	Project Title BUILDING 64 FOLLOW-ON RENOVATION - SHERIDAN VA MEDICAL CENTER			3 54
DTA 57701		Approved: Project Director Owner	Location SHERIDAN, WY			Drawing Number	_ 1
GN.COM	15.2226.17		Date AUGUST 28, 2020		Drawn PM - WW	Dwg. 102 of	
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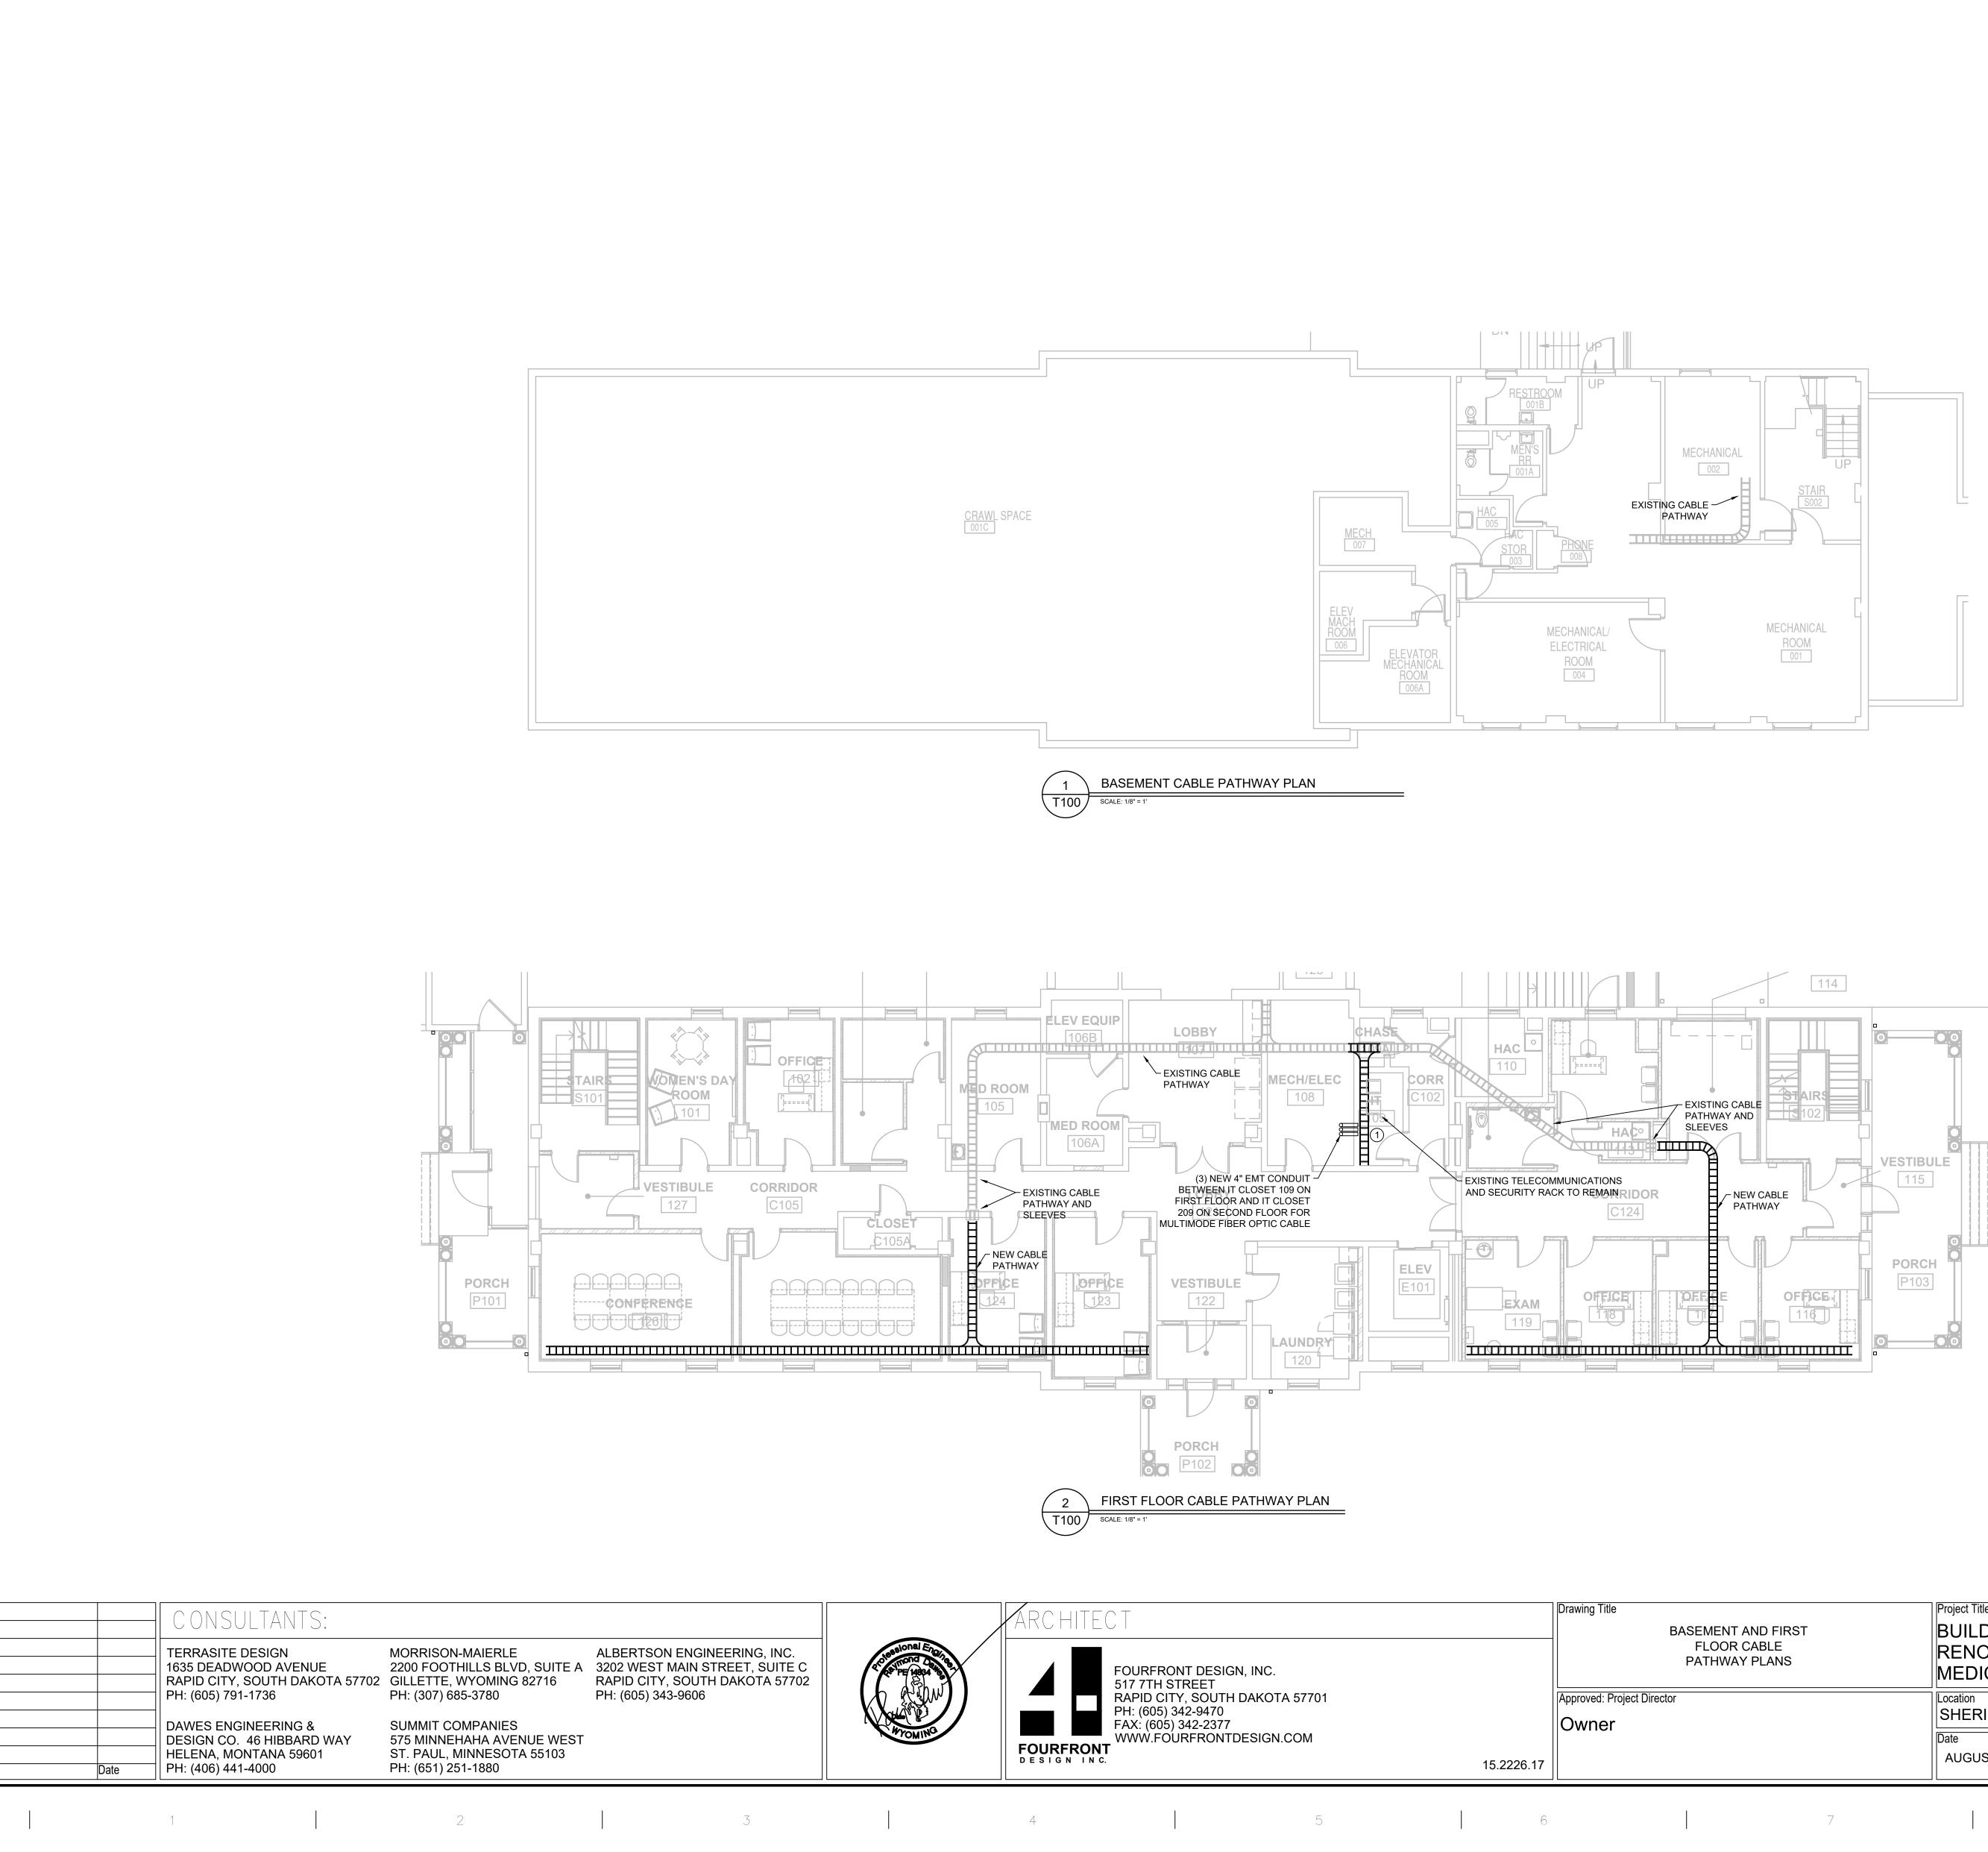


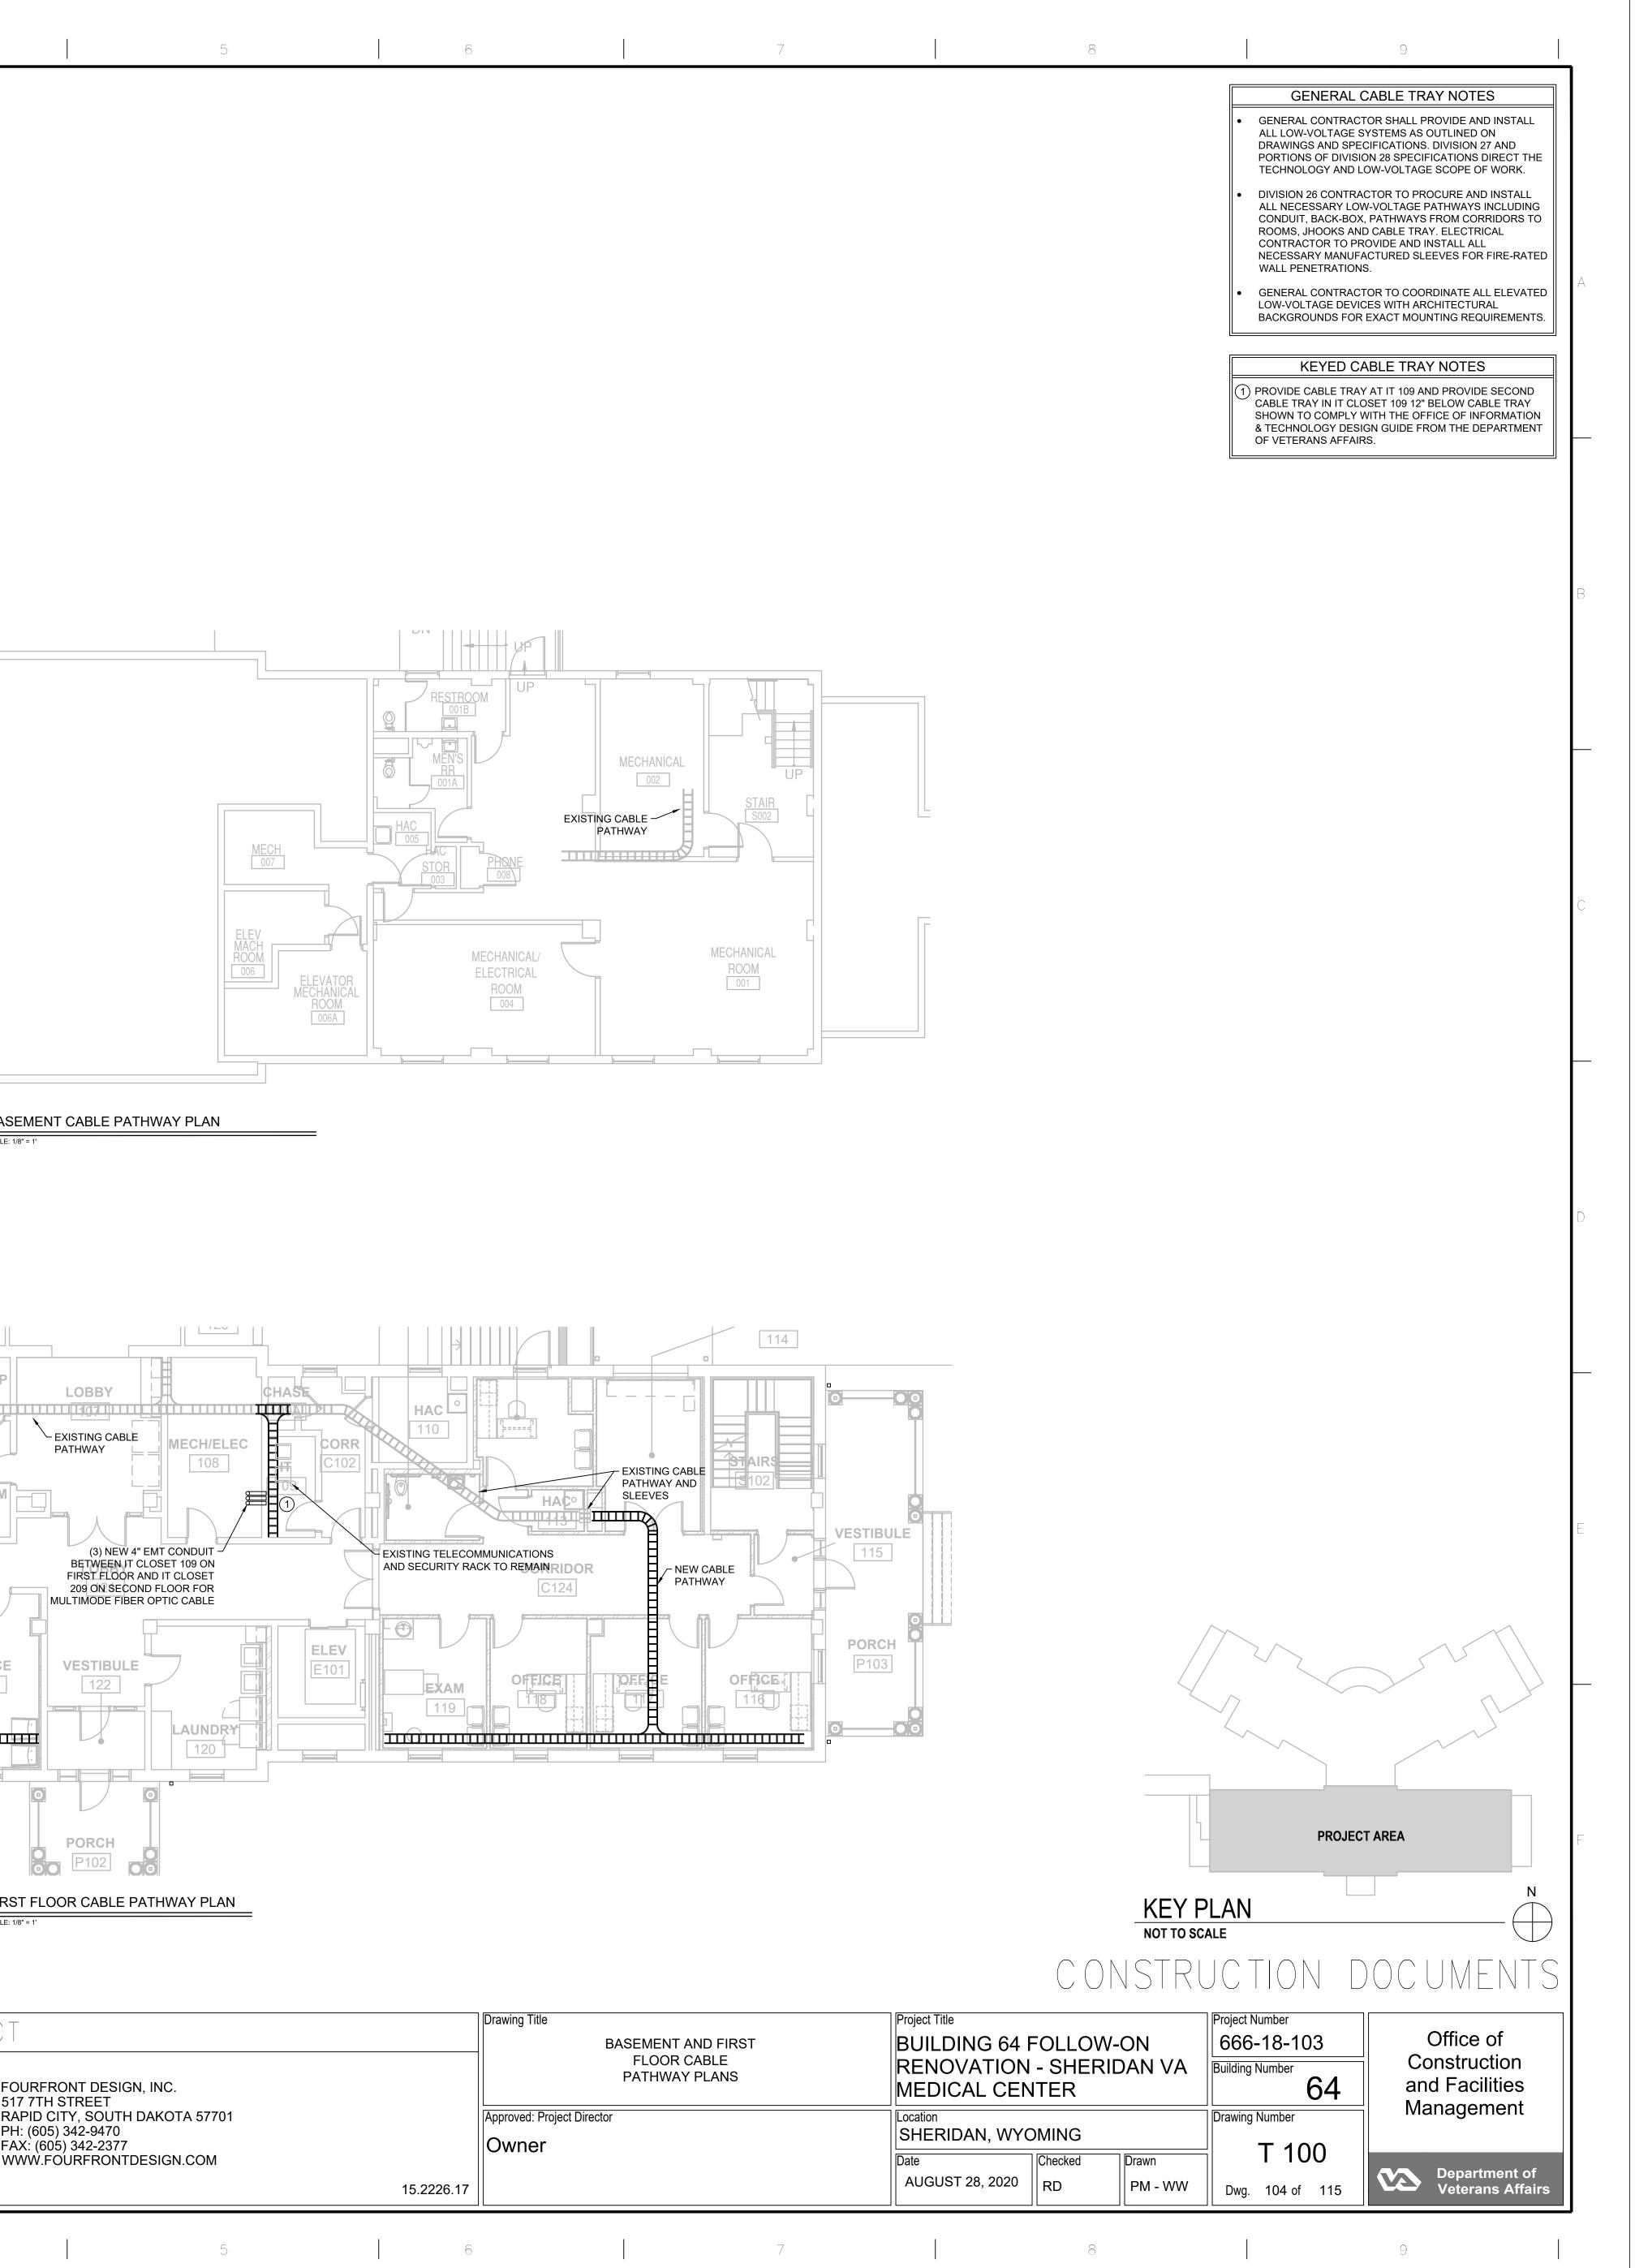


		Drawing Title COMMUNICATIONS DETAILS	RENOVATION	Project Title BUILDING 64 FOLLOW-ON RENOVATION - SHERIDAN VA MEDICAL CENTER		
A 57701 .COM		Approved: Project Director Owner	Location SHERIDAN, WY Date	SHERIDAN, WYOMING		
	15.2226.17		AUGUST 28, 2020	RD PM - WW	T 002 Dwg. 103 of 1	
5	6	7		8		



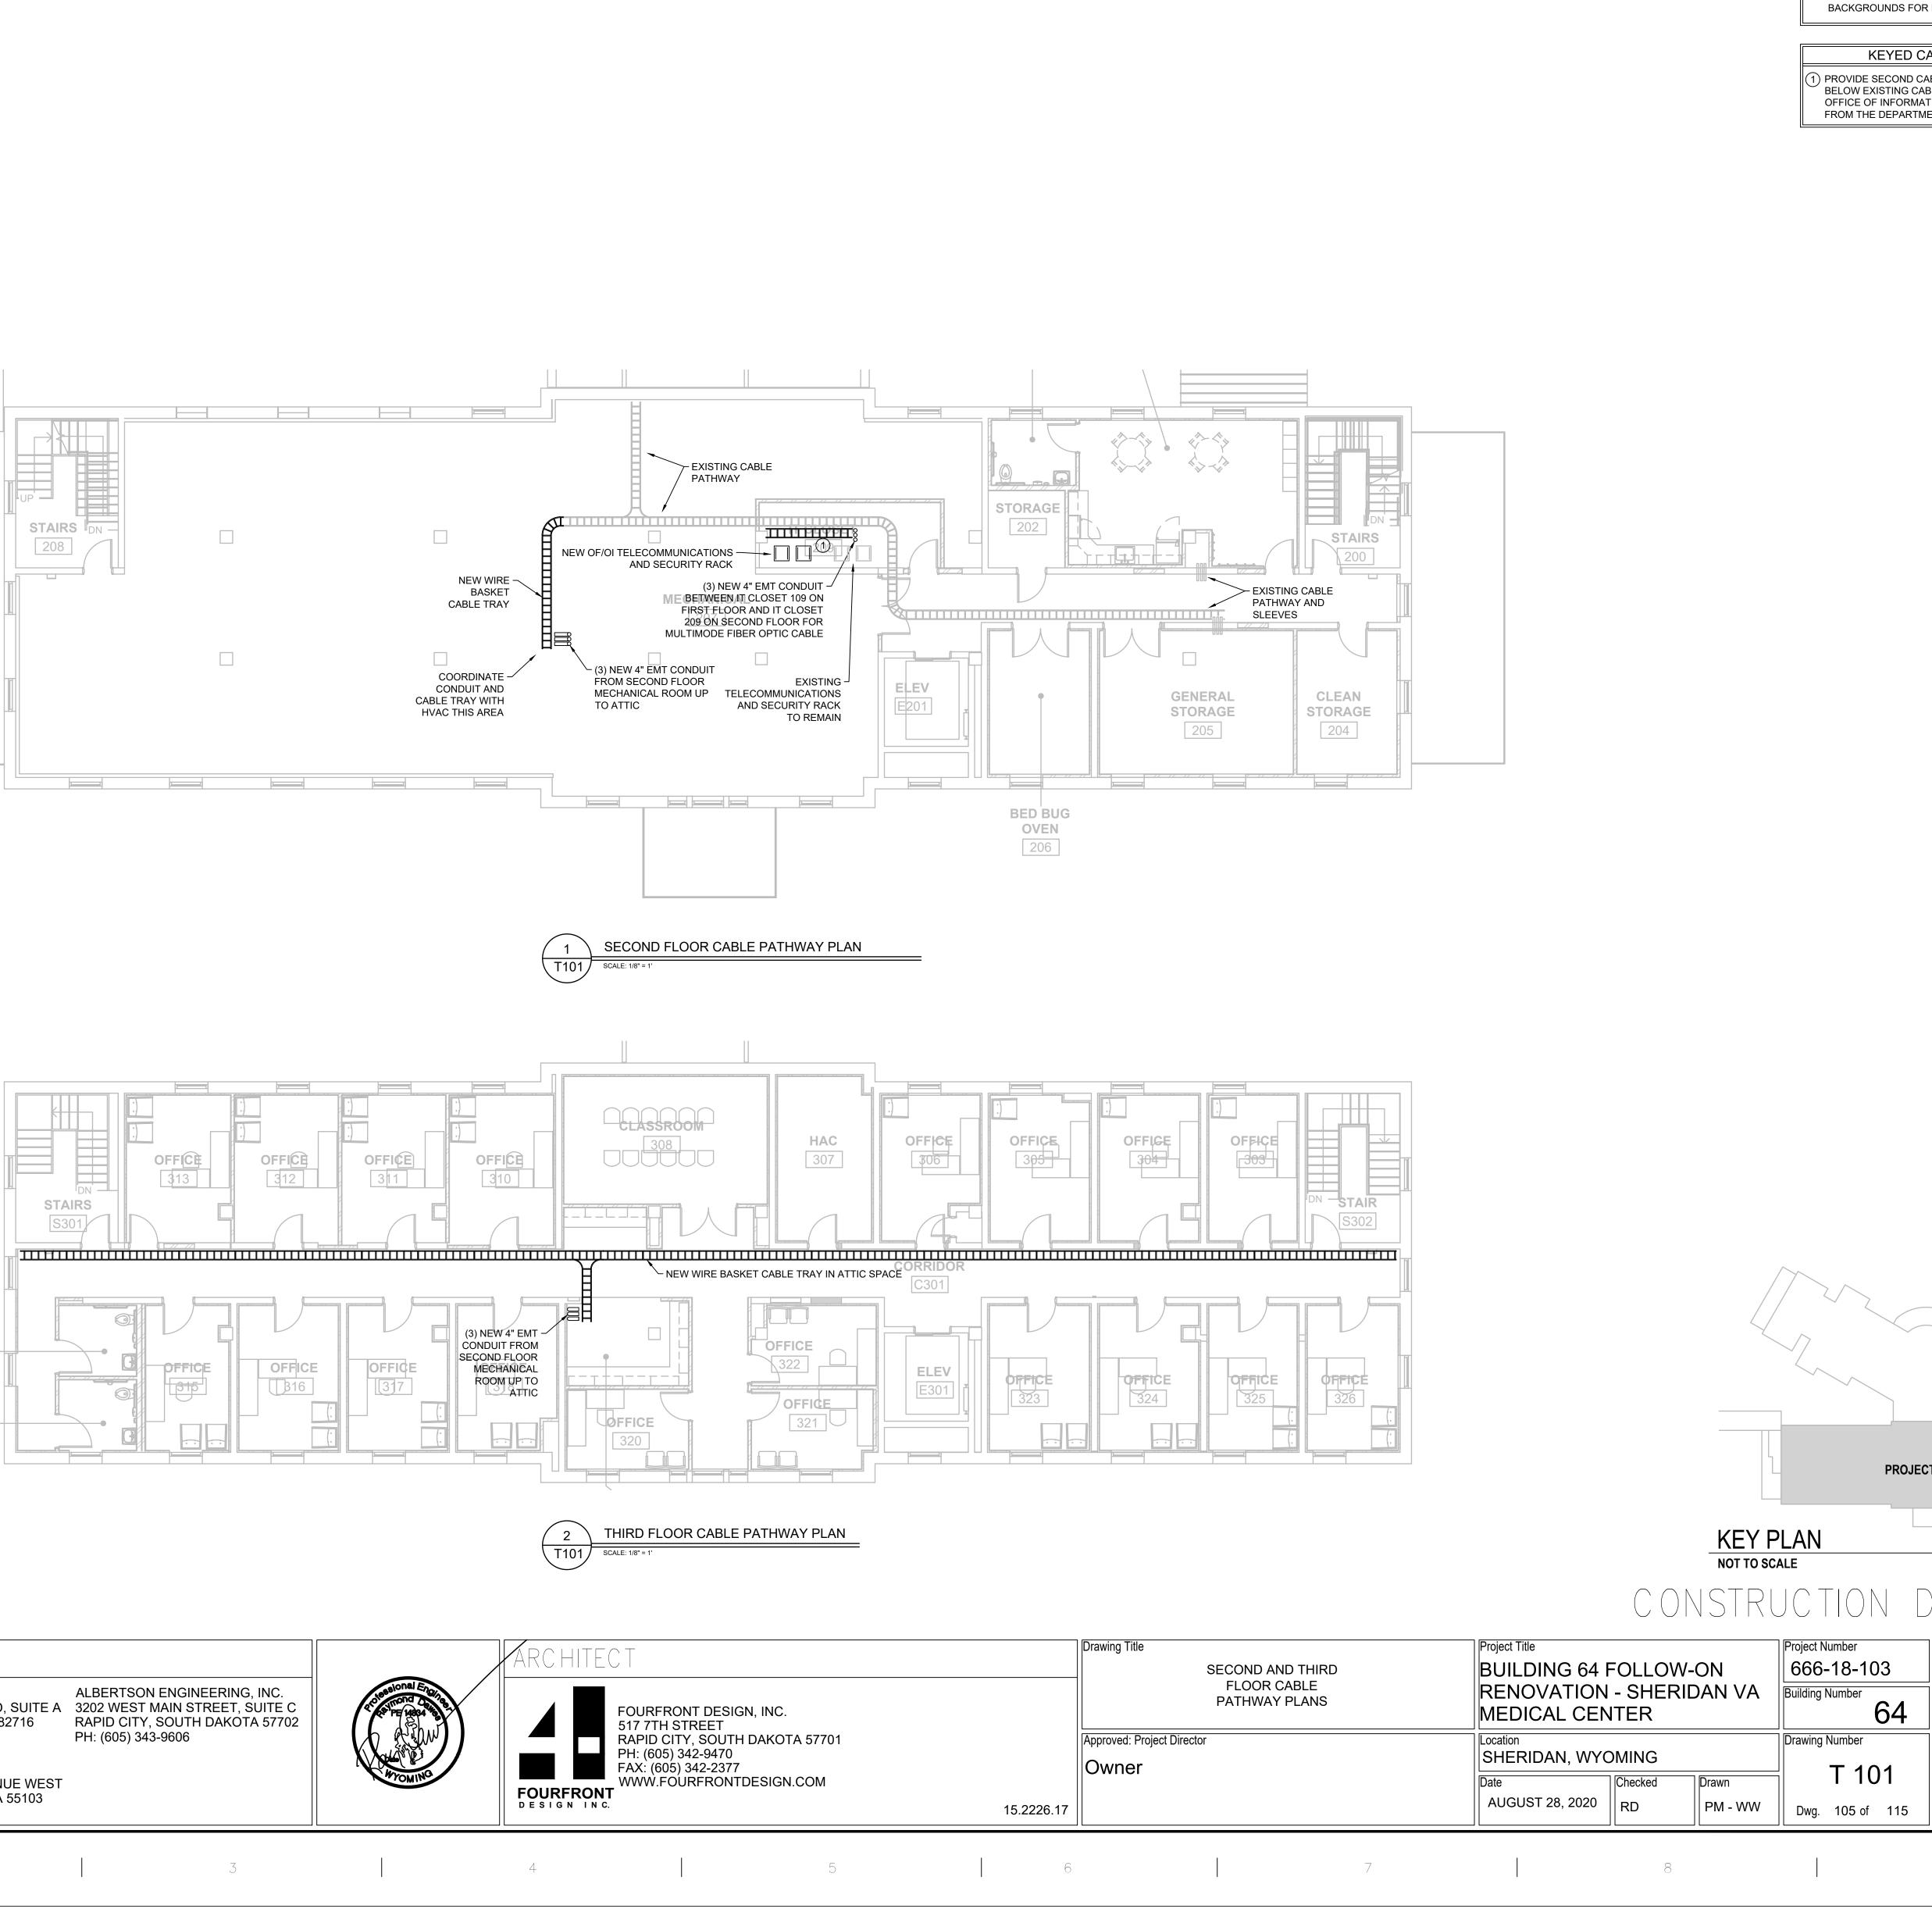
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			TERRASITE DESIGN 1635 DEADWOOD AVENUE RAPID CITY, SOUTH DAKOTA 5 PH: (605) 791-1736 DAWES ENGINEERING &	MORRISON-MAIERLE 2200 FOOTHILLS BLVD, GILLETTE, WYOMING 82 PH: (307) 685-3780 SUMMIT COMPANIES
1/3/2020 11:41:20 AM one eighth ir 0 4 8	Revisions: VA FORM 08-6231	Date	DAWES ENGINEERING & DESIGN CO. 46 HIBBARD WAY HELENA, MONTANA 59601 PH: (406) 441-4000	
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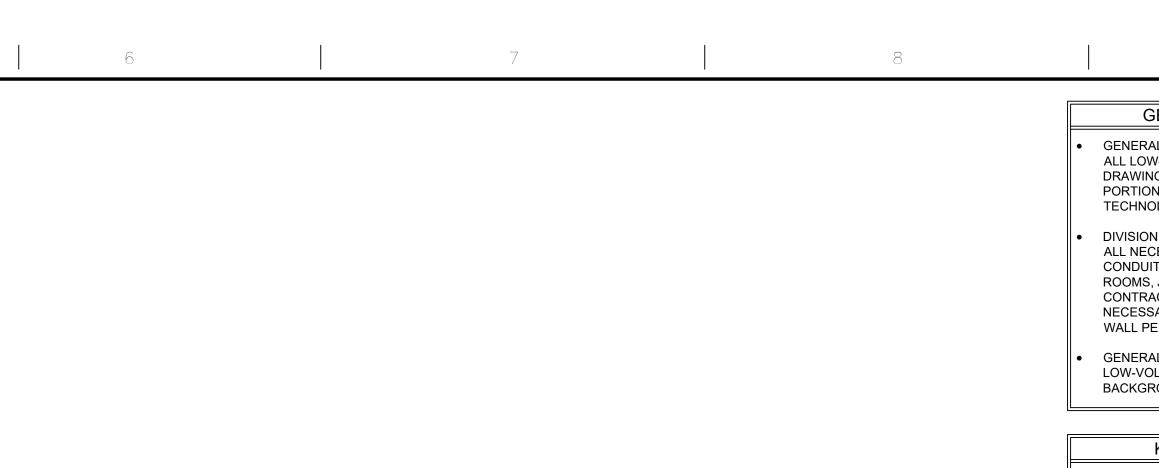




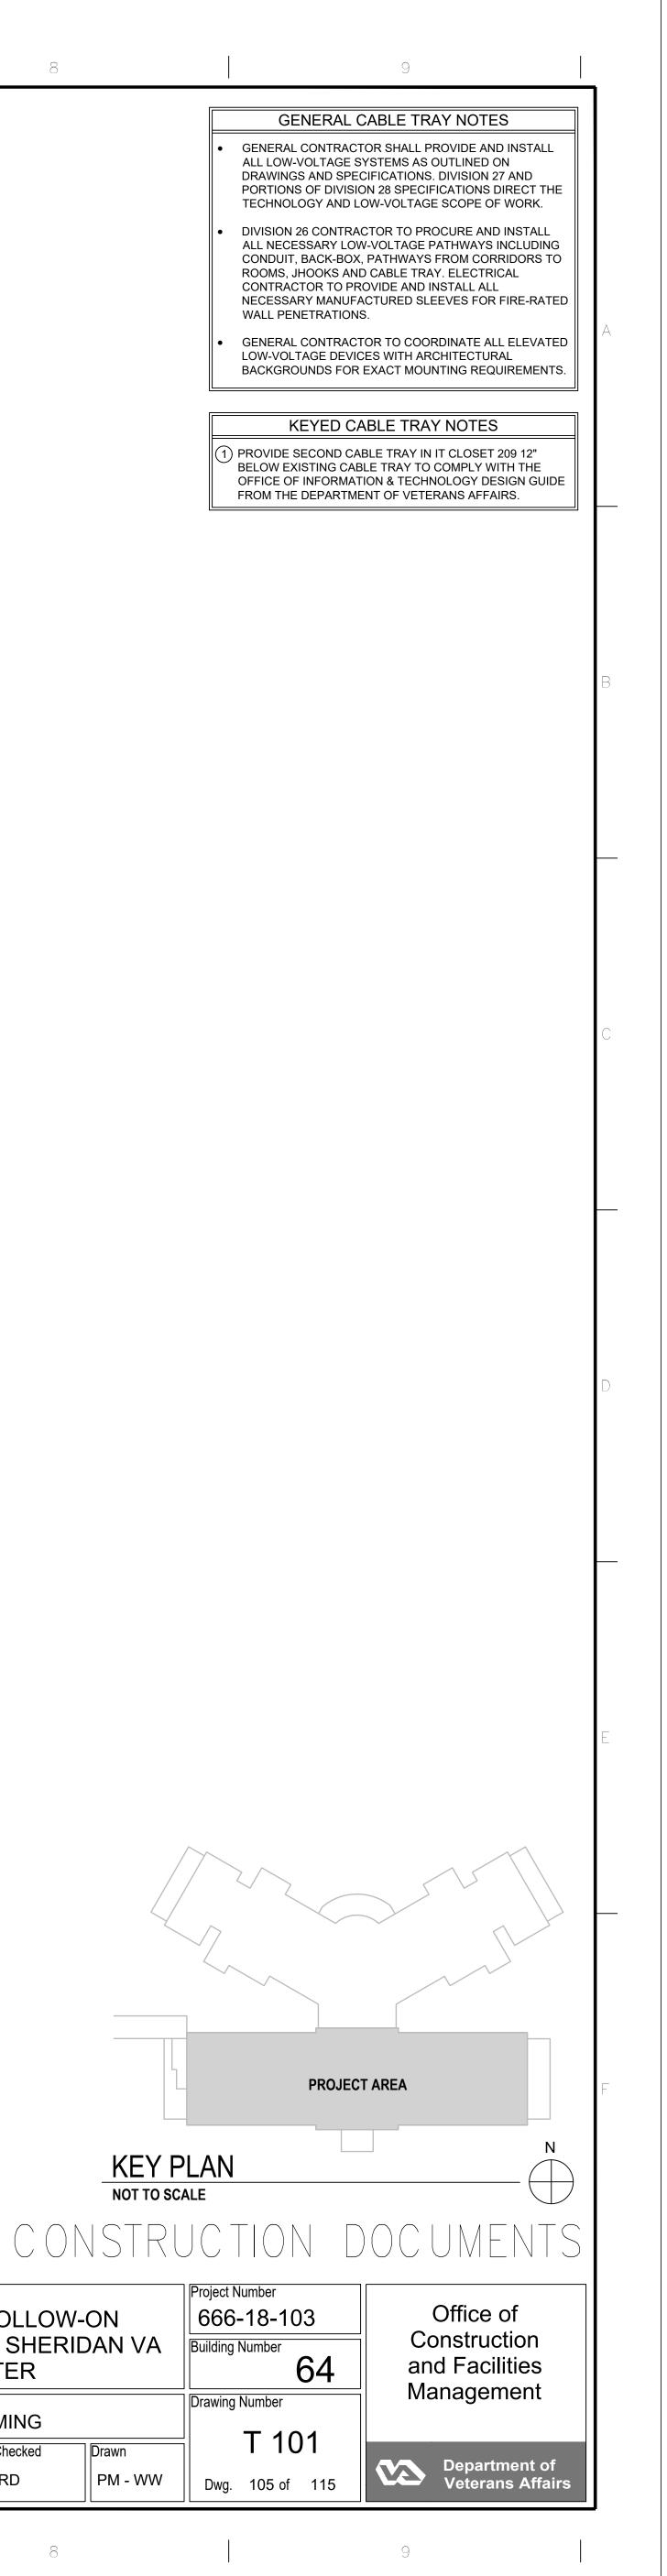
	Drawing Title BASEMENT AND FIRST FLOOR CABLE PATHWAY PLANS	RENOVATION	Project Title BUILDING 64 FOLLOW-ON RENOVATION - SHERIDAN VA MEDICAL CENTER			Project Number 666-18-103 Building Number 64		
	Approved: Project Director Owner	Location SHERIDAN, WYOMING			Drawing			
		Date	Checked	Drawn		T 100		
15.2226.17		AUGUST 28, 2020	RD	PM - WW	Dwg.	104 of 1		
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1/3/2020 11:41:20 AM one eighth inch 0 4 8 0 4 8	Revisions:	Date		PH: (307) 685-3780 SUMMIT COMPANIES 575 MINNEHAHA AVENU ST. PAUL, MINNESOTA 5 PH: (651) 251-1880
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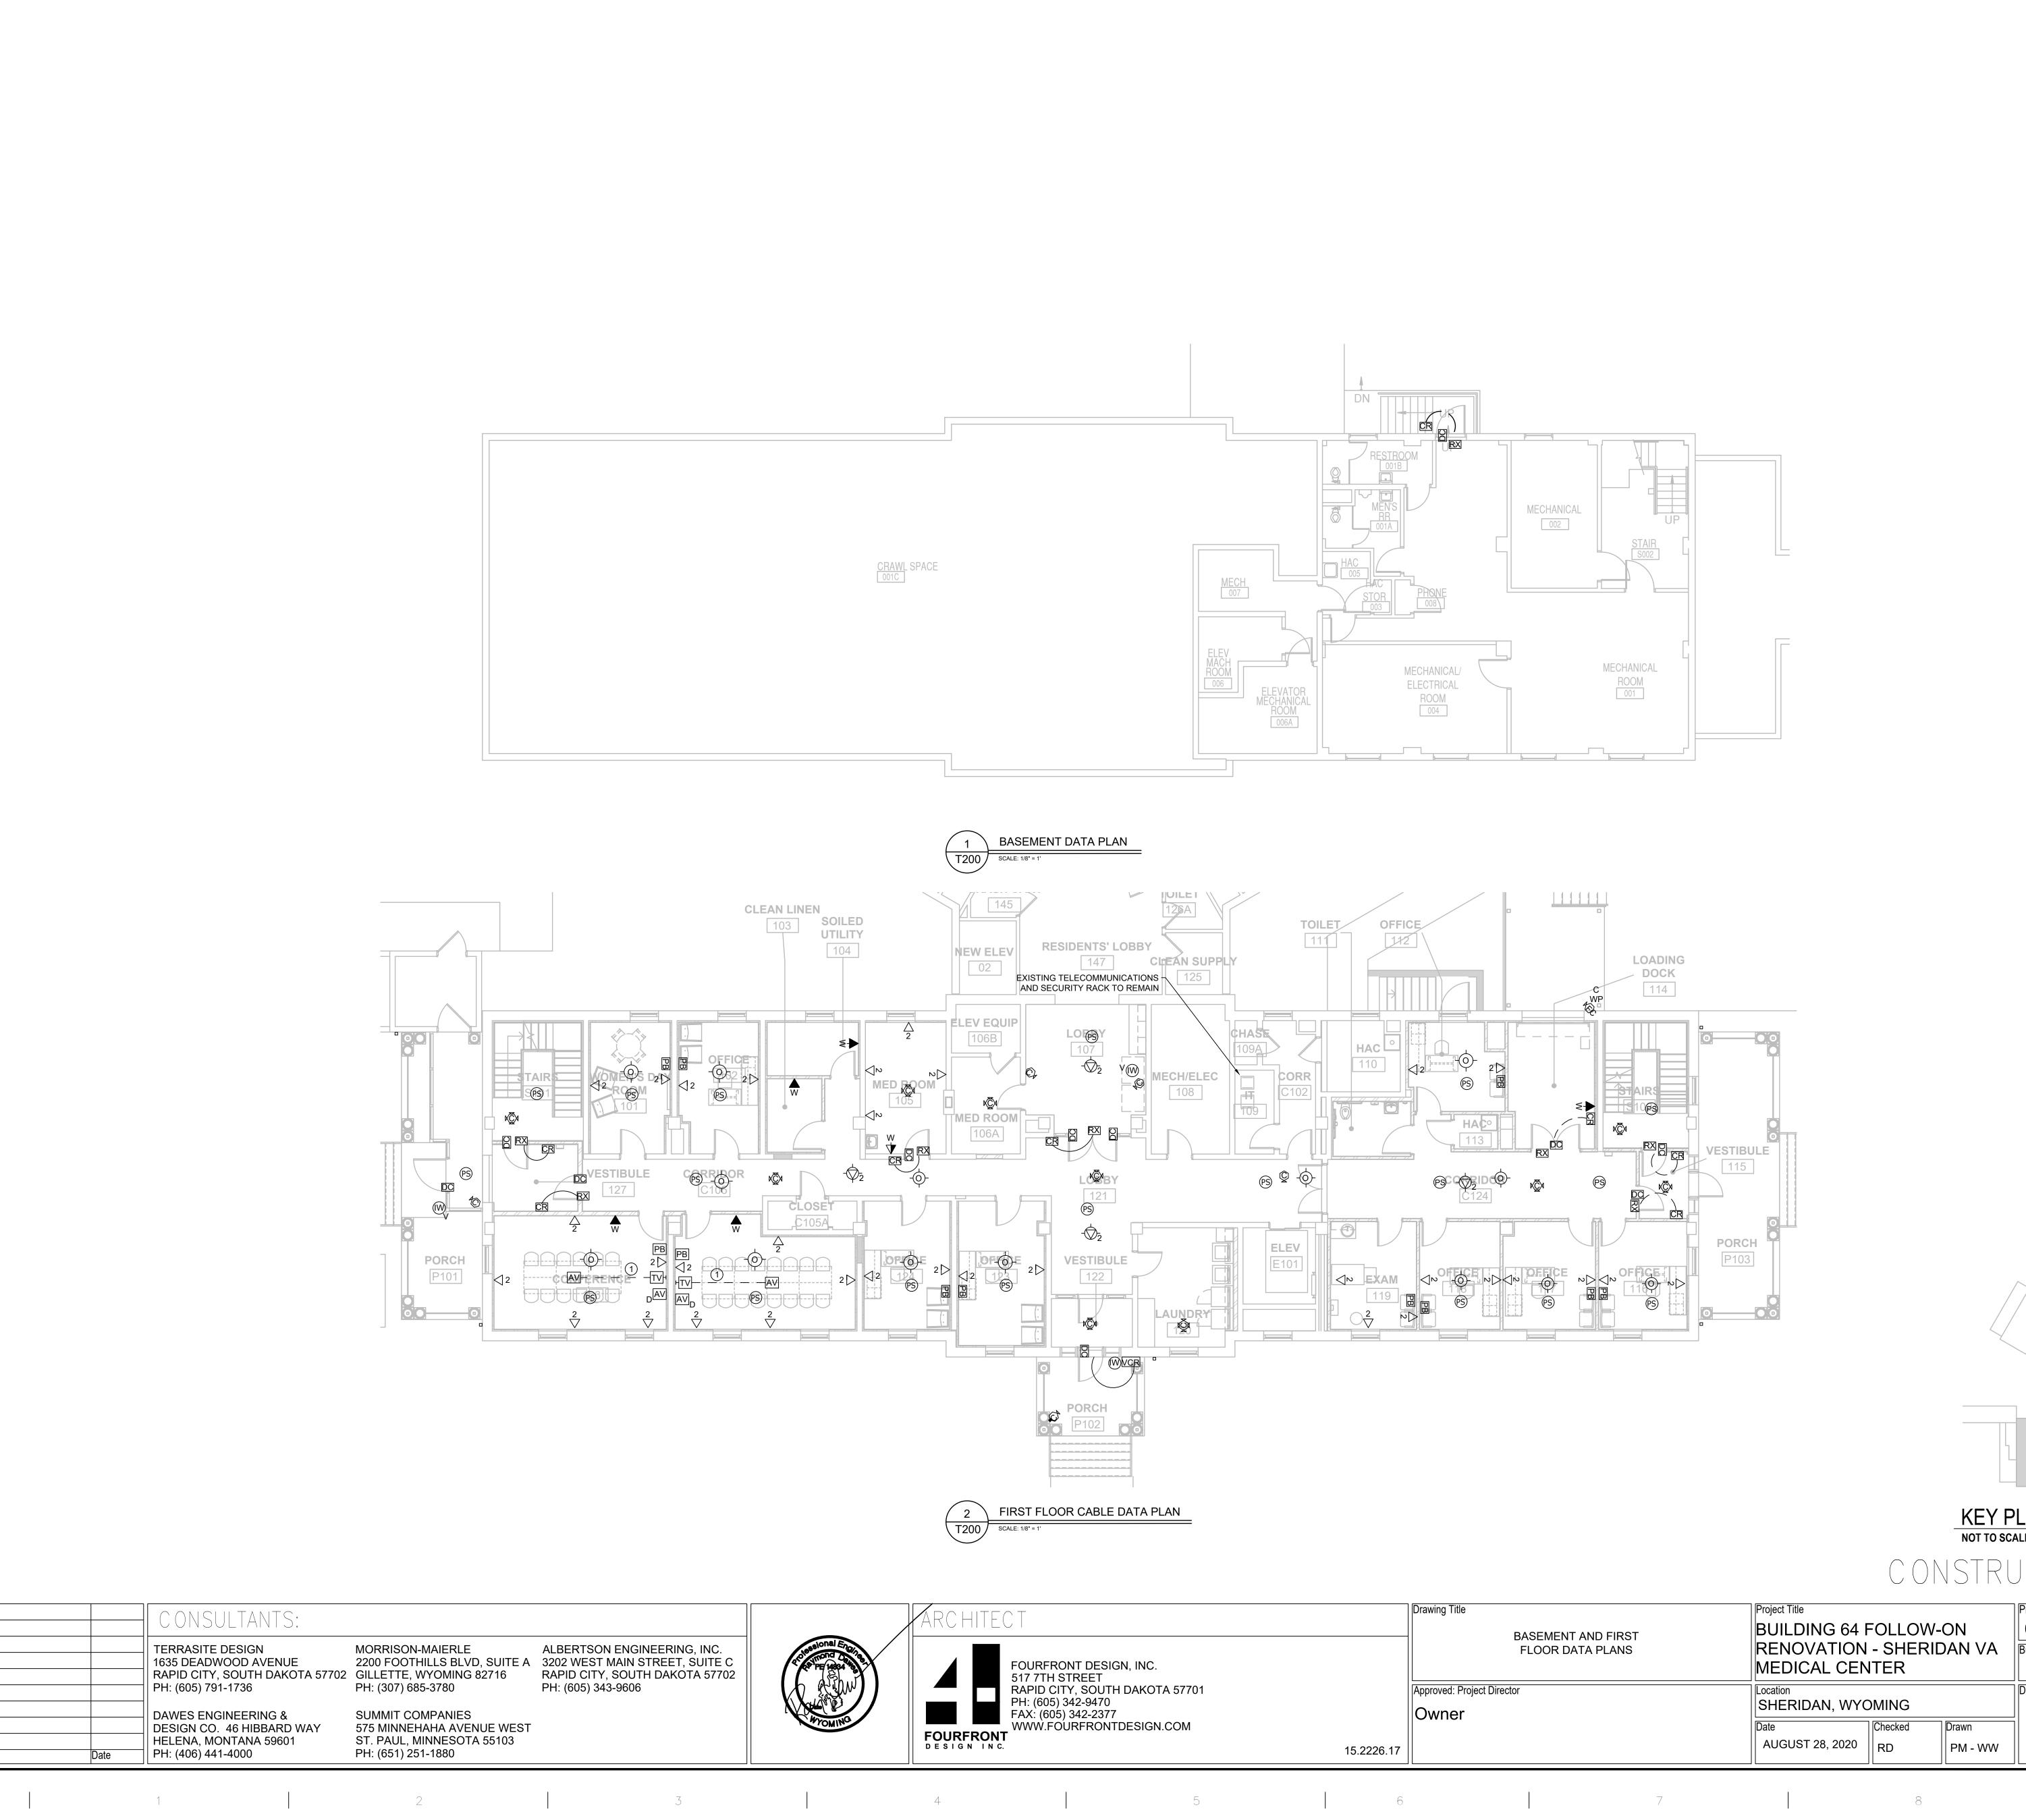




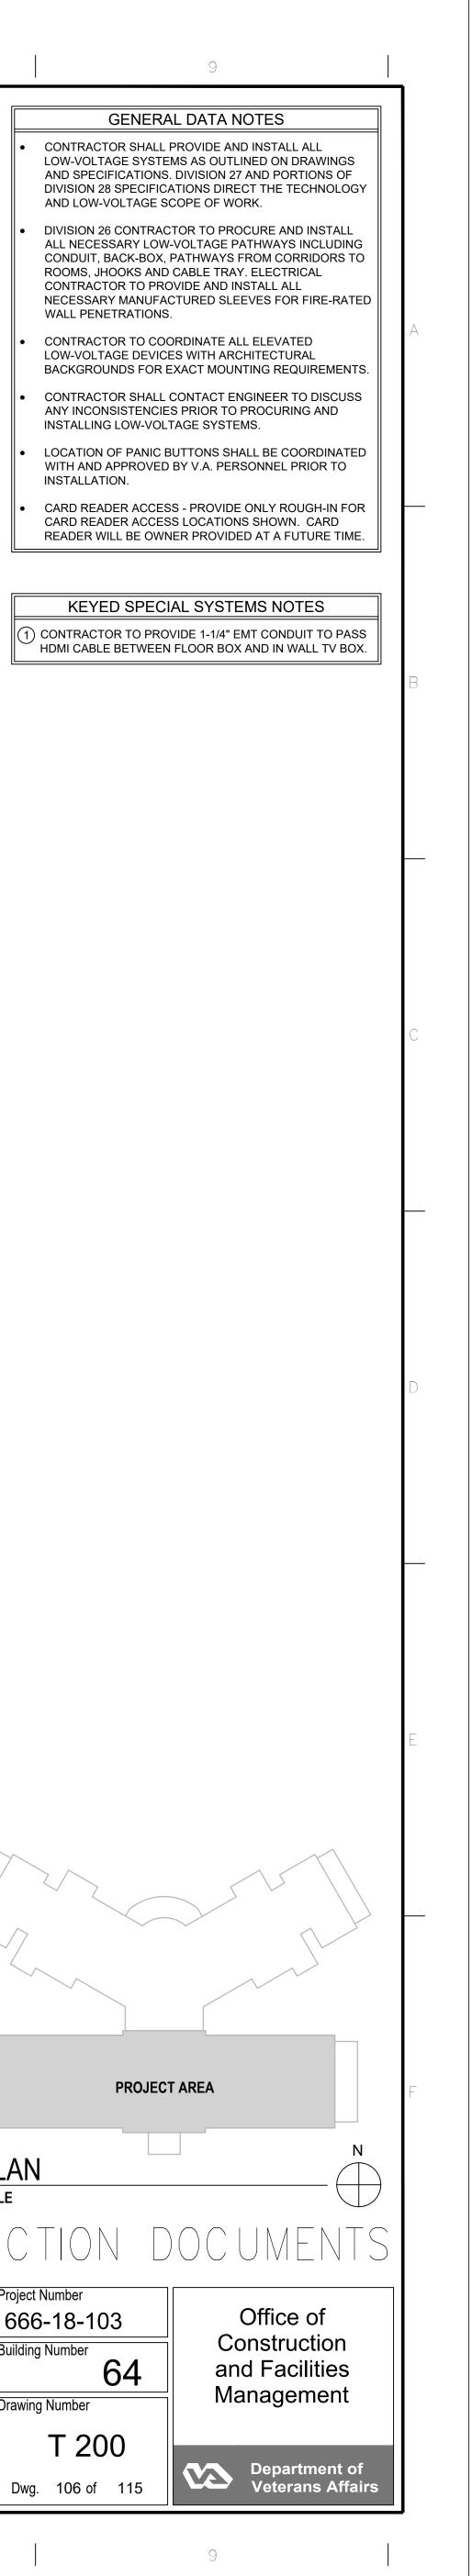
	Drawing Title SECOND AND THIRD FLOOR CABLE PATHWAY PLANS	RENOVATION -	Project Title BUILDING 64 FOLLOW-ON RENOVATION - SHERIDAN VA MEDICAL CENTER		
	Approved: Project Director Owner		/ING Checked Drawn	Drawing Number	
15.2226.17		AUGUST 28, 2020	RD PM - WW	Dwg. 105 of 1	

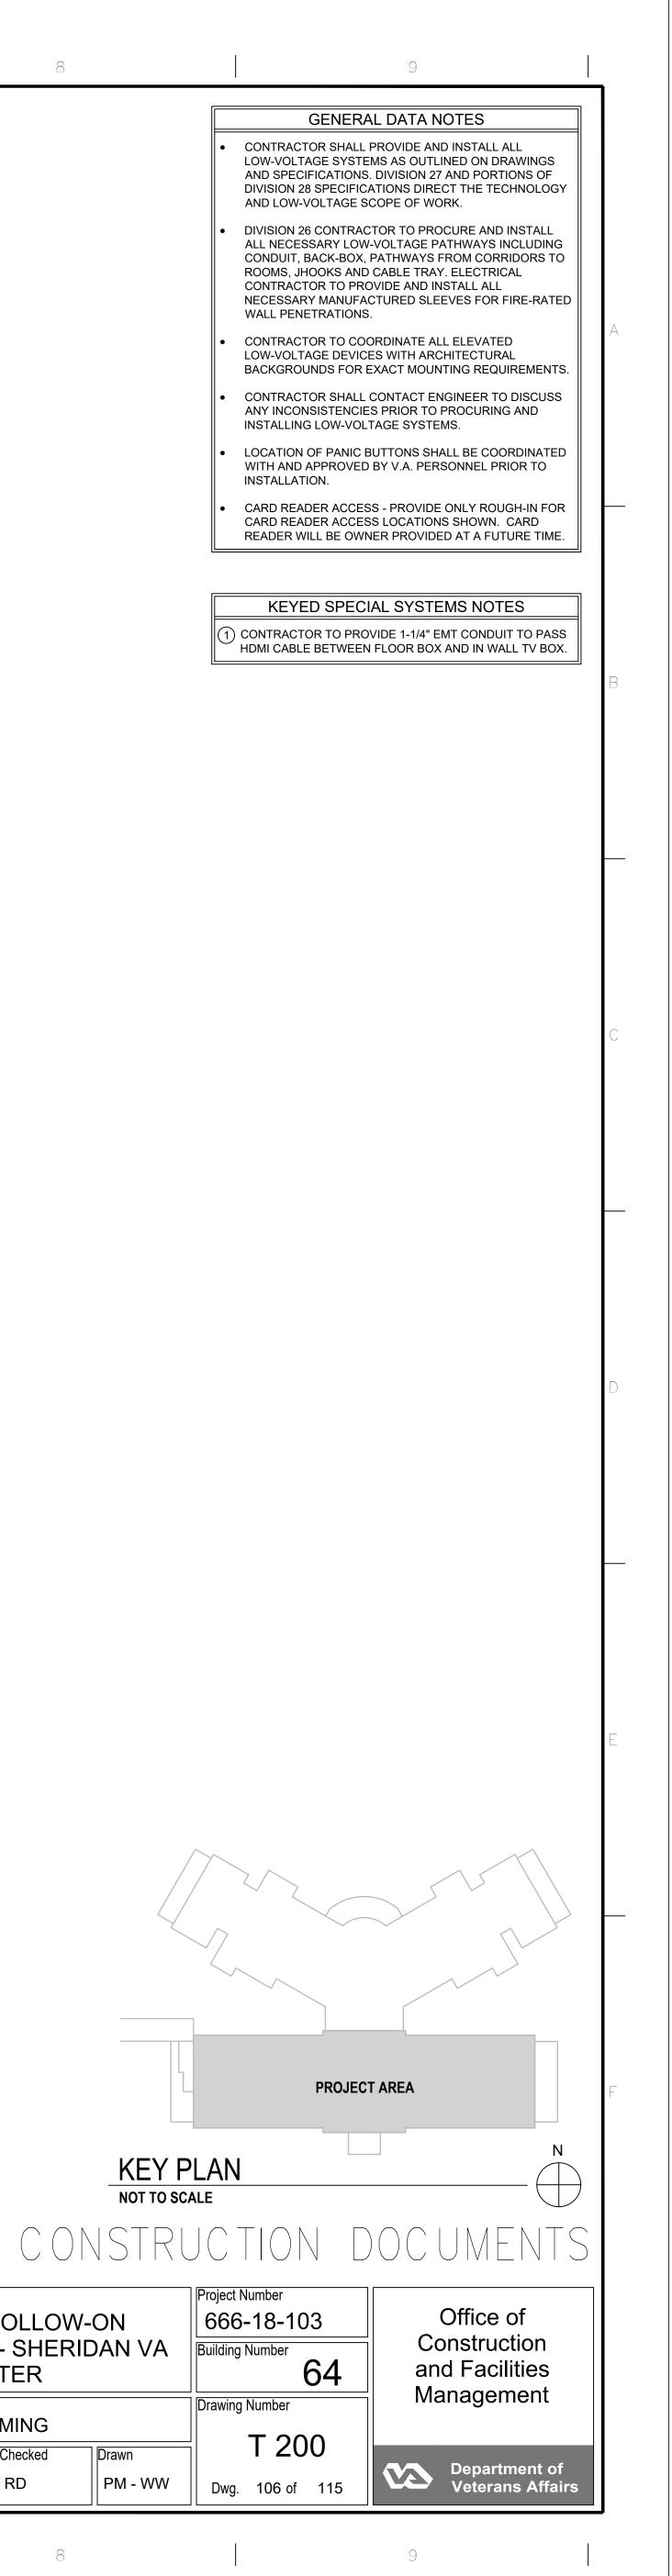


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	Revisions: VA FORM 08-6231	Date	DESIGN CO. 46 HIBBARD HELENA, MONTANA 5960 PH: (406) 441-4000	WAY 575 MINNEHAHA AVENI ST. PAUL, MINNESOTA PH: (651) 251-1880



	Drawing Title	Project Title			Project Number
	BASEMENT AND FIRST FLOOR DATA PLANS	BUILDING 64 FOLLOW-ON RENOVATION - SHERIDAN VA MEDICAL CENTER			666-18-
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	Approved: Project Director Owner	Location SHERIDAN, WY	OMING		Drawing Number
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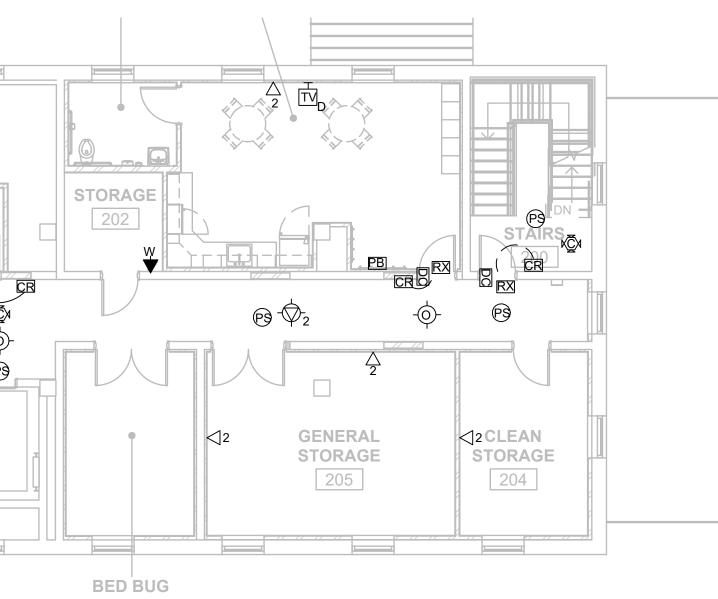


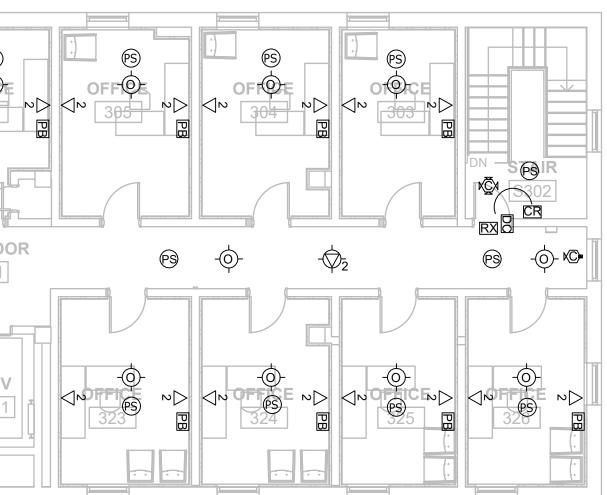


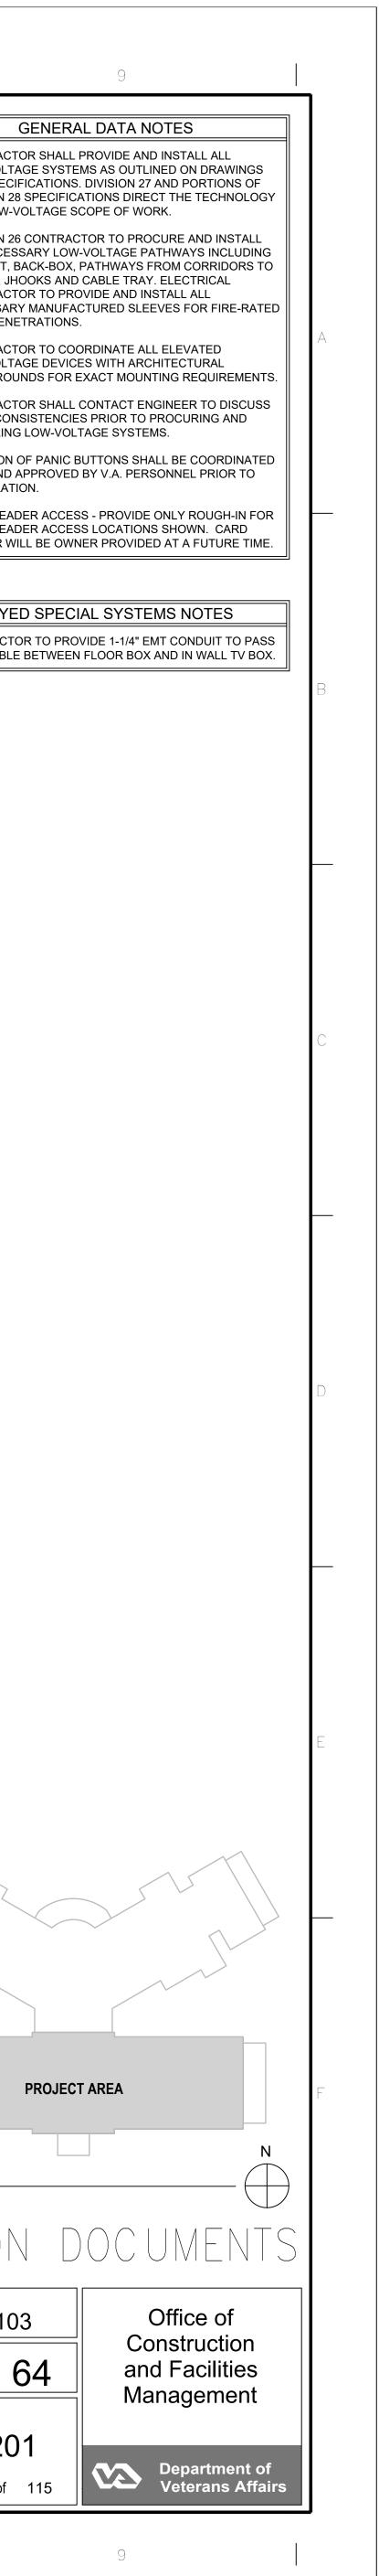
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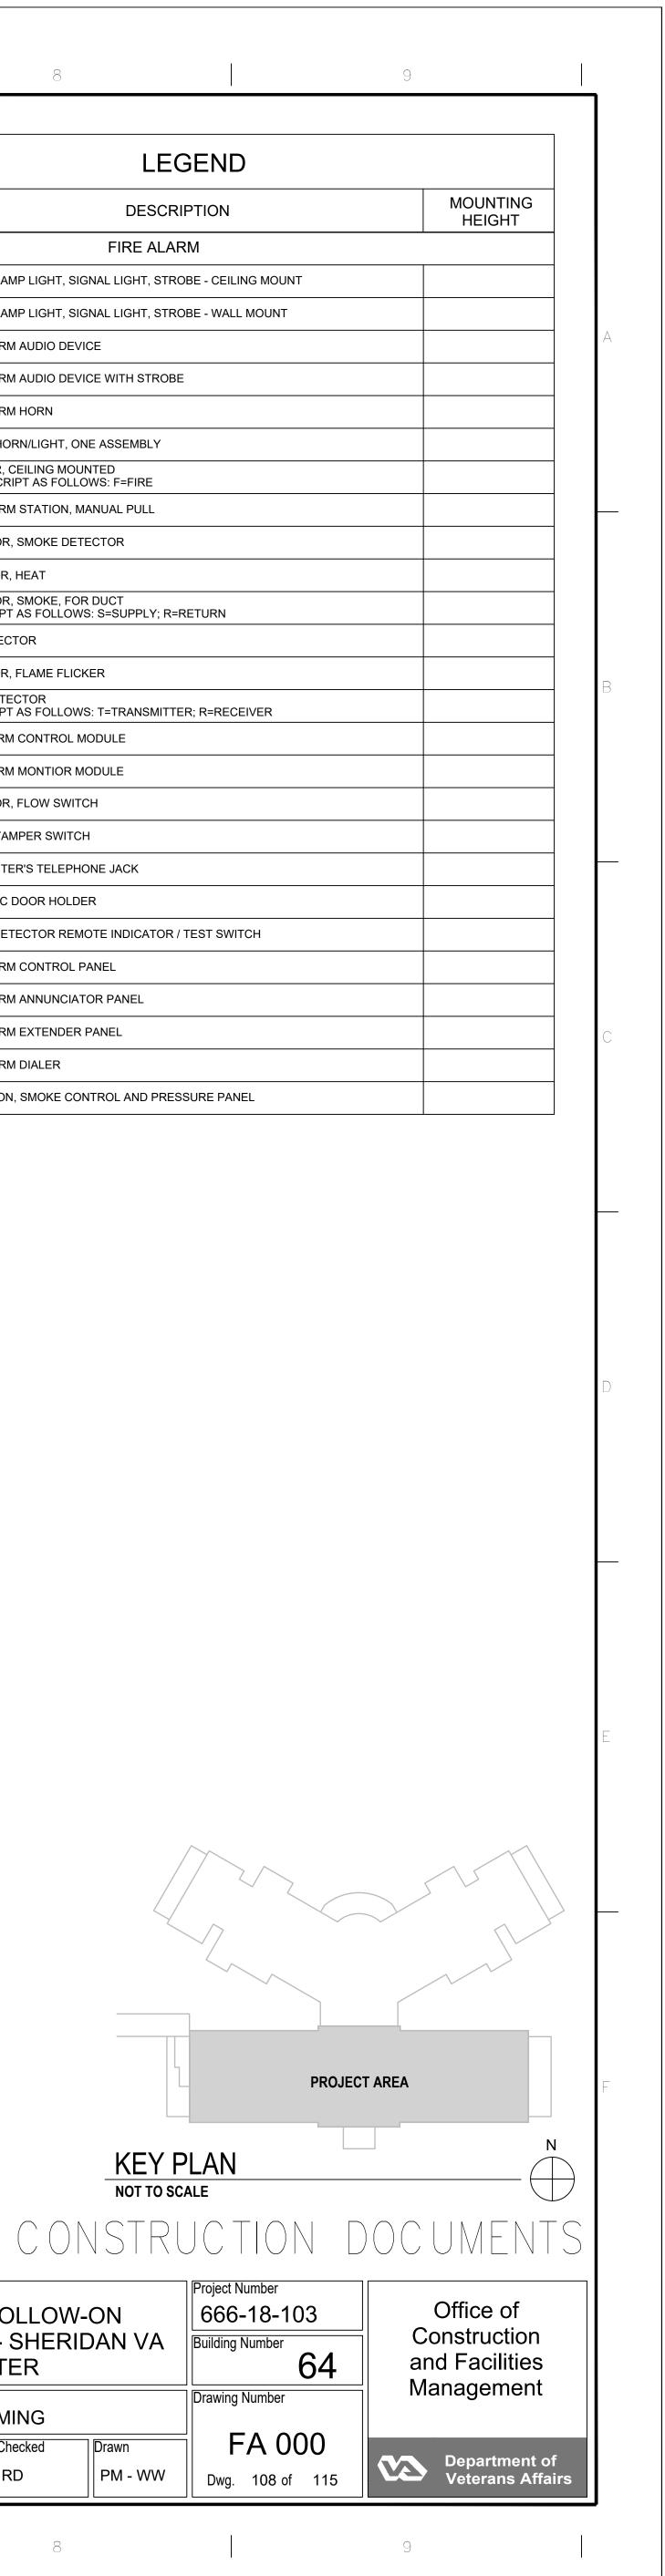


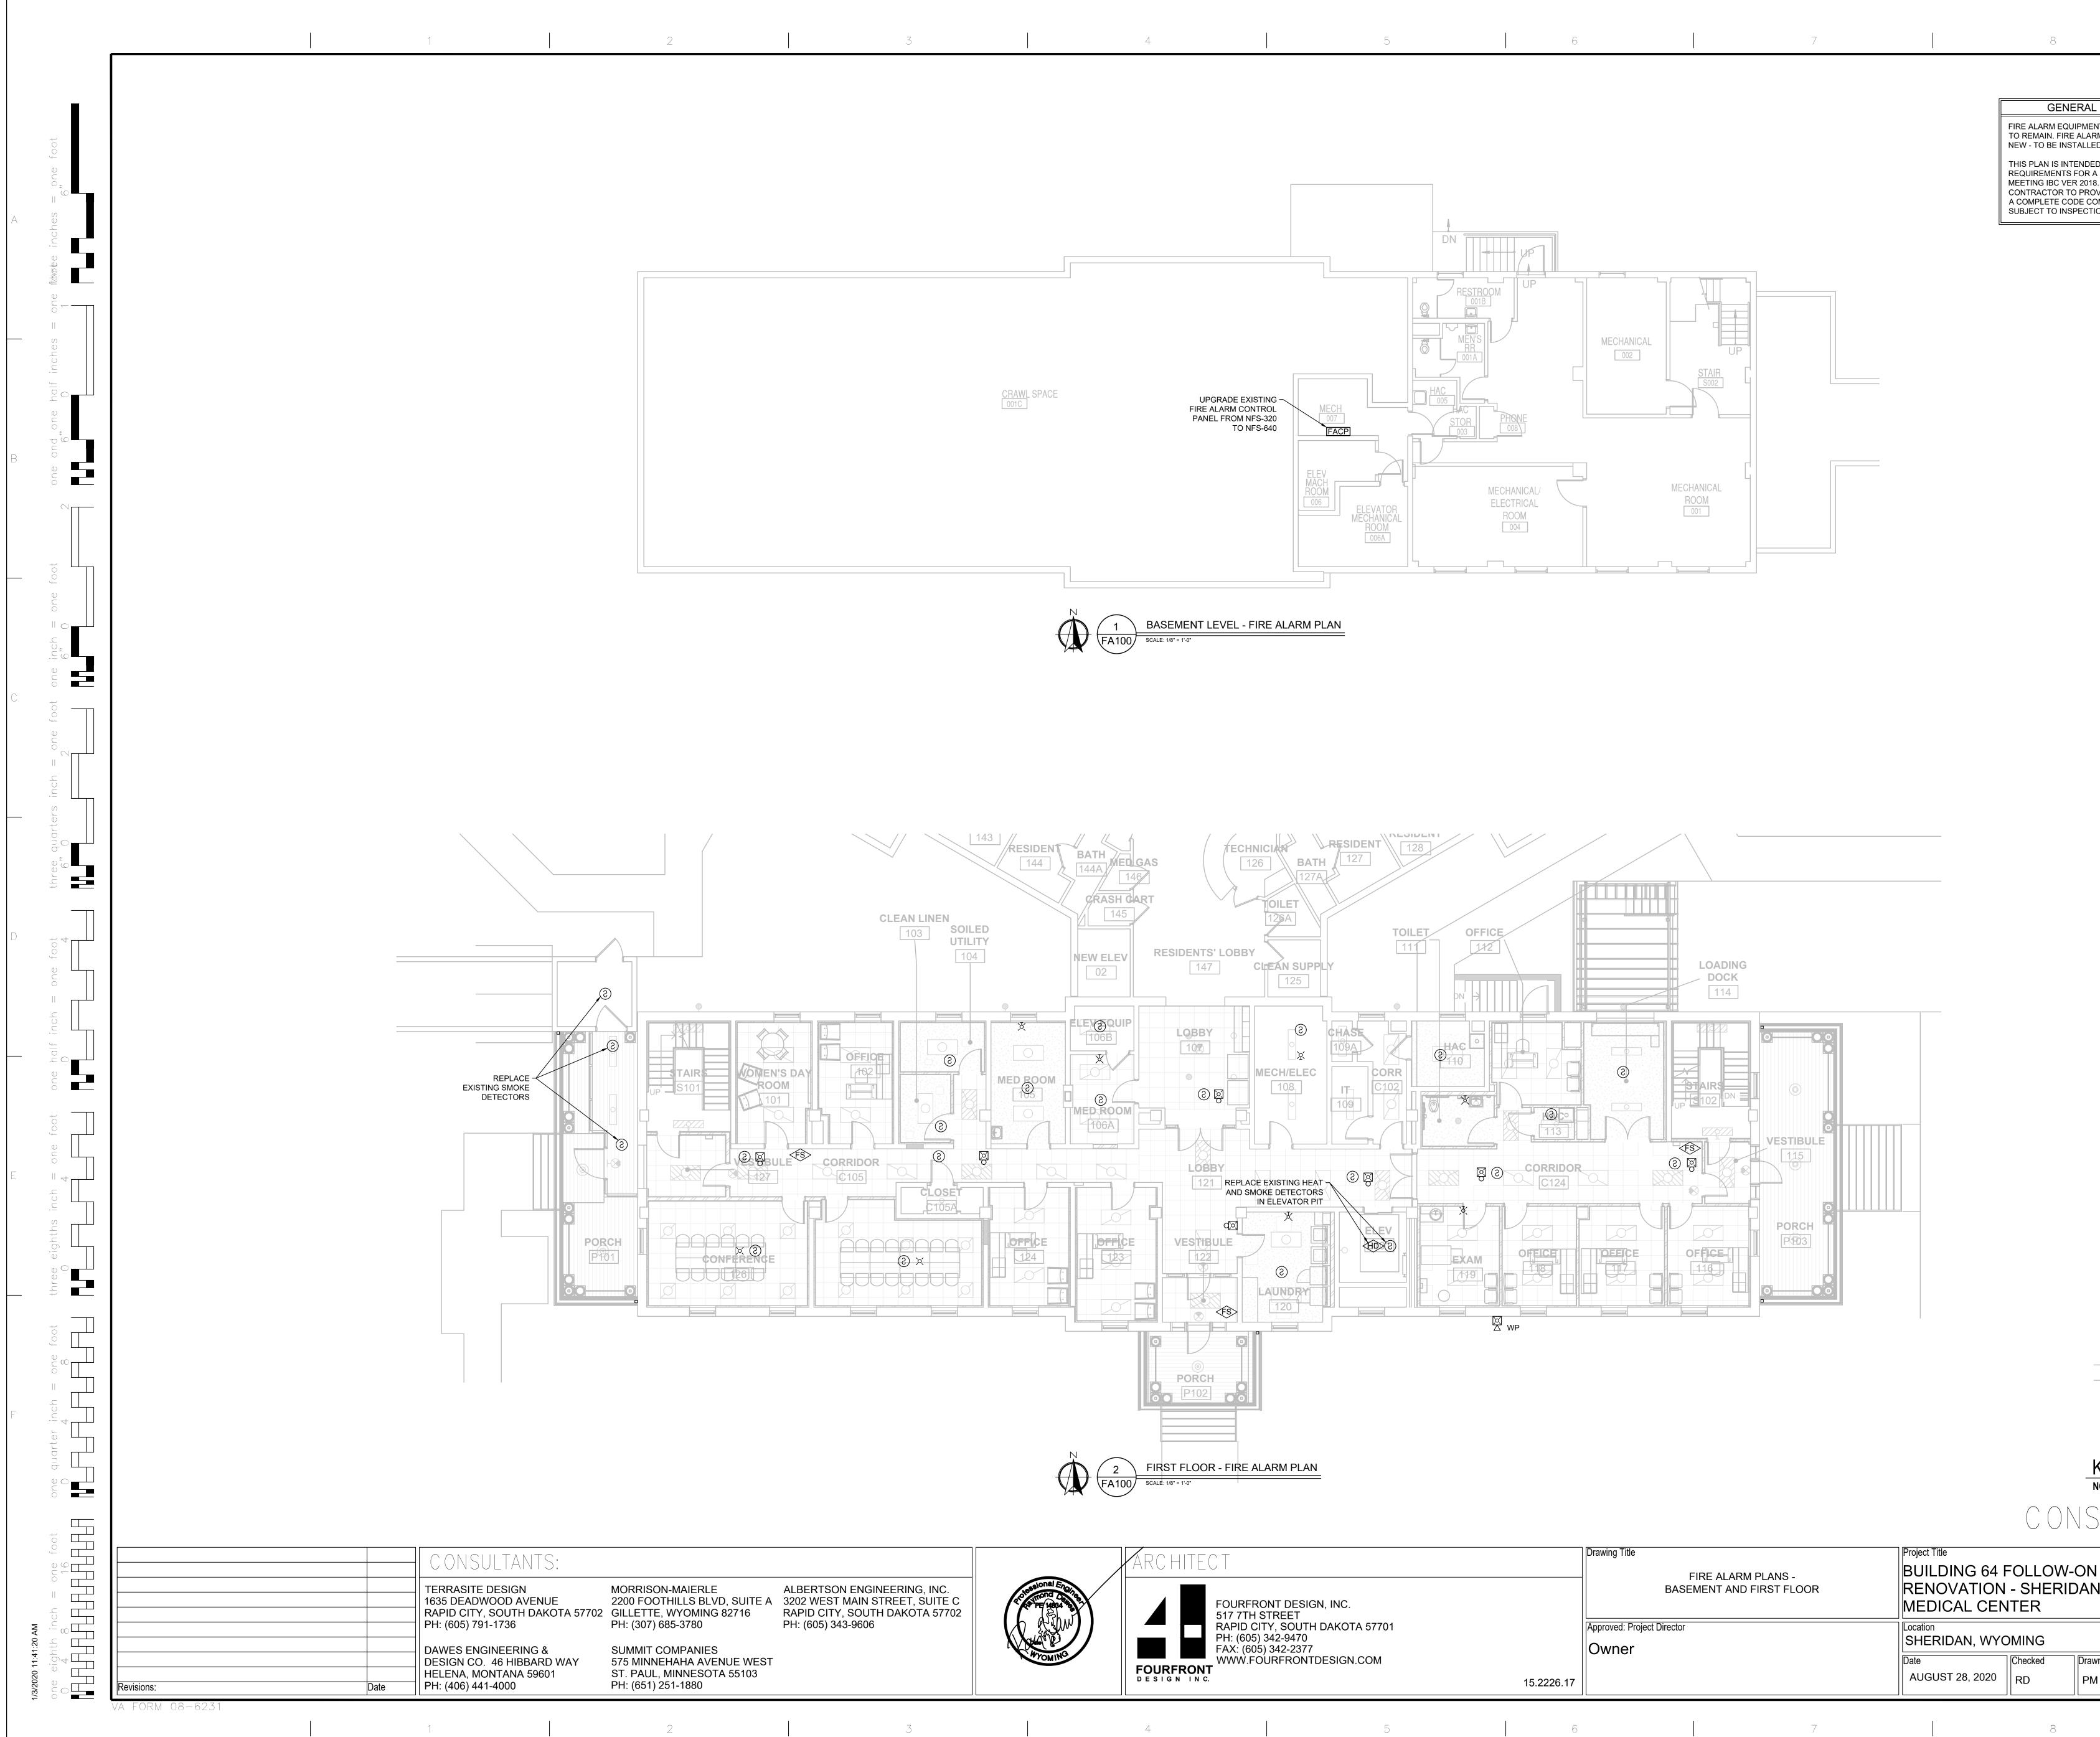
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SCPP DETECTION, SMOKE CONTROL AND PRESSURE PANEL

IGN, INC.		Drawing Title FIRE ALARM CODES AND REQUIREMENTS				Project Number 666-18-103 Building Number 64	
TH DAKOTA 57701) 77 NTDESIGN.COM		Approved: Project Director Owner	Location SHERIDAN, WY Date	SHERIDAN, WYOMING		Drawing Number FA 000	
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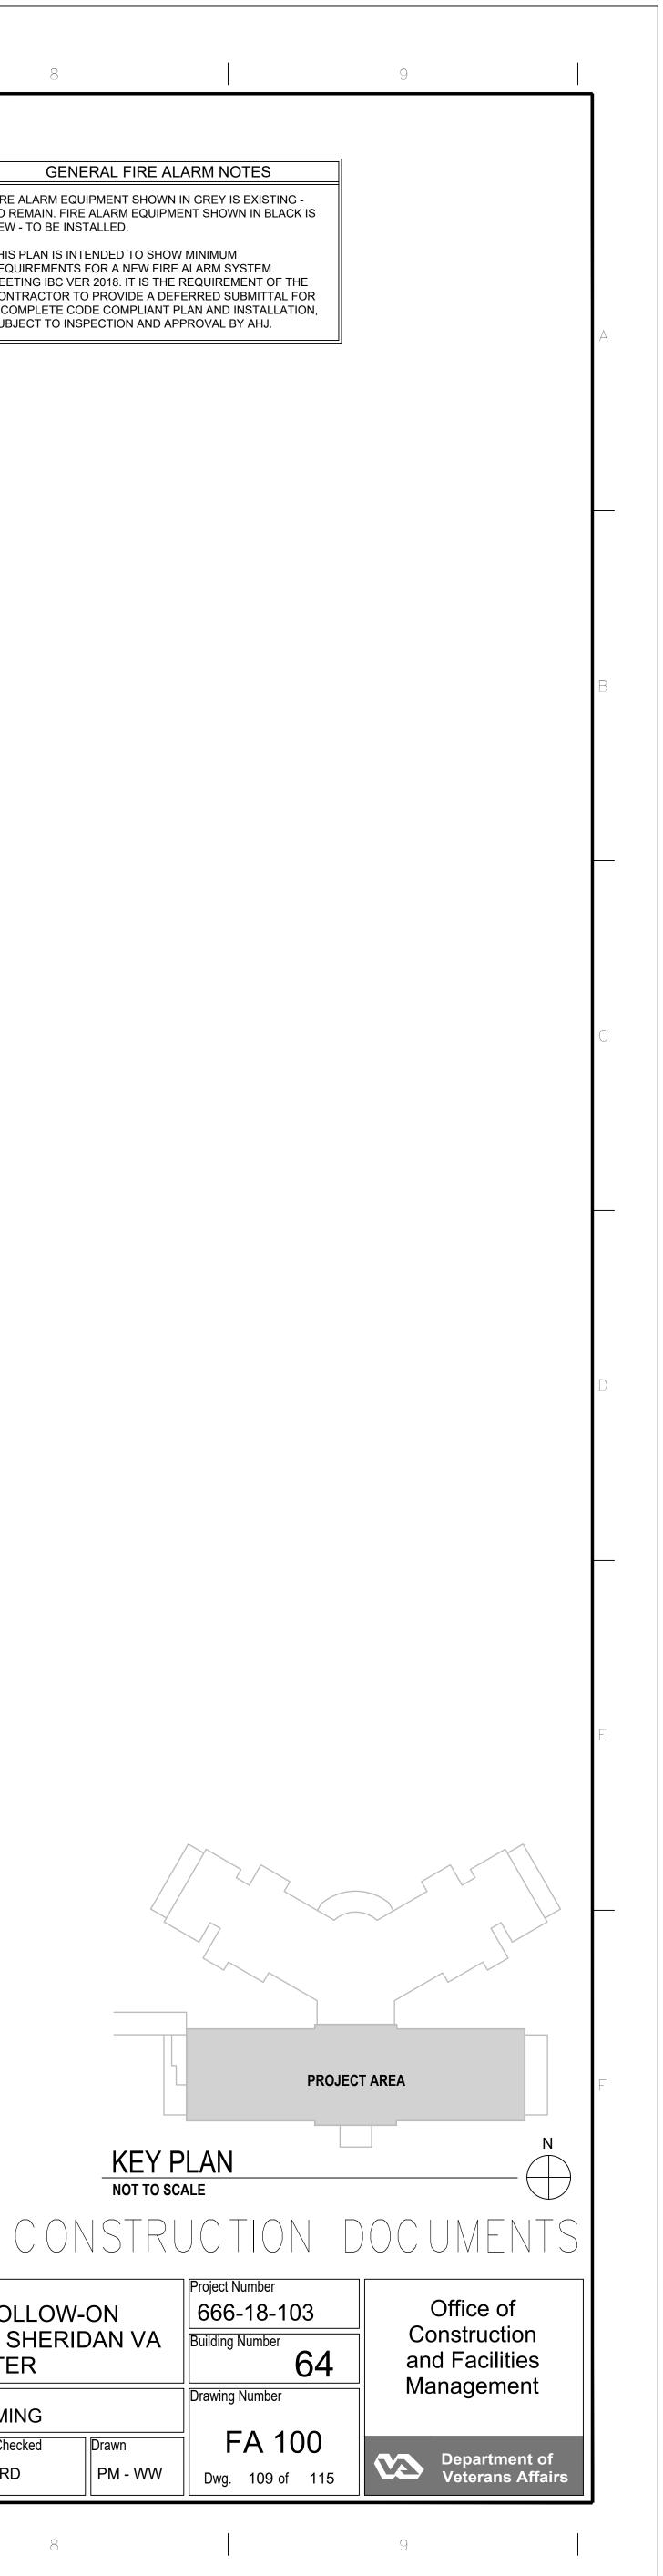


GENERAL FIRE ALARM NOTES FIRE ALARM EQUIPMENT SHOWN IN GREY IS EXISTING -TO REMAIN. FIRE ALARM EQUIPMENT SHOWN IN BLACK IS

NEW - TO BE INSTALLED. THIS PLAN IS INTENDED TO SHOW MINIMUM REQUIREMENTS FOR A NEW FIRE ALARM SYSTEM MEETING IBC VER 2018. IT IS THE REQUIREMENT OF THE CONTRACTOR TO PROVIDE A DEFERRED SUBMITTAL FOR A COMPLETE CODE COMPLIANT PLAN AND INSTALLATION,

SUBJECT TO INSPECTION AND APPROVAL BY AHJ.

Drawing Title	Project Title			Project Number	
FIRE ALARM PLANS -	BUILDING 64	BUILDING 64 FOLLOW-ON			
BASEMENT AND FIRST FLOOR	RENOVATION	RENOVATION - SHERIDAN VA			
	MEDICAL CEN	NTER			64
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Owner	SHERIDAN, WY		~ ~		
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	FIRE ALARM PLANS - BASEMENT AND FIRST FLOOR	FIRE ALARM PLANS - BASEMENT AND FIRST FLOOR BUILDING 64 RENOVATION MEDICAL CEN Approved: Project Director Location 	FIRE ALARM PLANS - BASEMENT AND FIRST FLOOR BUILDING 64 FOLLOW RENOVATION - SHEF MEDICAL CENTER Approved: Project Director Owner Location SHERIDAN, WYOMING	FIRE ALARM PLANS - BASEMENT AND FIRST FLOOR BUILDING 64 FOLLOW-ON RENOVATION - SHERIDAN VA MEDICAL CENTER Approved: Project Director Owner Location SHERIDAN, WYOMING Date Checked Drawn	FIRE ALARM PLANS - BASEMENT AND FIRST FLOOR BUILDING 64 FOLLOW-ON RENOVATION - SHERIDAN VA MEDICAL CENTER 666-18-10 Building Number Approved: Project Director Owner Image: Checked brawn Date AUGUST 28, 2020 Drawn Drawn Drawn Drawn Drawn FA 10



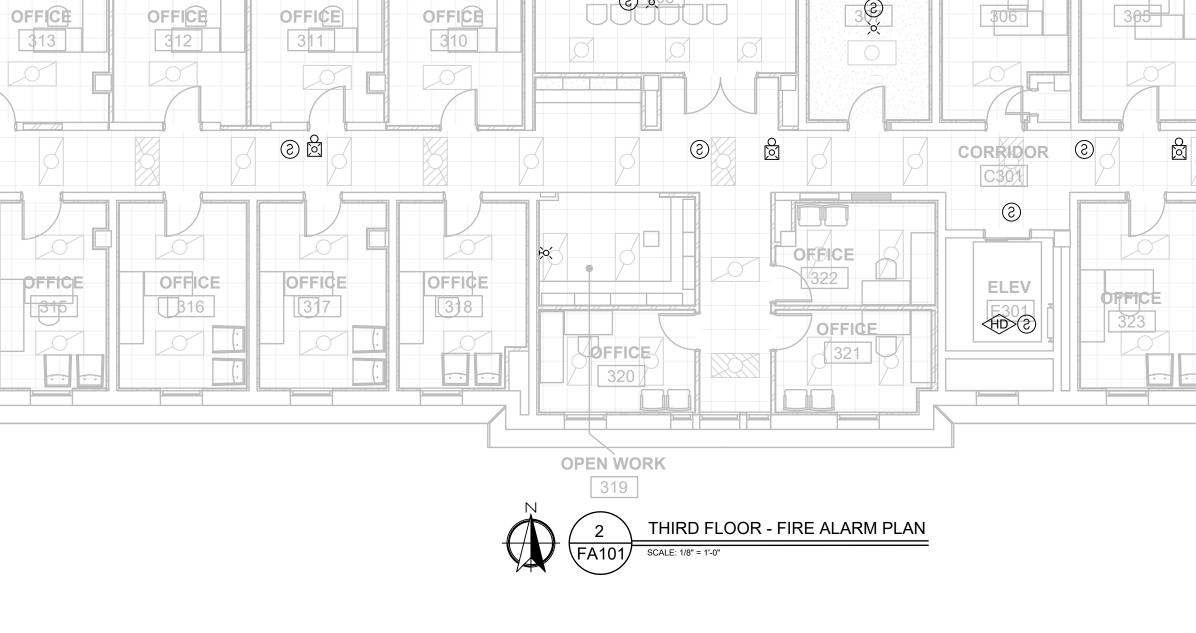
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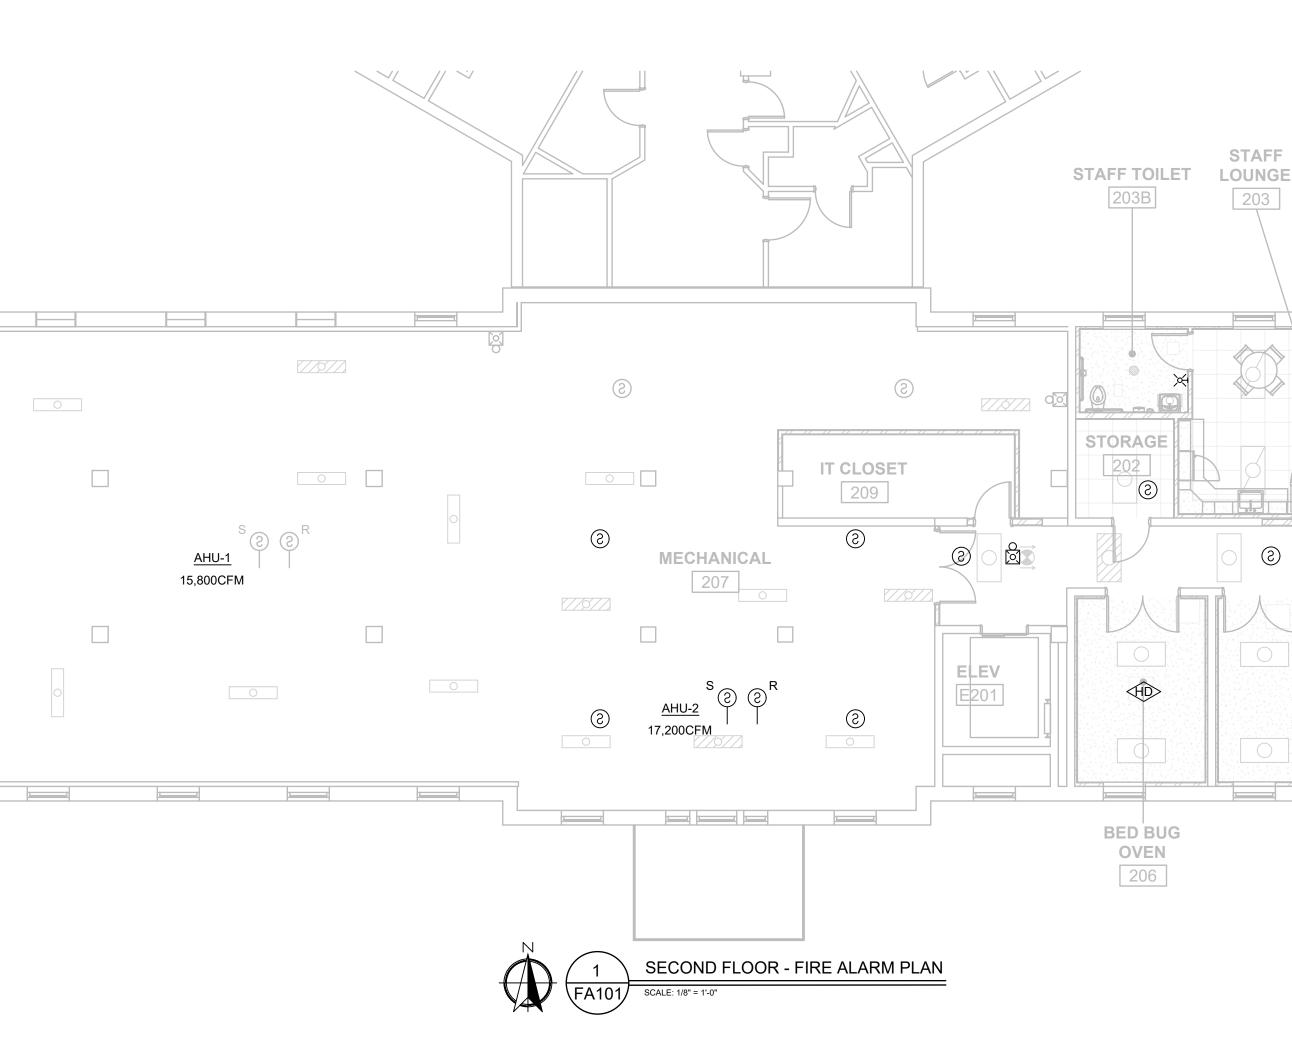
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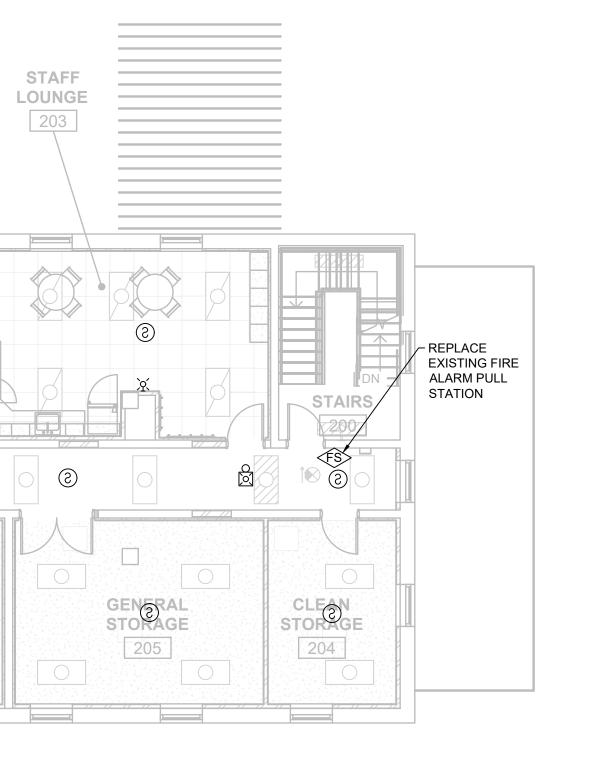
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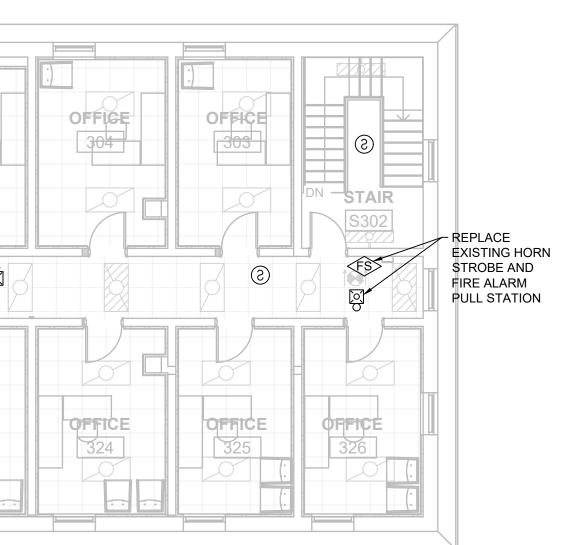
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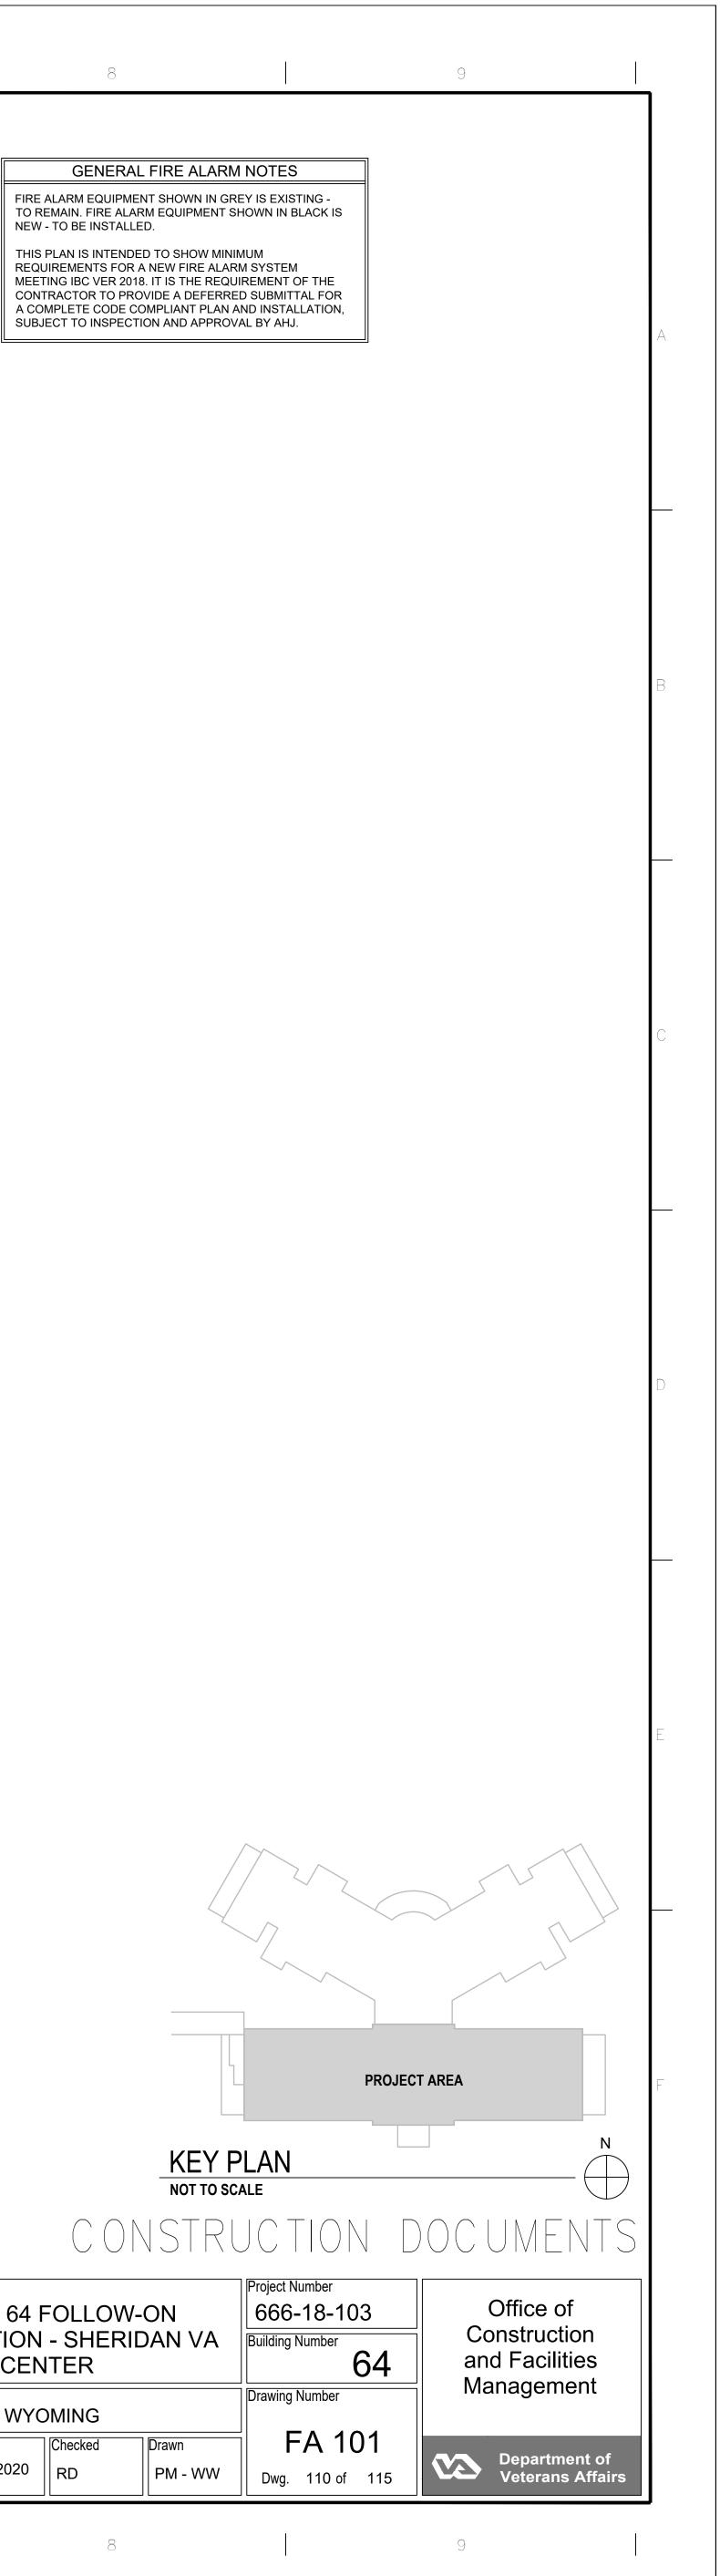


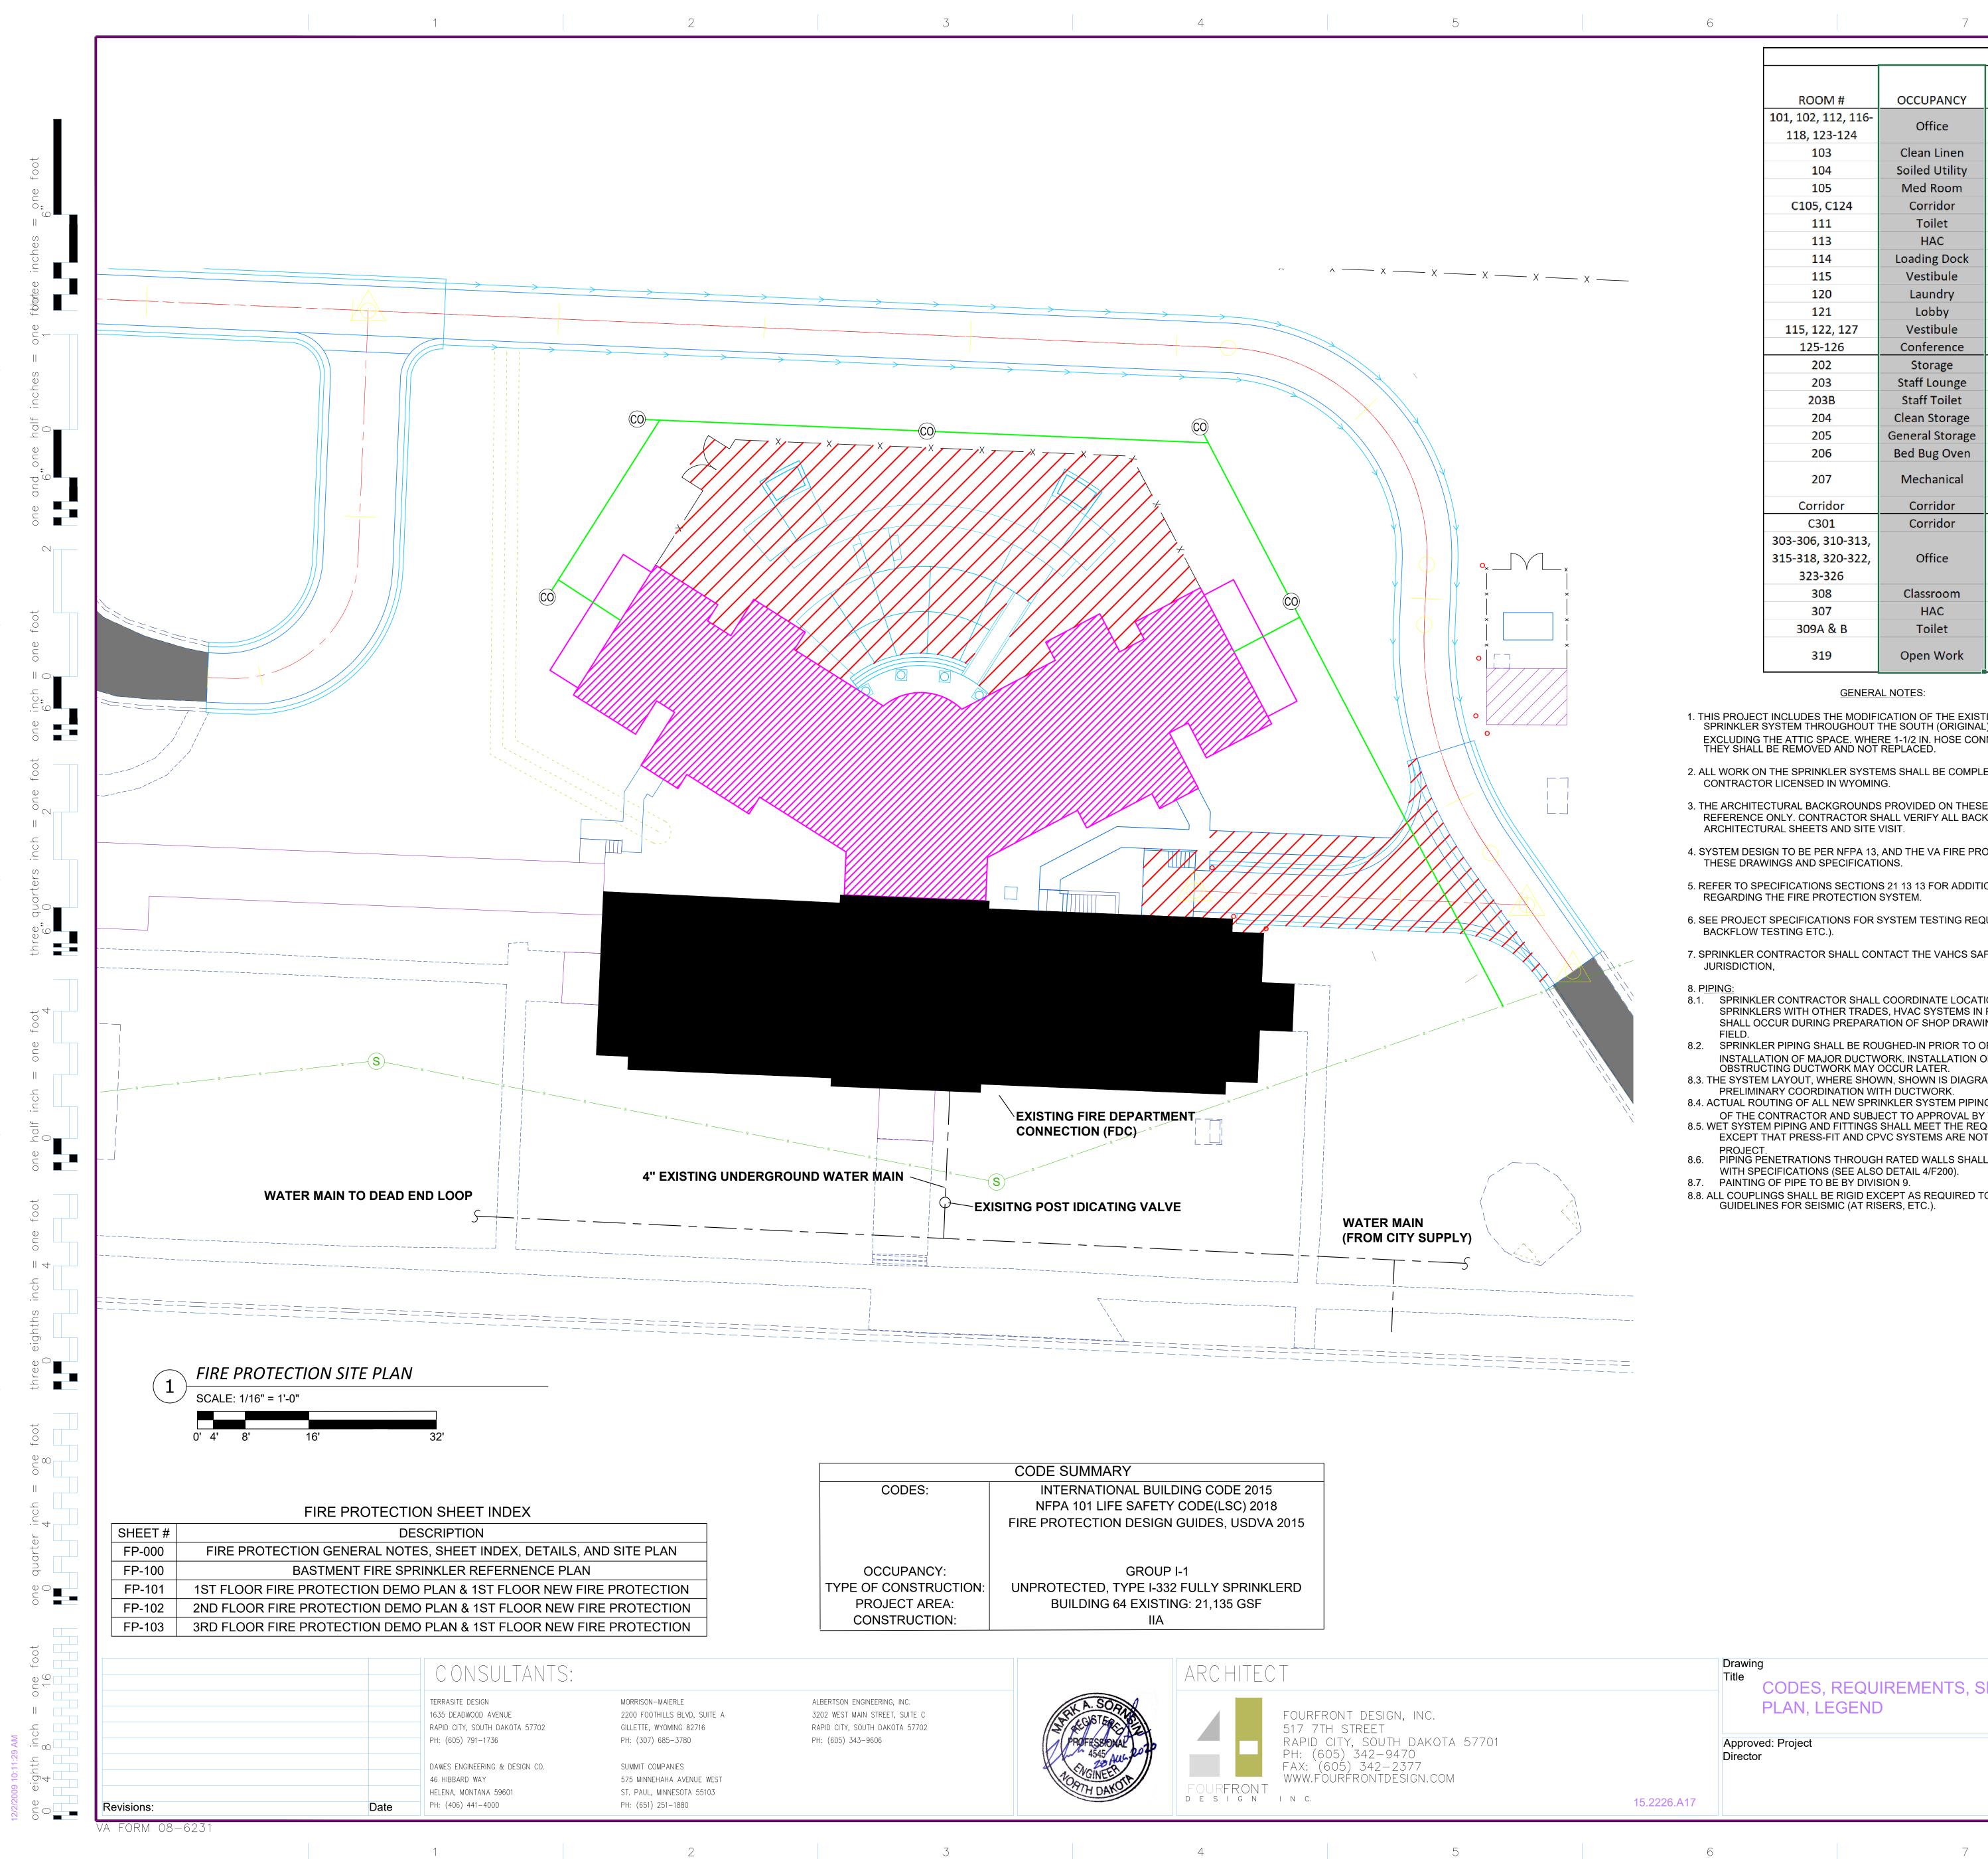
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AUTOMATIC SPRINKLER SYSTEM DESIGN SCHEDULE								
				SPRINKLER TEMP.	OUTSIDE HOSE			
ROOM #	OCCUPANCY	HAZARD CLASSIFICAITON	DESIGN DENSITY	RATING (DEG.F)	ALLOWANCE (GPM)			
101, 102, 112, 116- 118, 123-124	Office	Light	0.10 gpm/sq.ft. over Room	155	100			
103	Clean Linen	Ordinary Haz., Group 1	0.15 gpm/sq.ft. over Room	155	250			
104	Soiled Utility	Ordinary Haz., Group 1	0.15 gpm/sq.ft. over Room	155	100			
105	Med Room	Light	0.10 gpm/sq.ft. over Room	155	100			
C105, C124	Corridor	Light	0.10 gpm/sq.ft. over 5 sprinklers	155	100			
111	Toilet	Light	0.10 gpm/sq.ft. over Room	155	100			
113	HAC	Ordinary Haz., Group 1	0.15 gpm/sq.ft. over Room	155	250			
114	Loading Dock	Ordinary Haz., Group 2	0.20 gpm/sq.ft. over Room	155	250			
115	Vestibule	Light	0.10 gpm/sq.ft. over Room	155	100			
120	Laundry	Ordinary Haz., Group 1	0.15 gpm/sq.ft. over Room	155	250			
121	Lobby	Light	0.10 gpm/sq.ft. over Room	155	100			
115, 122, 127	Vestibule	Light	0.10 gpm/sq.ft. over Room	155	100			
125-126	Conference	Light	0.10 gpm/sq.ft. over Room	155	100			
202	Storage	Ordinary Haz., Group 2	0.20 gpm/sq.ft. over Room	155	250			
203	Staff Lounge	Light	0.10 gpm/sq.ft. over Room	155	100			
203B	Staff Toilet	Light	0.10 gpm/sq.ft. over Room	155	100			
204	Clean Storage	Ordinary Haz., Group 2	0.20 gpm/sq.ft. over Room	155	250			
205	General Storage	Ordinary Haz., Group 2	0.20 gpm/sq.ft. over Room	155	250			
206	Bed Bug Oven	Light	0.10 gpm/sq.ft. over Room	155	100			
207	Mechanical	Ordinary Haz., Group 1	0.15 gpm/sq.ft. over 900 sq.ft. (using QR reduction)	155	250			
Corridor	Corridor	Light	0.10 gpm/sq.ft. over 5 sprinklers	155	100			
C301	Corridor	Light	0.10 gpm/sq.ft. over 5 sprinklers	155	100			
303-306, 310-313,		_						
315-318, 320-322,	Office	Light	0.10 gpm/sq.ft. over Room	155				
323-326					100			
308	Classroom	Light	0.10 gpm/sq.ft. over Room	155	100			
307	HAC	Ordinary Haz., Group 1	0.15 gpm/sq.ft. over Room	155	250			
309A & B	Toilet	Light	0.10 gpm/sq.ft. over Room	155	100			
319	Open Work	Light	0.10 gpm/sq.ft. over 900 sq.ft. (incl. corr using QR reduction)	155	100			

GENERAL NOTES:

- 1. THIS PROJECT INCLUDES THE MODIFICATION OF THE EXISTING AUTOMATIC FIRE SPRINKLER SYSTEM THROUGHOUT THE SOUTH (ORIGINAL) PORTION OF BUILDING 64, EXCLUDING THE ATTIC SPACE. WHERE 1-1/2 IN. HOSE CONNECTIONS CURRENTLY EXIST THEY SHALL BE REMOVED AND NOT REPLACED.
- 2. ALL WORK ON THE SPRINKLER SYSTEMS SHALL BE COMPLETED BY A SPRINKLER CONTRACTOR LICENSED IN WYOMING.
- 3. THE ARCHITECTURAL BACKGROUNDS PROVIDED ON THESE SHEETS ARE FOR GENERAL REFERENCE ONLY. CONTRACTOR SHALL VERIFY ALL BACKGROUNDS WITH ARCHITECTURAL SHEETS AND SITE VISIT.
- 4. SYSTEM DESIGN TO BE PER NFPA 13, AND THE VA FIRE PROTECTION DESIGN GUIDE, AND THESE DRAWINGS AND SPECIFICATIONS.
- 5. REFER TO SPECIFICATIONS SECTIONS 21 13 13 FOR ADDITIONAL INFORMATION REGARDING THE FIRE PROTECTION SYSTEM.
- 6. SEE PROJECT SPECIFICATIONS FOR SYSTEM TESTING REQUIREMENTS (HYDROSTATIC, BACKFLOW TESTING ETC.).
- 7. SPRINKLER CONTRACTOR SHALL CONTACT THE VAHCS SAFETY OFFICER HAVING JURISDICTION,
- 8. PIPING: 8.1. SPRINKLER CONTRACTOR SHALL COORDINATE LOCATION OF ALL PIPING AND SPRINKLERS WITH OTHER TRADES, HVAC SYSTEMS IN PARTICULAR. COORDINATION SHALL OCCUR DURING PREPARATION OF SHOP DRAWINGS, AS WELL AS IN THE FIELD.
- 8.2. SPRINKLER PIPING SHALL BE ROUGHED-IN PRIOR TO OR CONCURRENTLY WITH THE INSTALLATION OF MAJOR DUCTWORK. INSTALLATION OF SPRINKLERS BELOW OBSTRUCTING DUCTWORK MAY OCCUR LATER.
- 8.3. THE SYSTEM LAYOUT, WHERE SHOWN, SHOWN IS DIAGRAMMATIC AND BASED ON PRELIMINARY COORDINATION WITH DUCTWORK. 8.4. ACTUAL ROUTING OF ALL NEW SPRINKLER SYSTEM PIPING IS THE RESPONSIBILITY
- OF THE CONTRACTOR AND SUBJECT TO APPROVAL BY THE ENGINEER. 8.5. WET SYSTEM PIPING AND FITTINGS SHALL MEET THE REQUIREMENTS OF NFPA-13,
- EXCEPT THAT PRESS-FIT AND CPVC SYSTEMS ARE NOT APPROVED FOR THIS PROJECT.
- PIPING PENETRATIONS THROUGH RATED WALLS SHALL BE SEALED IN ACCORDANCE 8.6. WITH SPECIFICATIONS (SEE ALSO DETAIL 4/F200). PAINTING OF PIPE TO BE BY DIVISION 9. 8.7.
- 8.8. ALL COUPLINGS SHALL BE RIGID EXCEPT AS REQUIRED TO MEET NFPA-13 GUIDELINES FOR SEISMIC (AT RISERS, ETC.).

9. HANGERS:

- 9.1. HANGERS, HANGER RODS, CLAMPS, AND INSERTS SHALL BE IN ACCORDANCE WITH NFPA-13.
- 9.2. TRAPEZE-STYLE HANGING ASSEMBLIES MAY BE USED, BUT ONLY WITH DOCUMENTATION ON THE SHOP DRAWINGS VALIDATING THE SIZING OF THE
- 9.3. HANGER ATTACHMENTS TO CONCRETE TEE CONSTRUCTION SHALL BE MADE VERTICALLY FROM THE HORIZONTAL FLANGE PORTION OF THE STRUCTURE (ABOVE), NOT FROM A HORIZONTAL CONNECTION TO THE VERTICAL WEB MEMBER.
- 10. SPRINKLERS: 10.1. ALL EXISTING SPRINKLERS ON THE ORIGINAL BUILDING WET-PIPE SYSTEM SHALL BE REPLACED.
- 10.3. ELECTRICAL AND MECHANICAL ROOMS SHALL UTILIZE INTERMEDIATE TEMPERATURE RATED SPRINKLERS.
- 10.4. SPRINKLERS INSIDE ELECTRICAL ROOMS AND IT CLOSETS SHALL BE STANDARD RESPONSE WITHOUT GLASS BULBS. 10.5. ALL AUTOMATIC SPRINKLERS LOCATED WITHIN SUSPENDED TILE CEILINGS SHALL
- MECHANICAL ROOM. 10.6. SPRINKLERS SHALL BE LOCATED IN THE CENTER OF TILE.
- 10.7. PROTECTION OF SPRINKLERS DURING PAINTING, AND REMOVAL THEREAFTER, SHALL BE BY DIVISION 9.
- AND/OR ARE SUSCEPTIBLE TO DAMAGE.
- 11. WATER SUPPLY DATA: CONTRACTOR SHALL USE THE FOLLOWING WATER SUPPLY INFORMATION FOR BID PURPOSES ONLY. SEE SPECIFICATIONS DETAILING
- REQUIREMENTS FOR UPDATED FLOW TESTING FOR SHOP DRAWINGS: 11.1. STATIC: 69 PSI RESIDUAL: 54 PSI FLOWING: 1,062 GPM
- 11.2. TEST CONDUCTED BY : WESTERN STATES FIRE DATE: 06/15/2015 11.3. G<u>UAGE HYDRANT SE</u> AT B64
- 11.4. EFFECTIVE POINT: WHERE 4 INCH UNDERGROUND CONNECTS TO UNDERGROUND
- MAIN SOUTH OF BUILDING. SEE 1/F000.



Building

Number

Drawing

Number

Dwg.111 of 115

RENOVATION - SHERIDAN VA

Checked

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Drawn

NC & AT

MEDICAL CENTER

SHERIDAN, WYOMING

AUGUST 28, 2020 MAS

Location

Date

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Title	
CODES, REQUIREMENTS, S	IT
PLAN, LEGEND	

Approved: Project

Director

15.2226.A17

GENERAL NOTES:

TRAPEZE MEMBERS. WHEN A TRAPEZE MEMBER IS NOT EXPLICITLY LISTED IN NFPA-13 (E.G. UNISTRUT), DOCUMENTATION MUST BE PROVIDED THAT INDICATES ADEQUATE SECTION MODULUS AND OTHER PERTINENT PARAMETERS ARE BEING

10.2. ALL NEW SPRINKLERS ARE TO BE QUICK RESPONSE, EXCEPT AS NOTED BELOW.

BE WHITE, CONCEALED. REMAINING EXPOSED SPRINKLERS SHALL BE WHITE POLY-COATED. BRASS SPRINKLERS MAY BE USED IN UNFINISHED AREAS SUCH AS THE

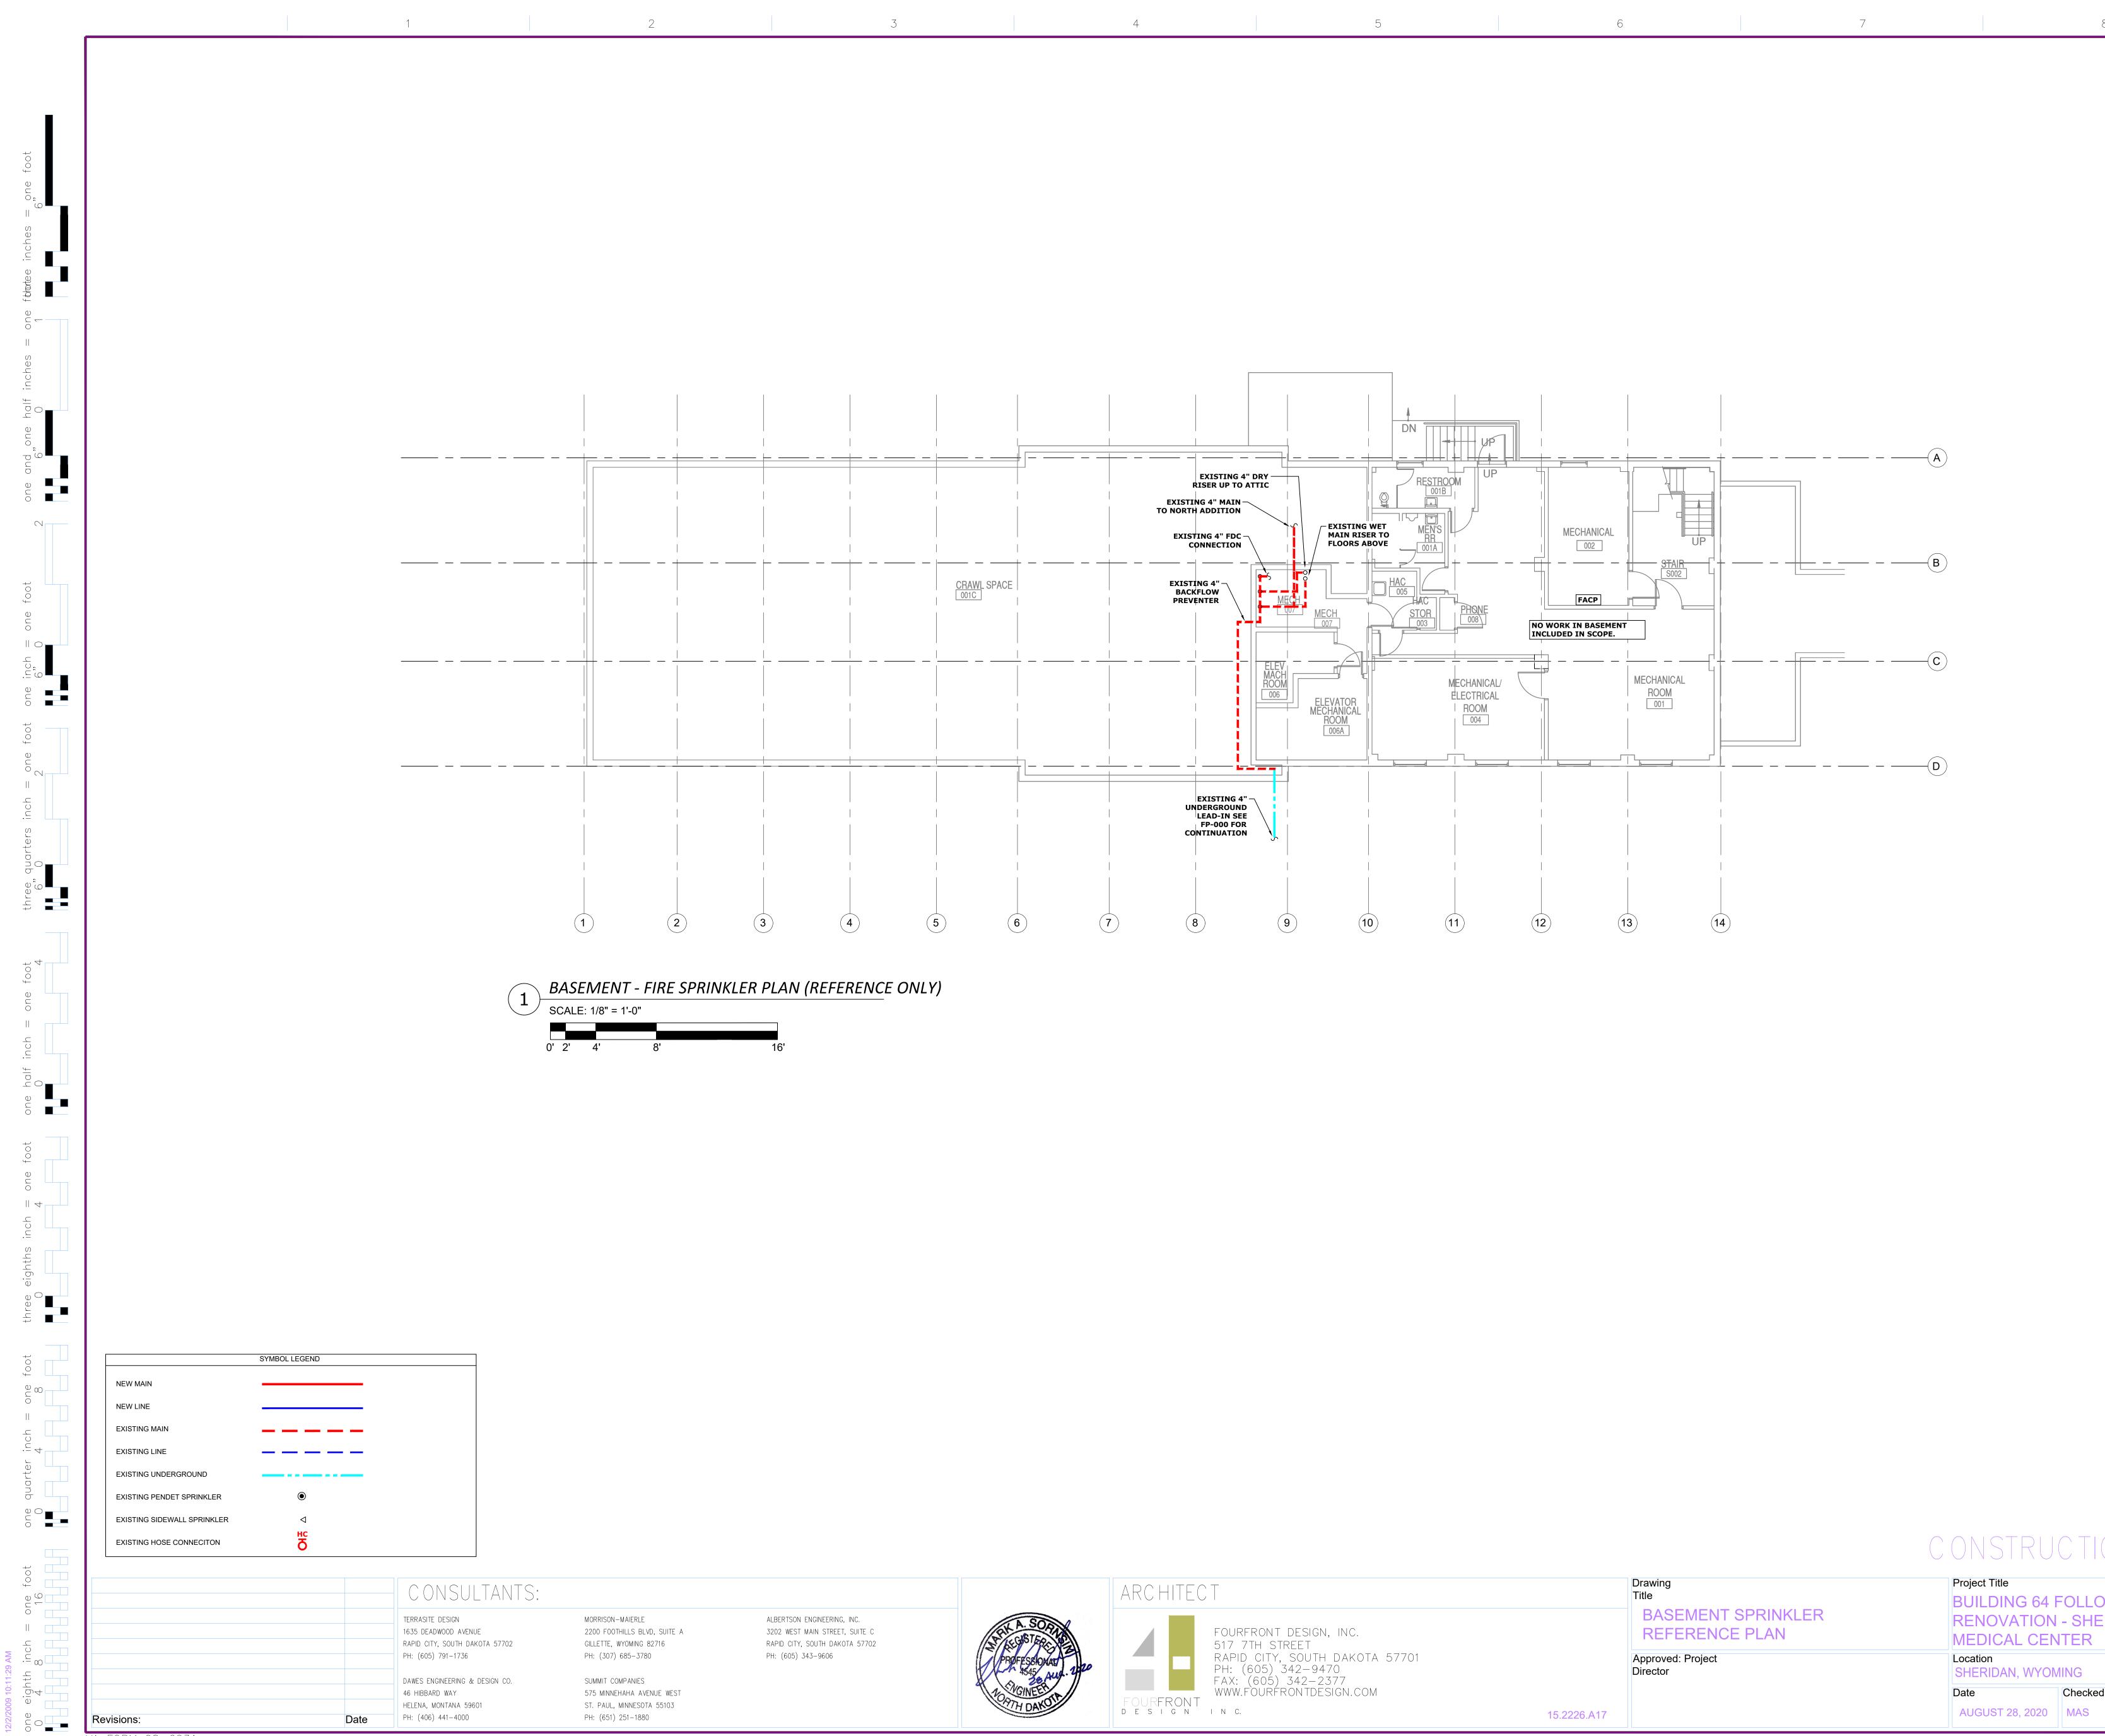
10.8. SPRINKLER GUARDS LISTED FOR USE WITH THE RESPECTIVE SPRINKLERS SHALL BE INSTALLED ANYWHERE EXPOSED SPRINKLERS ARE LOCATED BELOW 7'-6" AFF

11.5. HOSE ALLOWANCES SHALL BE TAKEN AT THIS SAME EFFECTIVE POINT.

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PROJECT AREA

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VA FORM 08-6231

KEY PLAN NOT TO SCALE CONSTRUCTION DOCUMENTS Project Title Project Number 666-18-103 **BUILDING 64 FOLLOW-ON RENOVATION - SHERIDAN VA** Building Number MEDICAL CENTER Location Drawing SHERIDAN, WYOMING Number

Checked

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