
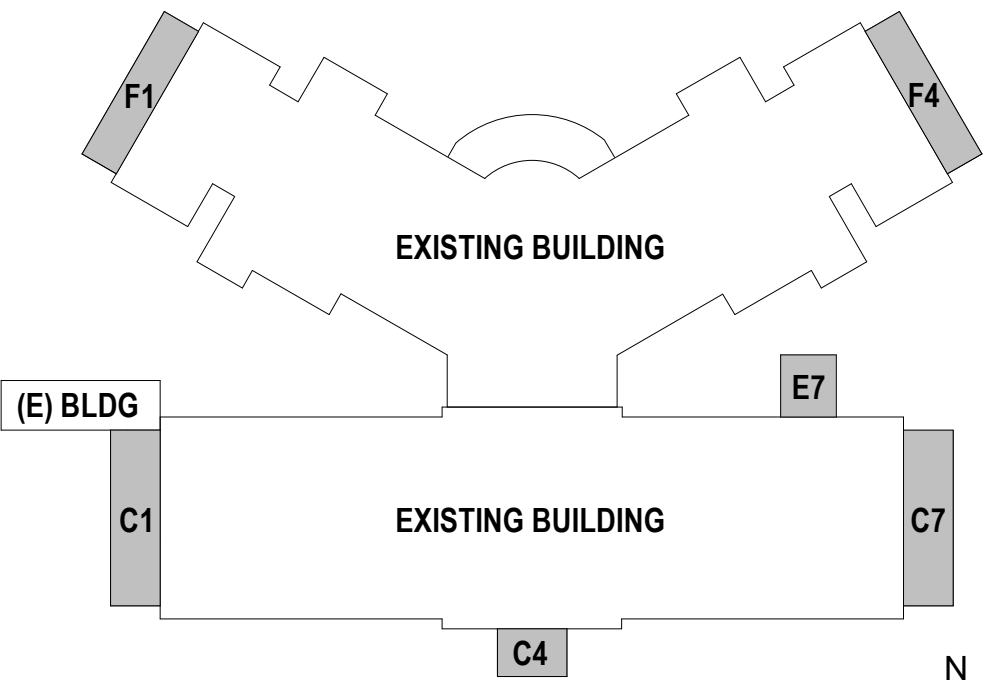


WIND UPLIFT SCHEDULE - PORCHES				
HATCH	WIDTH (a)	PRESSURE (PSF)		
		EFFECTIVE WIND AREA (SQUARE FEET)		
		0 - 10	10 - 40	>40
	REMAINDER	24	24	24
	3'-0"	36	36	24
	3'-0"	72	36	24

NOTE:
WIND UPLIFT PRESSURES SHOWN ARE GROSS PRESSURES FOR DESIGN OF COMPONENTS AND CLADDING (FACTORED).

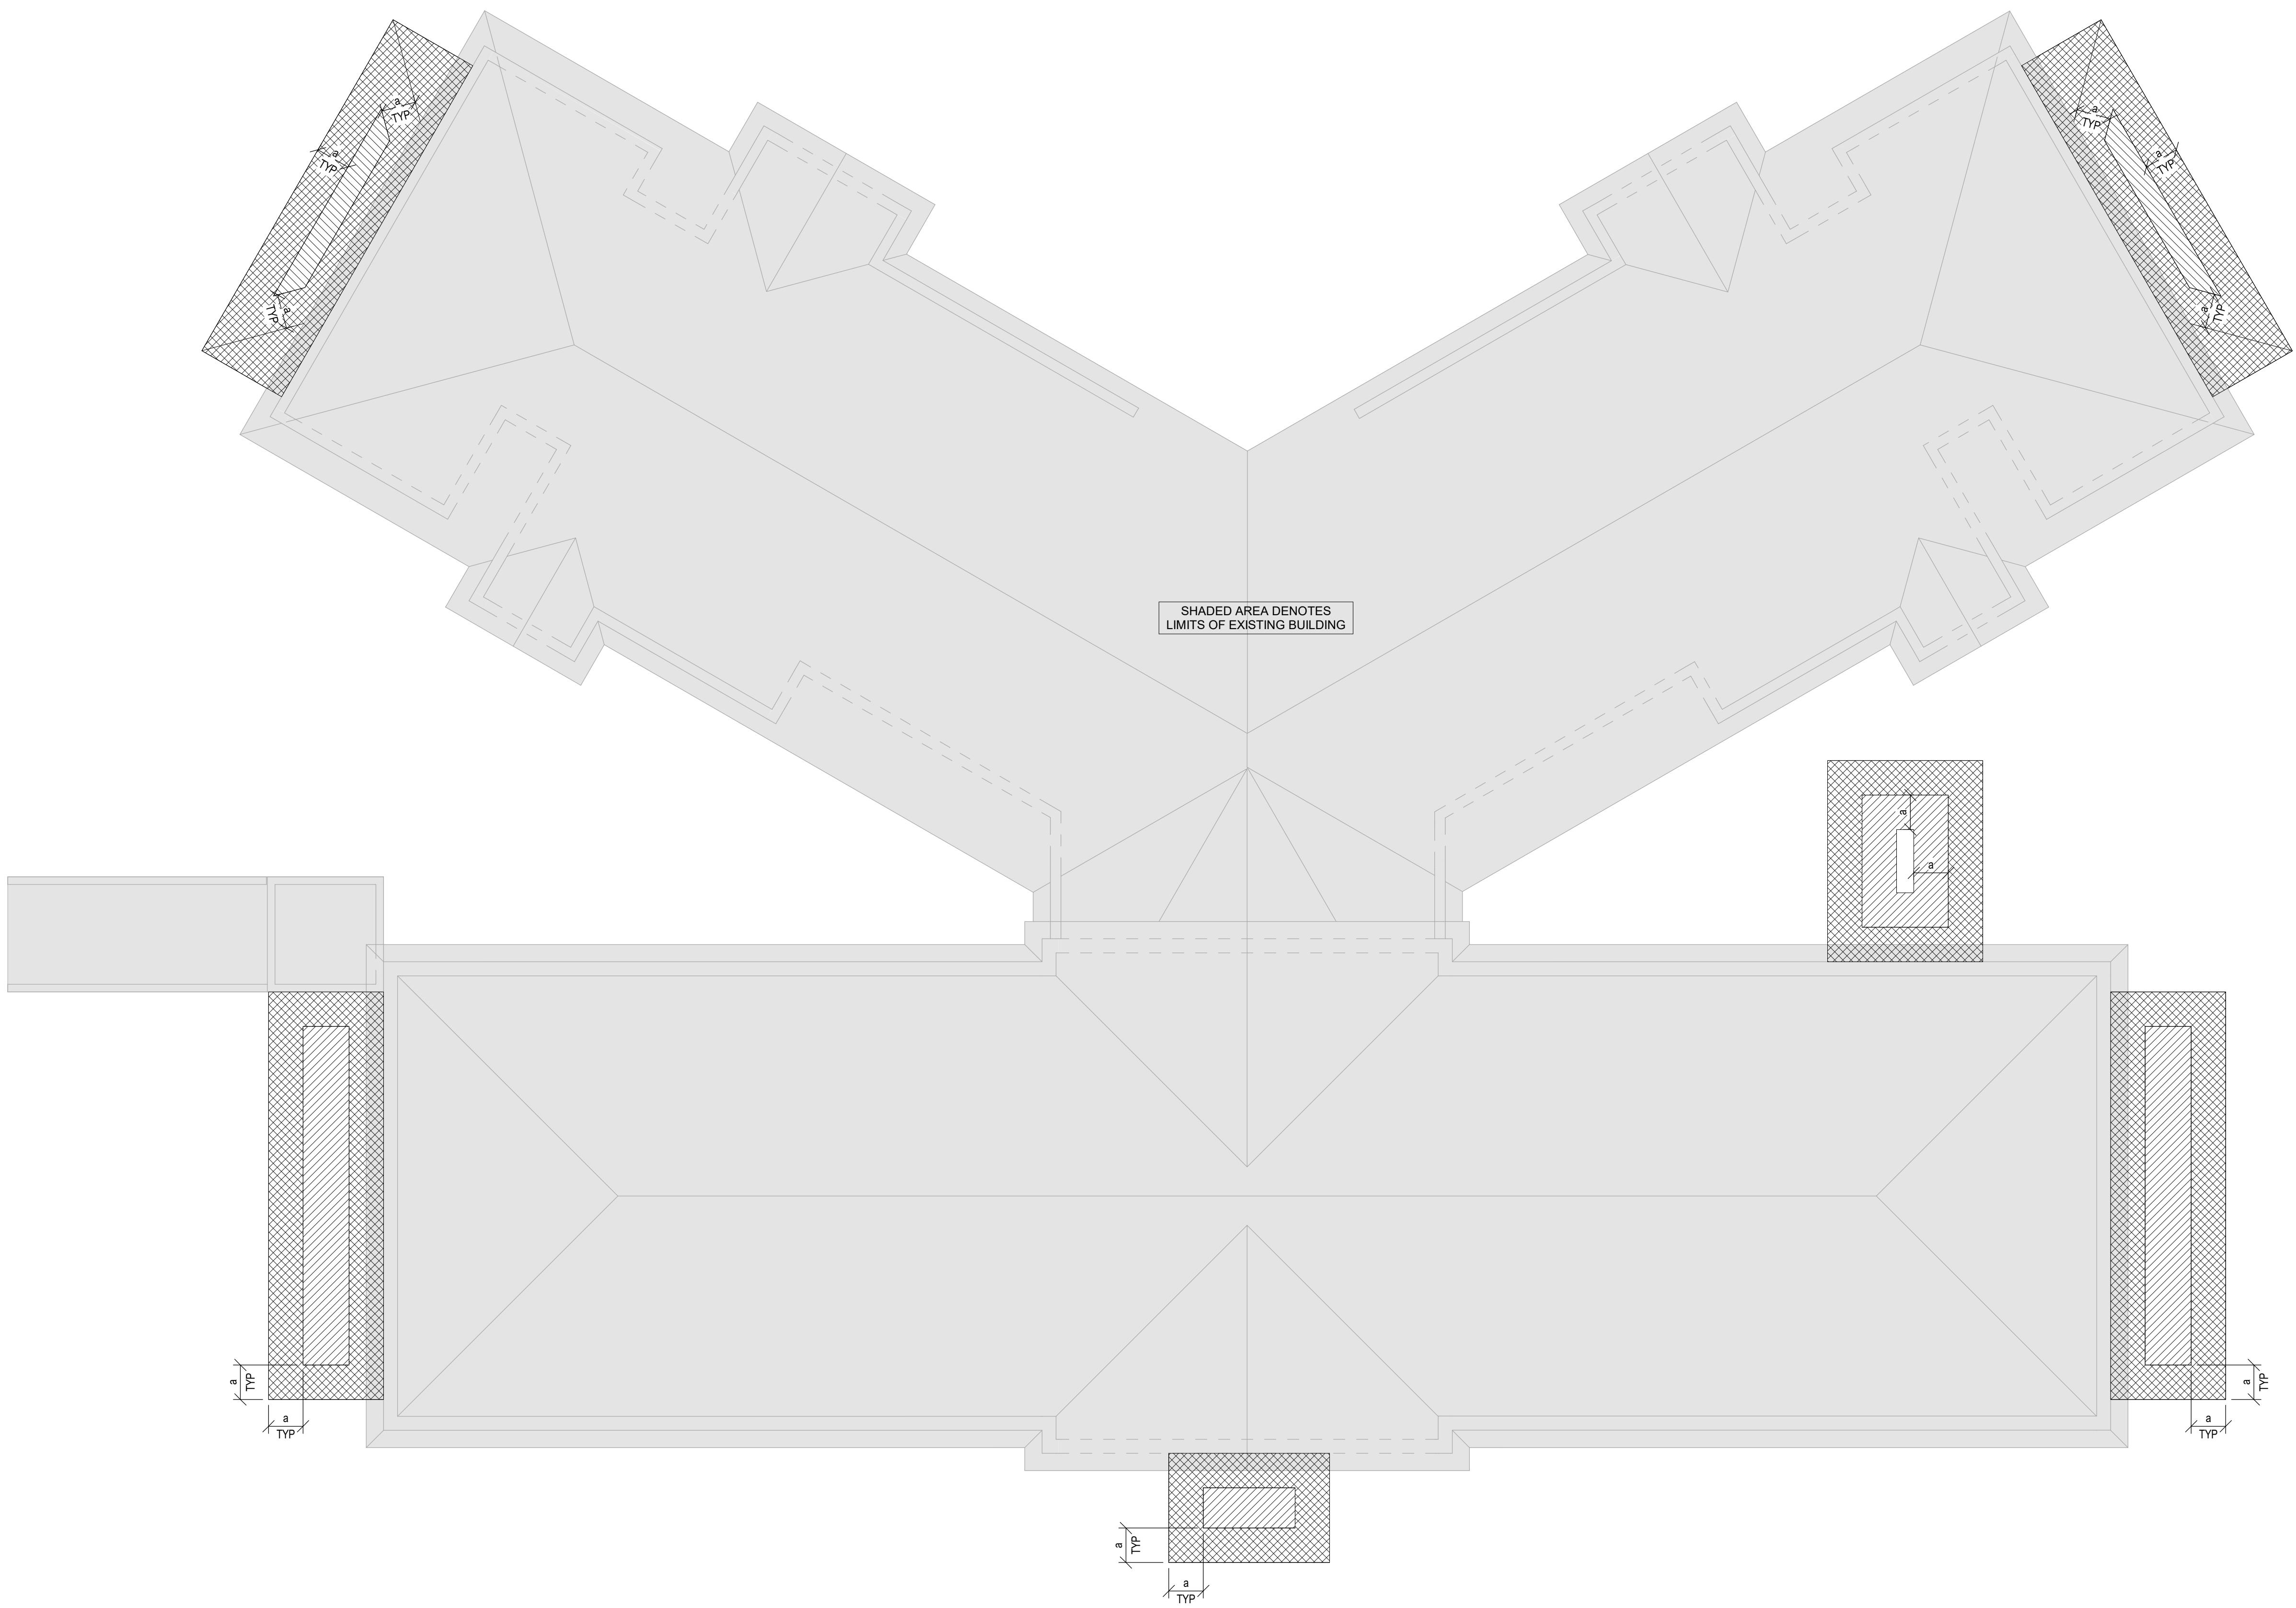

KEY PLAN
NOT TO SCALE

F1
S0.04
OVERALL PORCH & LOADING DOCK WIND UPLIFT PLANS
SCALE: 1/8" = 1'-0"

CONSTRUCTION DOCUMENTS

Revisions:

Date

CONSULTANTS:

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19.2482

Drawing Title

OVERALL PORCH & LOADING DOCK WIND UPLIFT PLANS

Approved: Project Director

OWNER

Project Title

BUILDING 64 FOLLOW-ON RENOVATION - SHERIDAN VA MEDICAL CENTER

Location

SHERIDAN, WYOMING

Date

AUGUST 28, 2020

Checked

LGF

Drawn

KNR

Project Number

666-18-103

Building Number

64

Drawing Number

S0.04


Dwg. 58 of 115

Office of Construction and Facilities Management

Department of Veterans Affairs

VA FORM 08-6231

8/27/2020 11:48:27 AM

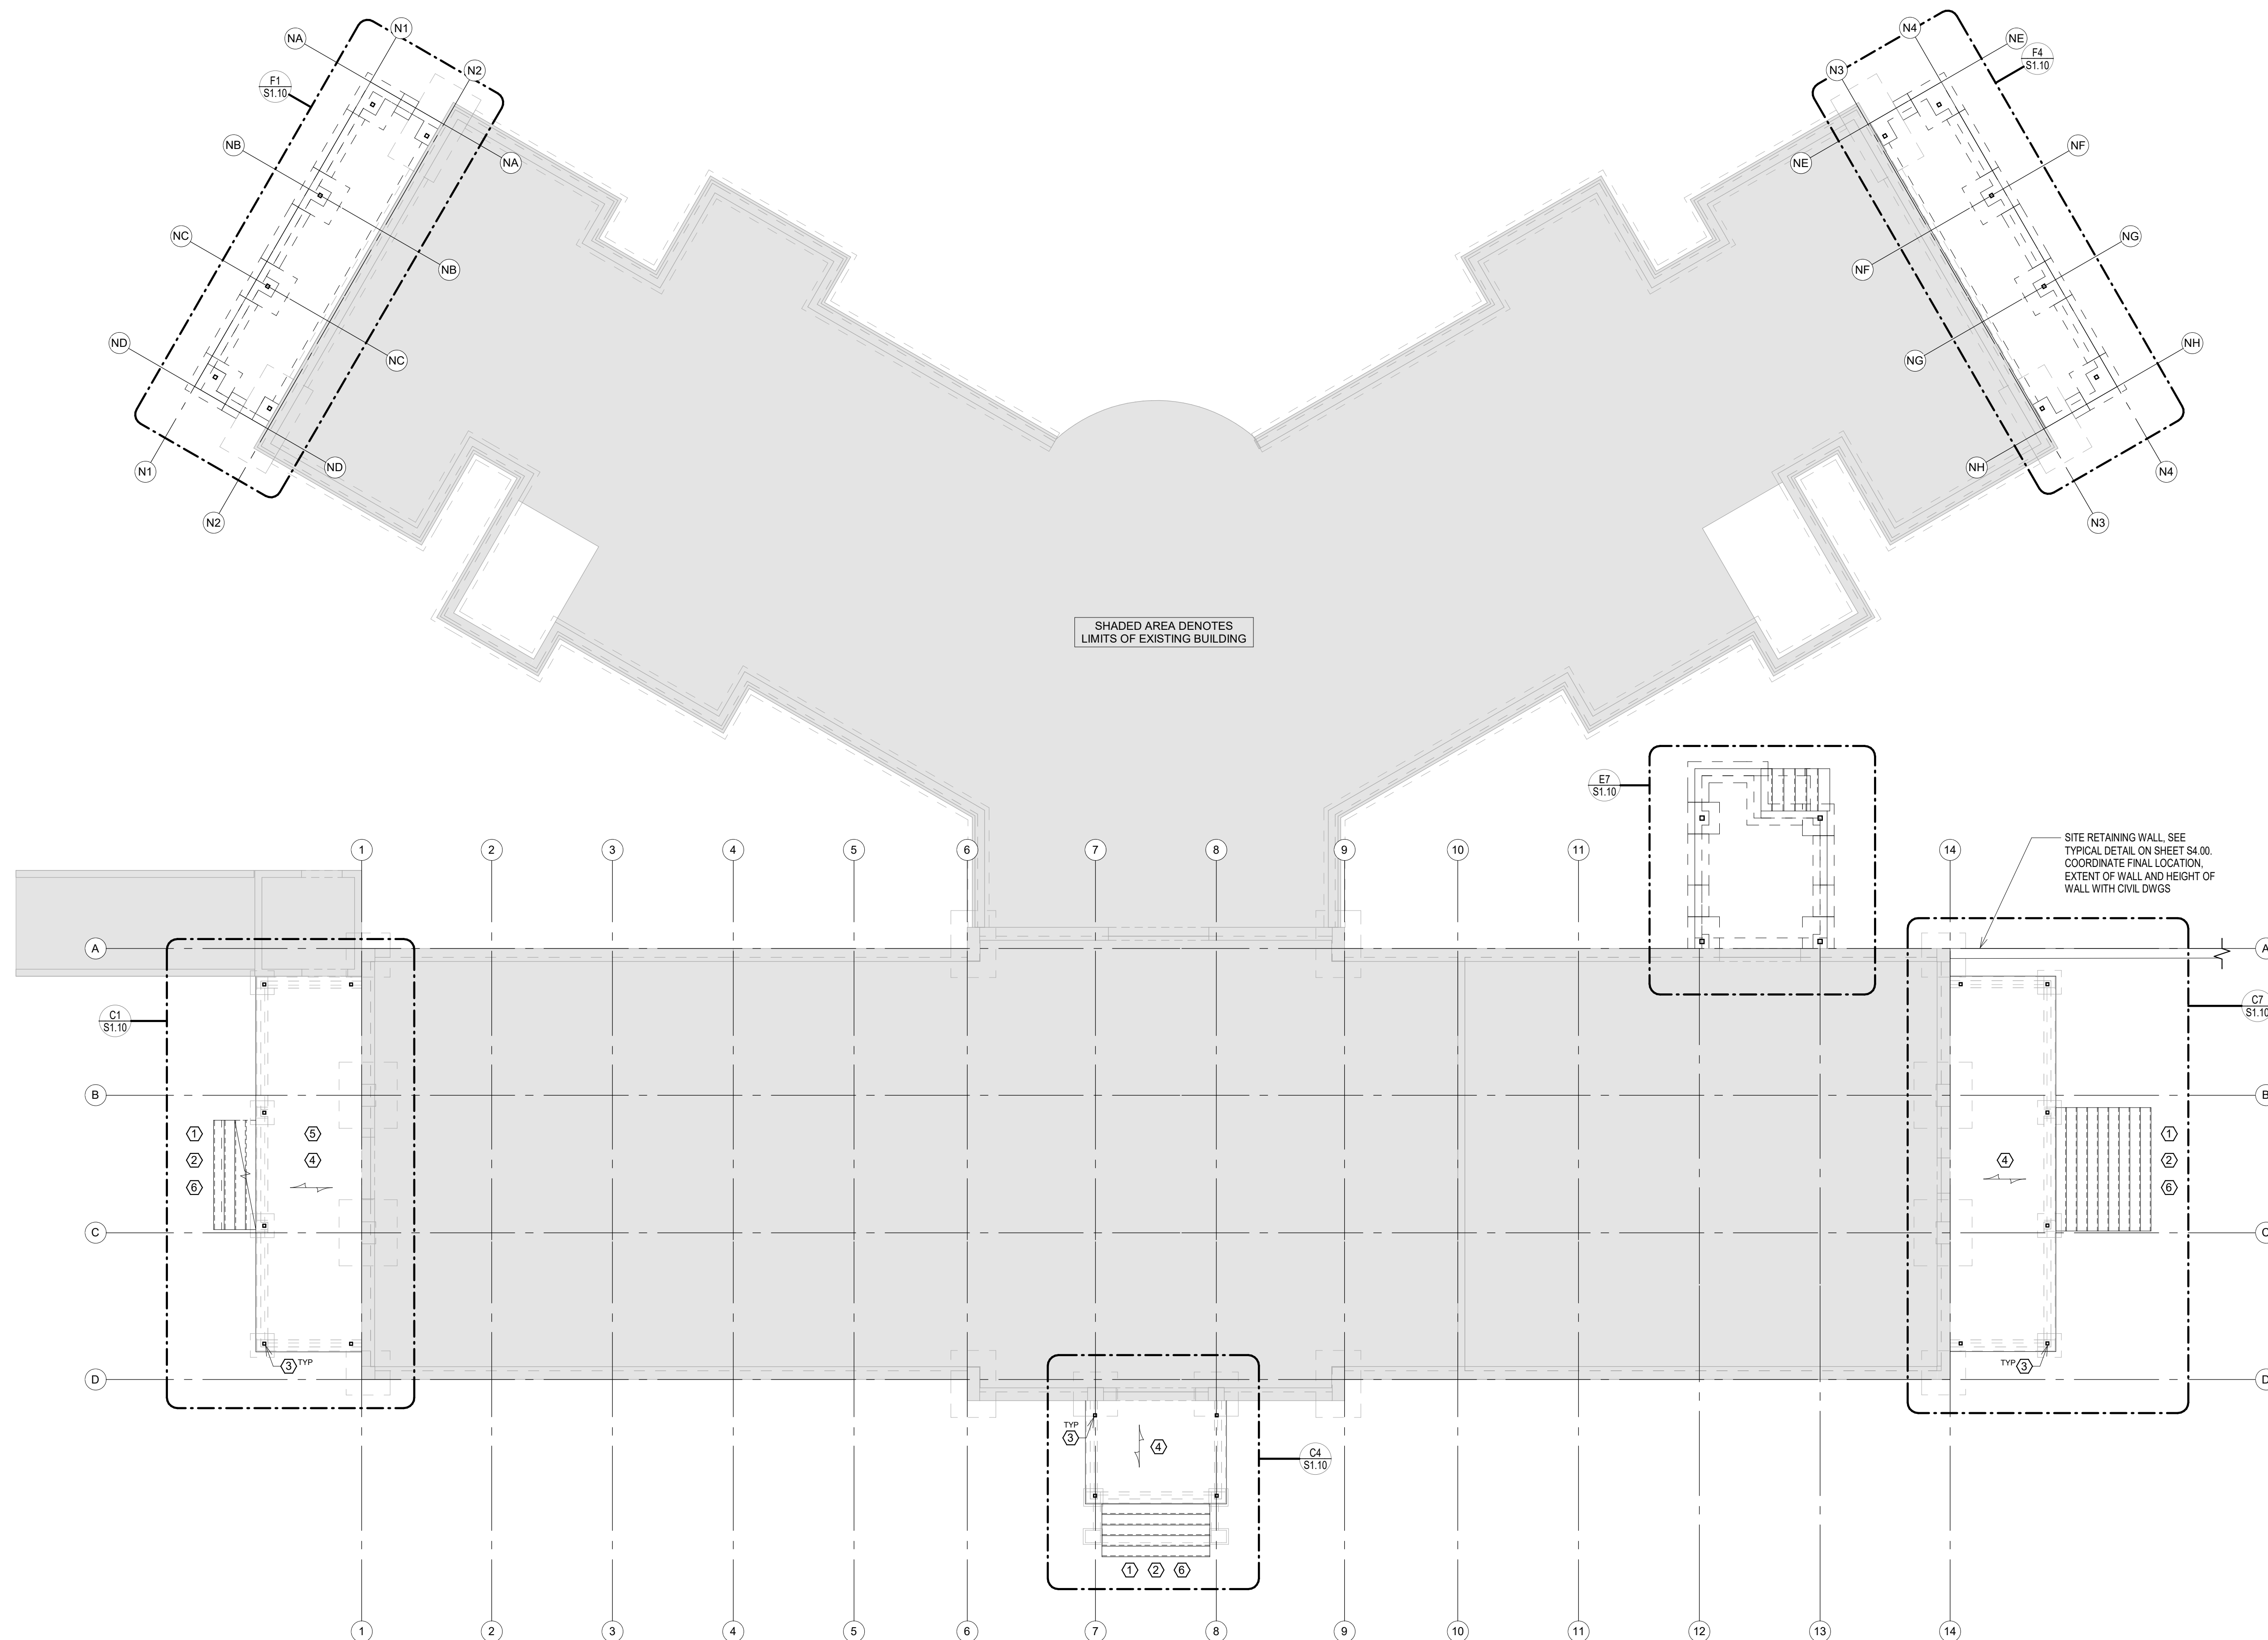



STRUCTURAL SHEET NOTES

GENERAL PLAN NOTES

- SEE SHEET S0.01 FOR GENERAL STRUCTURAL NOTES.
- SHEET SIZE FOR PROPER SCALE IS 30" x 42".
- VERIFY ALL DIMENSIONS AND ELEVATIONS WITH EXISTING CONDITIONS AND ARCHITECTURAL DRAWINGS BEFORE CONSTRUCTION COMMENCES.
- ELEVATIONS ON THE STRUCTURAL DRAWINGS REFER TO THE TOP OF CONCRETE REFERENCE ELEVATION SET AT 100'-0" (EXISTING FIRST FLOOR ELEVATION) = CIVIL ELEVATION 3881.5'.
- FIELD VERIFY ALL ELEVATIONS FOR FRAMING, MATCH EXISTING.


SHEET SPECIFIC NOTES

- THE (3) PORCHES LOCATED SOUTH OF GRIDLINE 'A' (C1, C4, & C7) ARE EXISTING PORCHES TO BE RENOVATED WITH ELEVATED STRUCTURAL SLABS AND CONCRETE DEGREE BEAMS.
- THE (2) PORCHES AND LOADING DOCK LOCATED NORTH OF GRIDLINE 'A' (F1, F4, & E7) ARE NEW PORCHES AND LOADING DOCK WITH CONCRETE FOUNDATION WALLS AND SLAB ON GRADE.
- SLAB ON GRADE CONCRETE JOINTS SHALL BE TOOLED OR SAWCUT. THE JOINT PATTERN SHALL BE APPROXIMATELY SQUARE AND LIMITED TO AN AREA NOT TO EXCEED 225 SF. JOINTS SHALL BE CUT WITHIN 8 HOURS OF POURING THE SLAB.
- ELEVATED STRUCTURAL SLAB CONCRETE JOINTS SHALL BE TOOLED OR SAWCUT. THE JOINT PATTERN SHALL BE AS INDICATED ON PLAN. DO NOT PROVIDE CONCRETE JOINTS PERPENDICULAR TO SLAB SPAN.
- CENTERLINE OF FOOTING SHALL COINCIDE WITH THE FOUNDATION AND COLUMN CENTERLINE, UNLESS SHOWN OTHERWISE.
- BACKFILL AND COMPACT BOTH SIDES OF FOUNDATION WALLS SIMULTANEOUSLY.
- SEE CIVIL DRAWINGS FOR EXTERIOR GRADES AND SITE RETAINING WALL.
- SEE THIS SHEET FOR CONCRETE FOOTING SCHEDULE.
- WALL REINFORCING SHALL BE CONTINUOUS AROUND CORNERS, PROVIDE 30"x30" CORNER BARS.
- CONTRACTOR SHALL TAKE PRECAUTION TO NOT DISTURB EXISTING FOUNDATIONS. ANY VOIDS CREATED UNDER EXISTING (E) STRUCTURAL FOUNDATION DURING CONSTRUCTION OF THE NEW FOOTINGS SHALL BE FILLED WITH CONCRETE.
- CONTRACTOR SHALL COORDINATE LOCATION OF ANY POTENTIAL EXISTING UTILITIES WITH CIVIL, STRUCTURAL AND MECHANICAL DRAWINGS BEFORE CONSTRUCTION COMMENCES.
-  INDICATES SPAN DIRECTION OF STRUCTURAL SLAB.
-  DENOTES STEP IN FOOT OF FOOTING. SEE TYPICAL FOOTING STEP DETAIL ON SHEET S4.00.
- SEE TYPICAL FINISHING WALL DETAIL ON SHEET S4.00. COORDINATE WITH CIVIL DRAWINGS FOR FINAL LOCATION, EXTENTS OF WALL, AND TOP OF WALL ELEVATIONS.

KEY PLAN NOTES

- 1 REMOVE AND REPLACE CRACKED MASONRY VENEER AROUND PERIMETER OF EXISTING PORCHES AND TUCKPOINT AS REQUIRED
- 2 REMOVE AND REPLACE EXISTING CONCRETE STAIRS AT EXISTING PORCHES. SEE ARCHITECTURAL DRAWINGS.
- 3 REMOVE AND REPLACE ALL COLUMNS AT EXISTING PORCHES. SEE DETAILS A2 & A4 ON SHEET S3.00.
- 4 REMOVE AND REPLACE EXISTING ELEVATED CONCRETE CONCRETE SLABS AT EXISTING PORCHES. SEE DETAILS A1, A2, A4, A5, A6, A7, & A7B ON SHEET S3.00. TO EXISTING CONCRETE EDGES BEAMS TO REMAIN. CONTRACTOR SHALL TAKE PRECAUTIONS WHEN REMOVING SLAB TO NOT DAMAGE EXISTING BEAMS.
- 5 REMOVE AND REPLACE VESTIBULE. SEE ARCHITECTURAL DRAWINGS FOR ADDITIONAL INFORMATION.
- 6 REMOVE, REPAIR AND RE-INSTALL EXISTING WROUGHT IRON RAILING AROUND PERIMETER OF EXISTING PORCHES. SEE ARCHITECTURAL DRAWINGS FOR ADDITIONAL INFORMATION.

FOOTING SCHEDULE			
MARK	FOOTING SIZE	REINFORCING	REMARKS
A	2' - 0" x 4' - 0" x CONT	(3) #5 CONT	BOTTOM
B	4' - 0" x 4' - 0" x 1' - 0"	(7) #5 EA WAY	BOTTOM
C	3' - 0" x 3' - 0" x 1' - 0"	(4) #5 EA WAY	BOTTOM

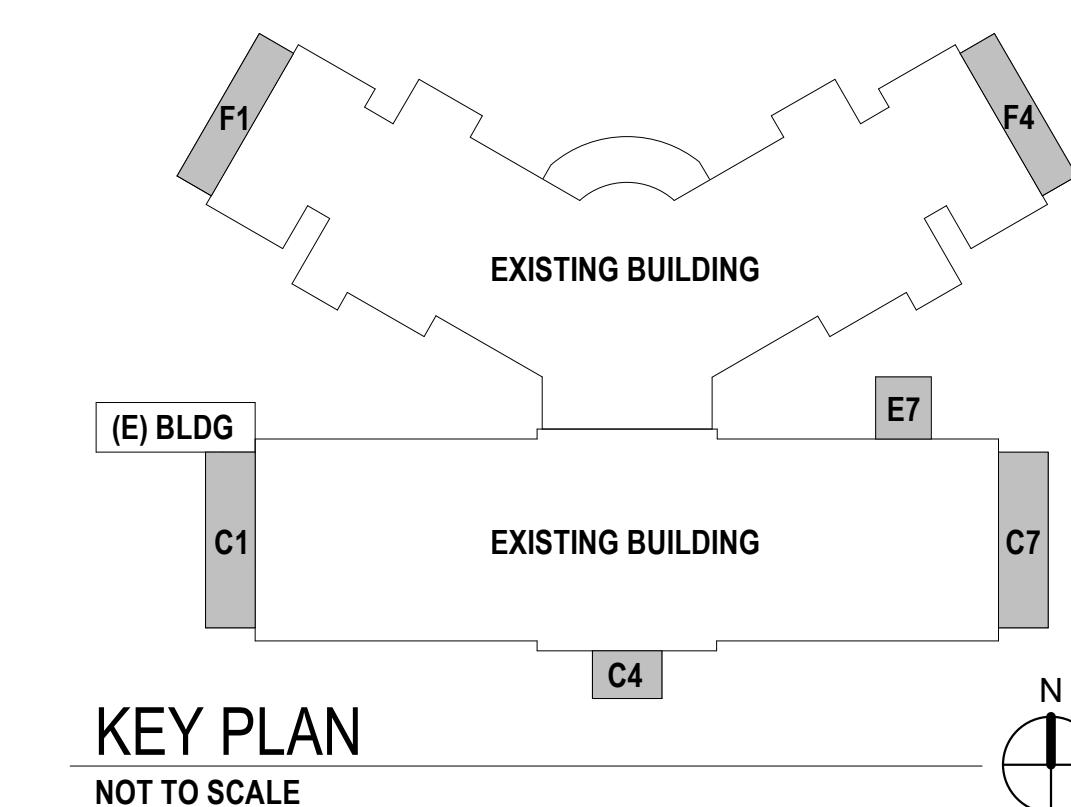

CONSTRUCTION DOCUMENTS

OVERALL PORCH & LOADING DOCK FLOOR FRAMING PLAN

SCALE: 1/8" = 1'-0"

[illegible]

CONSULTANTS:



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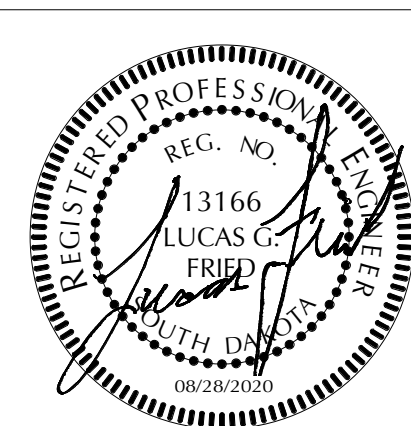


Albertson Engineering Inc.


Dawes
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19.2482

	Drawing Title
--	---------------

OVERALL PORCH & LOADING DOCK FLOOR FRAMING PLANS

Approved: Project Director

OWNER

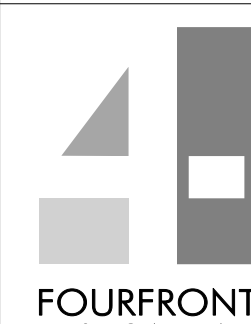	Project Title
--	---------------

**BUILDING 64 FOLLOW-ON
RENOVATION - SHERIDAN VA
MEDICAL CENTER**

	Location

SHERIDAN, WY
Date
AUGUST 28, 2020

Checked	LGE
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Drawn	KNB
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Project Number

666-18-103


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Drawing Number


S1.00

Office of
Construction
and Facilities
Management




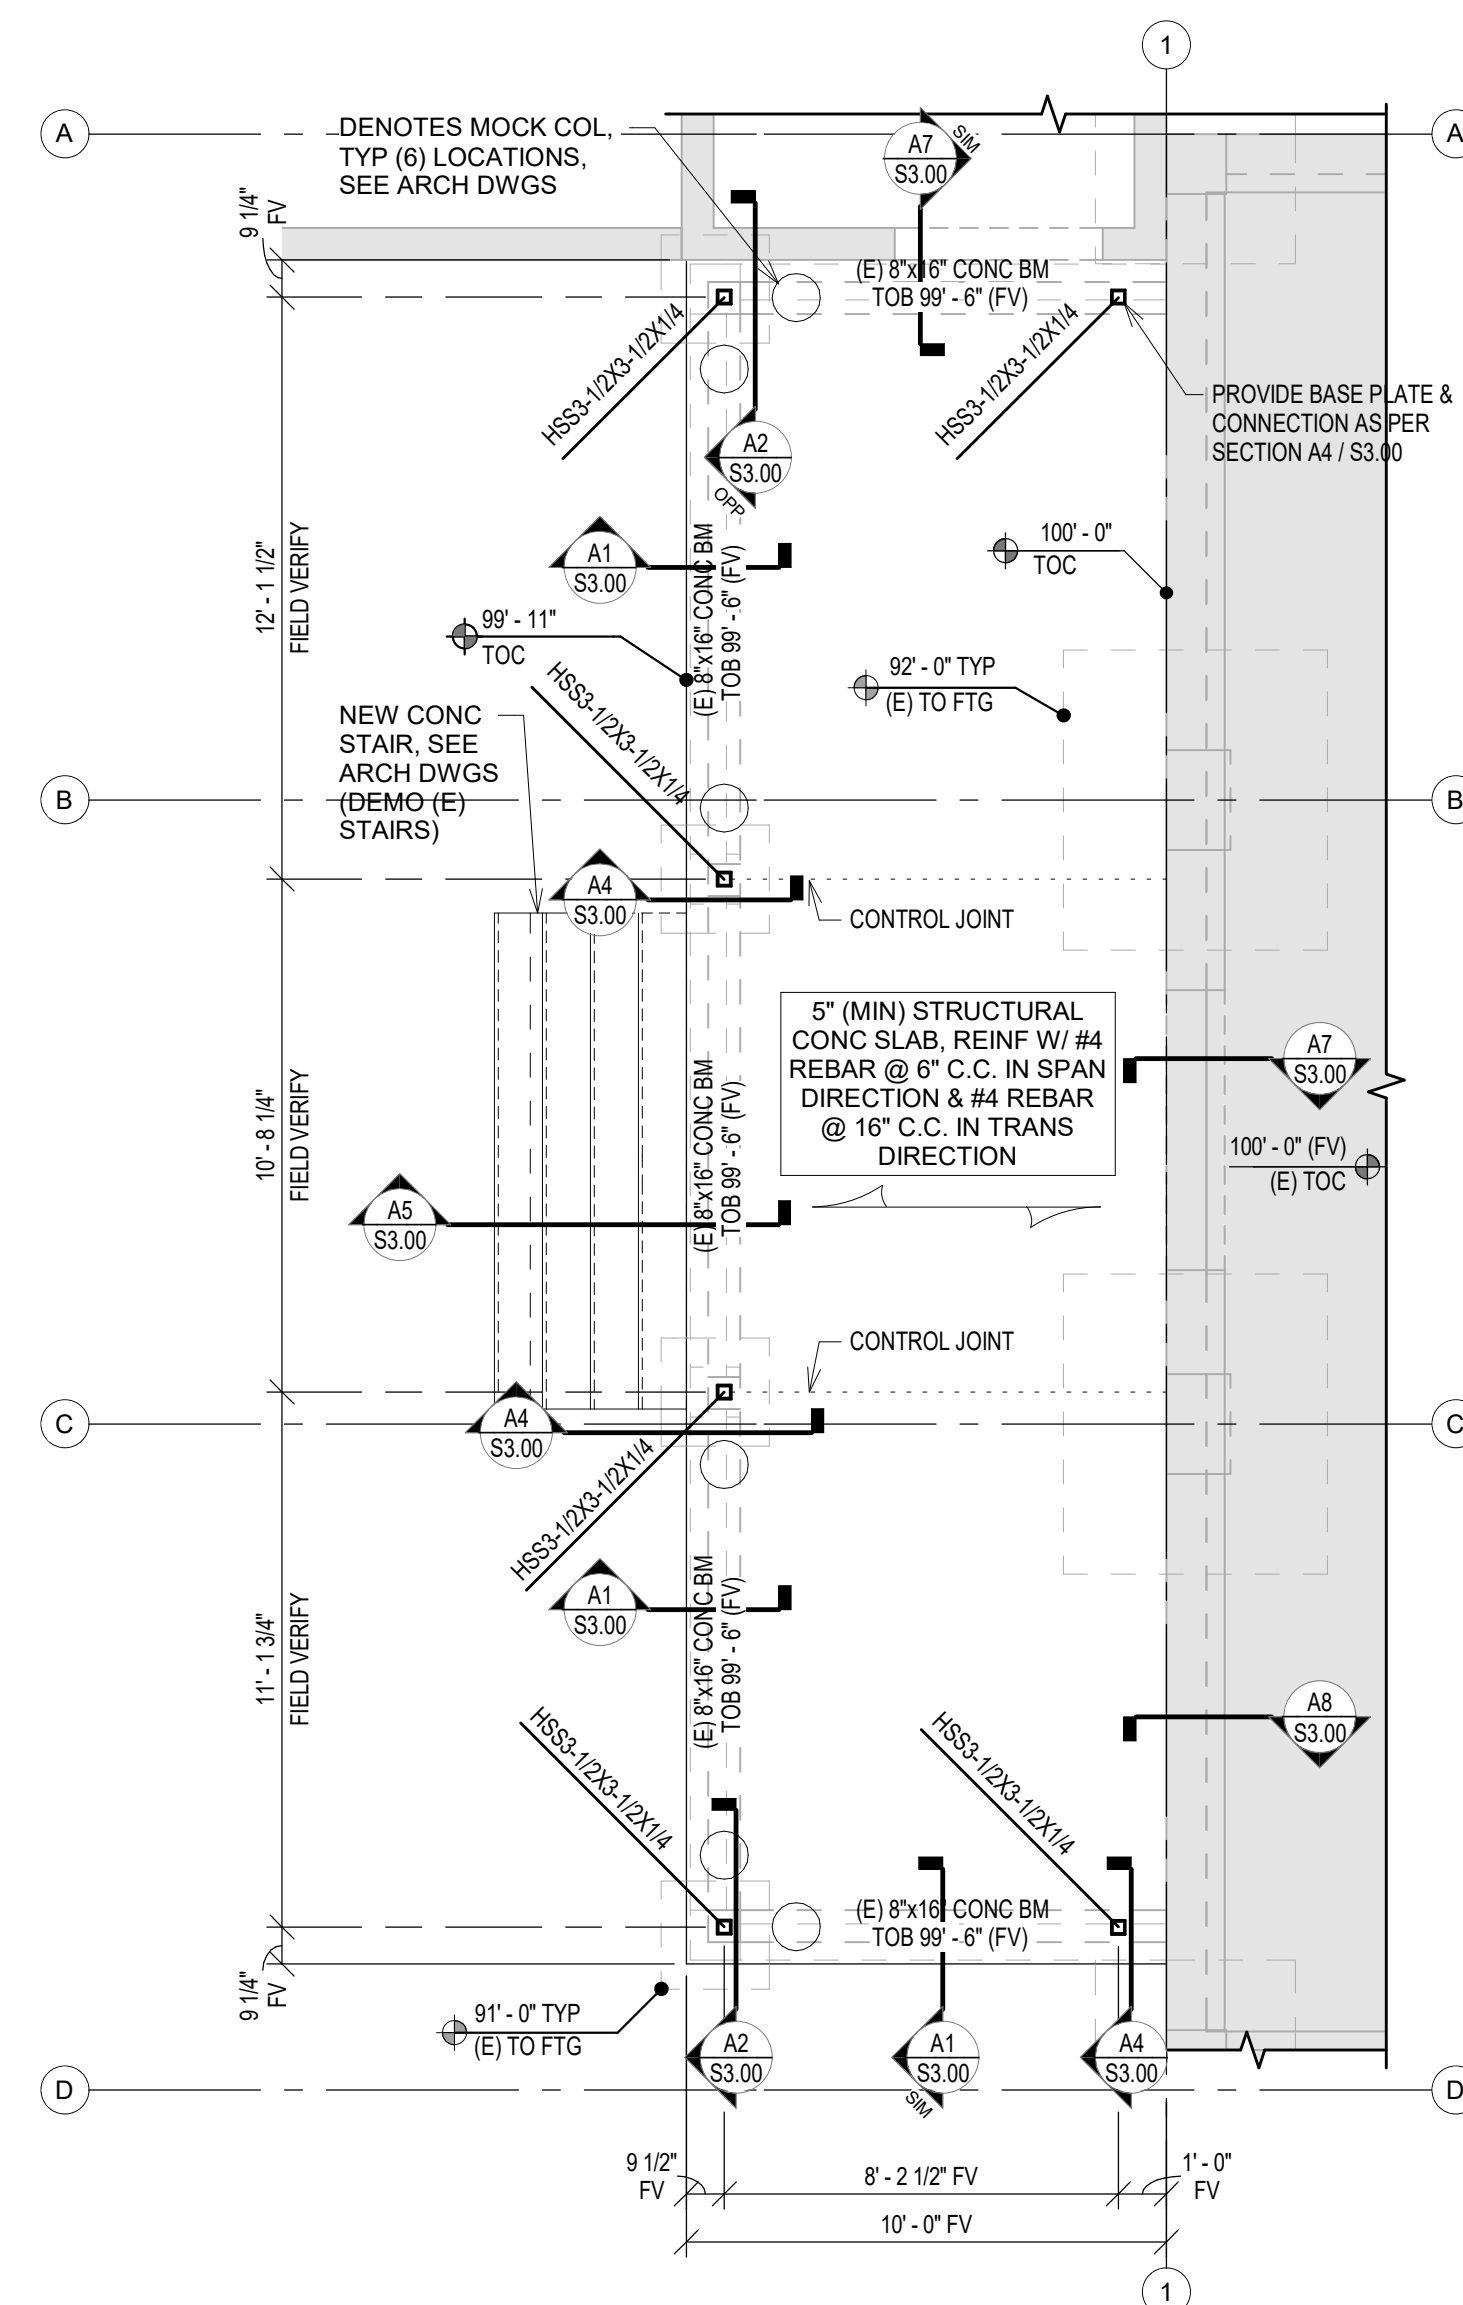


FOUNDATION PLAN - EXISTING PORCH WEST

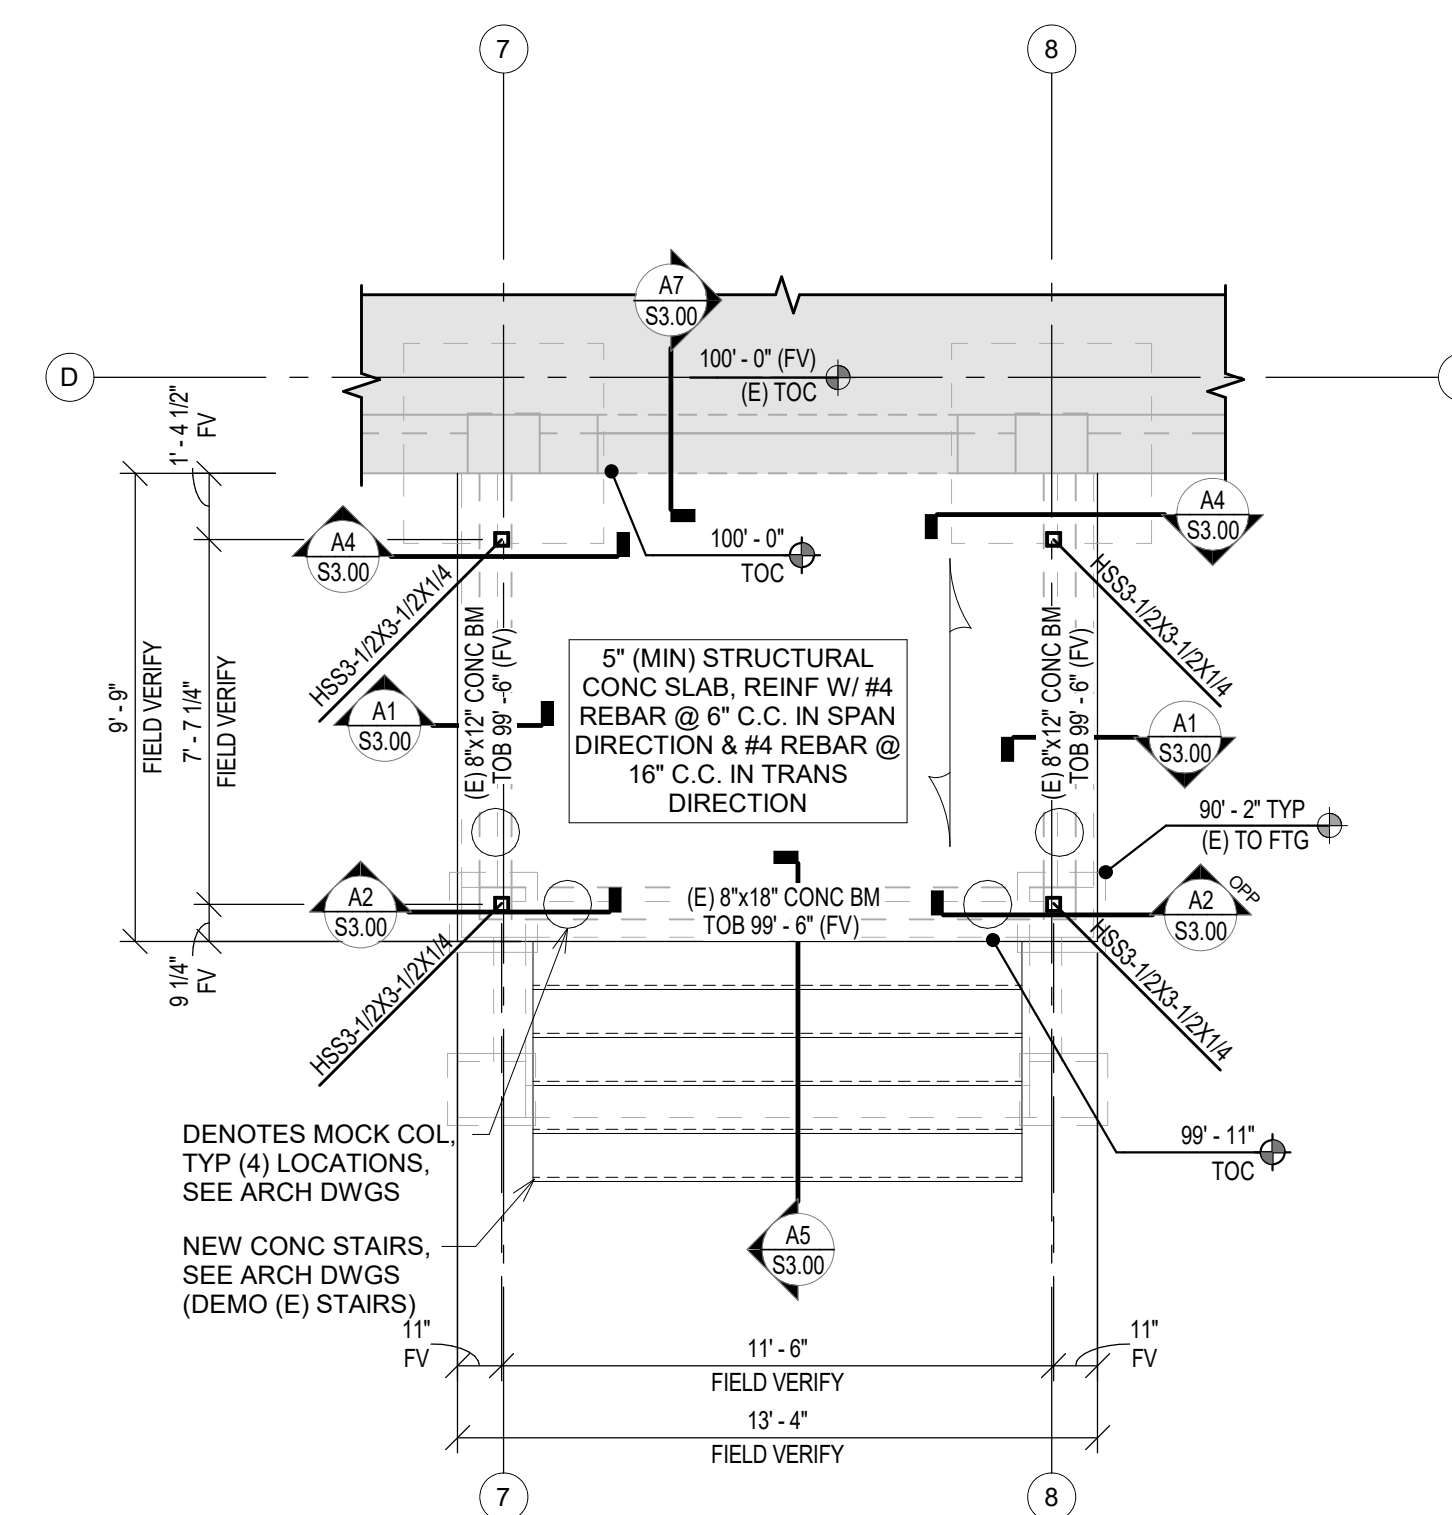


FOUNDATION PLAN - EXISTING PORCH SOUTH

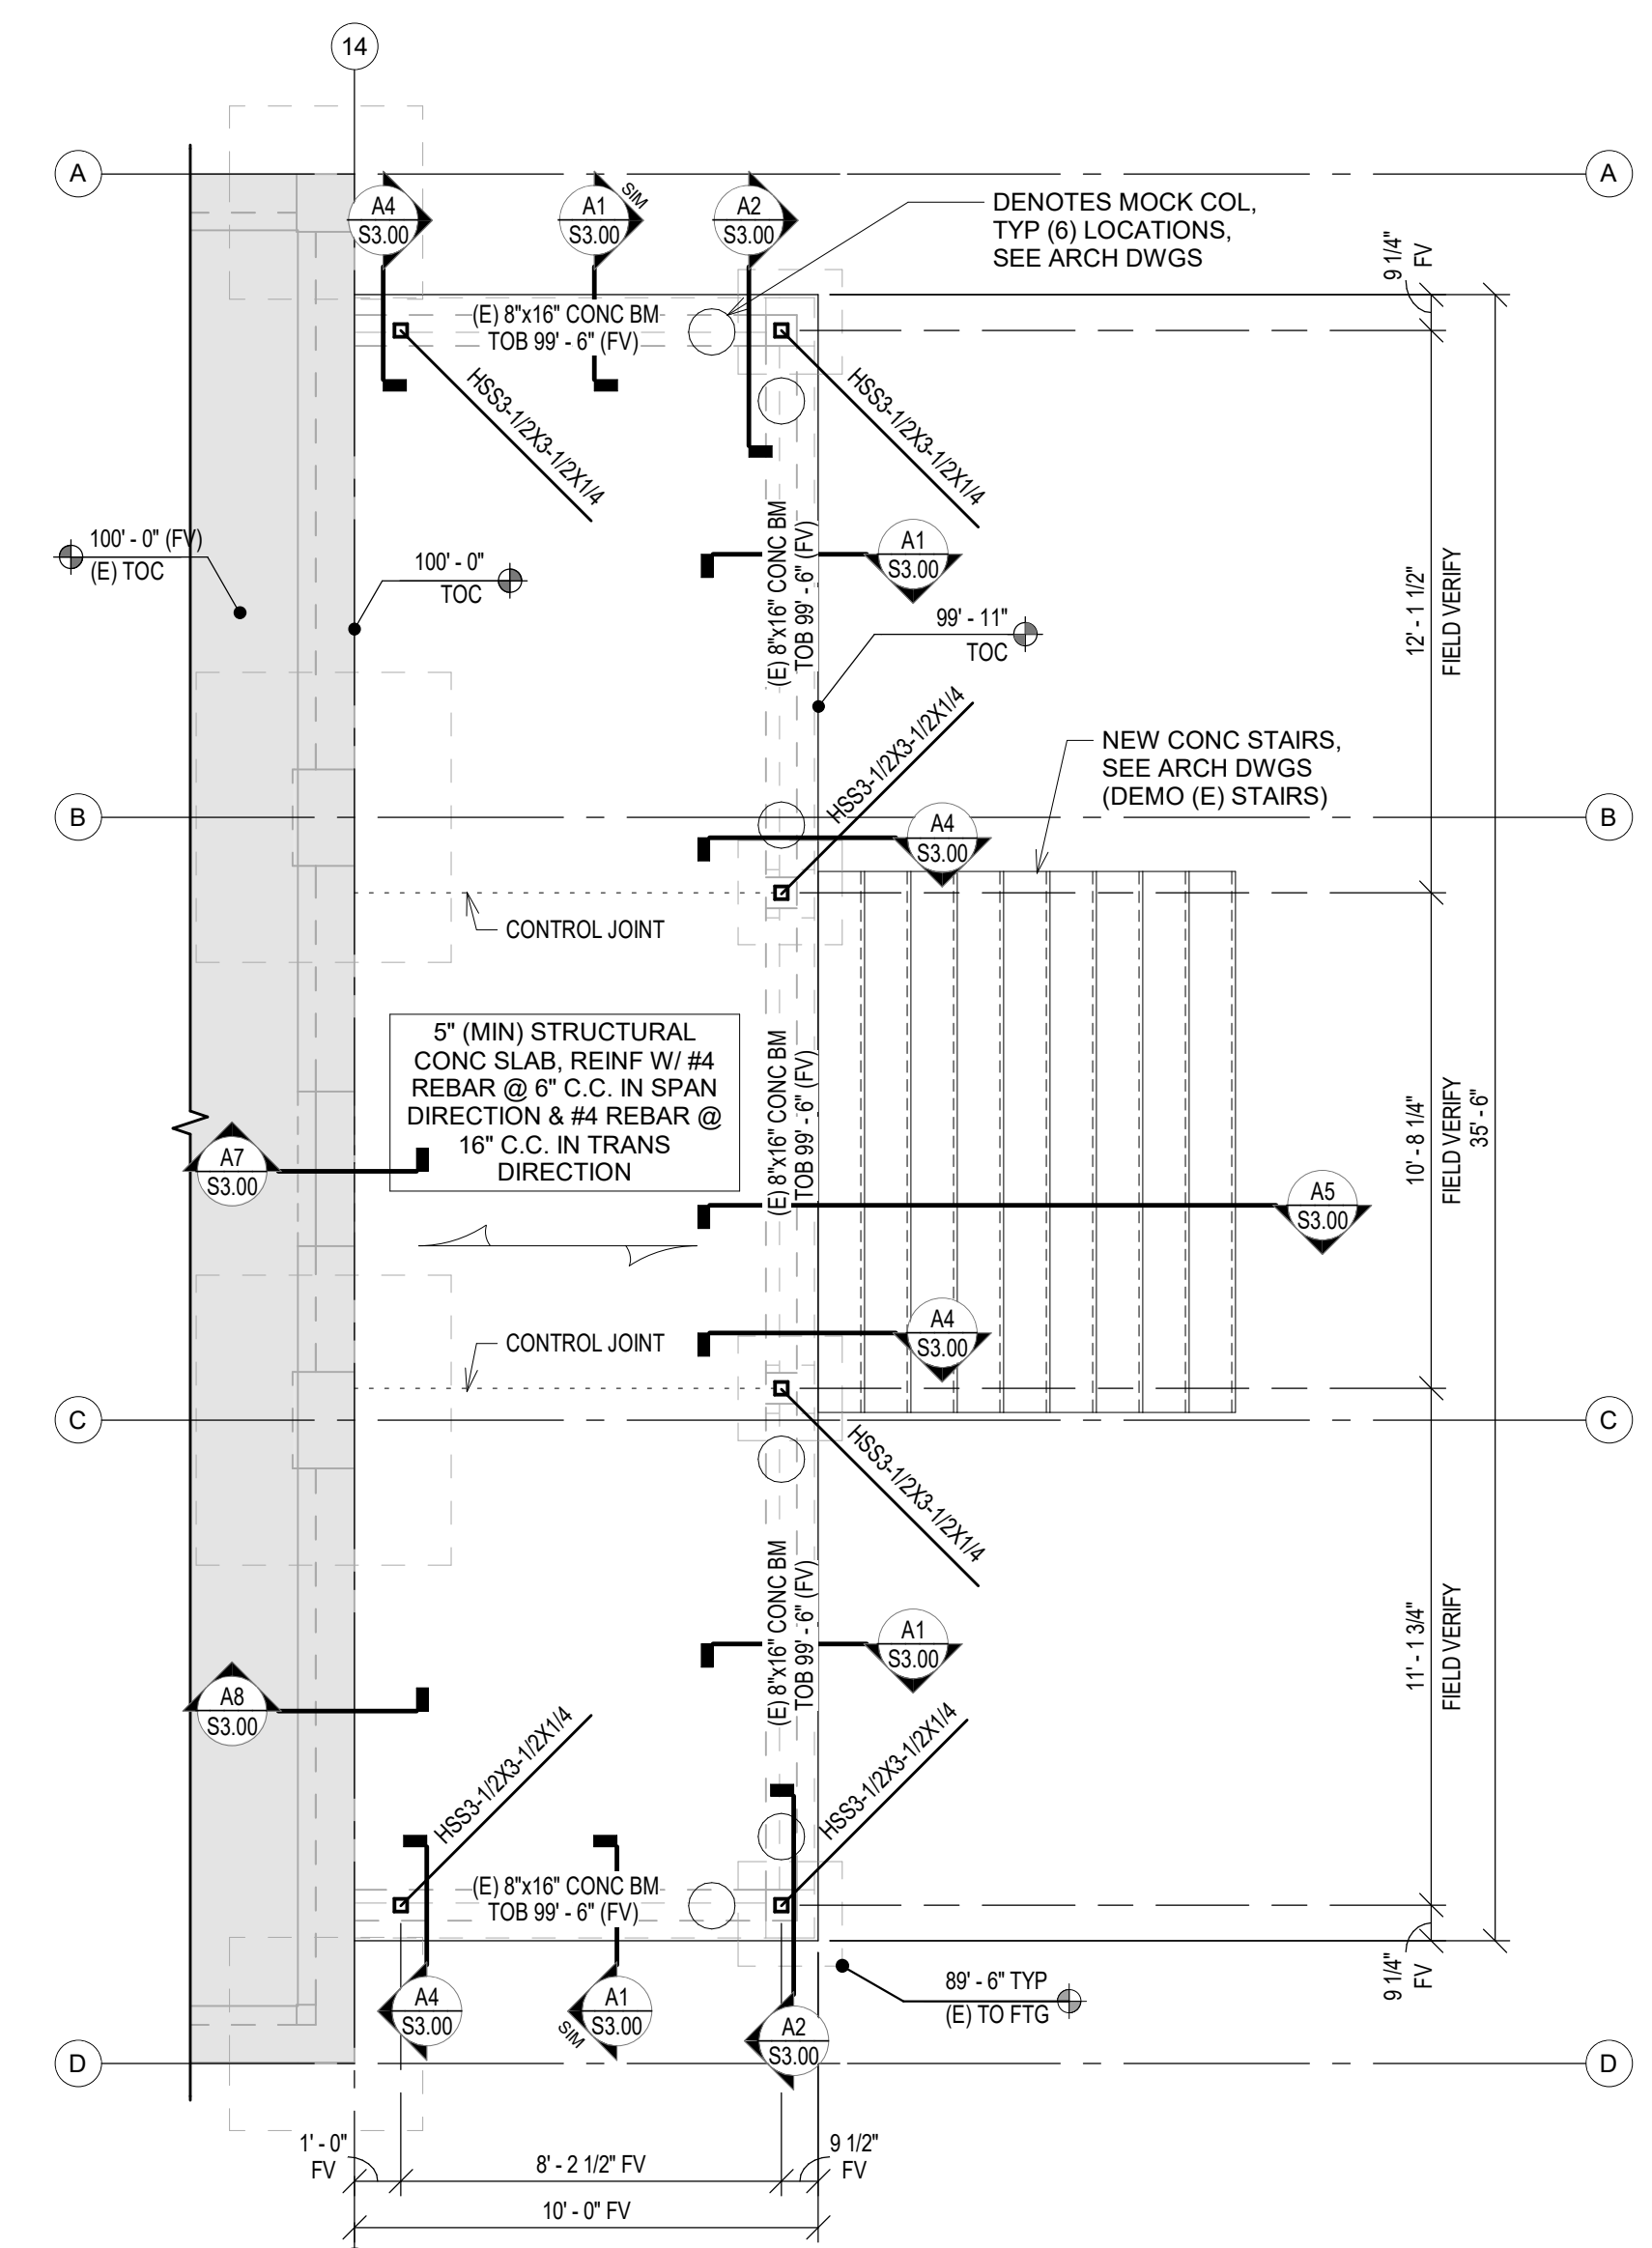


FOUNDATION PLAN - EXISTING PORCH EAST

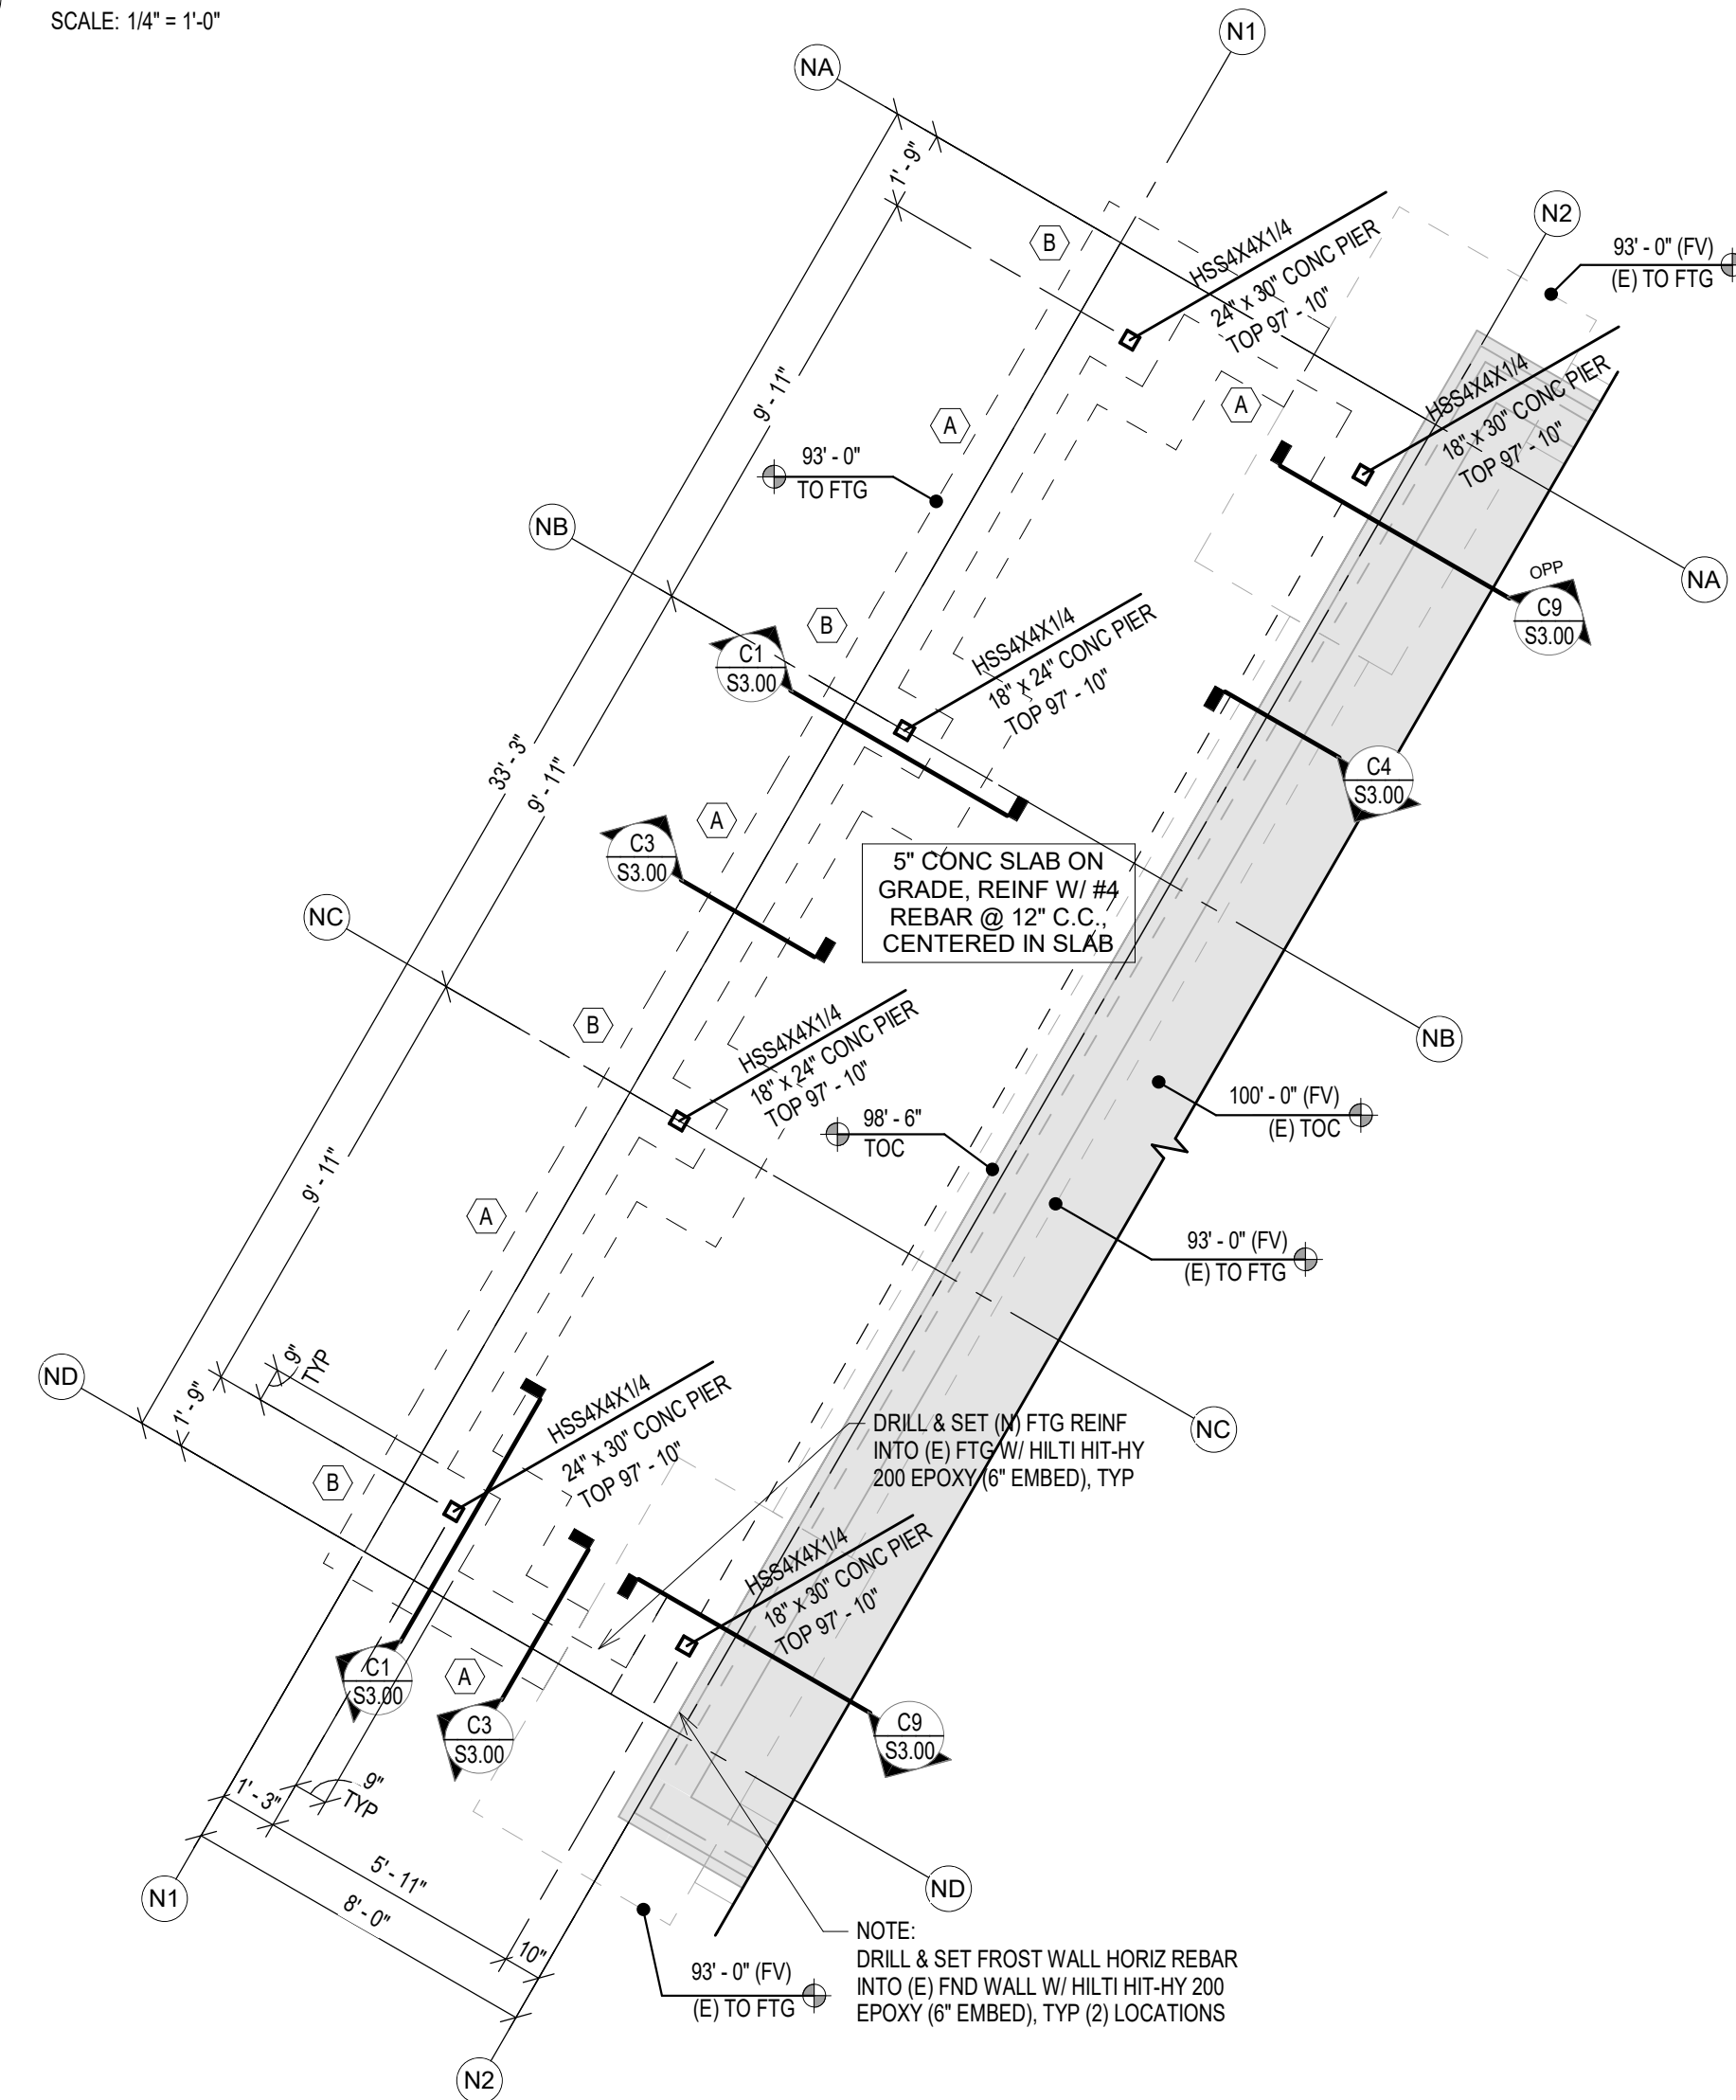


FOUNDATION PLAN - NEW PORCH WEST

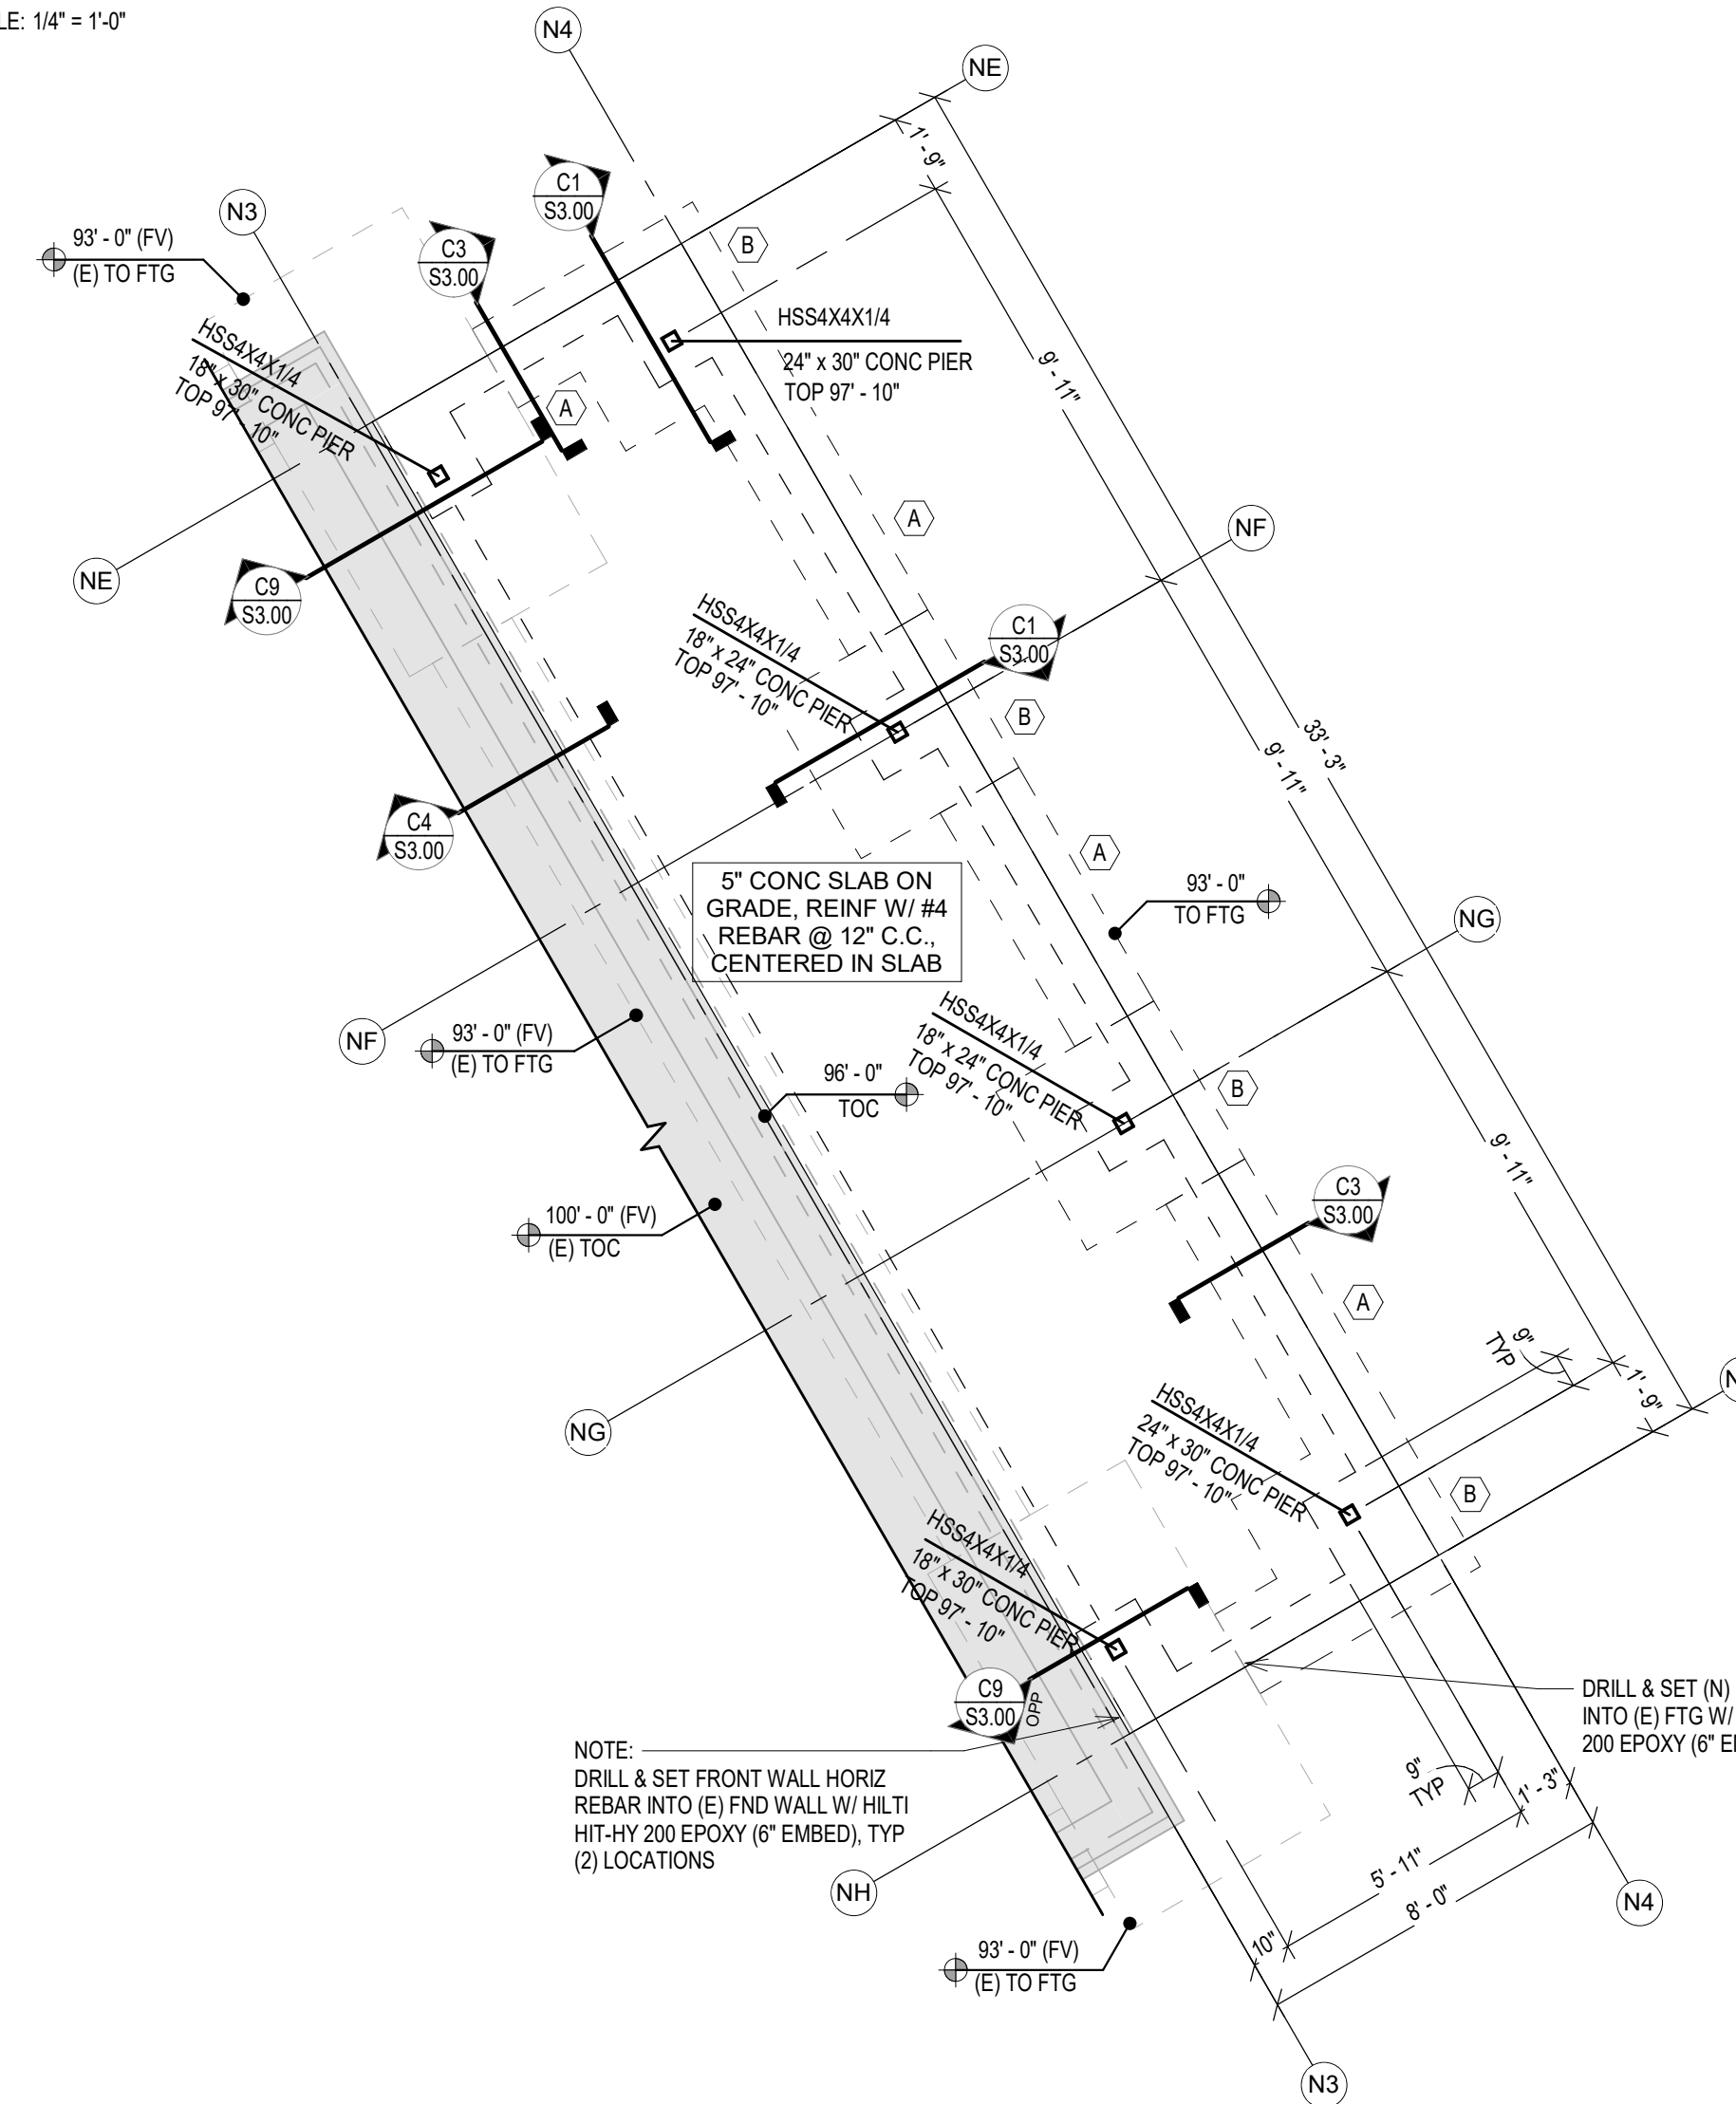

FOUNDATION PLAN - NEW PORCH EAST

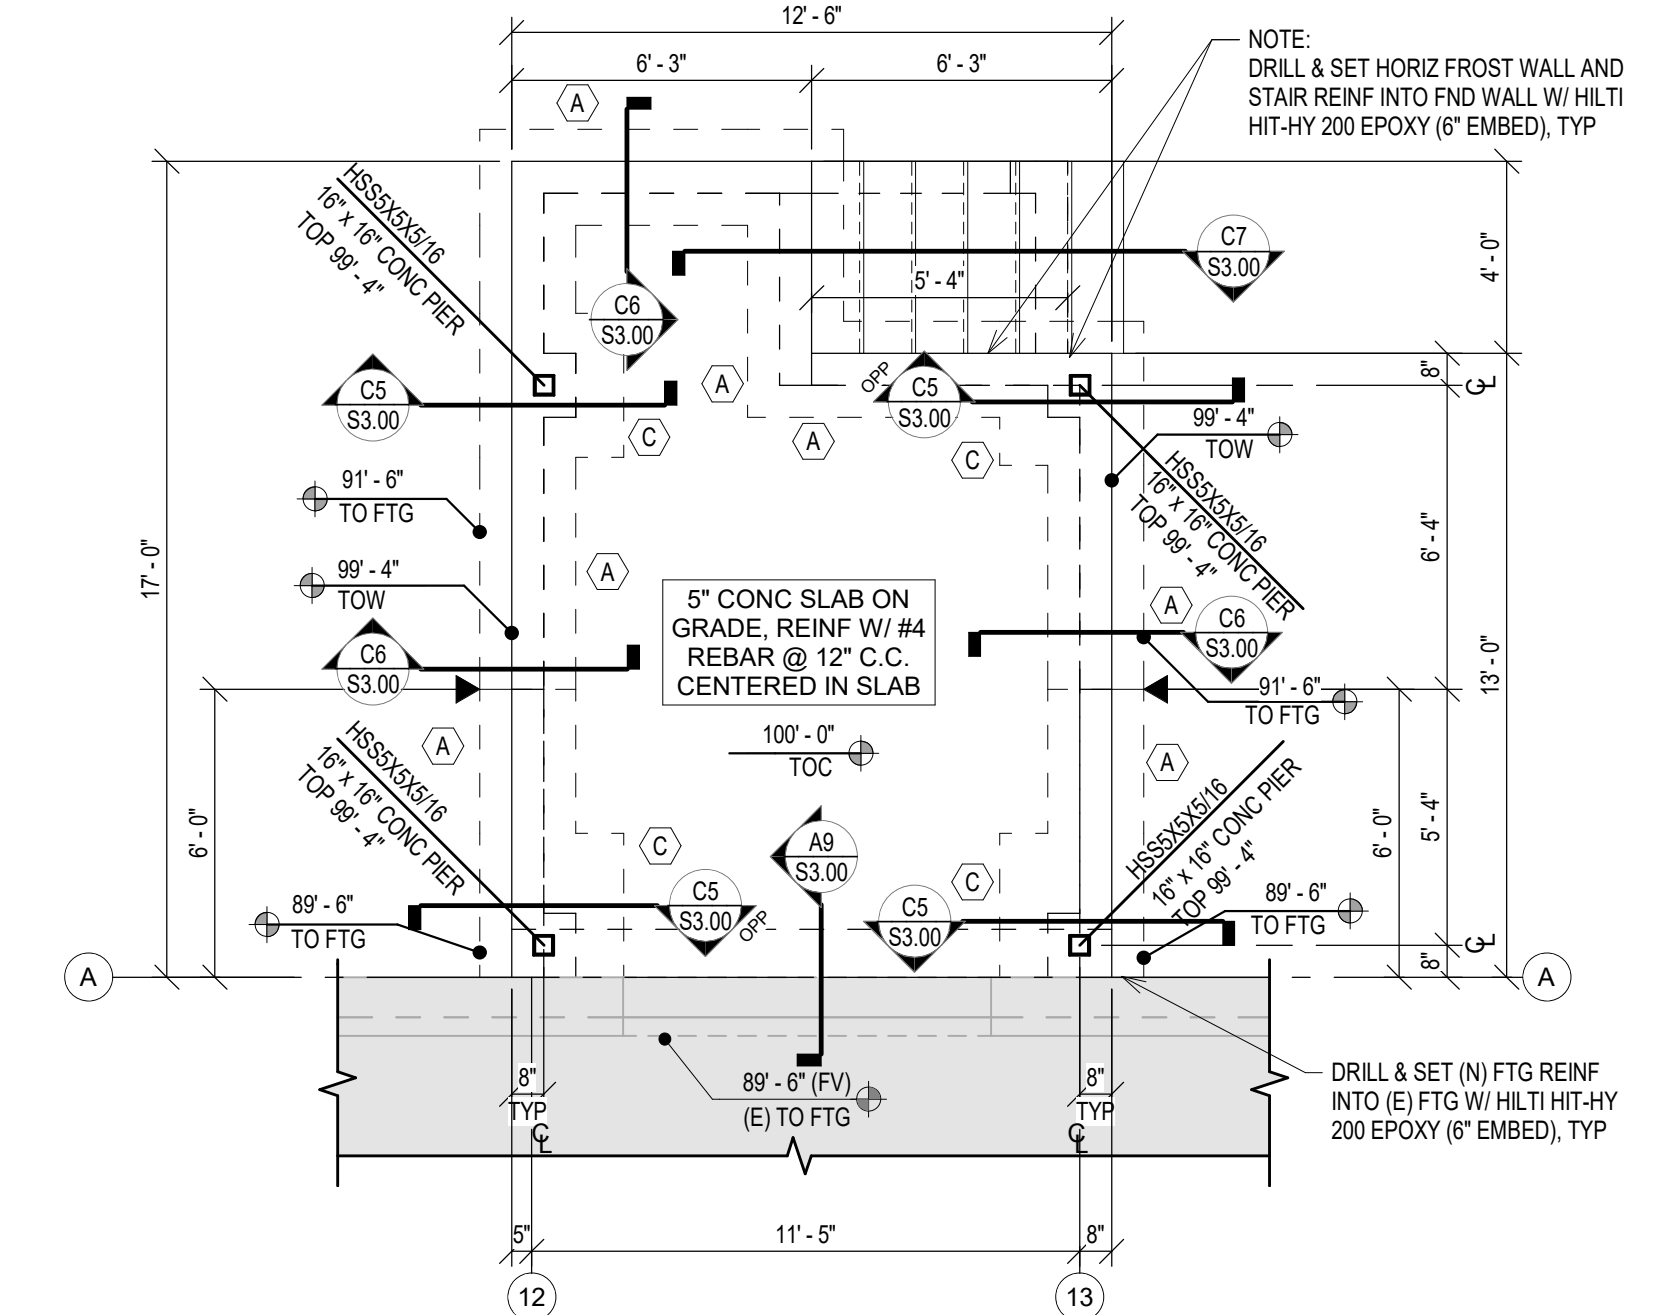

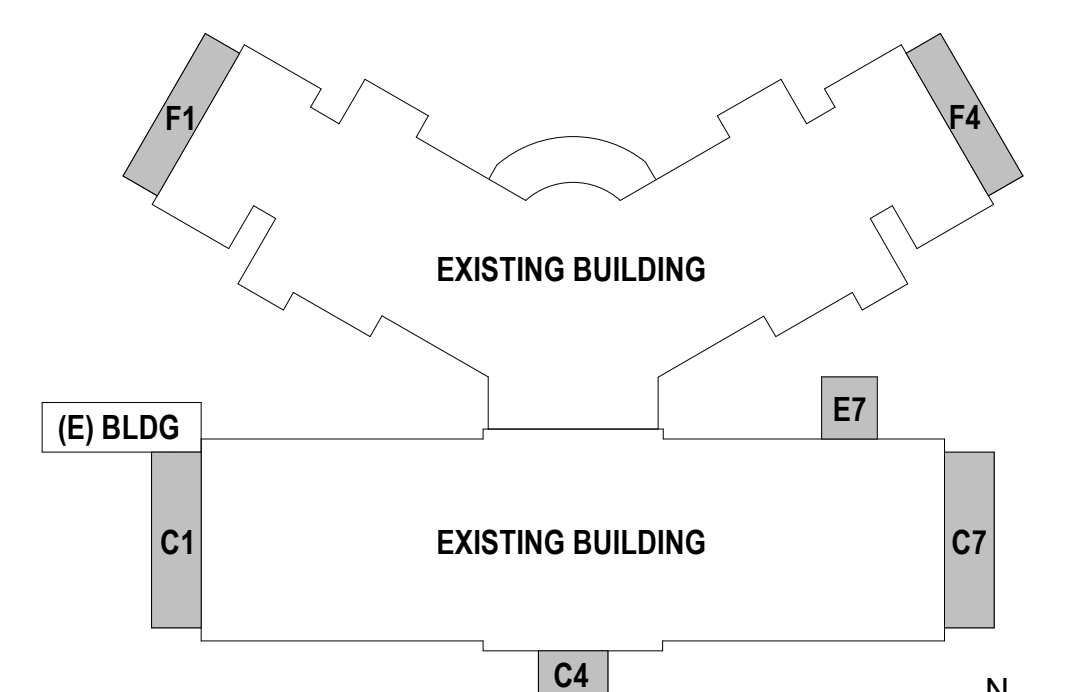

FOUNDATION PLAN - LOADING DOCK




KEY PLAN
NOT TO SCALE

CONSTRUCTION DOCUMENTS

[illegible]

CONSULTANTS:		
 <p>TERRASITE DESIGN 1635 DEADWOOD AVENUE RAPID CITY, SOUTH DAKOTA 57702 PH: (605) 791-1736</p>	 <p>Albertson Engineering Inc.</p>	<p>ALBERTSON ENGINEERING, INC. 3202 WEST MAIN STREET, SUITE C RAPID CITY, SOUTH DAKOTA 57702 PH: (605) 343-9606</p>
	<p>Dawes Engineering & Design</p>	<p>DAVES ENGINEERING & DESIGN CO. 46 HIBBARD WAY HELENA, MONTANA 59601 PH: (406) 441-4000</p>

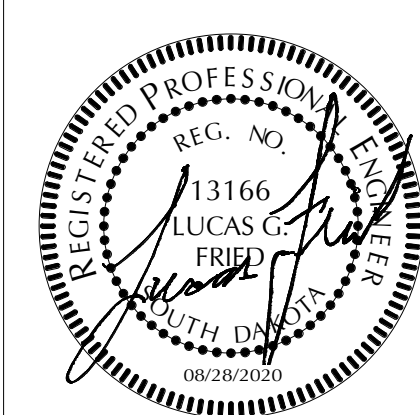

ARCHITECT


 FOURFRONT DESIGN, INC.
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WWW.FOURFRONTDESIGN.COM

Drawing Title	
PORCH & LOADING DOCK ENLARGED FOUNDATION PLANS	
Approved: Project Director	
OWNER	

Project Title			Project Number		
BUILDING 64 FOLLOW-ON RENOVATION - SHERIDAN VA MEDICAL CENTER			666-108-103		
Location			Billing Number		
SHERIDAN, WYOMING			64		
Drawing Number			S1.10		
Date	Checked	Drawn	Dwg. 60 of 115		
AUGUST 28, 2020	LGF	KNR			

Office of
Construction
and Facilities
Management

 Department of
Veterans Affairs

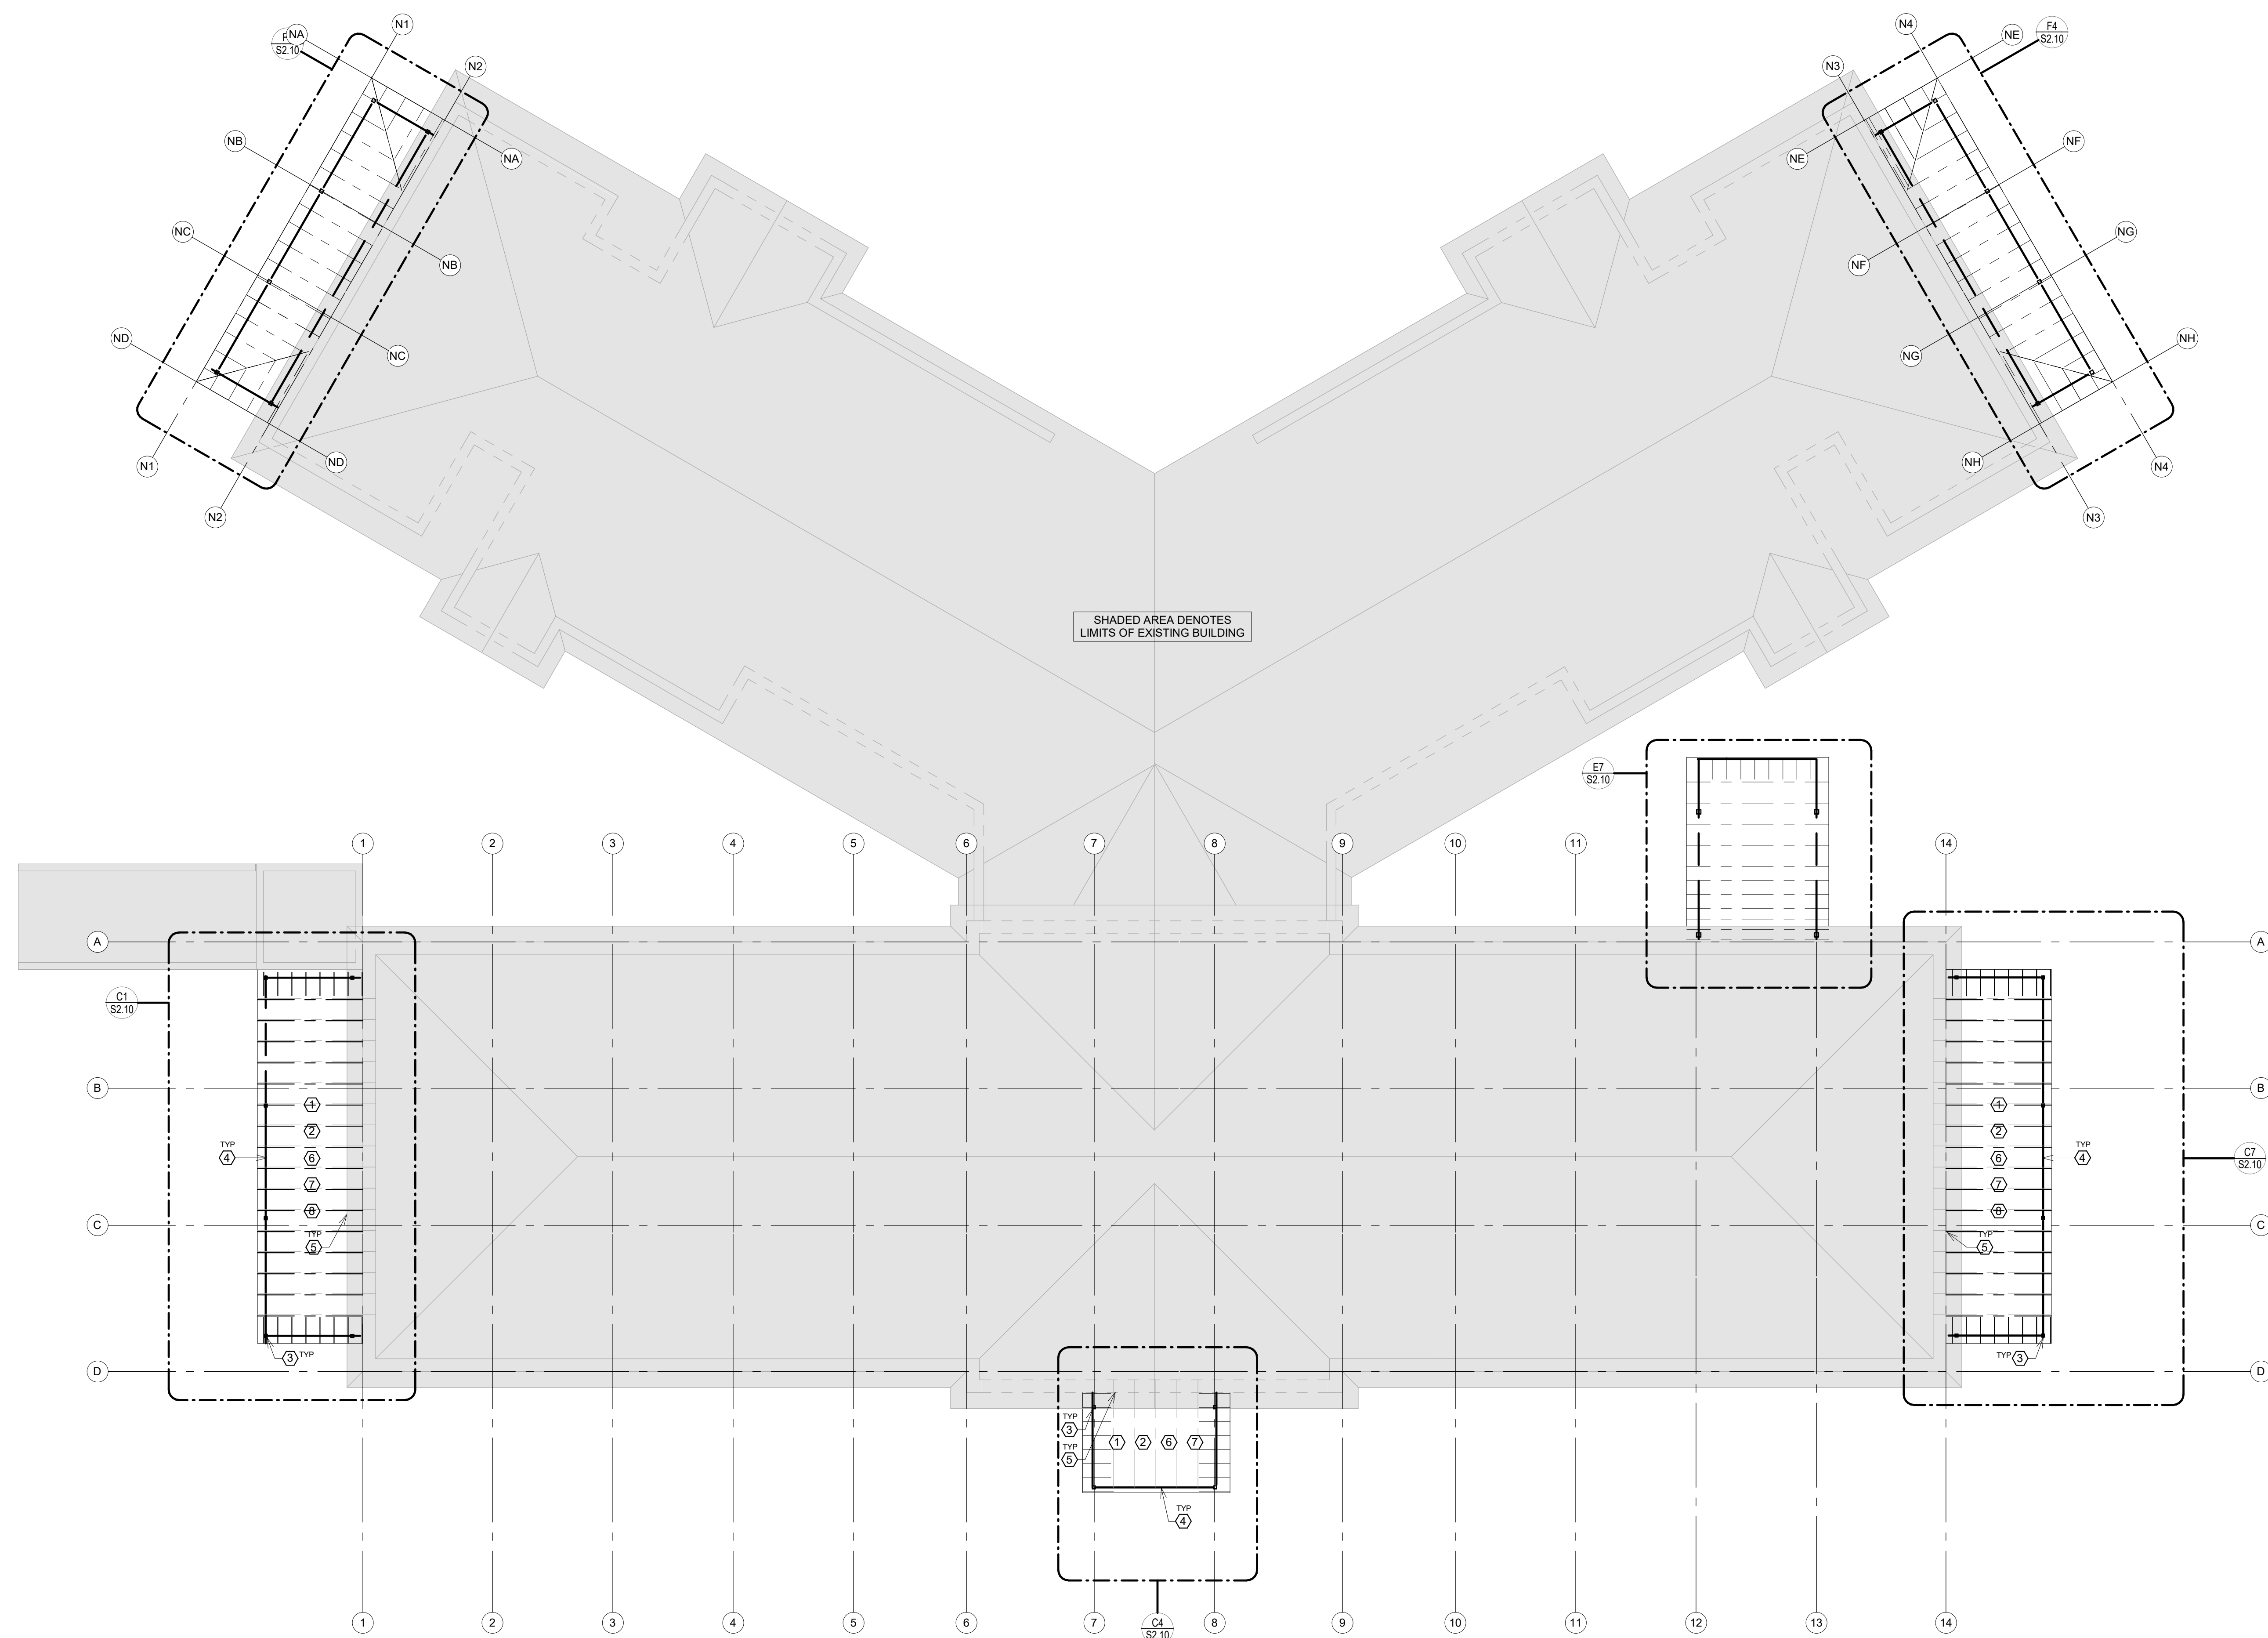

STRUCTURAL SHEET NOTES

GENERAL PLAN NOTES


- SEE SHEET 30.01 FOR GENERAL STRUCTURAL NOTES.
- SHEET SIZE FOR PROPER SCALE IS 30" x 42".
- VERIFY ALL DIMENSIONS AND ELEVATIONS WITH EXISTING CONDITIONS AND ARCHITECTURAL DRAWINGS BEFORE CONSTRUCTION COMMENCES.
- ELEVATIONS ON THE STRUCTURAL DRAWINGS REFER TO THE TOP OF CONCRETE REFERENCE ELEVATION SET AT 100'-0" (EXISTING FIRST FLOOR ELEVATION) = CIVIL ELEVATION 3881.5'.
- FIELD VERIFY ALL ELEVATIONS FOR FRAMING, MATCH EXISTING,

SHEET SPECIFIC NOTES

- * THE (3) PORCHES LOCATED SOUTH OF GRIDLINE 'A' (C1, C4 & C7) ARE EXISTING PORCH ROOFS TO BE RENOVATED WITH 2X WOOD ROOF JOISTS AND HEAVY TIMBER WOOD EDGE BEAMS (AS NEEDED).
 - * THE (2) PORCHES AND LOADING DOCK LOCATED NORTH OF GRIDLINE 'A' (F-F, F4, F7) ARE NEW PORCHES AND LOADING DOCK ROOFS WITH LIGHT GAGE METAL STUD JOISTS SUPPORTED BY STEEL BEAMS AND COLUMNS.
- UNLESS NOTED OR DETAILED OTHERWISE, ALL 2x MATERIAL SHALL BE TREATED SPRUCE PINE OR FIR (S-P-F) IN FIELD AT NO. 2 OR BETTER, SEE GENERAL STRUCTURAL NOTES ON SHEET S0.01.
- * ROOF SHEATHING SHALL BE APA 4020 SPAN RATED SHEATHING, 19/32" THICK (5/8" NOMINAL), EXPOSURE 1. AT EXISTING PORCHES (SOUTH OF GRIDLINE 'A') NAIL SHEATHING WITH 10d COMMON NAILS @ 6" C. TO ALL PANEL EDGES. AT NEW PORCHES AND LOADING DOCK (NORTH OF GRIDLINE 'A') SCREW SHEATHING WITH #10 (MIN) SELF-DRILLING ZINC-COATED WOOD-TO-STEEL SCREW @ 6" C. AT ALL PANEL PERIMETER EDGES AND @ 12" C. IN THE FIELD.
 - * CONTRACTOR SHALL PROVIDE SHORING FOR EXISTING STRUCTURE AS REQUIRED.

KEY PLAN NOTES

- 1 REMOVE AND REPLACE ALL ROOF SHEATHING.
- 2 REMOVE AND REPLACE WOOD ROOF JOISTS AS REQUIRED (JOIST SIZES DENOTED IN ENLARGED FRAMING PLANS ON SHEET S2.10) FOR BIDDING PURPOSES. CONTRACTOR TO ASSURE ADDITIONAL MINIMUM OF 30% OF EXISTING JOISTS WITHIN DESIGNATED PORCH ROOF AREA SHALL BE REMOVED TO BE REMOVED AND REPLACED. FINAL DETERMINATION OF REMOVAL TO BE BY CONTRACTING OFFICE.
- 3 REMOVE ALL COLUMNS AT EXISTING PORCHES AND REPLACE AS DENOTED ON PLANS. SEE DETAILS ON D3, D5 & E3/ON SHEET S3.00.
- 4 FOR BIDDING PURPOSES, CONTRACTOR TO ASSUME THAT ALL WOOD ROOF EDGE BEAMS SHALL BE REMOVED AND REPLACED AS NOTED IN ENLARGED FRAMING PLANS ON SHEET S2.10. SEE DETAILS D1, D3, D5, E1 & E5 ON SHEET S3.00.
- 5 REPAIR JOIST AND/OR BEAM BEARING AT EXISTING BUILDING. SEE DETAILS E1 & E2 ON SHEET S3.00.
- 6 REMOVE, REPAIR & RE-INSTALL EXISTINGS WROUGHT IRON RAILING AROUND PERIMETER OF EXISTING PORCH ROOF FRAMING. SEE ARCHITECTURAL DRAWINGS.
- 7 REMOVE AND REPLACE EXISTING CEILING PANELING AS REQUIRED. SEE ARCHITECTURAL DRAWINGS.
- 8 EACH JOIST SHALL BE REINFORCED WITH ADDITIONAL 2x6 WOOD JOIST "SISTERED" TO EXISTING 2x6 JOIST, SEE SECTION E7 ON SHEET S3.00.

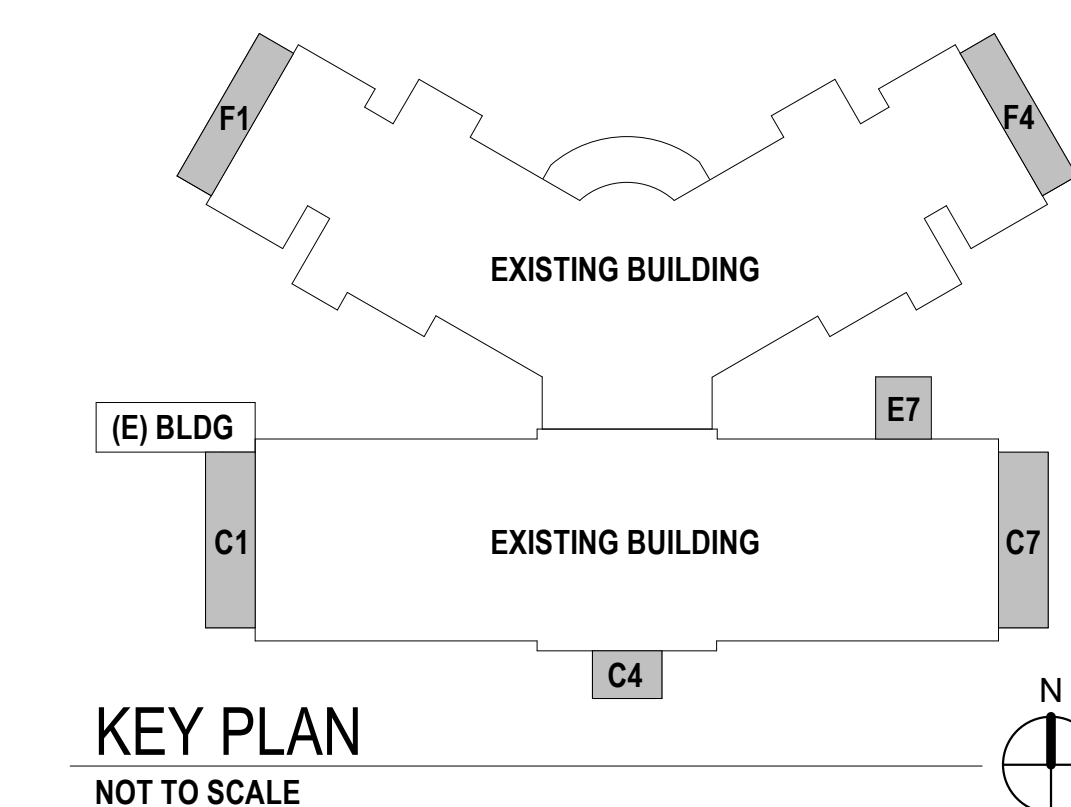

CONSTRUCTION DOCUMENTS

OVERALL PORCH FRAMING PLAN

SCALE: 1/8" = 1'-0"

[illegible]

CONSULTANTS:



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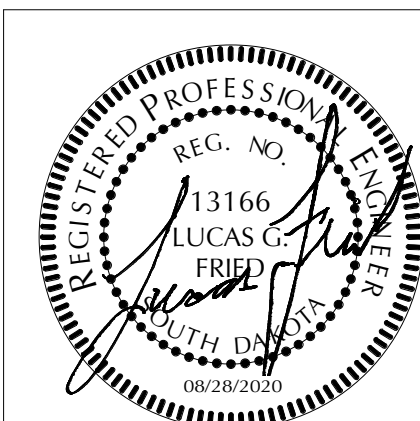


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19.2482

Drawing Title	OVERALL PORCH & LOADING DOCK ROOF FRAMING PLANS
---------------	--

Approved: Project Director

OWNER

Project Title	BUILDING 64 FOLLOW-ON RENOVATION - SHERIDAN VA MEDICAL CENTER
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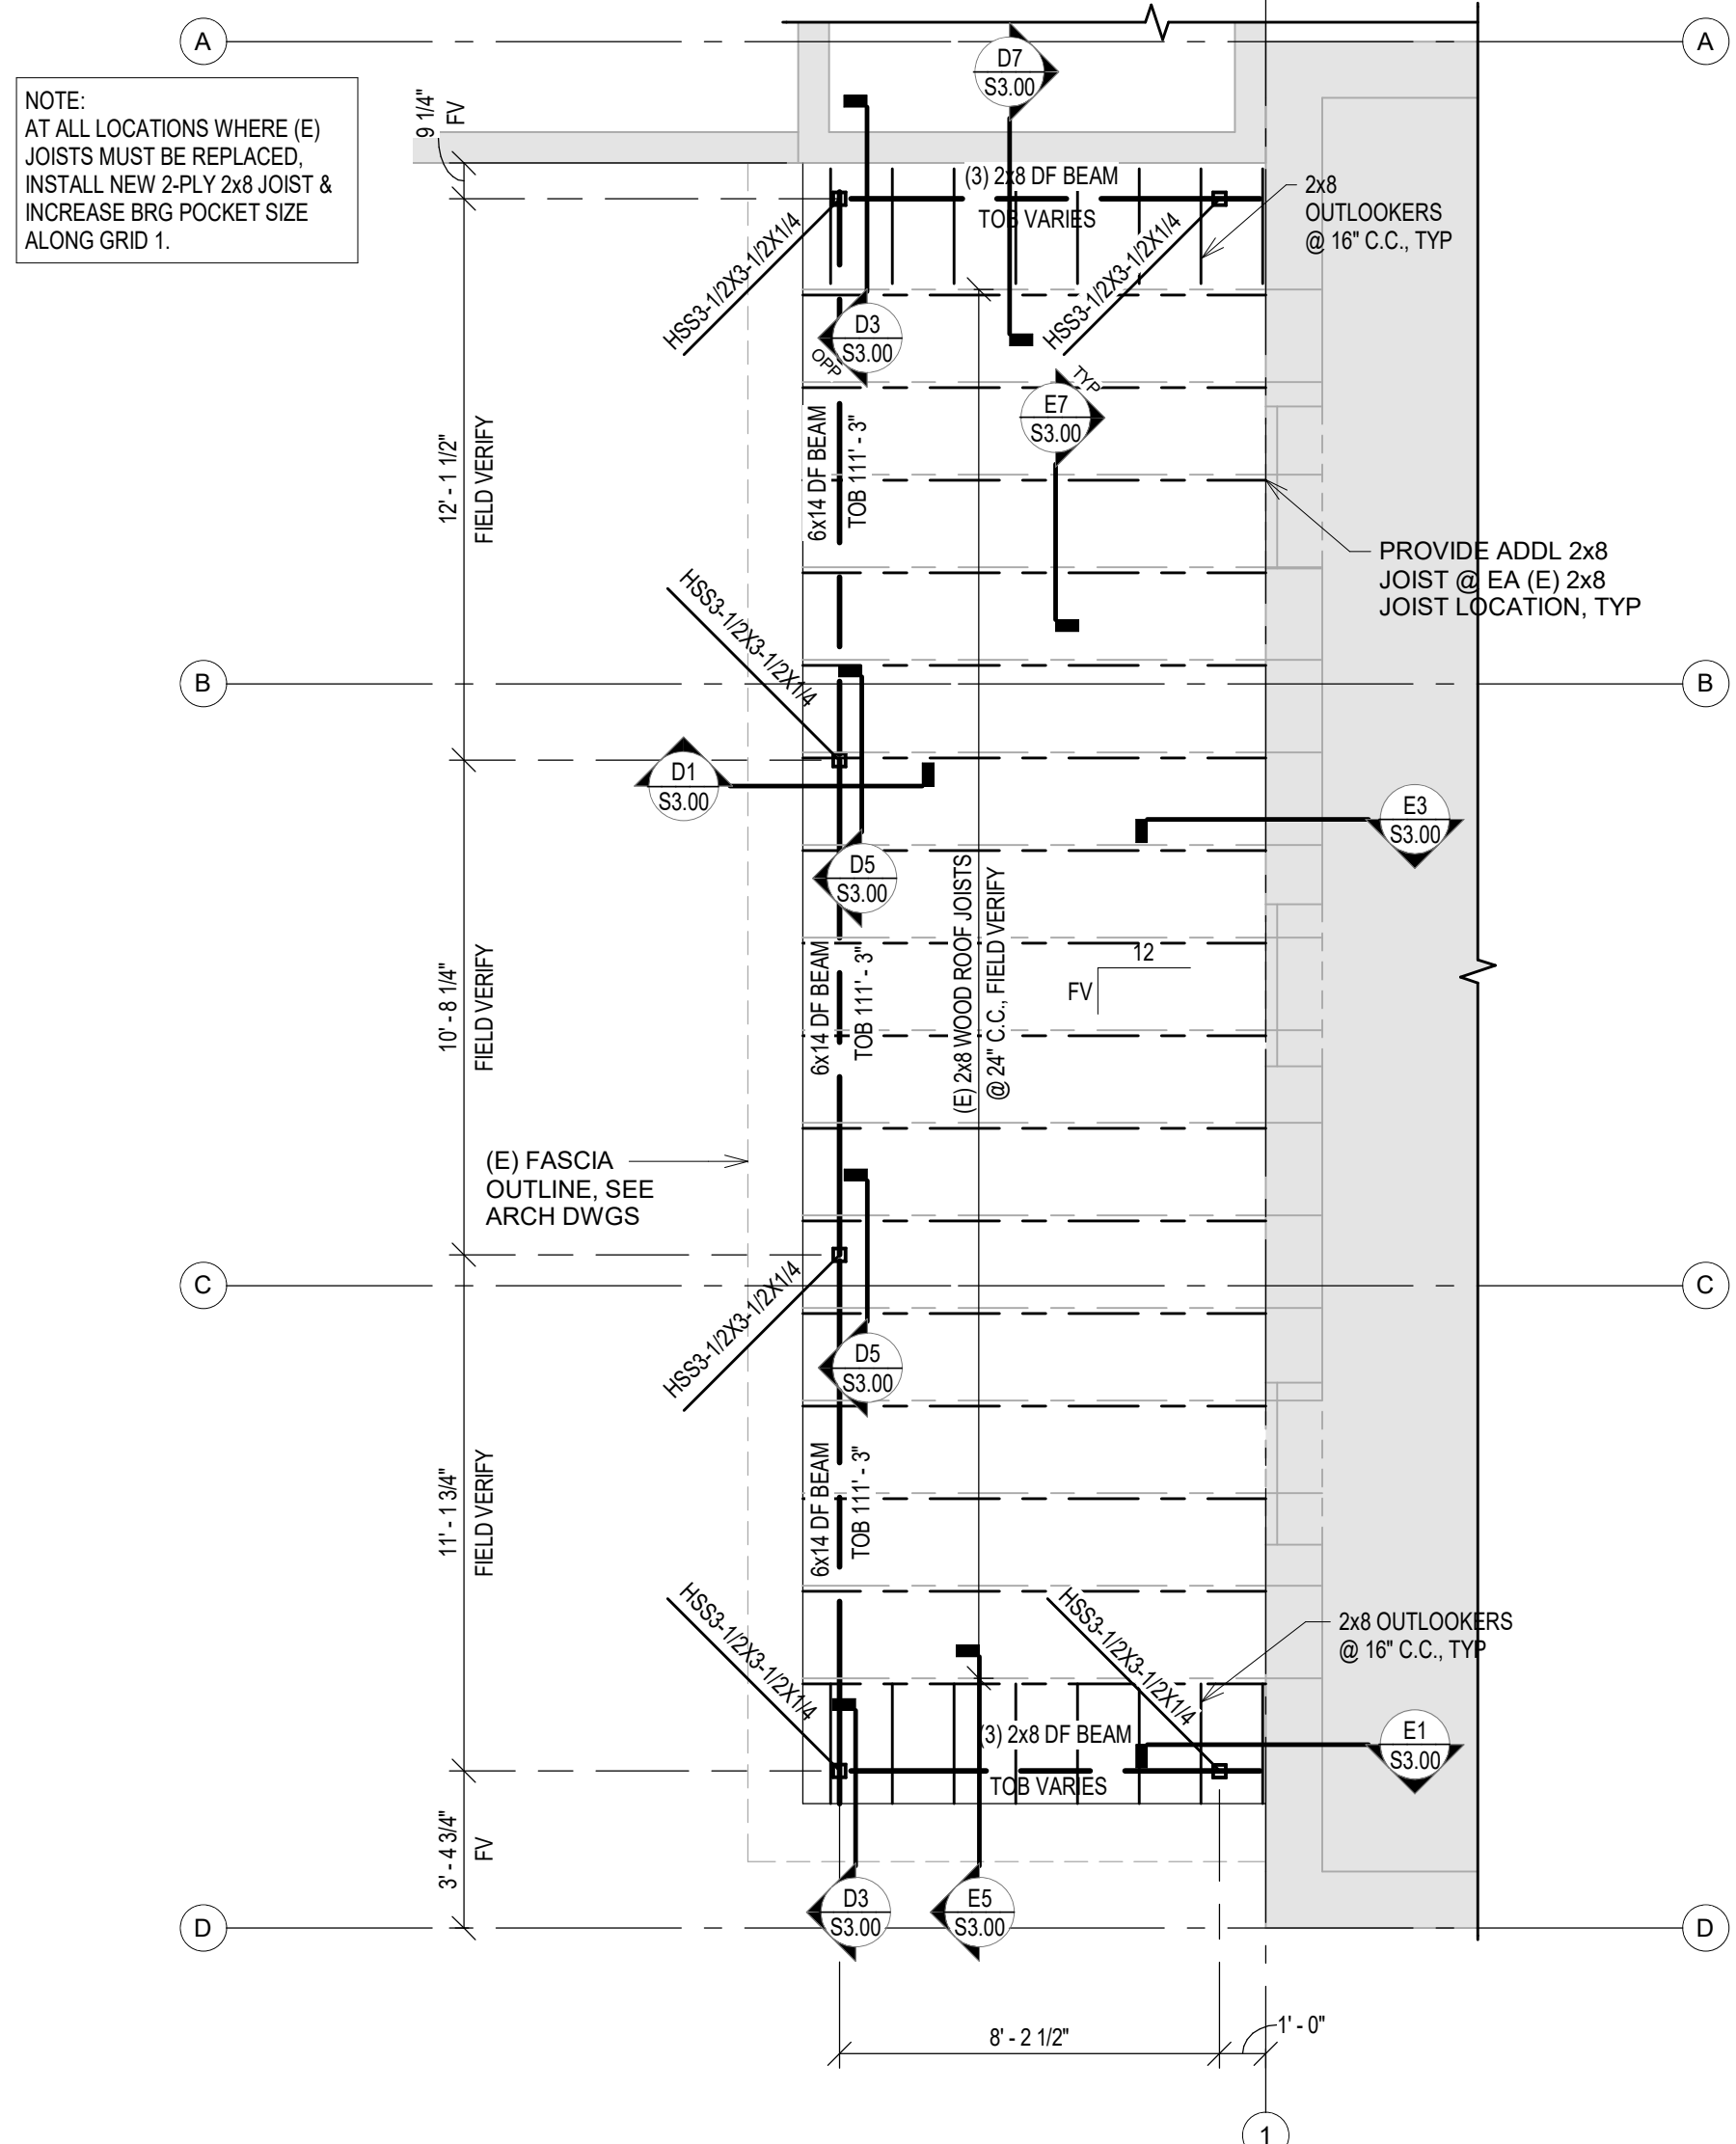
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Date		Checked

Project Number	666-18-103
Building Number	6


Dwg. 61 of 115

Office of
Construction
and Facilities
Management







C1
S2.10
ROOF FRAMING PLAN - EXISTING PORCH WEST
SCALE: 1/4" = 1'-0"

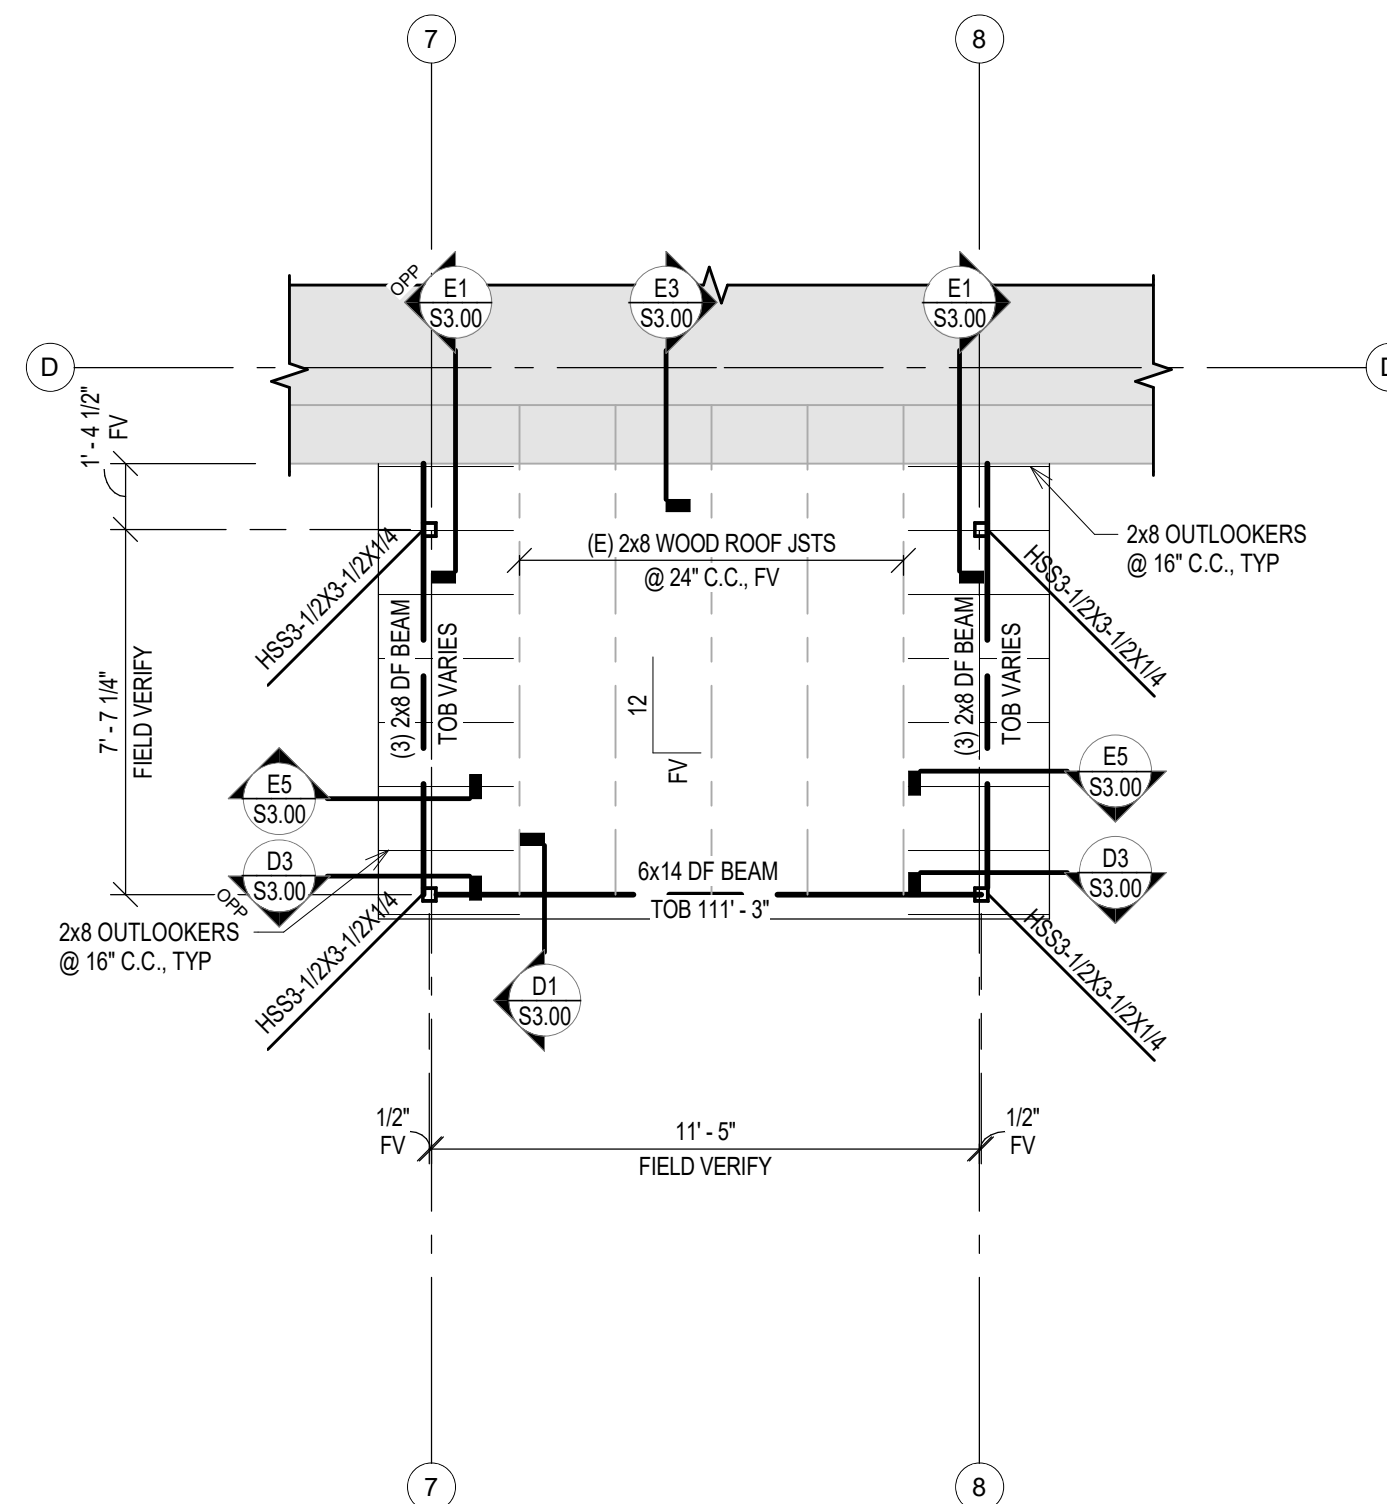


C4
S2.10
ROOF FRAMING PLAN - EXISTING PORCH SOUTH
SCALE: 1/4" = 1'-0"

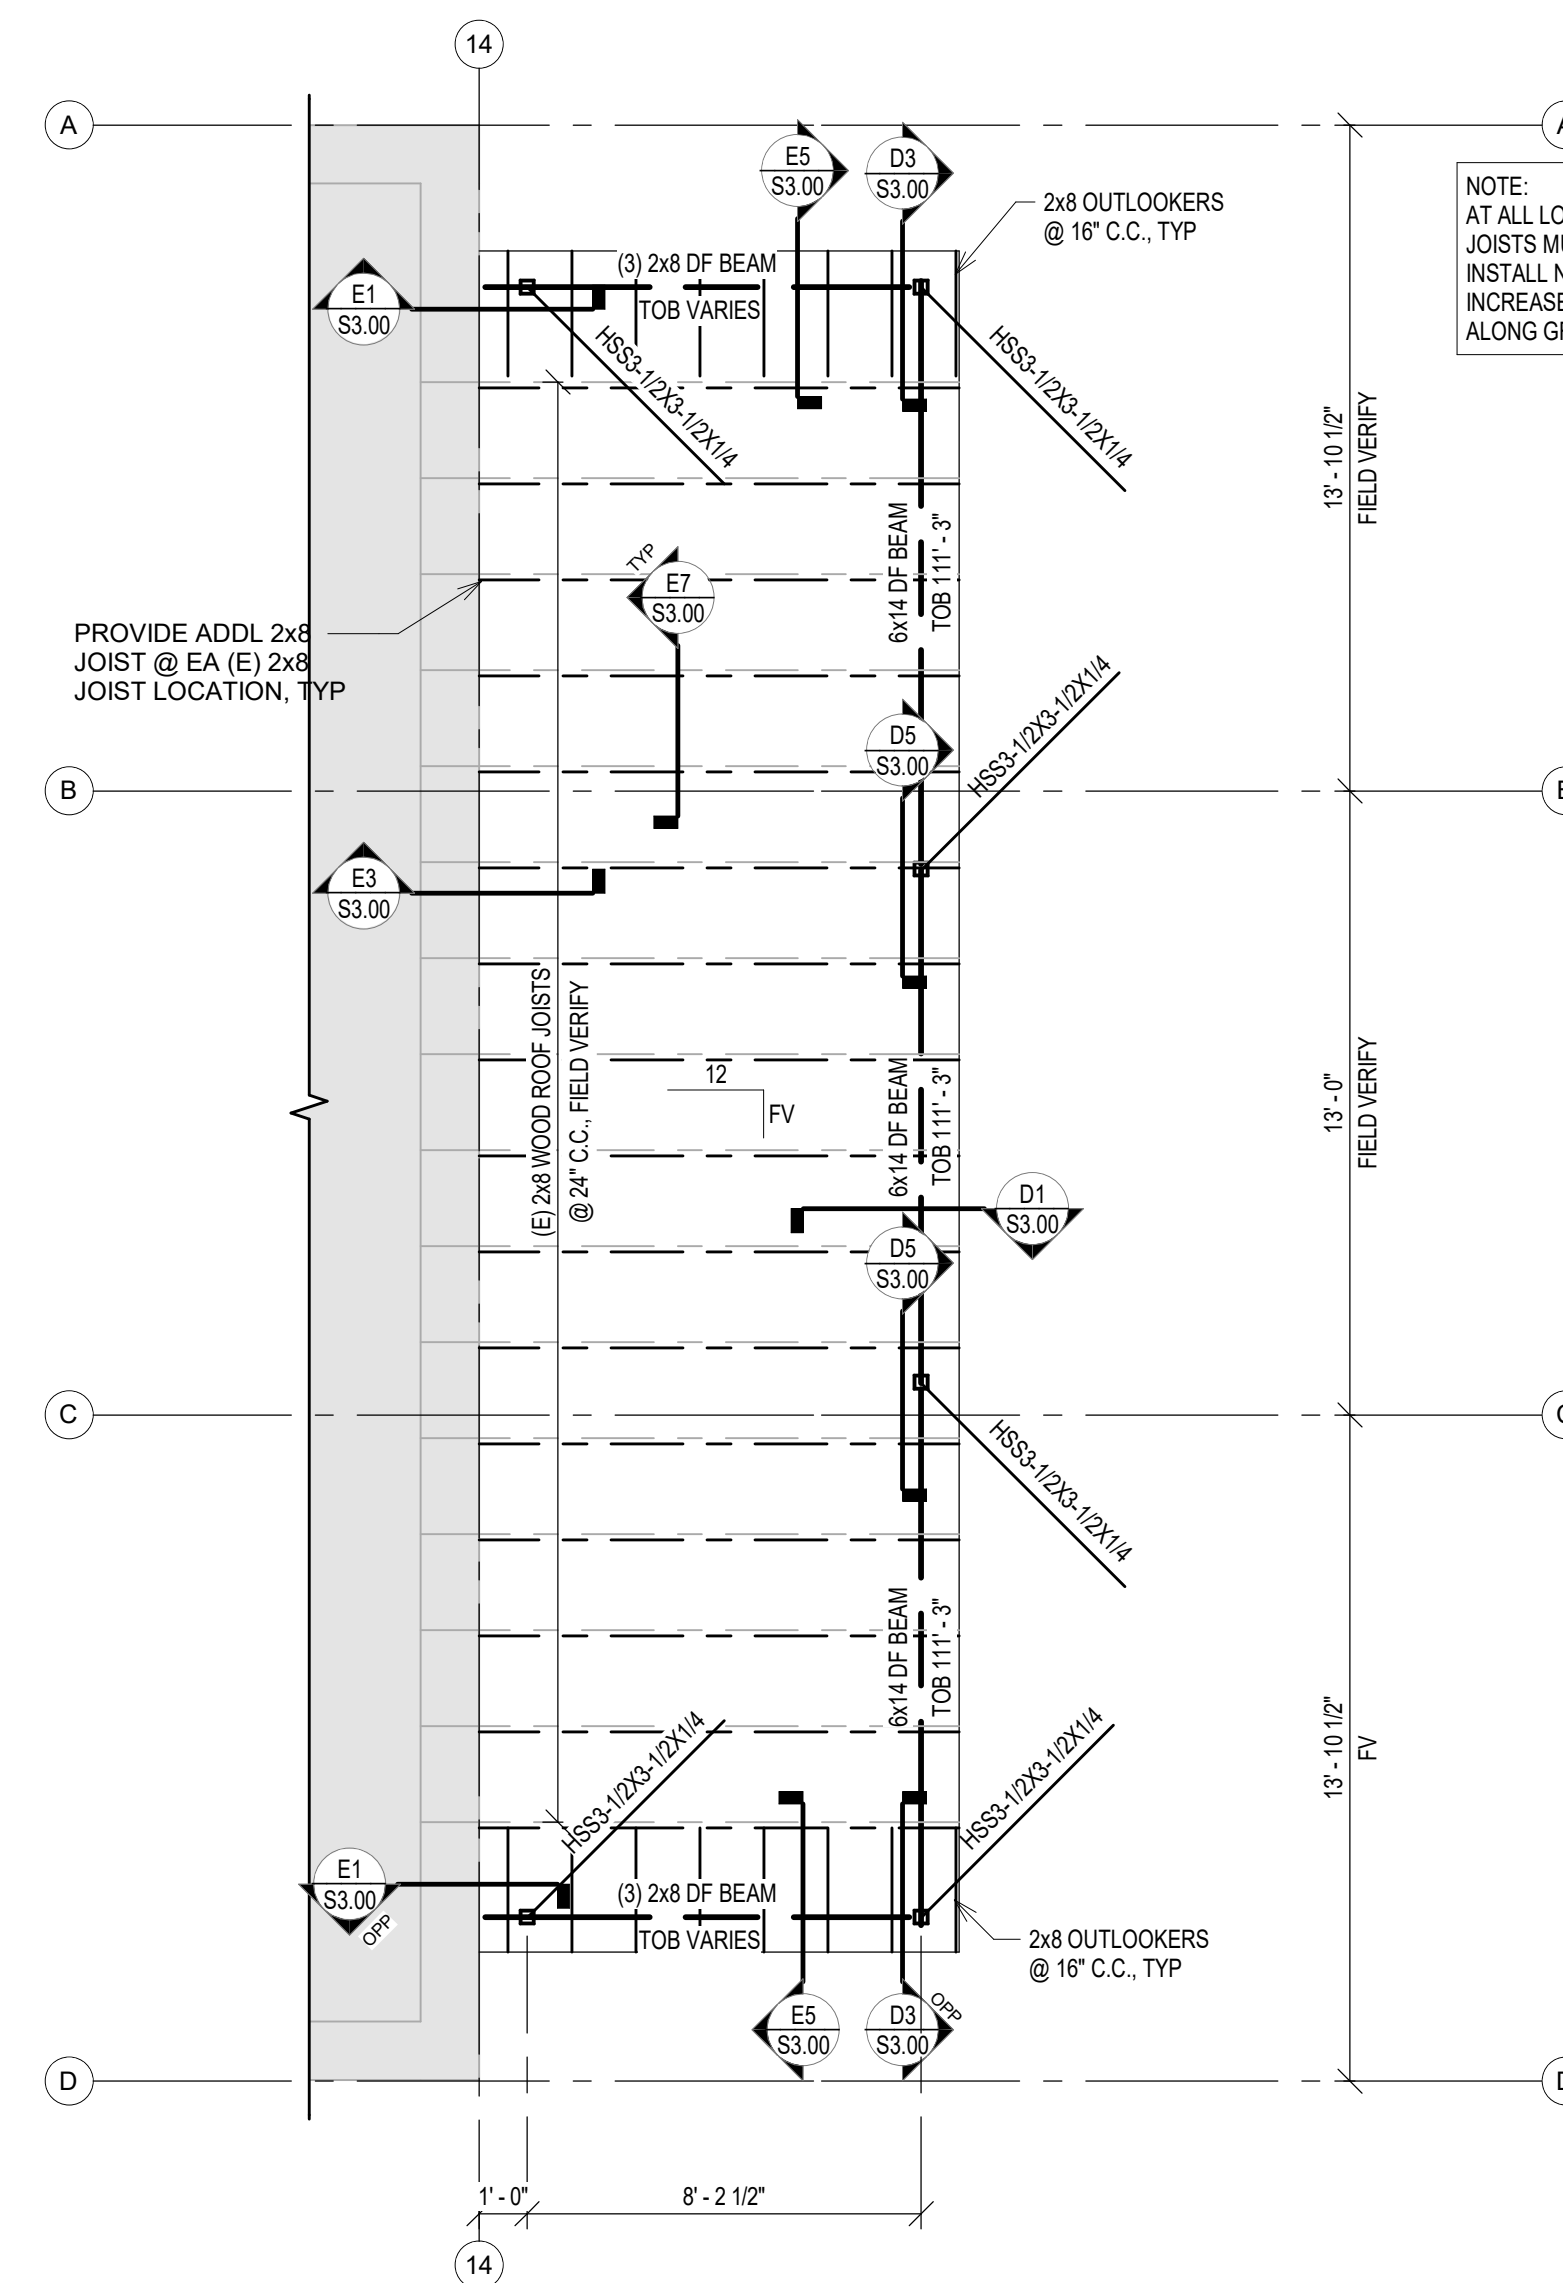


C7
S2.10
ROOF FRAMING PLAN - EXISTING PORCH EAST
SCALE: 1/4" = 1'-0"

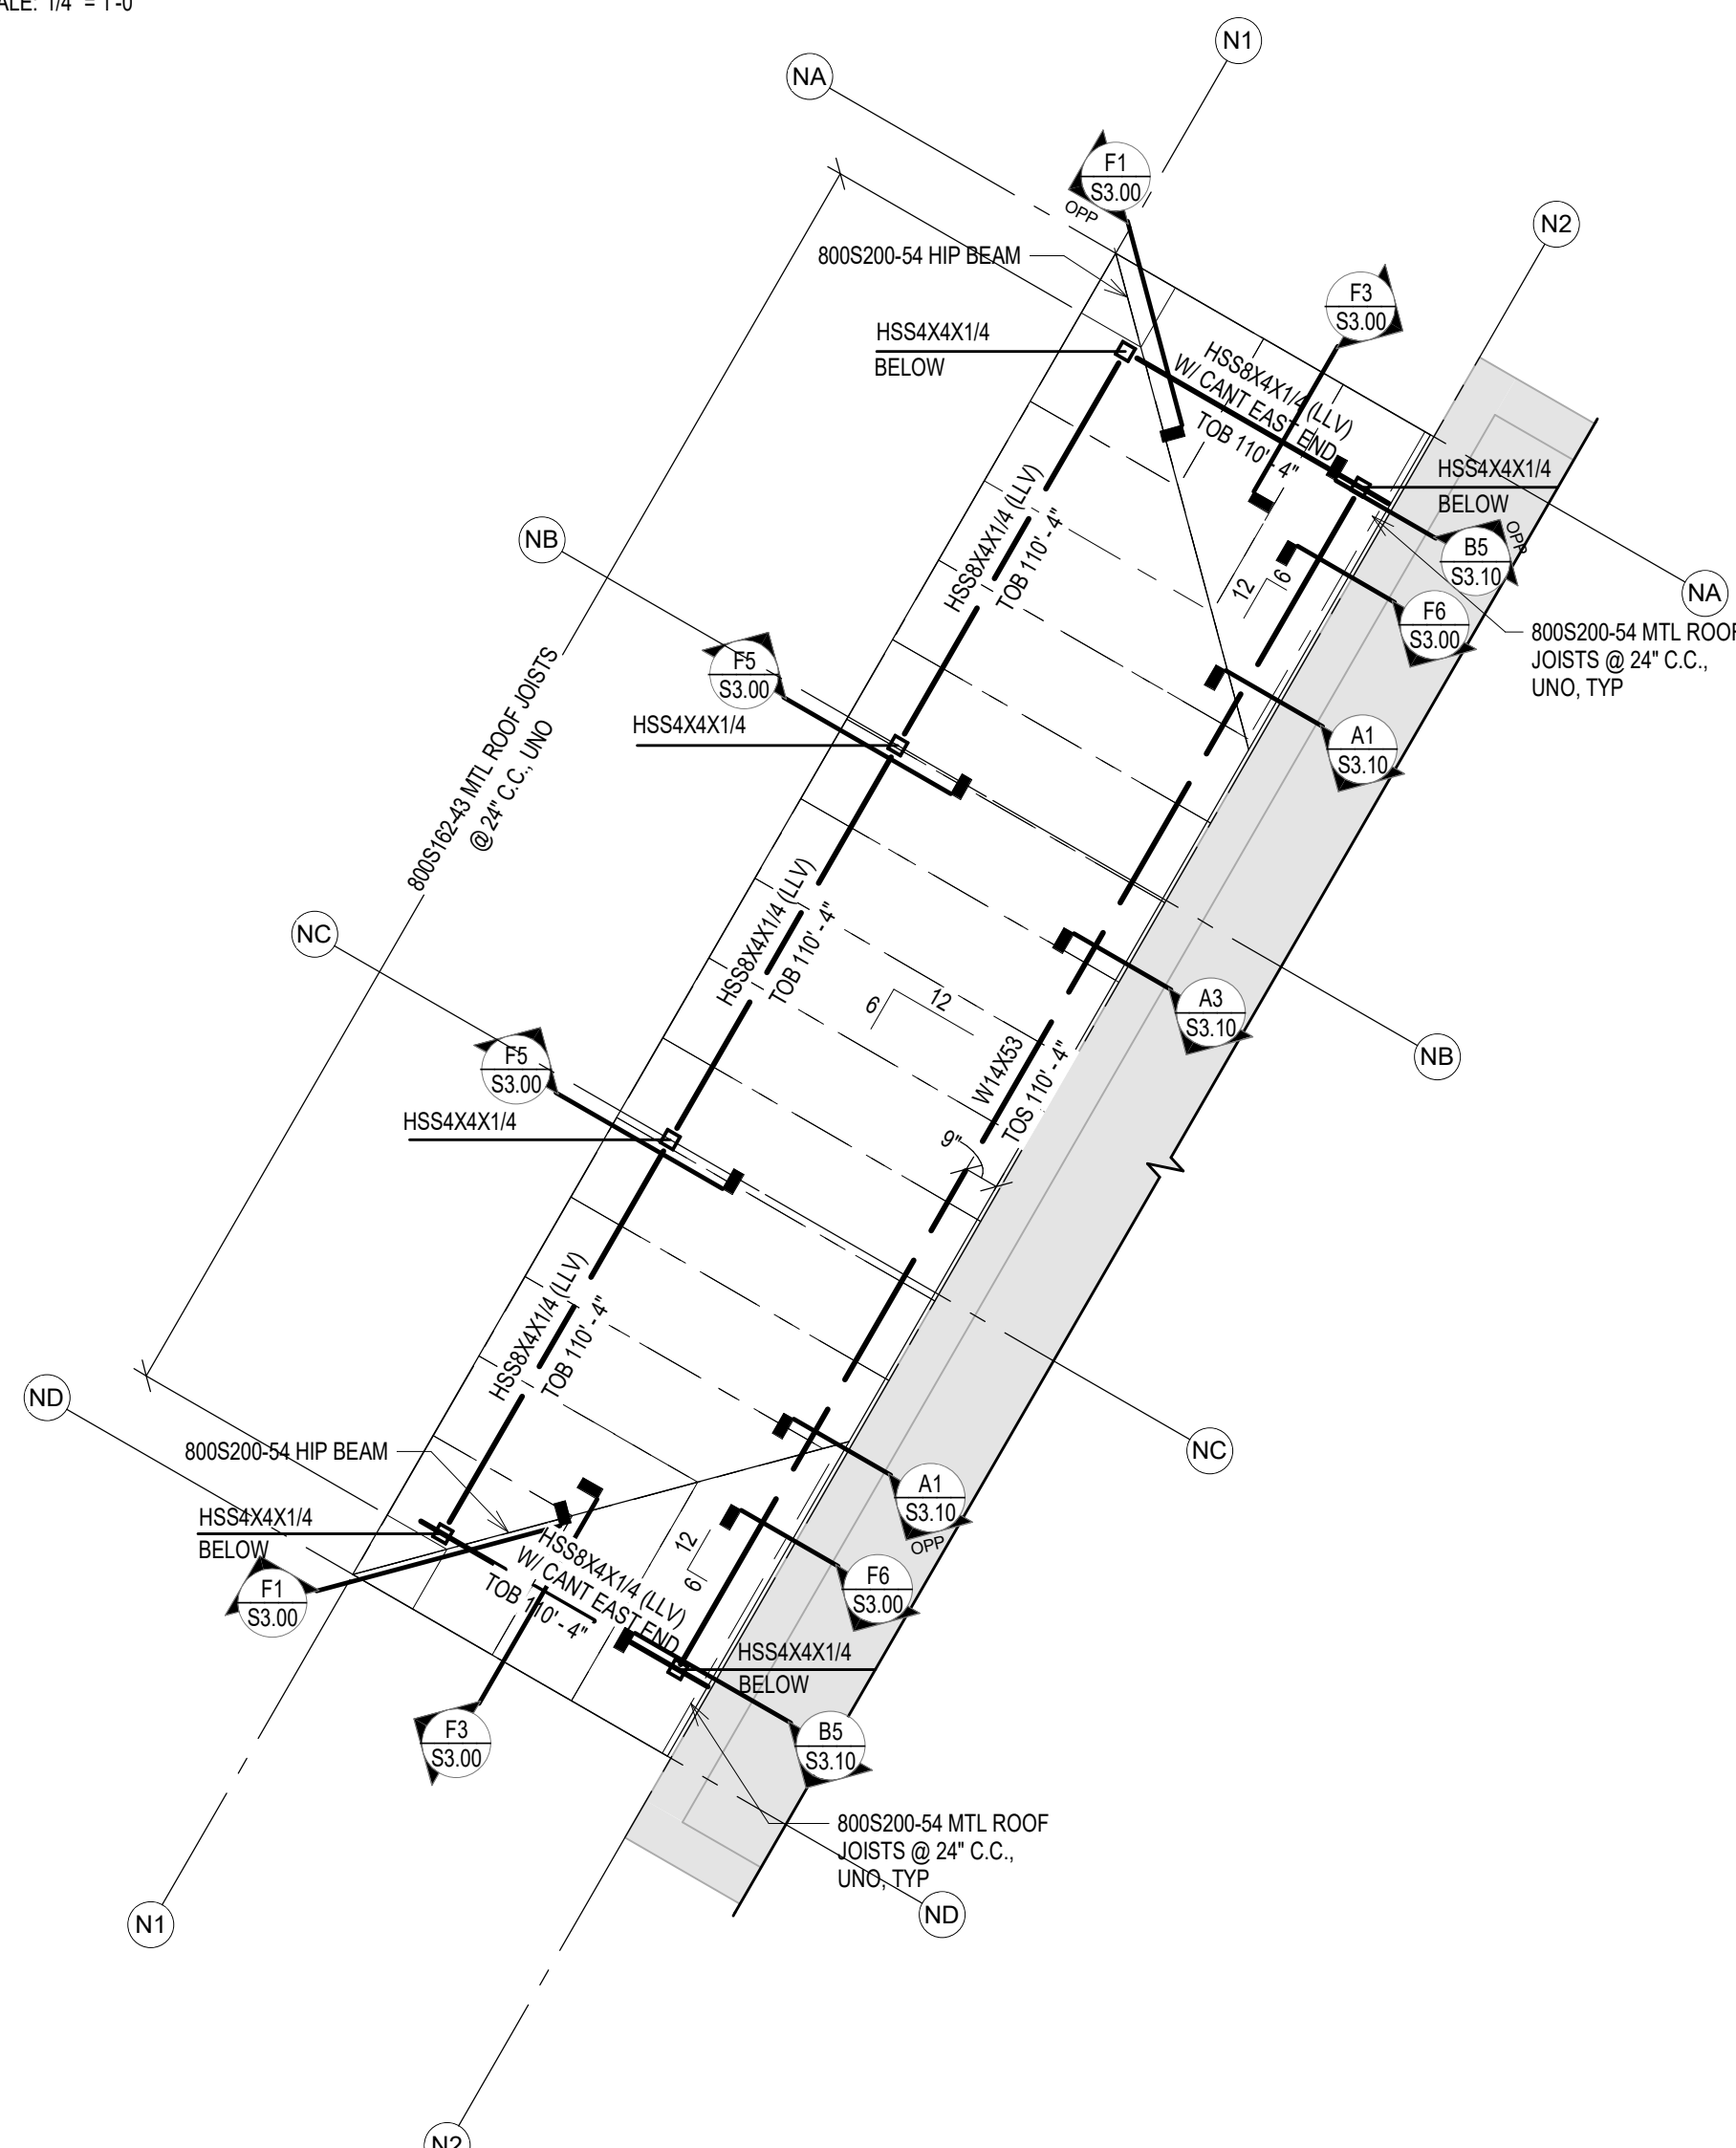


F1
S2.10
ROOF FRAMING PLAN - NEW PORCH WEST
SCALE: 1/4" = 1'-0"

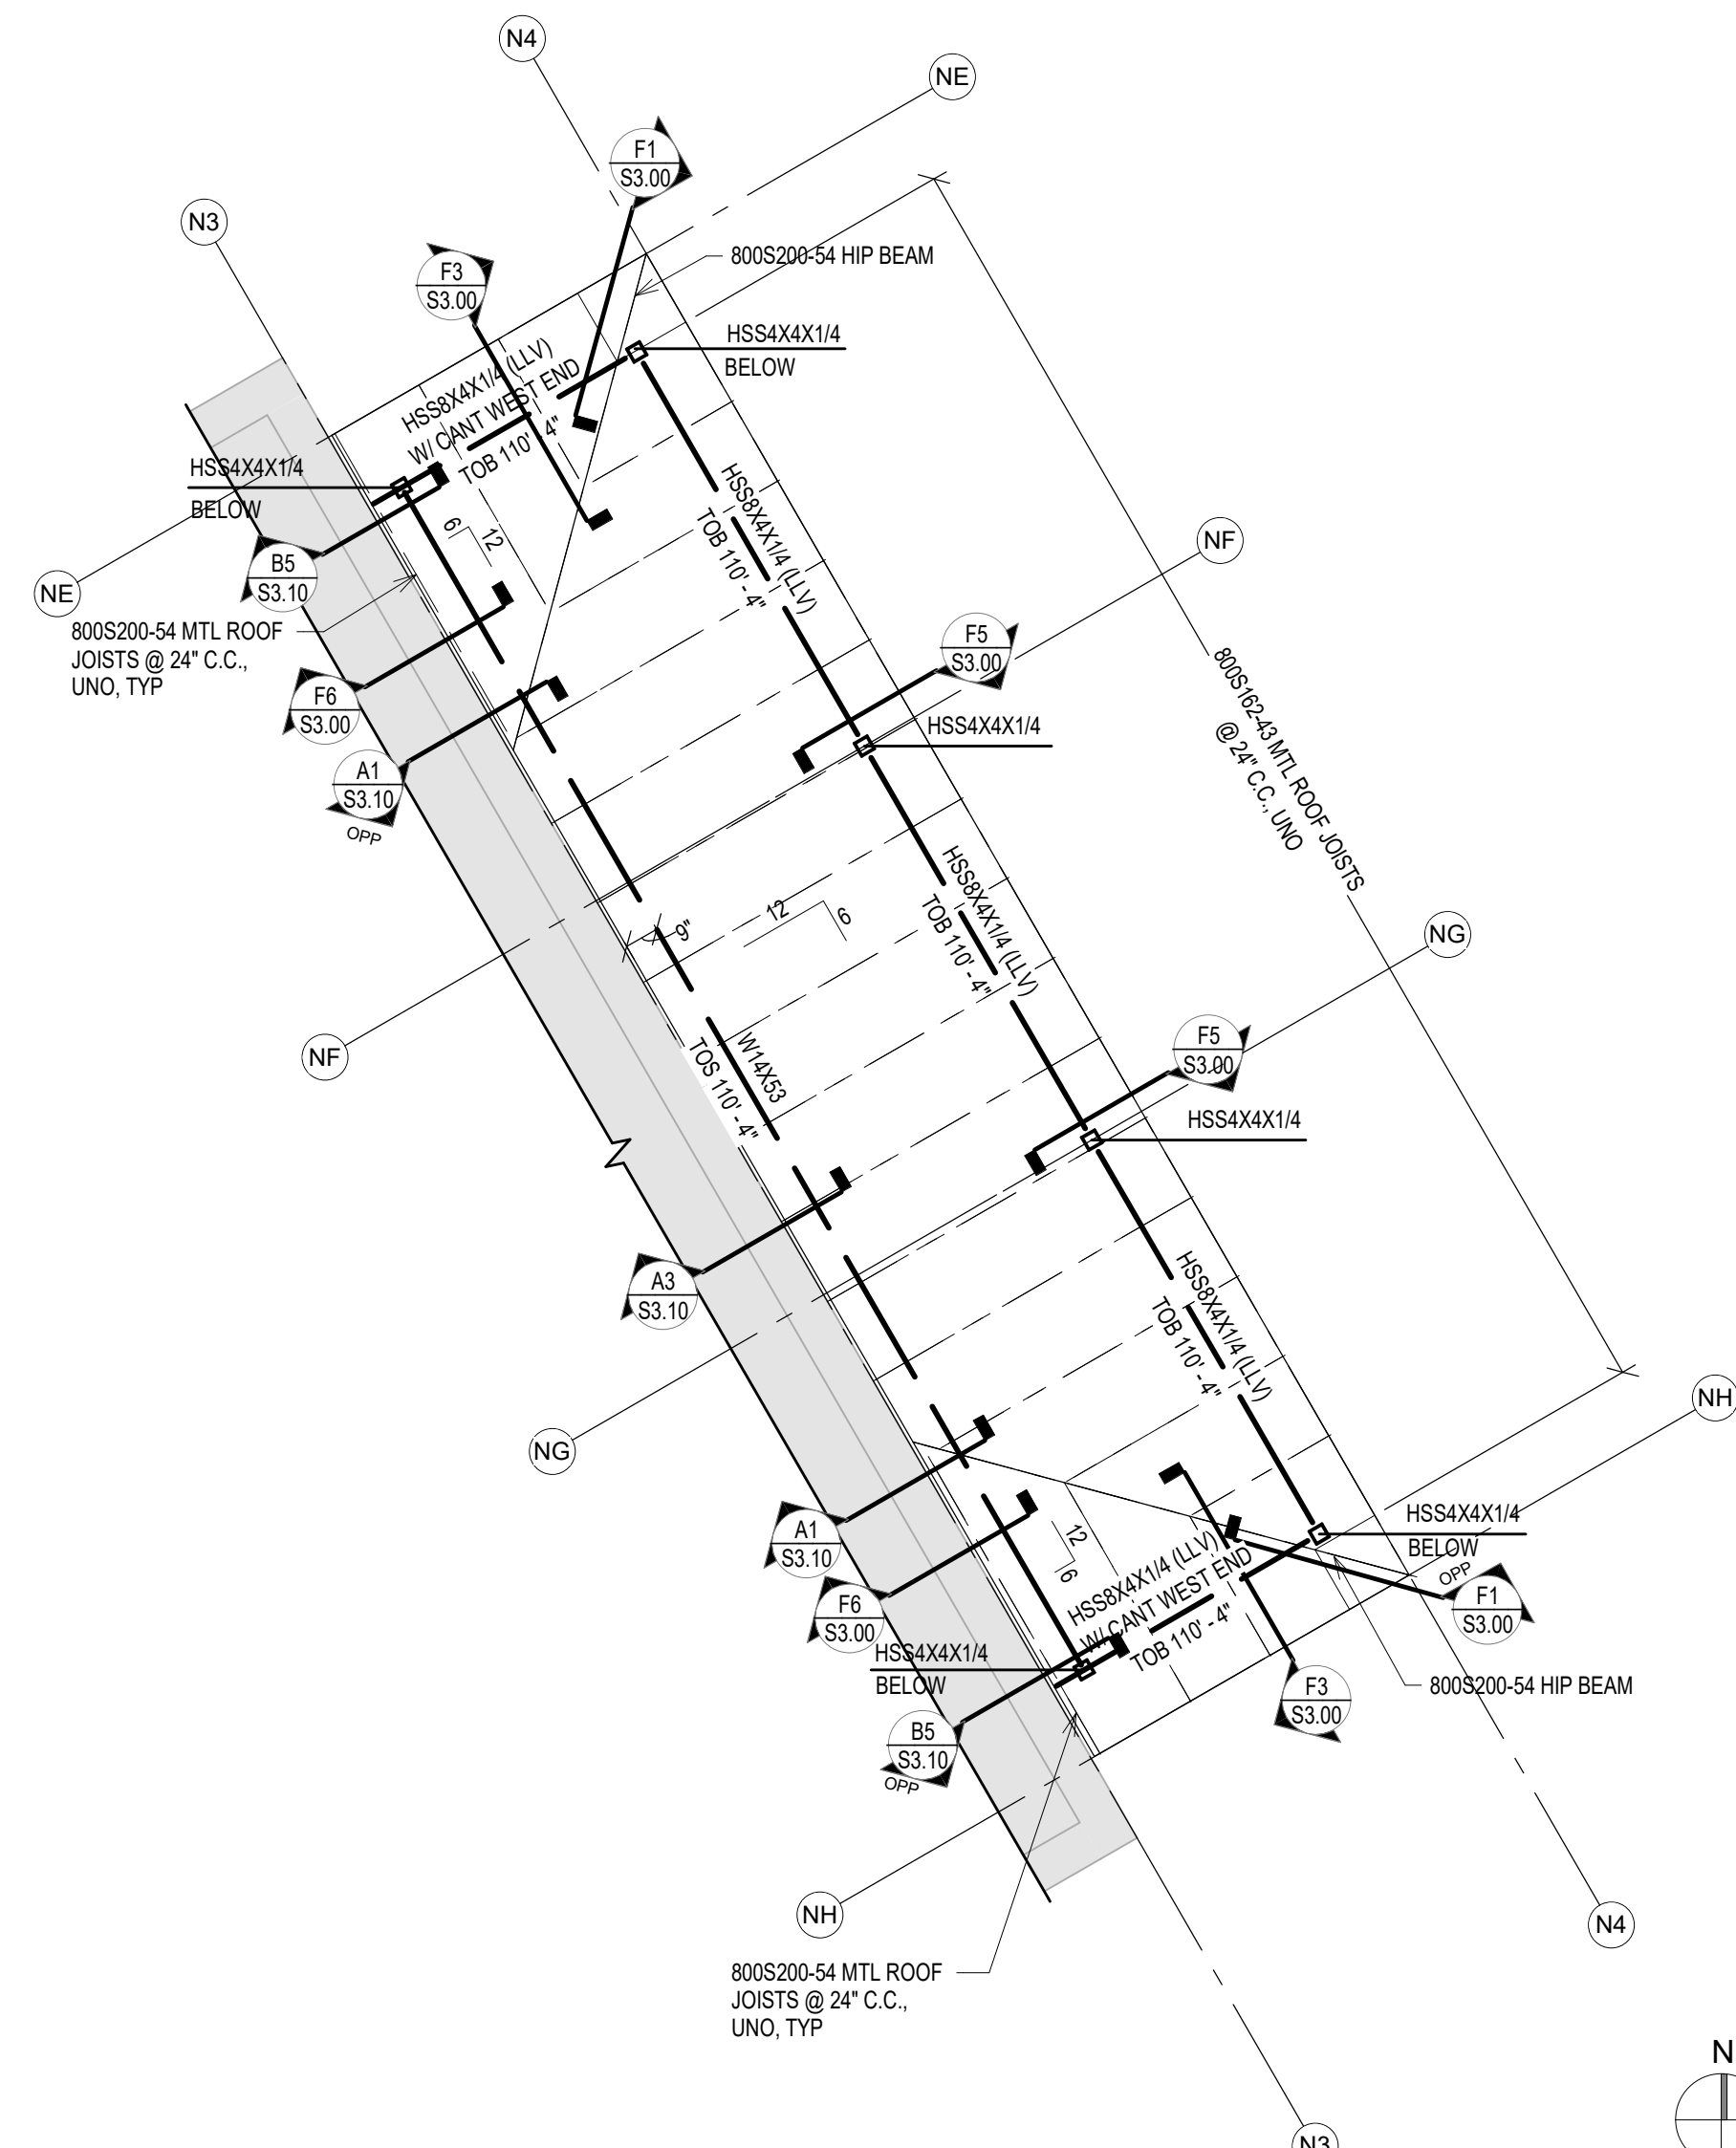

F4
S2.10
ROOF FRAMING PLAN - NEW PORCH EAST
SCALE: 1/4" = 1'-0"

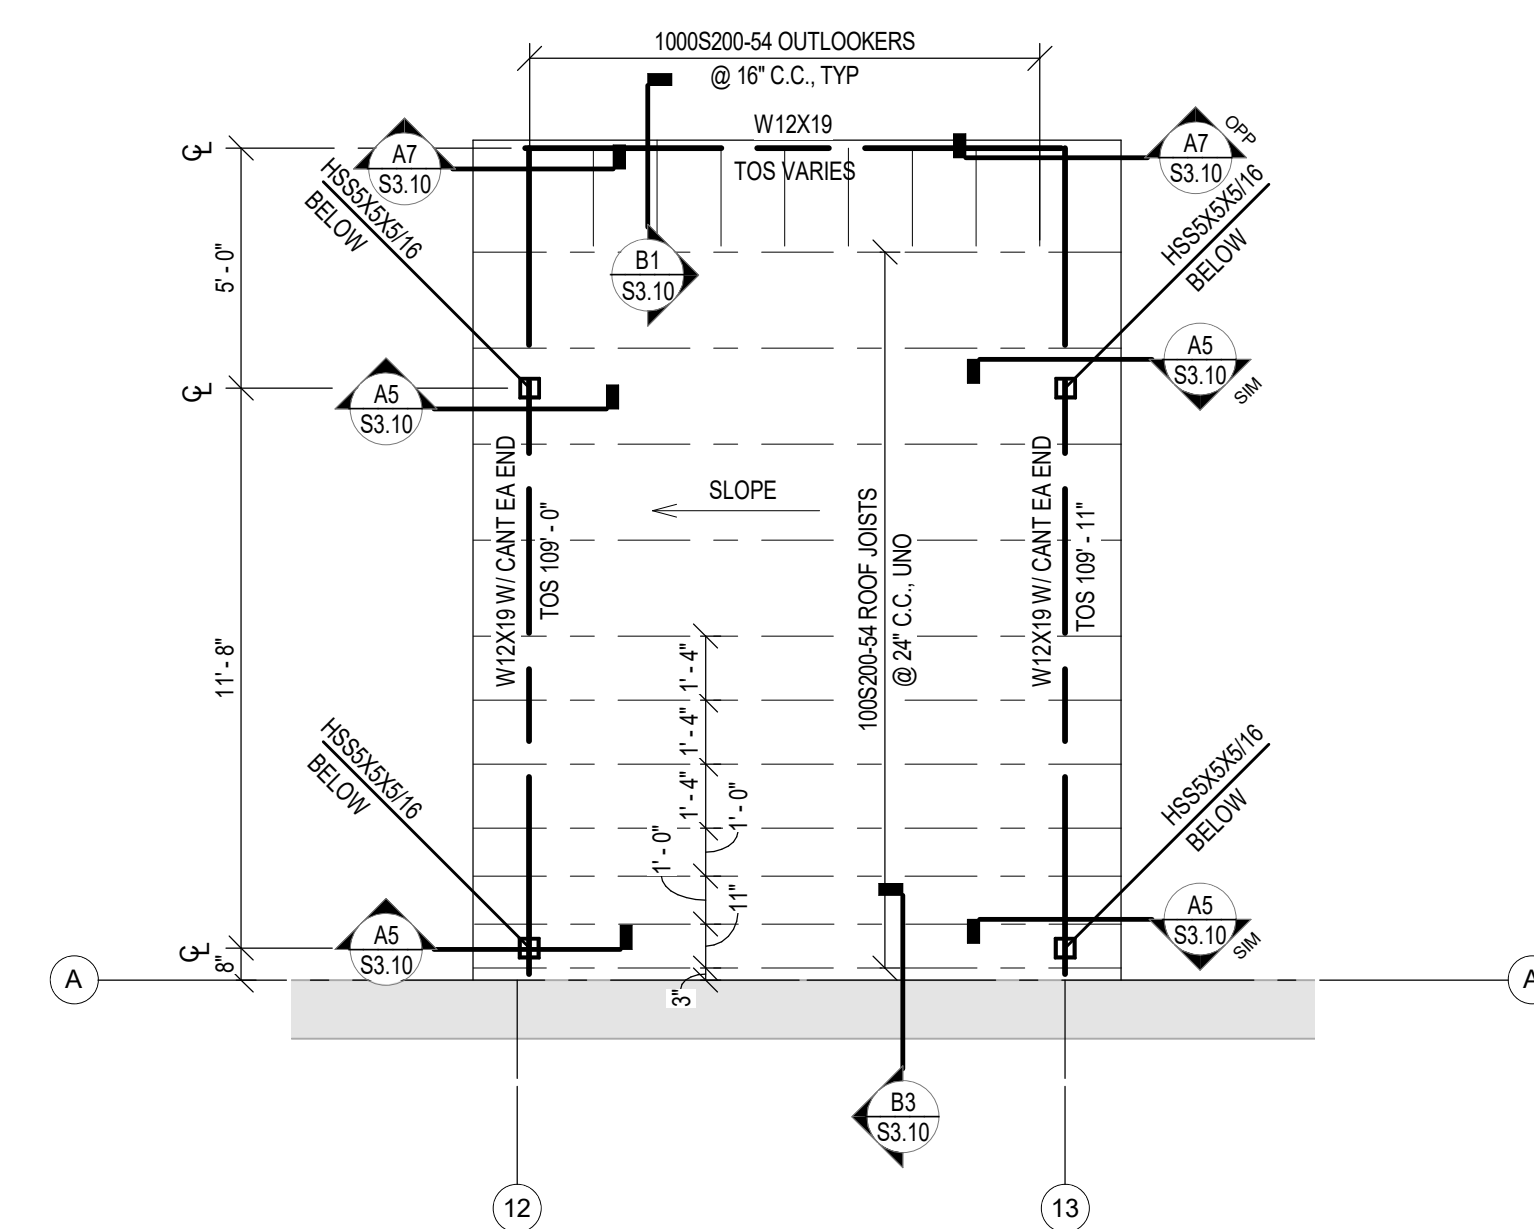

E7
S2.10
ROOF FRAMING PLAN - LOADING DOCK
SCALE: 1/4" = 1'-0"

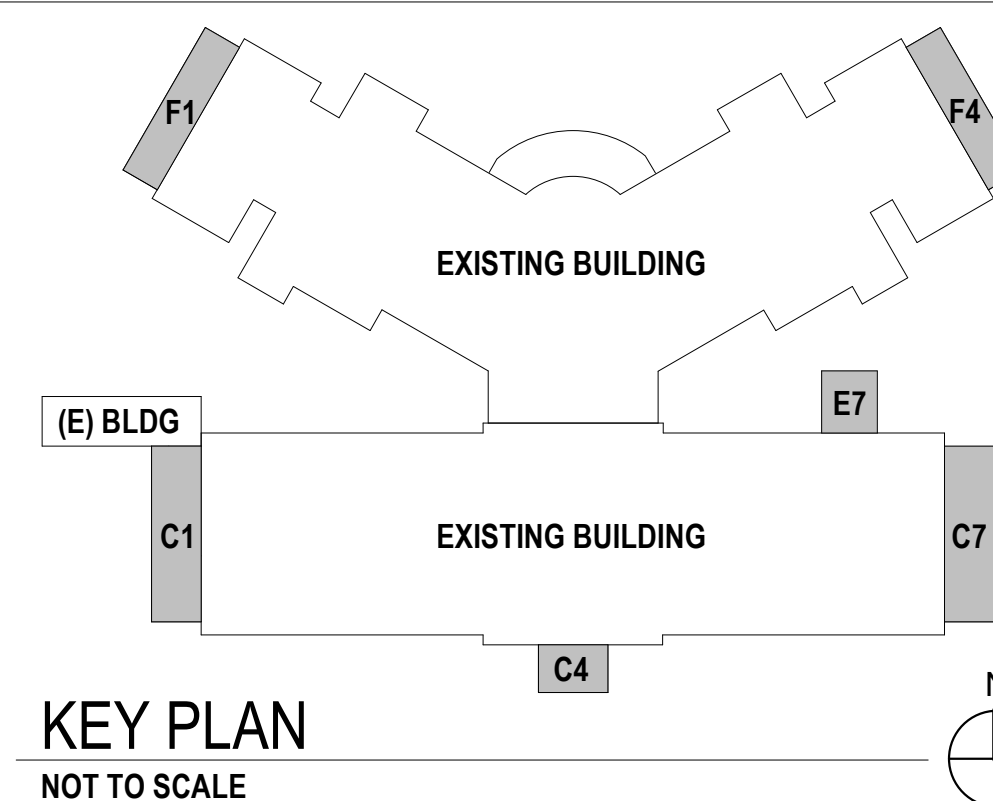

KEY PLAN
NOT TO SCALE

CONSTRUCTION DOCUMENTS

Revisions:	Date:

CONSULTANTS:

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Drawing Title
PORCH & LOADING DOCK ENLARGED ROOF FRAMING PLANS

Approved: Project Director
OWNER

19.2482

Project Title
BUILDING 64 FOLLOW-ON RENOVATION - SHERIDAN VA MEDICAL CENTER

Location
SHERIDAN, WYOMING

Date
AUGUST 28, 2020

Checked
LGF

Drawn
KNR


Project Number
666-18-103


Building Number
64

Drawing Number
S2.10

Dwg: 62 of 115

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Management

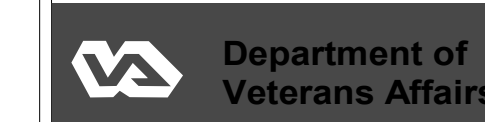


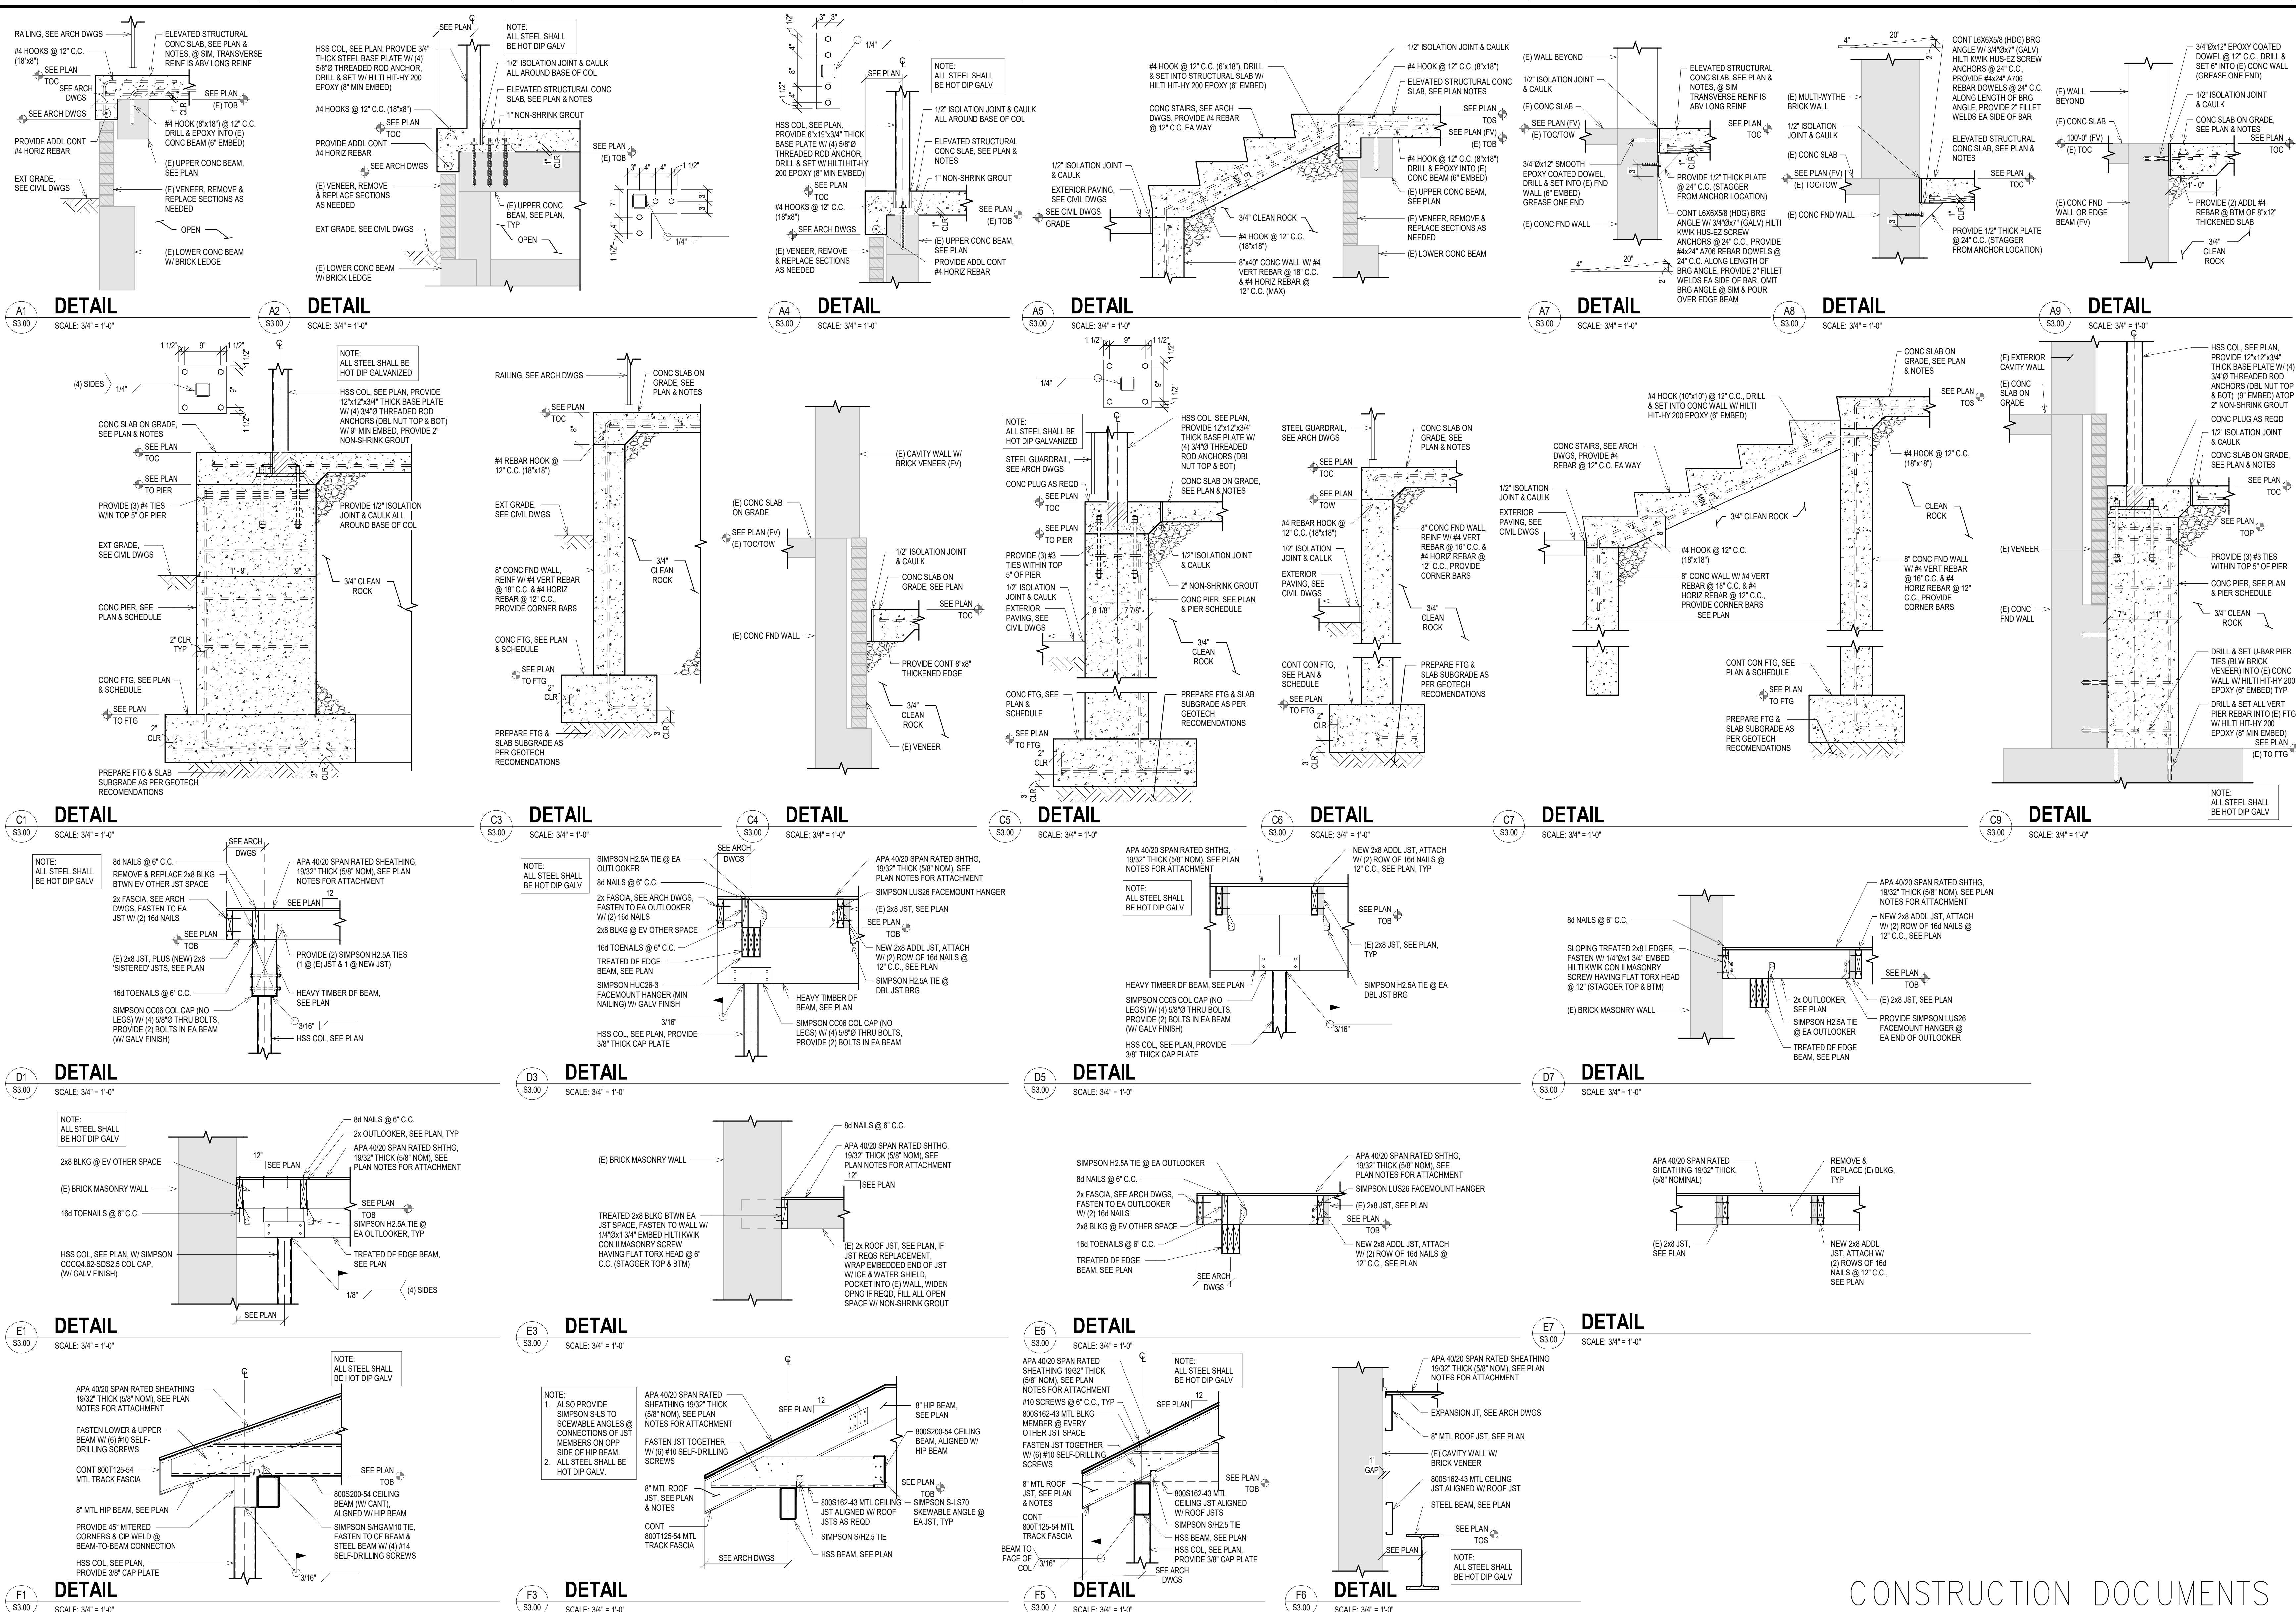

CONSTRUCTION DOCUMENTS

CONSULTANTS:


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Drawing Title
DETAILS

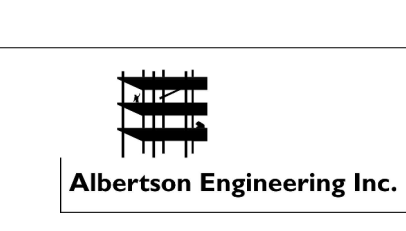Approved: Project Director
OWNER

19.2482

Project Title	Project Number
BUILDING 64 FOLLOW-ON RENOVATION - SHERIDAN VA MEDICAL CENTER	666-18-103
Location	Building Number
SHERIDAN, WYOMING	64
Date	Drawing Number
AUGUST 28, 2020	S3.00
Checked	Dwg. 63 of 115
LGF	
Drawn	
KNR	

Office of Construction and Facilities Management

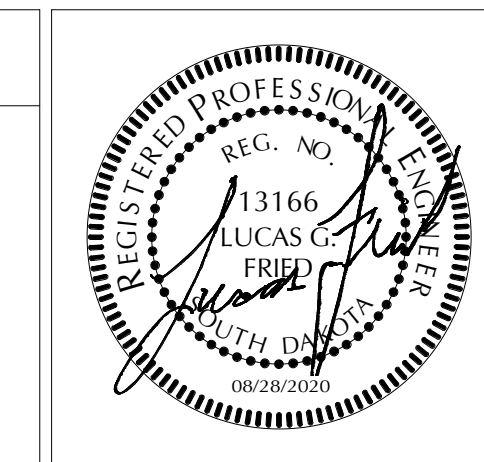Department of Veterans Affairs


ARCHITECT

 FOURFRONT DESIGN, INC.
517 7TH STREET
RAPID CITY, SOUTH DAKOTA 57701
PH: (605) 342-9470
FAX: (605) 342-2377
WWW.FOURFRONTDESIGN.COM


19.2482

 <p>Albertson Engineering, Inc.</p> <p>Dawes Engineering & Design</p>	<p>ALBERTSON ENGINEERING, INC. 3202 WEST MAIN STREET, SUITE C RAPID CITY, SOUTH DAKOTA 57702 PH: (605) 343-9606</p> <hr/> <p>DAWES ENGINEERING & DESIGN CO. 46 HIBBARD WAY HELENA, MONTANA 59601 PH: (406) 441-4000</p>
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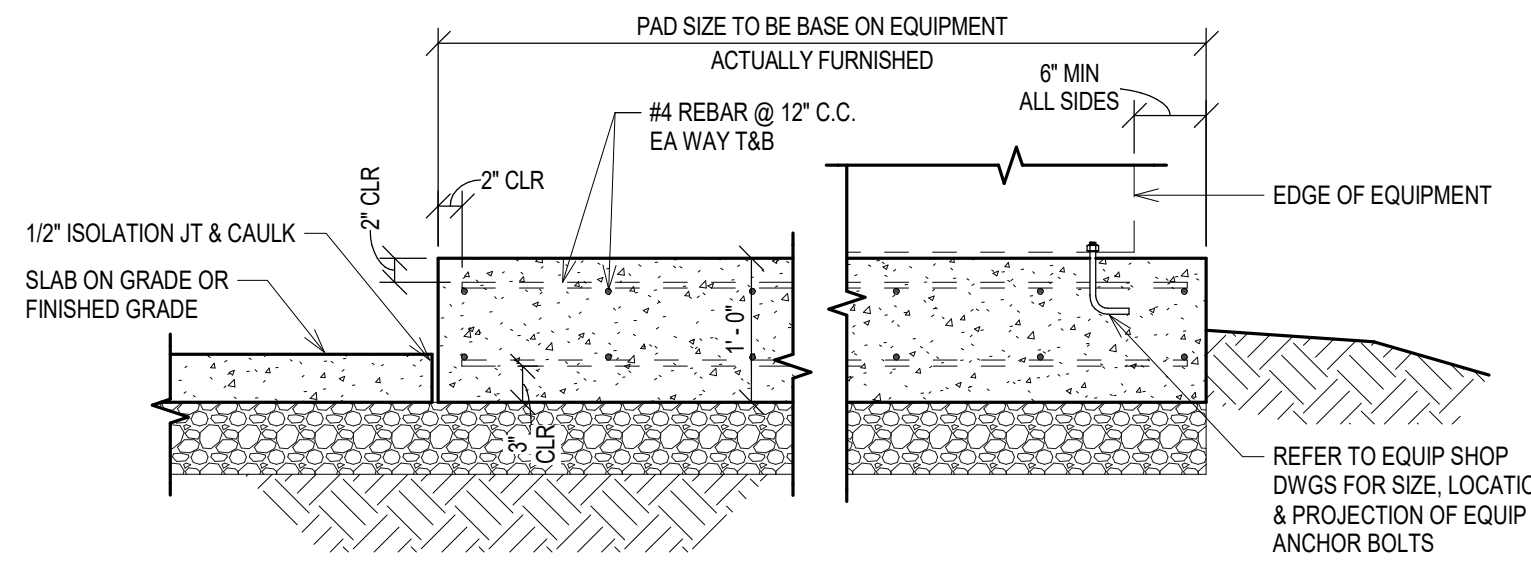
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Date _____

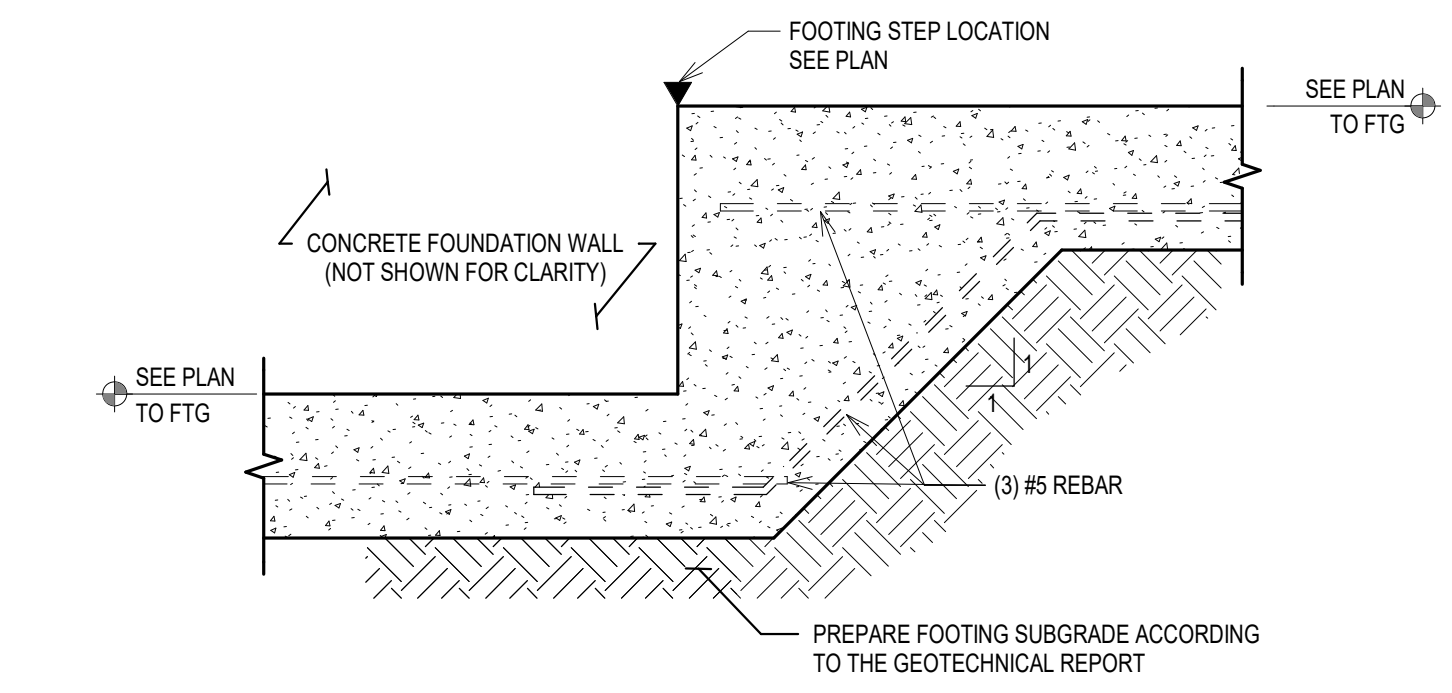


TYP FTG STEP
SCALE: 3/4" = 1'-0"

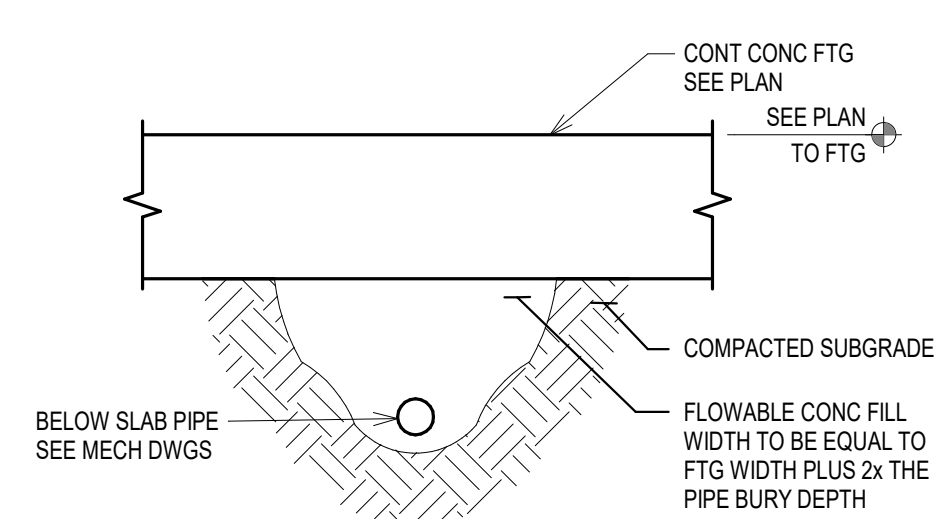


TYP PIPE BLW FTG
SCALE: 3/4" = 1'-0"



TYP EQUIP PAD - EXTERIOR
SCALE: 3/4" = 1'-0"

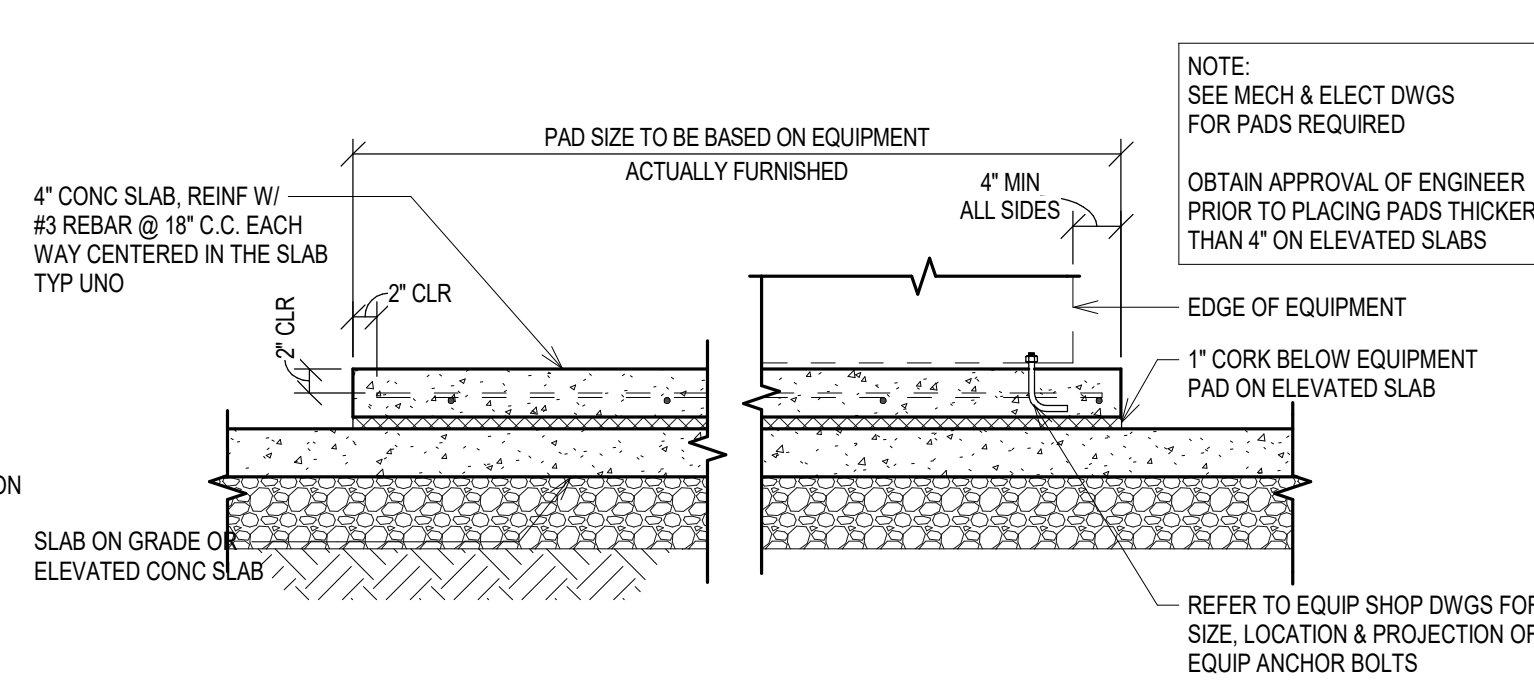

TYP EQUIP PAD - INTERIOR
SCALE: 3/4" = 1'-0"

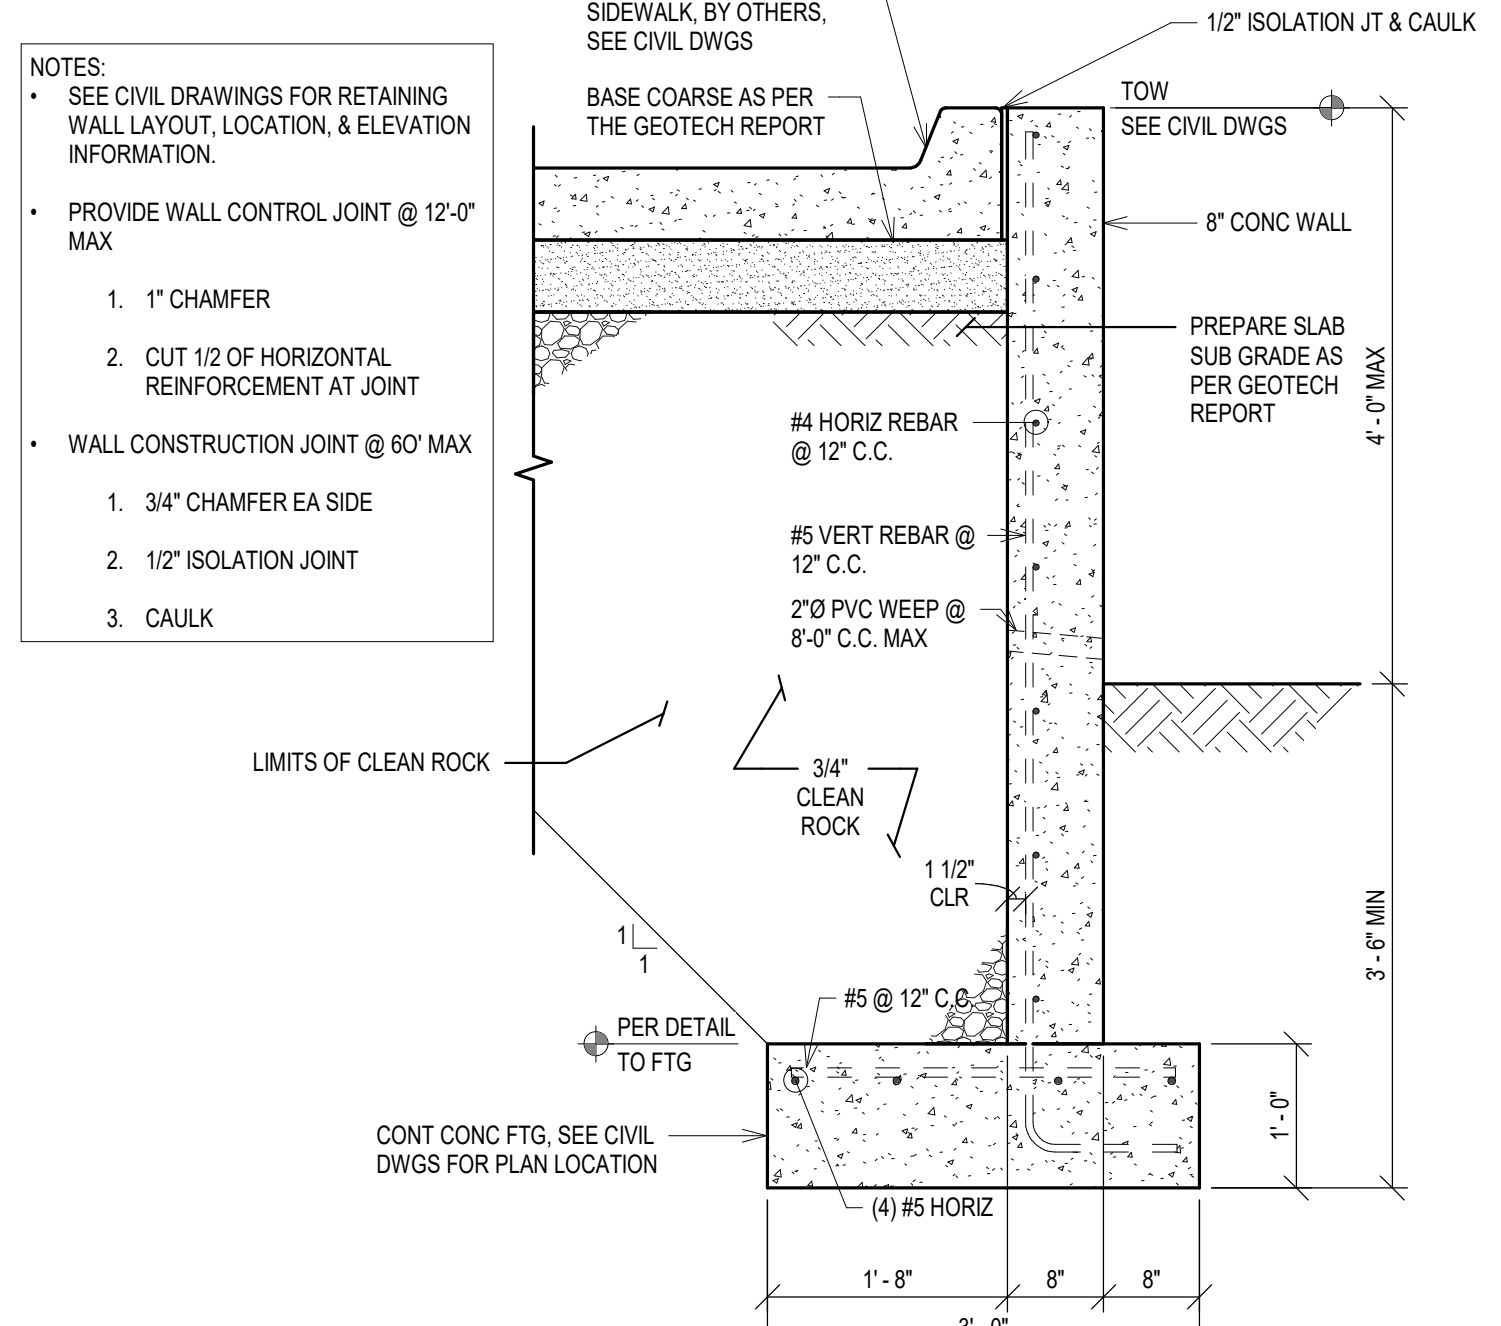


TYP RETAINING WALL
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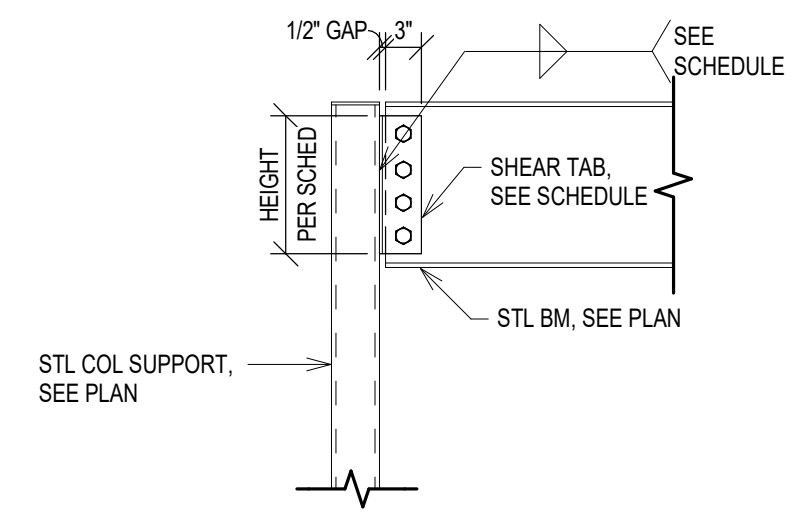
CONCRETE PIER SCHEDULE			
SIZE	REINFORCEMENT		REMARKS
	VERT REIN	TIE SIZE & SPACING	
16" x 16"	(4) #6	#3 @ 12" C.C.	DIAGRAM D
18" x 24"	(8) #6	#3 @ 12" C.C.	DIAGRAM A
18" x 30"	(8) #6	#3 @ 12" C.C.	DIAGRAM C
24" x 30"	(12) #6	#3 @ 12" C.C.	DIAGRAM B

ADDITIONAL REMARKS:

- PROVIDE (3) #3 TIES WITHIN TOP 5" OF CONCRETE PIERS WHEN ANCHOR BOLTS ARE CAST IN PLACE.
- CONTINUE HORIZONTAL WALL REINFORCEMENT THROUGH PIERS.
- PROVIDE CORNER BARS AT CORNERS.
- FOR DIAGRAM C, DRILL AND EPOXY U-BARS INTO EXISTING FOUNDATION WITH 6" MIN EMBEDMENT.

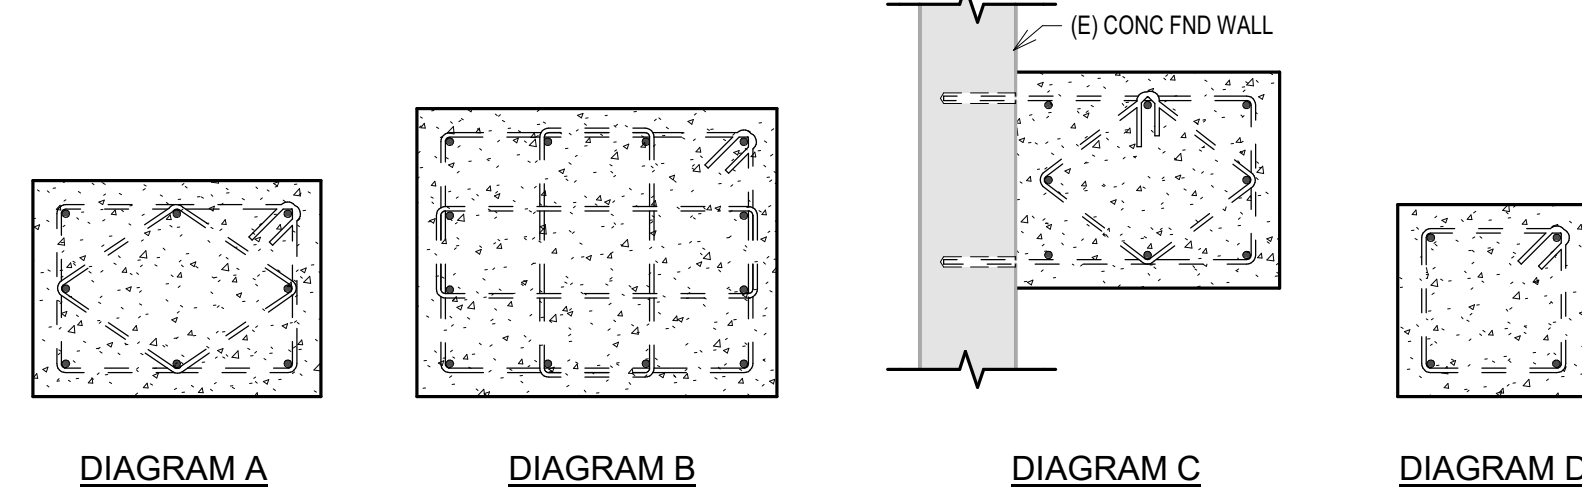

SHEAR TAB CONNECTION SCHEDULE				
BEAM	HEIGHT	THICKNESS	3/4"Ø A325N BOLTS	WELD SIZE TO COL
W12 & 14	8 1/2"	3/8"	3	5/16" FILLET



0 1 2 100

Revisions:

Date:

CONSULTANTS:

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1635 DEADWOOD AVENUE
RAPID CITY, SOUTH DAKOTA 57702
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Drawing Title

STANDARD DETAILS & SCHEDULES

Approved: Project Director

OWNER

Project Title

BUILDING 64 FOLLOW-ON RENOVATION - SHERIDAN VA MEDICAL CENTER

Location

SHERIDAN, WYOMING

Date

AUGUST 28, 2020

Checked

LGF

Drawn

KNR

Project Number

666-18-103

Building Number

64

Drawing Number

S4.00

Dwg. 65 of 115

Office of Construction and Facilities Management

19.2482

VA FORM 08-6231

one and one half inches = one foot
three quarters inch = one foot one inch = one foot
one half inch = one foot
three eighths inch = one foot
one quarter inch = one foot
one eighth inch = one foot
one sixteenth inch = one foot

NOTE: SNOW MELT LOOP PIPING UTILIZES 50% PROPYLENE GLYCOL SOLUTION																							SM #
SNOW MELT SCHEDULE																							
IDENT.	SERVED	MANIFOLD #	AREA S.F.	OUTDOOR TEMP.	TOTAL LOAD (BTU/HSP)	TOTAL LOAD (BTU/H)	SURFACE TEMPERATURE	TUBING SIZE	TUBING AMOUNT	WATER DIFFER.	TUBING O.C.	SUPPLY TEMP.	NUMBER LOOPS	ACTIVE LOOP LENGTH	LEADER LENGTH	TOTAL LOOP LENGTH	GLYCOL %	FLOW LINEAR FT. GPM	LOOP FLOW GPM	TOTAL FLOW GPM	PRESSURE DROP (LINEAR FT.)	PRESSURE DROP (FT.)	NOTES
SM-1	WEST SIDEWALK	-	300	-10	185	55,500	38 DEG	5/8"	600'	25	6	130	3	200'	15'	215'	50	0.0085	1.8	5.4	0.0410	8.8	1
SM-2	LOAD DOCK/ EAST SIDEWALK	-	610	-10	185	112850	38 DEG	5/8"	1220'	25	6	130	6	203'	10'	213'	50	0.0085	1.8	10.9	0.0410	8.7	1
NOTES 1. REFER TO SNOW MELT SPECIFICATION FOR MANUFACTURER AND COMPONENT DETAILS.																							

DUCTLESS SPLIT AIR CONDITIONING SYSTEM SCHEDULE											
EQUIP. NO.	SERVICE	COOLING CAPACITY (BTU/H)	CFM	REFRIG.	PERSON TEMPERATURE		ELECTRICAL	MANUFACTURER & MODEL		OPTIONS-ACCESSORIES	
					INDOOR	OUTDOOR					
AC-3	COOLING	24,000	470	R410-A	-	-	0.6	COMBINED	DAIKIN FAQ24TAVJU	2, 3, 4	
CU-3	COOLING	24,000	-	R410-A	-	-	16.5	208-230V 1P, 100V	DAIKIN RZR24TAVJU	1, 3, 4	
NOTES 1. PROVIDE LOW AMBIENT KIT, OPERATIONAL DOWN TO 0°F. 2. MOUNT REMOTE CONTROL THERMOSTAT (WERC24T1) ON WALL WHERE SHOWN ON PLANS. 3. SIZE REFRIGERANT LINESET STRICTLY PER MFR. DIRECTIONS 4. PROVIDE MFR. RECOMMENDED CONTROL WIRE AND POWER CONDUCTOR TO INTERCONNECT OUTDOOR & INDOOR UNIT.											


FAN COIL UNIT SCHEDULE													
EQUIPMENT NO.	AREA SERVED	FLOOR	FLOOR	FLOOR	FLOOR	FLOOR	FLOOR	FLOOR	FLOOR	FLOOR	FLOOR	FLOOR	FLOOR
FCU-1	STAIRWELL	360	1"	1.7	16.7	150	20	1	3/4"	120/160	71	DAIKIN FCVS-04	1, 2, 3, 4
FCU-2	STAIRWELL	360	1"	1.7	16.7	150	20	1	3/4"	120/160	71	DAIKIN FCVS-04	1, 2, 3, 4
FCU-3	STAIRWELL	360	1"	1.7	16.7	150	20	1	3/4"	120/160	71	DAIKIN FCVS-04	1, 2, 3, 4
FCU-4	STAIRWELL	360	1"	1.7	16.7	150	20	1	3/4"	120/160	71	DAIKIN FCVS-04	1, 2, 3, 4
NOTES 1. PROVIDE FACTORY PRE-WIRED DISCONNECT SWITCH. 2. PROVIDE 4 ADDITIONAL 1" MERV 8 FILTERS WITH UNIT. 3. EXTEND CABINET COVER TO CONCEAL VALVES, CONTROLS AND CONDENSATE PUMP. 4. FLOAT SWITCH IN MAIN CONDENSATE PAN.													

FAN SCHEDULE									
EQUIP. NO.	SERVICE	LOCATION	CFM	FLOOR	FLOOR	FLOOR	FLOOR	FLOOR	FLOOR
EF-2	EXHAUST	2ND FLOOR MECH	810	0.8	3.4	0.5	9.1	120-160	GREENHECK SQ-120-VG
RF-2	RETURN	2ND FLOOR MECH	14000	1.0	4.2	5	21	480-3-60	GREENHECK EOB-30-50
NOTES 1. PROVIDE WITH FACTORY DISCONNECT, FACTORY SPEED CONTROL, AND FACTORY BACKDRAFT DAMPER. 2. INTERLOCK FAN WITH AHU-2 FOR OPERATION. 3. PROVIDE WITH FACTORY BELT GUARD AND MOTOR COVER. 4. PROVIDE WITH FACTORY WIRED DISCONNECT SWITCH. 5. PROVIDE WITH VFD WITH BACNET INTERFACE CARD.									

AIR SEPARATOR SCHEDULE									
IDENT	MFR	MODEL	SYSTEM	TYPE	GPM	INLET/ OUTLET SIZE (IN)	MAX P.D. (FT)	OPER. WEIGHT (LBS)	NOTES
AS-1	SPIROTERM	VDN200	SNOW MELT	COALESCING	15	2"1/2"	2'-0"	110	1, 2
NOTES 1. RATED FOR 150 PSI @ 270 DEG. 2. COMBINATION AIR/DIRT SEPARATOR									

WATER-WATER HEAT EXCHANGER SCHEDULE									
IDENT.	SYSTEM	PRIMARY			SECONDARY			# OF PASSES	SCALE FACTOR
		GPM	EWT	LWT	GPM	EWT	LWT		
HEX-3	SNOW MELT	15	150	125	15	105	130	187.5	0.0005
NOTES 1. SYSTEM IS BASED ON 40% GLYCOL PRIMARY AND 50% GLYCOL SECONDARY. 2. PLATE AND FRAME HEAT EXCHANGER									










AIR HANDLING UNIT SCHEDULE													
EQUIP. NO.	SERVICE	LOCATION	FLOOR	FLOOR	FLOOR	FLOOR	FLOOR	FLOOR	FLOOR	FLOOR	FLOOR	FLOOR	FLOOR
AHU-2	HVAC	2ND MECH	6000	15000	3.50	15	375 MBH	80	44	54	79.6	63.2	54.9
NOTES 1. PROVIDE WITH FILTER, PREHEAT COIL, COOLING COIL, AND MIXED AIR (BLENDER) SECTIONS. 2. PROVIDE WITH FACTORY VFD WITH BACNET INTERFACE CARD. 3. HORIZONTAL DISCHARGE KIT, AND SMOKE DETECTORS (SUPPLY & MIXED). 4. COORDINATE DOOR LOCATIONS WITH OPEN SIDE OF UNIT. 5. PROVIDE 4 ADDITIONAL SETS OF MERV 11 PRIMARY FILTERS AND MERV 8 PRE-FILTERS. 6. UNIT IS INTENDED TO MODULAR SO IT CAN BE KNOCKED DOWN AND BROUGHT INTO THE BUILDING THROUGH THE WEST END WHERE THE EXISTING OUTDOOR AIR LOUVER IS LOCATED, AND FIELD ASSEMBLED IN THE MECHANICAL 207 SPACE.													

PUMP SCHEDULE														
IDENT.	SYSTEM	TYPE	MANUFACTURER	MODEL NO.	GPM	FEET HEAD	MOTOR				STARTER			NOTES
							H.P.	RPM	ELEC.	AMP	TYPE	LOCATION	DISC. TYPE	
SMP-1	SNOW MELT SYSTEM	INLINE	GRUNDFOS	MAGNA3 32-60-98128820	15	6	1/6	2194	115-230/160	1.01	A	MECHANICAL ROOM	SEE ELEC	1
SMP-2	SNOW MELT SYSTEM	INLINE	GRUNDFOS	MAGNA3 40-180F-98128807	20	35	3/4	3487	115-230/160	5.26	A	MECHANICAL ROOM	SEE ELEC	1
NOTES														
1. IF ANY POINT ON PUMP CURVE EXCEEDS THIS H.P. GO TO NEXT LARGER SIZE MOTOR AND INCLUDE IN PUMP. MOTOR MAY BE SMALLER IF IT IS NON-OVERLOADING. QUOTE ALL CHANGES TO STARTERS & ELECTRICAL WORK.										A. VFD WITH BACNET INTERFACE CARD PROVIDED BY DIV. 26.				

VAV TERMINAL SCHEDULE													
EQUIPMENT NO.	INLET SIZE	TERMINAL CAPACITY (CFM)	PRESSURE AT INLET	CFM	FLOOR	FLOOR	FLOOR	FLOOR	FLOOR	FLOOR	FLOOR	FLOOR	FLOOR
VAV-1	6"	550	0.75	460	60	95	17,710	150	127	1.5	1/2"	NAILOR 3001 HEATING	1
VAV-2	7"	800	0.75	600	60	95	17,710	150	127	1.5	1/2"	NAILOR 3001 HEATING	
VAV-3	6"	550	0.75	420	60	95	16,170	150	129	1.5	1/2"	NAILOR 3001 HEATING	
VAV-4	5"	400	0.75	300	60	95	11,550	150	127	1.0	1/2"	NAILOR 3001 HEATING	
VAV-5	6"	550	0.75	400	60	95	11,550	150	127	1.0	1/2"	NAILOR 3001 HEATING	
VAV-6	10"	1840	0.75	1540	60	95	59,290	155	125	4.0	3/4"	NAILOR 3001 HEATING	
NOT USED													
NOT USED													
VAV-9	6"	550	0.75	500	60	95	19,250	155	130	1.5	1/2"	NAILOR 3001 HEATING	
VAV-10	6"	550	0.75	420	60	95	12,512	155	130	1.0	1/2"	NAILOR 3001 HEATING	
VAV-11	4"	225	0.75	200	60	95	7,700	155	129	0.75	1/2"	NAILOR 3001 HEATING	
VAV-12	7"	800	0.75	580	60	95	22,330	155	125	1.5	1/2"	NAILOR 3001 HEATING	
VAV-13	7"	800	0.75	650	60	95	25,025	155	126	1.75	1/2"	NAILOR 3001 HEATING	
NOT USED													
VAV-15	6"	550	0.75	450	60	95	17,325	155	132	1.5	1/2"	NAILOR 3001 HEATING	
VAV-16	5"	400	0.75	300	60	95	11,550	155	127	1.0	1/2"	NAILOR 3001 HEATING	
VAV-17	6"	550	0.75	420	60	95	16,170	155	133	1.5	1/2"	NAILOR 3001 HEATING	
VAV-18	7"	800	0.75	640	60	95	24,640	155	133	1.75	1/2"	NAILOR 3001 HEATING	
VAV-19	6"	550	0.75	500	60	95	19,250	155	130	1.5	1/2"	NAILOR 3001 HEATING	
VAV-20	6"	550	0.75	320	60	95	12,320	155	130	1.0	1/2"	NAILOR 3001 HEATING	
VAV-21	6"	550	0.75	500	60	95	19,250	155	130	1.5	1/2"	NAILOR 3001 HEATING	
VAV-22	6"	550	0.75	540	60	95	20,780	155	127	1.5	1/2"	NAILOR 3001 HEATING	
VAV-23	6"	550	0.75	500	60	95	19,250	155	130	1.5	1/2"	NAILOR 3001 HEATING	
VAV-24	4"	225	0.75	200	60	95	7,700	155	129	0.75	1/2"	NAILOR 3001 HEATING	
VAV-25	5"	400	0.75	360	60	95	13,860	155	127	1.0	1/2"	NAILOR 3001 HEATING	
VAV-26	7"	800	0.75	750	60	95	28,875	155	126	2.0	1/2"	NAILOR 3001 HEATING	
VAV-27	5"	400	0.75	320	60	95	12,320	155	130	1.0	1/2"	NAILOR 3001 HEATING	
VAV-28	5"	400	0.75	360	60	95	13,860	155	127	1.0	1/2"	NAILOR 3001 HEATING	
VAV-29	5"	400	0.75	300	60	95	11,550	155	127	1.0	1/2"	NAILOR 3001 HEATING	
VAV-30	4"	225	0.75	150	60	95	5,775	155	132	0.5	1/2"	NAILOR 3001 HEATING	
NOTES 1. REFER TO CONTROL DRAWINGS FOR CONTROL TYPES.													

GRILLE/REGISTER/DIFFUSER SCHEDULE													
EQUIPMENT NO.		TYPE		REGISTER/DIFFUSER		EQUIPMENT NUMBER		EQUIPMENT CODE		TECHNICAL CODE			
MODEL	MECH. NO.	TYPE		REGISTER/DIFFUSER		REGISTER/DIFFUSER		REGISTER/DIFFUSER		REGISTER/DIFFUSER	REGISTER/DIFFUSER	REGISTER/DIFFUSER	
SG-1	VARIES	FLOOR REG		NAILOR 48-2424									
SD-1	VARIES	SQUARE CEILING DIFFUSER 24"x24" LAY-IN		NAILOR RNSA1-24x24L									
SD-2	VARIES	SQUARE CEILING DIFFUSER 12"x12" SURFACE		NAILOR RNSA1-12x12-S									
SD-3	VARIES	SQUARE CEILING DIFFUSER 24"x24" SURFACE		NAILOR RNSA1-24x24-S									
RG-1	VARIES	LOUVERED CEILING RETURN 24"x24" LAY-IN		NAILOR 154SH-O-L-24x24									
RG-2	VARIES	LOUVERED CEILING RETURN SURFACE		NAILOR 154SH-O-x-S									
EG-1	VARIES	LOUVERED CEILING EXHAUST SURFACE		NAILOR 154SH-O-x-S									
NOTES													


one eighth inch = one foot
one quarter inch = one foot
three eighths inch = one foot
one half inch = one foot
three quarters inch = one foot
one inch = one foot
one and one half inches = one foot
two inches = one foot
three inches = one foot
four inches = one foot
five inches = one foot
six inches = one foot
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nine inches = one foot
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eleven inches = one foot
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ninety three inches = one foot
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ninety seven inches = one foot
ninety eight inches = one foot
ninety nine inches = one foot
one hundred inches = one foot

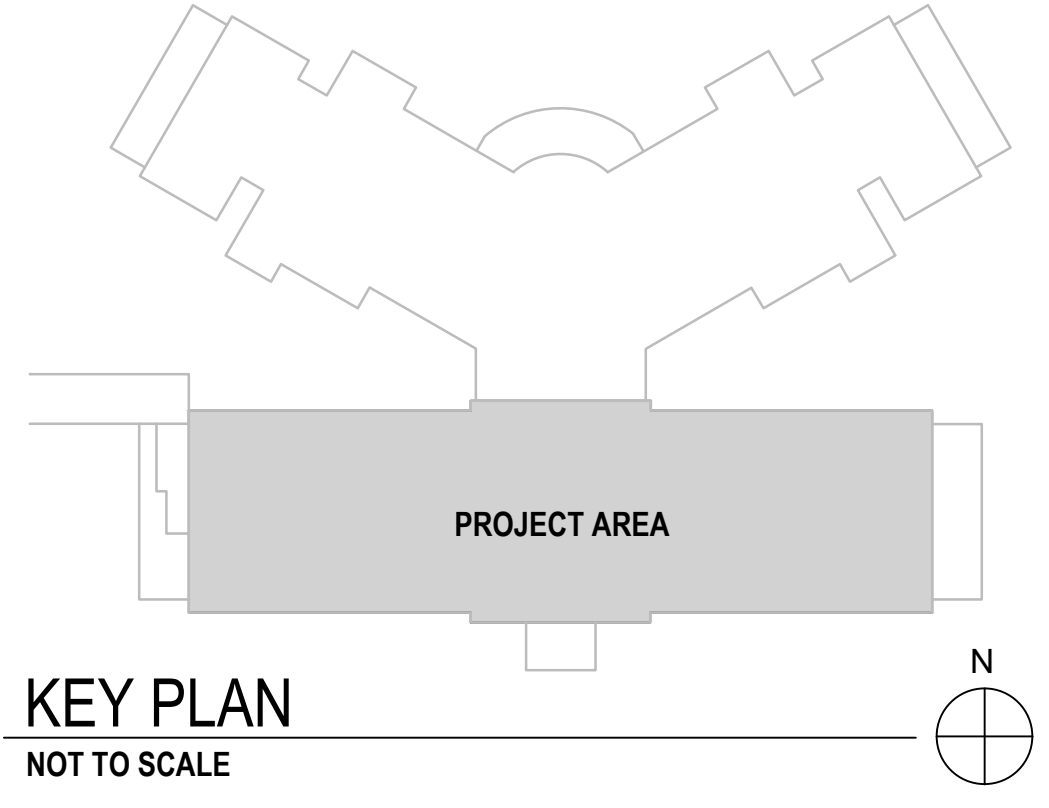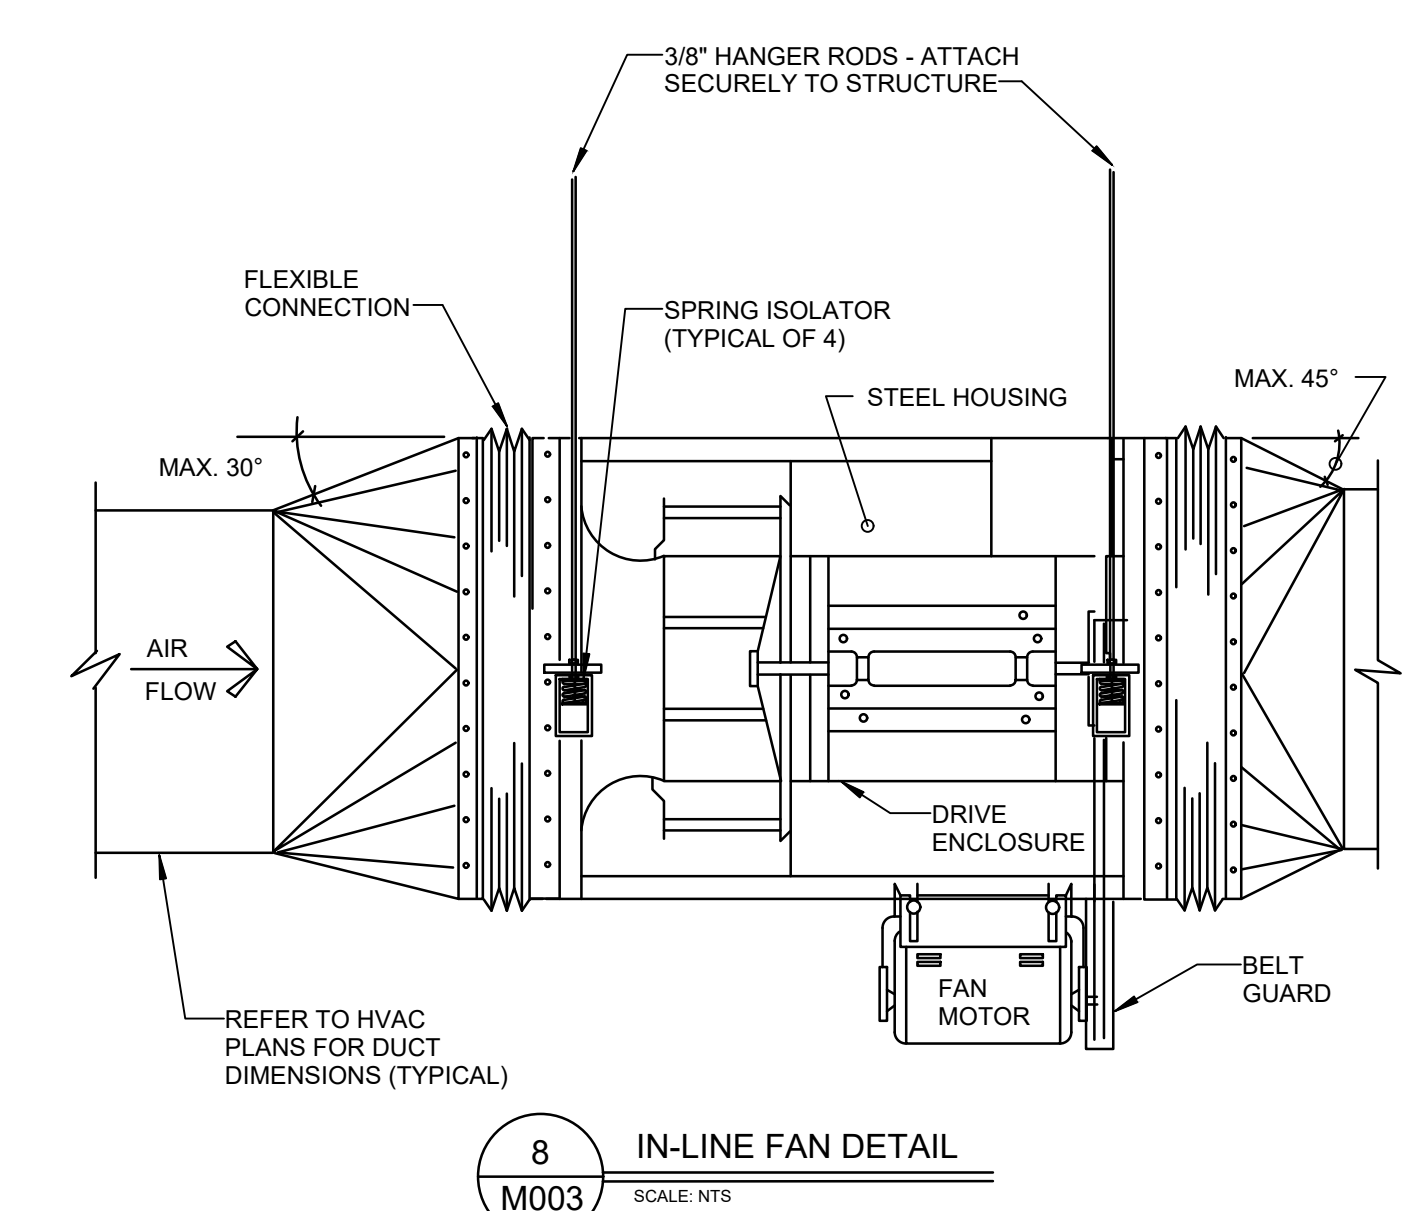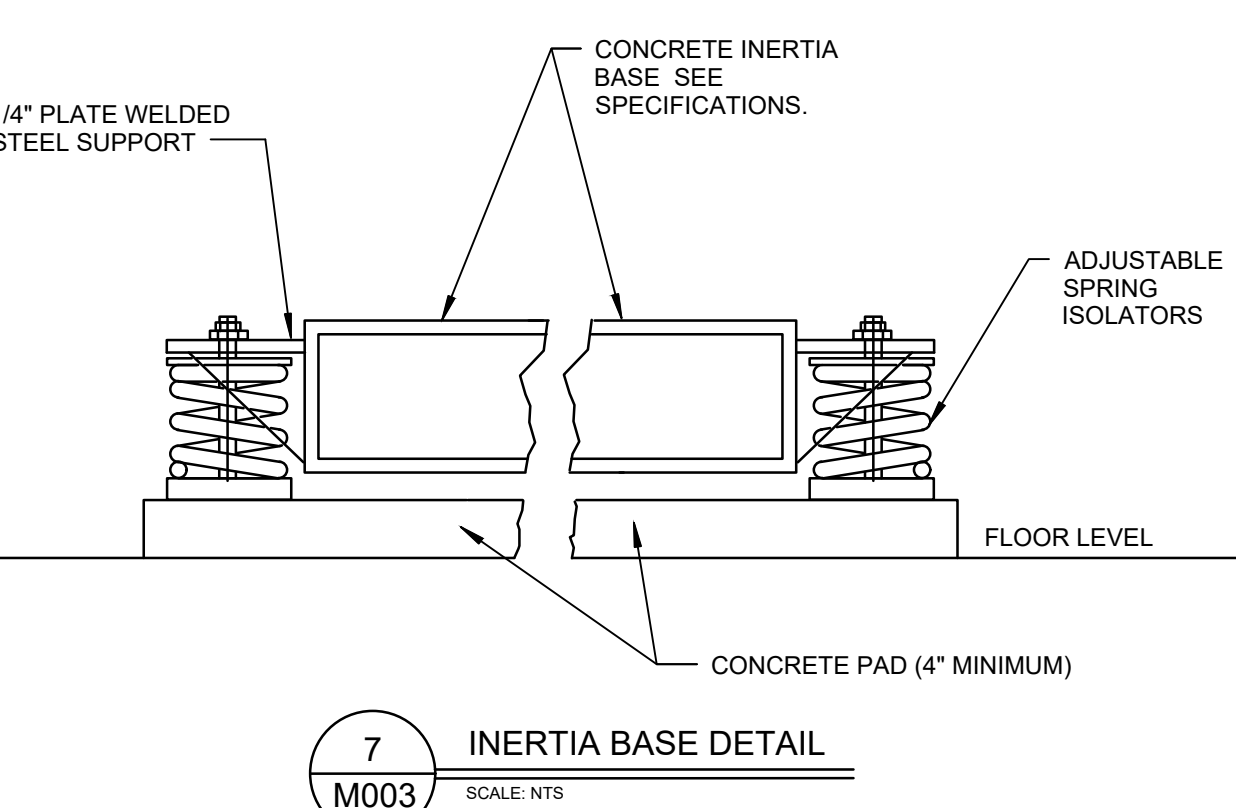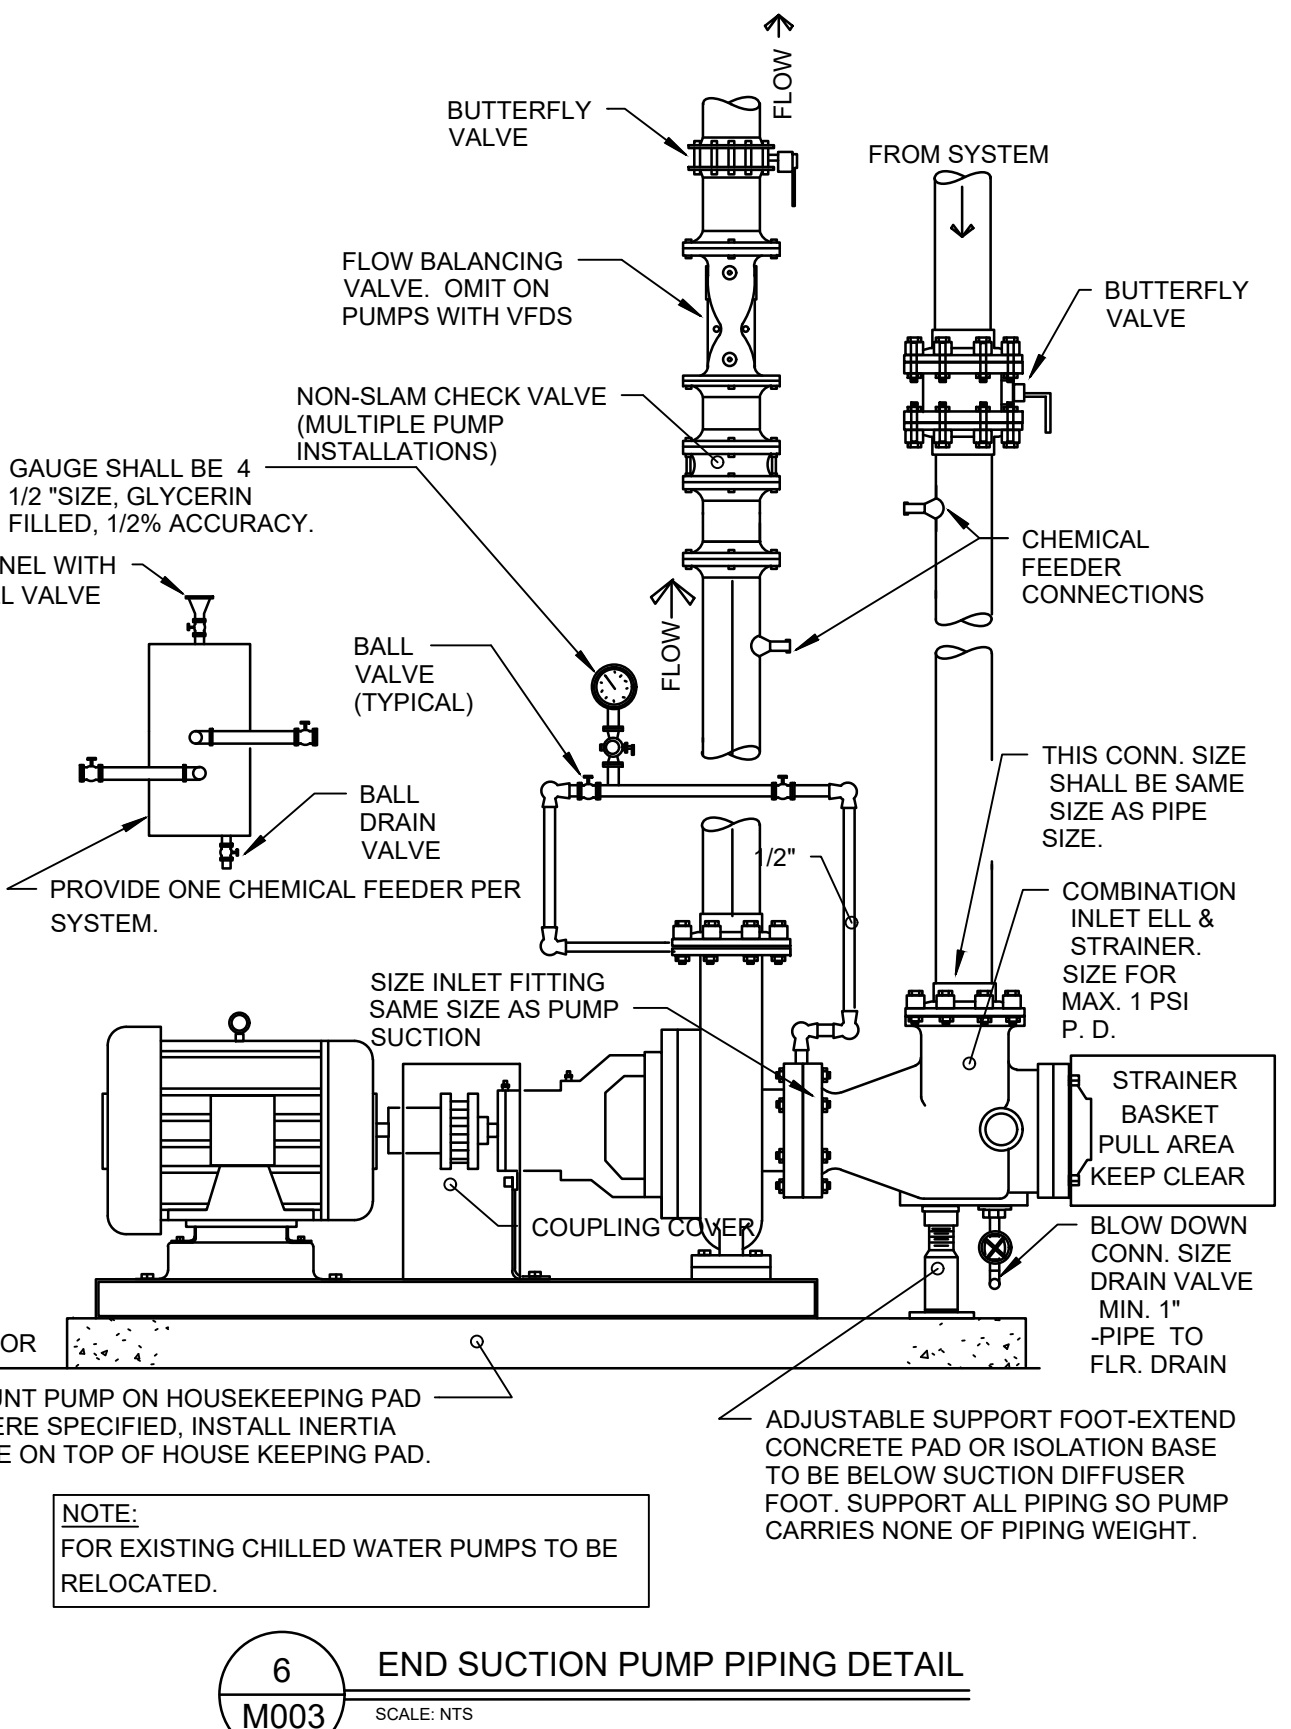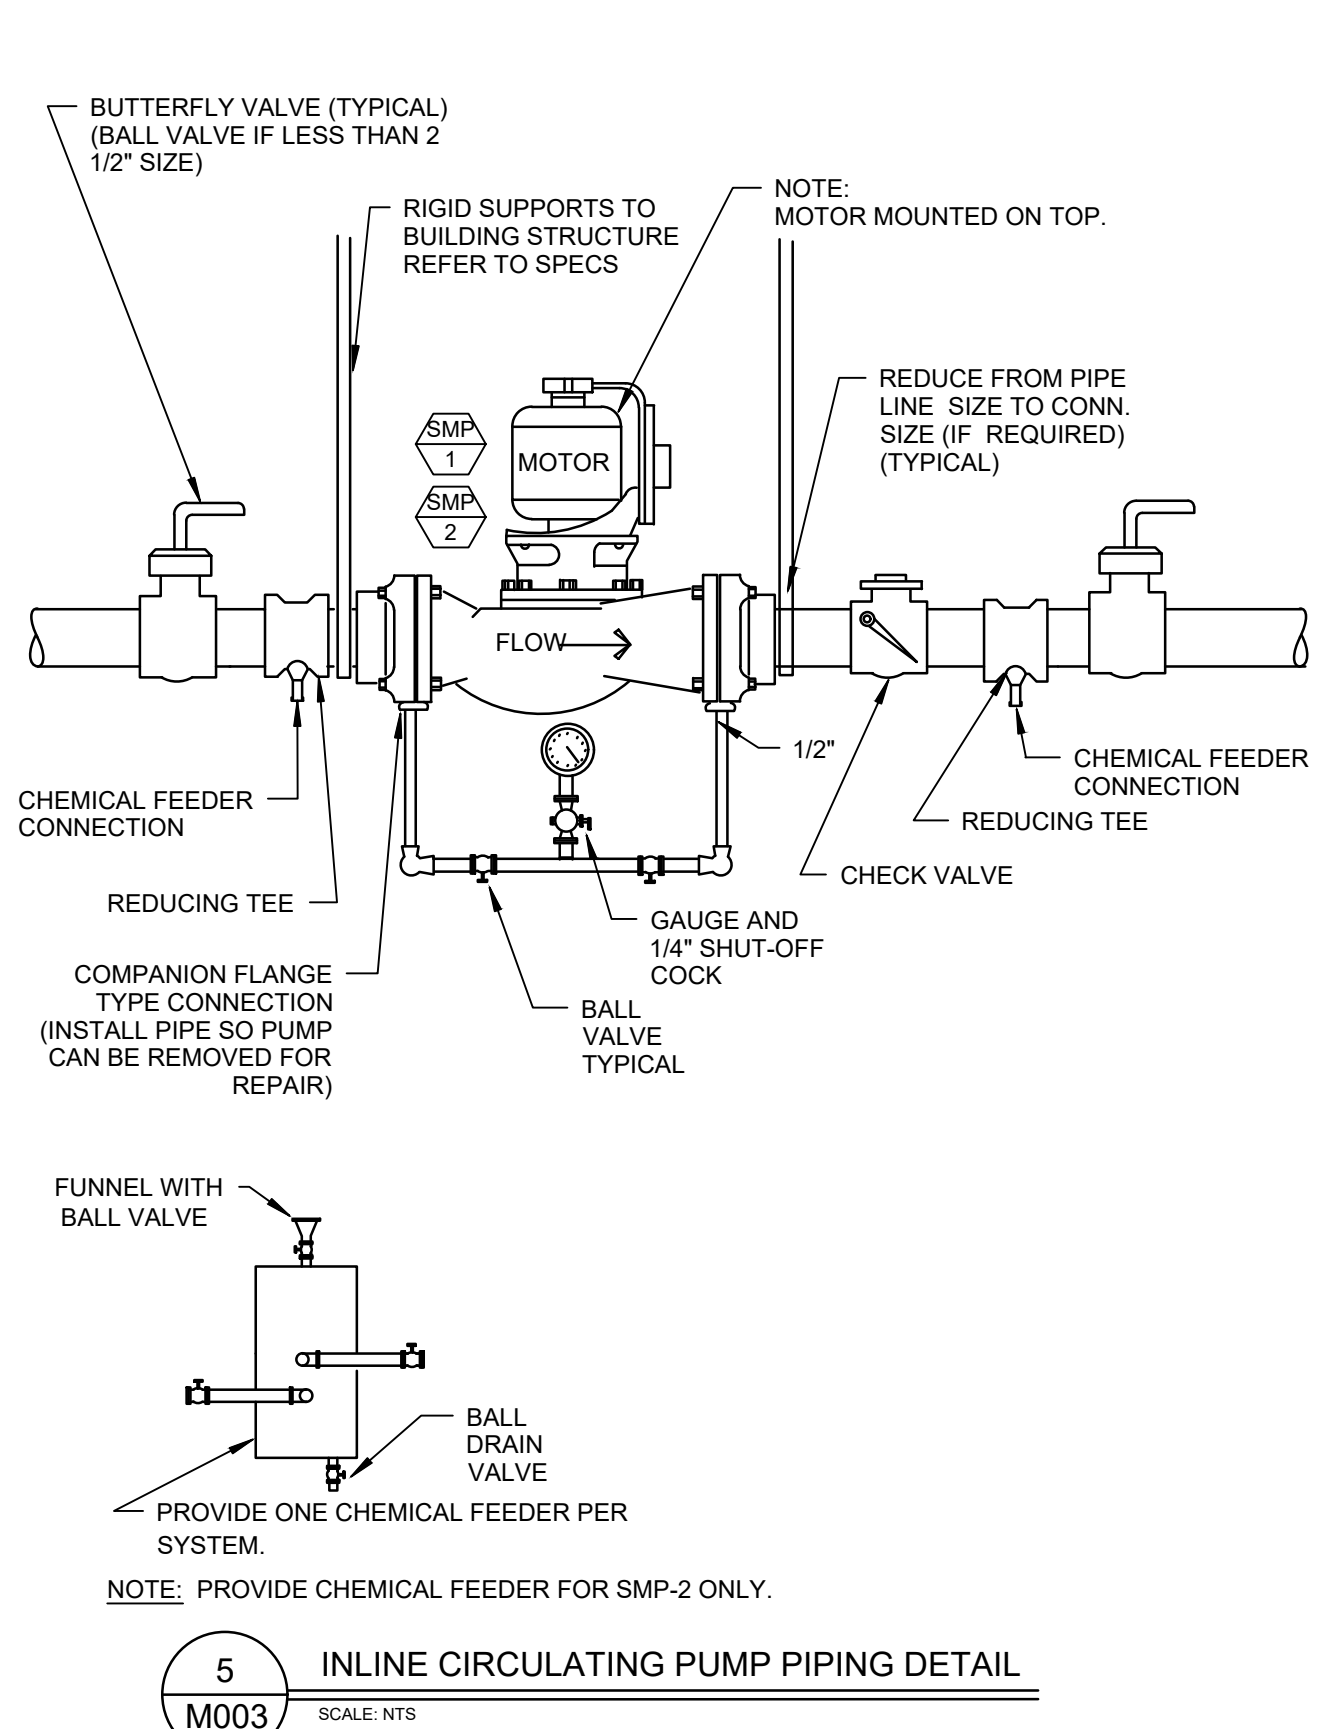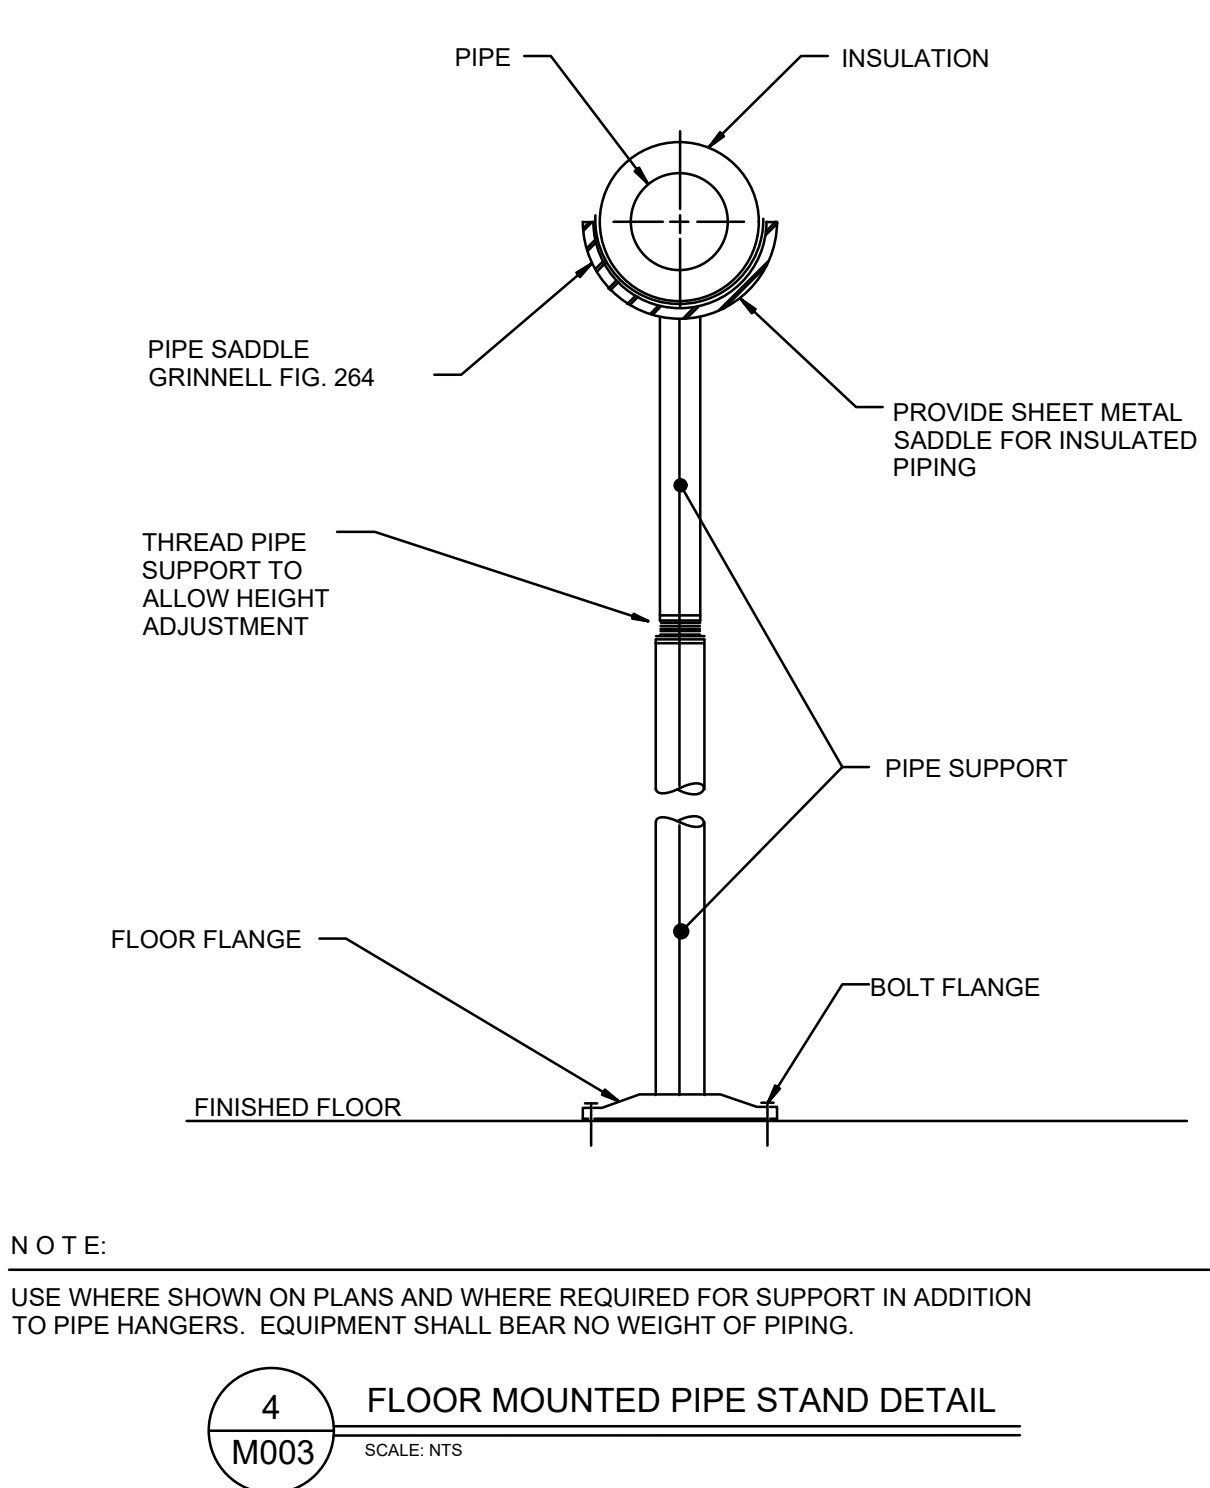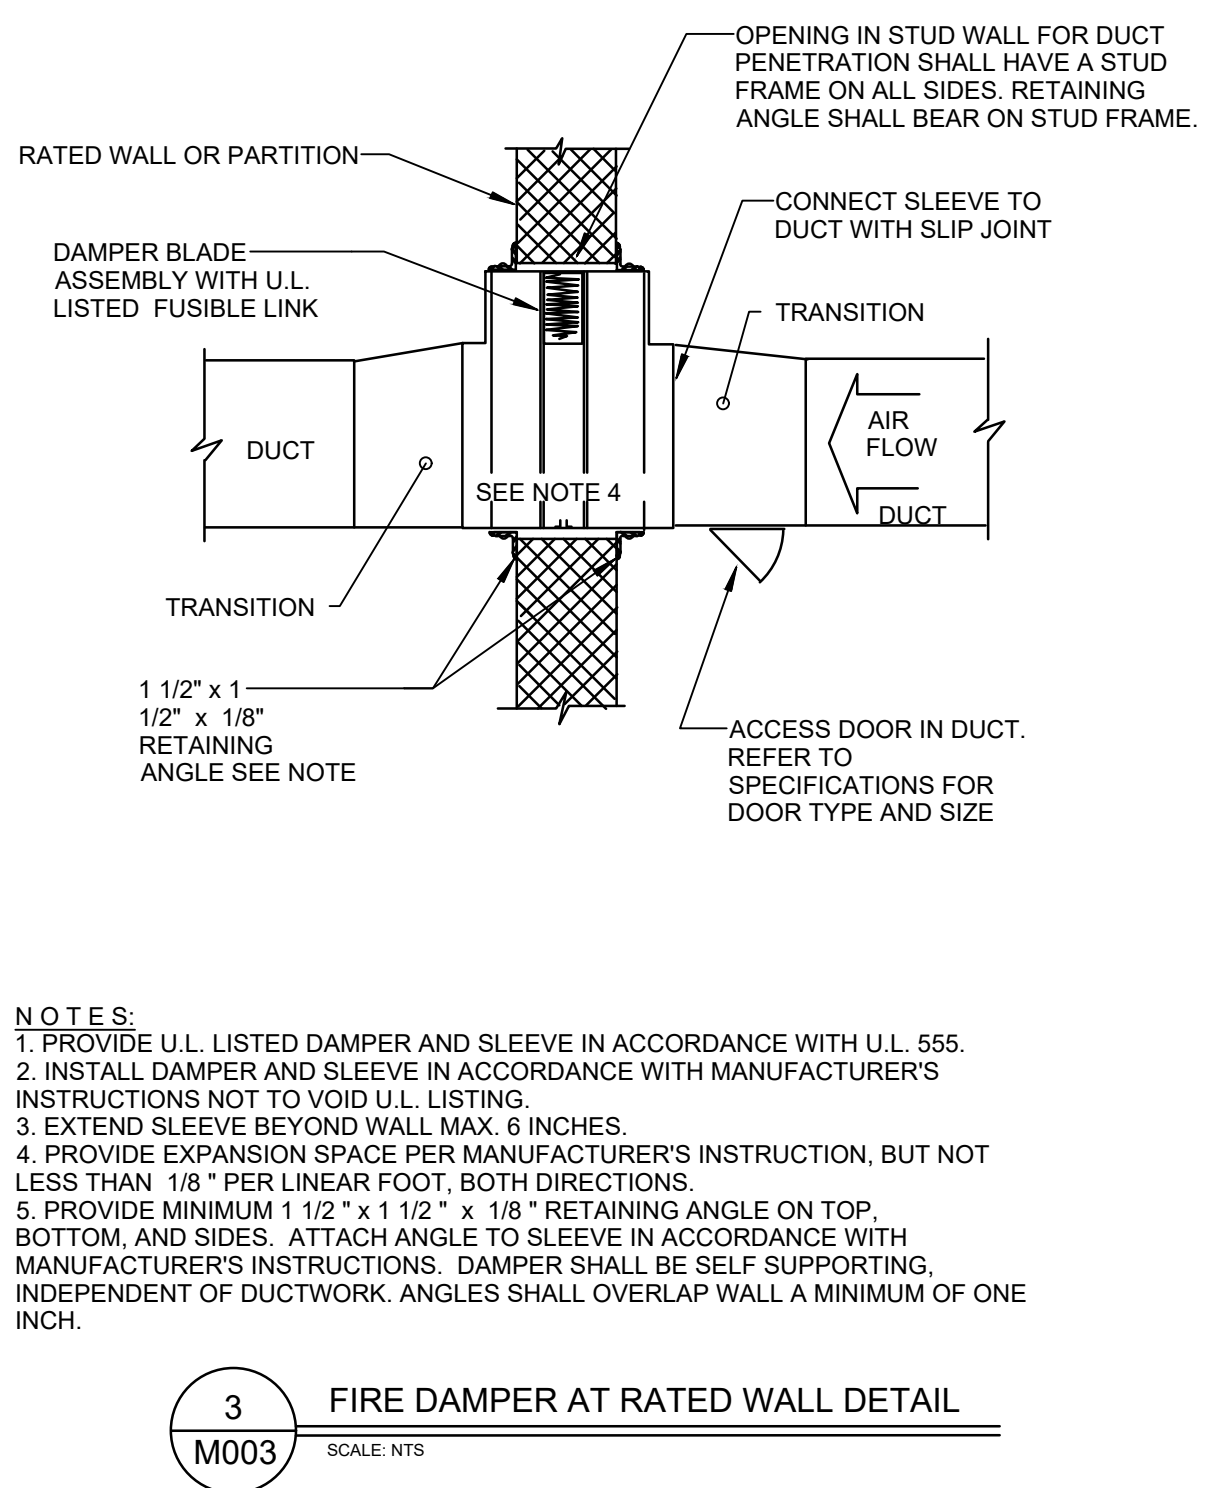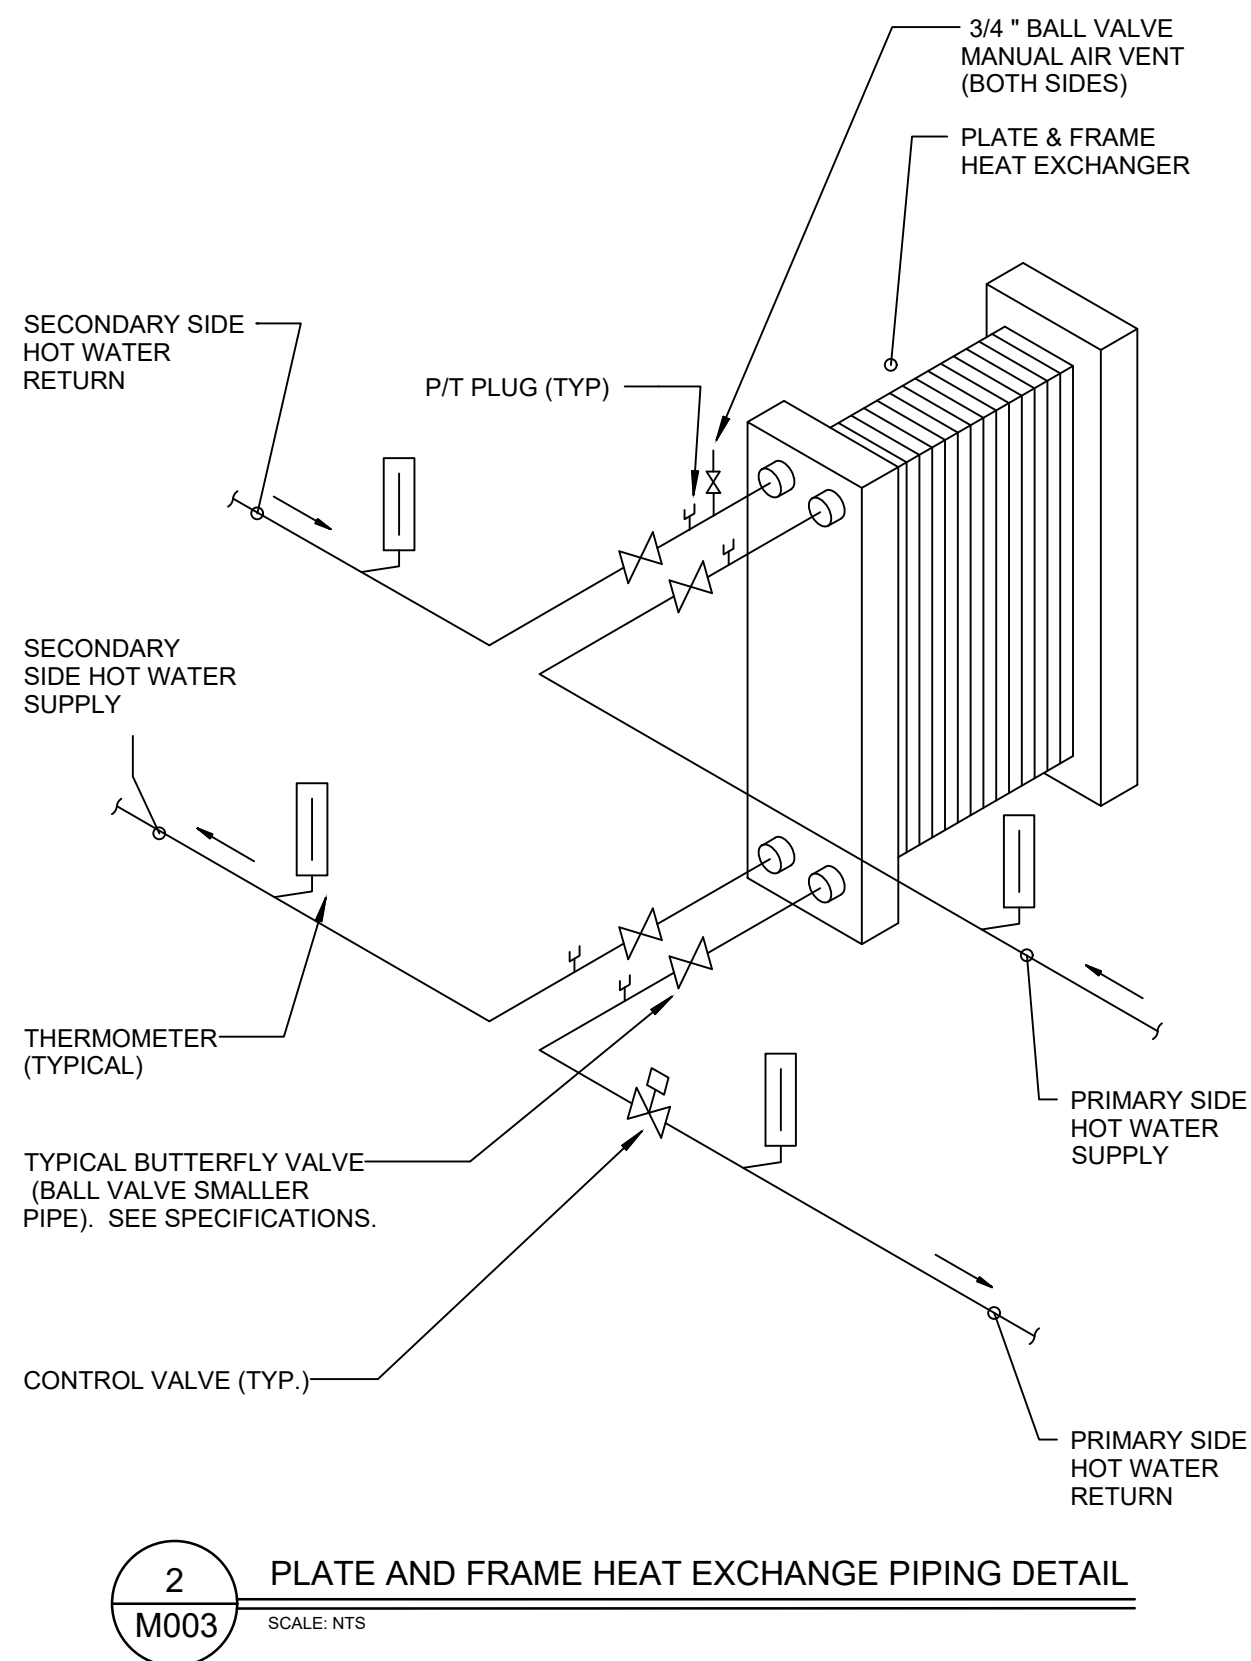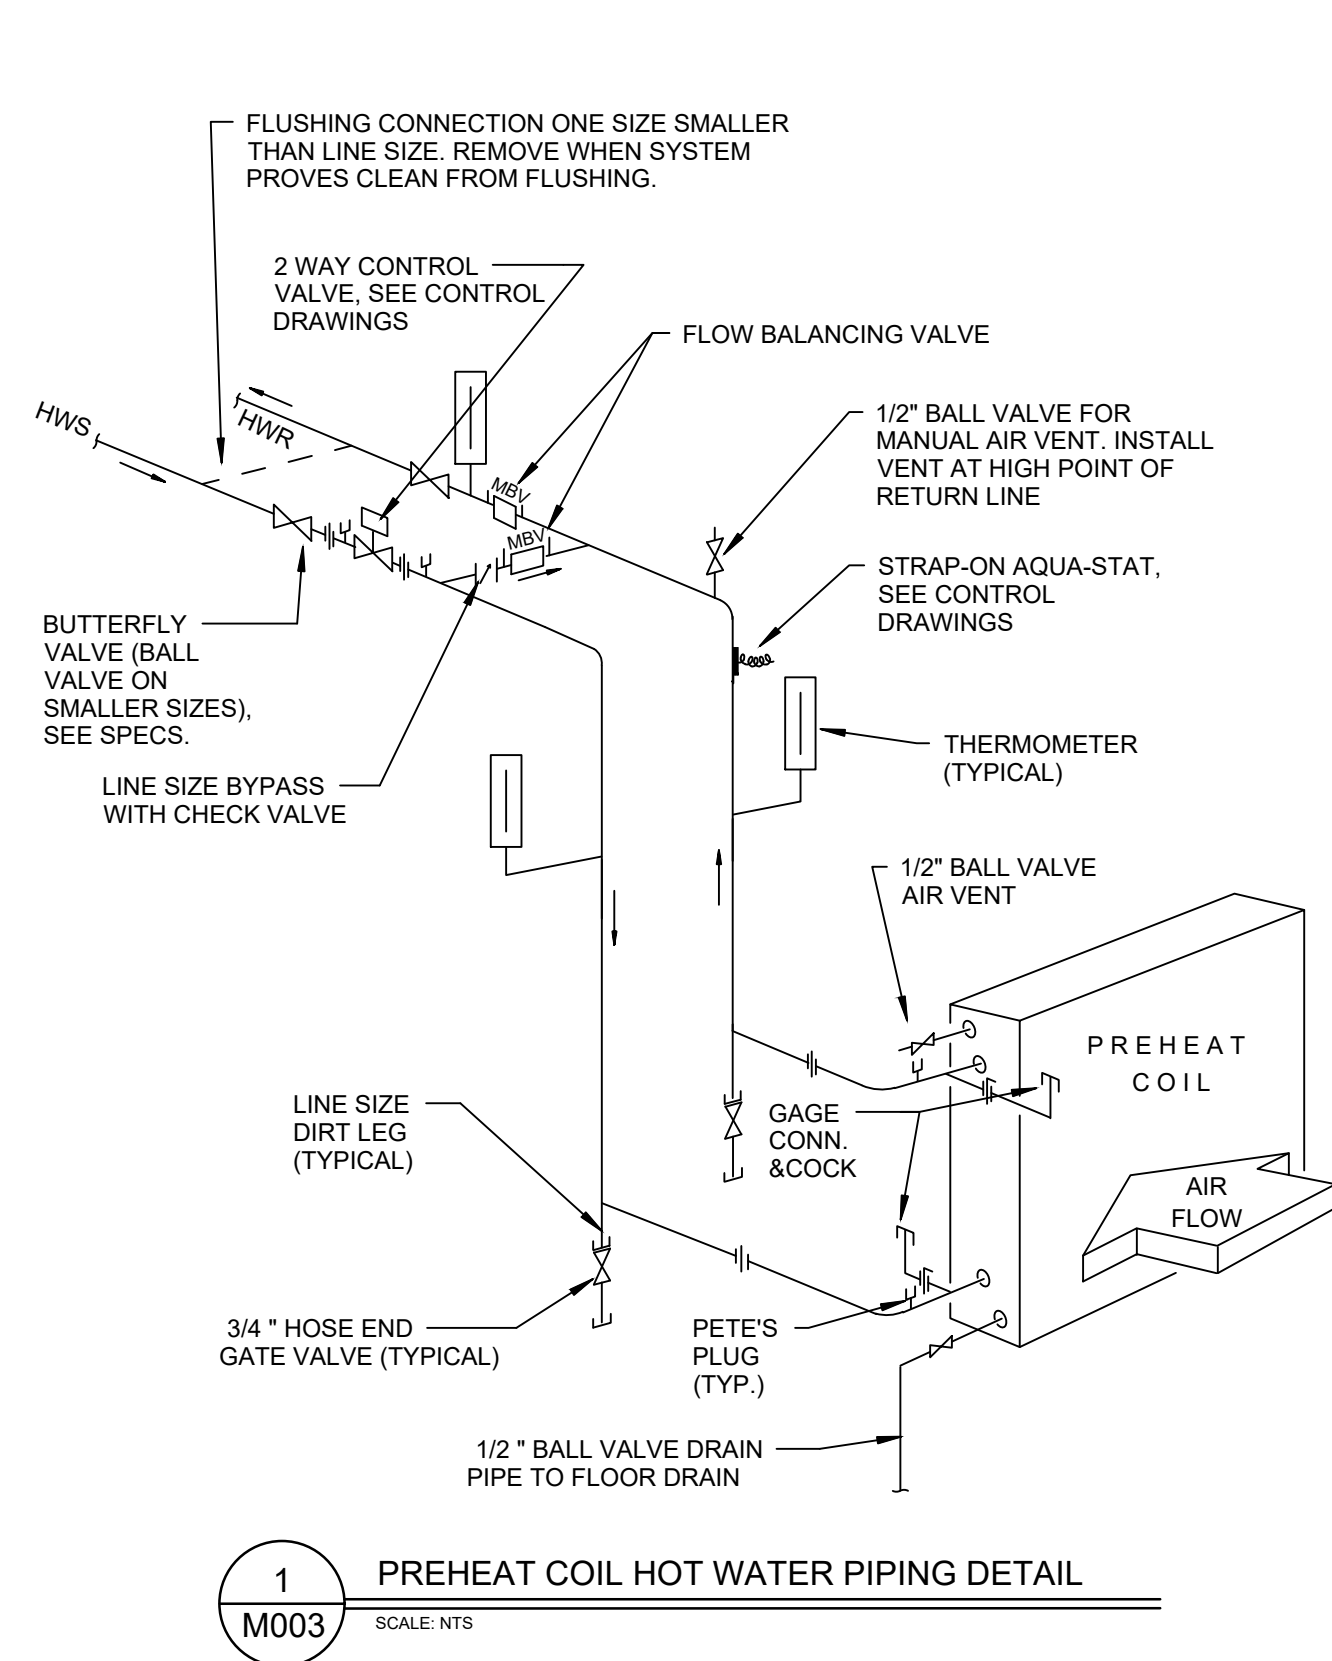


CONSTRUCTION DOCUMENTS

Revisions:		Date:		CONSULTANTS:		ARCHITECT		Drawing Title	Project Title	Project Number	Office of Construction and Facilities Management
				TERRASITE DESIGN 1635 DEADWOOD AVENUE RAPID CITY, SOUTH DAKOTA 57702 PH: (605) 791-1736		MORRISON-MAIERLE 2200 FOOTHILLS BLVD, SUITE A GILLETTE, WYOMING 82716 PH: (307) 685-3780		MECHANICAL DETAILS	BUILDING 64 FOLLOW-ON RENOVATION - SHERIDAN VA MEDICAL CENTER	666-18-103	
				DAWES ENGINEERING & DESIGN CO. 46 HIBBARD WAY HELENA, MONTANA 59601 PH: (406) 441-4000		SUMMIT COMPANIES 575 MINNEHAHA AVENUE WEST ST. PAUL, MINNESOTA 55103 PH: (651) 251-1880		Approved: Project Director	Location	Building Number	Department of Veterans Affairs
								Owner	SHERIDAN, WYOMING	64	
									Date	Checked	Drawn
									AUGUST 28, 2020	RD	PM - WW
								15.2226.17		M 003	Dwg. 69 of 115



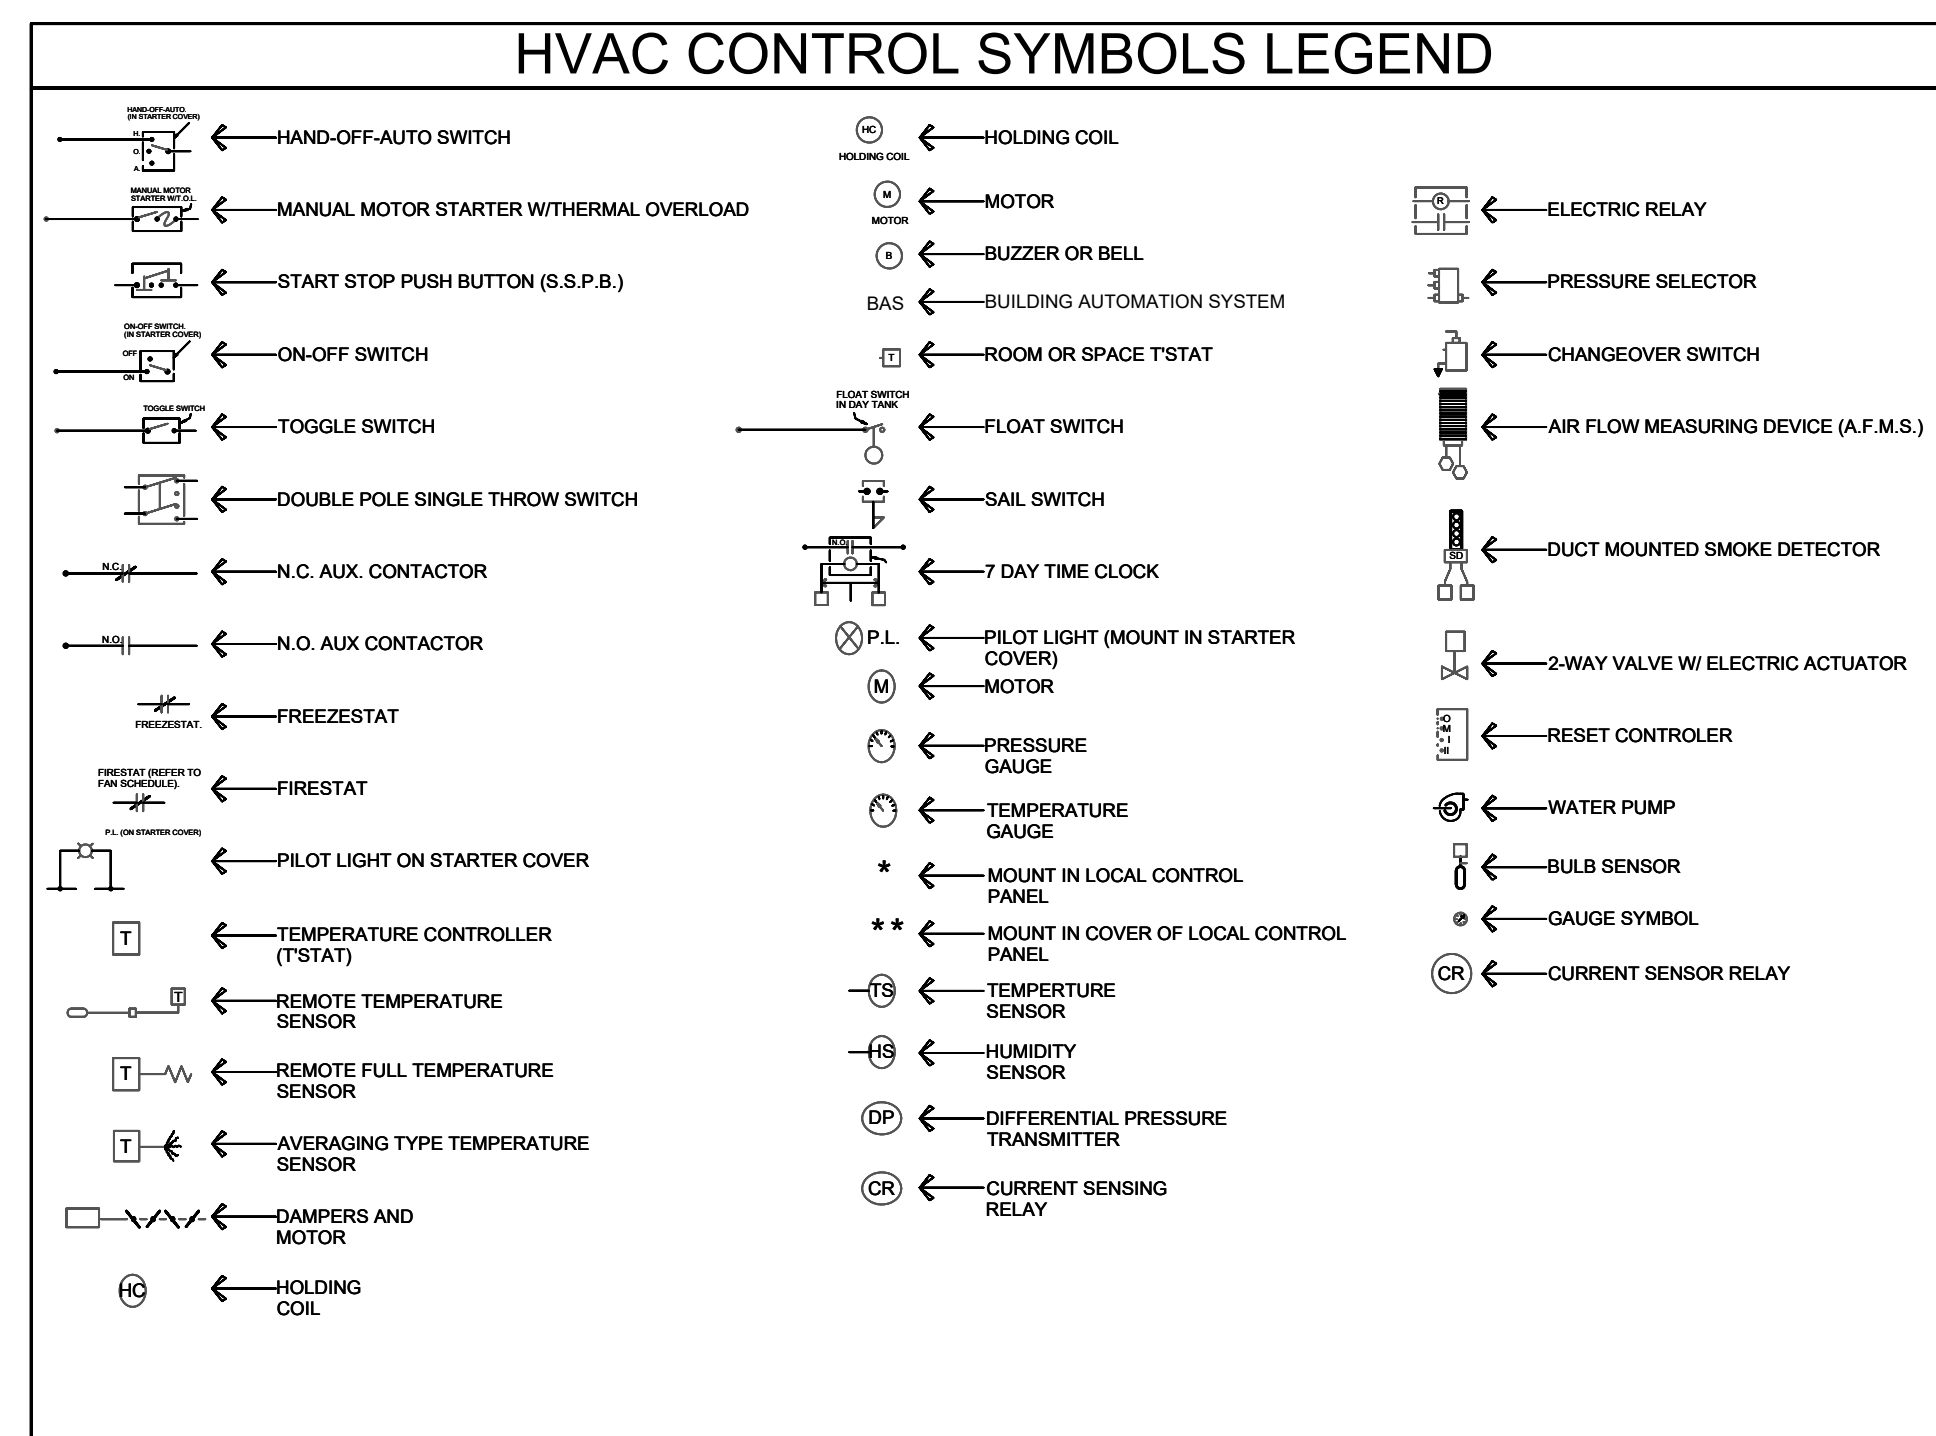


CONTROL ABBREVIATIONS	
SYMBOL	DEFINITION
T.O.L.	THERMAL OVERLOAD
O.L.	OVERLOAD
C.C.T.	CONTROL CIRCUIT TRANSFORMER
M.M.S.	MANUAL MOTOR STARTER
O.W.S.	OPERATOR WORKSTATION
B.A.S.	BUILDING AUTOMATION SYSTEM
H.O.A.	HAND OFF AUTOMATIC
A.F.M.S.	WIRE THRU AUX. CONTACT ON FAN MOTOR STARTER
A.P.M.S.	WIRE THRU AUX. CONTACT ON PUMP MOTOR STARTER
N.O.	NORMALLY OPEN
N.C.	NORMALLY CLOSED
AO	ANALOG OUTPUT
AI	ANALOG INPUT
DO	DIGITAL OUTPUT
DI	DIGITAL INPUT

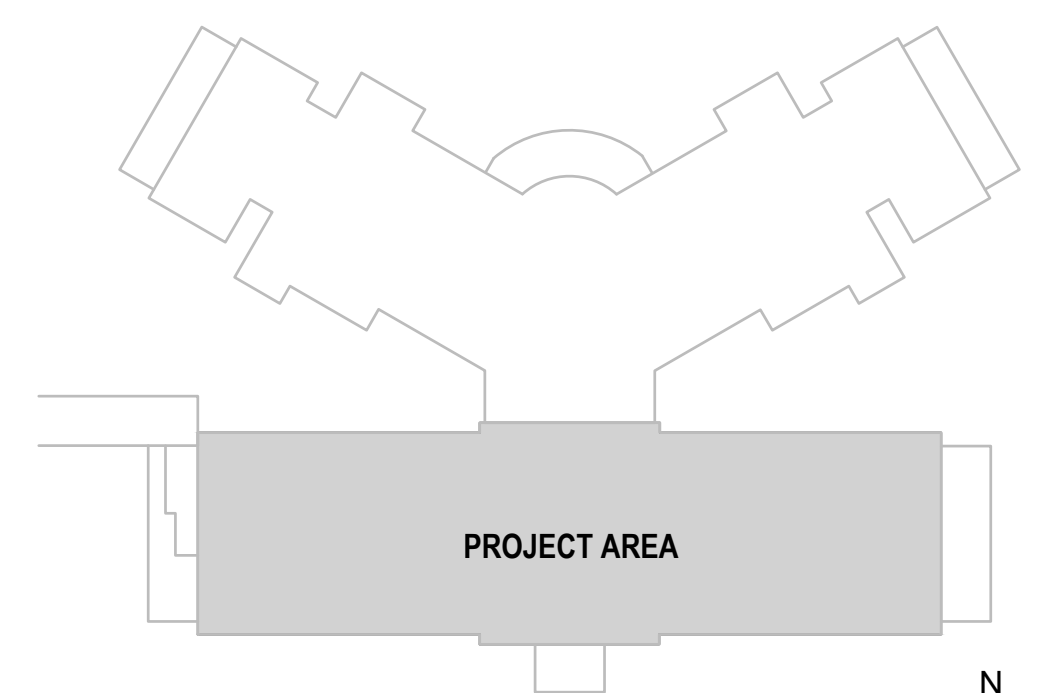

KEY PLAN
NOT TO SCALE


CONSTRUCTION DOCUMENTS

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

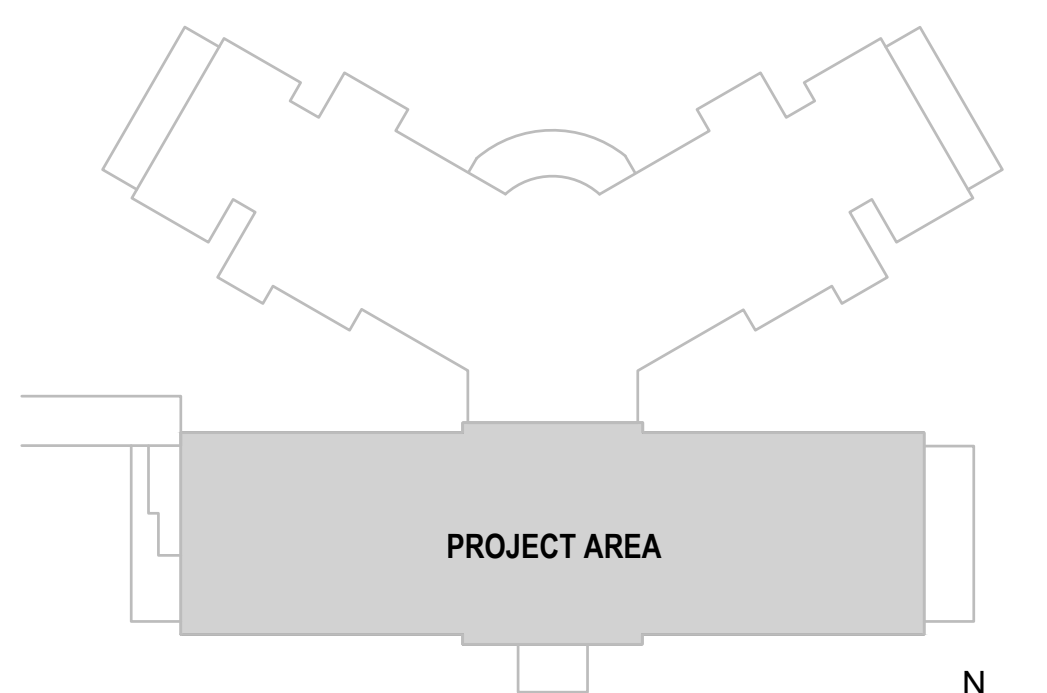KEY PLAN
NOT TO SCALE

CONSTRUCTION DOCUMENTS

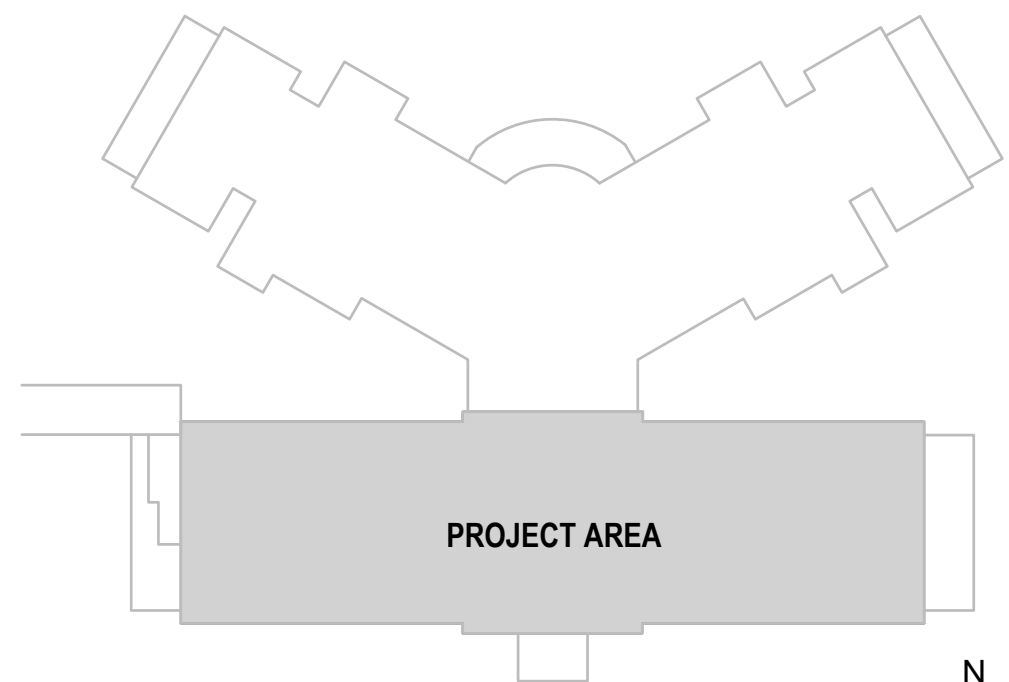


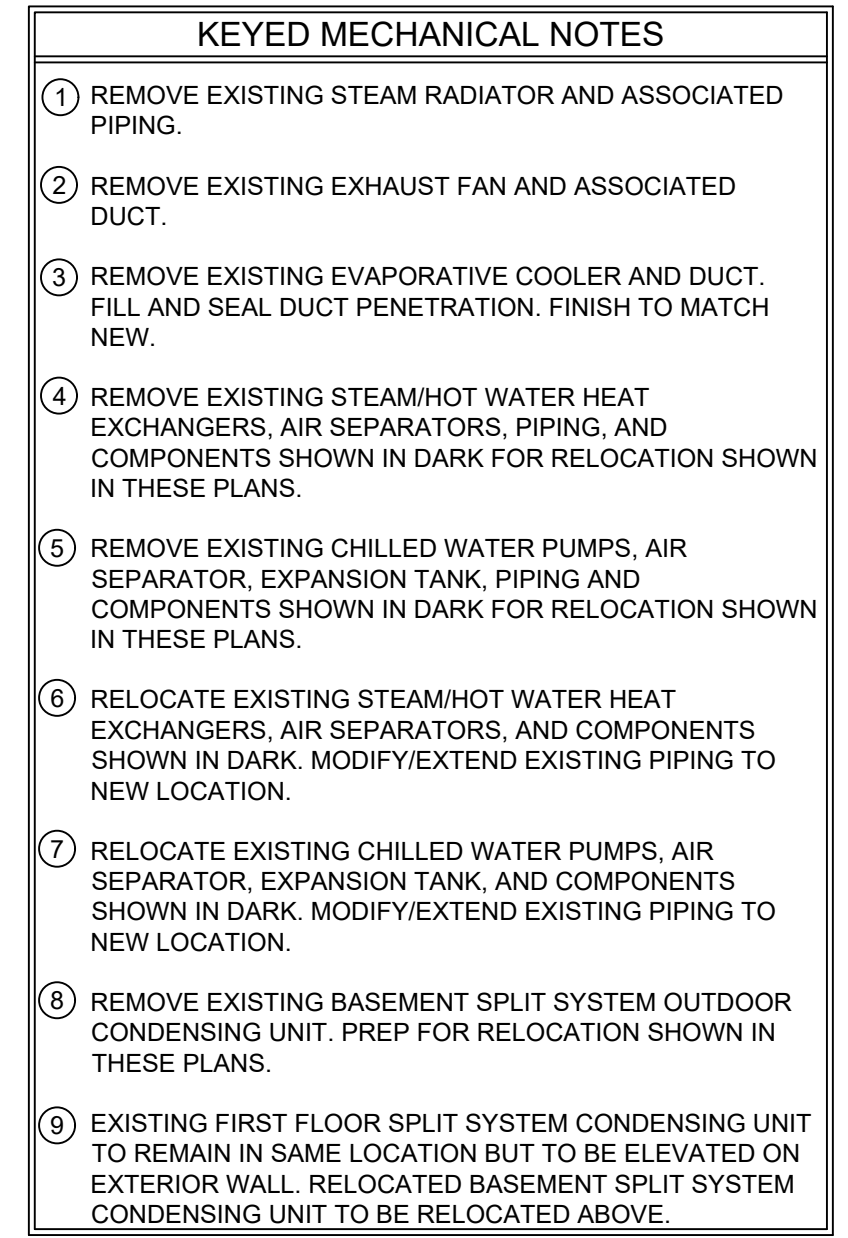
KEY PLAN
NOT TO SCALE

CONSTRUCTION DOCUMENTS

		CONSULTANTS:			ARCHITECT			FOURFRONT DESIGN, INC. 15.2226.17
		TERRASITE DESIGN 1635 DEADWOOD AVENUE RAPID CITY, SOUTH DAKOTA 57702 PH: (605) 791-1736	MORRISON-MAIERLE 3200 WEST MAIN STREET, SUITE A GILLETTE, WYOMING 82716 PH: (307) 685-3780		ALBERTSON ENGINEERING, INC. 3202 WEST MAIN STREET, SUITE C RAPID CITY, SOUTH DAKOTA 57702 PH: (605) 343-9606			
		DAWES ENGINEERING & DESIGN CO. 46 HIBBARD WAY HELENA, MONTANA 59601 PH: (406) 441-4000	SUMMIT COMPANIES 575 MINNEHAHA AVENUE WEST ST. PAUL, MINNESOTA 55103 PH: (651) 251-1880					
Revisions:		Date						


Drawing Title	Project Title			Project Number	Office of Construction and Facilities Management
	MECHANICAL CONTROLS DIAGRAM			666-18-103	
Approved: Project Director	Location			Building Number	Drawing Number
	OWNER			64	
Date	SHERIDAN, WYOMING			M 007	Dwg. 73 of 115
	AUGUST 28, 2020				
Checked	Drawn				
RD	PM - WW				

	Department of Veterans Affairs
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[illegible]

A key plan diagram showing the project area highlighted in grey. The project area is a large, irregularly shaped building footprint. Surrounding it are other building footprints and a road network. A north arrow is located in the bottom right corner, pointing upwards. The text "KEY PLAN" is written in large, bold, black letters on the left side, and "NOT TO SCALE" is written in smaller, bold, black letters below it.

[illegible]

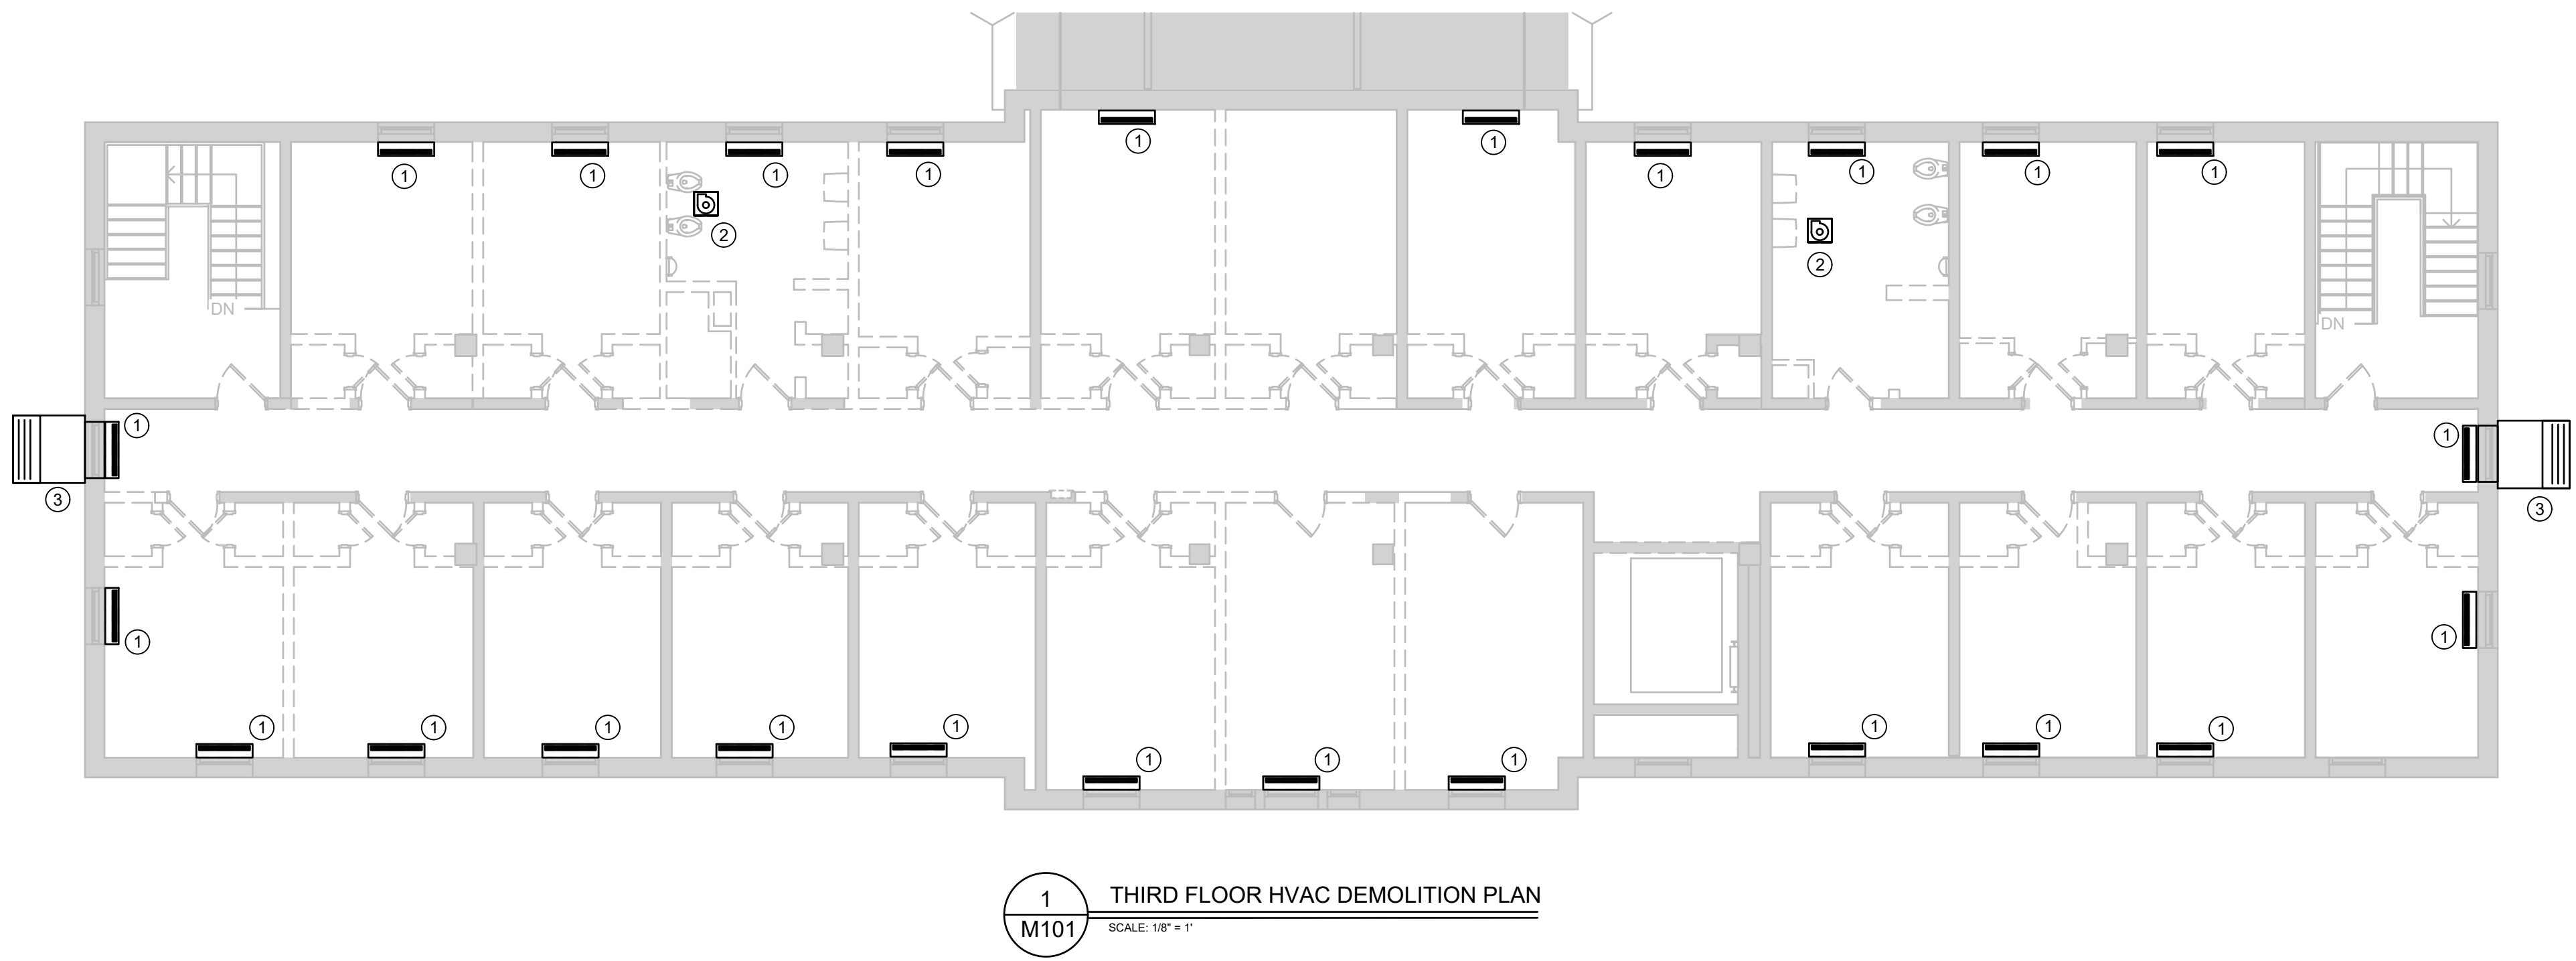


- KEYED MECHANICAL NOTES
- 1

REMOVE EXISTING STEAM RADIATOR AND ASSOCIATED PIPING.
- 2

REMOVE EXISTING EXHAUST FAN AND ASSOCIATED DUCT.
- 3



REMOVE EXISTING EVAPORATIVE COOLER AND DUCT. FILL AND SEAL DUCT PENETRATION. FINISH TO MATCH NEW.

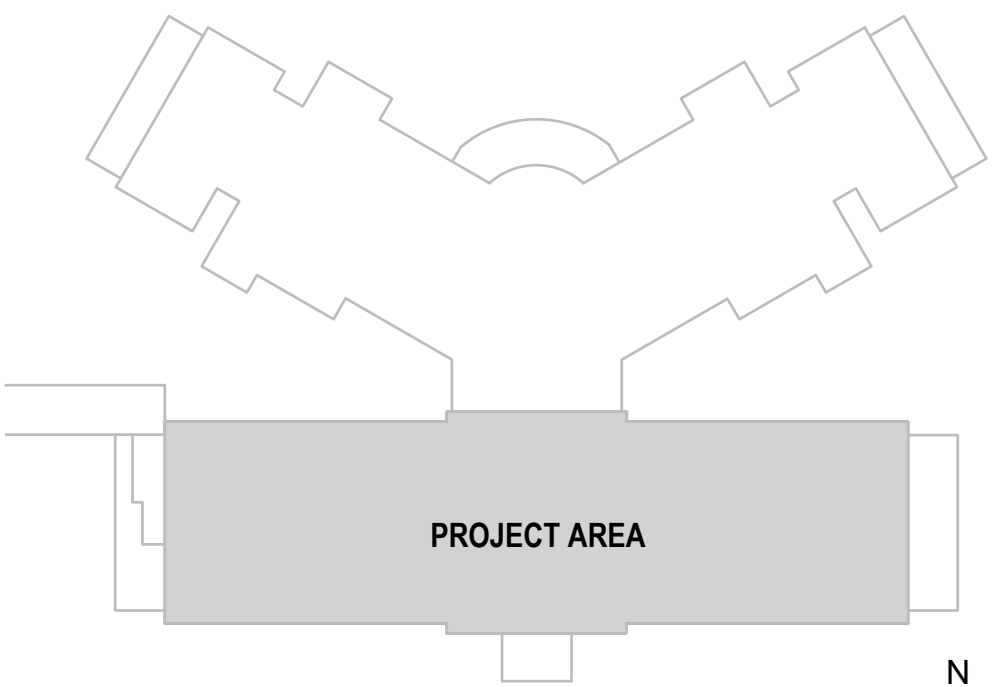

KEY PLAN

NOT TO SCALE

CONSTRUCTION DOCUMENTS

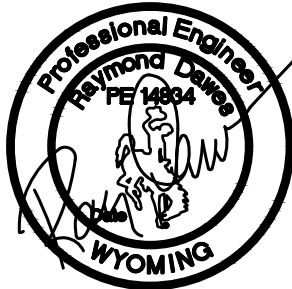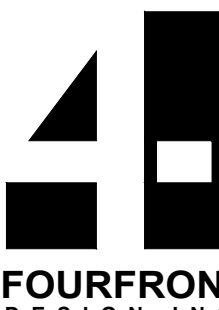		CONSULTANTS:			<div>ARCHITECT</div> <div>FOURFRONT DESIGN INC.</div>	Drawing Title THIRD FLOOR HVAC DEMOLITION PLAN	Project Title BUILDING 64 FOLLOW-ON RENOVATION - SHERIDAN VA MEDICAL CENTER	Project Number 666-18-103	Office of Construction and Facilities Management
		TERRASITE DESIGN 1635 DEADWOOD AVENUE RAPID CITY, SOUTH DAKOTA 57702 PH: (605) 791-1736	MORRISON-MAIERLE 2200 FOOTHILLS BLVD, SUITE A GILLETTE, WYOMING 82716 PH: (307) 685-3780					ALBERTSON ENGINEERING, INC. 3202 WEST MAIN STREET, SUITE C RAPID CITY, SOUTH DAKOTA 57702 PH: (605) 343-9606	
Revisions:		Date	DAWES ENGINEERING & DESIGN CO. 46 HIBBARD WAY HELENA, MONTANA 59601 PH: (406) 441-4000			SUMMIT COMPANIES 575 MINNEHAHA AVENUE WEST ST. PAUL, MINNESOTA 55103 PH: (651) 251-1880	15.2226.17	Approved: Project Director Owner	Location SHERIDAN, WYOMING
						Date AUGUST 28, 2020	Checked RD	Drawn PM - WW	Dwg. 75 of 115

A

B

C


D

E

F

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one and one half inches = one foot
three quarters inch = one foot
one half inch = one foot
three eighths inch = one foot
one quarter inch = one foot
one eighth inch = one foot

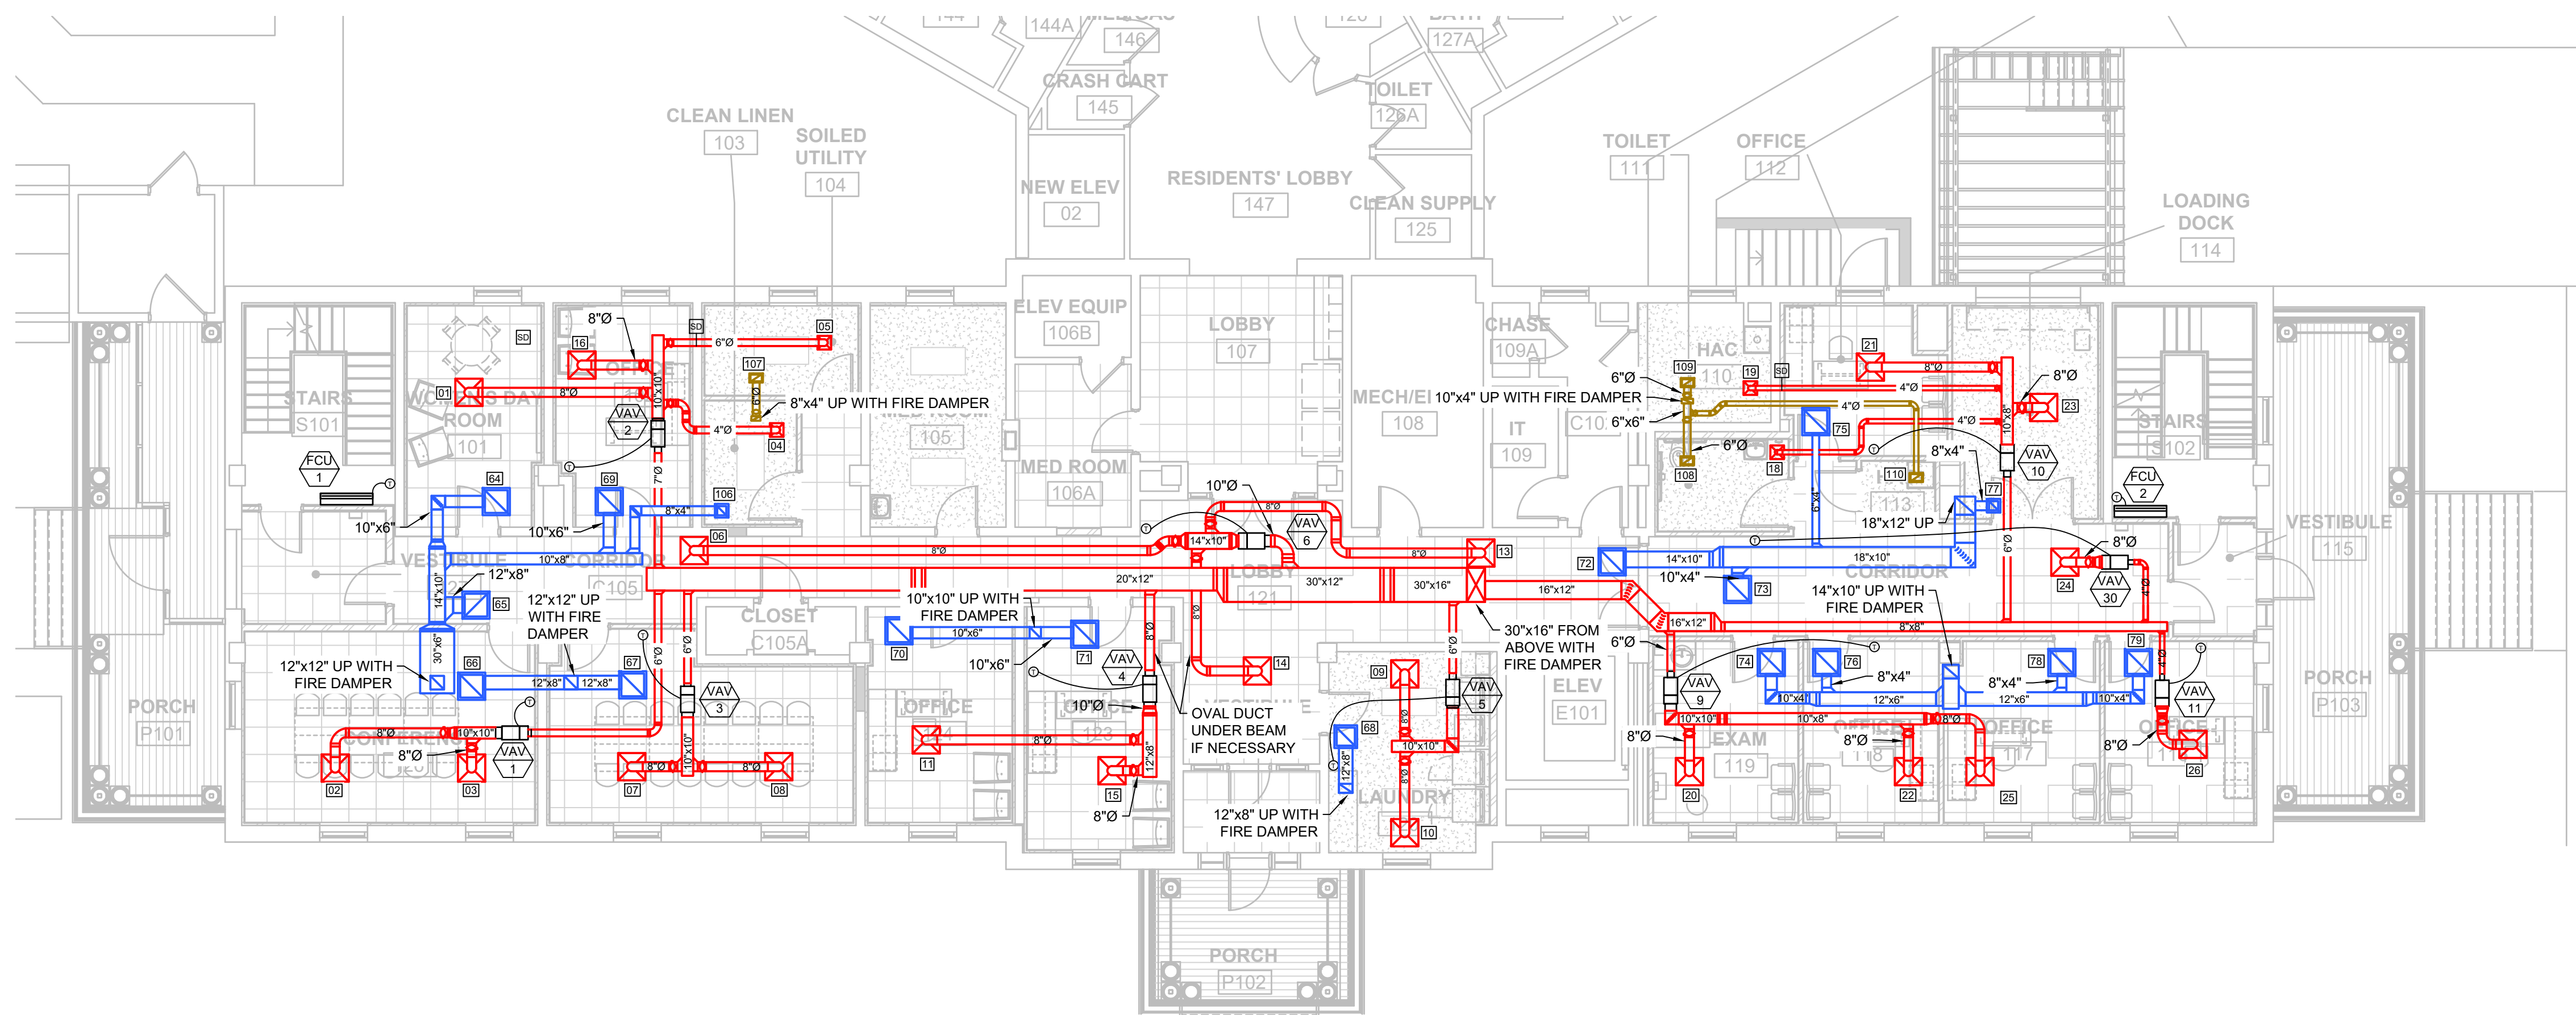


1 FIRST FLOOR HVAC DUCTING PLAN
M200 SCALE 1/8" = 1'-0"

GENERAL HVAC NOTE

AHU-2 IS INTENDED TO MODULAR SO IT CAN BE KNOCKED DOWN AND BROUGHT INTO THE BUILDING THROUGH THE WEST END WHERE THE EXISTING SOUTH OUTDOOR AIR LOUVER IS LOCATED, AND FIELD ASSEMBLED IN THE MECHANICAL 207 SPACE.

DUCT KEY


- DUCT SUPPLY
- DUCT RETURN
- DUCT OUTSIDE AIR
- DUCT EXHAUST/RELIEF AIR

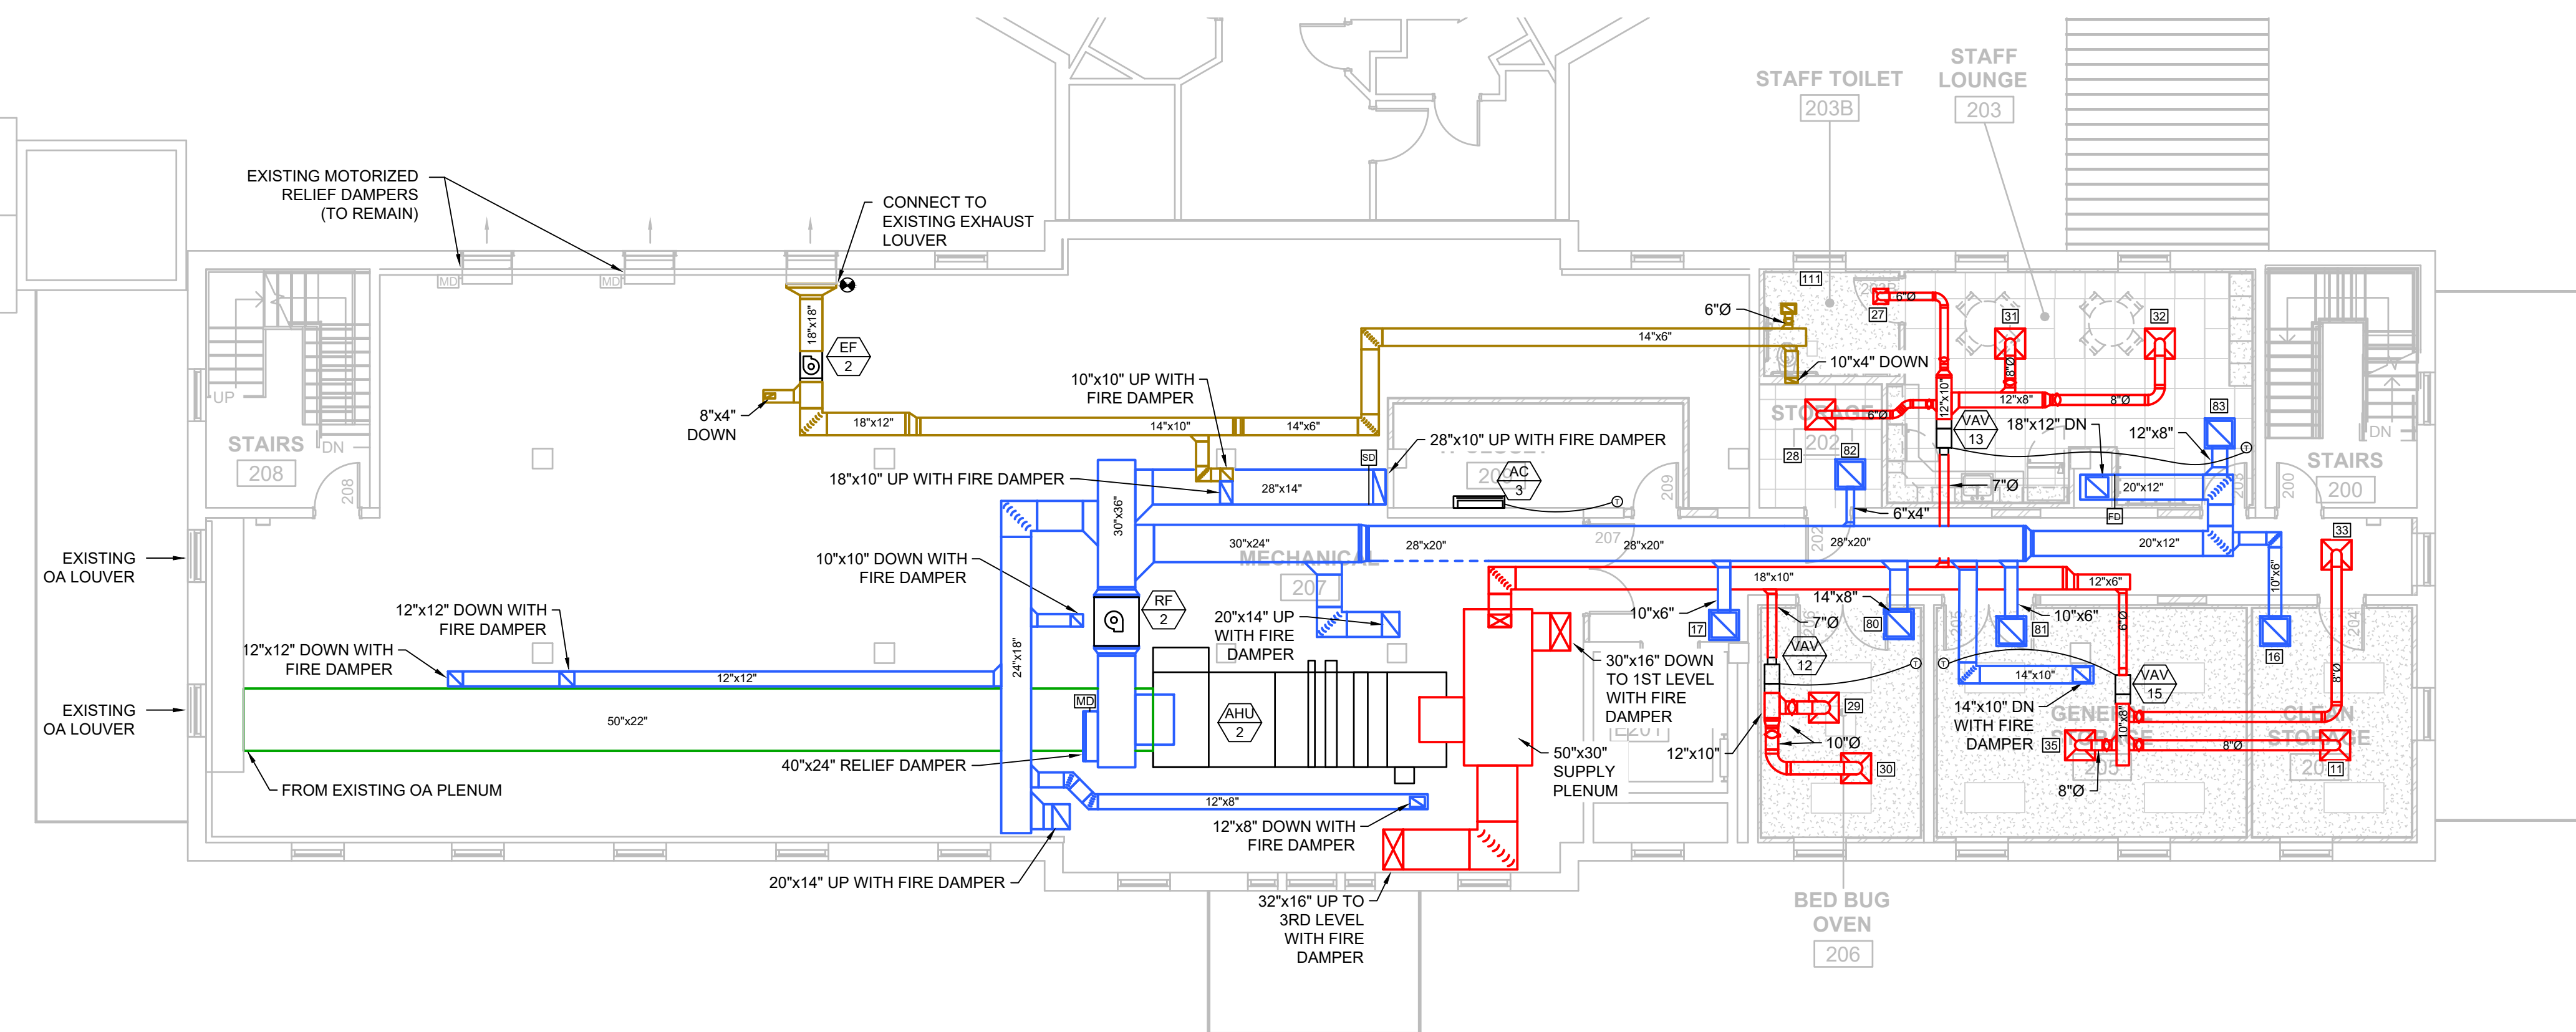

2 SECOND FLOOR HVAC DUCTING PLAN
M200 SCALE 1/8" = 1'-0"

GRD ID SCHEDULE

TAG	STYLE	CFM	NECK SIZE
01	SD-1	200	8"Ø
02	SD-1	230	8"Ø
03	SD-1	230	8"Ø
04	SD-2	100	6"Ø
05	SD-2	100	6"Ø
06	SD-1	300	10"Ø
07	SD-1	210	8"Ø
08	SD-1	210	8"Ø
09	SD-3	200	8"Ø
10	SD-3	200	8"Ø
11	SD-1	250	8"Ø
12	SD-3	200	8"Ø
13	SD-1	310	10"Ø
14	SD-1	310	10"Ø
15	SD-1	250	8"Ø
16	SD-1	200	8"Ø
17	NOT USED		
18	SD-2	50	4"Ø
19	SD-2	50	4"Ø
20	SD-1	200	8"Ø
21	SD-3	150	8"Ø
22	SD-1	150	8"Ø
23	SD-3	175	8"Ø
24	SD-1	150	8"Ø
25	SD-1	150	8"Ø
26	SD-1	200	8"Ø
27	SD-2	70	6"Ø
28	SD-1	80	6"Ø
29	SD-1	290	10"Ø
30	SD-1	290	10"Ø
31	SD-1	250	8"Ø
32	SD-1	250	8"Ø
33	SD-1	200	8"Ø
34	NOT USED		
35	SD-3	250	8"Ø
36	SD-1	300	10"Ø
37	SD-1	220	8"Ø
38	SD-1	250	8"Ø
39	SD-1	200	8"Ø
40	SD-1	250	8"Ø
41	SD-1	320	8"Ø
42	SD-2	80	6"Ø
43	SD-2	80	6"Ø
44	SD-1	250	8"Ø
45	SD-1	220	8"Ø
46	SD-1	250	8"Ø
47	SD-1	220	8"Ø
48	SD-1	220	8"Ø
49	SD-1	100	6"Ø
50	SD-1	250	8"Ø
51	SD-1	320	10"Ø
52	SD-2	100	6"Ø
53	SD-1	100	6"Ø
54	SD-1	250	8"Ø
55	SD-1	180	8"Ø
56	SD-1	180	8"Ø
57	SD-1	250	8"Ø
58	SD-1	320	10"Ø
59	SD-1	180	8"Ø
60	SD-1	250	8"Ø
61	SD-1	180	8"Ø
62	SD-1	250	8"Ø
63	SD-1	300	10"Ø
64	RG-1	-	22"x22"
65	RG-1	-	22"x22"
66	RG-1	-	22"x22"
67	RG-1	-	22"x22"
68	RG-2	-	20"x20"
69	RG-1	-	22"x22"
70	RG-1	-	22"x22"
71	RG-1	-	22"x22"
72	RG-1	-	22"x22"
73	RG-1	-	22"x22"
74	RG-1	-	22"x22"
75	RG-2	-	10"x10"
76	RG-1	-	22"x22"
77	RG-2	-	12"x12"
78	RG-1	-	22"x22"
79	RG-1	-	22"x22"
80	RG-1	-	22"x22"
81	RG-2	-	22"x22"
82	RG-1	-	22"x22"
83	RG-1	-	22"x22"
84	RG-1	-	22"x22"
85	RG-1	-	22"x22"
86	RG-1	-	22"x22"
87	RG-1	-	22"x22"
88	RG-1	-	22"x22"
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90	RG-1	-	22"x22"
91	RG-1	-	22"x22"
92	RG-1	-	22"x22"
93	RG-1	-	22"x22"
94	RG-2	-	22"x22"
95	RG-1	-	22"x22"
96	RG-1	-	22"x22"
97	RG-1	-	22"x22"
98	RG-1	-	22"x22"
99	RG-1	-	22"x22"
100	RG-1	-	22"x22"
101	RG-1	-	22"x22"
102	RG-1	-	22"x22"
103	RG-1	-	22"x22"
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105	RG-1	-	22"x22"
106	EG-1	80	10"x6"
107	EG-1	120	10"x6"
108	EG-1	80	10"x6"
109	EG-1	80	10"x6"
110	EG-1	50	10"x6"
111	EG-1	100	10"x6"
112	EG-1	100	10"x6"
113	EG-1	100	10"x6"
114	EG-1	150	12"x6"

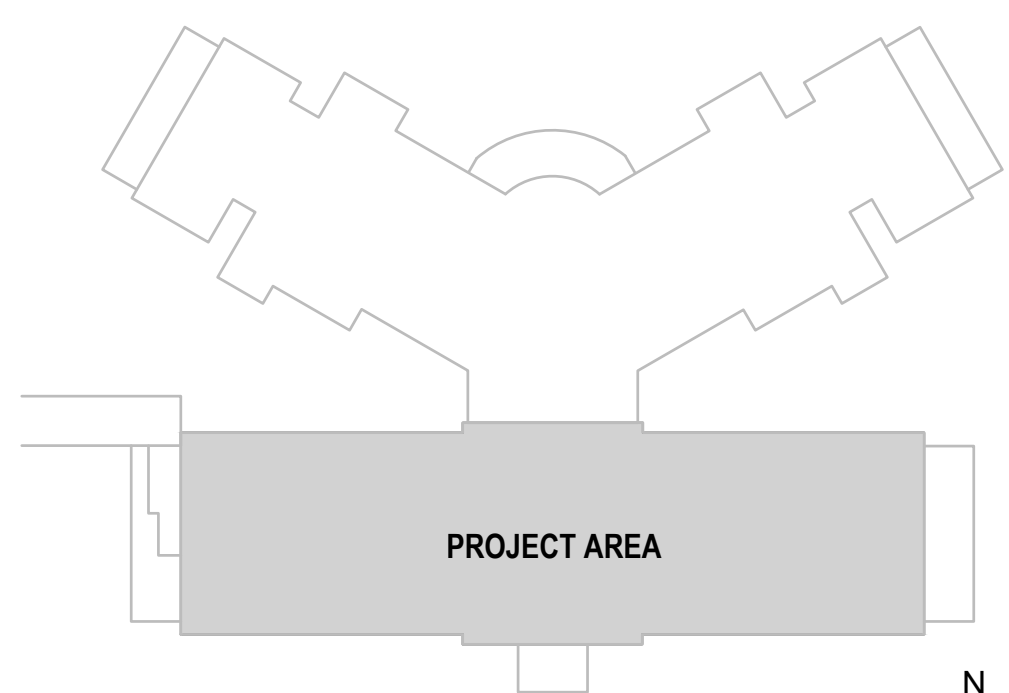


KEY PLAN
NOT TO SCALE

CONSTRUCTION DOCUMENTS

		CONSULTANTS:				ARCHITECT		Drawing Title		Project Title		Project Number		Office of Construction and Facilities Management	
		TERRASITE DESIGN 1635 DEADWOOD AVENUE RAPID CITY, SOUTH DAKOTA 57702 PH: (605) 791-1736		MORRISON-MAIERLE 3202 WEST MAIN STREET, SUITE C GILLETTE, WYOMING 82716 PH: (307) 685-3780		ALBERTSON ENGINEERING, INC. 3202 WEST MAIN STREET, SUITE C RAPID CITY, SOUTH DAKOTA 57702 PH: (605) 343-9606		FIRST & SECOND FLOOR HVAC DUCTING PLANS		BUILDING 64 FOLLOW-ON RENOVATION - SHERIDAN VA MEDICAL CENTER		666-18-103			
		DAWES ENGINEERING & DESIGN CO. 46 HIBBARD WAY HELENA, MONTANA 59601 PH: (406) 441-4000		SUMMIT COMPANIES 575 MINNEHAHA AVENUE WEST ST. PAUL, MINNESOTA 55103 PH: (651) 251-1880		FOURFRONT DESIGN, INC. 517 7TH STREET RAPID CITY, SOUTH DAKOTA 57701 PH: (605) 342-9470 FAX: (605) 342-2377 WWW.FOURFRONTDESIGN.COM		Approved: Project Director		Location SHERIDAN, WYOMING		Building Number 64			
								Owner		Date AUGUST 28, 2020		Checked RD		Drawing Number M 200	
Revisions:		Date						15.2226.17				Dwg. 76 of 115		Department of Veterans Affairs	


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one quarter inch = one foot
three eighths inch = one foot
one half inch = one foot
three quarters inch = one foot
one inch = one foot
one and one half inches = one foot
two inches = one foot
three inches = one foot
four inches = one foot
five inches = one foot
six inches = one foot
seven inches = one foot
eight inches = one foot
nine inches = one foot
ten inches = one foot
eleven inches = one foot
twelve inches = one foot

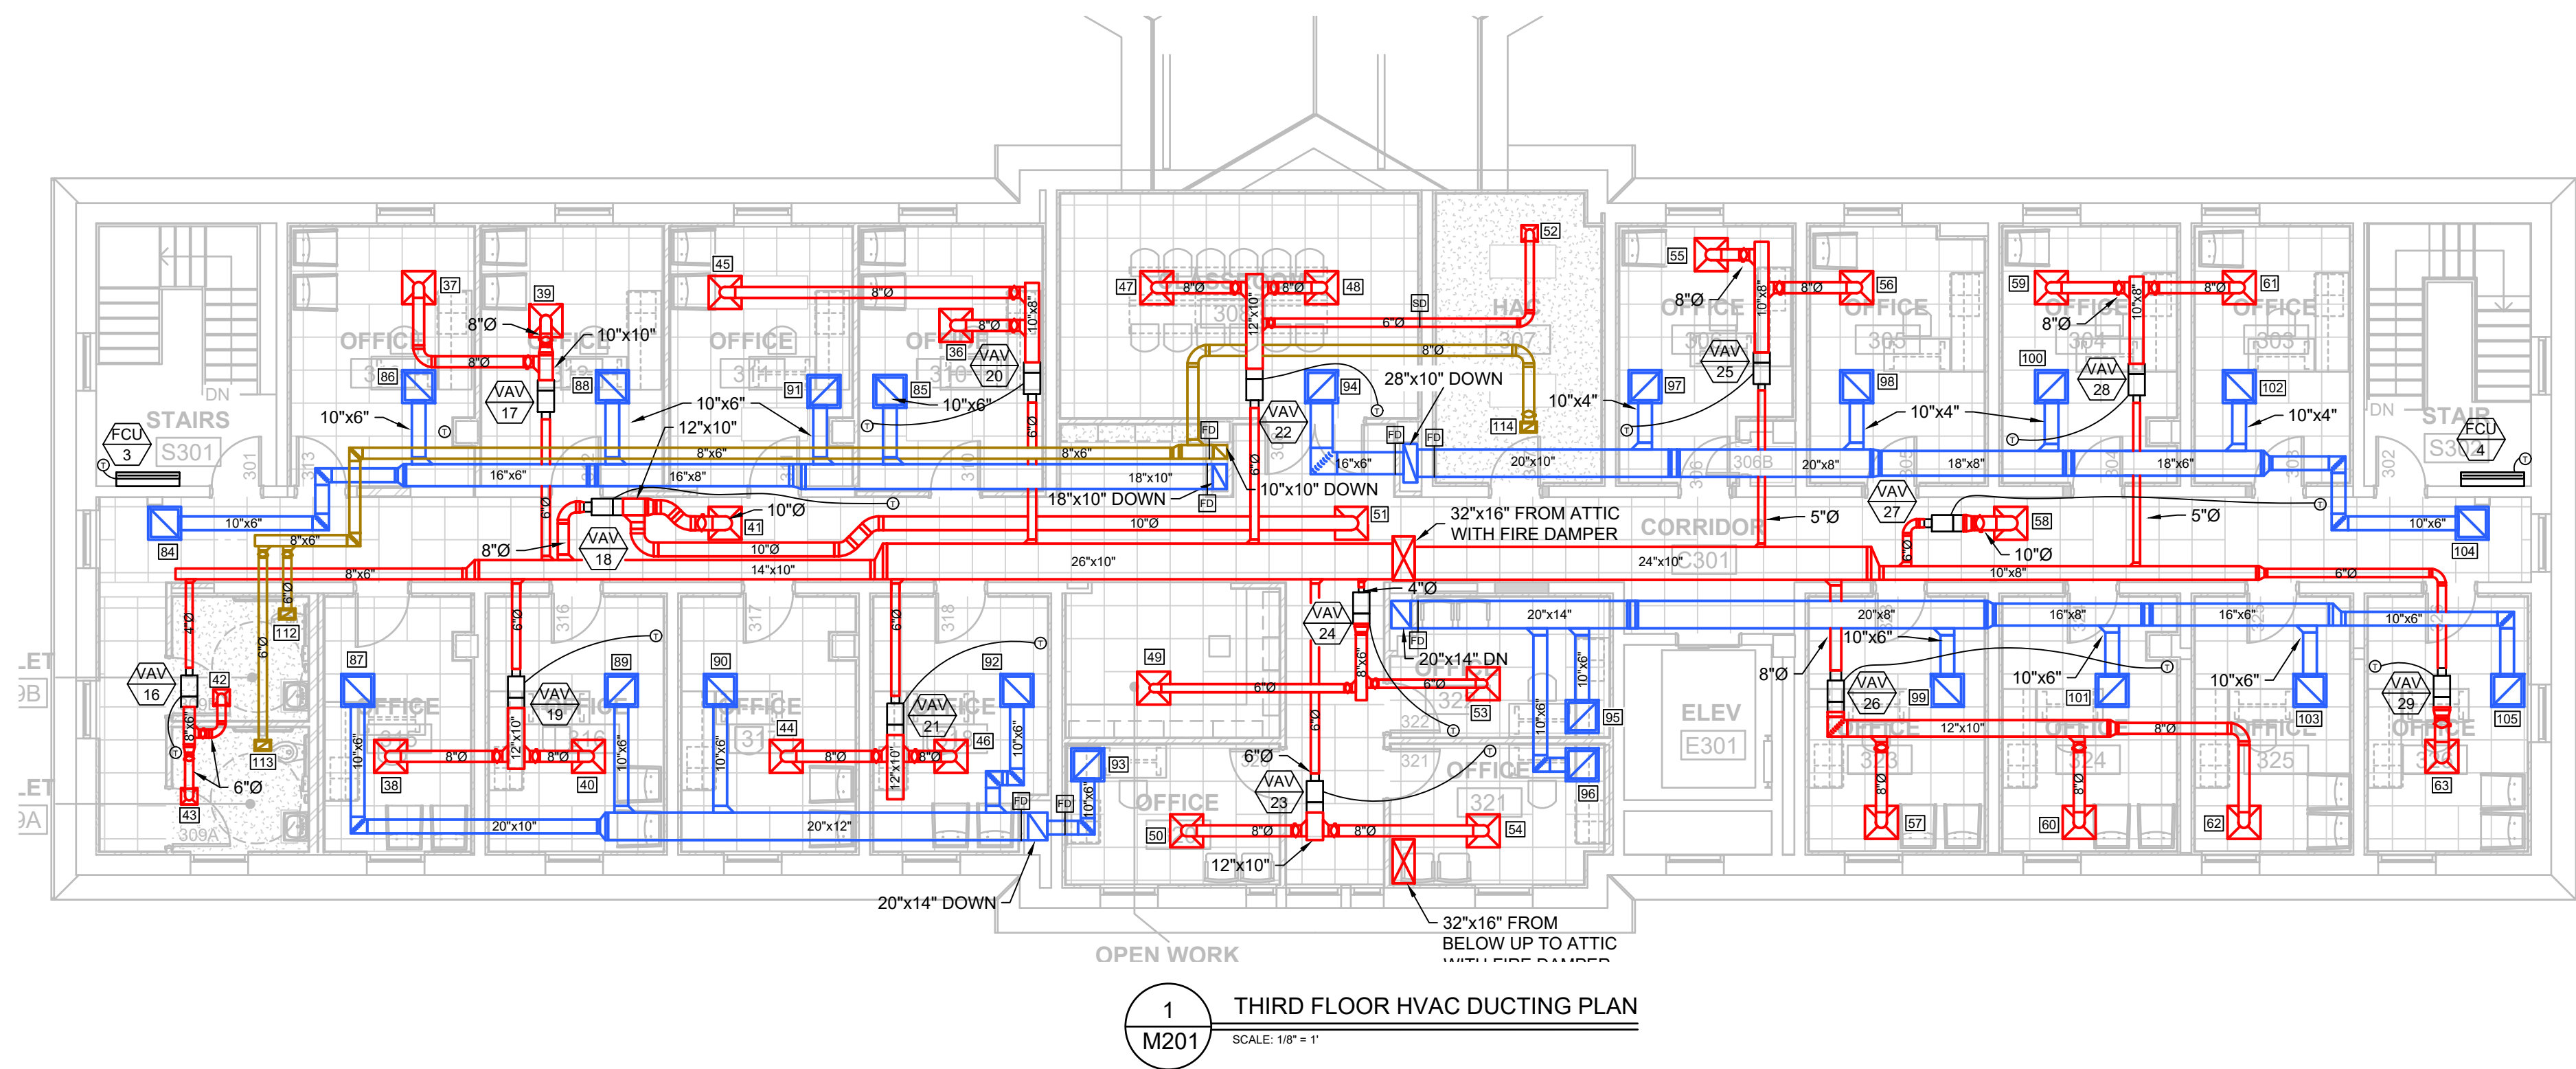


DUCT KEY	
8"Ø	DUCT SUPPLY
10"Ø	DUCT RETURN
12"Ø	DUCT OUTSIDE AIR
14"Ø	DUCT EXHAUST/RELIEF AIR

GRD ID SCHEDULE			
TAG	STYLE	CFM	NECK SIZE
01	SD-1	200	8"Ø
02	SD-1	230	8"Ø
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04	SD-2	100	6"Ø
05	SD-2	100	6"Ø
06	SD-1	300	10"Ø
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10	SD-3	200	8"Ø
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21	SD-3	150	8"Ø
22	SD-1	150	8"Ø
23	SD-3	175	8"Ø
24	SD-1	150	8"Ø
25	SD-1	150	8"Ø
26	SD-1	200	8"Ø
27	SD-2	70	6"Ø
28	SD-1	80	6"Ø
29	SD-1	290	10"Ø
30	SD-1	290	10"Ø
31	SD-1	250	8"Ø
32	SD-1	250	8"Ø
33	SD-1	200	8"Ø
34	NOT USED		
35	SD-3	250	8"Ø
36	SD-1	300	10"Ø
37	SD-1	220	8"Ø
38	SD-1	250	8"Ø
39	SD-1	200	8"Ø
40	SD-1	250	8"Ø
41	SD-1	320	8"Ø
42	SD-2	80	6"Ø
43	SD-2	80	6"Ø
44	SD-1	250	8"Ø
45	SD-1	220	8"Ø
46	SD-1	250	8"Ø
47	SD-1	220	8"Ø
48	SD-1	220	8"Ø
49	SD-1	100	6"Ø
50	SD-1	250	8"Ø
51	SD-1	320	10"Ø
52	SD-2	100	6"Ø
53	SD-1	100	6"Ø
54	SD-1	250	8"Ø
55	SD-1	180	8"Ø
56	SD-1	180	8"Ø
57	SD-1	250	8"Ø
58	SD-1	320	10"Ø
59	SD-1	180	8"Ø
60	SD-1	250	8"Ø
61	SD-1	180	8"Ø
62	SD-1	250	8"Ø
63	SD-1	300	10"Ø
64	RG-1	-	22"x22"
65	RG-1	-	22"x22"
66	RG-1	-	22"x22"
67	RG-1	-	22"x22"
68	RG-2	-	20"x20"
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113	EG-1	100	10"x6"
114	EG-1	150	12"x6"

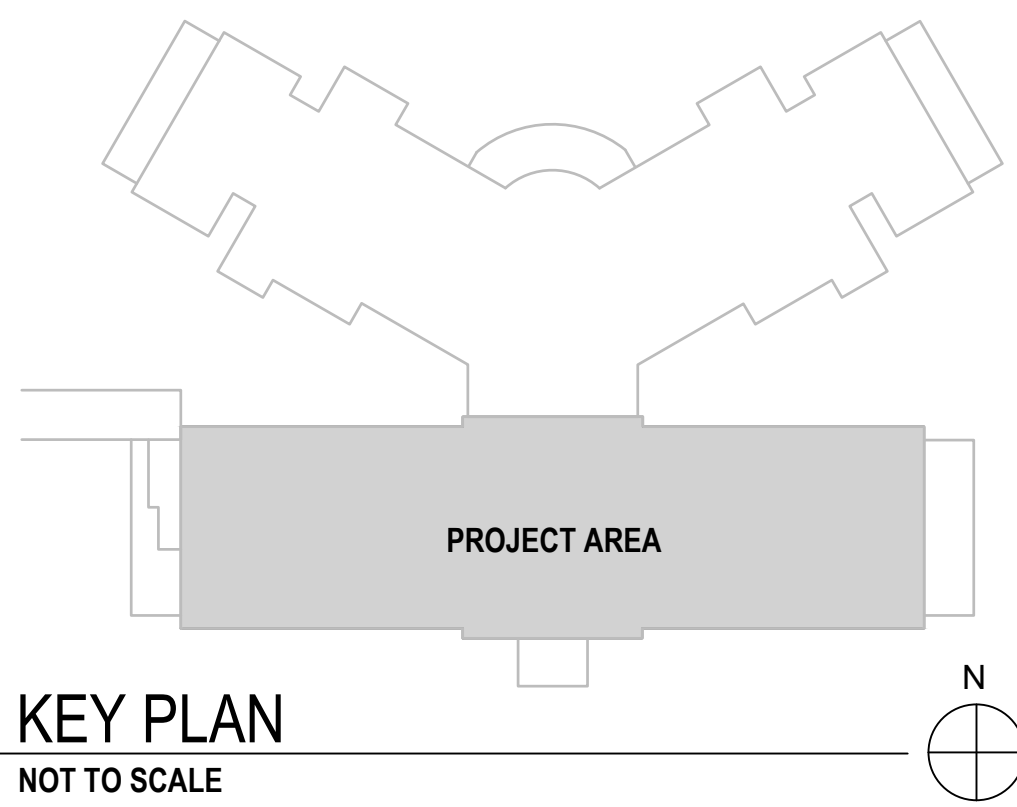

CONSTRUCTION DOCUMENTS


CONSULTANTS:		ARCHITECT		Drawing Title		Project Title		Project Number		Office of Construction and Facilities Management	
TERRASITE DESIGN 1635 DEADWOOD AVENUE RAPID CITY, SOUTH DAKOTA 57702 PH: (605) 791-1736		MORRISON-MAIERLE 2200 FOOTHILLS BLVD, SUITE A GILLETTE, WYOMING 82716 PH: (307) 685-3780		ALBERTSON ENGINEERING, INC. 3202 WEST MAIN STREET, SUITE C RAPID CITY, SOUTH DAKOTA 57702 PH: (605) 343-9606		THIRD FLOOR HVAC DUCTING PLAN		BUILDING 64 FOLLOW-ON RENOVATION - SHERIDAN VA MEDICAL CENTER		666-18-103	
DAWES ENGINEERING & DESIGN CO. 46 HIBBARD WAY HELENA, MONTANA 59601 PH: (406) 441-4000		SUMMIT COMPANIES 575 MINNEHAHA AVENUE WEST ST. PAUL, MINNESOTA 55103 PH: (651) 251-1880		FOURFRONT DESIGN, INC. 517 7TH STREET RAPID CITY, SOUTH DAKOTA 57701 PH: (605) 342-9470 FAX: (605) 342-2377 WWW.FOURFRONTDESIGN.COM		Approved: Project Director		Location SHERIDAN, WYOMING		Building Number 64	
Revisions:		Date		Owner		Date AUGUST 28, 2020		Checked RD		Drawn PM - WW	
				15.2226.17						Drawing Number M 201	
										Dwg. 77 of 115	

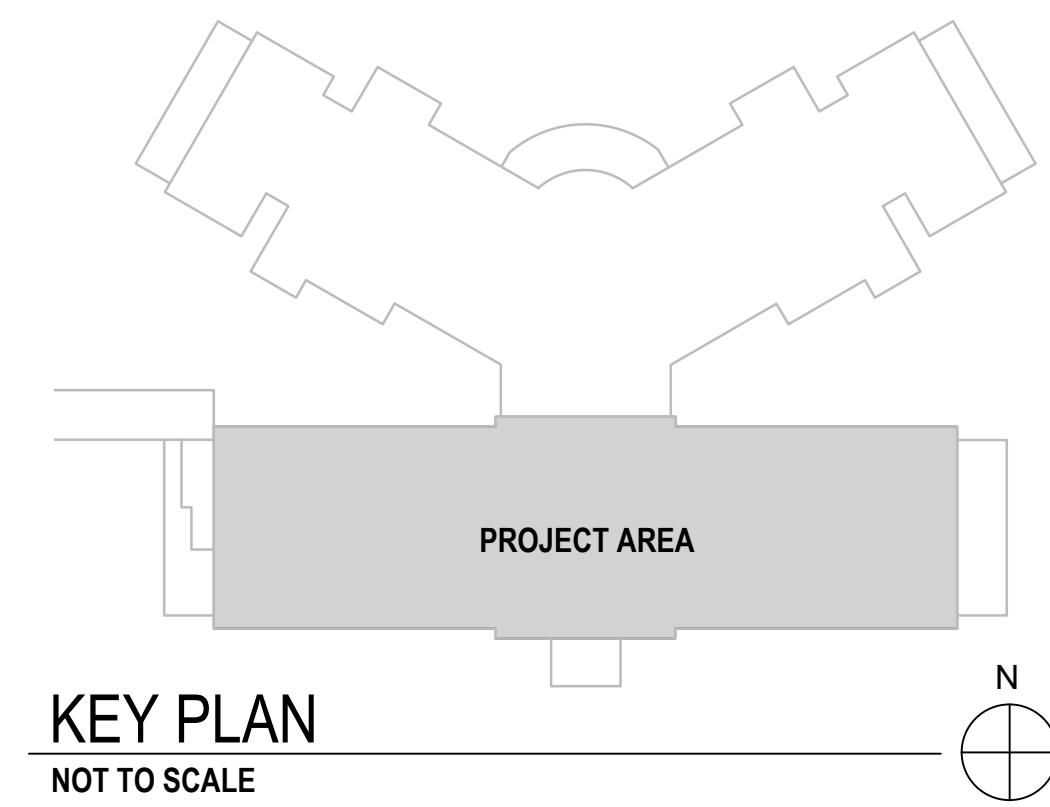


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1 one eighth inch = one foot
2 one eighth inch = one foot
3 one eighth inch = one foot
4 one eighth inch = one foot
5 one eighth inch = one foot
6 one eighth inch = one foot
7 one eighth inch = one foot
8 one eighth inch = one foot
9 one eighth inch = one foot
10 one eighth inch = one foot
11 one eighth inch = one foot
12 one eighth inch = one foot

NOTE: SNOW MELT LOOP PIPING UTILIZES 50% PROPYLENE GLYCOL SOLUTION														SNOW MELT SCHEDULE												SM #
IDENT.	SERVED	MANIFOLD #	AREA S.F.	OUTDOOR TEMP.	TOTAL LOAD (BTU/HF)	TOTAL LOAD (BTU)	SURFACE TEMPERATURE	TUBING SIZE	TUBING AMOUNT	WATER DIFFER.	TUBING O.C.	SUPPLY TEMP.	NUMBER LOOPS	ACTIVE LOOP LENGTH	LEADER LENGTH	TOTAL LOOP LENGTH	GLYCOL %	FLOW LINEAR FT. GPM	LOOP FLOW GPM	TOTAL FLOW GPM	PRESSURE DROP (LINEAR FT.)	PRESSURE DROP (FT.)	NOTES			
SM-1	WEST SIDEWALK	-	300	-10	185	55,500	38 DEG	5/8"	600'	25	6	130	3	200'	15'	215'	50	0.0085	1.8	5.4	0.0410	8.8	1			
SM-2	LOAD DOCK/ EAST SIDEWALK	-	610	-10	185	112850	38 DEG	5/8"	1220'	25	6	130	6	203'	10'	213'	50	0.0085	1.8	10.9	0.0410	8.7	1			
NOTES 1. REFER TO SNOW MELT SPECIFICATION FOR MANUFACTURER AND COMPONENT DETAILS.																										

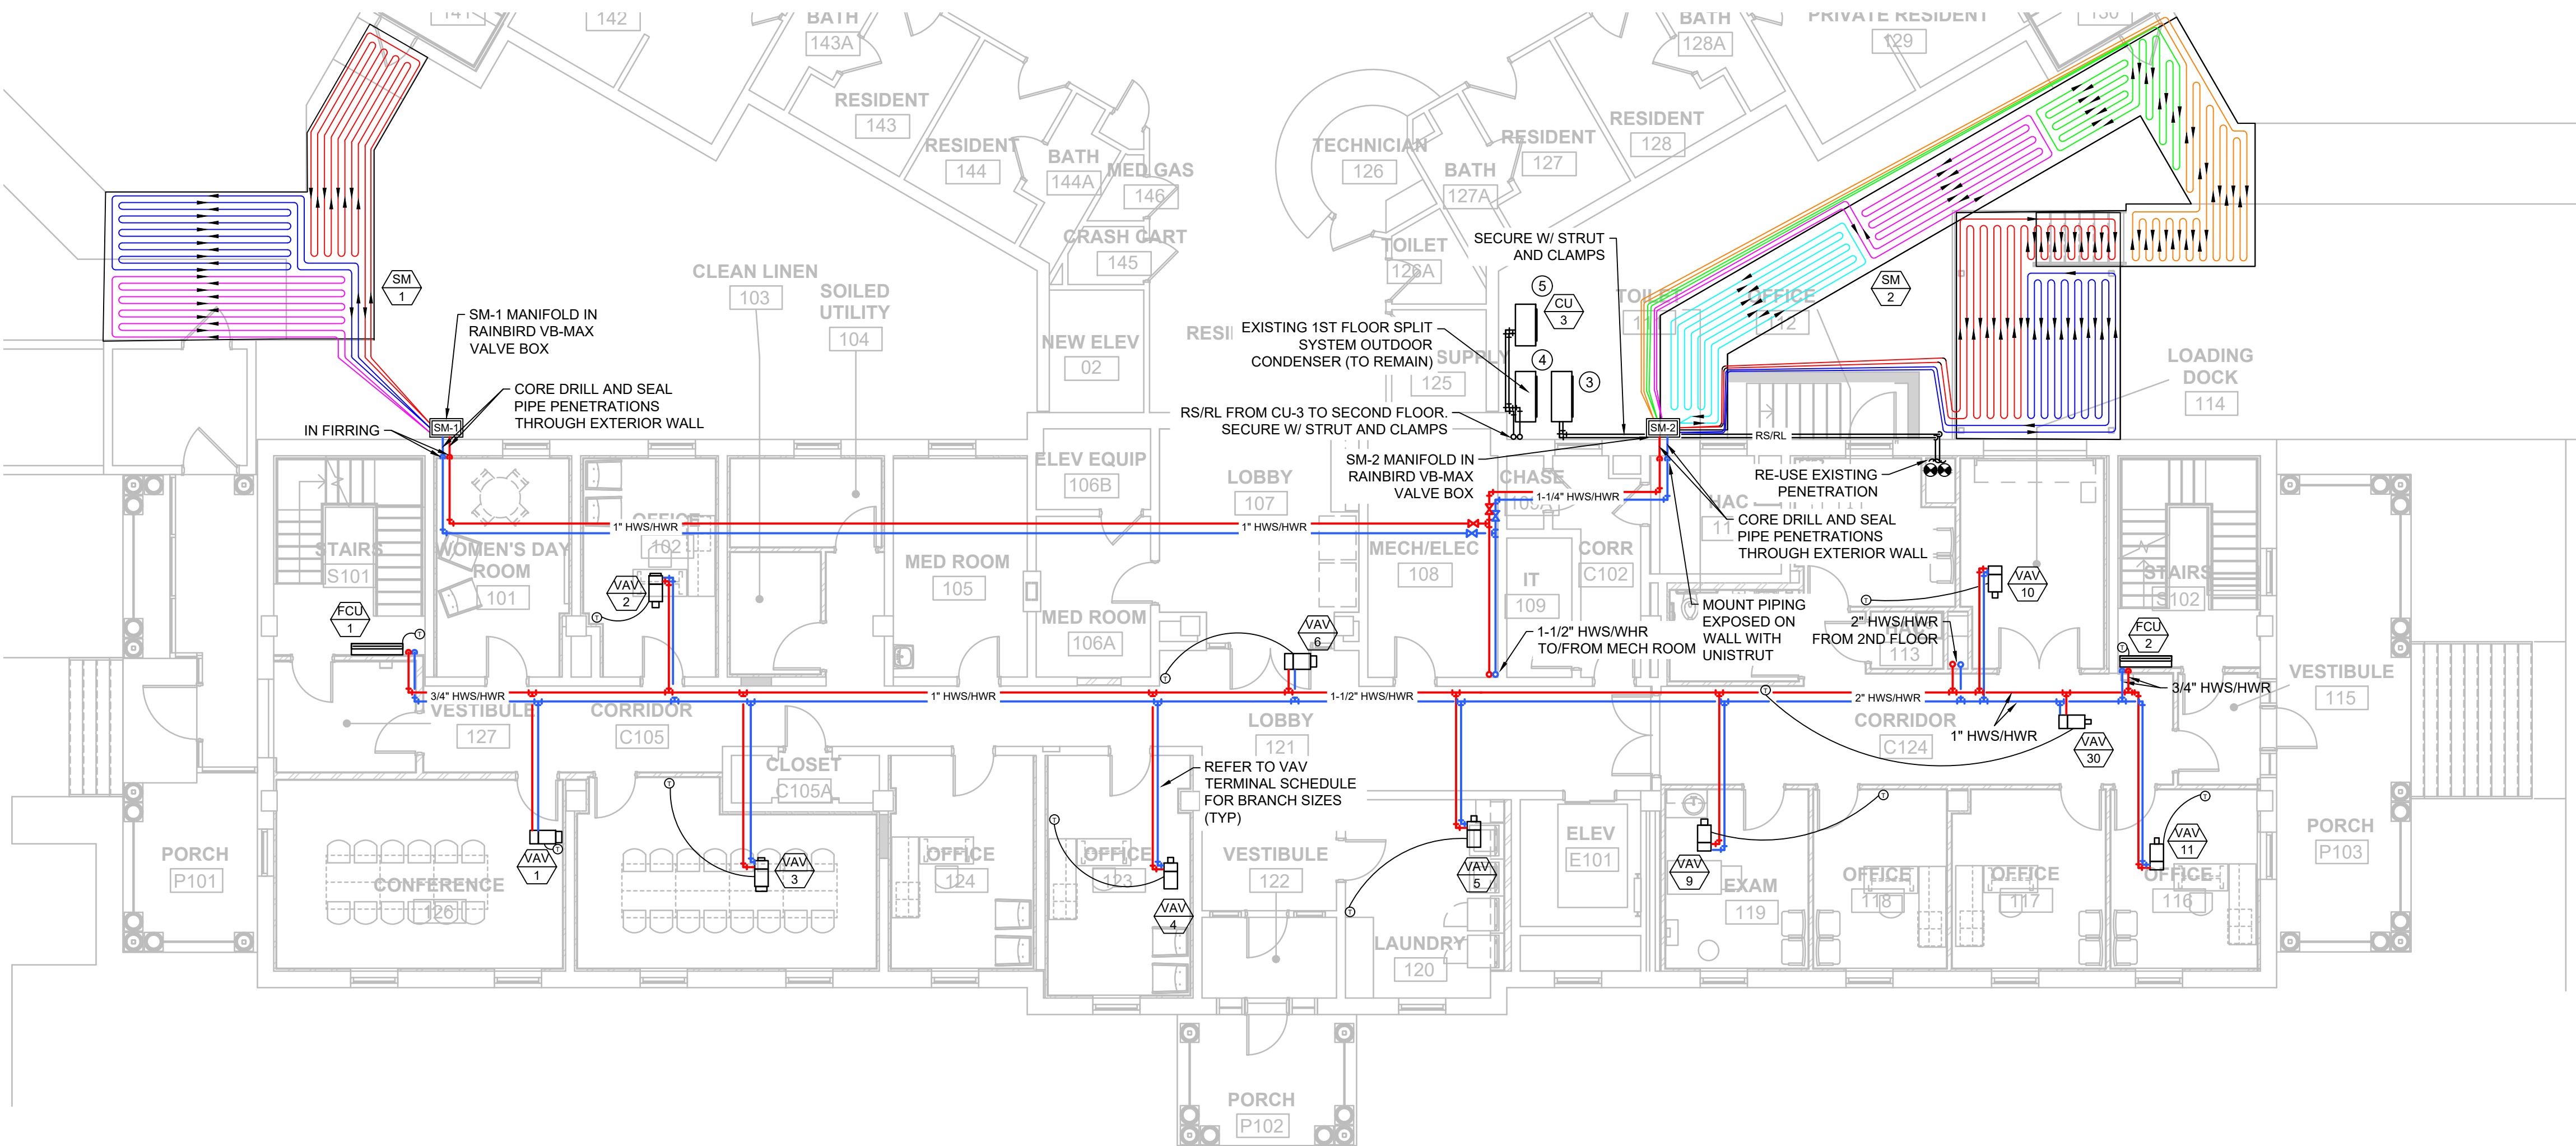

1 FIRST FLOOR HVAC PIPING PLAN
M300 SCALE: 1/8" = 1'

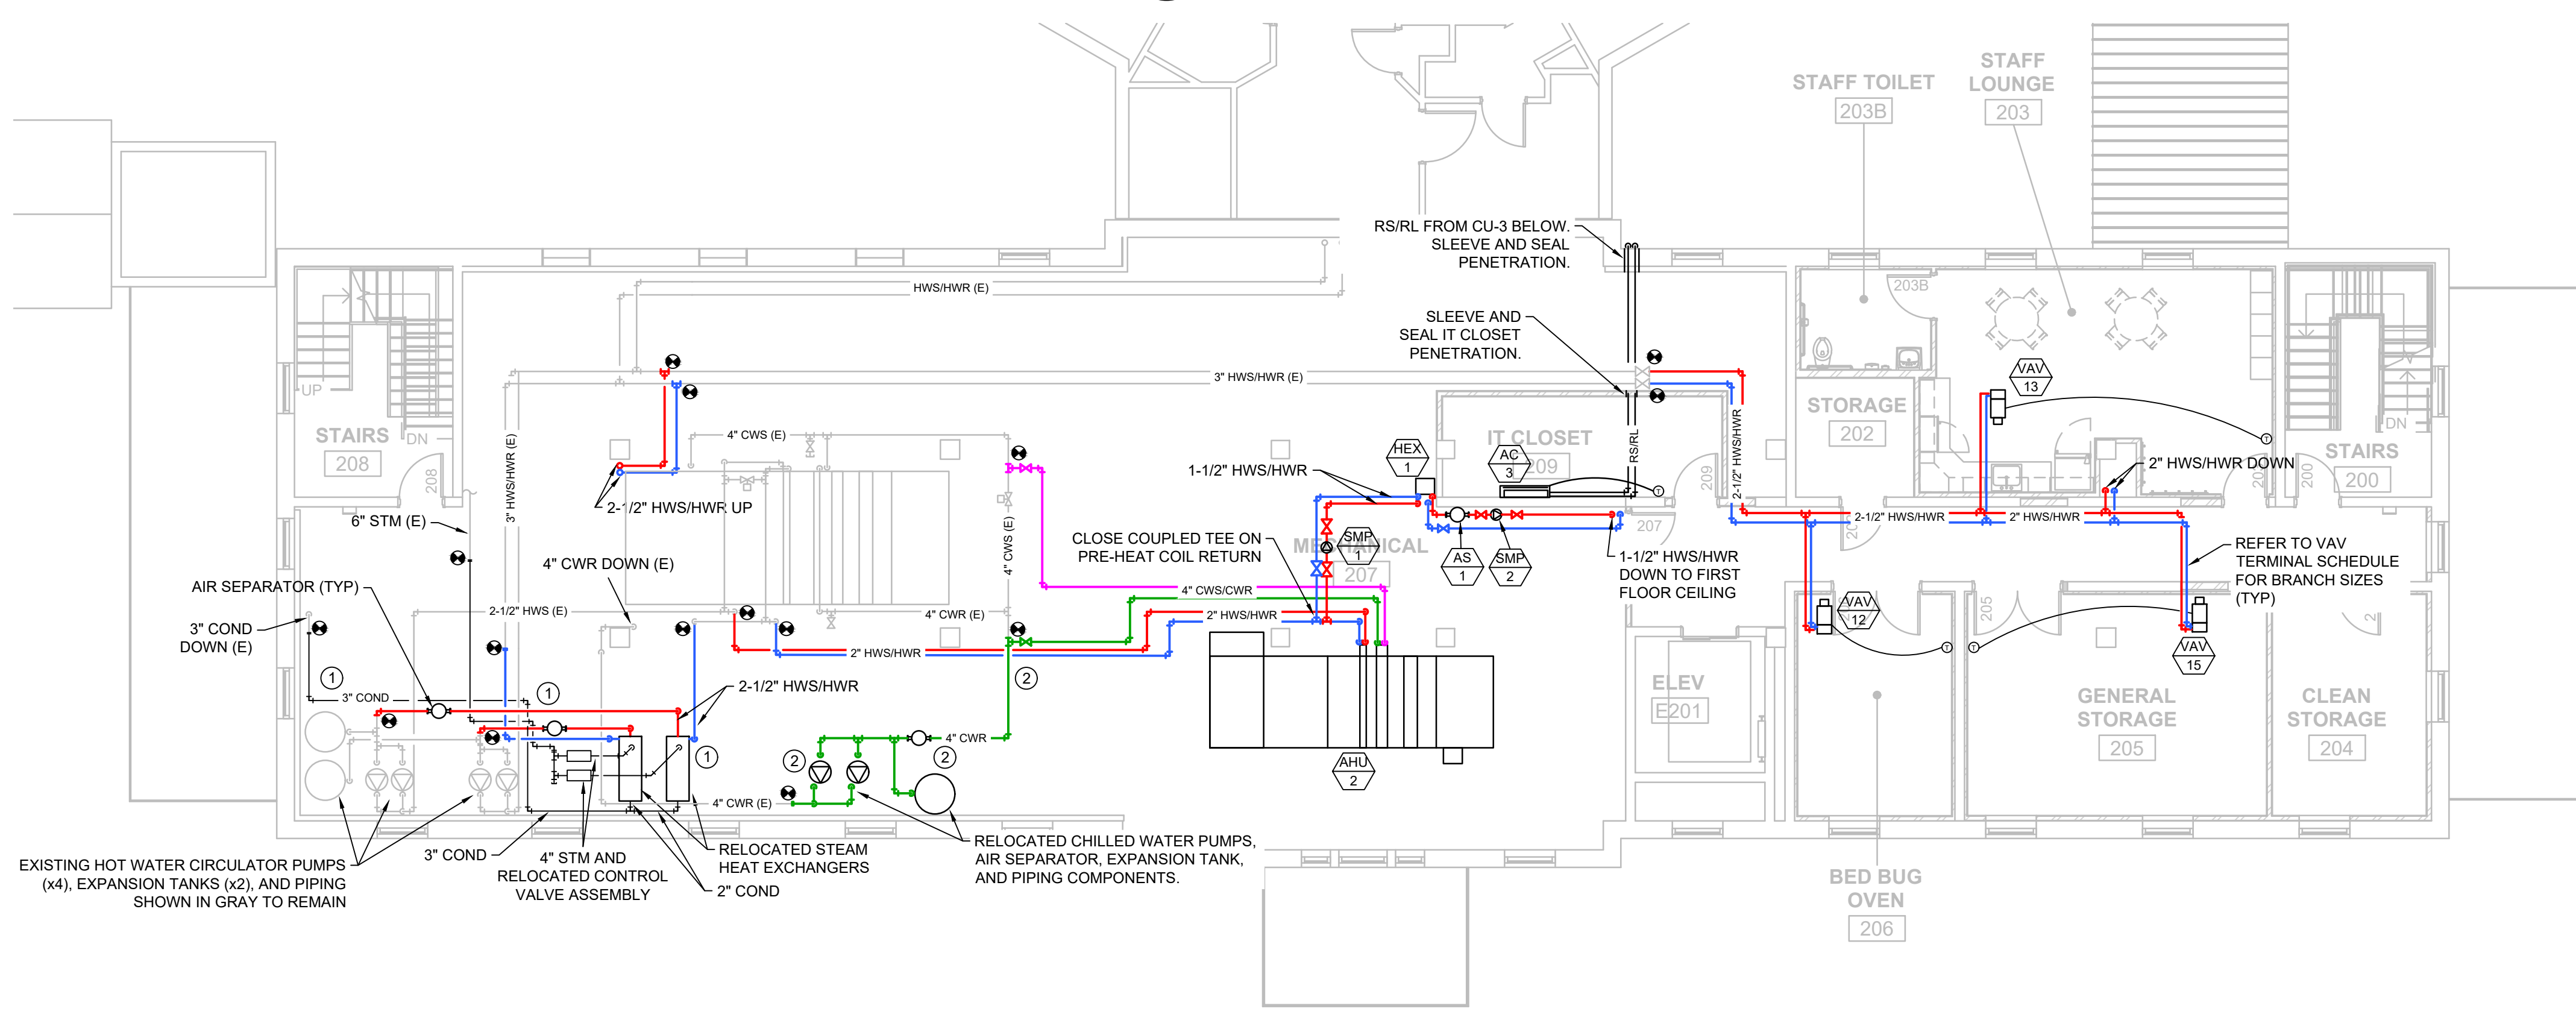


2 SECOND FLOOR HVAC PIPING PLAN
M300 SCALE: 1/8" = 1'

GENERAL HVAC NOTE
AHU-2 IS INTENDED TO MODULAR SO IT CAN BE KNOCKED DOWN AND BROUGHT INTO THE BUILDING THROUGH THE WEST END WHERE THE EXISTING SOUTH OUTDOOR AIR LOUVER IS LOCATED, AND FIELD ASSEMBLED IN THE MECHANICAL 207 SPACE.

PIPE KEY	
Blue line	HYDRONIC HEATING WATER SUPPLY
Red line	HYDRONIC HEATING WATER RETURN
Purple line	HYDRONIC CHILLED WATER SUPPLY
Green line	HYDRONIC CHILLED WATER RETURN

- KEYED MECHANICAL NOTES
- 1 RELOCATE EXISTING STEAMHOT WATER HEAT EXCHANGERS, AIR SEPARATORS, AND COMPONENTS SHOWN IN DARK. MODIFY/EXTEND EXISTING PIPING TO NEW LOCATION.
 - 2 RELOCATE EXISTING CHILLED WATER PUMPS, AIR SEPARATOR, EXPANSION TANK, AND COMPONENTS SHOWN IN DARK. MODIFY/EXTEND EXISTING PIPING TO NEW LOCATION.
 - 3 RELOCATE EXISTING BASEMENT SPLIT SYSTEM OUTDOOR CONDENSING UNIT TO NEW LOCATION MOUNTED ON WALL ABOVE EXISTING FIRST FLOOR SPLIT SYSTEM CONDENSING UNIT. MODIFY AND EXTEND REFRIGERANT PIPING TO NEW LOCATION.
 - 4 ELEVATE EXISTING FIRST FLOOR SPLIT SYSTEM CONDENSING UNIT ON EXTERIOR WALL. MODIFY AND EXTEND REFRIGERANT PIPING TO NEW LOCATION.
 - 5 CU-3 TO BE ELEVATED AND MOUNTED ON EXTERIOR WALL.

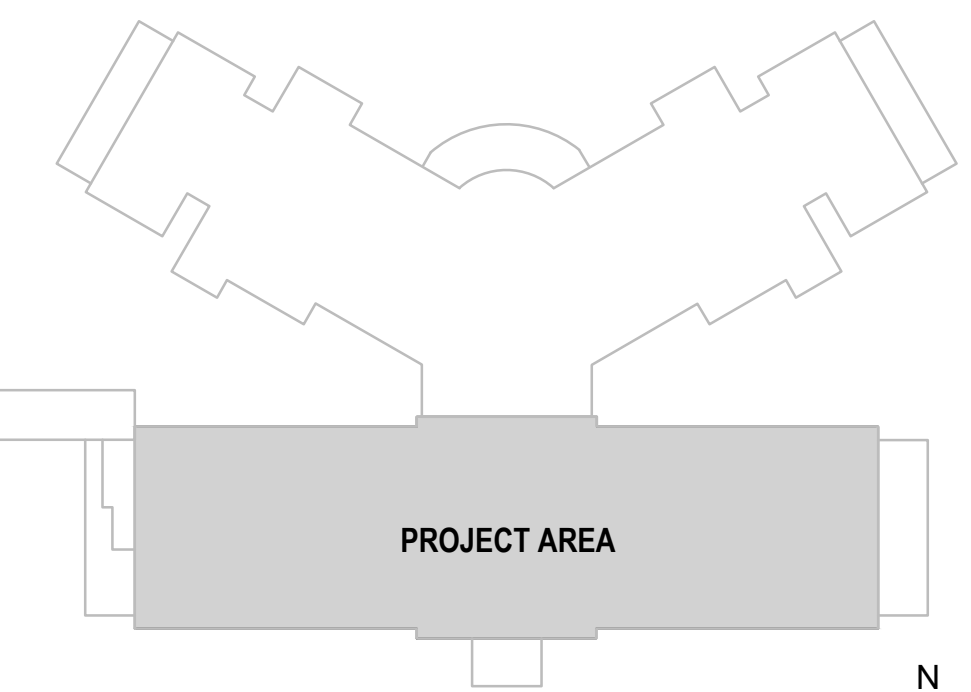

KEY PLAN
NOT TO SCALE

CONSTRUCTION DOCUMENTS

Revisions:

Date:

CONSULTANTS:

TERRASITE DESIGN
1635 DEADWOOD AVENUE
RAPID CITY, SOUTH DAKOTA 57702
PH: (605) 791-1736

MORRISON-MAIERLE
2200 FOOTHILLS BLVD, SUITE A
GILLETTE, WYOMING 82716
PH: (307) 685-3780

ALBERTSON ENGINEERING, INC.
3202 WEST MAIN STREET, SUITE C
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PH: (605) 343-9606

DAWES ENGINEERING &
DESIGN CO. 46 HIBBARD WAY
HELENA, MONTANA 59601
PH: (406) 441-4000

SUMMIT COMPANIES
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ARCHITECT

FOURFRONT
DESIGN INC.

FOURFRONT DESIGN, INC.
517 7TH STREET
RAPID CITY, SOUTH DAKOTA 57701
PH: (605) 342-9470
FAX: (605) 342-2377
WWW.FOURFRONTDESIGN.COM

15.2226.17

Drawing Title

FIRST & SECOND FLOOR HVAC PIPING PLANS

Approved: Project Director

Owner

Project Title

BUILDING 64 FOLLOW-ON RENOVATION - SHERIDAN VA MEDICAL CENTER

Location

SHERIDAN, WYOMING

Date

AUGUST 28, 2020

Checked

RD

Drawn

PM - WW

Project Number

666-18-103

Building Number

64

Drawing Number

M 300


Dwg. 79 of 115


Office of Construction and Facilities Management

Department of Veterans Affairs

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VA FORM 06-6231


 Department of
Veterans Affairs

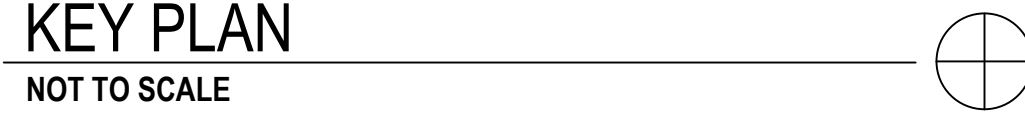

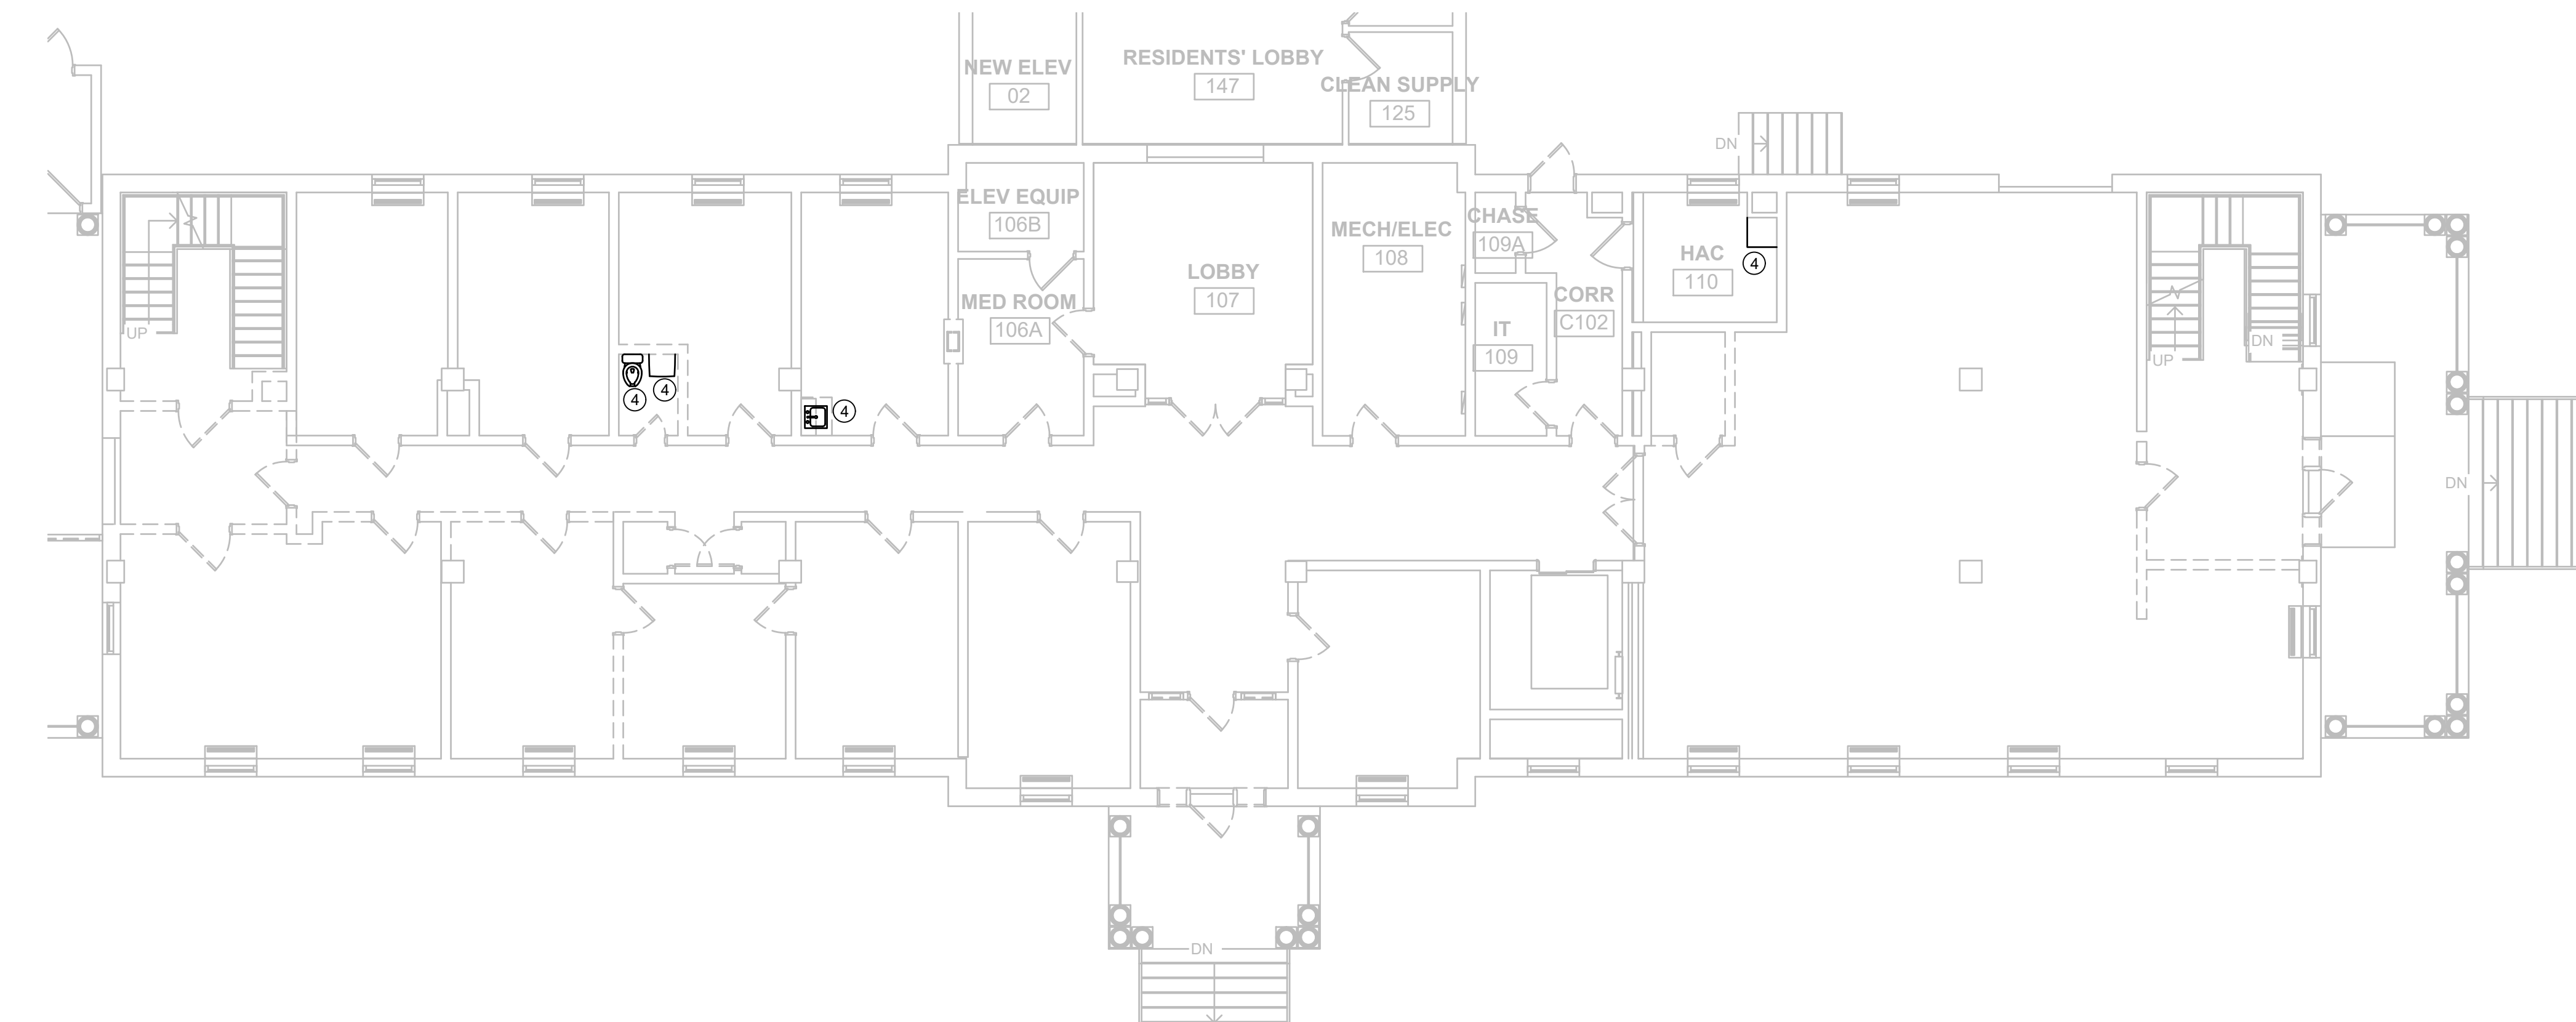2 FIRST FLOOR PLUMBING DEMOLITION PLAN
M400 SCALE: 1/8" = 1'

KEYED PLUMBING NOTES


- ① REMOVE EXISTING SANITARY SEWER RISER AND PIPING SHOWN IN DARK BACK TO BASEMENT. PREP REMAINING FOR RECONNECTION TO NEW SANITARY SEWER SHOWN IN THESE PLANS.
- ② REMOVE EXISTING SANITARY SEWER RISER AND PIPING SHOWN IN DARK BACK TO BASEMENT. CAP AND SEAL.
- ③ REMOVE EXISTING DOB, DHW, AND DHWR RISER AND PIPING SHOWN IN DARK, CAP AND SEAL. EXISTING DOB TO WATER PIPING TO BE RECONSTRUCTED TO SERVICE EXISTING BASEMENT PLUMBING FIXTURES.
- ④ REMOVE EXISTING PLUMBING FUTURE(S) AND ASSOCIATED SANITARY SEWER AND DOMESTIC WATER PIPING. SALVAGE PLUMBING FIXTURE(S) IF OWNER REMOVE/VENT PIPING BACK TO ATTIC SPACE. CAP AND SEAL.

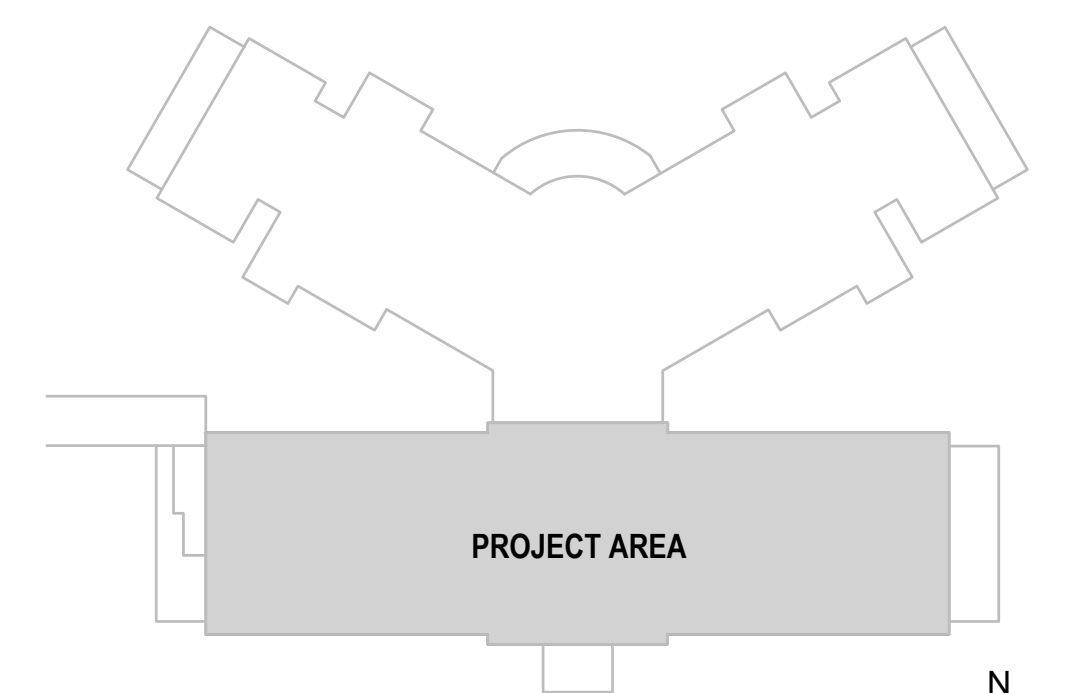

KEY PLAN
NOT TO SCALE

CONSTRUCTION DOCUMENTS

		CONSULTANTS:				ARCHITECT		Drawing Title		Project Title		Project Number		Office of Construction and Facilities Management	
		TERRASITE DESIGN 1635 DEADWOOD HILLS BLVD. RAPID CITY, SOUTH DAKOTA 57702 PH: (605) 791-1736		MORRISON-MAIERLE 575 MINNEHAHA AVENUE WEST ST. PAUL, MINNESOTA 55103 PH: (651) 251-1880		ALBERTSON ENGINEERING, INC. 3202 WEST MAIN STREET, SUITE C RAPID CITY, SOUTH DAKOTA 57702 PH: (605) 343-9606		BASEMENT & FIRST FLOOR PLUMBING DEMOLITION PLANS		BUILDING 64 FOLLOW-ON RENOVATION - SHERIDAN VA MEDICAL CENTER		666-18-103			
		DAWES ENGINEERING & DESIGN CO., 46 HIBBARD WAY HELENA, MONTANA 59601 PH: (406) 441-4000		SUMMIT COMPANIES 575 MINNEHAHA AVENUE WEST ST. PAUL, MINNESOTA 55103 PH: (651) 251-1880		FOURFRONT DESIGN, INC. 517 7TH STREET RAPID CITY, SOUTH DAKOTA 57701 PH: (605) 342-9470 FAX: (605) 342-2377 WWW.FOURFRONTDESIGN.COM		Approved: Project Director		Location SHERIDAN, WYOMING		Drawing Number			
Revisions:		Date						Owner		Date AUGUST 28, 2020		Checked RD		Drawn PM - WW	
								15.2226.17						M 400	
														Dwg. 81 of 115	
														 Department of Veterans Affairs	

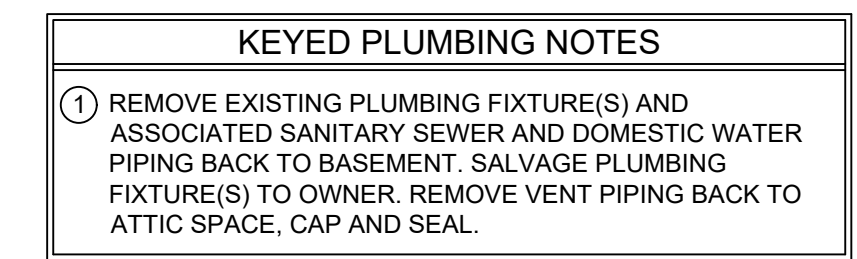


2 THIRD FLOOR PLUMBING DEMOLITION PLAN
M401 SCALE: 1/8" = 1'



VA FORM 08-6231

VA FORM 08-6231

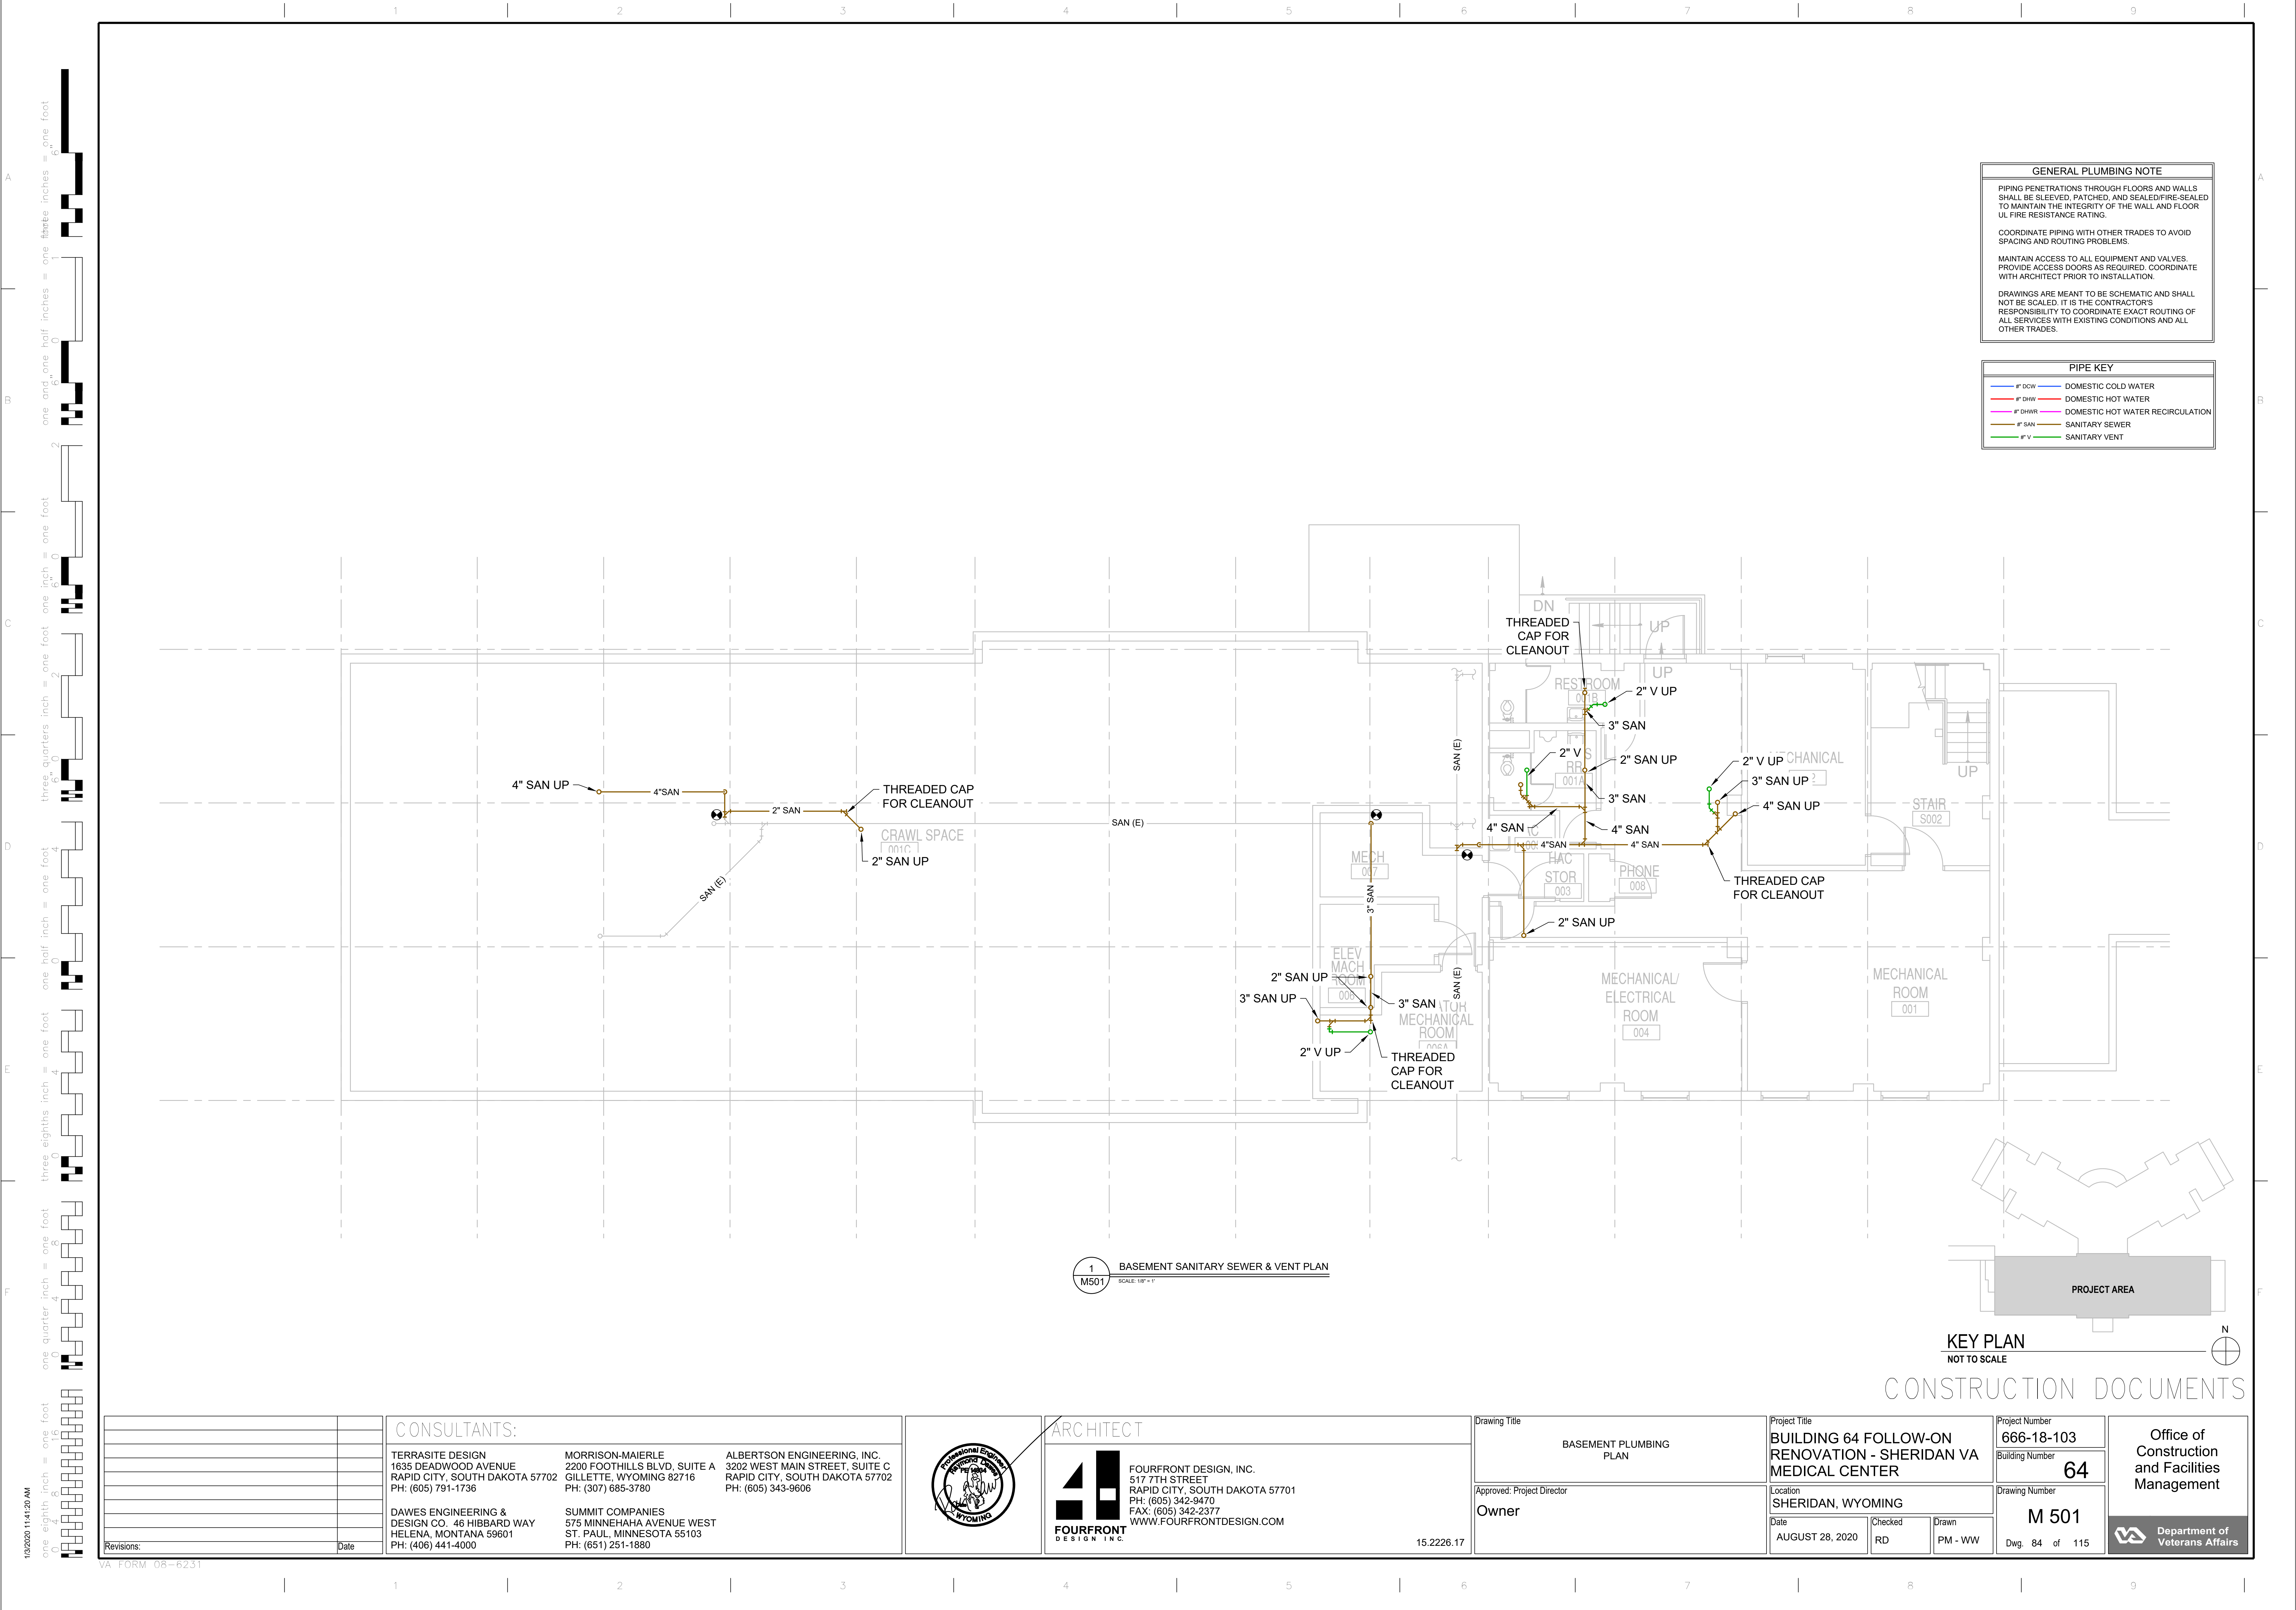

GENERAL PLUMBING NOTE


PIPING PENETRATIONS THROUGH FLOORS AND WALLS SHALL BE SLEEVED, PATCHED, AND SEALED/FIRE-SEALED TO MAINTAIN THE INTEGRITY OF THE WALL AND FLOOR UL FIRE RESISTANCE RATING.

COORDINATE PIPING WITH OTHER TRADES TO AVOID SPACING AND ROUTING PROBLEMS.

MAINTAIN ACCESS TO ALL EQUIPMENT AND VALVES. PROVIDE ACCESS DOORS AS REQUIRED. COORDINATE WITH ARCHITECT PRIOR TO INSTALLATION.

DRAWINGS ARE MEANT TO BE SCHEMATIC AND SHALL NOT BE SCALED. IT IS THE CONTRACTOR'S RESPONSIBILITY TO COORDINATE EXACT ROUTING OF ALL SERVICES WITH EXISTING CONDITIONS AND ALL OTHER TRADES.


PIPE KEY	
— 1" DCW	DOMESTIC COLD WATER
— 1" DHW	DOMESTIC HOT WATER
— 1" DHWR	DOMESTIC HOT WATER RECIRCULATION
— 1" SAN	SANITARY SEWER
— 1" V	SANITARY VENT

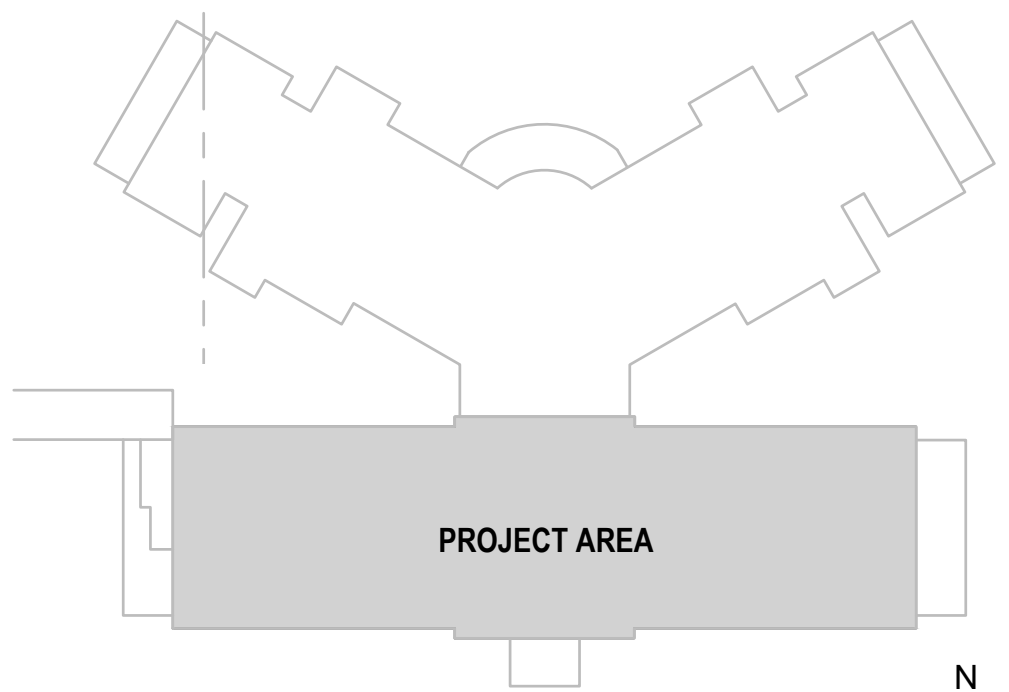

KEY PLAN
NOT TO SCALE

CONSTRUCTION DOCUMENTS

<div>Revisions:</div> <div>Date</div>	CONSULTANTS: <div><div>TERRASITE DESIGN 1635 DEADWOOD AVENUE RAPID CITY, SOUTH DAKOTA 57702 PH: (605) 791-1736</div><div>MORRISON-MAIERLE 2200 FOOTHILLS BLVD, SUITE A GILLETTE, WYOMING 82716 PH: (307) 685-3780</div><div>ALBERTSON ENGINEERING, INC. 3202 WEST MAIN STREET, SUITE C RAPID CITY, SOUTH DAKOTA 57702 PH: (605) 343-9606</div></div> <div><div>DAWES ENGINEERING & DESIGN CO. 46 HIBBARD WAY HELENA, MONTANA 59601 PH: (406) 441-4000</div><div>SUMMIT COMPANIES 575 MINNEHAHA AVENUE WEST ST. PAUL, MINNESOTA 55103 PH: (651) 251-1880</div></div>	<div><div><div>Professional Engineer Rapid City WYOMING</div></div><div><div>ARCHITECT</div><div><div>FOURFRONT DESIGN INC.</div><div>517 7TH STREET RAPID CITY, SOUTH DAKOTA 57701 PH: (605) 342-9470 FAX: (605) 342-2377 WWW.FOURFRONTDESIGN.COM</div></div></div><div>15.2226.17</div></div>	<div>Drawing Title</div> <div>BASEMENT PLUMBING PLAN</div> <div>Approved: Project Director</div> <div>Owner</div>	<div>Project Title</div> <div>BUILDING 64 FOLLOW-ON RENOVATION - SHERIDAN VA MEDICAL CENTER</div> <div>Location</div> <div>SHERIDAN, WYOMING</div> <div>Date</div> <div>AUGUST 28, 2020</div> <div>Checked</div> <div>RD</div> <div>Drawn</div> <div>PM - WW</div>	<div>Project Number</div> <div>666-18-103</div> <div>Building Number</div> <div>64</div> <div>Drawing Number</div> <div>M 501</div> <div>Dwg. 84 of 115</div>	<div>Office of Construction and Facilities Management</div> <div><div>Department of Veterans Affairs</div></div>
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GENERAL PLUMBING NOTE

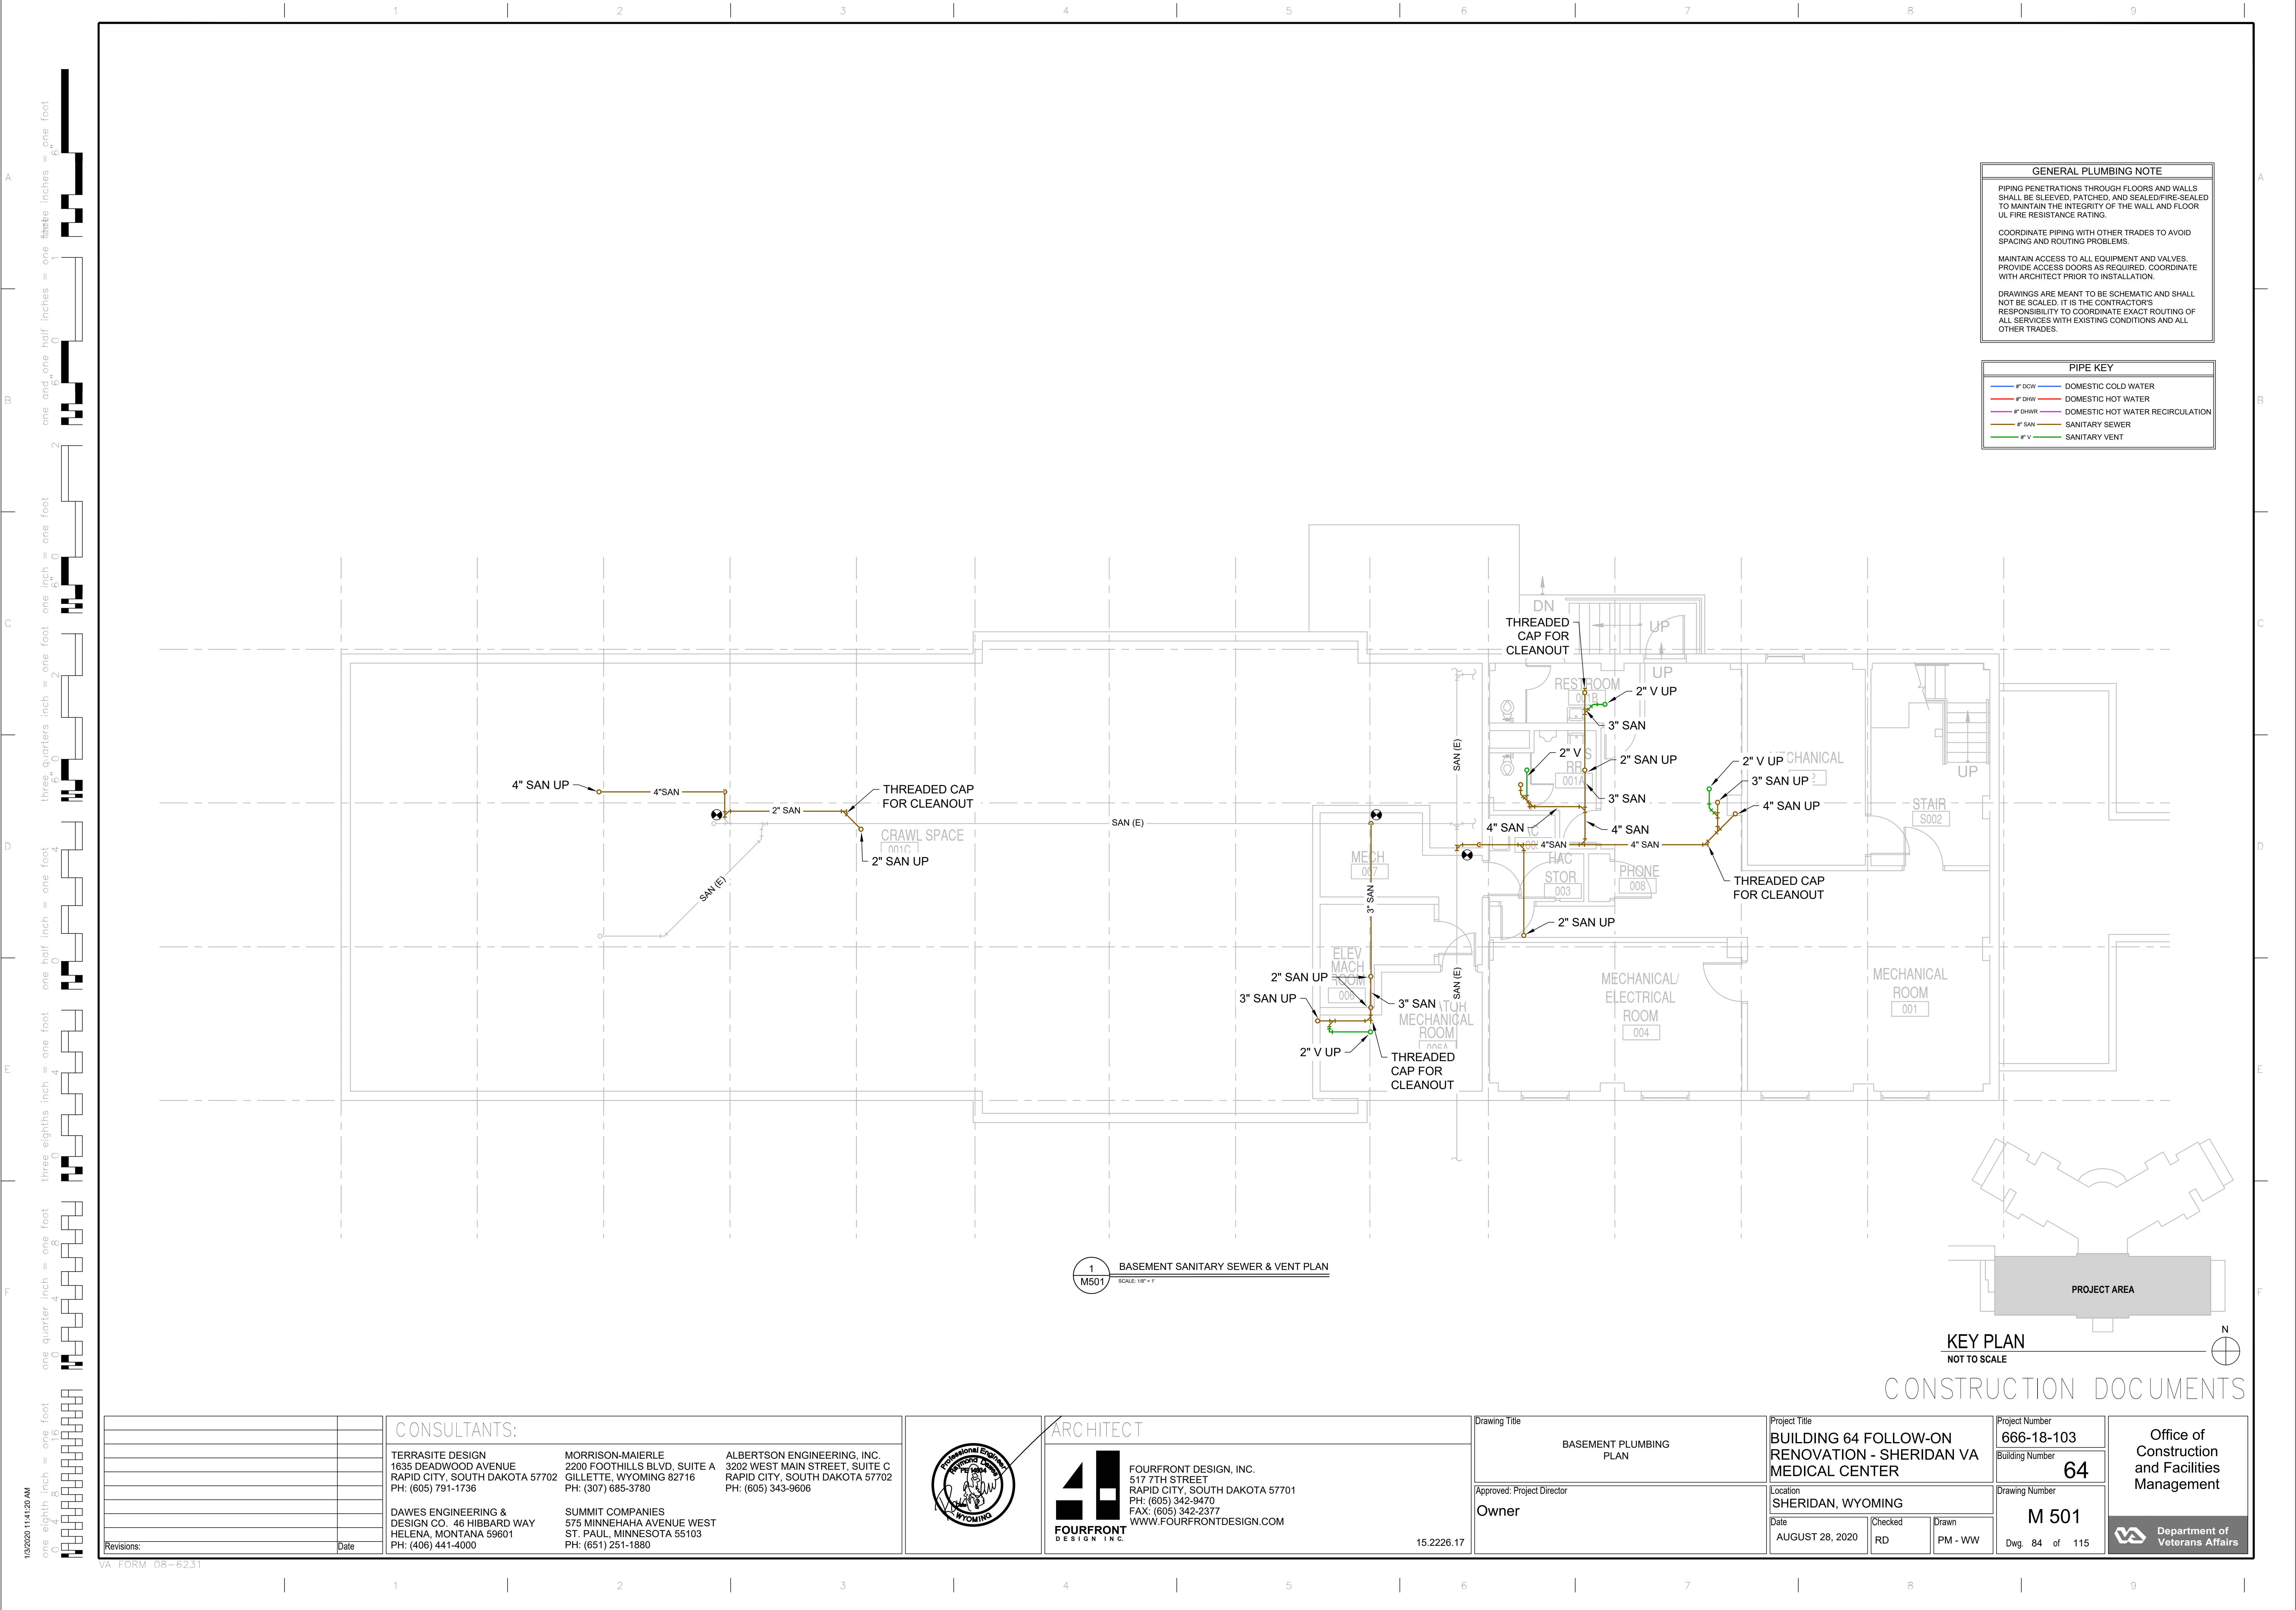
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COORDINATE PIPING WITH OTHER TRADES TO AVOID SPACING AND ROUTING PROBLEMS.

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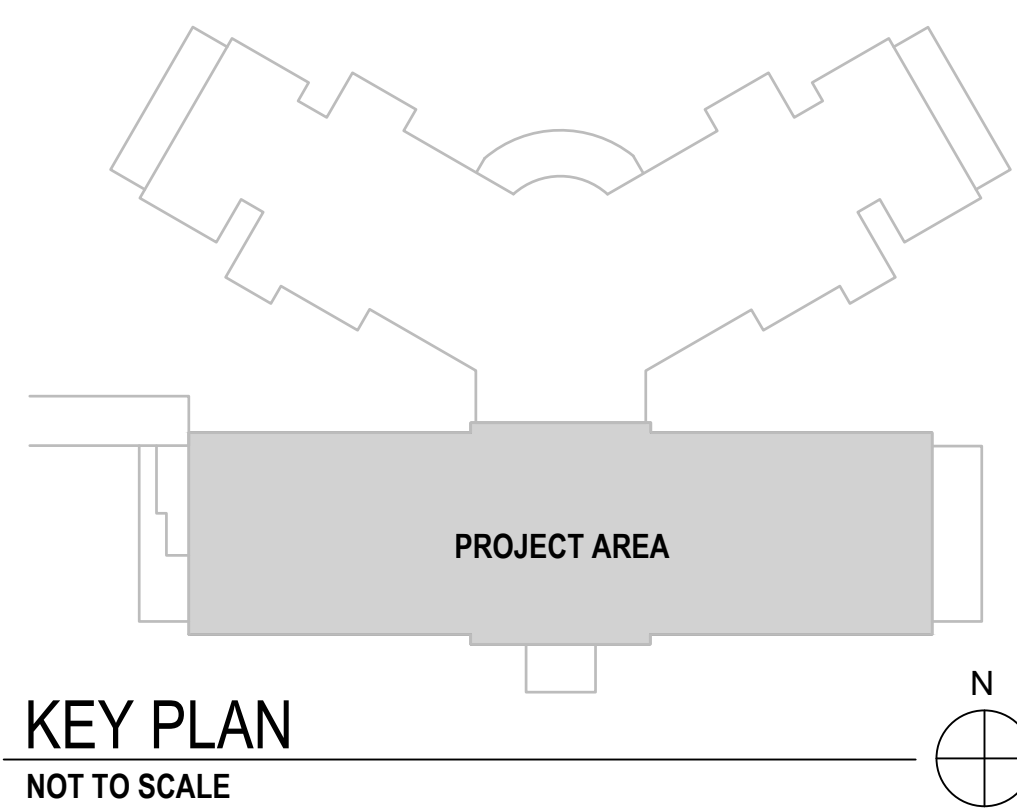
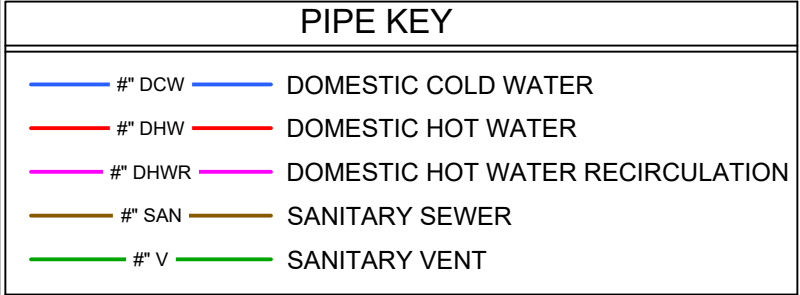
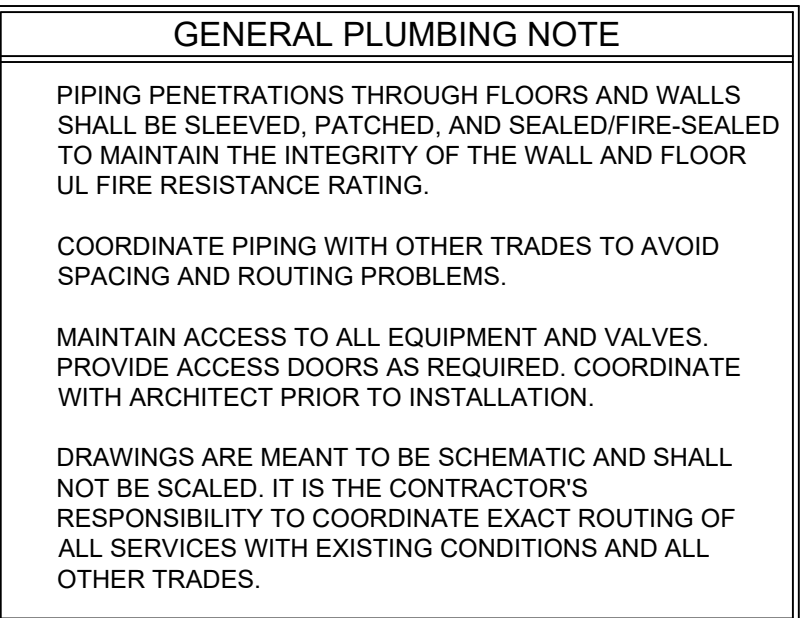
PIPE KEY	
— 1" DCW	DOMESTIC COLD WATER
— 1" DHW	DOMESTIC HOT WATER
— 1" DHWR	DOMESTIC HOT WATER RECIRCULATION
— 1" SAN	SANITARY SEWER
— 1" V	SANITARY VENT




KEY PLAN
NOT TO SCALE

CONSTRUCTION DOCUMENTS
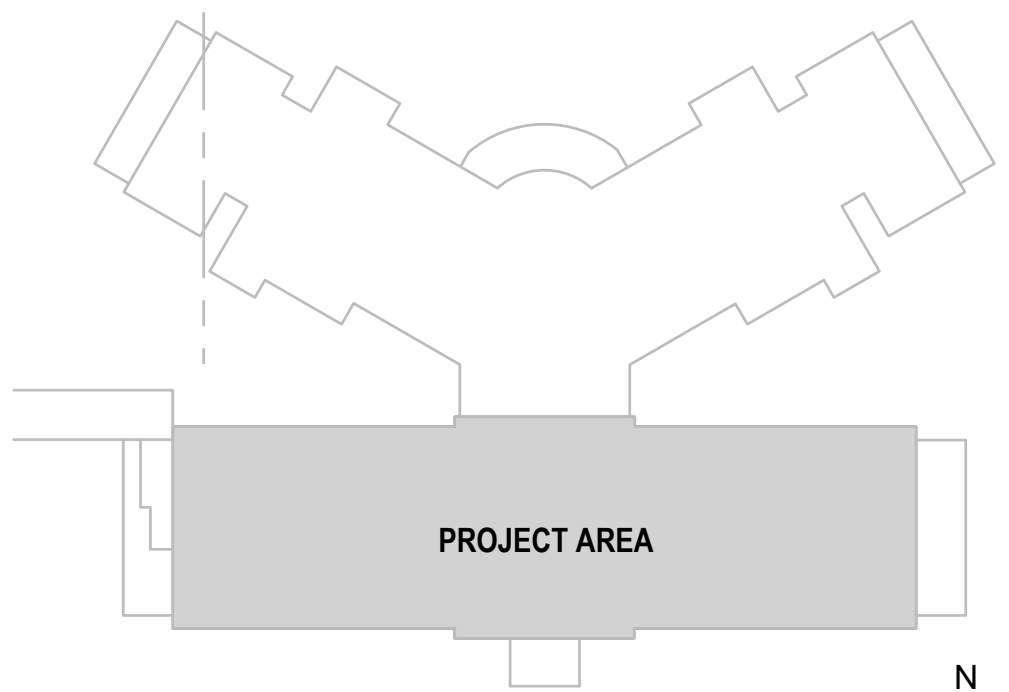
<div>Revisions:</div> <div>Date</div>	CONSULTANTS: <div><div>TERRASITE DESIGN 1635 DEADWOOD AVENUE RAPID CITY, SOUTH DAKOTA 57702 PH: (605) 791-1736</div><div>MORRISON-MAIERLE 2200 FOOTHILLS BLVD, SUITE A GILLETTE, WYOMING 82716 PH: (307) 685-3780</div><div>ALBERTSON ENGINEERING, INC. 3202 WEST MAIN STREET, SUITE C RAPID CITY, SOUTH DAKOTA 57702 PH: (605) 343-9606</div></div> <div><div>DAWES ENGINEERING & DESIGN CO. 46 HIBBARD WAY HELENA, MONTANA 59601 PH: (406) 441-4000</div><div>SUMMIT COMPANIES 575 MINNEHAHA AVENUE WEST ST. PAUL, MINNESOTA 55103 PH: (651) 251-1880</div></div>	<div><div><div>Professional Engineer Rapid City WYOMING</div></div><div><div>ARCHITECT</div><div><div>FOURFRONT DESIGN INC.</div><div>517 7TH STREET RAPID CITY, SOUTH DAKOTA 57701 PH: (605) 342-9470 FAX: (605) 342-2377 WWW.FOURFRONTDESIGN.COM</div></div></div><div>15.2226.17</div></div>	<div>Drawing Title</div> <div>BASEMENT PLUMBING PLAN</div> <div>Approved: Project Director</div> <div>Owner</div>	<div>Project Title</div> <div>BUILDING 64 FOLLOW-ON RENOVATION - SHERIDAN VA MEDICAL CENTER</div> <div>Location</div> <div>SHERIDAN, WYOMING</div> <div>Date</div> <div>AUGUST 28, 2020</div> <div>Checked</div> <div>RD</div> <div>Drawn</div> <div>PM - WW</div>	<div>Project Number</div> <div>666-18-103</div> <div>Building Number</div> <div>64</div> <div>Drawing Number</div> <div>M 501</div> <div>Dwg. 84 of 115</div>	<div>Office of Construction and Facilities Management</div> <div><div>Department of Veterans Affairs</div></div>
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VA FORM 08-6231

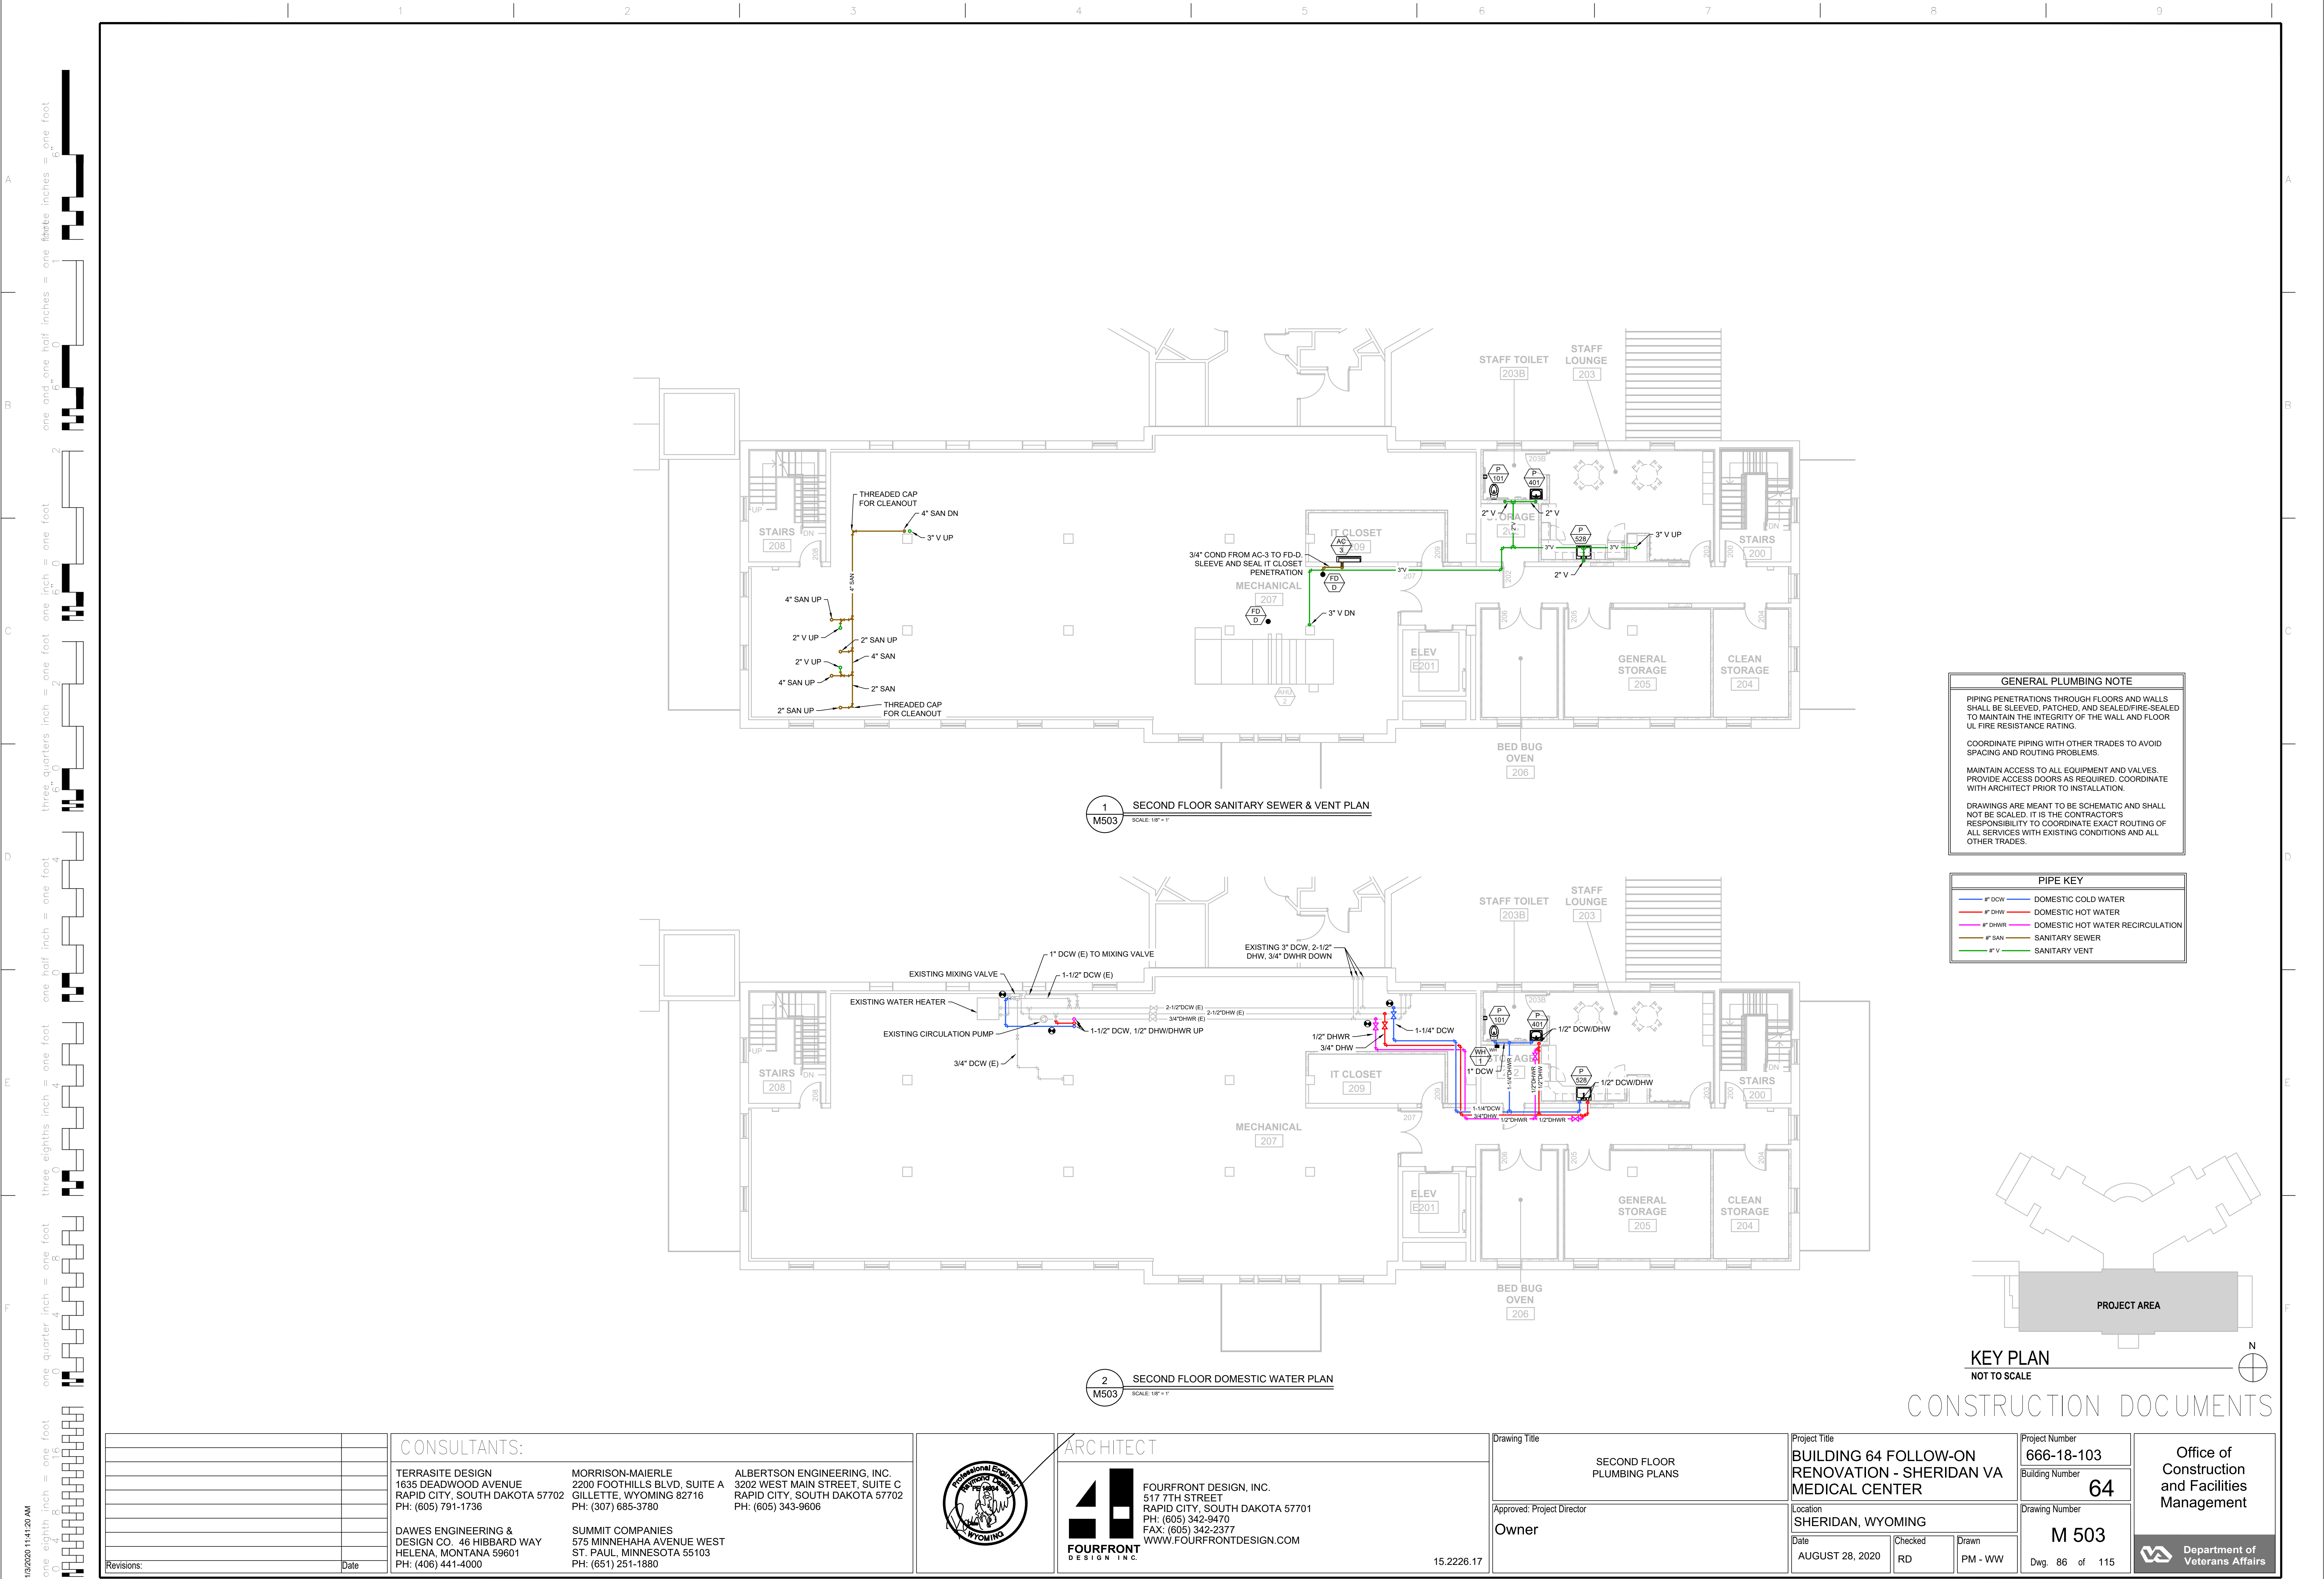


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

one eighth inch = one foot
one quarter inch = one foot
three eighths inch = one foot
one half inch = one foot
three quarters inch = one foot
one inch = one foot
one and one half inches = one foot
two inches = one foot
three inches = one foot
four inches = one foot
six inches = one foot
one foot = one foot

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2 THIRD FLOOR DOMESTIC WATER PLAN
M504 SCALE: 1/8" = 1'



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	4" DCW	DOMESTIC COLD WATER
	4" DHW	DOMESTIC HOT WATER
	4" DHWR	DOMESTIC HOT WATER RECIRCULATION
	4" SAN	SANITARY SEWER
	4" V	SANITARY VENT

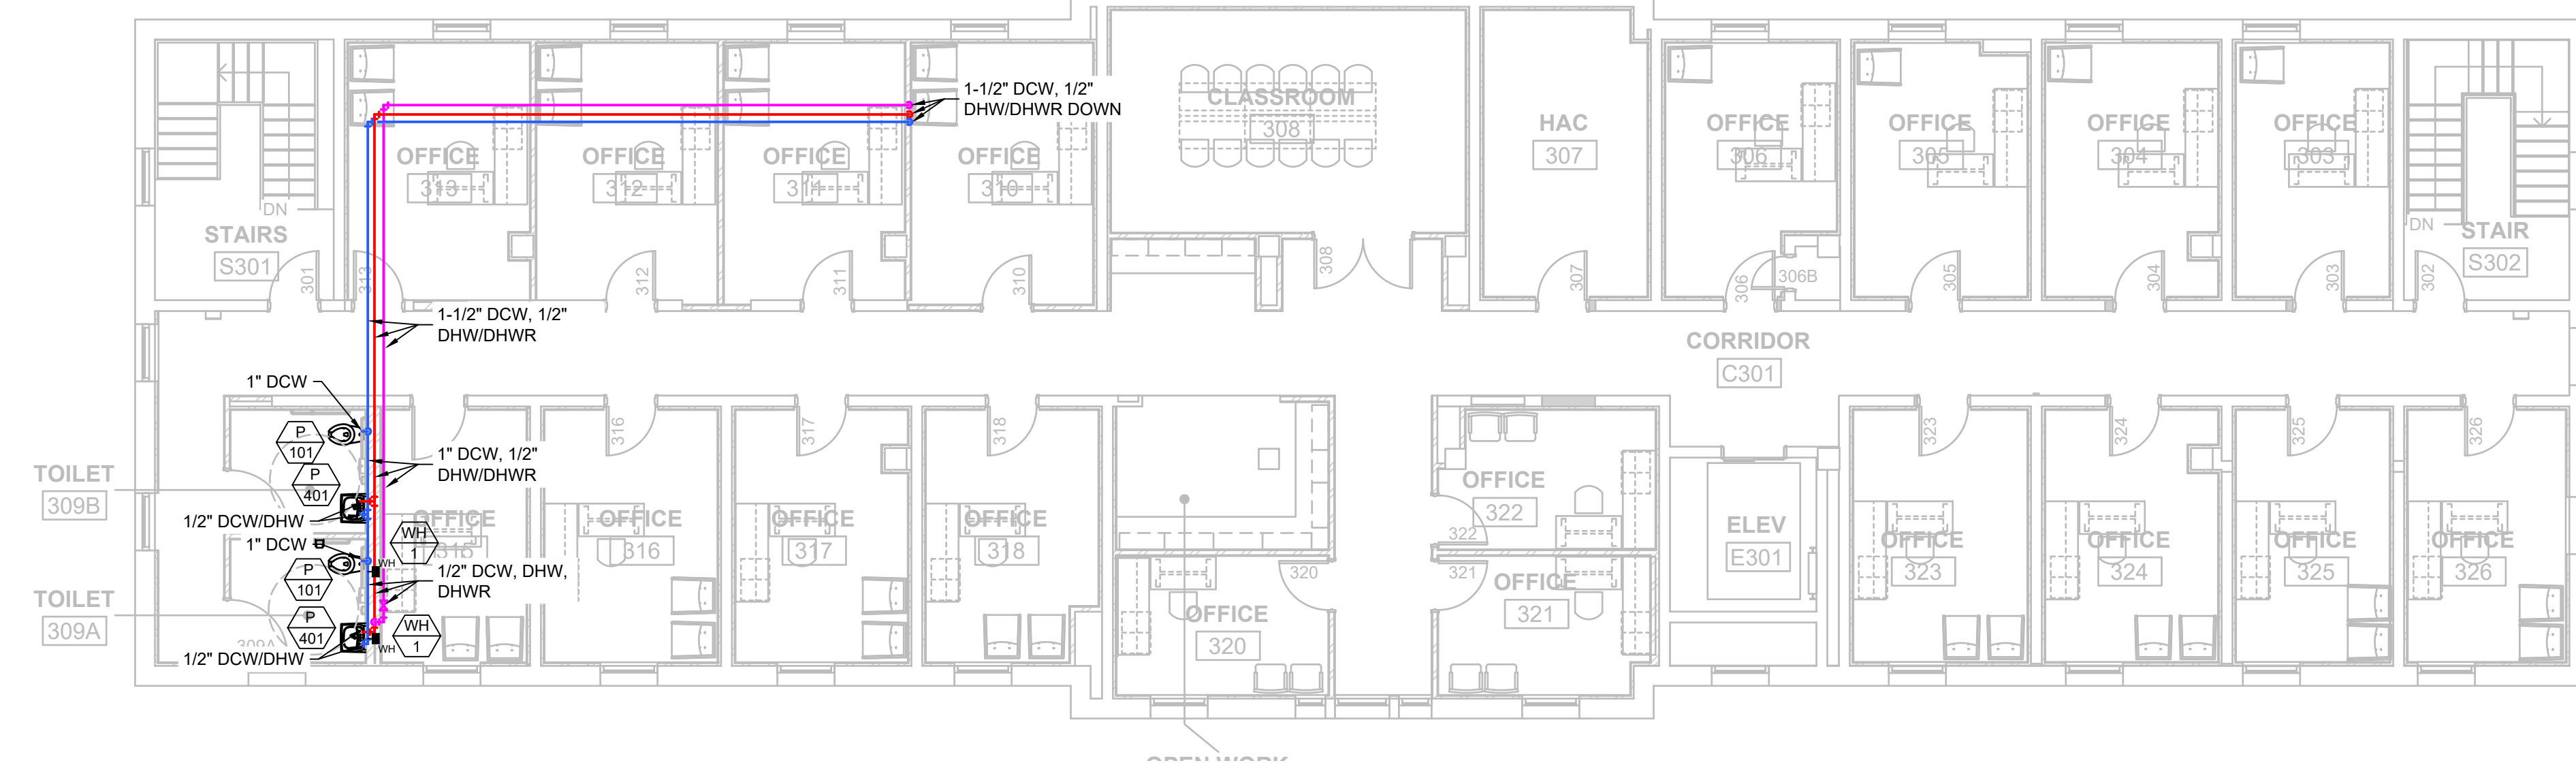

CONSTRUCTION DOCUMENTS

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CONSTRUCTION DOCUMENTS

		CONSULTANTS:				ARCHITECT				Drawing Title		Project Title		Project Number		Office of Construction and Facilities Management	
		TERRASITE DESIGN 1635 DEADWOOD AVENUE RAPID CITY, SOUTH DAKOTA 57702 PH: (605) 791-1736		MORRISON-MAIERLE 3200 WEST MAIN STREET, SUITE A GILLETTE, WYOMING 82716 PH: (307) 685-3780		ALBERTSON ENGINEERING, INC. 3117 7TH STREET RAPID CITY, SOUTH DAKOTA 57701 PH: (605) 342-9470 FAX: (605) 342-2377 WWW.FOURFRONTDESIGN.COM		NEW DOMESTIC WATER ISOMETRIC PLAN		BUILDING 64 FOLLOW-ON RENOVATION - SHERIDAN VA MEDICAL CENTER		666-18-103		Building Number 64		 Department of Veterans Affairs	
		DAWES ENGINEERING & DESIGN CO. 46 HIBBARD WAY HELENA, MONTANA 59601 PH: (406) 441-4000		SUMMIT COMPANIES 575 MINNEHAHA AVENUE WEST ST. PAUL, MINNESOTA 55103 PH: (651) 251-1880				Approved: Project Director Owner		Location SHERIDAN, WYOMING		Drawing Number M 505		Dwg. 88 of 115			
Revisions:		Date						15.2226.17				Date AUGUST 28, 2020		Checked RD		Drawn PM - WW	

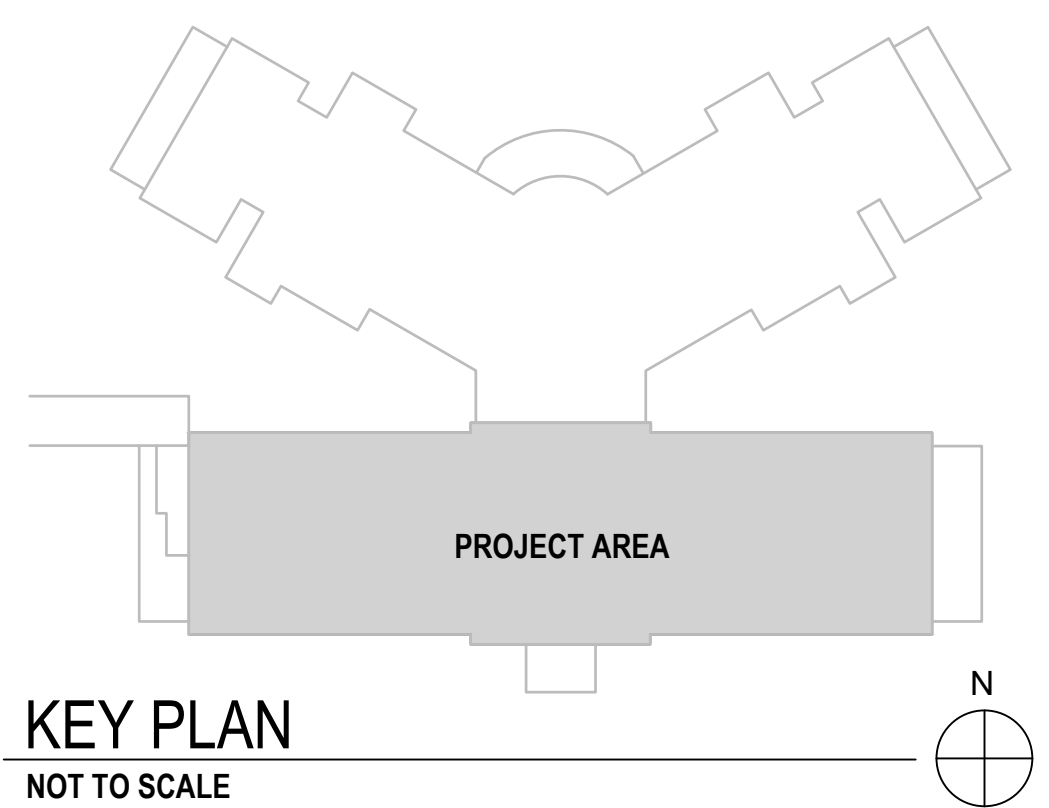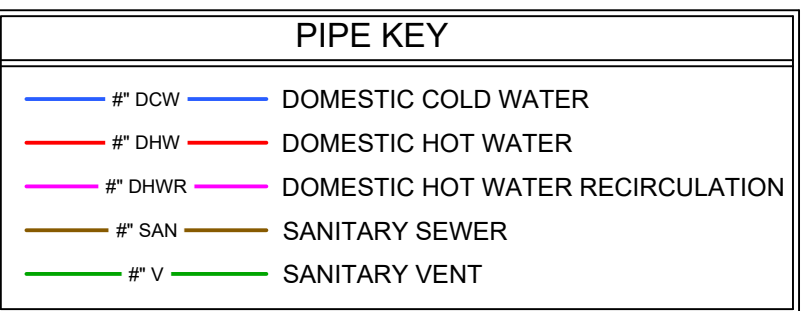one eighth inch = one foot
one quarter inch = one foot
three eighths inch = one foot
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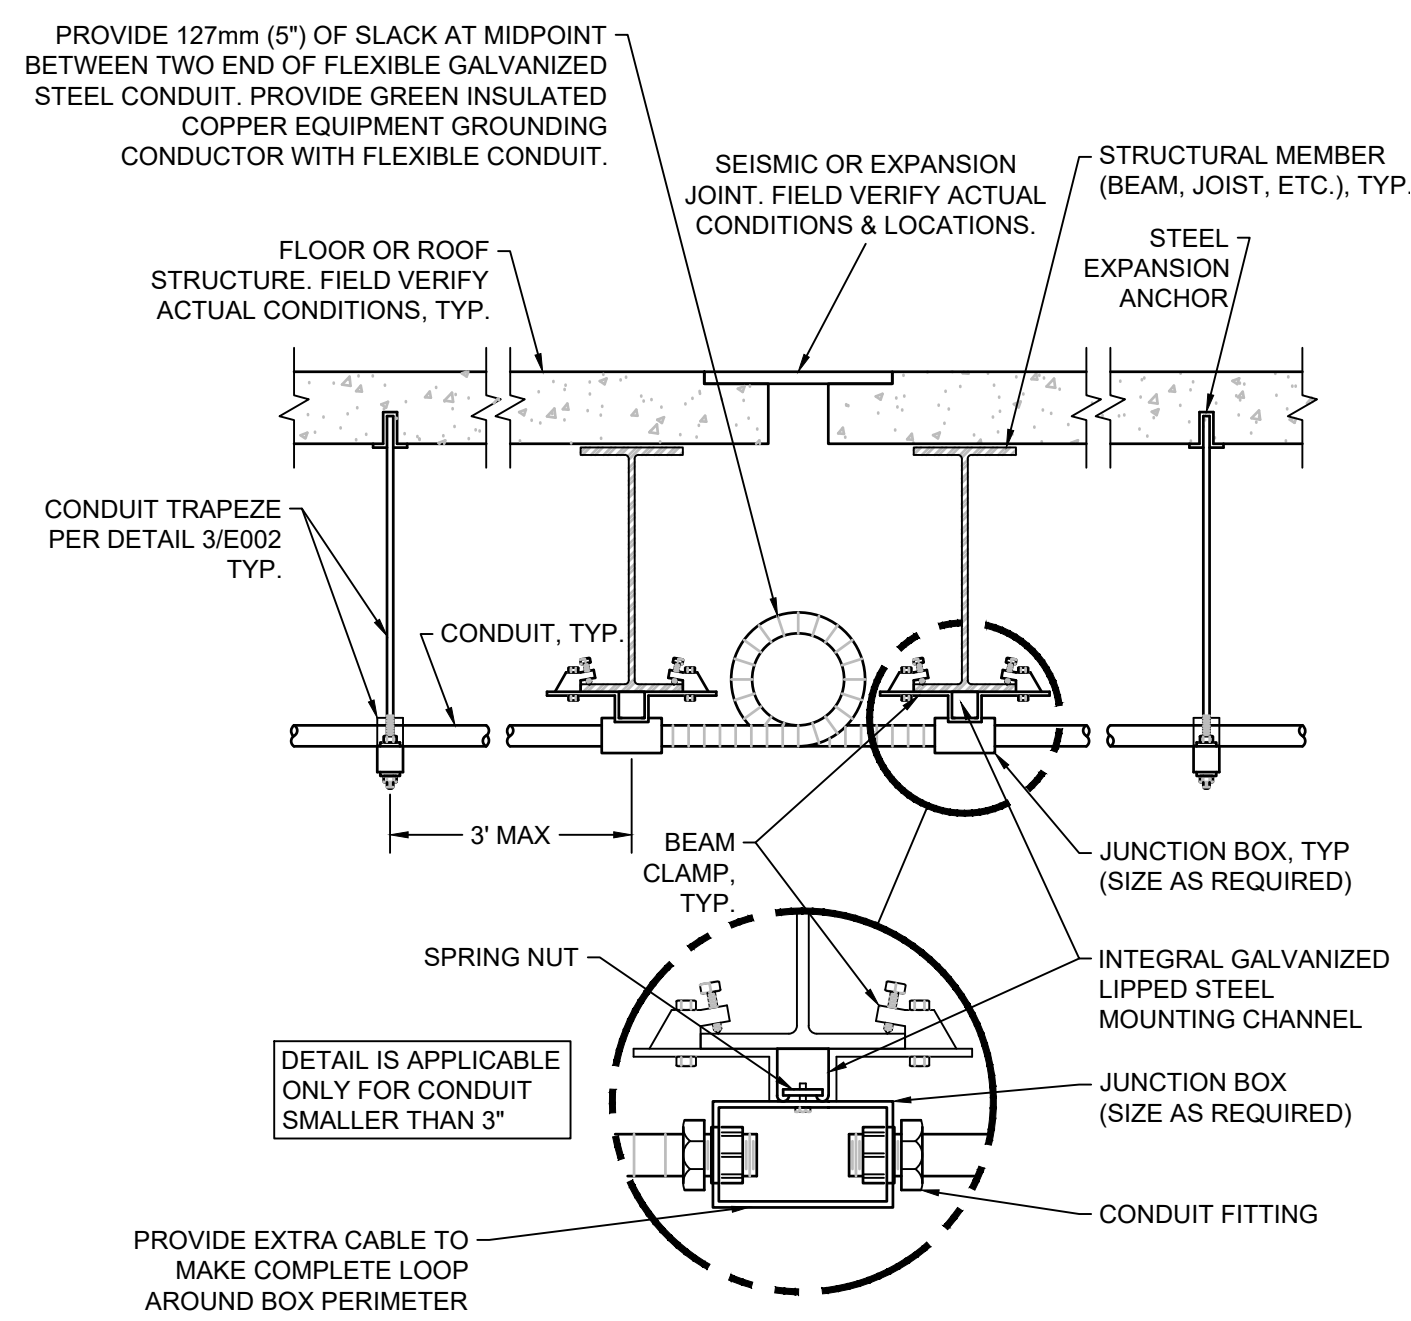
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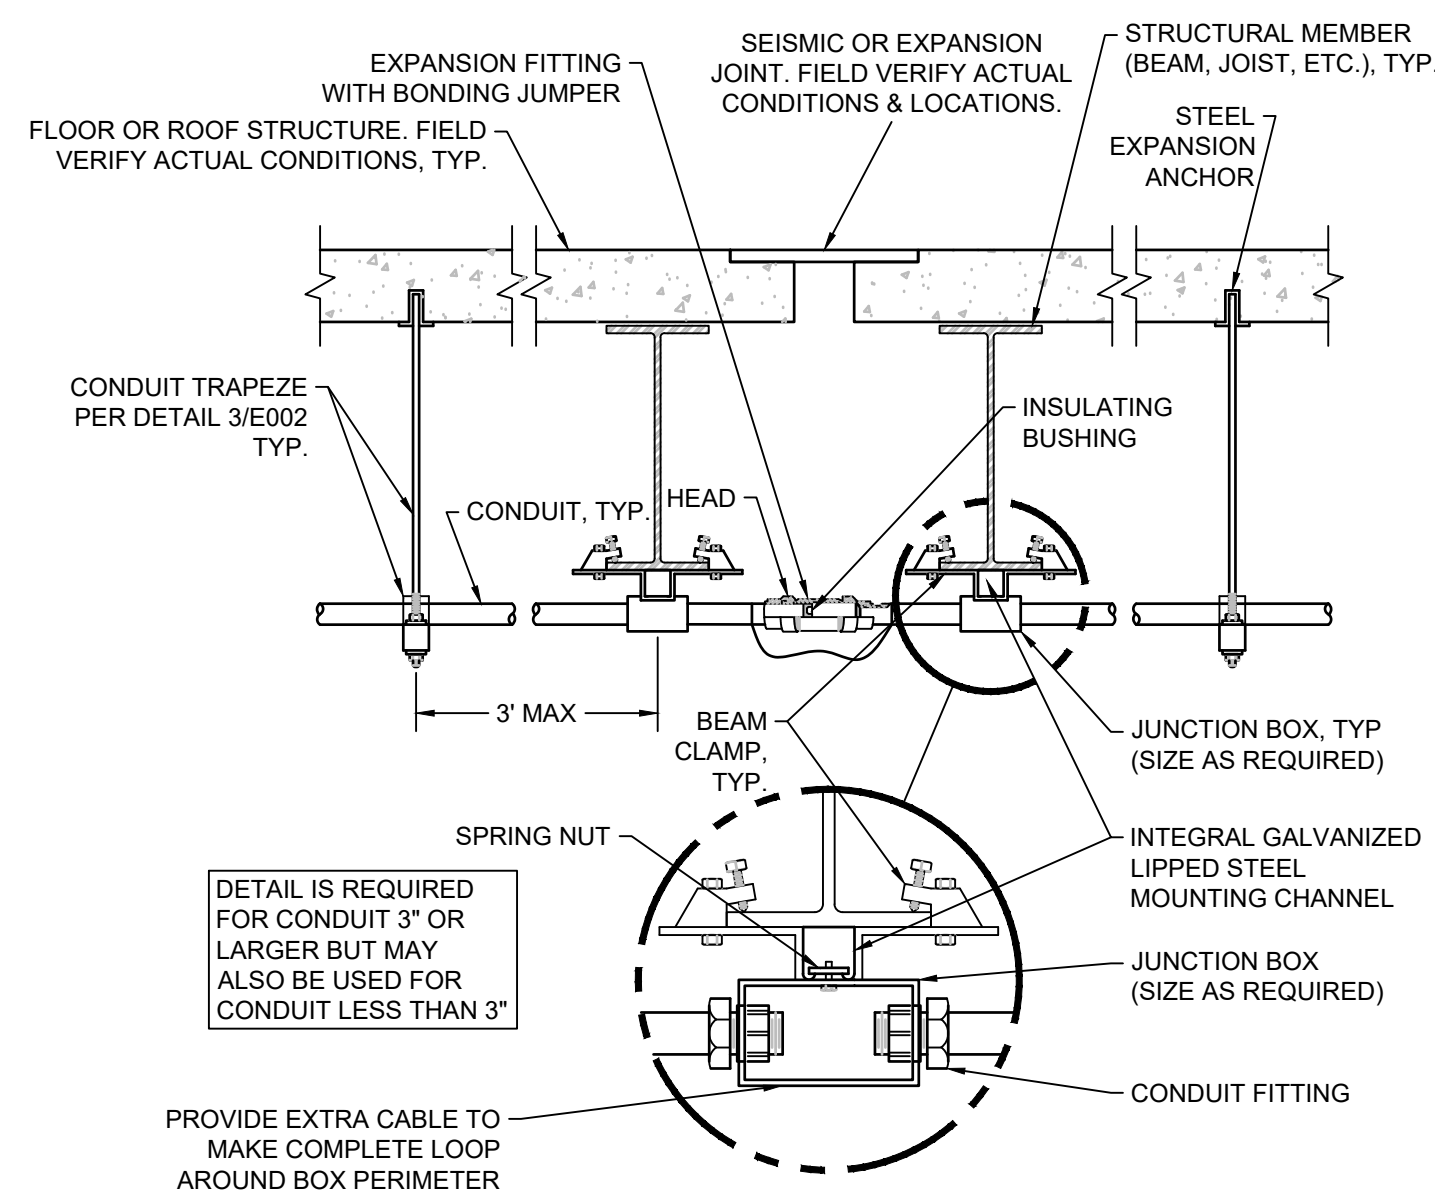
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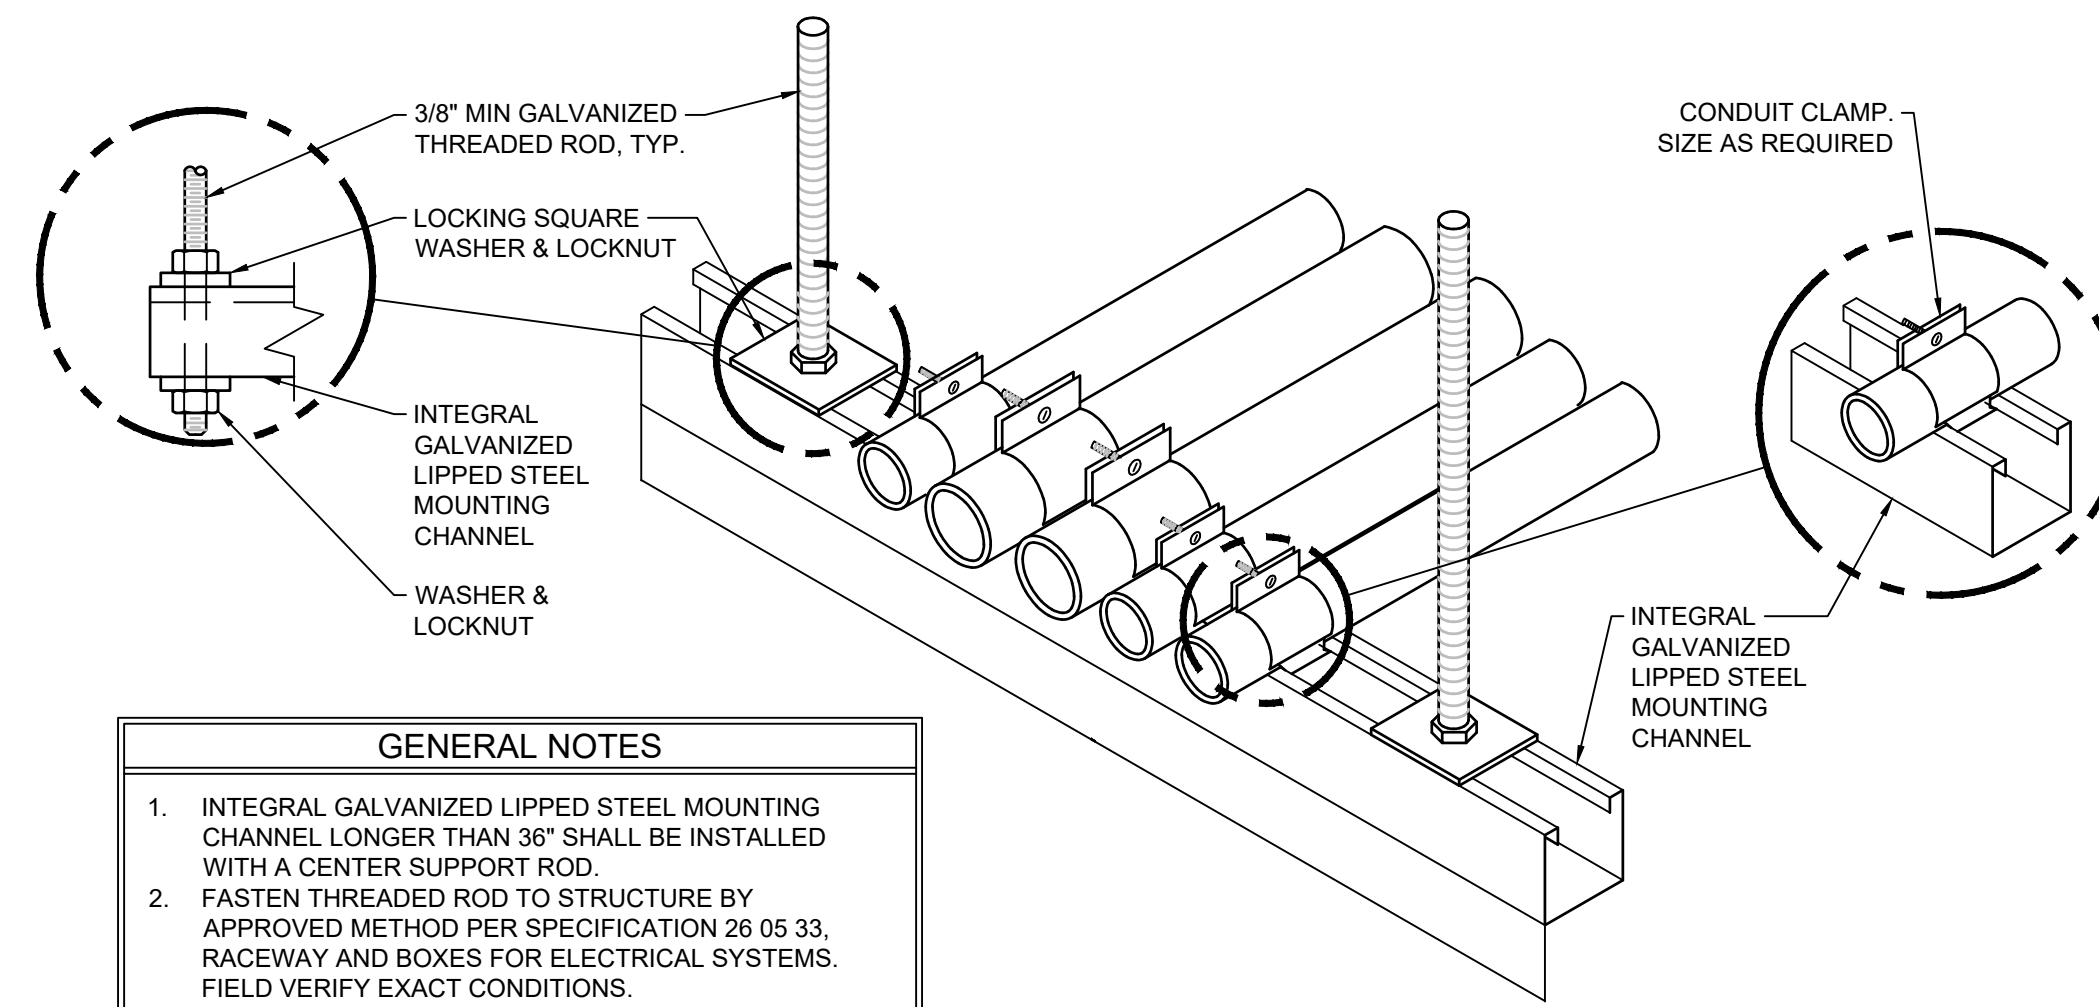
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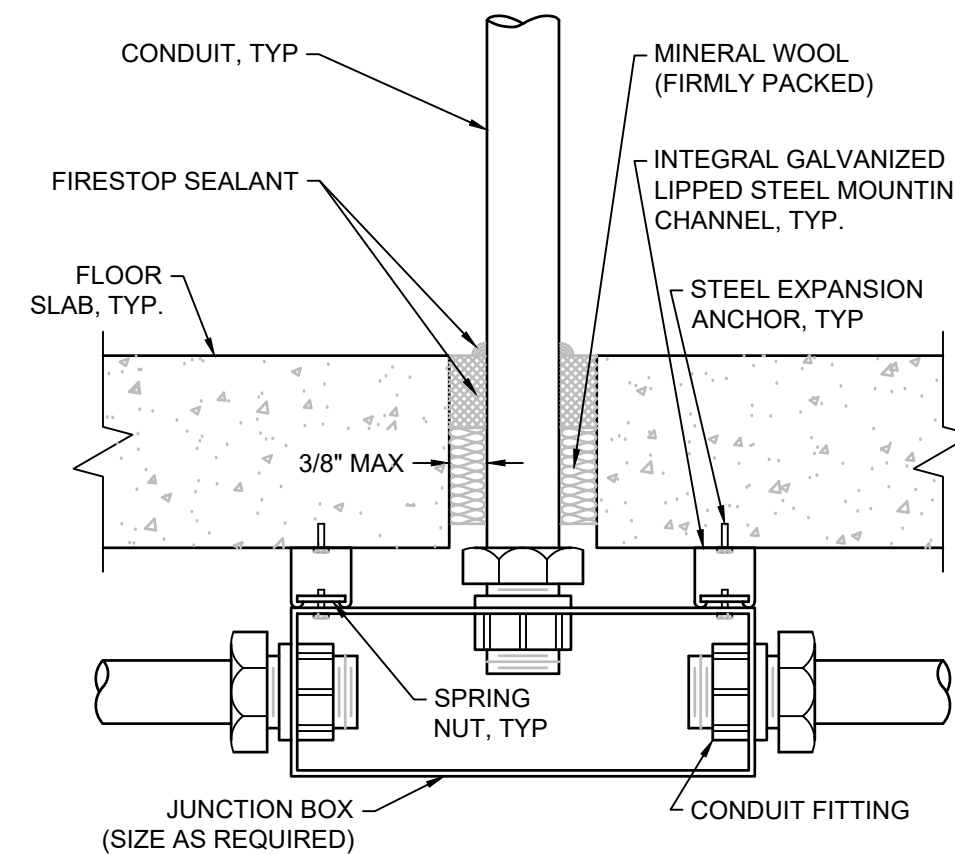
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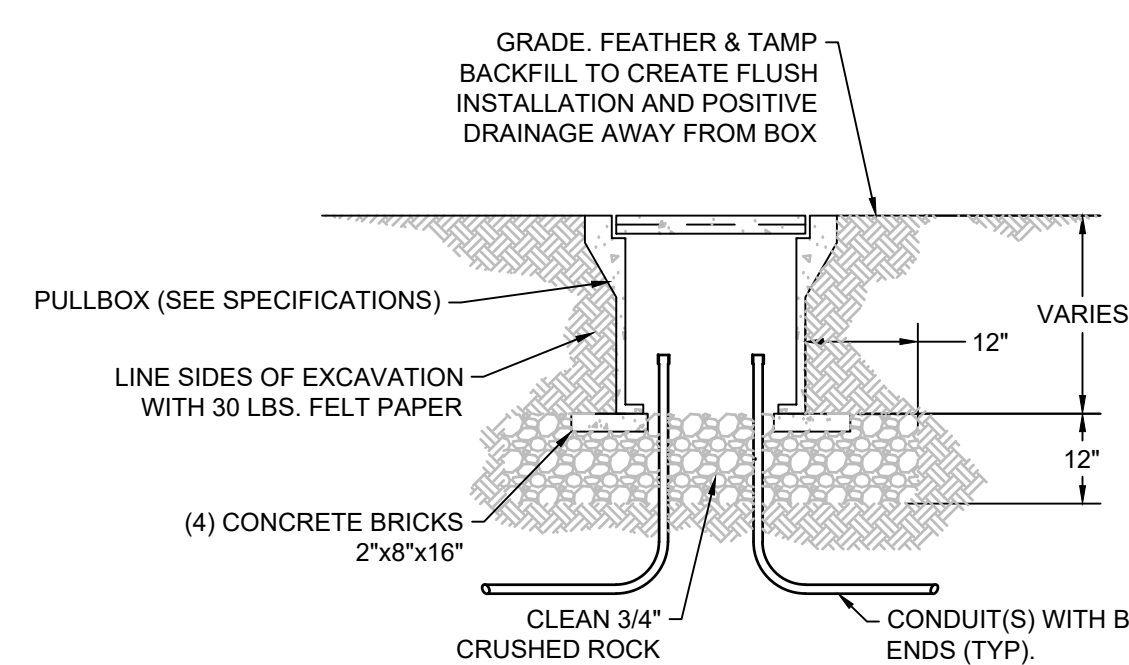
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CONDUIT EXPANSION JOINT CROSSING - EXPANSION FITTING




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CONDUIT TRAPEZE MOUNTING DETAIL




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FLOOR SLAB PENETRATION DETAIL




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UNDERGROUND CONCRETE PULLBOX - TURF AREAS

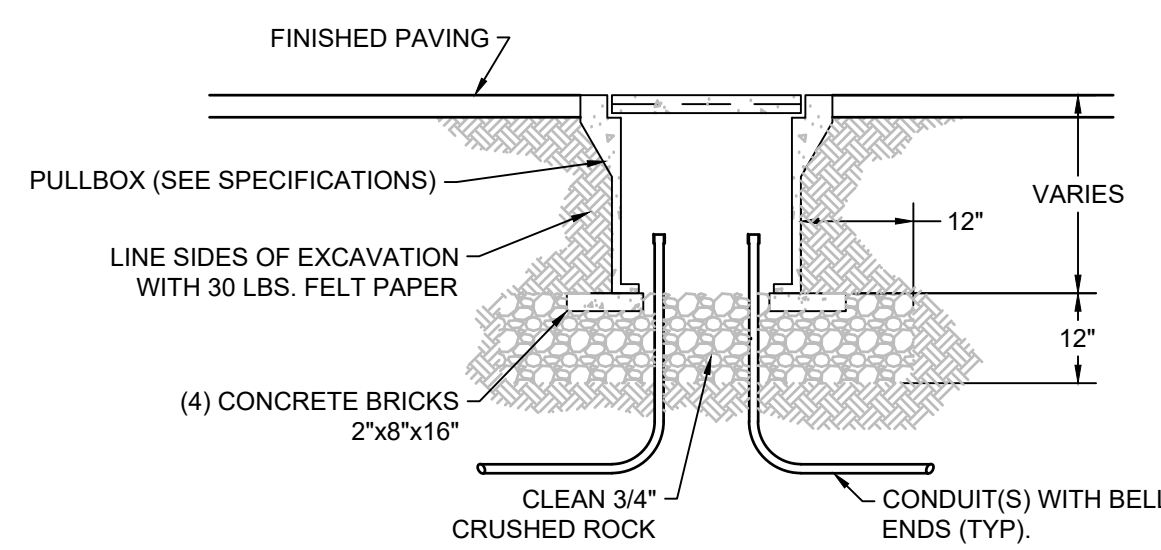


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UNDERGROUND CONCRETE PULLBOX - PAVED AREAS

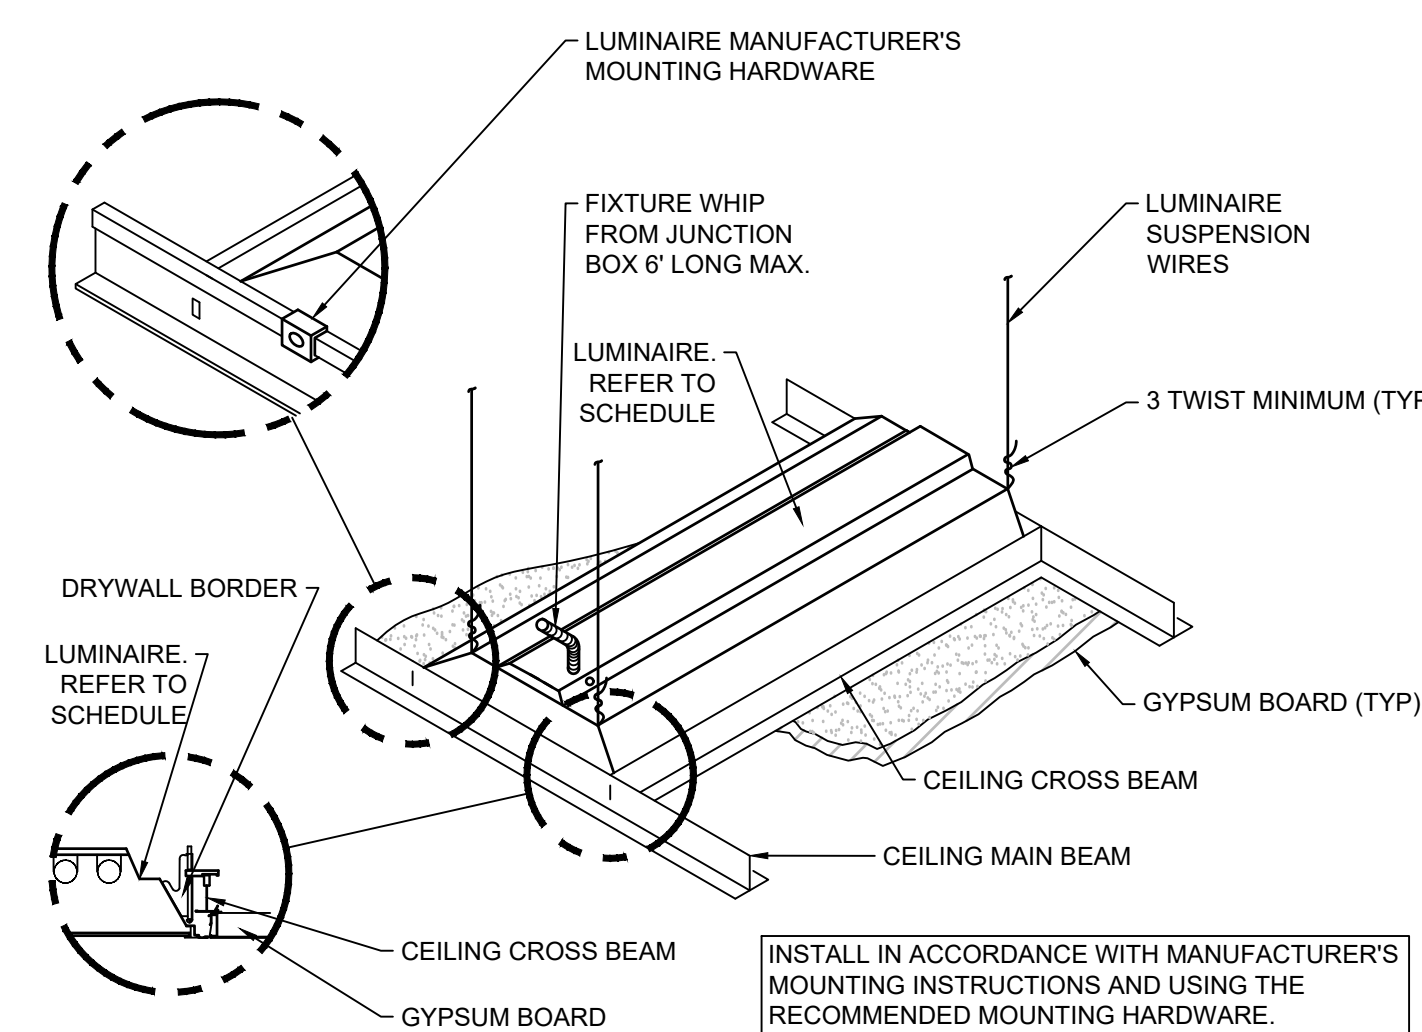


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LUMINAIRE MOUNTING - GYPBOARD CEILING

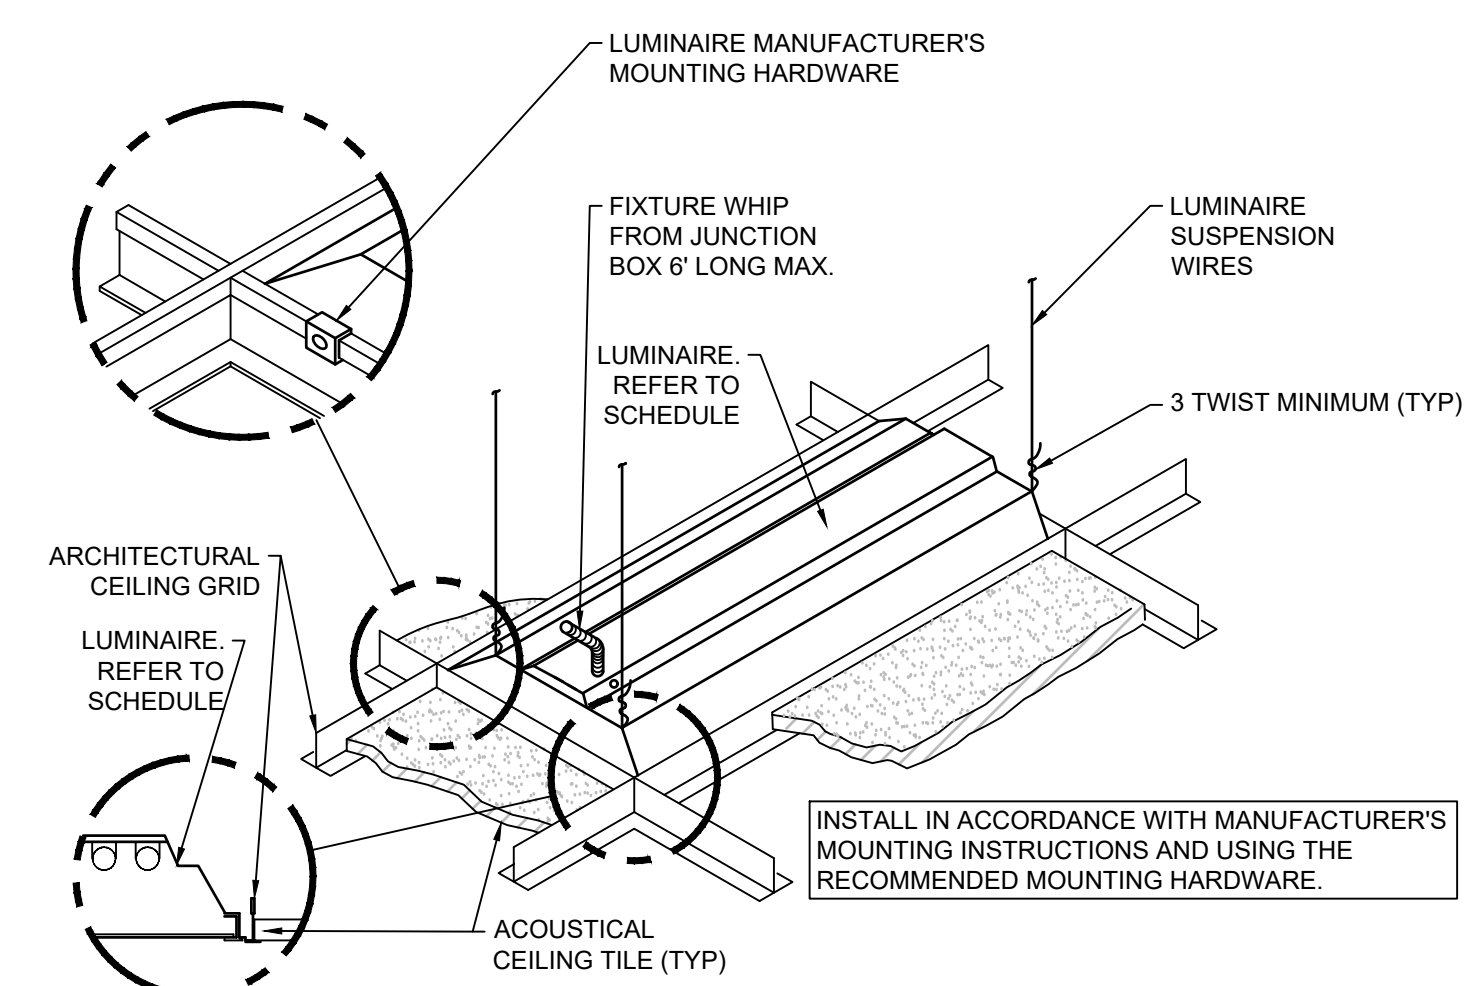


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SCALE: NTS
LUMINAIRE MOUNTING - LAY IN CEILING

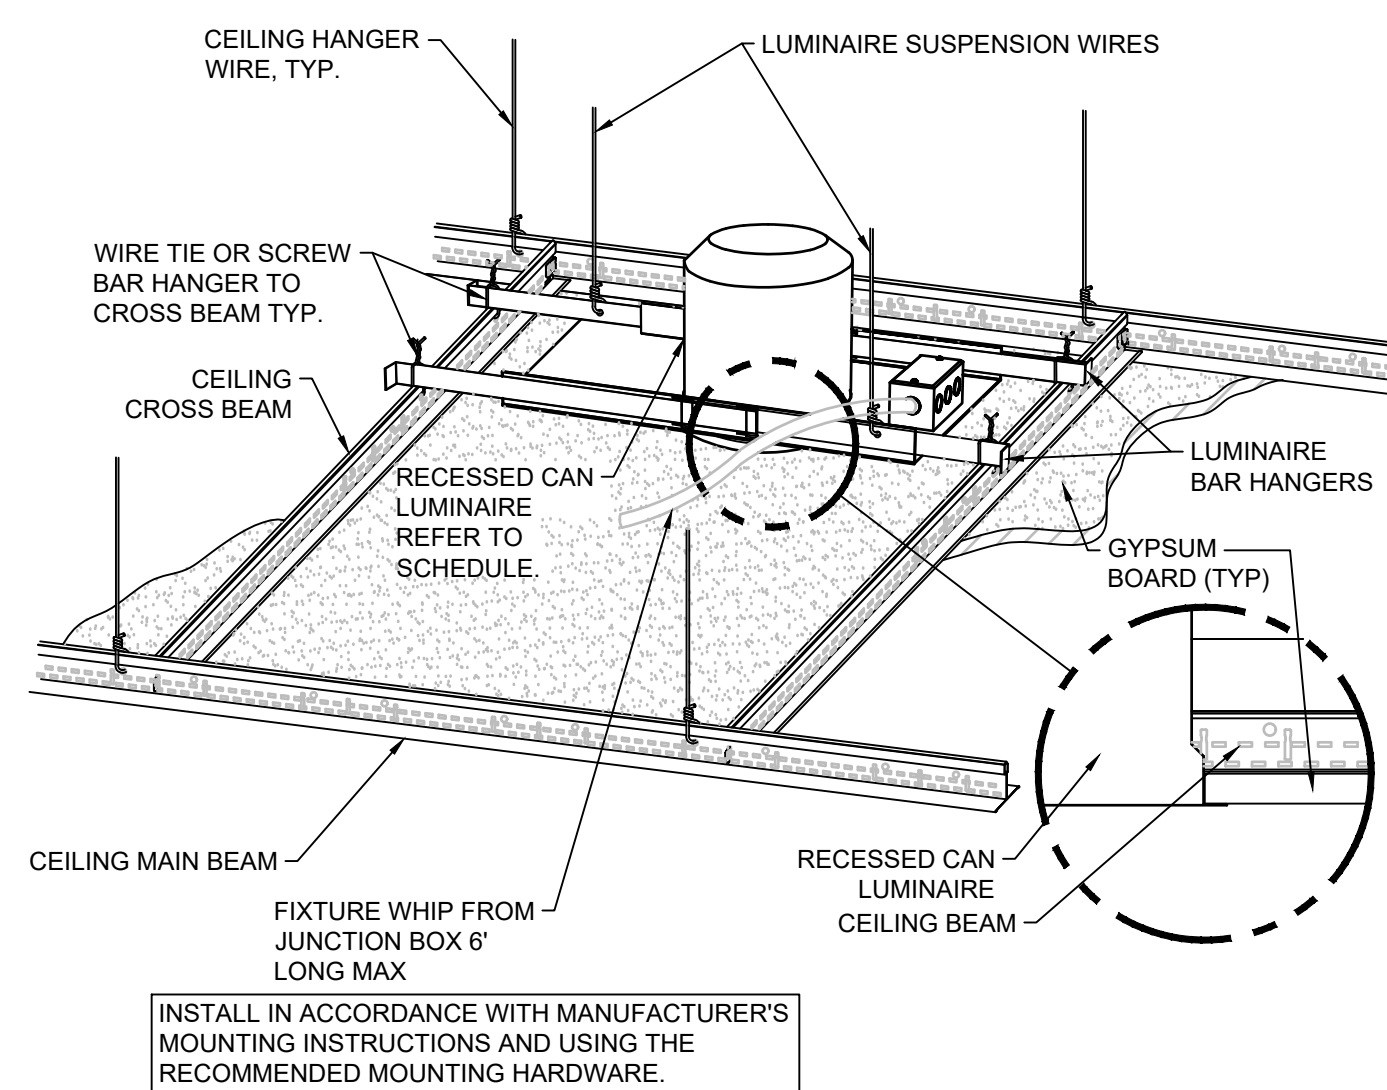


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SCALE: NTS
DOWNLIGHT MOUNTING - GYPBOARD CEILING

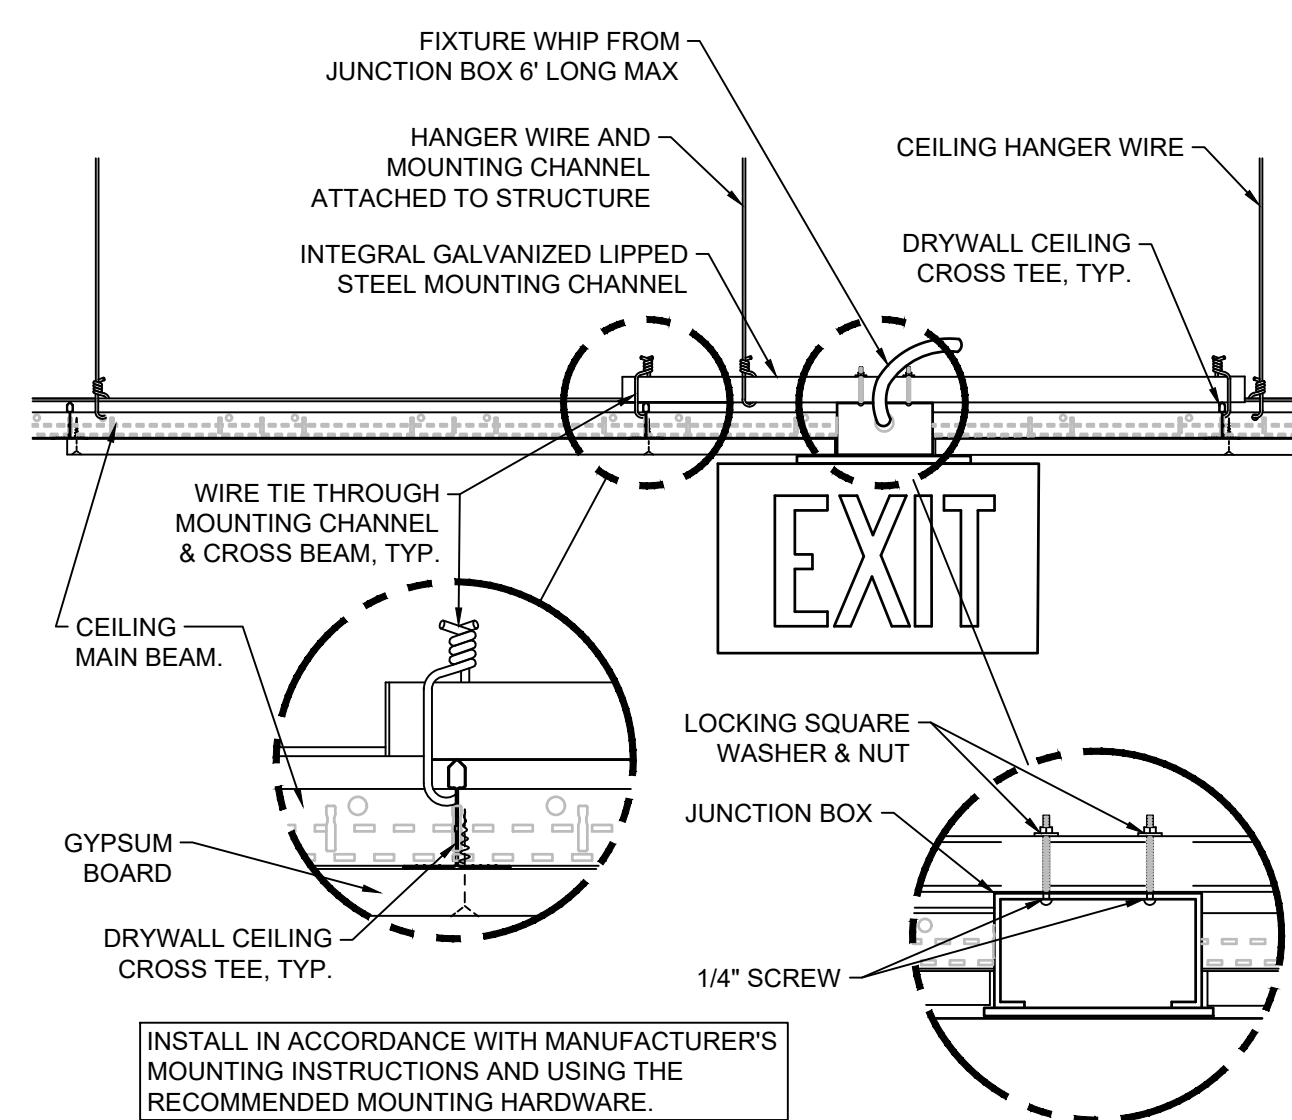

10
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SCALE: NTS
EXIT SIGN MOUNTING - GYPBOARD CEILING

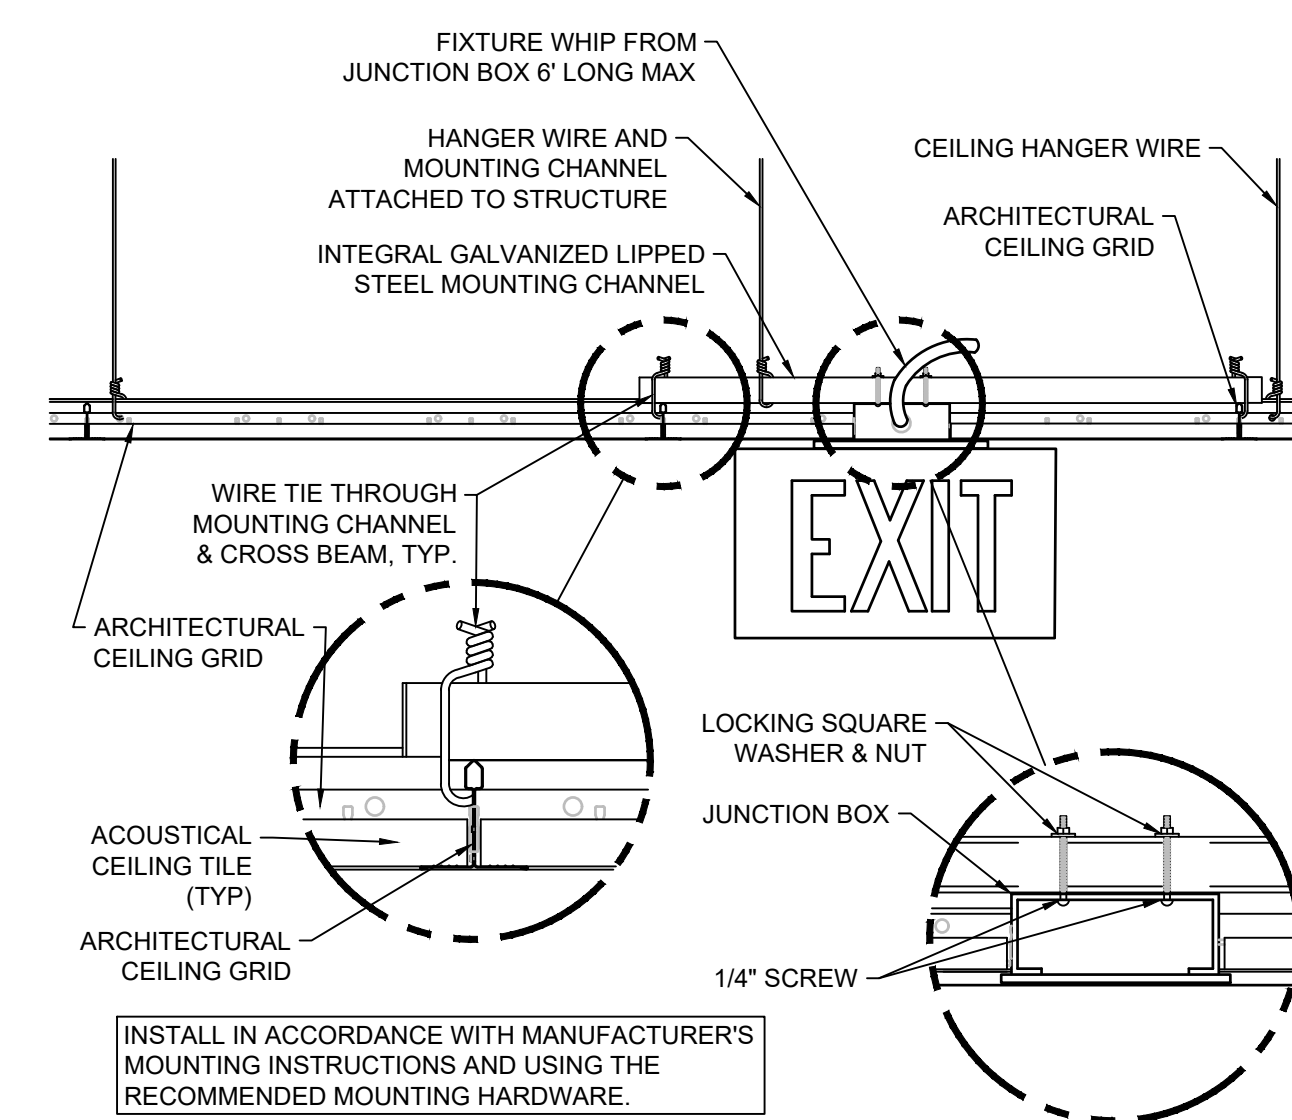


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EXIT SIGN MOUNTING - LAY IN CEILING

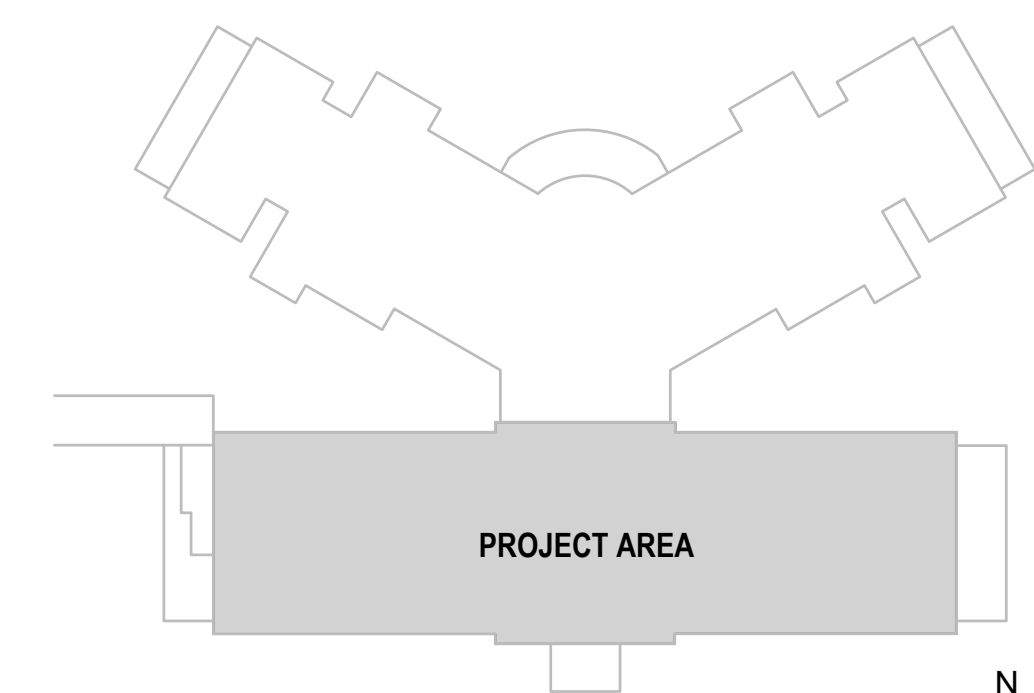

KEY PLAN
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
CONSTRUCTION DOCUMENTS

		CONSULTANTS:				ARCHITECT		Drawing Title		Project Title		Project Number		<div>Office of Construction and Facilities Management</div> <div>Department of Veterans Affairs</div>			
		TERRASITE DESIGN 1635 DEADWOOD AVENUE RAPID CITY, SOUTH DAKOTA 57702 PH: (605) 791-1736		MORRISON-MAIERLE 2200 FOOTHILLS BLVD, SUITE A GILLETTE, WYOMING 82716 PH: (307) 685-3780		ALBERTSON ENGINEERING, INC. 3202 WEST MAIN STREET, SUITE C RAPID CITY, SOUTH DAKOTA 57702 PH: (605) 343-9606		ELECTRICAL DETAILS		BUILDING 64 FOLLOW-ON RENOVATION - SHERIDAN VA MEDICAL CENTER		666-18-103					
		DAWES ENGINEERING & DESIGN CO. 46 HIBBARD WAY HELENA, MONTANA 59601 PH: (406) 441-4000		SUMMIT COMPANIES 575 MINNEHAHA AVENUE WEST ST. PAUL, MINNESOTA 55103 PH: (651) 251-1880		FOURFRONT DESIGN INC. 517 7TH STREET RAPID CITY, SOUTH DAKOTA 57701 PH: (605) 342-9470 FAX: (605) 342-2377 WWW.FOURFRONTDESIGN.COM		Approved: Project Director		Location SHERIDAN, WYOMING		Drawing Number 64					
								Owner		Date AUGUST 28, 2020		Checked RD				E 002	
												Drawn PM - WW				Dwg. 91 of 115	
Revisions:																	



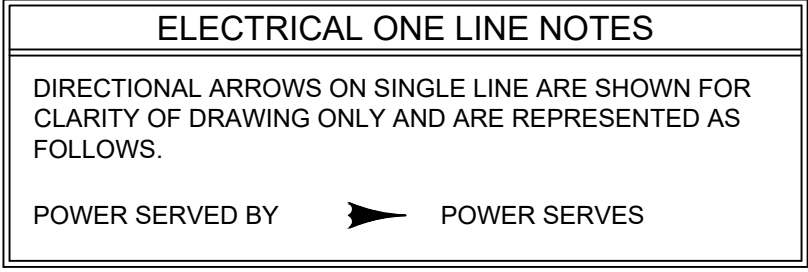


KEY PLAN

NOT TO SCALE





CONSTRUCTION DOCUMENTS

		CONSULTANTS:				ARCHITECT		Drawing Title		Project Title		Project Number		Office of Construction and Facilities Management		
		TERRASITE DESIGN 1635 DEADWOOD AVENUE RAPID CITY, SOUTH DAKOTA 57702 PH: (605) 791-1736		MORRISON-MAIERLE 2200 FOOTHILLS BLVD, SUITE A GILLETTE, WYOMING 82716 PH: (307) 685-3780		ALBERTSON ENGINEERING, INC. 3202 WEST MAIN STREET, SUITE C RAPID CITY, SOUTH DAKOTA 57702 PH: (605) 343-9806		 FOURFRONT DESIGN, INC. 517 7TH STREET RAPID CITY, SOUTH DAKOTA 57701 PH: (605) 342-9470 FAX: (605) 342-2377 WWW.FOURFRONTDESIGN.COM		ELECTRICAL SERVICE SCHEMATIC		BUILDING 64 FOLLOW-ON RENOVATION - SHERIDAN VA MEDICAL CENTER		666-18-103		Office of Construction and Facilities Management
		DAWES ENGINEERING & DESIGN CO. 46 HIBBARD WAY HELENA, MONTANA 59601 PH: (406) 441-4000		SUMMIT COMPANIES 575 MINNEHAHA AVENUE WEST ST. PAUL, MINNESOTA 55103 PH: (651) 251-1880				Approved: Project Director		Location SHERIDAN, WYOMING		Building Number 64		Drawing Number E 003		
								Owner		Date AUGUST 28, 2020		Checked RD			Drawn PM - WW	
Revisions:		Date						15.2226.17								 Department of Veterans Affairs

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one and one half inches = one foot
one inch = one foot
three quarters inch = one foot
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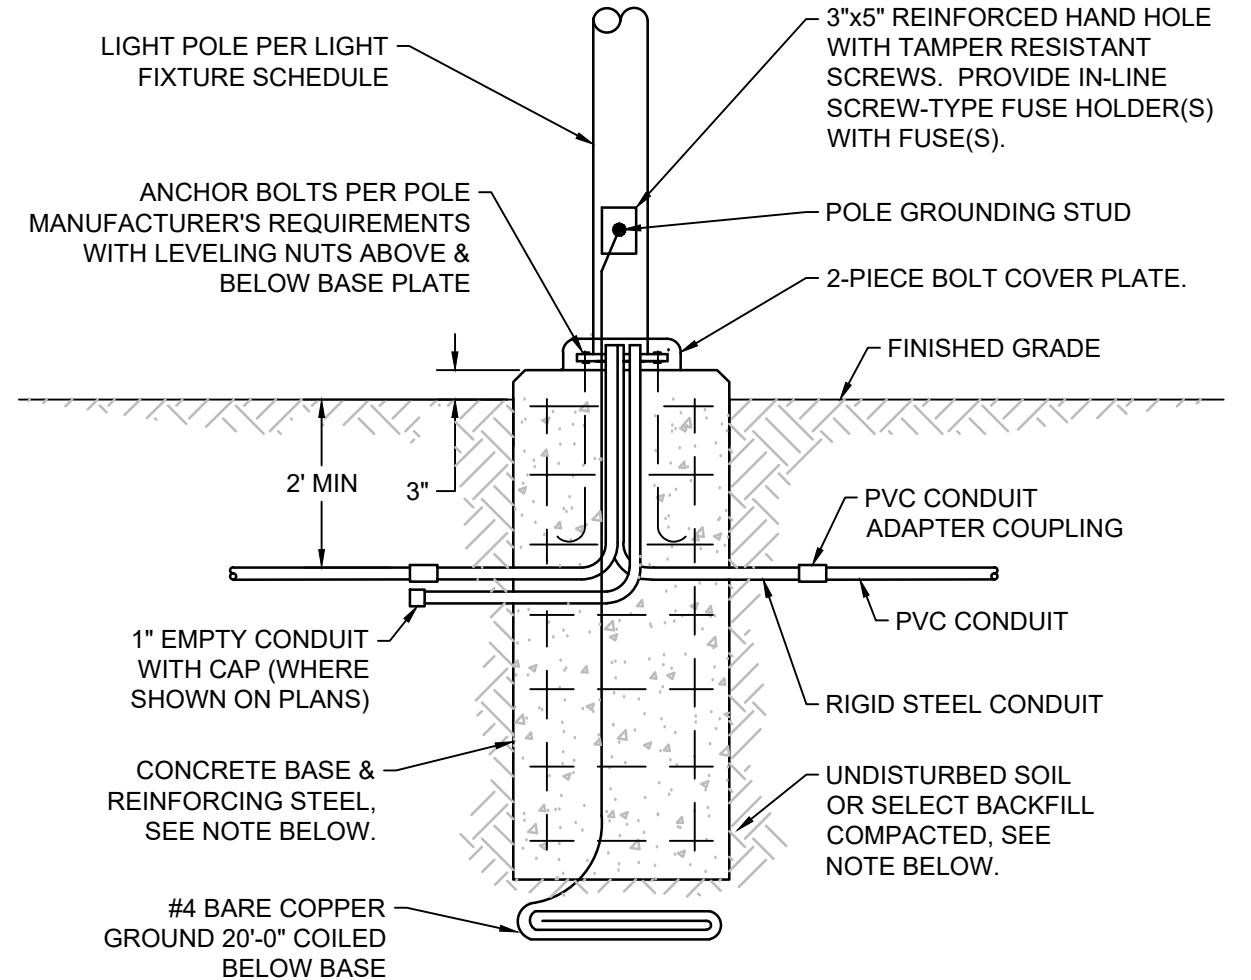


GENERAL NOTES

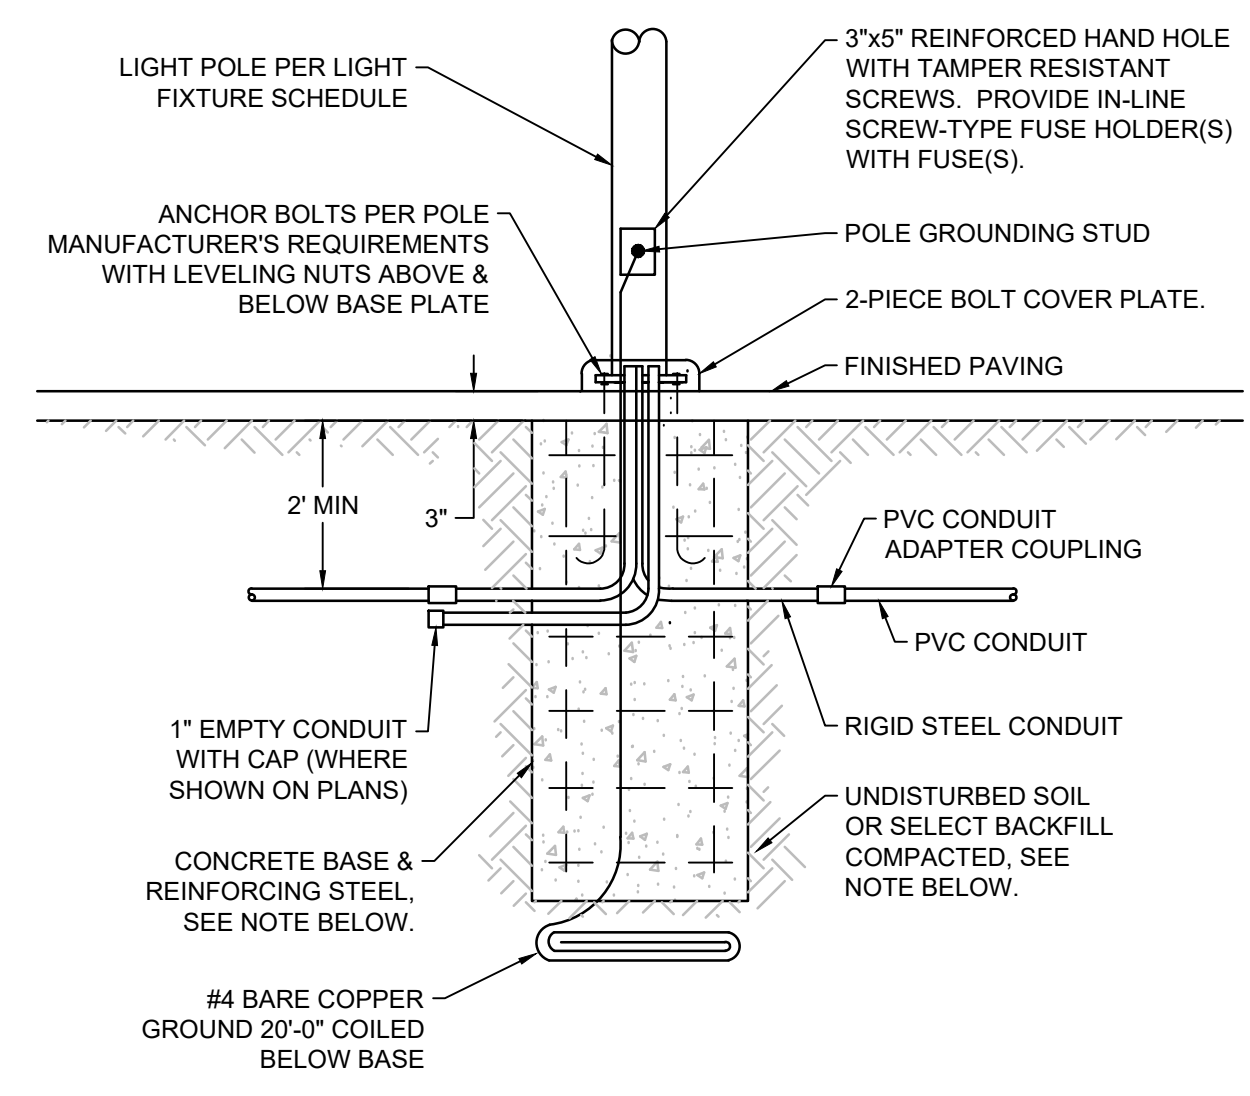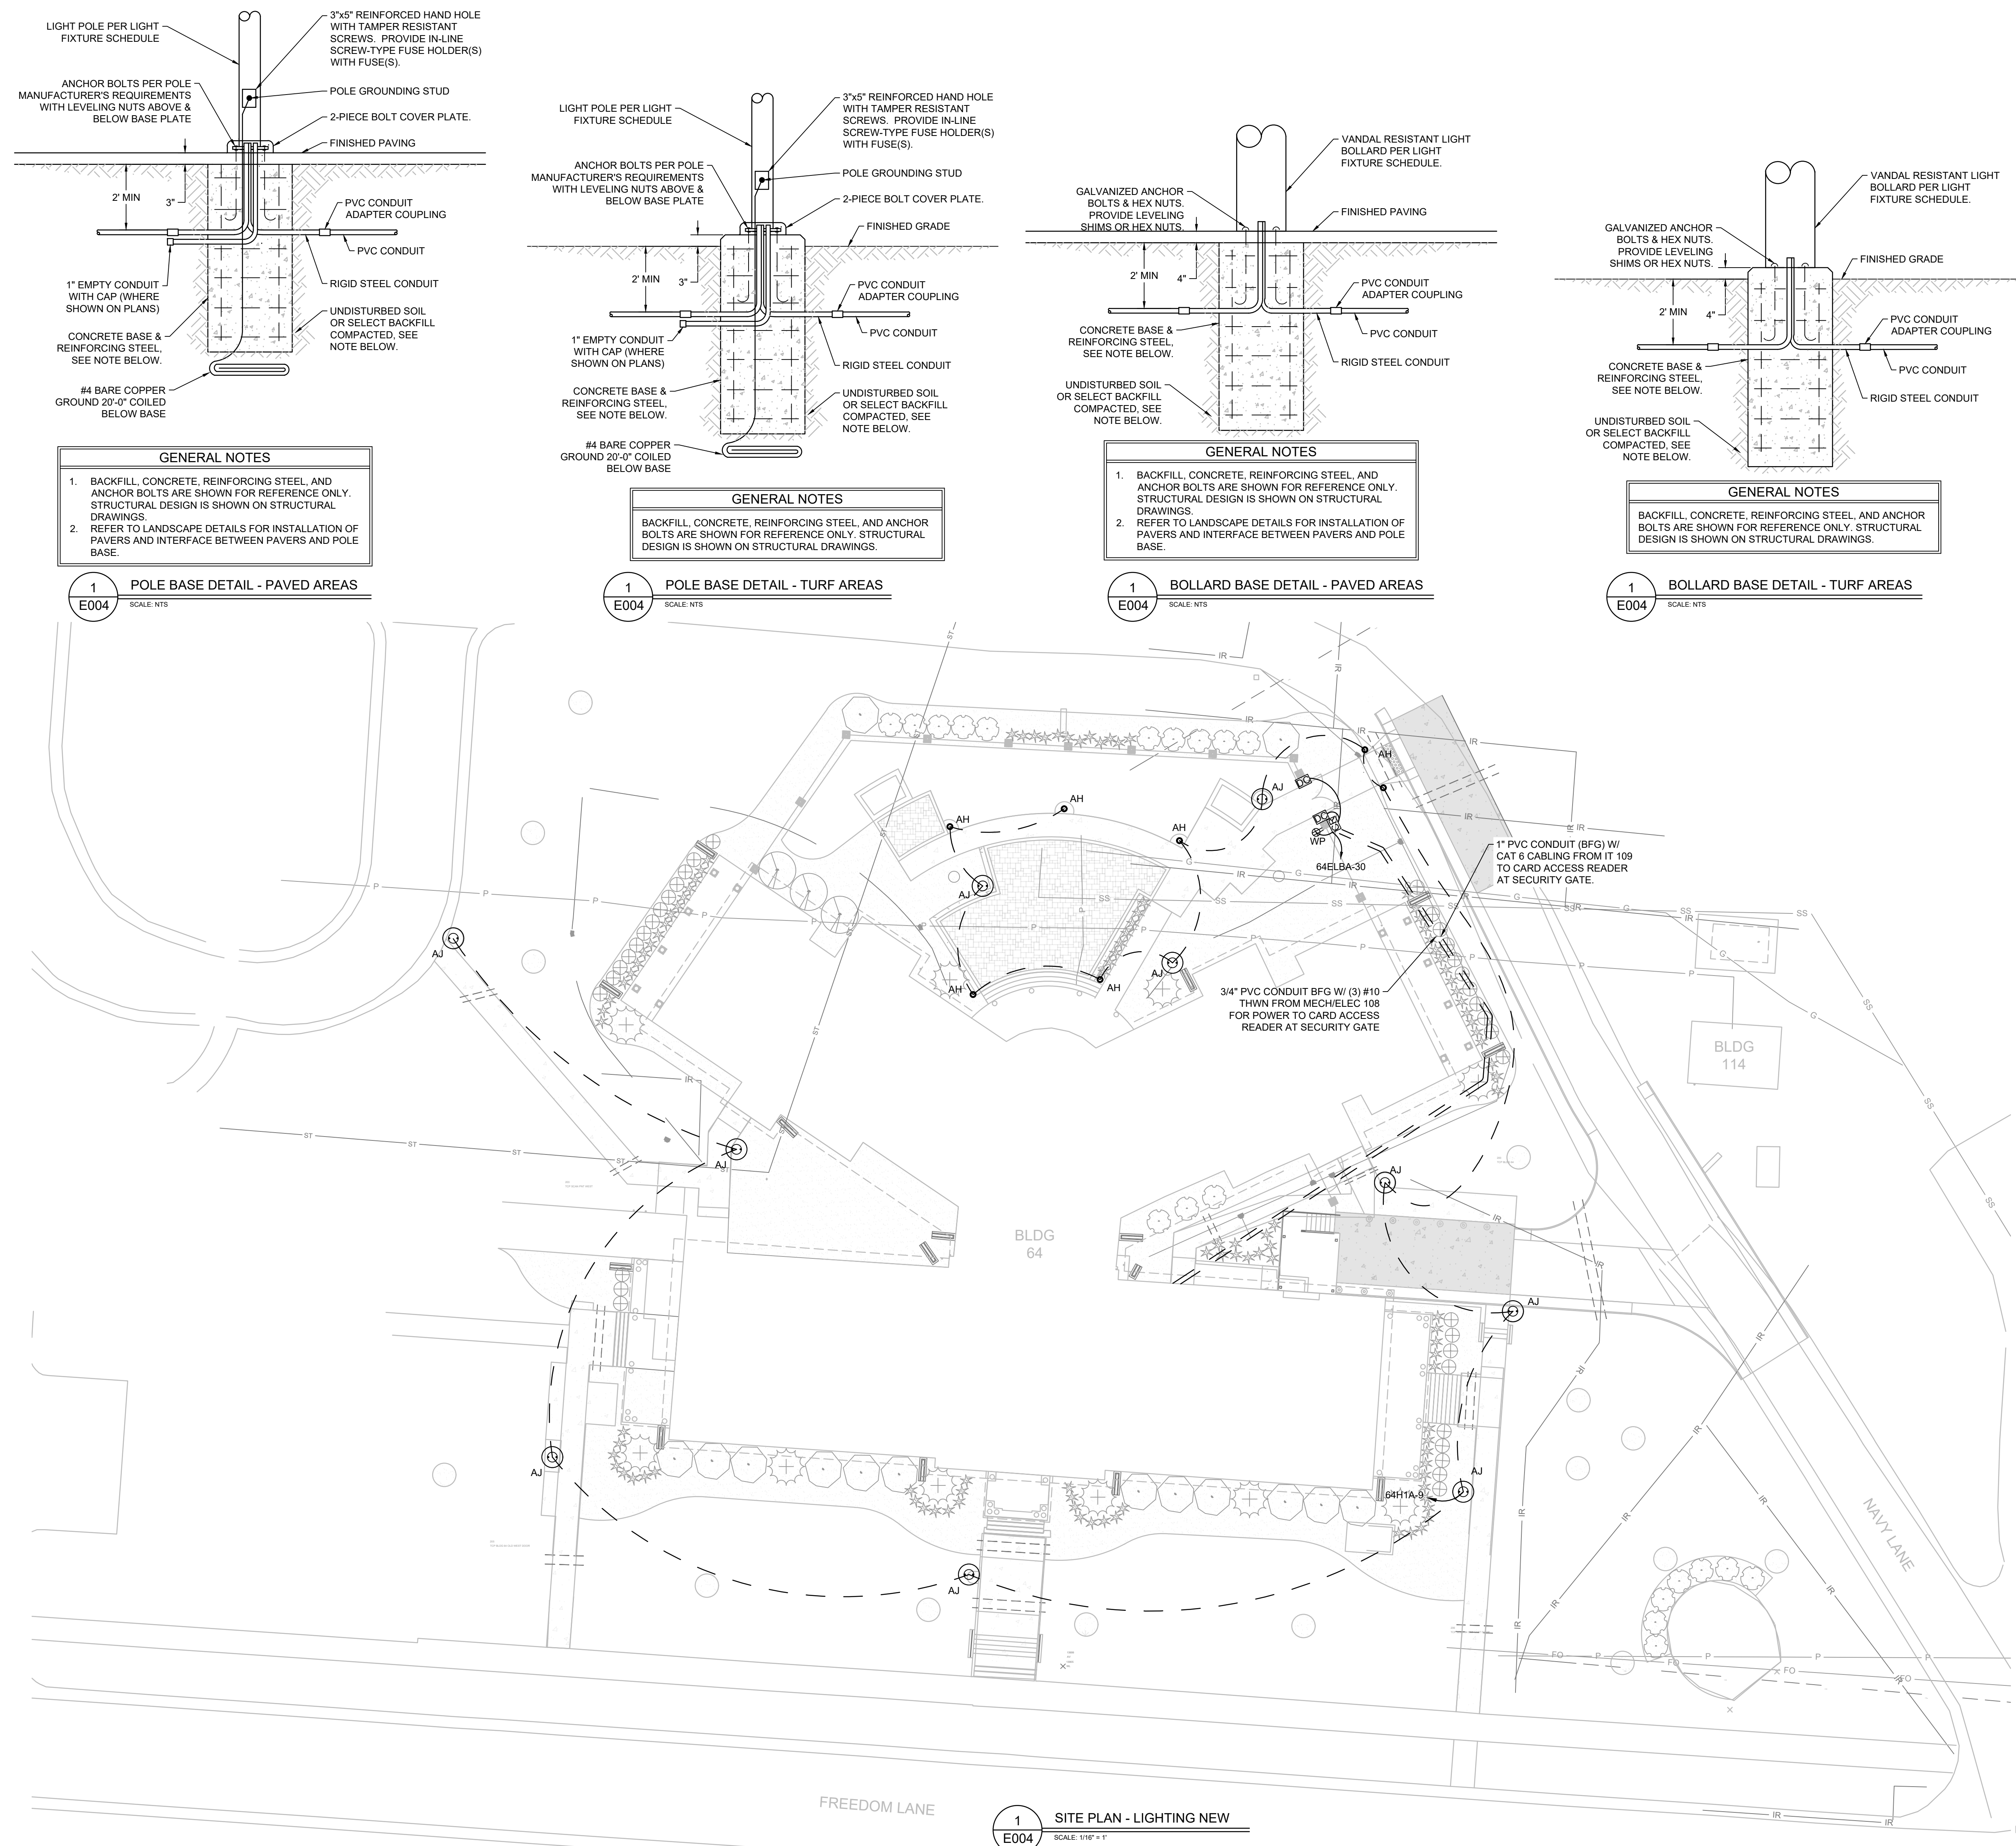- BACKFILL, CONCRETE, REINFORCING STEEL, AND ANCHOR BOLTS ARE SHOWN FOR REFERENCE ONLY. STRUCTURAL DESIGN IS SHOWN ON STRUCTURAL DRAWINGS.
- REFER TO LANDSCAPE DETAILS FOR INSTALLATION OF PAVERS AND INTERFACE BETWEEN PAVERS AND POLE BASE.

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SCALE: NTS

POLE BASE DETAIL - PAVED AREAS




GENERAL NOTES

BACKFILL, CONCRETE, REINFORCING STEEL, AND ANCHOR BOLTS ARE SHOWN FOR REFERENCE ONLY. STRUCTURAL DESIGN IS SHOWN ON STRUCTURAL DRAWINGS.

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SCALE: NTS

POLE BASE DETAIL - TURF AREAS

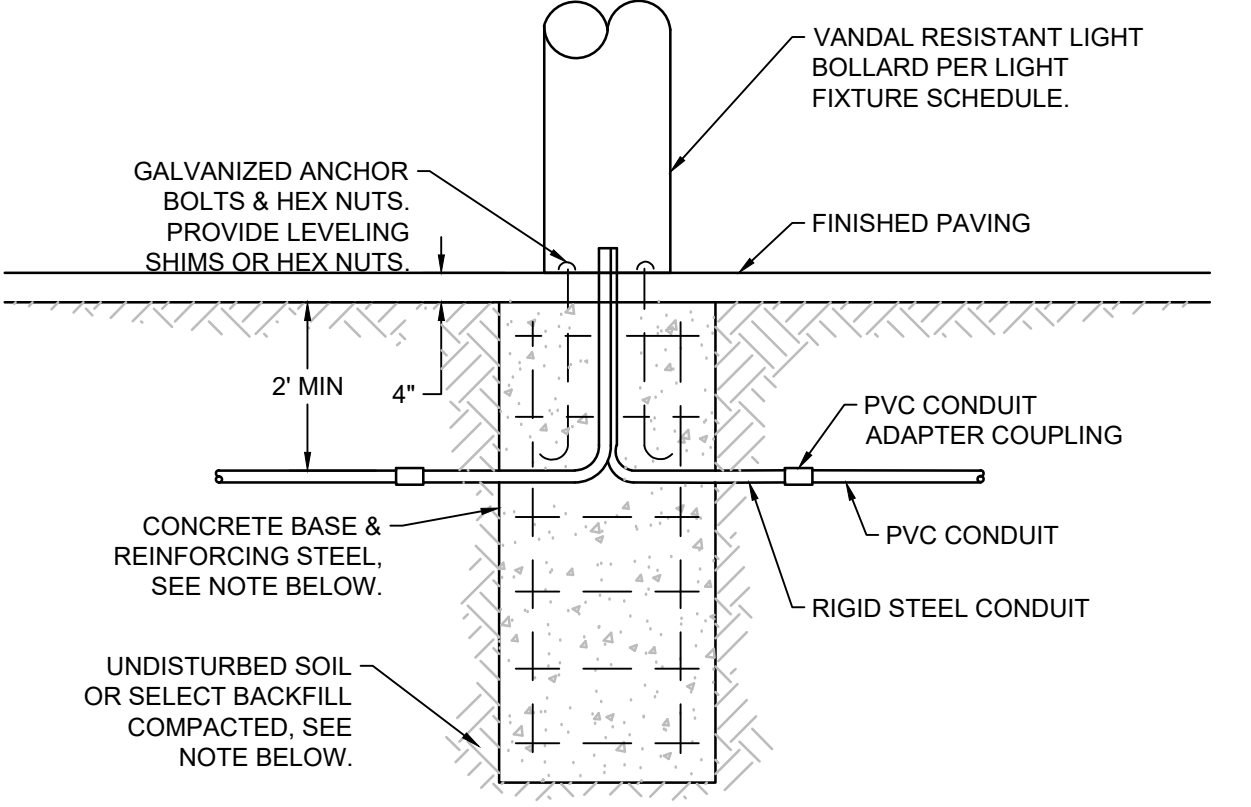


GENERAL NOTES

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- REFER TO LANDSCAPE DETAILS FOR INSTALLATION OF PAVERS AND INTERFACE BETWEEN PAVERS AND POLE BASE.

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SCALE: NTS

BOLLARD BASE DETAIL - PAVED AREAS

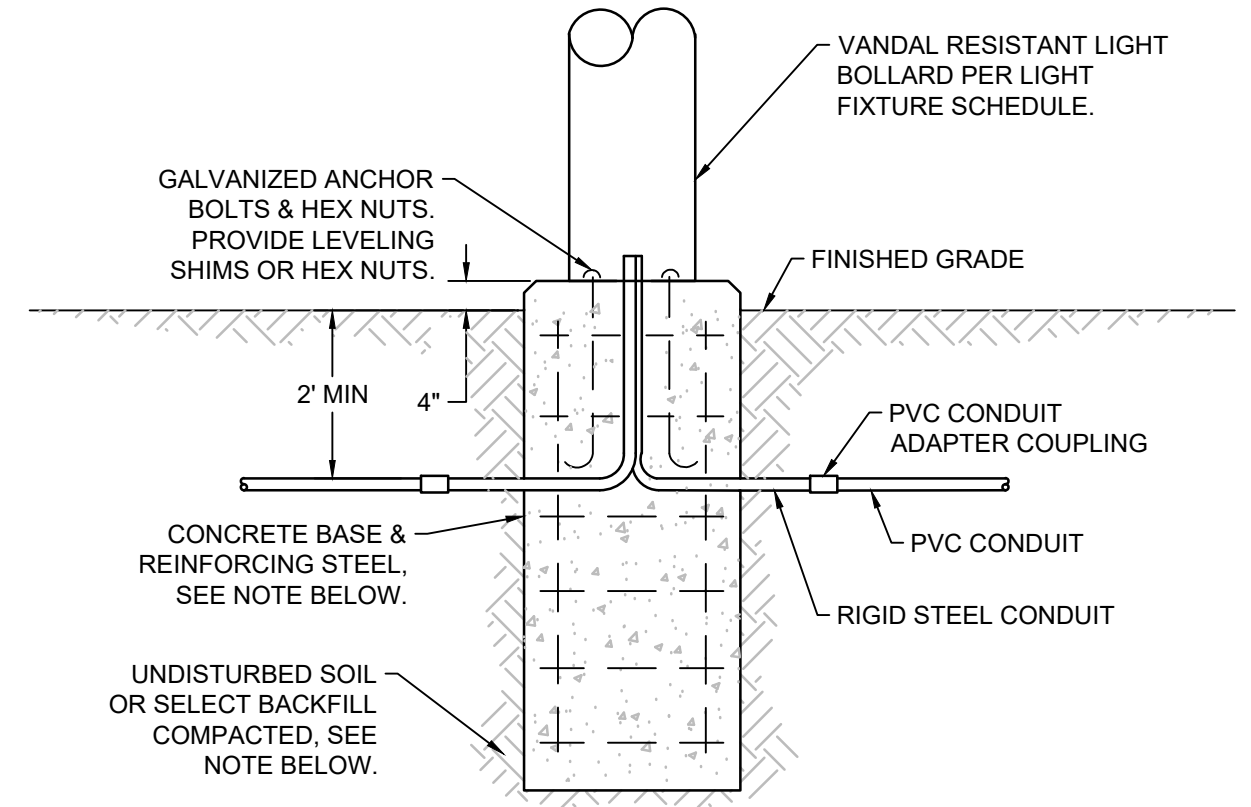


GENERAL NOTES

BACKFILL, CONCRETE, REINFORCING STEEL, AND ANCHOR BOLTS ARE SHOWN FOR REFERENCE ONLY. STRUCTURAL DESIGN IS SHOWN ON STRUCTURAL DRAWINGS.

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SCALE: NTS

BOLLARD BASE DETAIL - TURF AREAS

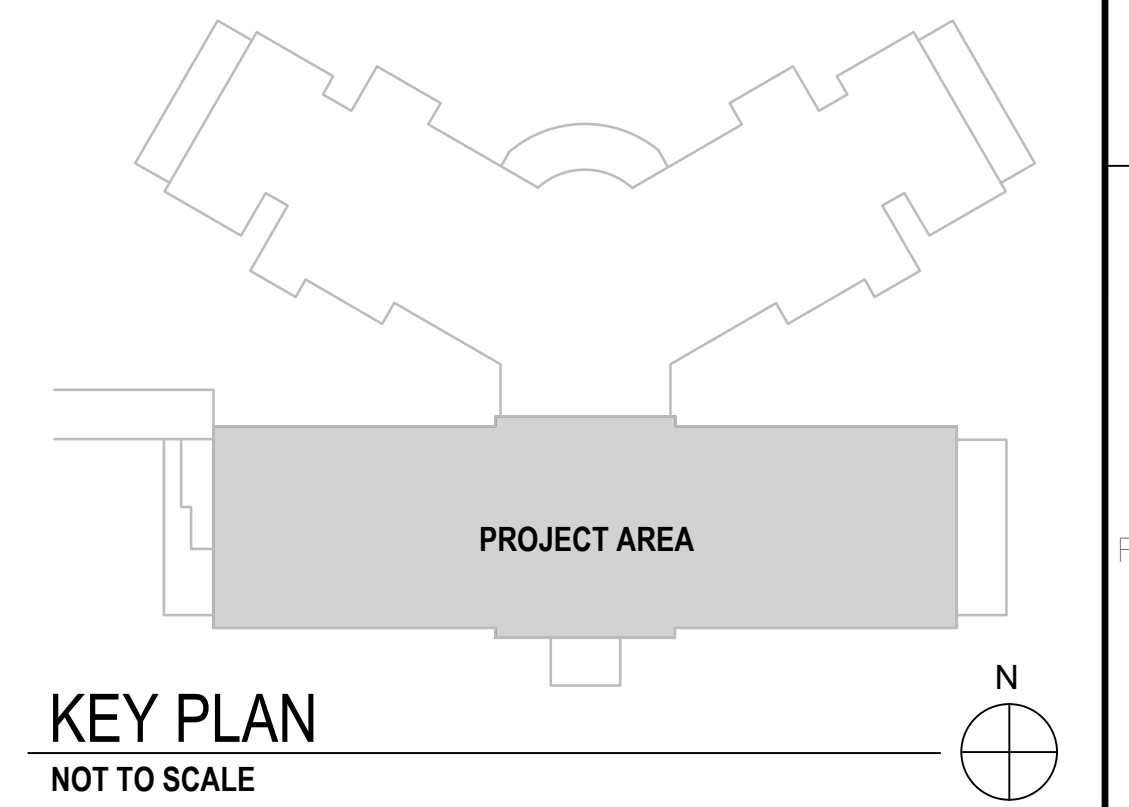

CONSULTANTS:		ARCHITECT		Drawing Title		Project Title		Project Number		Office of Construction and Facilities Management Department of Veterans Affairs			
TERRASITE DESIGN 1635 DEADWOOD AVENUE RAPID CITY, SOUTH DAKOTA 57702 PH: (605) 791-1736		MORRISON-MAIERLE 2200 FOOTHILLS BLVD, SUITE A GILLETTE, WYOMING 82716 PH: (307) 685-3780		ALBERTSON ENGINEERING, INC. 3202 WEST MAIN STREET, SUITE C RAPID CITY, SOUTH DAKOTA 57702 PH: (605) 343-9606		ELECTRICAL SITE PLAN		666-18-103					
DAWES ENGINEERING & DESIGN CO. 46 HIBBARD WAY HELENA, MONTANA 59601 PH: (406) 441-4000		SUMMIT COMPANIES 575 MINNEHAHA AVENUE WEST ST. PAUL, MINNESOTA 55103 PH: (651) 251-1880		FOURFRONT DESIGN INC. 517 7TH STREET RAPID CITY, SOUTH DAKOTA 57701 PH: (605) 342-9470 FAX: (605) 342-2377 WWW.FOURFRONTDESIGN.COM		Approved: Project Director Owner		Building Number 64					
Revisions:		Date		15.2226.17		Location SHERIDAN, WYOMING		Drawing Number E 004					
						Date AUGUST 28, 2020		Checked RD		Drawn PM - WW		Dwg. 93 of 115	

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VA FORM 08-6231

CONSULTANTS:


TERRASITE DESIGN
1635 DEADWOOD AVENUE
RAPID CITY, SOUTH DAKOTA 57702
PH: (605) 791-1736

DAWES ENGINEERING &
DESIGN CO. 46 HIBBARD WAY
HELENA, MONTANA 59601
PH: (406) 441-4000

MORRISON-MAIERLE
2200 FOOTHILLS BLVD, SUITE A
GILLETTE, WYOMING 82716
PH: (307) 685-3780

SUMMIT COMPANIES
575 MINNEHAHA AVENUE WEST
ST. PAUL, MINNESOTA 55103
PH: (651) 251-1880

ALBERTSON ENGINEERING, INC.
3202 WEST MAIN STREET, SUITE C
RAPID CITY, SOUTH DAKOTA 57702
PH: (605) 343-9606

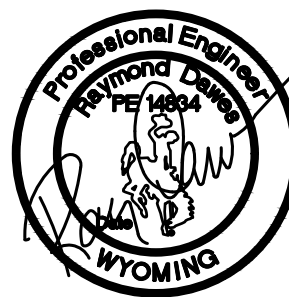

ARCHITECT



FOURFRONT DESIGN, INC.
517 7TH STREET
RAPID CITY, SOUTH DAKOTA 57701
PH: (605) 342-9470
FAX: (605) 342-2377
WWW.FOURFRONTDESIGN.COM

15.2226.17

Drawing Title

BASEMENT POWER
PLANS

Approved: Project Director

Owner

Project Title

BUILDING 64 FOLLOW-ON
RENOVATION - SHERIDAN VA
MEDICAL CENTER

Location

SHERIDAN, WYOMING

Date

AUGUST 28, 2020

Checked

RD

Drawn

PM - WW

Project Number

666-18-103

Building Number

64

Drawing Number



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Dwg. 94 of 115

Office of
Construction
and Facilities
Management



KEY PLAN
NOT TO SCALE

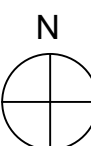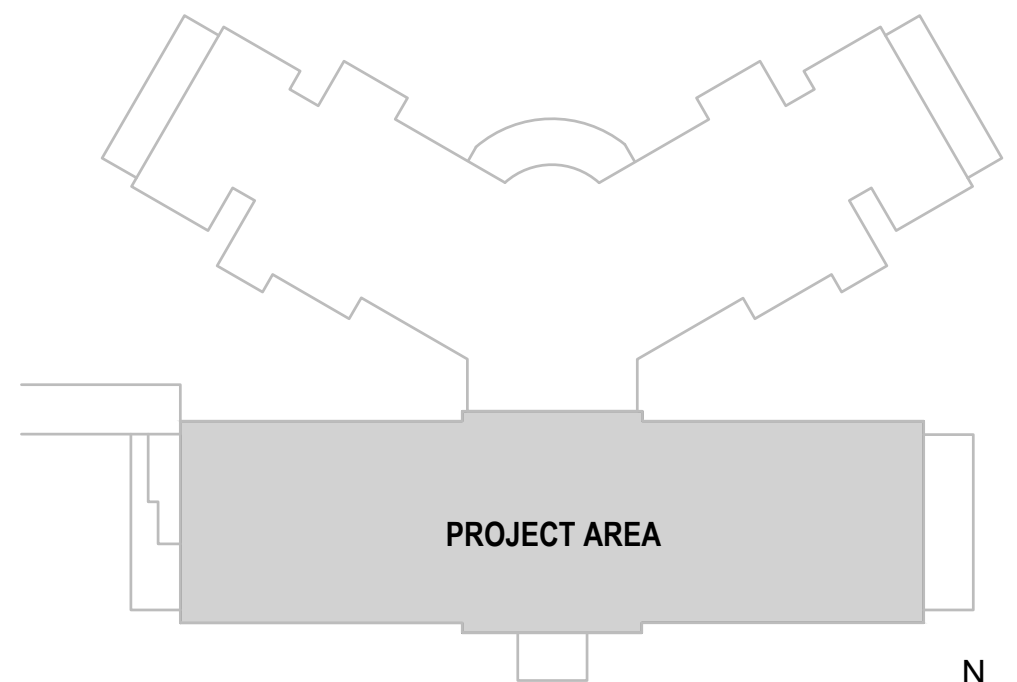


CONSTRUCTION DOCUMENTS


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- ② PREVIOUS PANEL LBA NOW USED AS JUNCTION BOX. CONTRACTOR TO LOCATE EXISTING HOMERUNS AND LABEL CONNECTIONS IN BOX.
- ③ CARD ACCESS READER ROUGH IN. REFER TO DETAILS 3 AND 4 ON SHEET T002.

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SCALE: 1/8" = 1'

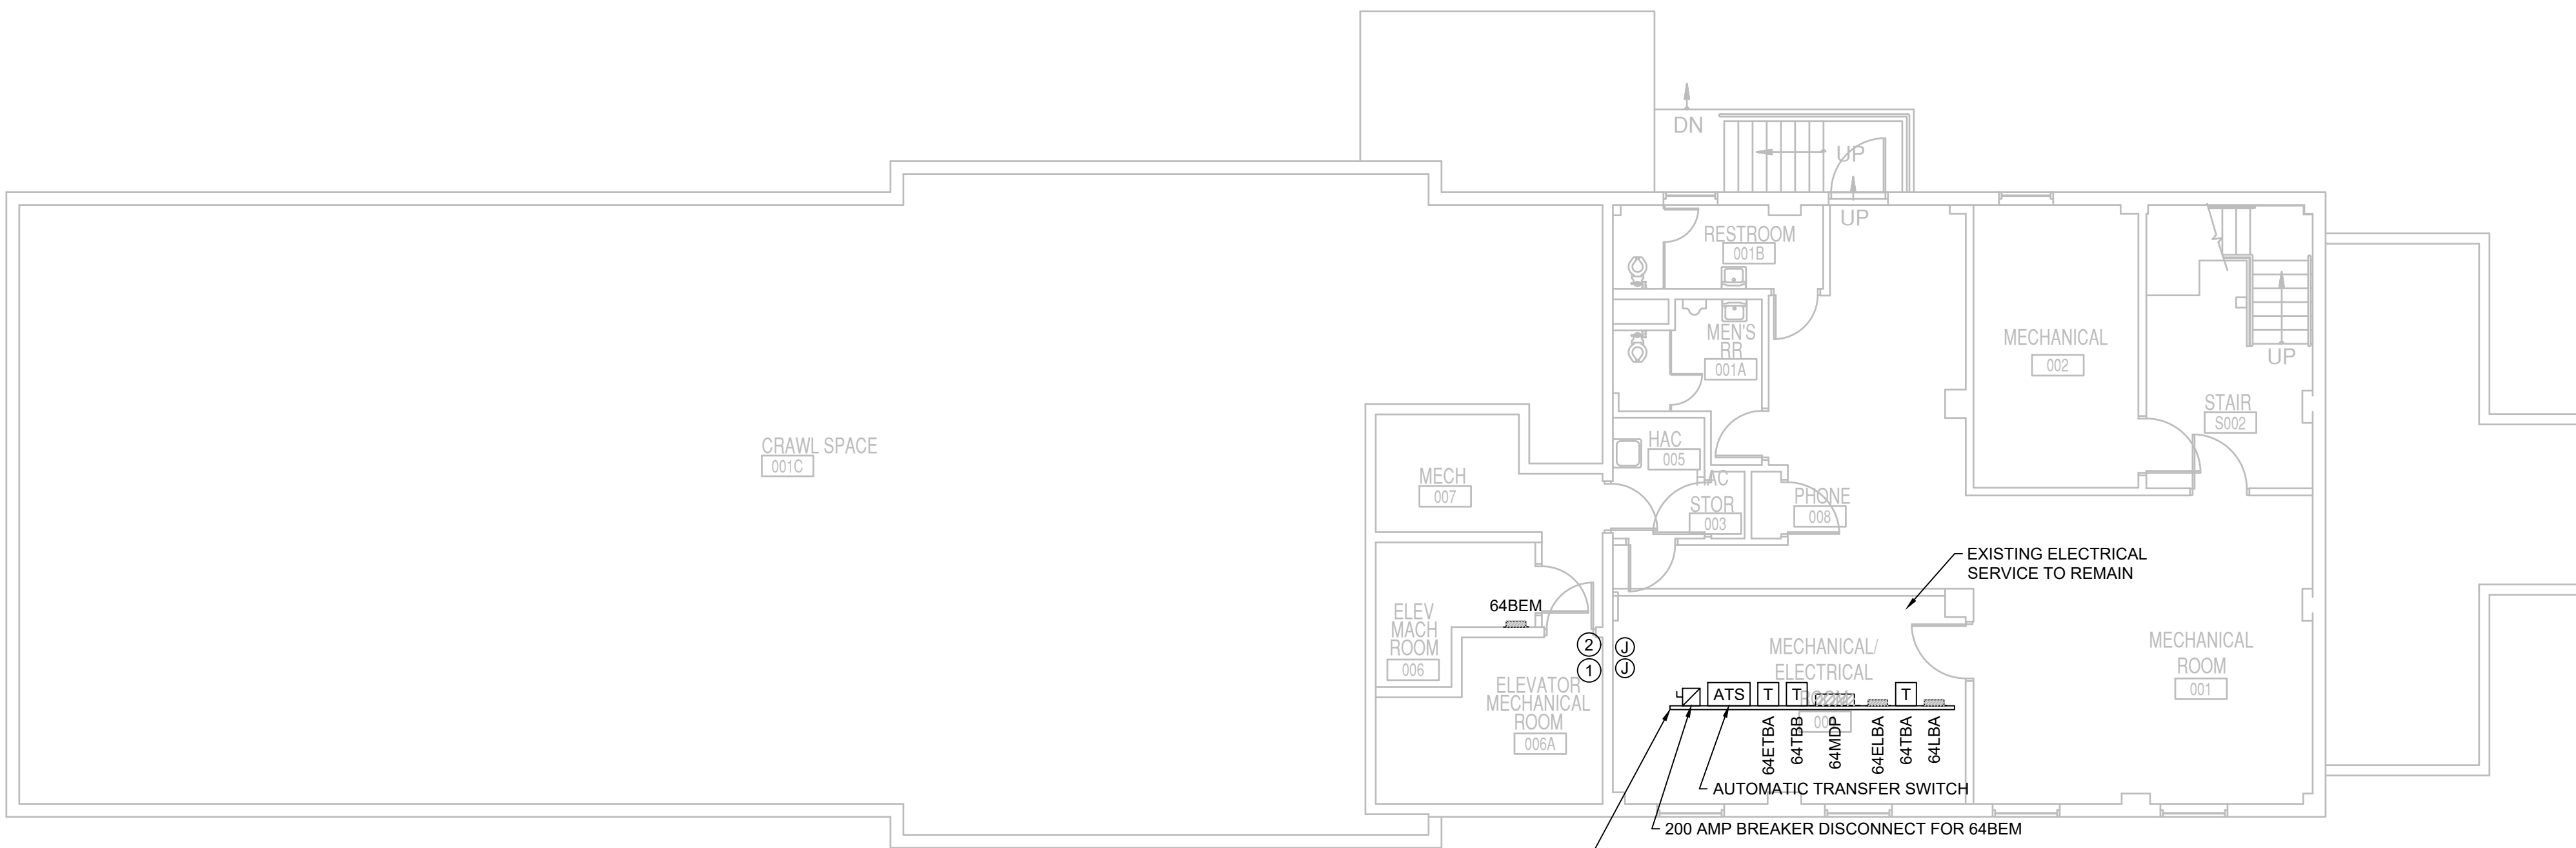

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one eighth inch = one foot
one quarter inch = one foot
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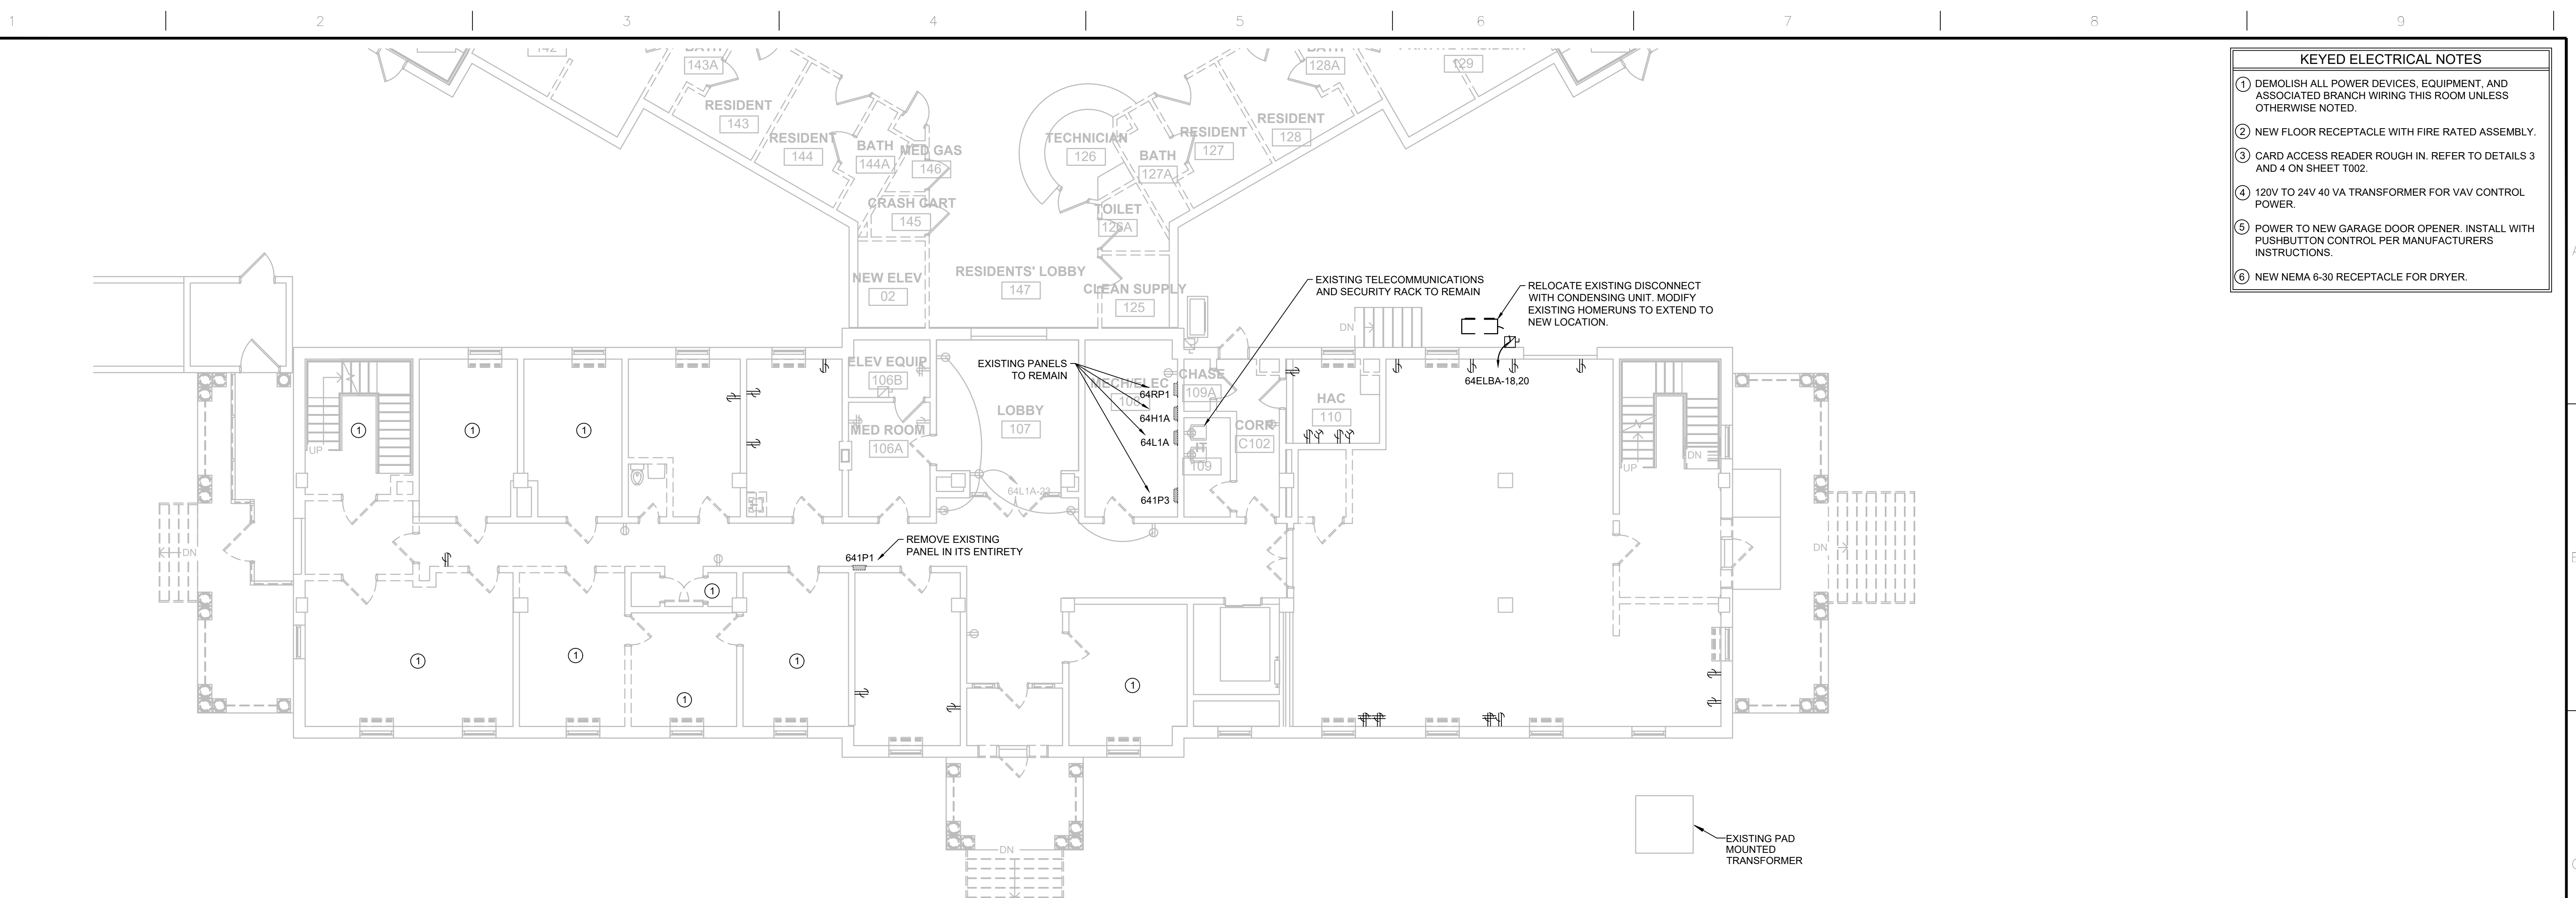
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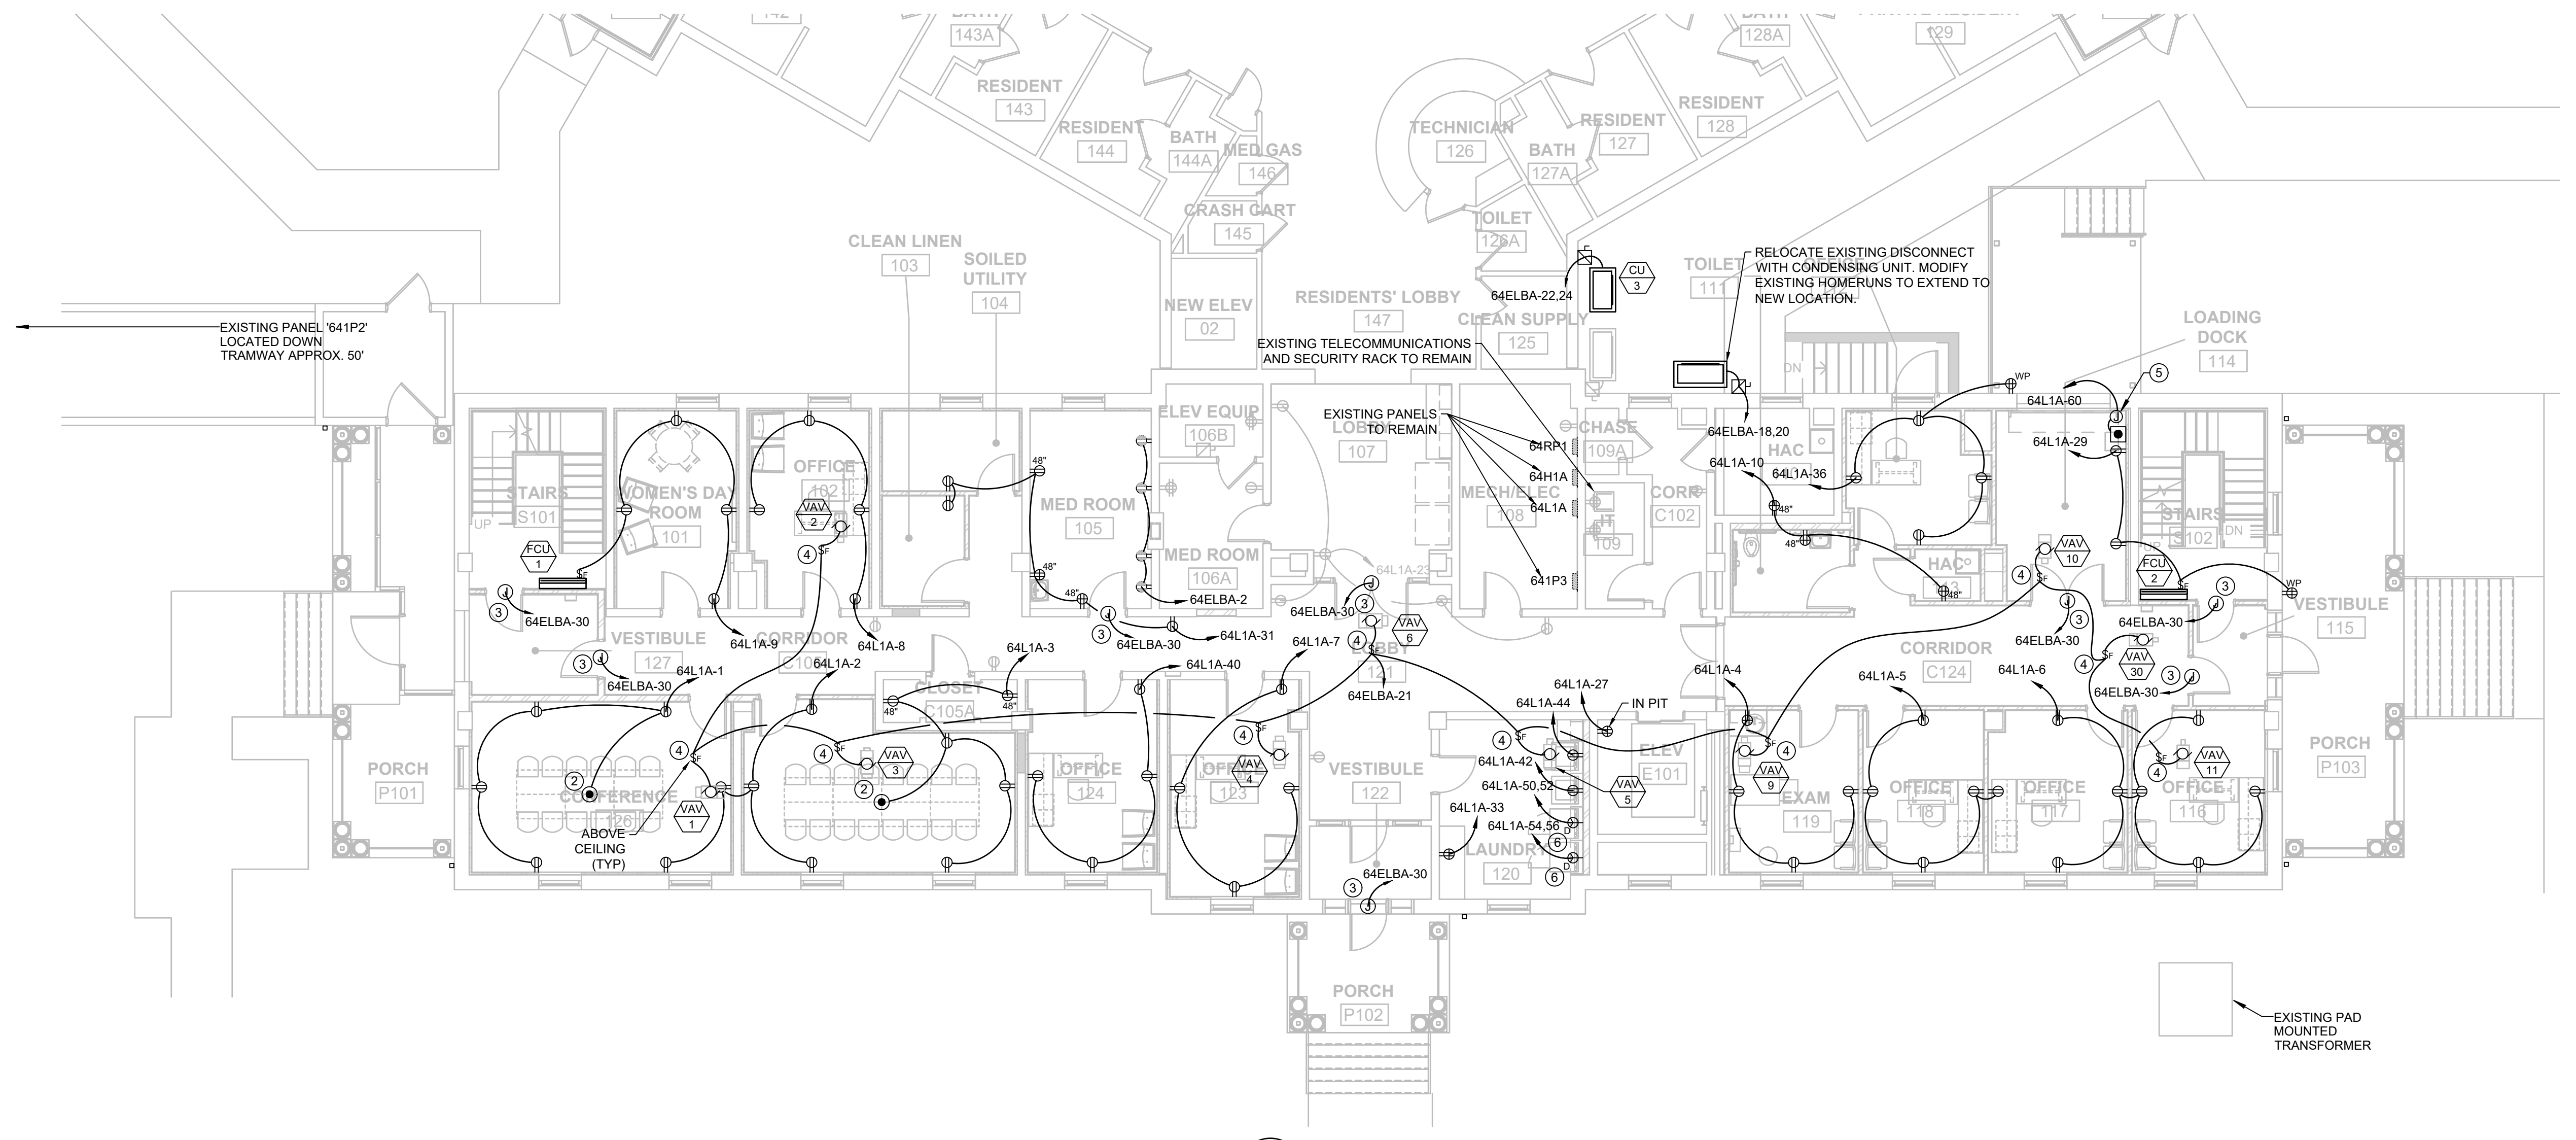
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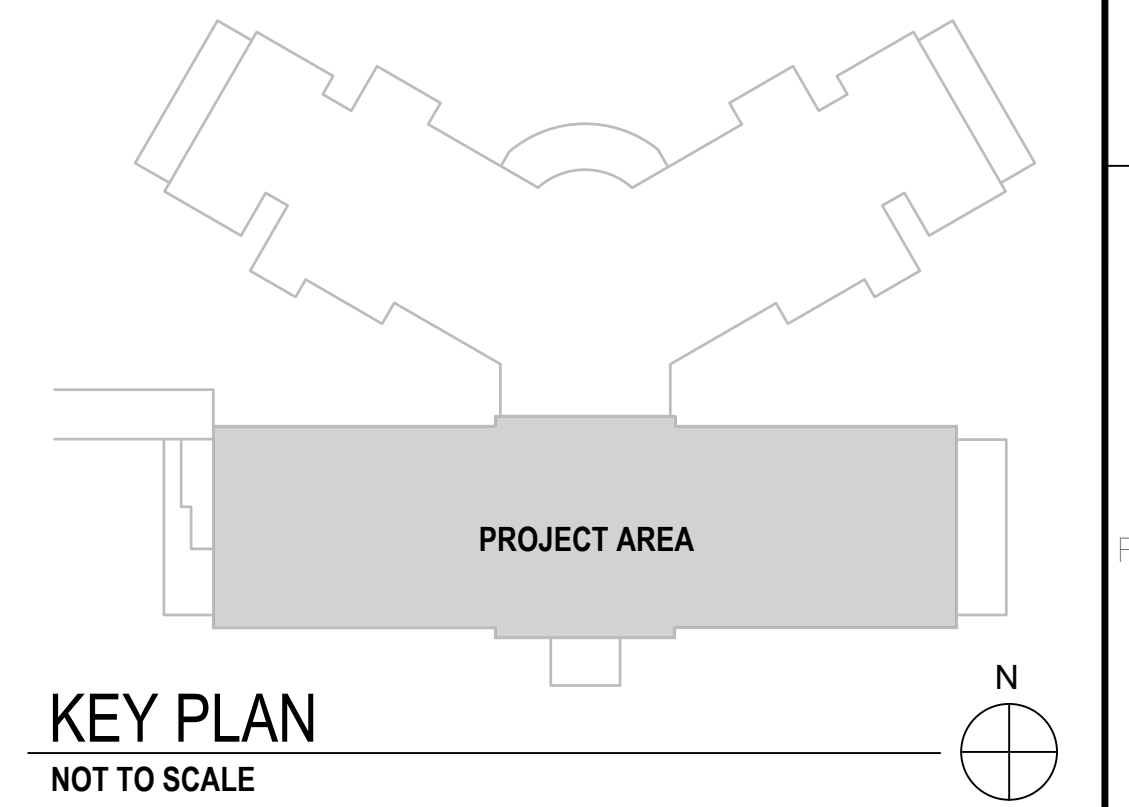
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
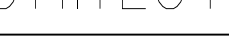



1 FIRST FLOOR FLOORPLAN - POWER DEMOLITION
E101 SCALE: 1/8" = 1'

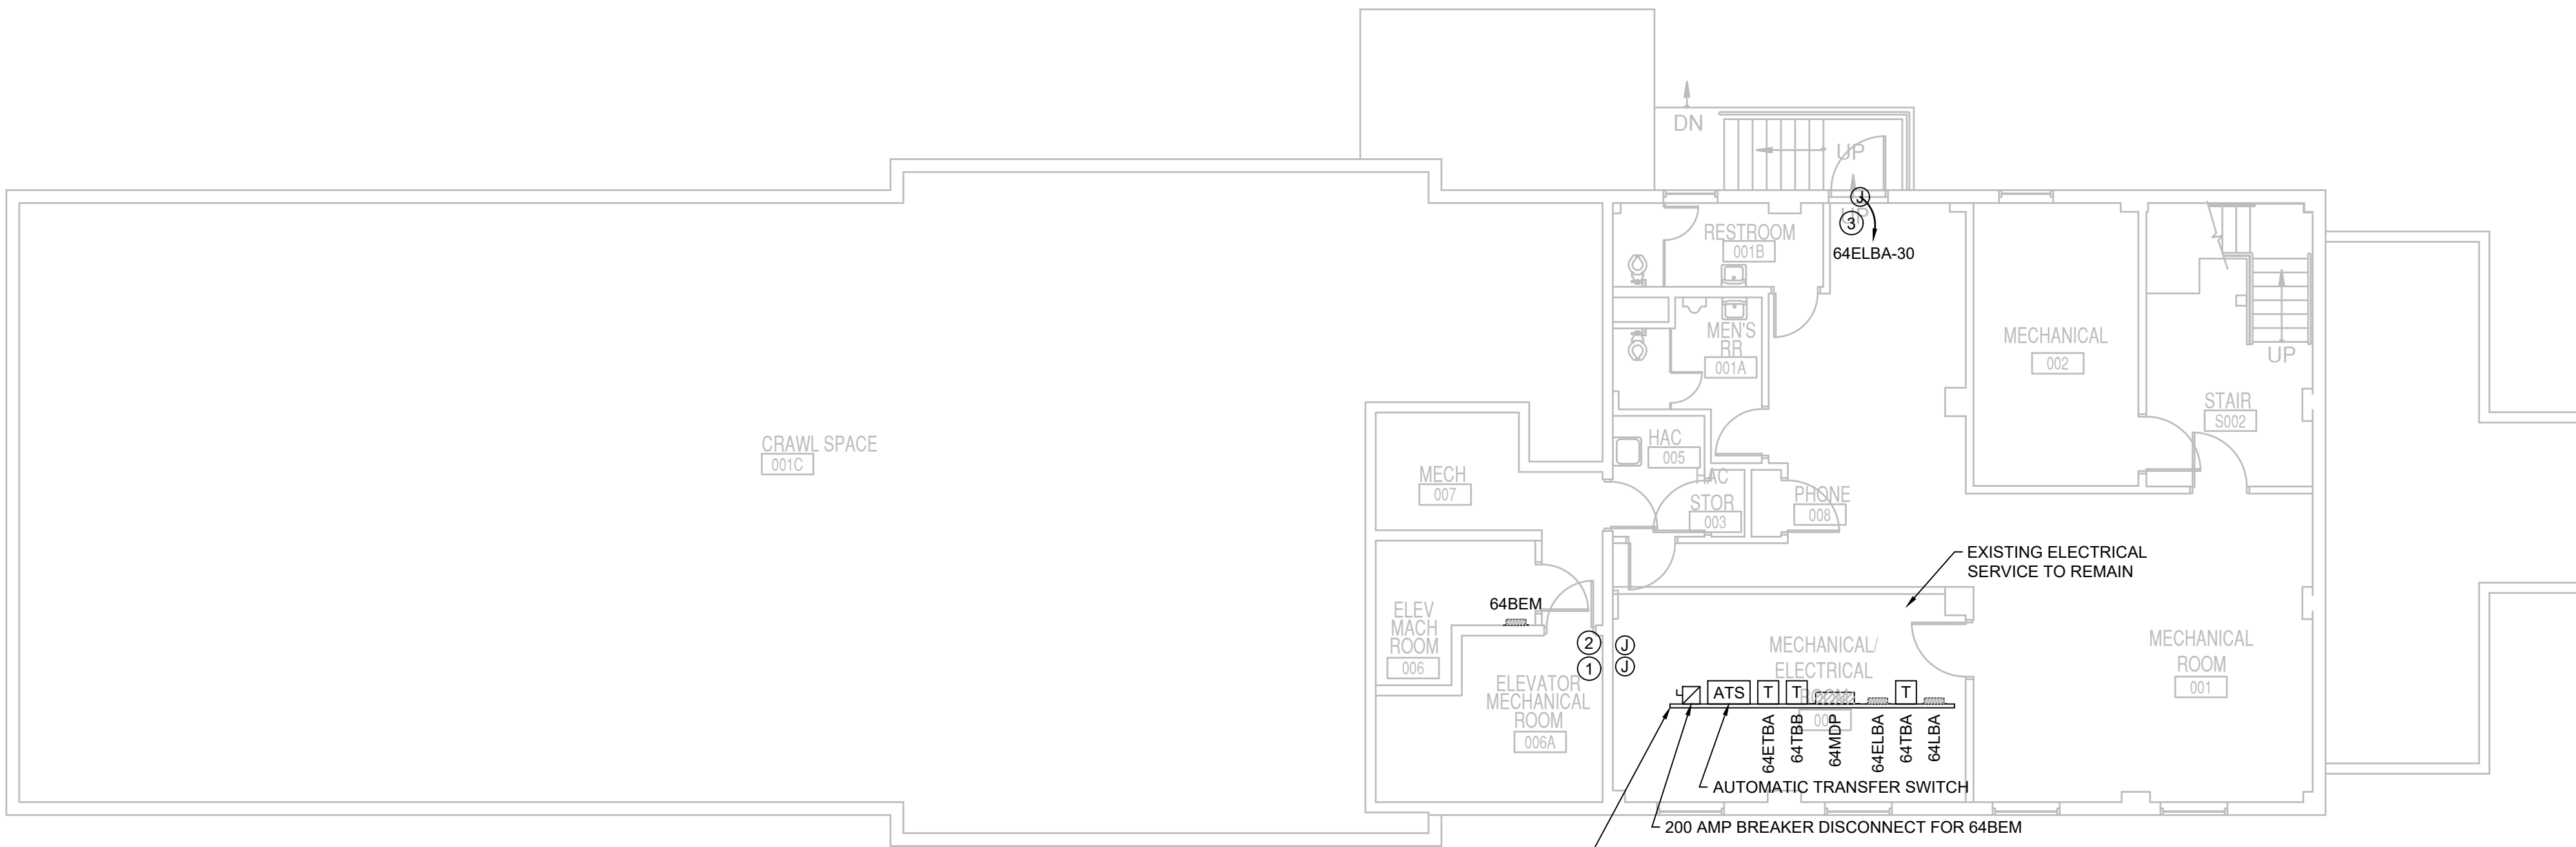

2 FIRST FLOOR FLOORPLAN - POWER NEW
E101 SCALE: 1/8" = 1'



		CONSULTANTS:				ARCHITECT		Drawing Title		Project Title		Project Number		Office of Construction and Facilities Management					
		TERRASITE DESIGN 1635 DEADWOOD AVENUE RAPID CITY, SOUTH DAKOTA 57702 PH: (605) 791-1736		MORRISON-MAIERLE 2200 FOOTHILLS BLVD, SUITE A GILLETTE, WYOMING 82716 PH: (307) 685-3780		ALBERTSON ENGINEERING, INC. 3202 WEST MAIN STREET, SUITE C RAPID CITY, SOUTH DAKOTA 57702 PH: (605) 343-9606		FIRST FLOOR POWER PLANS		BUILDING 64 FOLLOW-ON RENOVATION - SHERIDAN VA MEDICAL CENTER		666-18-103							
		DAWES ENGINEERING & DESIGN CO. 46 HIBBARD WAY HELENA, MONTANA 59601 PH: (406) 441-4000		SUMMIT COMPANIES 575 MINNEHAHA AVENUE WEST ST. PAUL, MINNESOTA 55103 PH: (651) 251-1880		 FOURFRONT DESIGN INC.		FOURFRONT DESIGN, INC. 517 7TH STREET RAPID CITY, SOUTH DAKOTA 57701 PH: (605) 342-9470 FAX: (605) 342-2377 WWW.FOURFRONTDESIGN.COM		Approved: Project Director		Location SHERIDAN, WYOMING				Building Number 64			
Revisions:		Date						Owner		Date AUGUST 28, 2020		Checked RD		Drawn PM - WW		Drawing Number E 101		 Department of Veterans Affairs	
								15.2226.17								Dwg. 95 of 115			

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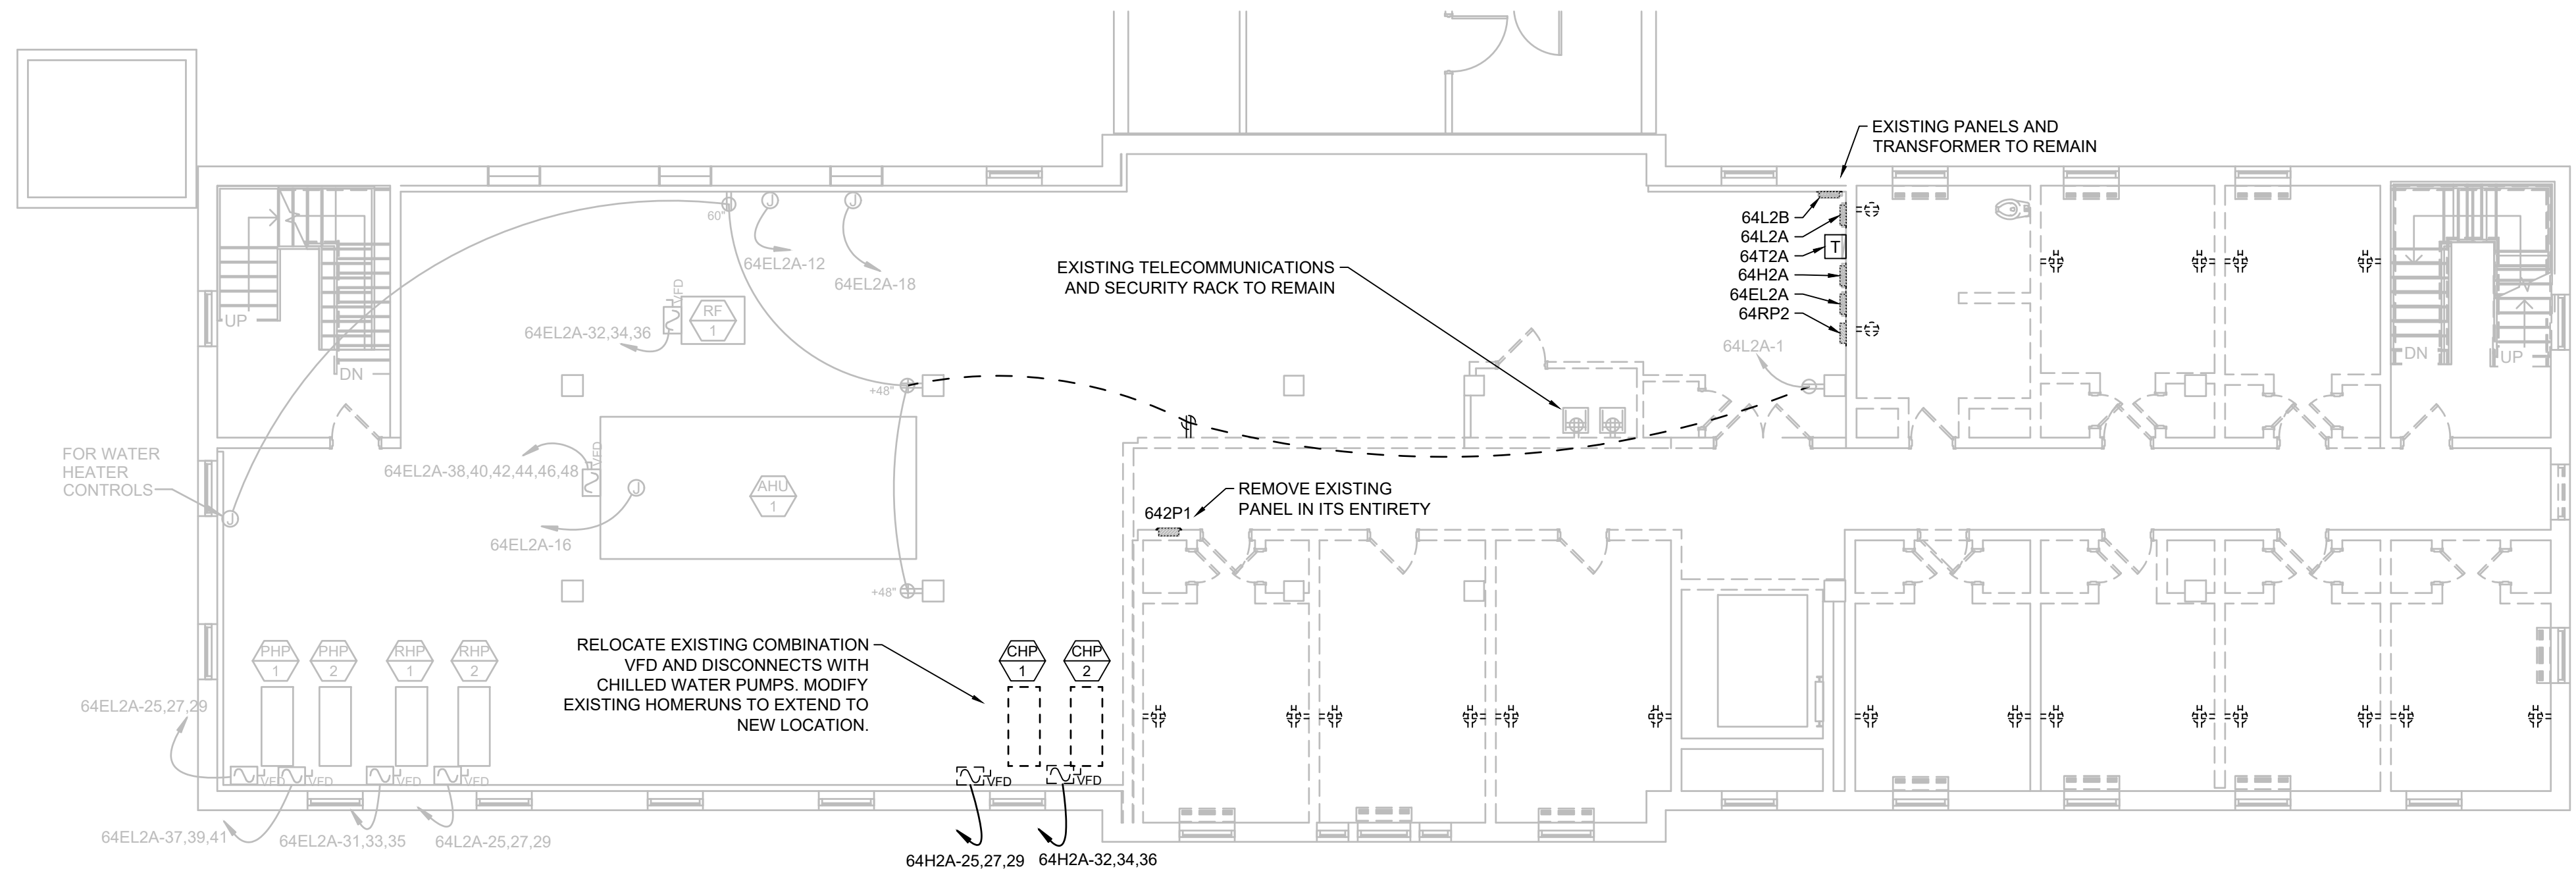
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- KEYED ELECTRICAL NOTES
- CONNECT NEW AIR HANDLER CONTROL AND LIGHTING POWER TO EXISTING AIR HANDLER CONTROL AND LIGHTING POWER AS SHOWN. COORDINATE WITH CONTROLS CONTRACTOR FOR LOCATION.
 - CARD ACCESS READER ROUGH IN. REFER TO DETAILS 3 AND 4 ON SHEET T002.
 - 120V TO 24V 40 VA TRANSFORMER FOR VAV CONTROL POWER.



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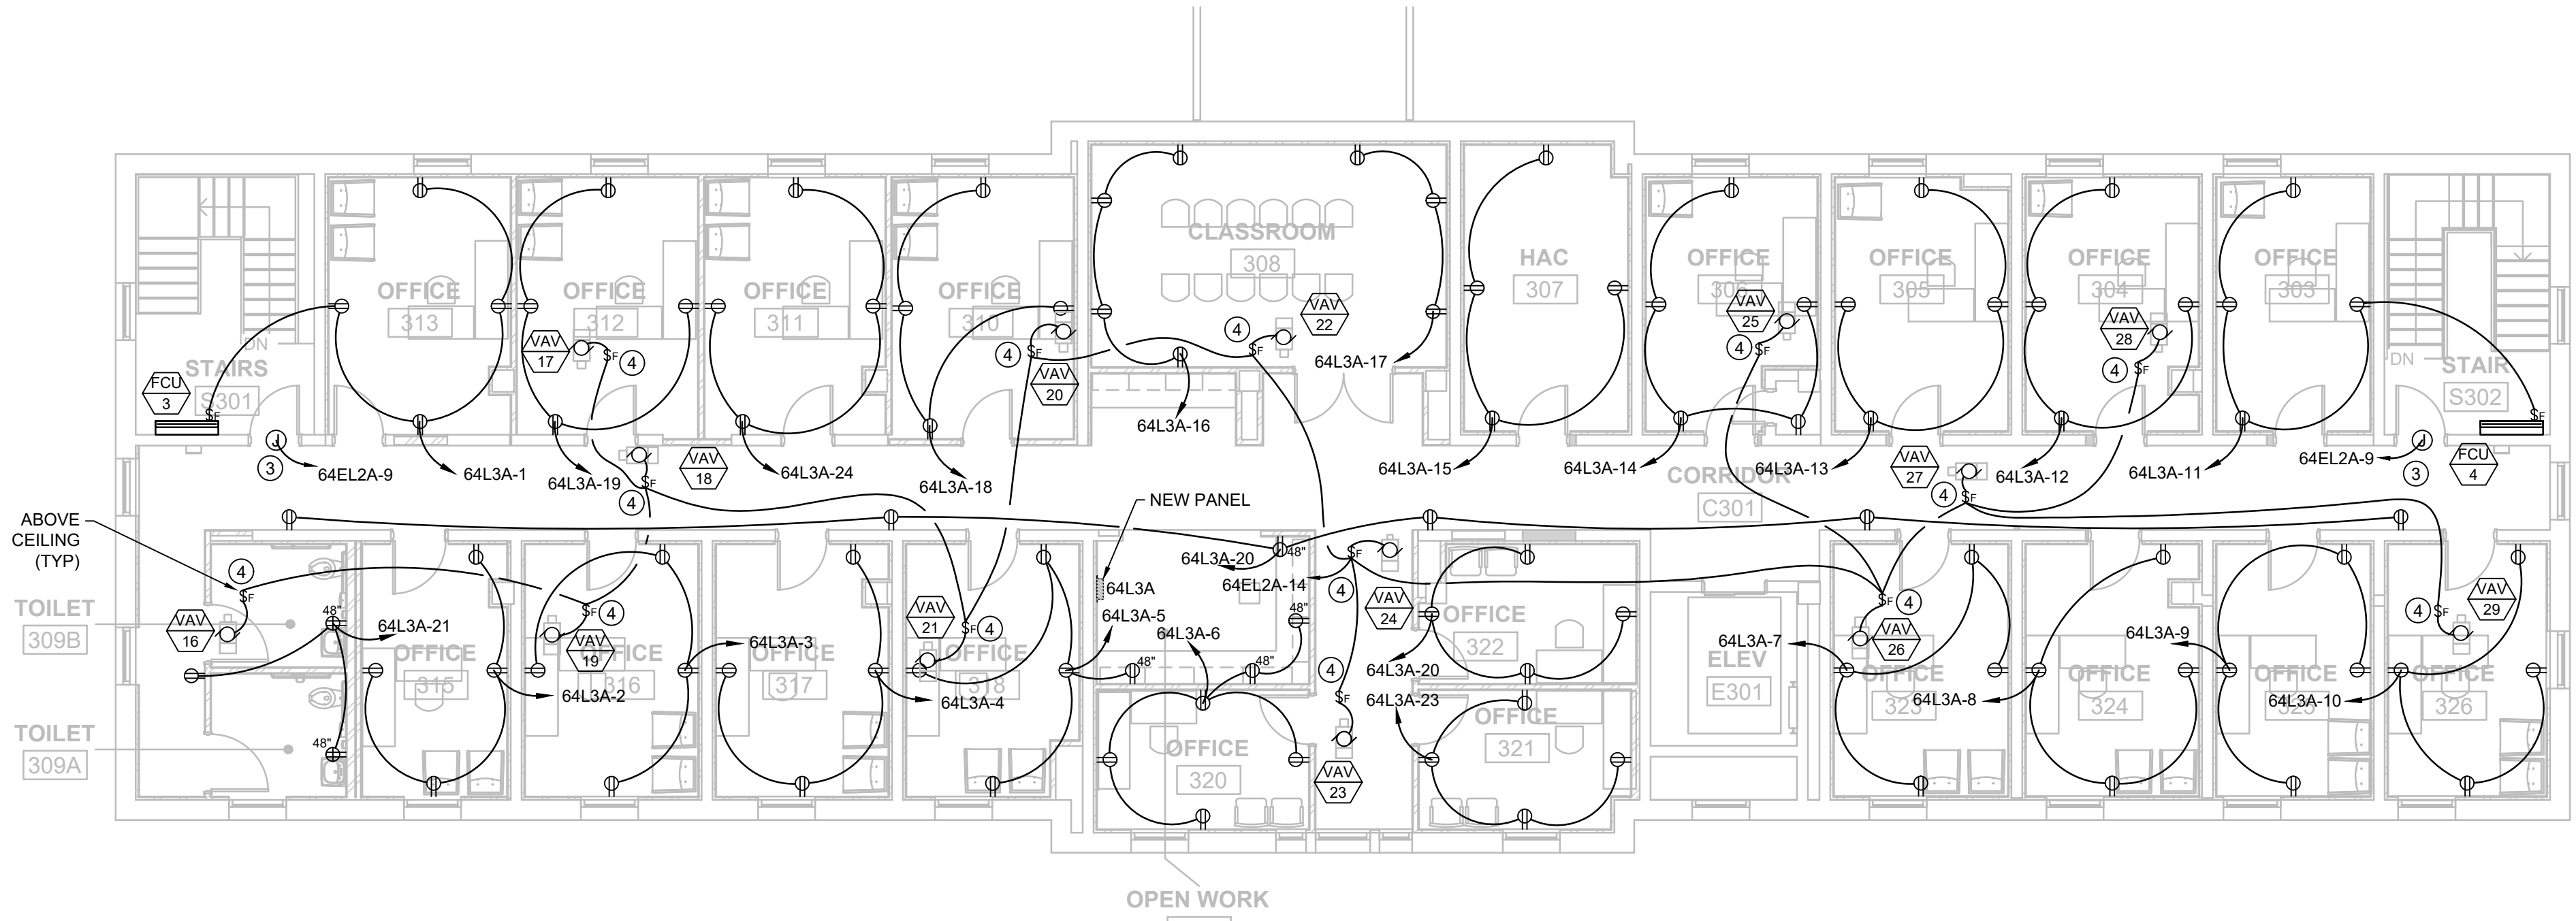
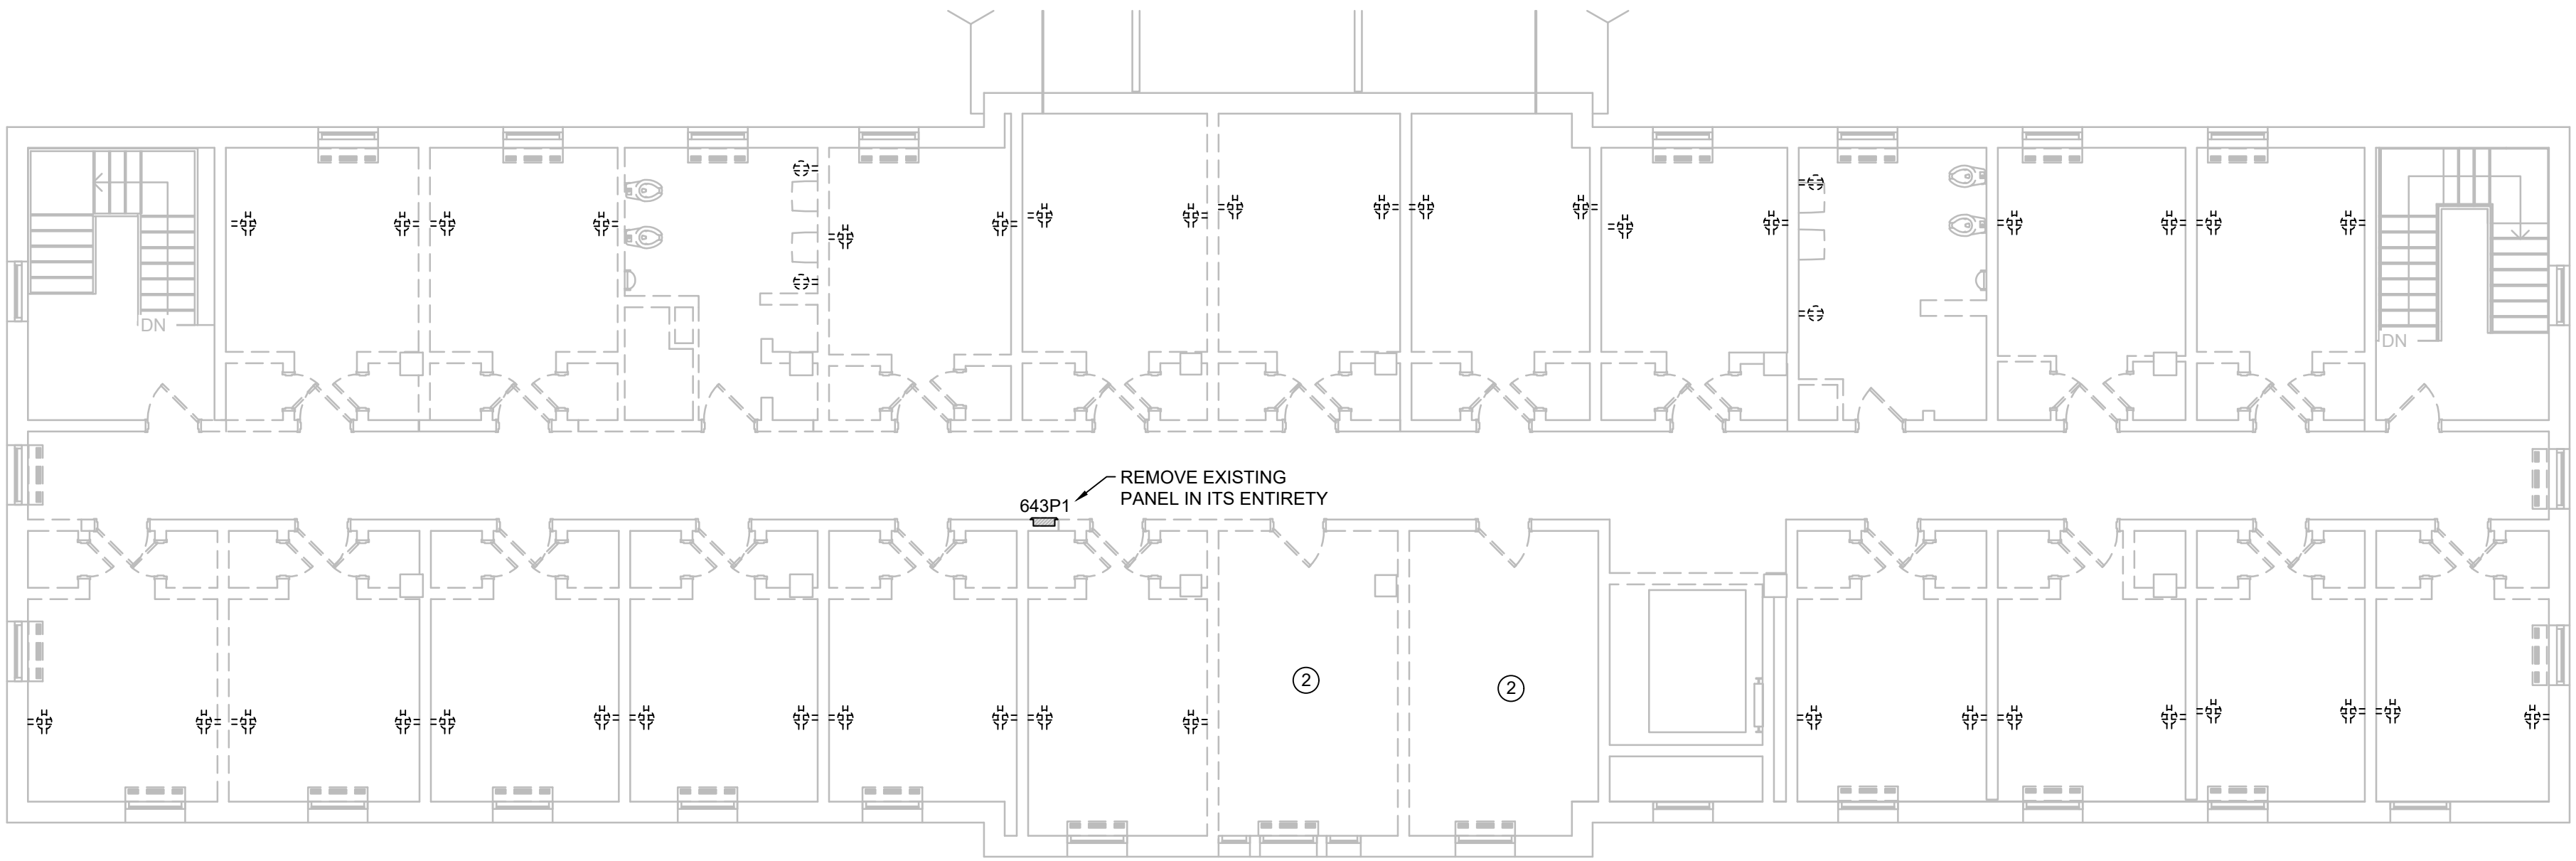
- KEYED ELECTRICAL NOTES
- 1

SWITCH RECEPTACLES IN THIS ROOM WITH CEILING OCCUPANCY SENSOR AS SHOWN.
- 2

DEMOLISH ALL POWER DEVICES, EQUIPMENT, AND ASSOCIATED BRANCH WIRING THIS ROOM UNLESS OTHERWISE NOTED.
- 3

JUNCTION BOXES FOR CARD ACCESS READER. REFER TO DETAILS 3 AND 4 ON SHEET T002.
- 4

120V TO 24V 40 VA TRANSFORMER FOR VAV CONTROL POWER.



one eighth inch = one foot
one quarter inch = one foot
three eighths inch = one foot
one half inch = one foot
three quarters inch = one foot
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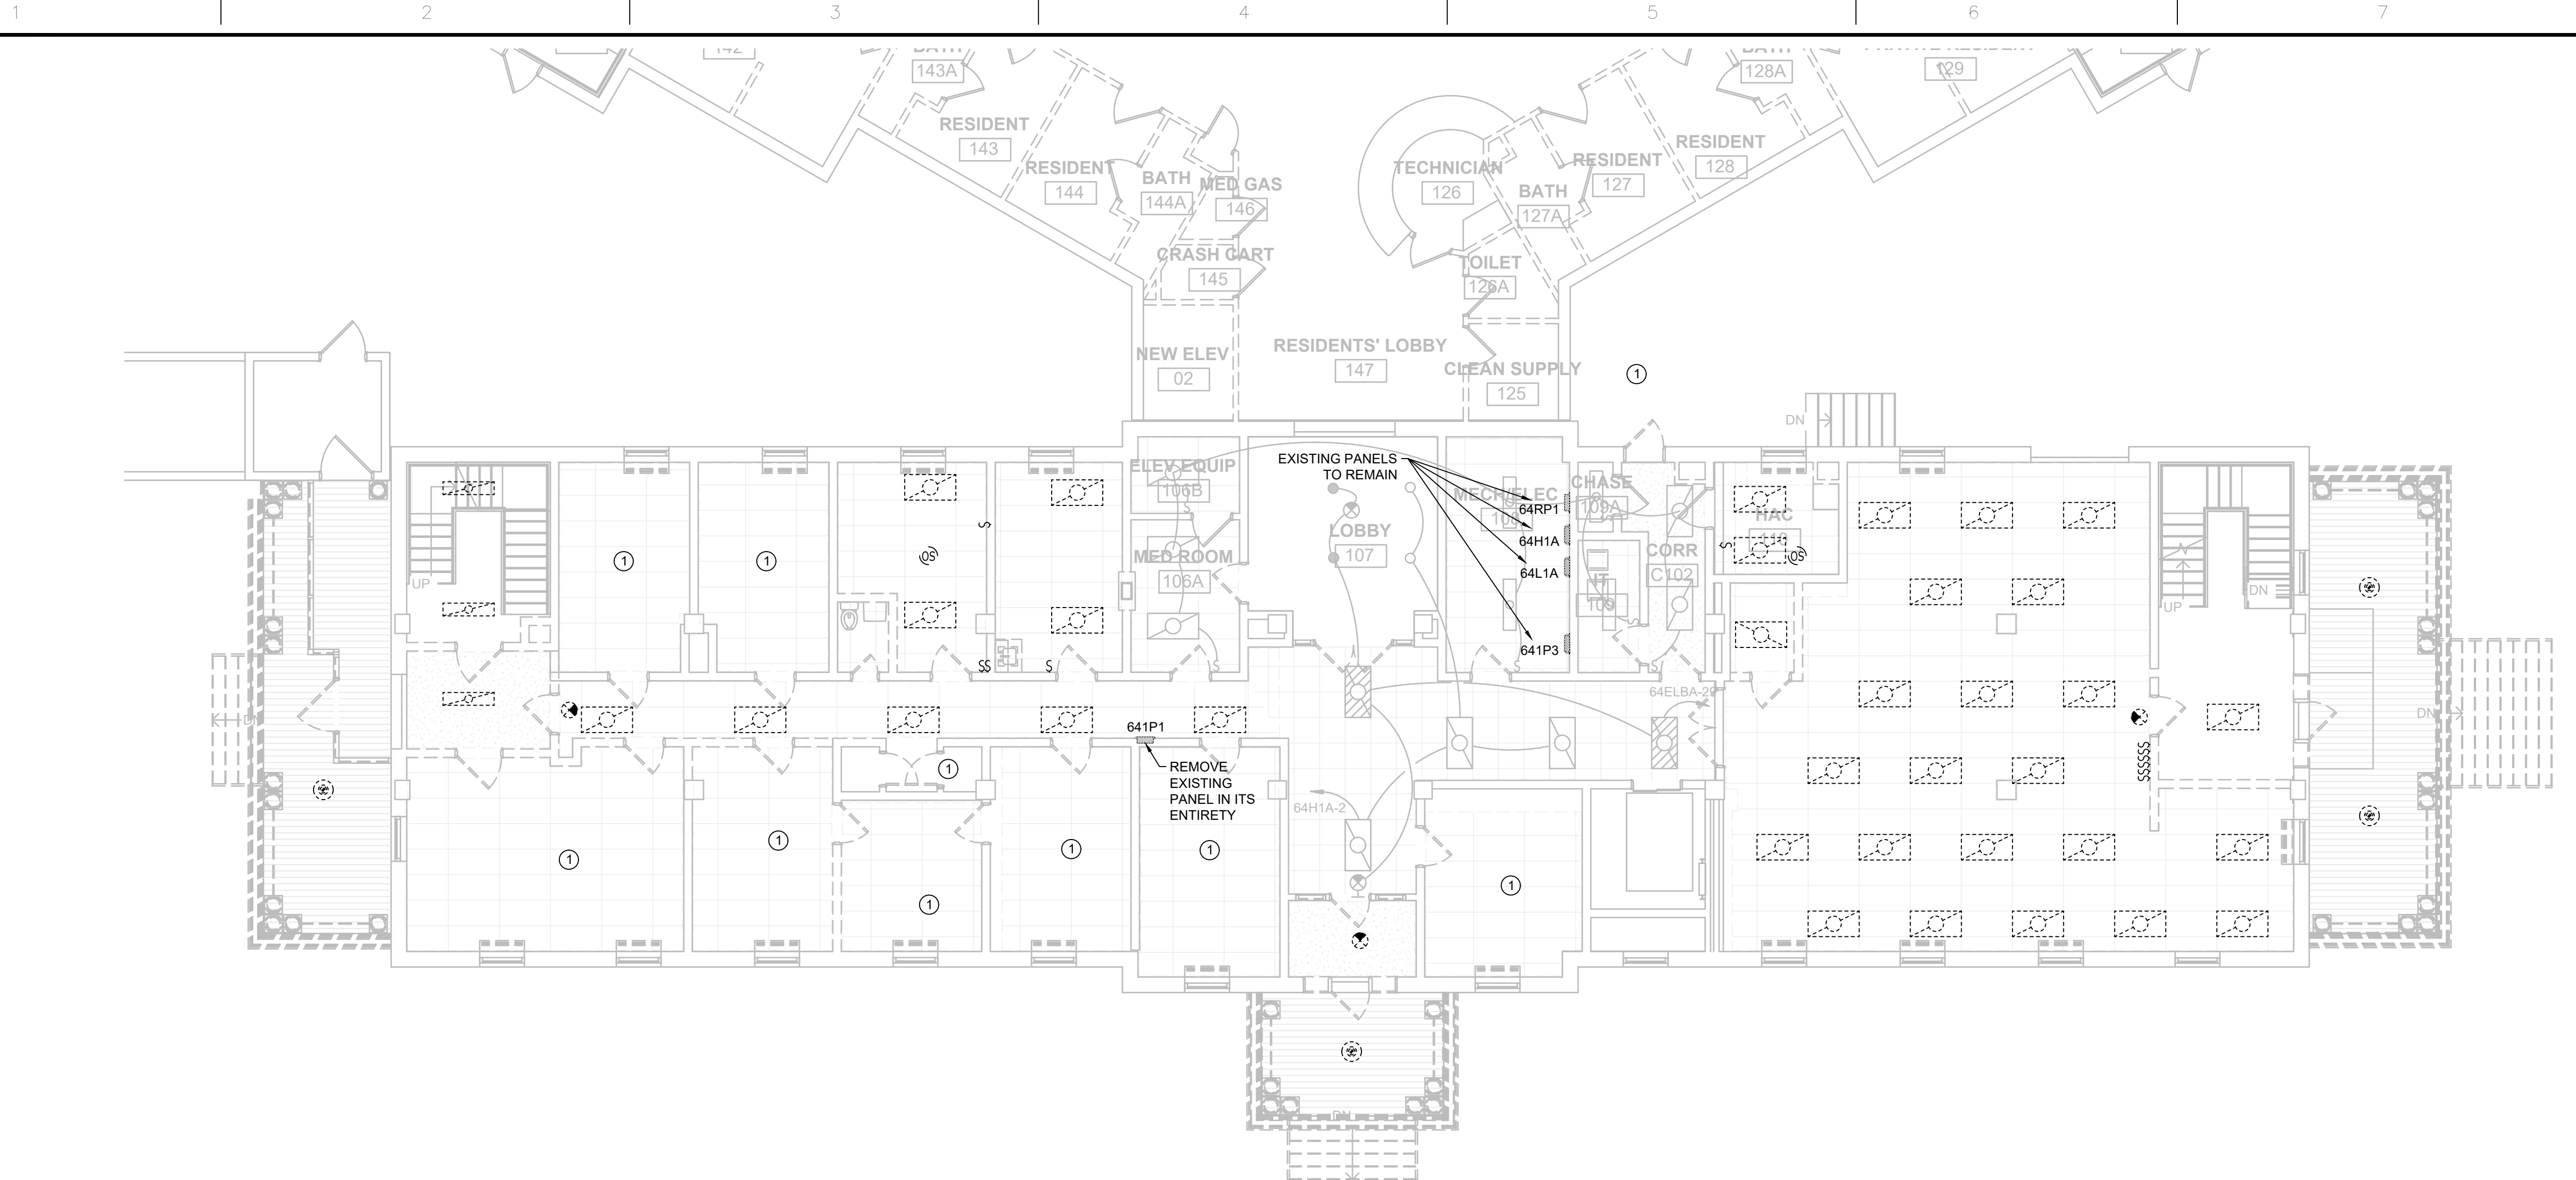
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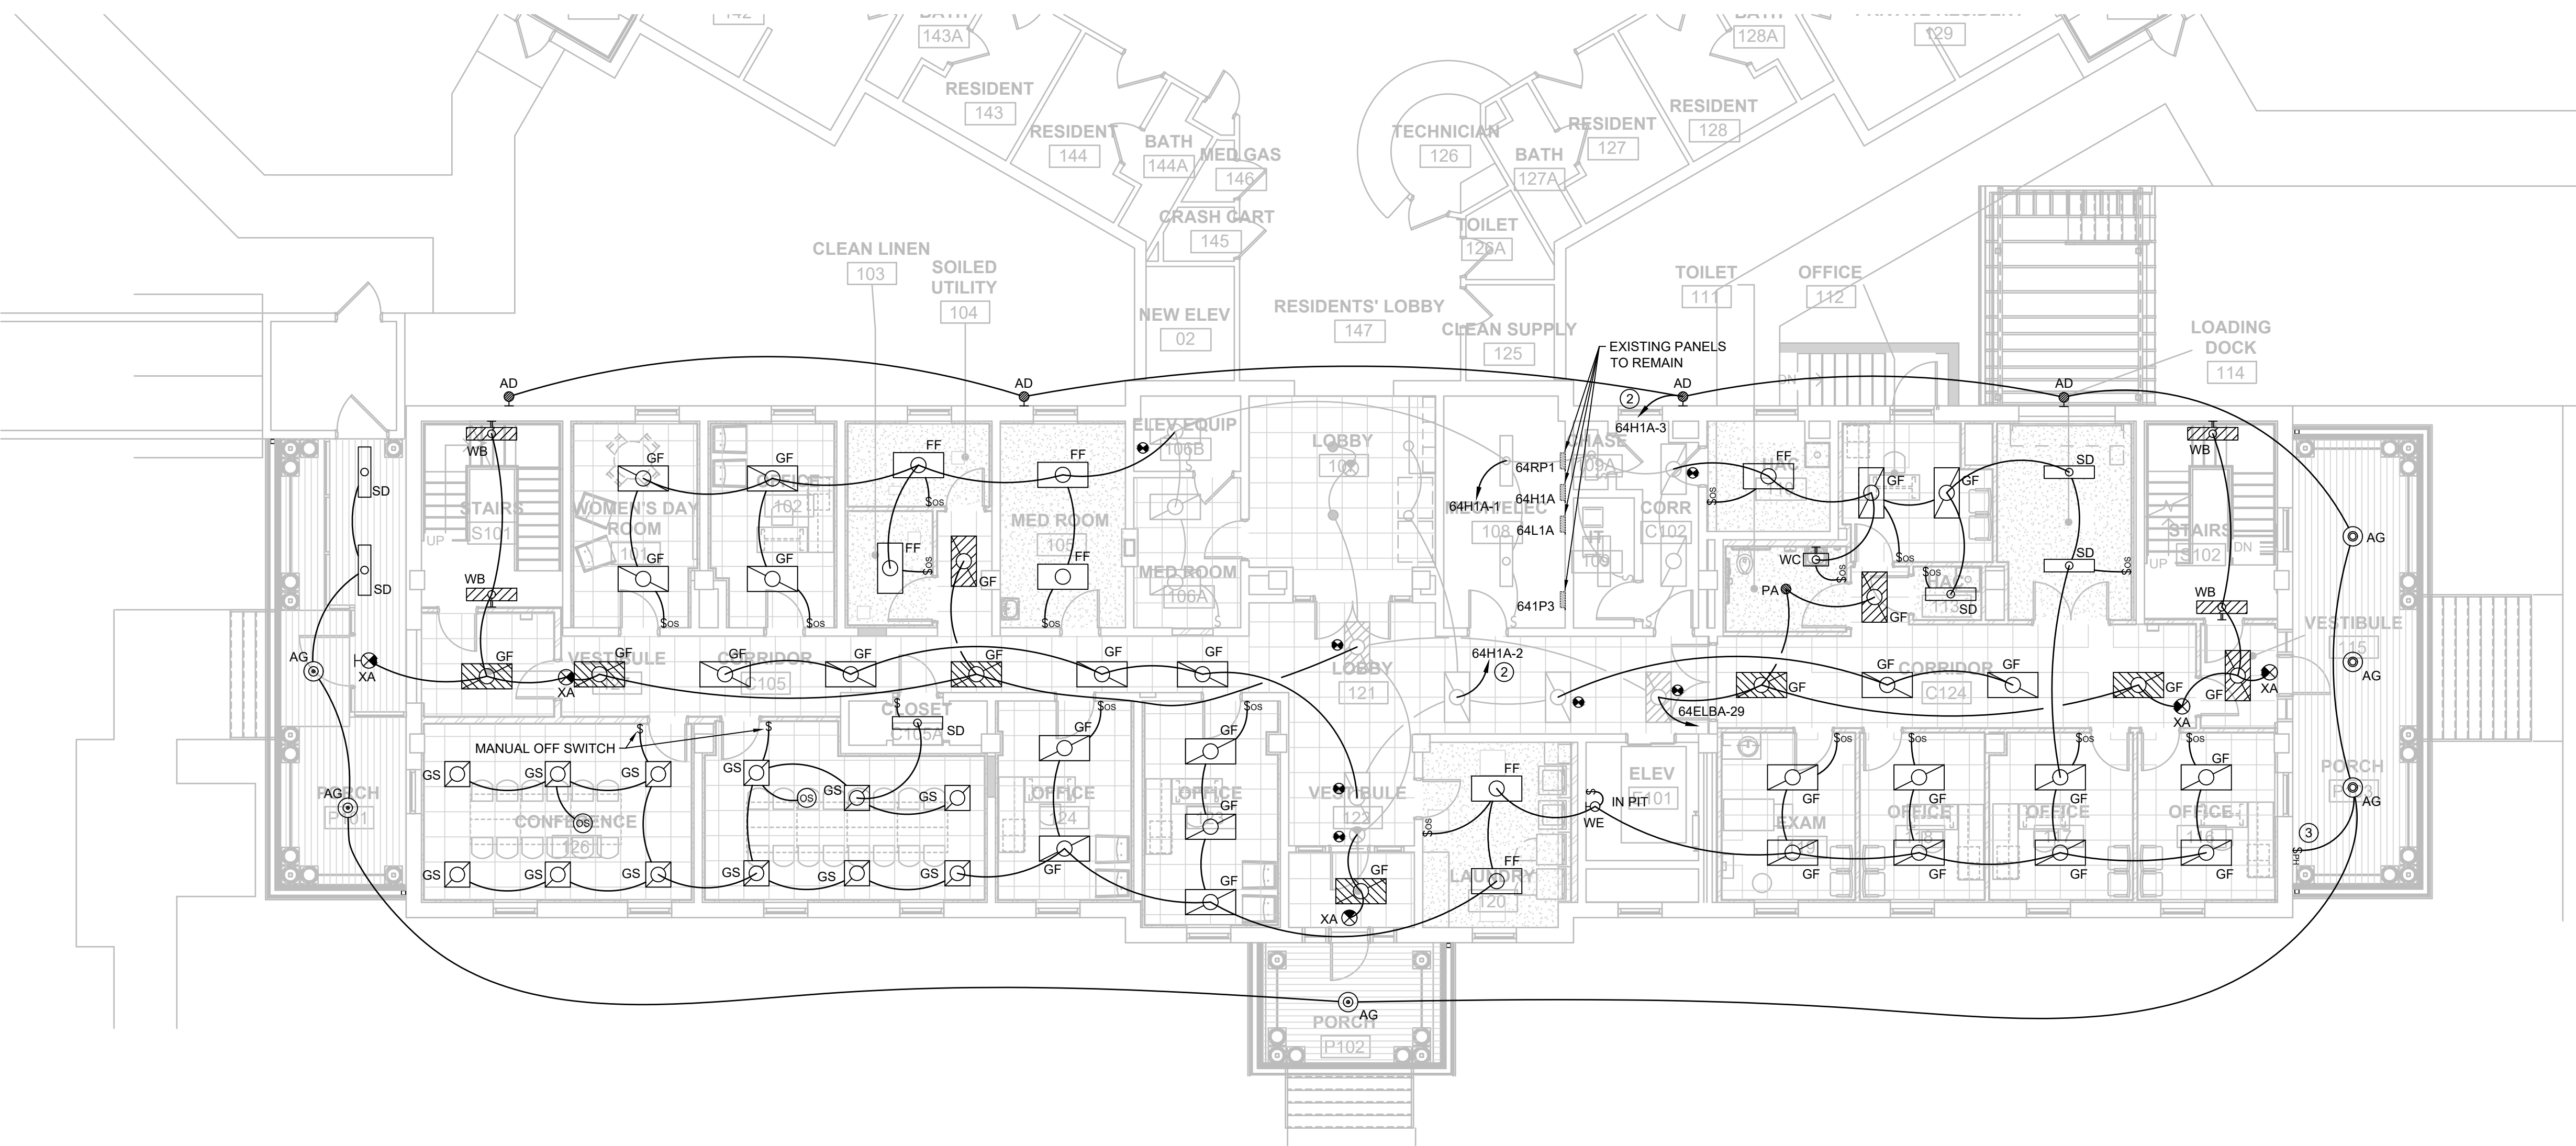
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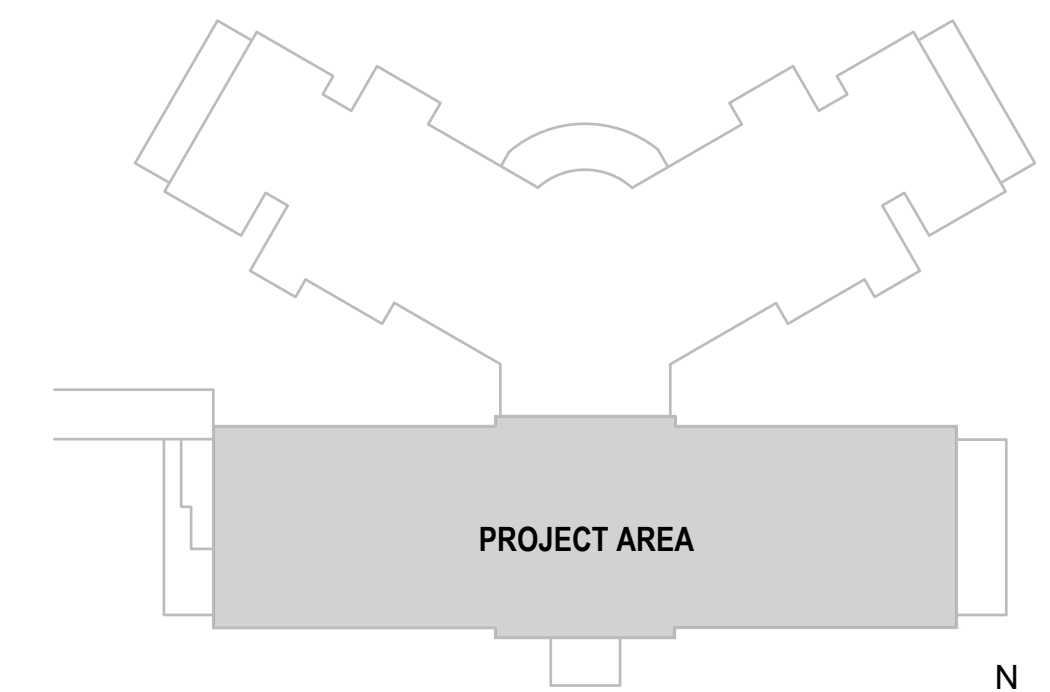


1 FIRST FLOOR FLOORPLAN - LIGHTING DEMOLITION
E201 SCALE: 1/8" = 1'



2 FIRST FLOOR FLOORPLAN - LIGHTING NEW
E201 SCALE: 1/8" = 1'

- KEYED ELECTRICAL NOTES
- ① DEMOLISH ALL LIGHTING FIXTURES, DEVICES, AND ASSOCIATED BRANCH WIRING THIS ROOM UNLESS OTHERWISE NOTED.
 - ② HOME RUN VIA LIGHTING CONTROL RELAY 64RP1.
 - ③ PHOTOCELL TO CONTROL ALL EXTERIOR LIGHTING. CONNECT TO EXISTING RELAY PANEL 64RP1 IN MECH/ELEC 108 PER MANUFACTURERS INSTRUCTIONS.



KEY PLAN
NOT TO SCALE

CONSTRUCTION DOCUMENTS

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