



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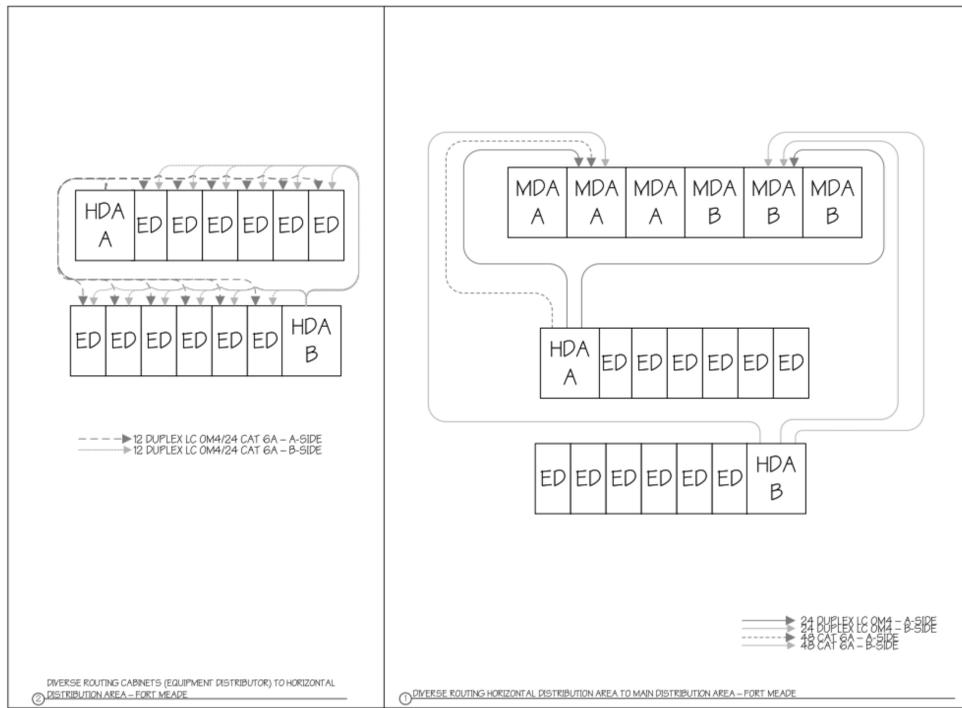
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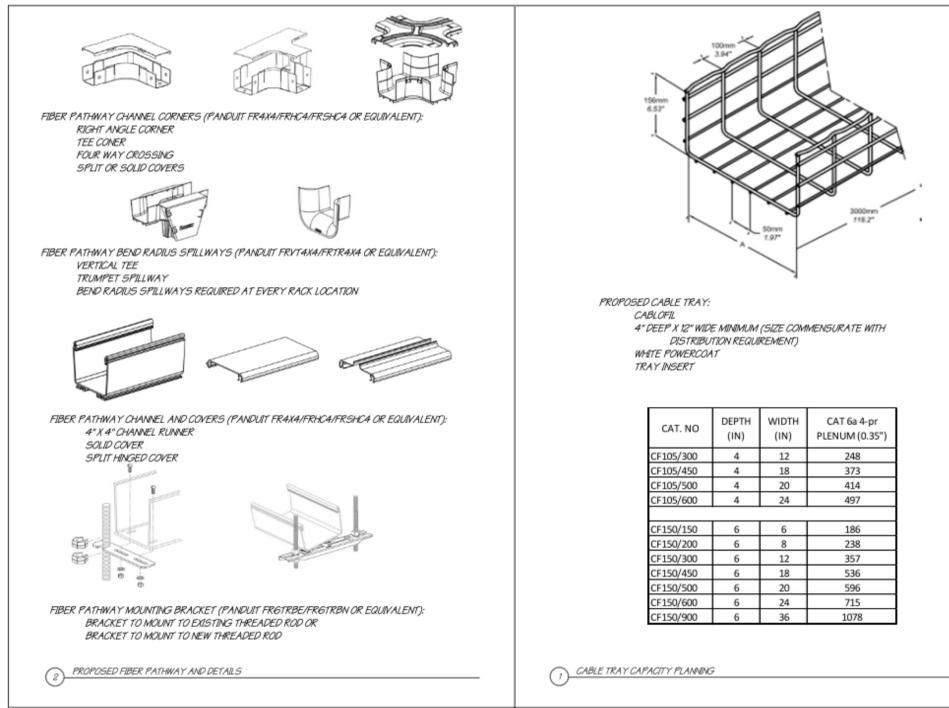
4 VA DATA CENTER MAIN DISTRIBUTION AREA DETAILS  
NOT TO SCALE

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1 VA MCR DETAILS  
NOT TO SCALE

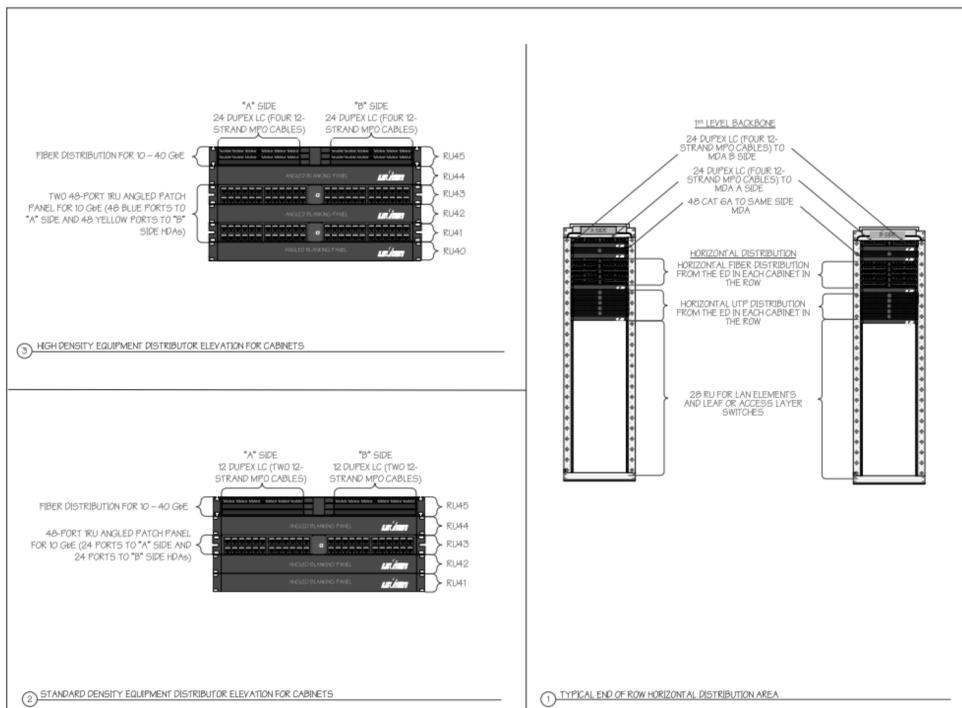

2 VA DATA CENTER PATHWAY DETAILS  
NOT TO SCALE

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Revisions:	Date:
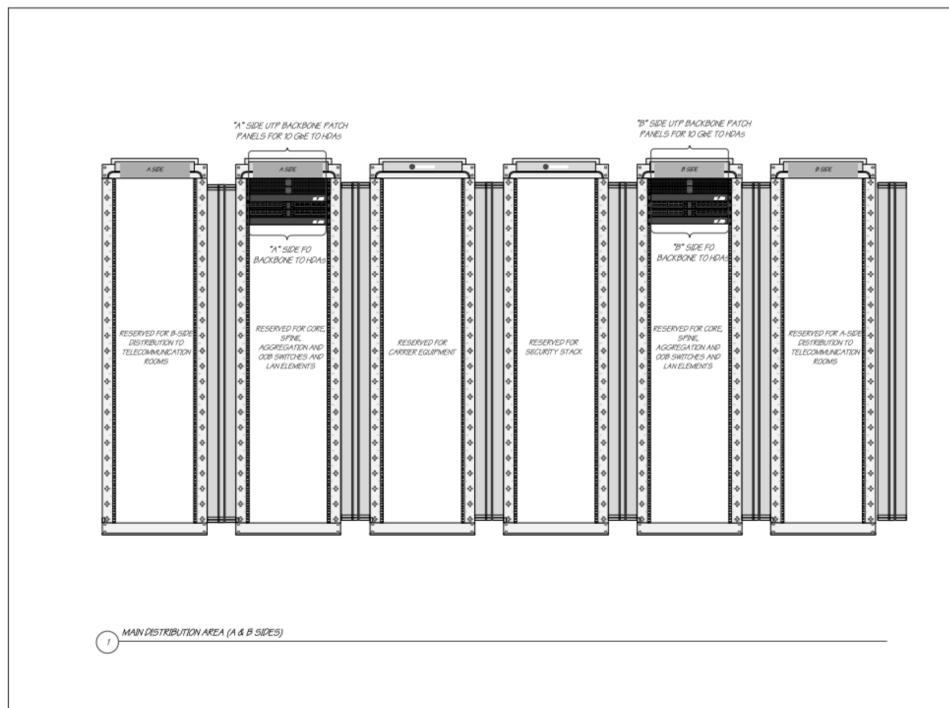
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**STAMP**

**PROGRAM CONTRACTING ACTIVITY CENTRAL (PCAC)**

VA U.S. Department of Veterans Affairs

**DRAWING TITLE**  
MCR DETAILS

APPROVED: Project Director

**PHASE**  
100% CONSTRUCTION DOCUMENTS

**FLS**  
FULLY SPRINKLERED

**PROJECT TITLE**  
EHRM INFRASTRUCTURE UPGRADES

**LOCATION**  
FORT MEADE, SOUTH DAKOTA

**ISSUE DATE**  
05/25/2022



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JAM

**DRAWN BY**  
LKA

**PROJECT NUMBER**  
568-21-701


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BLDG 145

**DRAWING NUMBER**  
145-TN-012

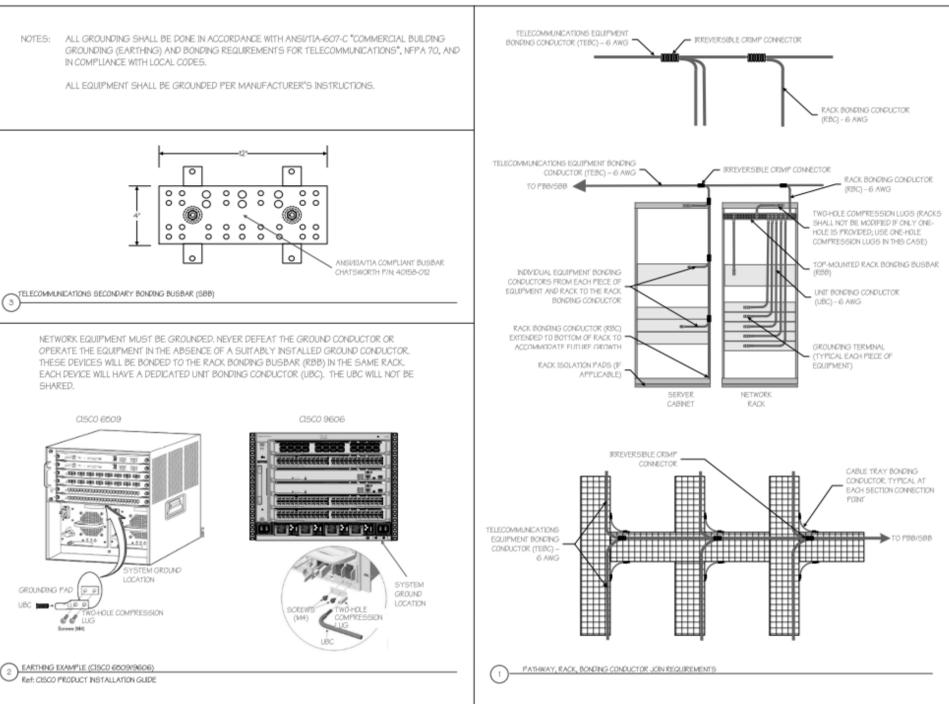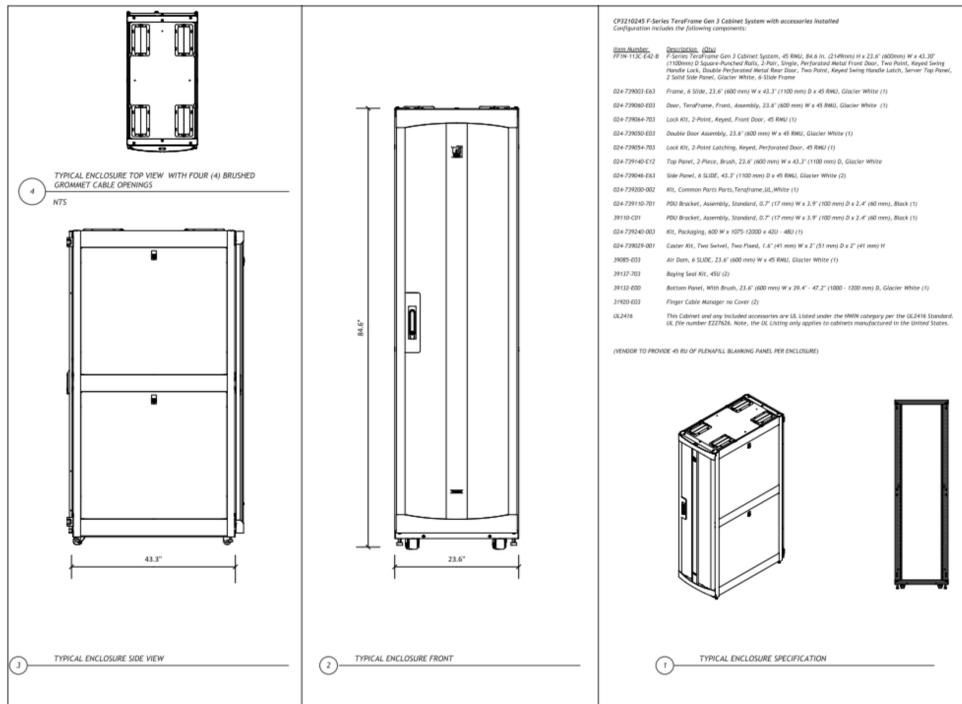


**3 VA TYPICAL SERVER CABINET DETAIL**  
 NOT TO SCALE

**4 VA BONDING DETAIL**  
 NOT TO SCALE

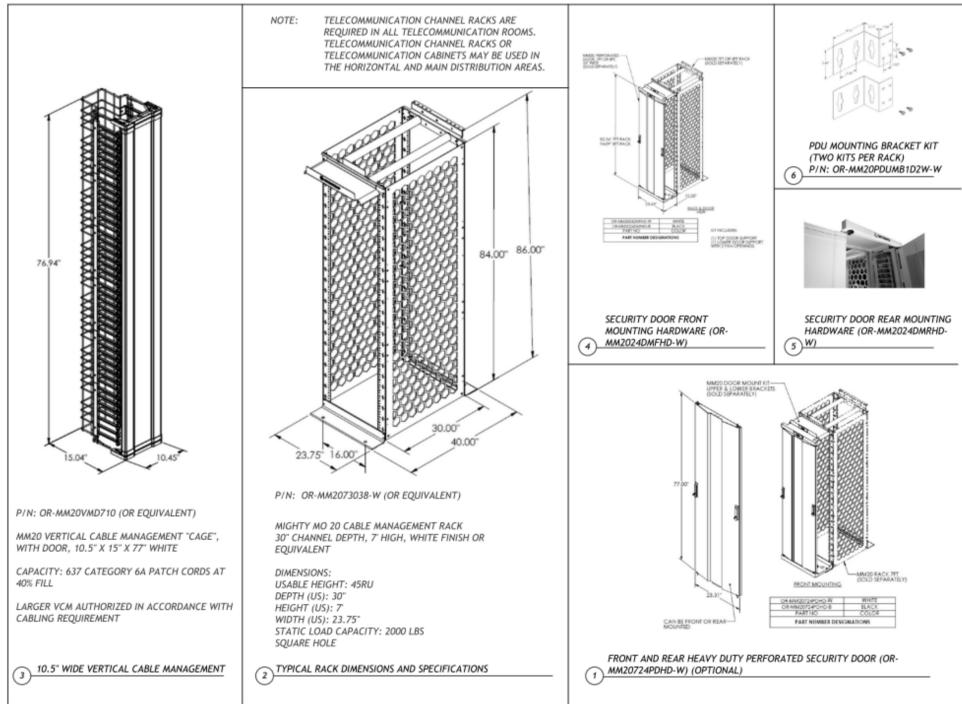

**1 VA TYPICAL NETWORK RACK DETAIL**  
 NOT TO SCALE

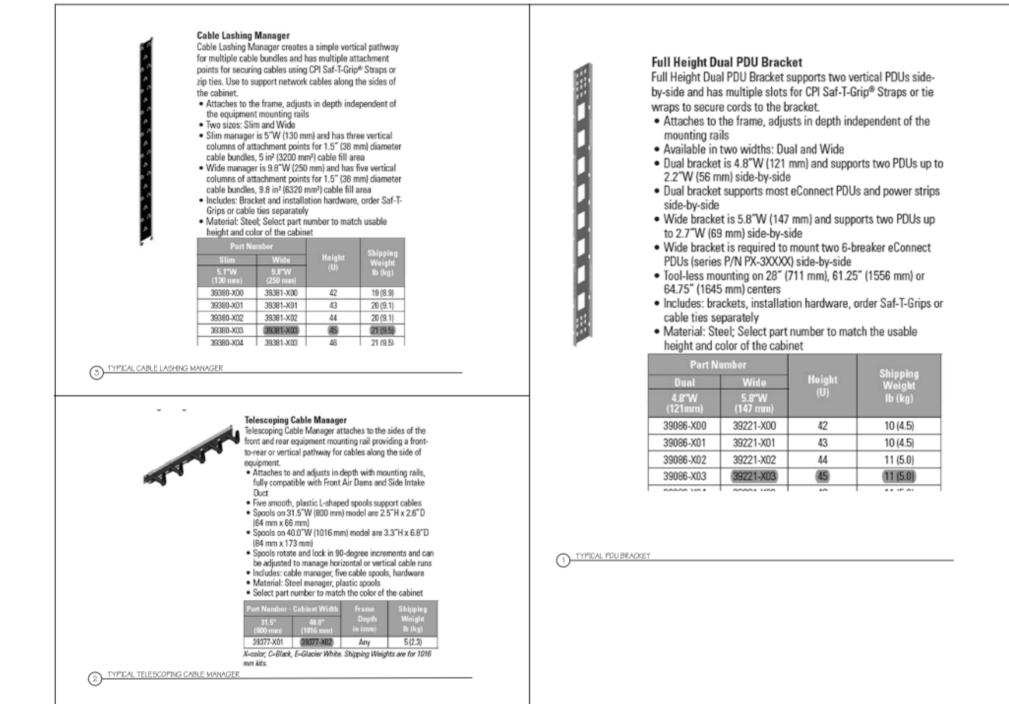

**2 VA TYPICAL NETWORK CABINET ACCESSORIES DETAIL**  
 NOT TO SCALE

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Revisions:	Date:


**CONSULTANT**

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 ADAM GOODIN, PE

**GDM ARCHITECTS - ENGINEERS**

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 Corporate No.: AEC542

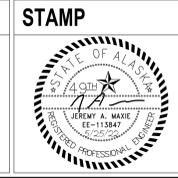

**PROGRAM CONTRACTING ACTIVITY CENTRAL (PCAC)**

VA U.S. Department of Veterans Affairs

**DRAWING TITLE**  
 MCR DETAILS

APPROVED: Project Director

**PHASE**  
 100% CONSTRUCTION DOCUMENTS

**FLS**  
 FULLY SPRINKLERED

**PROJECT TITLE**  
 EHRM INFRASTRUCTURE UPGRADES

**LOCATION**  
 FORT MEADE, SOUTH DAKOTA

**ISSUE DATE**  
 05/25/2022

**CHECKED BY**  
 JAM

**DRAWN BY**  
 LKA

**PROJECT NUMBER**  
 568-21-701

**BUILDING NUMBER**  
 BLDG 145

**DRAWING NUMBER**  
 145-TN-013

A


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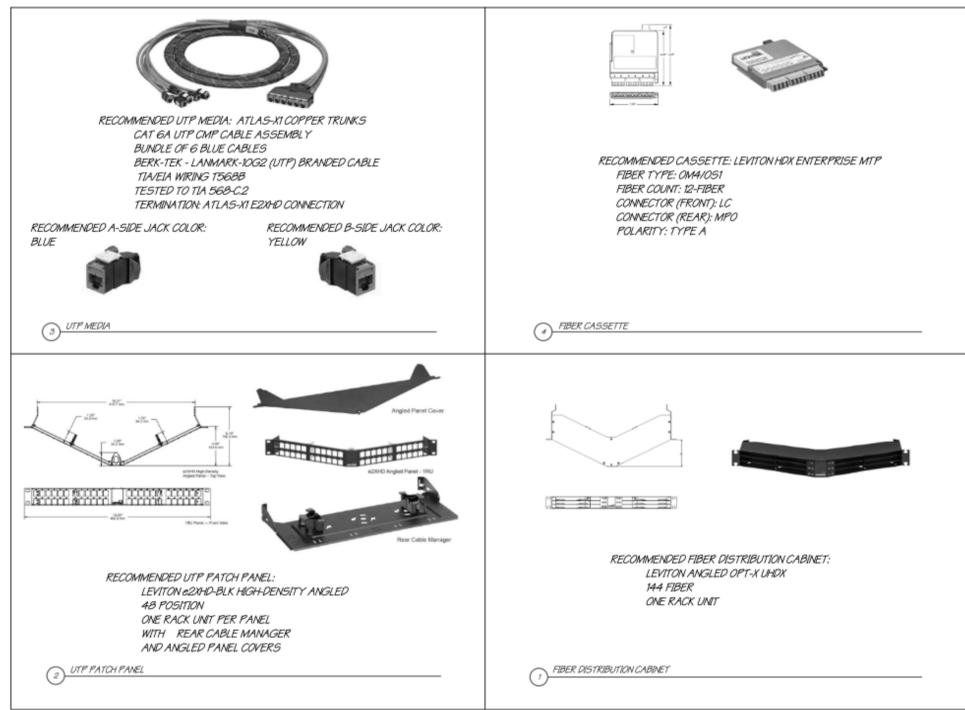
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F



3 MCR GRID IDENTIFICATION  
1/4" = 1'-0"



1 VA MEDIA DETAIL  
NOT TO SCALE

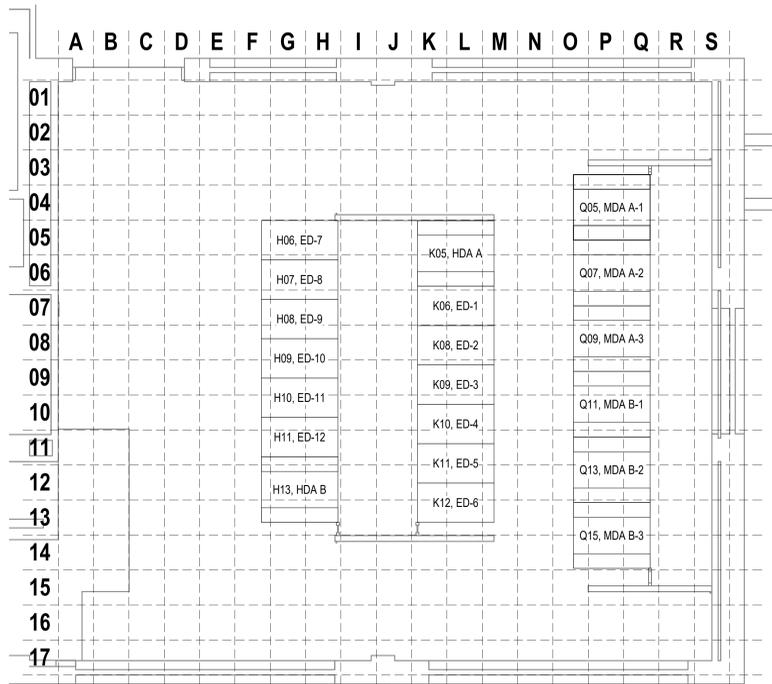ID	PRIMARY ATTRIBUTE	SECONDARY ATTRIBUTE	SPECIFICATION
1	COPPER PATCH PANELS	PERFORMANCE CATEGORY	CATEGORY 6A (10 GRE)
		POSITION COUNT	48
		FORM FACTOR	ANGLED
		SIZE	ONE RACK UNIT (RU)
2	FIBER DISTRIBUTION PANELS	JACK COLOR CODING	A-SIDE BLUE / B-SIDE YELLOW
		CASSETTE CAPACITY	12 CASSETTES OR 6 DOUBLE CASSETTES
		CASSETTE USER INTERFACES	LC DUPLEX CONNECTORS
		CASSETTE BACKBONE INTERFACES	MPO-24
3	UNSHIELDED TWISTED PAIR (UTP) (HORIZONTAL AND FIRST LEVEL BACKBONE)	PERFORMANCE CATEGORY	CATEGORY 6A (10 GRE)
		PERFORMANCE SPECIFICATIONS	MEETS OR EXCEEDS TIA/EIA-568-C-2, T58-85.
		MODE	OM4 LASER OPTIMIZED 40 GIGABIT ETHERNET (40G) / OS1 / OS2
		PERFORMANCE SPECIFICATIONS	LASER OPTIMIZED 20G MTP FIBERS WITH AT LEAST 4000 MEDIUM AT 850 NM / OS1 9/125 SM FIBERS (INTER-BUILDING) / OS2 9/125 SM (INTRA-BUILDING)
4	FIBER (HORIZONTAL AND FIRST LEVEL BACKBONE)	MODE	MULTIMODE/SINGLE MODE (DISTRIBUTION TO TRU ONLY)
		JACKET COLOR	AGUA (RM) / YELLOW (SM)
		MEDIA CONNECTOR	PRE-TERMINATE WITH MULTI-FIBER PUSH ON (MPO), TYPE A (FIELD TERMINATION AUTHORIZED FOR DISTRIBUTION LEAVING THE COMPUTER ROOM)
		STRAND COUNT	12 OR 24
5	UTP PATCH CORDS	PERFORMANCE CATEGORY	CATEGORY 6A 26-28 GAUGE, STRANDED
		PERFORMANCE SPECIFICATIONS	CENTER TUNED TO HORIZONTAL MEDIA
		TERMINATION METHOD	FACTORY PRE-TERMINATED
		PERFORMANCE CATEGORY	OM4 / OS1 / OS2
6	FIBER PATCH CORDS	PERFORMANCE SPECIFICATIONS	LASER OPTIMIZED 20G MTP FIBERS WITH AT LEAST 4000 MEDIUM AT 850 NM / OS1 9/125 SM FIBERS (INTER-BUILDING) / OS2 9/125 SM (INTRA-BUILDING)
		MODE	MULTIMODE/SINGLE MODE (ONLY IN TRU)
		JACKET COLOR	AGUA (RM) / YELLOW (SM)
		MEDIA CONNECTOR	PRE-TERMINATED WITH DUPLEX LC

2 VA SPECIFICATIONS  
NOT TO SCALE

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Revisions:	Date:

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**STAMP**

**PROGRAM CONTRACTING ACTIVITY CENTRAL (PCAC)**

VA U.S. Department of Veterans Affairs

**DRAWING TITLE**  
MCR DETAILS

APPROVED: Project Director

**PHASE**  
100% CONSTRUCTION DOCUMENTS

**FLS**  
FULLY SPRINKLERED

**PROJECT TITLE**  
EHRM INFRASTRUCTURE UPGRADES

**LOCATION**  
FORT MEADE, SOUTH DAKOTA


ISSUE DATE: 05/25/2022  
CHECKED BY: JAM  
DRAWN BY: LKA

**PROJECT NUMBER**  
568-21-701


**BUILDING NUMBER**  
BLDG 145

**DRAWING NUMBER**  
145-TN-014



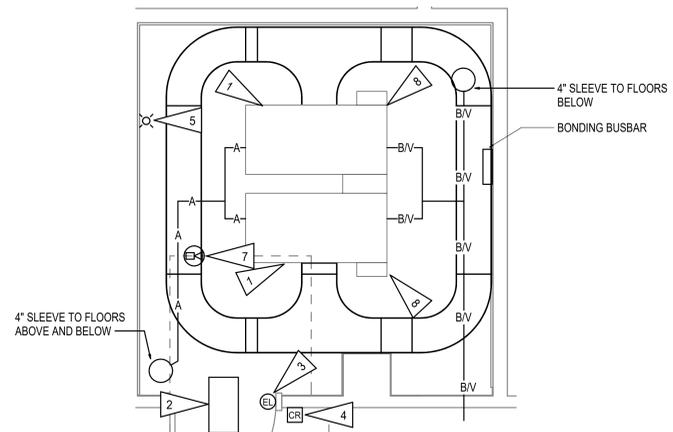

**3 ENLARGED ROOM - 229A TELECOM REMODEL**  
1/2" = 1'-0"

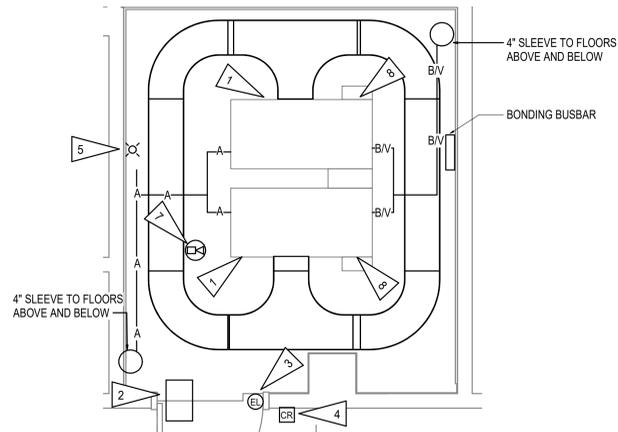



**4 ENLARGED ROOM - 329 TELECOM REMODEL**  
1/2" = 1'-0"

**GENERAL NOTES:**


A SEE 145-TN-011 FOR GENERAL NOTES.

**SHEET NOTES:**

- NEW RACK WITH PATCH PANELS, FIBER HOUSING, UPS, PDU'S, AND SPACE FOR OIT/OEHRM EQUIPMENT.
- NEW CONDUIT SLEEVES INTO ROOM. PROVIDE CONNECTION BETWEEN ADJACENT SPACE AND NEW ROOM.
- ELECTRIFIED HARDWARE PER DIVISION 8. PROVIDE CABLING AND CONNECTION TO ACCESS CONTROL SYSTEM PANEL.
- NEW PROXIMITY CARD READER BY ACCESS CONTROL INTEGRATOR. PROVIDE CABLING AND CONNECTION TO ACCESS CONTROL SYSTEM PANEL.
- NEW STROBE. CONNECT TO LOCAL FIRE ALARM NAC.
- PROVIDE 1"C TO NEW TELECOM CABINET IF EXISTING CANNOT BE RE-USED.
- PROVIDE NEW PAN-TILT-ZOOM SECURITY CAMERA, AXIS M5000 SERIES OR EQUAL, FOR MONITORING TELECOM ROOM. PROVIDE CABLING TO JOHNSON CONTROLS EQUIPMENT. PROVIDE ALL LABOR, CABLING, INTEGRATION, INFRASTRUCTURE, AIM/FOCUS, ETC. FOR AN OPERABLE SOLUTION. IF NO JOHNSON CONTROLS EQUIPMENT IS LOCATED IN THE BUILDING OR WITHIN 250', TERMINATE CABLING ON VA PATCH PANELS AND PROVIDE NETWORK SWITCH FOR CONNECTION TO CENTRAL JCI EQUIPMENT. AIR-GAPPED/DEDICATED VA FIBER MAY BE USED FOR CONNECTION. COORDINATE LOCATION VIEW WITH VA POLICE AND COR PRIOR TO ROUGH-IN.
- TERMINATE NEW 25 STRAND ANALOG BACKBONE ON NEW 24 PORT PATCH PANEL TO SUPPORT (E) ANALOG DEVICES.

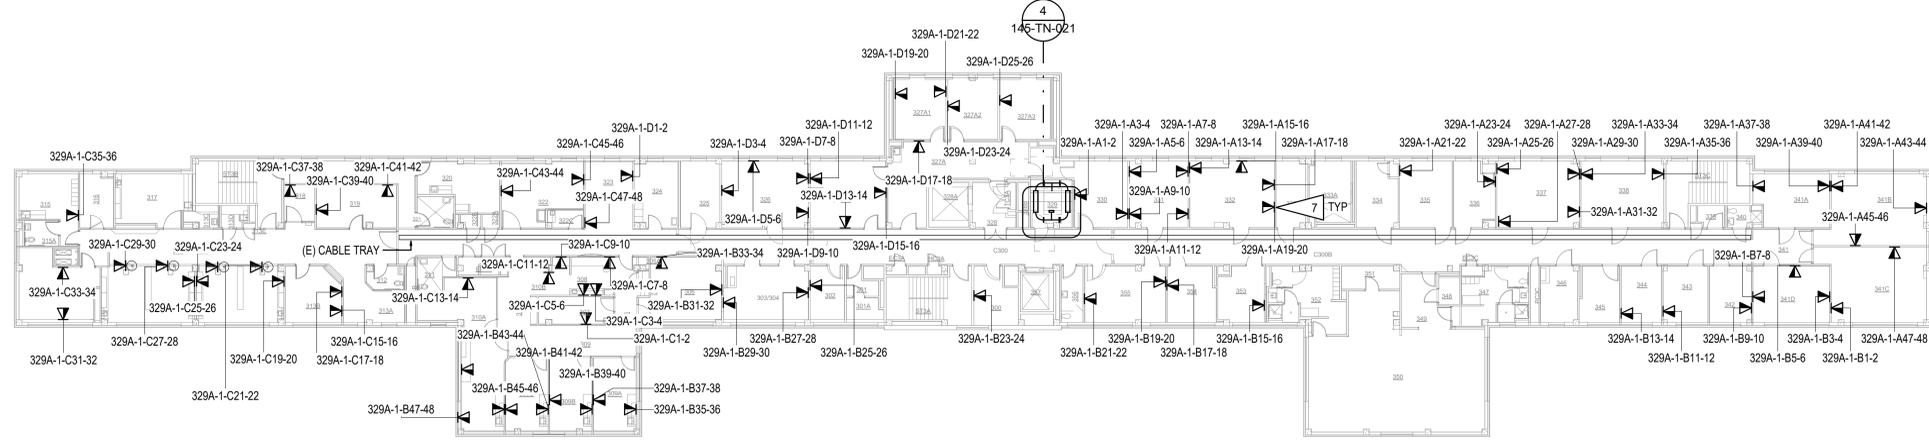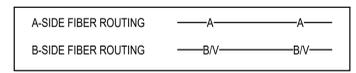


**2 TELECOM REMODEL PLAN - BLDG 145 THIRD FLOOR**  
1/16" = 1'-0"

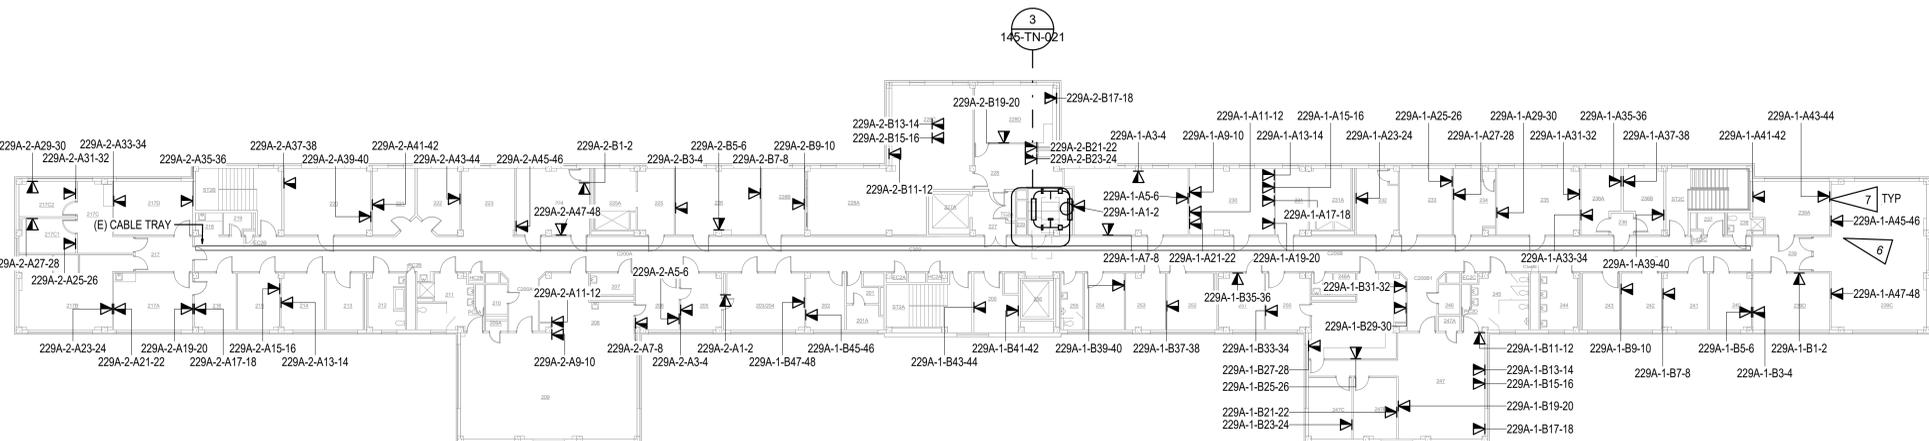

**1 TELECOM REMODEL PLAN - BLDG 145 SECOND FLOOR**  
1/16" = 1'-0"

**PROJECT KEY PLAN**

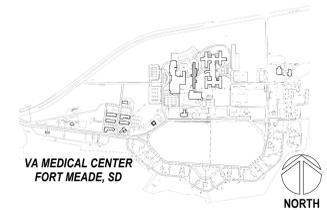

Revisions:	Date:

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**STAMP**

**PROGRAM CONTRACTING ACTIVITY CENTRAL (PCAC)**

VA U.S. Department of Veterans Affairs

**DRAWING TITLE**  
145-TELECOM REMODEL PLAN - SECOND & THIRD FLOORS

APPROVED: Project Director

**PHASE**  
100% CONSTRUCTION DOCUMENTS

**FLS**  
FULLY SPRINKLERED

**PROJECT TITLE**  
EHRM INFRASTRUCTURE UPGRADES

**LOCATION**  
FORT MEADE, SOUTH DAKOTA

ISSUE DATE: 05/25/2022  
CHECKED BY: JAM  
DRAWN BY: LKA

**PROJECT NUMBER**  
568-21-701

**BUILDING NUMBER**  
BLDG 145

**DRAWING NUMBER**  
145-TN-021

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VA FORM 08 - 6231




**GENERAL NOTES:**



- A. SEE TK SERIES FOR DETAILS AND SCHEDULES.
- B. INTENT IS TO PROVIDE (2) CABLES PER WORK AREA OUTLET, UNLESS OTHERWISE NOTED. TO PHASE WORK SO THAT EXISTING NETWORK IS MAINTAINED UNTIL NEW ROOMS ARE OPERABLE. GENERAL APPROACH IS TO FIRST REPLACE CABLING IN (1) OUTLET WHERE (2) EXIST, OR PROVIDE A SECOND IF NOT.
- C. IF PHASING ALLOWS FOR ALL CABLING IN A BUILDING OR AREA TO BE MIGRATED IN A NIGHT OR WEEKEND WITHOUT DISRUPTIONS, EXISTING SINGLE OUTLETS MAY BE RE-USED.

**SHEET NOTES:**

1. NEW RACK WITH PATCH PANELS, FIBER HOUSING, UPS, PDU'S, AND SPACE FOR OIT/OEHRM EQUIPMENT.
2. NEW CONDUIT SLEEVES INTO ROOM. PROVIDE CONNECTION BETWEEN ADJACENT SPACE AND NEW ROOM.
3. ELECTRIFIED HARDWARE PER DIVISION 8. PROVIDE CABLING AND CONNECTION TO ACCESS CONTROL SYSTEM PANEL.
4. NEW PROXIMITY CARD READER BY ACCESS CONTROL INTEGRATOR. PROVIDE CABLING AND CONNECTION TO ACCESS CONTROL SYSTEM PANEL.
5. NEW STROBE. CONNECT TO LOCAL FIRE ALARM NAC.
6. PROPOSED A-SIDE FIBER ROUTING IN CEILING ABOVE HALLWAY FROM BUILDING 113.
7. PROPOSED B-SIDE FIBER ROUTING IN CRAWLSPACE AND BASEMENT FROM BUILDING 145. STAB UP TO FIRST FLOOR AS CLOSE TO NEW TELECOM ROOM AS POSSIBLE.
8. PROVIDE 1°C TO NEW TELECOM CABINET IF EXISTING CANNOT BE RE-USED.
9. PROVIDE NEW PAN-TILT-ZOOM SECURITY CAMERA, AXIS M5000 SERIES OR EQUAL, FOR MONITORING TELECOM ROOM. PROVIDE CABLING TO JOHNSON CONTROLS EQUIPMENT. PROVIDE ALL LABOR, CABLING, INTEGRATION, INFRASTRUCTURE, AIMFOCUS, ETC. FOR AN OPERABLE SOLUTION. IF NO JOHNSON CONTROLS EQUIPMENT IS LOCATED IN THE BUILDING OR WITHIN 250', TERMINATE CABLING ON VA PATCH PANELS AND PROVIDE NETWORK SWITCH FOR CONNECTION TO CENTRAL JCI EQUIPMENT. AIR-GAPPED/DEDICATED VA FIBER MAY BE USED FOR CONNECTION. COORDINATE LOCATION/VIEW WITH VA POLICE AND COR PRIOR TO ROUGH-IN.
10. TERMINATE NEW 25 STRAND ANALOG BACKBONE ON NEW 24 PORT PATCH PANEL TO SUPPORT (E) ANALOG DEVICES.
11. B-SIDE FIBER AND ANALOG VOICE CABLING FOR BUILDINGS 113. CRAWLSPACE BELOW HALLWAY BETWEEN BUILDINGS 113 AND 146.

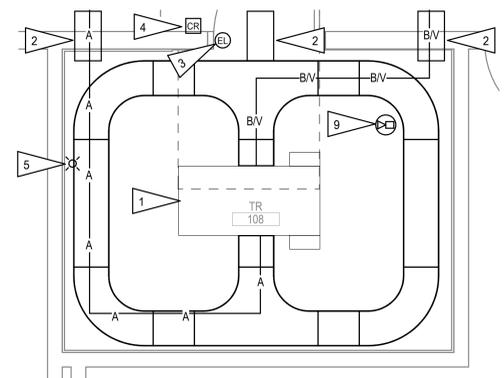

**2 ENLARGED ROOM - 108 TELECOM REMODEL**  
1/2" = 1'-0"  
**PROJECT KEY PLAN**

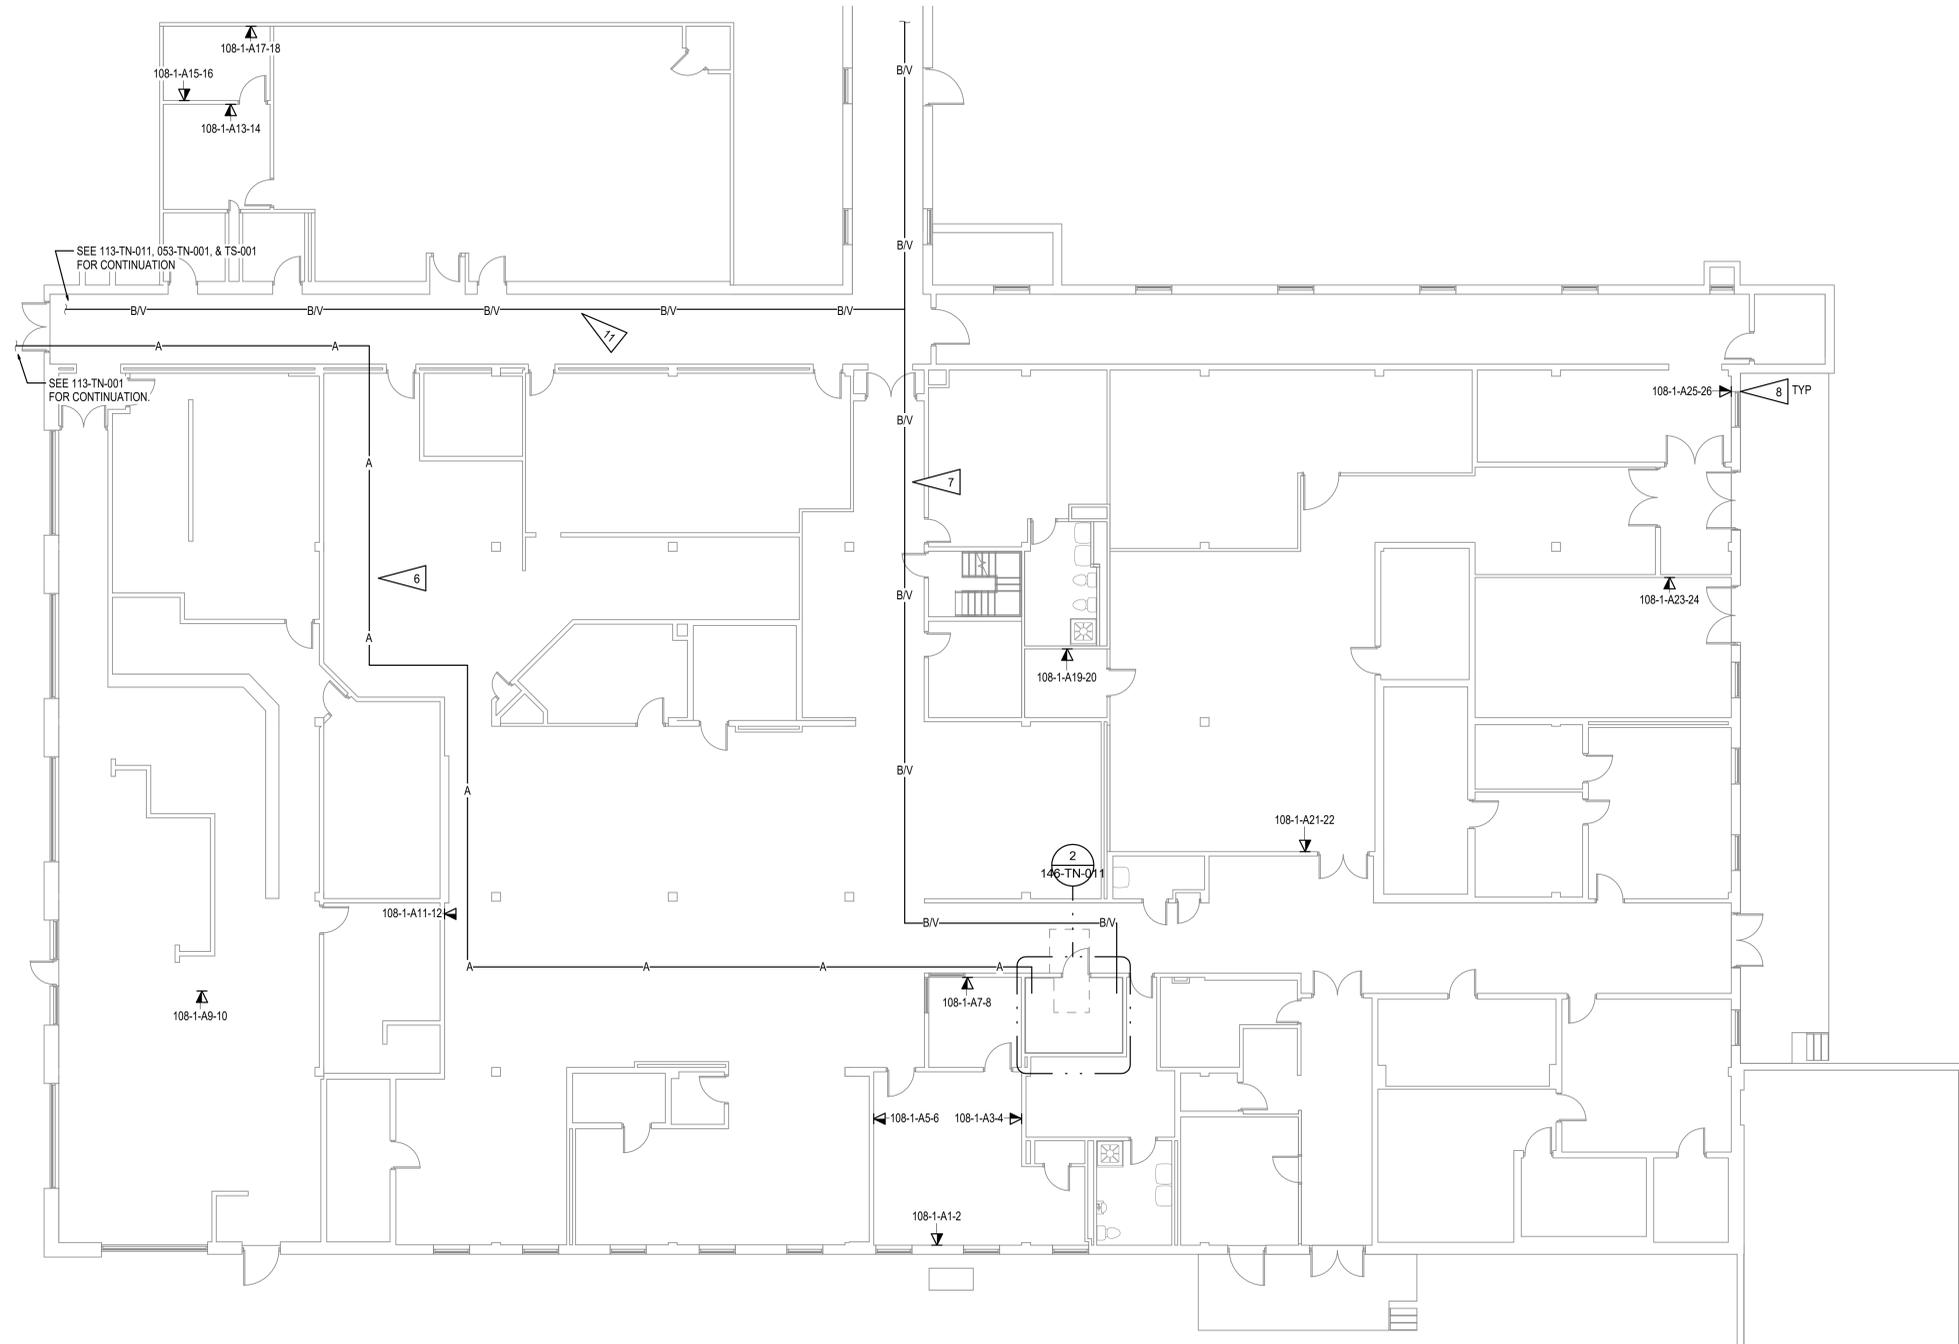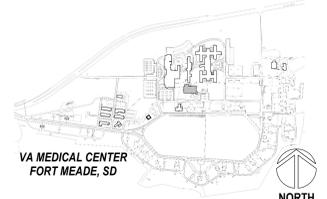

**1 TELECOM REMODEL PLAN - BLDG 146 FIRST FLOOR**  
1/8" = 1'-0"

Revisions:	Date:

**CONSULTANT**

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**PROGRAM CONTRACTING ACTIVITY CENTRAL (PCAC)**

VA U.S. Department of Veterans Affairs

**DRAWING TITLE**  
146-TELECOM REMODEL PLAN - FIRST FLOOR

APPROVED: Project Director

**PHASE**  
100% CONSTRUCTION DOCUMENTS

FLS  
FULLY SPRINKLERED

**PROJECT TITLE**  
EHRM INFRASTRUCTURE UPGRADES

**LOCATION**  
FORT MEADE, SOUTH DAKOTA

ISSUE DATE: 05/25/2022  
CHECKED BY: JAM  
DRAWN BY: CK, LKA

**PROJECT NUMBER**  
568-21-701

**BUILDING NUMBER**  
146

**DRAWING NUMBER**  
146-TN-011










**PROJECT KEY PLAN**


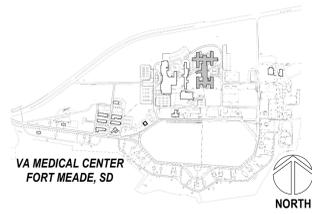


**GENERAL NOTES:**

- A. SEE TK SERIES FOR DETAILS AND SCHEDULES.
- B. INTENT IS TO PROVIDE (2) CABLES PER WORK AREA OUTLET, UNLESS OTHERWISE NOTED. TO PHASE WORK SO THAT EXISTING NETWORK IS MAINTAINED UNTIL NEW ROOMS ARE OPERABLE, GENERAL APPROACH IS TO FIRST REPLACE CABLING IN (1) OUTLET WHERE (2) EXIST, OR PROVIDE A SECOND IF NOT.
- C. IF PHASING ALLOWS FOR ALL CABLING IN A BUILDING OR AREA TO BE MIGRATED IN A NIGHT OR WEEKEND WITHOUT DISRUPTIONS, EXISTING SINGLE OUTLETS MAY BE RE-USED.

**SHEET NOTES:**

- 1. PROPOSED B-SIDE FIBER AND ANALOG VOICE CABLING ROUTE. FIBER TO BE IN CONDUIT IN THIS BUILDING. MAINTAIN MAXIMUM POSSIBLE SPACING FROM B-SIDE FIBER IN SHARED HALLWAYS.
- 2. PROPOSED A-SIDE FIBER ROUTE. FIBER TO BE IN CONDUIT IN THIS BUILDING. MAINTAIN MAXIMUM POSSIBLE SPACING FROM A-SIDE FIBER IN SHARED HALLWAYS.
- 3. EXISTING SIGNAL CONDUIT PATHWAY FROM BUILDING 145
- 4. FIBER TO BE IN CONDUIT IN SHARED HALLWAYS. MAINTAIN MAXIMUM POSSIBLE SEPARATION BETWEEN A-SIDE AND B-SIDE FIBER WITHIN HALLWAY.
- 5. ROUTE A-SIDE FIBER INTO BUILDING THROUGH NEW SITE WORK FROM BUILDING 145. SEE TS-001 FOR DETAILS.

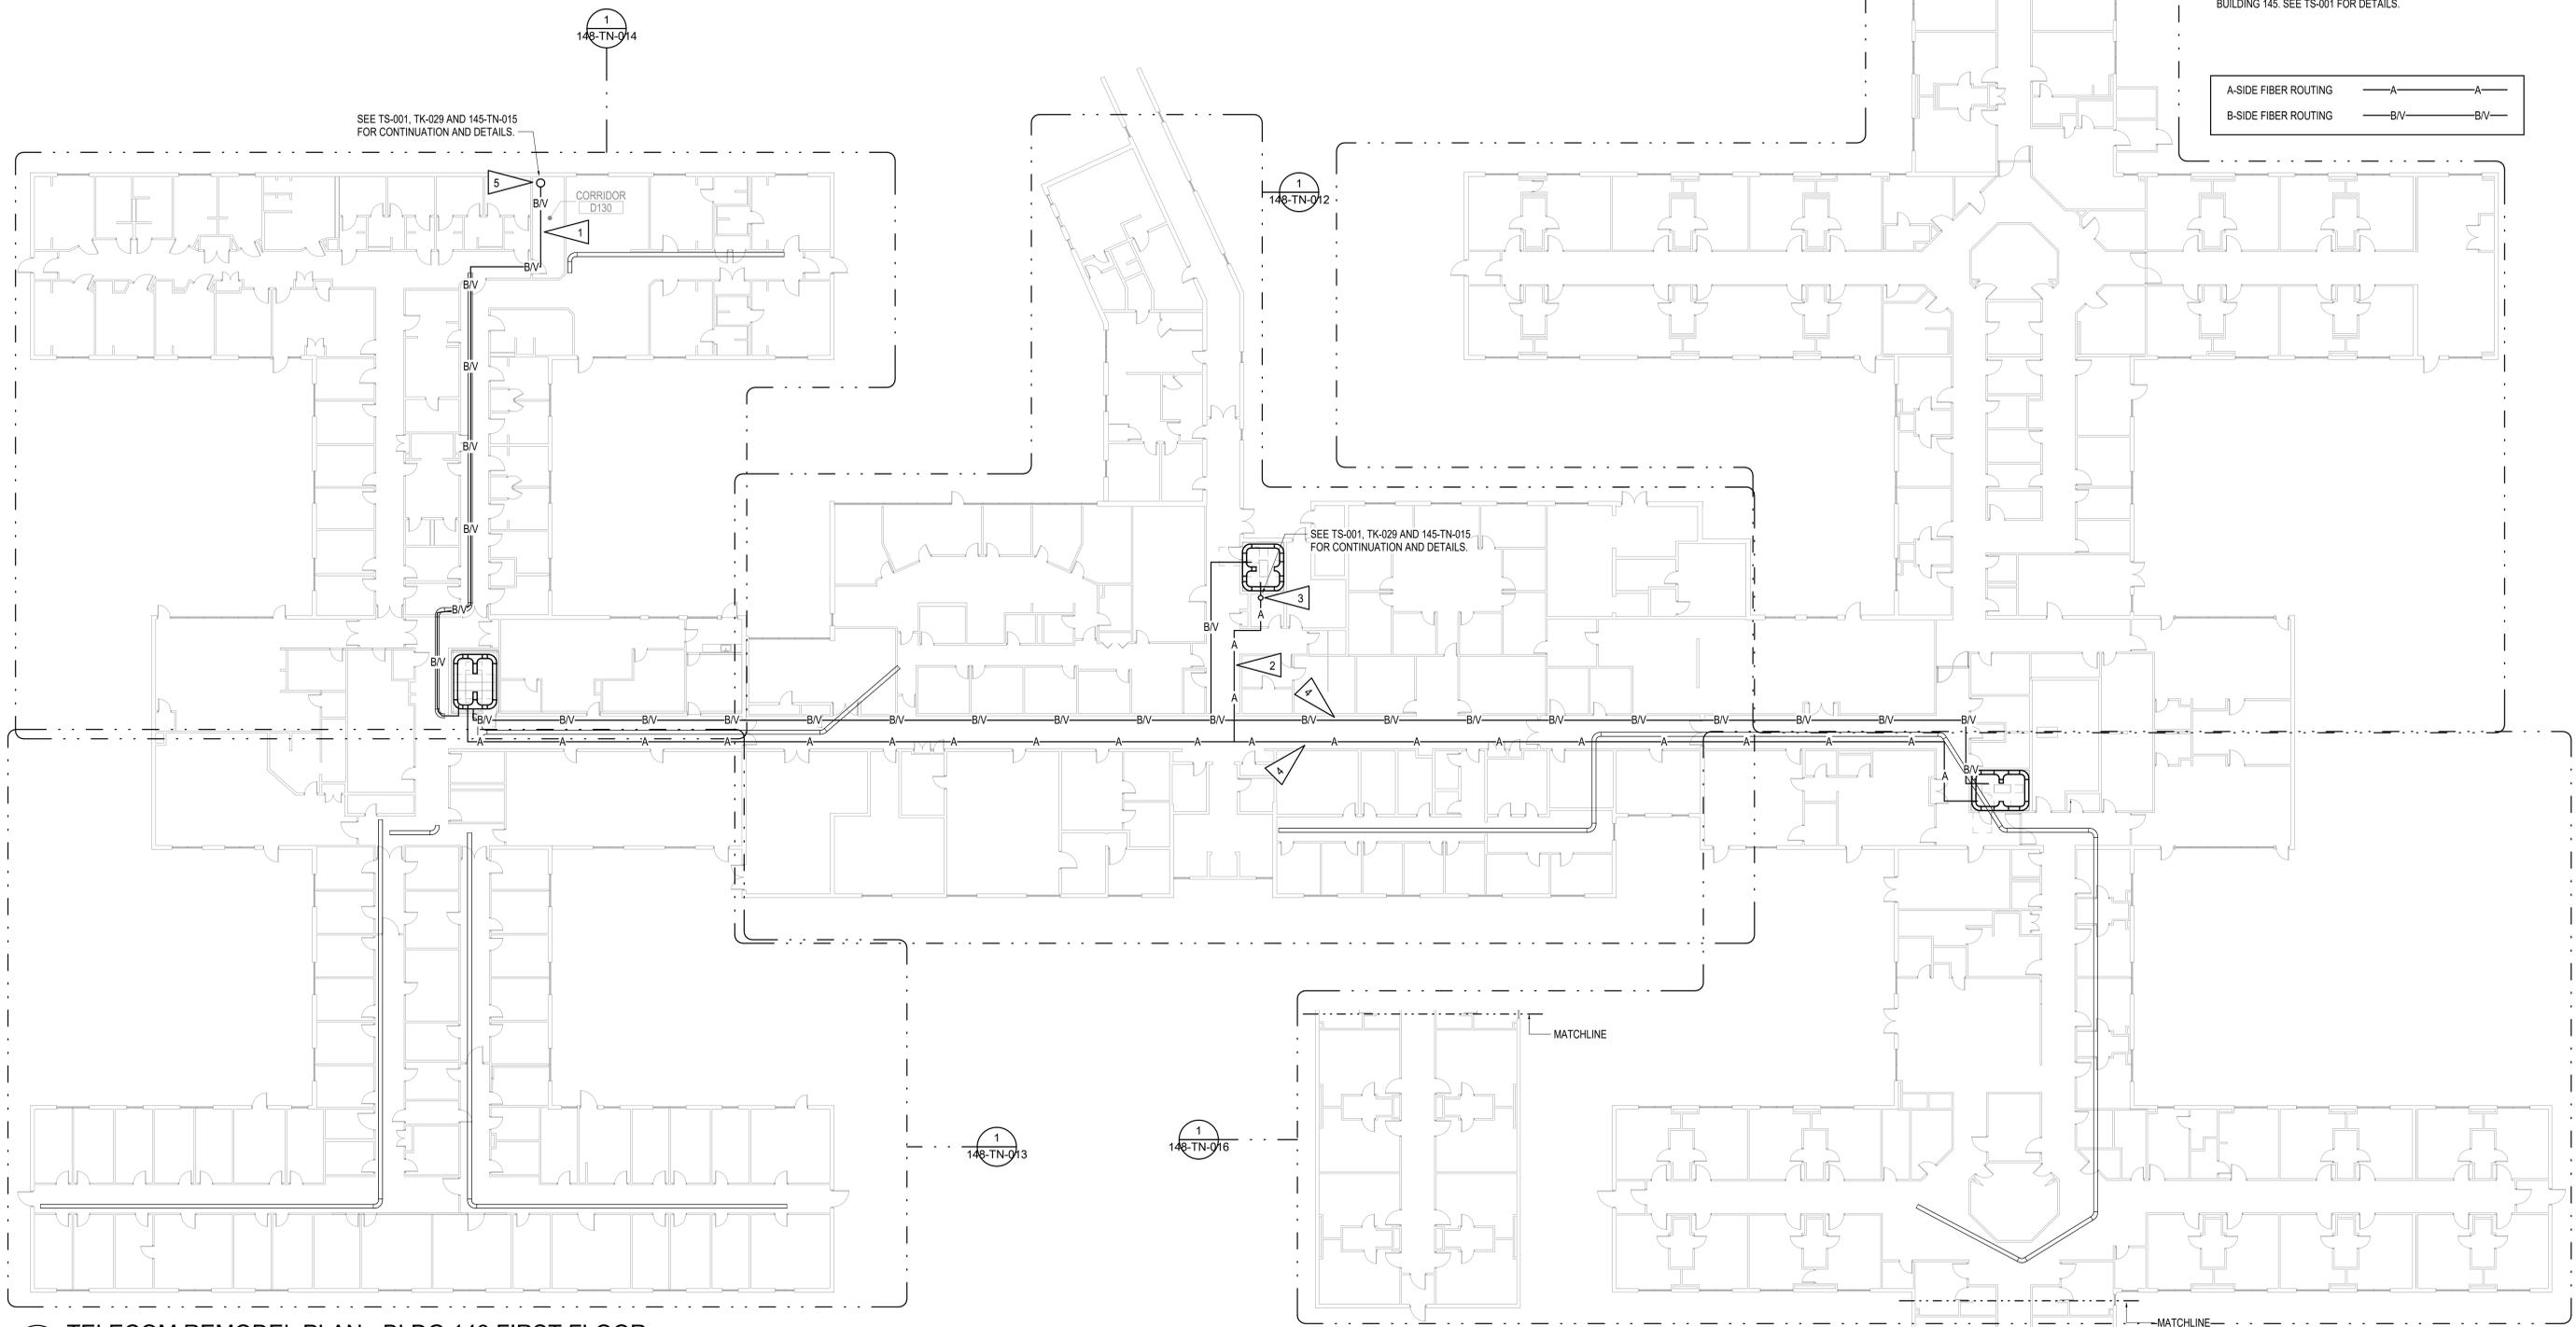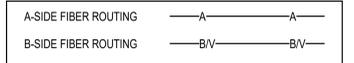

**1 TELECOM REMODEL PLAN - BLDG 148 FIRST FLOOR**  
1/16" = 1'-0"

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VA FORM 08-6231

Revisions:	Date:

**CONSULTANT**  
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**STAMP**

**PROGRAM CONTRACTING ACTIVITY CENTRAL (PCAC)**

**DRAWING TITLE**  
148-TELECOM REMODEL PLAN - FIRST FLOOR

APPROVED: Project Director

**PHASE**  
100% CONSTRUCTION DOCUMENTS

**FLS**  
FULLY SPRINKLERED

**PROJECT TITLE**  
EHRM INFRASTRUCTURE UPGRADES

**LOCATION**  
FORT MEADE, SOUTH DAKOTA

ISSUE DATE: 05/25/2022  
CHECKED BY: JAM  
DRAWN BY: CK,LKA


**PROJECT NUMBER**  
568-21-701

**BUILDING NUMBER**  
BLDG 148

**DRAWING NUMBER**  
148-TN-011

**GENERAL NOTES:**

- A. DISTANCE ASSESSMENT PER VA REQUIREMENTS NOTES ALL CABLING SHALL BE COMPLIANT.

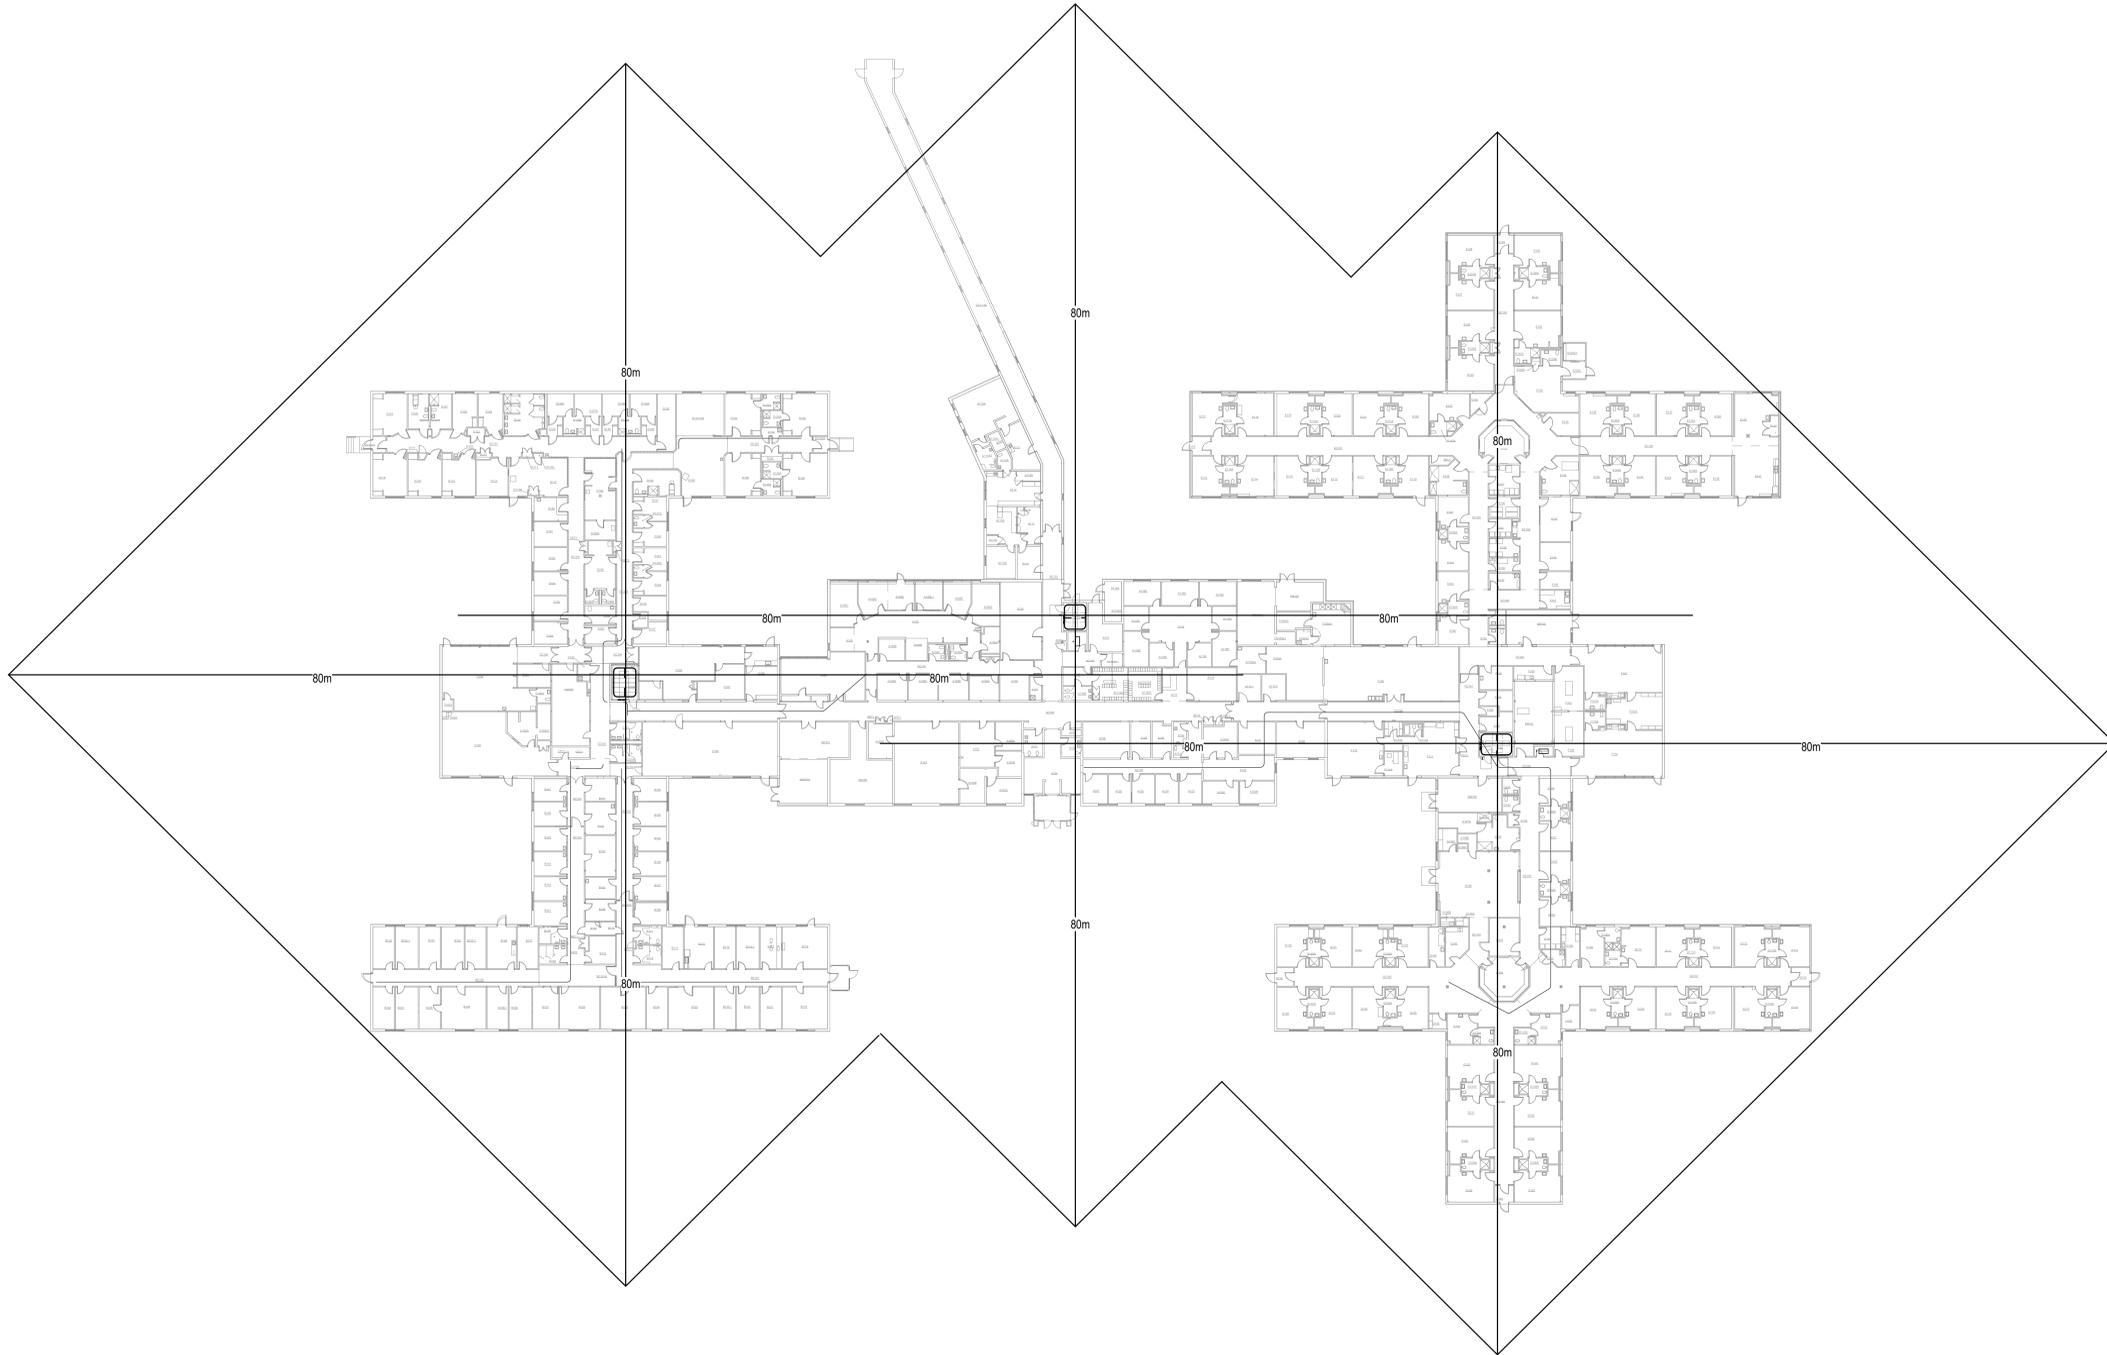

1 TELECOM DISTANCE ASSESSMENT - BLDG 148  
1" = 30'-0"



BIM 360://112\_VA Medical Center - Ft Meade SDSERIES - BLDG 148\_220.rvt  
 5/25/2022 11:01:18 AM  
 VA FORM 08 - 6231

Revisions:	Date:

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 Corporate No.: AEC542

**STAMP**

**PROGRAM CONTRACTING ACTIVITY CENTRAL (PCAC)**

**VA** U.S. Department of Veterans Affairs

**DRAWING TITLE**  
 148 - TELECOM DISTANCE ASSESSMENT

APPROVED: Project Director

**PHASE**  
 100% CONSTRUCTION DOCUMENTS

**FLS**  
 FULLY SPRINKLERED

**PROJECT TITLE**  
 EHRM INFRASTRUCTURE UPGRADES

**LOCATION**  
 FORT MEADE, SOUTH DAKOTA


ISSUE DATE: 05/25/2022  
 CHECKED BY: JAM  
 DRAWN BY: CK,LKA

**PROJECT NUMBER**  
 568-21-701

**BUILDING NUMBER**  
 BLDG 148

**DRAWING NUMBER**  
**148-TN-011.1**

**PROJECT KEY PLAN**

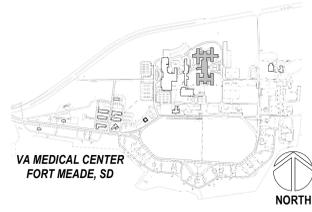


**GENERAL NOTES:**

A. SEE 148-TN-011 FOR GENERAL NOTES.

**SHEET NOTES:**

- NEW RACK WITH PATCH PANELS, FIBER HOUSING, UPS, PDU'S, AND SPACE FOR OIT/OEHRM EQUIPMENT.
- NEW CONDUIT SLEEVES INTO ROOM. PROVIDE CONNECTION BETWEEN ADJACENT SPACE AND NEW ROOM.
- ELECTRIFIED HARDWARE PER DIVISION 8. PROVIDE CABLING AND CONNECTION TO ACCESS CONTROL SYSTEM PANEL.
- NEW PROXIMITY CARD READER BY ACCESS CONTROL INTEGRATOR. PROVIDE CABLING AND CONNECTION TO ACCESS CONTROL SYSTEM PANEL.
- NEW STROBE. CONNECT TO LOCAL FIRE ALARM NAC.
- PROVIDE NEW PAN-TILT-ZOOM SECURITY CAMERA, AXIS M5000 SERIES OR EQUAL, FOR MONITORING TELECOM ROOM. PROVIDE CABLING TO JOHNSON CONTROLS EQUIPMENT. PROVIDE ALL LABOR, CABLING, INTEGRATION, INFRASTRUCTURE, AIM/FOCUS, ETC. FOR AN OPERABLE SOLUTION. IF NO JOHNSON CONTROLS EQUIPMENT IS LOCATED IN THE BUILDING OR WITHIN 250', TERMINATE CABLING ON VIA PATCH PANELS AND PROVIDE NETWORK SWITCH FOR CONNECTION TO CENTRAL JCI EQUIPMENT. AIR-GAPPED/DEDICATED VIA FIBER MAY BE USED FOR CONNECTION. COORDINATE LOCATION/VIEW WITH VA POLICE AND COR PRIOR TO ROUGH-IN.
- TERMINATE NEW 25 STRAND ANALOG BACKBONE ON NEW 24 PORT PATCH PANEL TO SUPPORT (E) ANALOG DEVICES.

**2 ENLARGED ROOM - A114A TELECOM REMODEL**  
1/2" = 1'-0"

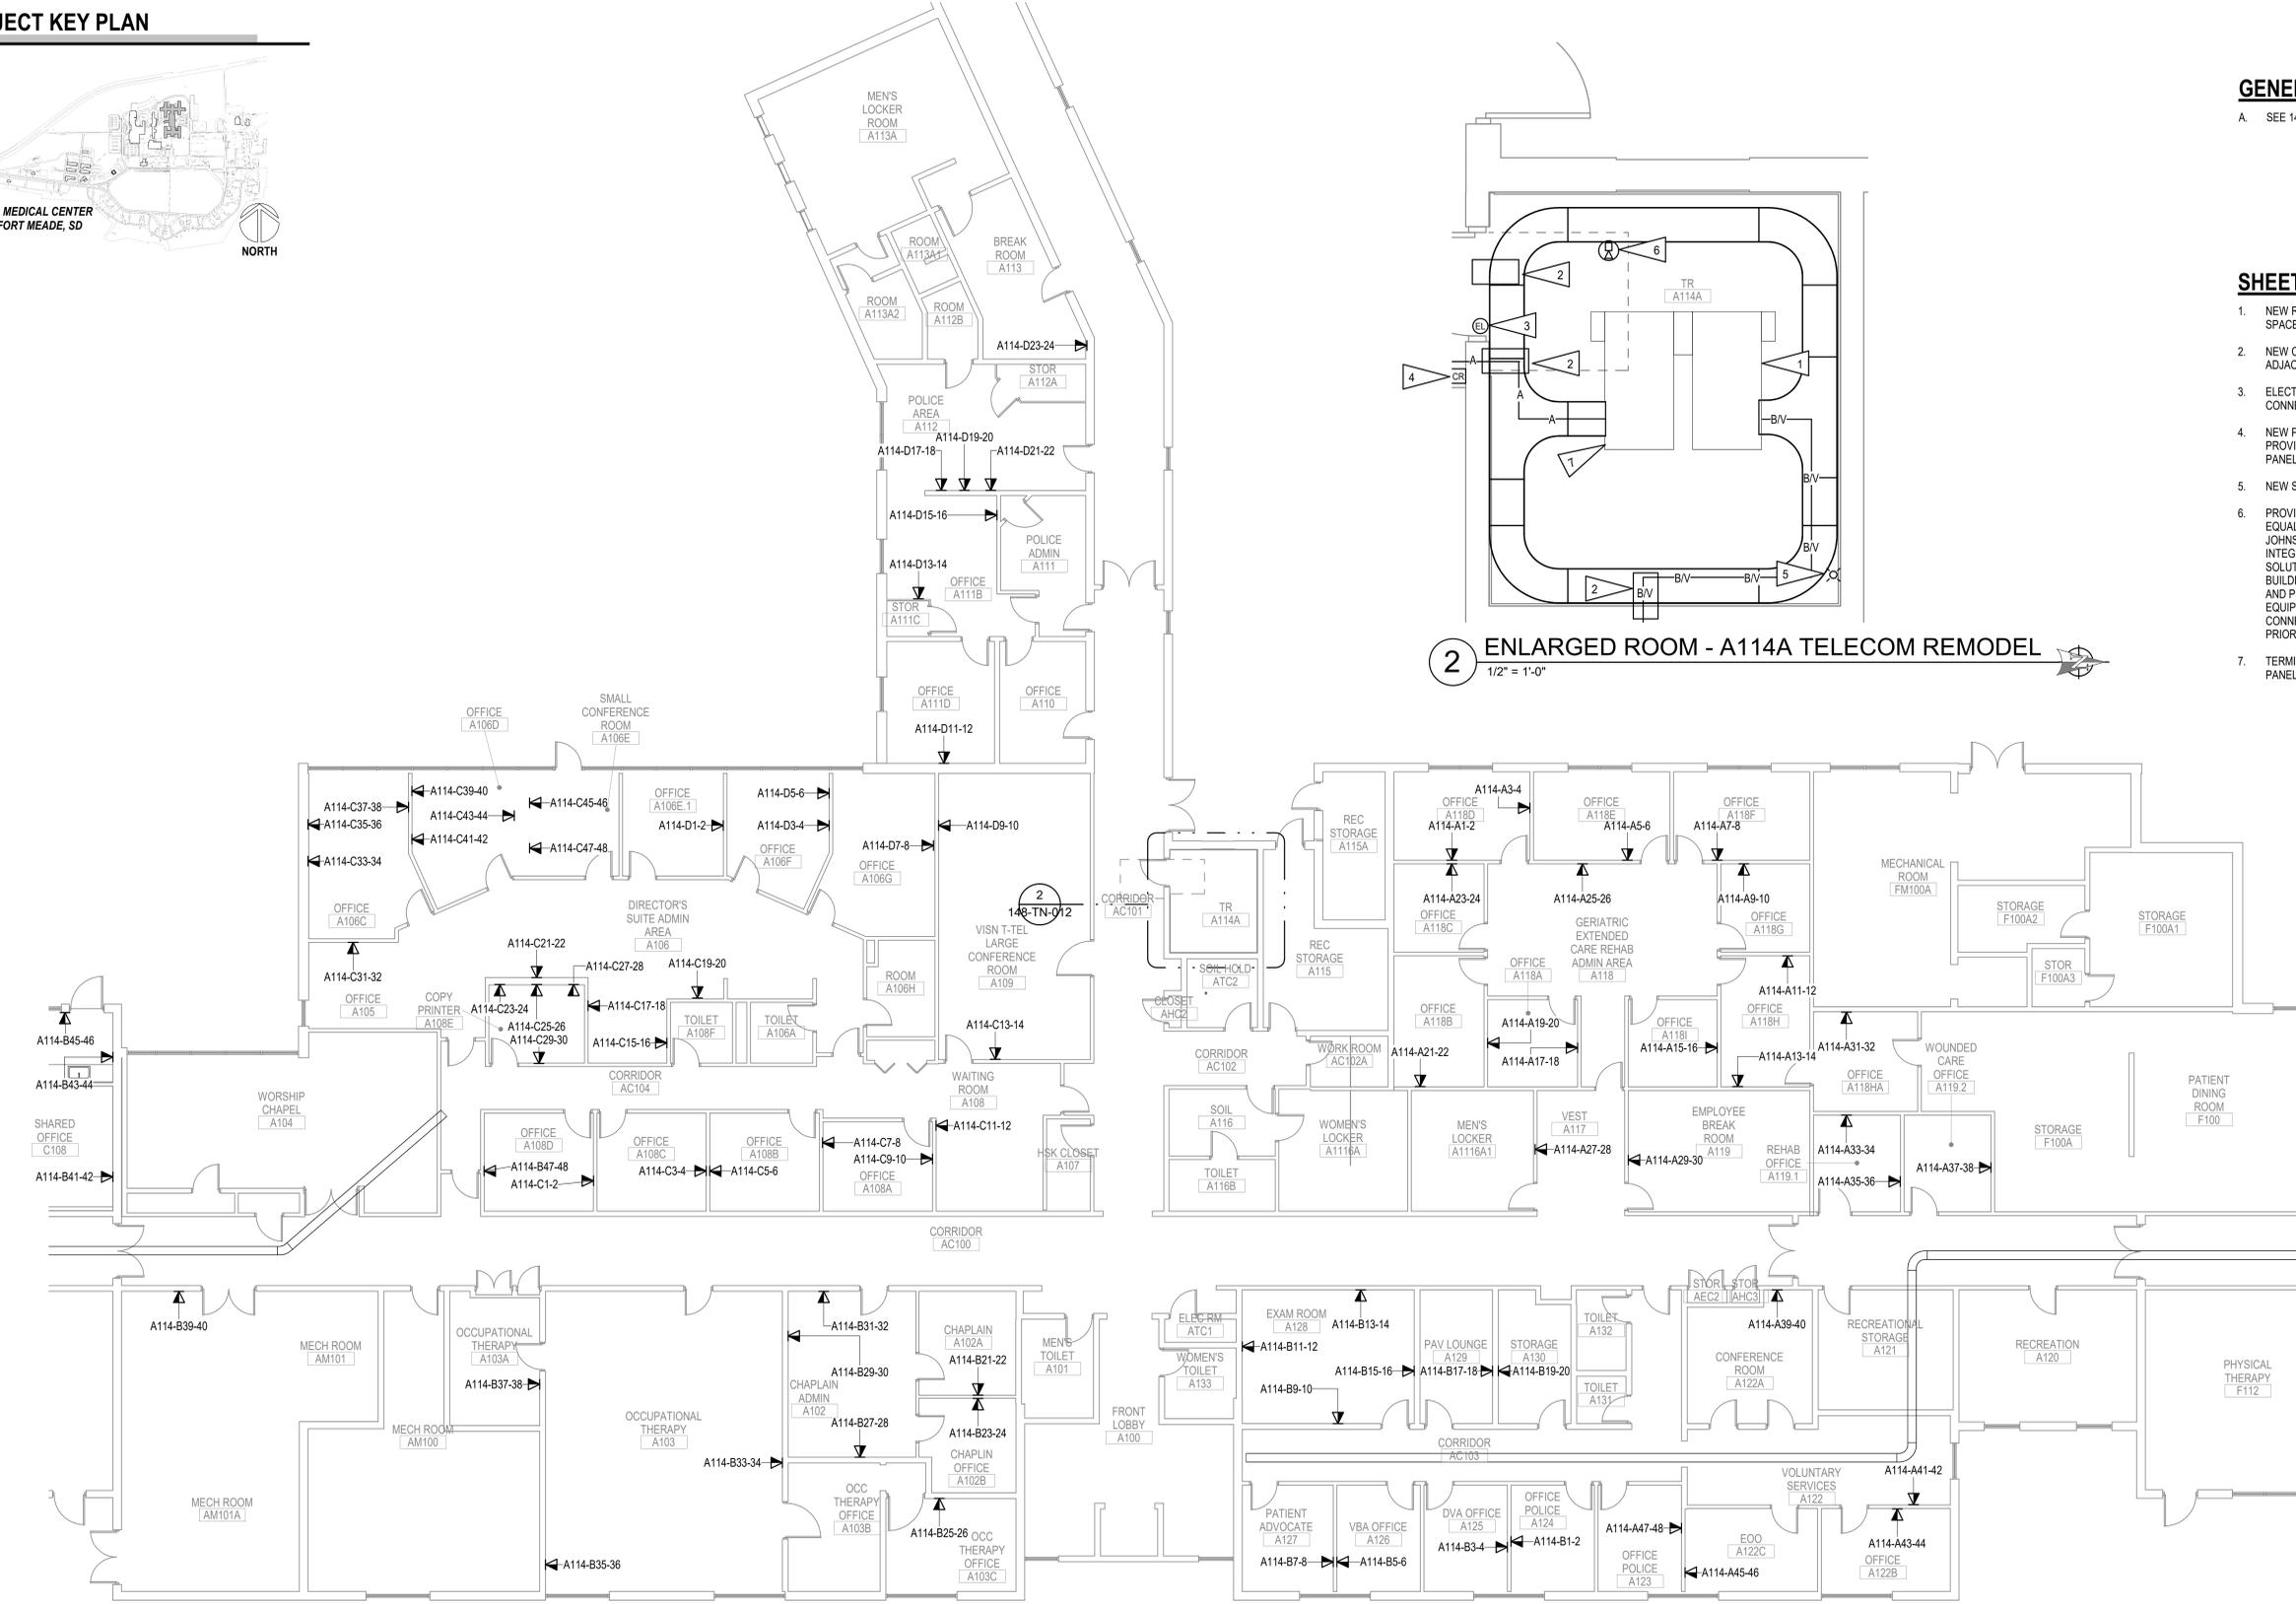

**1 TELECOM REMODEL PLAN - BLDG 148 FIRST FLOOR SECTOR A**  
1/8" = 1'-0"


Revisions:	Date:

**CONSULTANT**

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541.436.4723  
ADAM GOODIN, PE

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**PROGRAM CONTRACTING ACTIVITY CENTRAL (PCAC)**

U.S. Department of Veterans Affairs

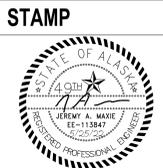**DRAWING TITLE**  
148-TELECOM REMODEL PLAN - FIRST FLOOR SECTOR A

APPROVED: Project Director

**PHASE**  
100% CONSTRUCTION DOCUMENTS

**FLS**  
FULLY SPRINKLERED


<b>PROJECT TITLE</b> EHRM INFRASTRUCTURE UPGRADES	<b>PROJECT NUMBER</b> 568-21-701
<b>LOCATION</b> FORT MEADE, SOUTH DAKOTA	<b>BUILDING NUMBER</b> BLDG 148
<b>ISSUE DATE</b> 05/25/2022	<b>DRAWING NUMBER</b> 148-TN-012
<b>CHECKED BY</b> JAM	<b>DRAWN BY</b> CK, LKA

5/25/2022 11:01:19 AM  
E:\148\21\112\_VA Medical Center - Ft Meade - SD\SERIES - BLDG 148\_2021.rvt






**PROJECT KEY PLAN**

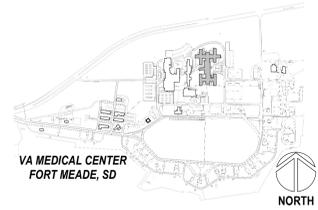

**GENERAL NOTES:**

A SEE 148-TN-011 FOR GENERAL NOTES.

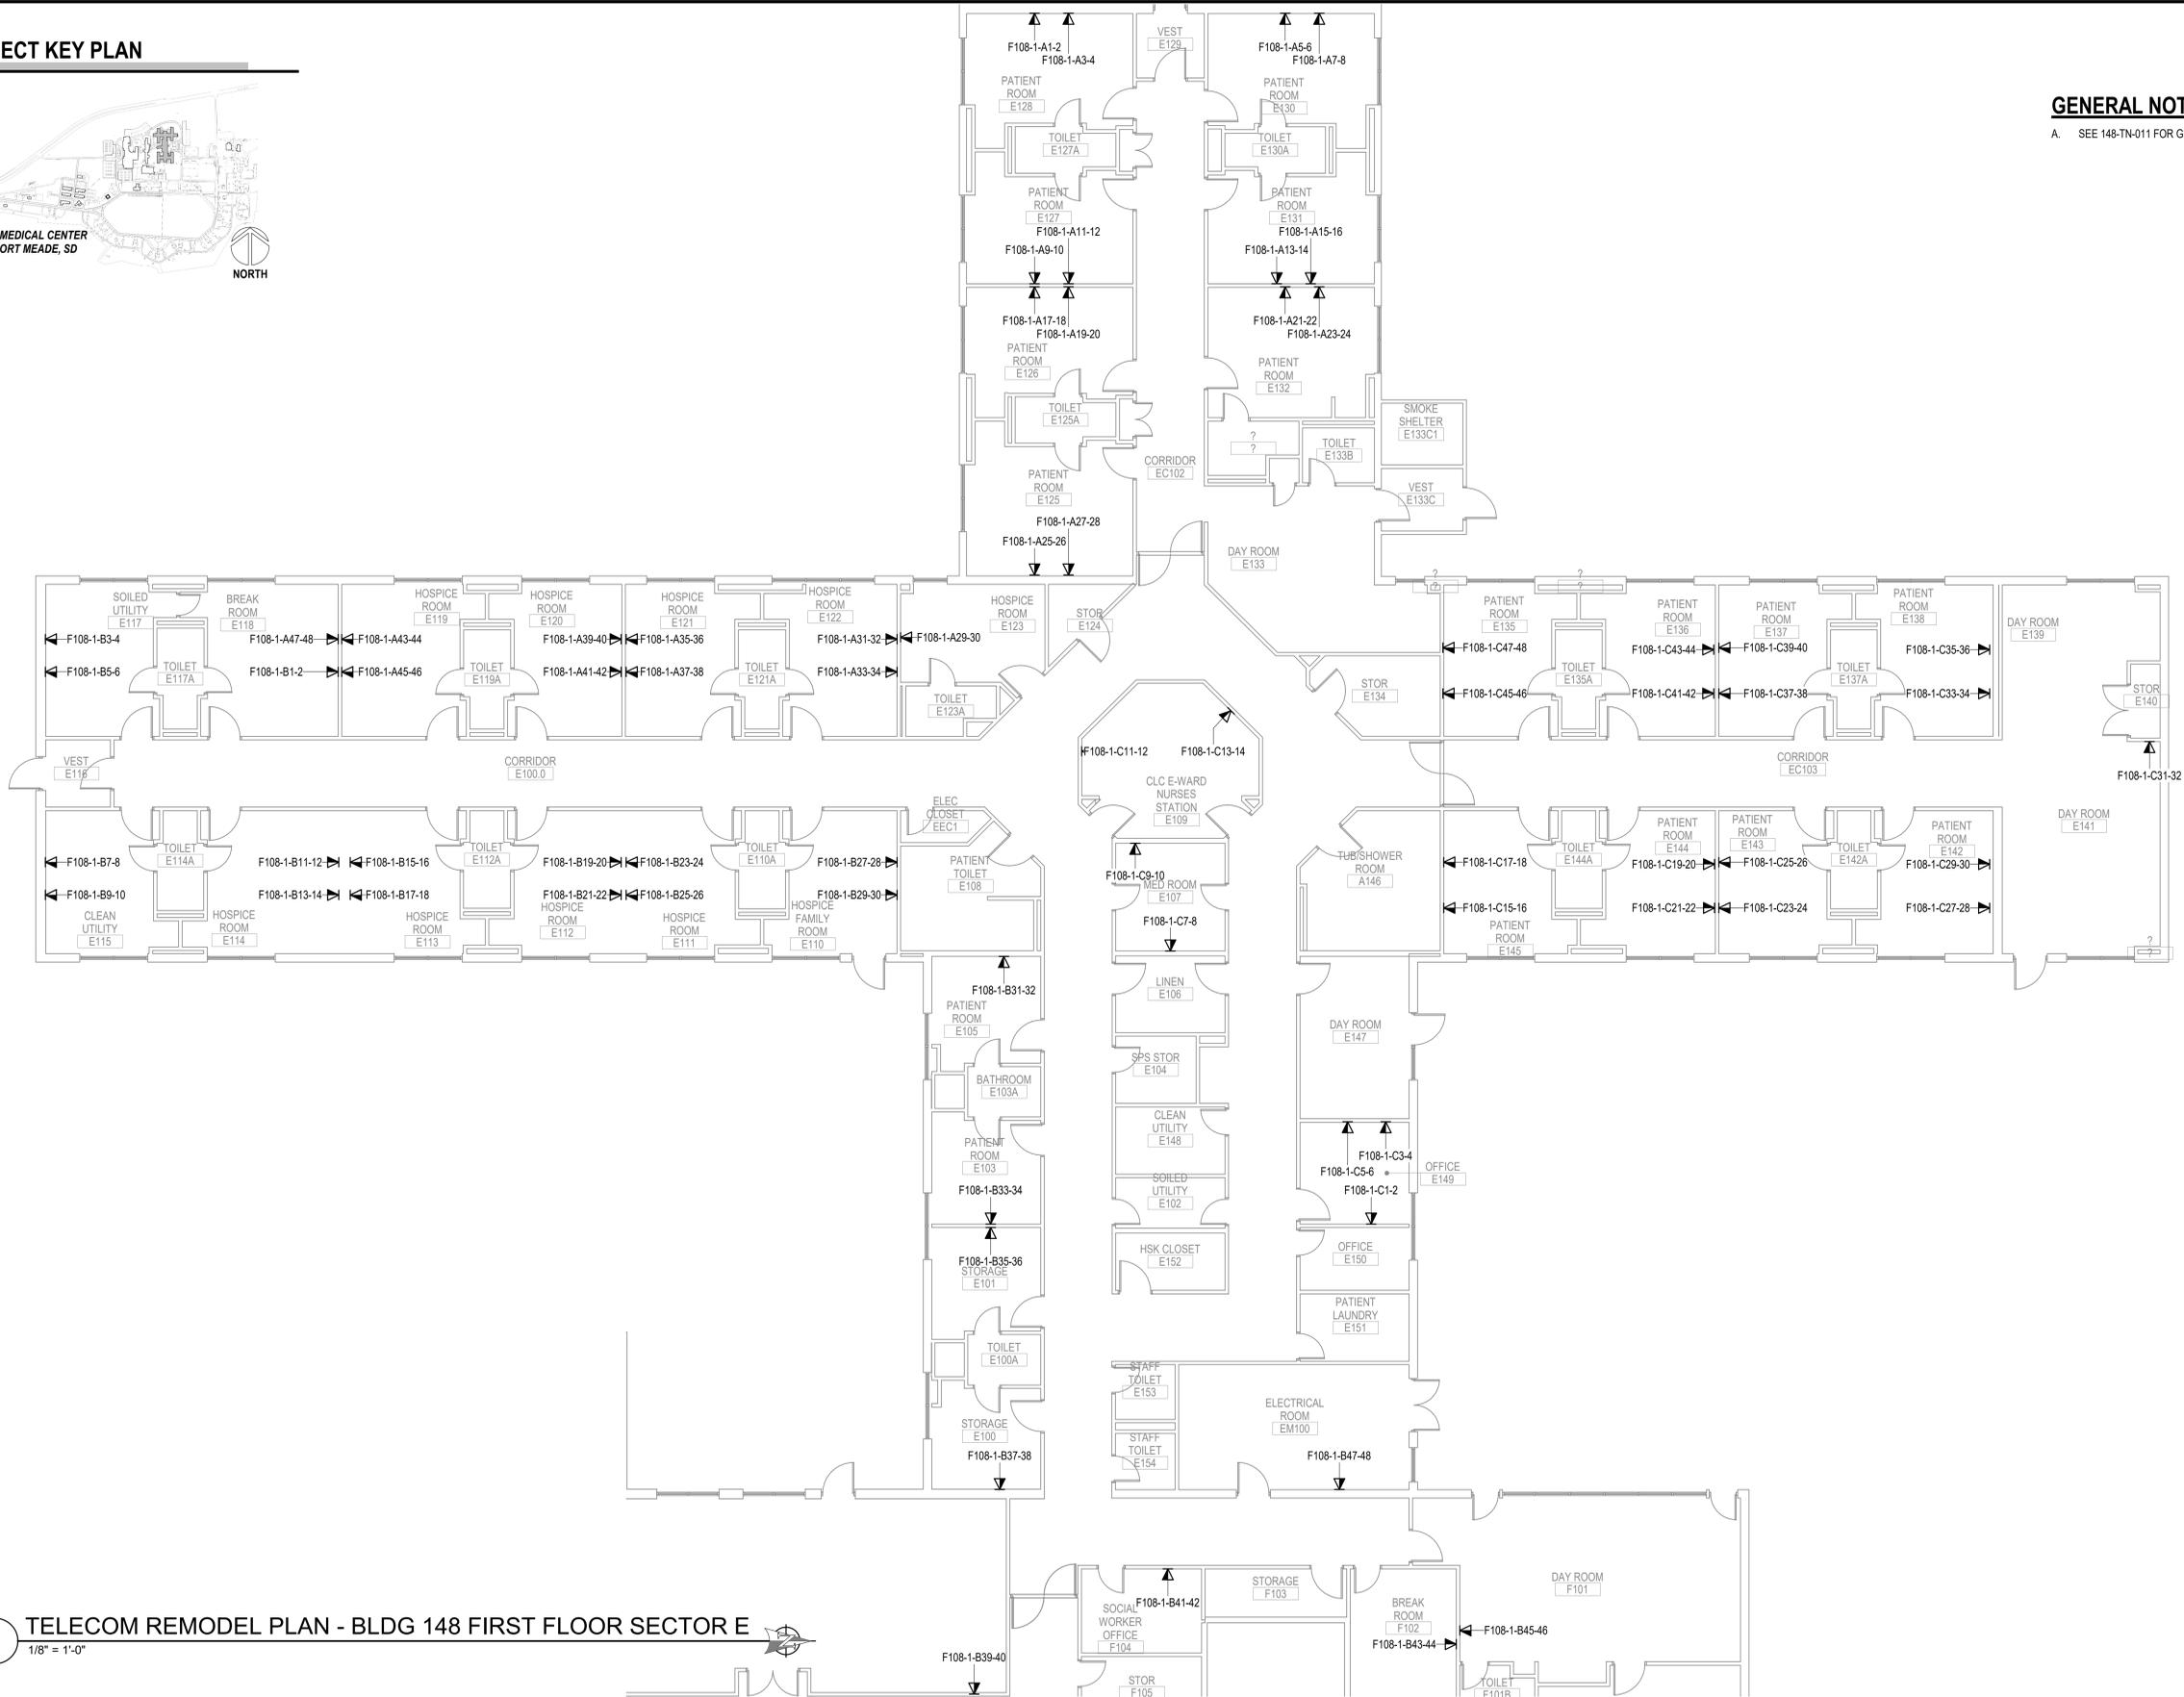

**1 TELECOM REMODEL PLAN - BLDG 148 FIRST FLOOR SECTOR E**  
1/8" = 1'-0"

5/25/2022 11:01:28 AM  
E:\148\2021\12\_VA Medical Center - Ft Meade\SD\SERIES - BLDG 148\_2021.rvt

Revisions:	Date:

**CONSULTANT**

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Corporate No.: AEC542

**STAMP**

**PROGRAM CONTRACTING ACTIVITY CENTRAL (PCAC)**

**VA** U.S. Department of Veterans Affairs

**DRAWING TITLE**  
148-TELECOM REMODEL PLAN - FIRST FLOOR SECTOR E

APPROVED: Project Director

**PHASE**  
100% CONSTRUCTION DOCUMENTS

**FLS**  
FULLY SPRINKLERED

**PROJECT TITLE**  
EHRM INFRASTRUCTURE UPGRADES

**LOCATION**  
FORT MEADE, SOUTH DAKOTA

ISSUE DATE: 05/25/2022  
CHECKED BY: JAM  
DRAWN BY: LKA



**PROJECT NUMBER**  
568-21-701

**BUILDING NUMBER**  
BLDG 148

**DRAWING NUMBER**  
148-TN-015



**PROJECT KEY PLAN**

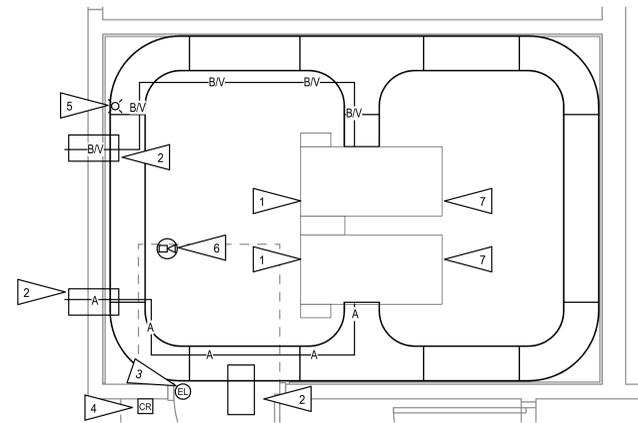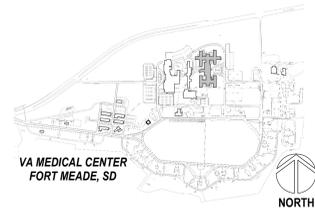


**2 ENLARGED ROOM - F108 TELECOM REMODEL**  
1/2" = 1'-0"

**GENERAL NOTES:**

A. SEE 148-TN-011 FOR GENERAL NOTES.

**SHEET NOTES:**

1. NEW RACK WITH PATCH PANELS, FIBER HOUSING, UPS, PDU'S, AND SPACE FOR OIT/OEHRM EQUIPMENT.
2. NEW CONDUIT SLEEVES INTO ROOM. PROVIDE CONNECTION BETWEEN ADJACENT SPACE AND NEW ROOM.
3. ELECTRIFIED HARDWARE PER DIVISION 8. PROVIDE CABLING AND CONNECTION TO ACCESS CONTROL SYSTEM PANEL.
4. NEW PROXIMITY CARD READER BY ACCESS CONTROL INTEGRATOR. PROVIDE CABLING AND CONNECTION TO ACCESS CONTROL SYSTEM PANEL.
5. NEW STROBE. CONNECT TO LOCAL FIRE ALARM NAC.
6. PROVIDE NEW PAN-TILT-ZOOM SECURITY CAMERA, AXIS M5000 SERIES OR EQUAL, FOR MONITORING TELECOM ROOM. PROVIDE CABLING TO JOHNSON CONTROLS EQUIPMENT. PROVIDE ALL LABOR, CABLING, INTEGRATION, INFRASTRUCTURE, AIM/FOCUS, ETC. FOR AN OPERABLE SOLUTION. IF NO JOHNSON CONTROLS EQUIPMENT IS LOCATED IN THE BUILDING OR WITHIN 250', TERMINATE CABLING ON VA PATCH PANELS AND PROVIDE NETWORK SWITCH FOR CONNECTION TO CENTRAL JCI EQUIPMENT. AIR-GAPPED/DEDICATED VA FIBER MAY BE USED FOR CONNECTION. COORDINATE LOCATION/VIEW WITH VA POLICE AND COR PRIOR TO ROUGH-IN.
7. TERMINATE NEW 25 STRAND ANALOG BACKBONE ON NEW 24 PORT PATCH PANEL TO SUPPORT (E) ANALOG DEVICES.

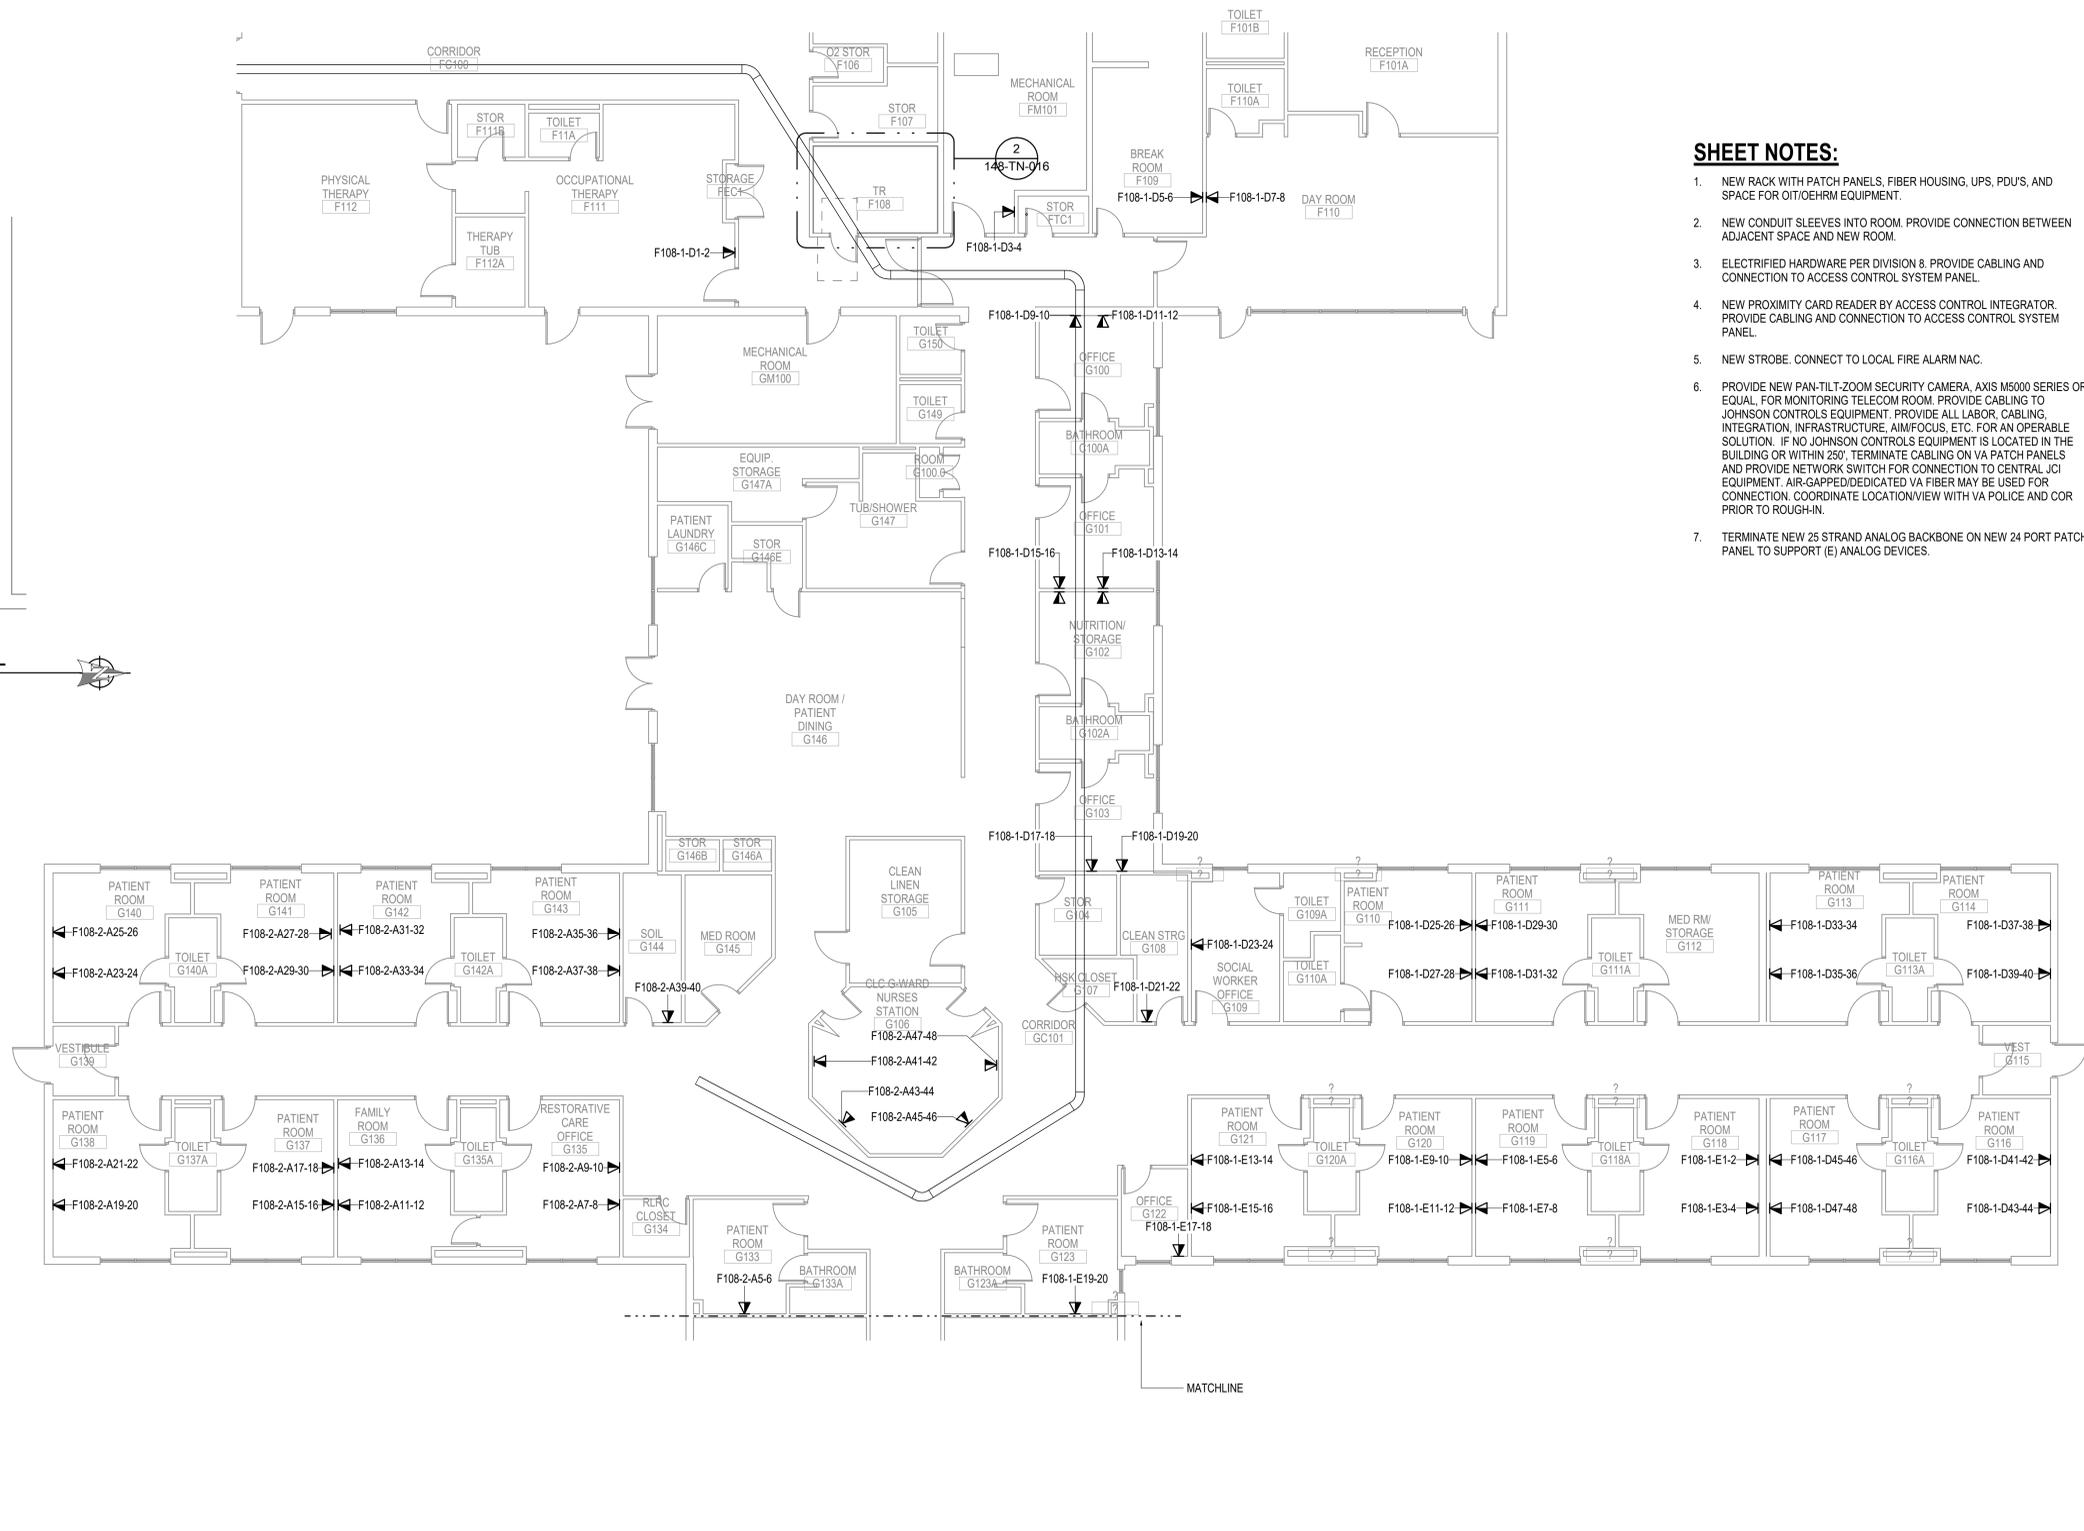

**1 TELECOM REMODEL PLAN - BLDG 148 FIRST FLOOR SECTOR G**  
1/8" = 1'-0"

Revisions:	Date:

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Corporate No.: AECC542

**STAMP**

**PROGRAM CONTRACTING ACTIVITY CENTRAL (PCAC)**

U.S. Department of Veterans Affairs

**DRAWING TITLE**  
148-TELECOM REMODEL PLAN - FIRST FLOOR SECTOR G

APPROVED: Project Director

**PHASE**  
100% CONSTRUCTION DOCUMENTS

**FLS**  
FULLY SPRINKLERED

**PROJECT TITLE**  
EHRM INFRASTRUCTURE UPGRADES

**LOCATION**  
FORT MEADE, SOUTH DAKOTA

**ISSUE DATE**  
05/25/2022

**CHECKED BY**  
JAM

**DRAWN BY**  
CK, LKA

**PROJECT NUMBER**  
568-21-701

**BUILDING NUMBER**  
BLDG 148

**DRAWING NUMBER**  
148-TN-016

5/25/2022 11:01:32 AM  
BIM 360/2/112 - VA Medical Center - Ft Meade - SD - SERIES - BLDG 148 - 2D.rvt



A

B

C

D

E



F

**GENERAL NOTES:**


- A. SEE TK SERIES FOR DETAILS AND SCHEDULES.
- B. INTENT IS TO PROVIDE (2) CABLES PER WORK AREA OUTLET, UNLESS OTHERWISE NOTED. TO PHASE WORK SO THAT EXISTING NETWORK IS MAINTAINED UNTIL NEW ROOMS ARE OPERABLE. GENERAL APPROACH IS TO FIRST REPLACE CABLING IN (1) OUTLET WHERE (2) EXIST, OR PROVIDE A SECOND IF NOT.
- C. CABLING PATHWAYS TO NEW TELECOM ROOMS SHALL BE CONDUIT IN THIS BUILDING.
- D. IF PHASING ALLOWS FOR ALL CABLING IN A BUILDING OR AREA TO BE MIGRATED IN A NIGHT OR WEEKEND WITHOUT DISRUPTIONS, EXISTING SINGLE OUTLETS MAY BE RE-USED.

**SHEET NOTES:**

- 1. NEW TELECOM CABINET.
- 2. NEW CONDUIT SLEEVES INTO ROOM. PROVIDE CONNECTION BETWEEN ADJACENT SPACE AND NEW ROOM.
- 3. PROPOSED FIBER ROUTING SHOWN. PROVIDE NEW CONDUIT FROM POINT WHERE SITE DISTRIBUTION ENTERS BUILDING.
- 4. PROVIDE NEW PAN-TILT-ZOOM SECURITY CAMERA, AXIS M5000 SERIES OR EQUAL, FOR MONITORING TELECOM ROOM. PROVIDE CABLING TO JOHNSON CONTROLS EQUIPMENT. PROVIDE ALL LABOR, CABLING, INTEGRATION, INFRASTRUCTURE, AIM/FOCUS, ETC. FOR AN OPERABLE SOLUTION. IF NO JOHNSON CONTROLS EQUIPMENT IS LOCATED IN THE BUILDING OR WITHIN 250', TERMINATE CABLING ON VA PATCH PANELS AND PROVIDE NETWORK SWITCH FOR CONNECTION TO CENTRAL JCI EQUIPMENT. AIR-GAPPED/DEDICATED VA FIBER MAY BE USED FOR CONNECTION. COORDINATE LOCATION/VIEW WITH VA POLICE AND COR PRIOR TO ROUGH-IN.

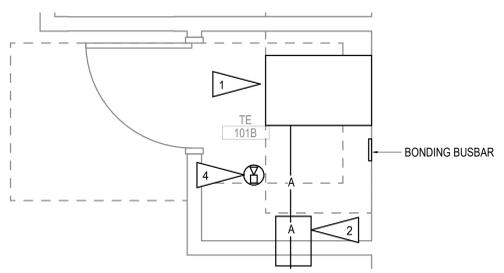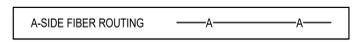


**2 ENLARGED ROOM - 101B TELECOM REMODEL**  
1/2" = 1'-0"

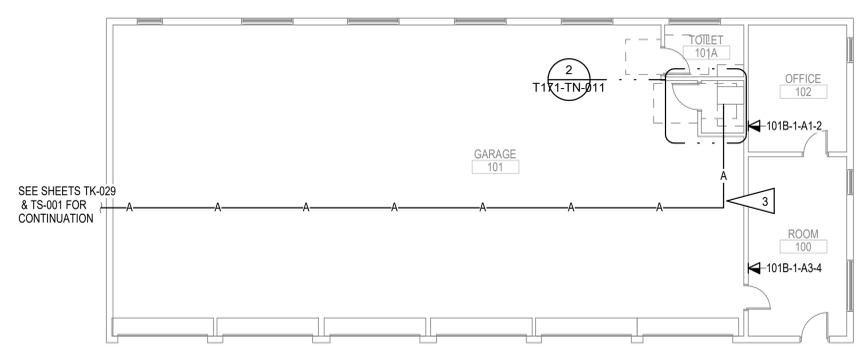

**1 TELECOM REMODEL PLAN - BLDG T171 FIRST FLOOR**  
1/8" = 1'-0"

**PROJECT KEY PLAN**

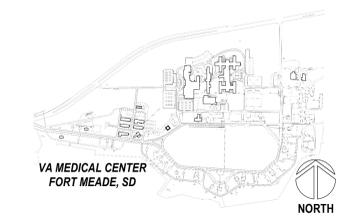

5/25/2022 8:03:17 AM  
R:\36012112\_VA Medical Center - Ft Meade\SD\SERIES - BLDG T171 - R20.dwg

Revisions:	Date:

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**STAMP**

**PROGRAM CONTRACTING ACTIVITY CENTRAL (PCAC)**

VA U.S. Department of Veterans Affairs

**DRAWING TITLE**  
T171-TELECOM REMODEL PLAN - FIRST FLOOR

APPROVED: Project Director

**PHASE**  
100% CONSTRUCTION DOCUMENTS

**FLS**  
FULLY SPRINKLERED

<b>PROJECT TITLE</b> EHRM INFRASTRUCTURE UPGRADES		<b>PROJECT NUMBER</b> 568-21-701	
<b>LOCATION</b> FORT MEADE, SOUTH DAKOTA		<b>BUILDING NUMBER</b> BLDG T171	
<b>ISSUE DATE</b> 05/25/2022	<b>CHECKED BY</b> JAM	<b>DRAWN BY</b> CK,LKA	<b>DRAWING NUMBER</b> T171-TN-011










A

B



C

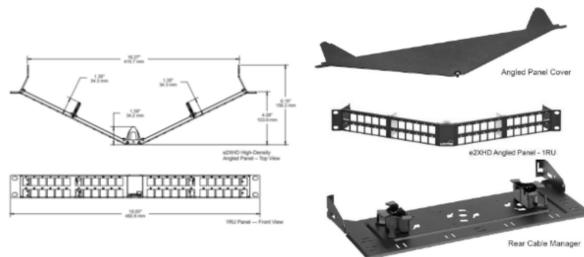

RECOMMENDED UTP PATCH PANEL:  
 LEVITON e2XHD-BLK HIGH-DENSITY ANGLED  
 48 POSITION  
 ONE RACK UNIT PER PANEL  
 WITH REAR CABLE MANAGER  
 AND ANGLED PANEL COVERS

**2 UNIVERSAL PATCH PANEL TERMINATION DETAIL**  
 NOT TO SCALE

CABLE TO BE RUN FREE IN WALLS

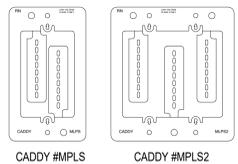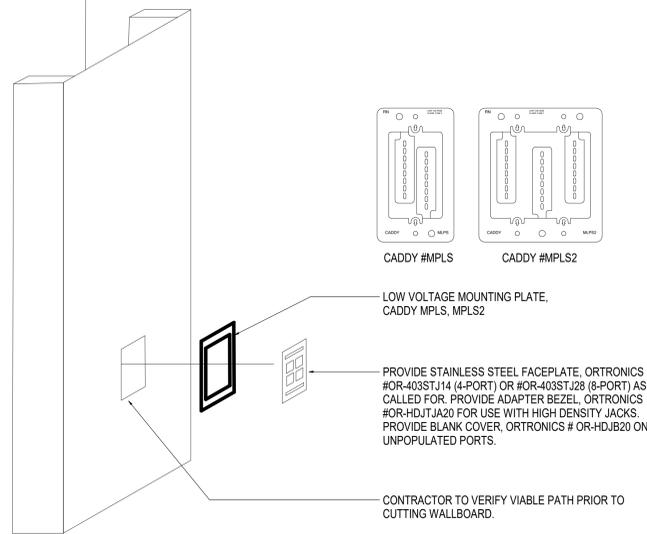


LOW VOLTAGE MOUNTING PLATE,  
 CADDY MPLS, MPLS2

PROVIDE STAINLESS STEEL FACEPLATE, ORTRONICS  
 #OR-403STJ14 (4-PORT) OR #OR-403STJ28 (8-PORT) AS  
 CALLED FOR. PROVIDE ADAPTER BEZEL, ORTRONICS  
 #OR-HDJTJA20 FOR USE WITH HIGH DENSITY JACKS.  
 PROVIDE BLANK COVER, ORTRONICS #OR-HDJB20 ON  
 UNPOPULATED PORTS.

CONTRACTOR TO VERIFY VIABLE PATH PRIOR TO  
 CUTTING WALLBOARD.

**1 TELECOMMUNICATIONS OUTLET ROUGH-IN DETAIL**  
 NOT TO SCALE

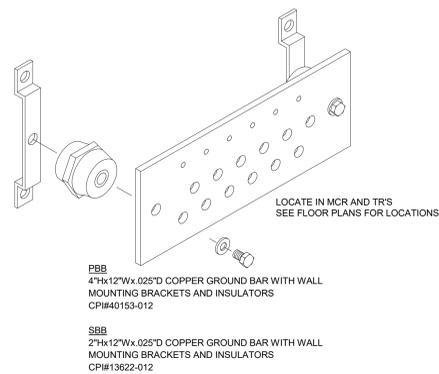

FBB  
 4"x12"Wx.025"D COPPER GROUND BAR WITH WALL  
 MOUNTING BRACKETS AND INSULATORS  
 CPM#40153-012

SBB  
 2"x12"Wx.025"D COPPER GROUND BAR WITH WALL  
 MOUNTING BRACKETS AND INSULATORS  
 CPM#13622-012

LOCATE IN MCR AND TR'S  
 SEE FLOOR PLANS FOR LOCATIONS.

**3 GROUND BUS BAR ASSEMBLY**  
 NOT TO SCALE

5/25/2022 11:06:25 AM  
 BIM 360://2112\_VA Medical Center - F1 Meade SDESERIES - DETAILS\_R201.rvt

Revisions:	Date:

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 Corporate No.: AECC542

**STAMP**

**PROGRAM CONTRACTING ACTIVITY CENTRAL (PCAC)**

**VA** U.S. Department of Veterans Affairs

**DRAWING TITLE**  
 TELECOM DETAILS

APPROVED: Project Director

**PHASE**  
 100% CONSTRUCTION DOCUMENTS

**FLS**  
 FULLY SPRINKLERED

**PROJECT TITLE**  
 EHRM INFRASTRUCTURE UPGRADES

**LOCATION**  
 FORT MEADE, SOUTH DAKOTA

ISSUE DATE: 05/25/2022  
 CHECKED BY: JAM  
 DRAWN BY: LKA, CK

**PROJECT NUMBER**  
 568-21-701

**BUILDING NUMBER**

**DRAWING NUMBER**  
 TK-001











































**24-PORT COPPER CONDUCTOR PANEL SHEET**

PROJECT #: M1200      ROOM #: TC2A      PANEL #:

BUILDING #: 145      RACK #:

\*LIF? = LOCATED IN FIELD?  
NO LABEL  
PATCH CORD

12-PORT COPPER PATCH PANEL																					
X	X	X										NA	NA	NA	NA	NA	NA	NA	NA	NA	NA
X	X	X										NA	NA	NA	NA	NA	NA	NA	NA	NA	NA

PORT #	ROOM #	CAT	LIF?	PORT #	ROOM #	CAT	LIF?	PORT #	ROOM #	CAT	LIF?	PORT #	ROOM #	CAT	LIF?
PORT 1	WAP PUB2ND			PORT 7				PORT 13				PORT 19			
PORT 2	WAP PUB2ND			PORT 8				PORT 14				PORT 20			
PORT 3	WAP PUB3RD			PORT 9				PORT 15				PORT 21			
PORT 4				PORT 10				PORT 16				PORT 22			
PORT 5				PORT 11				PORT 17				PORT 23			
PORT 6				PORT 12				PORT 18				PORT 24			

1 PATCH PANEL - BLDG 145 TC2A - 6

**24-PORT COPPER CONDUCTOR PANEL SHEET**

PROJECT #: M1200      ROOM #: TC2A      PANEL #:

BUILDING #: 145      RACK #:

\*LIF? = LOCATED IN FIELD?  
NO LABEL  
PATCH CORD

24-PORT COPPER PATCH PANEL																					
X	X	X	X	X	X	X	X	X	X	X	X	X	X	X	X	X	X	X	X	X	X
X	X	X	X	X	X	X	X	X	X	X	X	X	X	X	X	X	X	X	X	X	X

PORT #	ROOM #	CAT	LIF?	PORT #	ROOM #	CAT	LIF?	PORT #	ROOM #	CAT	LIF?	PORT #	ROOM #	CAT	LIF?
PORT 1	WAP 1			PORT 7	WAP 7			PORT 13	WAP 13			PORT 19			
PORT 2	WAP 2			PORT 8	WAP 8			PORT 14	WAP 14			PORT 20			
PORT 3	WAP 3			PORT 9	WAP 9			PORT 15	WAP 15			PORT 21			
PORT 4	WAP 4			PORT 10	WAP 10			PORT 16	WAP 16			PORT 22			
PORT 5	WAP 5			PORT 11	WAP 11			PORT 17	WAP 17			PORT 23			
PORT 6	WAP 6			PORT 12	WAP 12			PORT 18	WAP 18			PORT 24			

2 PATCH PANEL - BLDG 145 TC2A - 7

**24-PORT COPPER CONDUCTOR PANEL SHEET**

PROJECT #: M1200      ROOM #: TC3A      PANEL #:

BUILDING #: 145      RACK #:

\*LIF? = LOCATED IN FIELD?  
NO LABEL  
PATCH CORD

24-PORT COPPER PATCH PANEL																					
X	X	X	X	X	X	X	X	X	X	X	X	X	X	X	X	X	X	X	X	X	X
X	X	X	X	X	X	X	X	X	X	X	X	X	X	X	X	X	X	X	X	X	X

PORT #	ROOM #	CAT	LIF?	PORT #	ROOM #	CAT	LIF?	PORT #	ROOM #	CAT	LIF?	PORT #	ROOM #	CAT	LIF?
PORT 1	D-349A			PORT 7	D-349G			PORT 13	D-349M			PORT 19	D-332A		
PORT 2	D-349B			PORT 8	D-349H			PORT 14	D-349N			PORT 20	D-332B		
PORT 3	D-349C			PORT 9	D-349I			PORT 15	D-349O			PORT 21	D337-7		
PORT 4	D-349D			PORT 10	D-349J			PORT 16	D-349P			PORT 22	D337-8		
PORT 5	D-349E			PORT 11	D-349K			PORT 17	D-325A			PORT 23	D337-9		
PORT 6	D-349F			PORT 12	D-349L			PORT 18	D-325B			PORT 24	D337-10		

3 PATCH PANEL - BLDG 145 TC3A - 1

**48-PORT COPPER CONDUCTOR PANEL SHEET**

PROJECT #: M1200      ROOM #: TC3A      PANEL #:

BUILDING #: 145      RACK #:

\*LIF? = LOCATED IN FIELD?  
NO LABEL  
PATCH CORD

48-PORT COPPER PATCH PANEL																																													
X	X	X	X	X	X	X	X	X	X	X	X	X	X	X	X	X	X	X	X	X	X	X	X	X	X	X	X	X	X	X	X	X	X	X	X	X	X	X	X	X	X	X	X	X	
X	X	X	X	X	X	X	X	X	X	X	X	X	X	X	X	X	X	X	X	X	X	X	X	X	X	X	X	X	X	X	X	X	X	X	X	X	X	X	X	X	X	X	X	X	X

PORT #	ROOM #	CAT	LIF?	PORT #	ROOM #	CAT	LIF?	PORT #	ROOM #	CAT	LIF?	PORT #	ROOM #	CAT	LIF?
PORT 1	313A 2			PORT 13	313B 3			PORT 25	OP 24			PORT 37	314 8		
PORT 2	319 3			PORT 14	OP 3			PORT 26	317 3			PORT 38	315 2		
PORT 3	319 4			PORT 15	OP 4			PORT 27	317 4			PORT 39	315 5		
PORT 4	319 7			PORT 16	OP 7			PORT 28	317 7			PORT 40	315 6		
PORT 5	319 8			PORT 17	OP 8			PORT 29	317 8			PORT 41			
PORT 6	313B 3			PORT 18	OP 11			PORT 30	316 3			PORT 42			
PORT 7	313B 4			PORT 19	OP 12			PORT 31	316 4			PORT 43			
PORT 8	313B 7			PORT 20	OP 15			PORT 32	314A 3			PORT 44			
PORT 9	313B 8			PORT 21	OP 16			PORT 33	314A 4			PORT 45	3130P1		
PORT 10	313B 11			PORT 22	OP 19			PORT 34	314 3			PORT 46	3130P2		
PORT 11	313B 12			PORT 23	OP 20			PORT 35	314 4			PORT 47	3130P3		
PORT 12	313B 3			PORT 24	OP 23			PORT 36	314 7			PORT 48	3130P4		

4 PATCH PANEL - BLDG 145 TC3A - 2

**48-PORT COPPER CONDUCTOR PANEL SHEET**

PROJECT #: M1200      ROOM #: TC3A      PANEL #:

BUILDING #: 145      RACK #:

\*LIF? = LOCATED IN FIELD?  
NO LABEL  
PATCH CORD

48-PORT COPPER PATCH PANEL																																													
X	X	X	X	X	X	X	X	X	X	X	X	X	X	X	X	X	X	X	X	X	X	X	X	X	X	X	X	X	X	X	X	X	X	X	X	X	X	X	X	X	X	X	X	X	
X	X	X	X	X	X	X	X	X	X	X	X	X	X	X	X	X	X	X	X	X	X	X	X	X	X	X	X	X	X	X	X	X	X	X	X	X	X	X	X	X	X	X	X	X	X

PORT #	ROOM #	CAT	LIF?	PORT #	ROOM #	CAT	LIF?	PORT #	ROOM #	CAT	LIF?	PORT #	ROOM #	CAT	LIF?
PORT 1	300-1			PORT 13	306-1			PORT 25	326-3			PORT 37	331-5		
PORT 2	300-2			PORT 14	306-2			PORT 26	326-4			PORT 38	331-6		
PORT 3	302-1			PORT 15	308-1			PORT 27	326-5			PORT 39	332-1		
PORT 4	302-2			PORT 16	308-2			PORT 28	326-6			PORT 40	332-2		
PORT 5	303-1			PORT 17	308-3			PORT 29	329-1			PORT 41	332-3		
PORT 6	303-2			PORT 18	308-4			PORT 30	329-2			PORT 42	332-4		
PORT 7	304-1			PORT 19	308-5			PORT 31	330-1			PORT 43	332-5		
PORT 8	304-2			PORT 20	308-6			PORT 32	330-2			PORT 44	332-6		
PORT 9	305-1			PORT 21	308-7			PORT 33	331-1			PORT 45	334-1		
PORT 10	305-2			PORT 22	308-8			PORT 34	331-2			PORT 46	334-2		
PORT 11	305-3			PORT 23	326-1			PORT 35	331-3			PORT 47	334-3		
PORT 12	305-4			PORT 24	326-2			PORT 36	331-4			PORT 48	335-1		

5 PATCH PANEL - BLDG 145 TC3A - 3

**48-PORT COPPER CONDUCTOR PANEL SHEET**

PROJECT #: M1200      ROOM #: TC3A      PANEL #:

BUILDING #: 145      RACK #:

\*LIF? = LOCATED IN FIELD?  
NO LABEL  
PATCH CORD

48-PORT COPPER PATCH PANEL																																													
X	X	X	X	X	X	X	X	X	X	X	X	X	X	X	X	X	X	X	X	X	X	X	X	X	X	X	X	X	X	X	X	X	X	X	X	X	X	X	X	X	X	X	X	X	
X	X	X	X	X	X	X	X	X	X	X	X	X	X	X	X	X	X	X	X	X	X	X	X	X	X	X	X	X	X	X	X	X	X	X	X	X	X	X	X	X	X	X	X	X	X

PORT #	ROOM #	CAT	LIF?	PORT #	ROOM #	CAT	LIF?	PORT #	ROOM #	CAT	LIF?	PORT #	ROOM #	CAT	LIF?
PORT 1	335-2			PORT 13	338-2			PORT 25	341B-2			PORT 37	341C-5		
PORT 2	335-3			PORT 14	338-3			PORT 26	341B-3			PORT 38	341C-6		
PORT 3	336-1			PORT 15	338-4			PORT 27	341B-4			PORT 39	341C-7		
PORT 4	336-2			PORT 16	338-5			PORT 28	341B-5			PORT 40	341C-8		
PORT 5	336-3			PORT 17	338-6			PORT 29	341B-6			PORT 41	341C-9		
PORT 6	337-1			PORT 18	341A-1			PORT 30	341B-7			PORT 42	341D-1		
PORT 7	337-2			PORT 19	341A-2			PORT 31	341B-8			PORT 43	341D-2		
PORT 8	337-3			PORT 20	341A-3			PORT 32	341B-9			PORT 44	341D-3		
PORT 9	337-4			PORT 21	341A-4			PORT 33	341C-1			PORT 45	341D-4		
PORT 10	337-5			PORT 22	341A-5			PORT 34	341C-2			PORT 46	341D-5		
PORT 11	337-6			PORT 23	341A-6			PORT 35	341C-3			PORT 47	341D-6		
PORT 12	338-1			PORT 24	341B-1			PORT 36	341C-4			PORT 48	342-1		

6 PATCH PANEL - BLDG 145 TC3A - 4

**48-PORT COPPER CONDUCTOR PANEL SHEET**

PROJECT #: M1200      ROOM #: TC3A      PANEL #:

BUILDING #: 145      RACK #:

\*LIF? = LOCATED IN FIELD?  
NO LABEL  
PATCH CORD

48-PORT COPPER PATCH PANEL																																													
X	X	X	X	X	X	X	X	X	X	X	X	X	X	X	X	X	X	X	X	X	X	X	X	X	X	X	X	X	X	X	X	X	X	X	X	X	X	X	X	X	X	X	X	X	
X	X	X	X	X	X	X	X	X	X	X	X	X	X	X	X	X	X	X	X	X	X	X	X	X	X	X	X	X	X	X	X	X	X	X	X	X	X	X	X	X	X	X	X	X	X

PORT #	ROOM #	CAT	LIF?	PORT #	ROOM #	CAT	LIF?	PORT #	ROOM #	CAT	LIF?	PORT #	ROOM #	CAT	LIF?
PORT 1	342-2			PORT 13	350-5			PORT 25	355-3			PORT 37	326-7		
PORT 2	342-3			PORT 14	350-6			PORT 26	355-4			PORT 38	326-8		
PORT 3	343-1			PORT 15	350-7			PORT 27	305-2			PORT 39	327-1		
PORT 4	343-2			PORT 16	350-8			PORT 28	305-1			PORT 40	327-2		
PORT 5	343-3			PORT 17	352-1			PORT 29	303-3			PORT 41	327-3		
PORT 6	344-1			PORT 18	352-2			PORT 30	303-4			PORT 42	327-4		
PORT 7	344-2			PORT 19	353-1			PORT 31	326-1			PORT 43	327A-1		
PORT 8	344-3			PORT 20	353-2			PORT 32	326-2			PORT 44	327A-2		
PORT 9	350-1			PORT 21	354-1			PORT 33	326-3			PORT 45	327A-3		
PORT 10	350-2			PORT 22	354-2			PORT 34	326-4			PORT 46	327A-4		
PORT 11															









































**GENERAL NOTES:**

A. SEE SHEET TK-038 FOR TELECOMMUNICATION BONDING BACKBONE MINIMUM AWG SIZE REQUIREMENTS.

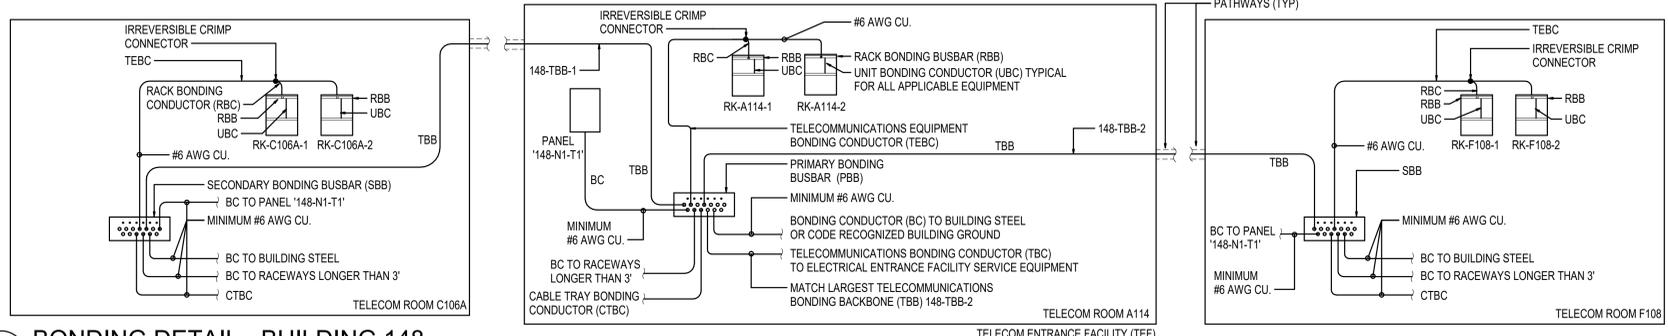

**2 BONDING DETAIL - BUILDING 148**  
NOT TO SCALE

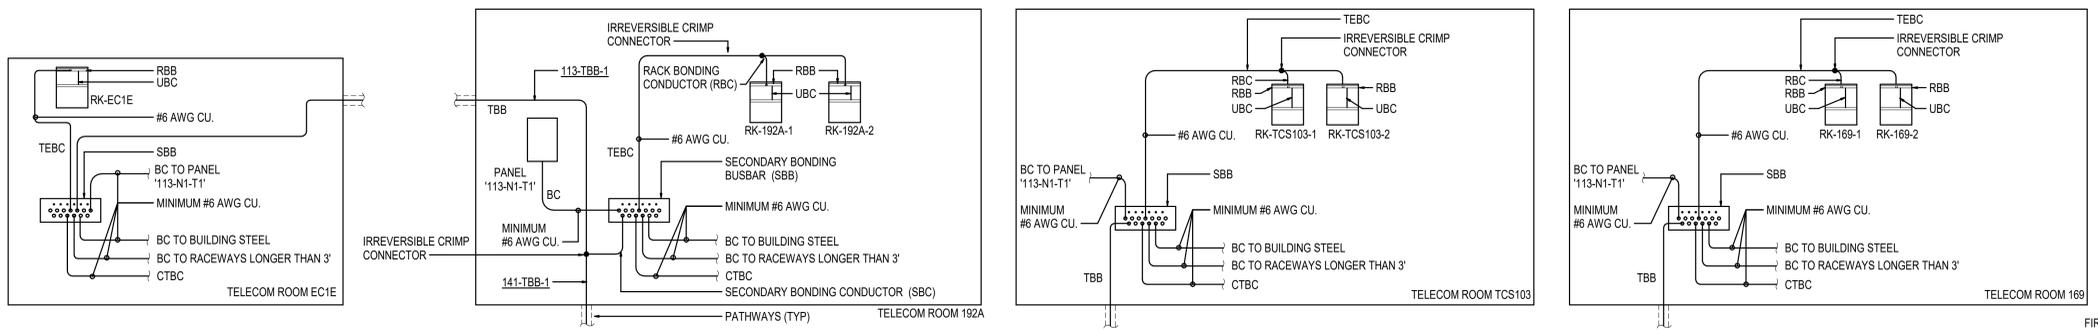

**1 BONDING DETAIL - BUILDING 113**  
NOT TO SCALE

5/25/2022 11:08:18 AM  
E:\M\36012\112\_VA Medical Center - Ft Meade\SD\SERIES - DETAILS\_R201.rvt

Revisions:	Date:

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**STAMP**

**PROGRAM CONTRACTING ACTIVITY CENTRAL (PCAC)**

VA U.S. Department of Veterans Affairs

**DRAWING TITLE**  
TELECOM BONDING DETAILS

APPROVED: Project Director

**PHASE**  
100% CONSTRUCTION DOCUMENTS

**FLS**  
FULLY SPRINKLERED

<b>PROJECT TITLE</b> EHRM INFRASTRUCTURE UPGRADES	<b>PROJECT NUMBER</b> 568-21-701
<b>LOCATION</b> FORT MEADE, SOUTH DAKOTA	<b>BUILDING NUMBER</b>
<b>ISSUE DATE</b> 05/25/2022	<b>DRAWING NUMBER</b> TK-038
<b>CHECKED BY</b> JAM	<b>DRAWN BY</b> LKA, CK

A


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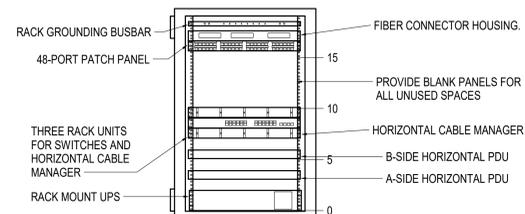
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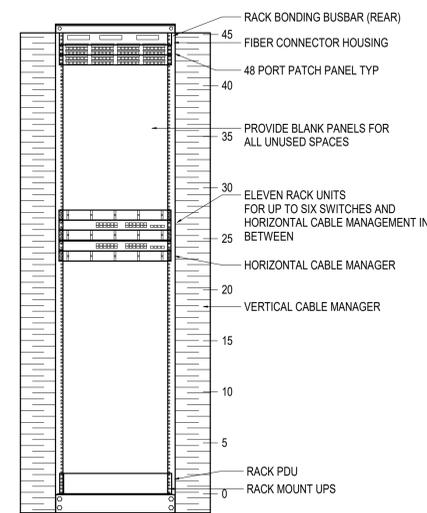
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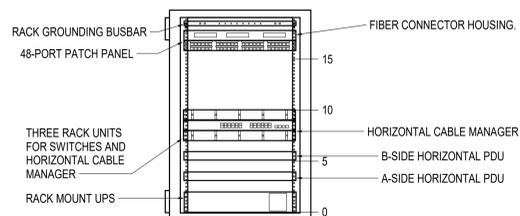
**4** RACK LAYOUT - BLDG 53  
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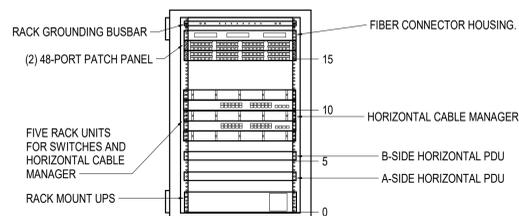
**5** RACK LAYOUT - BLDG 88  
NOT TO SCALE




**6** RACK LAYOUT - BLDG 89  
NOT TO SCALE



**1** RACK LAYOUT - BLDG 40  
NOT TO SCALE

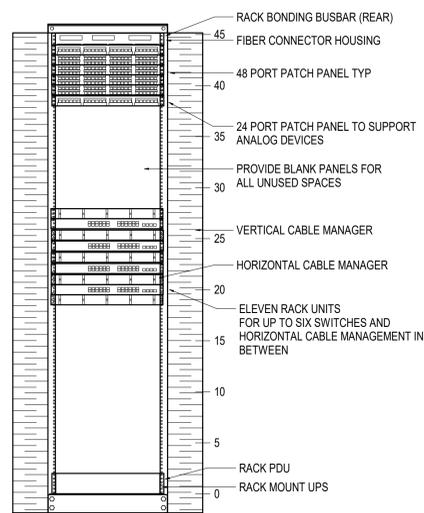

**2** RACK LAYOUT - BLDG 46  
NOT TO SCALE

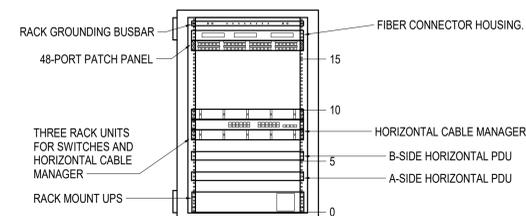

**3** RACK LAYOUT - BLDG 50  
NOT TO SCALE

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Revisions:	Date:

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Corporate No.: AEC542

**STAMP**

**PROGRAM CONTRACTING ACTIVITY CENTRAL (PCAC)**  
U.S. Department of Veterans Affairs

**DRAWING TITLE**  
NEW RACK ELEVATIONS

APPROVED: Project Director

**PHASE**  
100% CONSTRUCTION DOCUMENTS

**FLS**  
FULLY SPRINKLERED

**PROJECT TITLE**  
EHRM INFRASTRUCTURE UPGRADES

**LOCATION**  
FORT MEADE, SOUTH DAKOTA

ISSUE DATE: 05/25/2022  
CHECKED BY: JAM  
DRAWN BY: LKA, CK

**PROJECT NUMBER**  
568-21-701

**BUILDING NUMBER**

**DRAWING NUMBER**  
TK-039







NEW TELECOM EQUIPMENT SCHEDULE

Main equipment schedule table with columns: BLDG, ROOM #, RACK #, MCR GRID ID, CHANNEL RACK, SERVER RACK, CABINET, CAT 6A CABLES, 48 PORT PATCH PANELS, 6" VERTICAL CABLE MANAGEMENT, 10" VERTICAL CABLE MANAGEMENT, 20A RACK PDU, 30A ZONE PDU, 20A HORIZONTAL PDU, RACK-MOUNTED UPS, FIBER HOUSING, MULTI-MODE FIBER (OM4) COUNT, SINGLE MODE FIBER (OS2) COUNT, NOTES.

FT. MEADE SOUTH DAKOTA CABLE RAW DATA table with columns: # OF PATCH PANELS, # OF PORTS, CABLES IN CLOSET, CABLES TO PHONES, CABLES TO CPU, TOTAL CABLES.

FT. MEADE SOUTH DAKOTA CABLE REQUIREMENTS table with columns: LENGTH (ft), # OF CABLES.

ESTIMATED EXISTING WAP COUNTS table with columns: BUILDING, COUNT.

NOTE:


WAP'S ARE NOT SHOWN AND SHALL BE RE-CABLED WITH A SINGLE CAT 6A CABLE AND DIRECT-TERMINATED FIELD PLUG.

5/25/2022 11:08:32 AM  
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Revisions table with columns: Revisions, Date.

CONSULTANT: GDM ARCHITECTS - ENGINEERS, ADAM GOODIN, PE

ARCHITECT/ENGINEER OF RECORD: RSA Engineering, Inc.

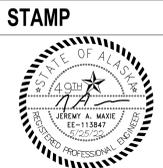

PROGRAM CONTRACTING ACTIVITY CENTRAL (PCAC) U.S. Department of Veterans Affairs


DRAWING TITLE: NEW TELECOM SPACE EQUIPMENT SCHEDULE. APPROVED: Project Director

PHASE: 100% CONSTRUCTION DOCUMENTS. FULLY SPRINKLERED

PROJECT TITLE: EHRM INFRASTRUCTURE UPGRADES. LOCATION: FORT MEADE, SOUTH DAKOTA. ISSUE DATE: 05/25/2022. CHECKED BY: JAM. DRAWN BY: LKA, CK.

PROJECT NUMBER: 568-21-701. BUILDING NUMBER. DRAWING NUMBER: TK-042

LEGEND	
	25 PAIR COPPER FOR ANALOG BACKBONE

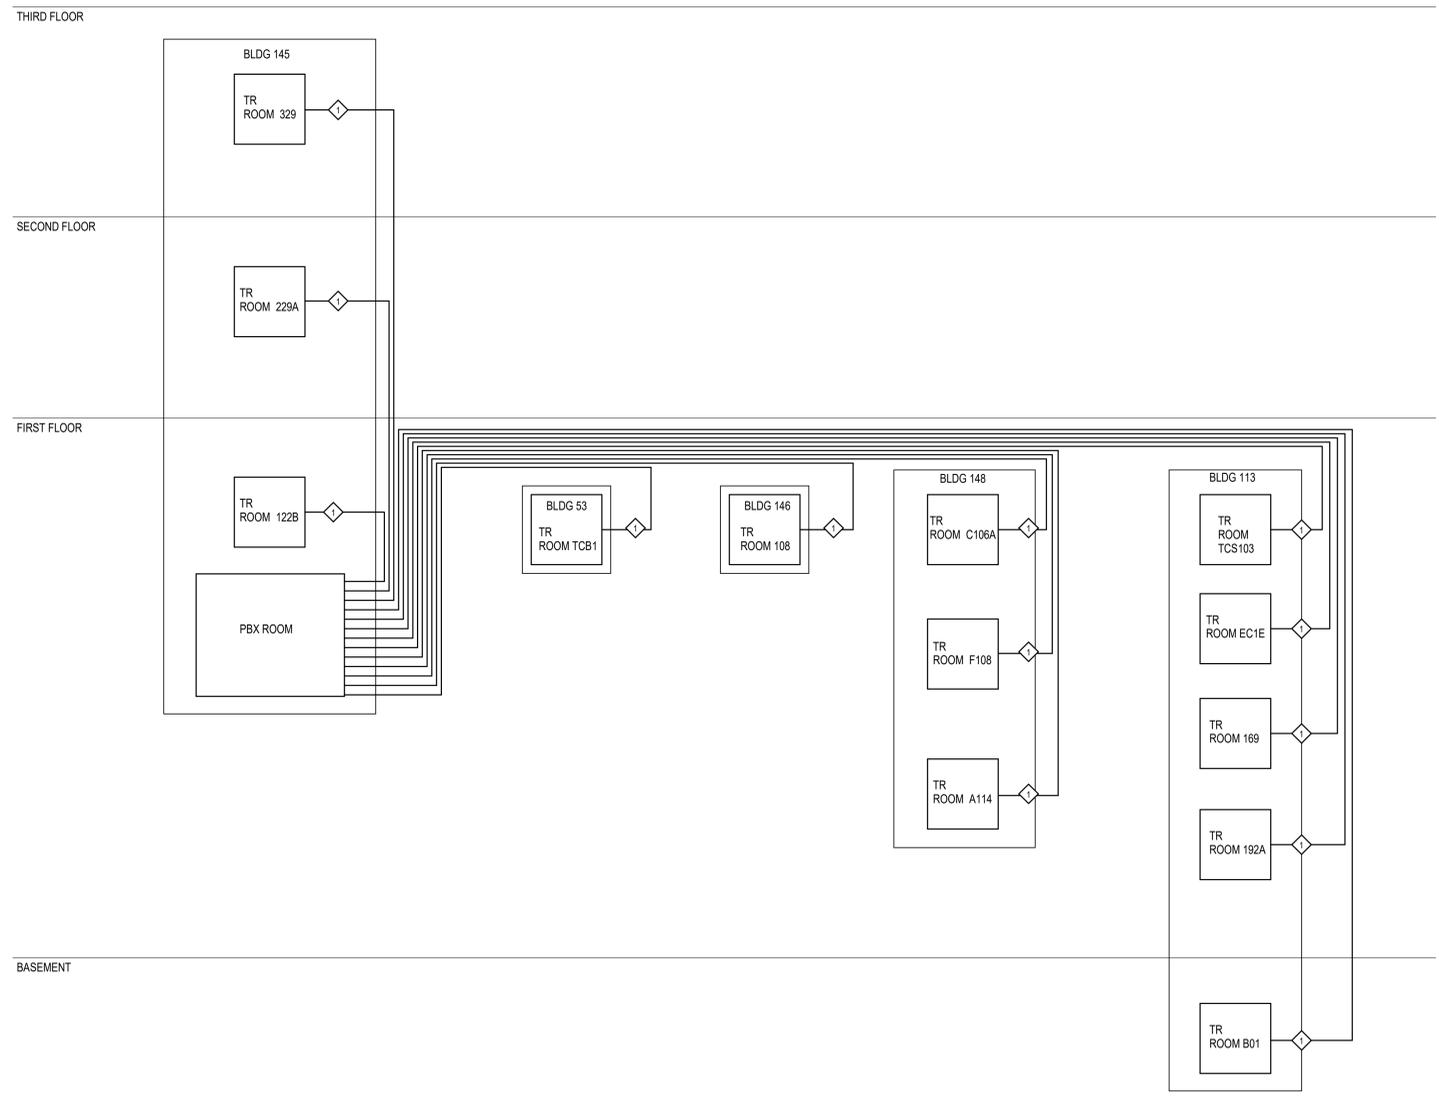

1 ANALOG RISER DIAGRAM  
NOT TO SCALE

5/25/2022 11:08:32 AM  
F:\M\568-21-701-VA Medical Center - Ft Meade\SD\SERIES - DETAILS\_R201.rvt

Revisions:	Date:

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**PROGRAM CONTRACTING ACTIVITY CENTRAL (PCAC)**  
U.S. Department of Veterans Affairs

**DRAWING TITLE**  
ANALOG RISER DIAGRAM

APPROVED: Project Director

**PHASE**  
100% CONSTRUCTION DOCUMENTS

**FLS**  
FULLY SPRINKLERED

**PROJECT TITLE**  
EHRM INFRASTRUCTURE UPGRADES

**LOCATION**  
FORT MEADE, SOUTH DAKOTA

ISSUE DATE: 05/25/2022  
CHECKED BY: JAM  
DRAWN BY: CK

**PROJECT NUMBER**  
568-21-701

**BUILDING NUMBER**

**DRAWING NUMBER**  
TK-043

