




4 90 - TR109A EAST ELEVATION
1/2" = 1'-0"

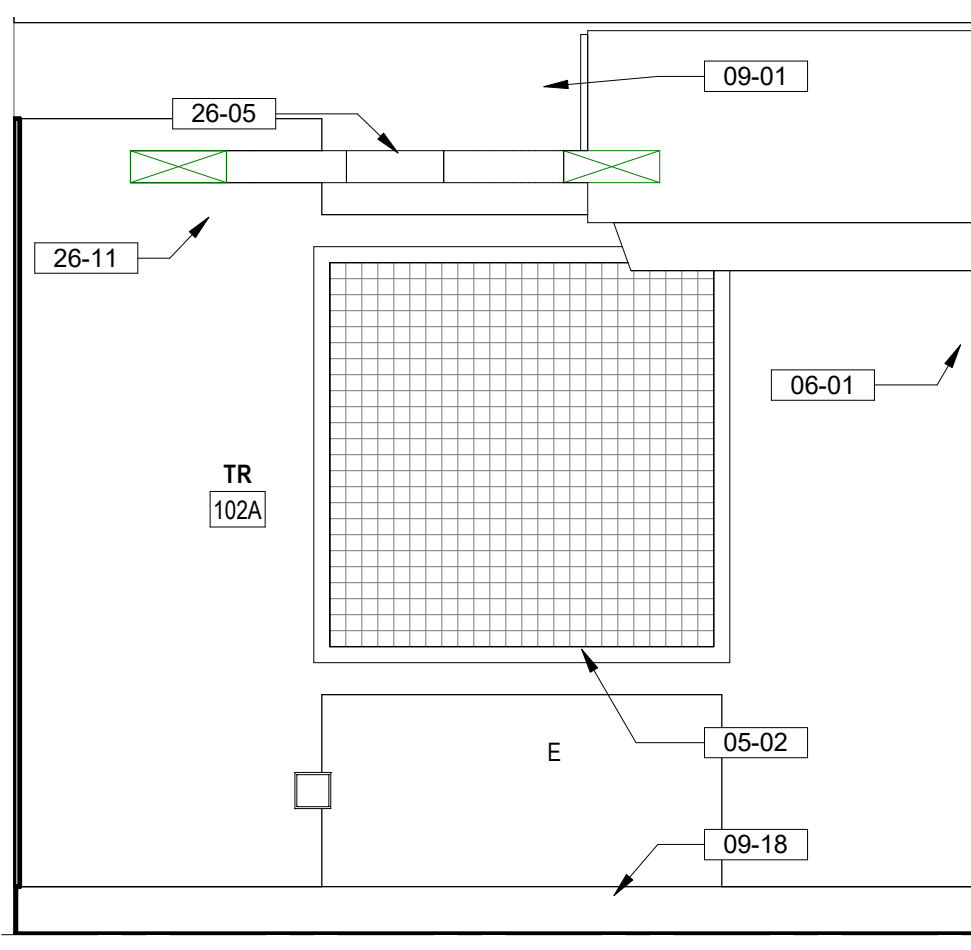


3 90 - TR 109A NORTH ELEVATION
1/2" = 1'-0"

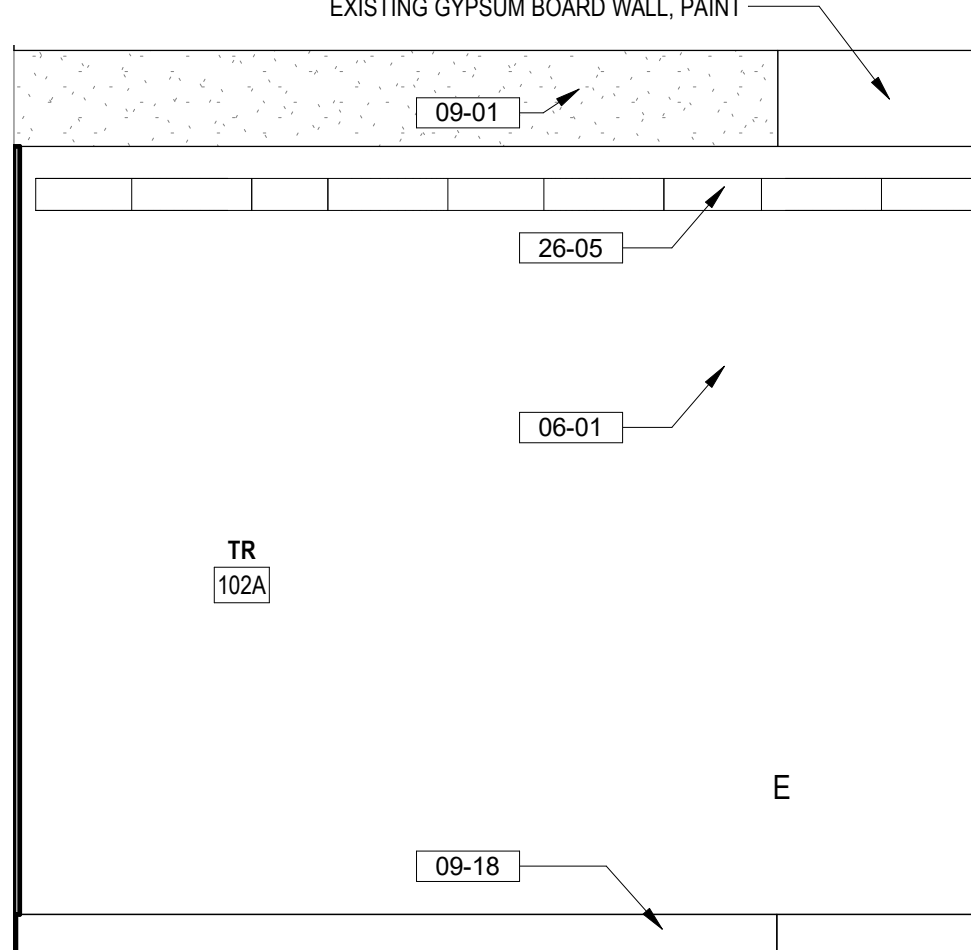


2 90 - TR 109A SOUTH ELEVATION
1/2" = 1'-0"

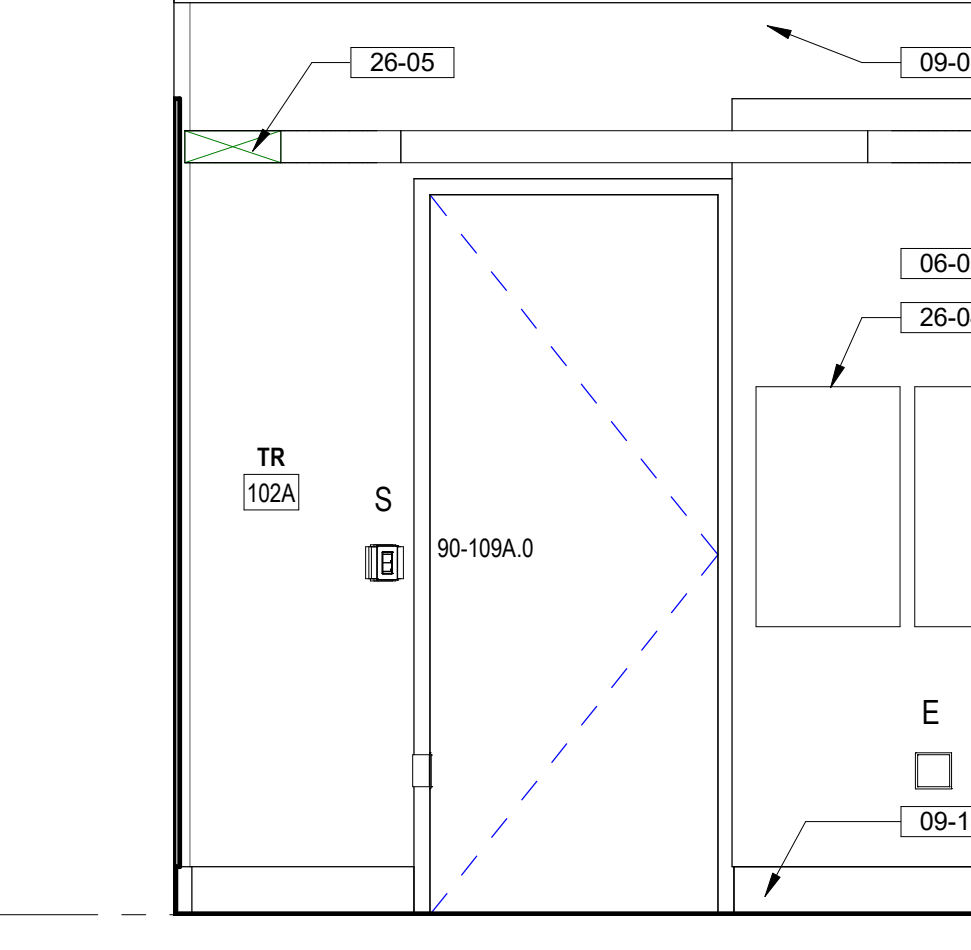


1 90 - TR 109A WEST ELEVATION
1/2" = 1'-0"

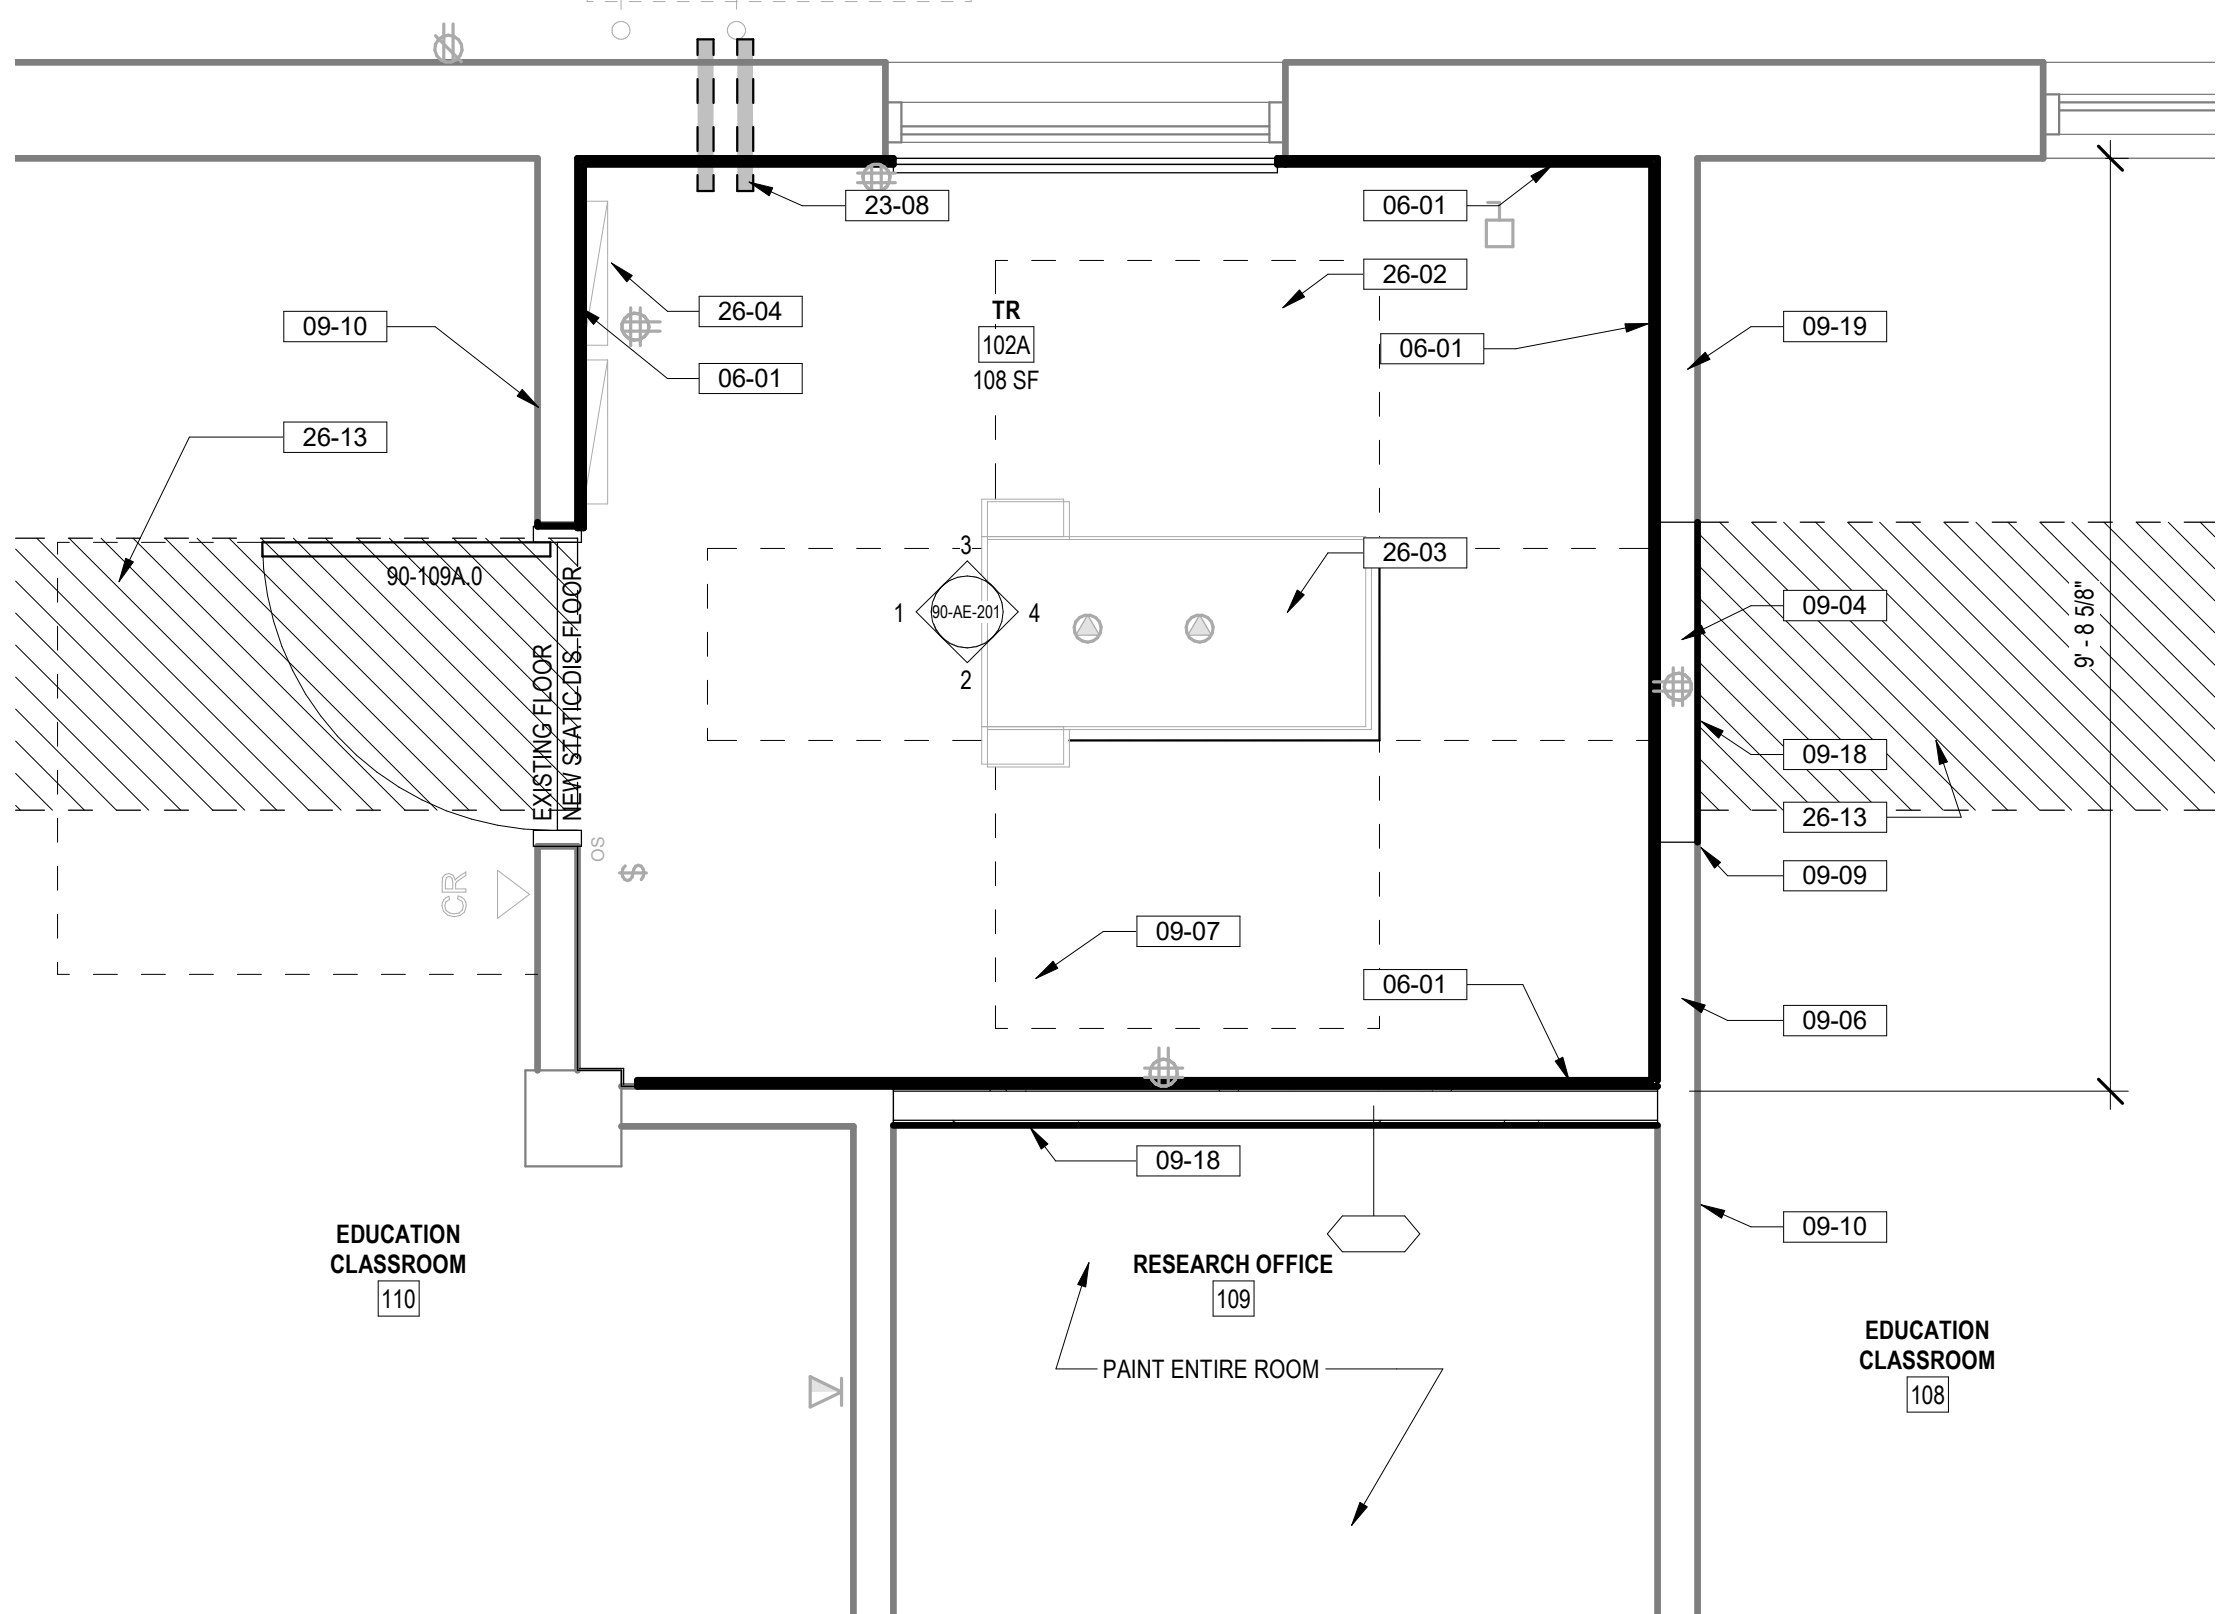

6 90 - 109A ENLARGED PLAN
1/2" = 1'-0"

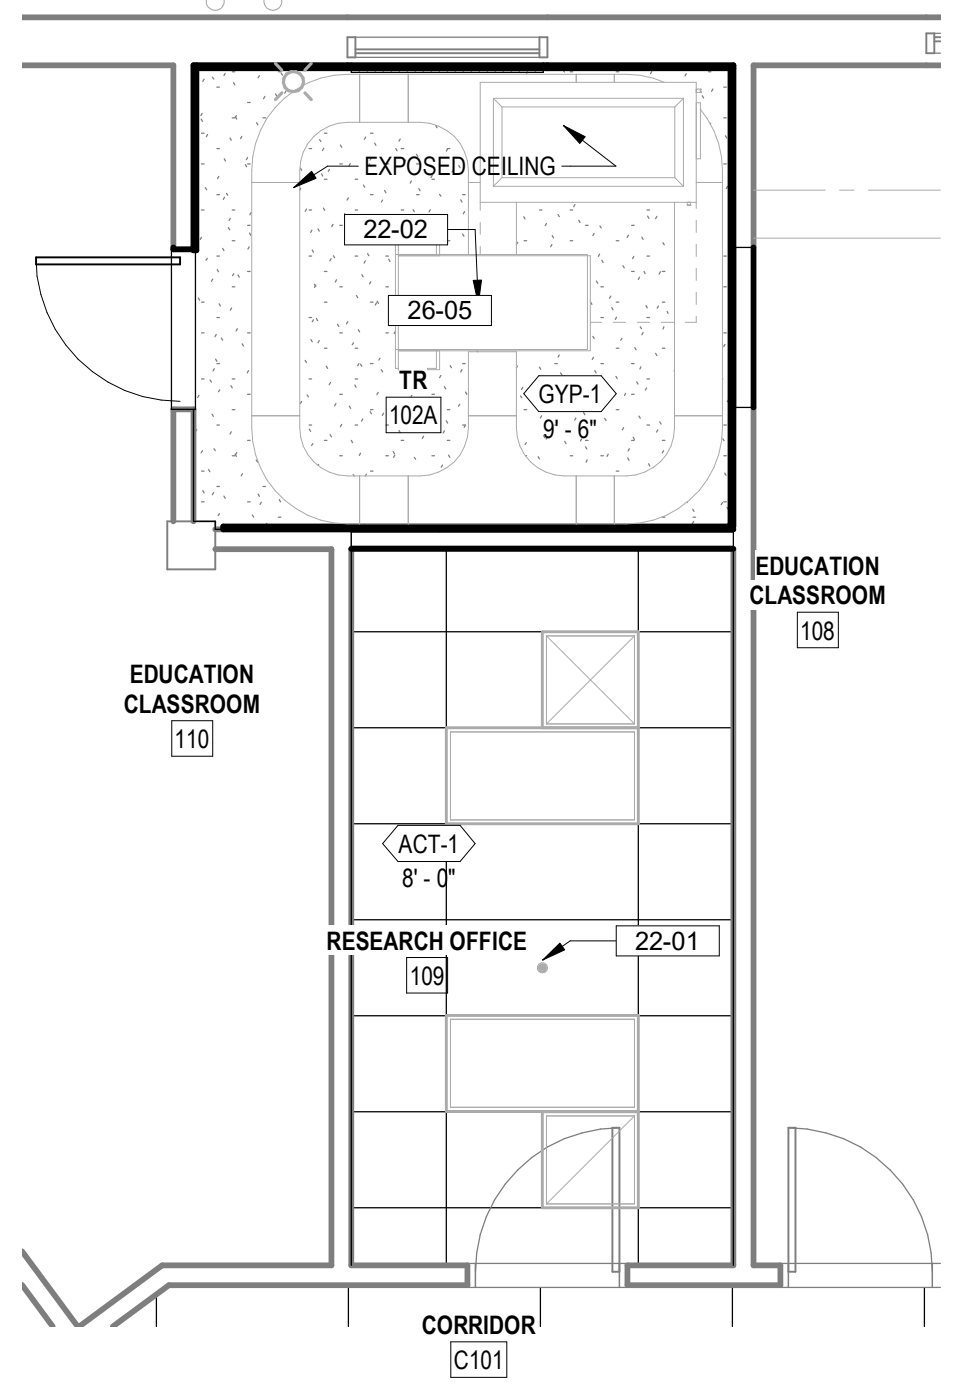

7 LEVEL 1 - ENLARGED RCP
1/4" = 1'-0"

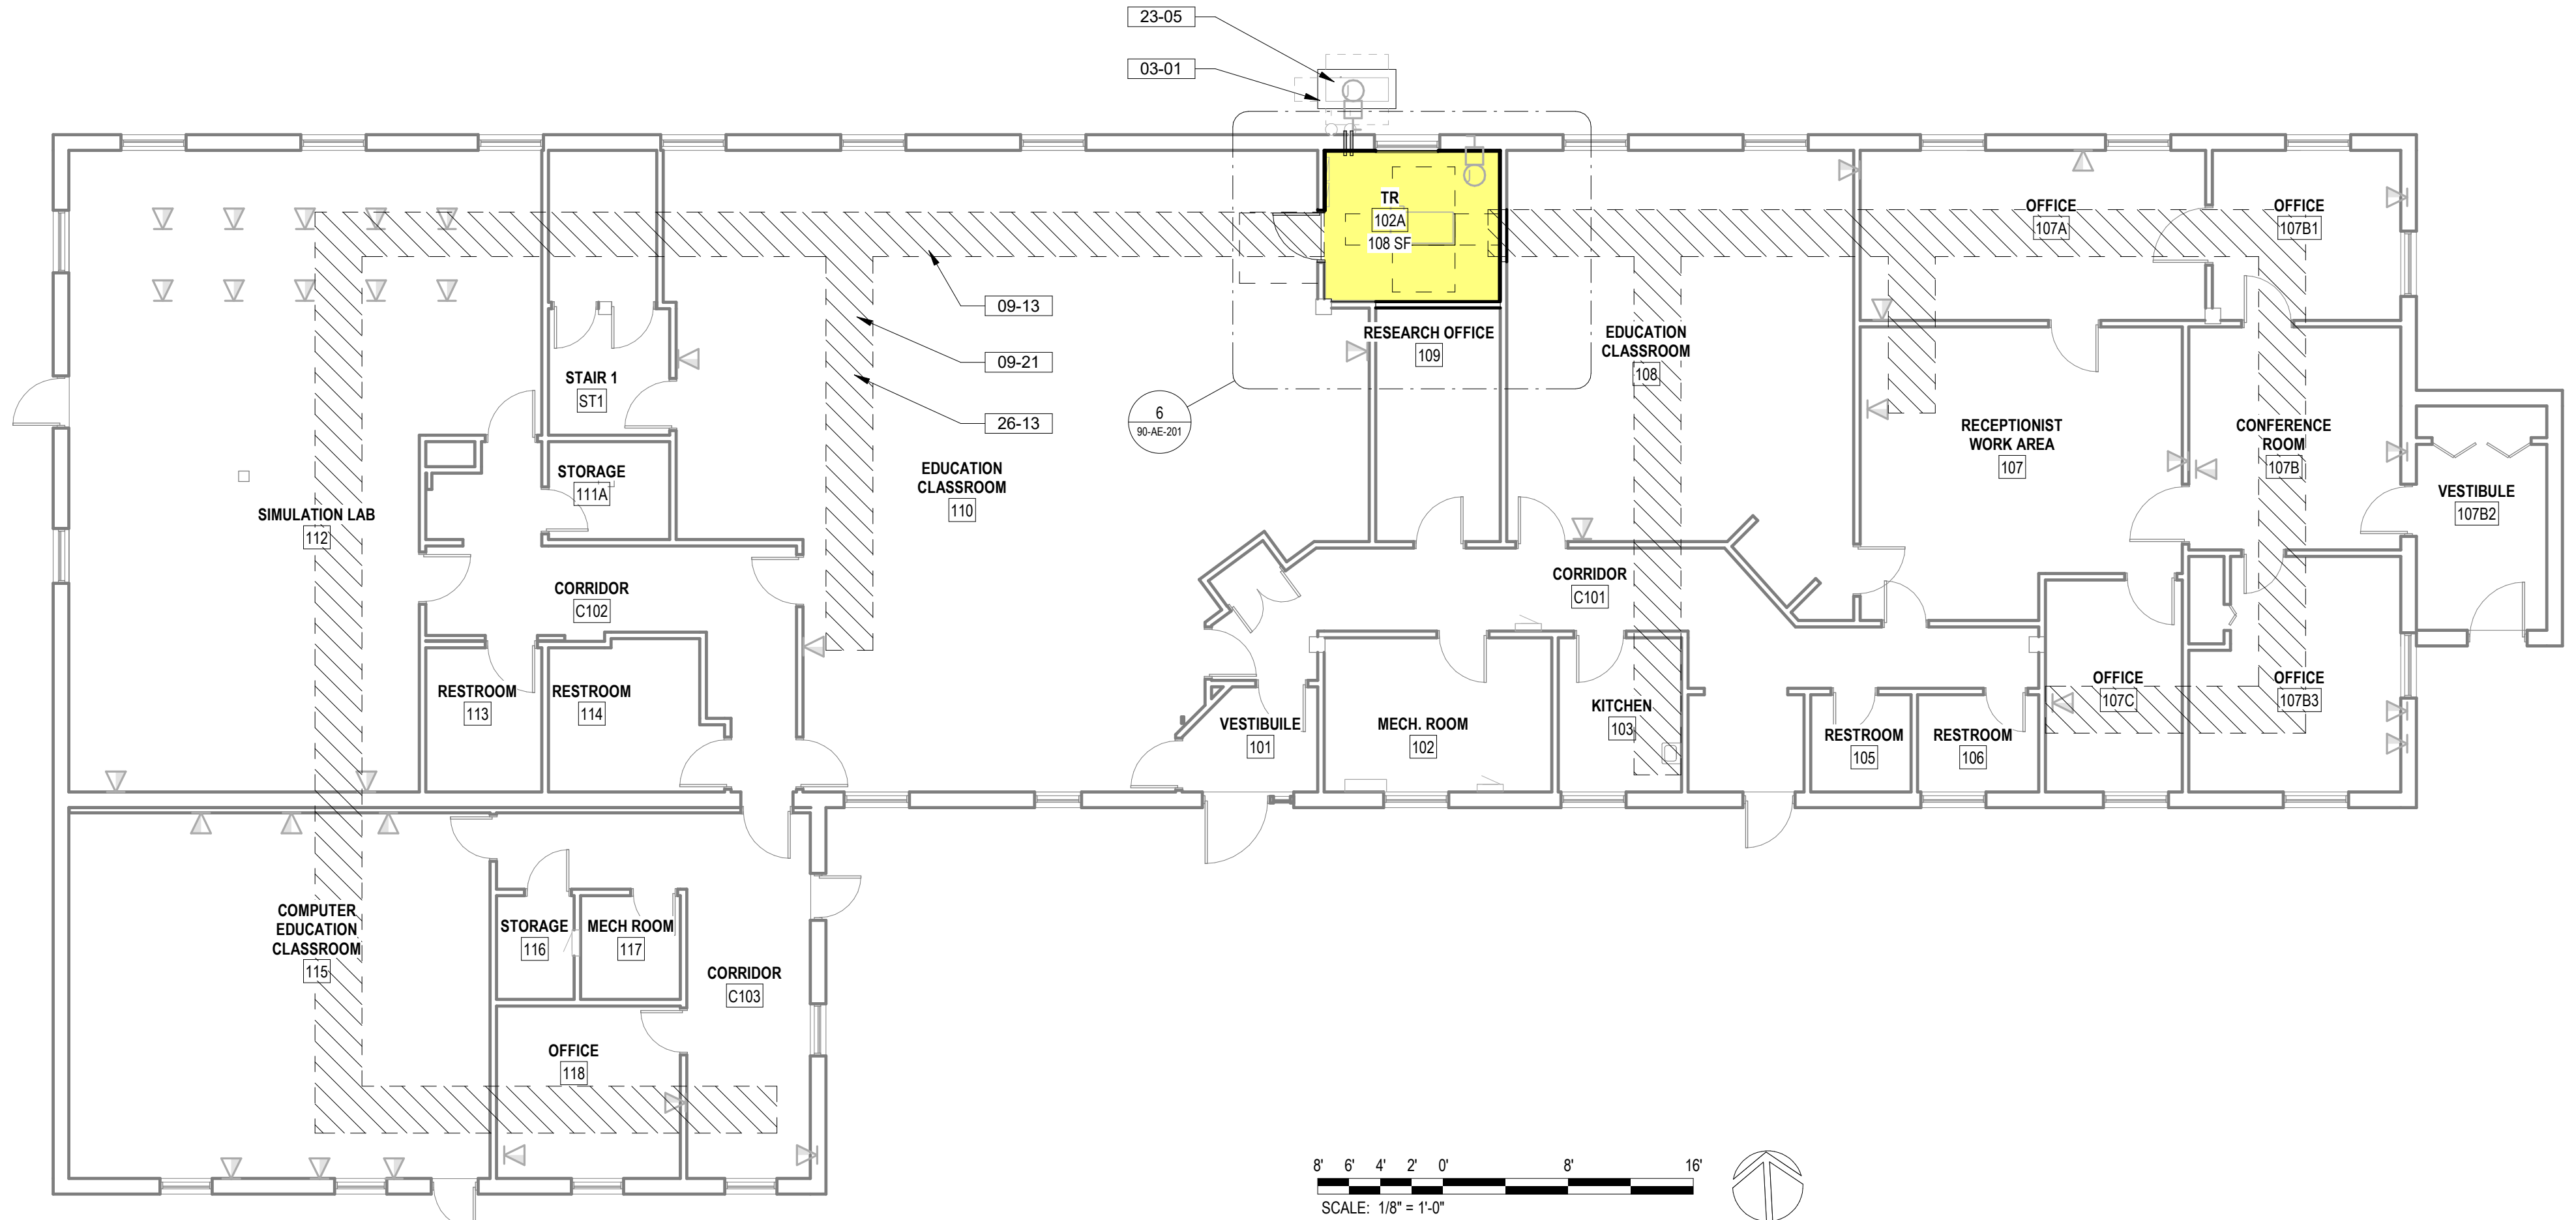

5 90 - LEVEL 1 FLOOR PLAN
1/8" = 1'-0"

REFLECTED CEILING PLAN LEGEND

- 2x2 LIGHT FIXTURE
- 2x4 LIGHT FIXTURE
- STRIP LIGHT FIXTURE
- 6" RECESSED CAN LIGHT FIXTURE
- SUPPLY AIR DIFFUSER
- RETURN AIR VENT
- EXHAUST FAN
- 5/8" GYP. BOARD CEILING AFFIXED TO 3/8" MTL STUDS
- 2x2' SUSPENDED ACOUSTIC CEILING TILE CEILING
- 2x4' SUSPENDED ACOUSTIC CEILING TILE CEILING

ROOM ALLOCATION LEGEND

- PROPOSED NEW CABINET / TR / MCR LOCATION
- PROPOSED EXPANSION TO TR
- EXISTING TR WITH POWER AND FIBER UPGRADES. SEE TELECOM AND ELECTRICAL DRAWINGS
- ABANDONED ROOM
- ROOM TO REMAIN, NO WORK
- REMODEL REQUIRED DUE TO EHRM IMPACT

FLOOR PLAN NOTES

1. SEE G SERIES SHEETS FOR BALANCE OF PLAN GENERAL NOTES.
2. REFER TO STRUCTURAL, MECHANICAL, AND ELECTRICAL DRAWINGS FOR ADDITIONAL INFORMATION. ALL INFORMATION REGARDING EXISTING CONDITIONS IS BASED UPON OWNER-SUPPLIED DOCUMENTS AND MAY NOT PRECISELY REFLECT FIELD CONDITIONS.
3. PROVIDE ALL BACKING FOR MILLWORK, GRAB BARS, AND ANY AND ALL WALL MOUNTED EQUIPMENT OR ACCESSORIES; COORDINATE LOCATIONS.
4. ALL DIMENSIONS ARE FROM STRUCTURAL OR UNFINISHED FACE OF STUD, UNLESS OTHERWISE NOTED.
5. PROVIDE A SMOOTH AND LEVEL FINISH FLOOR, TYP. PATCH AND REPAIR ALL INCONSISTENCIES IN FLOOR ELEVATIONS.
6. PATCH AND REPAIR ANY / ALL WALL SURFACES AS REQUIRED TO PROVIDE SUITABLE SUBSTRATE FOR FINISHES.
7. REFER TO DOOR AND FRAME SCHEDULE FOR DOORS REQUIRING ADA ACCESS CONTROL.
8. PROVIDE ACOUSTICAL SEALANT AROUND WALL EDGES, TOP AND BOTTOM, AND PENETRATIONS, AND INSTALL PUTTY PADS AROUND ELECTRICAL BOXES WHERE PARTITION CONTAINS ACOUSTICAL INSULATION.
9. ALL TELECOMMUNICATION ROOMS ARE TO HAVE EXPOSED STRUCTURE UNLESS NOTED OTHERWISE, NO CEILINGS SPECIFIED.

REFLECTED CEILING PLAN NOTES

1. REFER TO ELECTRICAL SHEETS FOR FIXTURE TYPES, SWITCHING, AND SPECIAL SYSTEMS.
2. REFER TO MECHANICAL SHEETS FOR DIFFUSER AND DUCTING LAYOUTS.
3. SEE SHEET 00-GI-006 FOR TYPICAL ACOUSTICAL PANEL CEILING DETAILS


FLOOR PLAN LEGEND

- CARD READER, REF TELECOM DRAWINGS
- DATA PORT, REF TELECOM DRAWINGS
- OUTLET, REF ELEC DRAWINGS
- WIRELESS ACCESS POINT, REF TELECOM DRAWINGS
- ELEC PANEL, REF ELEC DRAWINGS

KEY NOTES

- 03-01 NEW HOUSEKEEPING PAD, COORDINATE WITH MECHANICAL DRAWINGS FOR SIZE AND CIVIL DRAWINGS FOR DETAILS
- 05-02 SECURITY GRILL: 2" x 2" x 10GA WIRE MESH WELDED TO 1 1/2" x 1 1/4" x 13GA ROLL FORMED ANGLE FRAME. PROVIDE 3" CLIPS, ANCHOR DIRECTLY ONTO EXISTING WALL. CONTRACTOR TO VERIFY ACTUAL WINDOW SIZE PRIOR TO GRILL FABRICATION
- 06-01 INSTALL 3/4" AC GRADE OR BETTER FIRE RETARDANT PLYWOOD, PAINT WITH TWO COATS OF SEMI-GLOSS BRIGHT WHITE FIRE RETARDANT PAINT, MOUNT BOTTOM OF PLYWOOD 6" A.F.F., TOP OF PLYWOOD AT 8'-6" A.F.F.
- 09-01 PAINT WALL ABOVE PLYWOOD WITH SEMI-GLOSS PAINT, COLOR TO MATCH PLYWOOD PAINT.
- 09-04 INFILL DOOR OPENING WITH WALL TYPE MATCHING ADJACENT, INSTALL TRIM & BASE TO MATCH ADJACENT WALL
- 09-06 SEAL ALL WALL PENETRATIONS EXISTING AND NEW, PROVIDE APPROPRIATE FIRE RATED UL HELIX DESIGNATION FOR PIPES AND/OR CONDUIT PENETRATIONS; SEE TYPICAL PENETRATION DETAILS FOR RATED WALL CONDITIONS
- 09-07 INSTALL STATIC DISSIPATIVE RESILIENT FLOORING
- 09-09 APPLY JOINT COMPOUND AND FEATHER A MINIMUM OF 3' HORIZONTALLY AS REQUIRED TO ACHIEVE A SMOOTH AND UNIFORM APPEARANCE
- 09-10 PAINT FULL LENGTH OF WALL TO NEAREST EXTERIOR OR INTERIOR CORNER, COLOR TO MATCH EXISTING WALLS
- 09-13 FOLLOW EXISTING CABLE ROUTING FOR REMOVAL OF EXISTING CABLE AND INSTALLATION OF NEW CABLES AT LOCATIONS AS NOTED IN TELECOM DRAWINGS
- 09-18 8" HIGH COVERED RUBBER WALL BASE, COLOR TO BE SELECTED FROM MANUFACTURER'S STANDARD SELECTION
- 09-19 EXTEND GYPSUM BOARD WALL TO UNDERSIDE OF STRUCTURE WITH 5/8" GYPSUM BOARD LAYER ON EACH SIDE OF WALL, SEAL
- 09-21 REMOVE AND RE-INSTALL CEILING TILES AND OTHER CEILING MOUNTED DEVICES AS NEEDED FOR INSTALLATION OF CABLES AND CONDUITS ABOVE CEILING AS PER TELECOM DRAWINGS, REPLACE ALL DAMAGED TILES TO MATCH EXISTING AND REINSTALL ALL DEVICES AS NEEDED. DO NOT LEAVE CEILING TILES UNINSTALLED AND UNATTENDED PAST DURATION OF WORKING SHIFT. CONTINUOUSLY REINSTALL TILES TO PROVIDE SEALED SMOKE ASSEMBLY
- 22-01 FIRE SUPPRESSION SPRINKLER HEAD SHOWN FOR REFERENCE ONLY; FIRE SUPPRESSION CONTRACTOR TO VERIFY ACTUAL QUANTITIES REQUIRED, INSTALL SYMMETRICALLY CENTER IN TILE
- 22-02 UPRIGHT HEAD FIRE SUPPRESSION SPRINKLER HEAD SHOWN FOR REFERENCE ONLY; FIRE SUPPRESSION CONTRACTOR TO VERIFY ACTUAL QUANTITIES REQUIRED, COORDINATE INSTALLATION WITH MECH DRAWINGS
- 23-05 MECHANICAL UNITS, SEE MECH DRAWINGS FOR SIZE AND SPECS
- 23-08 NEW REFRIGERANT PIPE LINES ROUTING SHOWN FOR REFERENCE ONLY; SEE MECHANICAL DRAWINGS FOR ACTUAL ROUTING; CONTRACTOR TO REMOVE CEILING TILES ALONG ROUTE OUTSIDE OF TRS AND REPLACE WITHIN WORKING SHIFT, CONDUCT INFECTION PREVENTION MEASURES AS SPECIFIED.
- 26-02 3" PERIMETER CLEARANCE AROUND SERVER RACK SHOWN DASHED
- 26-03 TELECOM RACK, SEE TELECOMMUNICATION DRAWINGS
- 26-04 ELECTRICAL PANELS, SEE ELECTRICAL DRAWINGS
- 26-05 CABLE TRAY, SEE TELECOMMUNICATION DRAWINGS
- 26-11 STROBE LIGHT, SEE ELECTRICAL DRAWINGS
- 26-13 NEW CABLE TRAY ROUTING SHOWN FOR REFERENCE ONLY; SEE TELECOMMUNICATION DRAWINGS FOR ACTUAL ROUTING, CONDUCT INFECTION PREVENTION MEASURES AS SPECIFIED.

PROJECT KEY PLAN

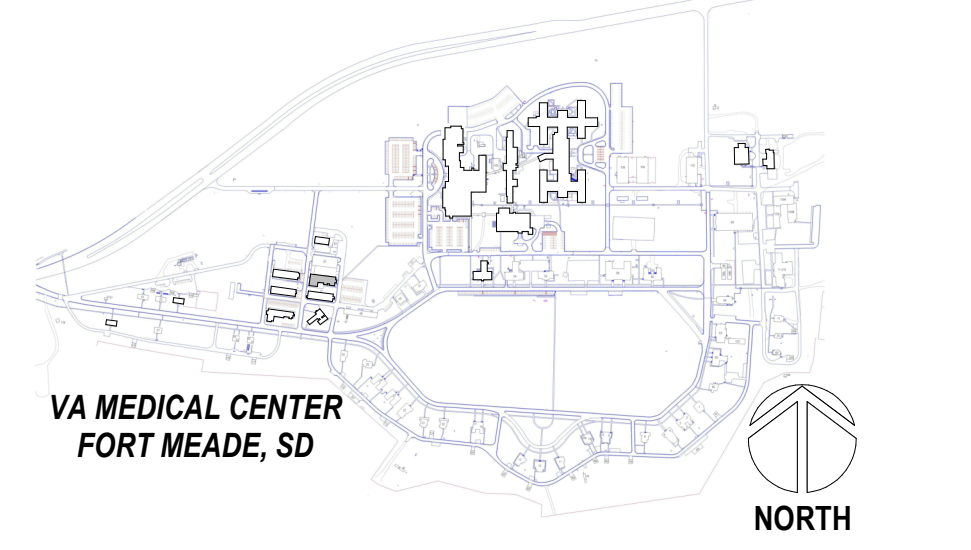

Revisions:	Date:

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PROGRAM CONTRACTING ACTIVITY CENTRAL (PCAC)

VA U.S. Department of Veterans Affairs

DRAWING TITLE
90-FLOOR PLANS AND ELEVATIONS

APPROVED: Project Director

PHASE
100% CONSTRUCTION DOCUMENTS

FLS
FULLY SPRINKLERED

PROJECT TITLE
EHRM INFRASTRUCTURE UPGRADES

LOCATION
FORT MEADE, SOUTH DAKOTA






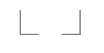
ISSUE DATE: 04/15/2022
CHECKED BY: TMP
DRAWN BY: JPR

PROJECT NUMBER
568-21-701

BUILDING NUMBER
BLDG 90

DRAWING NUMBER
90-AE-201

FLOOR PLAN LEGEND

-  CARD READER, REF TELECOM DRAWINGS
-  DATA PORT, REF TELECOM DRAWINGS
-  OUTLET, REF ELEC DRAWINGS
-  WIRELESS ACCESS POINT, REF TELECOM DRAWINGS
-  ELEC PANEL, REF ELEC DRAWINGS
-  STRIP LIGHT FIXTURE, REF ELEC DRAWINGS



FLOOR PLAN NOTES

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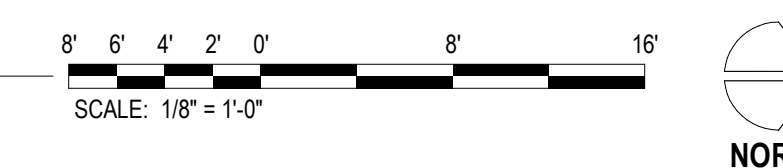
KEYNOTES

- 01-01 CLEAN UP AREA AROUND PROPOSED WALL MOUNTED CABINET LOCATION; COORDINATE WITH C.O.R. FOR RELOCATION OR REMOVAL OF INSTALLATION OBSTRUCTING ITEMS.
- 09-13 FOLLOW EXISTING CABLE ROUTING FOR REMOVAL OF EXISTING CABLE AND INSTALLATION OF NEW CABLES AT LOCATIONS AS NOTED IN TELECOM DRAWINGS.
- 13-01 ICRB CLASS I. SEE SPEC SECTION 01 35 26 FOR REQUIREMENTS AND WORKING HOURS RESTRICTIONS.
- 26-09 30" CLEARANCE AT WALL MOUNTED SERVER RACK SHOWN DASHED
- 26-10 WALL MOUNTED TELECOM CABINET, SEE TELECOM DRAWINGS

PROJECT KEY PLAN

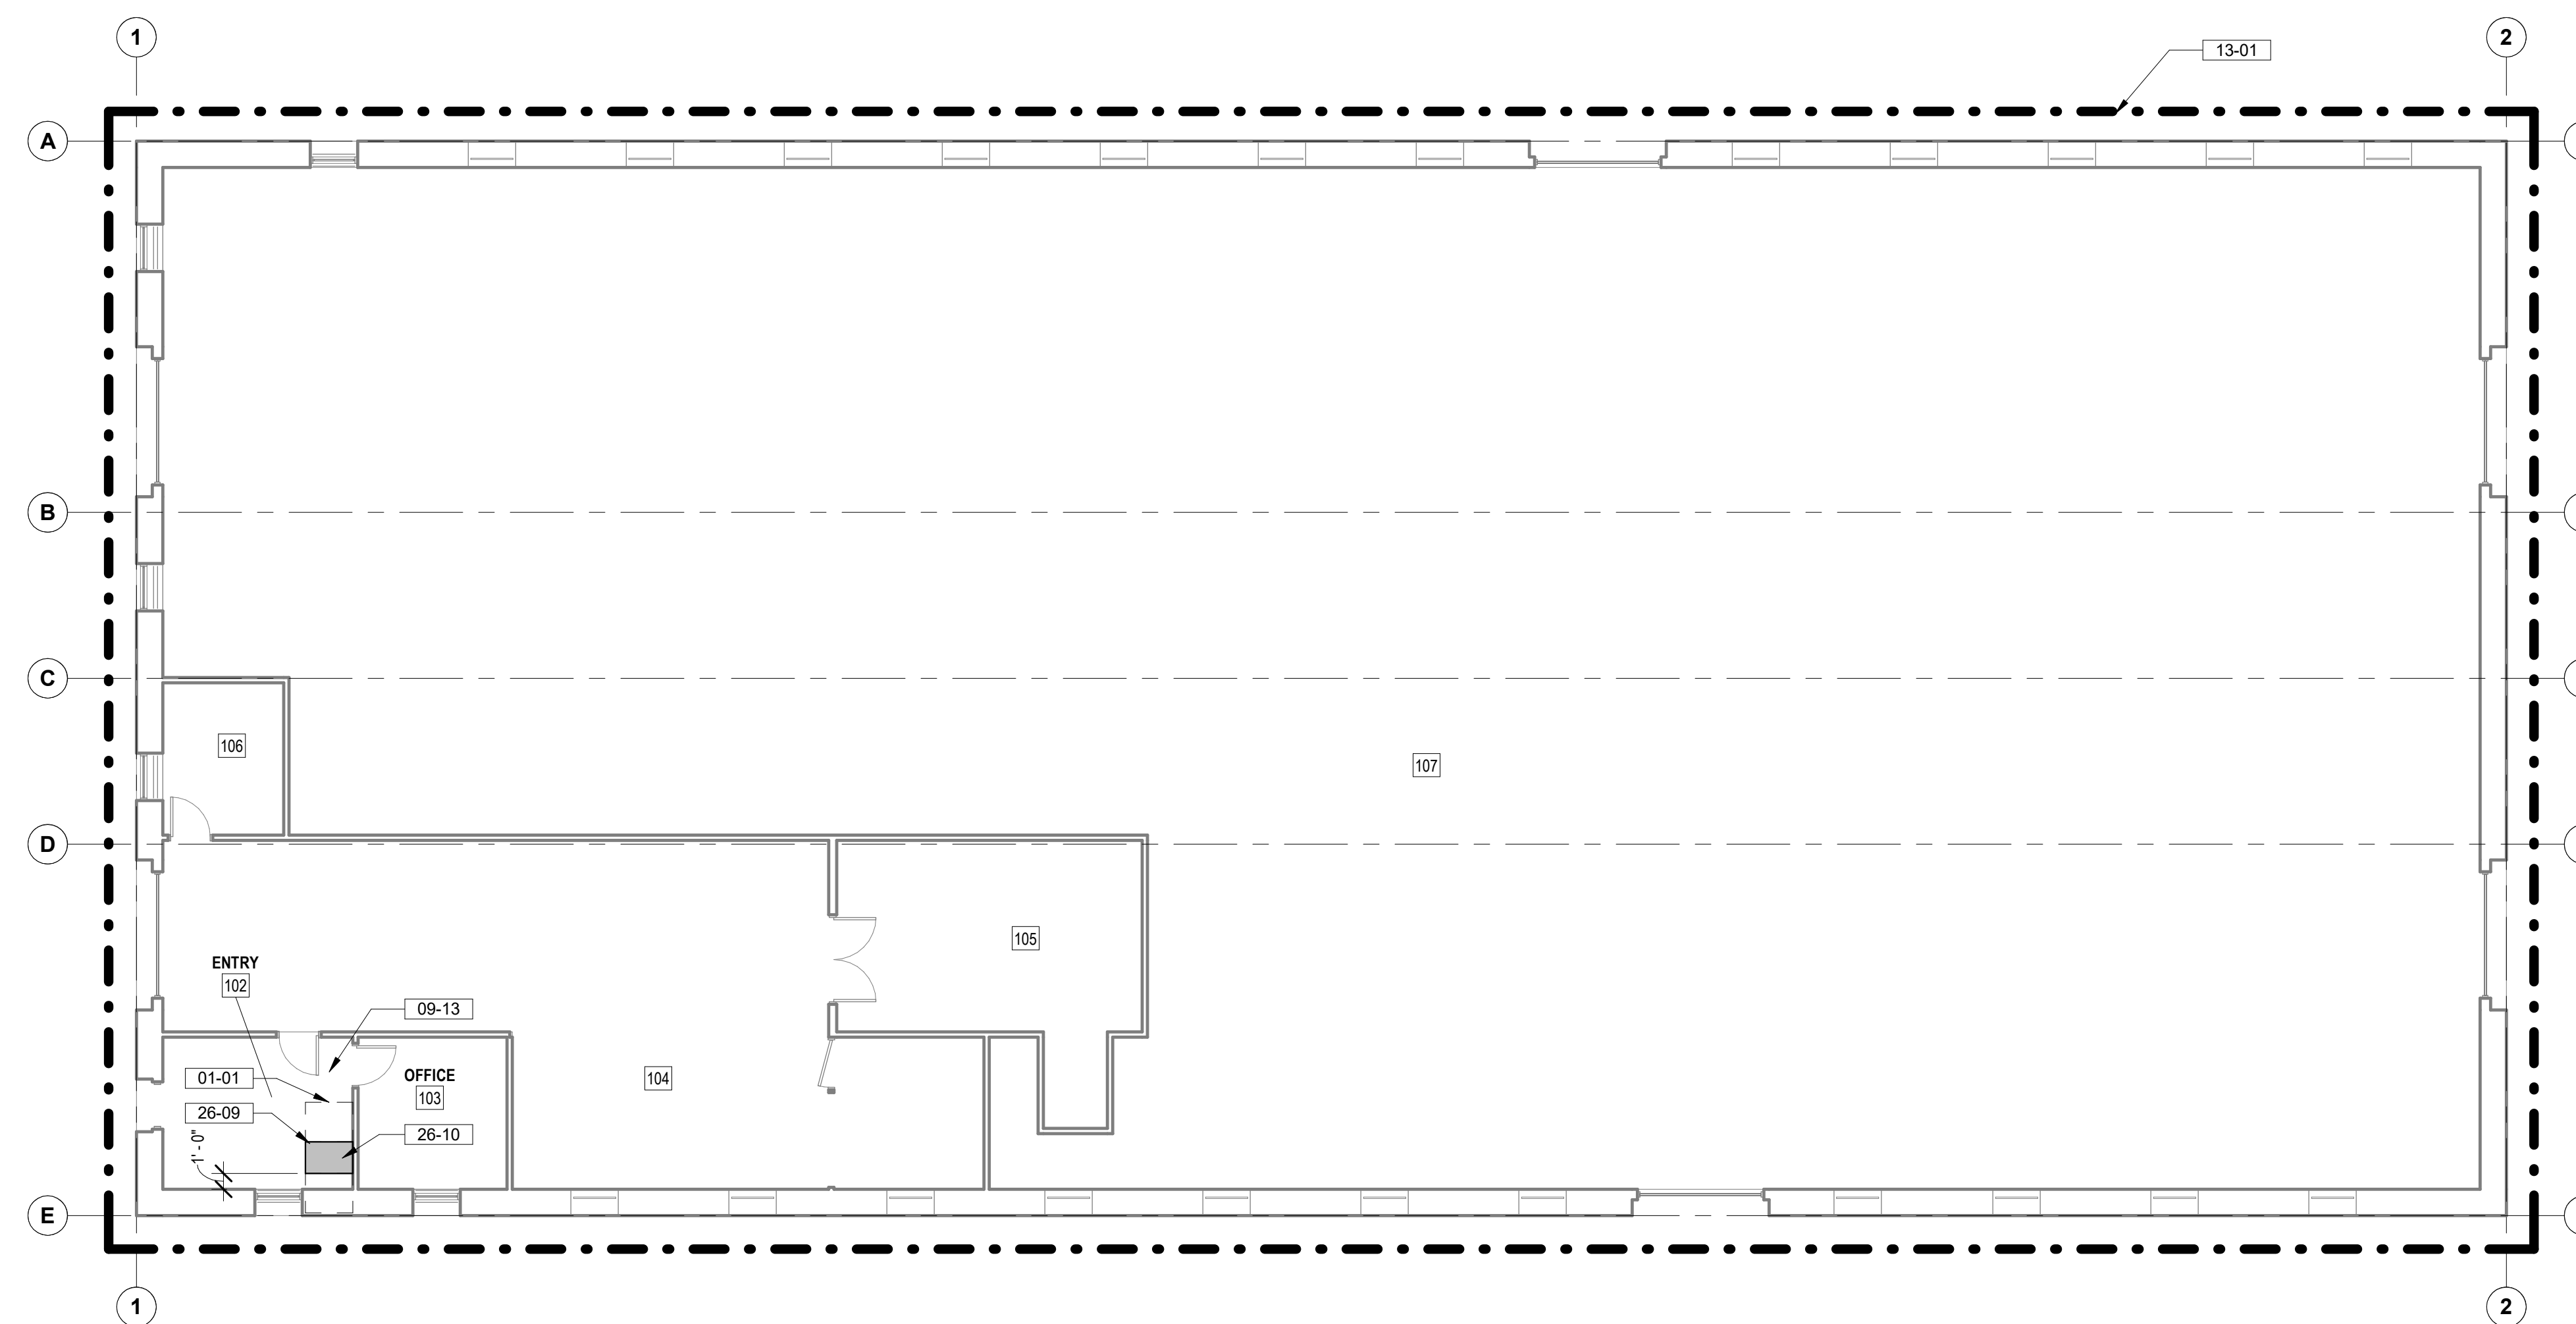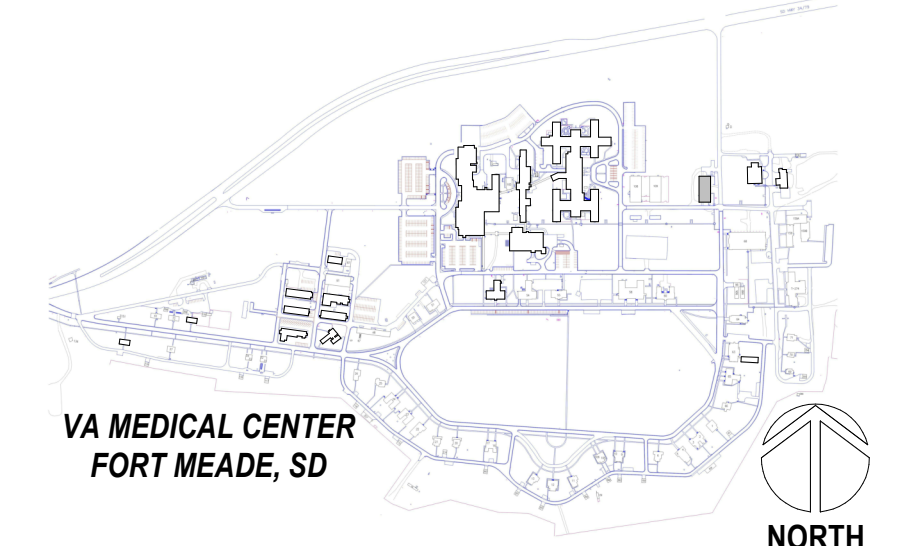

1 LEVEL 1 FLOOR PLAN
1/8" = 1'-0"



BIM 360/2/112_VA Medical Center - Ft Meade SD/2112_Bldg 110_20.rvt
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Revisions:	Date:


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


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PROGRAM CONTRACTING ACTIVITY CENTRAL (PCAC)

VA U.S. Department of Veterans Affairs

DRAWING TITLE
110-FLOOR PLANS

APPROVED: Project Director

PHASE
100% CONSTRUCTION DOCUMENTS

FLS
FULLY SPRINKLERED

PROJECT TITLE
EHRM INFRASTRUCTURE UPGRADES

LOCATION
FORT MEADE, SOUTH DAKOTA

ISSUE DATE: 04/15/2022
 CHECKED BY: TMP
 DRAWN BY: JPR





PROJECT NUMBER
568-21-701

BUILDING NUMBER
BLDG 110







DRAWING NUMBER
110-AE-201

A
B
C
D
E
F

LIFE SAFETY LEGEND

-  1-HOUR FIRE WALL
-  2-HOUR FIRE WALL
-  1-HOUR FIRE/SMOKE WALL
-  SMOKE RESISTIVE HAZARDOUS AREA







FLOOR PLAN LEGEND

-  CARD READER, REF TELECOM DRAWINGS
-  DATA PORT, REF TELECOM DRAWINGS
-  OUTLET, REF ELEC DRAWINGS
-  WIRELESS ACCESS POINT, REF TELECOM DRAWINGS
-  ELEC PANEL, REF ELEC DRAWINGS
-  STRIP LIGHT FIXTURE, REF ELEC DRAWINGS



FLOOR PLAN NOTES

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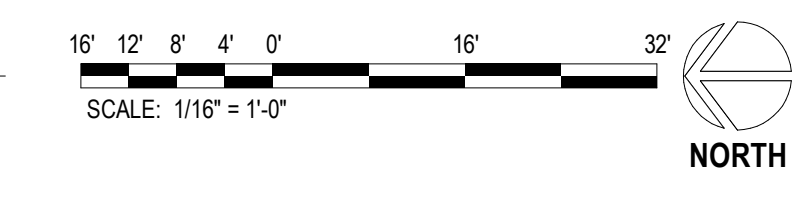
ROOM ALLOCATION LEGEND

-  PROPOSED NEW CABINET / TR / MCR LOCATION
-  PROPOSED EXPANSION TO TR
-  EXISTING TR WITH POWER AND FIBER UPGRADES. SEE TELECOM AND ELECTRICAL DRAWINGS
-  ABANDONED ROOM
-  ROOM TO REMAIN, NO WORK
-  REMODEL REQUIRED DUE TO EHRM IMPACT

PROJECT KEY PLAN

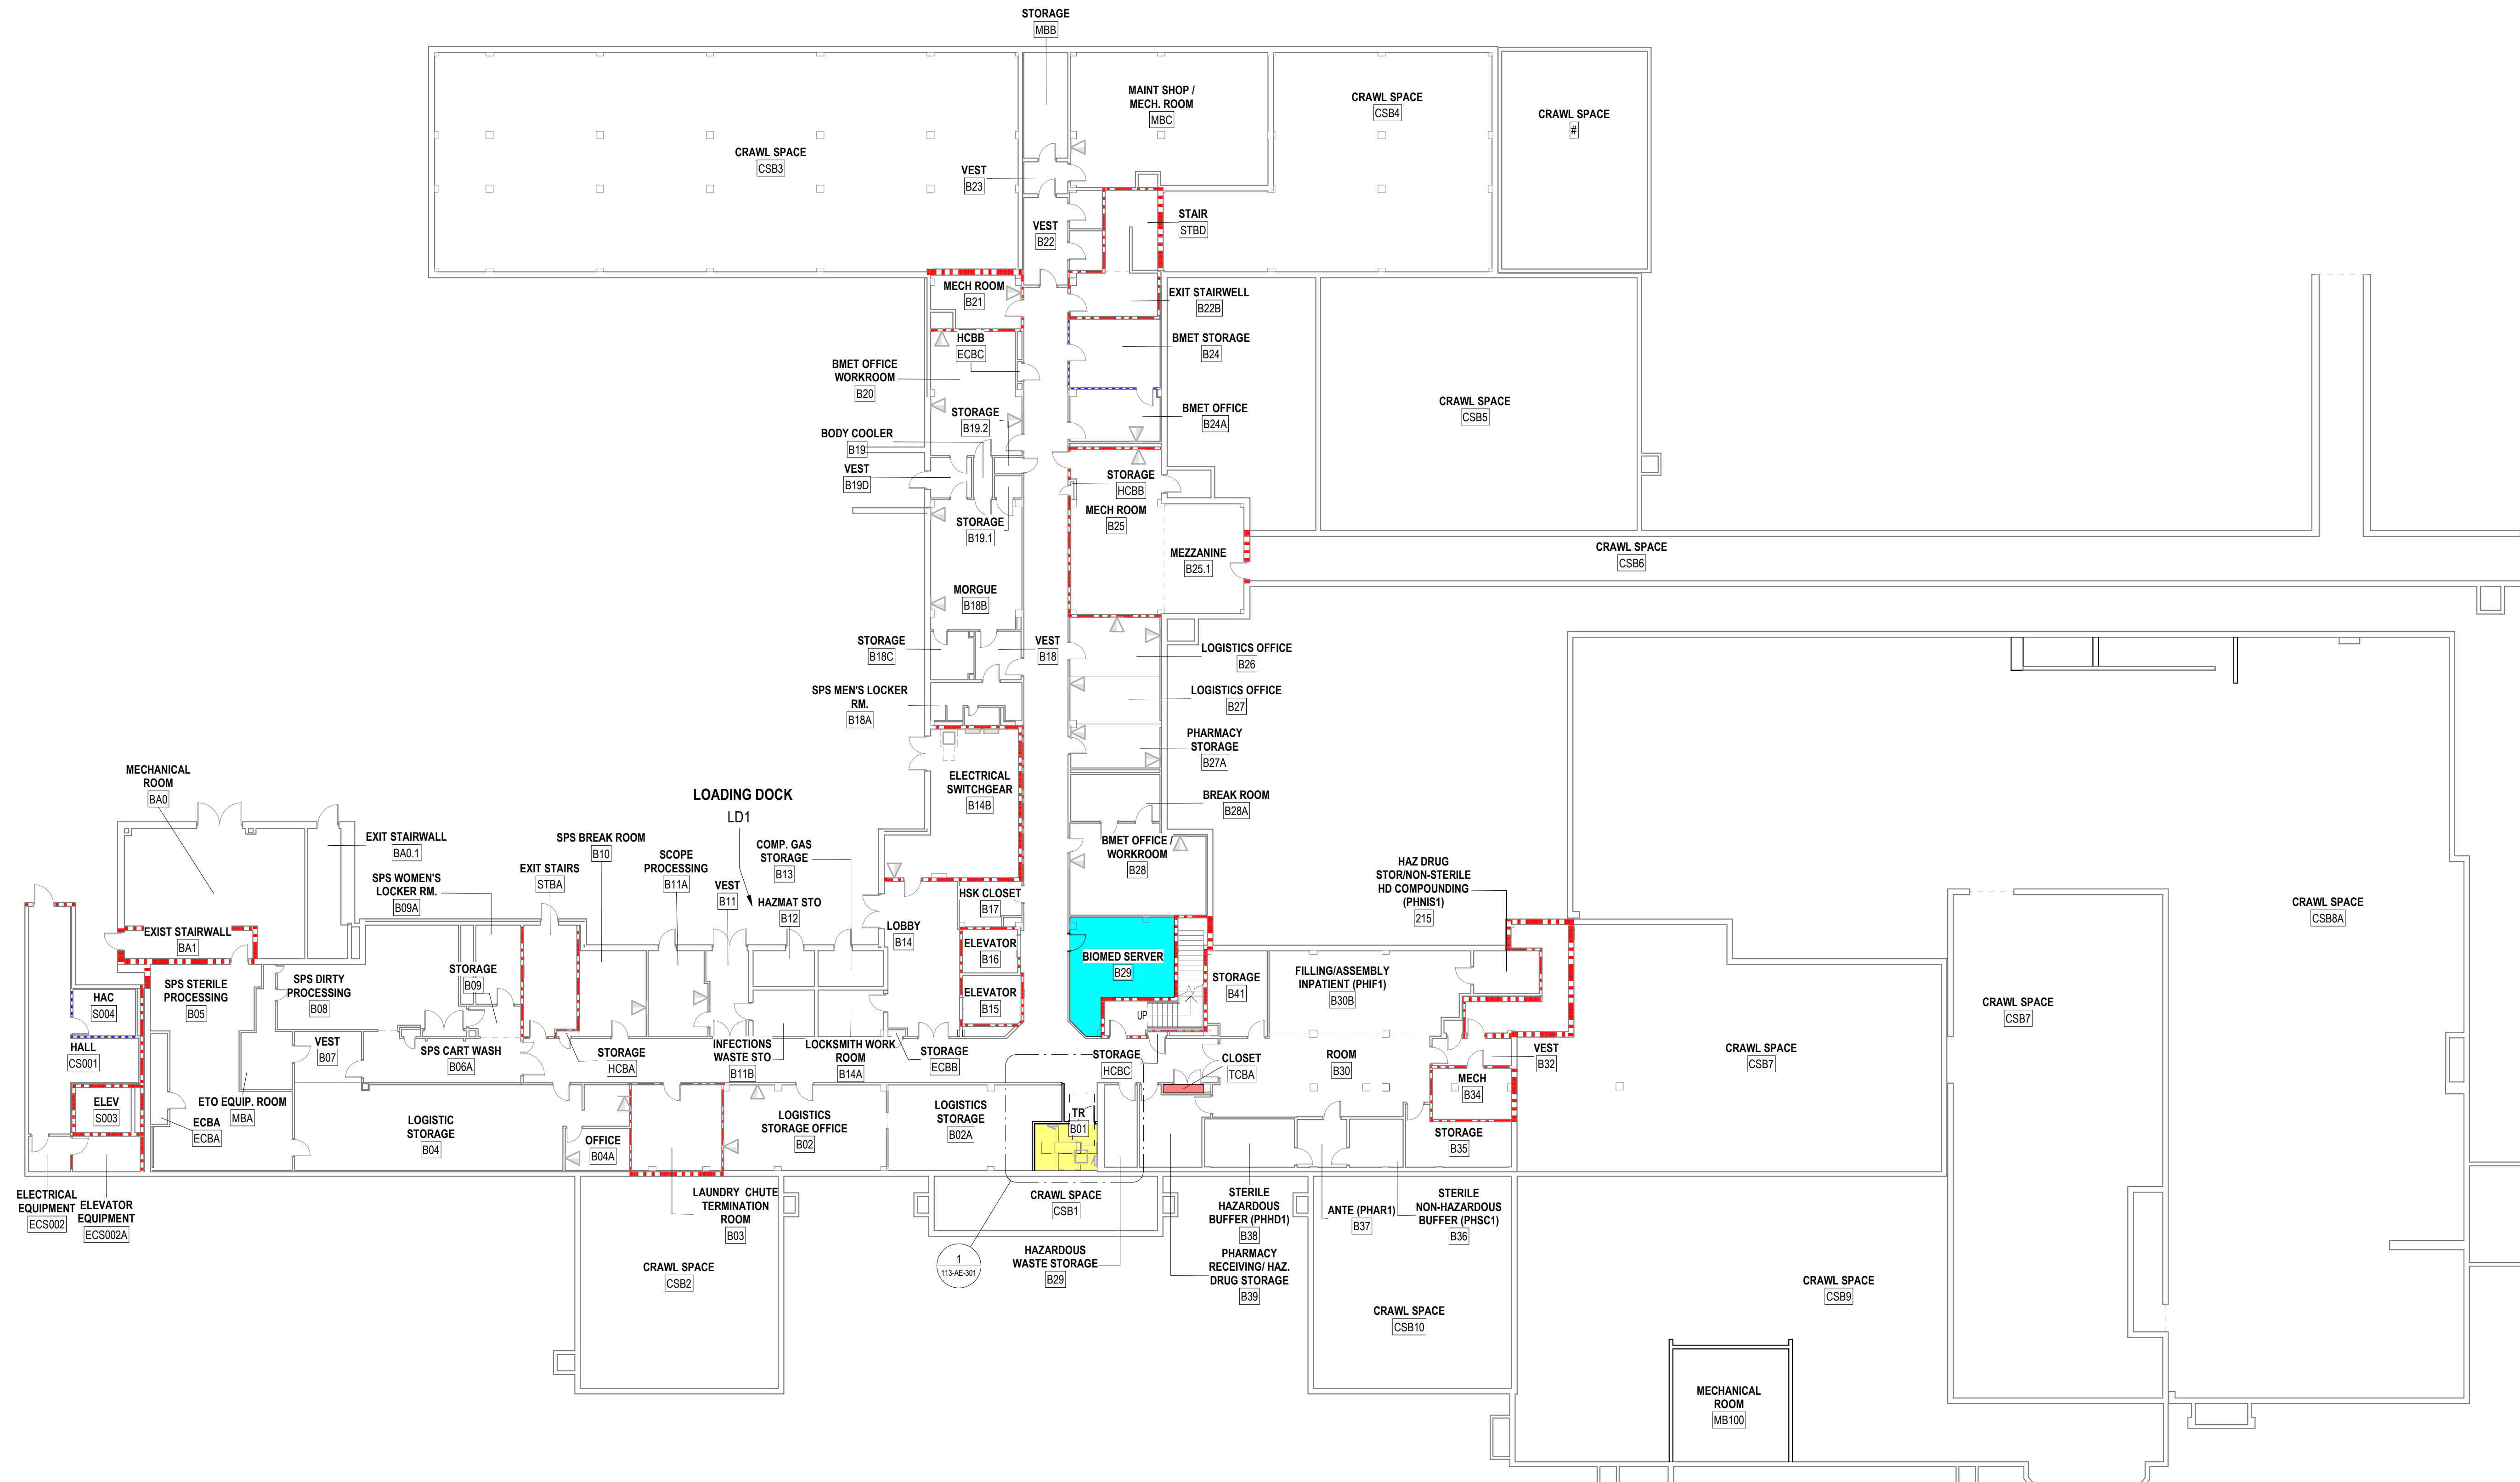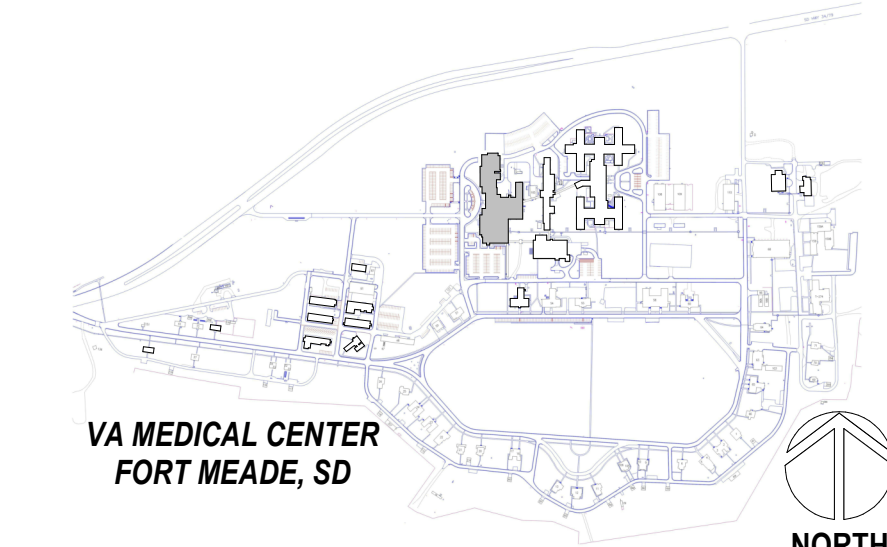

1 BASEMENT FLOOR PLAN
1/16" = 1'-0"



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Revisions:	Date:


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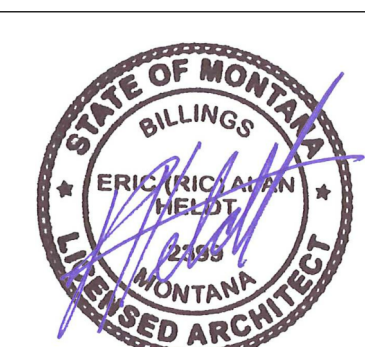


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
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PROGRAM CONTRACTING ACTIVITY CENTRAL (PCAC)



DRAWING TITLE
113-BASEMENT FLOOR PLAN

APPROVED: Project Director

PHASE
100% CONSTRUCTION DOCUMENTS

FLS
FULLY SPRINKLERED

PROJECT TITLE
EHRM INFRASTRUCTURE UPGRADES

LOCATION
FORT MEADE, SOUTH DAKOTA

ISSUE DATE: 04/15/2022
CHECKED BY: TMP
DRAWN BY: JPR

PROJECT NUMBER
568-21-701

BUILDING NUMBER
BLDG 113

DRAWING NUMBER
113-AE-200

ROOM ALLOCATION LEGEND

- PROPOSED NEW CABINET / TR / MCR LOCATION
- PROPOSED EXPANSION TO TR
- EXISTING TR WITH POWER AND FIBER UPGRADES, SEE TELECOM AND ELECTRICAL DRAWINGS
- ABANDONED ROOM
- ROOM TO REMAIN, NO WORK
- REMODEL REQUIRED DUE TO EHRM IMPACT

KEY NOTES

- 02-31 SEE TELECOM PLANS FOR PATH LOCATION. PREP CEILING FOR SURFACE MOUNT CONDUIT IN LOCATIONS W/O ACOUSTIC CEILING TILES.
- 03-01 NEW HOUSEKEEPING PAD. COORDINATE WITH MECHANICAL DRAWINGS FOR SIZE AND CIVIL DRAWINGS FOR DETAILS.
- 09-13 FOLLOW EXISTING CABLE ROUTING FOR REMOVAL OF EXISTING CABLE AND INSTALLATION OF NEW CABLES AT LOCATIONS AS NOTED IN TELECOM DRAWINGS.
- 26-13

LIFE SAFETY LEGEND

- 1-HOUR FIRE WALL
- 2-HOUR FIRE WALL
- 1-HOUR FIRE/SMOKE WALL
- SMOKE RESISTIVE HAZARDOUS AREA



FLOOR PLAN LEGEND

- CARD READER, REF TELECOM DRAWINGS
- DATA PORT, REF TELECOM DRAWINGS
- OUTLET, REF ELEC DRAWINGS
- WIRELESS ACCESS POINT, REF TELECOM DRAWINGS
- ELEC PANEL, REF ELEC DRAWINGS
- STRIP LIGHT FIXTURE, REF ELEC DRAWINGS

FLOOR PLAN NOTES

1. SEE G SERIES SHEETS FOR BALANCE OF PLAN GENERAL NOTES.
2. REFER TO STRUCTURAL, MECHANICAL, AND ELECTRICAL DRAWINGS FOR ADDITIONAL INFORMATION. ALL INFORMATION REGARDING EXISTING CONDITIONS IS BASED UPON OWNER-SUPPLIED DOCUMENTS AND MAY NOT PRECISELY REFLECT FIELD CONDITIONS.
3. PROVIDE ALL BACKING FOR MILLWORK, GRAB BARS, AND ANY AND ALL WALL MOUNTED EQUIPMENT OR ACCESSORIES; COORDINATE LOCATIONS.
4. ALL DIMENSIONS ARE FROM STRUCTURAL OR UNFINISHED FACE OF STUD, UNLESS OTHERWISE NOTED.
5. PROVIDE A SMOOTH AND LEVEL FINISH FLOOR, TYP. PATCH AND REPAIR ALL INCONSISTENCIES IN FLOOR ELEVATIONS.
6. PATCH AND REPAIR ANY / ALL WALL SURFACES AS REQUIRED TO PROVIDE SUITABLE SUBSTRATE FOR FINISHES.
7. REFER TO DOOR AND FRAME SCHEDULE FOR DOORS REQUIRING ADA ACCESS CONTROL.
8. PROVIDE ACOUSTICAL SEALANT AROUND WALL EDGES, TOP AND BOTTOM, AND PENETRATIONS, AND INSTALL PUTTY PADS AROUND ELECTRICAL BOXES WHERE PARTITION CONTAINS ACOUSTICAL INSULATION.
9. ALL TELECOMMUNICATION ROOMS ARE TO HAVE EXPOSED STRUCTURE UNLESS NOTED OTHERWISE, NO CEILING SPECIFIED.

PROJECT KEY PLAN

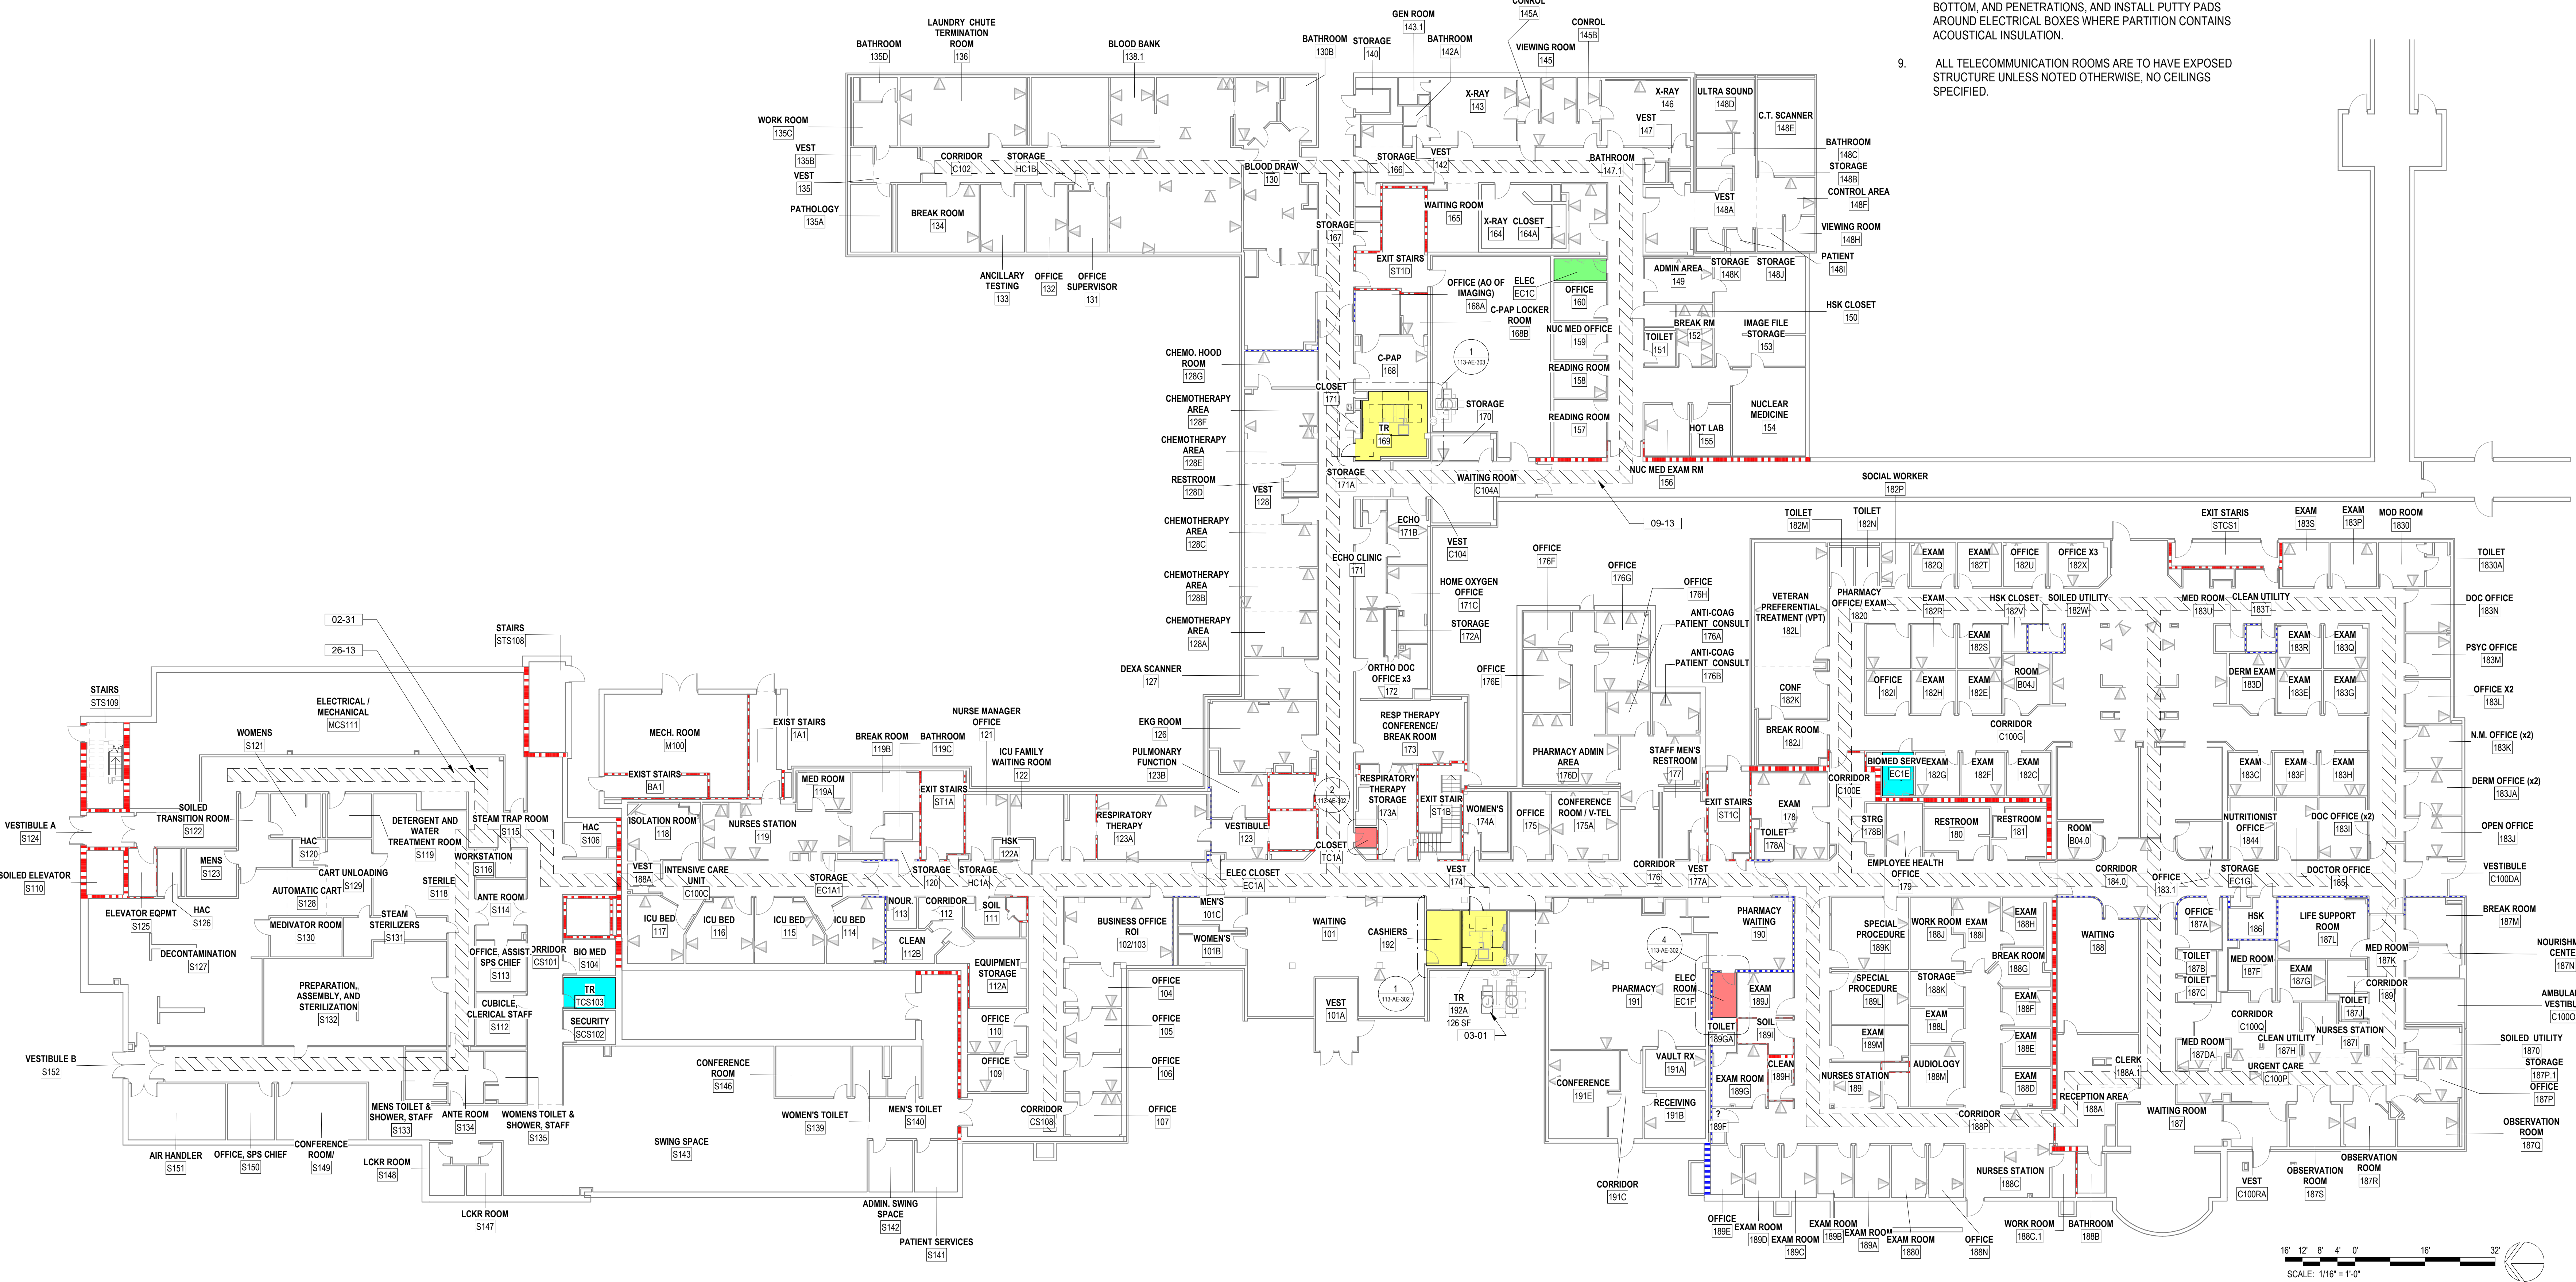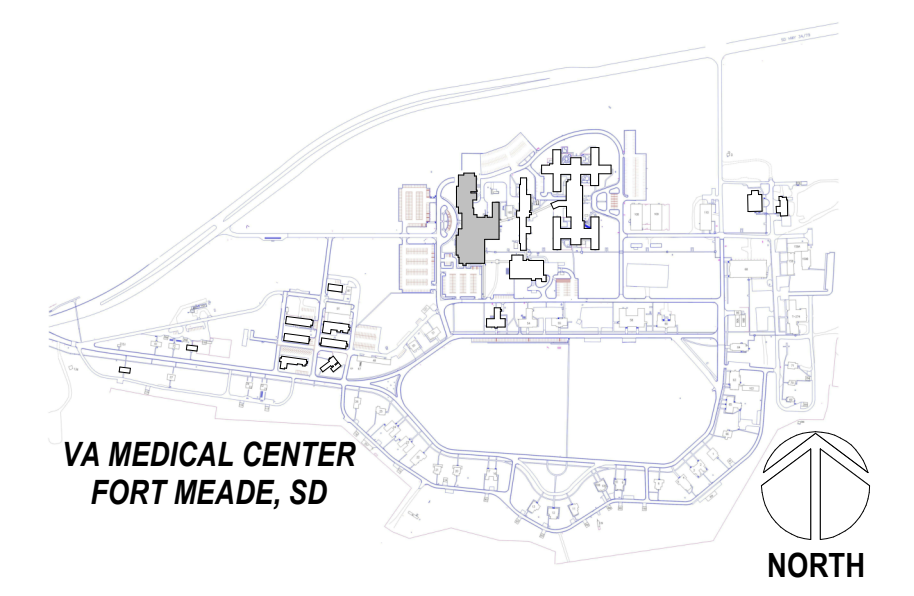

1 FIRST FLOOR PLAN
1/16" = 1'-0"



<p>CONSULTANT</p> <p>A/E: GDM 1000 W STEUBEN ST. UNIT 3 BINGEN, WA 98605 541.436.4723 ADAM GODDIN, PE</p>	<p>ARCHITECT/ENGINEER OF RECORD</p> <p>ARCHITECT A&E DESIGN 124 NORTH 29TH STREET, #100 BILLINGS, MONTANA 59101 406.248.2633 T. MARCELLO PIERROTTET, AIA</p>	<p>STAMP</p>	<p>PROGRAM CONTRACTING ACTIVITY CENTRAL (PCAC)</p> <p>VA U.S. Department of Veterans Affairs</p>	<p>DRAWING TITLE 113-LEVEL 1 FLOOR PLAN</p> <p>APPROVED: Project Director</p>	<p>PHASE 100% CONSTRUCTION DOCUMENTS</p> <p>FLS FULLY SPRINKLERED</p>	<p>PROJECT TITLE EHRM INFRASTRUCTURE UPGRADES</p> <p>LOCATION FORT MEADE, SOUTH DAKOTA</p> <p>ISSUE DATE 04/15/2022</p> <p>CHECKED BY TMP</p> <p>DRAWN BY JPR</p>	<p>PROJECT NUMBER 568-21-701</p> <p>BUILDING NUMBER BLDG 113</p> <p>DRAWING NUMBER 113-AE-201</p>
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 VA FORM 08-6231

LIFE SAFETY LEGEND

- 1-HOUR FIRE WALL
- 2-HOUR FIRE WALL
- 1-HOUR FIRE/SMOKE WALL
- SMOKE RESISTIVE HAZARDOUS AREA

FLOOR PLAN LEGEND

- CARD READER, REF TELECOM DRAWINGS
- DATA PORT, REF TELECOM DRAWINGS
- OUTLET, REF ELEC DRAWINGS
- WIRELESS ACCESS POINT, REF TELECOM DRAWINGS
- ELEC PANEL, REF ELEC DRAWINGS
- STRIP LIGHT FIXTURE, REF ELEC DRAWINGS

FLOOR PLAN NOTES



- SEE G SERIES SHEETS FOR BALANCE OF PLAN GENERAL NOTES.
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- PROVIDE ALL BACKING FOR MILLWORK, GRAB BARS, AND ANY AND ALL WALL MOUNTED EQUIPMENT OR ACCESSORIES; COORDINATE LOCATIONS.
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- ALL TELECOMMUNICATION ROOMS ARE TO HAVE EXPOSED STRUCTURE UNLESS NOTED OTHERWISE, NO CEILINGS SPECIFIED.

02-31 SEE TELECOM PLANS FOR PATH LOCATION; PREP CEILING FOR SURFACE MOUNT CONDUIT IN LOCATIONS W/O ACOUSTIC CEILING TILES.
 09-13 FOLLOW EXISTING CABLE ROUTING FOR REMOVAL OF EXISTING CABLE AND INSTALLATION OF NEW CABLES AT LOCATIONS AS NOTED IN TELECOM DRAWINGS.
 26-13


ROOM ALLOCATION LEGEND

- PROPOSED NEW CABINET / TR / MCR LOCATION
- PROPOSED EXPANSION TO TR
- EXISTING TR WITH POWER AND FIBER UPGRADES. SEE TELECOM AND ELECTRICAL DRAWINGS
- ABANDONED ROOM
- ROOM TO REMAIN, NO WORK
- REMODEL REQUIRED DUE TO EHRM IMPACT

PROJECT KEY PLAN

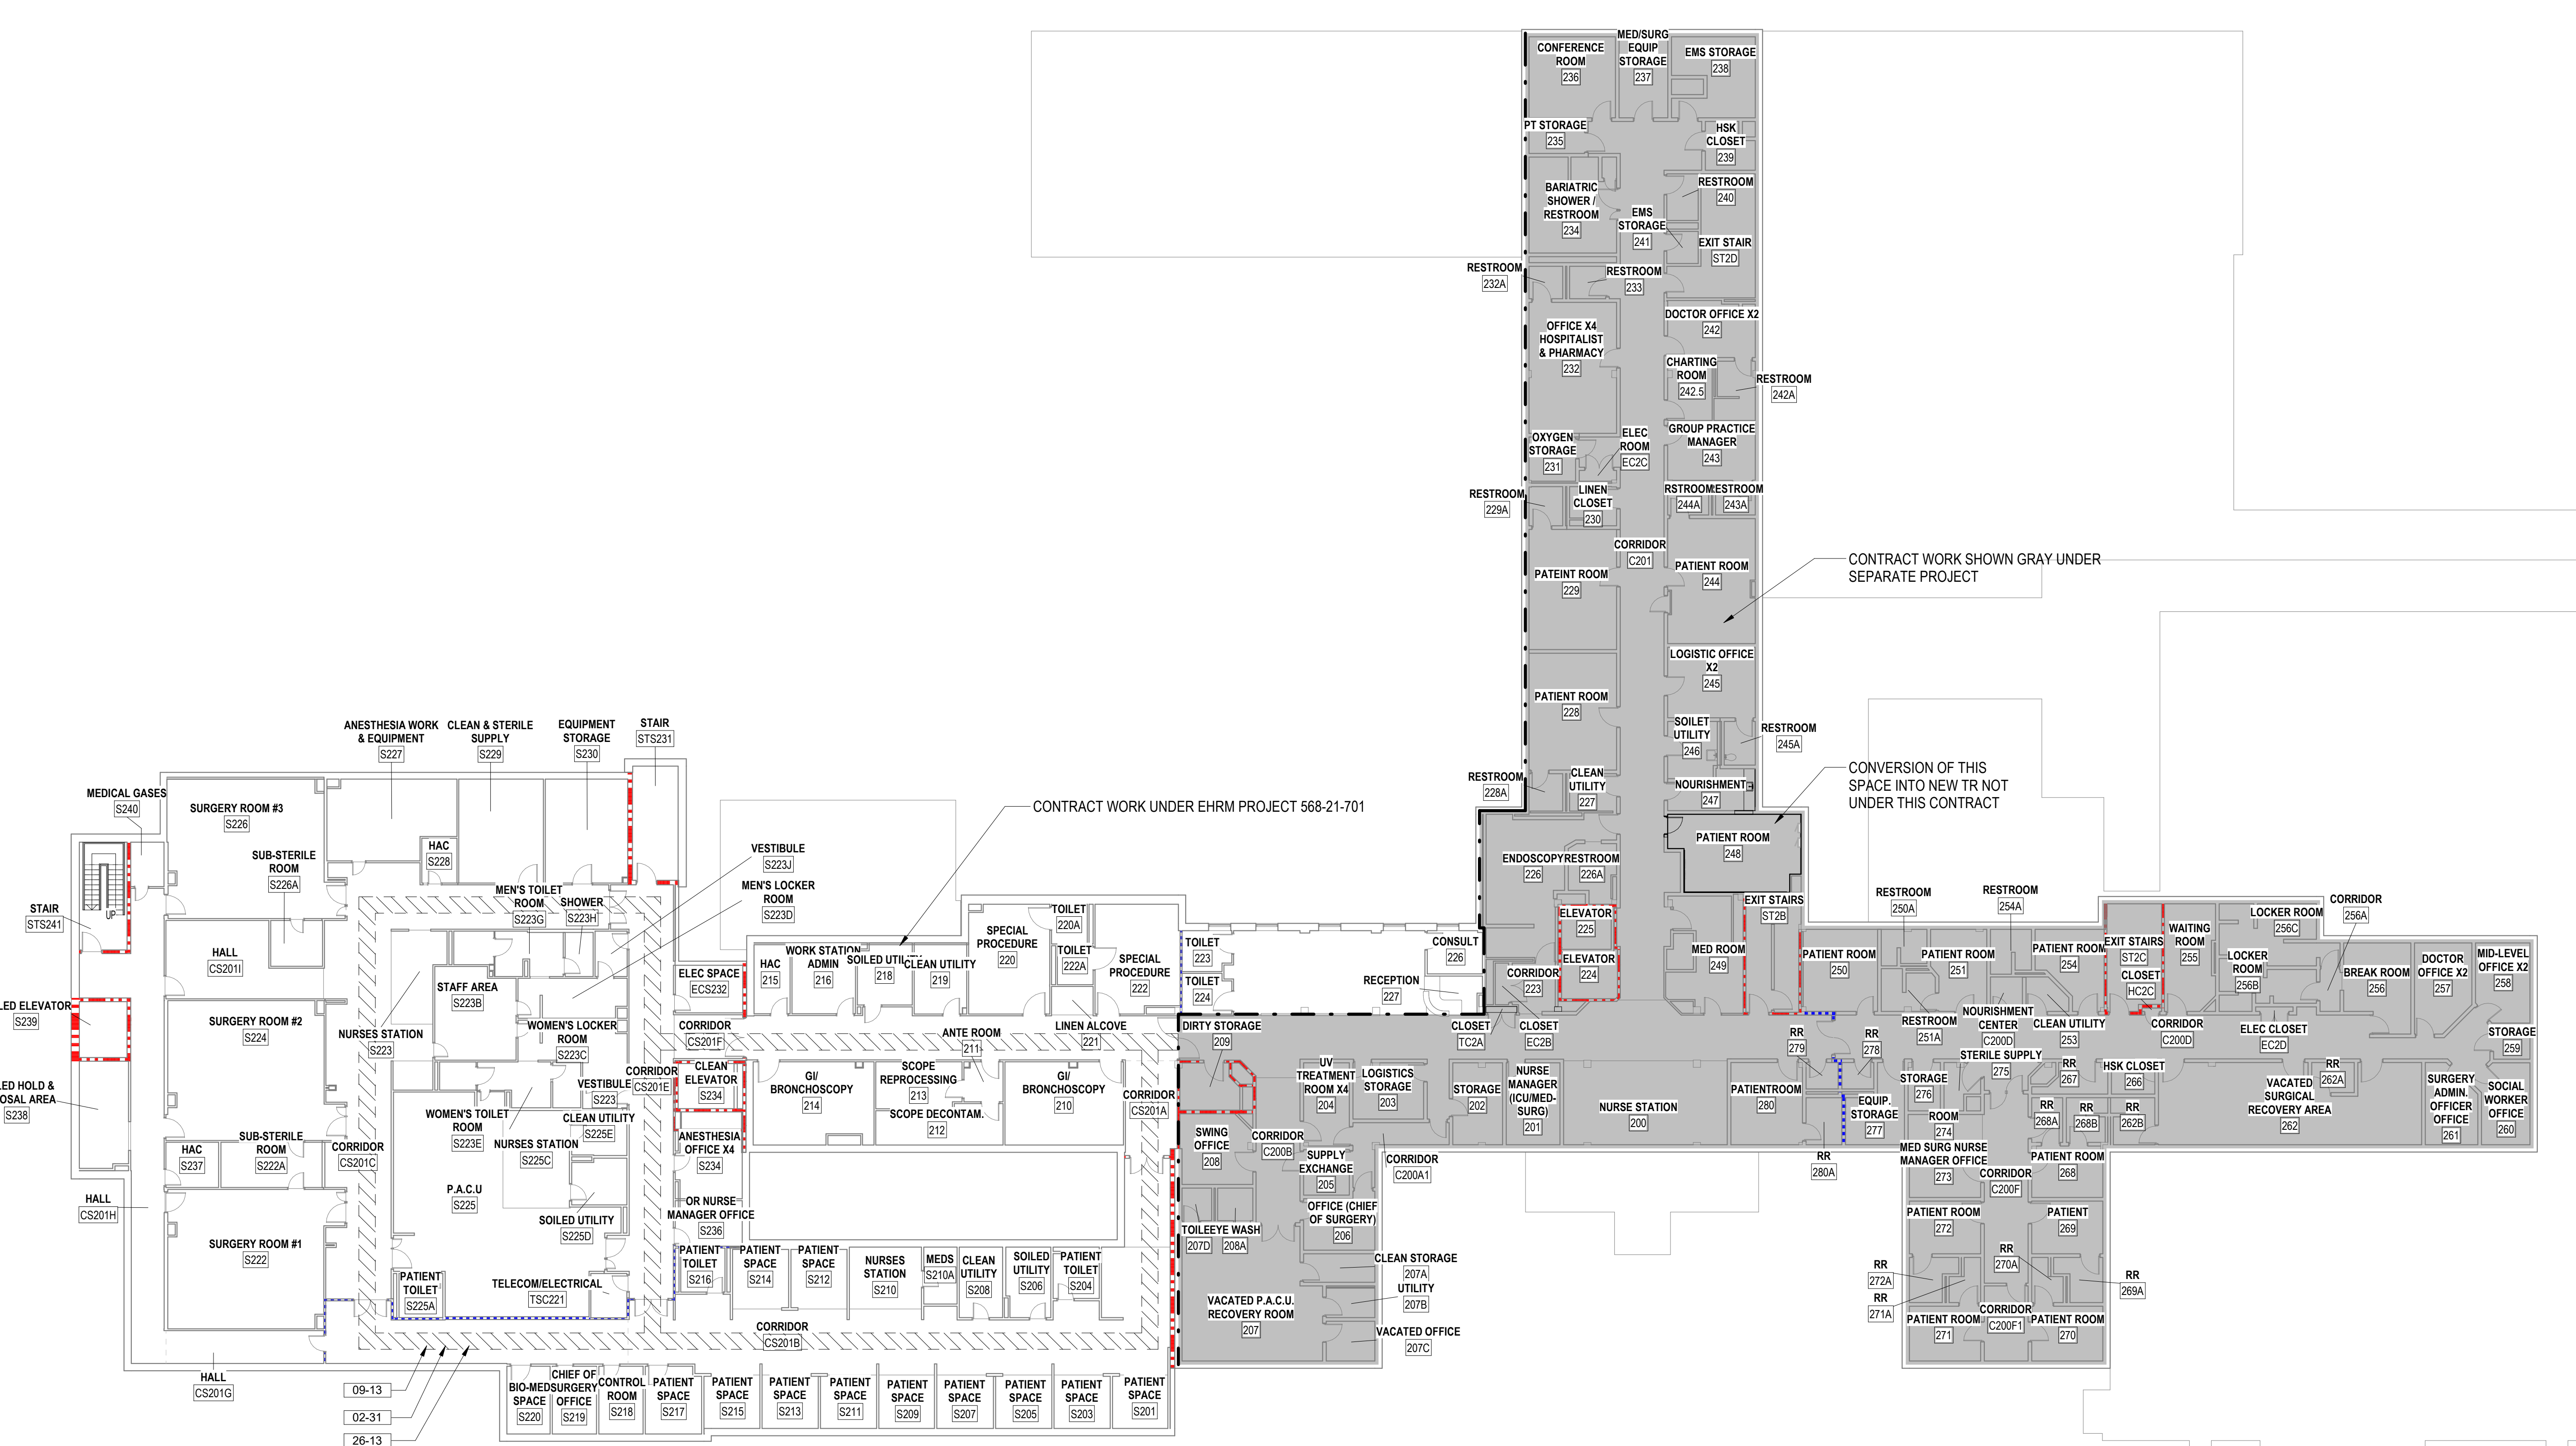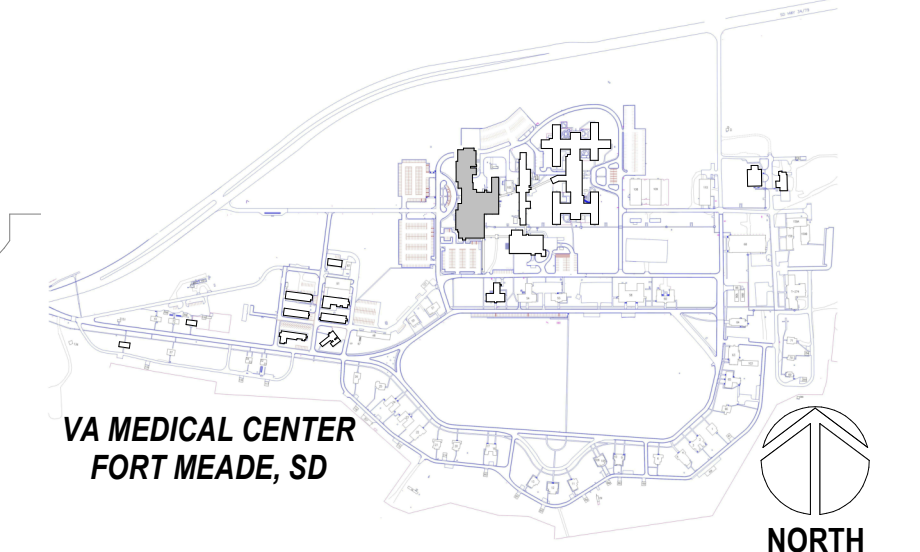

1 SECOND FLOOR PLAN 1/16" = 1'-0"

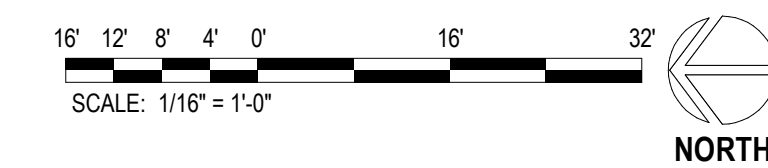

Revisions:	Date:

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STAMP

PROGRAM CONTRACTING ACTIVITY CENTRAL (PCAC)
 VA U.S. Department of Veterans Affairs


DRAWING TITLE
 113-LEVEL 2 FLOOR PLAN

APPROVED: Project Director


PHASE
 100% CONSTRUCTION DOCUMENTS

FLS
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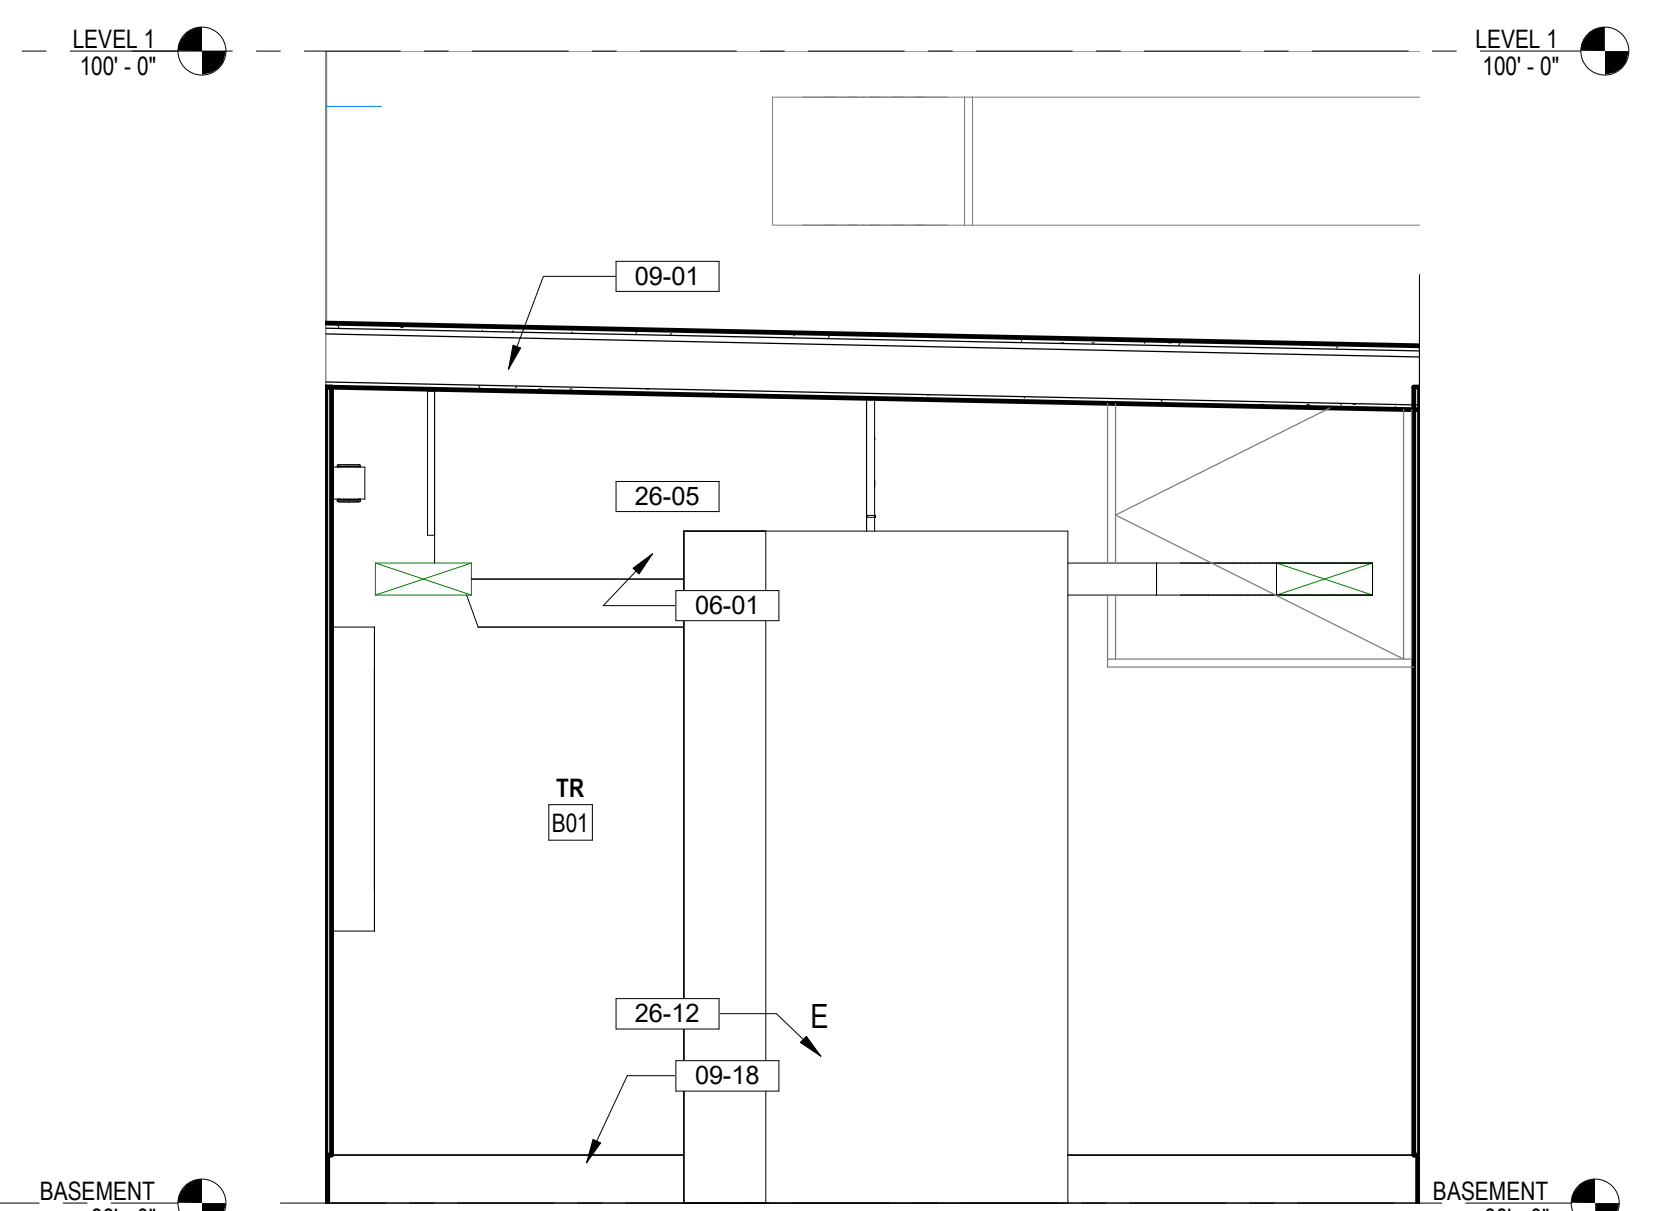
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LOCATION FORT MEADE, SOUTH DAKOTA	BUILDING NUMBER BLDG 113
ISSUE DATE 04/15/2022	DRAWING NUMBER 113-AE-202
CHECKED BY TMP	DRAWN BY JPR

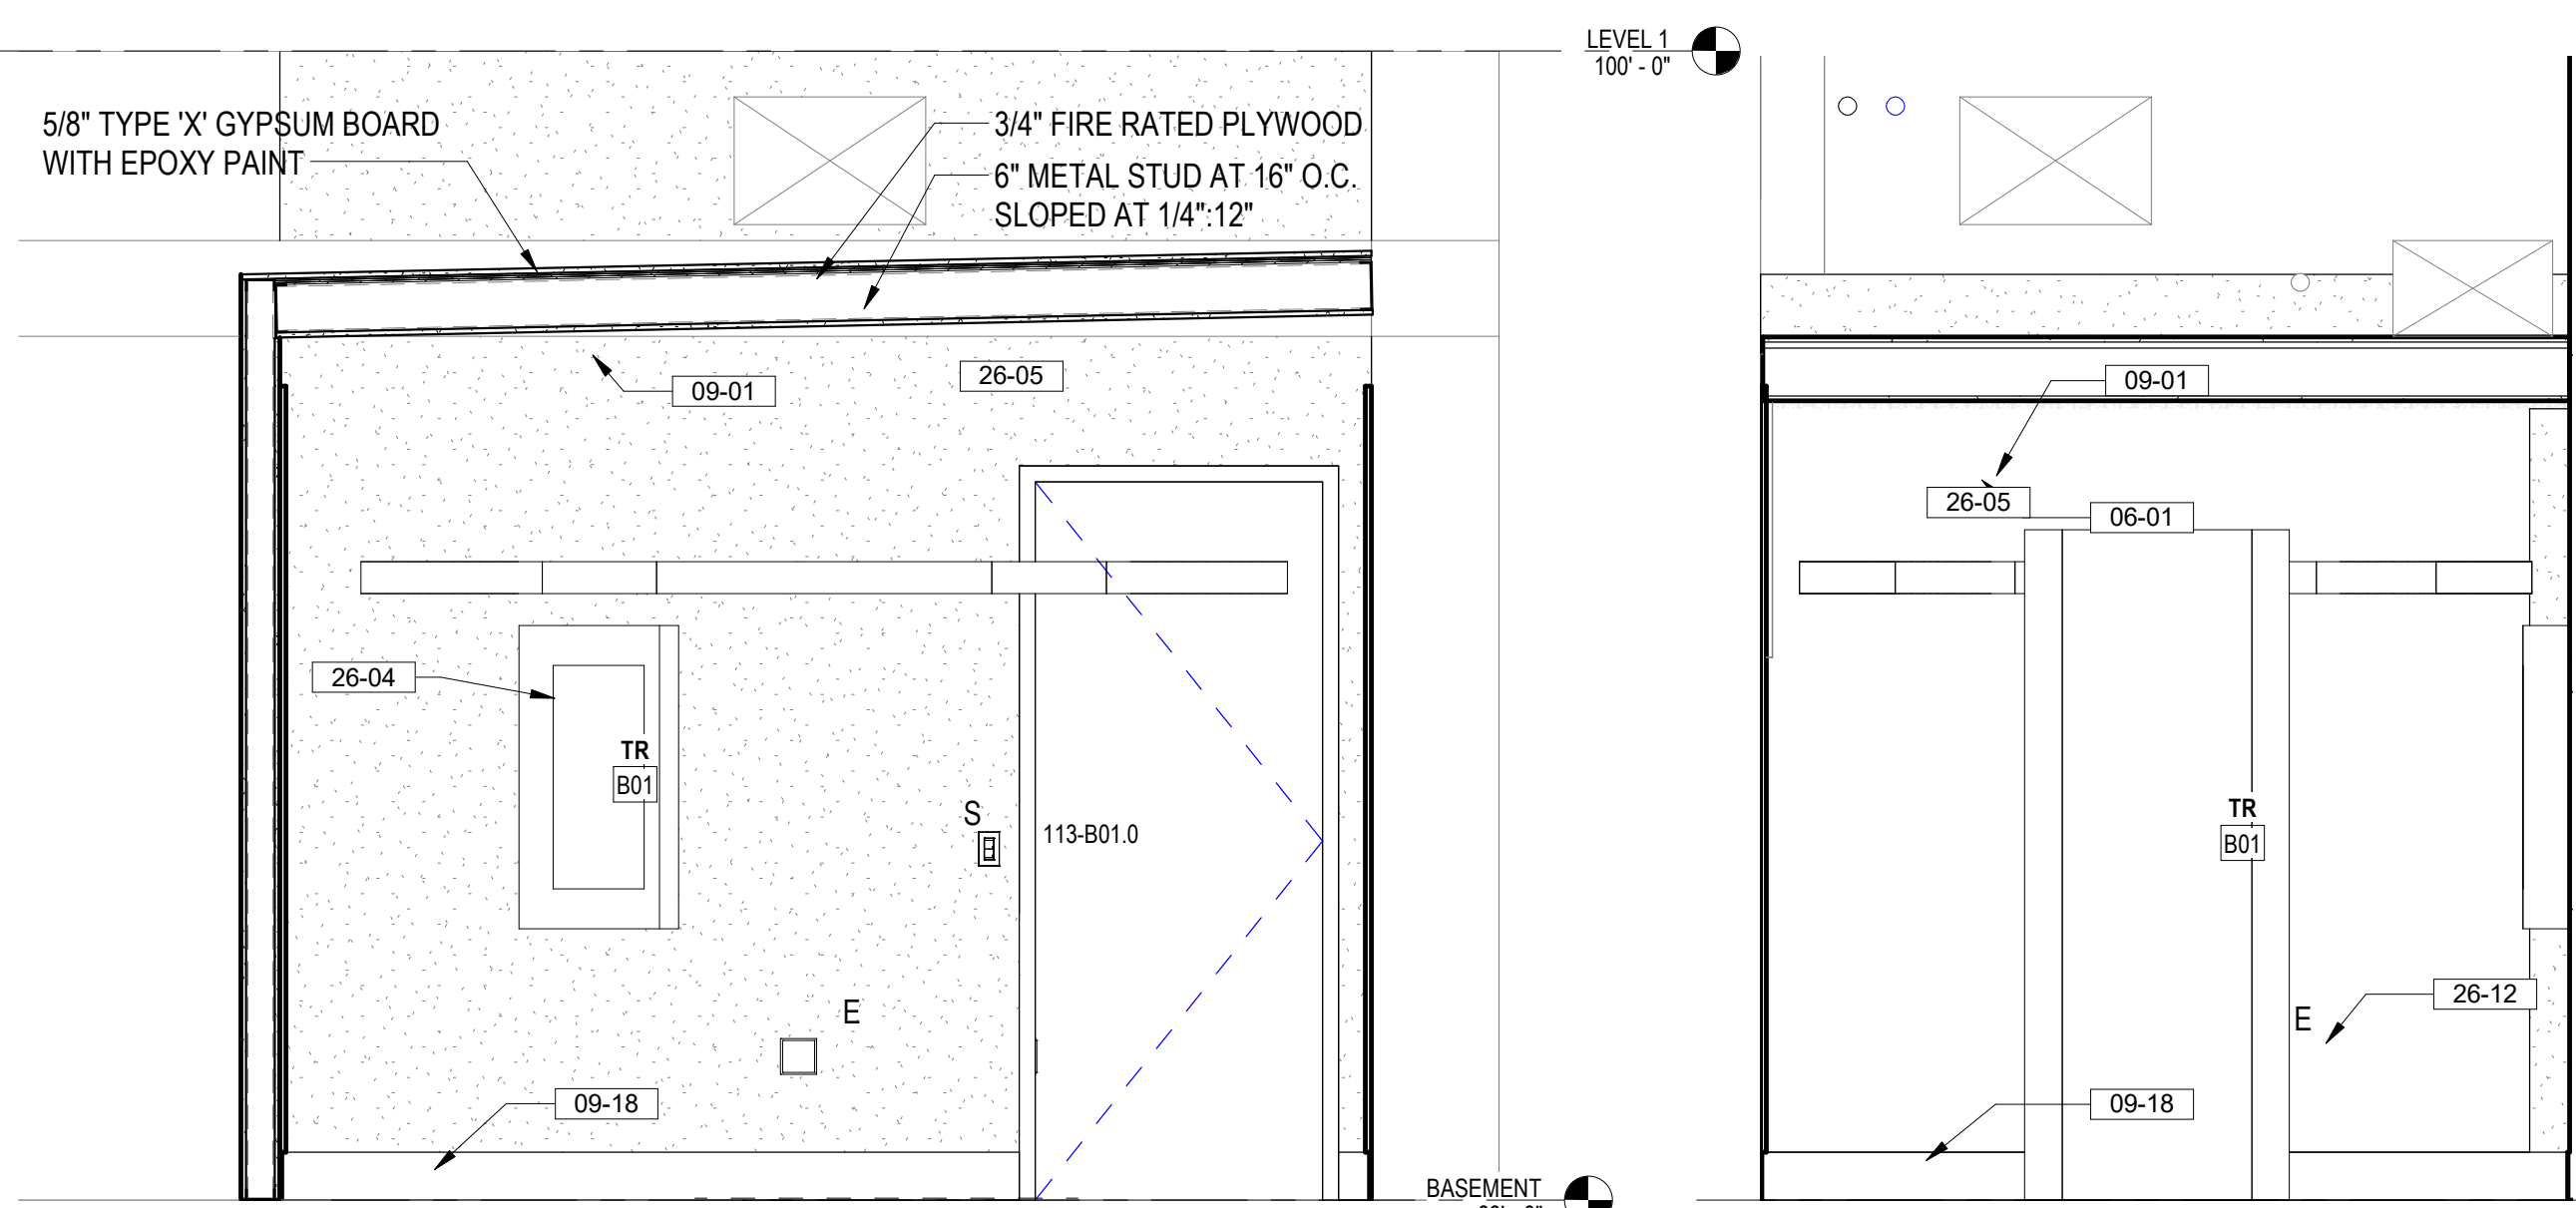

16 TR B01 EAST ELEVATION
1/2" = 1'-0"

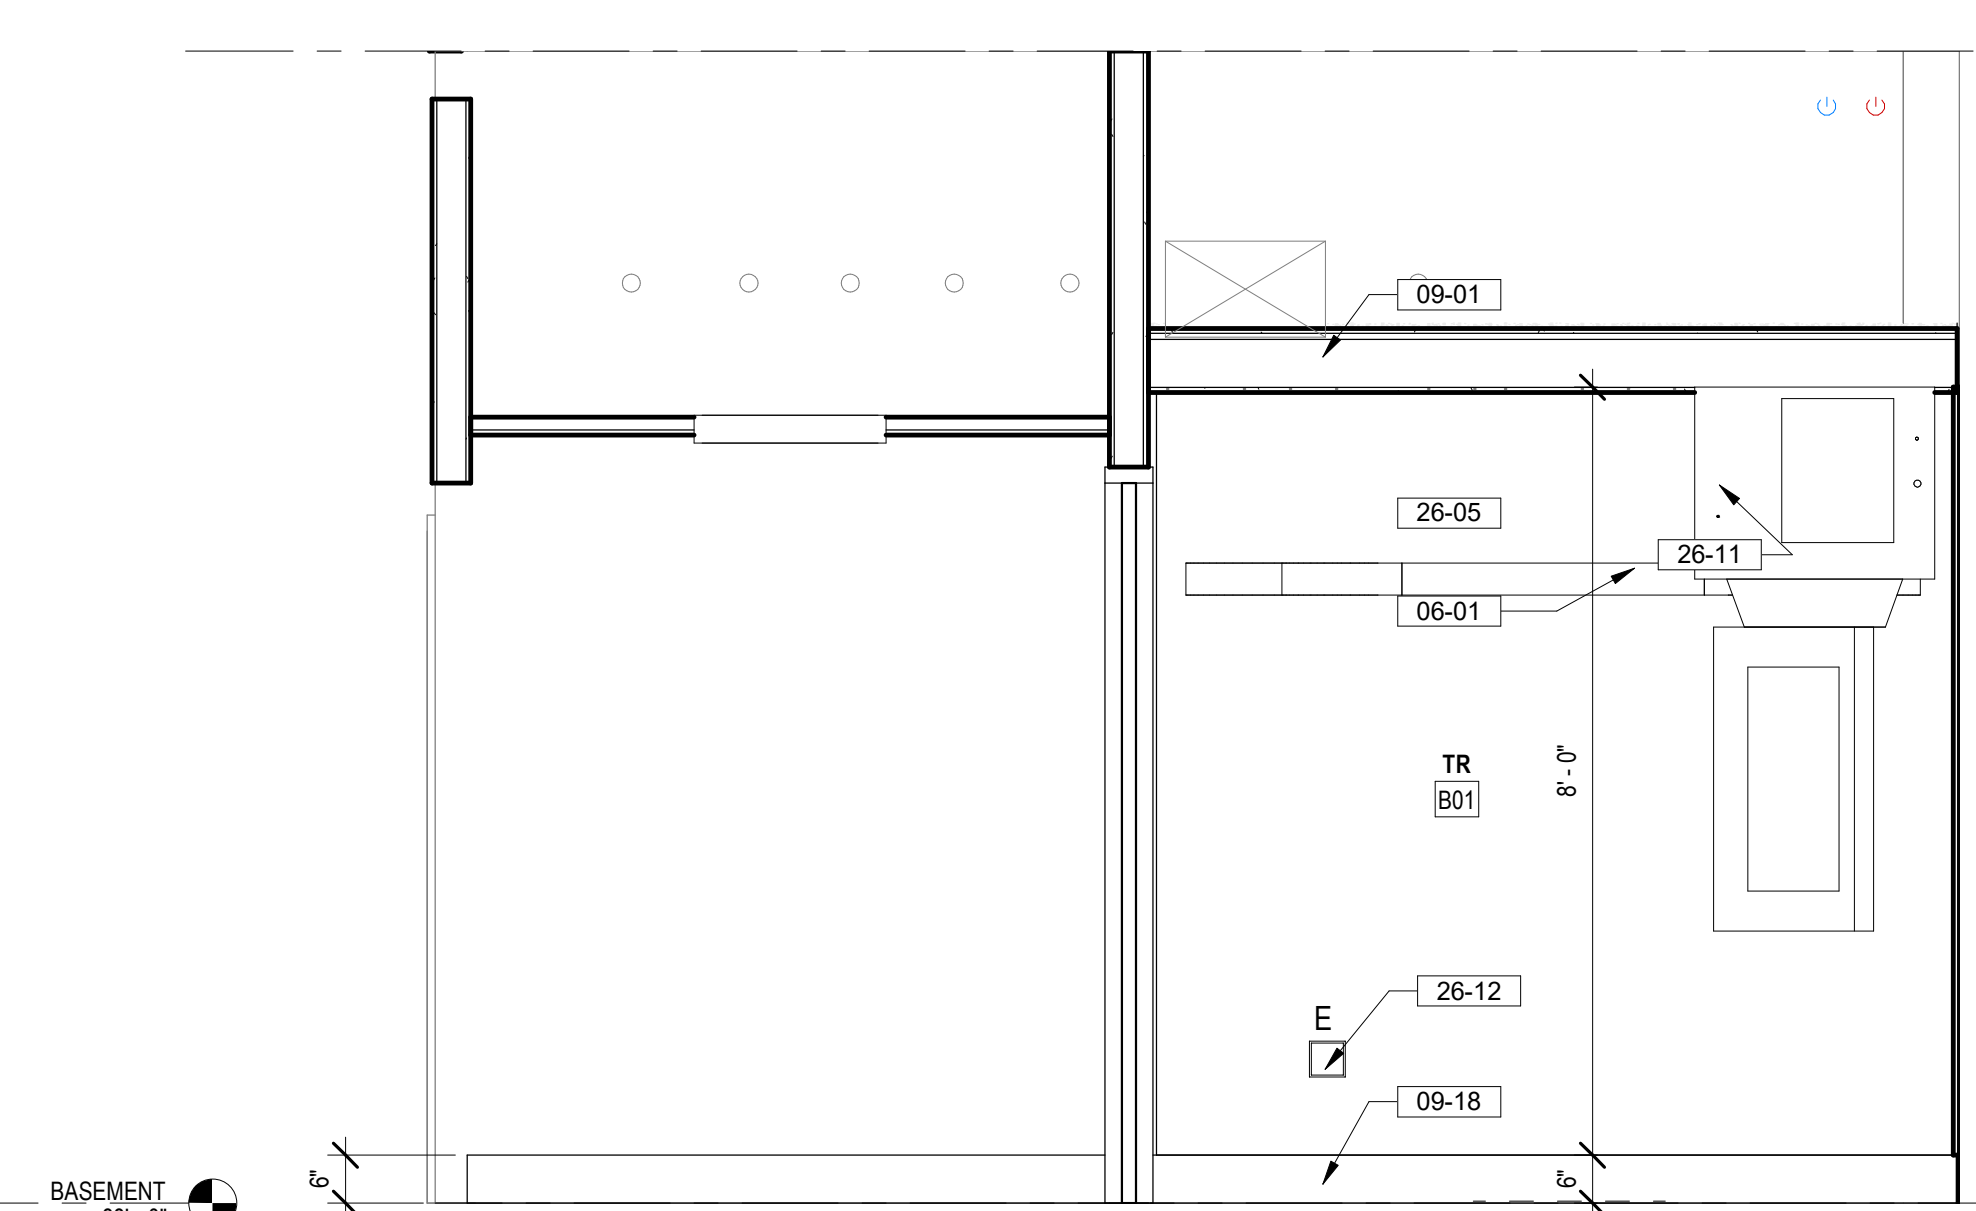

17 TR B01 NORTH ELEVATION
1/2" = 1'-0"




18 TR B01 SOUTH ELEVATION
1/2" = 1'-0"

FLOOR PLAN NOTES


- SEE G SERIES SHEETS FOR BALANCE OF PLAN GENERAL NOTES.
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- PATCH AND REPAIR ANY / ALL WALL SURFACES AS REQUIRED TO PROVIDE SUITABLE SUBSTRATE FOR FINISHES.
- REFER TO DOOR AND FRAME SCHEDULE FOR DOORS REQUIRING ADA ACCESS CONTROL.
- PROVIDE ACOUSTICAL SEALANT AROUND WALL EDGES, TOP AND BOTTOM, AND PENETRATIONS, AND INSTALL PUTTY PADS AROUND ELECTRICAL BOXES WHERE PARTITION CONTAINS ACOUSTICAL INSULATION.
- ALL TELECOMMUNICATION ROOMS ARE TO HAVE EXPOSED STRUCTURE UNLESS NOTED OTHERWISE, NO CEILINGS SPECIFIED.

KEY NOTES

- 02-08 CAREFULLY REMOVE CEILING TILES AND OTHER CEILING MOUNTED DEVICES; CAREFULLY STORE IN NON-TRAFFICKED AREA AND PREPARE FOR REINSTALLATION AT COMPLETION OF WORK.
- 06-01 INSTALL 3/4" AC GRADE OR BETTER FIRE RETARDANT PLYWOOD; PAINT WITH TWO COATS OF SEMI-GLOSS BRIGHT WHITE FIRE RETARDANT PAINT; MOUNT BOTTOM OF PLYWOOD 6" A.F.F., TOP OF PLYWOOD AT 8'-6" A.F.F.; DO NOT PAINT OVER STAMPED PLYWOOD RATING.
- 06-02 ALIGN PLYWOOD AT EDGE OF STEEL CHANNEL. SEE STRUCTURAL DRAWINGS FOR CHANNEL DETAILS.
- 06-03 ADA DOOR CLEARANCES SHOWN DASHED.
- 09-01 PAINT WALL ABOVE PLYWOOD WITH SEMI-GLOSS PAINT, COLOR TO MATCH PLYWOOD PAINT.
- 09-06 SEAL ALL WALL PENETRATIONS EXISTING AND NEW. PROVIDE APPROPRIATE FIRE RATED UL HILT DESIGNATION FOR PIPE AND/OR CONDUIT PENETRATIONS. SEE TYPICAL PENETRATION DETAILS FOR RATED WALL CONDITIONS.
- 09-07 INSTALL STATIC DISSIPATIVE RESILIENT FLOORING.
- 09-09 APPLY JOINT COMPOUND AND FEATHER A MINIMUM OF 3" HORIZONTALLY AS REQUIRED TO ACHIEVE A SMOOTH AND UNIFORM APPEARANCE.
- 09-10 PAINT FULL LENGTH OF WALL TO NEAREST EXTERIOR OR INTERIOR CORNER, COLOR TO MATCH EXISTING WALLS.
- 09-18 6" HIGH COVERED RUBBER WALL BASE, COLOR TO BE SELECTED FROM MANUFACTURER'S STANDARD SELECTION.
- 09-19 EXTEND GYPSUM BOARD WALL TO UNDERSIDE OF STRUCTURE WITH 5/8" GYPSUM BOARD LAYER ON EACH SIDE OF WALL SEAL.
- 22-01 FIRE SUPPRESSION SPRINKLER HEAD SHOWN FOR REFERENCE ONLY, FIRE SUPPRESSION CONTRACTOR TO VERIFY ACTUAL QUANTITIES REQUIRED, INSTALL SYMMETRICALLY CENTER IN TILE.
- 23-05 MECHANICAL UNITS. SEE MECH DRAWINGS FOR SIZE AND SPECS.
- 23-08 NEW REFRIGERANT PIPE LINES ROUTING SHOWN FOR REFERENCE ONLY. SEE MECHANICAL DRAWINGS FOR ACTUAL ROUTING; CONTRACTOR TO REMOVE CEILING TILES ALONG ROUTE OUTSIDE OF TRS AND REPLACE WITHIN WORKING SHIFT. CONDUCT LEAK TEST PREVENTION MEASURES AS SPECIFIED.
- 26-03 TELECOMM RACK, SEE TELECOMMUNICATION DRAWINGS.
- 26-04 ELECTRICAL PANELS, SEE ELECTRICAL DRAWINGS.
- 26-11 STROBE LIGHT, SEE ELECTRICAL DRAWINGS.
- 26-12 ELECTRICAL OUTLETS MOUNTED ON PLYWOOD.

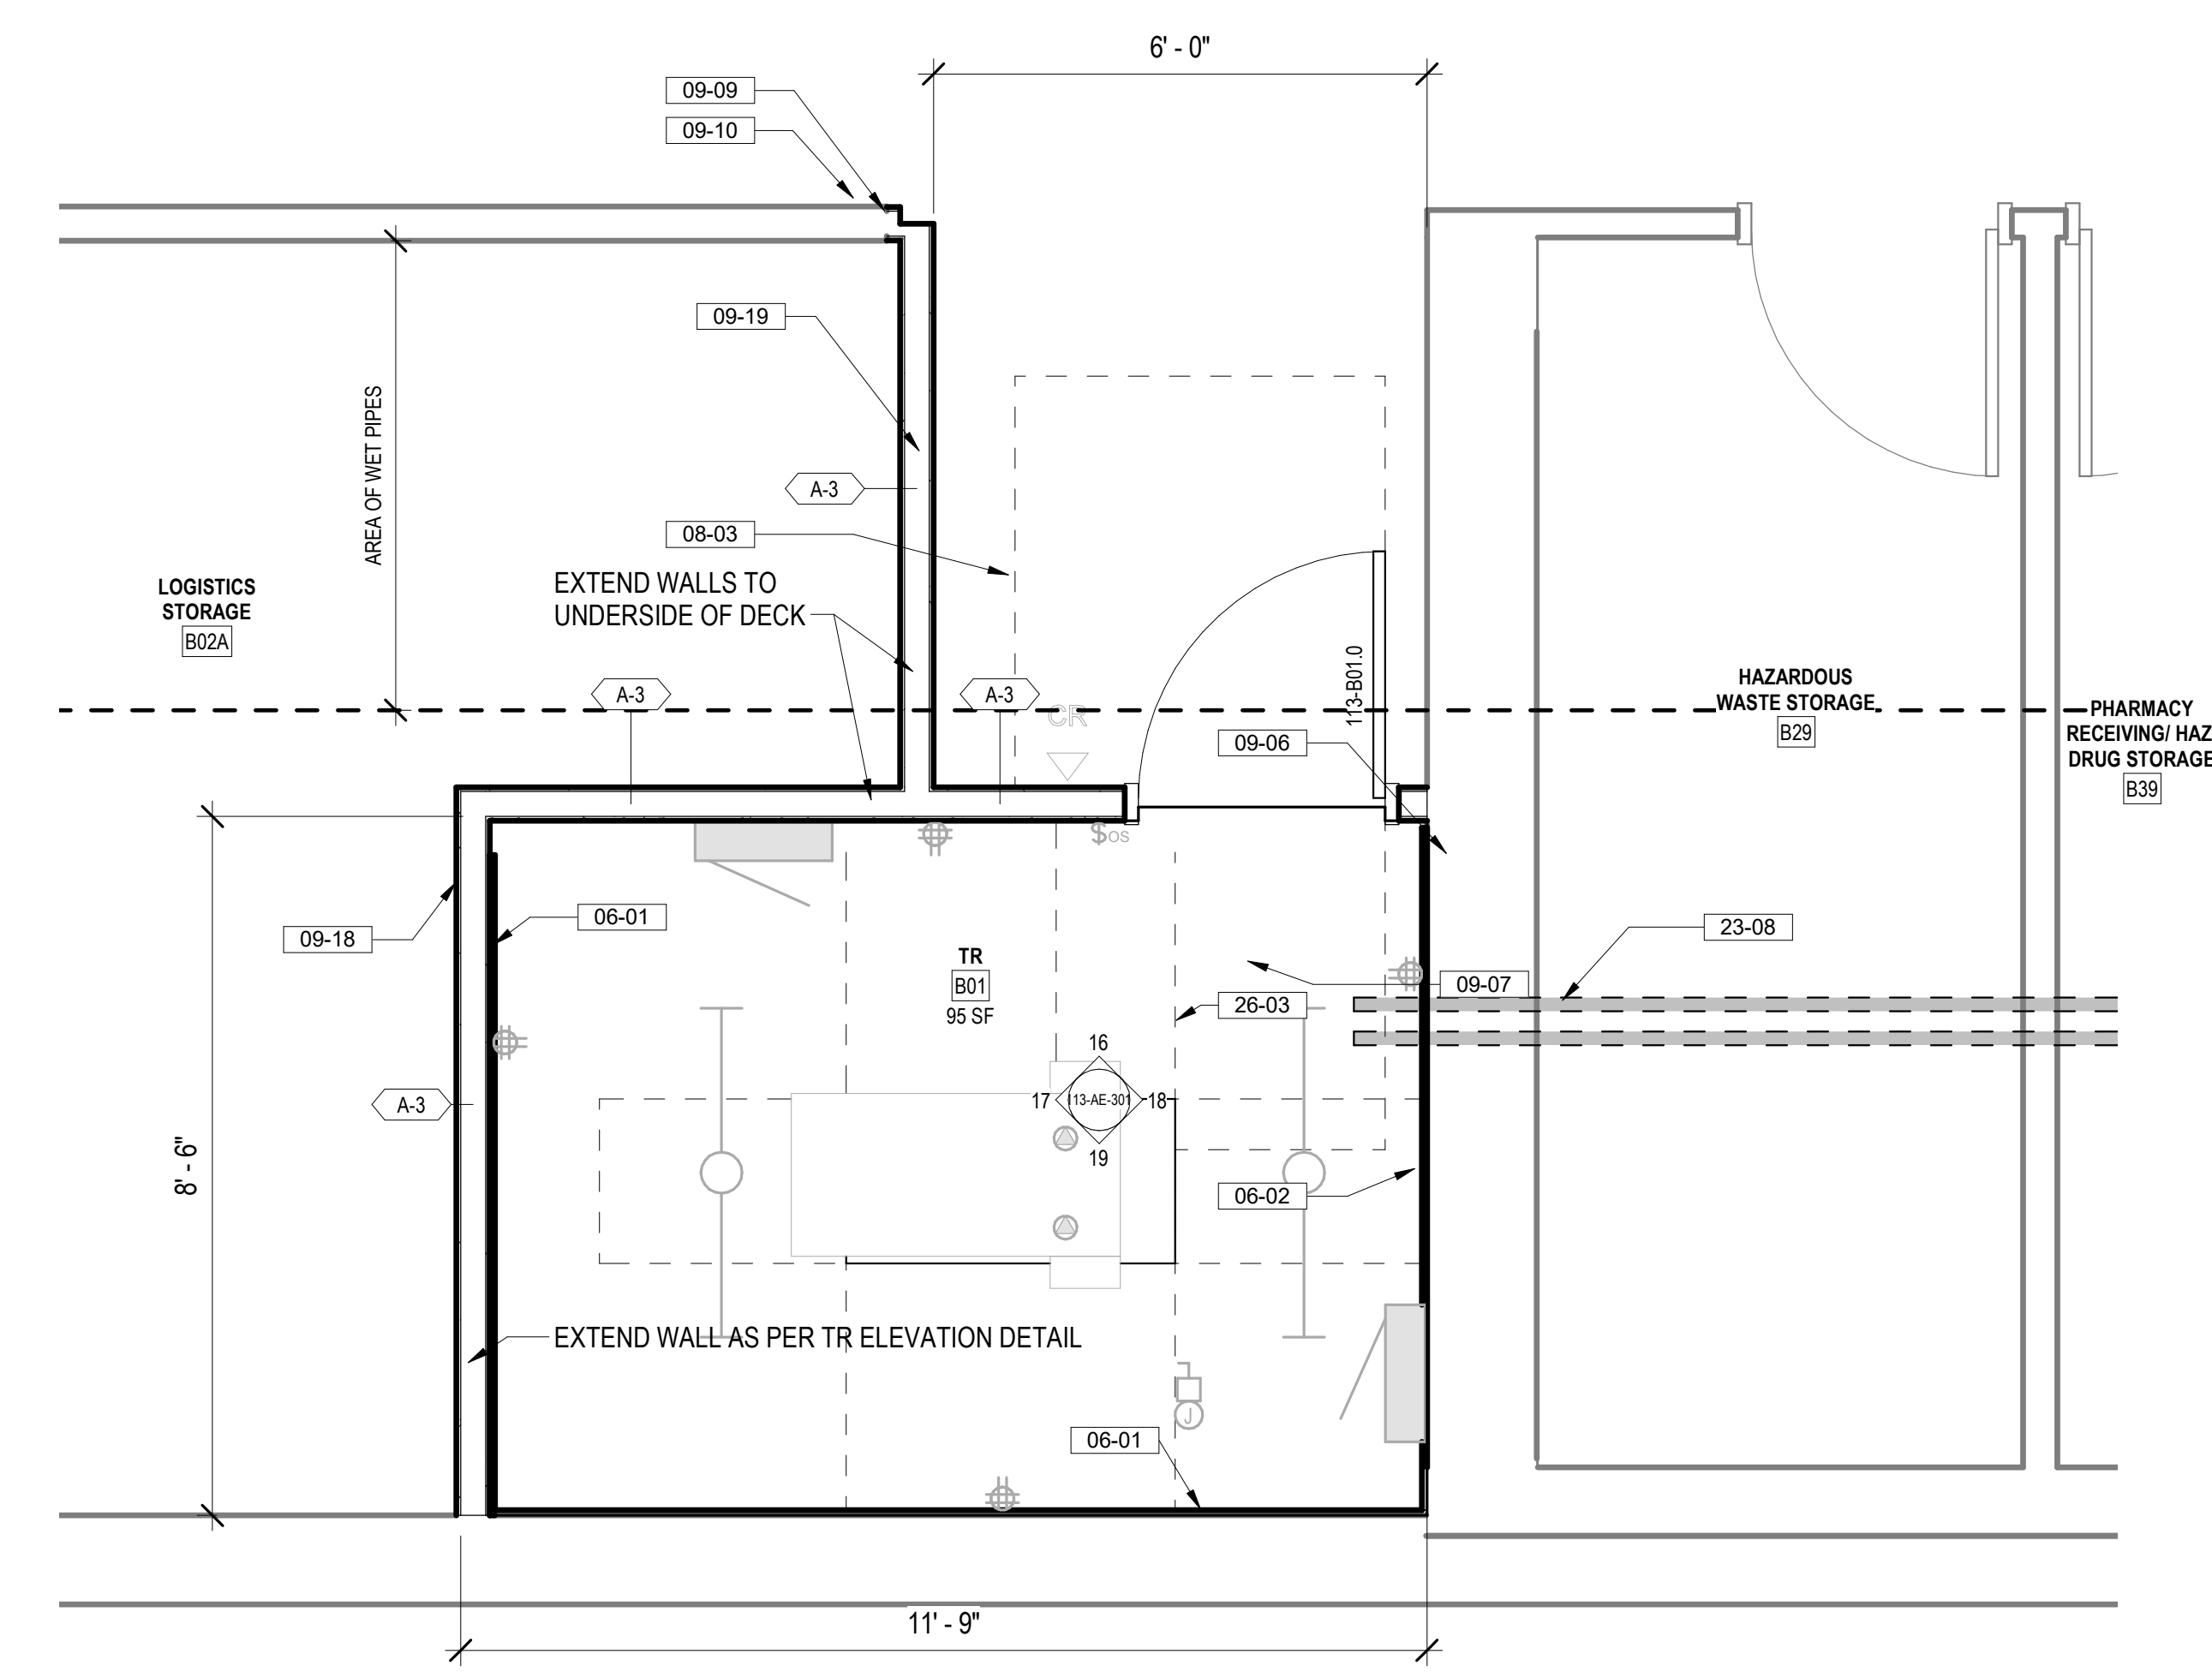

1 113 - B02A ENLARGED PLAN
1/2" = 1'-0"

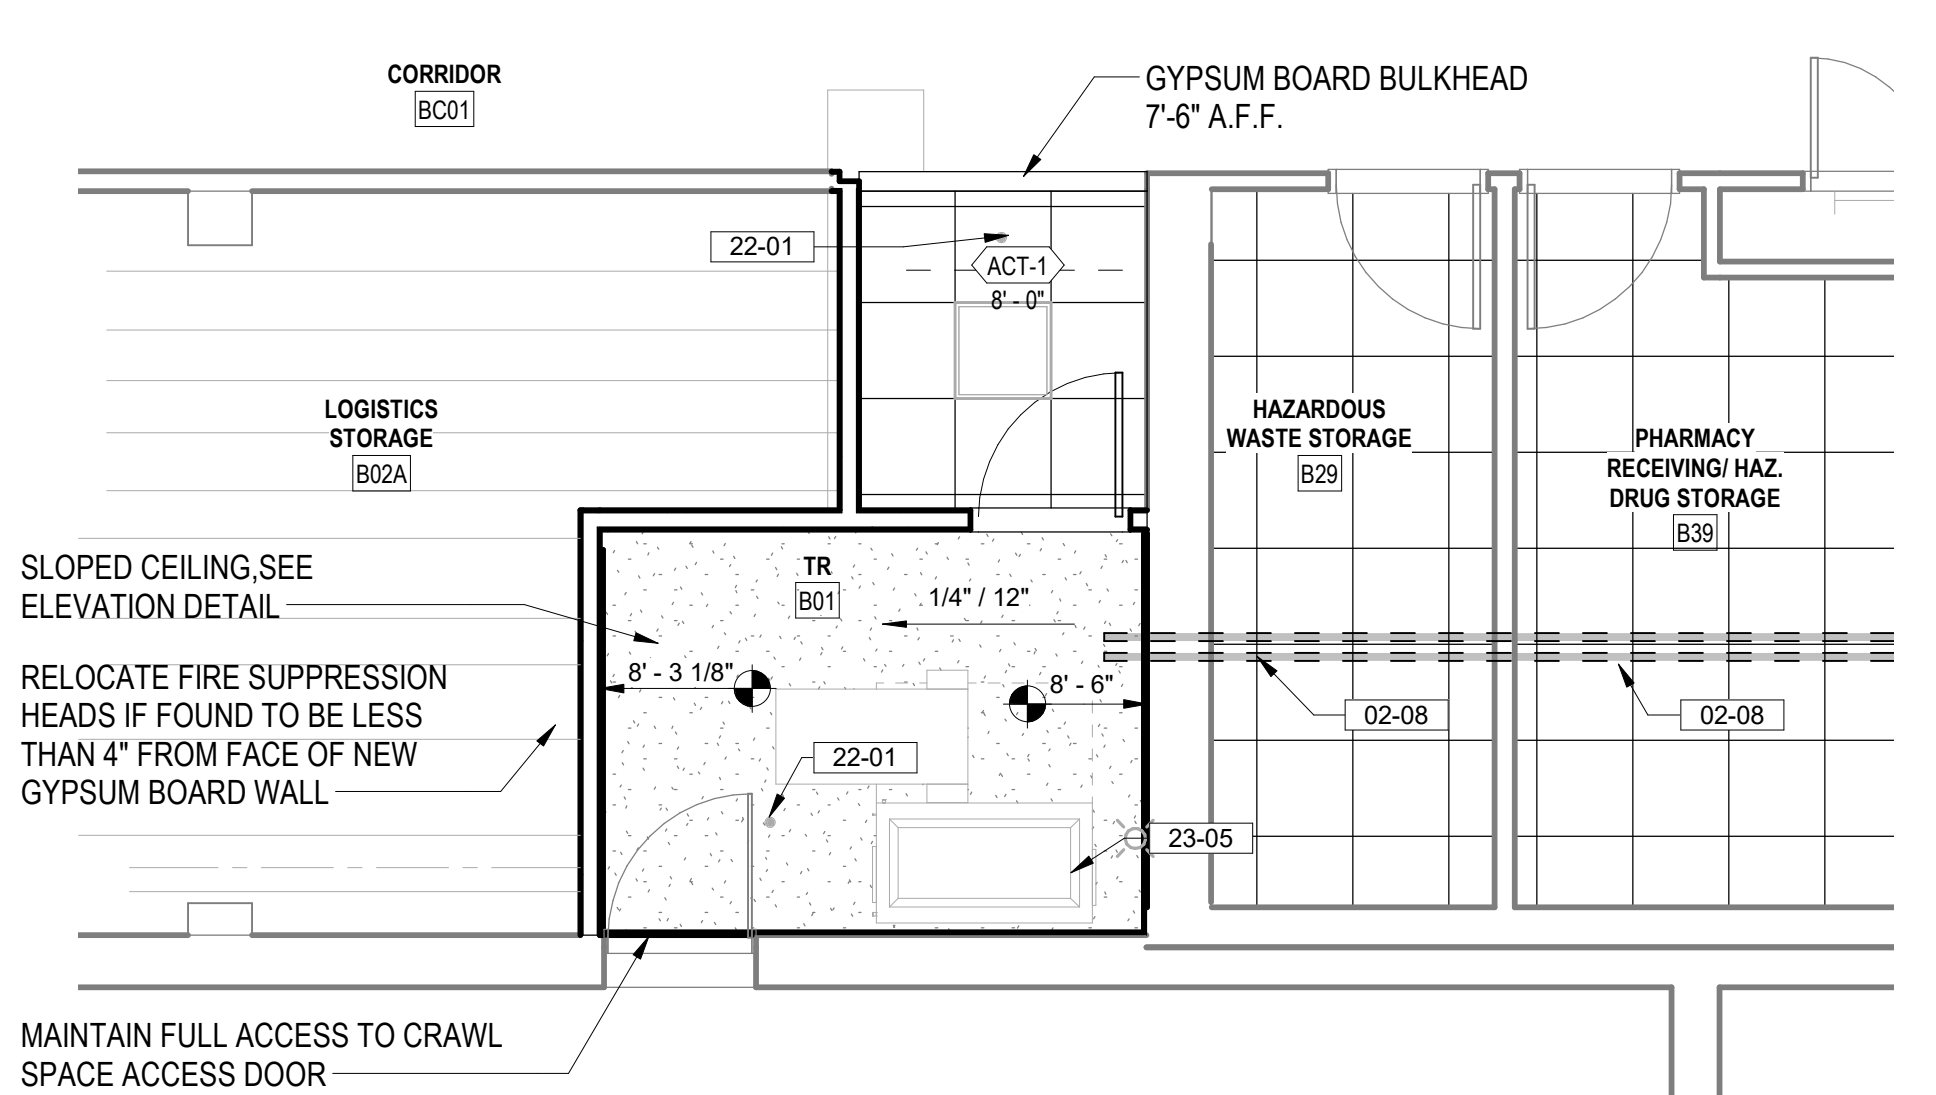

4 113 - B01 ENLARGED REFLECTED CEILING PLAN
1/4" = 1'-0"

REFLECTED CEILING PLAN NOTES

- REFER TO ELECTRICAL SHEETS FOR FIXTURE TYPES, SWITCHING, AND SPECIAL SYSTEMS.
- REFER TO MECHANICAL SHEETS FOR DIFFUSER AND DUCTING LAYOUTS.
- SEE SHEET 00-GI-006 FOR TYPICAL ACOUSTICAL PANEL CEILING DETAILS.


REFLECTED CEILING PLAN LEGEND

- 2x2 LIGHT FIXTURE
- 2x4 LIGHT FIXTURE
- STRIP LIGHT FIXTURE
- 6" RECESSED CAN LIGHT FIXTURE
- SUPPLY AIR DIFFUSER
- RETURN AIR VENT
- EXHAUST FAN
- 5/8" GYP. BOARD CEILING AFFIXED TO 3 5/8" MTL STUDS
- 2x2' SUSPENDED ACOUSTIC CEILING TILE CEILING
- 2x4' SUSPENDED ACOUSTIC CEILING TILE CEILING

FLOOR PLAN LEGEND

- CARD READER, REF TELECOM DRAWINGS
- DATA PORT, REF TELECOM DRAWINGS
- OUTLET, REF ELEC DRAWINGS
- WIRELESS ACCESS POINT, REF TELECOM DRAWINGS
- ELEC PANEL, REF ELEC DRAWINGS
- STRIP LIGHT FIXTURE, REF ELEC DRAWINGS

PROJECT KEY PLAN

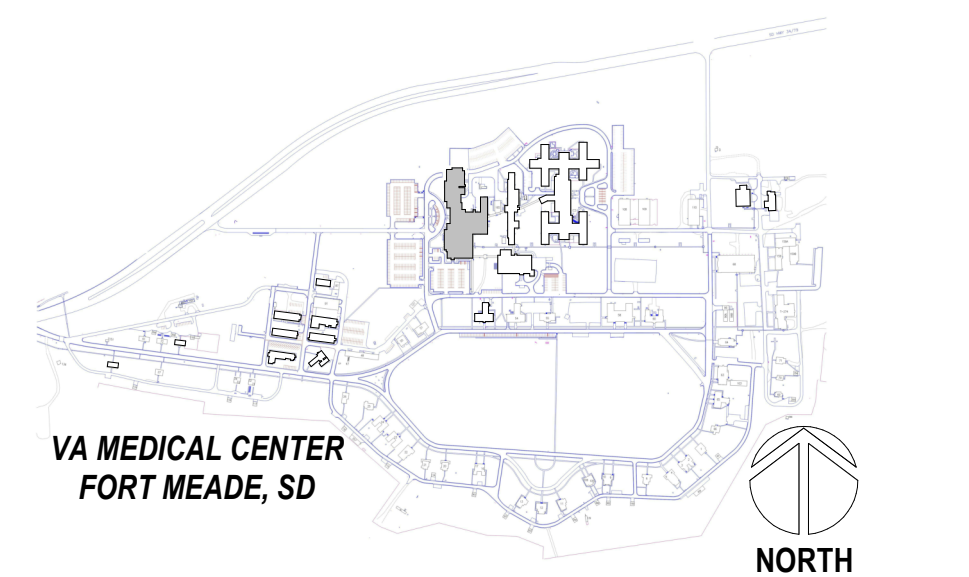

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Revisions:	Date:

CONSULTANT

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ADAM GODDIN, PE

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STAMP

PROGRAM CONTRACTING ACTIVITY CENTRAL (PCAC)

VA U.S. Department of Veterans Affairs

DRAWING TITLE
113-ENLARGED PLANS AND ELEVATIONS

APPROVED: Project Director

PHASE
100% CONSTRUCTION DOCUMENTS

FLS
FULLY SPRINKLERED

PROJECT FILE
EHRM INFRASTRUCTURE UPGRADES

LOCATION
FORT MEADE, SOUTH DAKOTA

ISSUE DATE: 04/15/2022
CHECKED BY: TMP
DRAWN BY: JPR

PROJECT NUMBER
568-21-701

BUILDING NUMBER
BLDG 113


DRAWING NUMBER
113-AE-301

FLOOR PLAN NOTES


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- PROVIDE ALL BACKING FOR MILLWORK, GRAB BARS, AND ANY AND ALL WALL MOUNTED EQUIPMENT OR ACCESSORIES; COORDINATE LOCATIONS.
- ALL DIMENSIONS ARE FROM STRUCTURAL OR UNFINISHED FACE OF STUD, UNLESS OTHERWISE NOTED.
- PROVIDE A SMOOTH AND LEVEL FINISH FLOOR, TYP. PATCH AND REPAIR ALL INCONSISTENCIES IN FLOOR ELEVATIONS.
- PATCH AND REPAIR ANY / ALL WALL SURFACES AS REQUIRED TO PROVIDE SUITABLE SUBSTRATE FOR FINISHES.
- REFER TO DOOR AND FRAME SCHEDULE FOR DOORS REQUIRING ADA ACCESS CONTROL.
- PROVIDE ACOUSTICAL SEALANT AROUND WALL EDGES, TOP AND BOTTOM, AND PENETRATIONS, AND INSTALL PUTTY PADS AROUND ELECTRICAL BOXES WHERE PARTITION CONTAINS ACOUSTICAL INSULATION.
- ALL TELECOMMUNICATION ROOMS ARE TO HAVE EXPOSED STRUCTURE UNLESS NOTED OTHERWISE, NO CEILINGS SPECIFIED.

KEYNOTES


- 02-08 CAREFULLY REMOVE CEILING TILES AND OTHER CEILING MOUNTED DEVICES. CAREFULLY STORE IN NON-TRAFFICED AREA AND PREPARE FOR REINSTALLATION AT COMPLETION OF WORK.
- 06-01 INSTALL 3/4" AC GRADE OR BETTER FIRE RETARDANT PLYWOOD. PAINT WITH TWO COATS OF SEMI-GLOSS BRIGHT WHITE FIRE RETARDANT PAINT. MOUNT BOTTOM OF PLYWOOD 8" A.F.F., TOP OF PLYWOOD AT 8" A.F.F., DO NOT PAINT OVER STAMPED PLYWOOD RATING.
- 08-03 ADA DOOR CLEARANCES SHOWN DASHED
- 09-01 PAINT WALL ABOVE PLYWOOD WITH SEMI-GLOSS PAINT. COLOR TO MATCH PLYWOOD PAINT.
- 09-02 PATCH ALL DAMAGED WORK ON EXISTING SURFACES ABOVE AND BELOW CEILING TILES. PAINT ALL WALLS. PROVIDE NEW RESILIENT 6TH RESILIENT WALL BASE.
- 09-03 EXTEND EXISTING GYPSUM BOARD TO UNDERSIDE OF STRUCTURE WHERE NOT INSTALLED. SEAL TO STRUCTURAL DECK
- 09-06 SEAL ALL WALL PENETRATIONS EXISTING AND NEW. PROVIDE APPROPRIATE FIRE RATED UL HLTJ DESIGNATION FOR PIPE AND/OR CONDUIT PENETRATIONS; SEE TYPICAL PENETRATION DETAILS FOR RATED WALL CONDITIONS.
- 09-07 INSTALL STATIC DISSIPATIVE RESILIENT FLOORING
- 09-11 INSTALL NEW WALL BASE TO MATCH TYPE, COLOR, AND PROFILE OF EXISTING WALL BASE
- 09-18 6" HIGH COVERED RUBBER WALL BASE. COLOR TO BE SELECTED FROM MANUFACTURER'S STANDARD SELECTION
- 09-25 PATCH AND REPAIR ANY GYPSUM BOARD OPENINGS FOUND AT PERIMETER OF WALL, ENSURING NO VISIBLE EVIDENCE OF PATCH. SEAL PERIMETER OF ROOM IN ITS ENTIRETY, PAINT.
- 09-29 INSTALL NEW FLOORING TO MATCH EXISTING SIMILAR USE ROOM
- 22-01 FIRE SUPPRESSION SPRINKLER HEAD SHOWN FOR REFERENCE ONLY. FIRE SUPPRESSION CONTRACTOR TO VERIFY ACTUAL QUANTITIES REQUIRED. INSTALL SYMMETRICALLY CENTER IN TILE.
- 22-02 UPRIGHT HEAD FIRE SUPPRESSION SPRINKLER HEAD SHOWN FOR REFERENCE ONLY. FIRE SUPPRESSION CONTRACTOR TO VERIFY ACTUAL QUANTITIES REQUIRED. COORDINATE INSTALLATION WITH MEPT DRAWINGS
- 23-06 NEW REFRIGERANT PIPE LINES ROUTING SHOWN FOR REFERENCE ONLY. SEE MECHANICAL DRAWINGS FOR ACTUAL ROUTING. CONTRACTOR TO REMOVE CEILING TILES ALONG ROUTE OUTSIDE OF TRS AND REPLACE WITHIN WORKING SHIFT. CONDUCT INFECTION PREVENTION MEASURES AS SPECIFIED.
- 26-02 3" PERIMETER CLEARANCE AROUND SERVER RACK SHOWN DASHED
- 26-03 TELECOMM RACK. SEE TELECOMMUNICATION DRAWINGS
- 26-04 ELECTRICAL PANELS. SEE ELECTRICAL DRAWINGS
- 26-11 STROBE LIGHT. SEE ELECTRICAL DRAWINGS
- 26-12 ELECTRICAL OUTLETS MOUNTED ON PLYWOOD

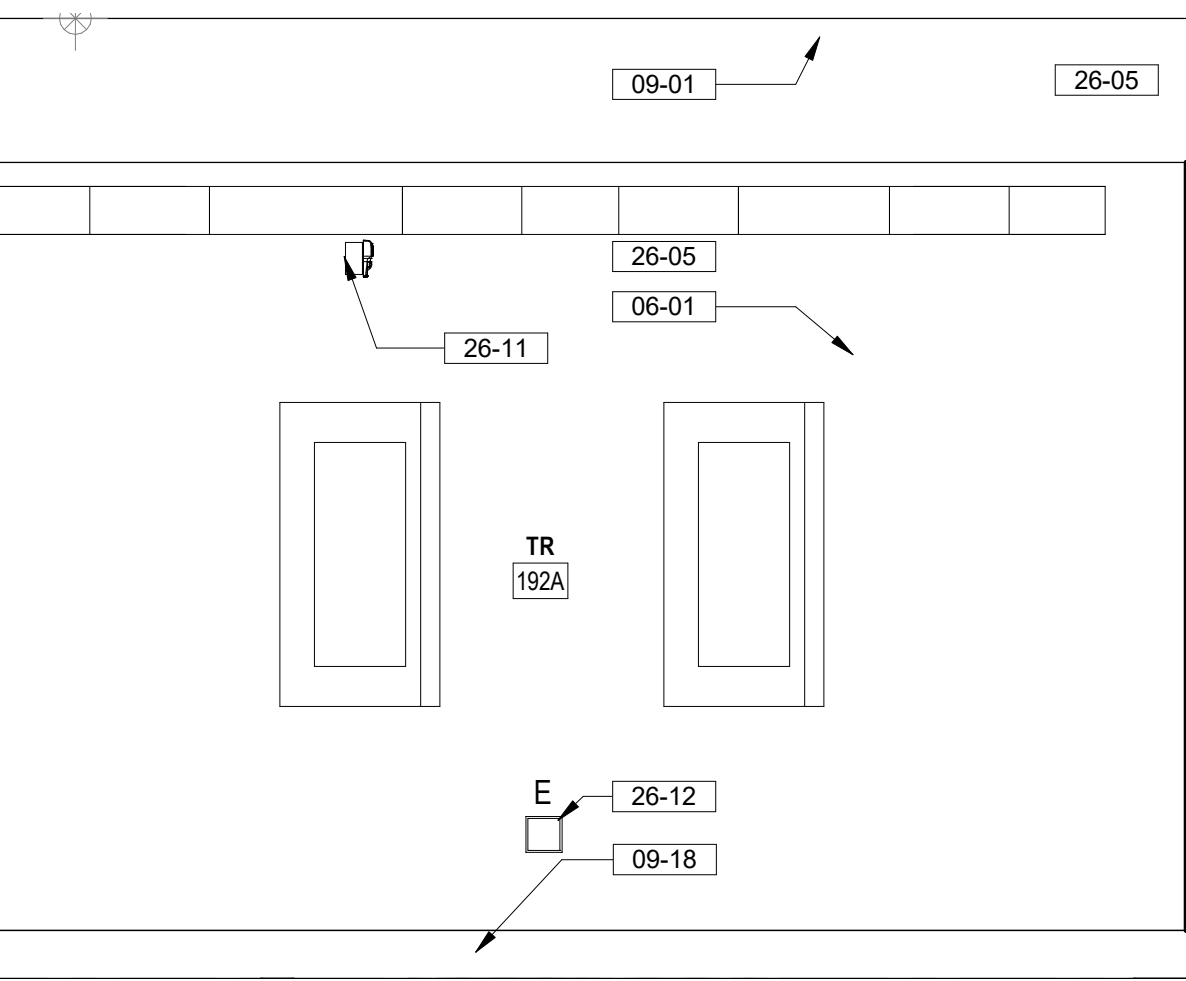


3 TR 192A EAST ELEVATION
1/2" = 1'-0"

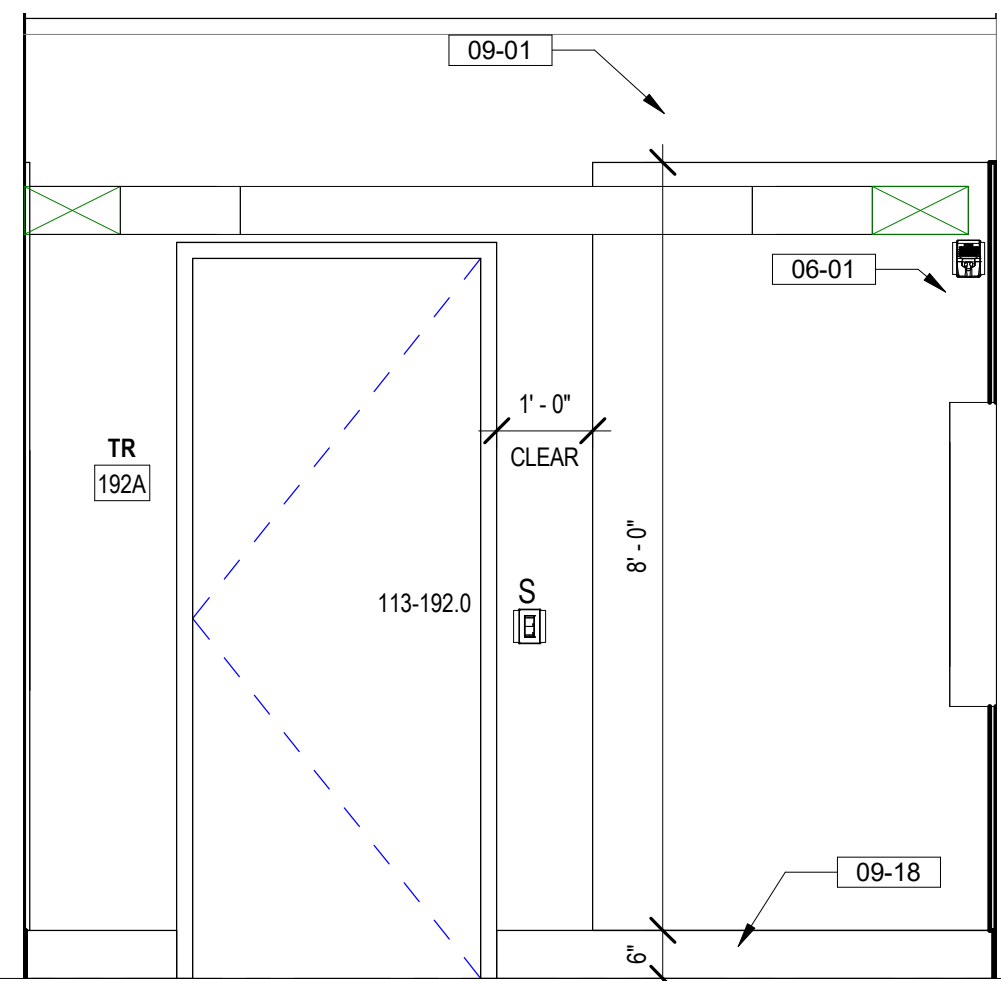


5 TR 192A NORTH ELEVATION
1/2" = 1'-0"

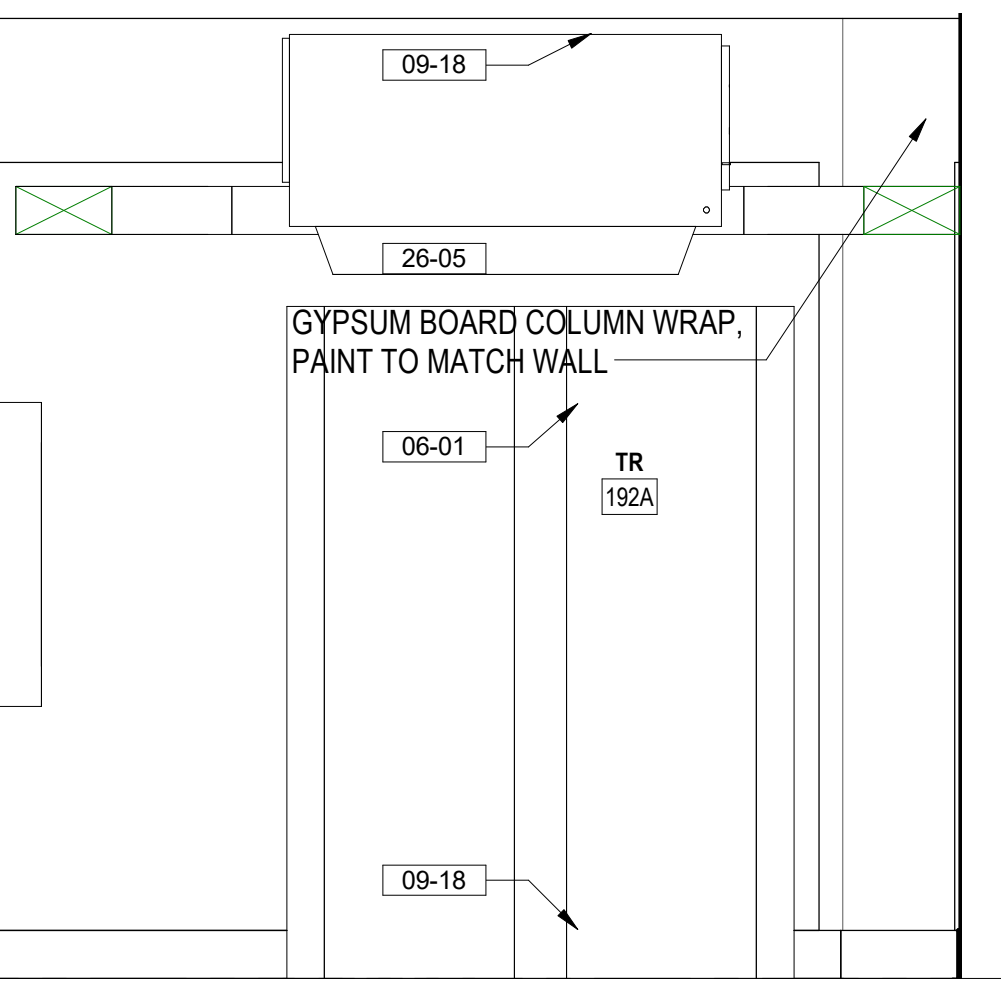


8 TR 192A SOUTH ELEVATION
1/2" = 1'-0"

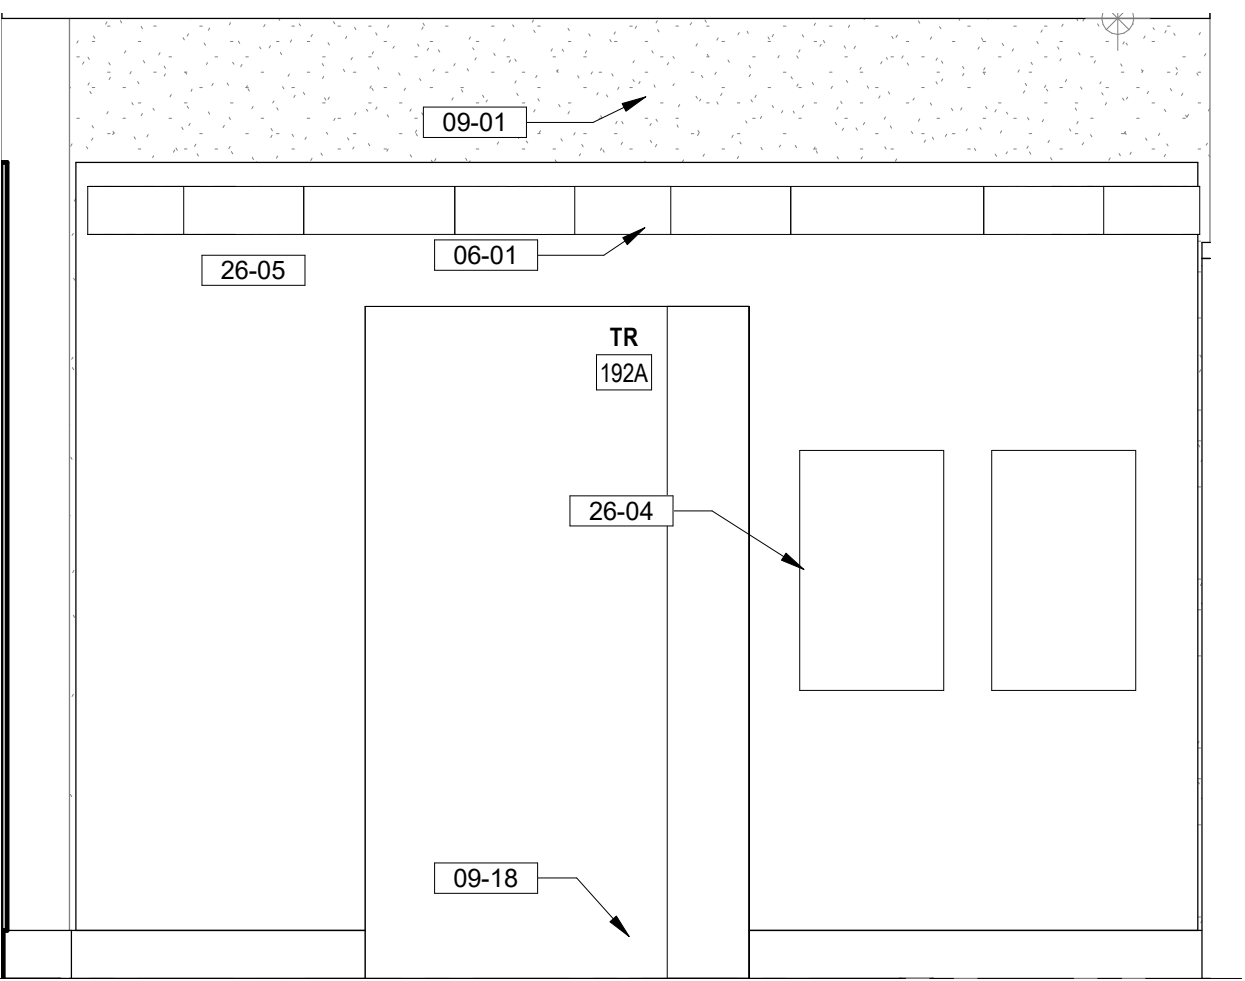


11 TR 192A WEST ELEVATION
1/2" = 1'-0"

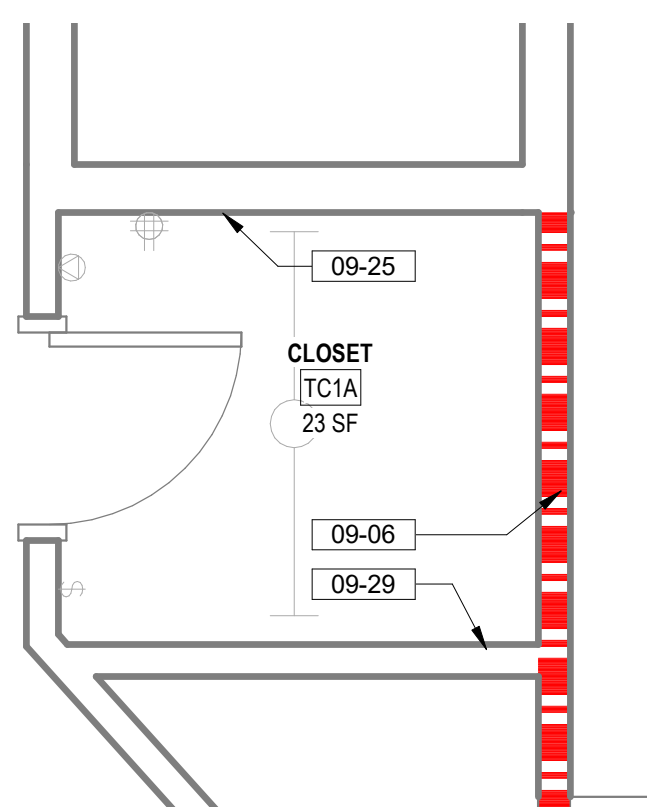


2 113 - TC1A ENLARGED PLAN
1/2" = 1'-0"

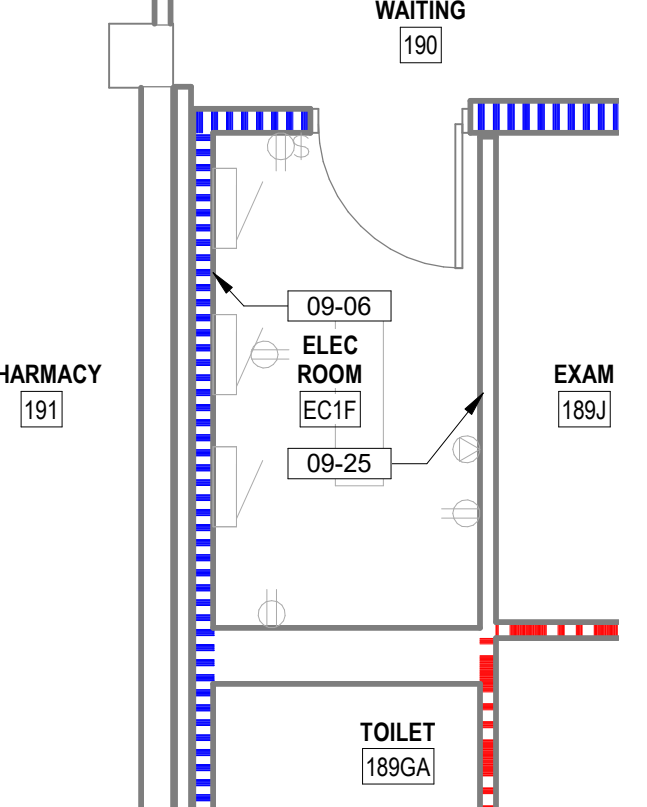

4 ECIF FLOOR PLAN
1/4" = 1'-0"

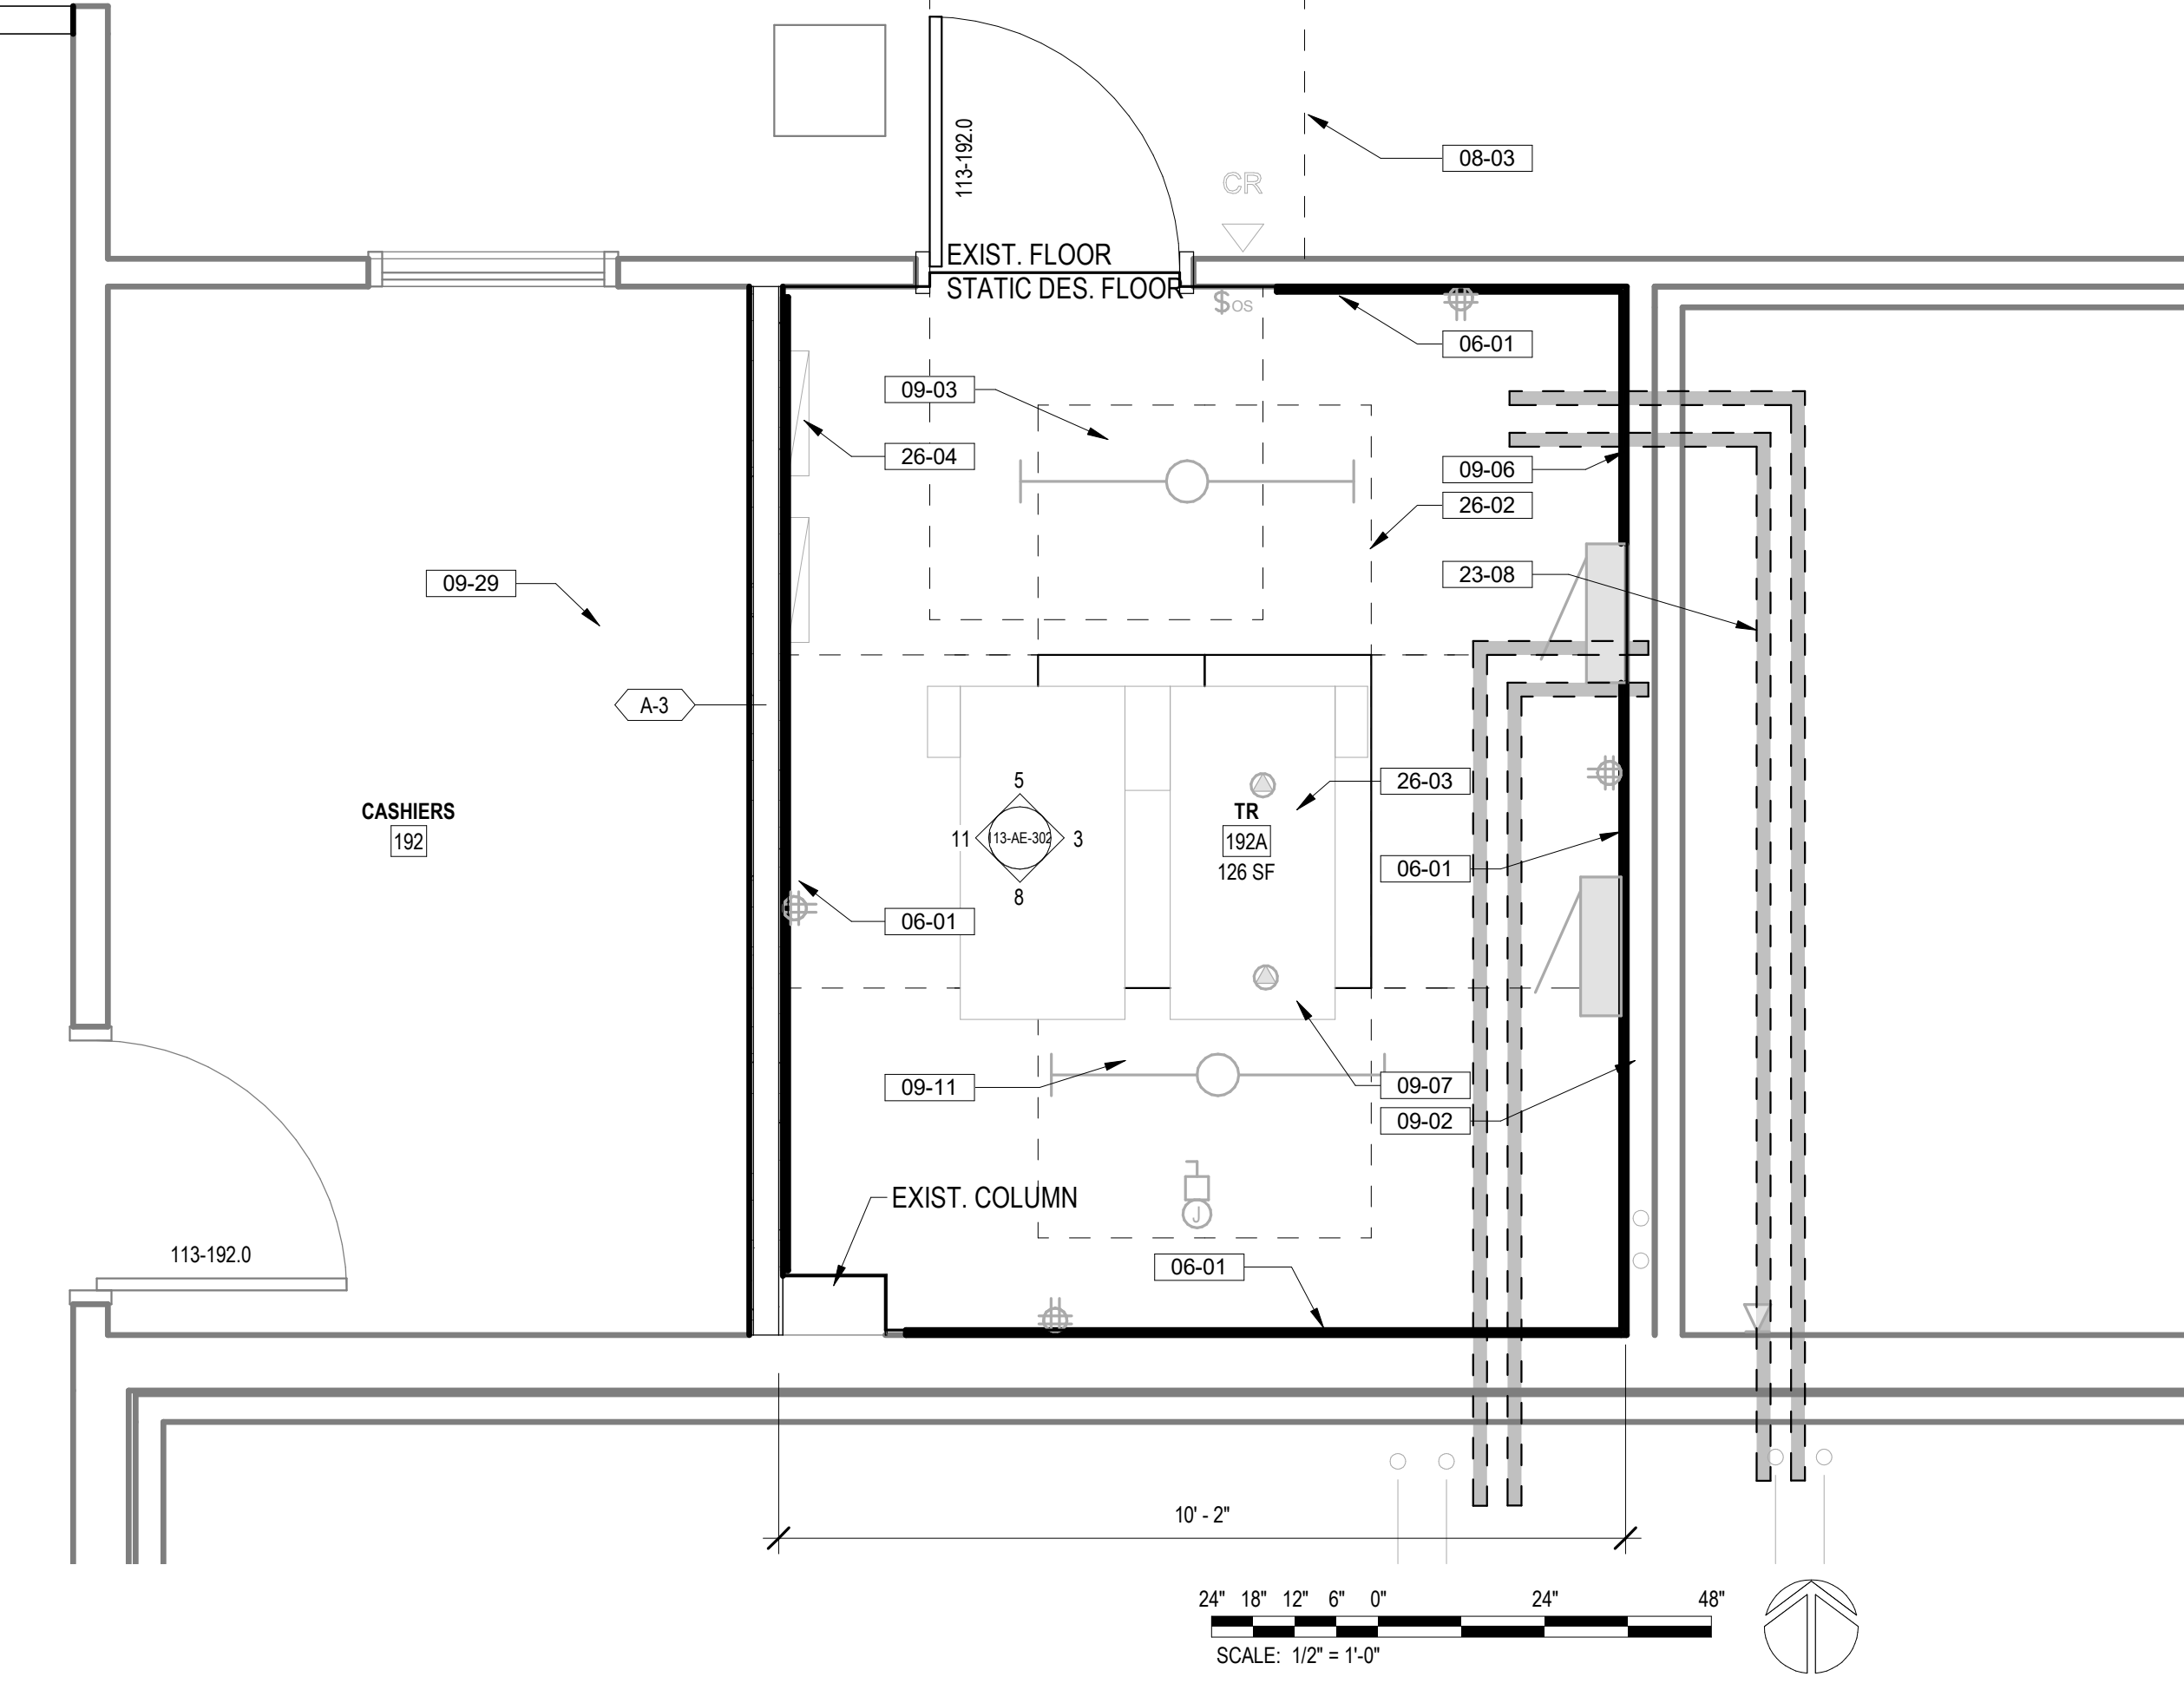

1 113 - 192 ENLARGED PLAN
1/2" = 1'-0"

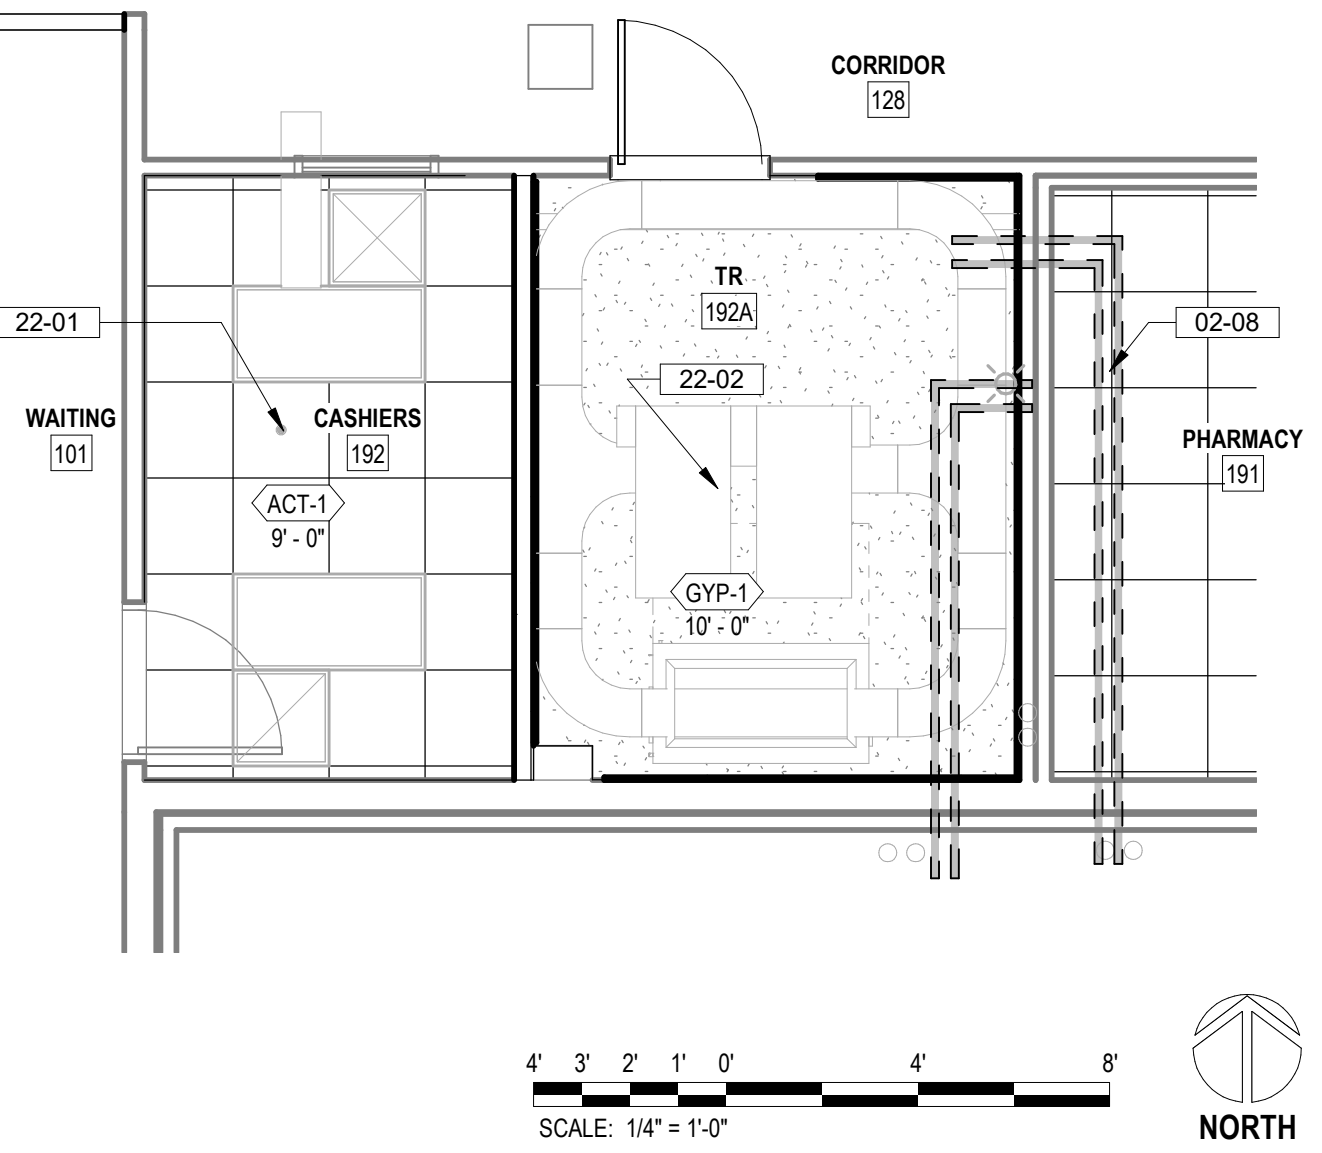

6 113 - 192 ENLARGED REFLECTED CEILING PLAN
1/4" = 1'-0"

REFLECTED CEILING PLAN NOTES

- REFER TO ELECTRICAL SHEETS FOR FIXTURE TYPES, SWITCHING, AND SPECIAL SYSTEMS.
- REFER TO MECHANICAL SHEETS FOR DIFFUSER AND DUCTING LAYOUTS
- SEE SHEET 00-GI-006 FOR TYPICAL ACOUSTICAL PANEL CEILING DETAILS


REFLECTED CEILING PLAN LEGEND

- 2x2 LIGHT FIXTURE
- 2x4 LIGHT FIXTURE
- STRIP LIGHT FIXTURE
- 6" RECESSED CAN LIGHT FIXTURE
- SUPPLY AIR DIFFUSER
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- CARD READER, REF TELECOM DRAWINGS
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- WIRELESS ACCESS POINT, REF TELECOM DRAWINGS
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- STRIP LIGHT FIXTURE, REF ELEC DRAWINGS

PROJECT KEY PLAN



2022-05-24 10:14:14
BIM 360/2/112_VA Medical Center - Fort Meade SD 2112_Bldg 113_20.rvt
VA FORM 08 - 6231

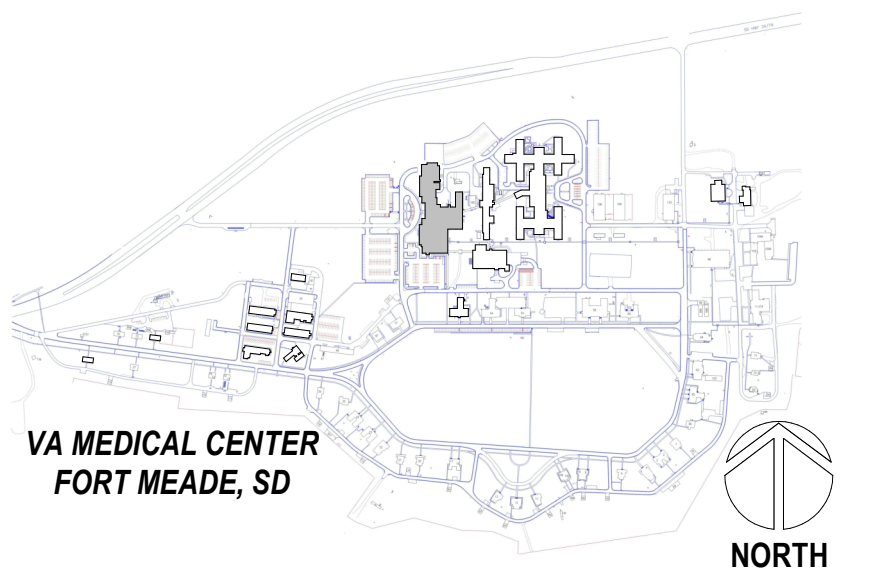Revisions:	Date:

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T. MARCELLO PIERROTTI, AIA

STAMP
PROGRAM CONTRACTING ACTIVITY CENTRAL (PCAC)
VA U.S. Department of Veterans Affairs


DRAWING TITLE
113-ENLARGED PLANS AND ELEVATIONS
APPROVED: Project Director

PHASE
100% CONSTRUCTION DOCUMENTS
FLS
FULLY SPRINKLERED


PROJECT TITLE
EHRM INFRASTRUCTURE UPGRADES
LOCATION
FORT MEADE, SOUTH DAKOTA
ISSUE DATE
04/15/2022
CHECKED BY
TMP
DRAWN BY
JPR

PROJECT NUMBER
568-21-701
BUILDING NUMBER
BLDG 113
DRAWING NUMBER
113-AE-302


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F

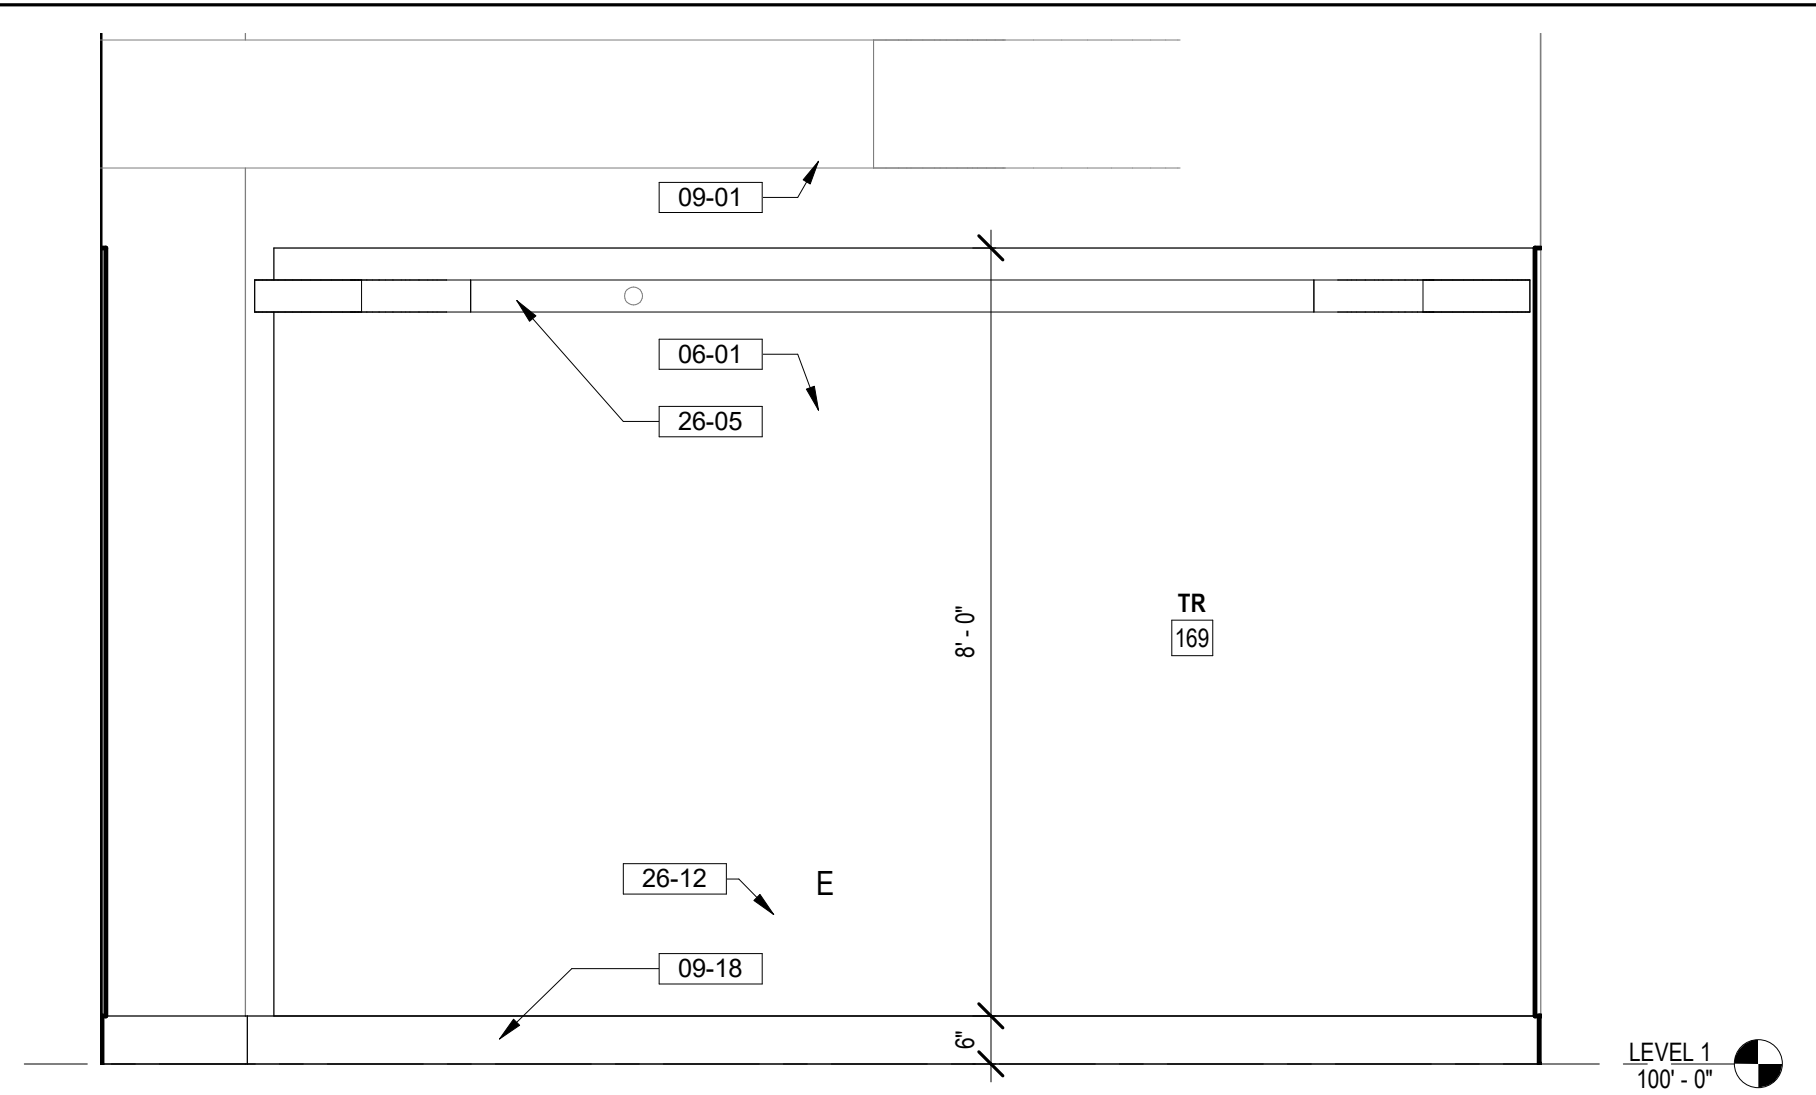


3 TR 169 NORTH ELEVATION
1/2" = 1'-0"

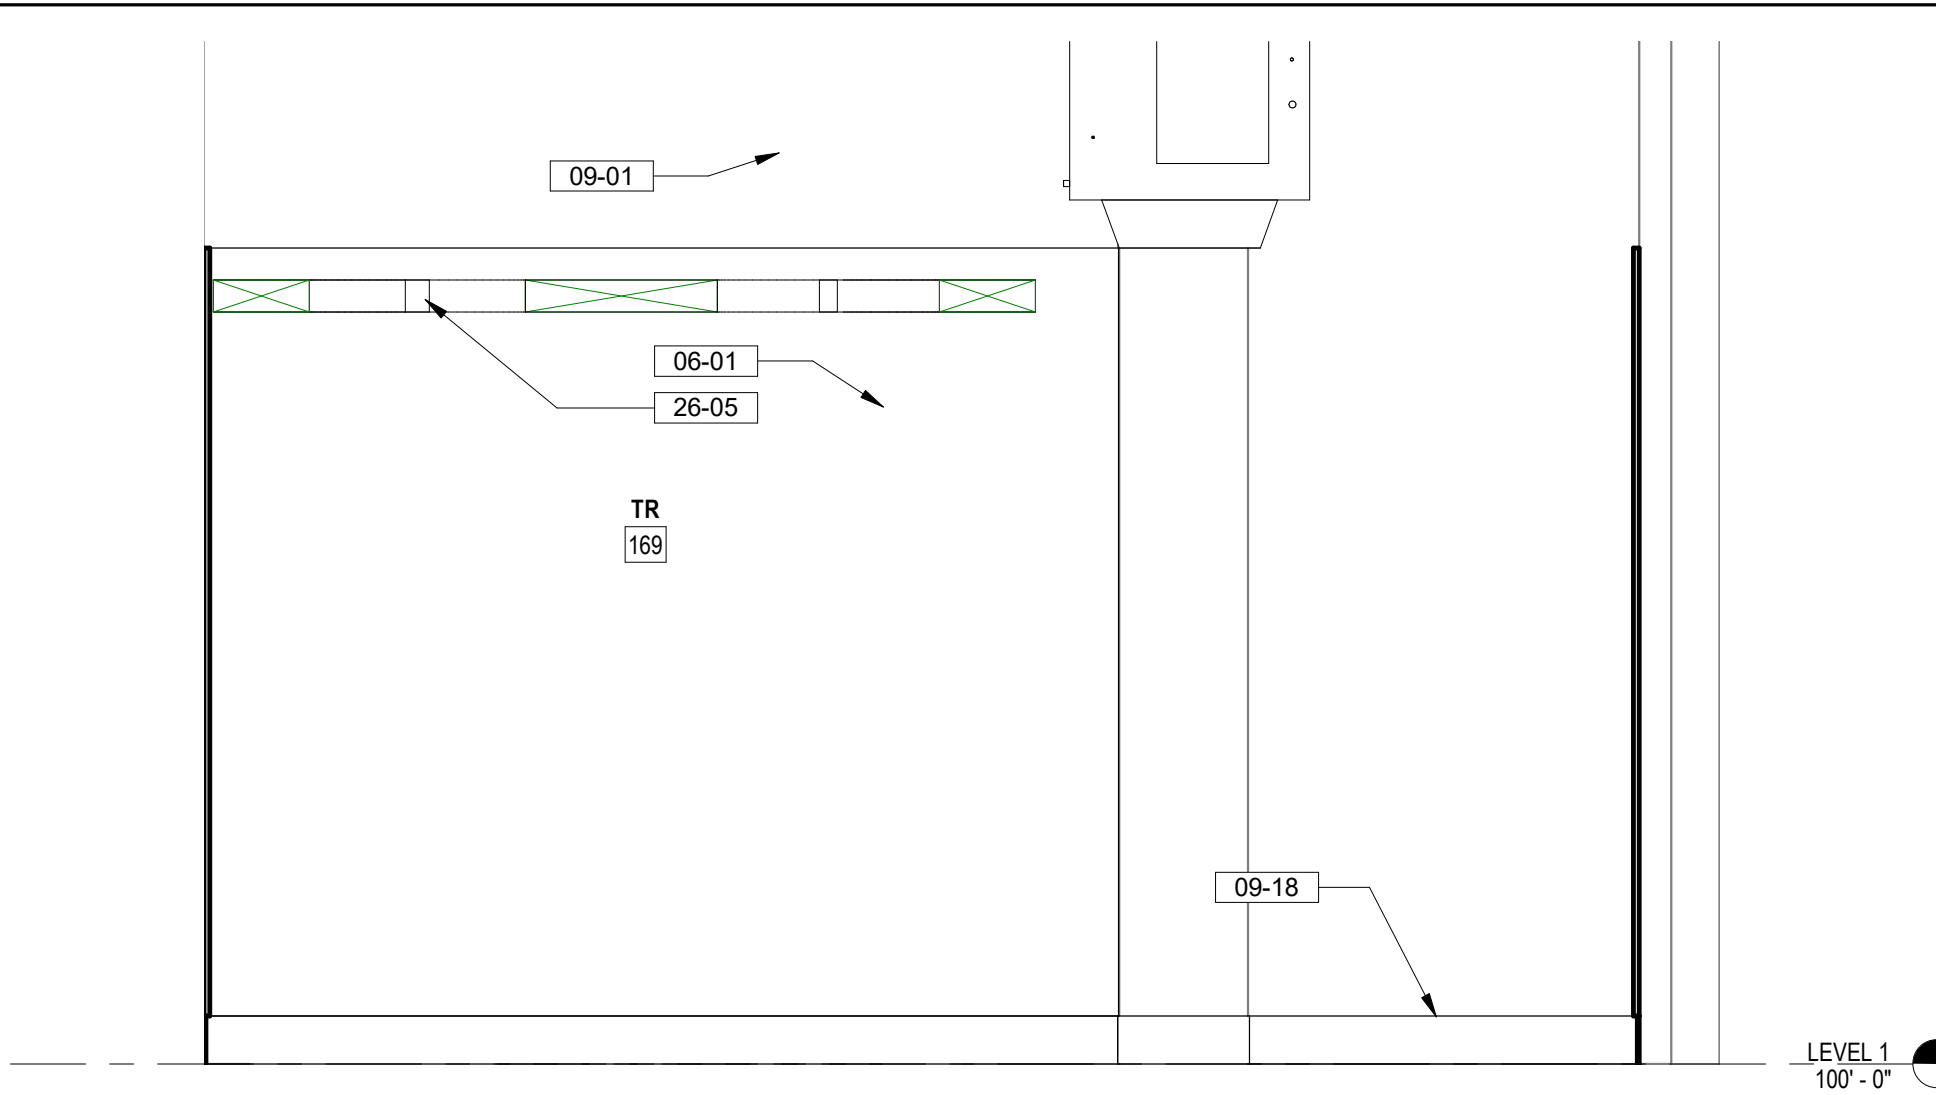


6 TR 169 EAST ELEVATION
1/2" = 1'-0"

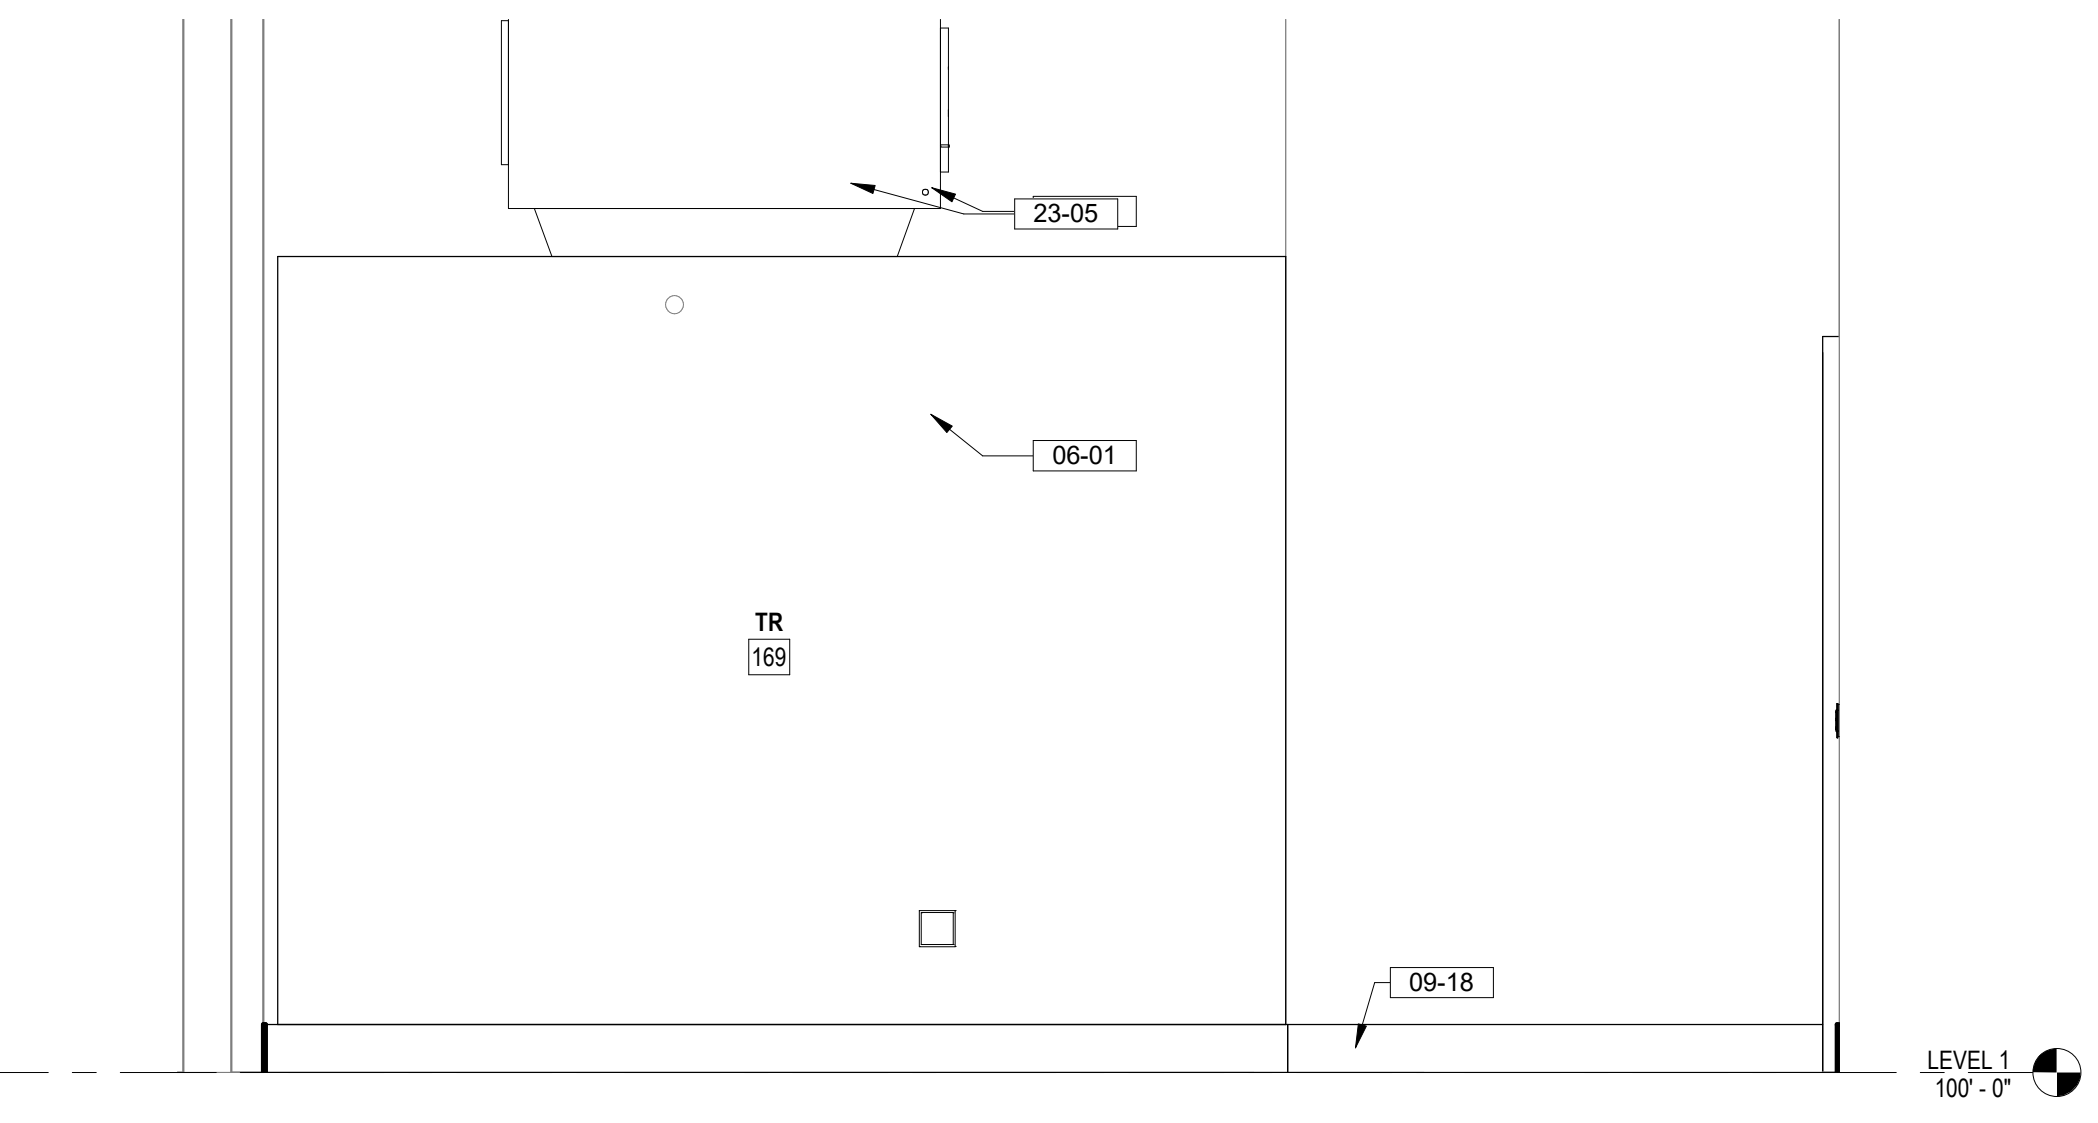


2 TR 169 SOUTH ELEVATION
1/2" = 1'-0"

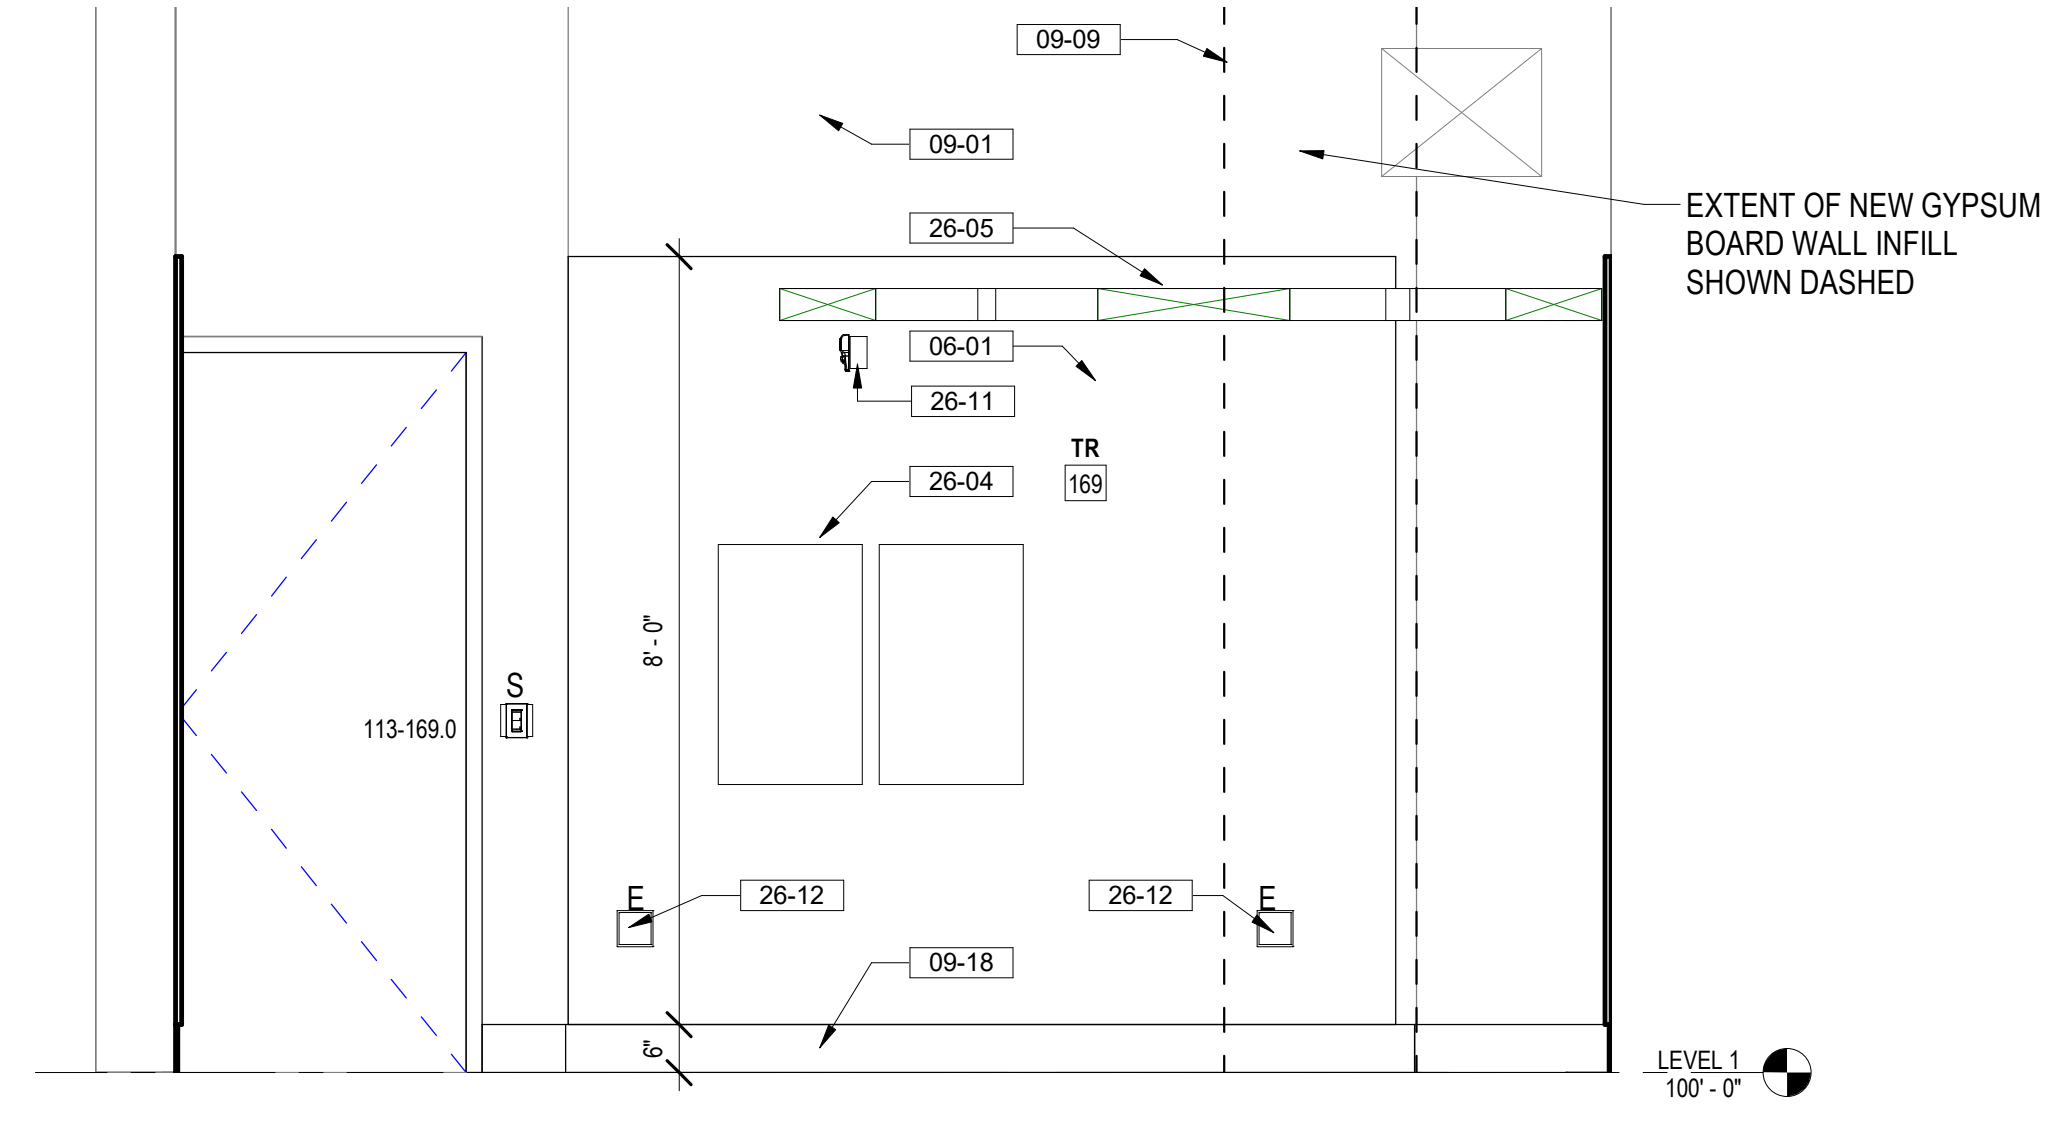

5 TR 169 WEST ELEVATION
1/2" = 1'-0"

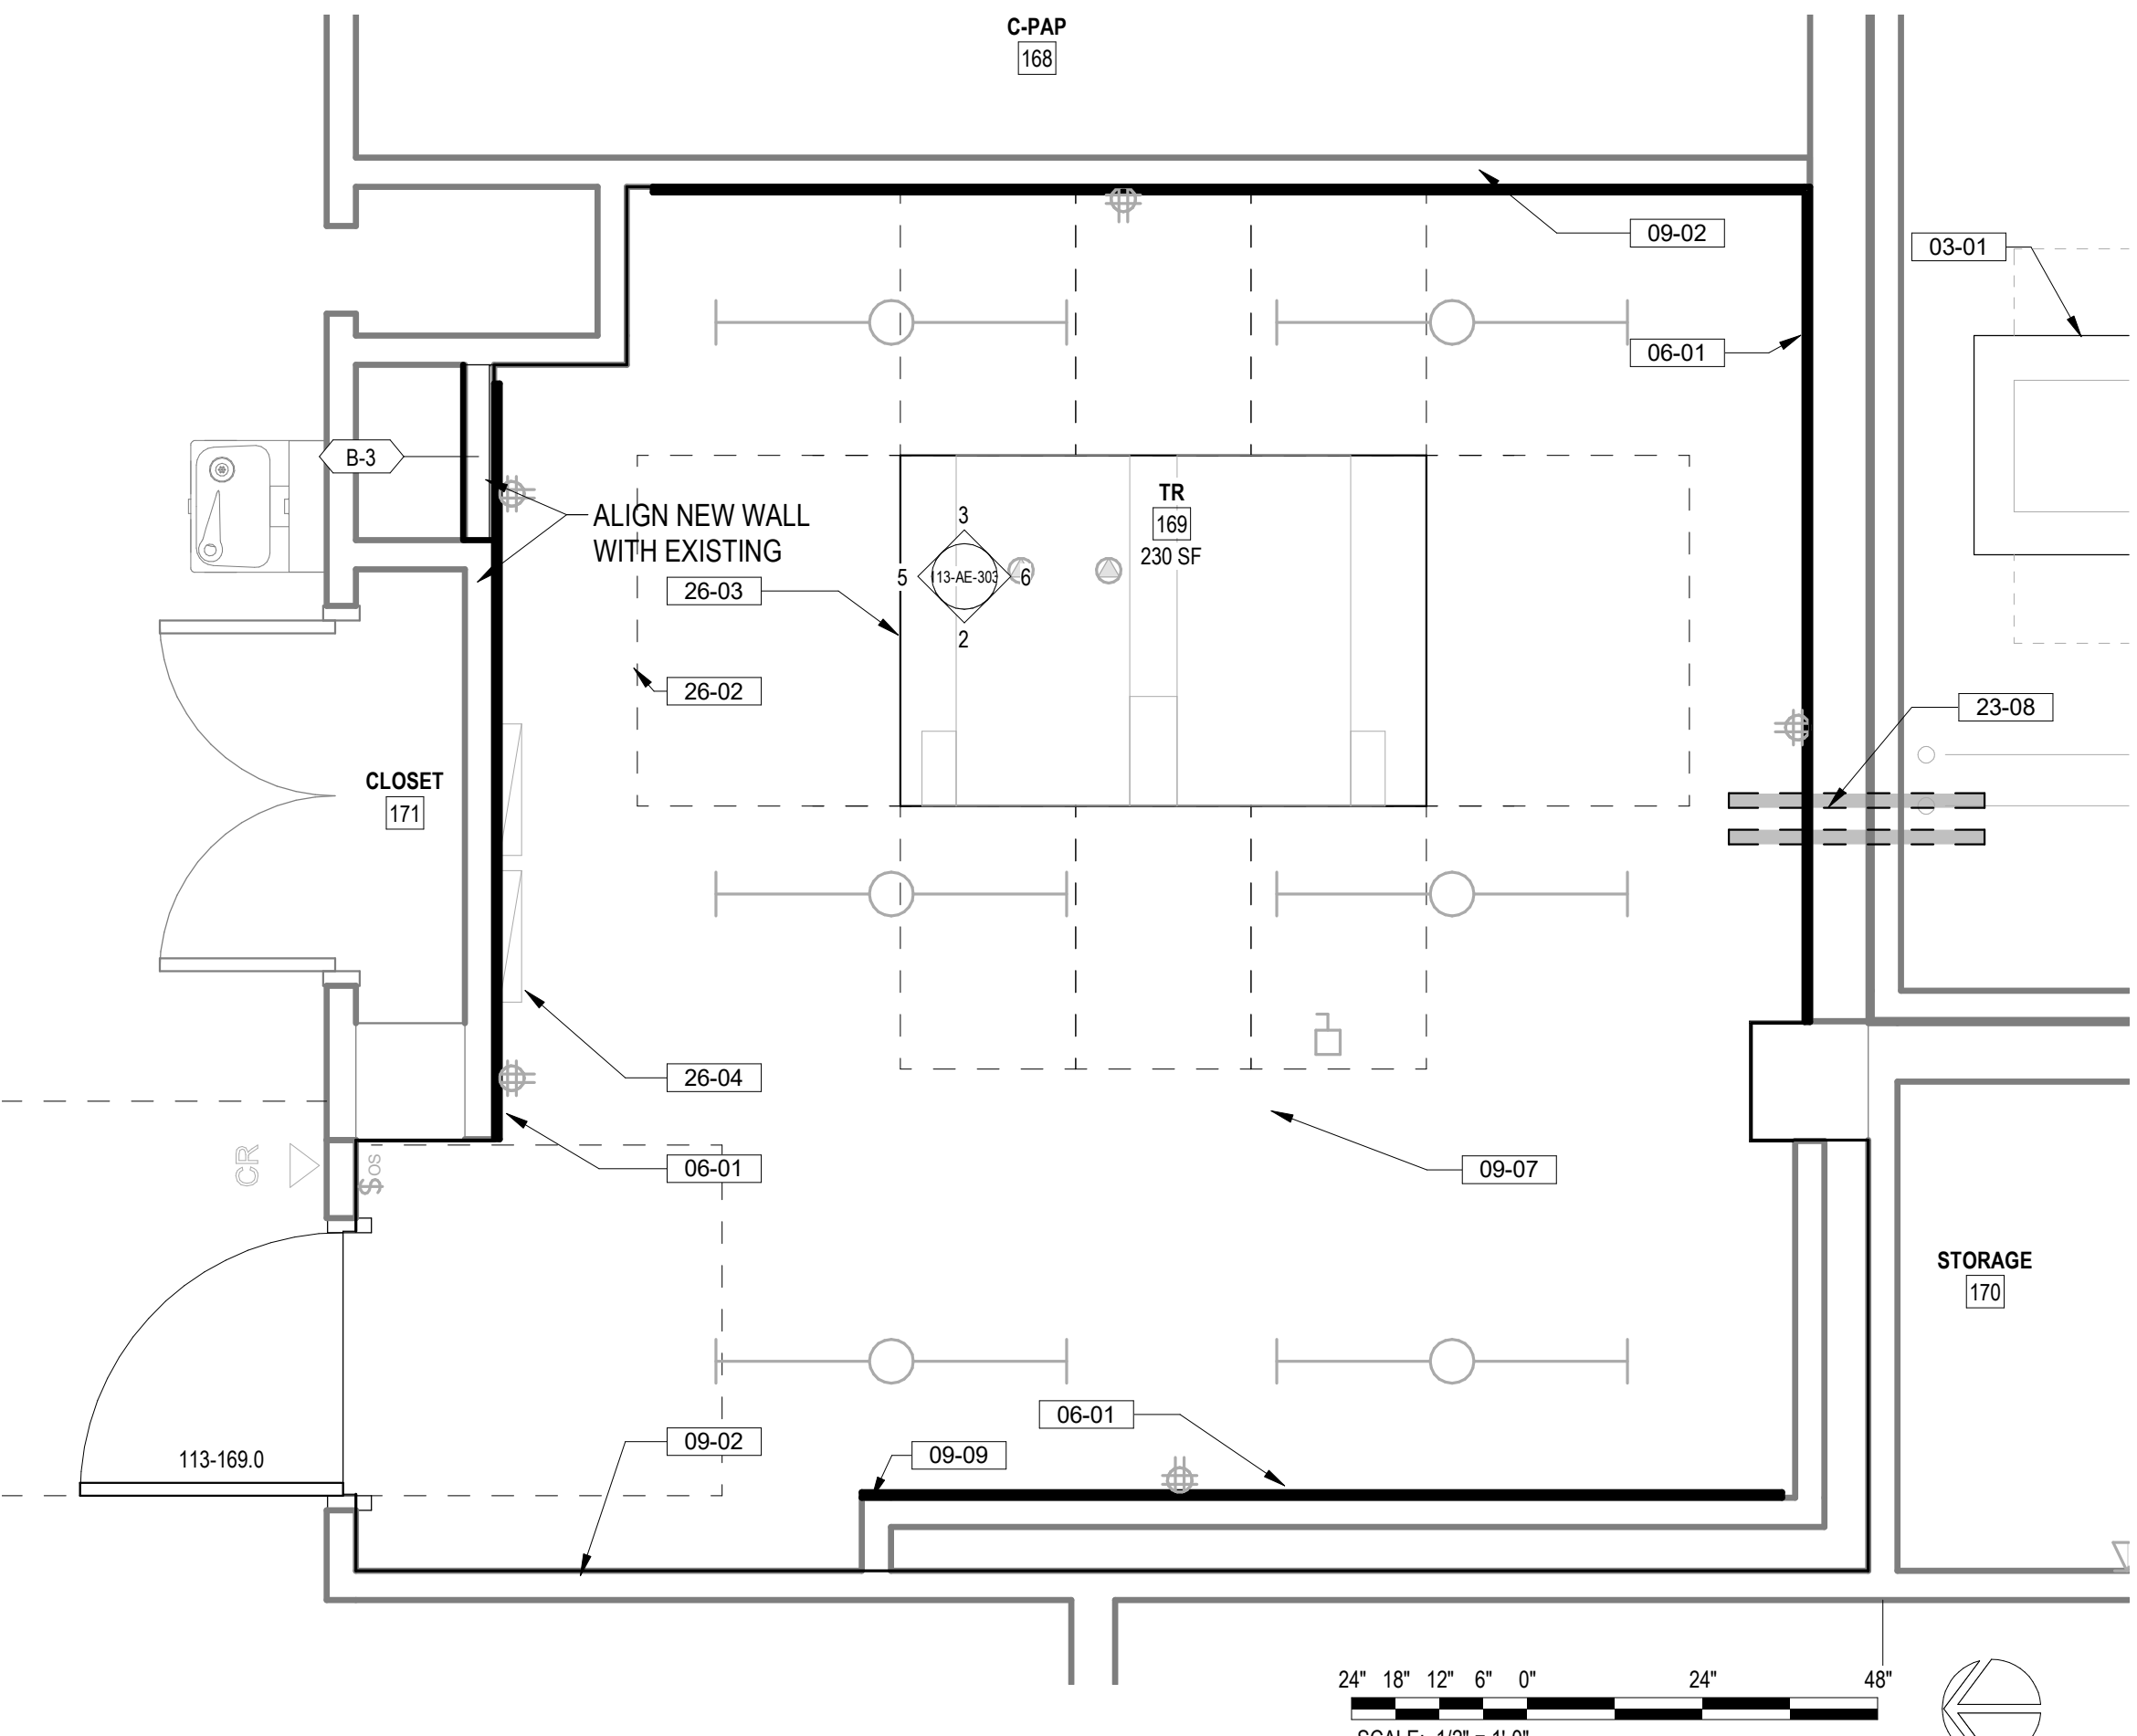

1 113 -169 ENLARGED PLAN
1/2" = 1'-0"

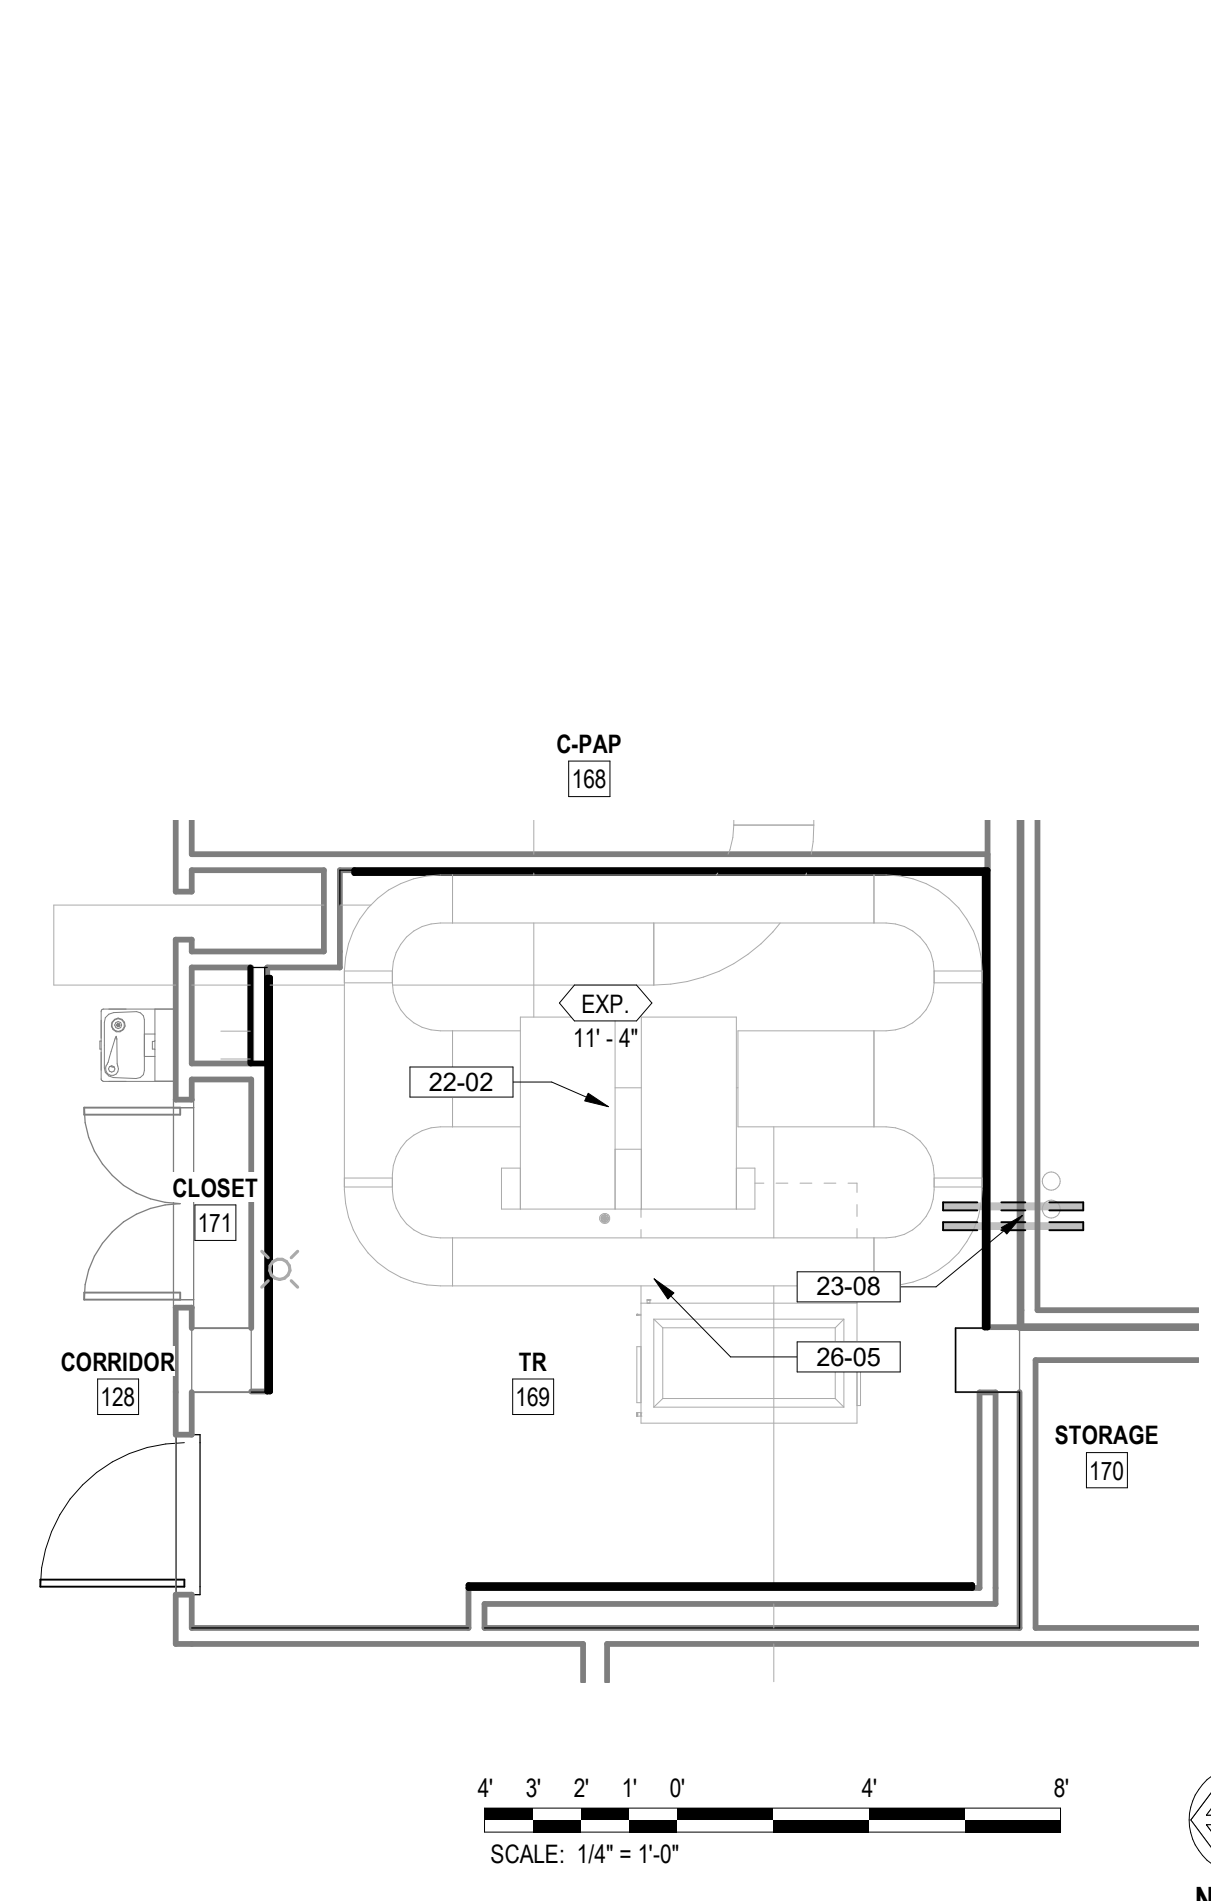

4 113 - 169 ENLARGED REFLECTED CEILING PLAN
1/4" = 1'-0"

FLOOR PLAN NOTES

- SEE G SERIES SHEETS FOR BALANCE OF PLAN GENERAL NOTES.
- REFER TO STRUCTURAL, MECHANICAL, AND ELECTRICAL DRAWINGS FOR ADDITIONAL INFORMATION. ALL INFORMATION REGARDING EXISTING CONDITIONS IS BASED UPON OWNER-SUPPLIED DOCUMENTS AND MAY NOT PRECISELY REFLECT FIELD CONDITIONS.
- PROVIDE ALL BACKING FOR MILLWORK, GRAB BARS, AND ANY AND ALL WALL MOUNTED EQUIPMENT OR ACCESSORIES; COORDINATE LOCATIONS.
- ALL DIMENSIONS ARE FROM STRUCTURAL OR UNFINISHED FACE OF STUD, UNLESS OTHERWISE NOTED.
- PROVIDE A SMOOTH AND LEVEL FINISH FLOOR, TYP. PATCH AND REPAIR ALL INCONSISTENCIES IN FLOOR ELEVATIONS.
- PATCH AND REPAIR ANY / ALL WALL SURFACES AS REQUIRED TO PROVIDE SUITABLE SUBSTRATE FOR FINISHES.
- REFER TO DOOR AND FRAME SCHEDULE FOR DOORS REQUIRING ADA ACCESS CONTROL.
- PROVIDE ACOUSTICAL SEALANT AROUND WALL EDGES, TOP AND BOTTOM, AND PENETRATIONS, AND INSTALL PUTTY PADS AROUND ELECTRICAL BOXES WHERE PARTITION CONTAINS ACOUSTICAL INSULATION.
- ALL TELECOMMUNICATION ROOMS ARE TO HAVE EXPOSED STRUCTURE UNLESS NOTED OTHERWISE, NO CEILINGS SPECIFIED.

KEYNOTES

- 03-01 NEW HOUSEKEEPING PAD, COORDINATE WITH MECHANICAL DRAWINGS FOR SIZE AND CIVIL DRAWINGS FOR DETAILS
- 06-01 INSTALL 3/4" AC GRADE OR BETTER FIRE RETARDANT PLYWOOD; PAINT WITH TWO COATS OF SEMI-GLOSS BRIGHT WHITE FIRE RETARDANT PAINT; MOUNT BOTTOM OF PLYWOOD 6" A.F.F., TOP OF PLYWOOD AT 8'-6" A.F.F.; DO NOT PAINT OVER STAINED PLYWOOD RATING
- 09-01 PAINT WALL ABOVE PLYWOOD WITH SEMI-GLOSS PAINT, COLOR TO MATCH PLYWOOD PAINT.
- 09-02 PATCH ALL DAMAGED WORK ON EXISTING SURFACES ABOVE AND BELOW CEILING TILES, PAINT ALL WALLS, PROVIDE NEW RESILIENT 6TH RESILIENT WALL BASE
- 09-07 INSTALL STATIC DISSIPATIVE RESILIENT FLOORING
- 09-09 APPLY JOINT COMPOUND AND FEATHER A MINIMUM OF 3" HORIZONTALLY AS REQUIRED TO ACHIEVE A SMOOTH AND UNIFORM APPEARANCE
- 09-18 6" HIGH COVERED RUBBER WALL BASE, COLOR TO BE SELECTED FROM MANUFACTURER'S STANDARD SELECTION
- 22-02 UPRIGHT HEAD FIRE SUPPRESSION SPRINKLER HEAD SHOWN FOR REFERENCE ONLY. FIRE SUPPRESSION CONTRACTOR TO VERIFY ACTUAL QUANTITIES REQUIRED, COORDINATE INSTALLATION WITH MEPT DRAWINGS
- 23-05 MECHANICAL UNITS, SEE MECH DRAWINGS FOR SIZE AND SPECS
- 23-08 NEW REFRIGERANT PIPE LINES ROUTING SHOWN FOR REFERENCE ONLY. SEE MECHANICAL DRAWINGS FOR ACTUAL ROUTING, CONTRACTOR TO REMOVE CEILING TILES ALONG ROUTE OUTSIDE OF TRS AND REPLACE WITHIN WORKING SHIFT. CONDUCT INFECTION PREVENTION MEASURES AS SPECIFIED.
- 26-02 3" PERIMETER CLEARANCE AROUND SERVER RACK SHOWN DASHED
- 26-03 TELECOMM RACK, SEE TELECOMMUNICATION DRAWINGS
- 26-04 ELECTRICAL PANELS, SEE ELECTRICAL DRAWINGS
- 26-05 CABLE TRAY, SEE TELECOMMUNICATION DRAWINGS
- 26-11 STROBE LIGHT, SEE ELECTRICAL DRAWINGS
- 26-12 ELECTRICAL OUTLETS MOUNTED ON PLYWOOD

FLOOR PLAN LEGEND

- CARD READER, REF TELECOM DRAWINGS
- DATA PORT, REF TELECOM DRAWINGS
- OUTLET, REF ELEC DRAWINGS
- WIRELESS ACCESS POINT, REF TELECOM DRAWINGS
- ELEC PANEL, REF ELEC DRAWINGS
- STRIP LIGHT FIXTURE, REF ELEC DRAWINGS


REFLECTED CEILING PLAN LEGEND

- 2x2 LIGHT FIXTURE
- 2x4 LIGHT FIXTURE
- STRIP LIGHT FIXTURE
- 6" RECESSED CAN LIGHT FIXTURE
- SUPPLY AIR DIFFUSER
- RETURN AIR VENT
- EXHAUST FAN
- 5/8" GYP. BOARD CEILING AFFIXED TO 3 5/8" MTL STUDS
- 2x2 SUSPENDED ACOUSTIC CEILING TILE CEILING
- 2x4 SUSPENDED ACOUSTIC CEILING TILE CEILING

REFLECTED CEILING PLAN NOTES

- REFER TO ELECTRICAL SHEETS FOR FIXTURE TYPES, SWITCHING, AND SPECIAL SYSTEMS.
- REFER TO MECHANICAL SHEETS FOR DIFFUSER AND DUCTING LAYOUTS
- SEE SHEET 00-GI-006 FOR TYPICAL ACOUSTICAL PANEL CEILING DETAILS

PROJECT KEY PLAN

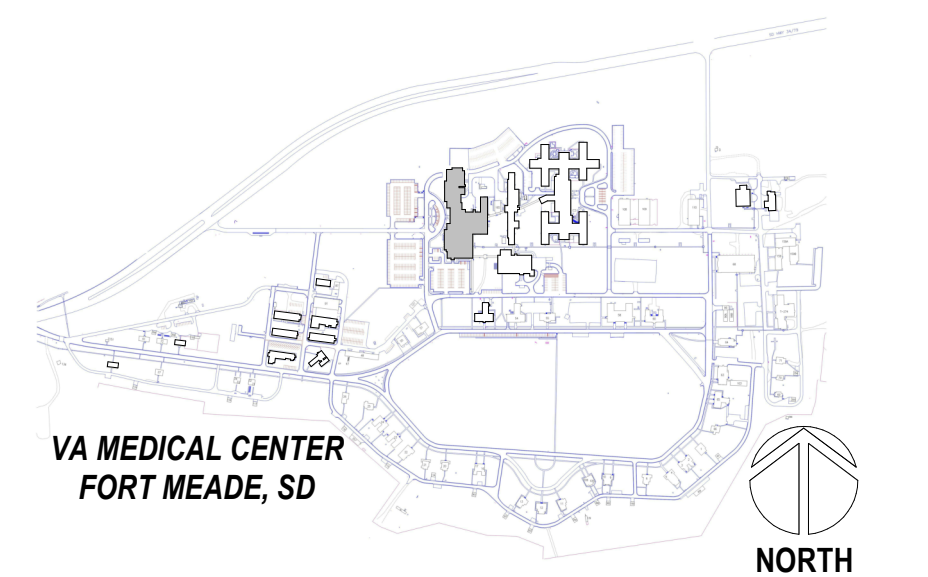

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Revisions:	Date:

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T. MARCELLO PIERROTTET, AIA

STAMP

PROGRAM CONTRACTING ACTIVITY CENTRAL (PCAC)

VA U.S. Department of Veterans Affairs

DRAWING TITLE
113-ENLARGED PLANS AND ELEVATIONS







APPROVED: Project Director

PHASE
100% CONSTRUCTION DOCUMENTS

FLS
FULLY SPRINKLERED

PROJECT TITLE EHRM INFRASTRUCTURE UPGRADES		PROJECT NUMBER 568-21-701	
LOCATION FORT MEADE, SOUTH DAKOTA		BUILDING NUMBER BLDG 113	
ISSUE DATE 04/15/2022	CHECKED BY TMP	DRAWN BY JPR	DRAWING NUMBER 113-AE-303

FLOOR PLAN LEGEND


-  CARD READER, REF TELECOM DRAWINGS
-  DATA PORT, REF TELECOM DRAWINGS
-  OUTLET, REF ELEC DRAWINGS
-  WIRELESS ACCESS POINT, REF TELECOM DRAWINGS
-  ELEC PANEL, REF ELEC DRAWINGS
-  STRIP LIGHT FIXTURE, REF ELEC DRAWINGS

FLOOR PLAN NOTES


1. SEE G SERIES SHEETS FOR BALANCE OF FLOOR PLAN GENERAL NOTES.
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5. PROVIDE A SMOOTH AND LEVEL FINISH FLOOR, TYP. PATCH AND REPAIR ALL INCONSISTENCIES IN FLOOR ELEVATIONS.
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9. ALL TELECOMMUNICATION ROOMS ARE TO HAVE EXPOSED STRUCTURE UNLESS NOTED OTHERWISE, NO CEILINGS SPECIFIED.

KEYNOTES

- 01-01 CLEAN UP AREA AROUND PROPOSED WALL MOUNTED CABINET LOCATION, COORDINATE WITH C.O.R. FOR RELOCATION OR REMOVAL OF INSTALLATION OBSTRUCTING ITEMS.
- 02-48 DEMO MECHANICAL WALL MOUNTED UNIT AND ASSOCIATED CONDUIT AND SERVICES TO NEAREST J-BOX. CLEAN WALL AND PREPARE FOR INSTALLATION OF WALL MOUNTED TELECOM CABINET.
- 02-49 DEMO EXISTING LOUVER, PREPARE OPENING TO RECEIVE MASONRY WALL INFIL.
- 02-50 DEMO EXISTING CAGED LIGHT FIXTURES AND CONDUITS TO NEAREST J-BOX. CONTRACTOR TO ROUTE CONDUIT IN LEAST DESTRUCTIVE MANNER TO LOCATIONS AS INDICATED IN TELECOMMUNICATION DRAWINGS.
- 02-56 CONTRACTOR TO BE RESPONSIBLE TO VISIT SITE AND UNDERSTAND ROUTING AND MATERIAL TREATMENT, PATCH AND FINISH TO MATCH EXISTING MATERIALS, TYPICAL AT ALL DATA DROP LOCATIONS (ICMA CLASS I). SEE SPEC SECTION 01 35 26 FOR REQUIREMENTS AND WORKING HOURS RESTRICTIONS.
- 13-01 30" CLEARANCE AT WALL MOUNTED SERVER RACK SHOWN DASHED WALL MOUNTED TELECOM CABINET, SEE TELECOM DRAWINGS.
- 26-09
- 26-10

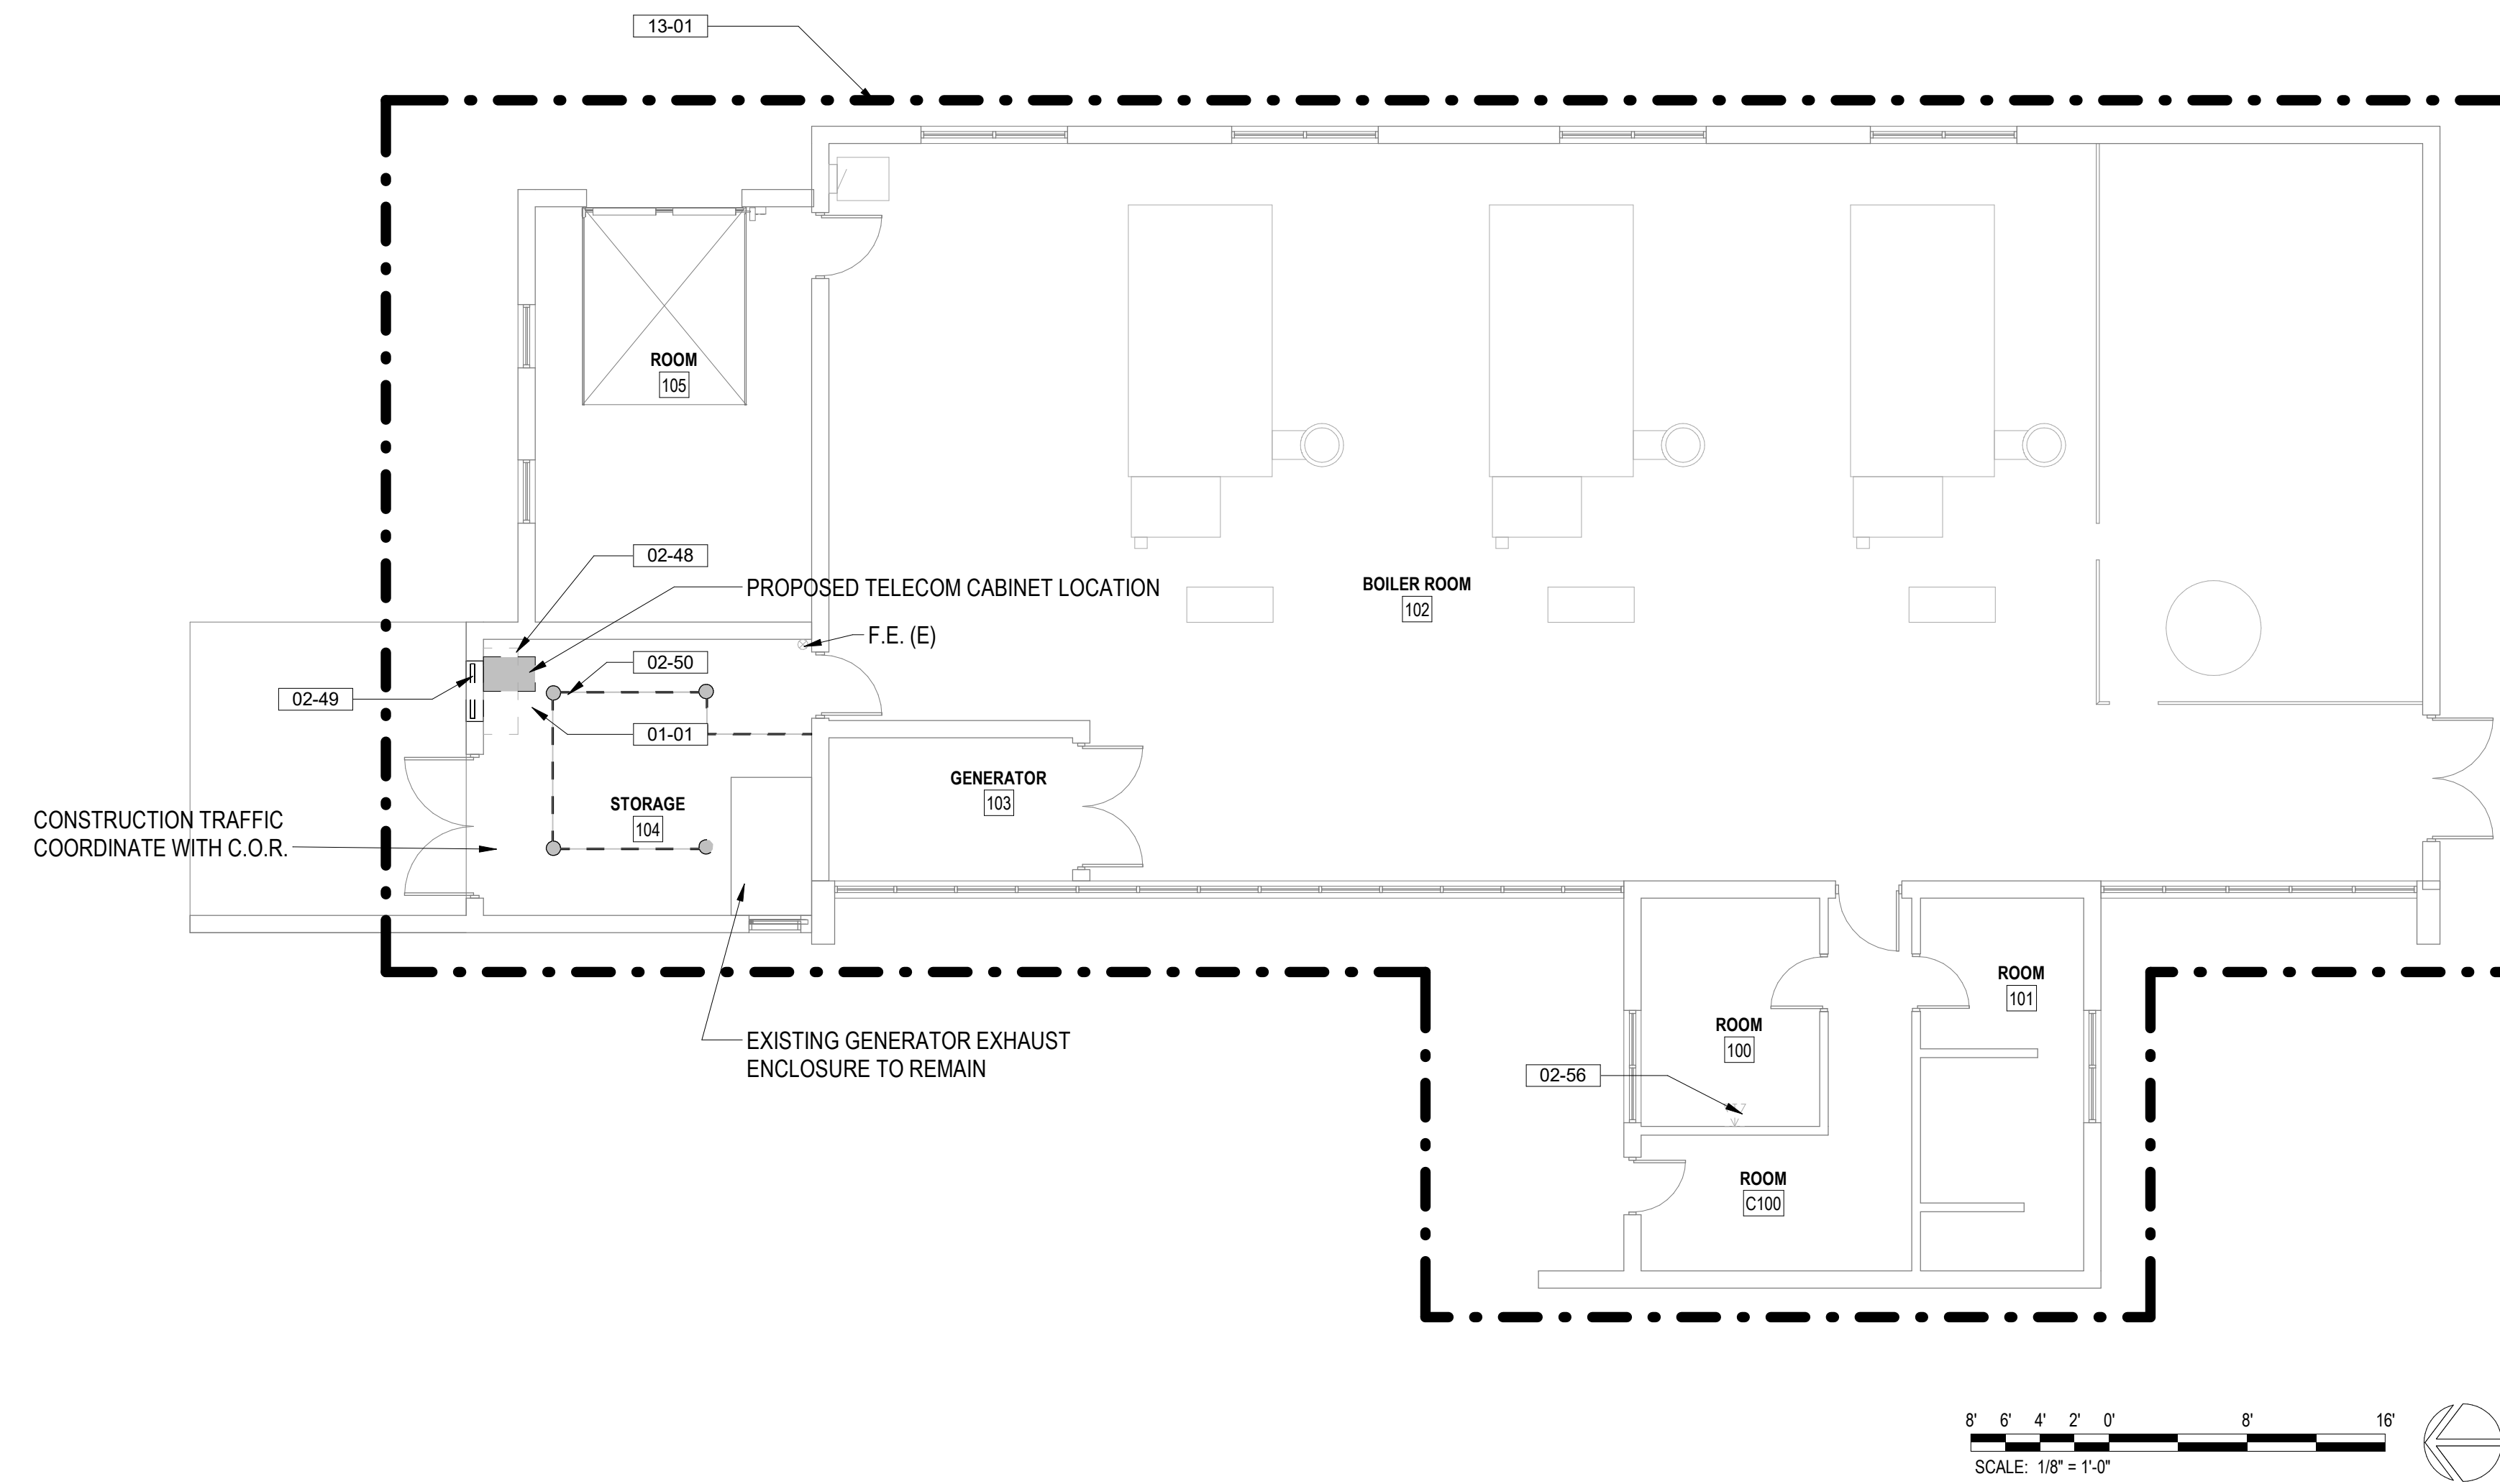


2 LEVEL 1 DEMOLITION FLOOR PLAN
1/8" = 1'-0"

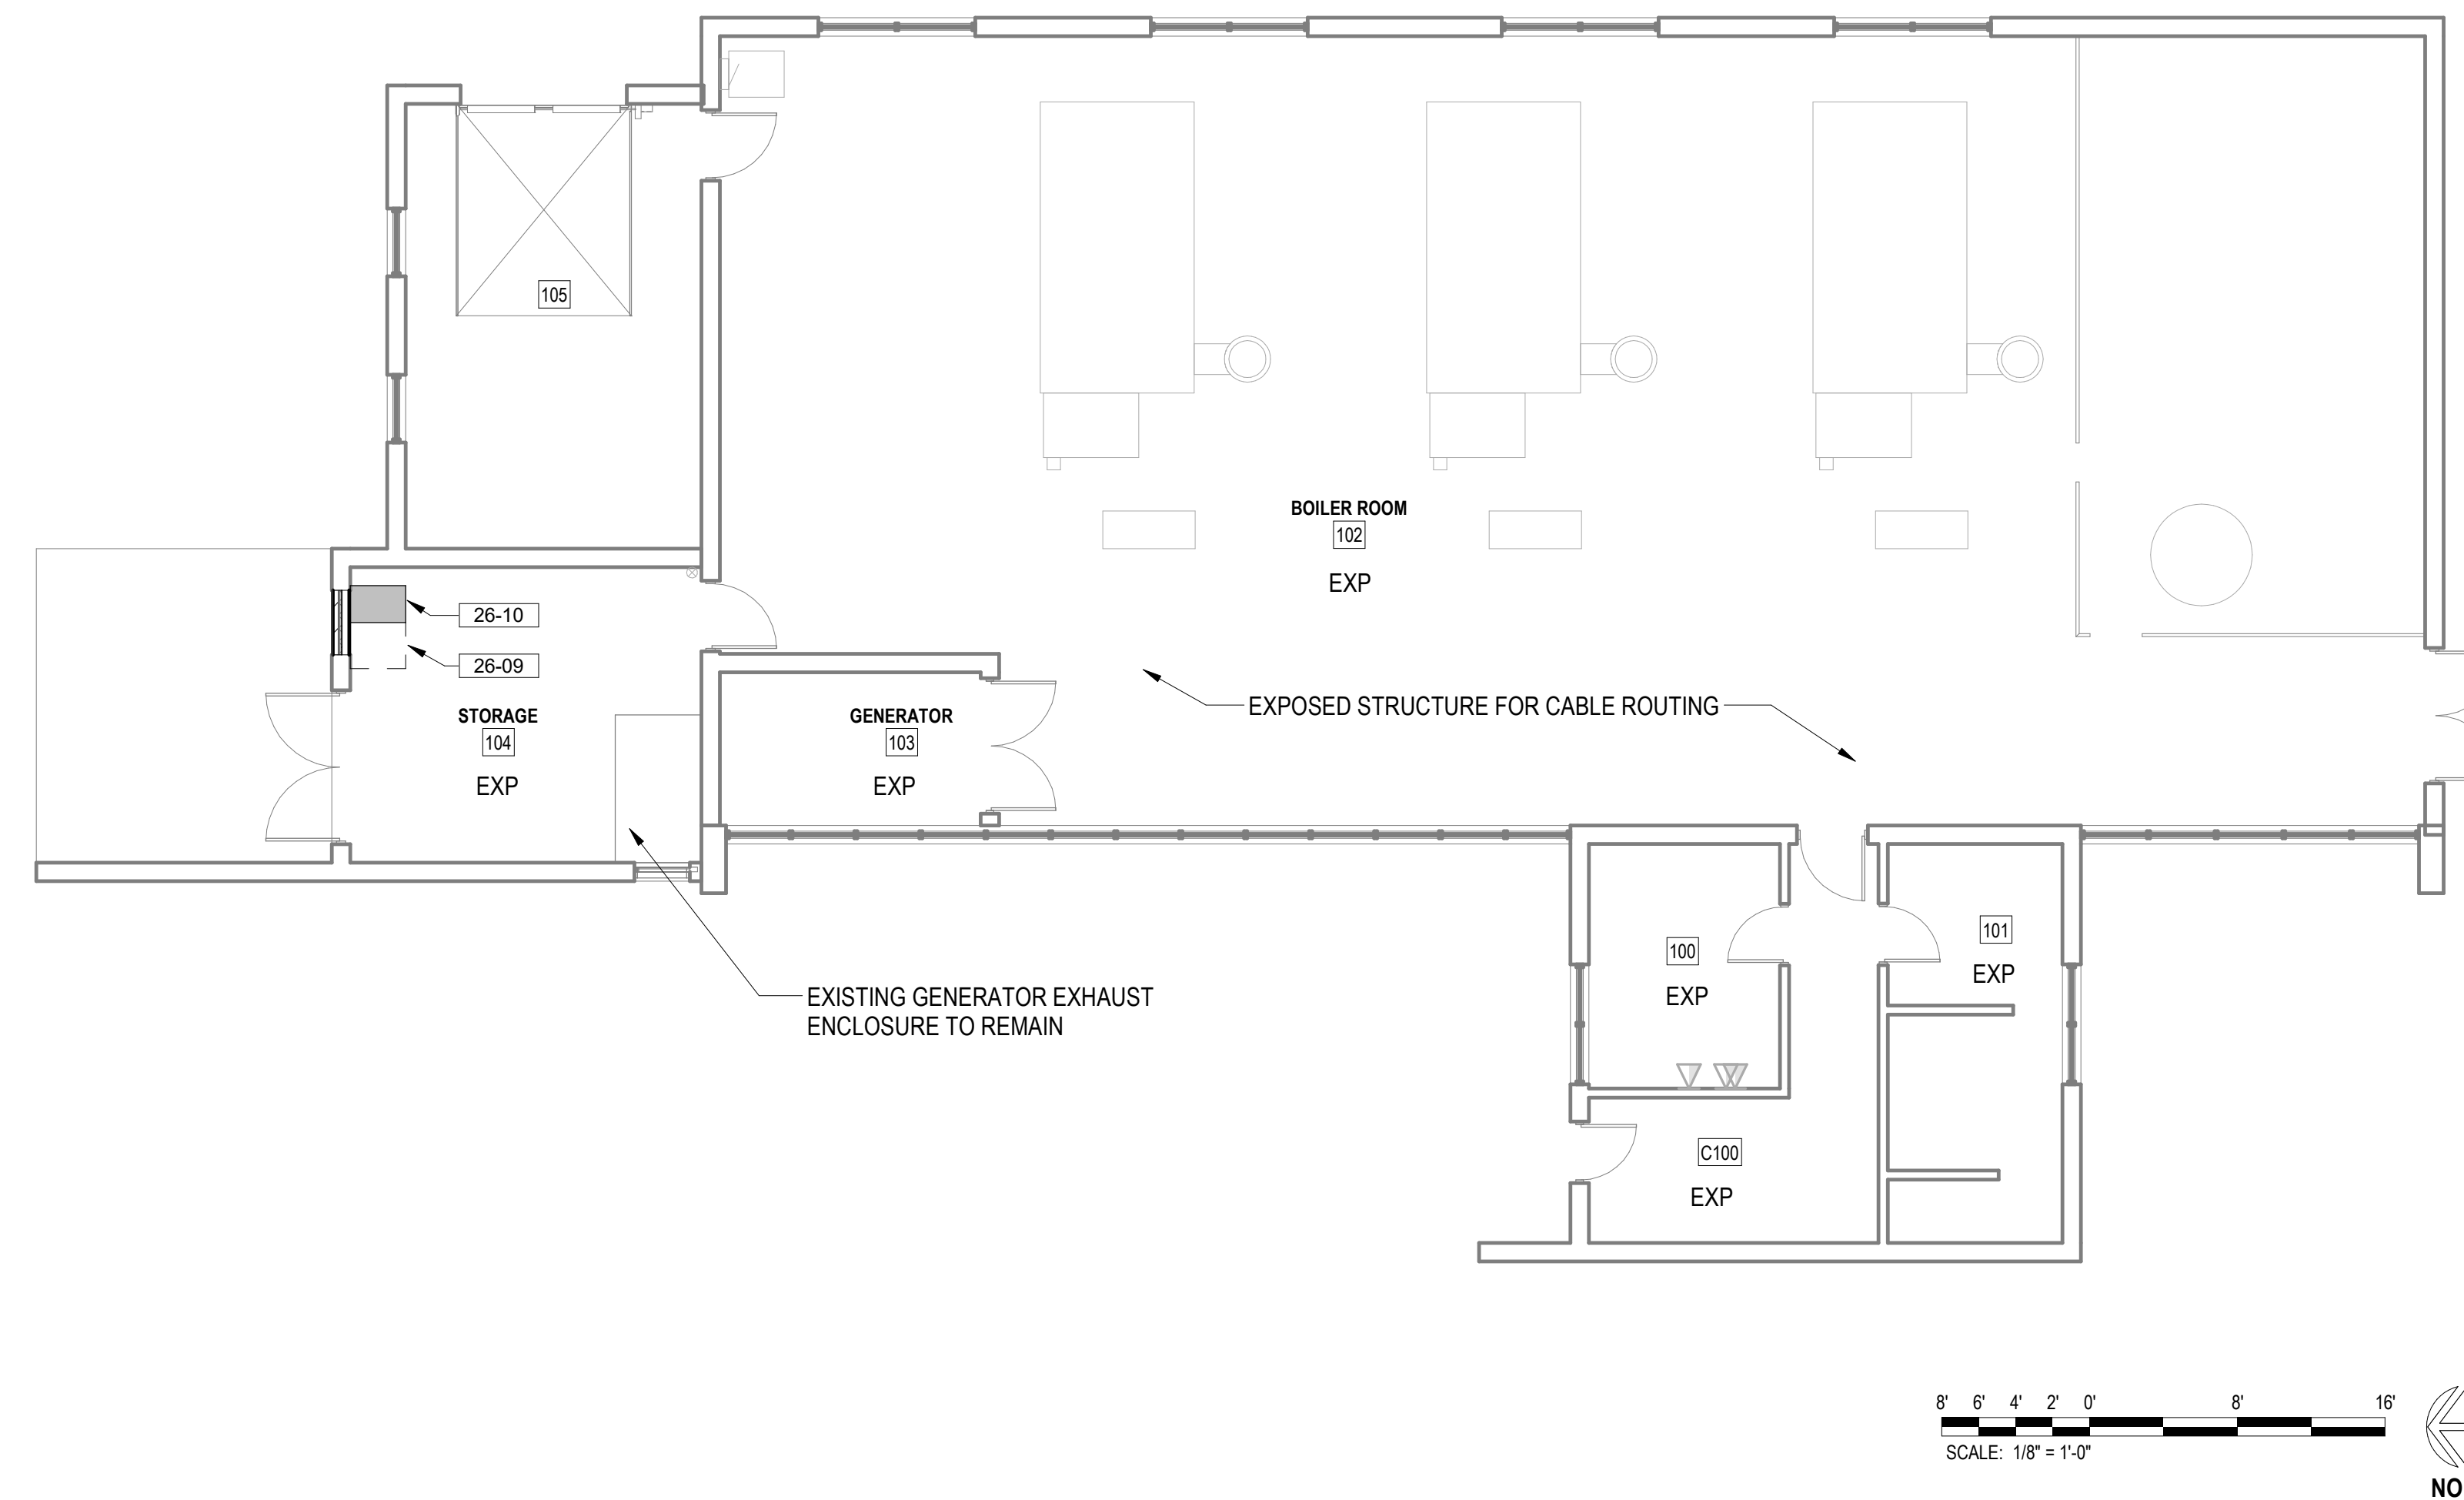

1 LEVEL 1 FLOOR PLAN
1/8" = 1'-0"

PROJECT KEY PLAN

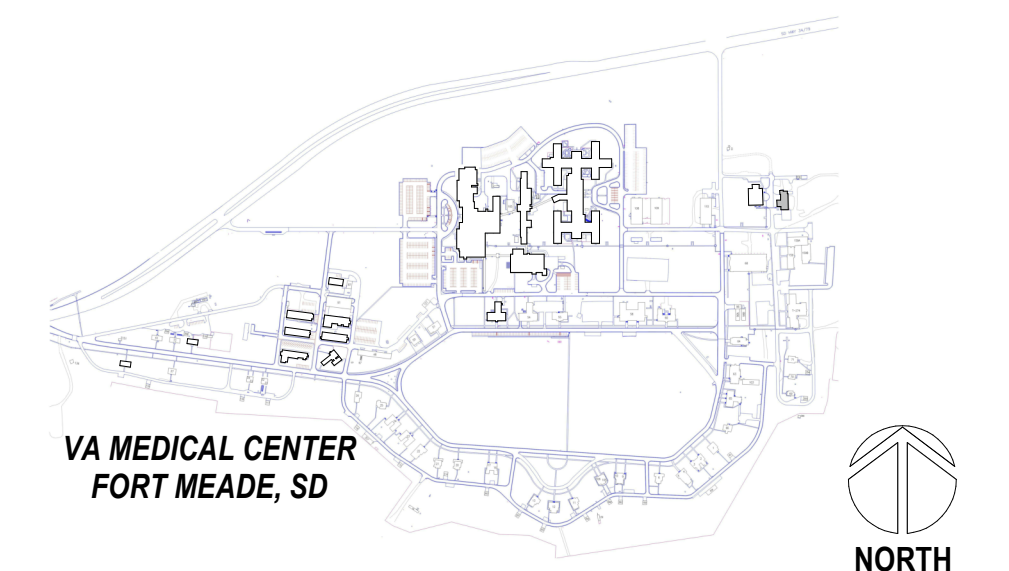

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
CONSULTANT

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ADAM GODDIN, PE




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STAMP



PROGRAM CONTRACTING ACTIVITY CENTRAL (PCAC)

VA U.S. Department of Veterans Affairs

DRAWING TITLE
137-FLOOR PLANS

APPROVED: Project Director

PHASE
100% CONSTRUCTION DOCUMENTS

FLS
FULLY SPRINKLERED

PROJECT TITLE
EHRM INFRASTRUCTURE UPGRADES

LOCATION
FORT MEADE, SOUTH DAKOTA

ISSUE DATE: 04/15/2022
CHECKED BY: TMP
DRAWN BY: JPR

PROJECT NUMBER
568-21-701

BUILDING NUMBER
BLDG 137

DRAWING NUMBER
137-AE-200

FLOOR PLAN LEGEND

- CARD READER, REF TELECOM DRAWINGS
- DATA PORT, REF TELECOM DRAWINGS
- OUTLET, REF ELEC DRAWINGS
- WIRELESS ACCESS POINT, REF TELECOM DRAWINGS
- ELEC PANEL, REF ELEC DRAWINGS
- STRIP LIGHT FIXTURE, REF ELEC DRAWINGS

FLOOR PLAN NOTES

1. SEE G SERIES SHEETS FOR BALANCE OF FLOOR PLAN GENERAL NOTES.
2. REFER TO STRUCTURAL, MECHANICAL, AND ELECTRICAL DRAWINGS FOR ADDITIONAL INFORMATION. ALL INFORMATION REGARDING EXISTING CONDITIONS IS BASED UPON OWNER-SUPPLIED DOCUMENTS AND MAY NOT PRECISELY REFLECT FIELD CONDITIONS.
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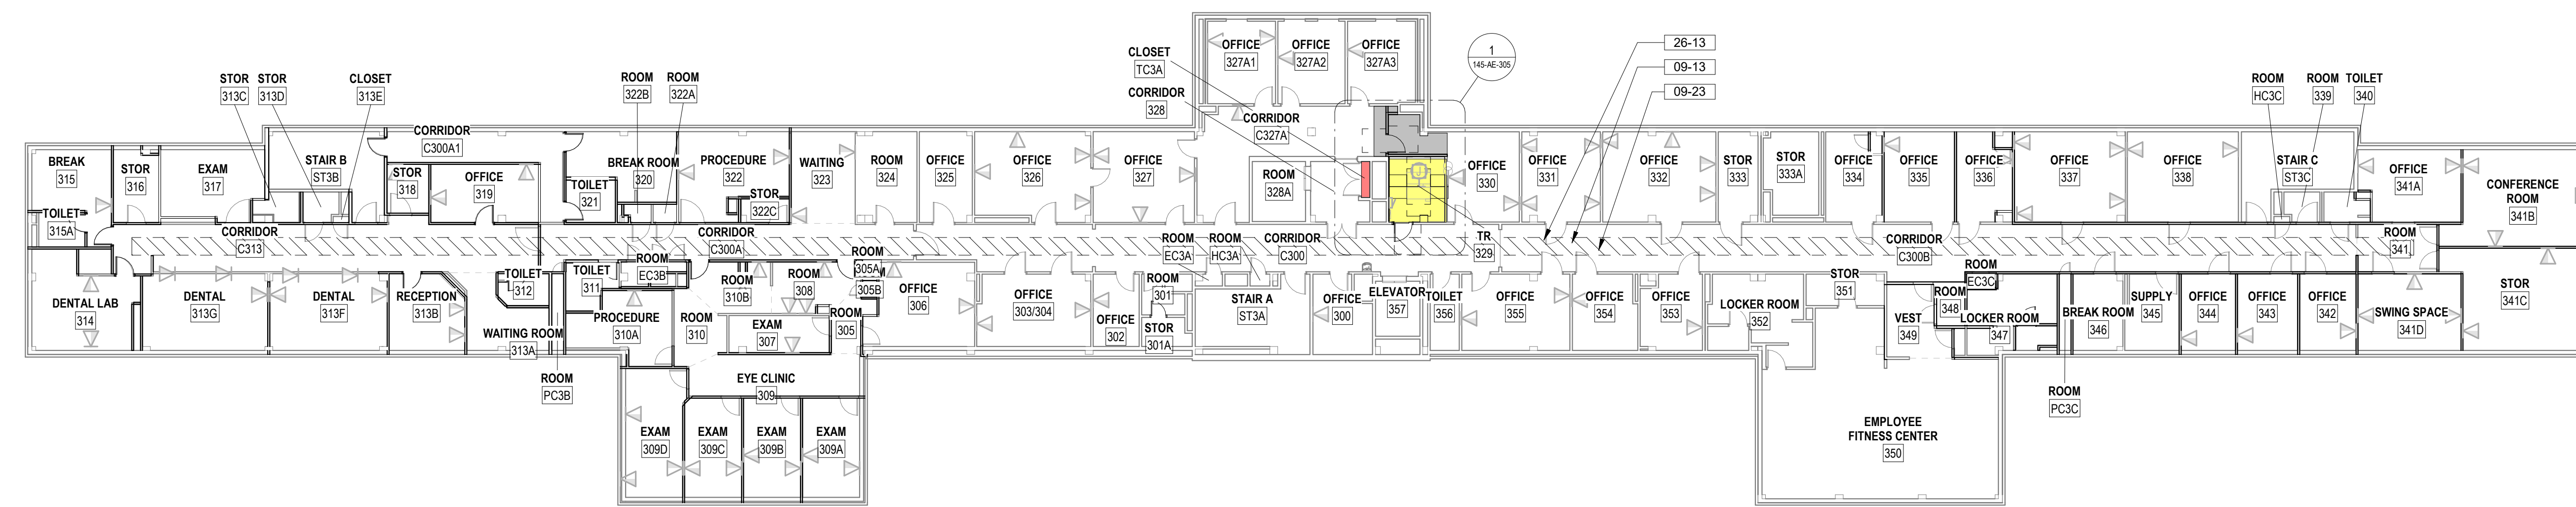
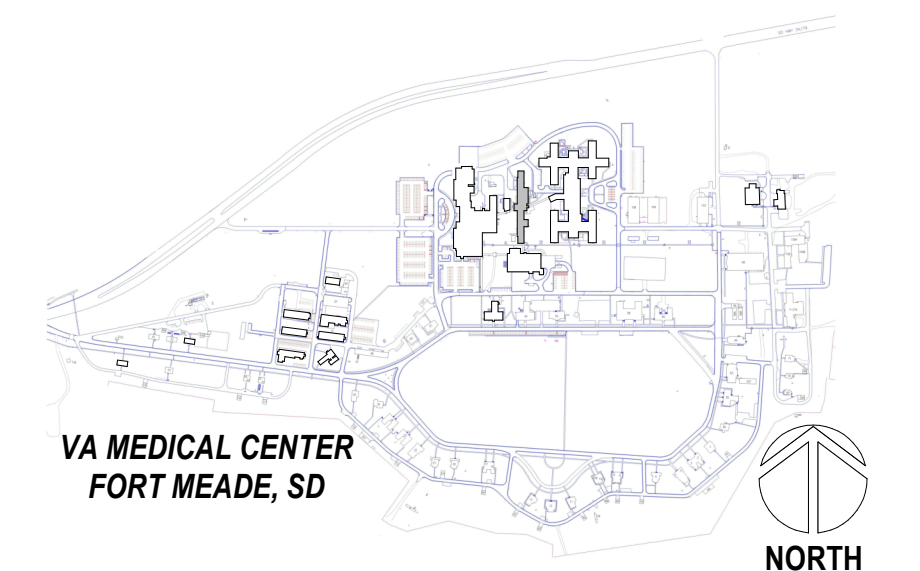
KEY NOTES

- 03-01 NEW HOUSEKEEPING PAD, COORDINATE WITH MECHANICAL DRAWINGS FOR SIZE AND CIVIL DRAWINGS FOR DETAILS
- 09-13 FOLLOW EXISTING CABLE ROUTING FOR REMOVAL OF EXISTING CABLE AND INSTALLATION OF NEW CABLES AT LOCATIONS AS NOTED IN TELECOM DRAWINGS
- 09-23 RE-INSTALL STORED FLOOR TILES, REPLACE MISSING OR DAMAGED TILES TO MATCH EXISTING
- 23-05 MECHANICAL UNITS, SEE MECH DRAWINGS FOR SIZE AND SPECS
- 23-06 NEW REFRIGERANT PIPE LINES ROUTING SHOWN FOR REFERENCE ONLY. SEE MECHANICAL DRAWINGS FOR ACTUAL ROUTING. CONTRACTOR TO REMOVE CEILING TILES ALONG ROUTE OUTSIDE OF TRS AND REPLACE WITHIN WORKING SHIFT. CONDUCT INFECTION PREVENTION MEASURES AS SPECIFIED.
- 26-13 NEW CABLE TRAY ROUTING SHOWN FOR REFERENCE ONLY. SEE TELECOMMUNICATION DRAWINGS FOR ACTUAL ROUTING. CONDUCT INFECTION PREVENTION MEASURES AS SPECIFIED.


ROOM ALLOCATION LEGEND

- PROPOSED NEW CABINET / TR / MCR LOCATION
- PROPOSED EXPANSION TO TR
- EXISTING TR WITH POWER AND FIBER UPGRADES, SEE TELECOM AND ELECTRICAL DRAWINGS
- ABANDONED ROOM
- ROOM TO REMAIN, NO WORK
- REMODEL REQUIRED DUE TO EHRM IMPACT


PROJECT KEY PLAN



3 LEVEL 3 FLOOR PLAN
1/16" = 1'-0"

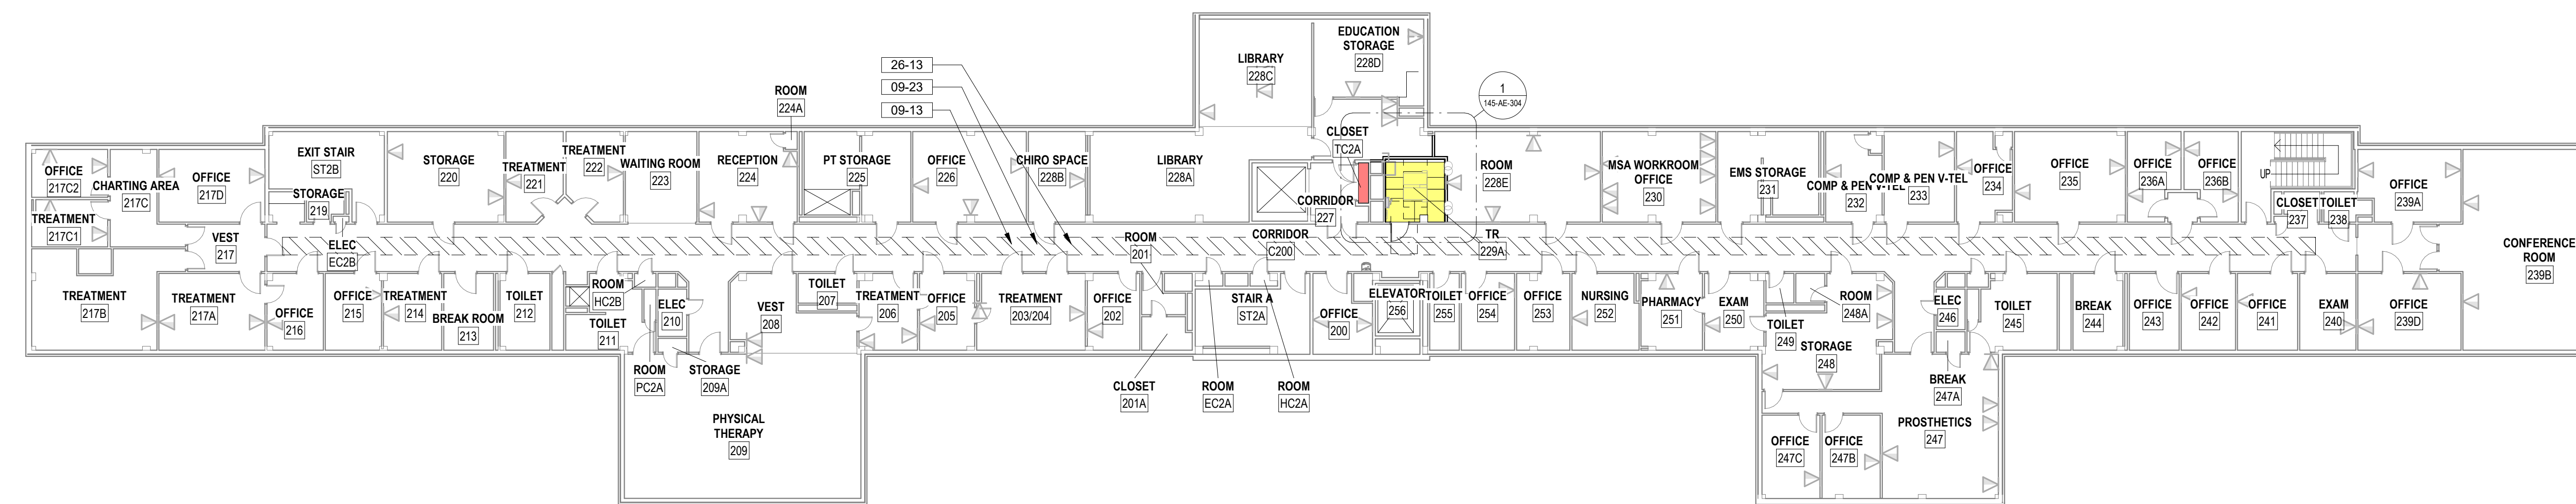

2 LEVEL 2 FLOOR PLAN
1/16" = 1'-0"

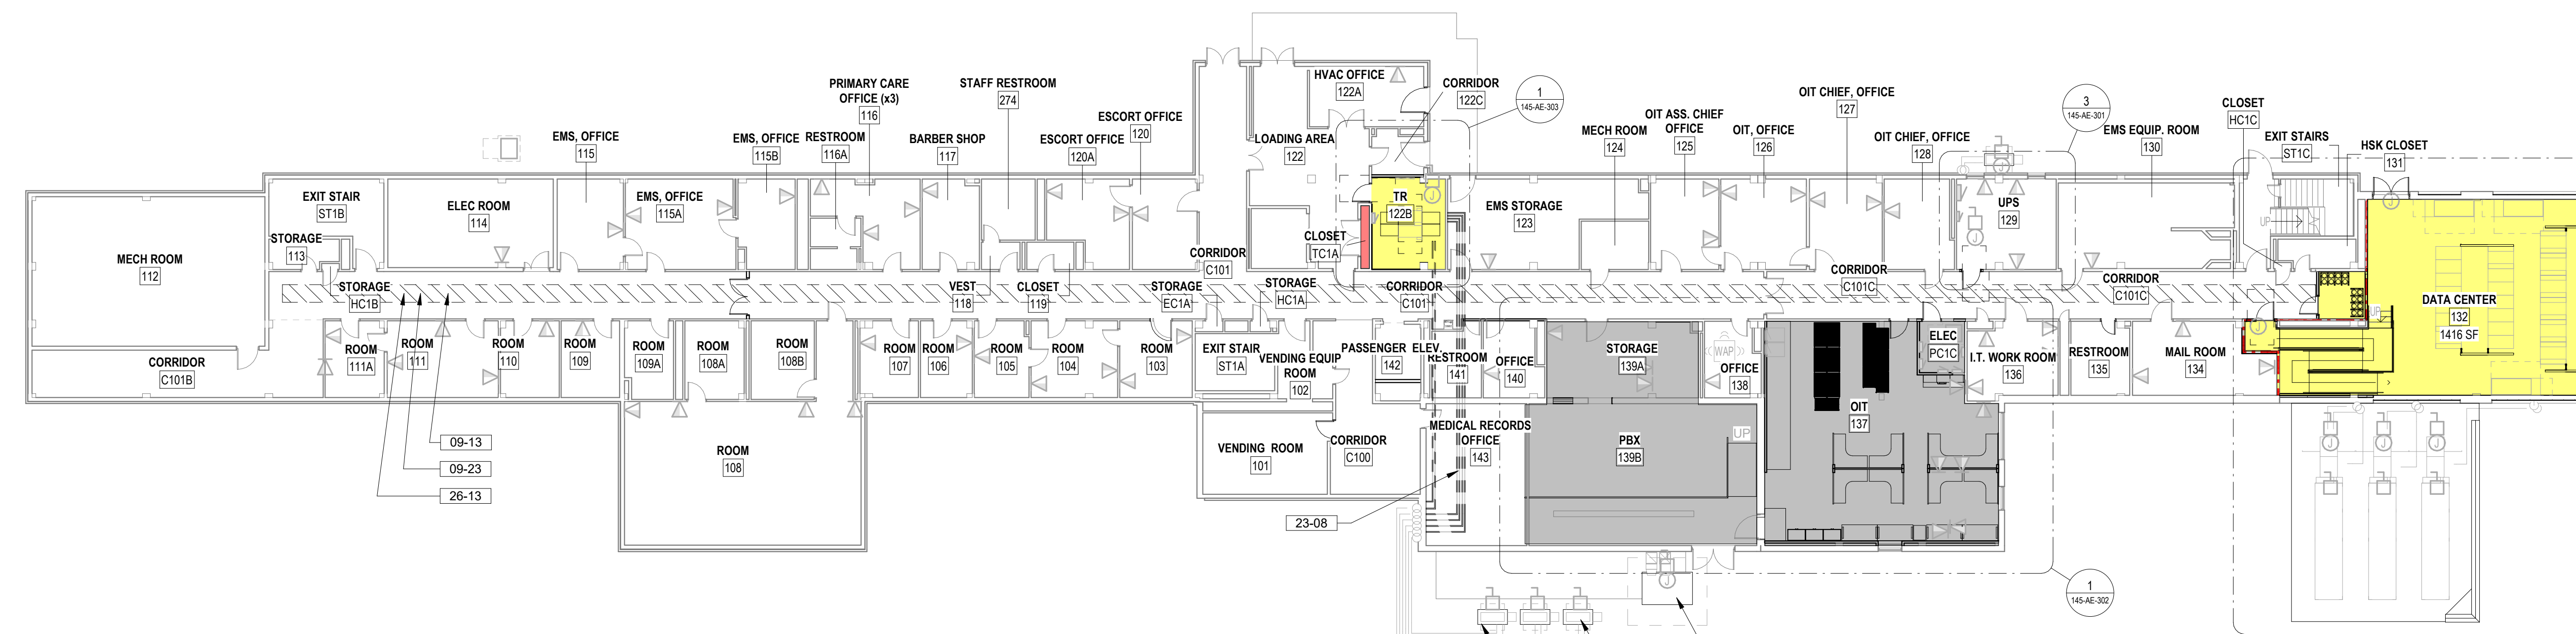

1 LEVEL 1 FLOOR PLAN
1/16" = 1'-0"

Revisions:	Date:

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STAMP

PROGRAM CONTRACTING ACTIVITY CENTRAL (PCAC)
U.S. Department of Veterans Affairs

DRAWING TITLE
145 - LEVEL 1, LEVEL 2, AND LEVEL 3 FLOOR PLANS
APPROVED: Project Director

PHASE
100% CONSTRUCTION DOCUMENTS
FLS
FULLY SPRINKLERED

PROJECT TITLE
EHRM INFRASTRUCTURE UPGRADES
LOCATION
FORT MEADE, SOUTH DAKOTA
ISSUE DATE
04/15/2022
CHECKED BY
TMP
DRAWN BY
JPR

PROJECT NUMBER
568-21-701
BUILDING NUMBER
BLDG 145
DRAWING NUMBER
145-AE-201

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VA FORM 08 - 6231

FLOOR PLAN LEGEND

- CARD READER, REF TELECOM DRAWINGS
- DATA PORT, REF TELECOM DRAWINGS
- OUTLET, REF ELEC DRAWINGS
- WIRELESS ACCESS POINT, REF TELECOM DRAWINGS
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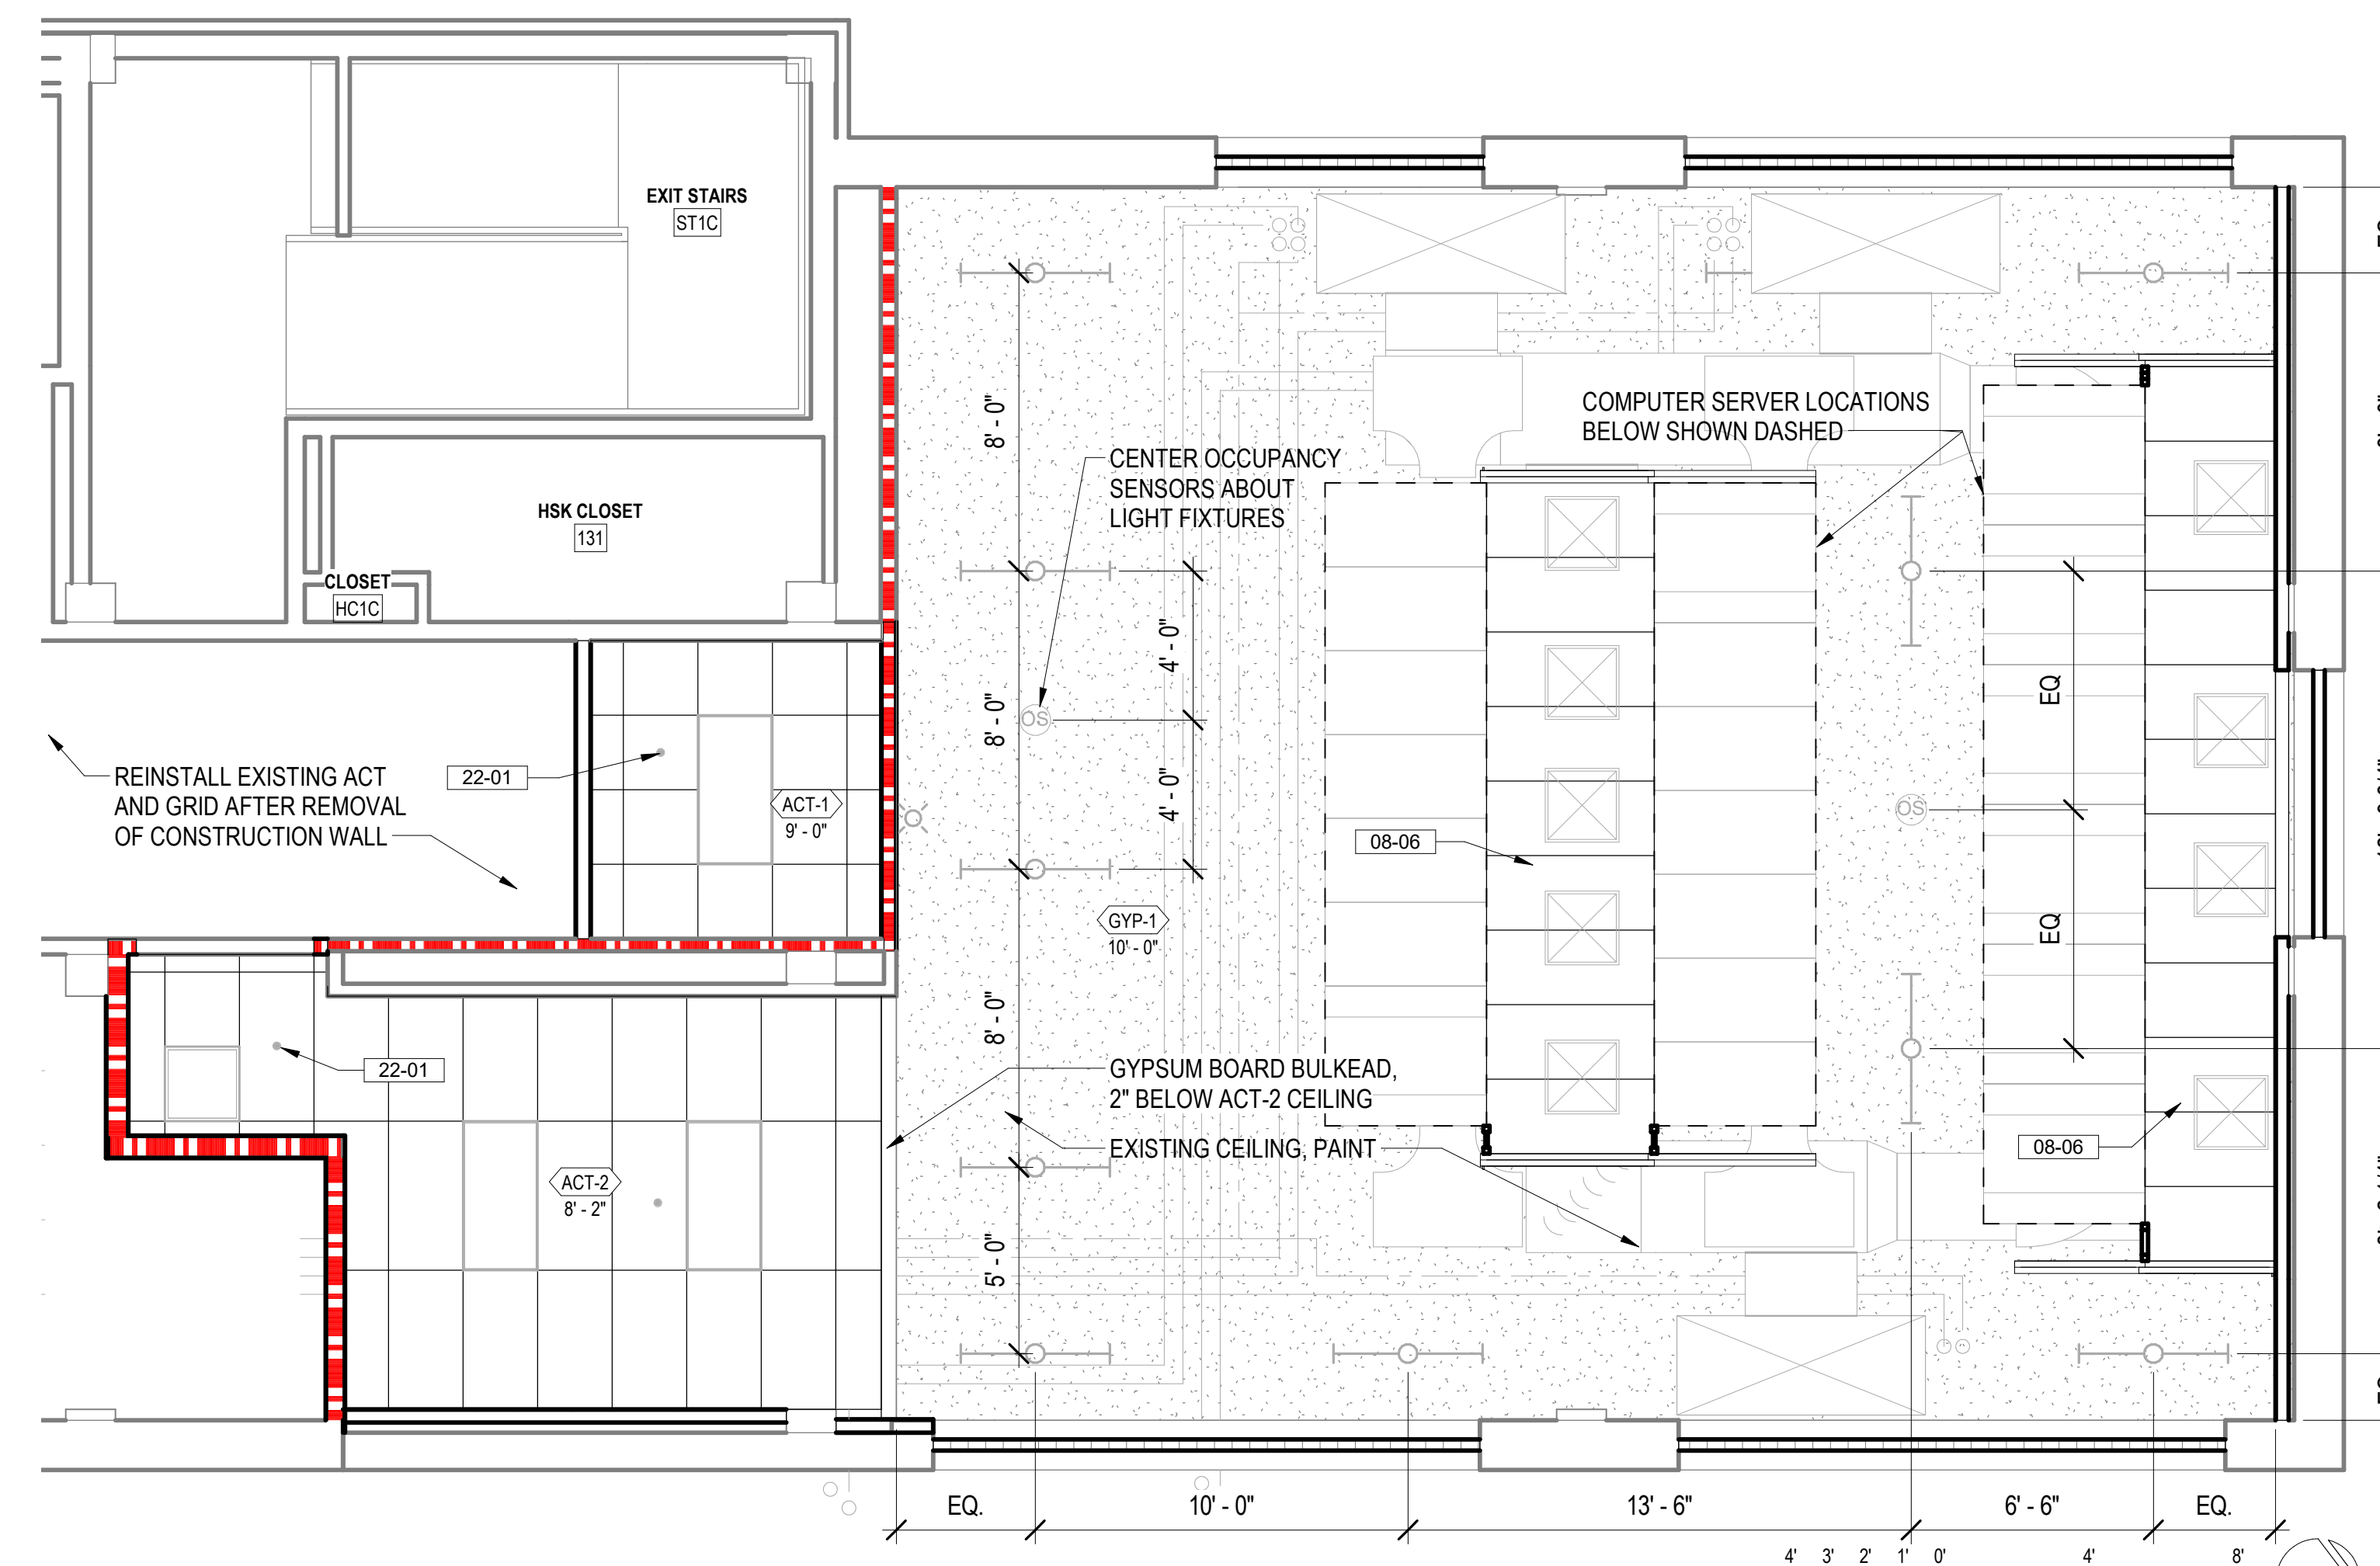
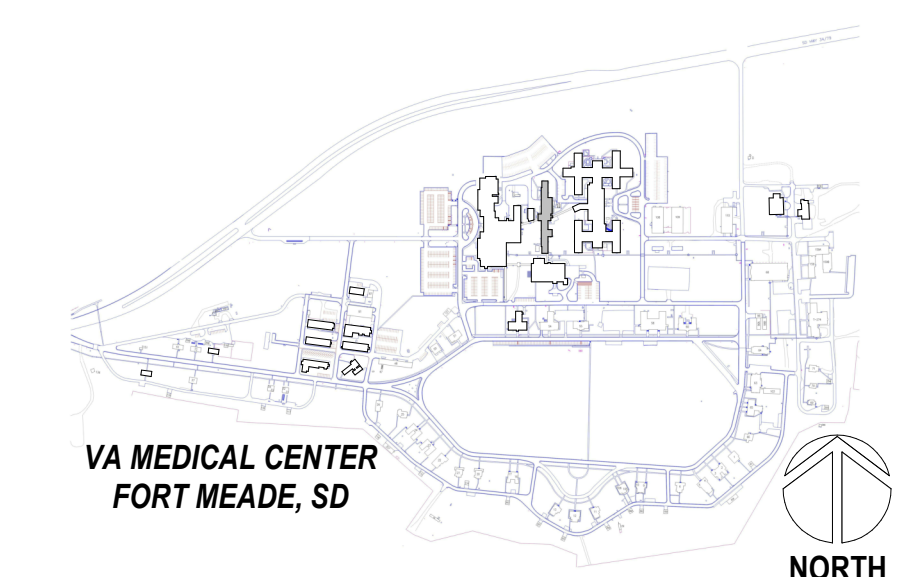
REFLECTED CEILING PLAN LEGEND

- 2x2 LIGHT FIXTURE
- 2x4 LIGHT FIXTURE
- STRIP LIGHT FIXTURE
- 6" RECESSED CAN LIGHT FIXTURE
- SUPPLY AIR DIFFUSER
- RETURN AIR VENT
- EXHAUST FAN
- 5/8" GYP. BOARD CEILING AFFIXED TO 3 5/8" MTL STUDS
- 2'x2' SUSPENDED ACOUSTIC CEILING TILE CEILING
- 2'x4' SUSPENDED ACOUSTIC CEILING TILE CEILING

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- REFER TO MECHANICAL SHEETS FOR DIFFUSER AND DUCTING LAYOUTS.
- SEE SHEET 00-G-006 FOR TYPICAL ACOUSTICAL PANEL CEILING DETAILS

PROJECT KEY PLAN



2 LEVEL 1 -MCR REFLECTED CEILING PLAN


1/4" = 1'-0"

LIFE SAFETY LEGEND

- 1-HOUR FIRE WALL
- 2-HOUR FIRE WALL
- 1-HOUR FIRE/SMOKE WALL
- SMOKE RESISTIVE HAZARDOUS AREA


KEYNOTES

- 02-07 CORE DRILL EXISTING WALL AND PREPARE FOR PLUMBING PIPE INSTALLATION. COORDINATE WITH MECHANICAL DRAWINGS. SEAL AND MAINTAIN WALL ENVELOPE AND INTEGRITY AFTER COMPLETION OF WORK
- 03-01 NEW HOUSEKEEPING PAD, COORDINATE WITH MECHANICAL DRAWINGS FOR SIZE AND CIVIL DRAWINGS FOR DETAILS
- 04-01 12" X 12" GLASS BLOCK INFILL AT EXISTING WINDOW OPENINGS
- 05-02 SECURITY GRILL 2" X 2" X 16GA WIRE MESH WELDED TO 1 1/2" X 1 1/4" X 13GA ROLL FORMED ANGLE FRAME. PROVIDE 3" CLIPS, ANCHOR DIRECTLY ONTO EXISTING WALL. CONTRACTOR TO VERIFY ACTUAL WINDOW SIZE PRIOR TO GRILL FABRICATION
- 06-06 COLD ISLE CONTAINMENT SYSTEM CEILING. SEE SPEC SECTION 08 34 00.10
- 09-03 EXTEND EXISTING GYPSUM BOARD TO UNDERSIDE OF STRUCTURE WHERE NOT INSTALLED, SEAL TO STRUCTURAL DECK
- 09-06 SEAL ALL WALL PENETRATIONS EXISTING AND NEW. PROVIDE APPROPRIATE FIRE RATED UL HILT DESIGNATION FOR PIPE AND/OR CONDUIT PENETRATIONS. SEE TYPICAL PENETRATION DETAILS FOR RATED WALL CONDITIONS.
- 09-07 INSTALL STATIC DISSIPATIVE RESILIENT FLOORING
- 09-18 6" HIGH COVERED RUBBER WALL BASE, COLOR TO BE SELECTED FROM MANUFACTURER'S STANDARD SELECTION
- 09-25 PATCH AND REPAIR ANY GYPSUM BOARD OPENINGS FOUND AT PERIMETER OF WALL. SEAL PERIMETER OF ROOM IN ITS ENTIRETY. PAINT
- 10-01 FIRE EXTINGUISHER CABINET AND FIRE EXTINGUISHER TYPE 2A:10B:C. INSTALL HANDLE NO HIGHER THAN 54" A.F.F.
- 22-01 FIRE SUPPRESSION SPRINKLER HEAD SHOWN FOR REFERENCE ONLY. FIRE SUPPRESSION CONTRACTOR TO VERIFY ACTUAL QUANTITIES REQUIRED. INSTALL SYMMETRICALLY CENTER IN TILE
- 22-02 UPRIGHT HEAD FIRE SUPPRESSION SPRINKLER HEAD SHOWN FOR REFERENCE ONLY. FIRE SUPPRESSION CONTRACTOR TO VERIFY ACTUAL QUANTITIES REQUIRED. COORDINATE INSTALLATION WITH MEPT DRAWINGS ELECTRICAL PANELS. SEE ELECTRICAL DRAWINGS
- 26-04

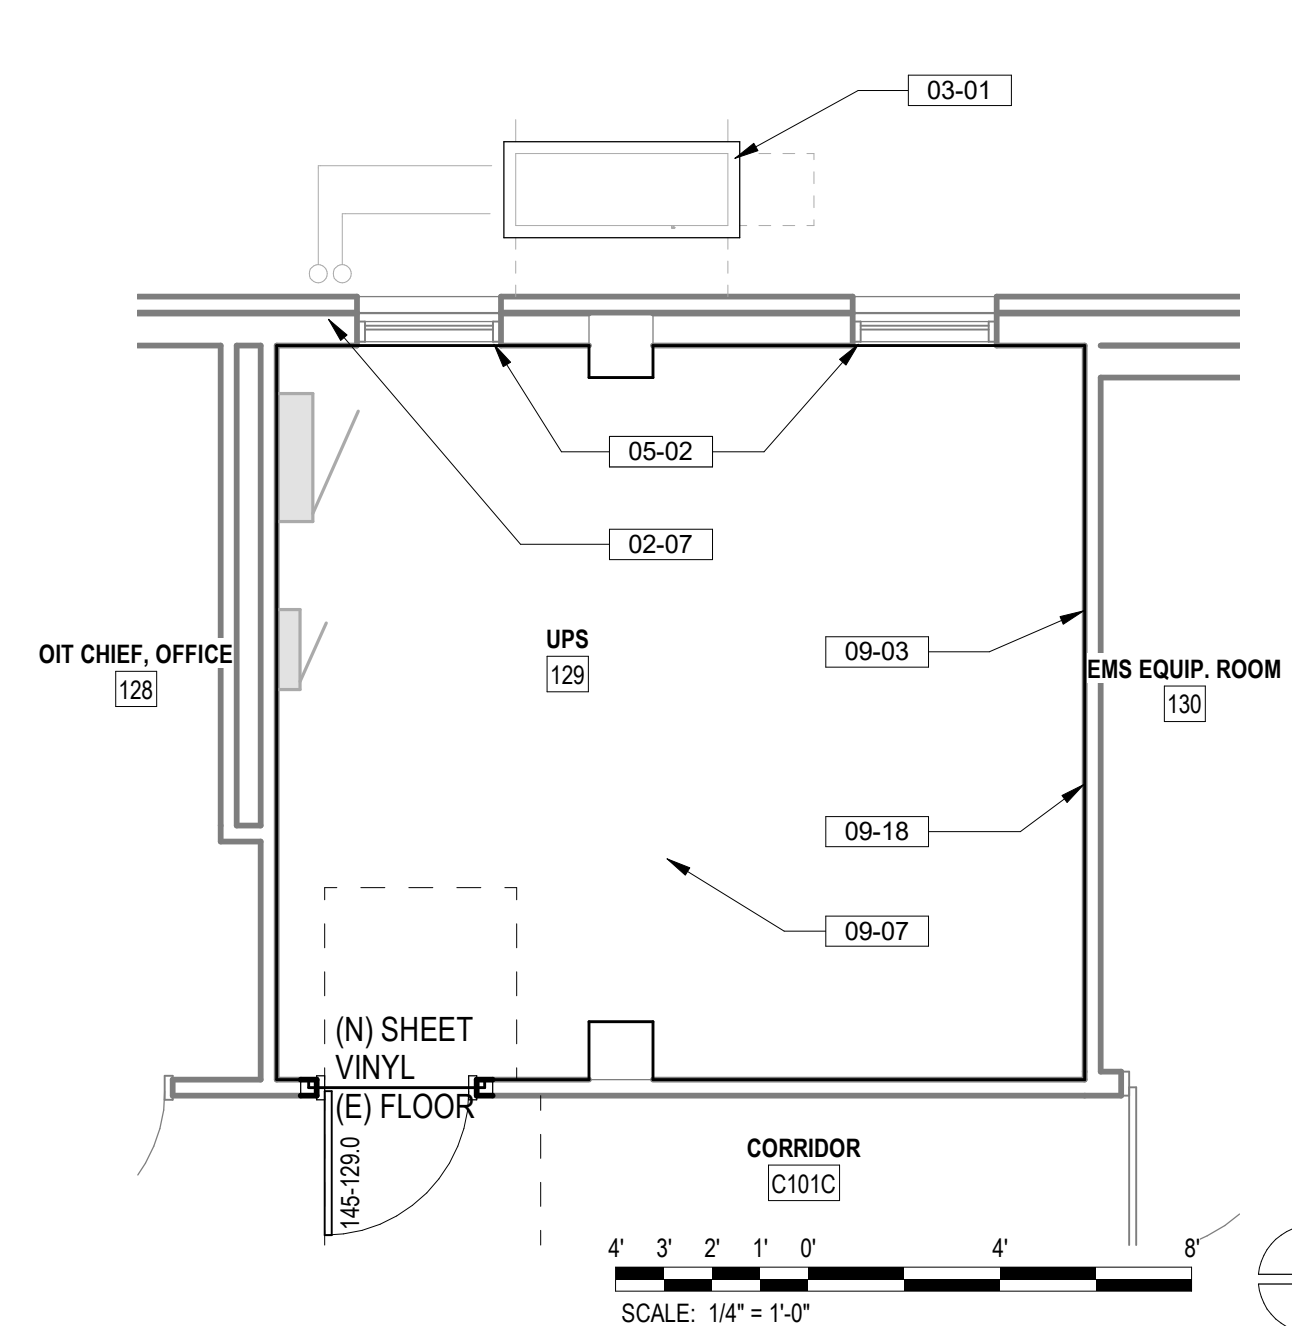


3 ENLARGED UPS FLOOR PLAN

1/4" = 1'-0"

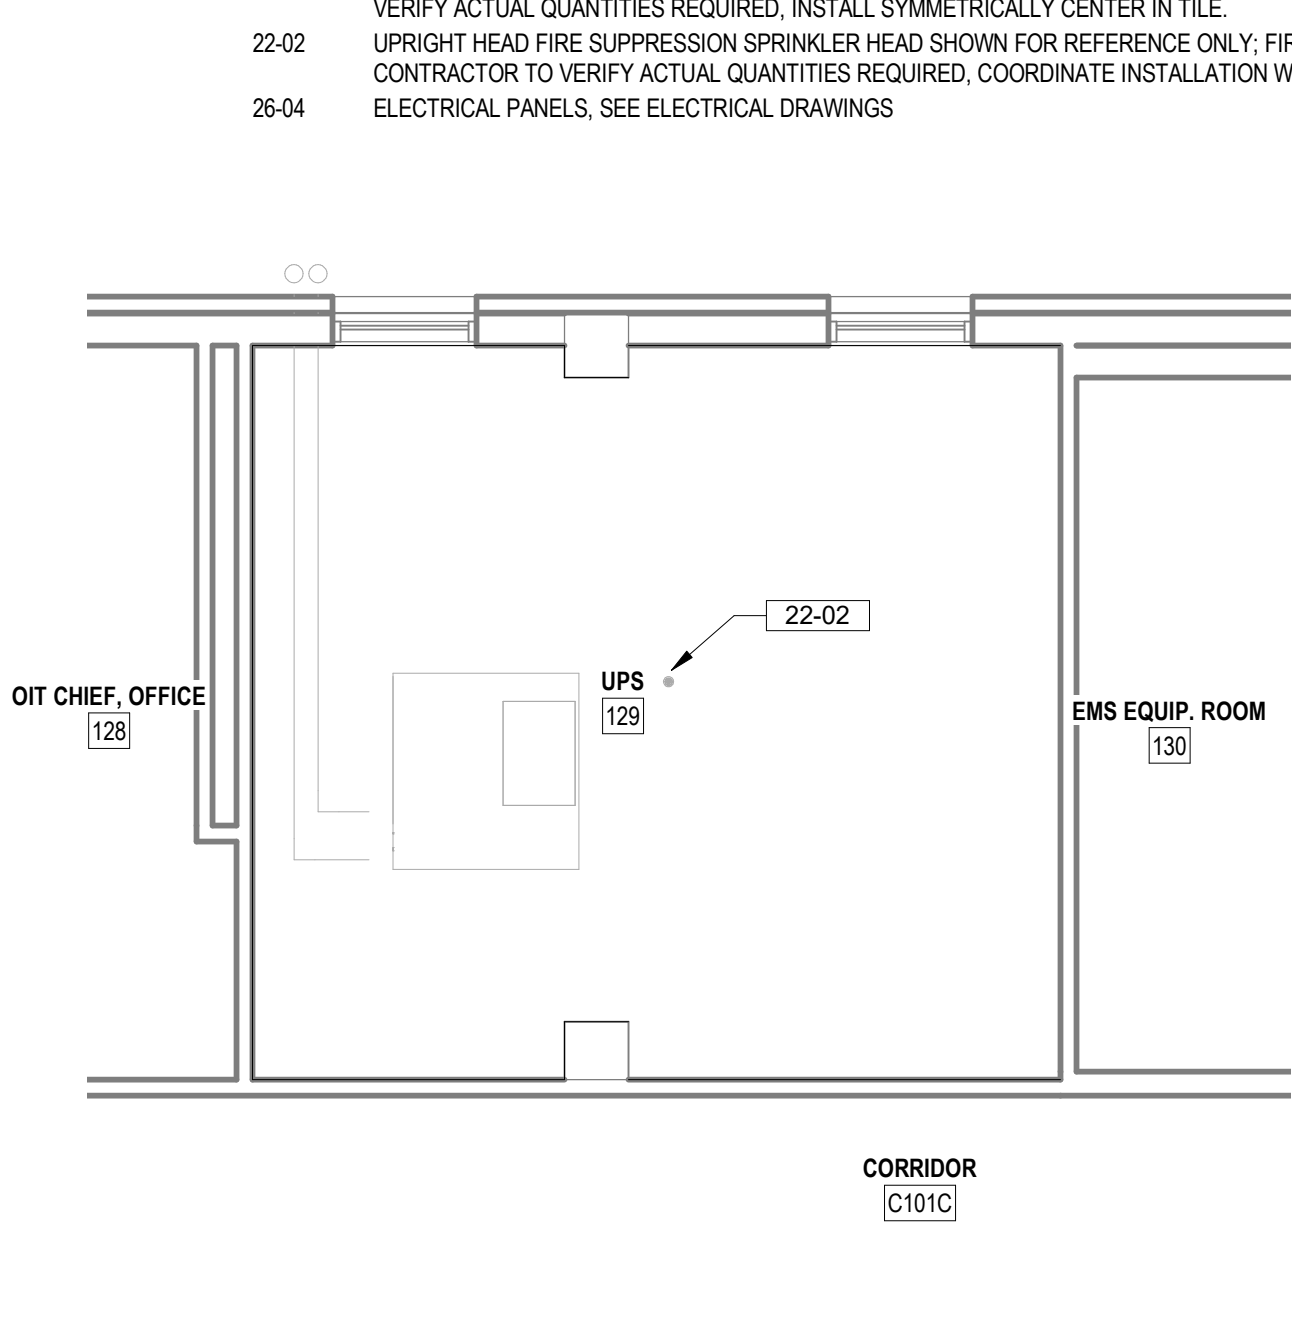

4 UPS REFLECTED CEILING PLAN

1/4" = 1'-0"

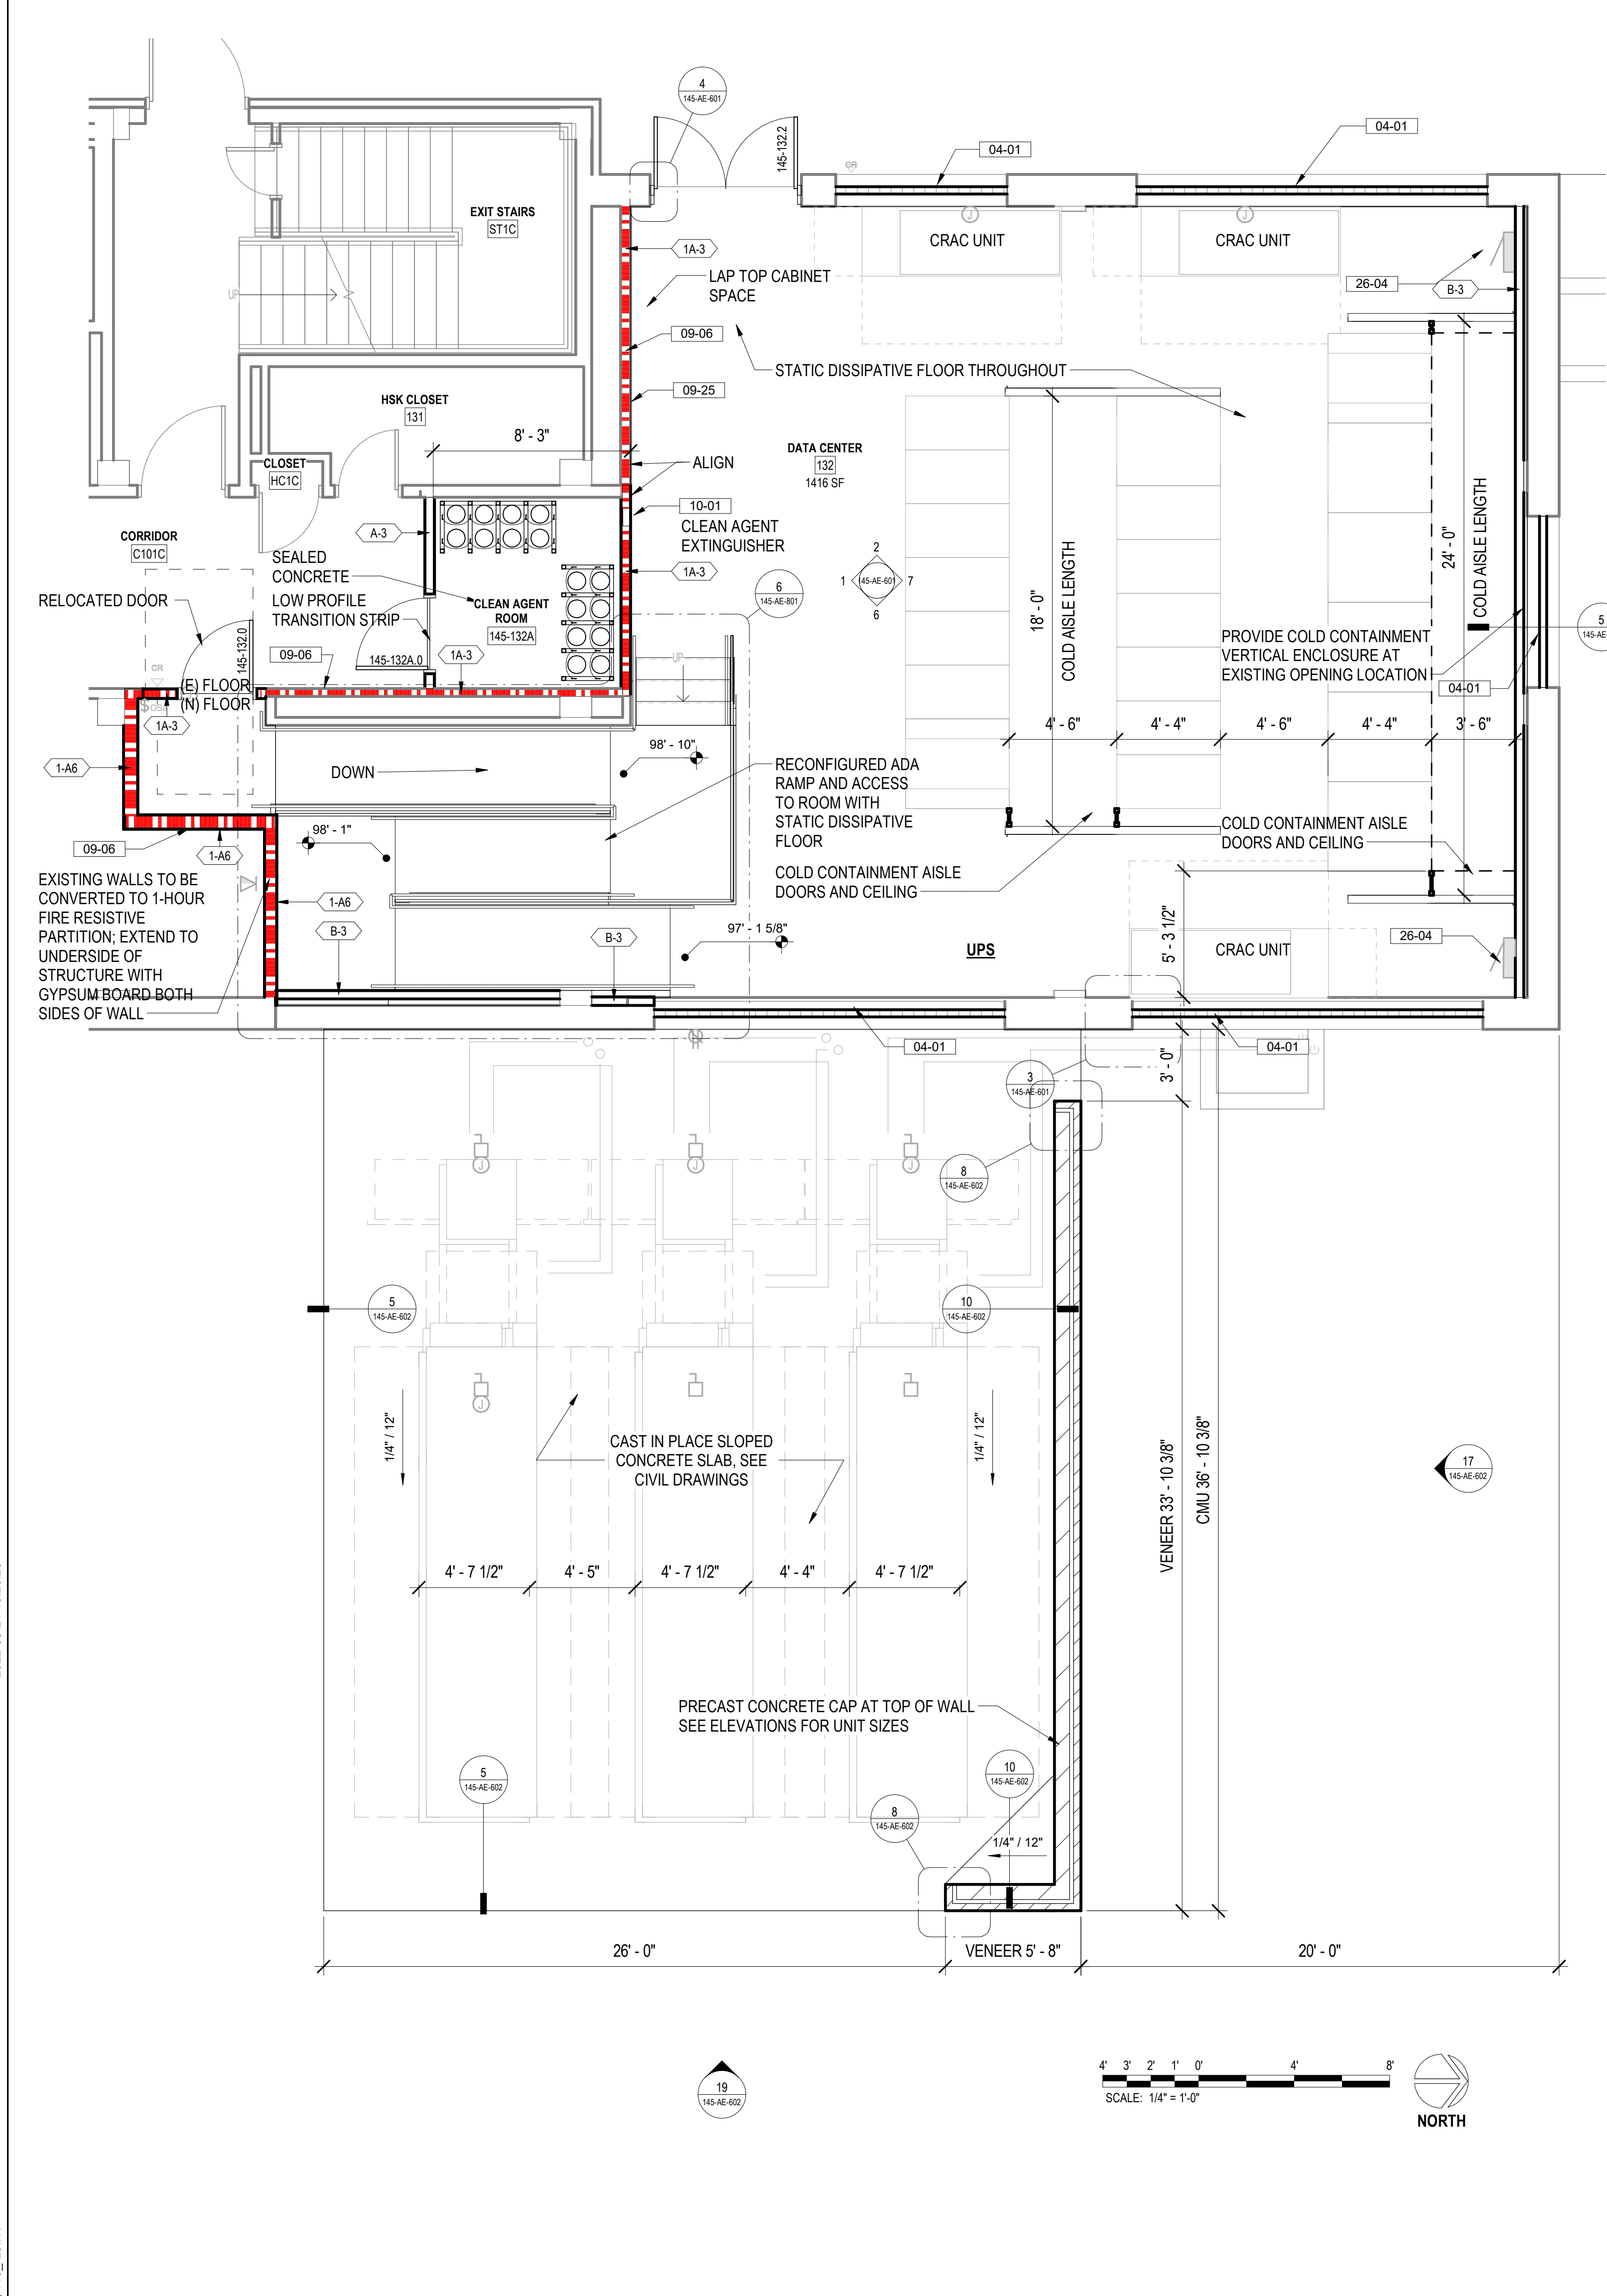

1 132 MCR ENLARGED PLAN

1/4" = 1'-0"

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VA FORM 08 - 6231

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STAMP
PROGRAM CONTRACTING ACTIVITY CENTRAL (PCAC)


PROGRAM CONTRACTING ACTIVITY CENTRAL (PCAC)
U.S. Department of Veterans Affairs

DRAWING TITLE
145-ENLARGED MCR PLANS
APPROVED: Project Director

PHASE
100% CONSTRUCTION DOCUMENTS
FLS
FULLY SPRINKLERED

PROJECT TITLE
EHRM INFRASTRUCTURE UPGRADES
LOCATION
FORT MEADE, SOUTH DAKOTA
ISSUE DATE
04/15/2022
CHECKED BY
TMP
DRAWN BY
JPR

PROJECT NUMBER
568-21-701
BUILDING NUMBER
BLDG 145
DRAWING NUMBER
145-AE-301


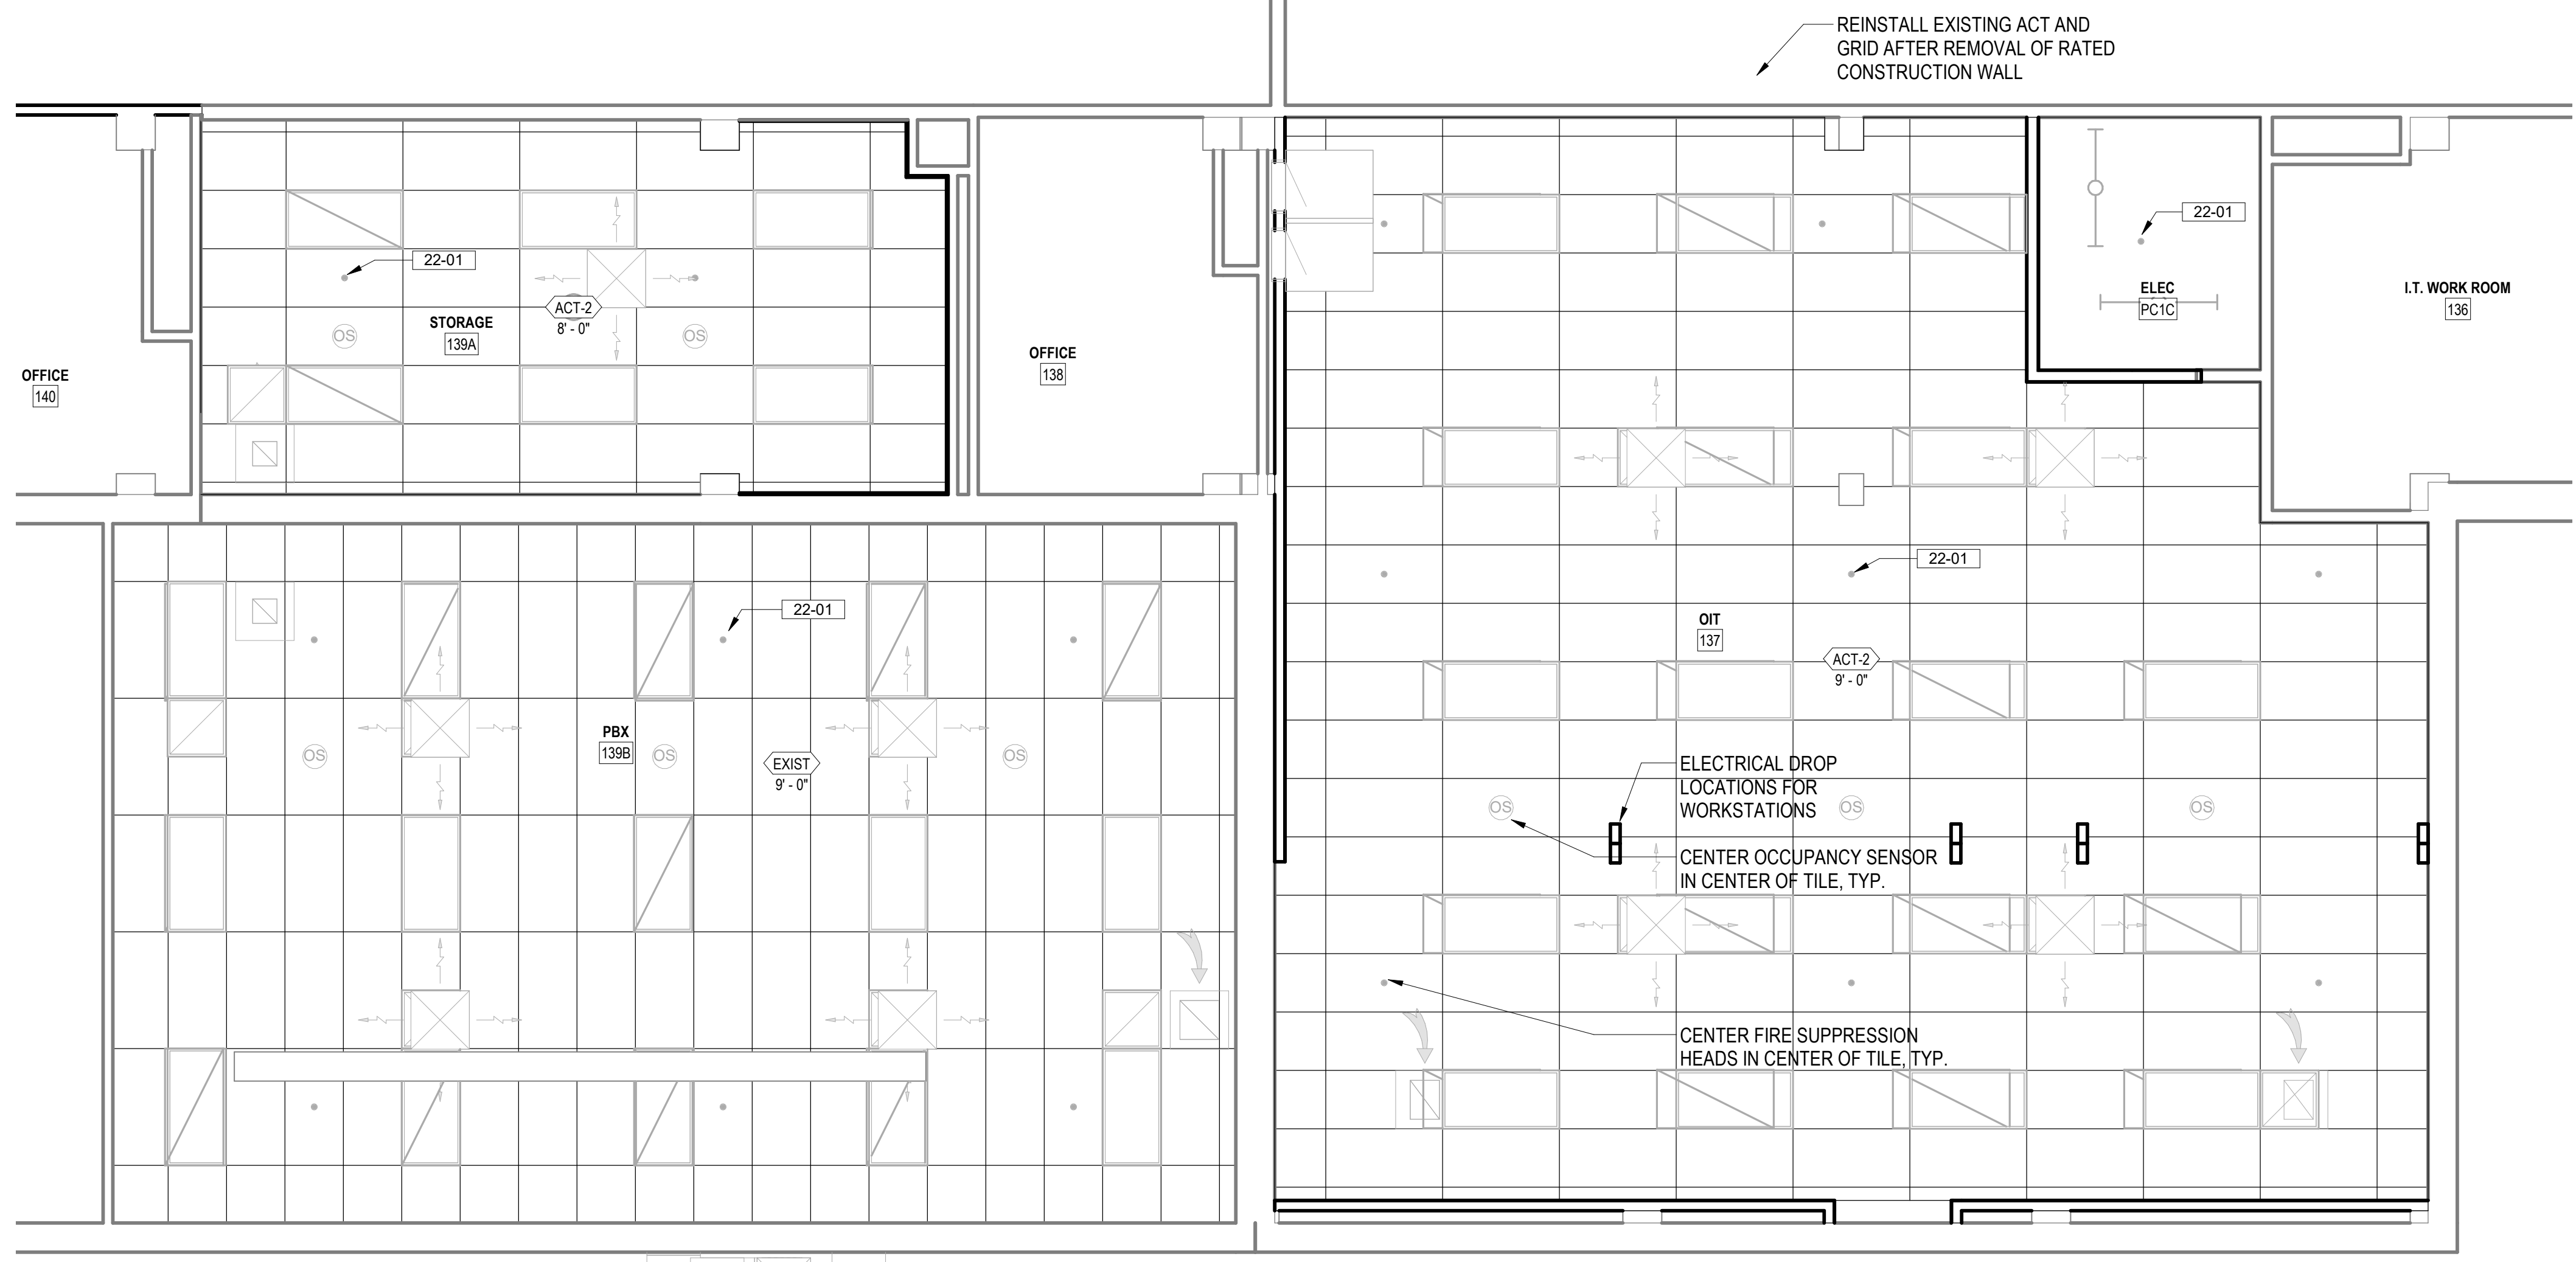


2 LEVEL 1 - OIT REFLECTED CEILING PLAN
1/4" = 1'-0"

KEYNOTES

- 02-25 CORE DRILL THROUGH FLOOR NEW PIPE OR CONDUIT INSTALLATION. APPLY APPROPRIATE HLTI FIRE RATED SEAL FOR TYPE OF PENETRATION. SEE MEP OR TELECOM DRAWINGS FOR COORDINATION.
- 05-02 SECURITY GRILL: 2' x 2' x 10GA WIRE MESH WELDED TO 1 1/2" x 1 1/4" x 13GA ROLL FORMED ANGLE FRAME; PROVIDE 3" CLIPS, ANCHOR DIRECTLY ONTO EXISTING WALL; CONTRACTOR TO VERIFY ACTUAL WINDOW SIZE PRIOR TO GRILL FABRICATION.
- 09-09 APPLY JOINT COMPOUND AND FEATHER A MINIMUM OF 3" HORIZONTALLY AS REQUIRED TO ACHIEVE A SMOOTH AND UNIFORM APPEARANCE.
- 09-18 6" HIGH COVED RUBBER WALL BASE, COLOR TO BE SELECTED FROM MANUFACTURERS STANDARD SELECTION.
- 09-29 INSTALL NEW FLOORING TO MATCH EXISTING.
- 22-01 FIRE SUPPRESSION SPRINKLER HEAD SHOWN FOR REFERENCE ONLY; FIRE SUPPRESSION CONTRACTOR TO VERIFY ACTUAL QUANTITIES REQUIRED, INSTALL SYMMETRICALLY CENTER IN TILE.

CASEWORK TYPE LEGEND

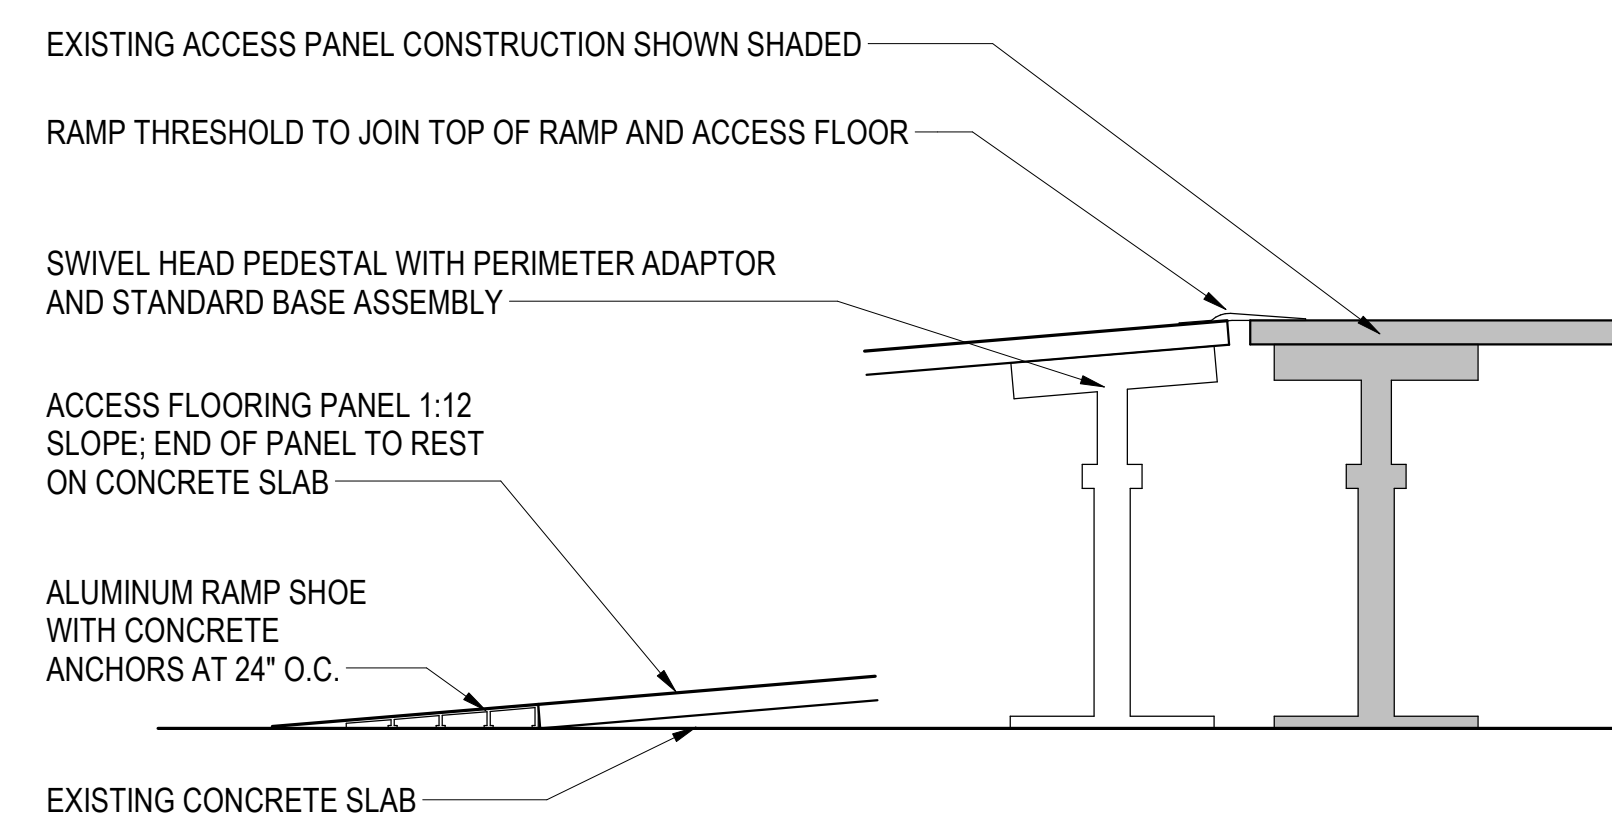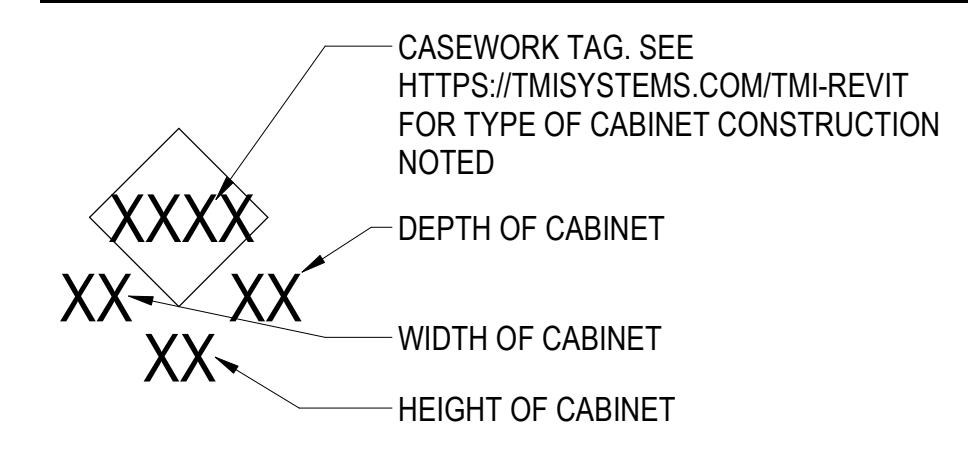

5 BASE OF RAMP DETAIL
3" = 1'-0"

FLOOR PLAN LEGEND

- CARD READER, REF TELECOM DRAWINGS
- ⏏ DATA PORT, REF TELECOM DRAWINGS
- ⏏ OUTLET, REF ELEC DRAWINGS
- ⏏ WIRELESS ACCESS POINT, REF TELECOM DRAWINGS
- ⏏ ELEC PANEL, REF ELEC DRAWINGS
- STRIP LIGHT FIXTURE, REF ELEC DRAWINGS

FLOOR PLAN NOTES

1. SEE G SERIES SHEETS FOR BALANCE OF FLOOR PLAN GENERAL NOTES.
2. REFER TO STRUCTURAL, MECHANICAL, AND ELECTRICAL DRAWINGS FOR ADDITIONAL INFORMATION. ALL INFORMATION REGARDING EXISTING CONDITIONS IS BASED UPON OWNER-SUPPLIED DOCUMENTS AND MAY NOT PRECISELY REFLECT FIELD CONDITIONS.
3. PROVIDE ALL BACKING FOR MILLWORK, GRAB BARS, AND ANY AND ALL WALL MOUNTED EQUIPMENT OR ACCESSORIES; COORDINATE LOCATIONS.
4. ALL DIMENSIONS ARE FROM STRUCTURAL OR UNFINISHED FACE OF STUD, UNLESS OTHERWISE NOTED.
5. PROVIDE A SMOOTH AND LEVEL FINISH FLOOR, TYP. PATCH AND REPAIR ALL INCONSISTENCIES IN FLOOR ELEVATIONS.
6. PATCH AND REPAIR ANY / ALL WALL SURFACES AS REQUIRED TO PROVIDE SUITABLE SUBSTRATE FOR FINISHES.
7. REFER TO DOOR AND FRAME SCHEDULE FOR DOORS REQUIRING ADA ACCESS CONTROL.
8. PROVIDE ACOUSTICAL SEALANT AROUND WALL EDGES, TOP AND BOTTOM, AND PENETRATIONS, AND INSTALL PUTTY PADS AROUND ELECTRICAL BOXES WHERE PARTITION CONTAINS ACOUSTICAL INSULATION.
9. ALL TELECOMMUNICATION ROOMS ARE TO HAVE EXPOSED STRUCTURE UNLESS NOTED OTHERWISE, NO CEILINGS SPECIFIED.



REFLECTED CEILING PLAN LEGEND

- 2x2 LIGHT FIXTURE
- 2x4 LIGHT FIXTURE
- STRIP LIGHT FIXTURE
- 6" RECESSED CAN LIGHT FIXTURE
- ⊠ SUPPLY AIR DIFFUSER
- ⊠ RETURN AIR VENT
- ⊠ EXHAUST FAN
- ⊠ 5/8" GYP. BOARD CEILING AFFIXED TO 3 5/8" MTL STUDS
- ⊠ 2'x2' SUSPENDED ACOUSTIC CEILING TILE CEILING
- ⊠ 2'x4' SUSPENDED ACOUSTIC CEILING TILE CEILING

REFLECTED CEILING PLAN NOTES


1. REFER TO ELECTRICAL SHEETS FOR FIXTURE TYPES, SWITCHING, AND SPECIAL SYSTEMS.
2. REFER TO MECHANICAL SHEETS FOR DIFFUSER AND DUCTING LAYOUTS.
3. SEE SHEET 00-GI-006 FOR TYPICAL ACOUSTICAL PANEL CEILING DETAILS.

PROJECT KEY PLAN

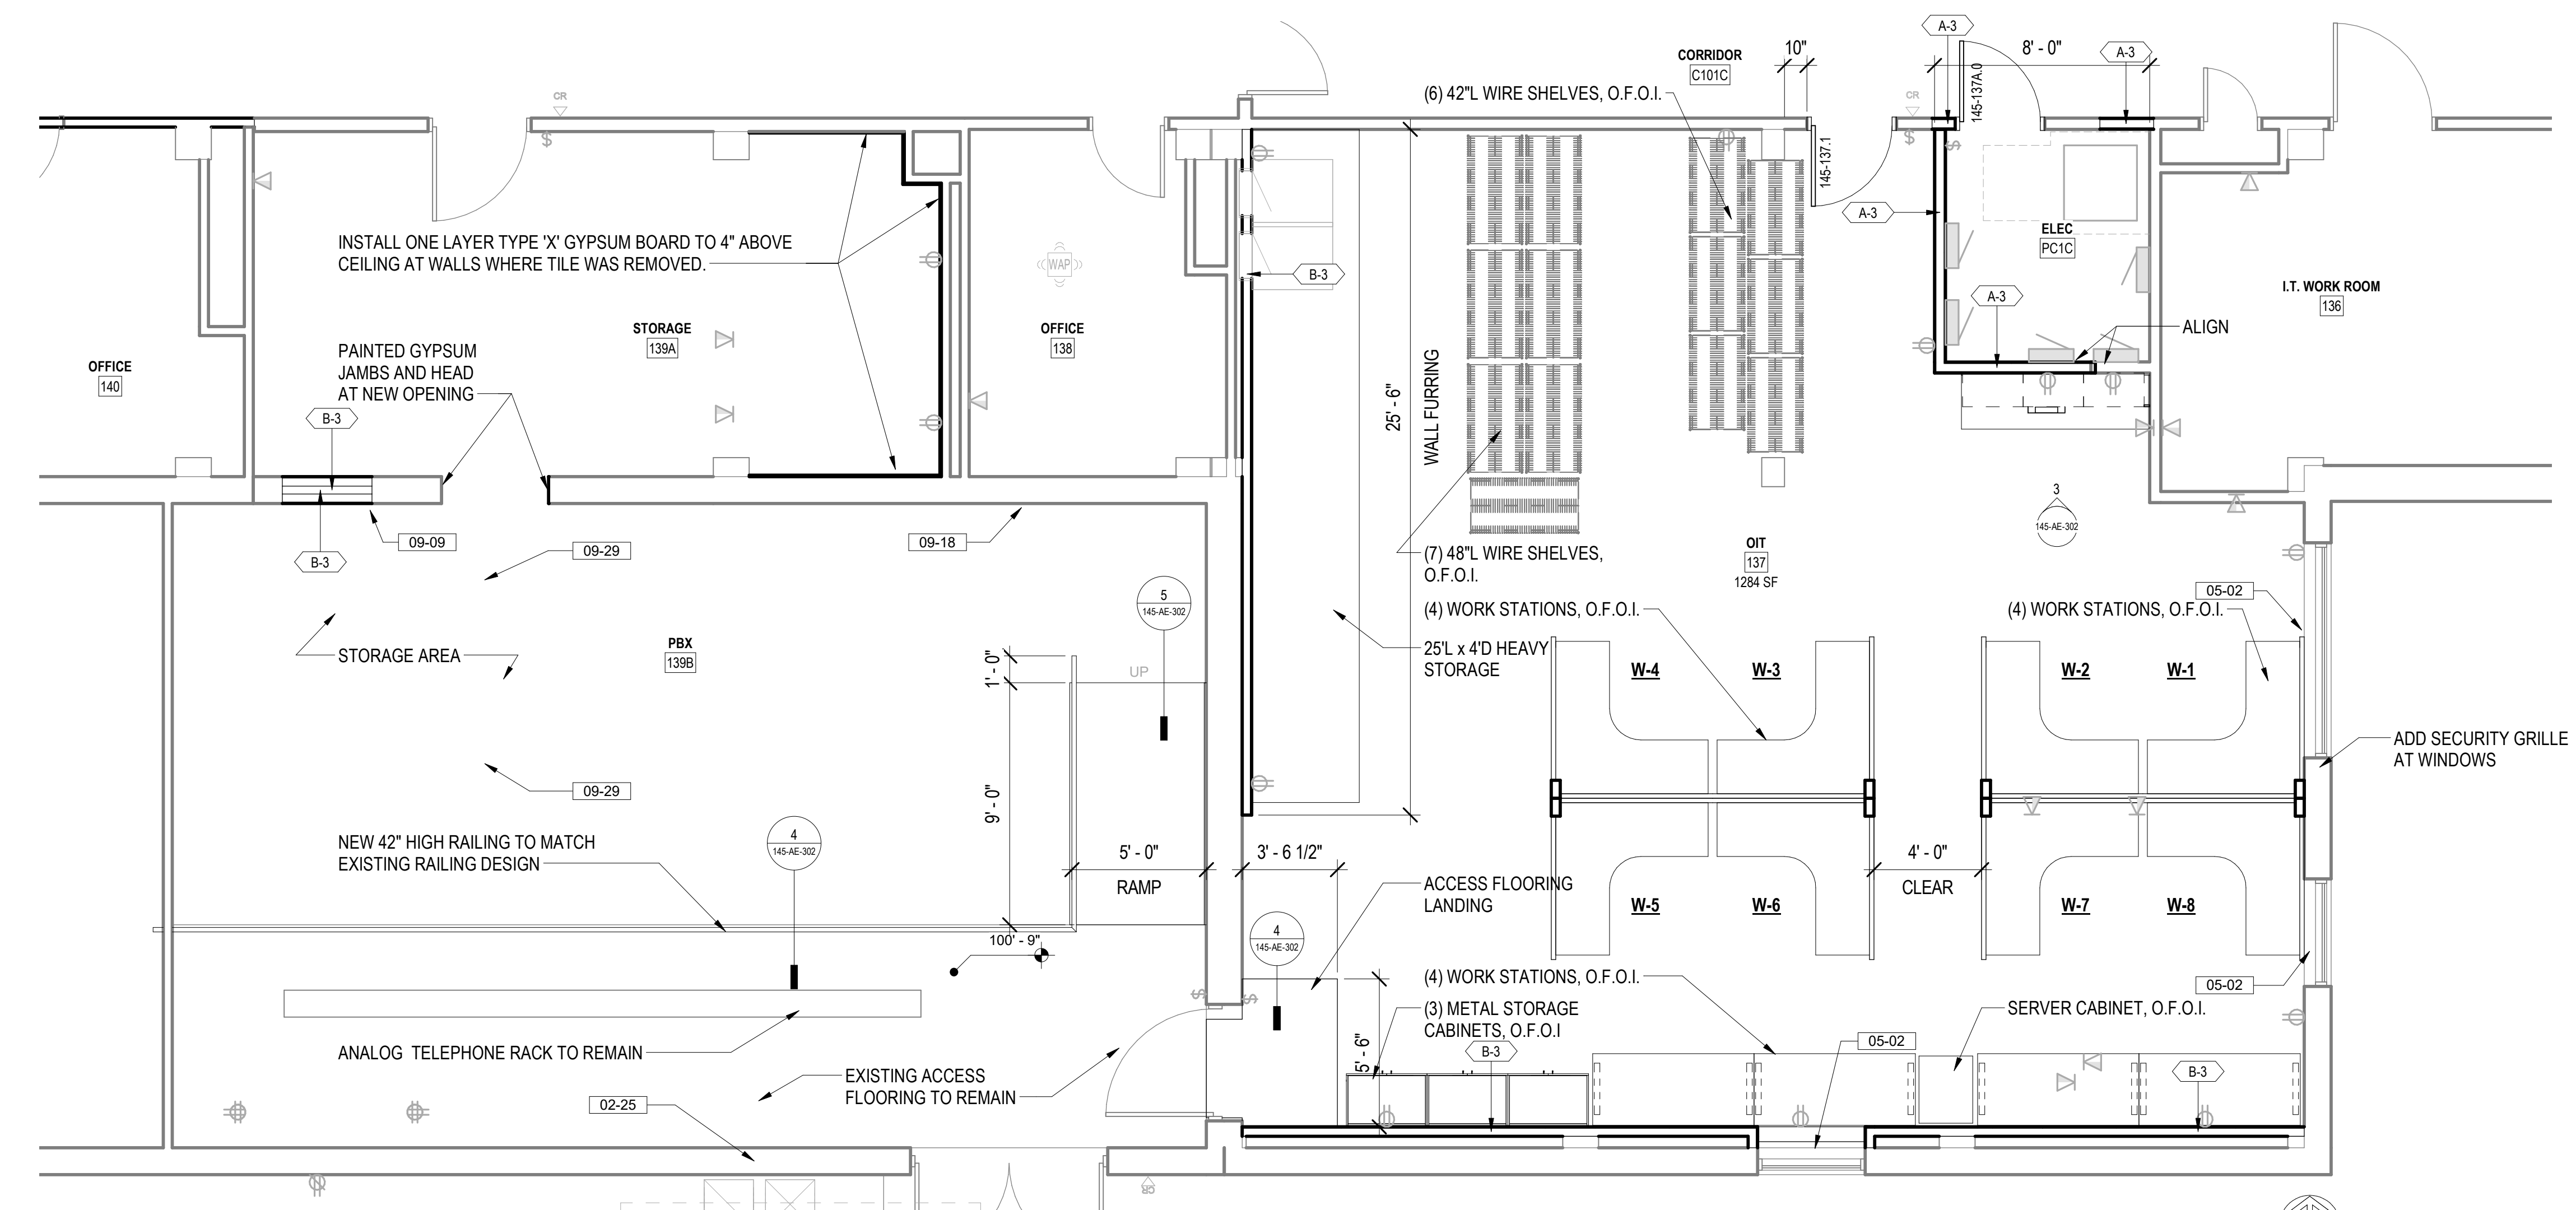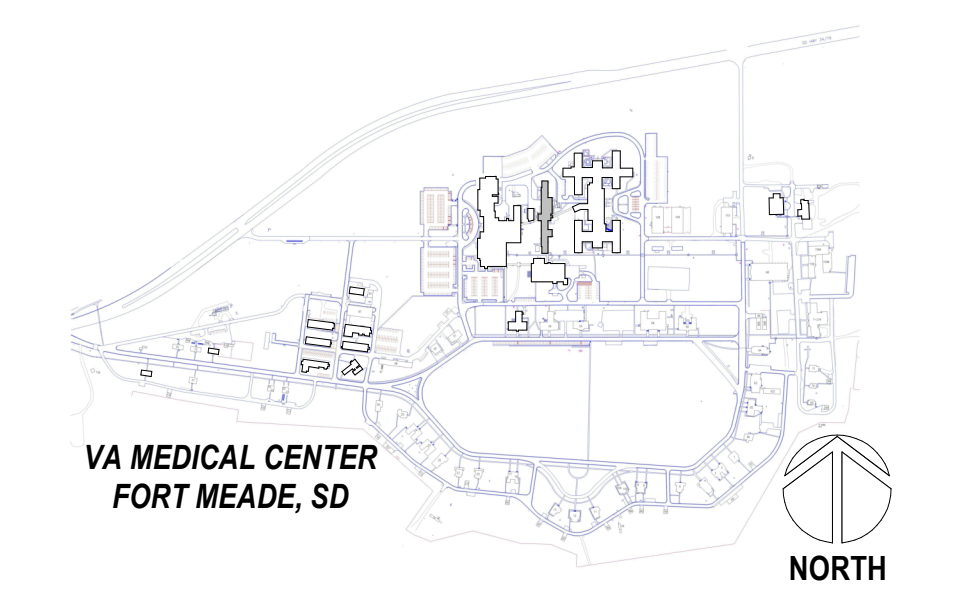


1 OIT DEPARTMENT PLAN
1/4" = 1'-0"

4 ACCESS FLOOR SYSTEM FASCIA DETAIL
3" = 1'-0"

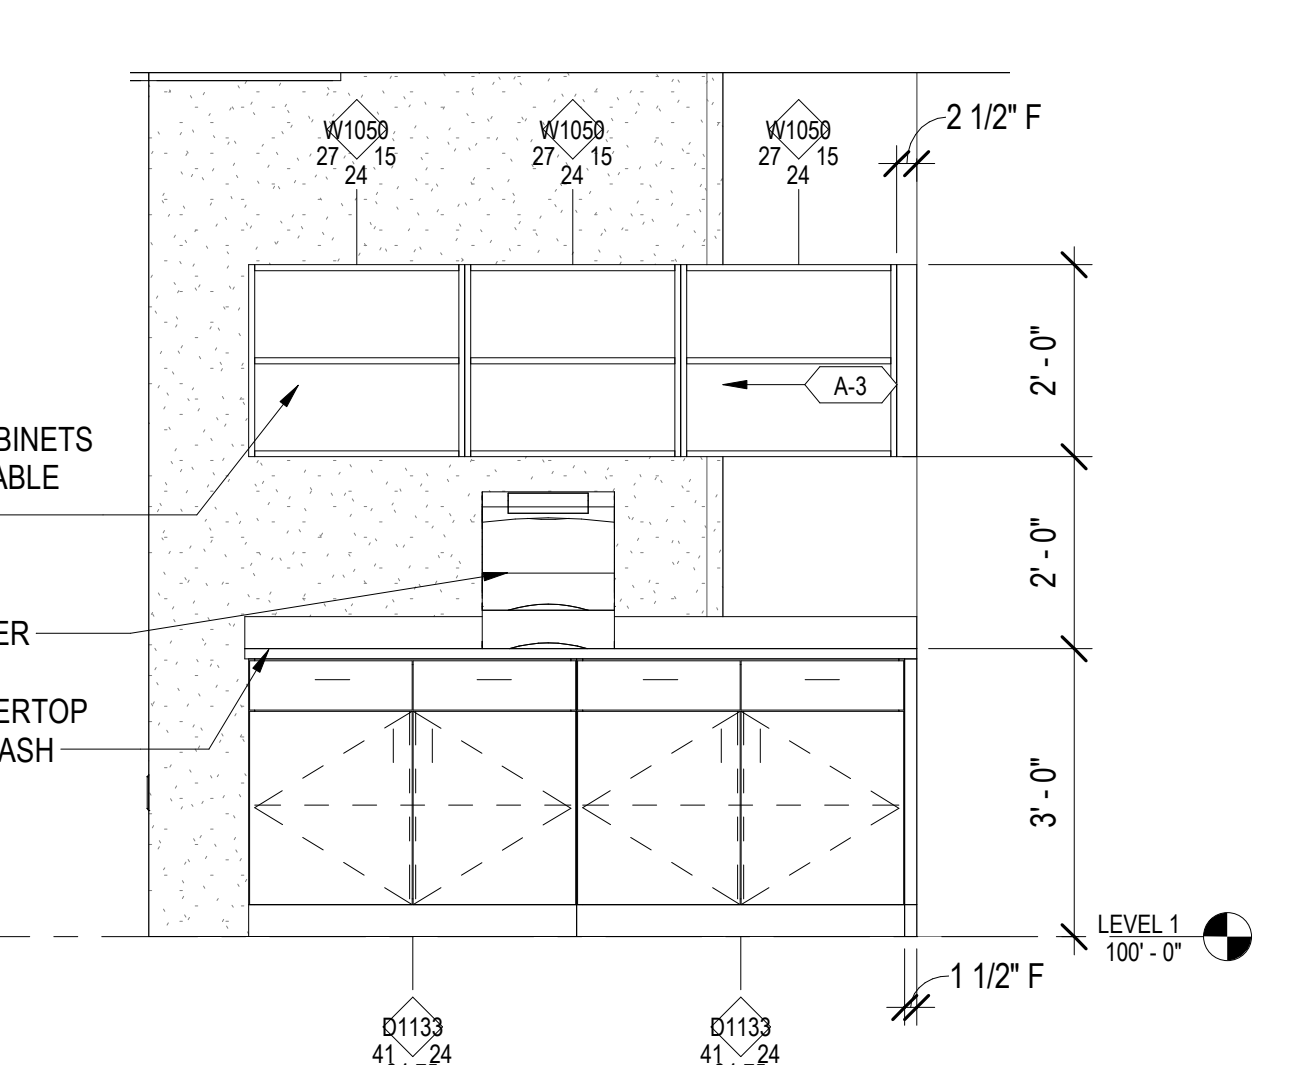

3 OIT 137 CASEWORK ELEVATION
1/2" = 1'-0"

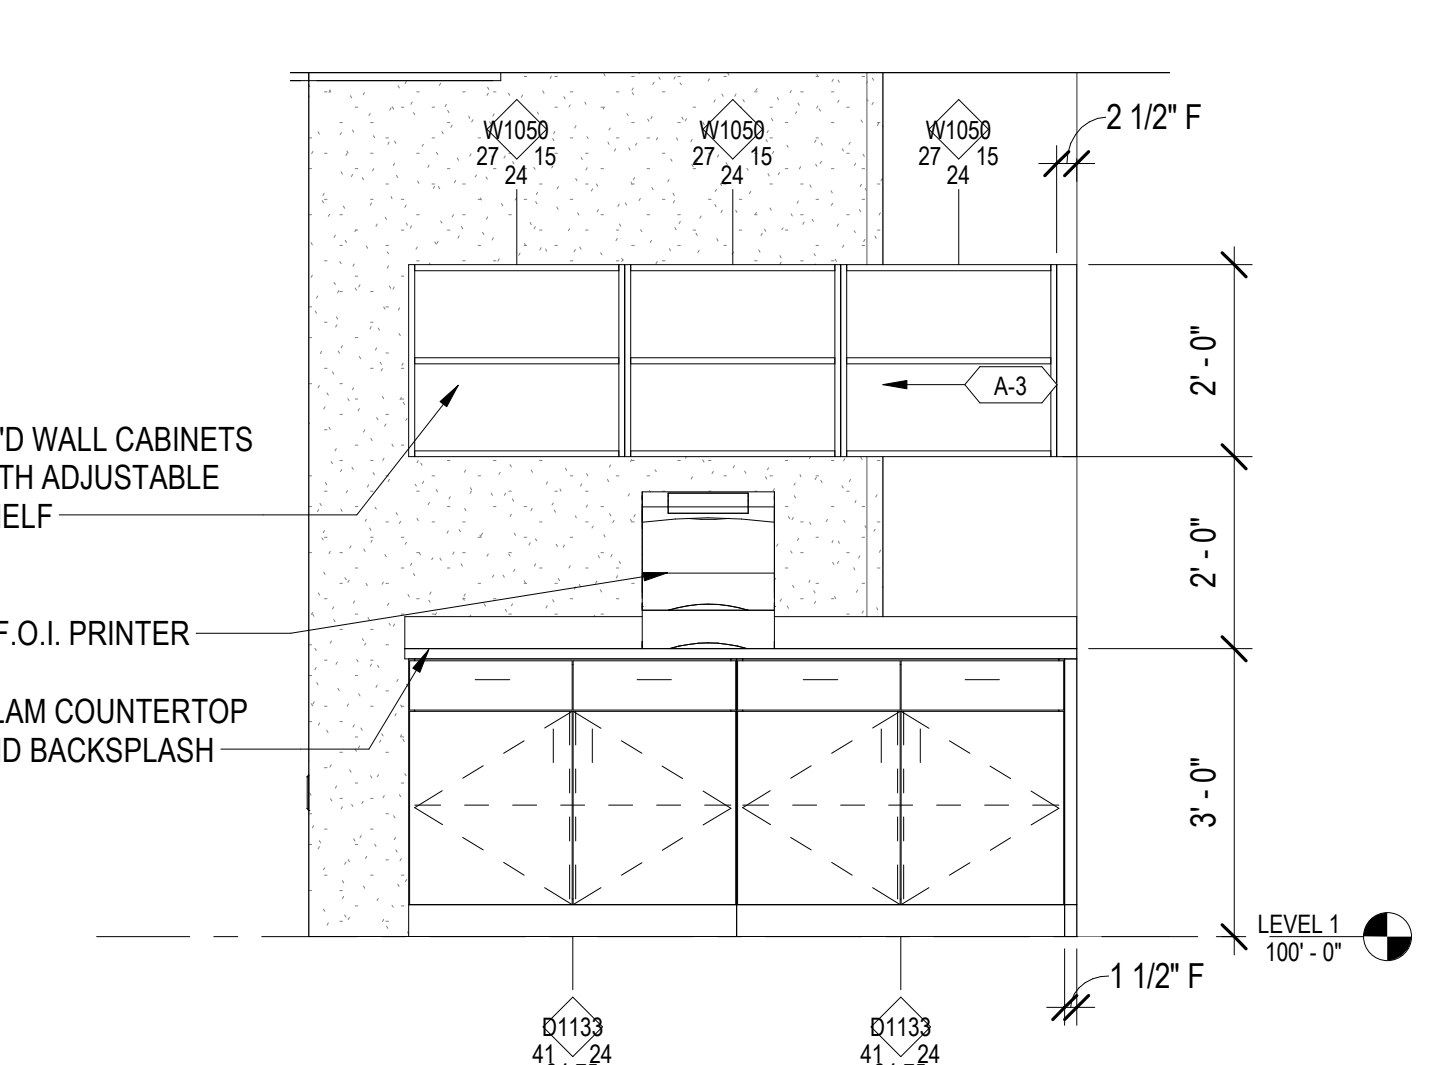

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PROGRAM CONTRACTING ACTIVITY CENTRAL (PCAC)

DRAWING TITLE
145 - ENLARGED OIT PLANS

APPROVED: Project Director

PHASE
100% CONSTRUCTION DOCUMENTS

FLS
FULLY SPRINKLERED

PROJECT TITLE
EHRM INFRASTRUCTURE UPGRADES

LOCATION
FORT MEADE, SOUTH DAKOTA

ISSUE DATE
04/15/2022

CHECKED BY
TMP


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JPR

PROJECT NUMBER
568-21-701


BUILDING NUMBER
BLDG 145

DRAWING NUMBER
145-AE-302


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 VA FORM 08 - 6231

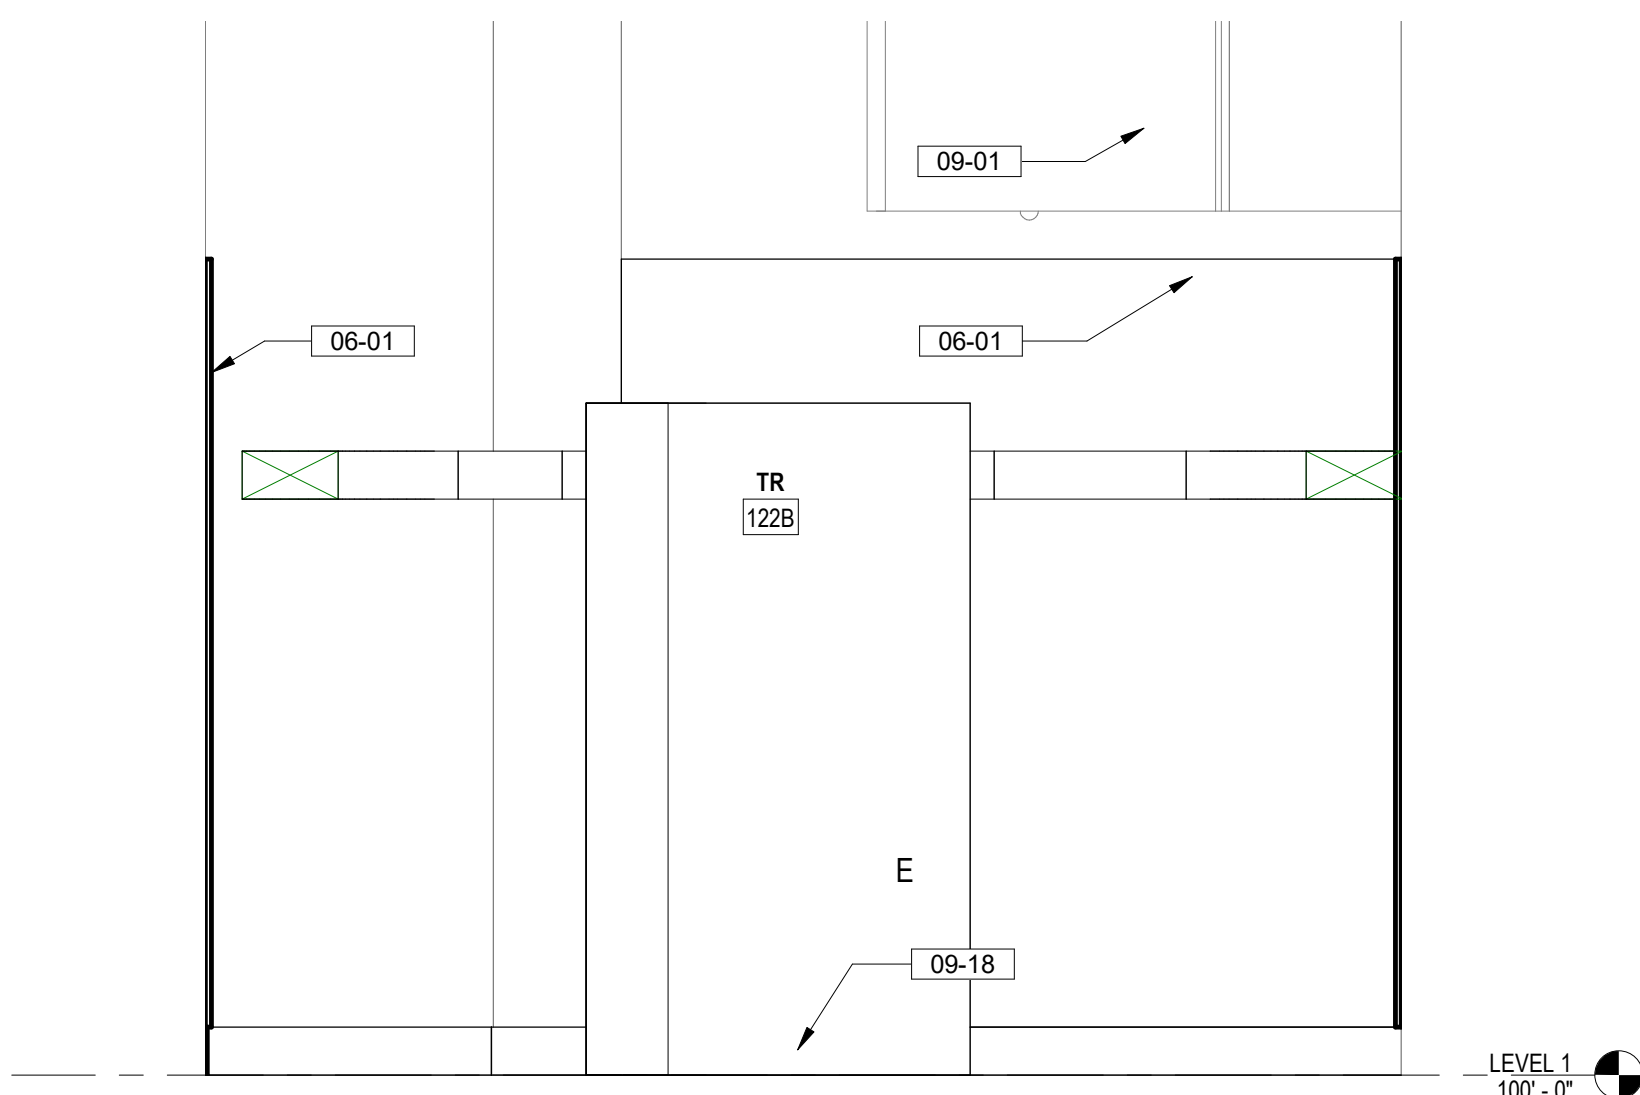

2 TR 122B EAST ELEVATION
1/2" = 1'-0"

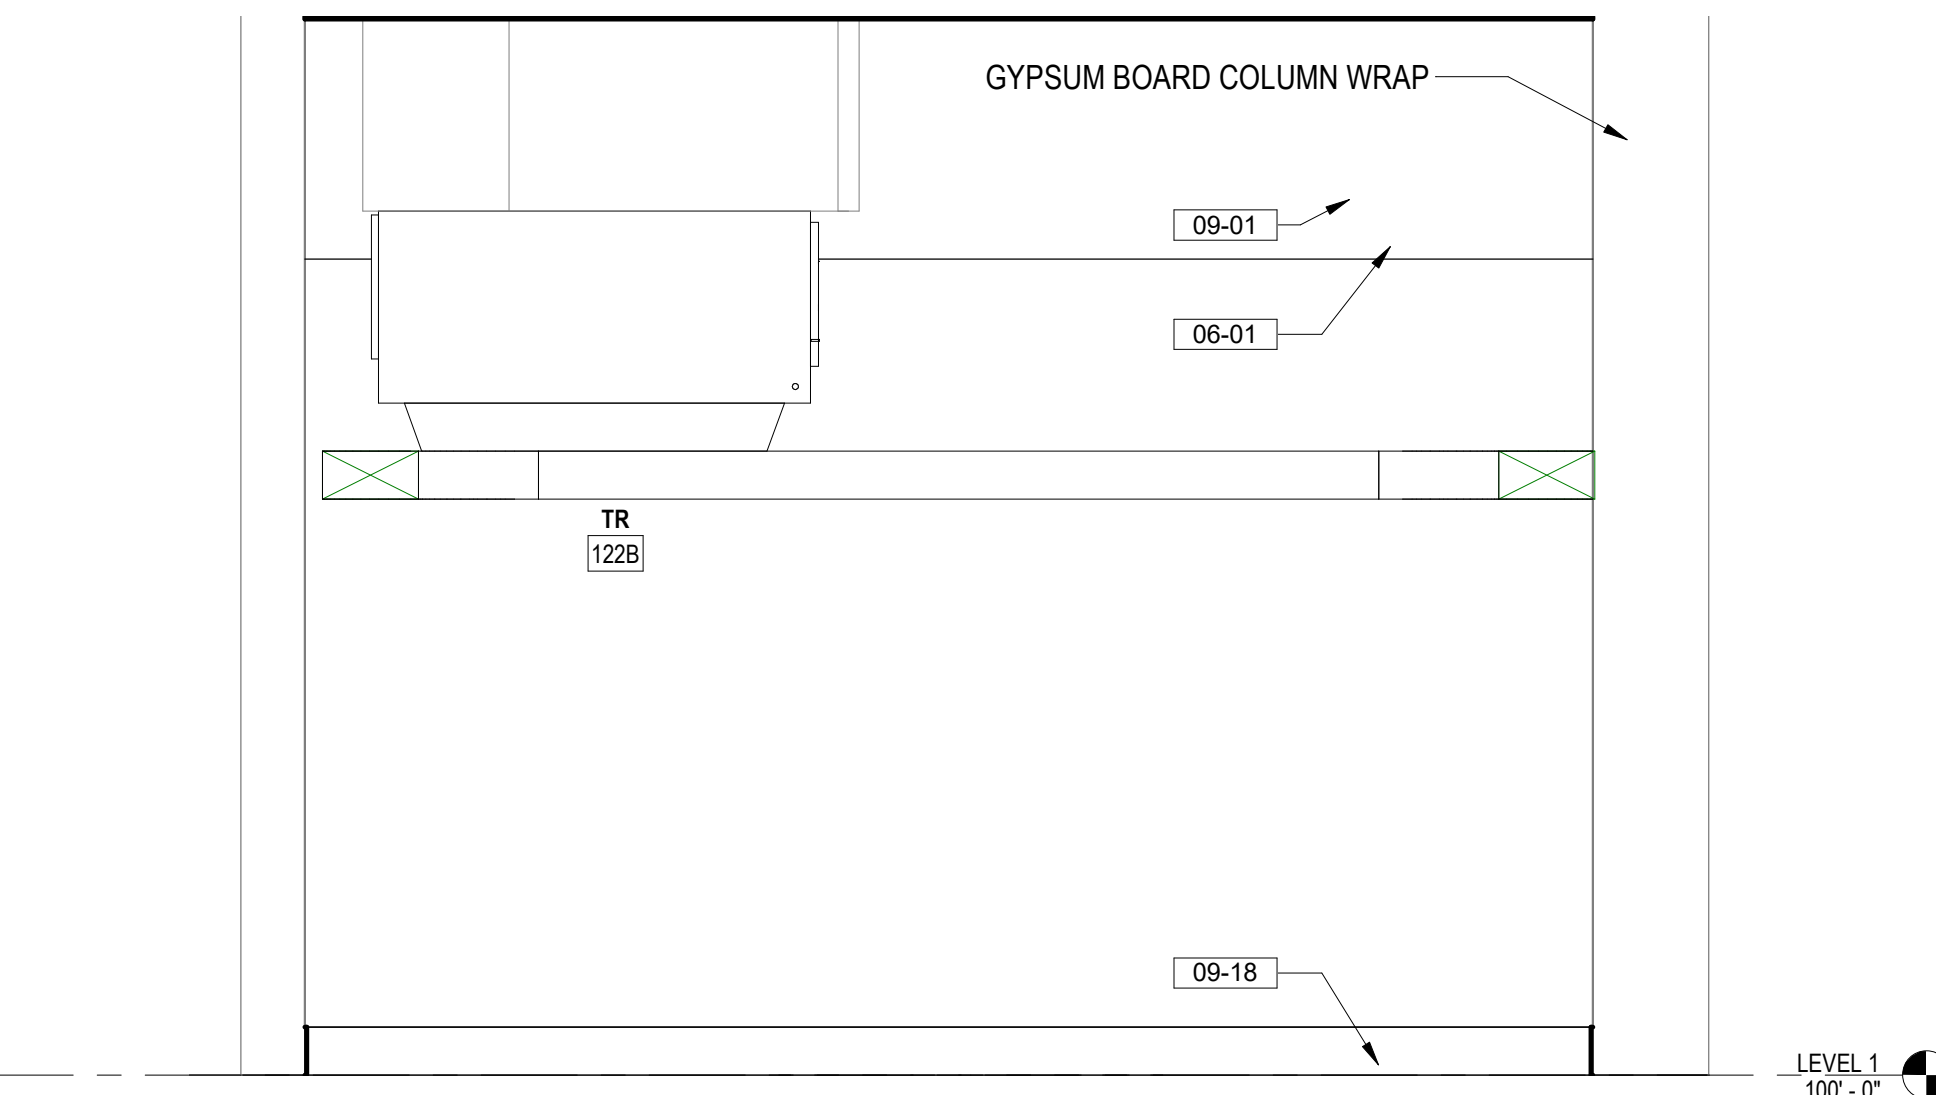

4 TR 122B NORTH ELEVATION
1/2" = 1'-0"

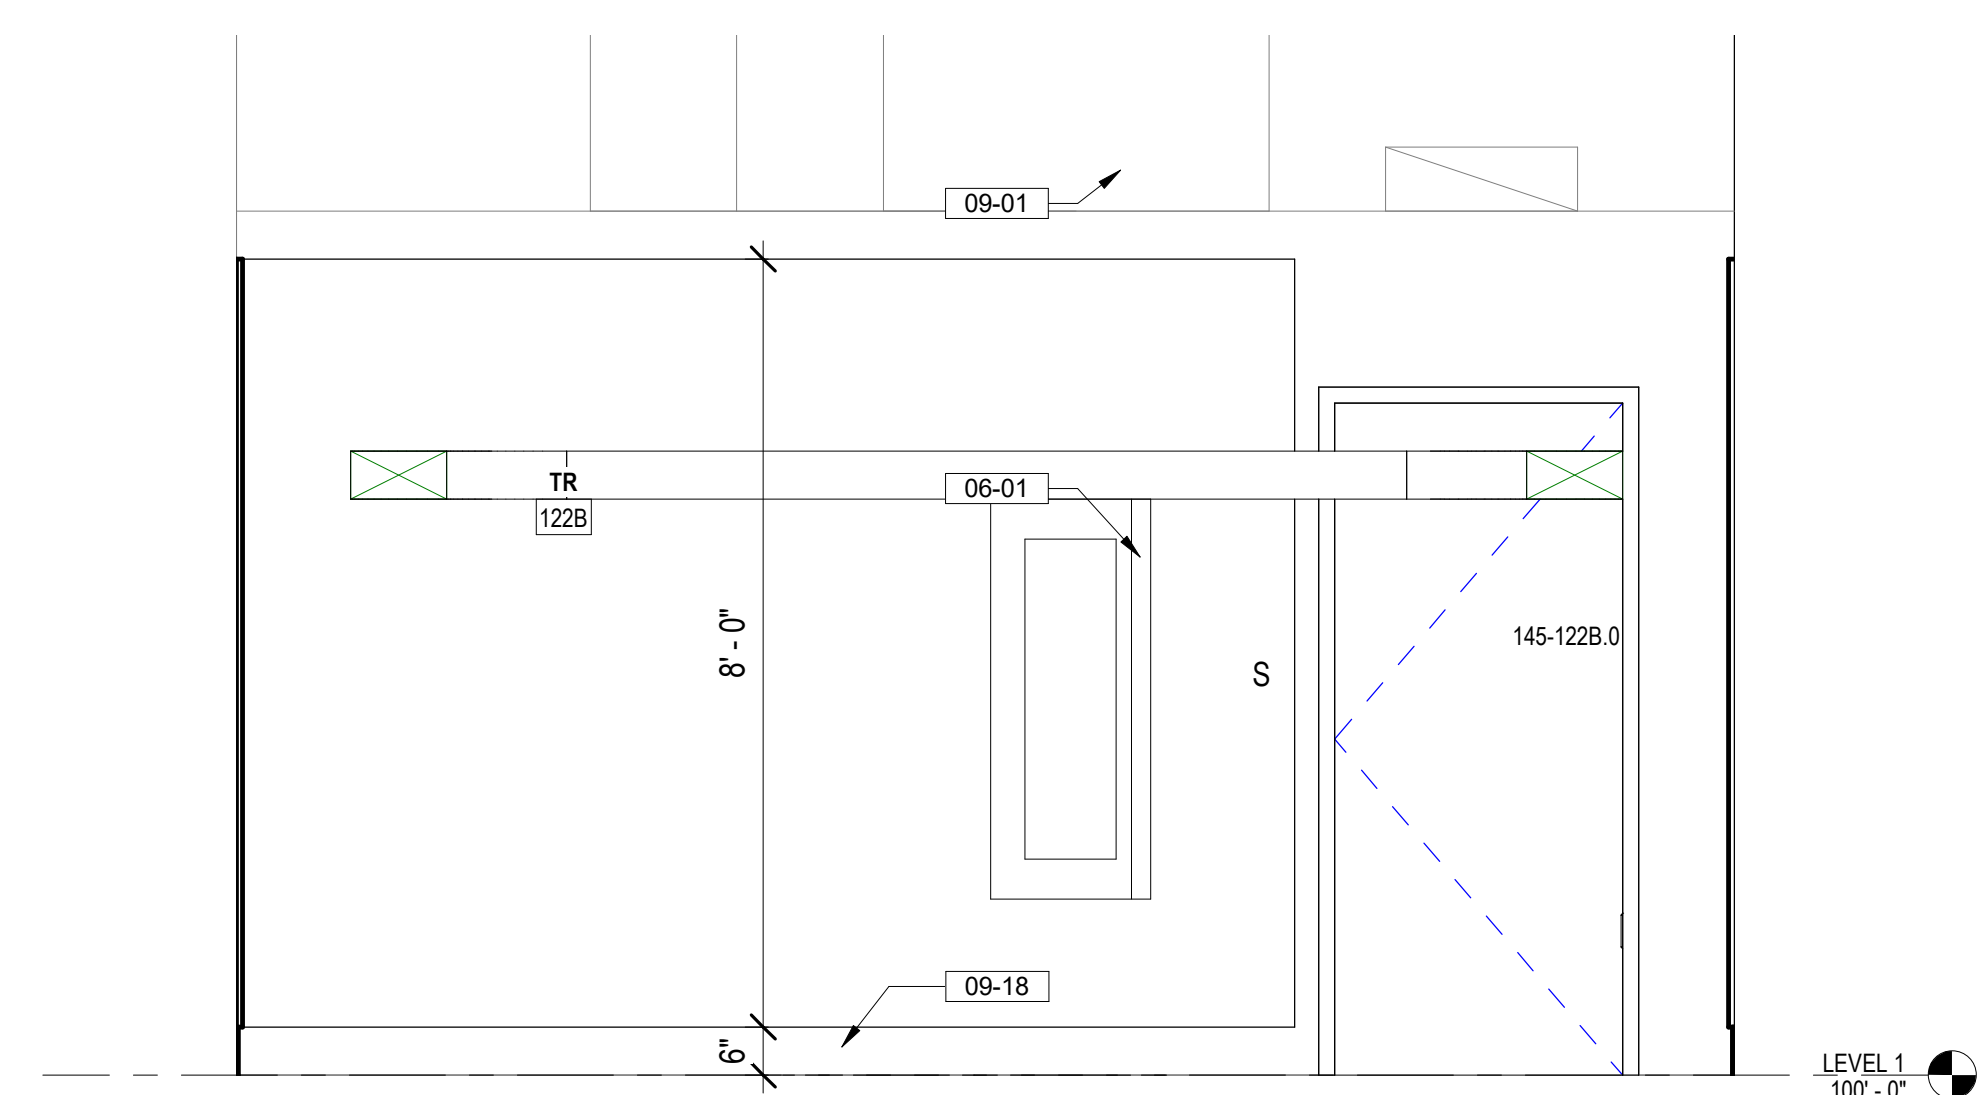

6 TR 122B SOUTH ELEVATION
1/2" = 1'-0"

FLOOR PLAN LEGEND

- CARD READER, REF TELECOM DRAWINGS
- DATA PORT, REF TELECOM DRAWINGS
- OUTLET, REF ELEC DRAWINGS
- WIRELESS ACCESS POINT, REF TELECOM DRAWINGS
- ELEC PANEL, REF ELEC DRAWINGS
- STRIP LIGHT FIXTURE, REF ELEC DRAWINGS

FLOOR PLAN NOTES

1. SEE G SERIES SHEETS FOR BALANCE OF FLOOR PLAN GENERAL NOTES.
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3. PROVIDE ALL BACKING FOR MILLWORK, GRAB BARS, AND ANY AND ALL WALL MOUNTED EQUIPMENT OR ACCESSORIES; COORDINATE LOCATIONS.
4. ALL DIMENSIONS ARE FROM STRUCTURAL OR UNFINISHED FACE OF STUD, UNLESS OTHERWISE NOTED.
5. PROVIDE A SMOOTH AND LEVEL FINISH FLOOR, TYP. PATCH AND REPAIR ALL INCONSISTENCIES IN FLOOR ELEVATIONS.
6. PATCH AND REPAIR ANY / ALL WALL SURFACES AS REQUIRED TO PROVIDE SUITABLE SUBSTRATE FOR FINISHES.
7. REFER TO DOOR AND FRAME SCHEDULE FOR DOORS REQUIRING ADA ACCESS CONTROL.
8. PROVIDE ACOUSTICAL SEALANT AROUND WALL EDGES, TOP AND BOTTOM, AND PENETRATIONS, AND INSTALL PUTTY PADS AROUND ELECTRICAL BOXES WHERE PARTITION CONTAINS ACOUSTICAL INSULATION.
9. ALL TELECOMMUNICATION ROOMS ARE TO HAVE EXPOSED STRUCTURE UNLESS NOTED OTHERWISE, NO CEILINGS SPECIFIED.



REFLECTED CEILING PLAN LEGEND

- 2x2 LIGHT FIXTURE
- 2x4 LIGHT FIXTURE
- STRIP LIGHT FIXTURE
- 6" RECESSED CAN LIGHT FIXTURE
- SUPPLY AIR DIFFUSER
- RETURN AIR VENT
- EXHAUST FAN
- 5/8" GYP. BOARD CEILING AFFIXED TO 3 5/8" MTL STUDS
- 2'x2' SUSPENDED ACOUSTIC CEILING TILE CEILING
- 2'x4' SUSPENDED ACOUSTIC CEILING TILE CEILING



REFLECTED CEILING PLAN NOTES

1. REFER TO ELECTRICAL SHEETS FOR FIXTURE TYPES, SWITCHING, AND SPECIAL SYSTEMS.
2. REFER TO MECHANICAL SHEETS FOR DIFFUSER AND DUCTING LAYOUTS.
3. SEE SHEET 00-GI-006 FOR TYPICAL ACOUSTICAL PANEL CEILING DETAILS

PROJECT KEY PLAN

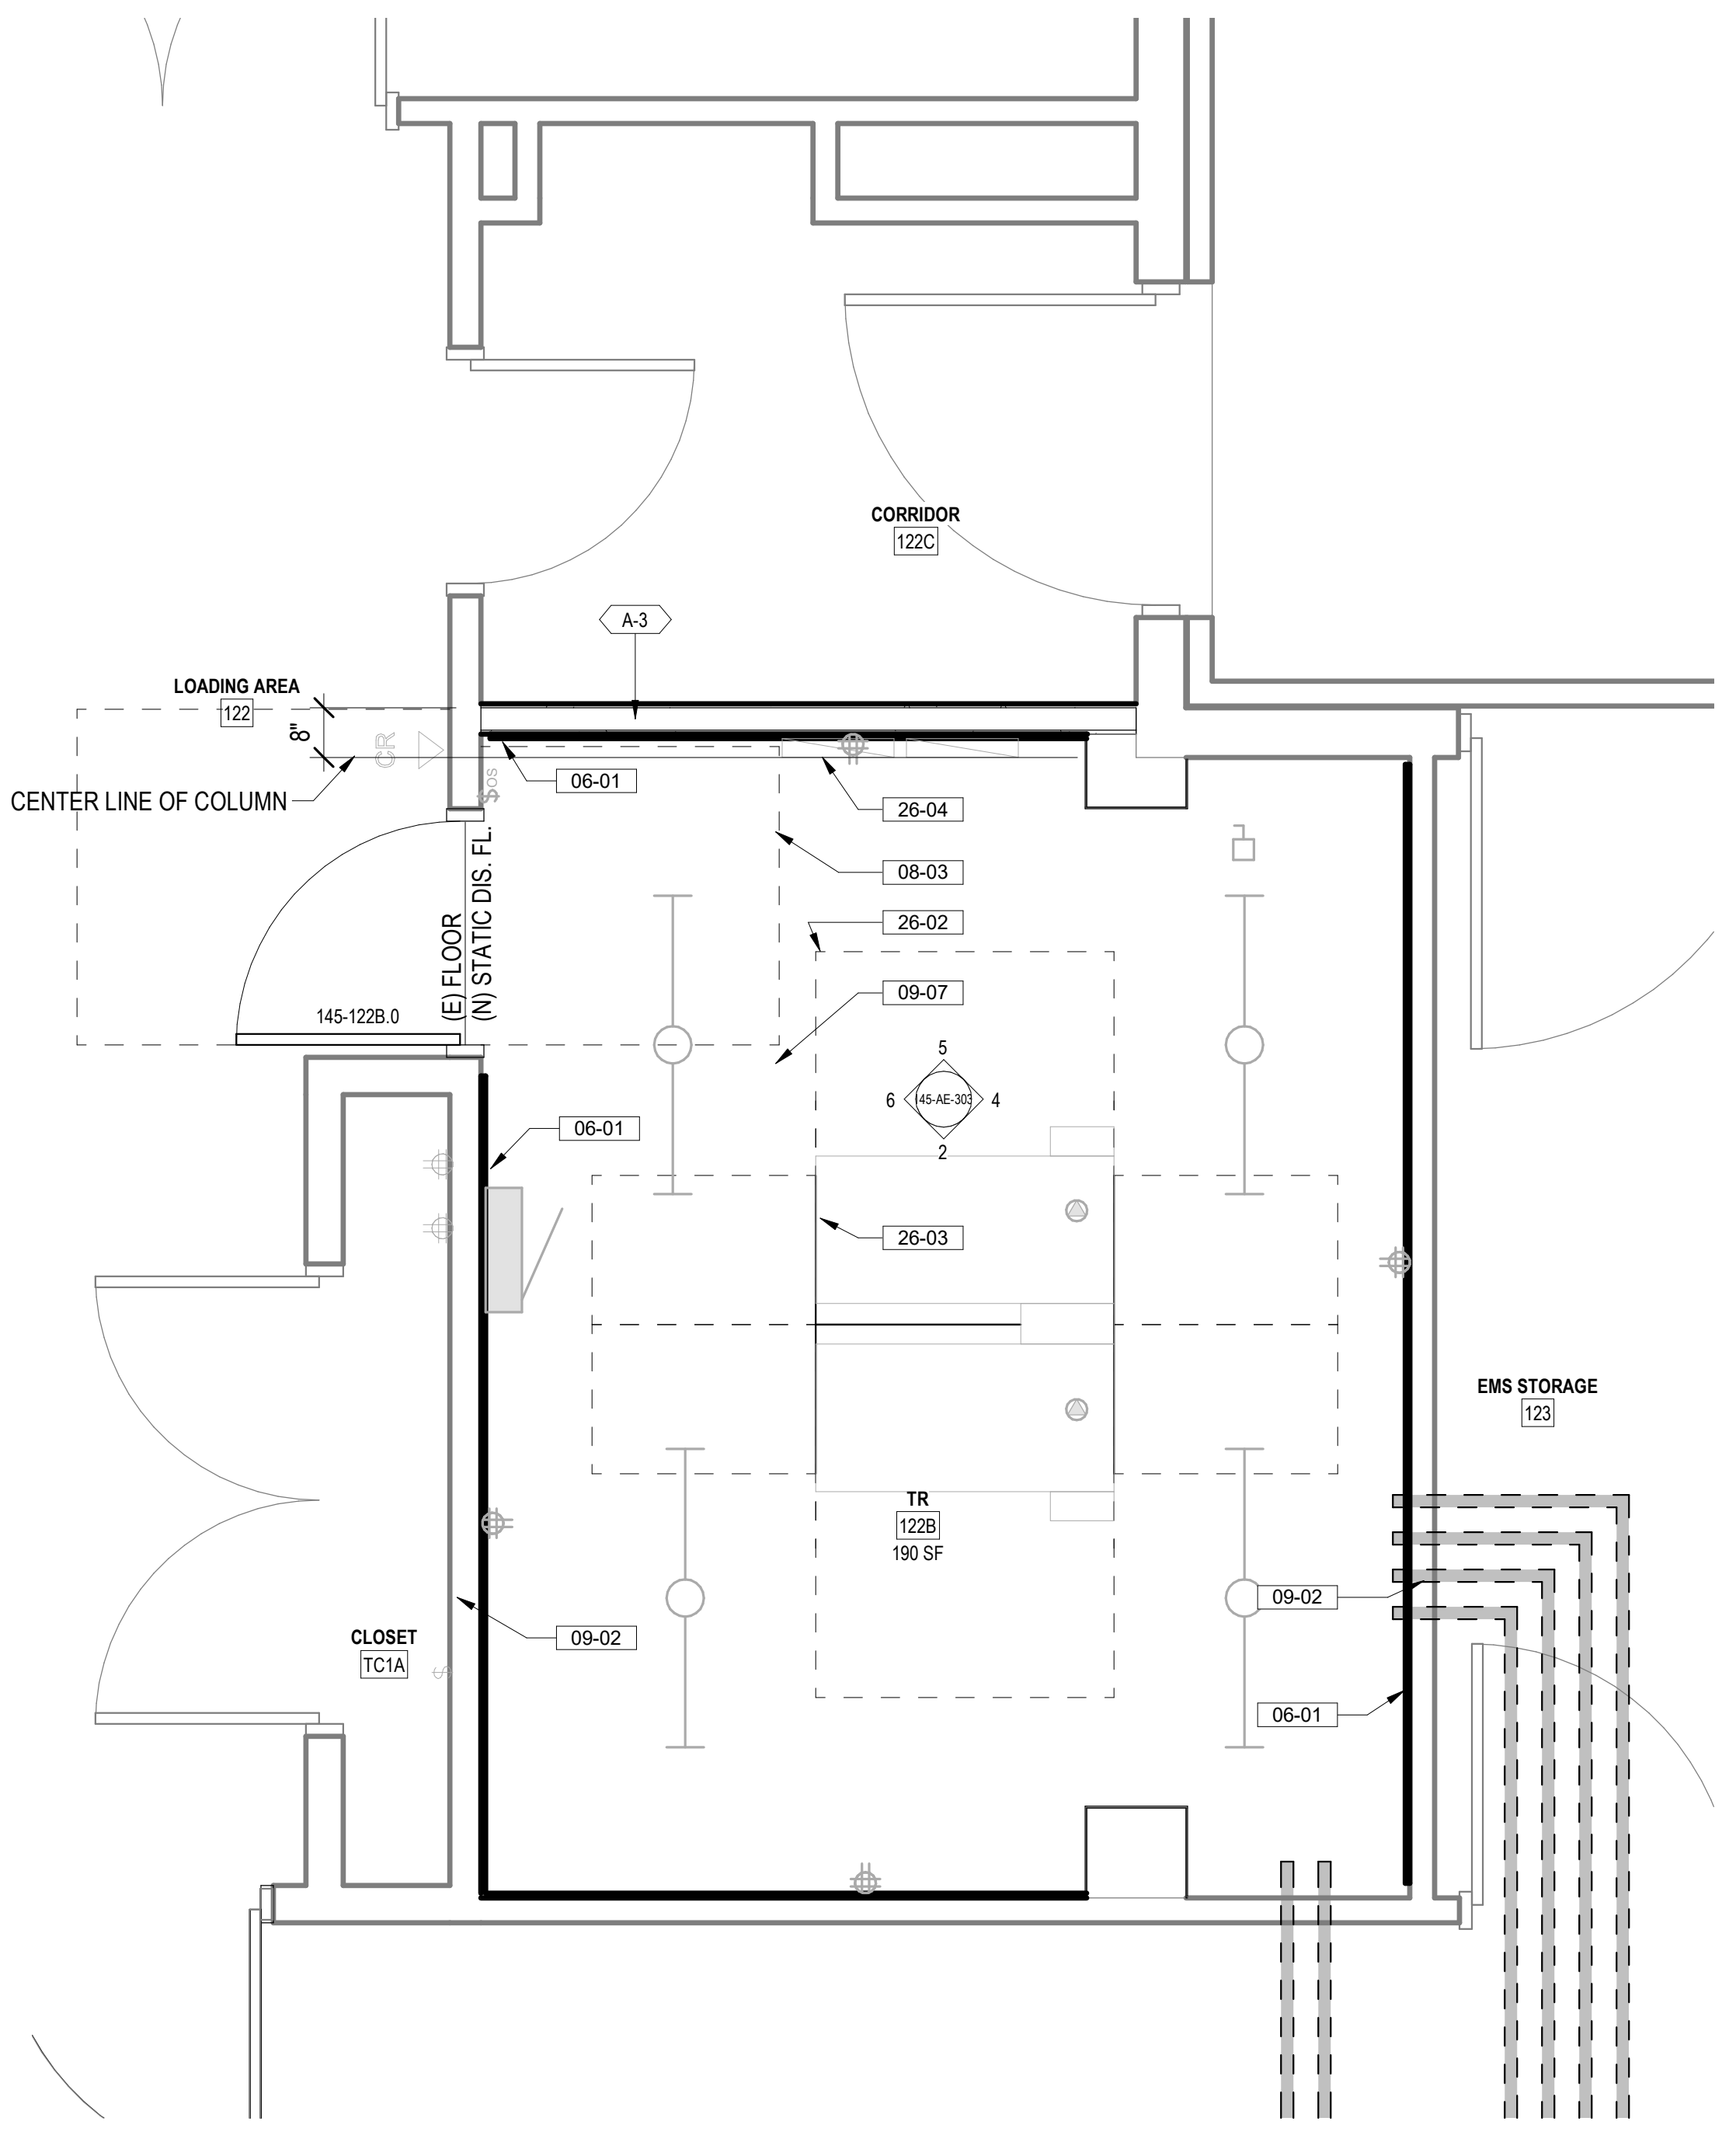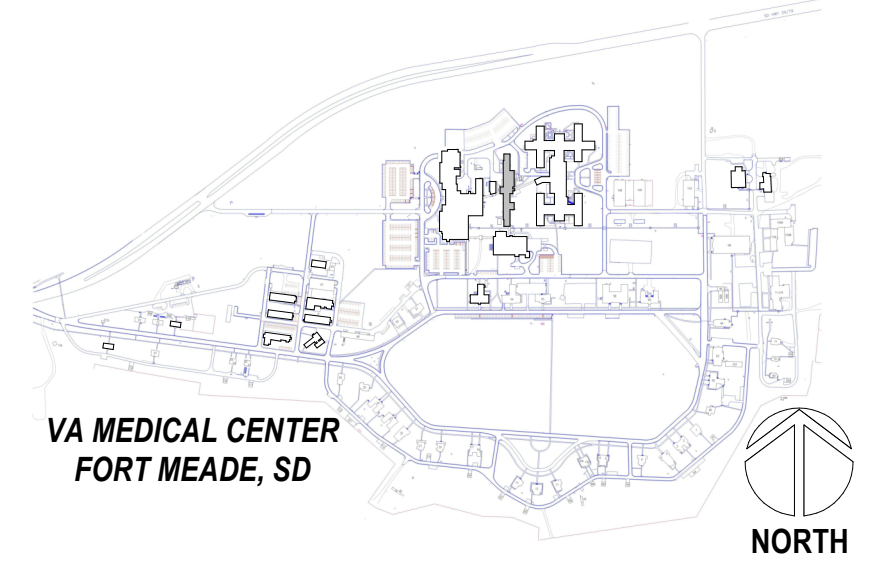

1 TR 122B ENLARGED PLAN
1/2" = 1'-0"

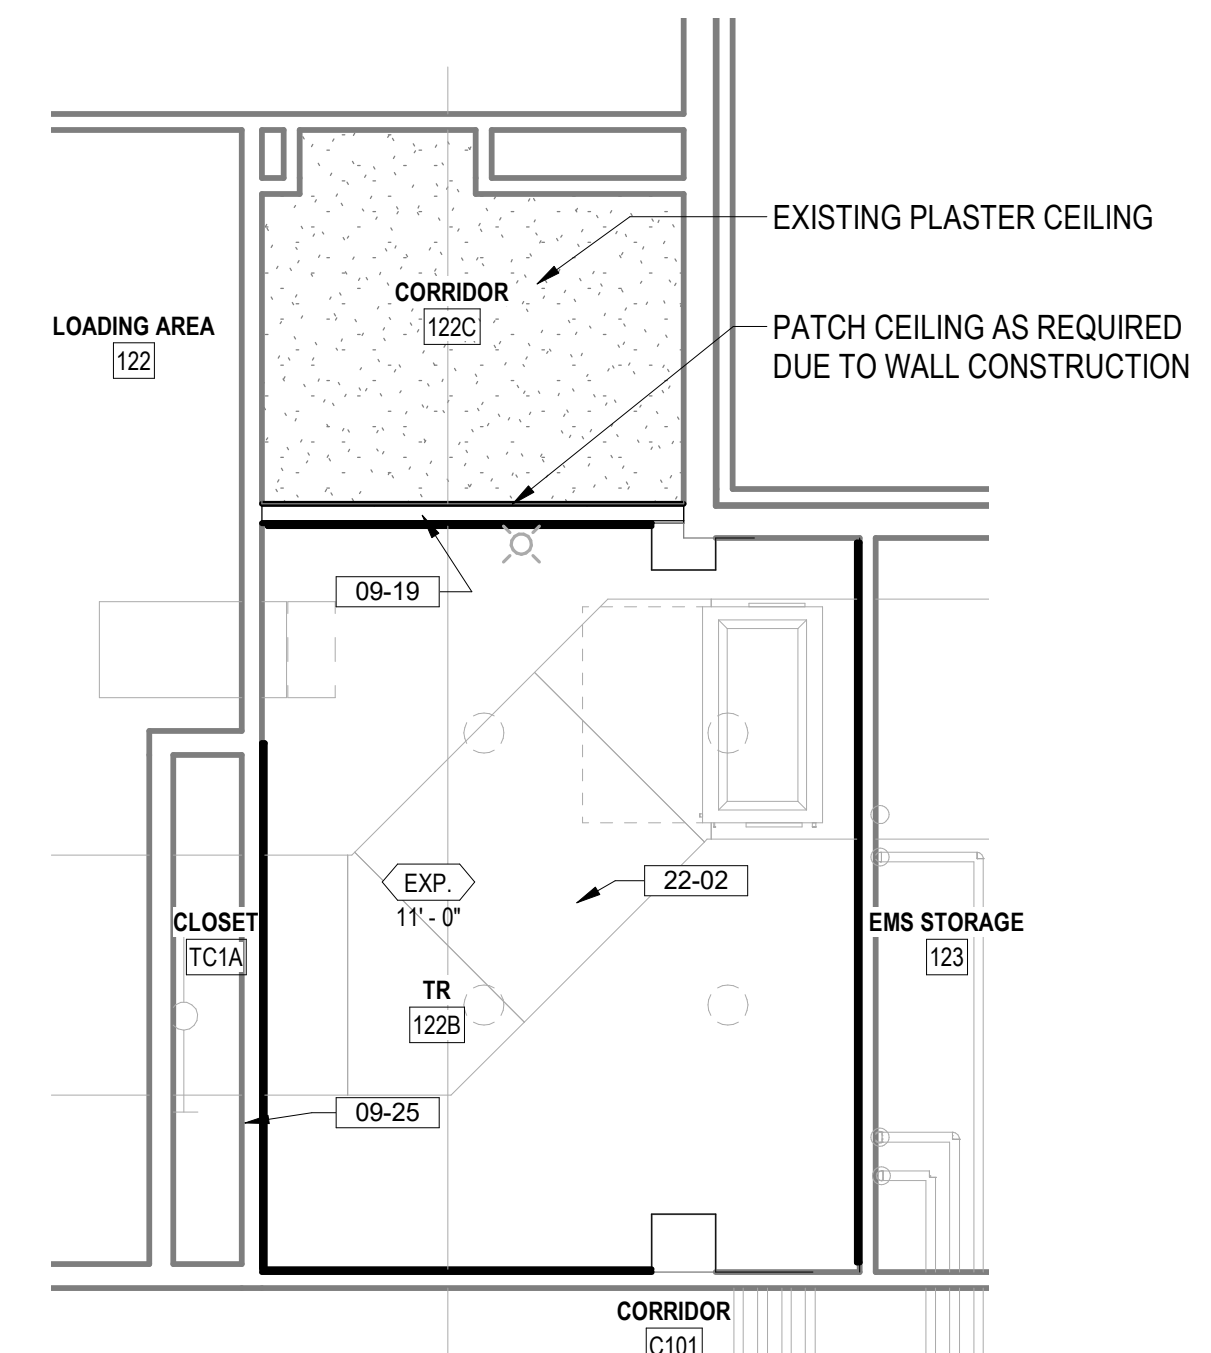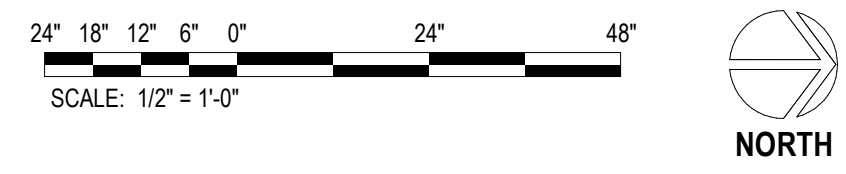

3 LEVEL 1 - TR REFLECTED CEILING PLAN
1/4" = 1'-0"

KEYNOTES

- 06-01 INSTALL 3/4" AC GRADE OR BETTER FIRE RETARDANT PLYWOOD; PAINT WITH TWO COATS OF SEMI-GLOSS BRIGHT WHITE FIRE RETARDANT PAINT; MOUNT BOTTOM OF PLYWOOD 6" A.F.F. TOP OF PLYWOOD AT 8'4" A.F.F.
- 09-01 PAINT WALL ABOVE PLYWOOD WITH SEMI-GLOSS PAINT, COLOR TO MATCH PLYWOOD PAINT.
- 08-03 ADA DOOR CLEARANCES SHOWN DASHED
- 09-02 PATCH ALL DAMAGED WORK ON EXISTING SURFACES ABOVE AND BELOW CEILING TILES. SEAL PERIMETER OF ROOM IN ITS ENTIRETY. PAINT.
- 09-07 INSTALL STATIC DISSIPATIVE RESILIENT FLOORING
- 09-18 6" HIGH COVERED RUBBER WALL BASE, COLOR TO BE SELECTED FROM MANUFACTURER'S STANDARD SELECTION
- 09-19 EXTEND GYPSUM BOARD WALL TO UNDERSIDE OF STRUCTURE WITH 5/8" GYPSUM BOARD LAYER ON EACH SIDE OF WALL. SEAL.
- 09-25 PATCH AND REPAIR ANY GYPSUM BOARD OPENINGS FOUND AT PERIMETER OF WALL. SEAL PERIMETER OF ROOM IN ITS ENTIRETY. PAINT.
- 22-02 UPRIGHT HEAD FIRE SUPPRESSION SPRINKLER HEAD SHOWN FOR REFERENCE ONLY. FIRE SUPPRESSION CONTRACTOR TO VERIFY ACTUAL QUANTITIES REQUIRED. COORDINATE INSTALLATION WITH MEPT DRAWINGS
- 26-02 3" PERIMETER CLEARANCE AROUND SERVER RACK SHOWN DASHED
- 26-03 TELECOMM RACK, SEE TELECOMMUNICATION DRAWINGS
- 26-04 ELECTRICAL PANELS, SEE ELECTRICAL DRAWINGS
- 26-05 CABLE TRAY, SEE TELECOMMUNICATION DRAWINGS

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Revisions:	Date:

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T. MARCELLO PIERROTTI, AIA

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PROGRAM CONTRACTING ACTIVITY CENTRAL (PCAC)
VA U.S. Department of Veterans Affairs

DRAWING TITLE
145-ENLARGED TR PLANS AND ELEVATIONS
APPROVED: Project Director

PHASE
100% CONSTRUCTION DOCUMENTS
FLS
FULLY SPRINKLERED

PROJECT TITLE
EHRM INFRASTRUCTURE UPGRADES
LOCATION
FORT MEADE, SOUTH DAKOTA
ISSUE DATE
04/15/2022
CHECKED BY
TMP
DRAWN BY
TMP

PROJECT NUMBER
568-21-701
BUILDING NUMBER
BLDG 145
DRAWING NUMBER
145-AE-303

FLOOR PLAN LEGEND

- CARD READER, REF TELECOM DRAWINGS
- DATA PORT, REF TELECOM DRAWINGS
- OUTLET, REF ELEC DRAWINGS
- WIRELESS ACCESS POINT, REF TELECOM DRAWINGS
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9. ALL TELECOMMUNICATION ROOMS ARE TO HAVE EXPOSED STRUCTURE UNLESS NOTED OTHERWISE, NO CEILINGS SPECIFIED.



REFLECTED CEILING PLAN LEGEND

- 2x2 LIGHT FIXTURE
- 2x4 LIGHT FIXTURE
- STRIP LIGHT FIXTURE
- 6" RECESSED CAN LIGHT FIXTURE
- SUPPLY AIR DIFFUSER
- RETURN AIR VENT
- EXHAUST FAN
- 5/8" GYP. BOARD CEILING AFFIXED TO 3 5/8" MTL STUDS
- 2x2" SUSPENDED ACOUSTIC CEILING TILE CEILING
- 2x4" SUSPENDED ACOUSTIC CEILING TILE CEILING


REFLECTED CEILING PLAN NOTES

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3. SEE SHEET 00-GI-006 FOR TYPICAL ACOUSTICAL PANEL CEILING DETAILS


PROJECT KEY PLAN

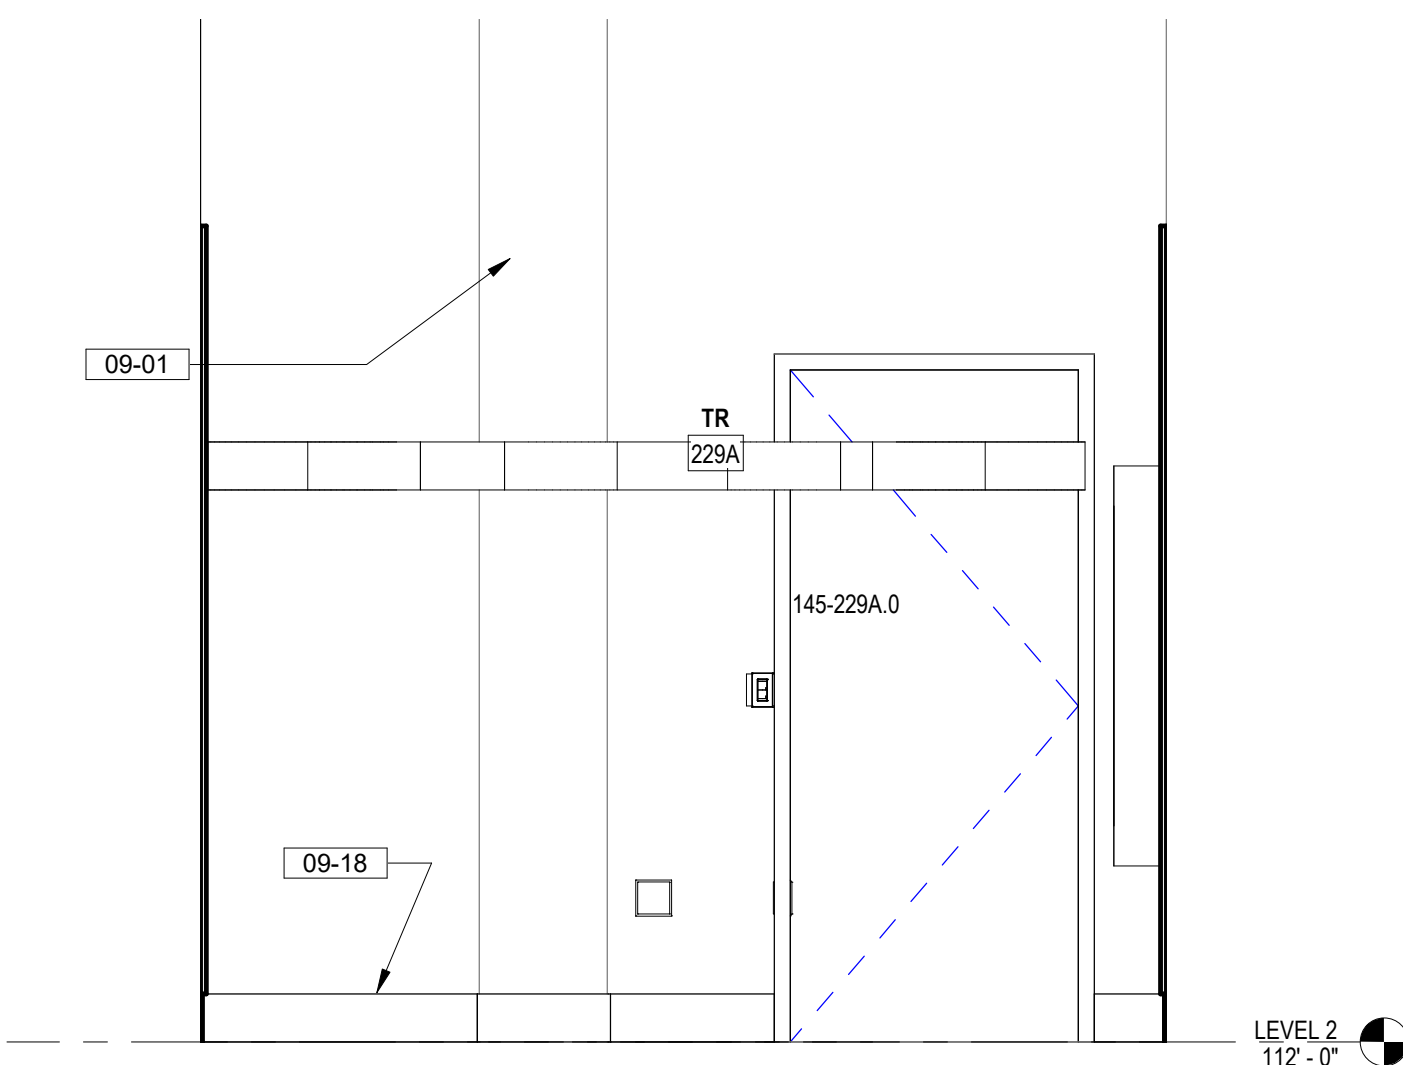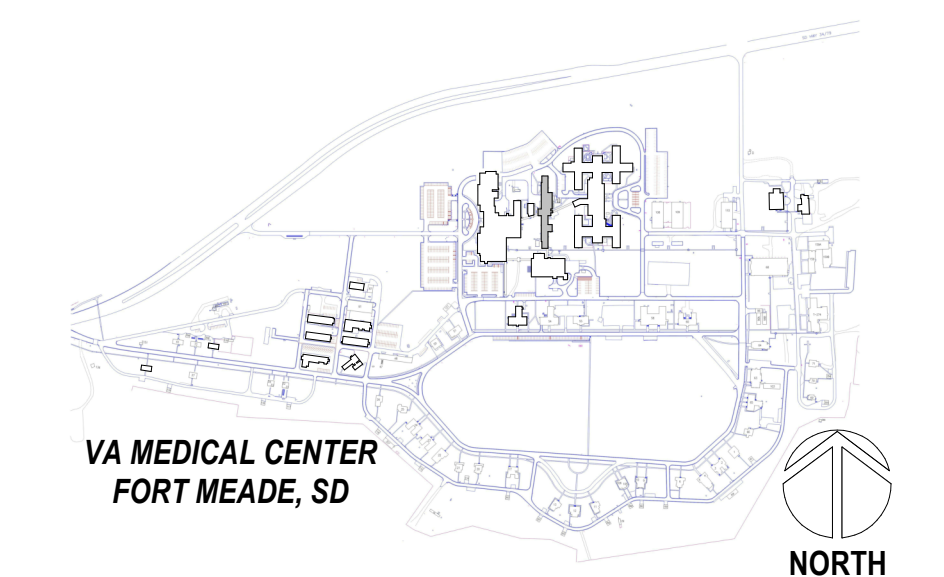


2 TR 229A EAST ELEVATION
1/2" = 1'-0"

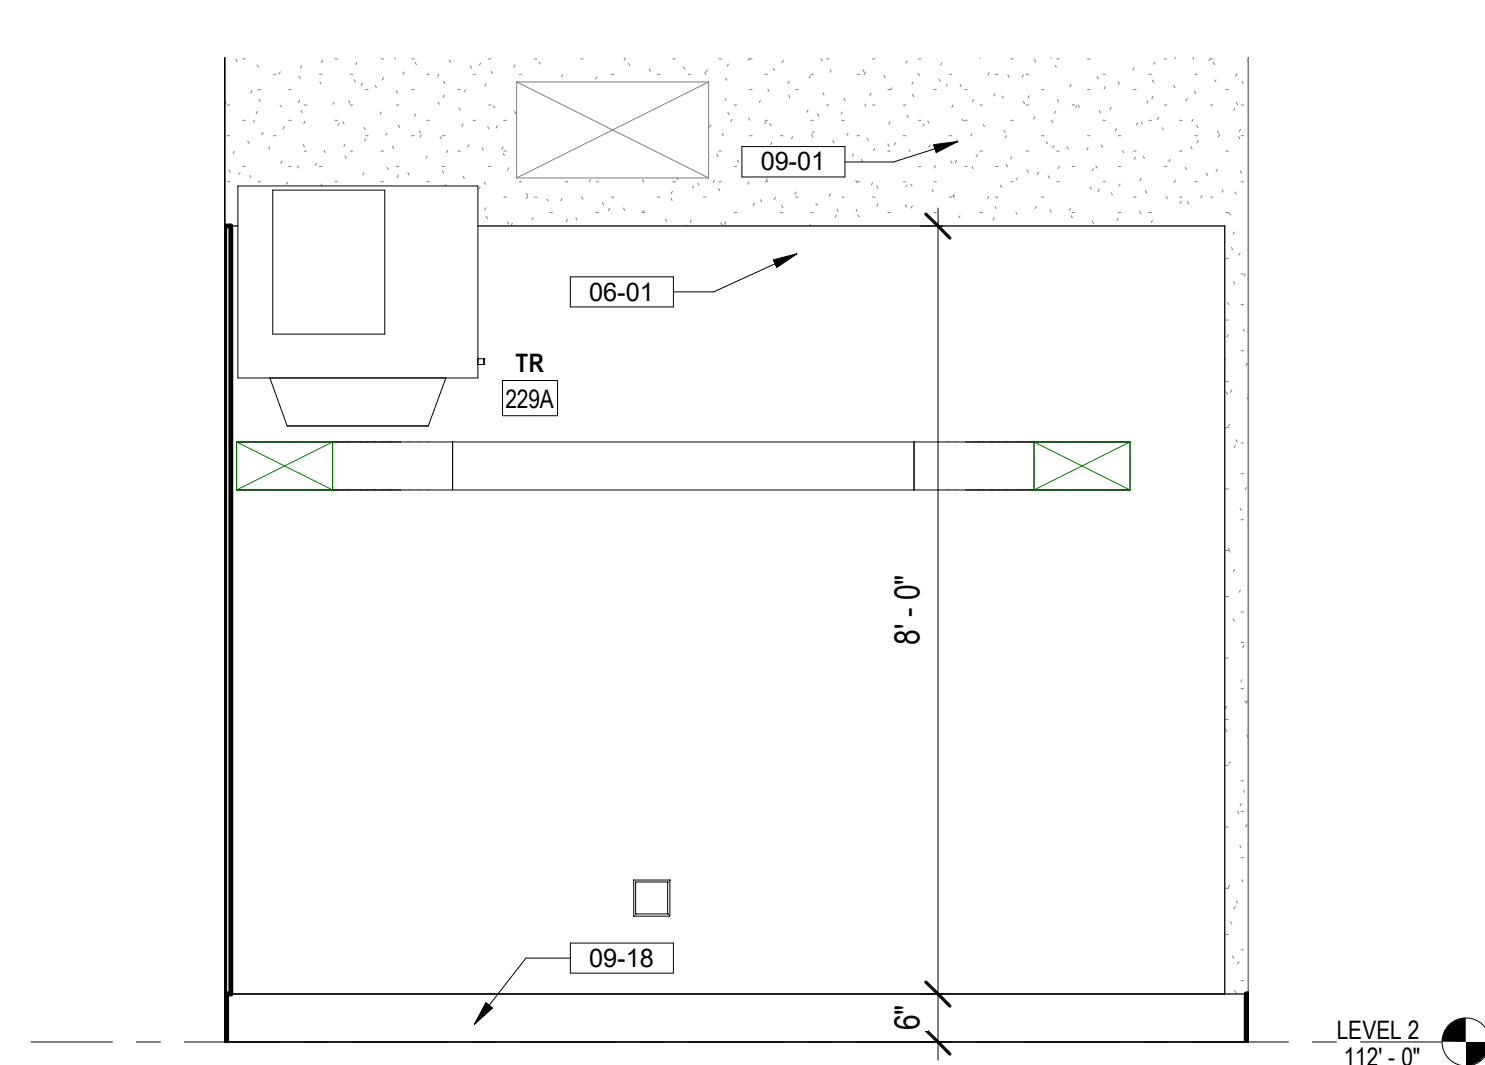


3 TR 229A NORTH ELEVATION
1/2" = 1'-0"

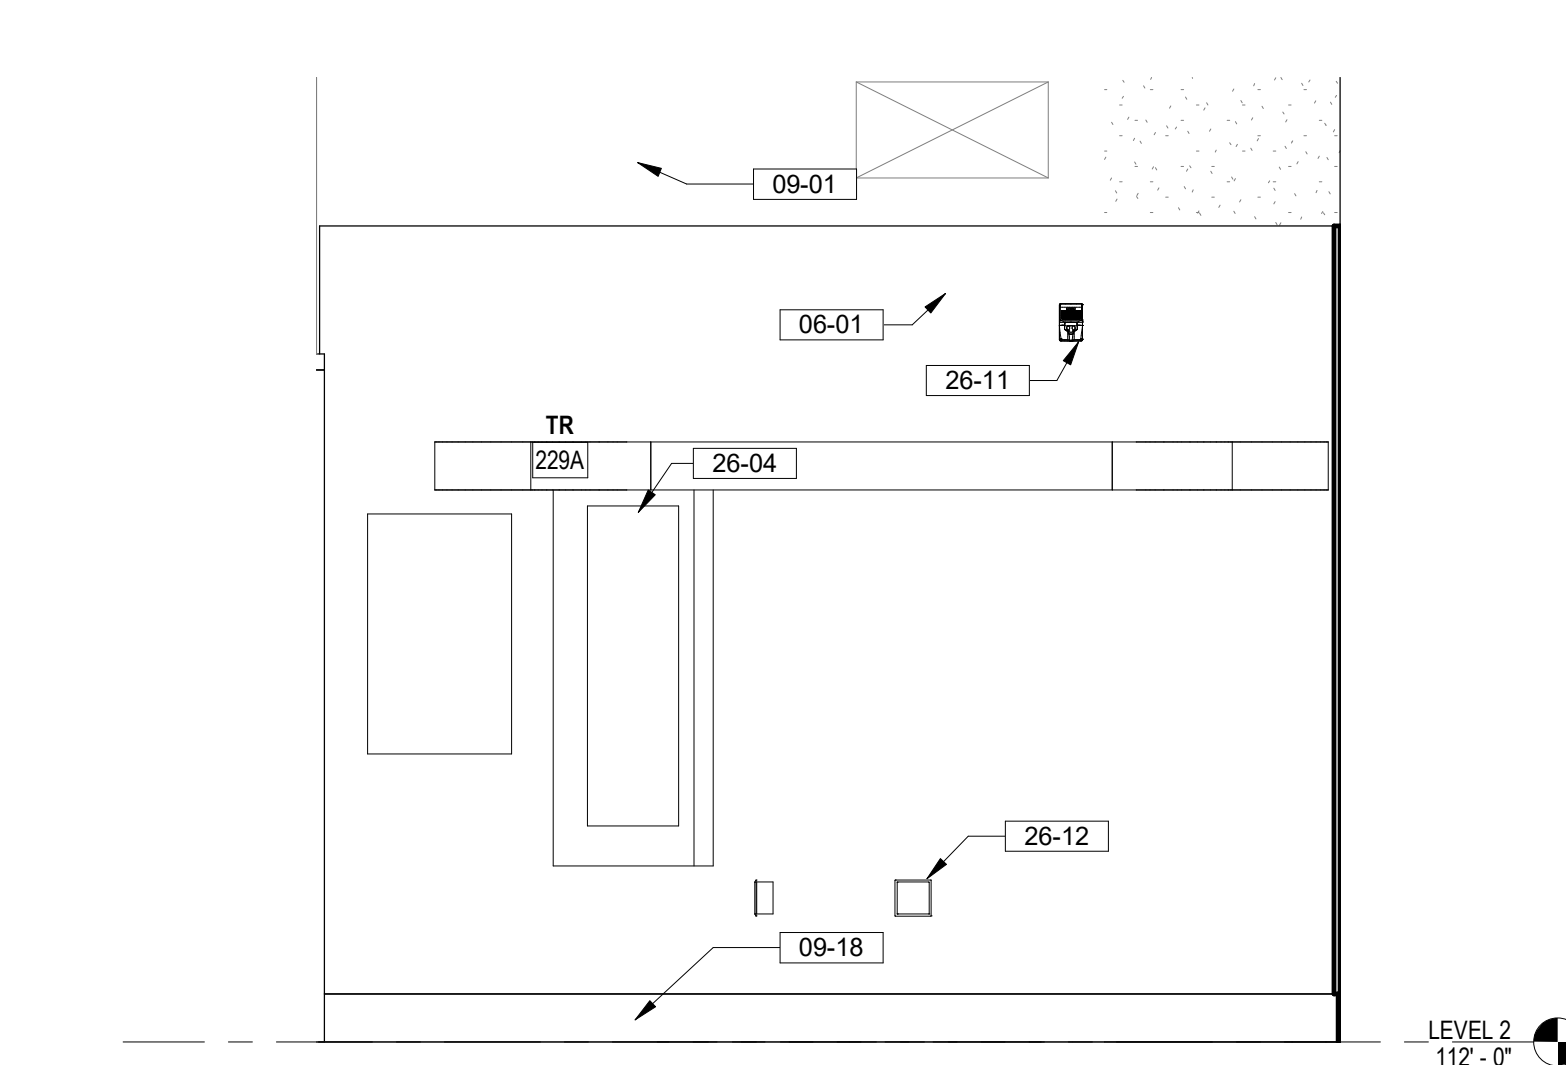


5 TR 229A SOUTH ELEVATION
1/2" = 1'-0"

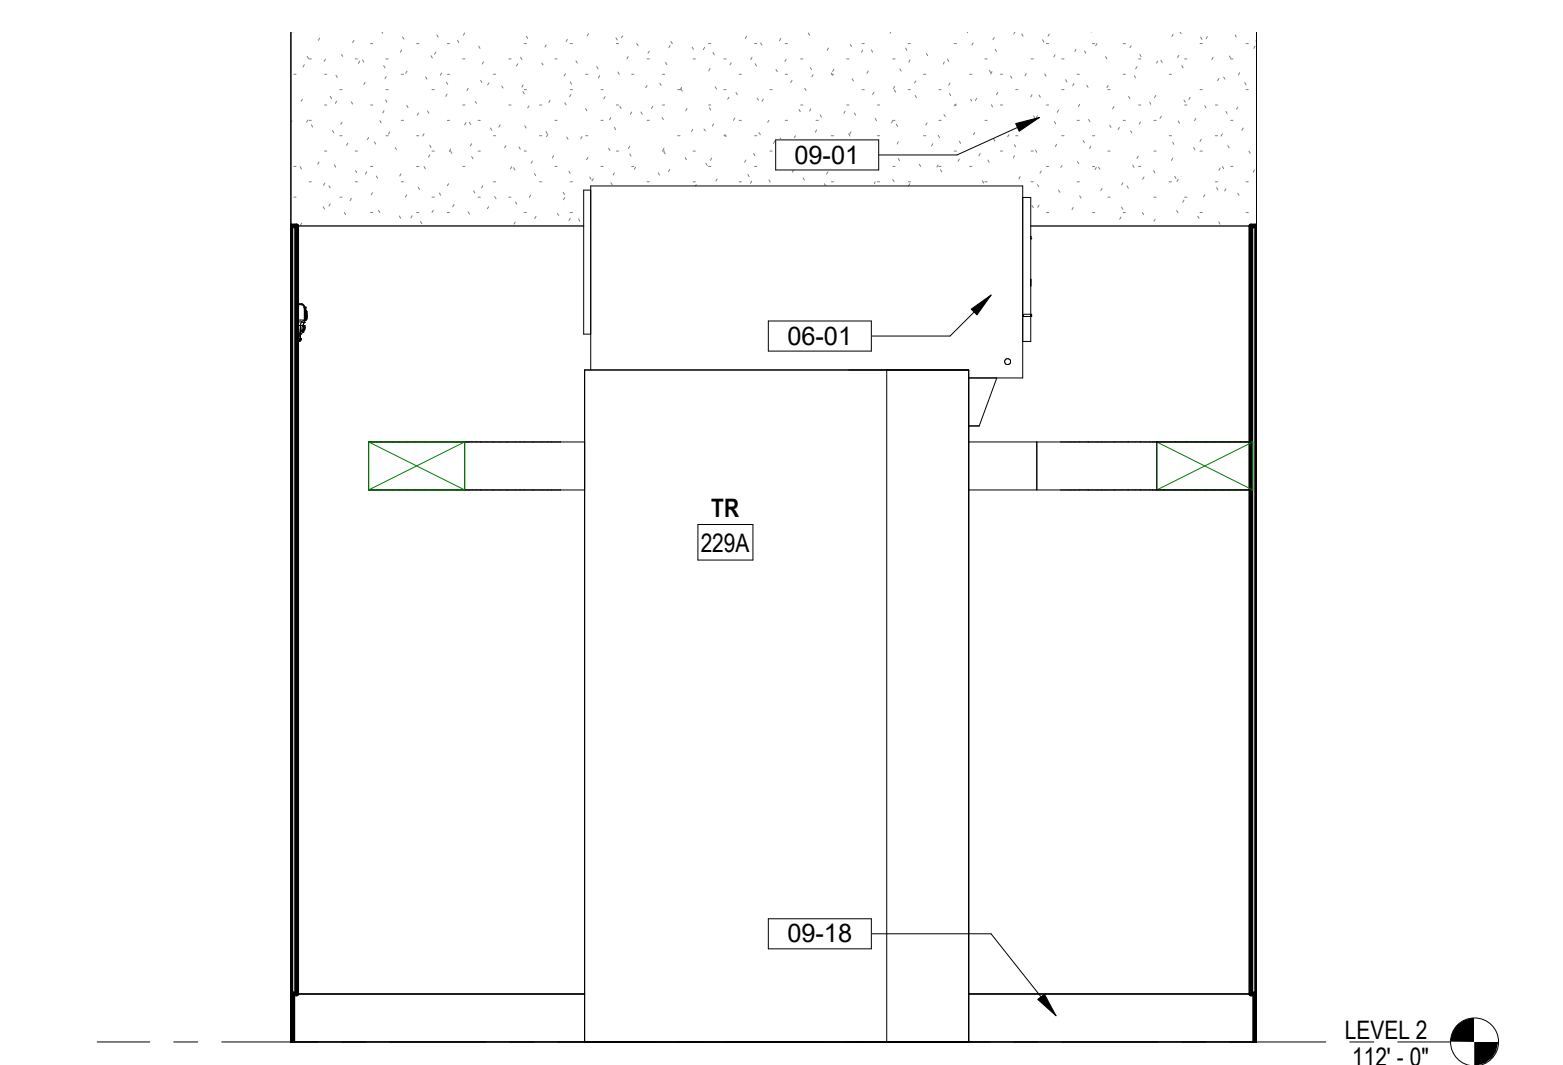

6 TR 229A WEST ELEVATION
1/2" = 1'-0"

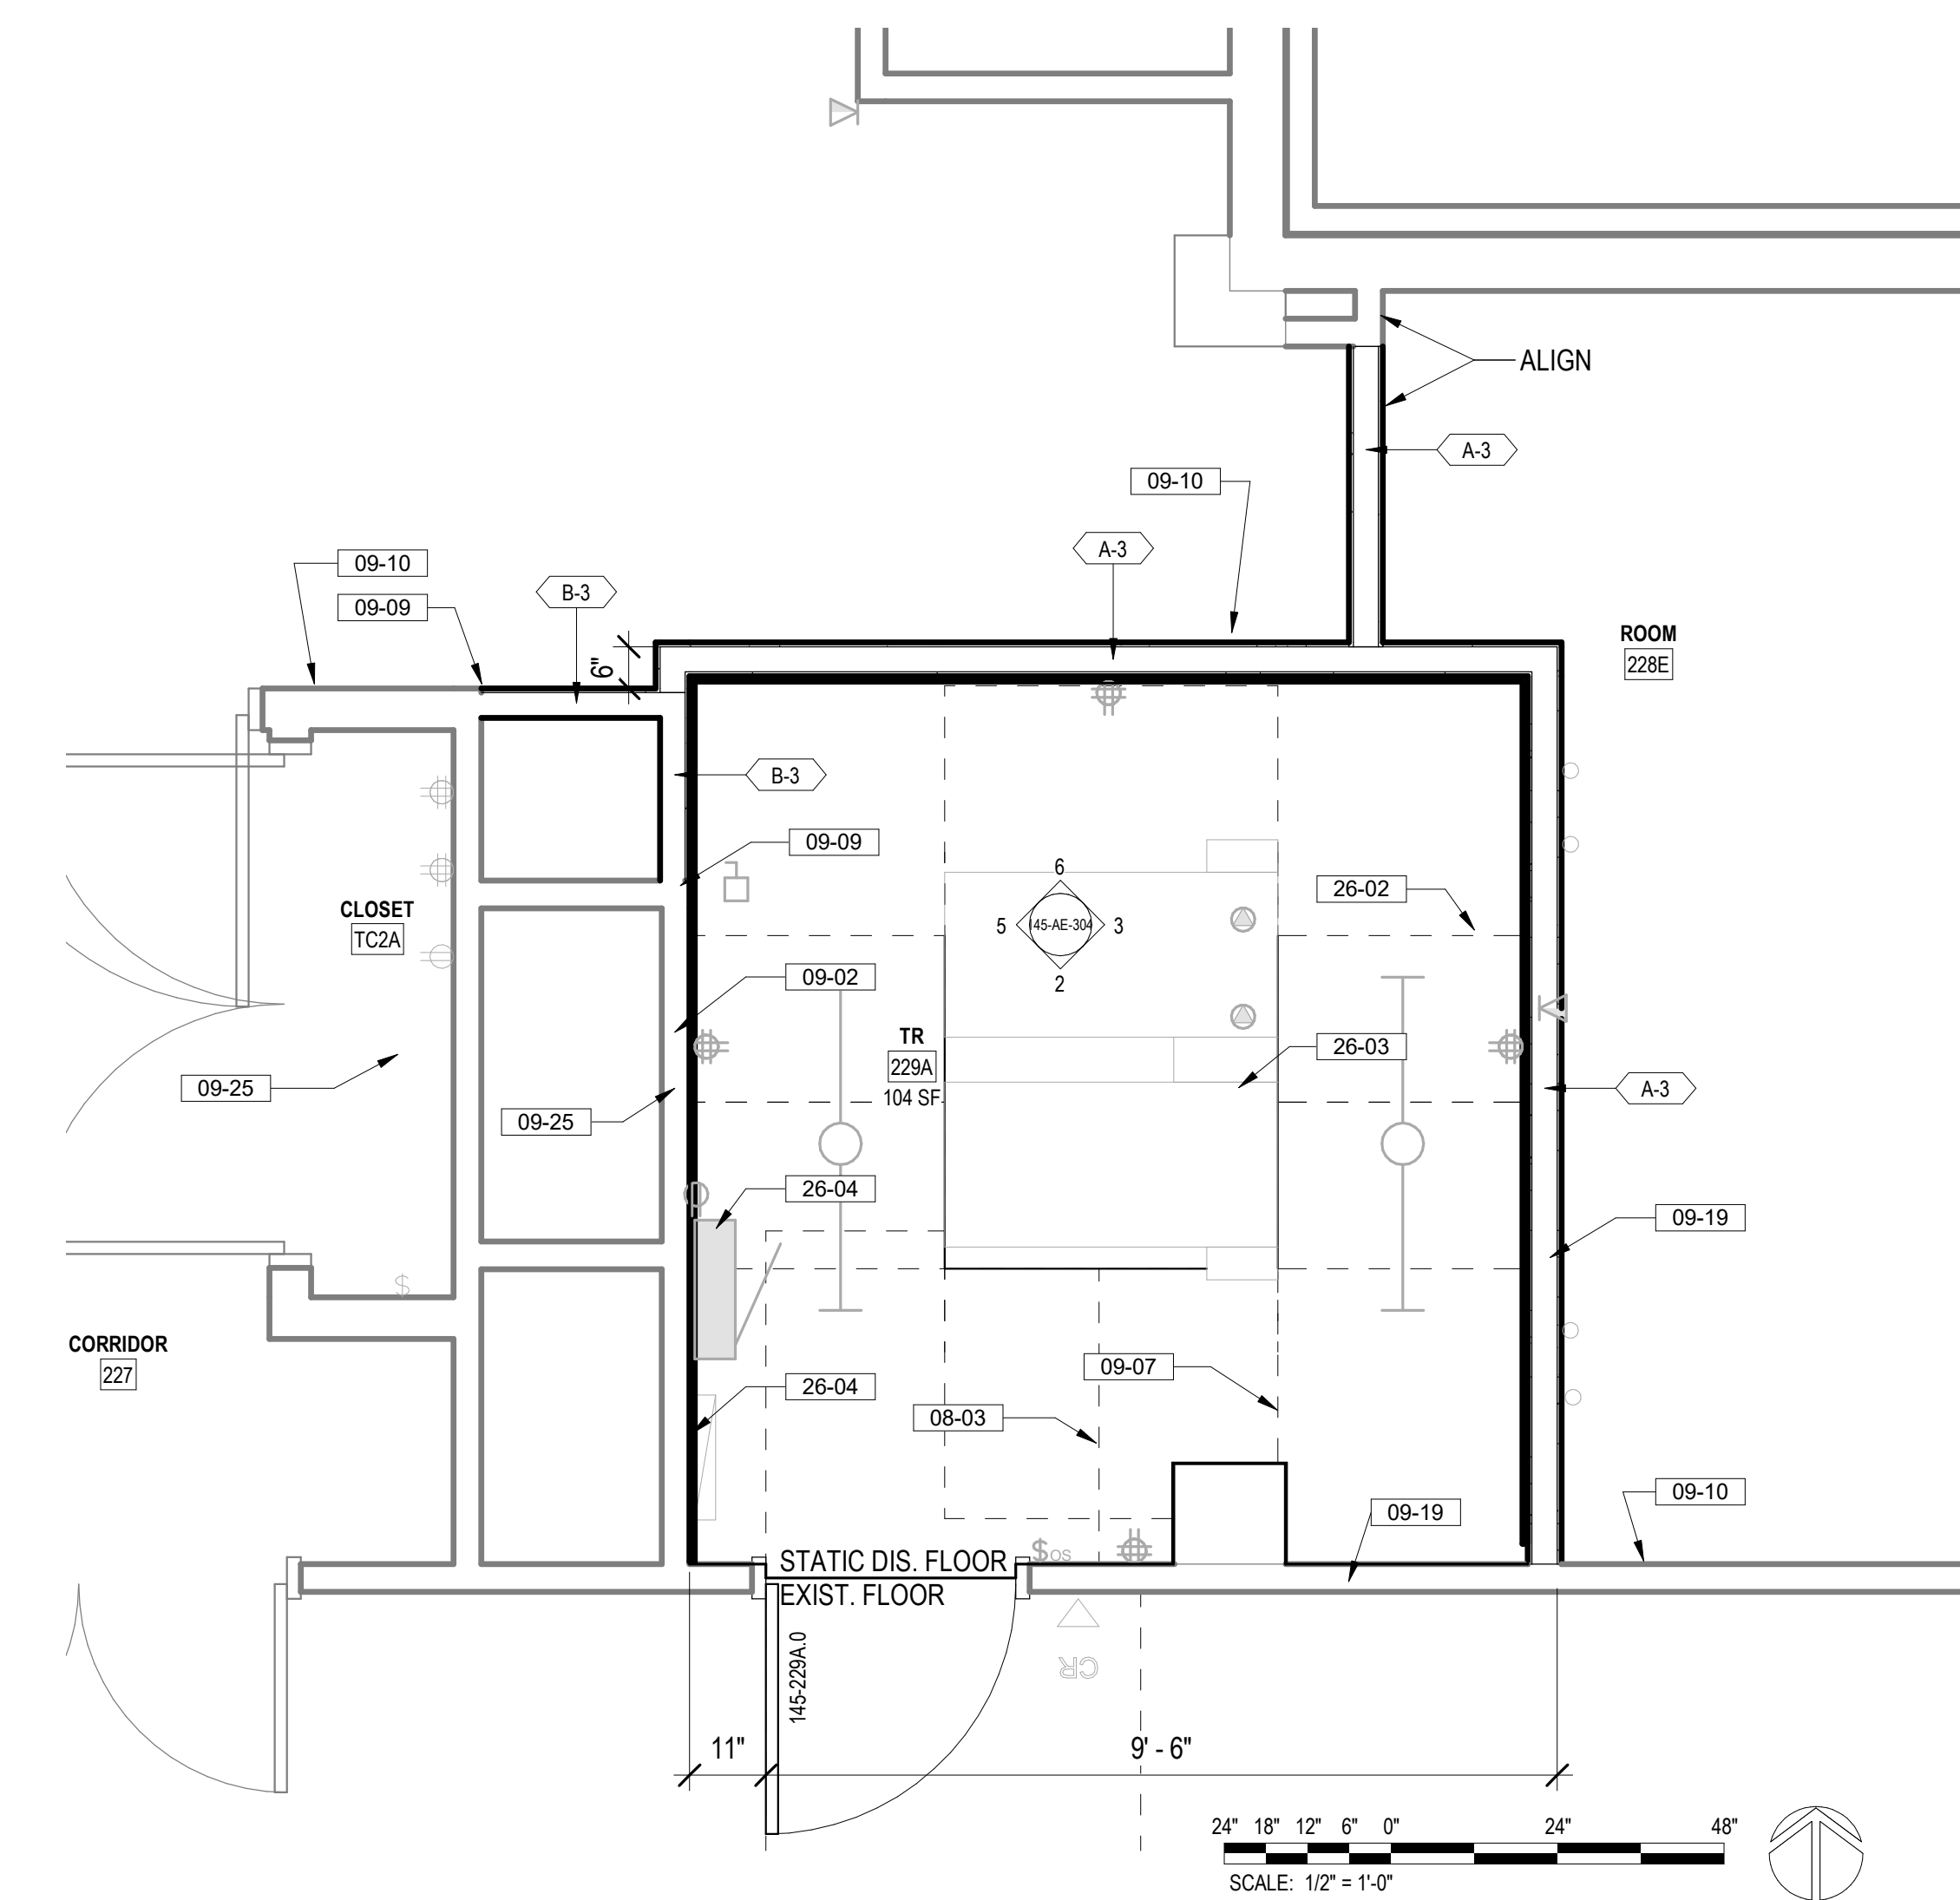

1 TR 229 ENLARGED PLAN
1/2" = 1'-0"

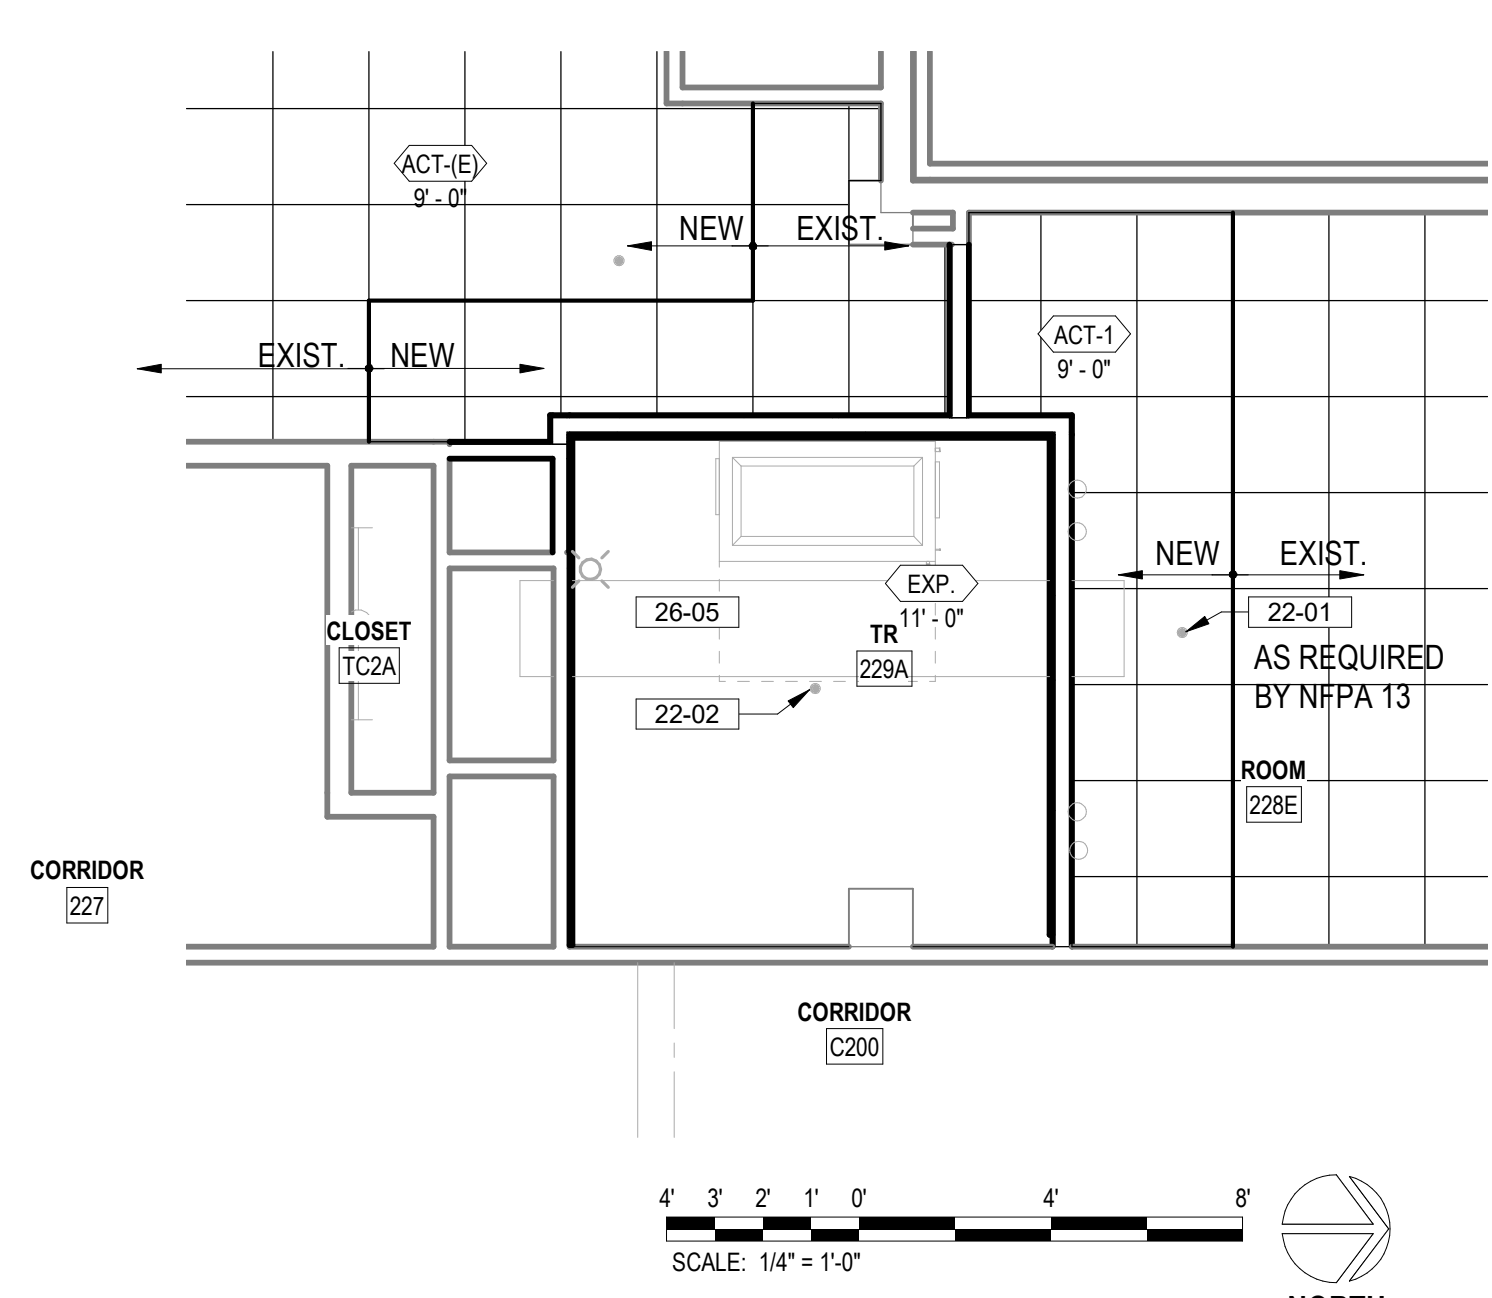

4 LEVEL 2 - TR 229A REFLECTED CEILING PLAN
1/4" = 1'-0"

KEYNOTES

- 06-01 INSTALL 3/4" AC GRADE OR BETTER FIRE RETARDANT PLYWOOD. PAINT WITH TWO COATS OF SEMI-GLOSS BRIGHT WHITE FIRE RETARDANT PAINT. MOUNT BOTTOM OF PLYWOOD 6" A.F.F., TOP OF PLYWOOD AT 8'-6" A.F.F.
- 06-03 ADA DOOR CLEARANCES SHOWN DASHED
- 09-01 PAINT WALL ABOVE PLYWOOD WITH SEMI-GLOSS PAINT. COLOR TO MATCH PLYWOOD PAINT.
- 09-02 PATCH ALL DAMAGED WORK ON EXISTING SURFACES ABOVE AND BELOW CEILING TILES. PAINT ALL WALLS; PROVIDE NEW RESILIENT 6TH RESILIENT WALL BASE
- 09-07 INSTALL STATIC DISSIPATIVE RESILIENT FLOORING
- 09-09 APPLY JOINT COMPOUND AND FEATHER A MINIMUM OF 3" HORIZONTALLY AS REQUIRED TO ACHIEVE A SMOOTH AND UNIFORM APPEARANCE
- 09-10 PAINT FULL LENGTH OF WALL TO NEAREST EXTERIOR OR INTERIOR CORNER. COLOR TO MATCH EXISTING WALLS.
- 09-18 6" HIGH COVED RUBBER WALL BASE. COLOR TO BE SELECTED FROM MANUFACTURER'S STANDARD SELECTION
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- 23-05 MECHANICAL UNITS. SEE MECH DRAWINGS FOR SIZE AND SPECS
- 26-02 3" PERIMETER CLEARANCE AROUND SERVER RACK SHOWN DASHED
- 26-03 TELECOMM RACK. SEE TELECOMMUNICATION DRAWINGS
- 26-04 ELECTRICAL PANELS. SEE ELECTRICAL DRAWINGS
- 26-11 STROBE LIGHT. SEE ELECTRICAL DRAWINGS
- 26-12 ELECTRICAL OUTLETS MOUNTED ON PLYWOOD

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Revisions:	Date:

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PROGRAM CONTRACTING ACTIVITY CENTRAL (PCAC)

VA U.S. Department of Veterans Affairs

DRAWING TITLE
145-ENLARGED TR PLANS AND ELEVATIONS

APPROVED: Project Director

PHASE
100% CONSTRUCTION DOCUMENTS

FLS
FULLY SPRINKLERED

PROJECT TITLE
EHRM INFRASTRUCTURE UPGRADES

LOCATION
FORT MEADE, SOUTH DAKOTA

ISSUE DATE
04/15/2022

CHECKED BY
TMP


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PROJECT NUMBER
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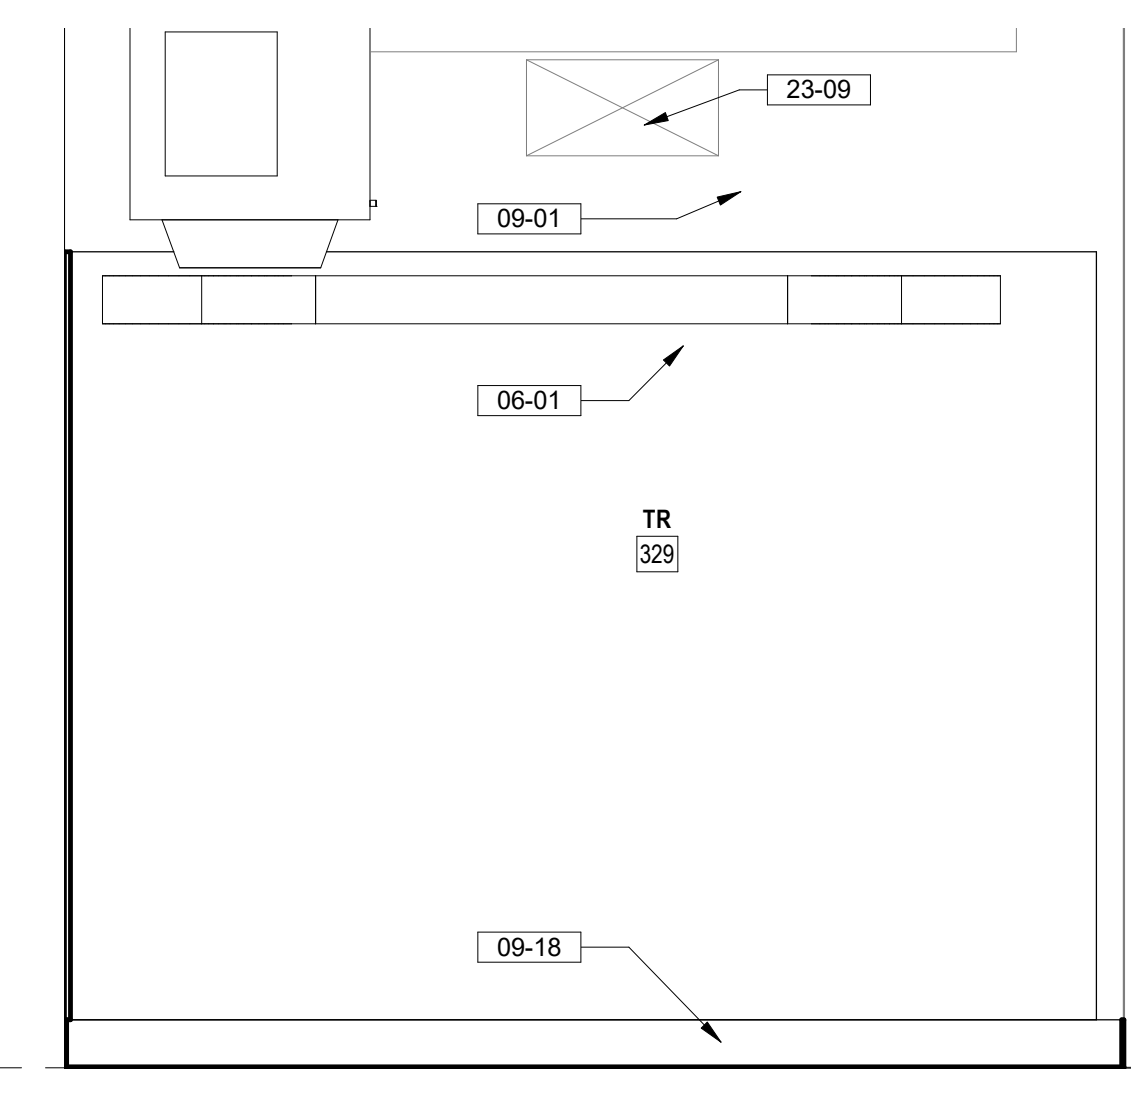
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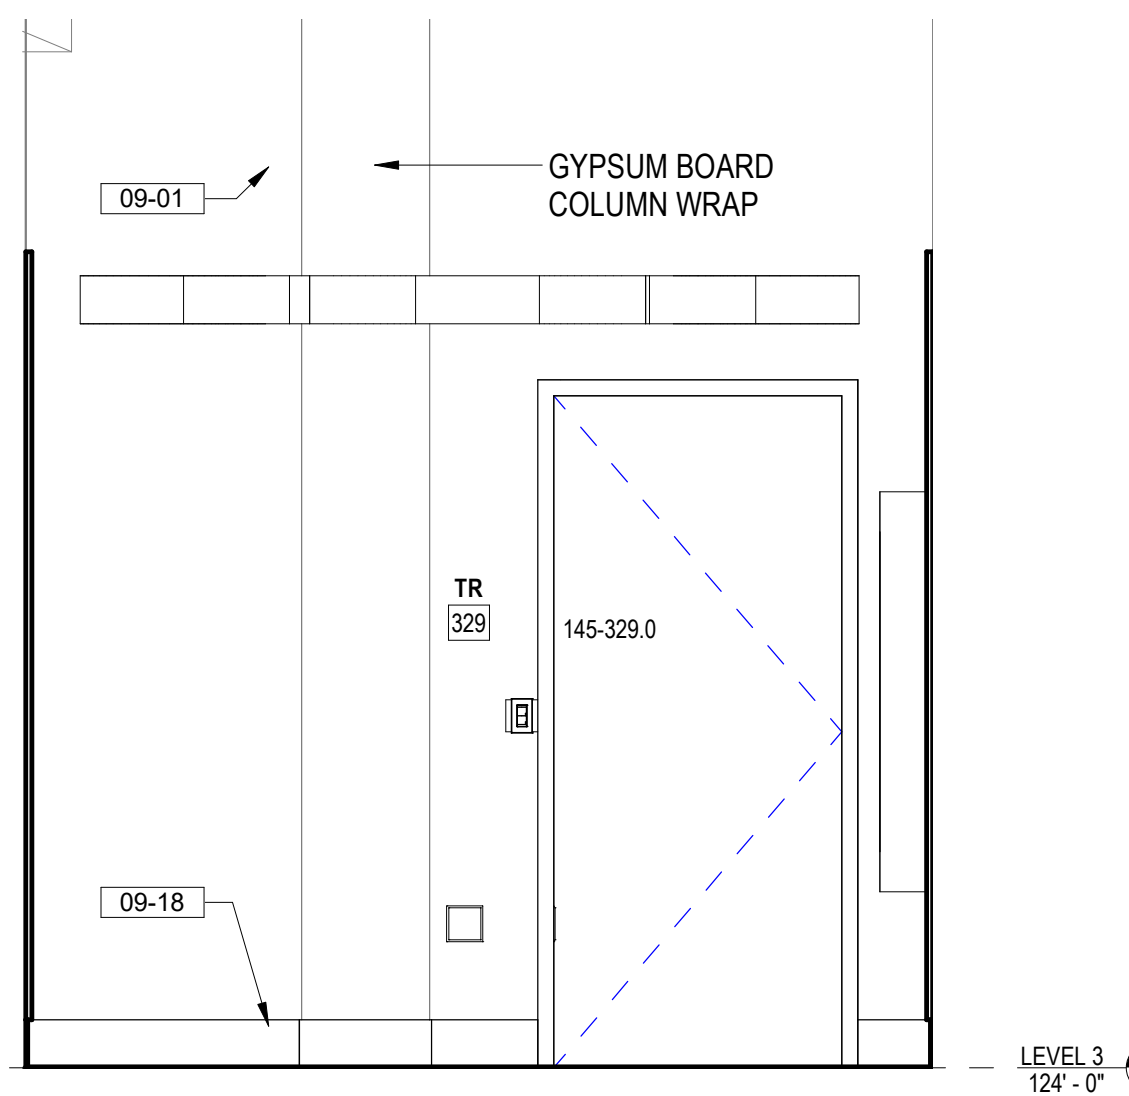
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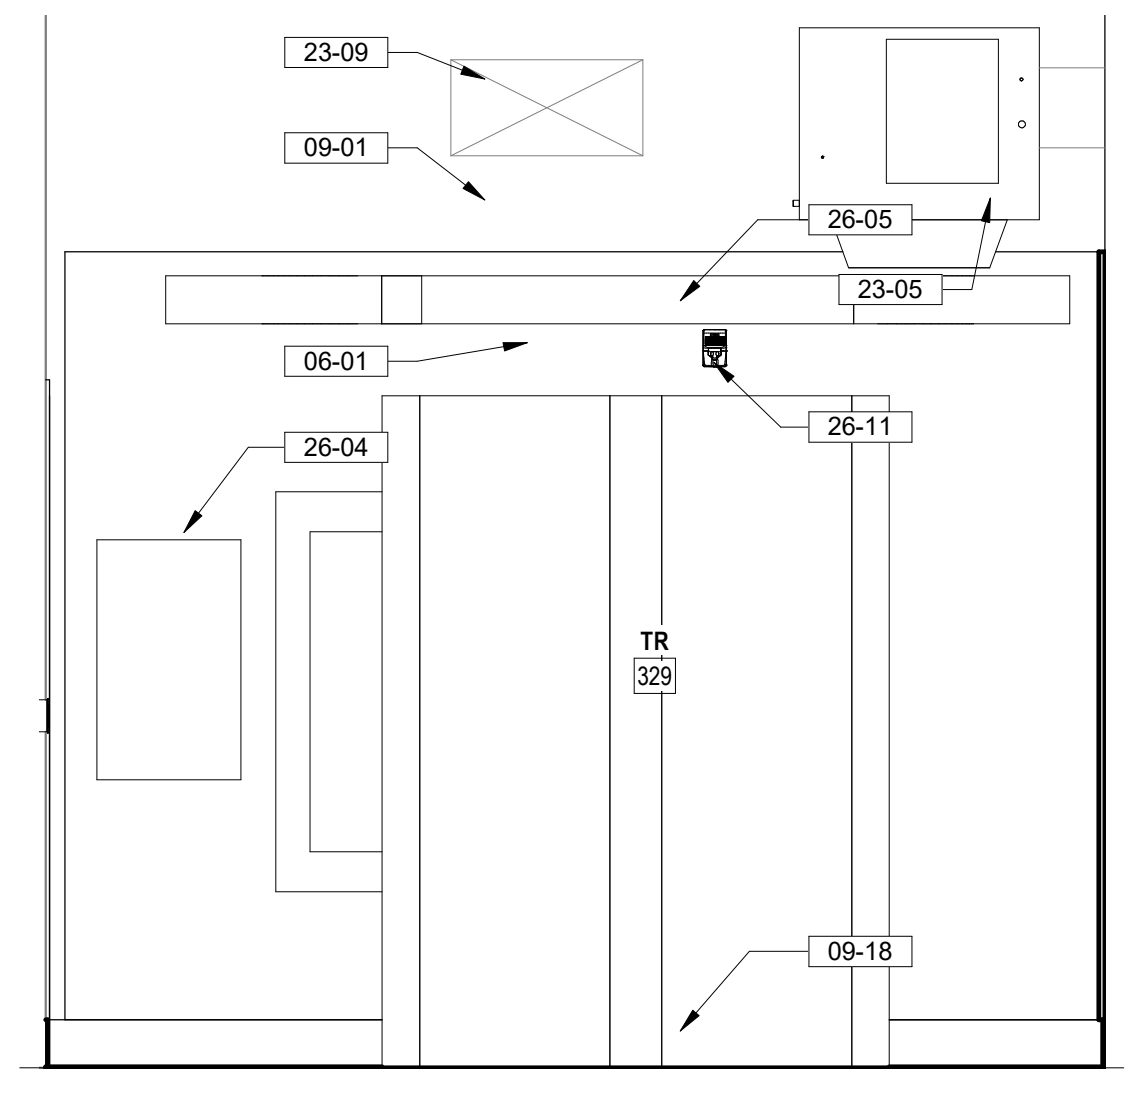
2 TR 329 WEST ELEVATION
1/2" = 1'-0"



3 TR 329 NORTH ELEVATION
1/2" = 1'-0"



5 TR 329 EAST ELEVATION
1/2" = 1'-0"

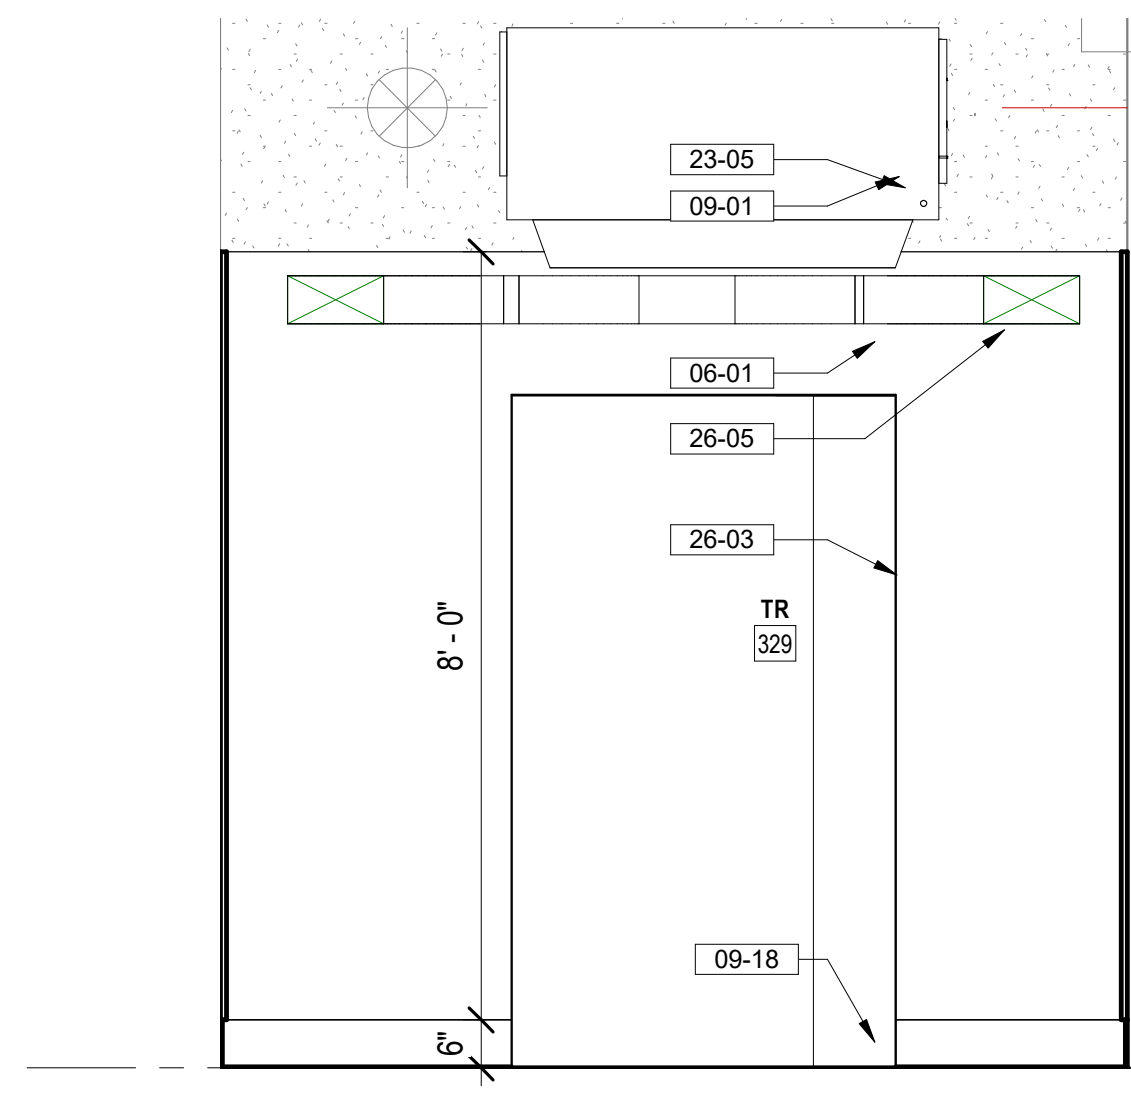

6 TR 329 SOUTH ELEVATION
1/2" = 1'-0"

FLOOR PLAN LEGEND

- CARD READER, REF TELECOM DRAWINGS
- DATA PORT, REF TELECOM DRAWINGS
- OUTLET, REF ELEC DRAWINGS
- WIRELESS ACCESS POINT, REF TELECOM DRAWINGS
- ELEC PANEL, REF ELEC DRAWINGS
- STRIP LIGHT FIXTURE, REF ELEC DRAWINGS

FLOOR PLAN NOTES

1. SEE G SERIES SHEETS FOR BALANCE OF FLOOR PLAN GENERAL NOTES.
2. REFER TO STRUCTURAL, MECHANICAL, AND ELECTRICAL DRAWINGS FOR ADDITIONAL INFORMATION. ALL INFORMATION REGARDING EXISTING CONDITIONS IS BASED UPON OWNER-SUPPLIED DOCUMENTS AND MAY NOT PRECISELY REFLECT FIELD CONDITIONS.
3. PROVIDE ALL BACKING FOR MILLWORK, GRAB BARS, AND ANY AND ALL WALL MOUNTED EQUIPMENT OR ACCESSORIES; COORDINATE LOCATIONS.
4. ALL DIMENSIONS ARE FROM STRUCTURAL OR UNFINISHED FACE OF STUD, UNLESS OTHERWISE NOTED.
5. PROVIDE A SMOOTH AND LEVEL FINISH FLOOR, TYP. PATCH AND REPAIR ALL INCONSISTENCIES IN FLOOR ELEVATIONS.
6. PATCH AND REPAIR ANY / ALL WALL SURFACES AS REQUIRED TO PROVIDE SUITABLE SUBSTRATE FOR FINISHES.
7. REFER TO DOOR AND FRAME SCHEDULE FOR DOORS REQUIRING ADA ACCESS CONTROL.
8. PROVIDE ACOUSTICAL SEALANT AROUND WALL EDGES, TOP AND BOTTOM, AND PENETRATIONS, AND INSTALL PUTTY PADS AROUND ELECTRICAL BOXES WHERE PARTITION CONTAINS ACOUSTICAL INSULATION.
9. ALL TELECOMMUNICATION ROOMS ARE TO HAVE EXPOSED STRUCTURE UNLESS NOTED OTHERWISE, NO CEILINGS SPECIFIED.



REFLECTED CEILING PLAN LEGEND

- 2x2 LIGHT FIXTURE
- 2x4 LIGHT FIXTURE
- STRIP LIGHT FIXTURE
- 6" RECESSED CAN LIGHT FIXTURE
- SUPPLY AIR DIFFUSER
- RETURN AIR VENT
- EXHAUST FAN
- 5/8" GYP. BOARD CEILING AFFIXED TO 3 5/8" MTL STUDS
- 2x2' SUSPENDED ACOUSTIC CEILING TILE CEILING
- 2x4' SUSPENDED ACOUSTIC CEILING TILE CEILING


REFLECTED CEILING PLAN NOTES

1. REFER TO ELECTRICAL SHEETS FOR FIXTURE TYPES, SWITCHING, AND SPECIAL SYSTEMS.
2. REFER TO MECHANICAL SHEETS FOR DIFFUSER AND DUCTING LAYOUTS.
3. SEE SHEET 00-GI-006 FOR TYPICAL ACOUSTICAL PANEL CEILING DETAILS

PROJECT KEY PLAN

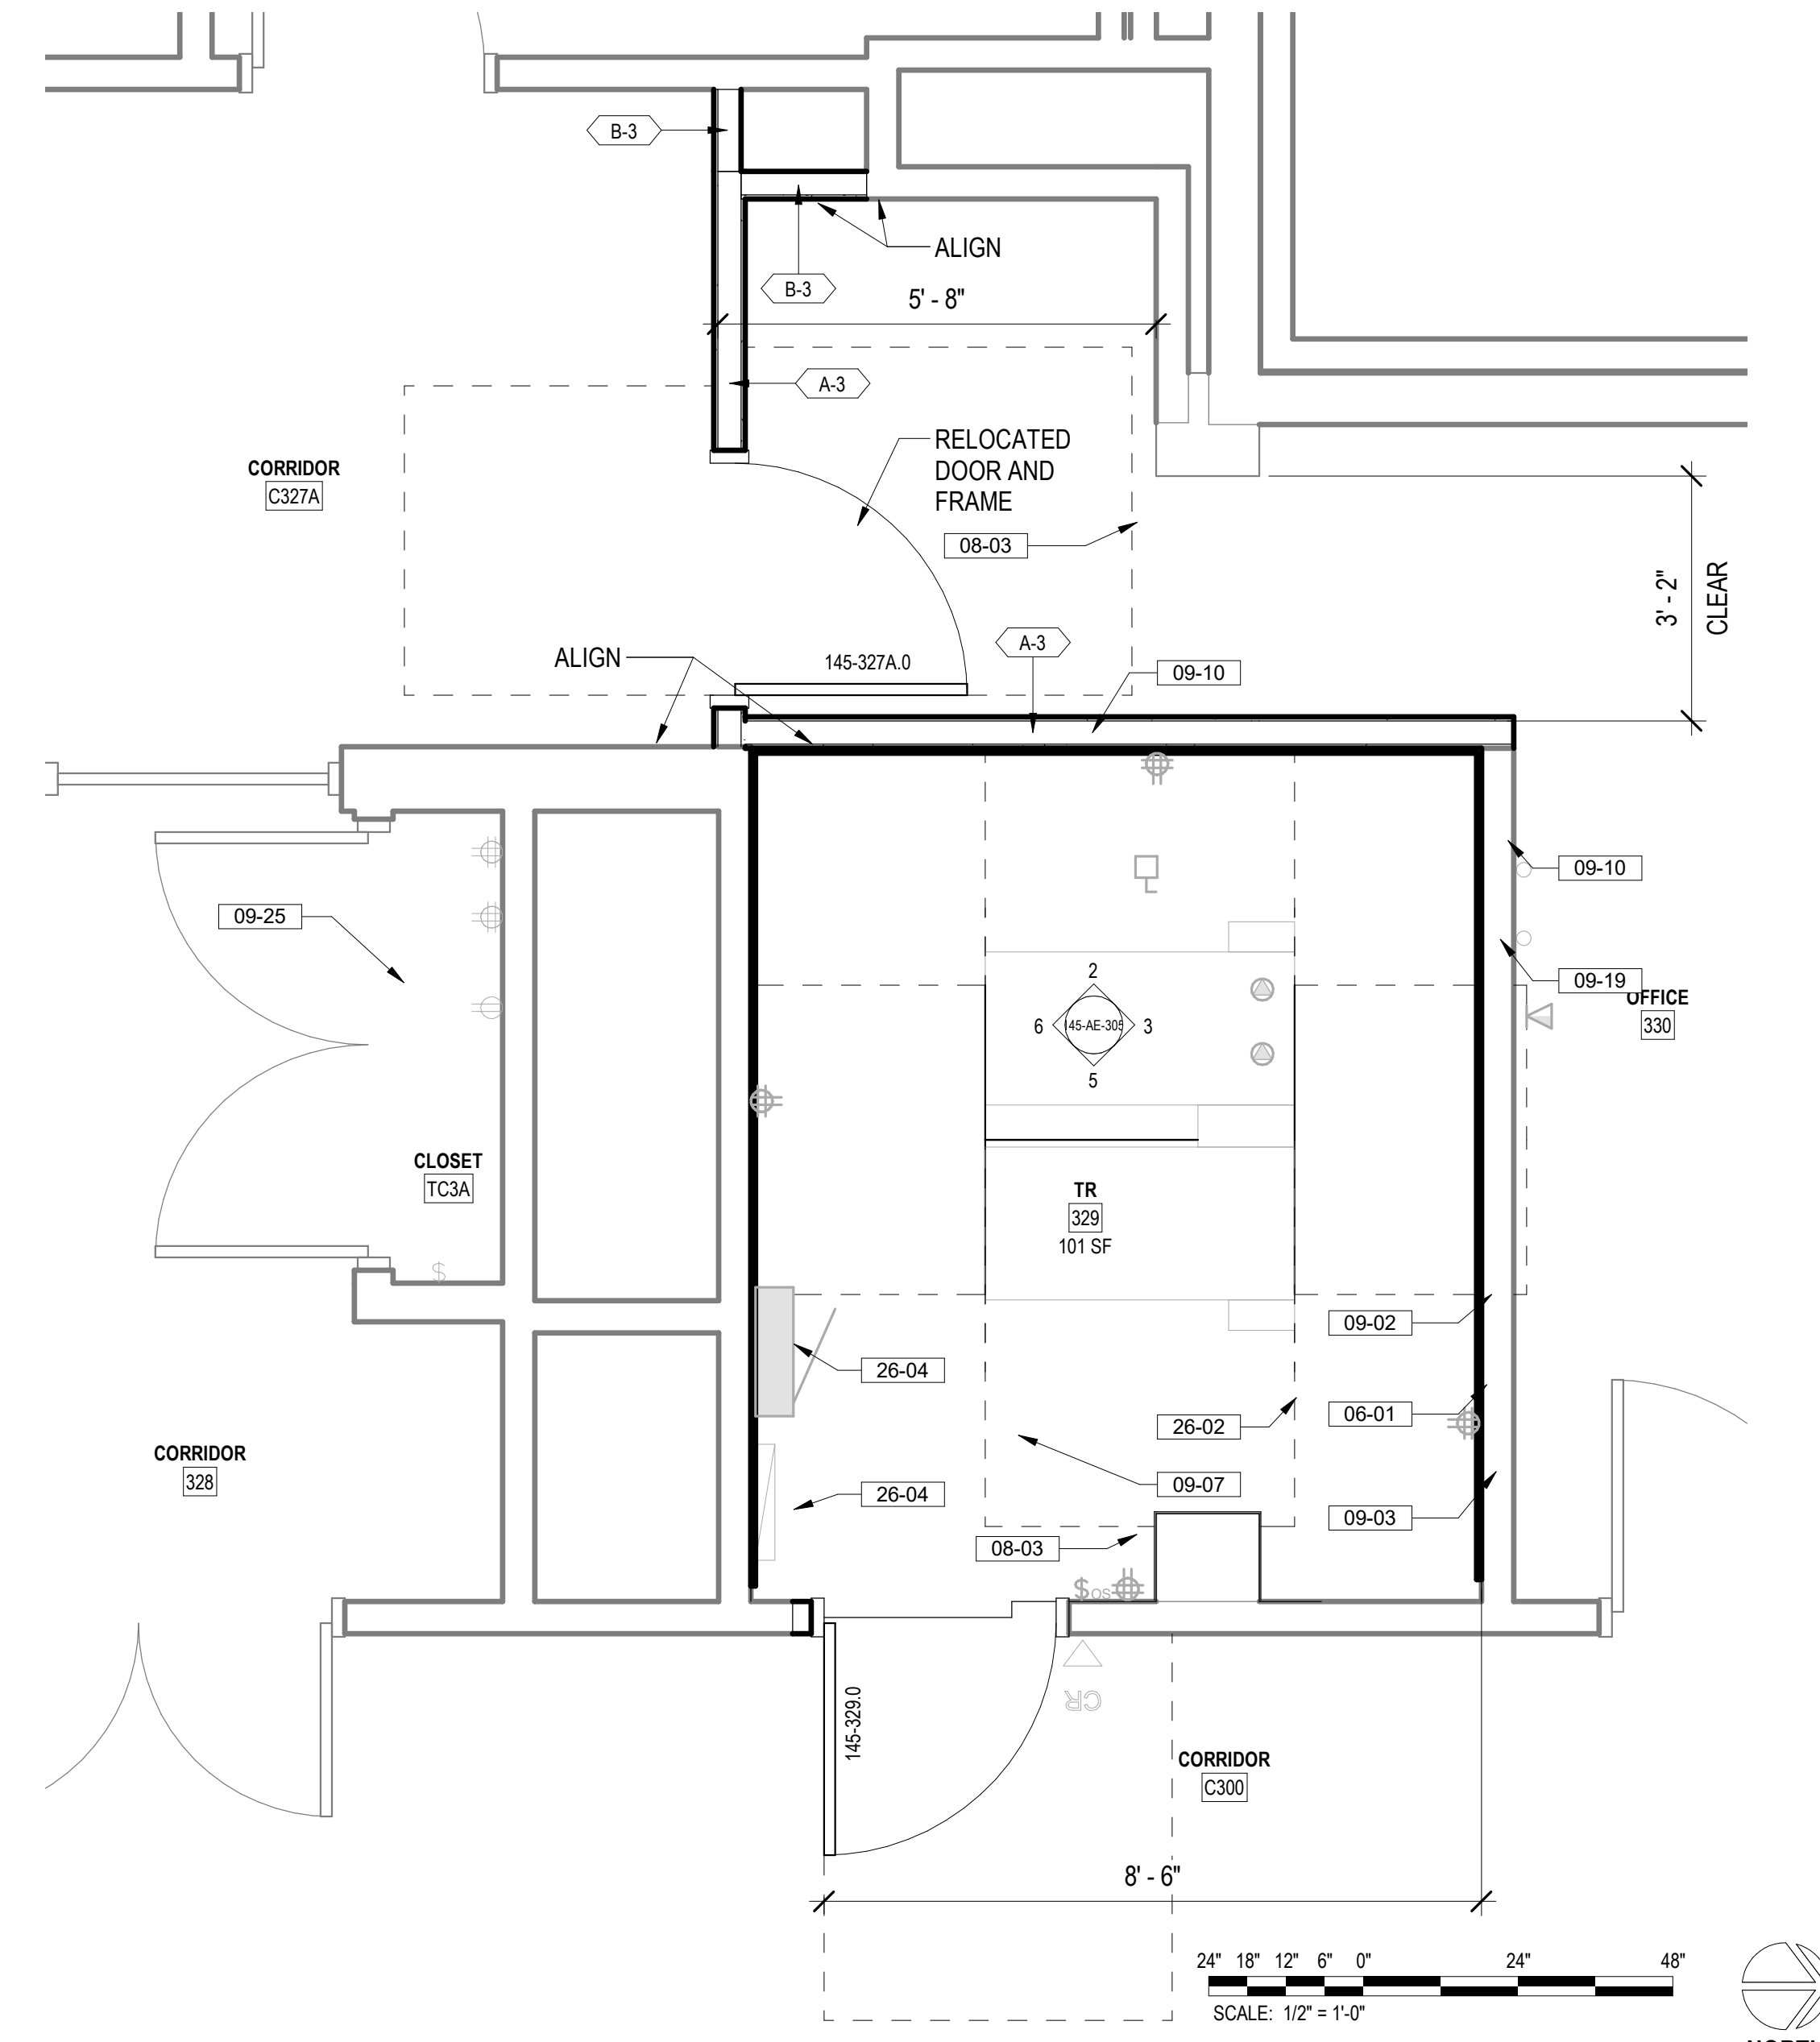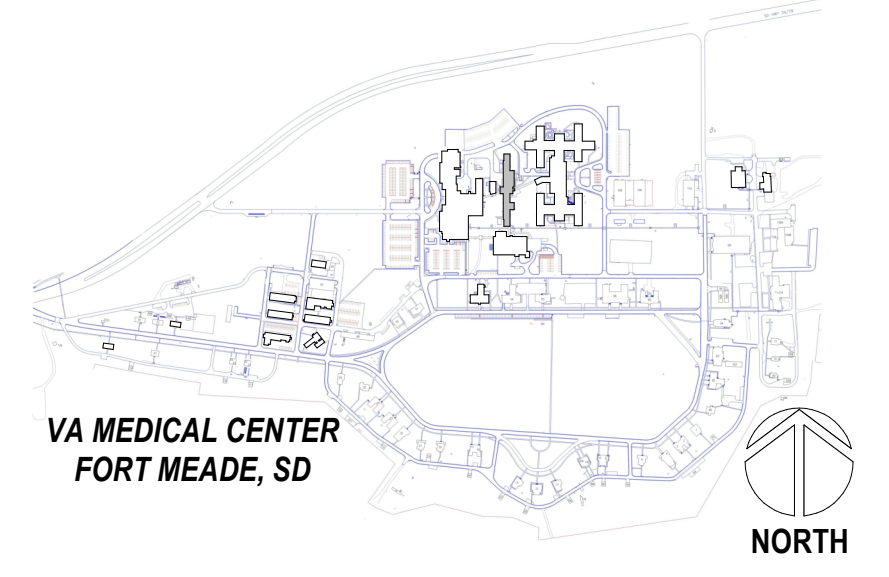

1 TR 329 ENLARGED PLAN
1/2" = 1'-0"

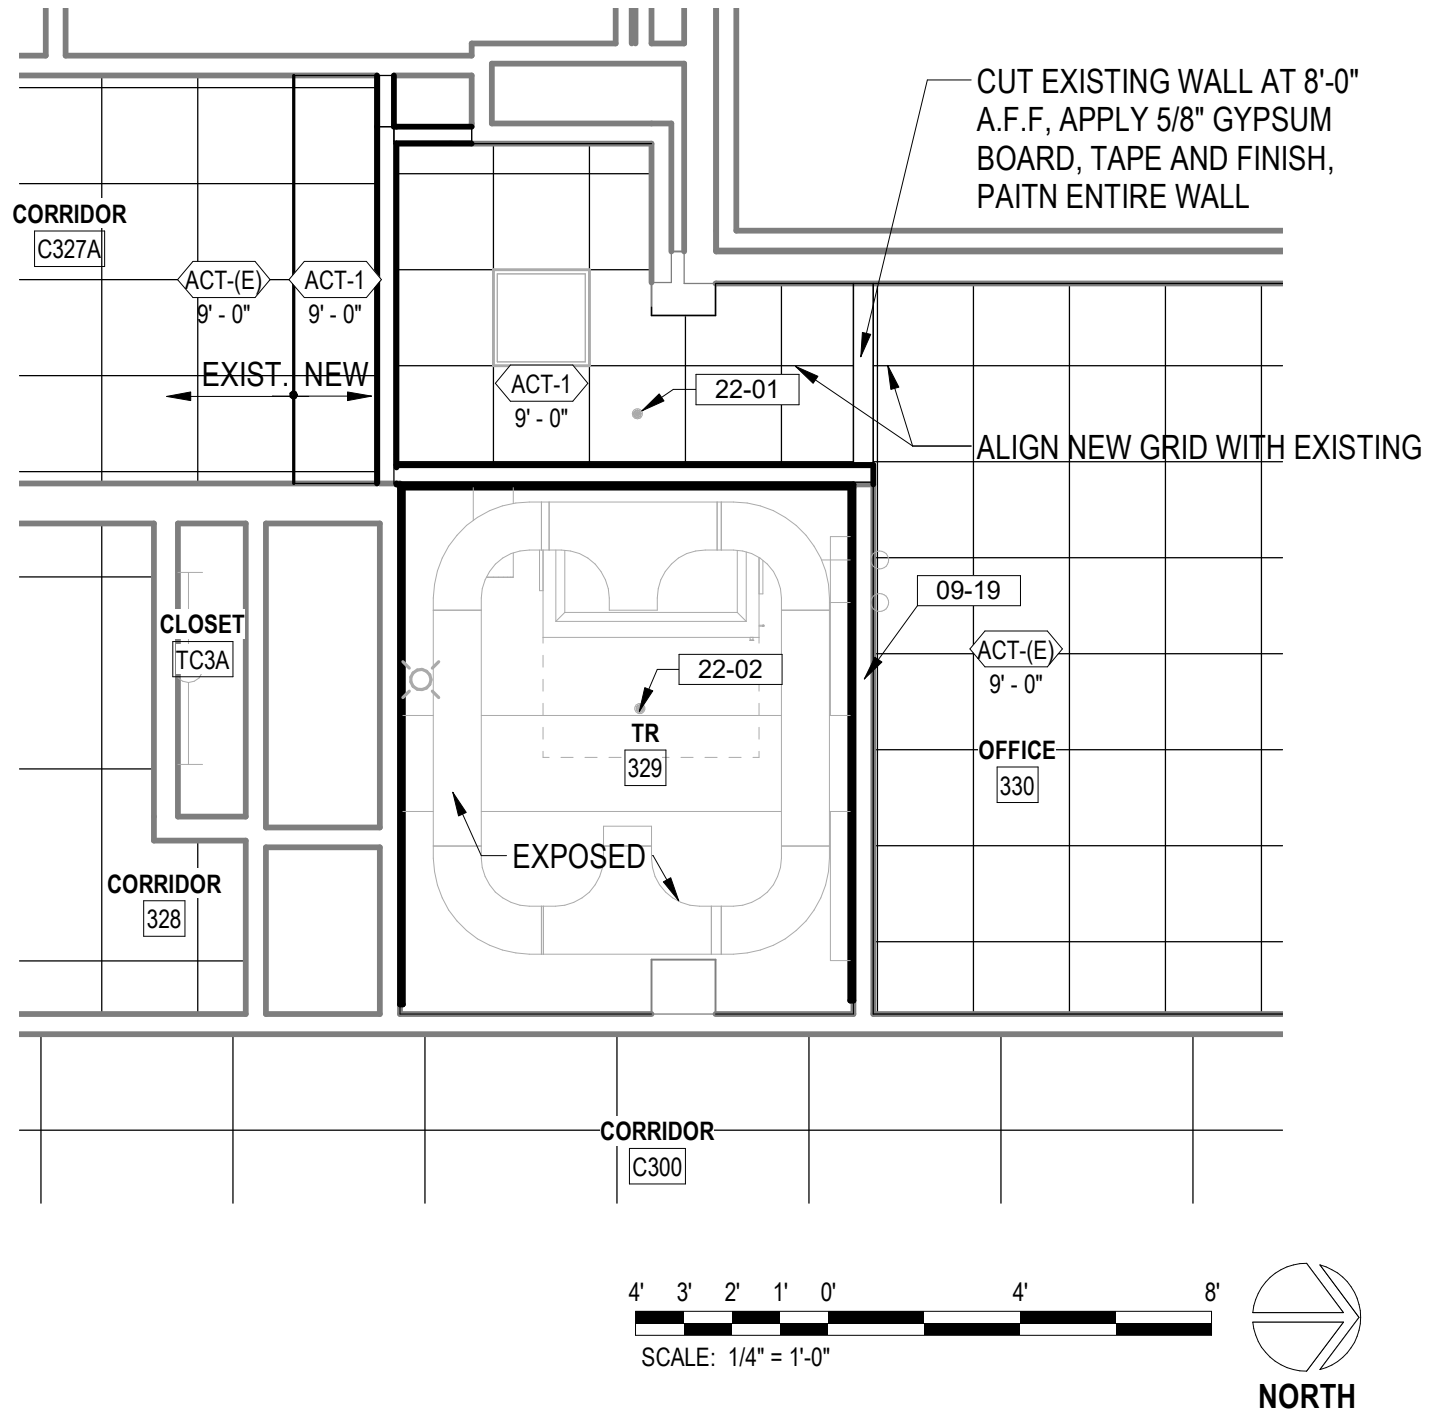

4 LEVEL 3 - TR 329 REFLECTED CEILING PLAN
1/4" = 1'-0"

KEYNOTES

- 06-01 INSTALL 3/4" AC GRADE OR BETTER FIRE RETARDANT PLYWOOD; PAINT WITH TWO COATS OF SEMI-GLOSS BRIGHT WHITE FIRE RETARDANT PAINT; MOUNT BOTTOM OF PLYWOOD 6" A.F.F. TOP OF PLYWOOD AT 8'-6" A.F.F.
- 09-01 ADA DOOR CLEARANCES SHOWN DASHED
- 09-02 PATCH ALL DAMAGED WORK ON EXISTING SURFACES ABOVE AND BELOW CEILING TILES. PAINT ALL WALLS; PROVIDE NEW RESILIENT 6" RESILIENT WALL BASE
- 09-03 EXTEND EXISTING GYPSUM BOARD TO UNDERSIDE OF STRUCTURE WHERE NOT INSTALLED; SEAL TO STRUCTURAL DECK
- 09-07 INSTALL STATIC DISSIPATIVE RESILIENT FLOORING
- 09-10 PAINT FULL LENGTH OF WALL TO NEAREST EXTERIOR OR INTERIOR CORNER. COLOR TO MATCH EXISTING WALLS
- 09-18 6" HIGH COVERED RUBBER WALL BASE. COLOR TO BE SELECTED FROM MANUFACTURER'S STANDARD SELECTION
- 09-19 EXTEND GYPSUM BOARD WALL TO UNDERSIDE OF STRUCTURE WITH 5/8" GYPSUM BOARD LAYER ON EACH SIDE OF WALL. SEAL
- 09-25 PATCH AND REPAIR ANY GYPSUM BOARD OPENINGS FOUND AT PERIMETER OF WALL. SEAL PERIMETER OF ROOM IN ITS ENTIRETY. PAINT
- 22-01 FIRE SUPPRESSION SPRINKLER HEAD SHOWN FOR REFERENCE ONLY. FIRE SUPPRESSION CONTRACTOR TO VERIFY ACTUAL QUANTITIES REQUIRED. INSTALL SYMMETRICALLY CENTER IN TILE
- 22-02 UPRIGHT HEAD FIRE SUPPRESSION SPRINKLER HEAD SHOWN FOR REFERENCE ONLY. FIRE SUPPRESSION CONTRACTOR TO VERIFY ACTUAL QUANTITIES REQUIRED. COORDINATE INSTALLATION WITH MECH DRAWINGS
- 23-05 MECHANICAL UNITS. SEE MECH DRAWINGS FOR SIZE AND SPECS
- 23-09 MECHANICAL DUCT WORK. SEE MECHANICAL DRAWINGS
- 26-02 3" PERIMETER CLEARANCE AROUND SERVER RACK SHOWN DASHED
- 26-03 TELECOMM RACK. SEE TELECOMMUNICATION DRAWINGS
- 26-04 ELECTRICAL PANELS. SEE ELECTRICAL DRAWINGS
- 26-05 CABLE TRAY. SEE TELECOMMUNICATION DRAWINGS
- 26-11 STROBE LIGHT. SEE ELECTRICAL DRAWINGS

Revisions:	Date:

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PROGRAM CONTRACTING ACTIVITY CENTRAL (PCAC)

VA U.S. Department of Veterans Affairs

DRAWING TITLE
145-ENLARGED TR PLANS AND ELEVATIONS

APPROVED: Project Director

PHASE
100% CONSTRUCTION DOCUMENTS

FLS
FULLY SPRINKLERED

PROJECT TITLE
EHRM INFRASTRUCTURE UPGRADES

LOCATION
FORT MEADE, SOUTH DAKOTA

ISSUE DATE
04/15/2022


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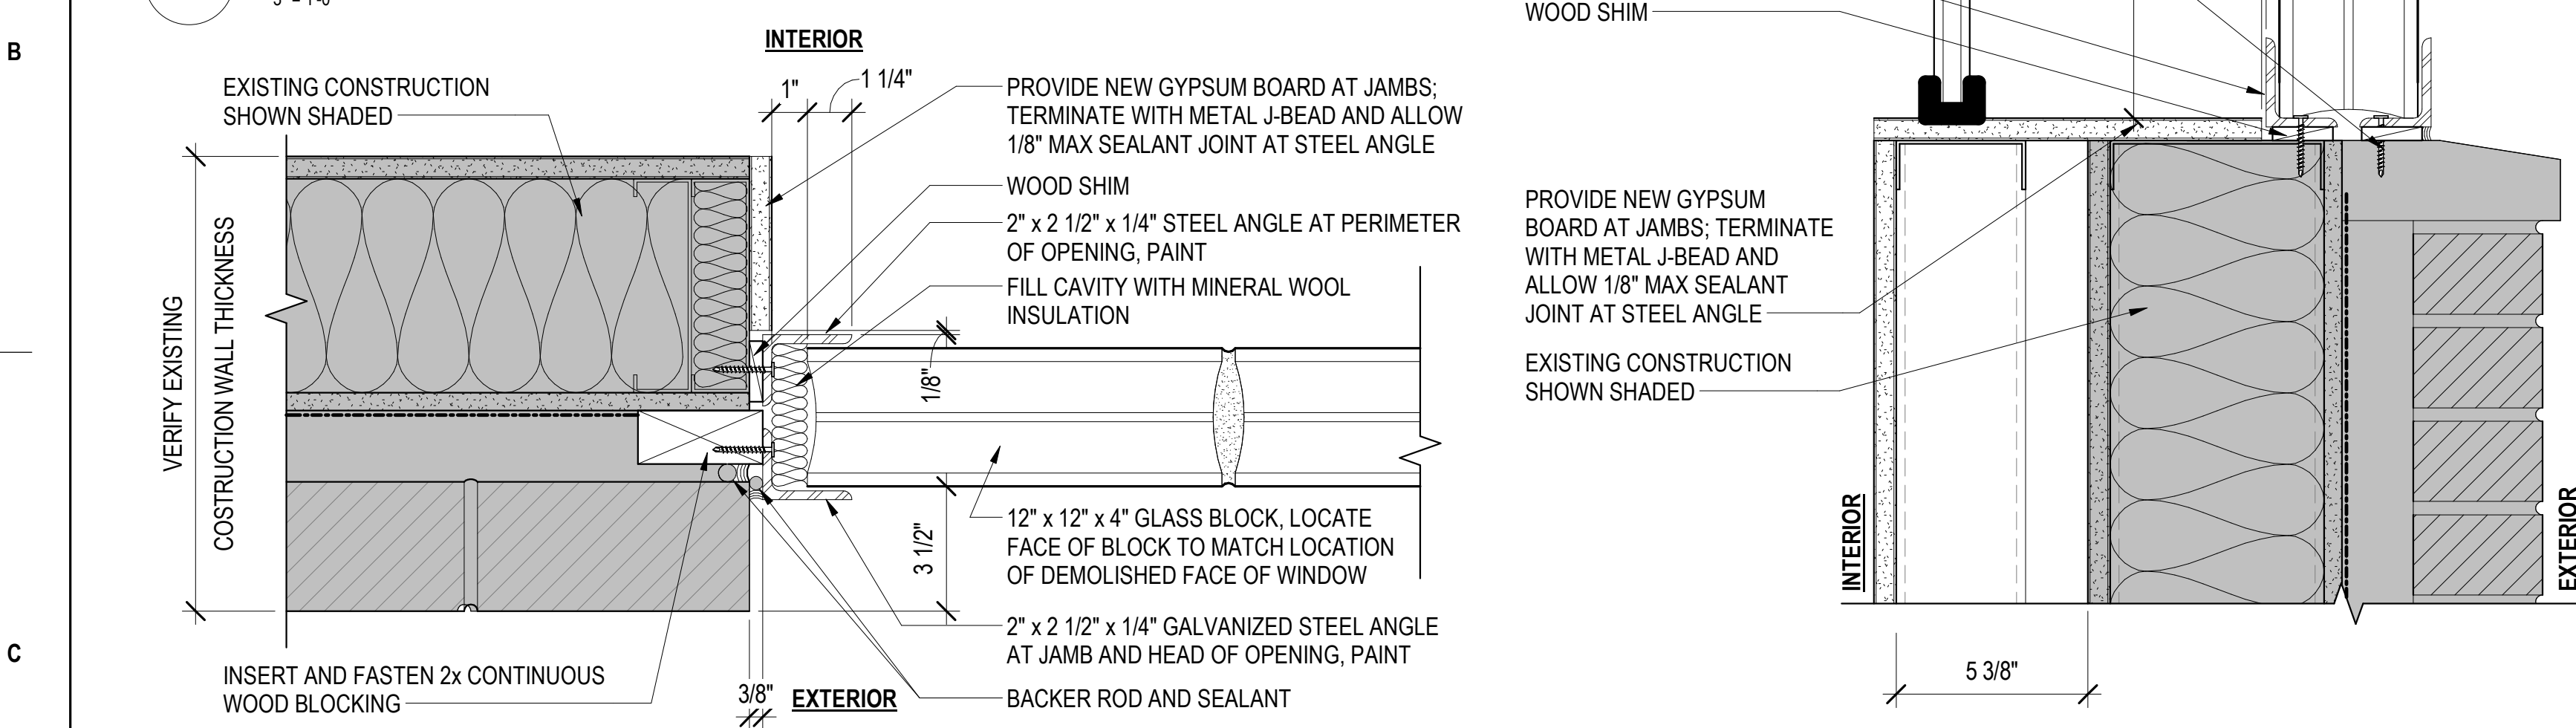
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568-21-701

BUILDING NUMBER
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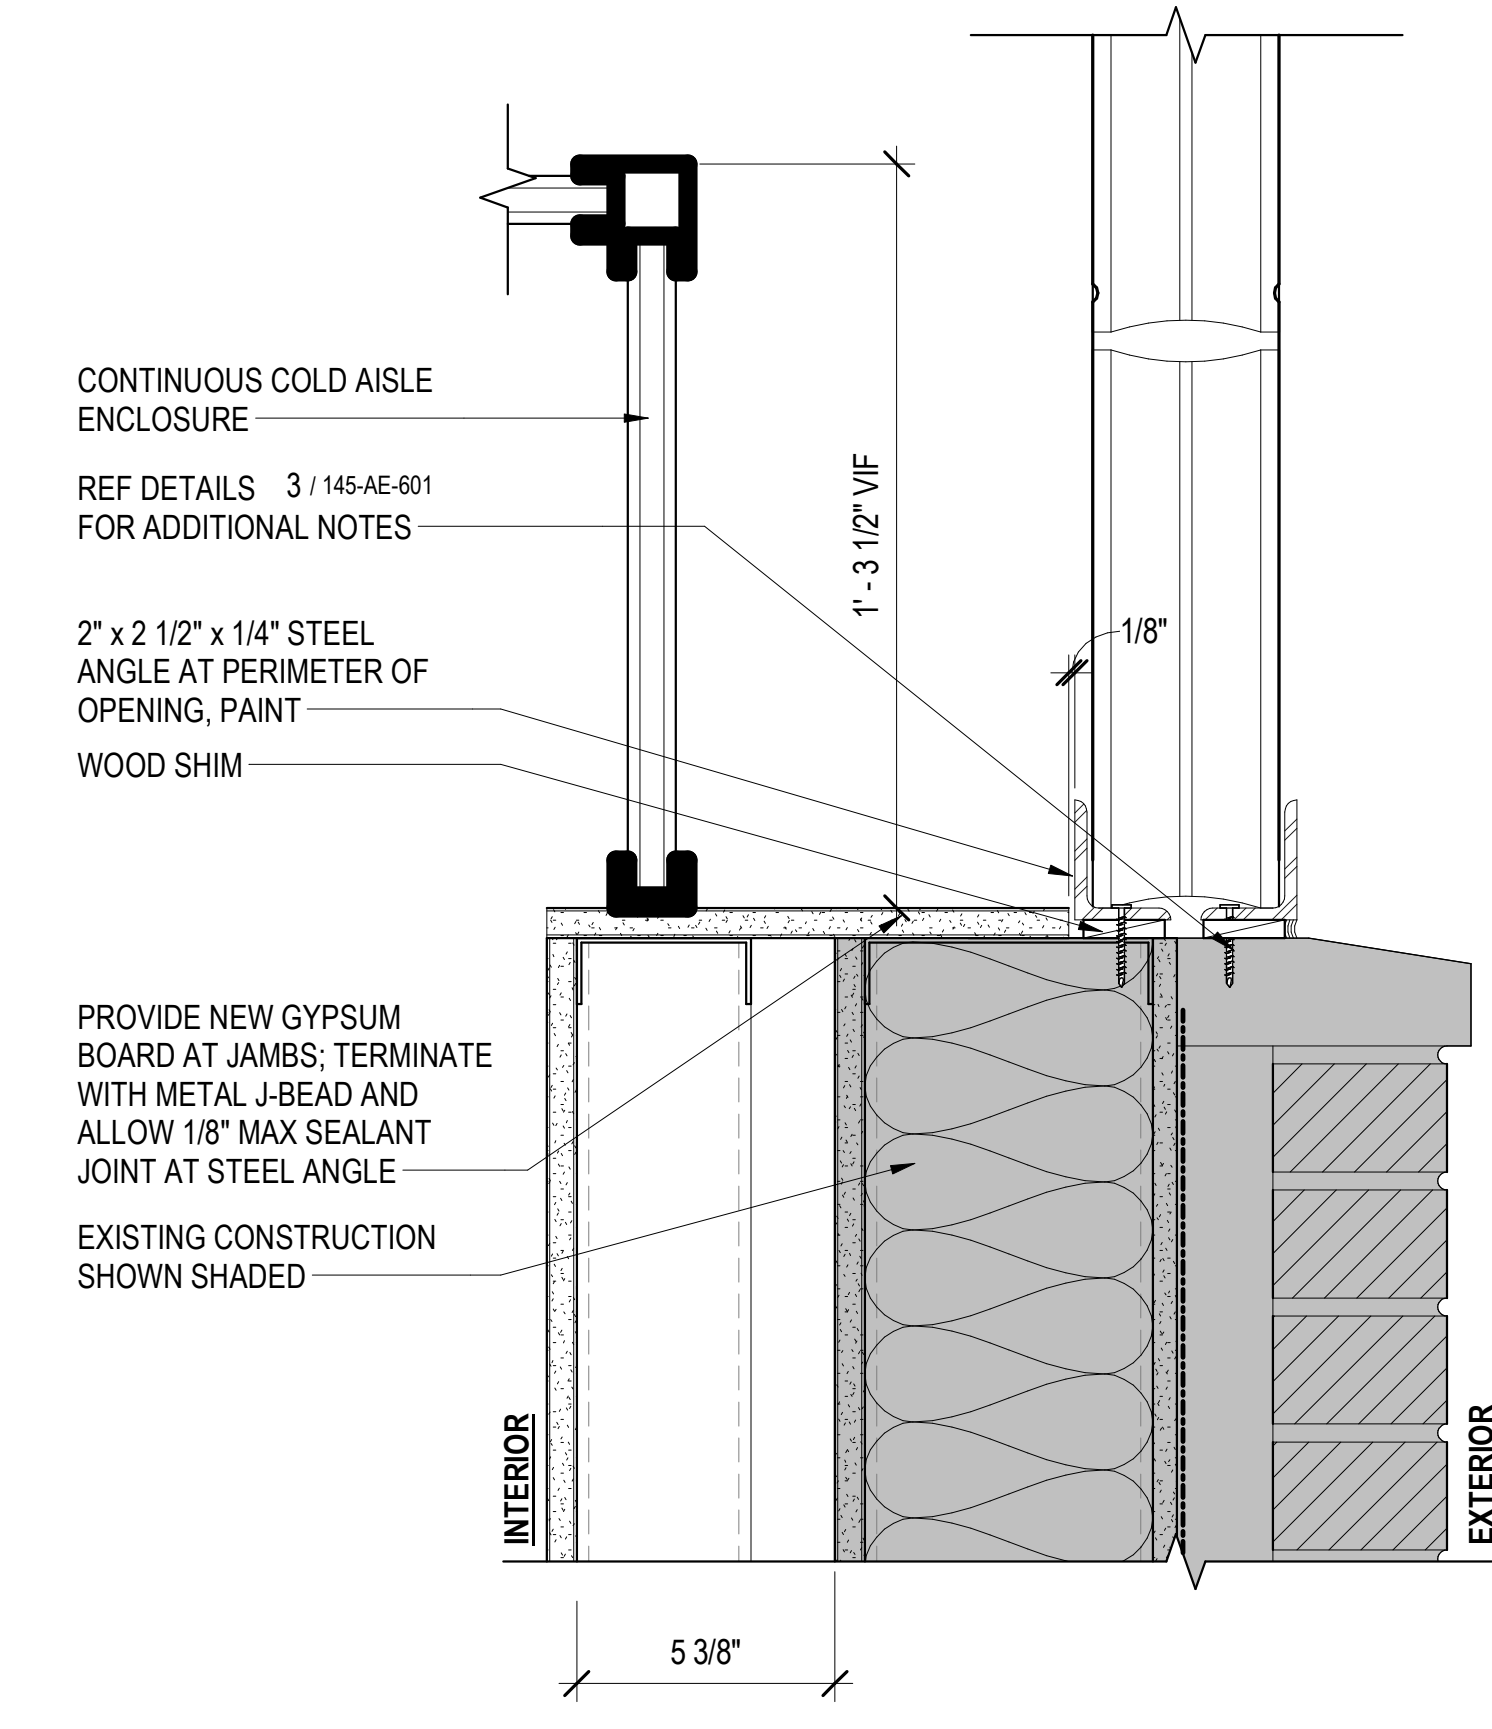
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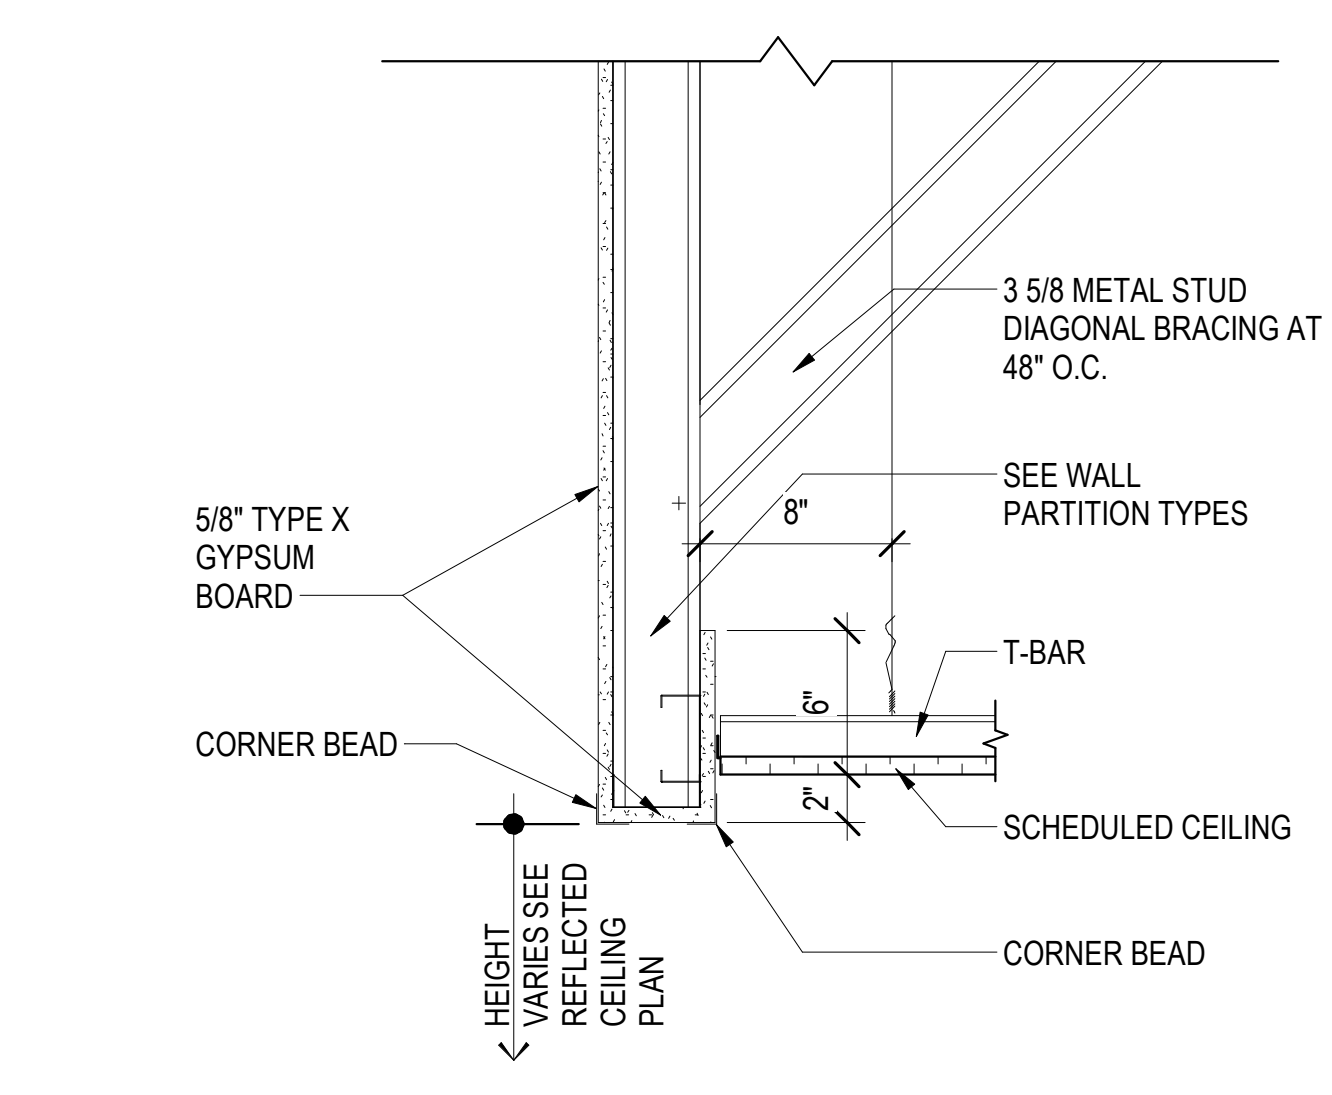
4 JAMB DETAIL AT NEW EXTERIOR DOOR INSTALLATION
3/8" = 1'-0"




3 GLASS BLOCK INFIL JAMB DETAIL
3/8" = 1'-0"

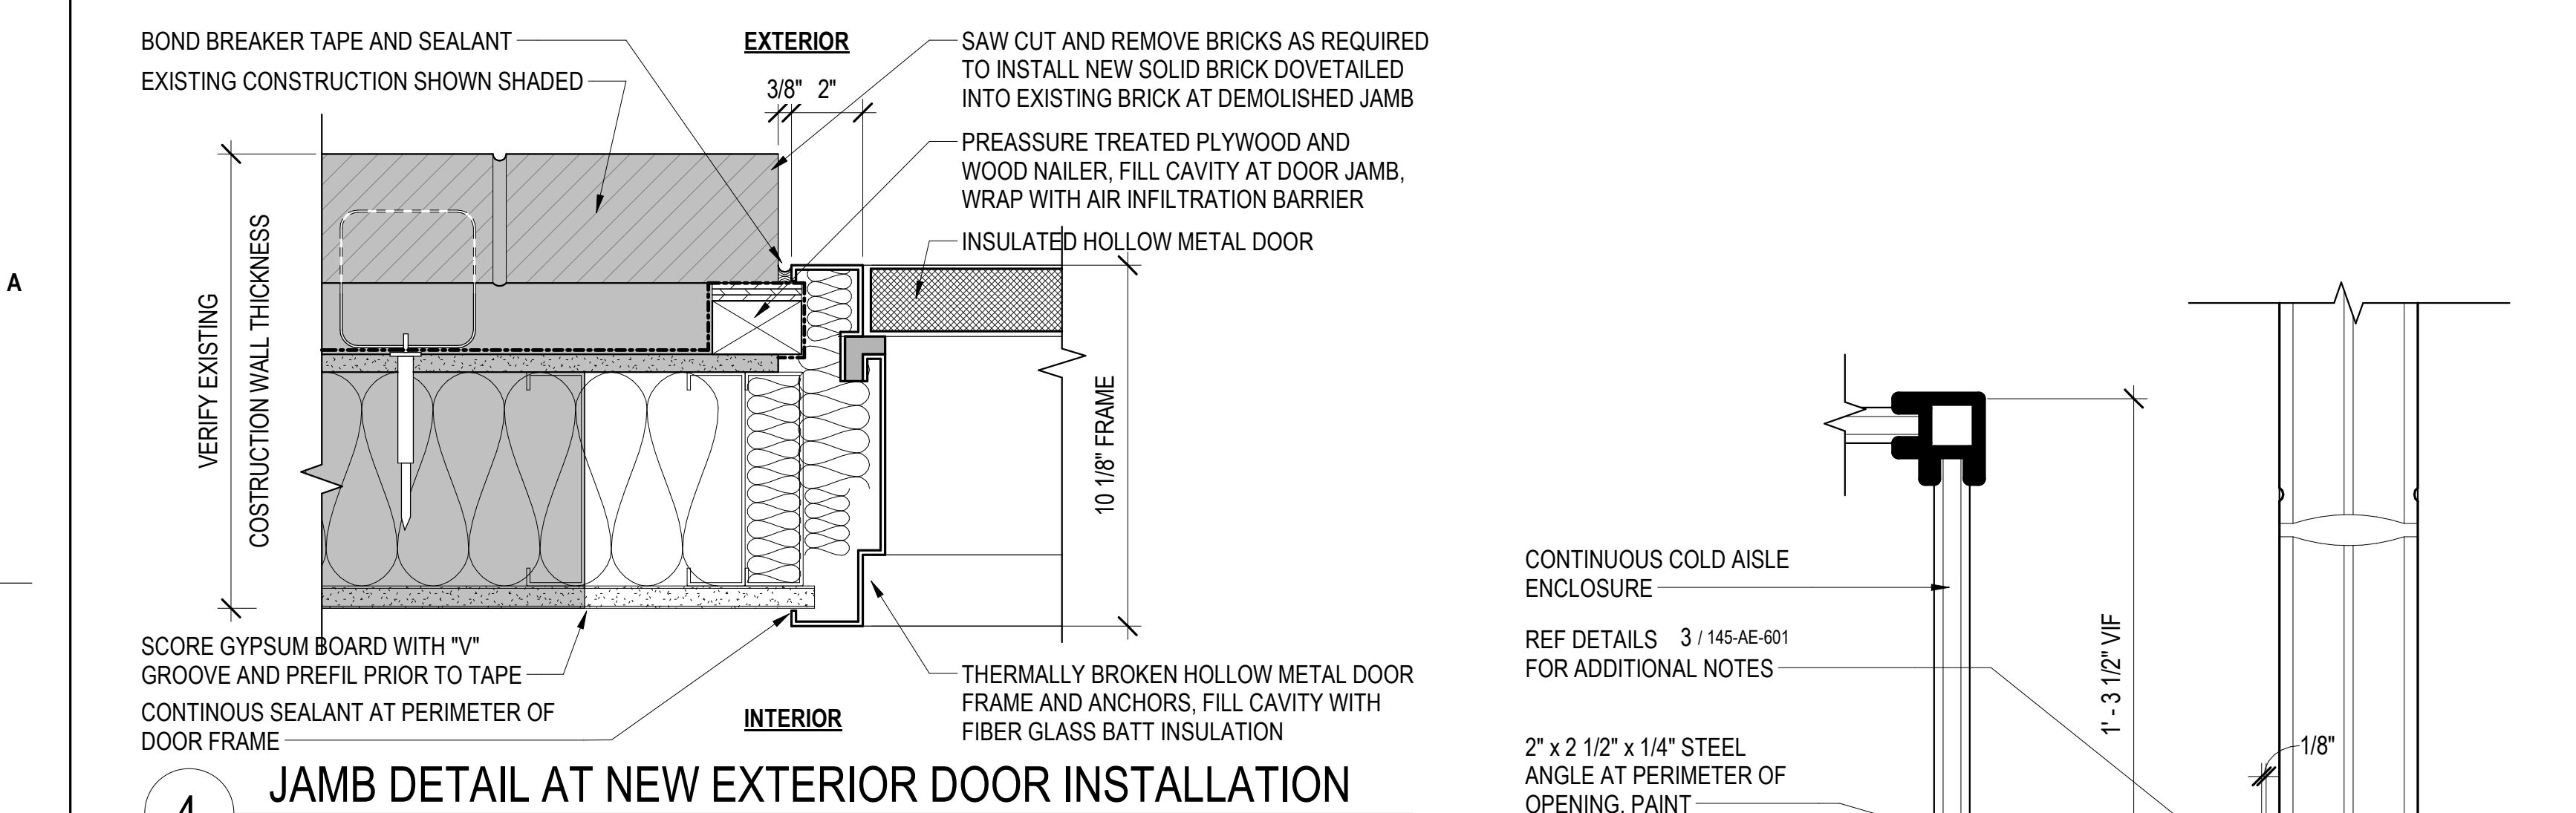


5 GLASS BLOCK INFIL SILL DETAIL
3/8" = 1'-0"




8 TYPICAL BULKHEAD DETAIL
1 1/2" = 1'-0"

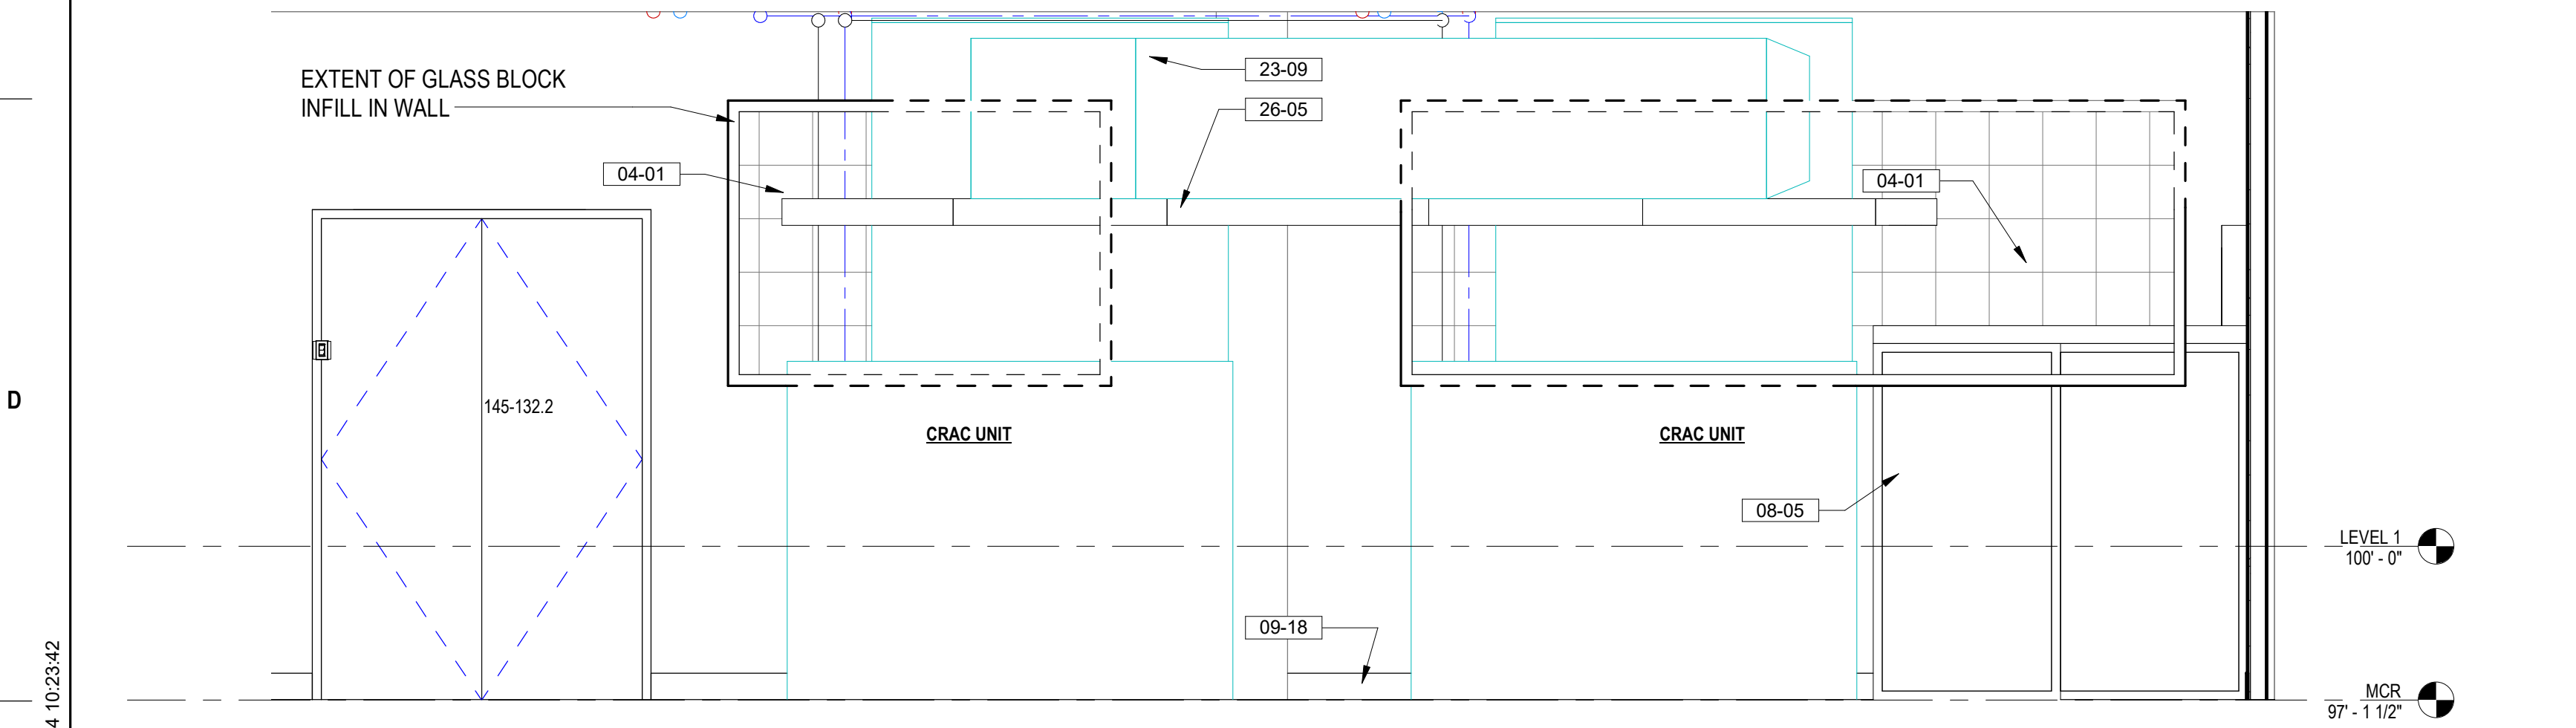


2 MCR 132 WEST ELEVATION
3/8" = 1'-0"

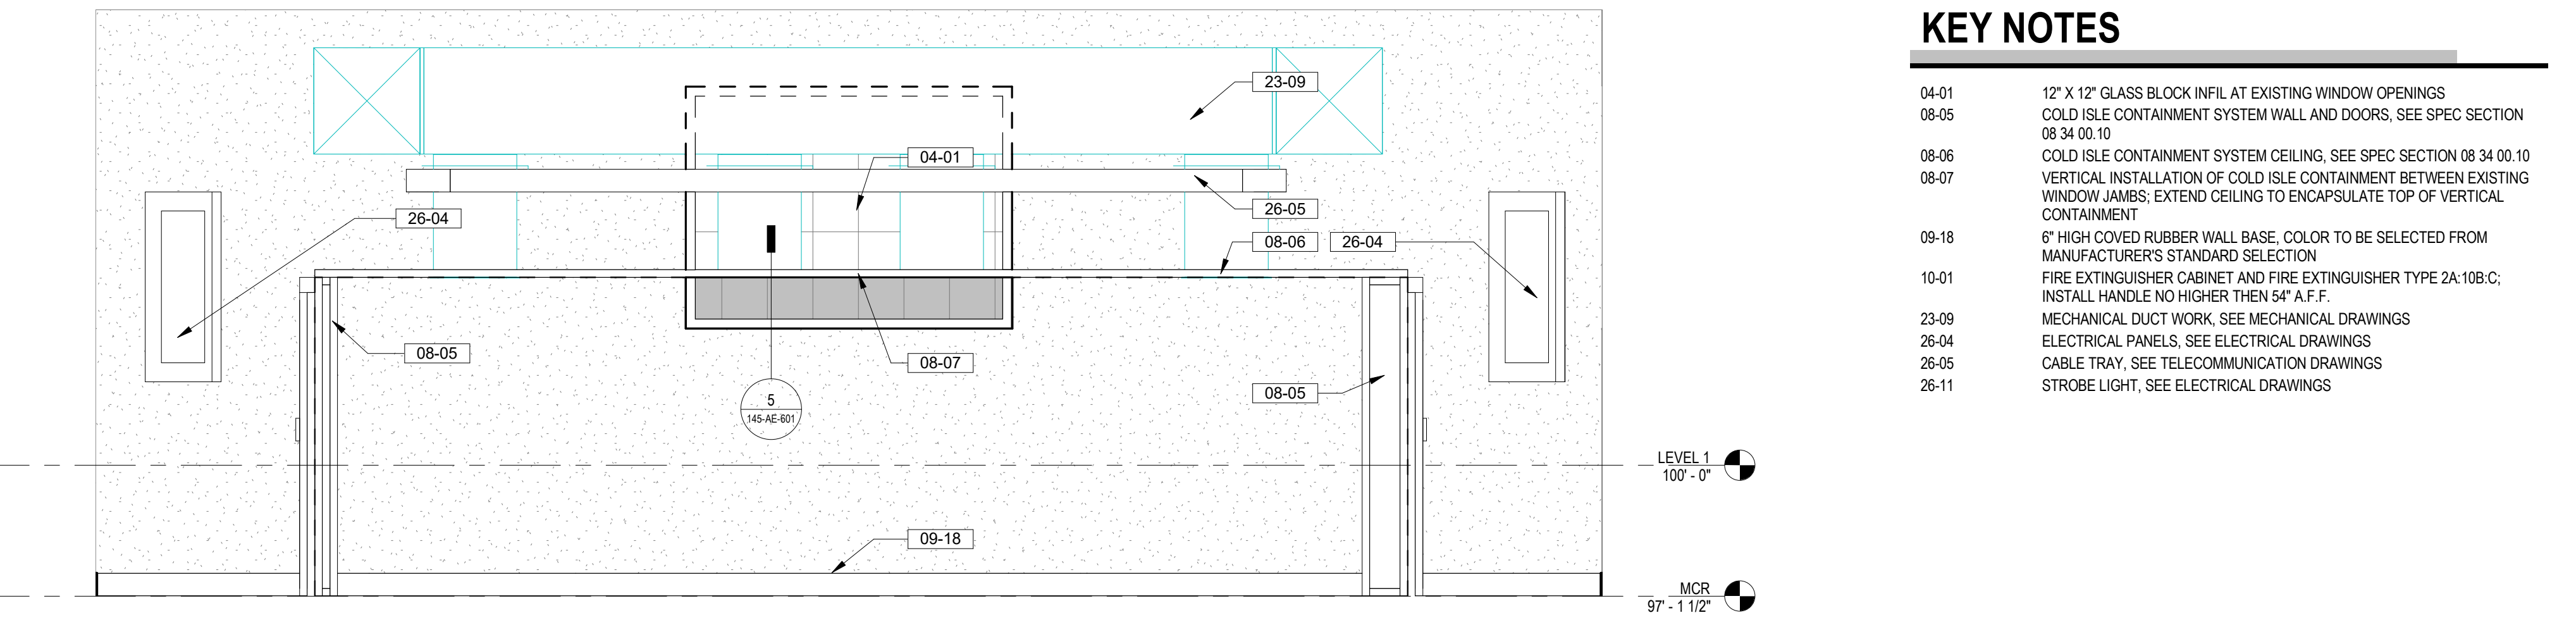

7 MCR 132 NORTH ELEVATION
3/8" = 1'-0"

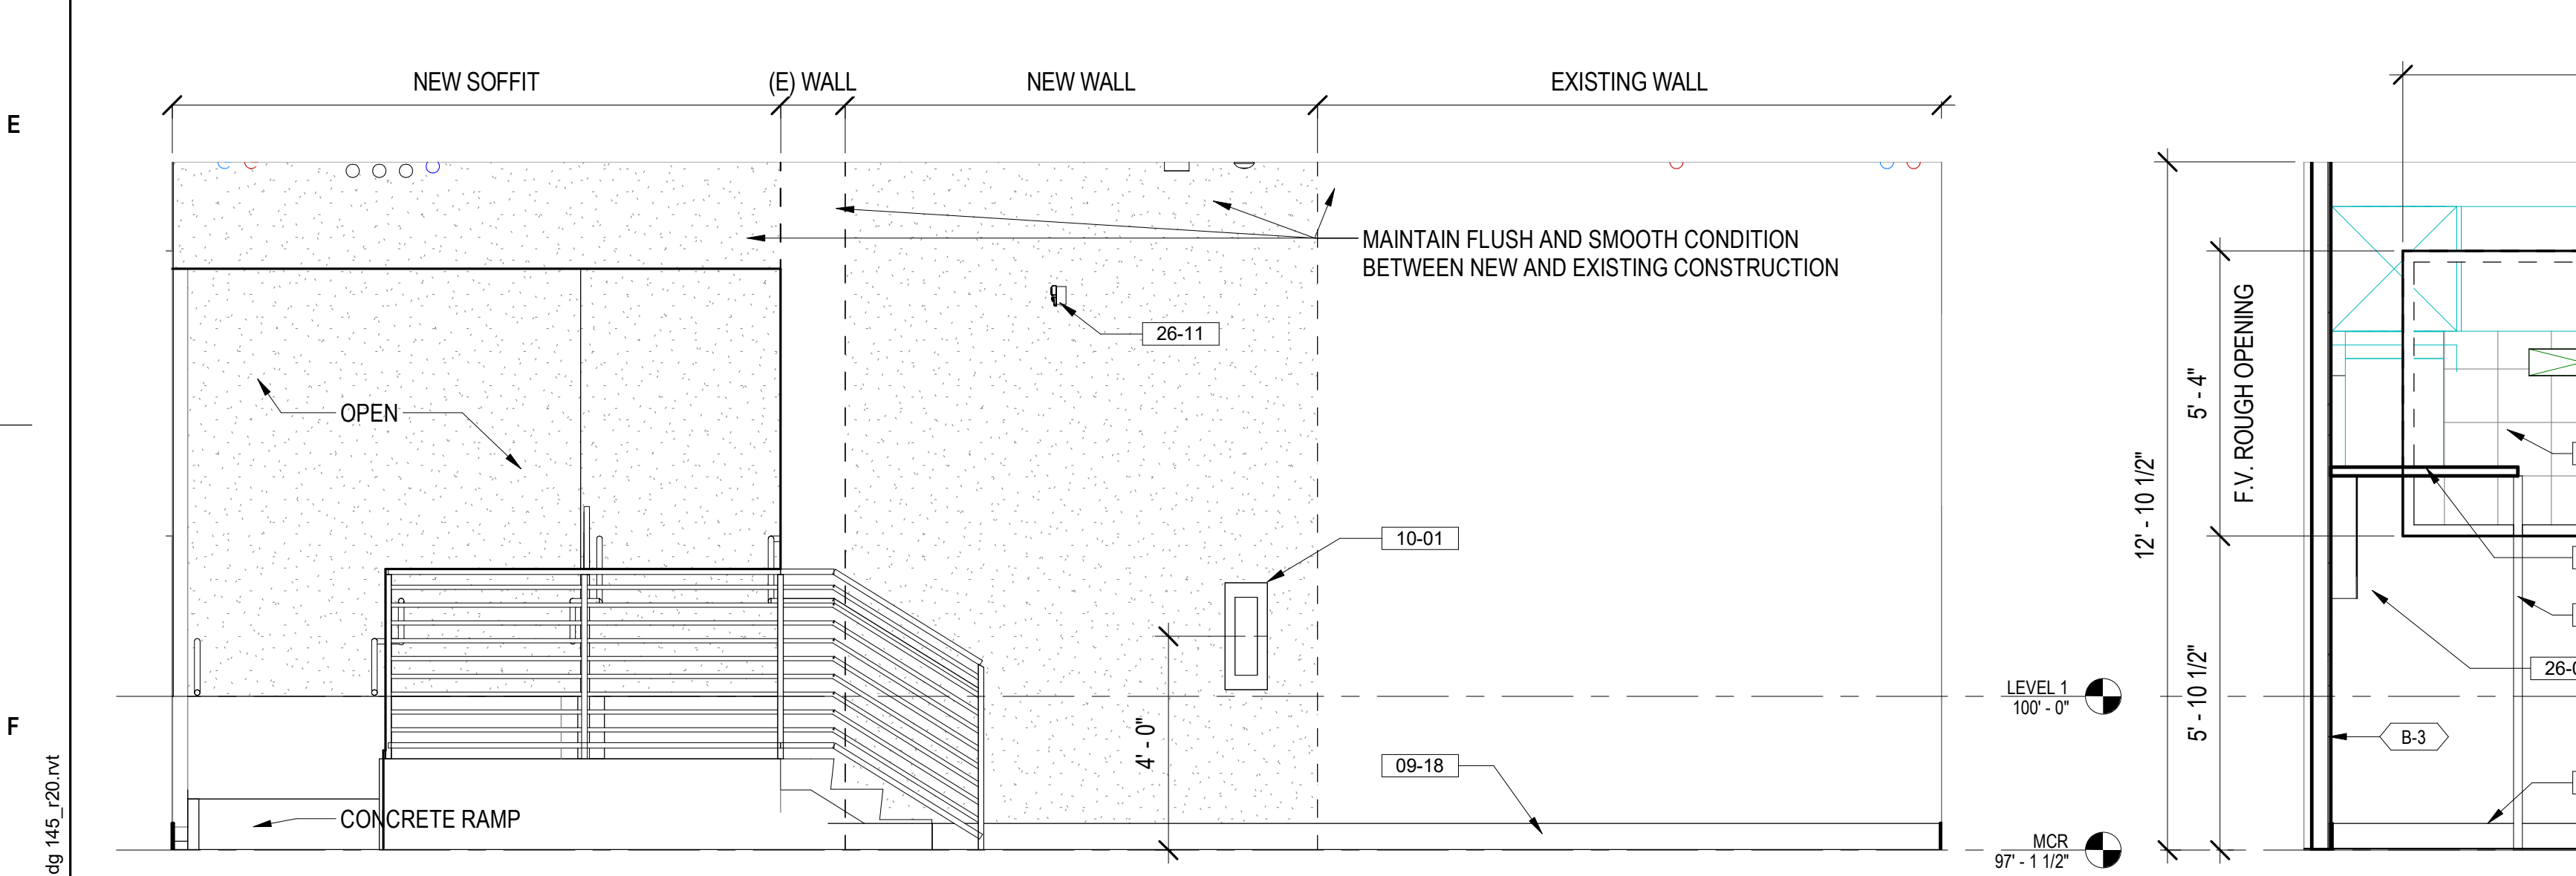

1 MCR 132 SOUTH ELEVATION
3/8" = 1'-0"

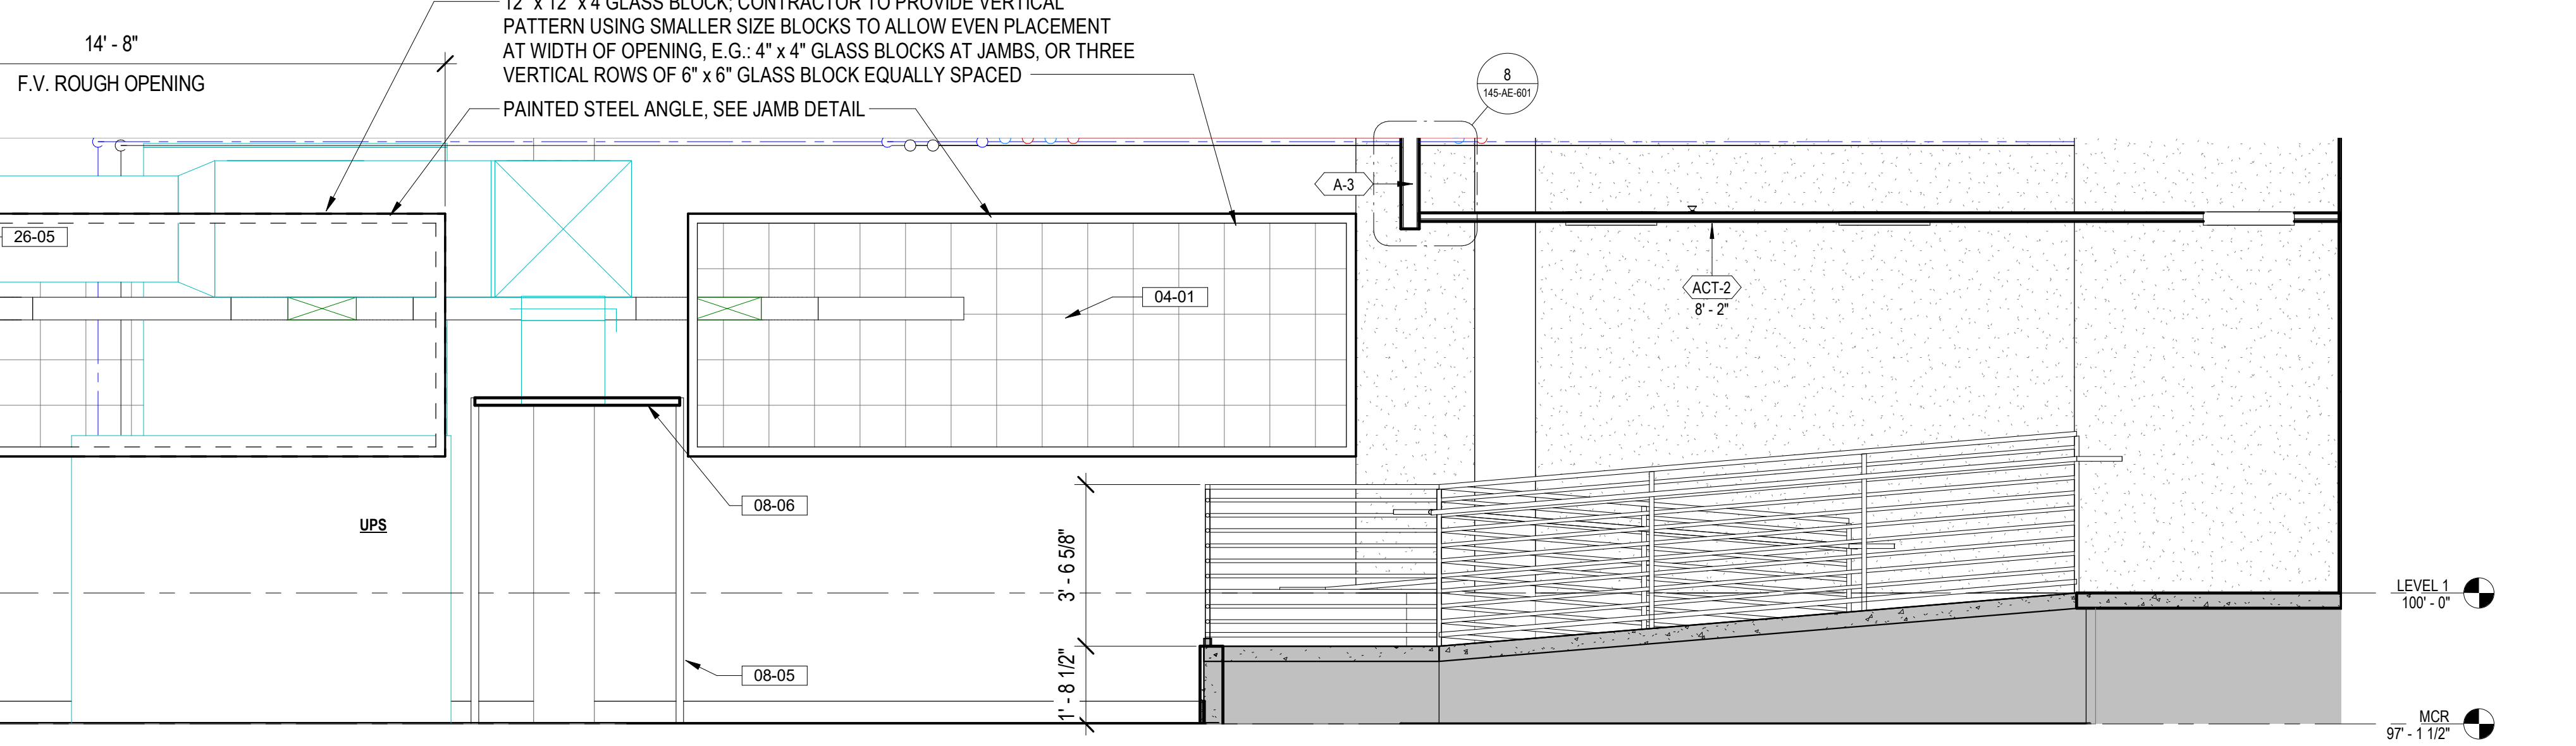

6 MCR 132 EAST ELEVATION
3/8" = 1'-0"

- KEY NOTES**
- 04-01 12" X 12" GLASS BLOCK INFIL AT EXISTING WINDOW OPENINGS
 - 08-05 COLD ISLE CONTAINMENT SYSTEM WALL AND DOORS, SEE SPEC SECTION 08 34 00 10
 - 08-06 COLD ISLE CONTAINMENT SYSTEM CEILING, SEE SPEC SECTION 08 34 00 10
 - 08-07 VERTICAL INSTALLATION OF COLD ISLE CONTAINMENT BETWEEN EXISTING WINDOW JAMBS; EXTEND CEILING TO ENCAPSULATE TOP OF VERTICAL CONTAINMENT
 - 09-18 6" HIGH COVERED RUBBER WALL BASE. COLOR TO BE SELECTED FROM MANUFACTURER'S STANDARD SELECTION
 - 10-01 FIRE EXTINGUISHER CABINET AND FIRE EXTINGUISHER TYPE 2A 10B-C; INSTALL HANDLE NO HIGHER THEN 54" A.F.F.
 - 23-09 MECHANICAL DUCT WORK, SEE MECHANICAL DRAWINGS
 - 26-04 ELECTRICAL PANELS, SEE ELECTRICAL DRAWINGS
 - 26-05 CABLE TRAY, SEE TELECOMMUNICATION DRAWINGS
 - 26-11 STROBE LIGHT, SEE ELECTRICAL DRAWINGS

Revisions:	Date:

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PROGRAM CONTRACTING ACTIVITY CENTRAL (PCAC)

DRAWING TITLE
145-MCR ELEVATIONS

APPROVED: Project Director

PHASE
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FLS
FULLY SPRINKLERED

PROJECT TITLE
EHRM INFRASTRUCTURE UPGRADES

PROJECT NUMBER
568-21-701

BUILDING NUMBER
BLDG 145


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LOCATION
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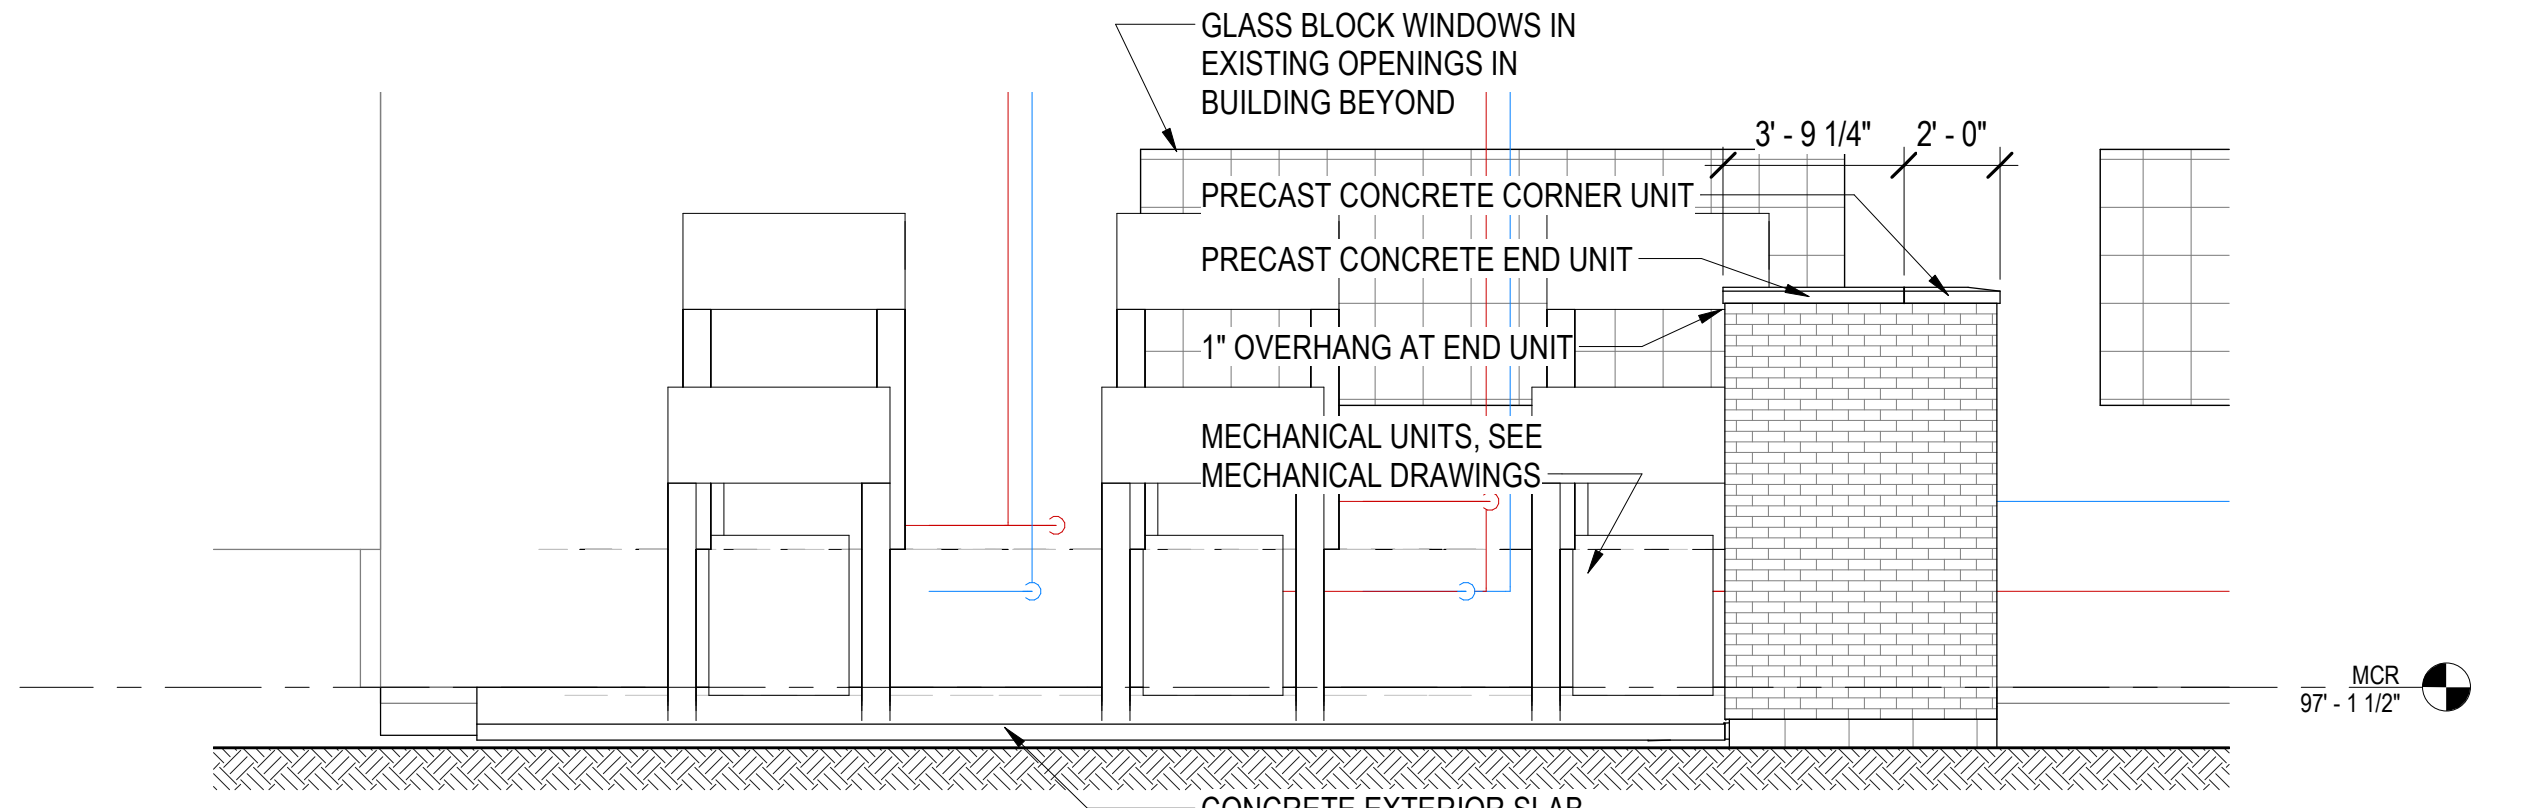
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04/15/2022

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TMP


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JPR




17 NORTH SCREEN WALL ELEVATION
1/4" = 1'-0"

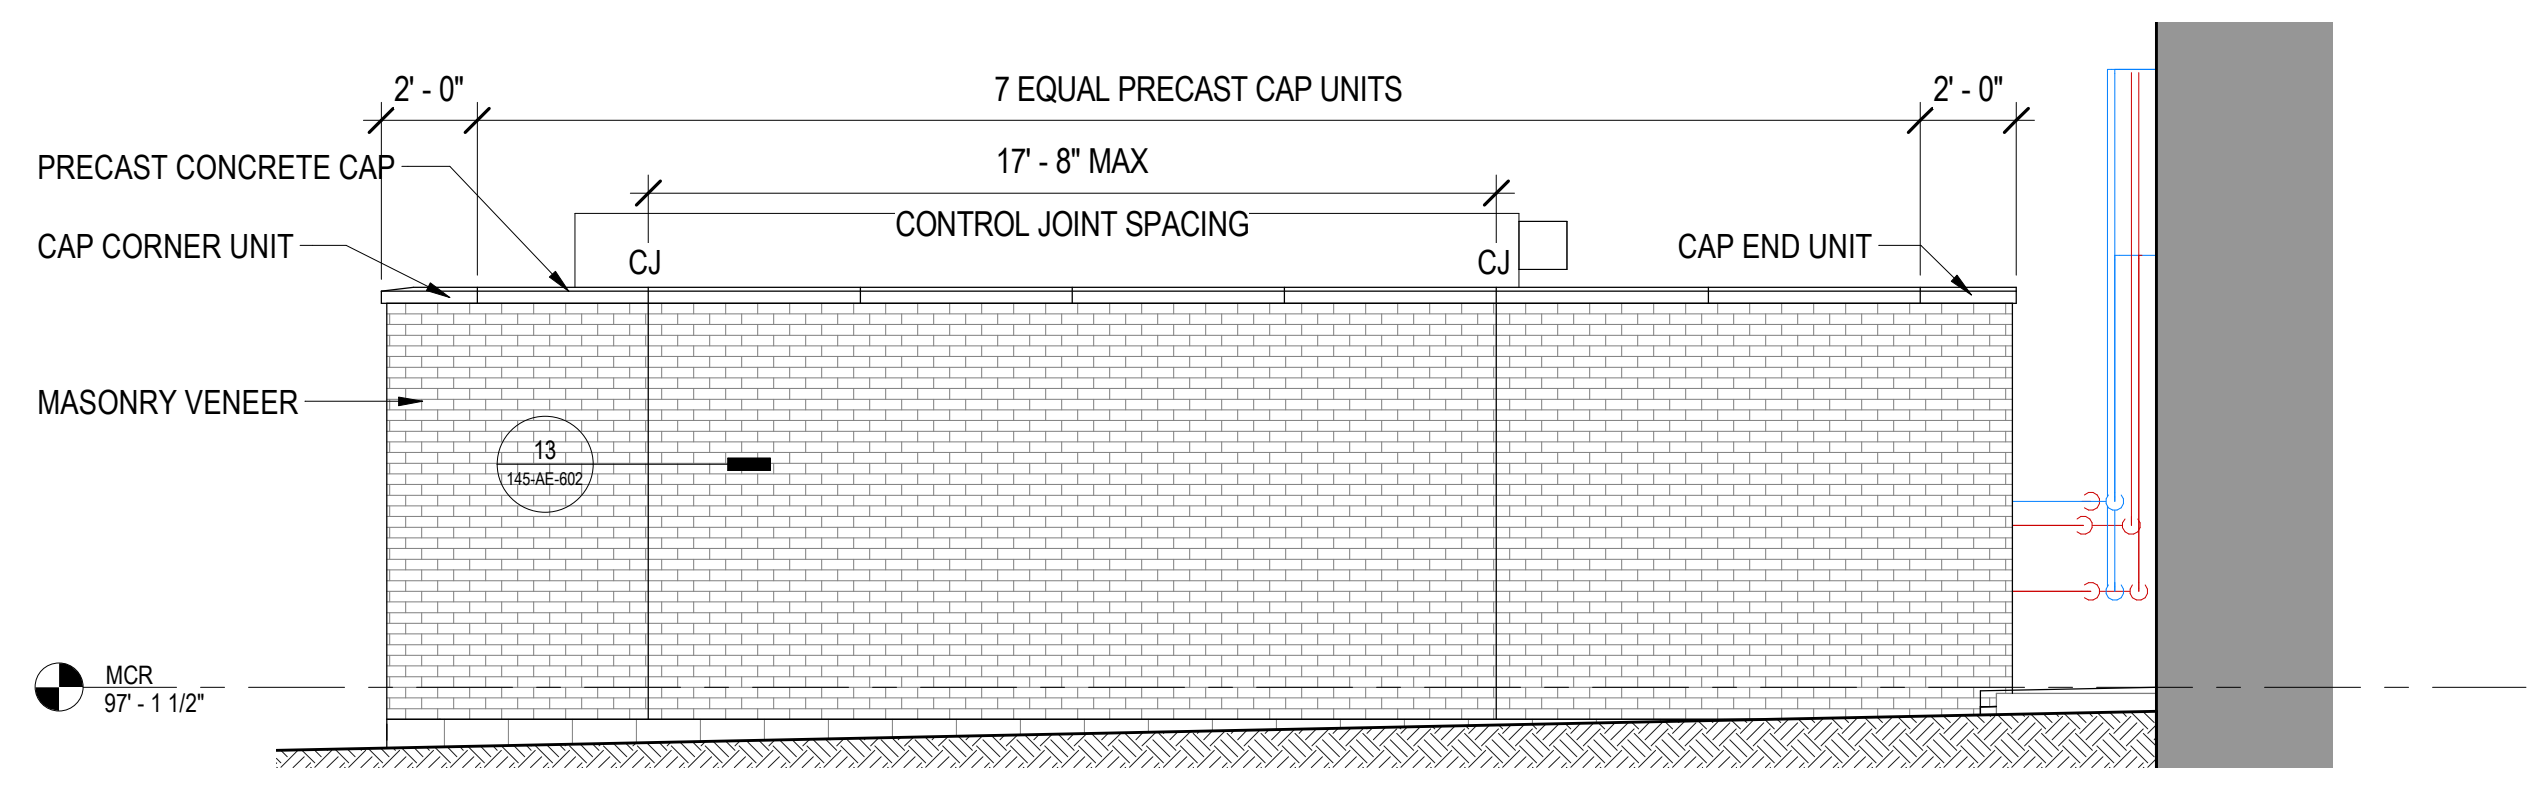


19 EAST SCREEN WALL ELEVATION
1/4" = 1'-0"

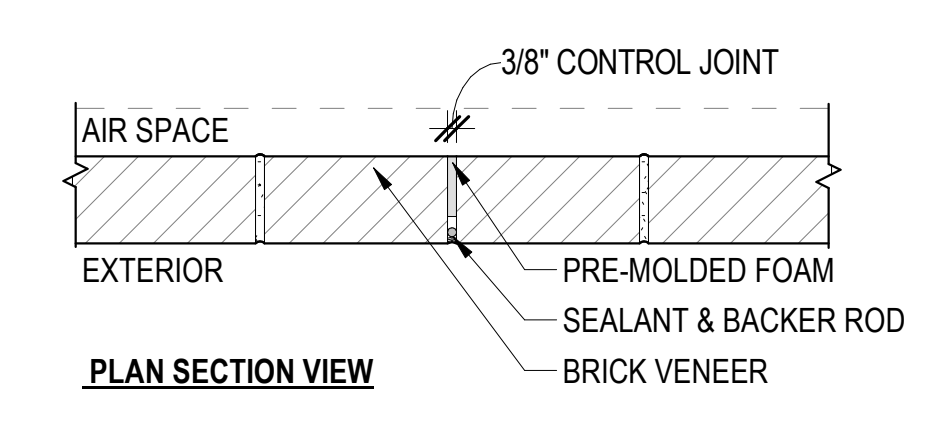


13 VERTICAL BRICK CONTROL JOINT
1 1/2" = 1'-0"

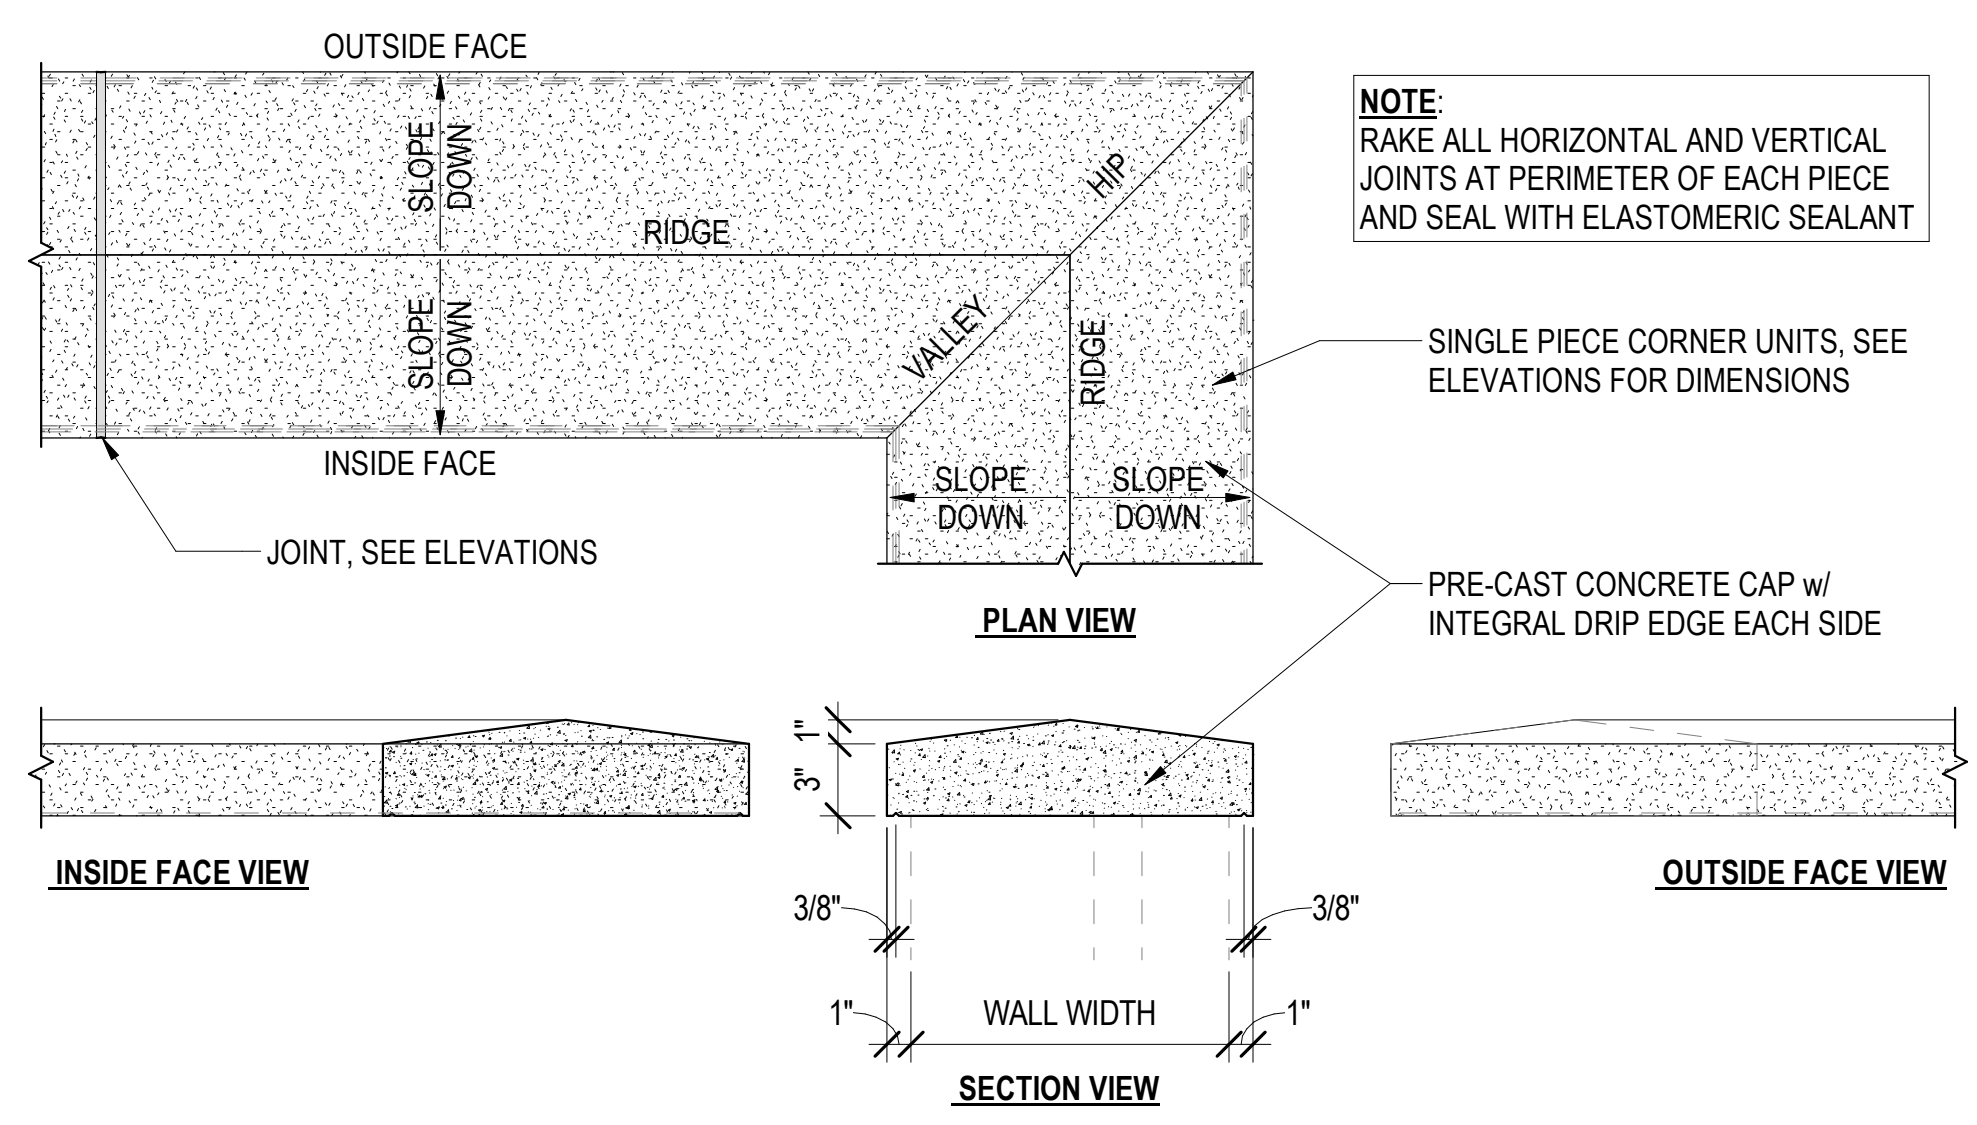


7 PRE-CAST CAP FOR SCREEN WALL
1 1/2" = 1'-0"

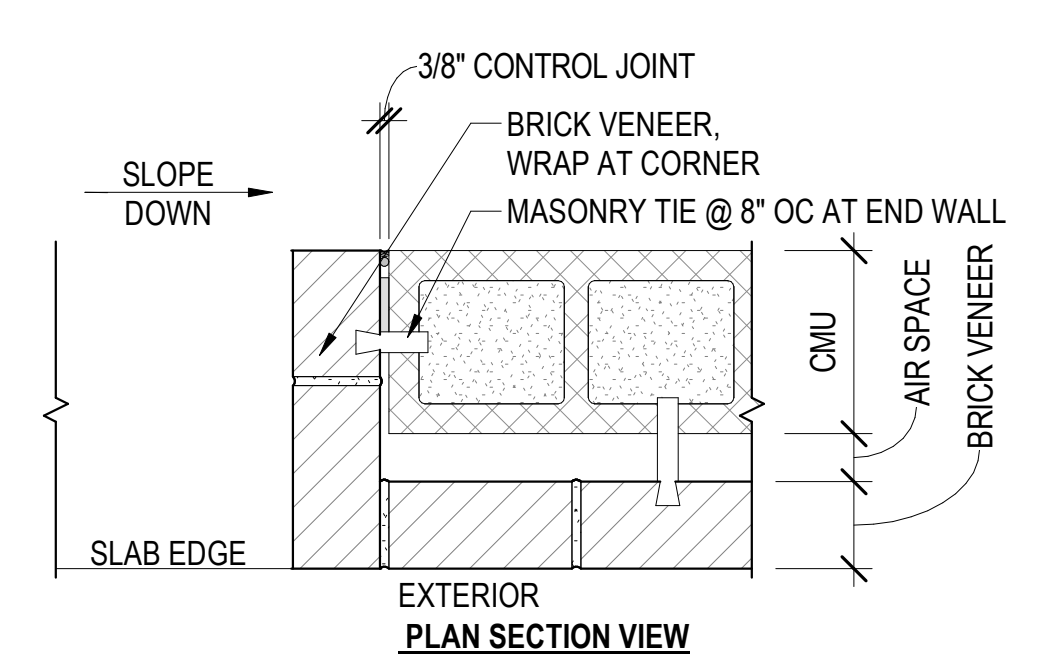


8 SCREEN WALL BRICK TERMINATION
1 1/2" = 1'-0"

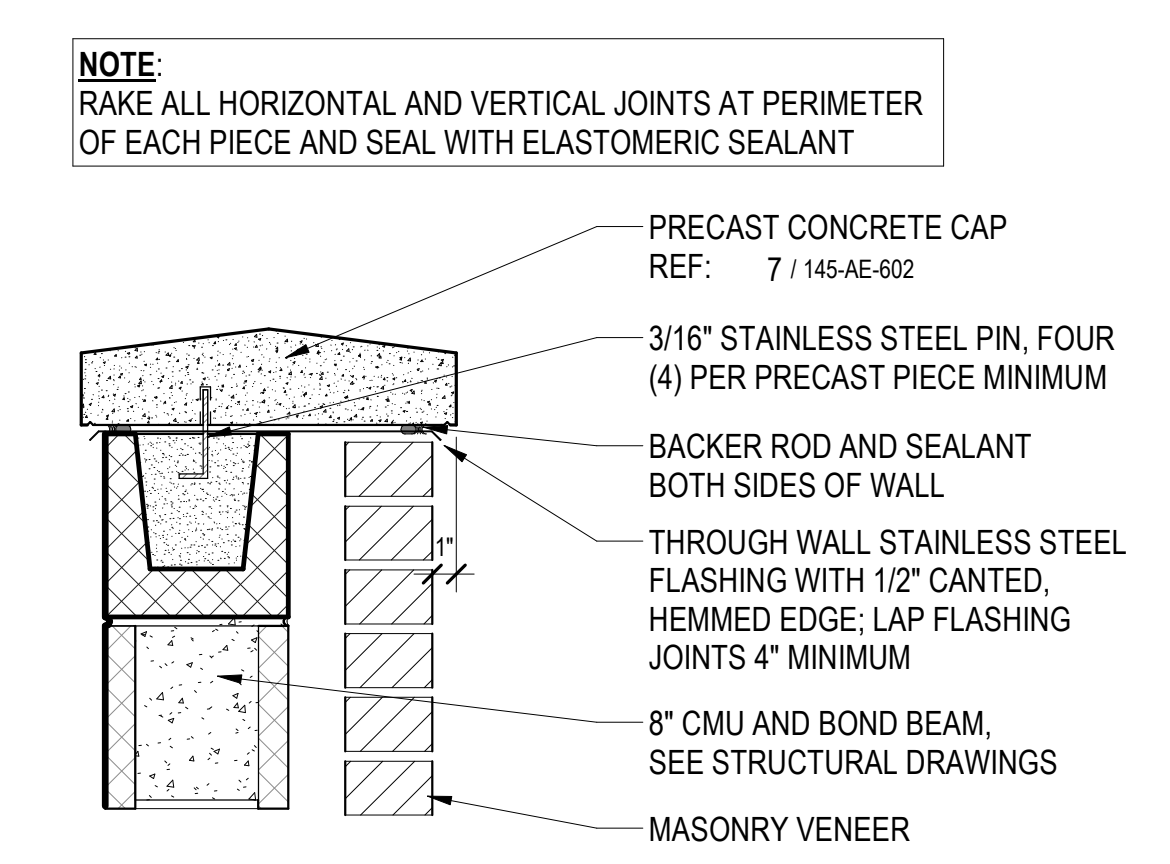


9 PRECAST CONCRETE CAP DETAIL
1 1/2" = 1'-0"

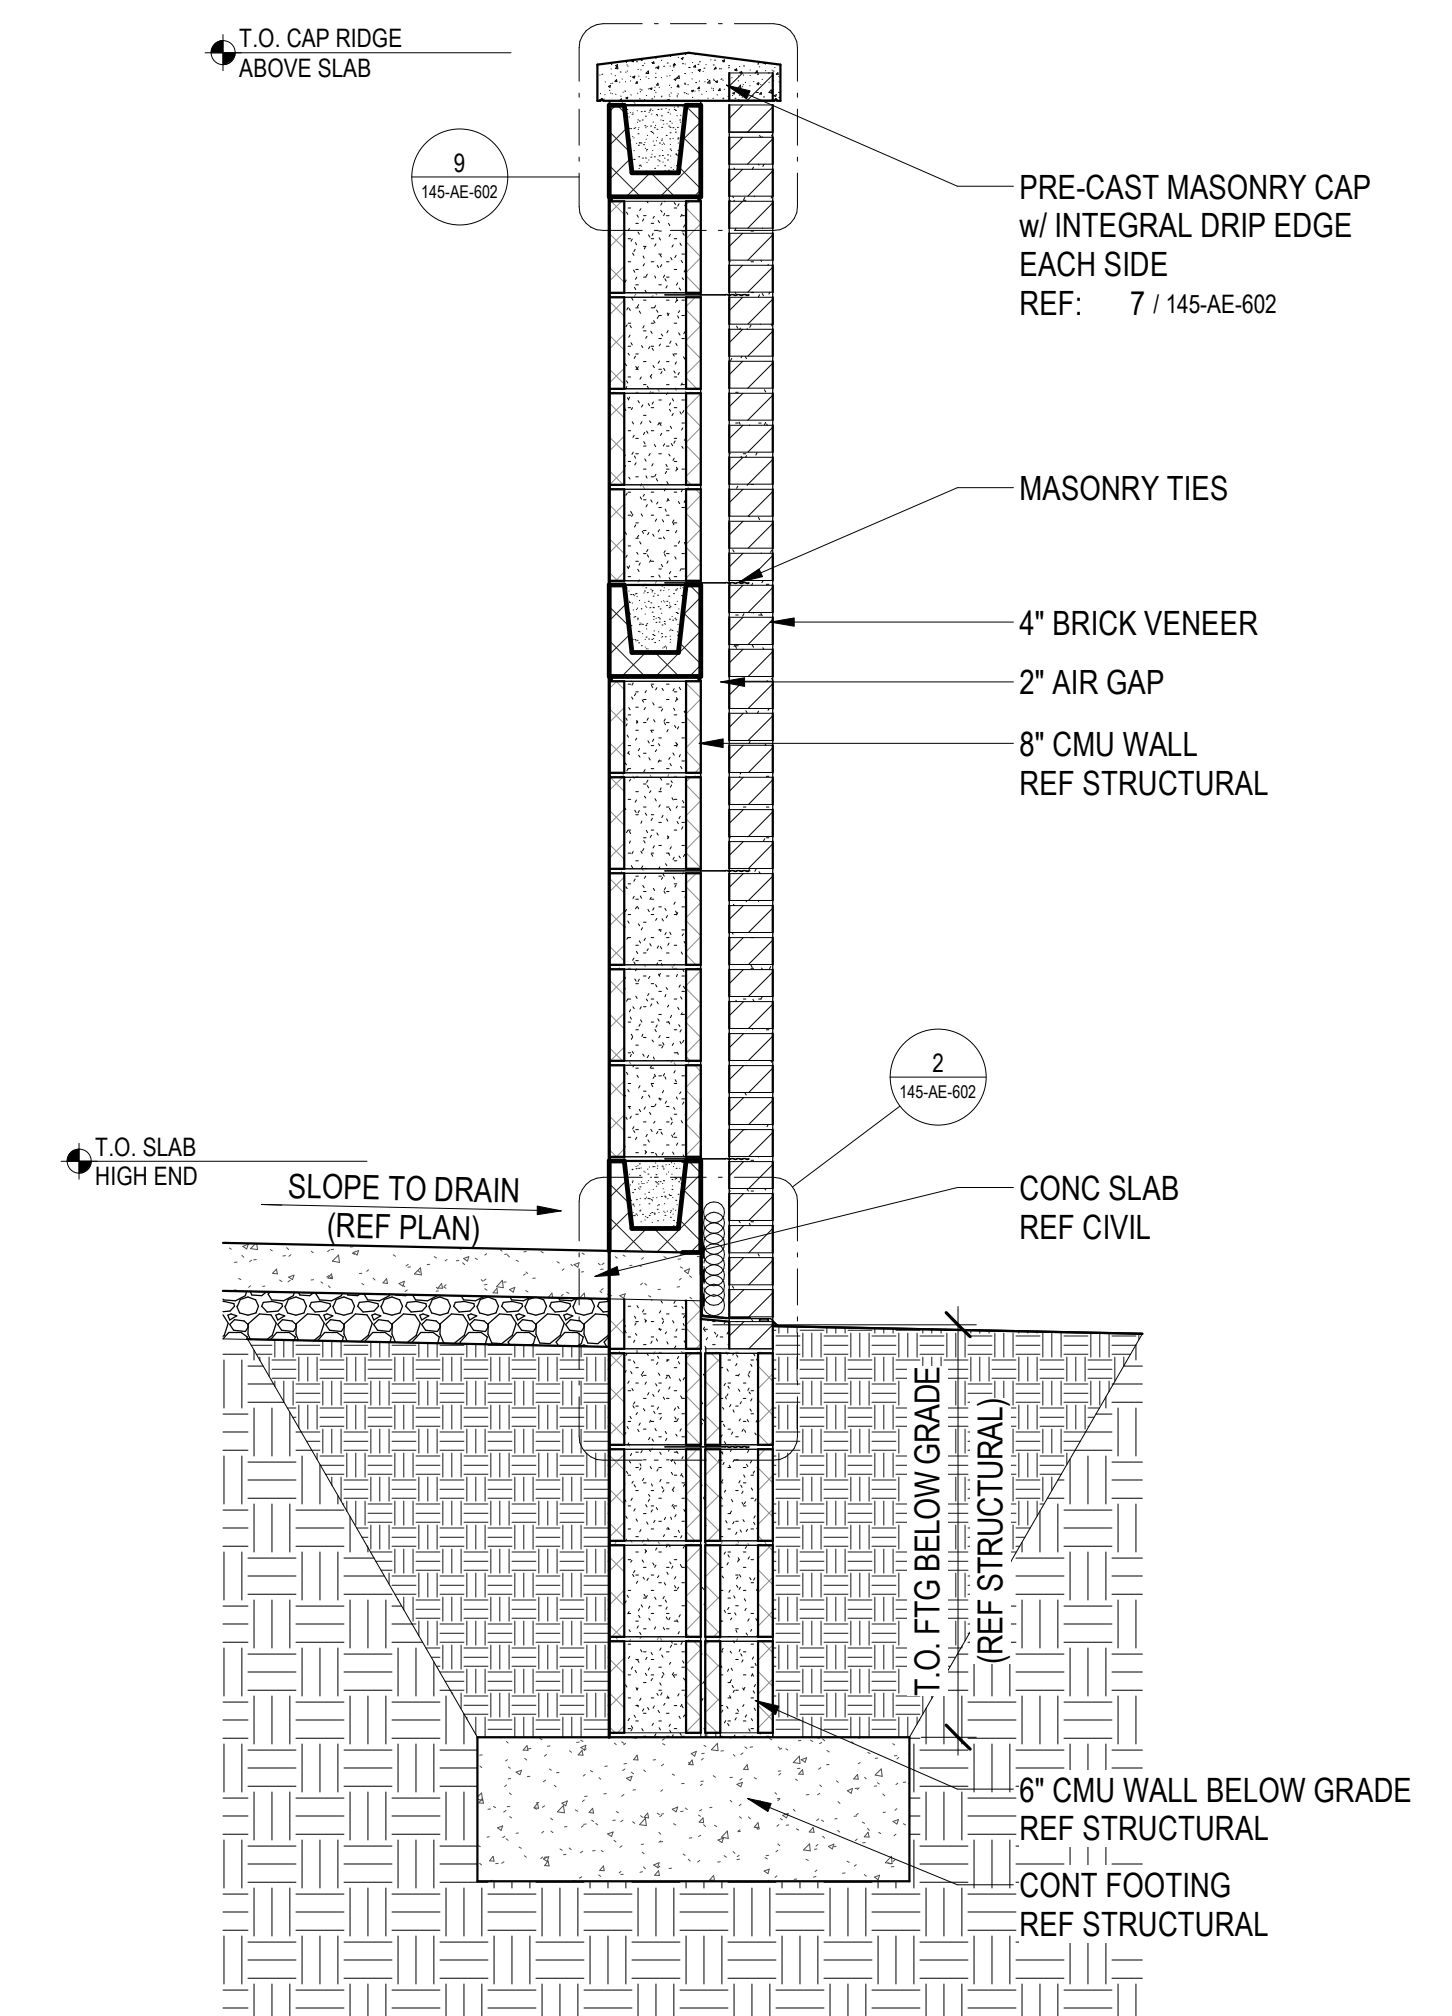

10 CMU SCREEN WALL WITH BRICK VENEER
3/4" = 1'-0"

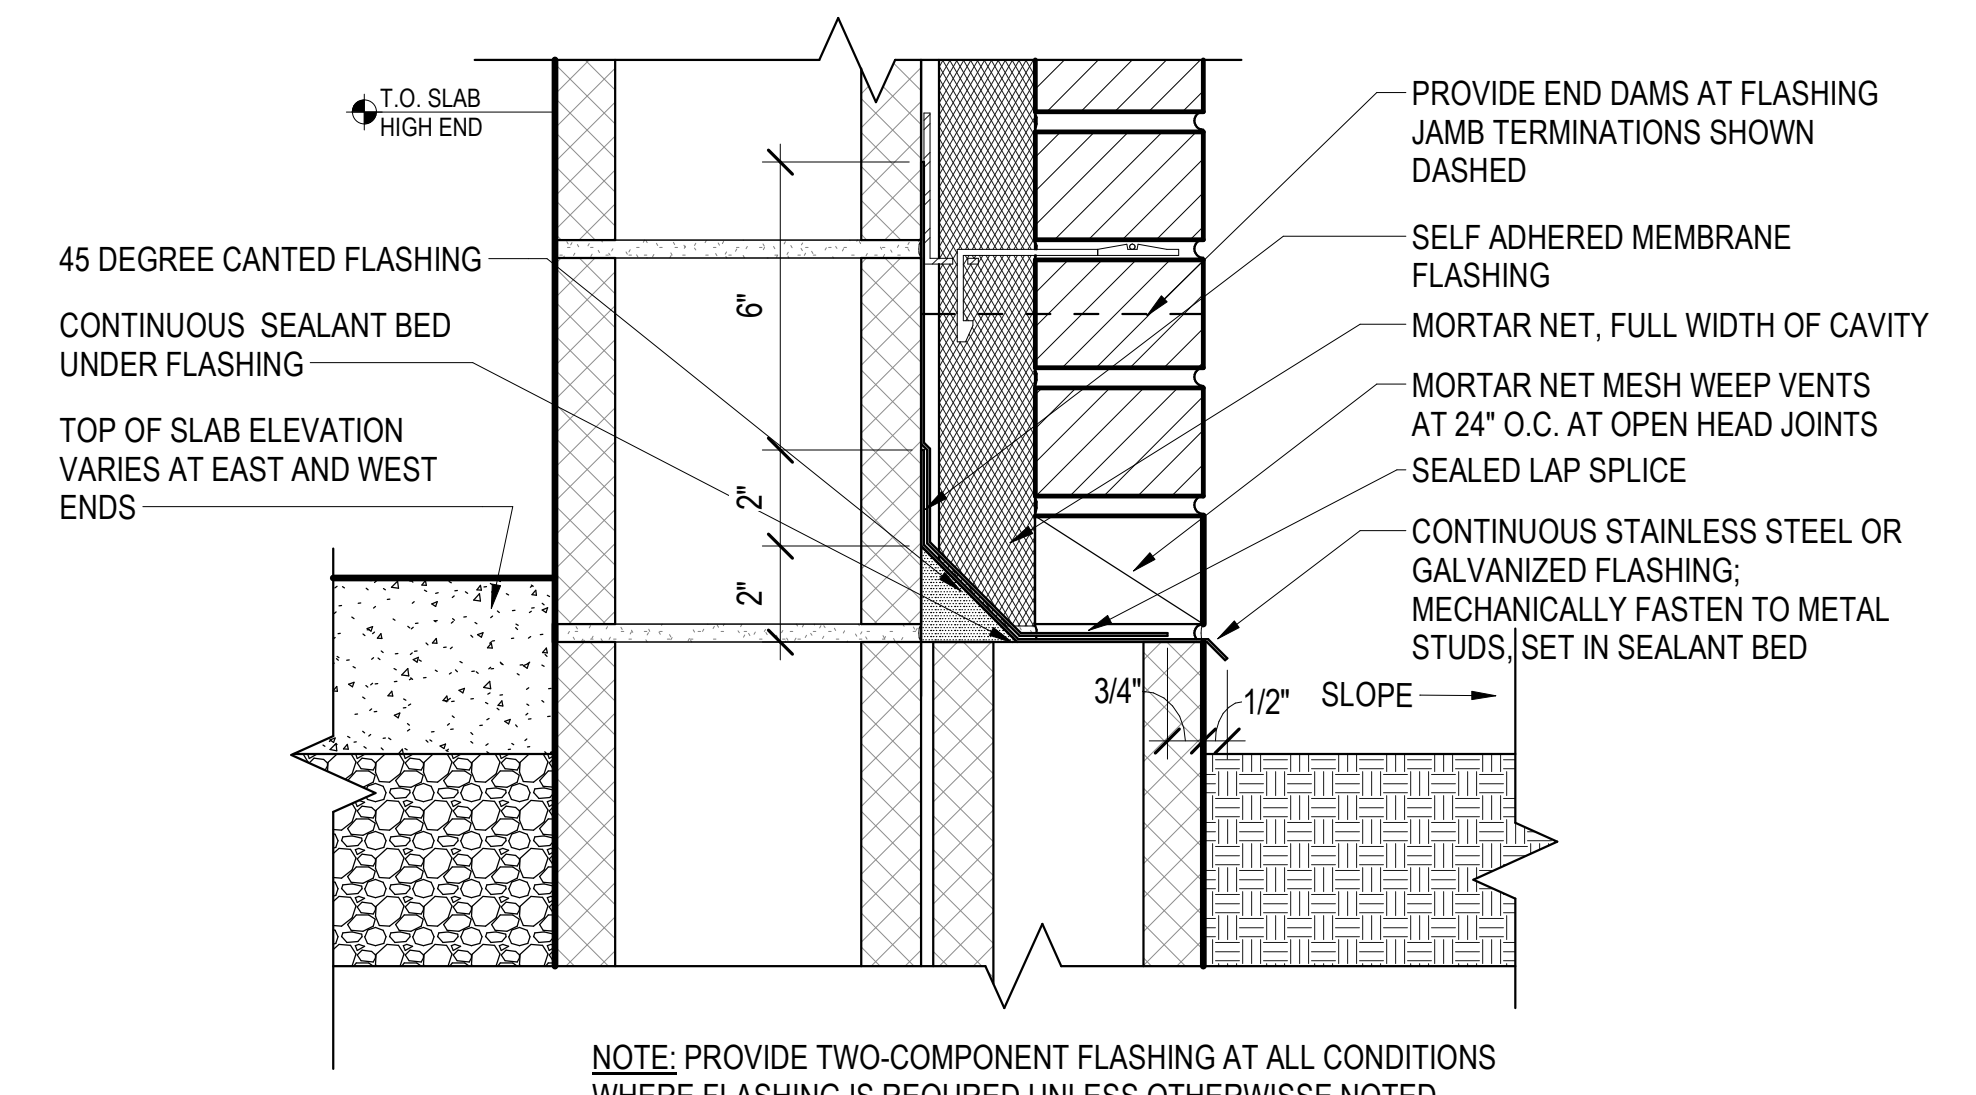

2 MASONRY BASE DETAIL
3" = 1'-0"

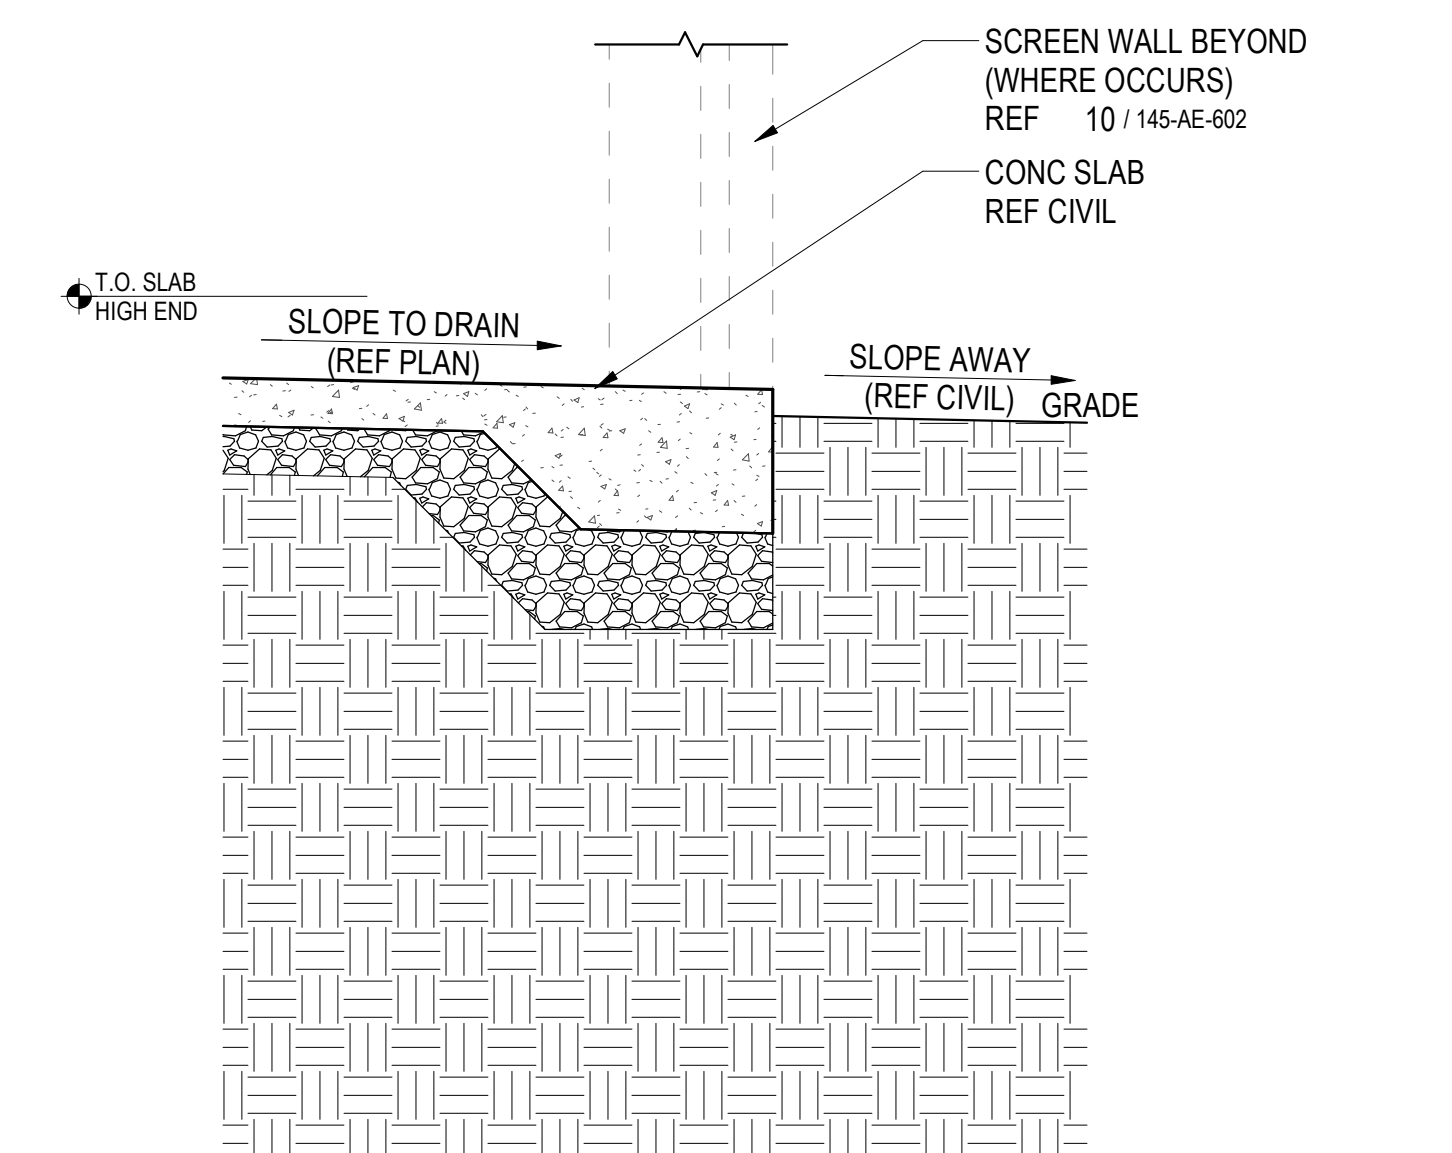

5 CMU FOUNDATION WALL
3/4" = 1'-0"

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Revisions:	Date:

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PROGRAM CONTRACTING ACTIVITY CENTRAL (PCAC)
VA U.S. Department of Veterans Affairs

DRAWING TITLE
SECTIONS AND DETAILS

APPROVED: Project Director

PHASE
100% CONSTRUCTION DOCUMENTS

FLS
FULLY SPRINKLERED

PROJECT TITLE
EHRM INFRASTRUCTURE UPGRADES








LOCATION
FORT MEADE, SOUTH DAKOTA

ISSUE DATE: 04/15/2022
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DRAWN BY: JPR

PROJECT NUMBER
568-21-701

BUILDING NUMBER
BLDG 145

DRAWING NUMBER
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Revisions:	Date:

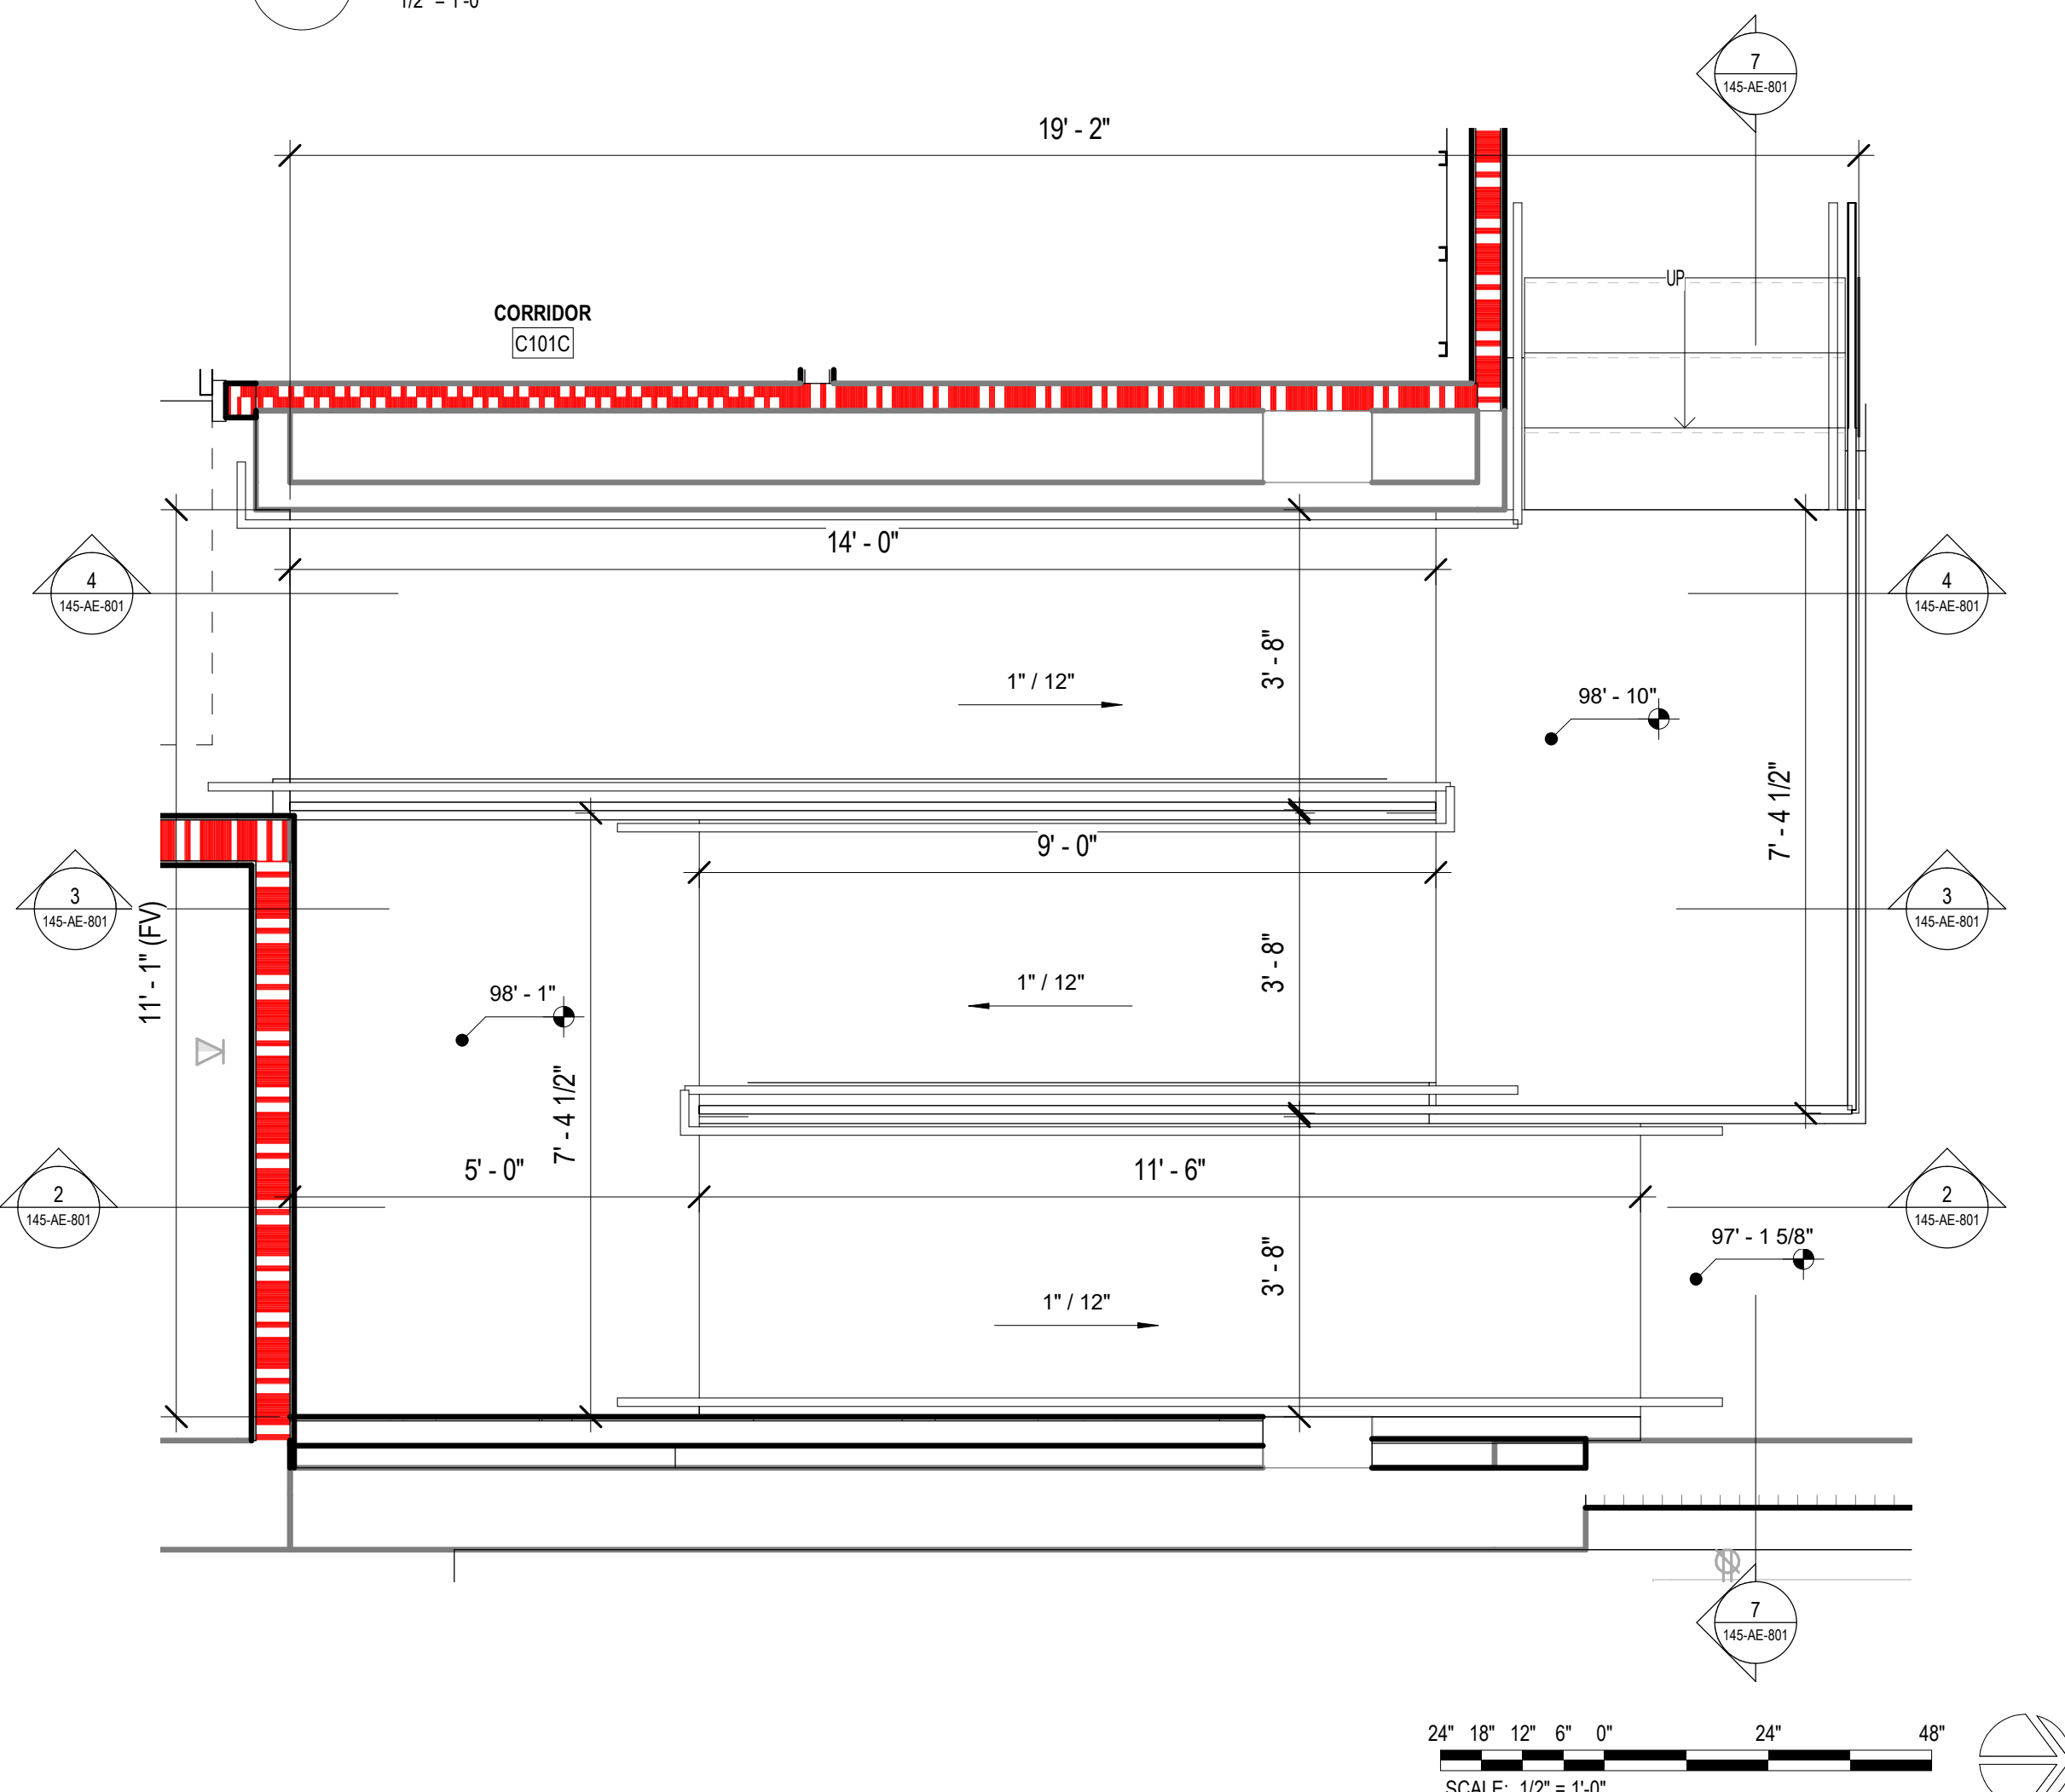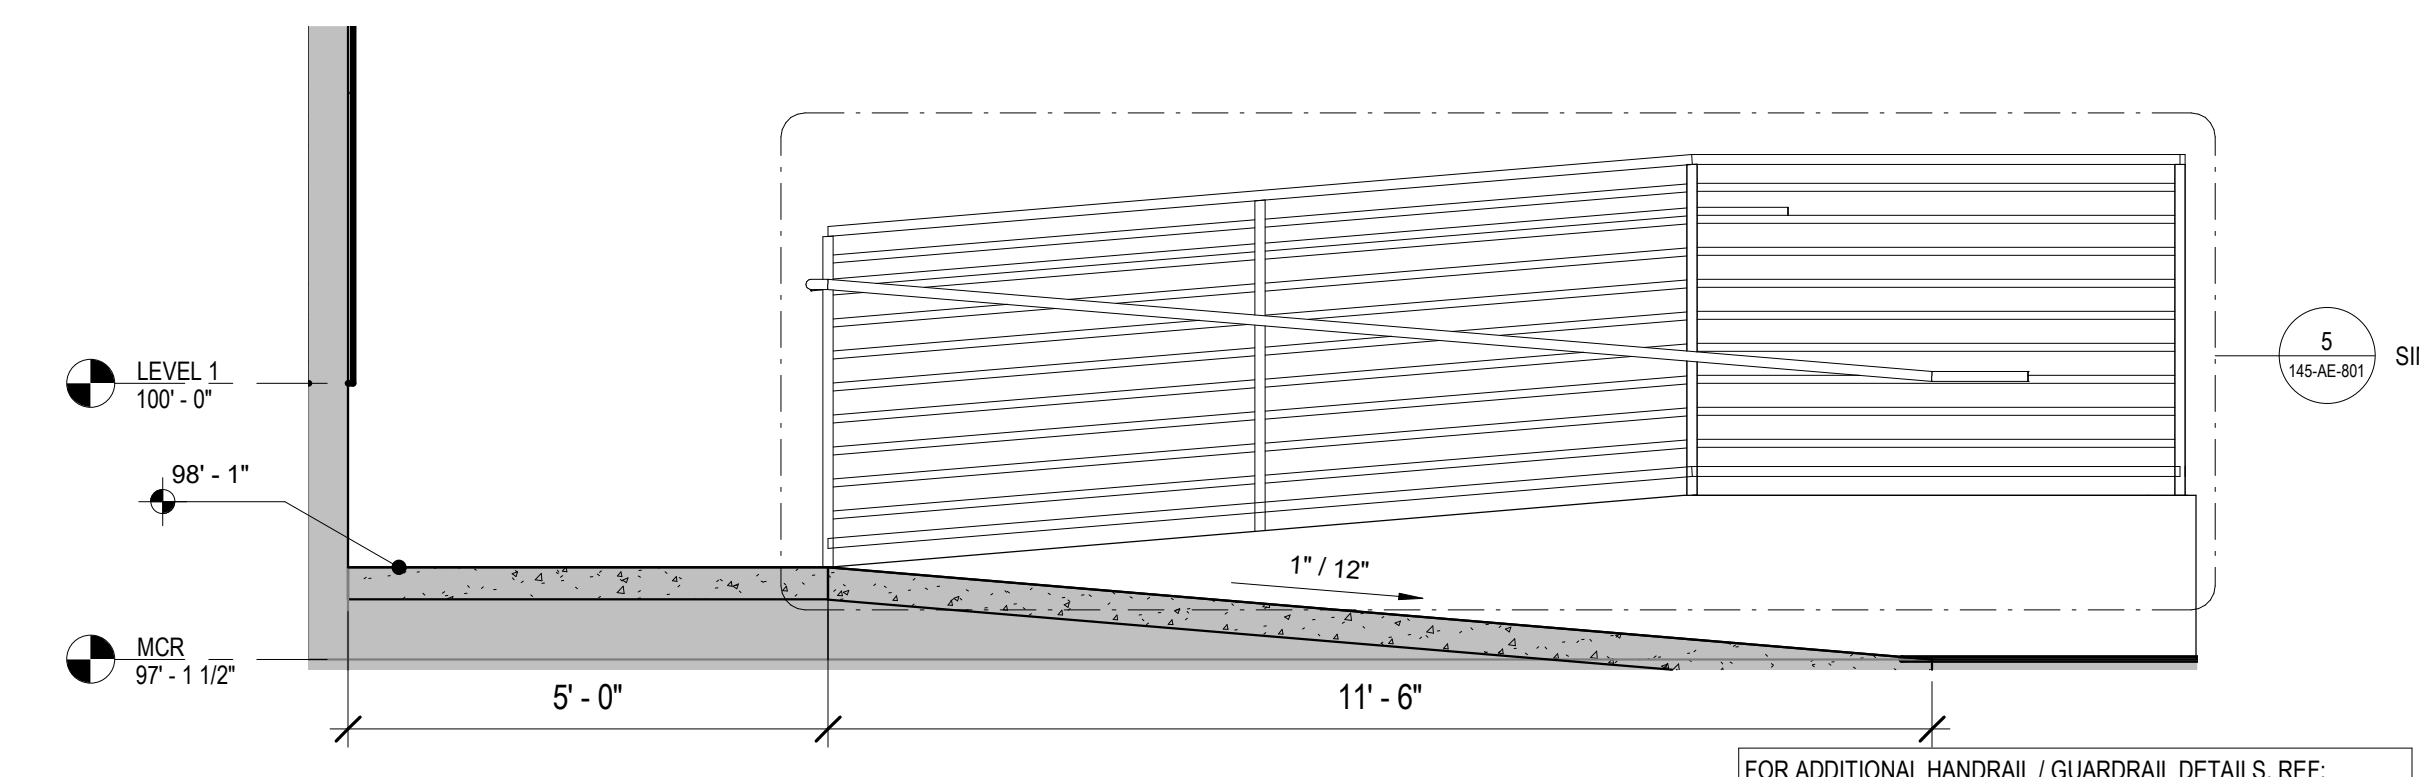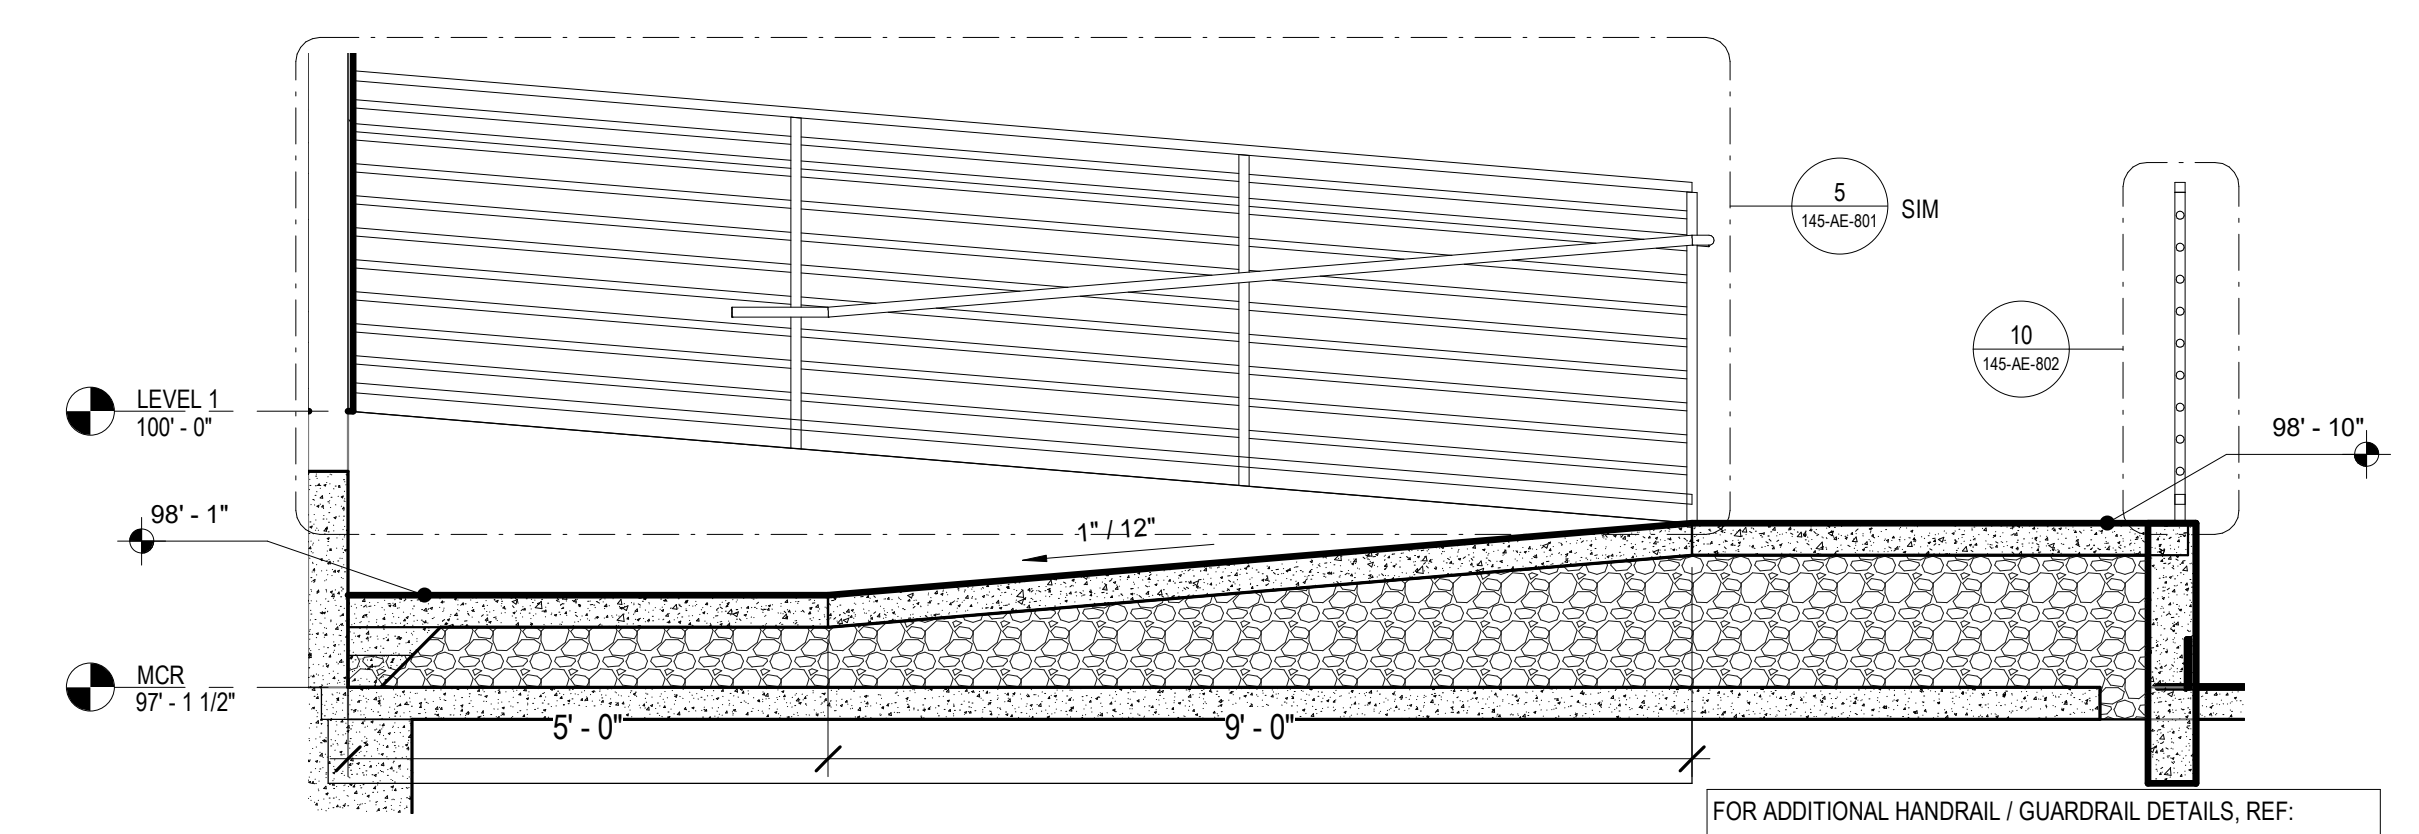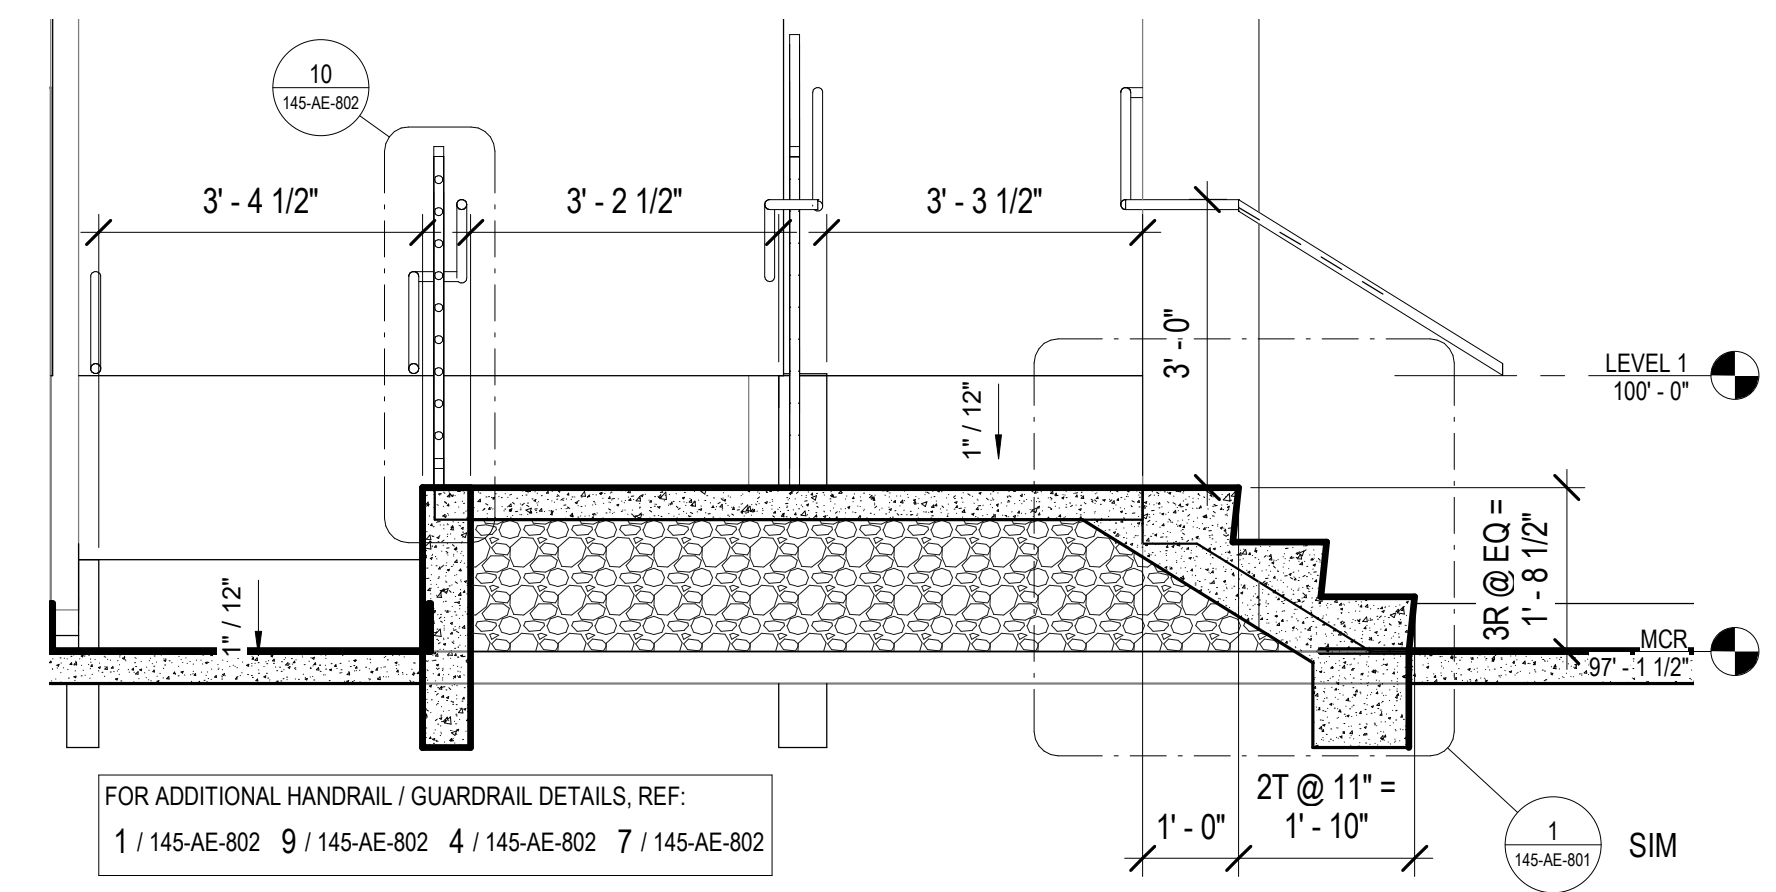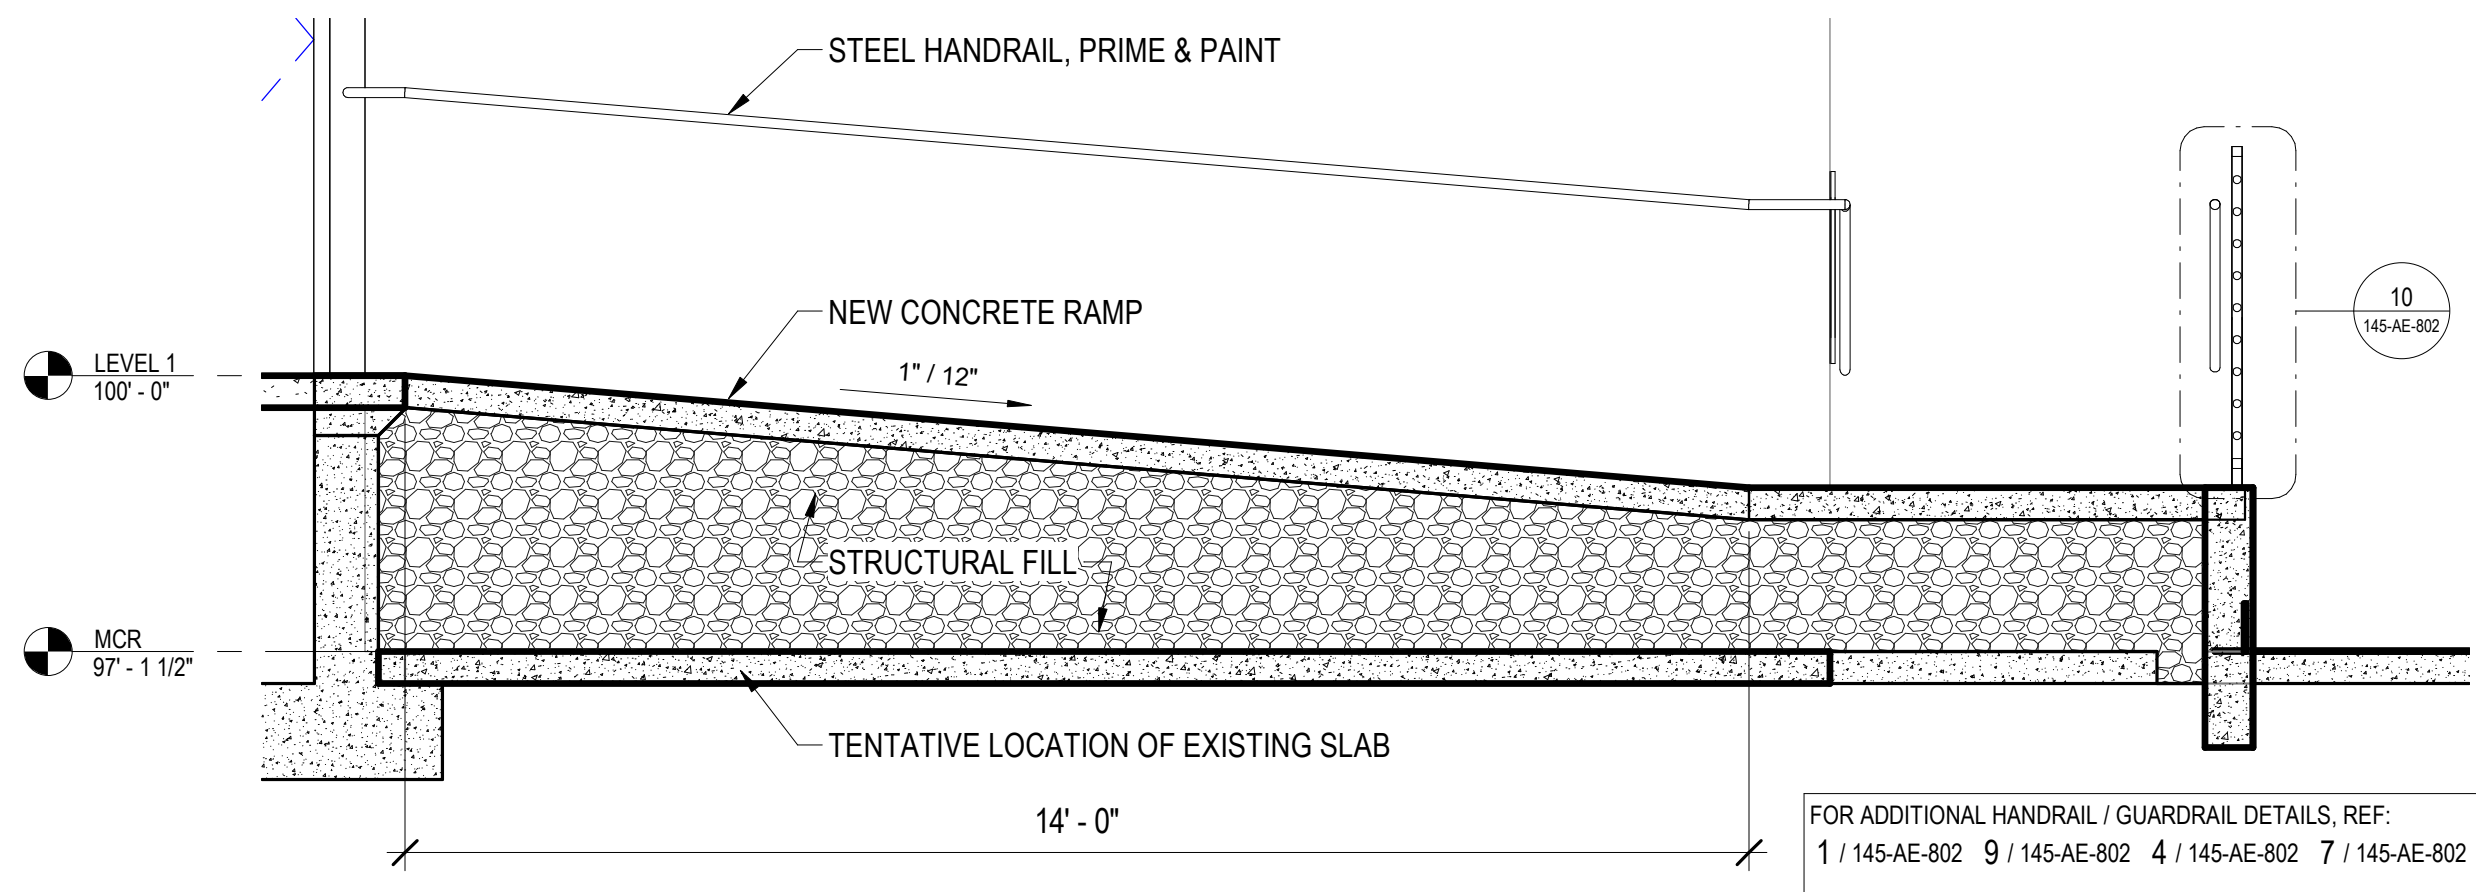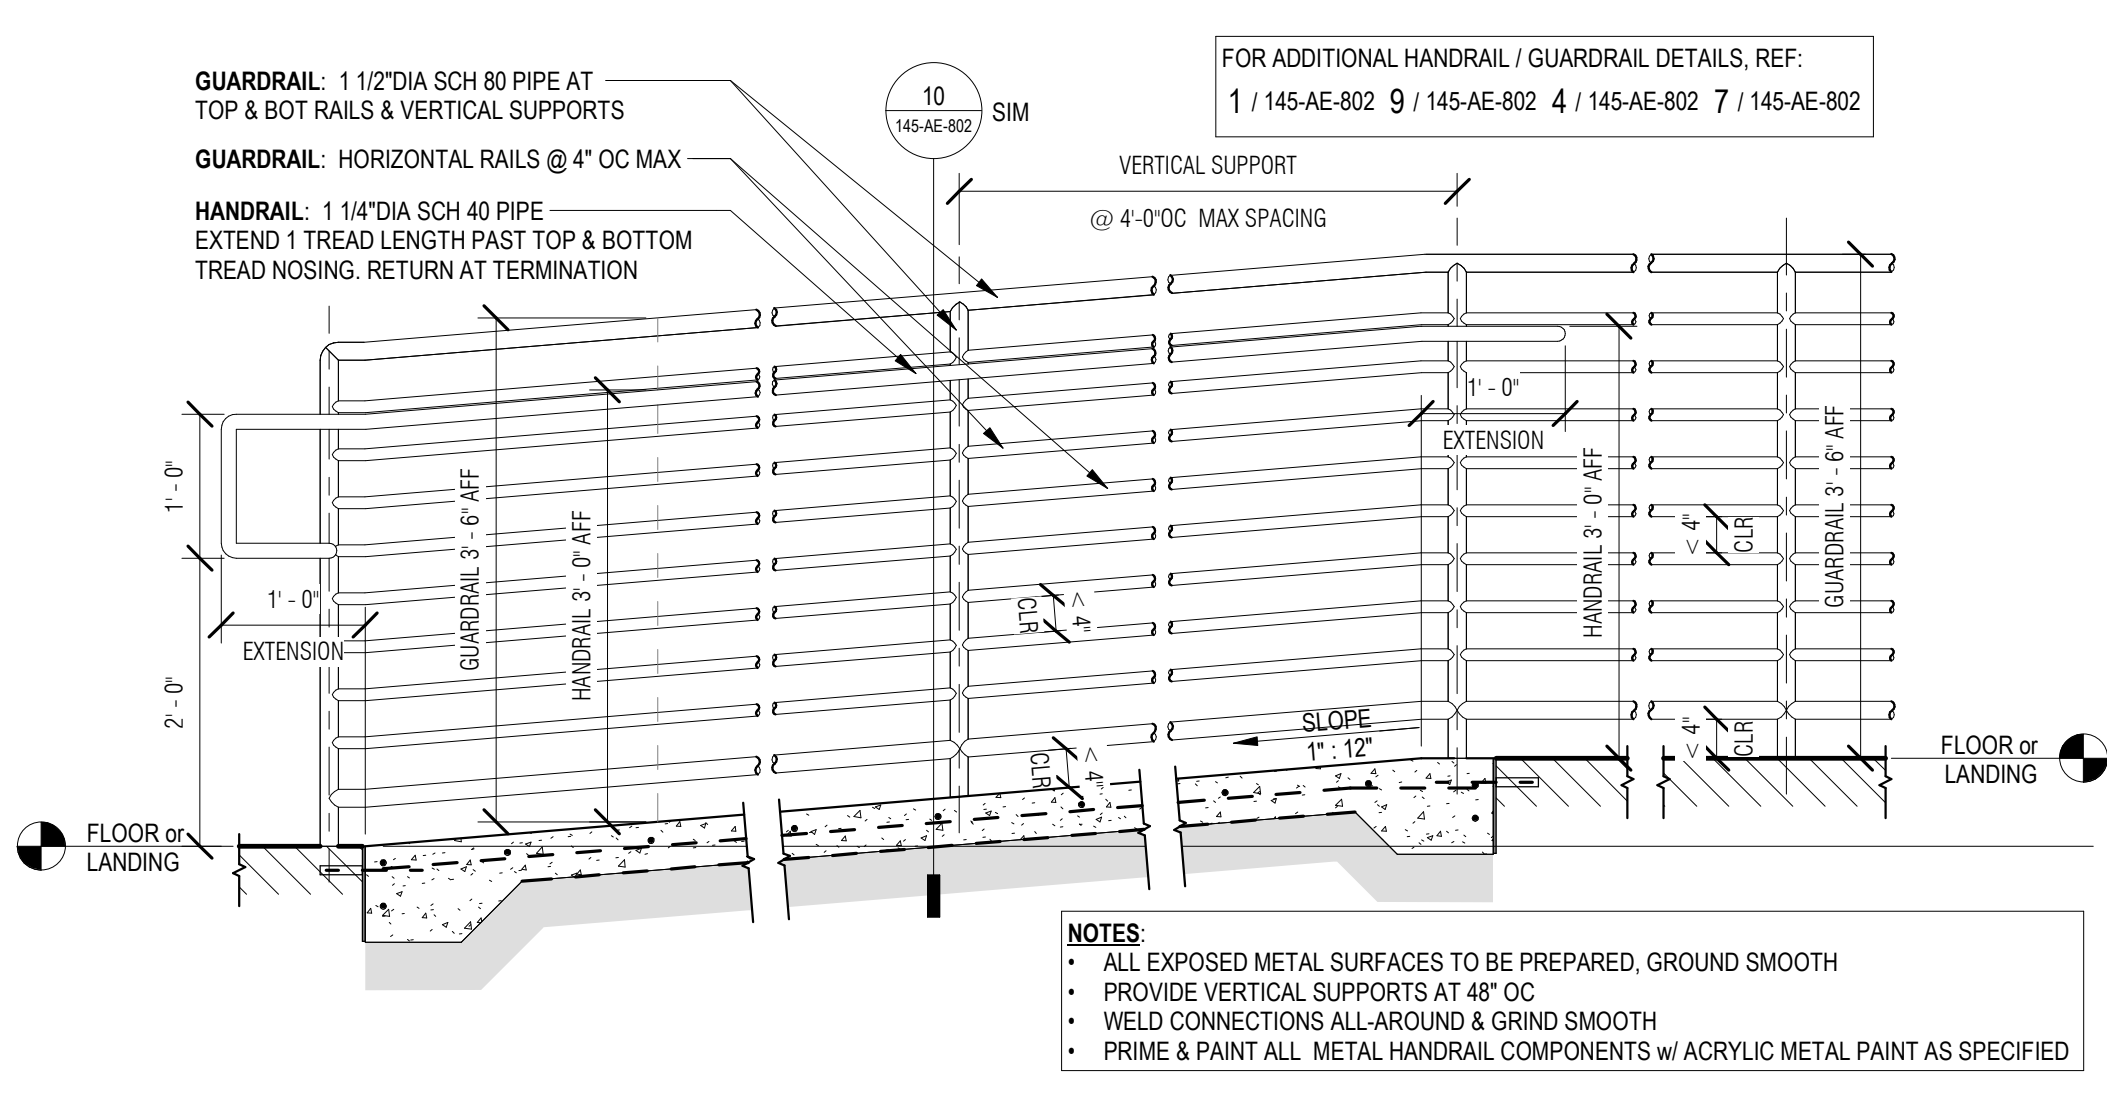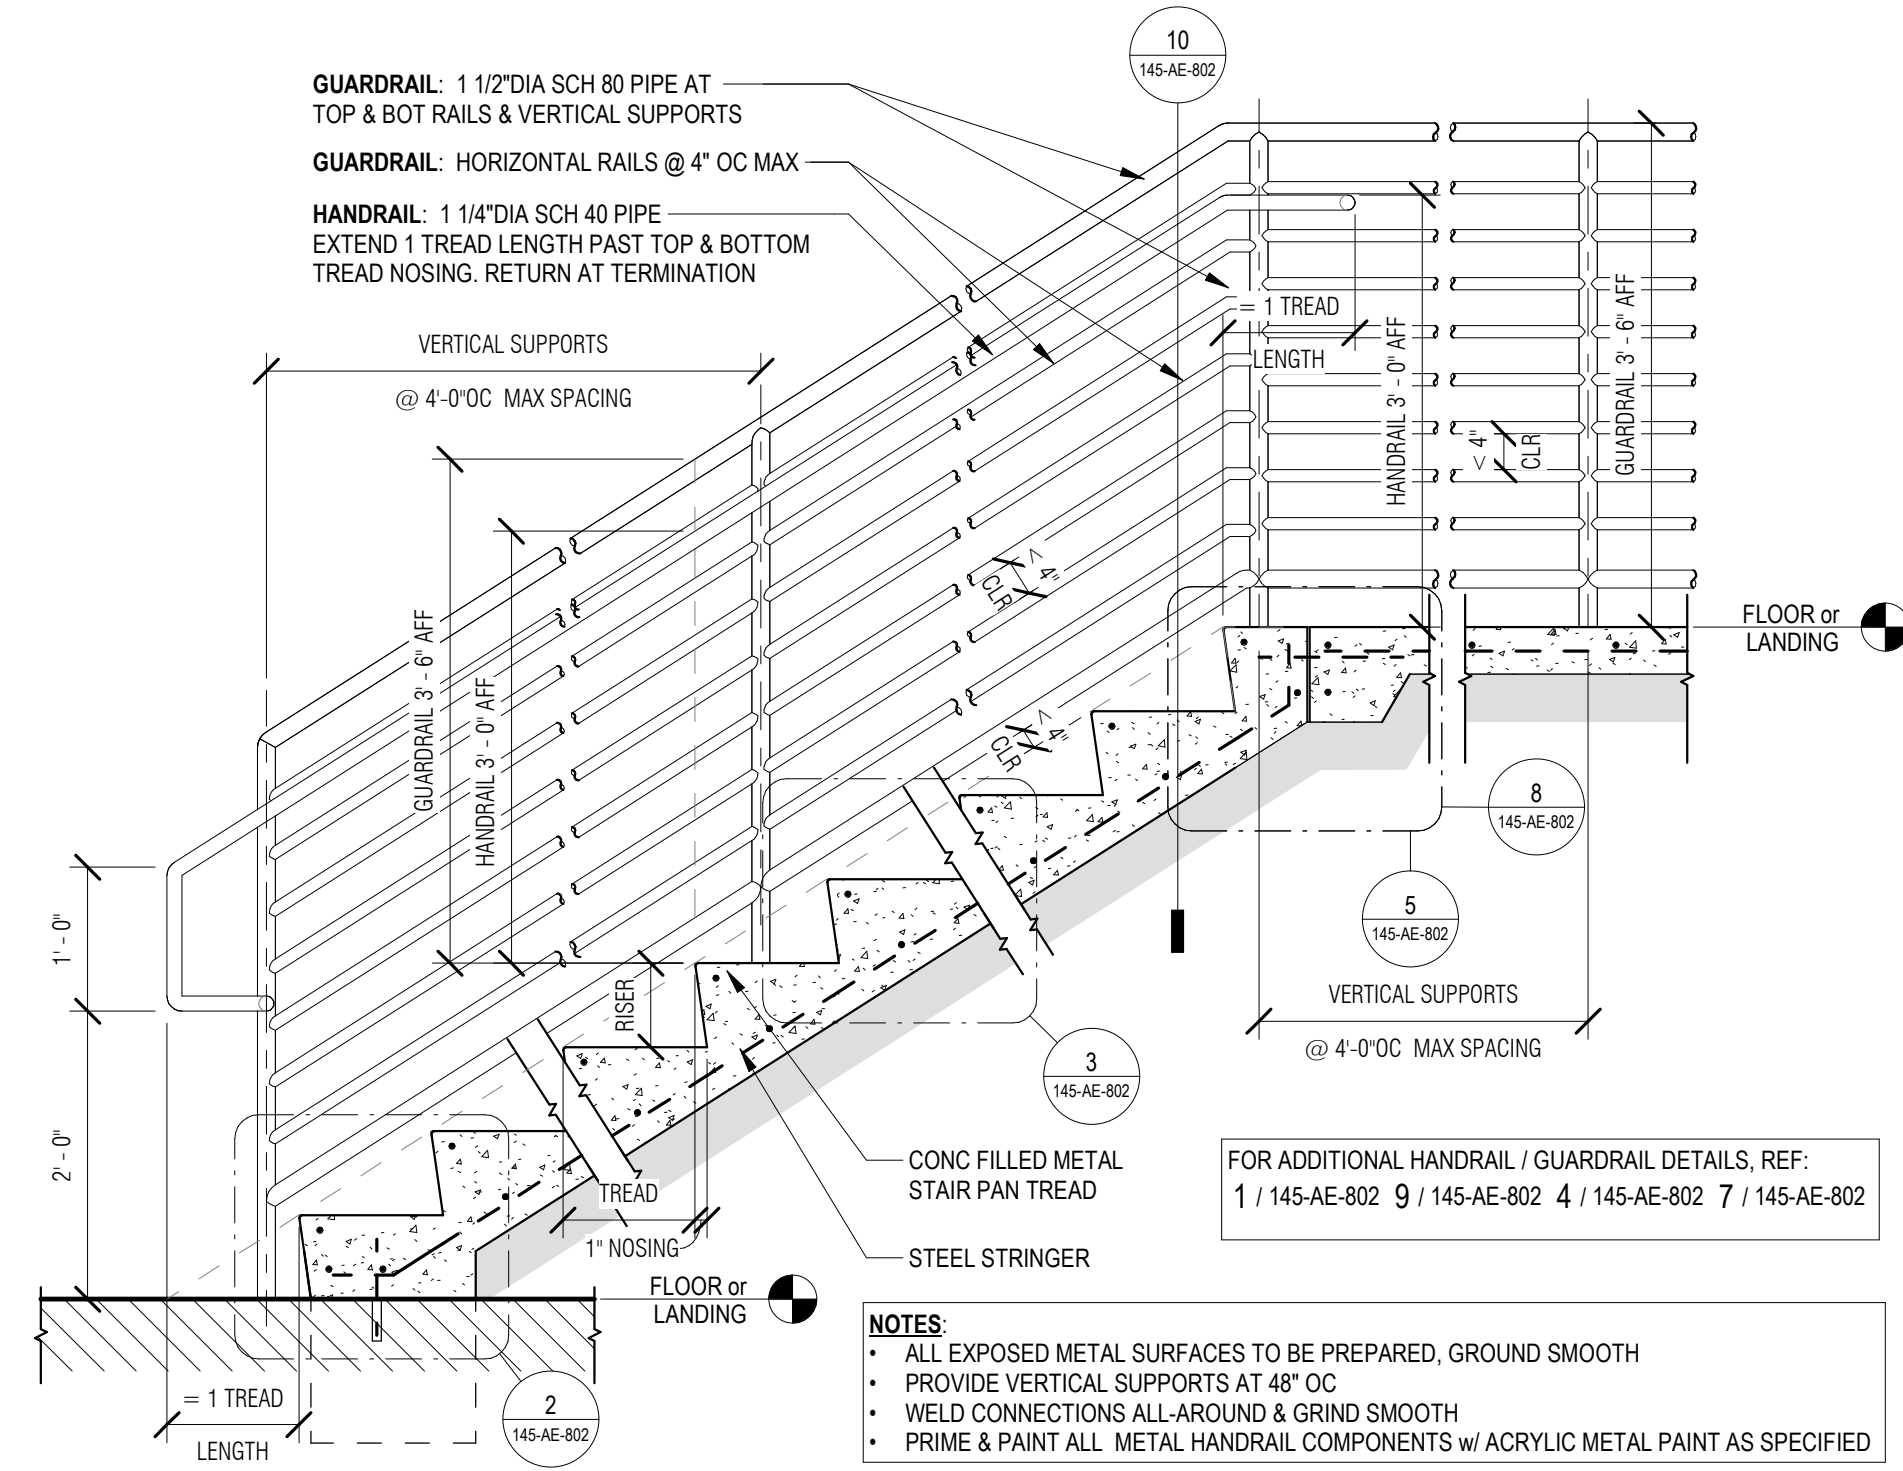CONSULTANT

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PROGRAM CONTRACTING ACTIVITY CENTRAL (PCAC)

VA U.S. Department of Veterans Affairs

DRAWING TITLE
145-VERTICAL CIRCULATION

APPROVED: Project Director

PHASE
100% CONSTRUCTION DOCUMENTS

FLS
FULLY SPRINKLERED

PROJECT TITLE
EHRM INFRASTRUCTURE UPGRADES

LOCATION
FORT MEADE, SOUTH DAKOTA

ISSUE DATE
04/15/2022


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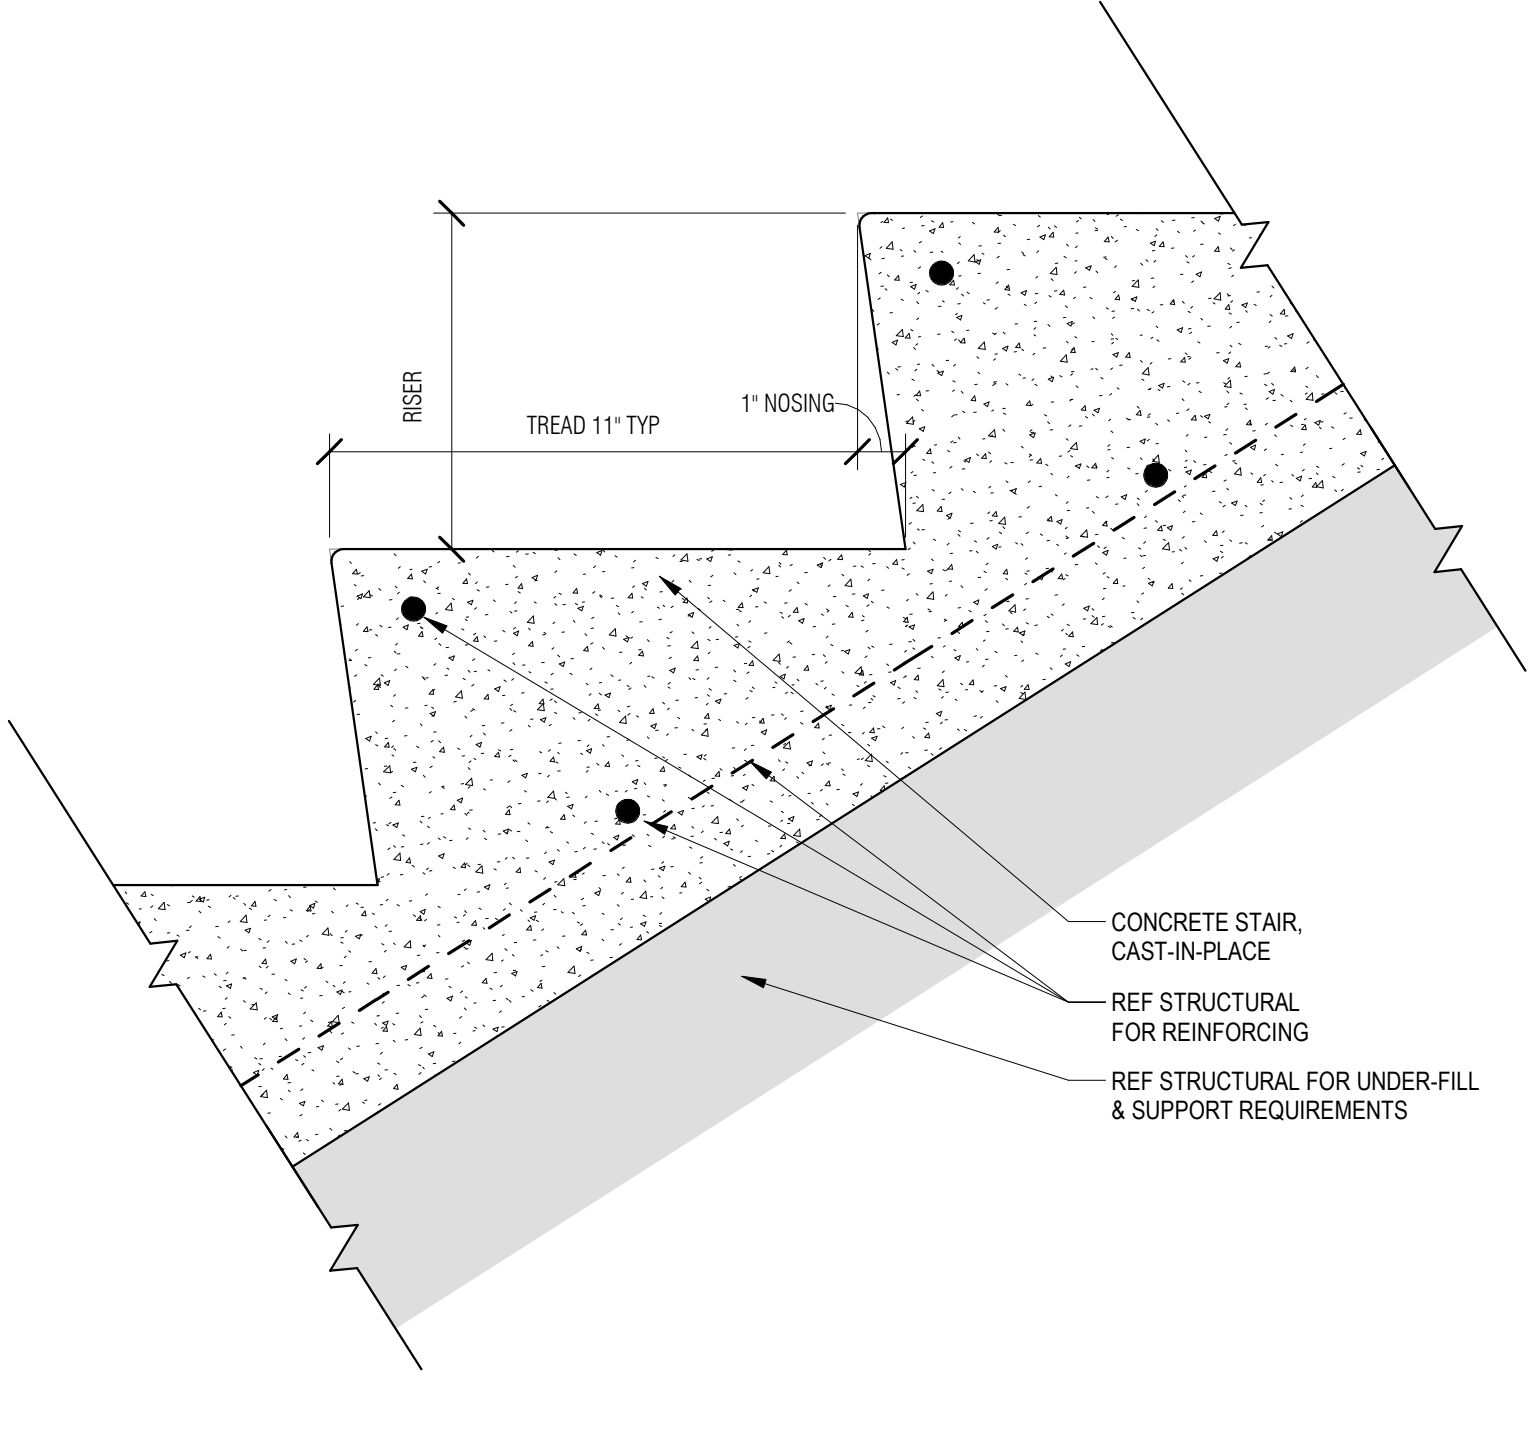
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BUILDING NUMBER
BLDG 145


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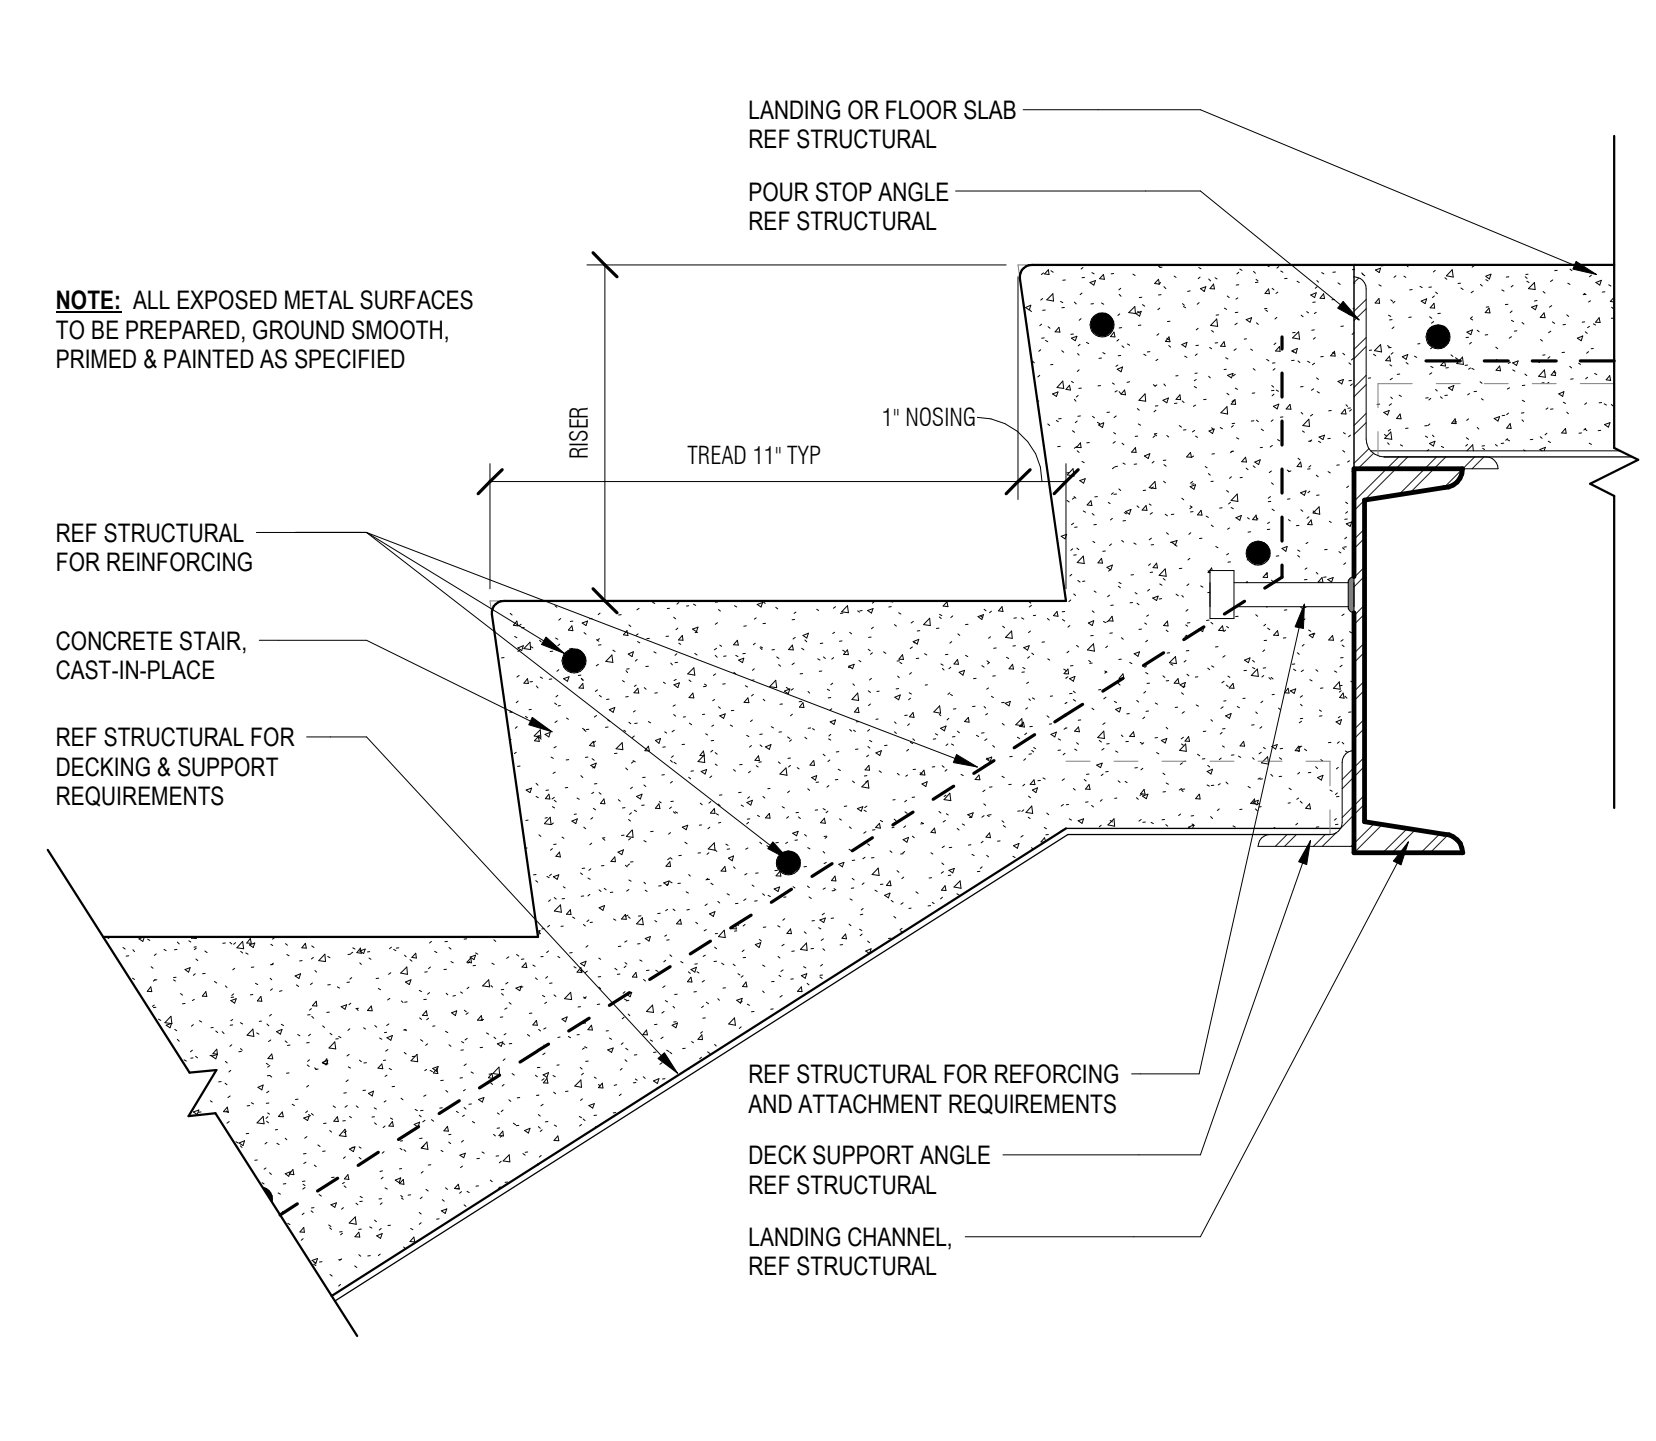
2 CONCRETE STAIR - STARTER CONNECTION
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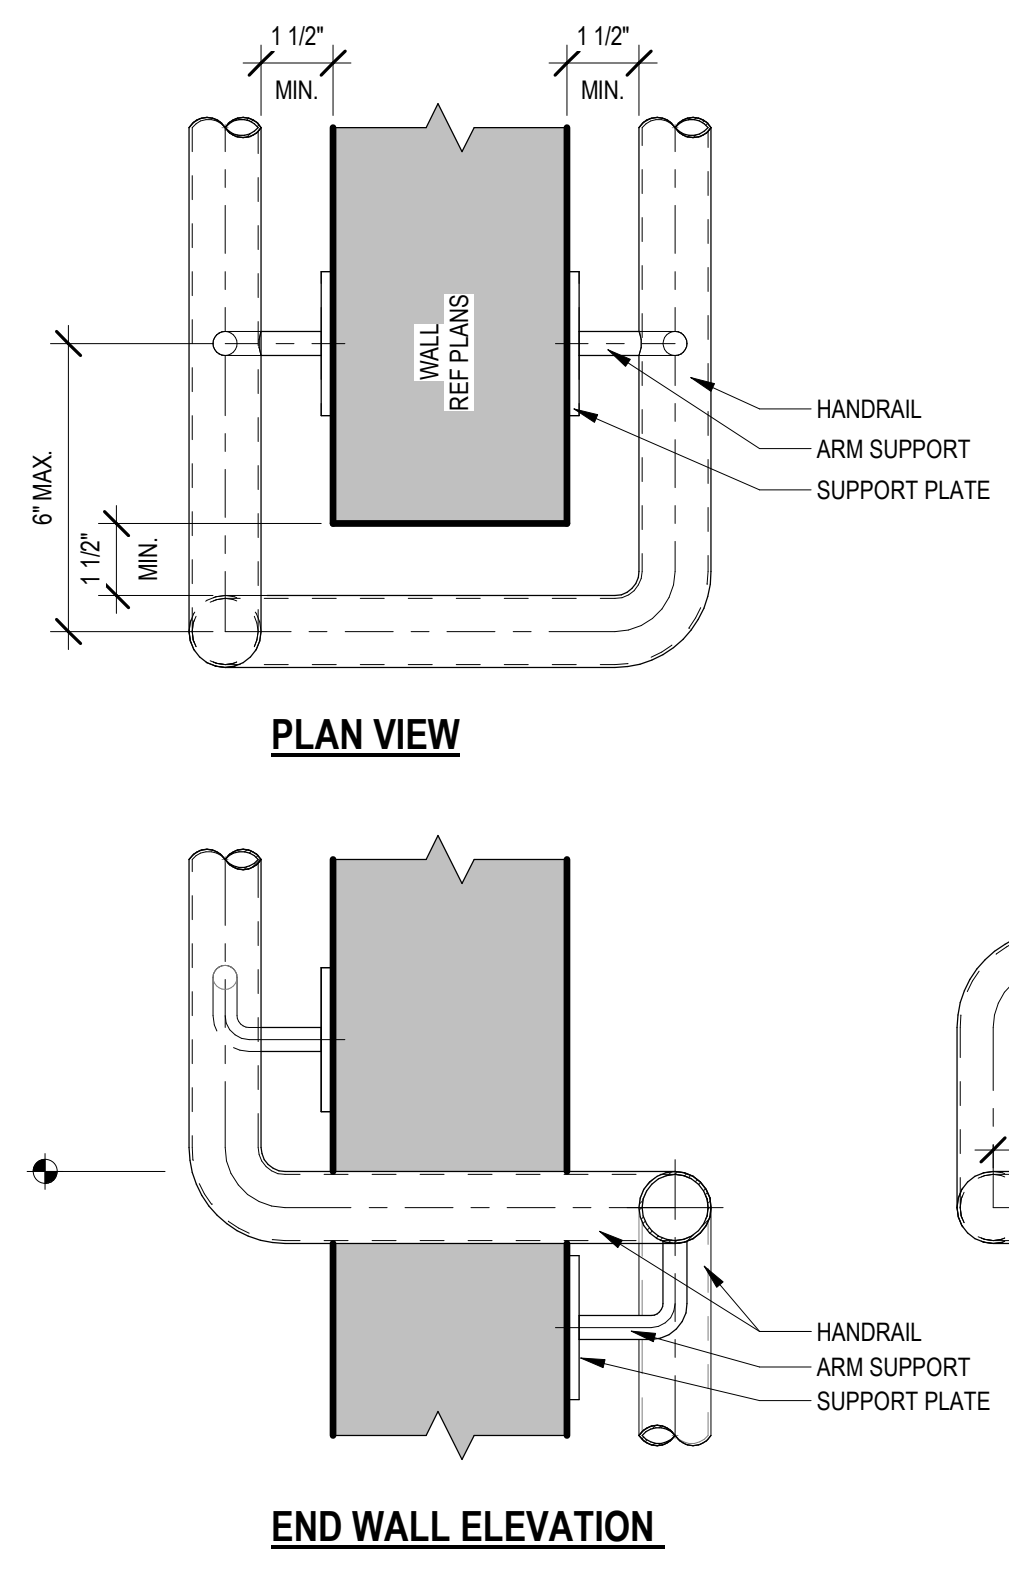
3 CONCRETE STAIR - TREAD DETAIL
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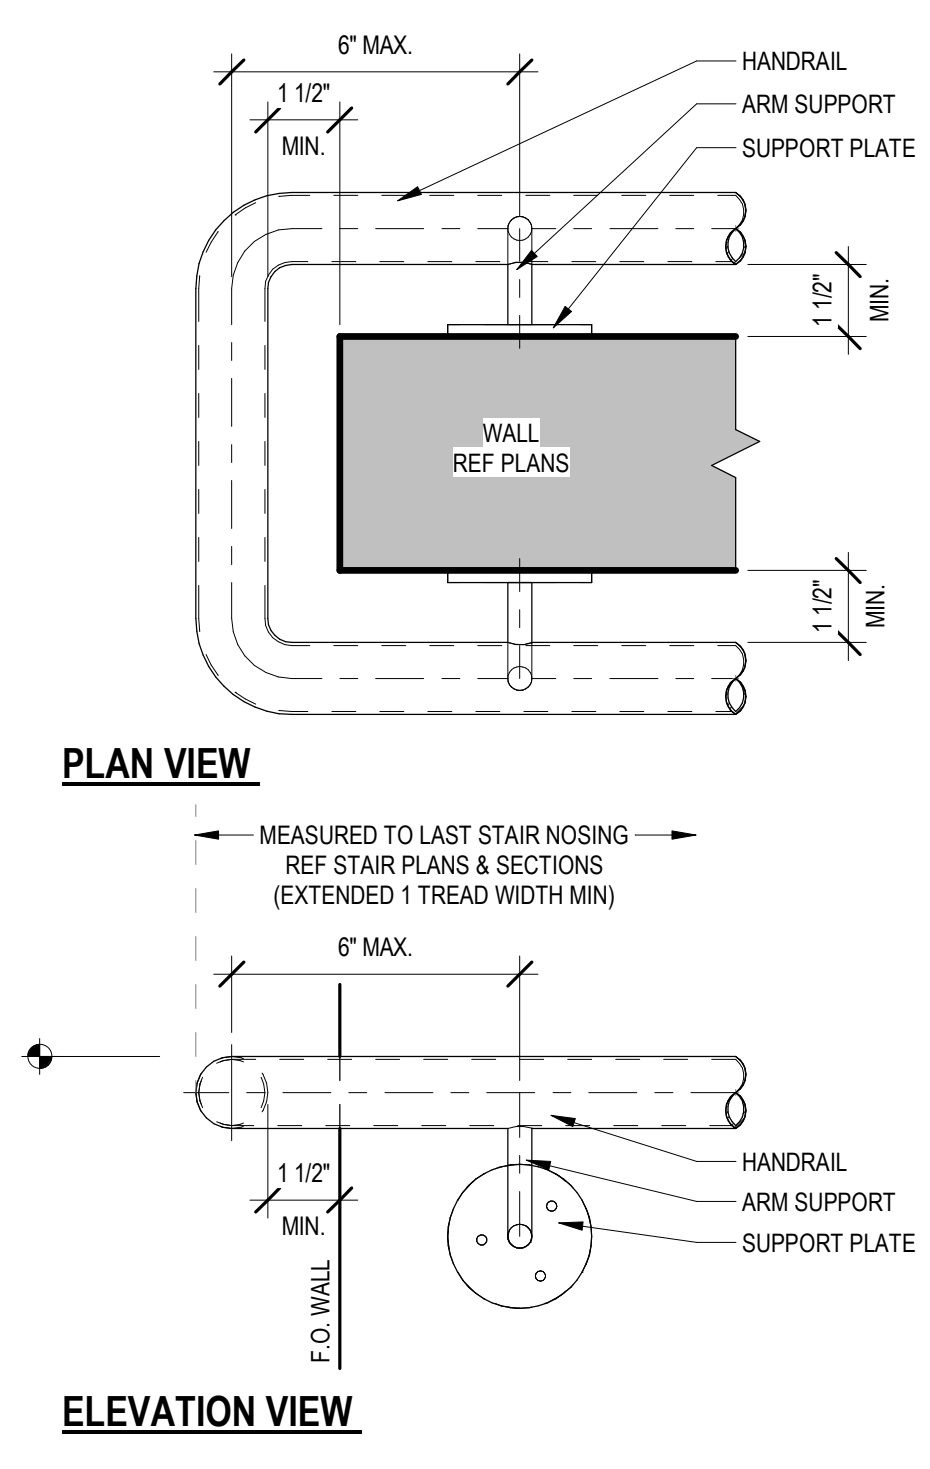
5 CONCRETE STAIR - TERMINATION CONNECTION
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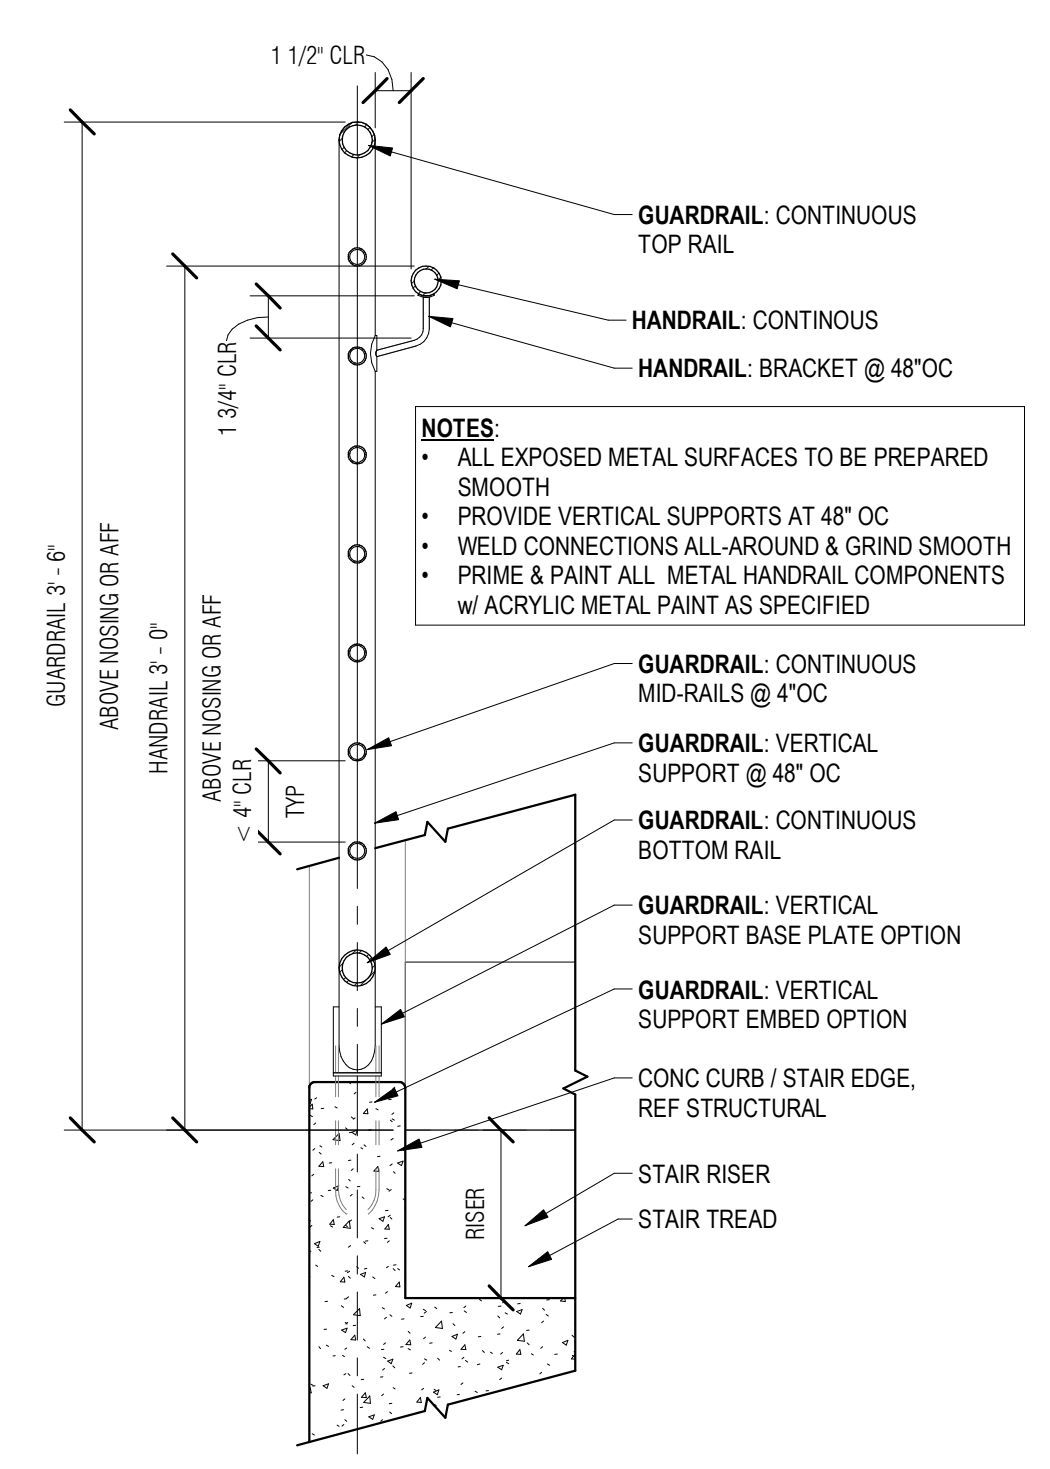
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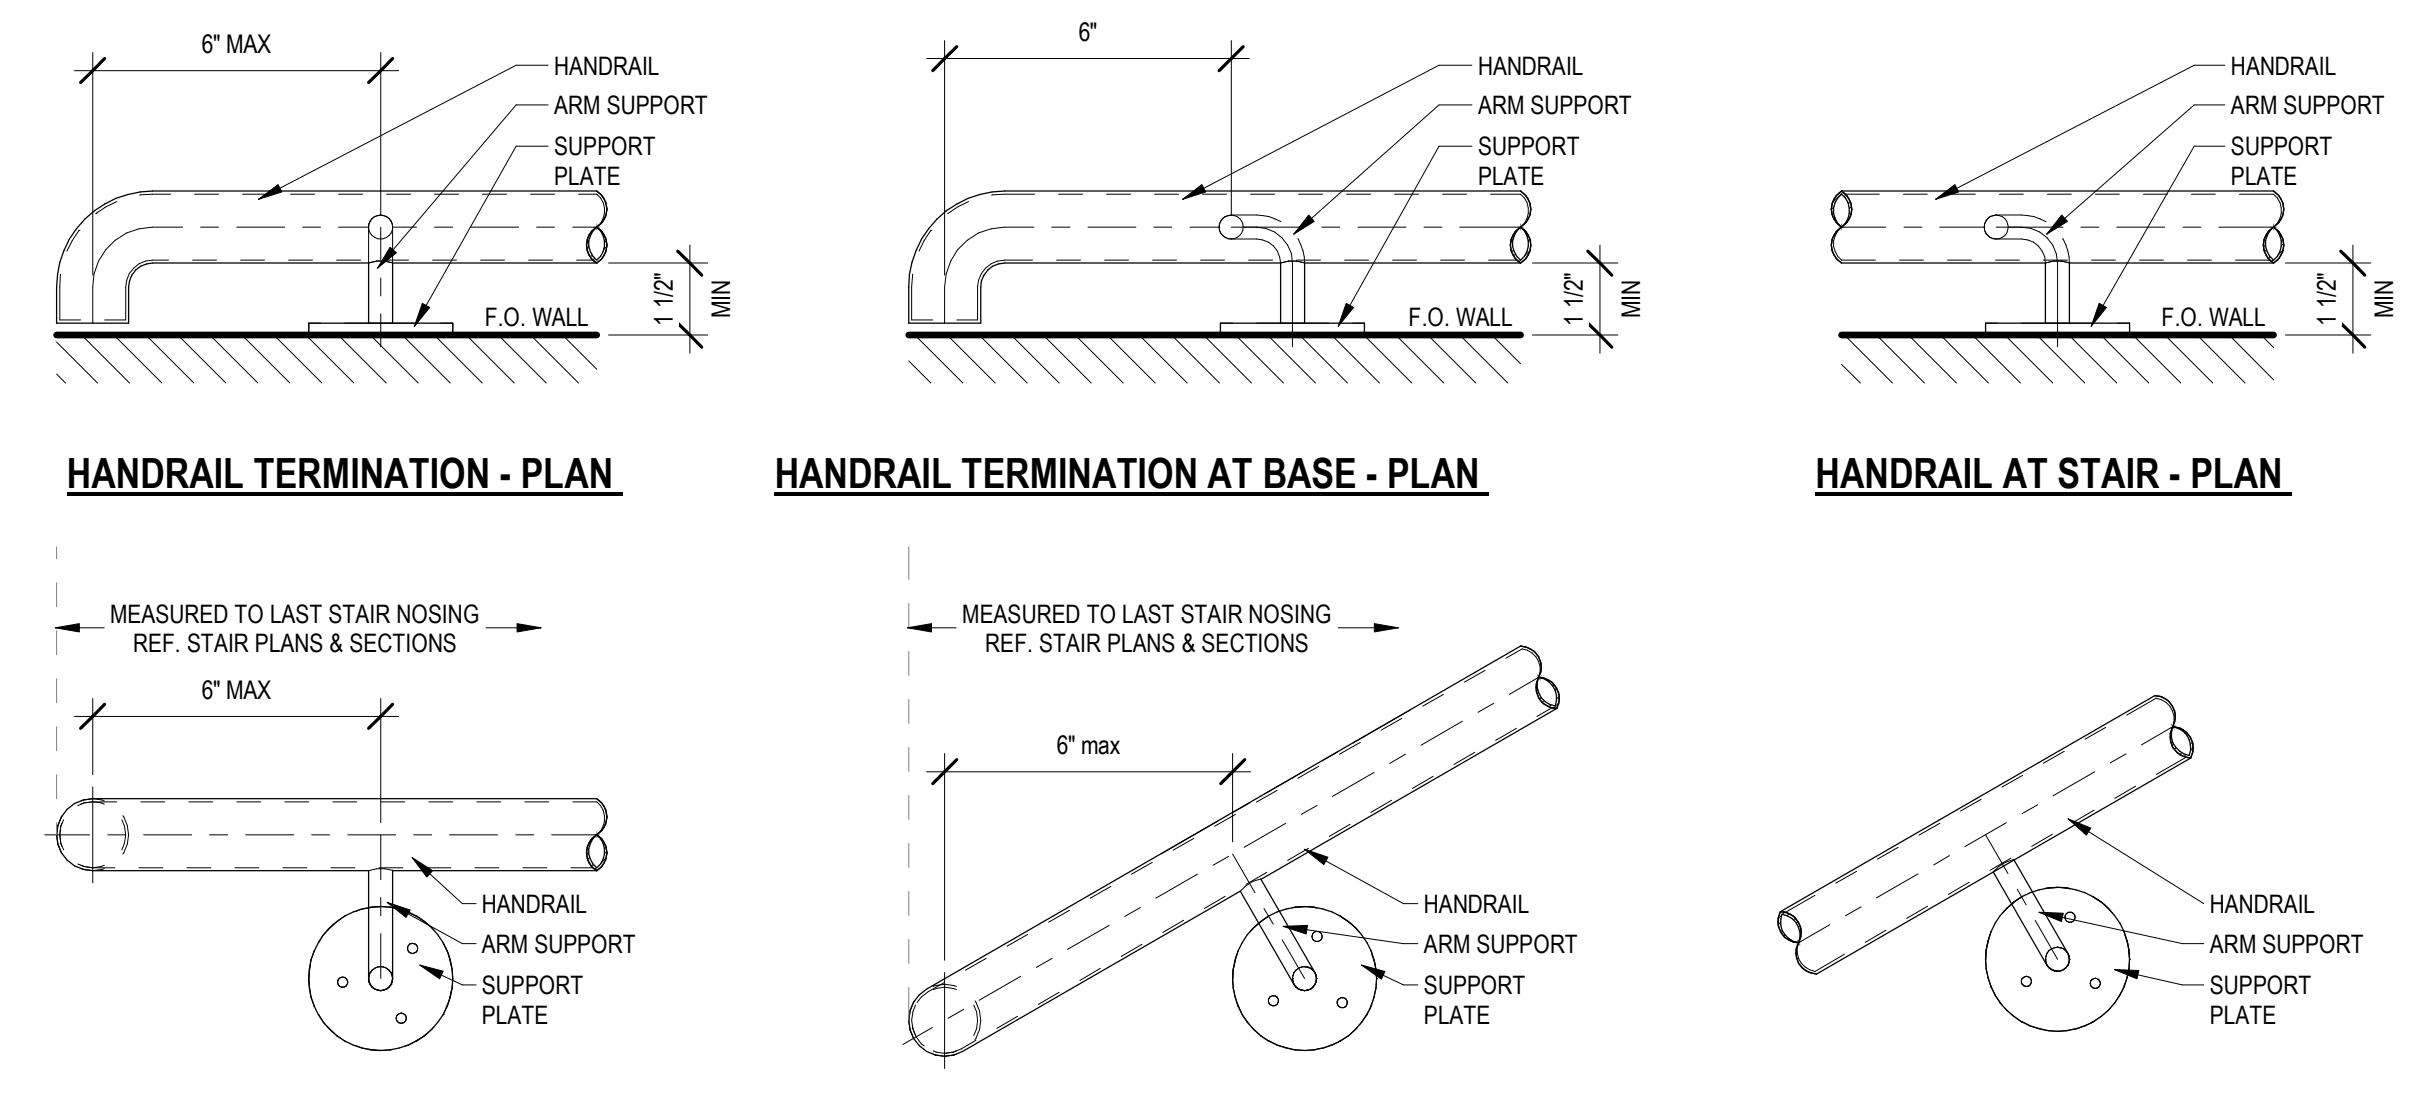
4 CONTINUOUS HANDRAIL TRANSITION
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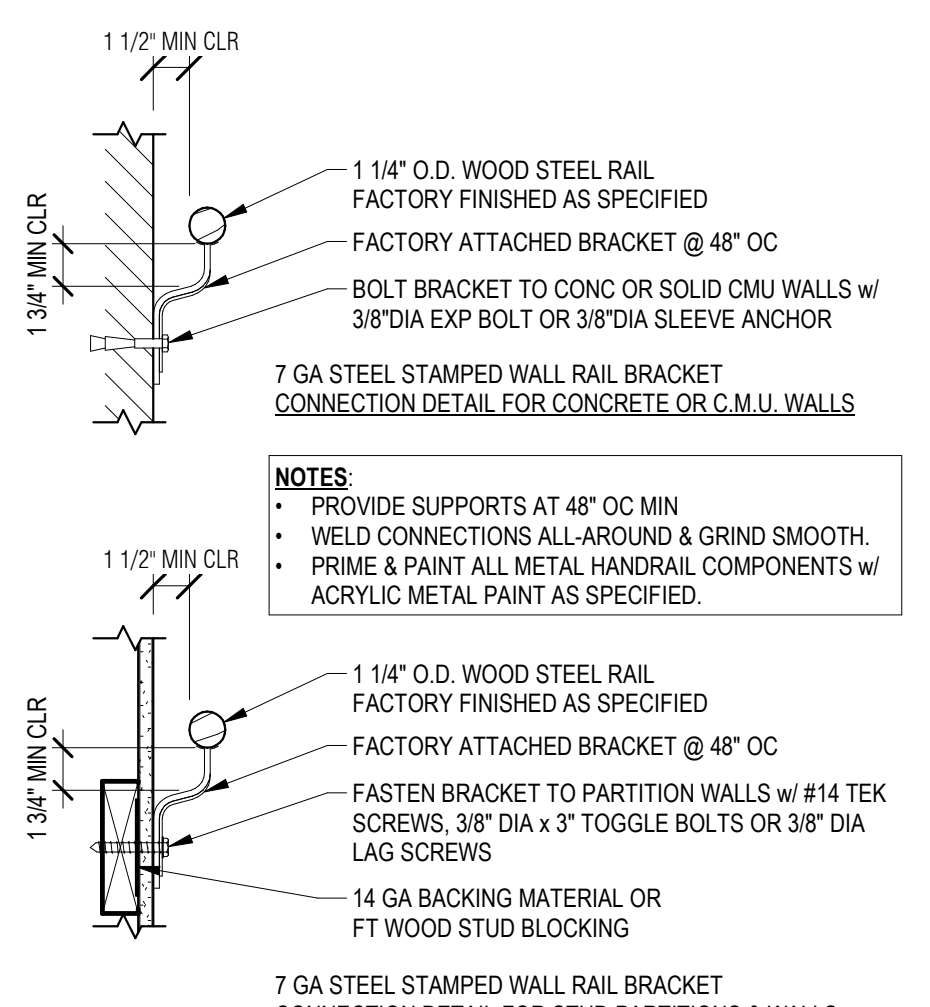
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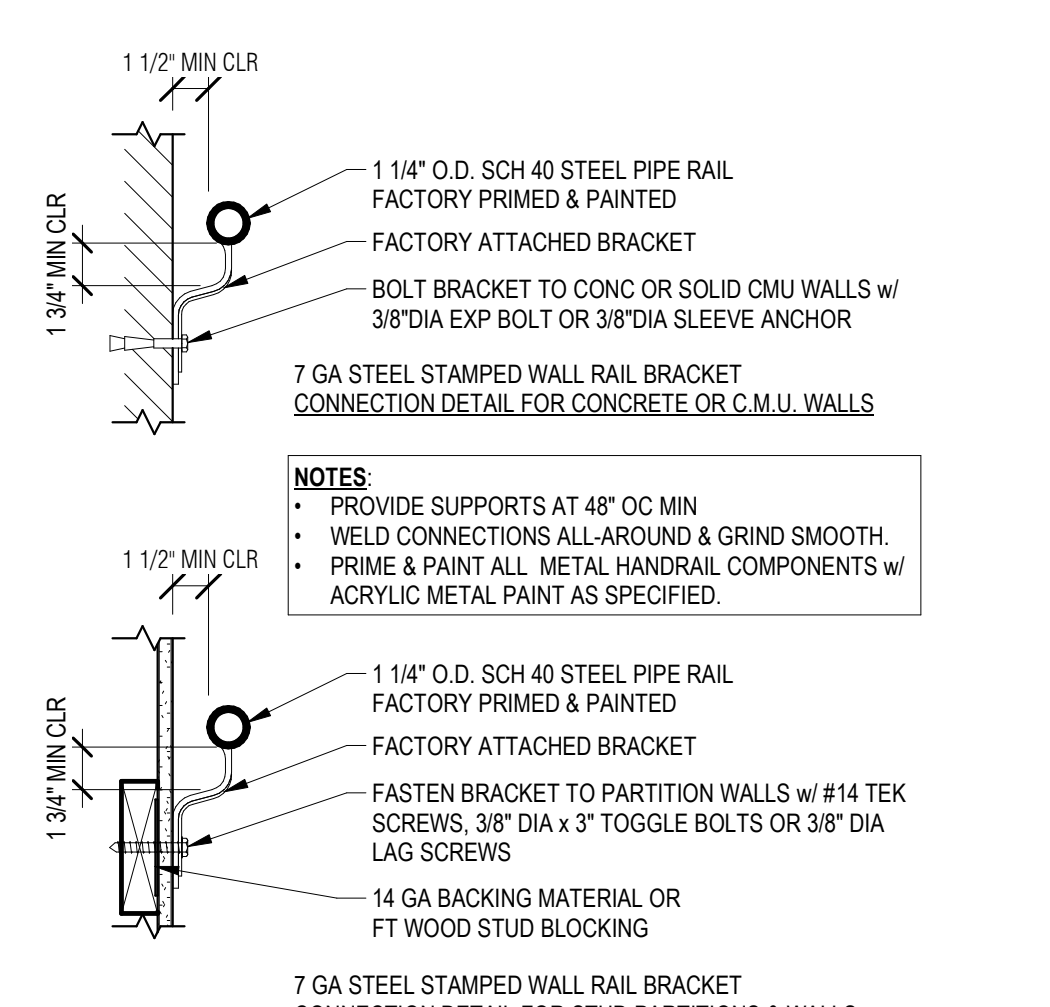
10 STEEL STAIR - RAILING SECTION
1 1/2\"/>



1 HANDRAIL MOUNTING AND TERMINATION
3\"/>

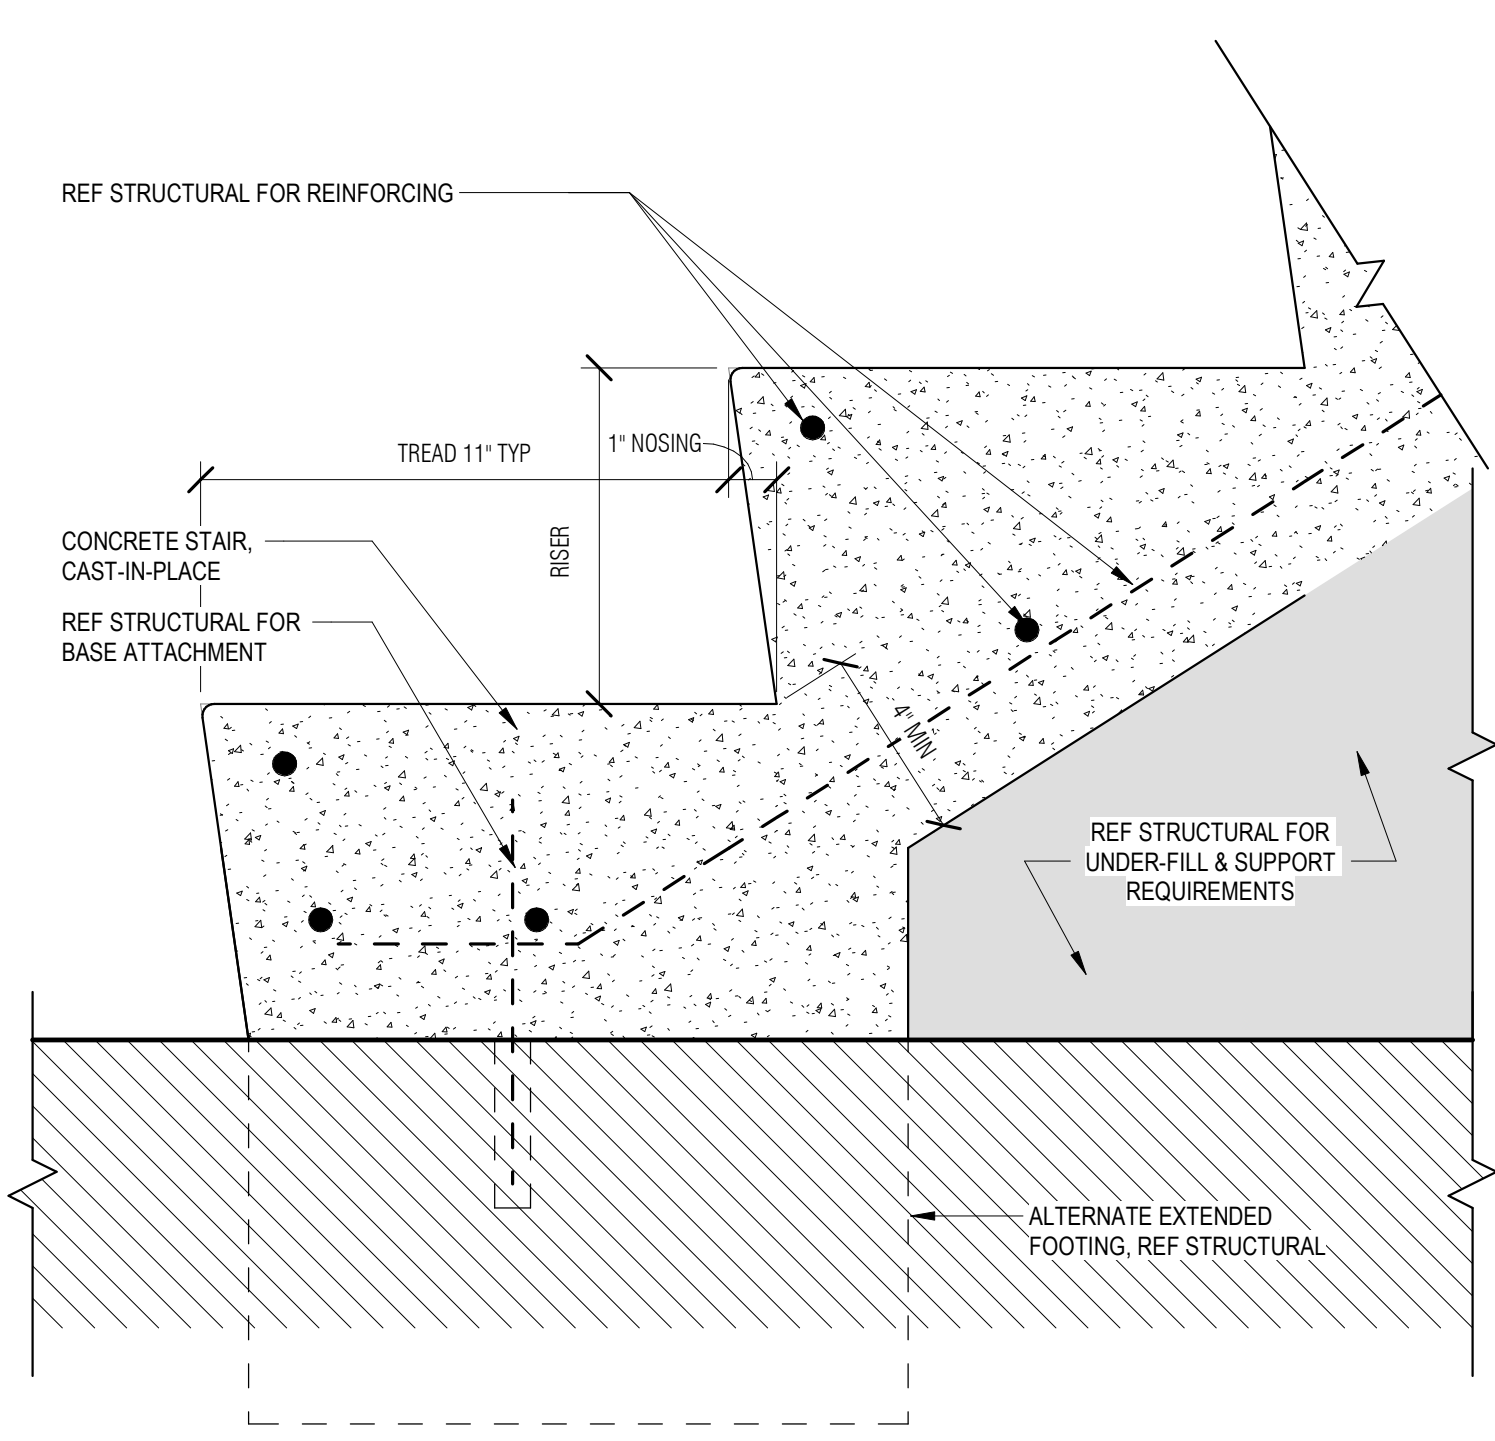

6 WALL-MOUNTED WOOD HANDRAIL
N.T.S.

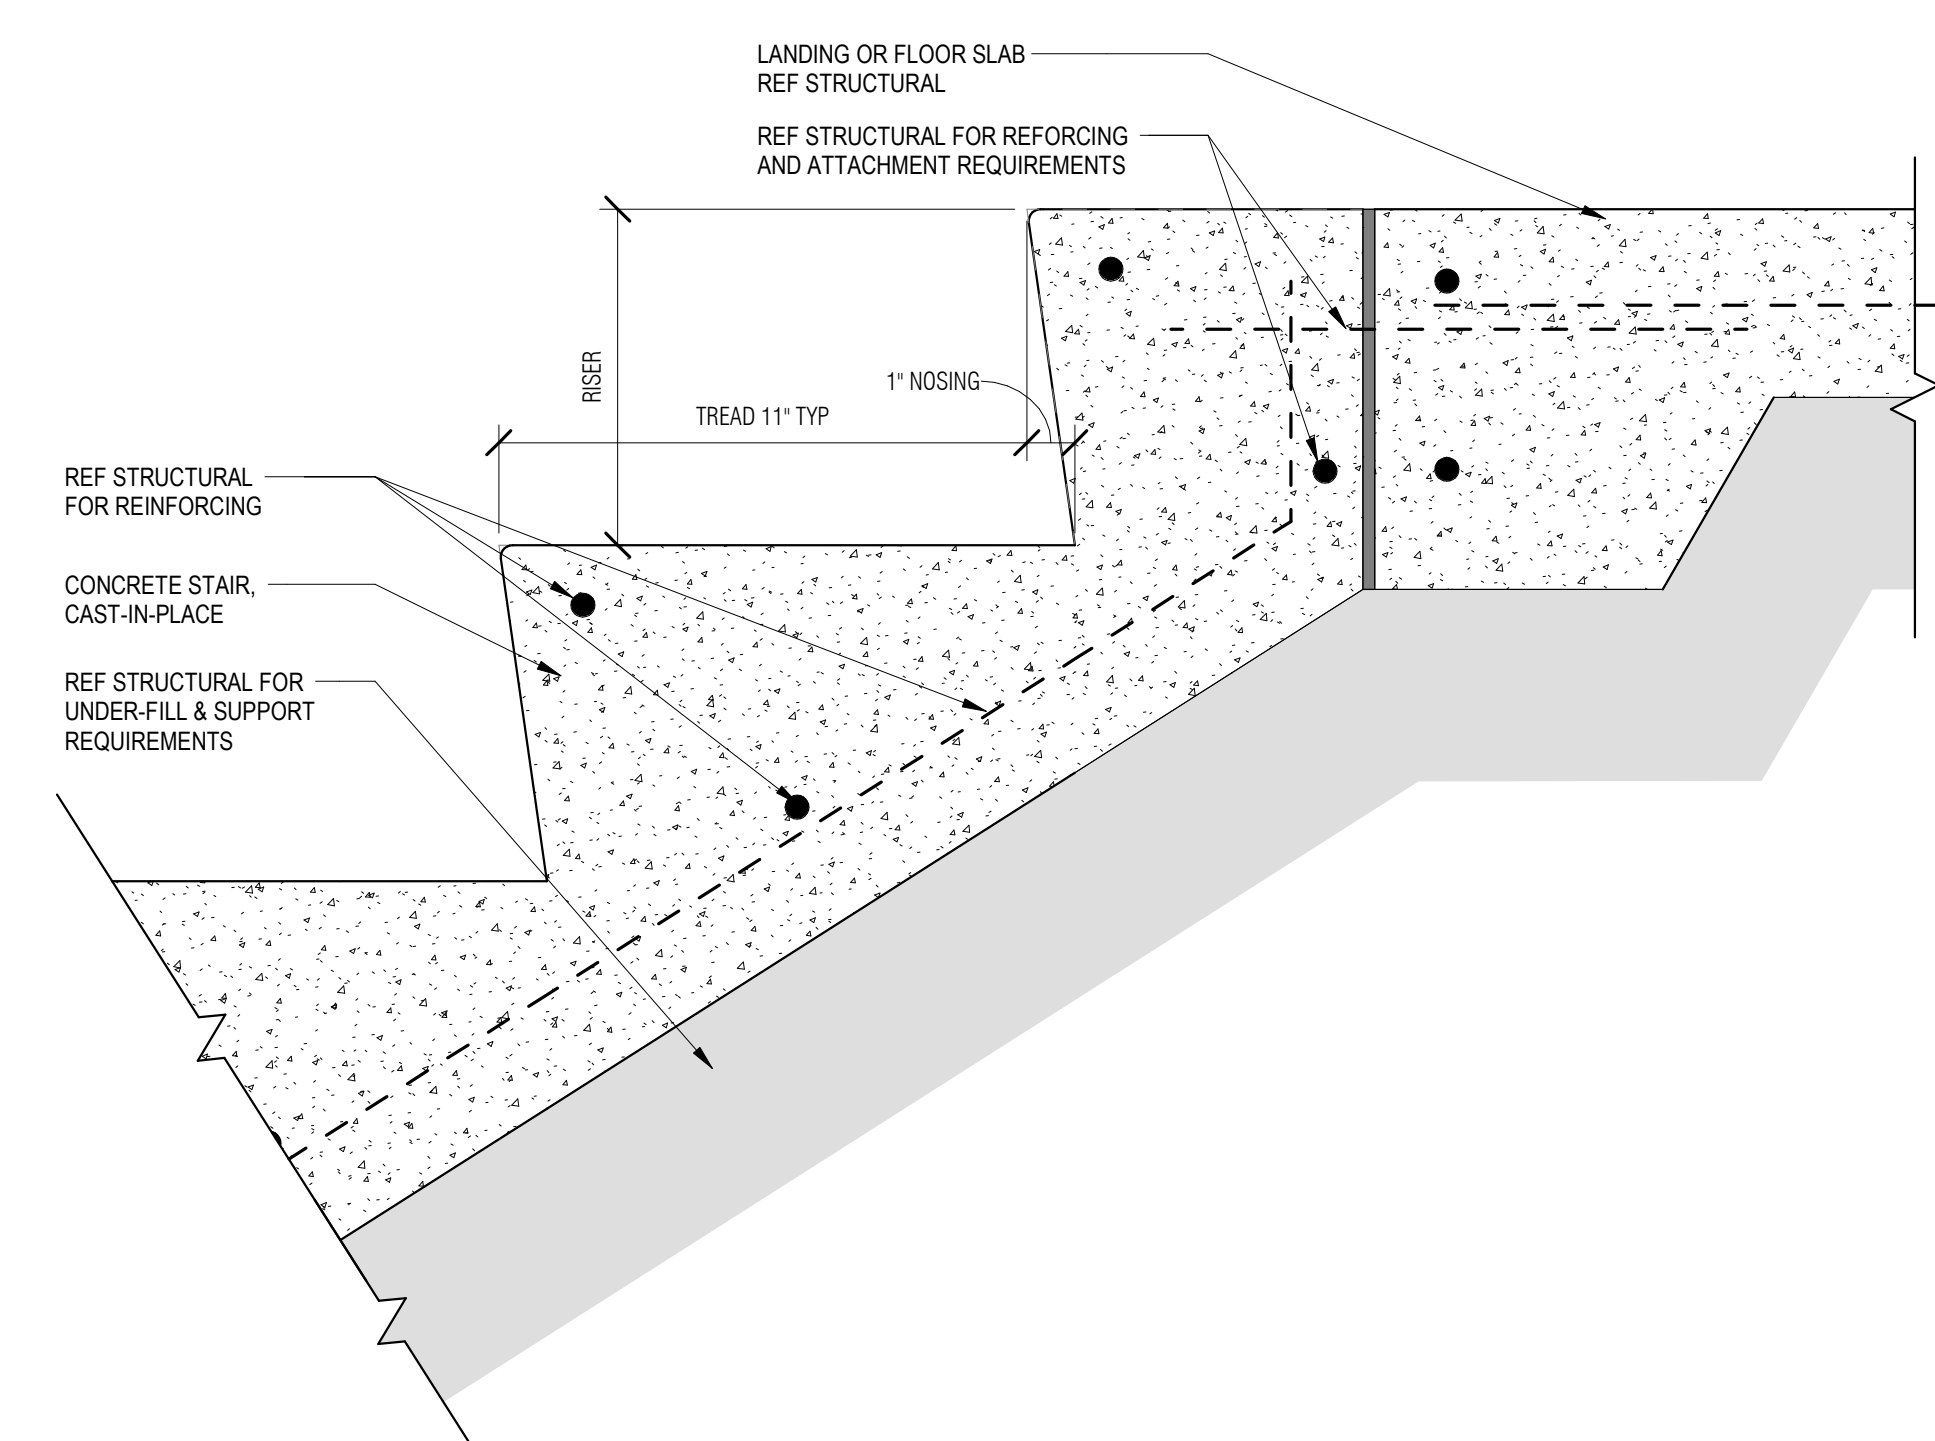

9 WALL-MOUNTED STEEL HANDRAIL
N.T.S.

BIM 360/2/112_VA Medical Center - Ft Meade SD2112_Bldg 145_050.rvt
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STAMP

PROGRAM CONTRACTING ACTIVITY CENTRAL (PCAC)

DRAWING TITLE
 STAIR, RAMP AND RAILING DETAILS

APPROVED: Project Director

PHASE
 100% CONSTRUCTION DOCUMENTS

FLS
 FULLY SPRINKLERED

PROJECT TITLE
 EHRM INFRASTRUCTURE UPGRADES

LOCATION
 FORT MEADE, SOUTH DAKOTA

ISSUE DATE
 04/15/2022

CHECKED BY
 JPR

DRAWN BY
 JPR

PROJECT NUMBER
 568-21-701

BUILDING NUMBER
 BLDG 145

DRAWING NUMBER
 145-AE-802

FLOOR PLAN NOTES

- SEE G SERIES SHEETS FOR BALANCE OF FLOOR PLAN GENERAL NOTES.
- REFER TO STRUCTURAL, MECHANICAL, AND ELECTRICAL DRAWINGS FOR ADDITIONAL INFORMATION. ALL INFORMATION REGARDING EXISTING CONDITIONS IS BASED UPON OWNER-SUPPLIED DOCUMENTS AND MAY NOT PRECISELY REFLECT FIELD CONDITIONS.
- PROVIDE ALL BACKING FOR MILLWORK, GRAB BARS, AND ANY AND ALL WALL MOUNTED EQUIPMENT OR ACCESSORIES, COORDINATE LOCATIONS.
- ALL DIMENSIONS ARE FROM STRUCTURAL OR UNFINISHED FACE OF STUD, UNLESS OTHERWISE NOTED.
- PROVIDE A SMOOTH AND LEVEL FINISH FLOOR. TYP. PATCH AND REPAIR ALL INCONSISTENCIES IN FLOOR ELEVATIONS.
- PATCH AND REPAIR ANY / ALL WALL SURFACES AS REQUIRED TO PROVIDE SUITABLE SUBSTRATE FOR FINISHES.
- REFER TO DOOR AND FRAME SCHEDULE FOR DOORS REQUIRING ADA ACCESS CONTROL.
- PROVIDE ACOUSTICAL SEALANT AROUND WALL EDGES, TOP AND BOTTOM, AND PENETRATIONS, AND INSTALL PUTTY PADS AROUND ELECTRICAL BOXES WHERE PARTITION CONTAINS ACOUSTICAL INSULATION.
- ALL TELECOMMUNICATION ROOMS ARE TO HAVE EXPOSED STRUCTURE UNLESS NOTED OTHERWISE, NO CEILINGS SPECIFIED.


KEY NOTES

- 03-01 NEW HOUSEKEEPING PAD. COORDINATE WITH MECHANICAL DRAWINGS FOR SIZE AND CIVIL DRAWINGS FOR DETAILS
- 09-13 FOLLOW EXISTING CABLE ROUTING FOR REMOVAL OF EXISTING CABLE AND INSTALLATION OF NEW CABLES AT LOCATIONS AS NOTED IN TELECOM DRAWINGS
- 09-23 RE-INSTALL STORED FLOOR TILES. REPLACE MISSING OR DAMAGED TILES TO MATCH EXISTING
- 23-08 NEW REFRIGERANT PIPE LINES ROUTING SHOWN FOR REFERENCE ONLY. SEE MECHANICAL DRAWINGS FOR ACTUAL ROUTING. CONTRACTOR TO REMOVE CEILING TILES ALONG ROUTE OUTSIDE OF TRS AND REPLACE WITHIN WORKING SHIFT. CONDUCT INFECTION PREVENTION MEASURES AS SPECIFIED.
- 26-13 NEW CABLE TRAY ROUTING SHOWN FOR REFERENCE ONLY. SEE TELECOMMUNICATION DRAWINGS FOR ACTUAL ROUTING. CONDUCT INFECTION PREVENTION MEASURES AS SPECIFIED.

ROOM ALLOCATION LEGEND

- PROPOSED NEW TR LOCATION
- PROPOSED EXPANSION TO TR
- EXISTING TR TO BE UPDATED
- ABANDONED ROOM
- ROOM TO REMAIN, NO WORK
- REMODEL REQUIRED DUE TO EHRM IMPACT

PROJECT KEY PLAN

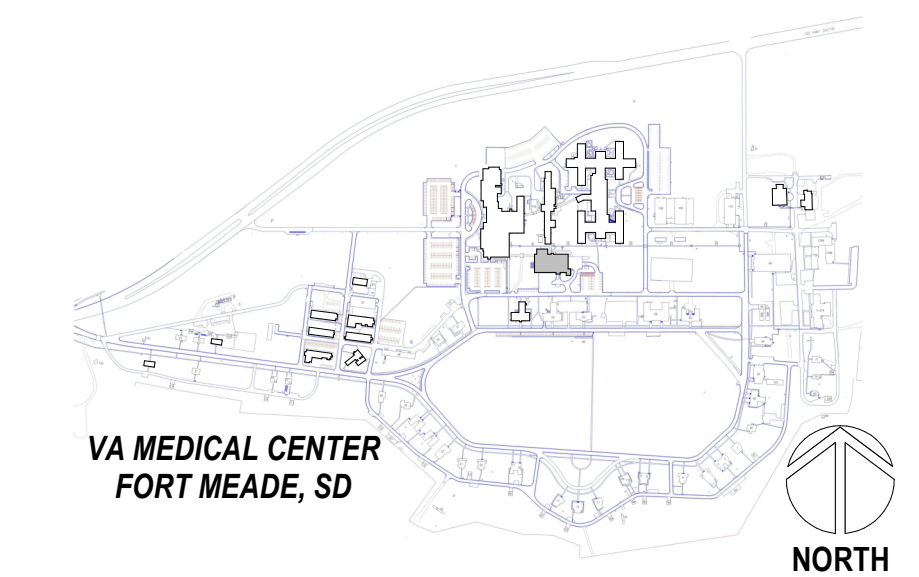

A

B

C


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E



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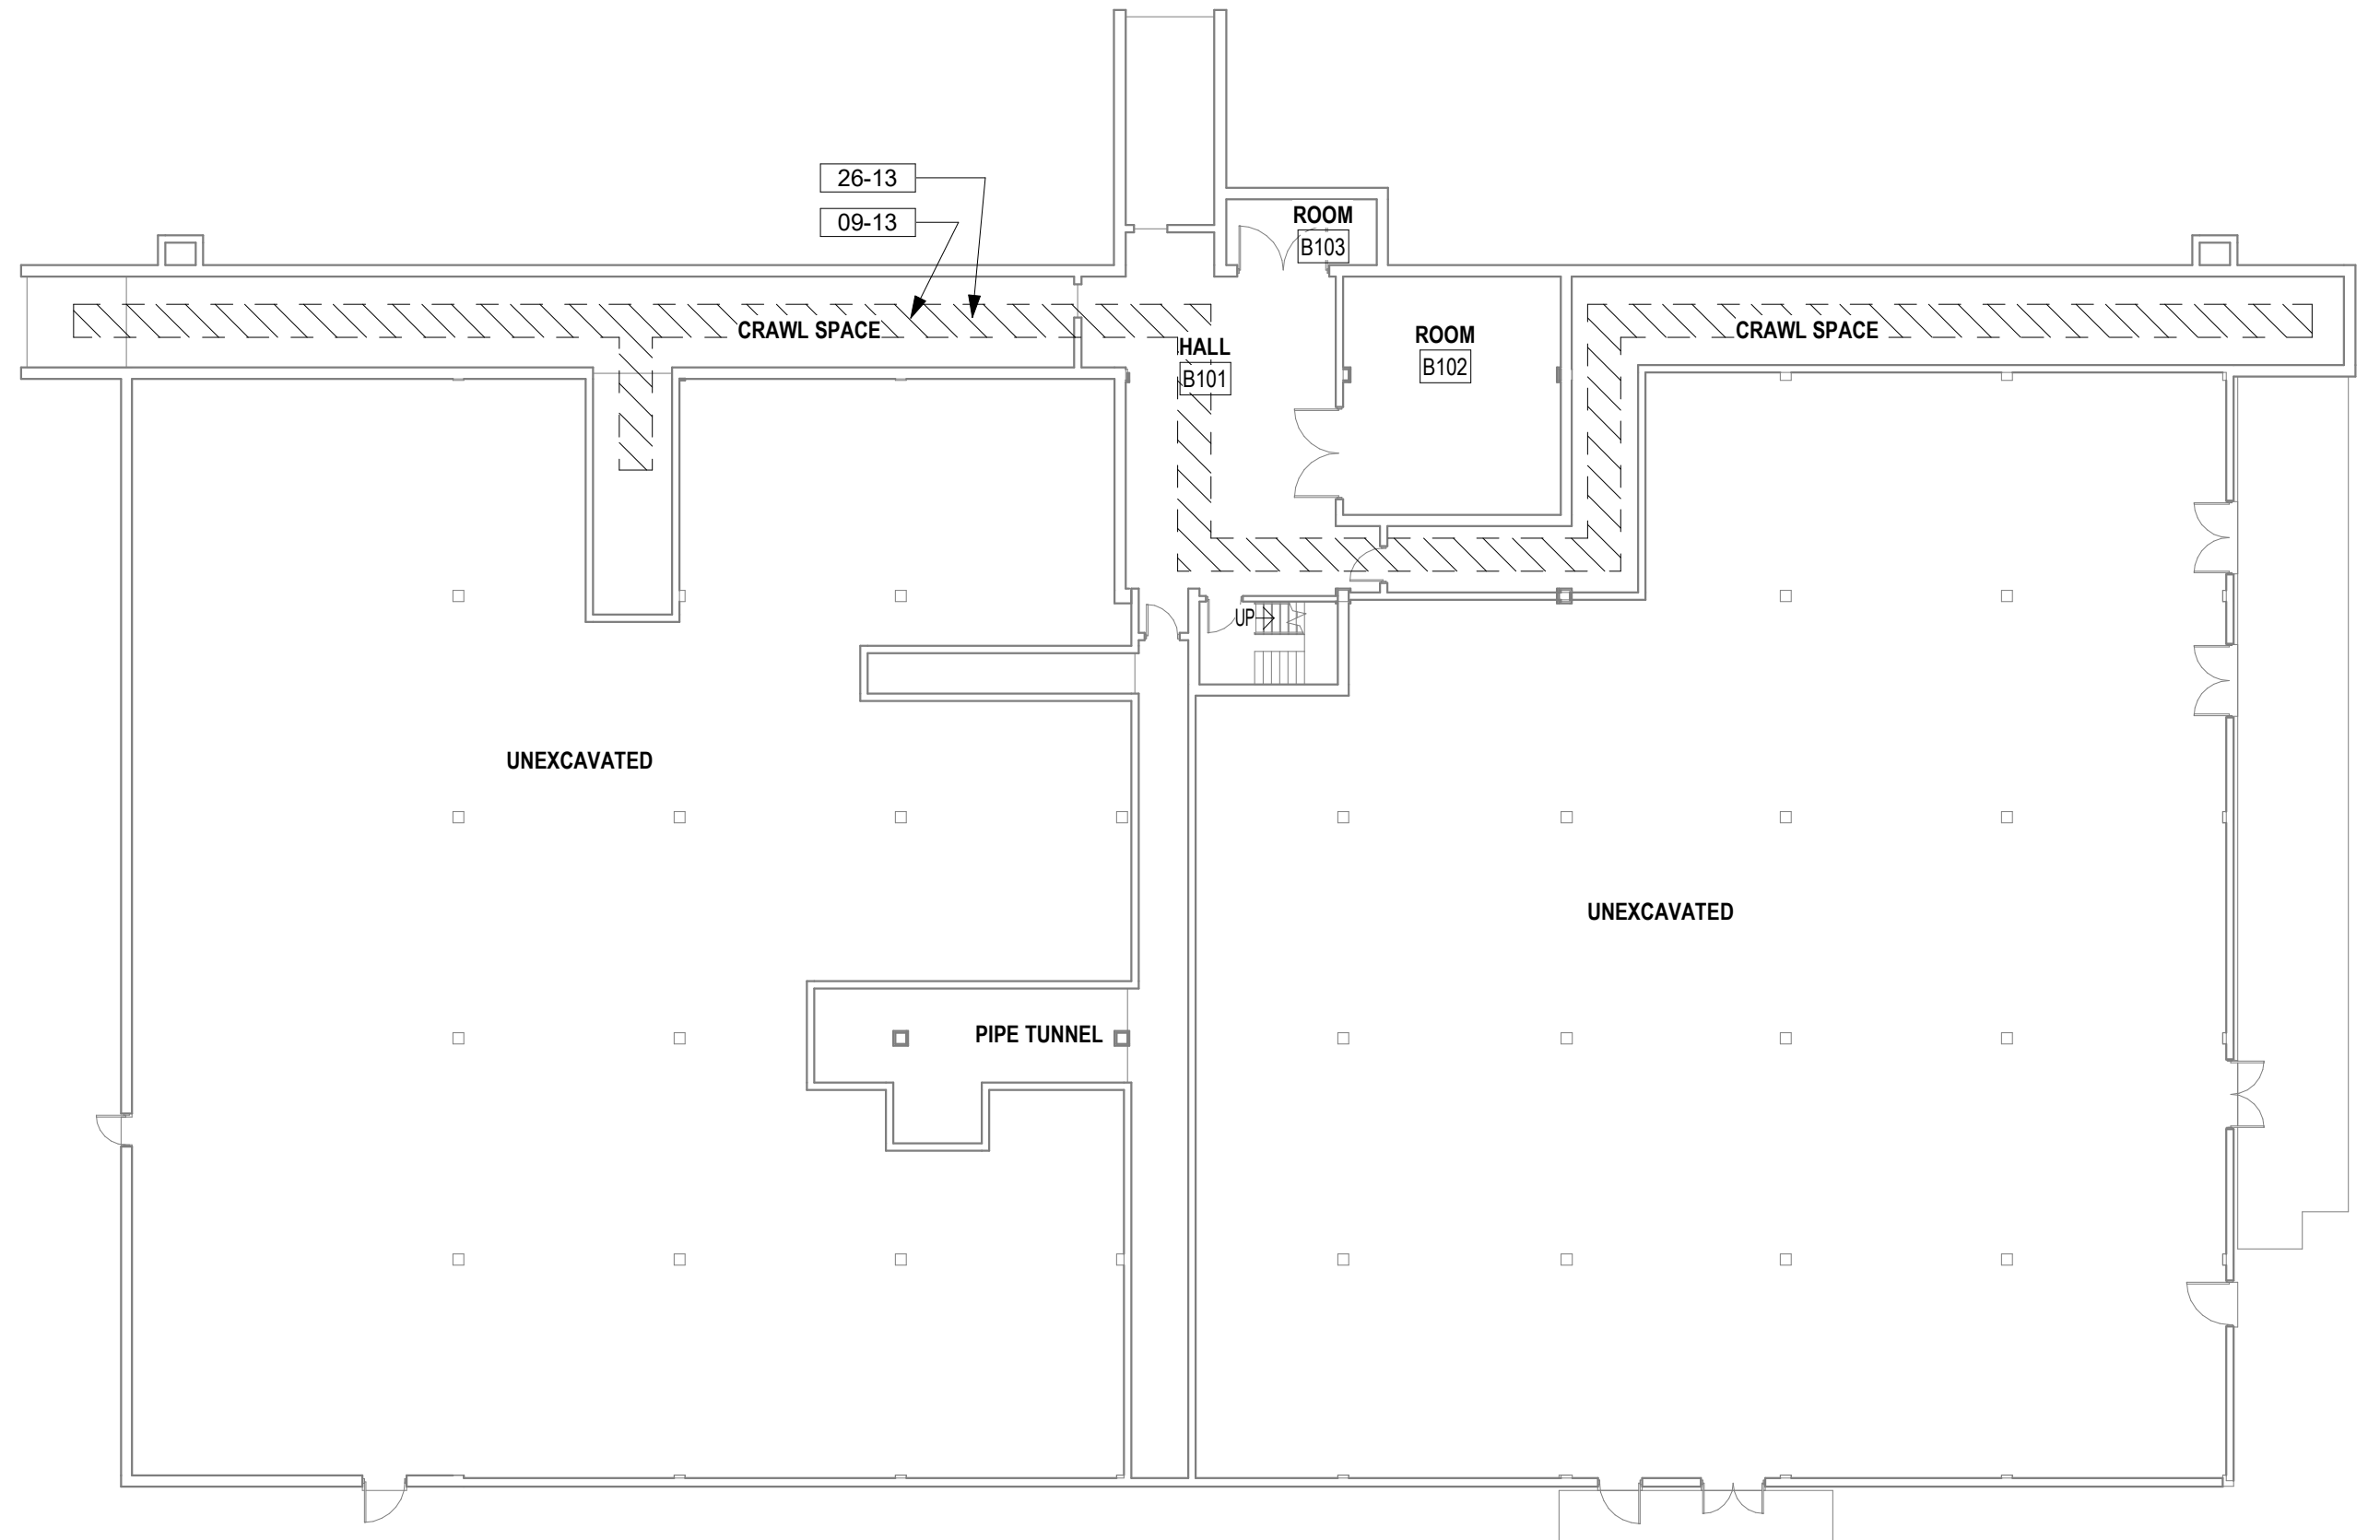
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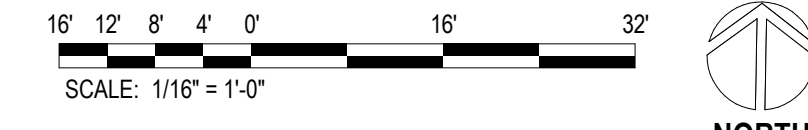
1 146 - LEVEL 2 FLOOR PLAN
1/16" = 1'-0"



3 146 - LEVEL 1 FLOOR PLAN
1/16" = 1'-0"

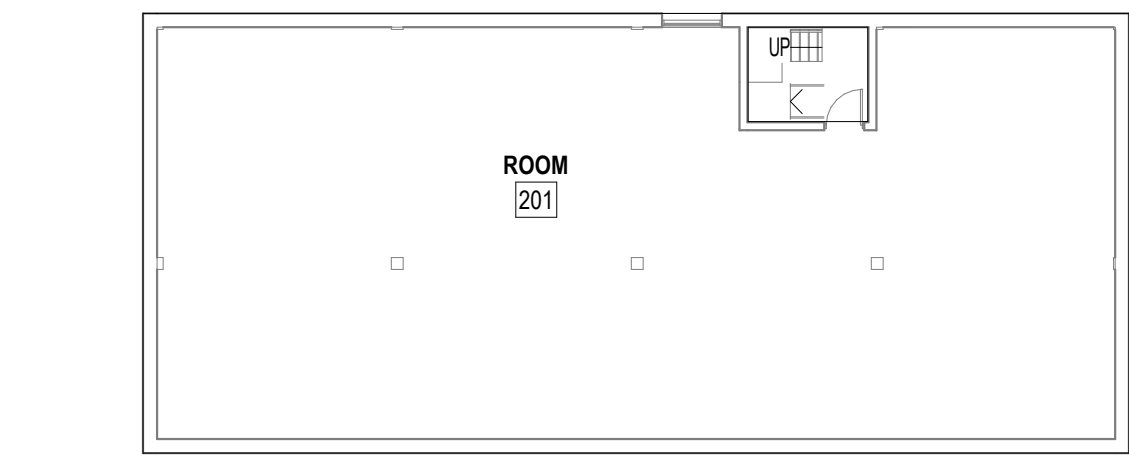

2 146 - BASEMENT FLOOR PLAN
1/16" = 1'-0"

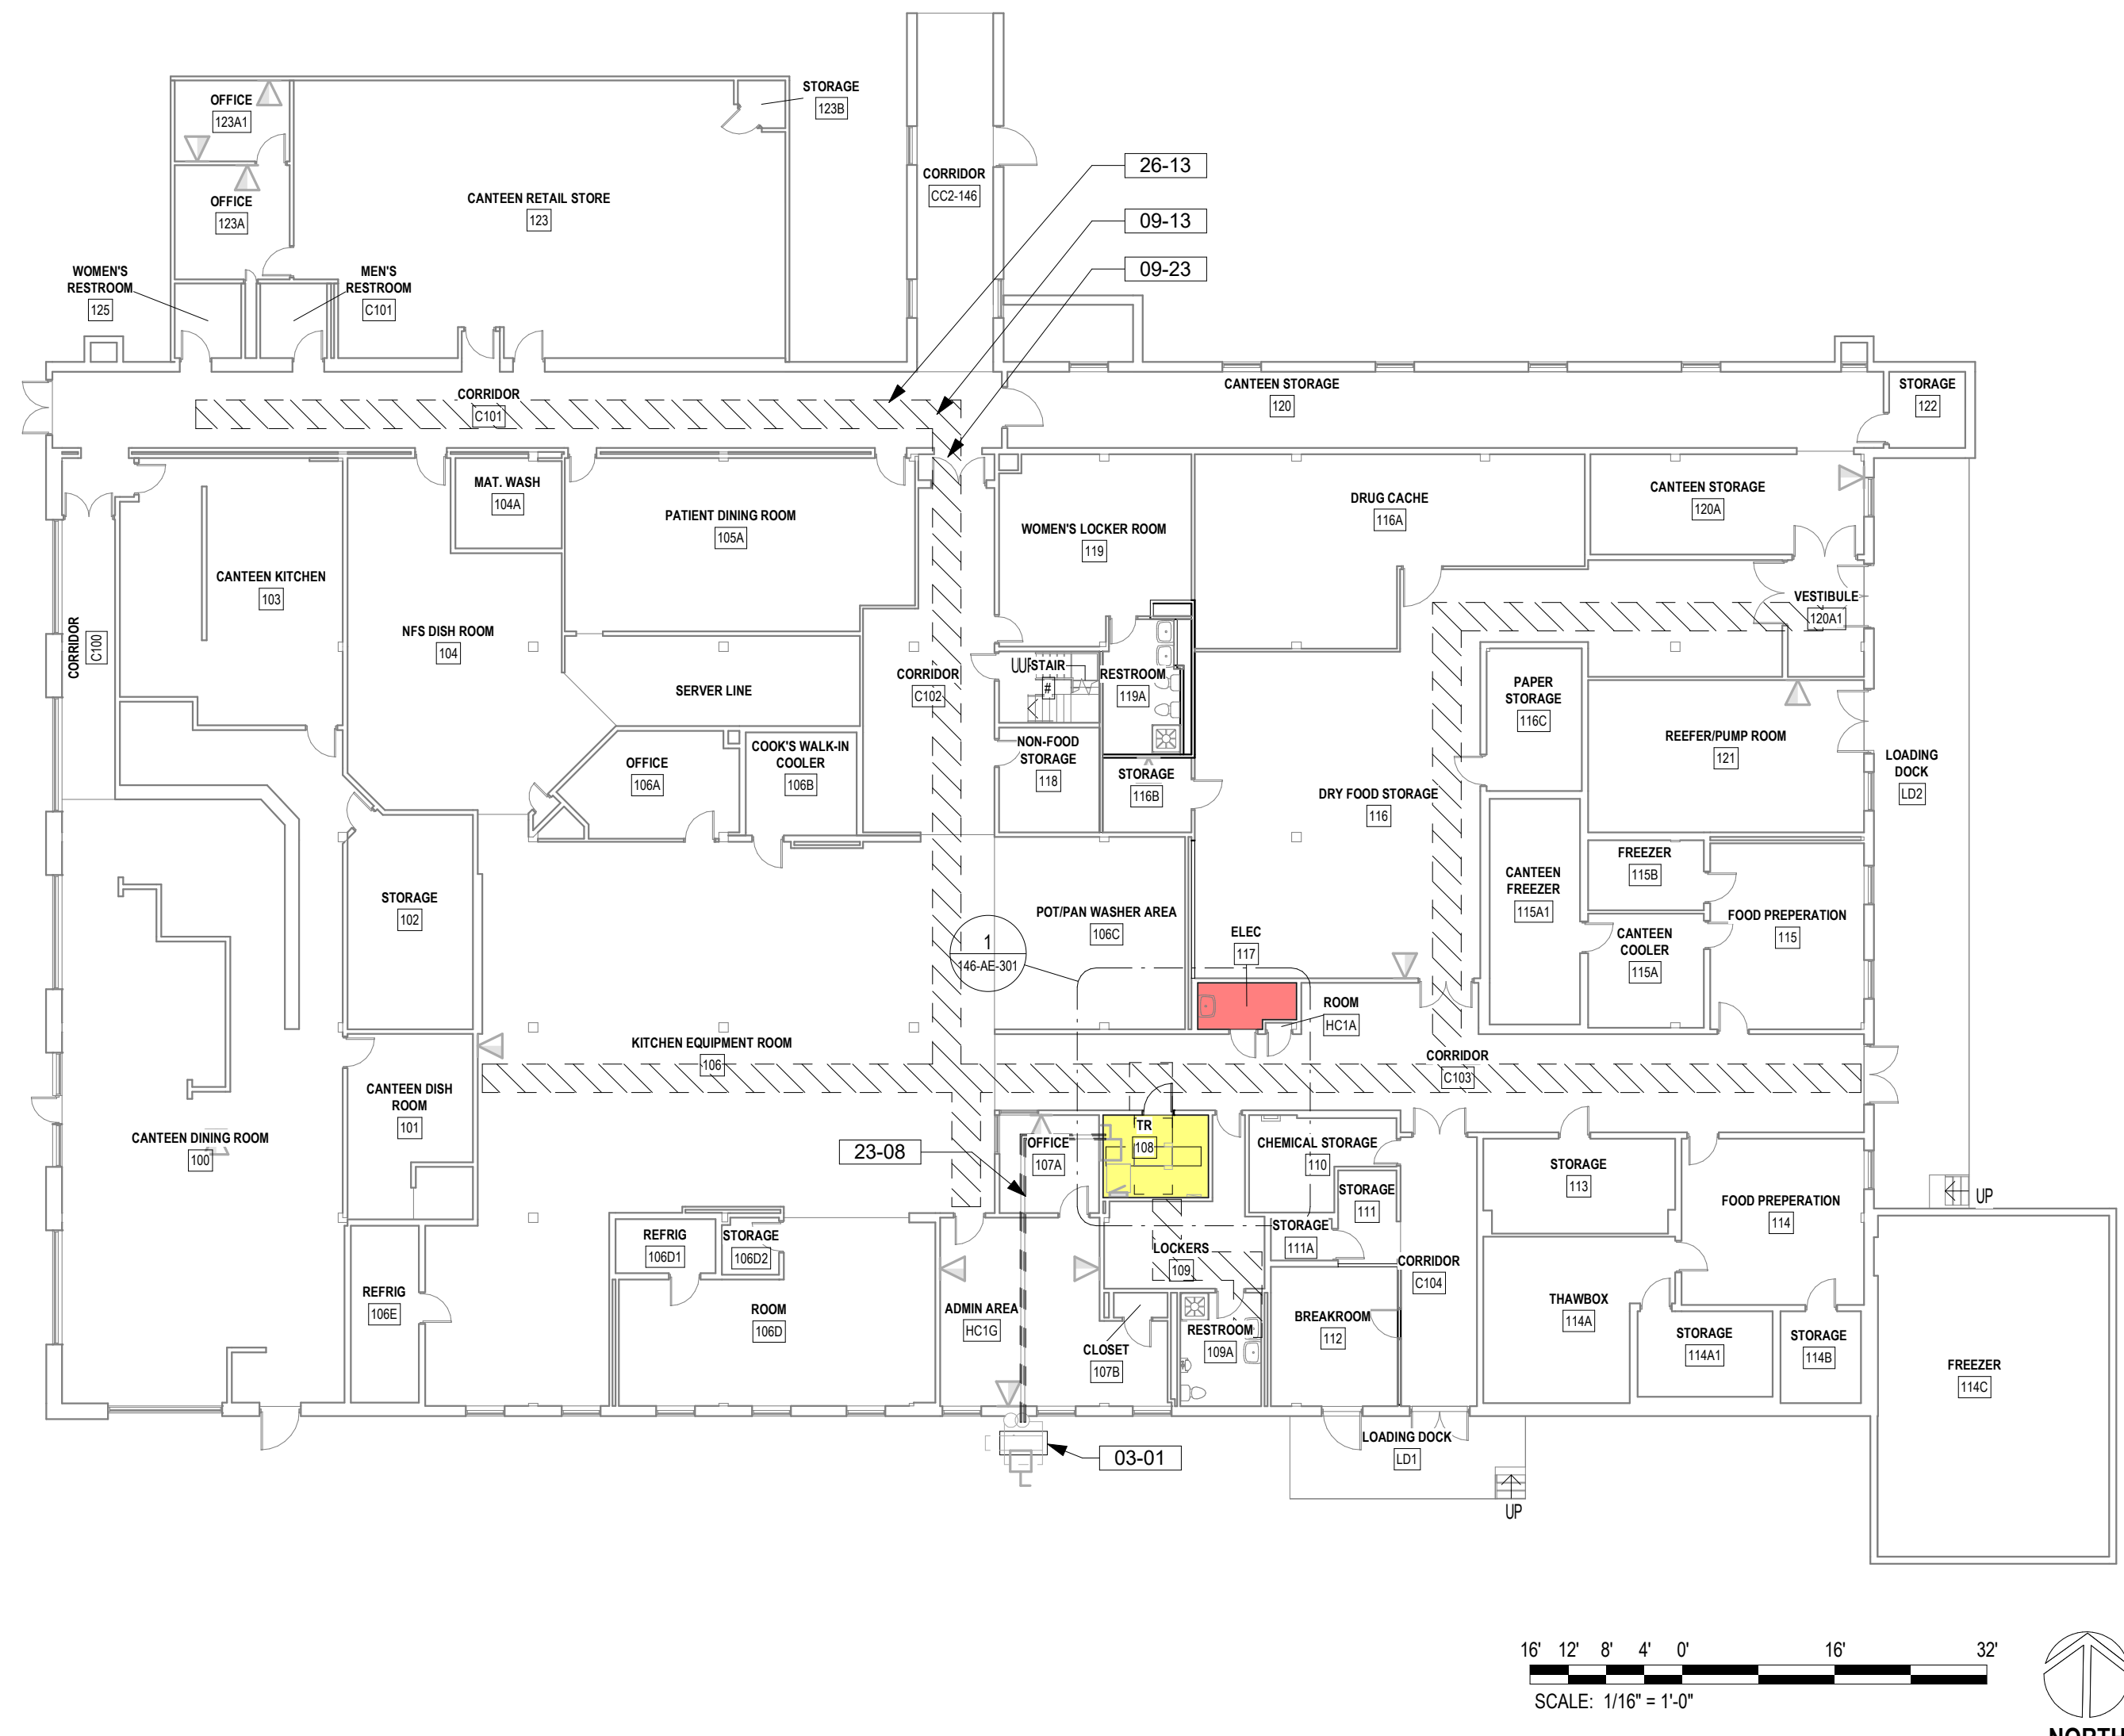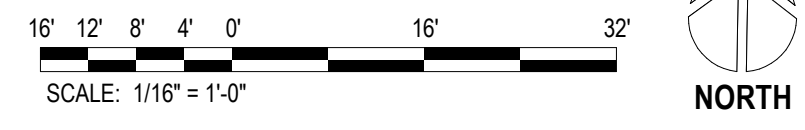

CONSULTANT

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541.436.4723
ADAM GODDIN, PE




ARCHITECT/ENGINEER OF RECORD

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STAMP



PROGRAM CONTRACTING ACTIVITY CENTRAL (PCAC)

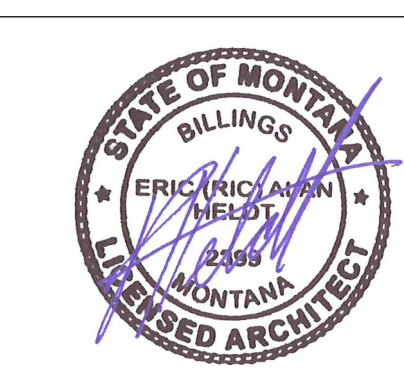VA U.S. Department of Veterans Affairs

DRAWING TITLE
146-FLOOR PLANS

APPROVED: Project Director

PHASE
100% CONSTRUCTION DOCUMENTS

FLS
FULLY SPRINKLERED

PROJECT TITLE
EHRM INFRASTRUCTURE UPGRADES

LOCATION
FORT MEADE, SOUTH DAKOTA

ISSUE DATE
04/15/2022

CHECKED BY
TMP

DRAWN BY
JPR

PROJECT NUMBER
568-21-701

BUILDING NUMBER
BLDG 146

DRAWING NUMBER
146-AE-201

Revisions:	Date:

FLOOR PLAN NOTES

- SEE G SERIES SHEETS FOR BALANCE OF FLOOR PLAN GENERAL NOTES.
- REFER TO STRUCTURAL, MECHANICAL, AND ELECTRICAL DRAWINGS FOR ADDITIONAL INFORMATION. ALL INFORMATION REGARDING EXISTING CONDITIONS IS BASED UPON OWNER-SUPPLIED DOCUMENTS AND MAY NOT PRECISELY REFLECT FIELD CONDITIONS.
- PROVIDE ALL BACKING FOR MILLWORK, GRAB BARS, AND ANY AND ALL WALL MOUNTED EQUIPMENT OR ACCESSORIES; COORDINATE LOCATIONS.
- ALL DIMENSIONS ARE FROM STRUCTURAL OR UNFINISHED FACE OF STUD, UNLESS OTHERWISE NOTED.
- PROVIDE A SMOOTH AND LEVEL FINISH FLOOR, TYP. PATCH AND REPAIR ALL INCONSISTENCIES IN FLOOR ELEVATIONS.
- PATCH AND REPAIR ANY / ALL WALL SURFACES AS REQUIRED TO PROVIDE SUITABLE SUBSTRATE FOR FINISHES.
- REFER TO DOOR AND FRAME SCHEDULE FOR DOORS REQUIRING ADA ACCESS CONTROL.
- PROVIDE ACOUSTICAL SEALANT AROUND WALL EDGES, TOP AND BOTTOM, AND PENETRATIONS, AND INSTALL PUTTY PADS AROUND ELECTRICAL BOXES WHERE PARTITION CONTAINS ACOUSTICAL INSULATION.
- ALL TELECOMMUNICATION ROOMS ARE TO HAVE EXPOSED STRUCTURE UNLESS NOTED OTHERWISE, NO CEILINGS SPECIFIED.

KEY NOTES

- 06-01 INSTALL 3/4" AC GRADE OR BETTER FIRE RETARDANT PLYWOOD, PAINT WITH TWO COATS OF SEMI-GLOSS BRIGHT WHITE FIRE RETARDANT PAINT; MOUNT BOTTOM OF PLYWOOD 6" A.F.F., TOP OF PLYWOOD AT 8'-6" A.F.F.
- 09-01 PAINT WALL ABOVE PLYWOOD WITH SEMI-GLOSS PAINT, COLOR TO MATCH PLYWOOD PAINT.
- 09-07 INSTALL STATIC DISSIPATIVE RESILIENT FLOORING
- 09-10 PAINT FULL LENGTH OF WALL TO NEAREST EXTERIOR OR INTERIOR CORNER, COLOR TO MATCH EXISTING WALLS.
- 09-18 6" HIGH COVERED RUBBER WALL BASE, COLOR TO BE SELECTED FROM MANUFACTURER'S STANDARD SELECTION
- 09-19 EXTEND GYPSUM BOARD WALL TO UNDERSIDE OF STRUCTURE WITH 5/8" GYPSUM BOARD LAYER ON EACH SIDE OF WALL, SEAL
- 09-25 PATCH AND REPAIR ANY GYPSUM BOARD OPENINGS FOUND AT PERIMETER OF WALL, SEAL PERIMETER OF ROOM IN ITS ENTIRETY, PAINT
- 22-02 UPRIGHT HEAD FIRE SUPPRESSION SPRINKLER HEAD SHOWN FOR REFERENCE ONLY; FIRE SUPPRESSION CONTRACTOR TO VERIFY ACTUAL QUANTITIES REQUIRED; COORDINATE INSTALLATION WITH MEPT DRAWINGS
- 23-08 NEW REFRIGERANT PIPE LINES ROUTING SHOWN FOR REFERENCE ONLY; SEE MECHANICAL DRAWINGS FOR ACTUAL ROUTING; CONTRACTOR TO REMOVE CEILING TILES ALONG ROUTE OUTSIDE OF TRS AND REPLACE WITHIN WORKING SHIFT. CONDUCT INSPECTION PREVENTION MEASURES AS SPECIFIED.
- 26-02 3" PERIMETER CLEARANCE AROUND SERVER RACK SHOWN DASHED
- 26-03 TELECOMM RACK, SEE TELECOMMUNICATION DRAWINGS
- 26-04 ELECTRICAL PANELS, SEE ELECTRICAL DRAWINGS
- 26-05 CABLE TRAY, SEE TELECOMMUNICATION DRAWINGS
- 26-11 STROBE LIGHT, SEE ELECTRICAL DRAWINGS
- 26-12 ELECTRICAL OUTLETS MOUNTED ON PLYWOOD

REFLECTED CEILING PLAN NOTES

- REFER TO ELECTRICAL SHEETS FOR FIXTURE TYPES, SWITCHING, AND SPECIAL SYSTEMS.
- REFER TO MECHANICAL SHEETS FOR DIFFUSER AND DUCTING LAYOUTS.



REFLECTED CEILING PLAN LEGEND

- 2x2 LIGHT FIXTURE
- 2x4 LIGHT FIXTURE
- STRIP LIGHT FIXTURE
- 6" RECESSED CAN LIGHT FIXTURE
- SUPPLY AIR DIFFUSER
- RETURN AIR VENT
- EXHAUST FAN
- 5/8" GYP. BOARD CEILING AFFIXED TO 3 5/8" MTL STUDS
- 2'x2' SUSPENDED ACOUSTIC CEILING TILE CEILING
- 2'x4' SUSPENDED ACOUSTIC CEILING TILE CEILING


FLOOR PLAN LEGEND

- CARD READER, REF TELECOM DRAWINGS
- DATA PORT, REF TELECOM DRAWINGS
- OUTLET, REF ELEC DRAWINGS
- WIRELESS ACCESS POINT, REF TELECOM DRAWINGS
- ELEC PANEL, REF ELEC DRAWINGS
- STRIP LIGHT FIXTURE, REF ELEC DRAWINGS


PROJECT KEY PLAN

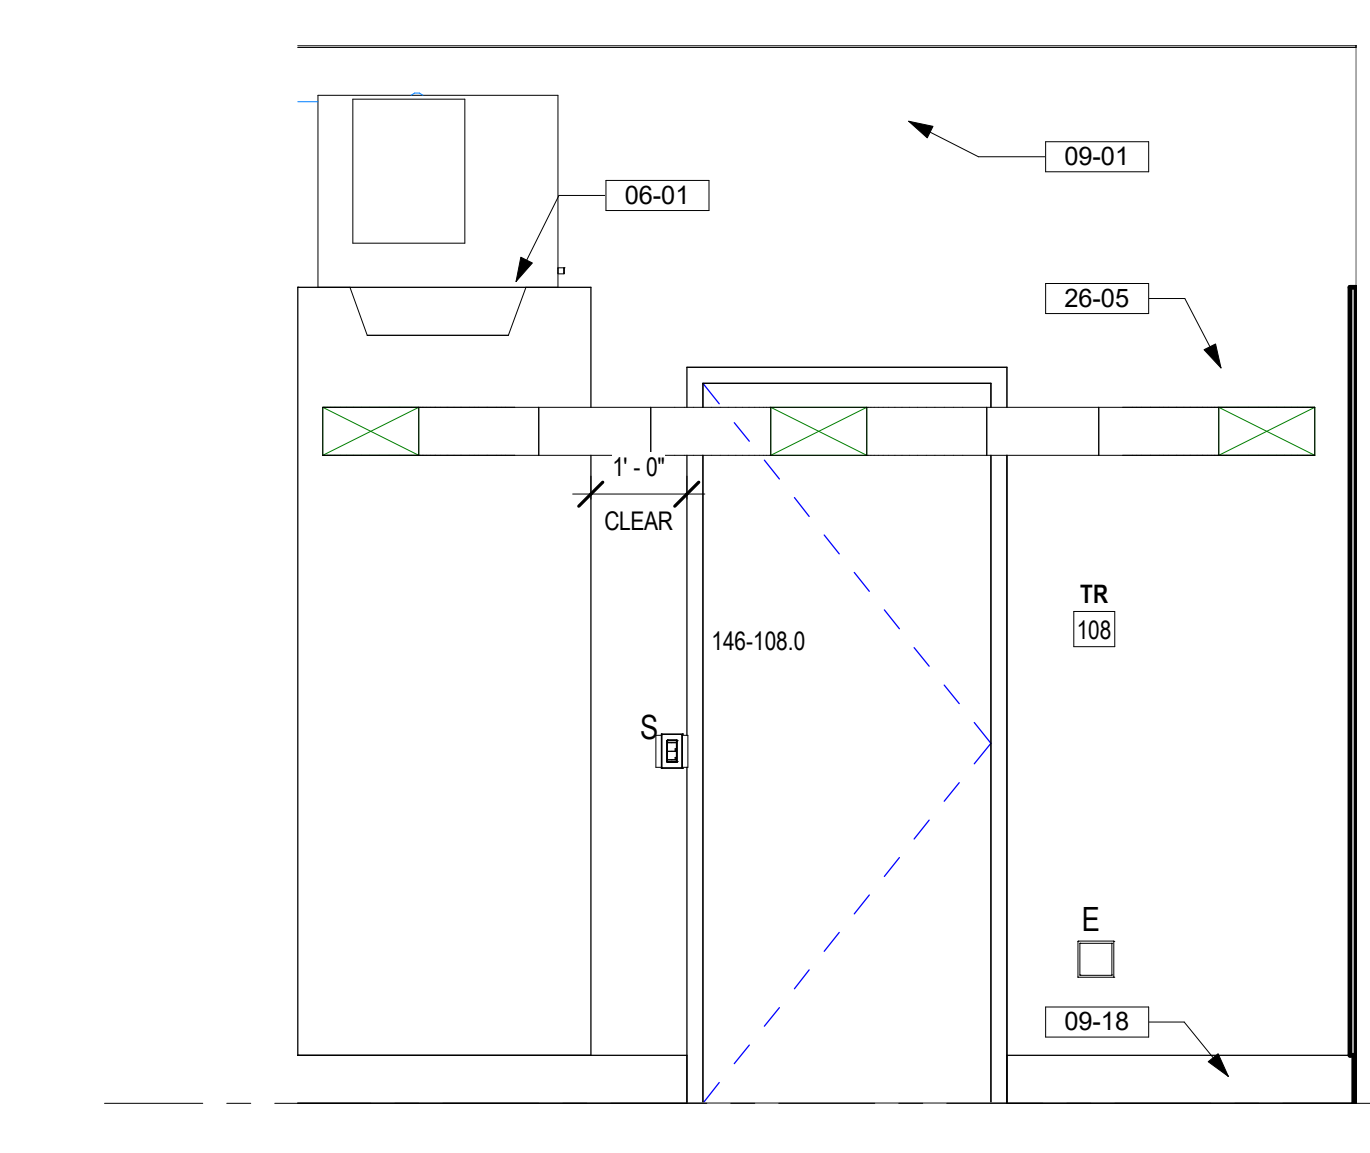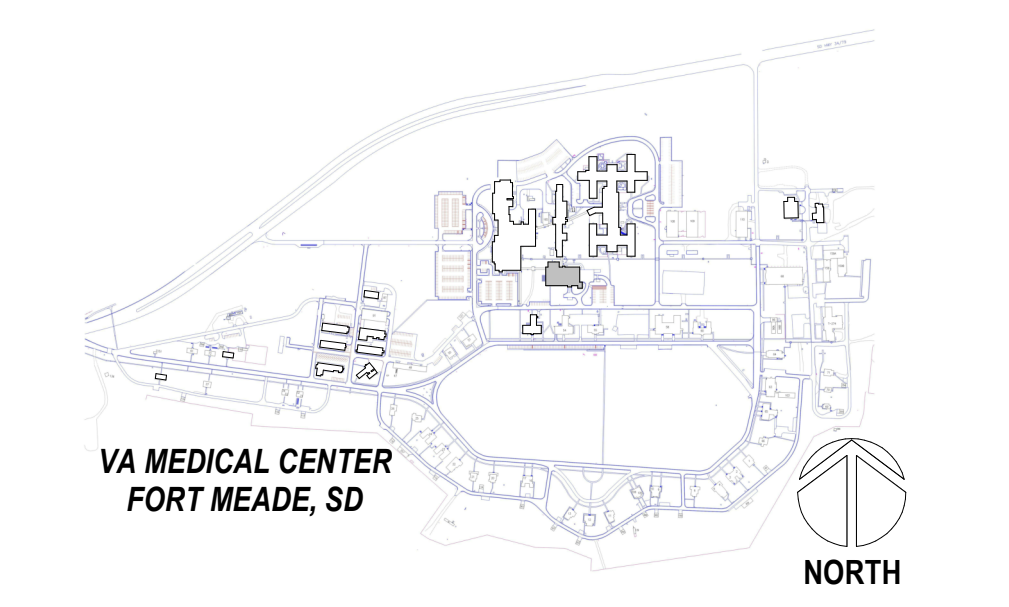


2 146 - 108 TR NORTH ELEVATION
1/2" = 1'-0"

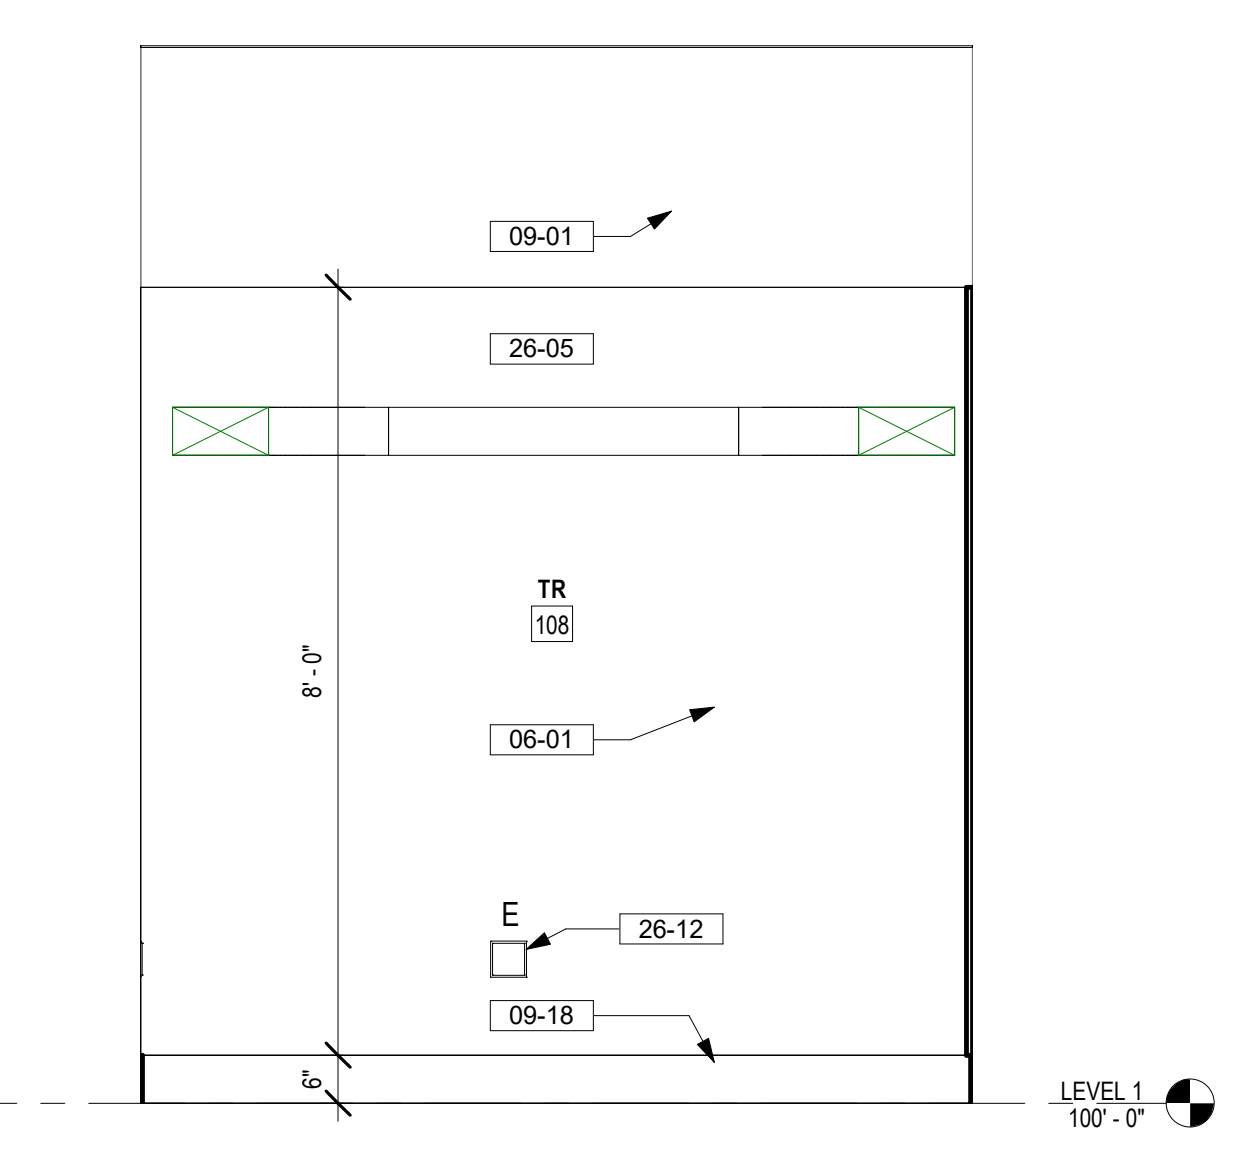


3 146 - 108 TR EAST ELEVATION
1/2" = 1'-0"

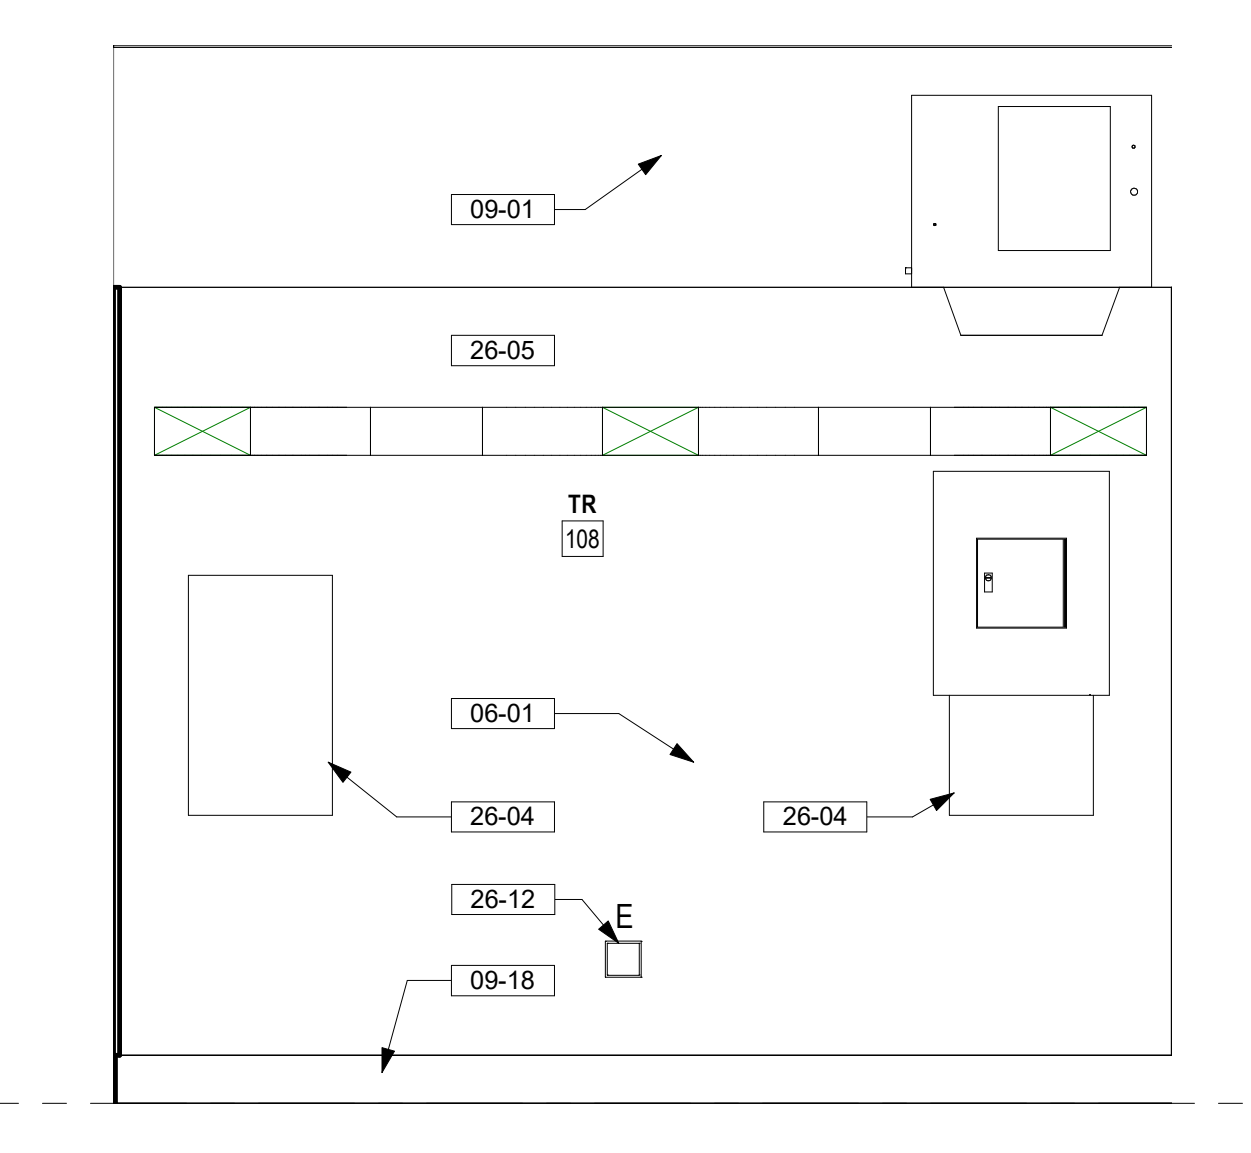


5 146 - 108 TR SOUTH ELEVATION
1/2" = 1'-0"

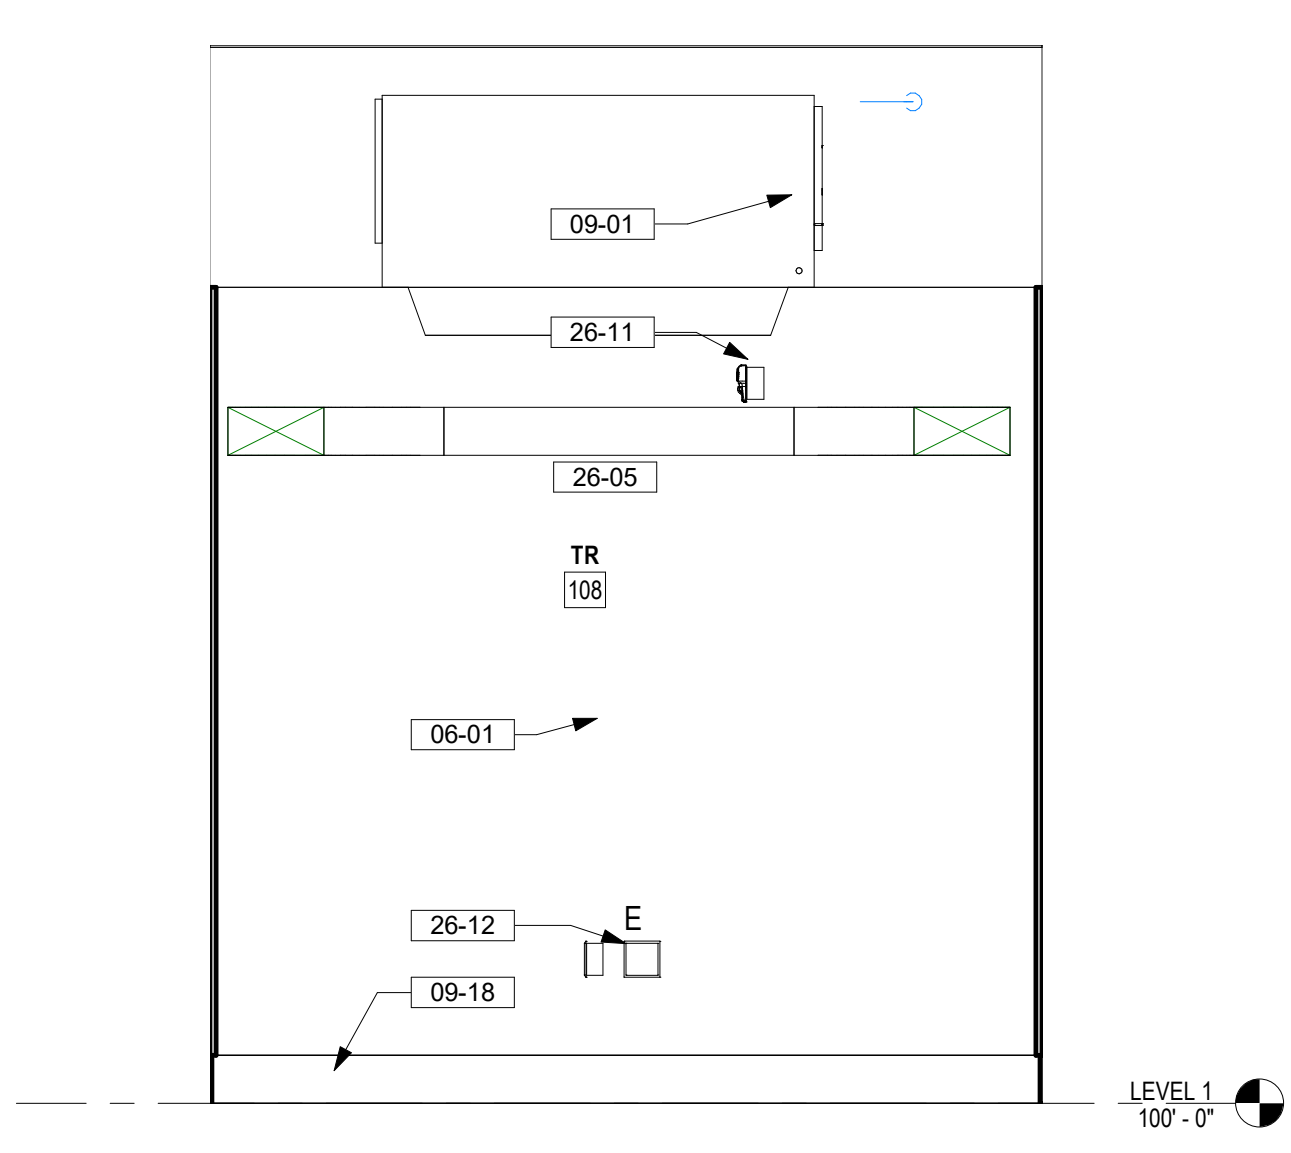

6 146 - 108 TR WEST ELEVATION
1/2" = 1'-0"

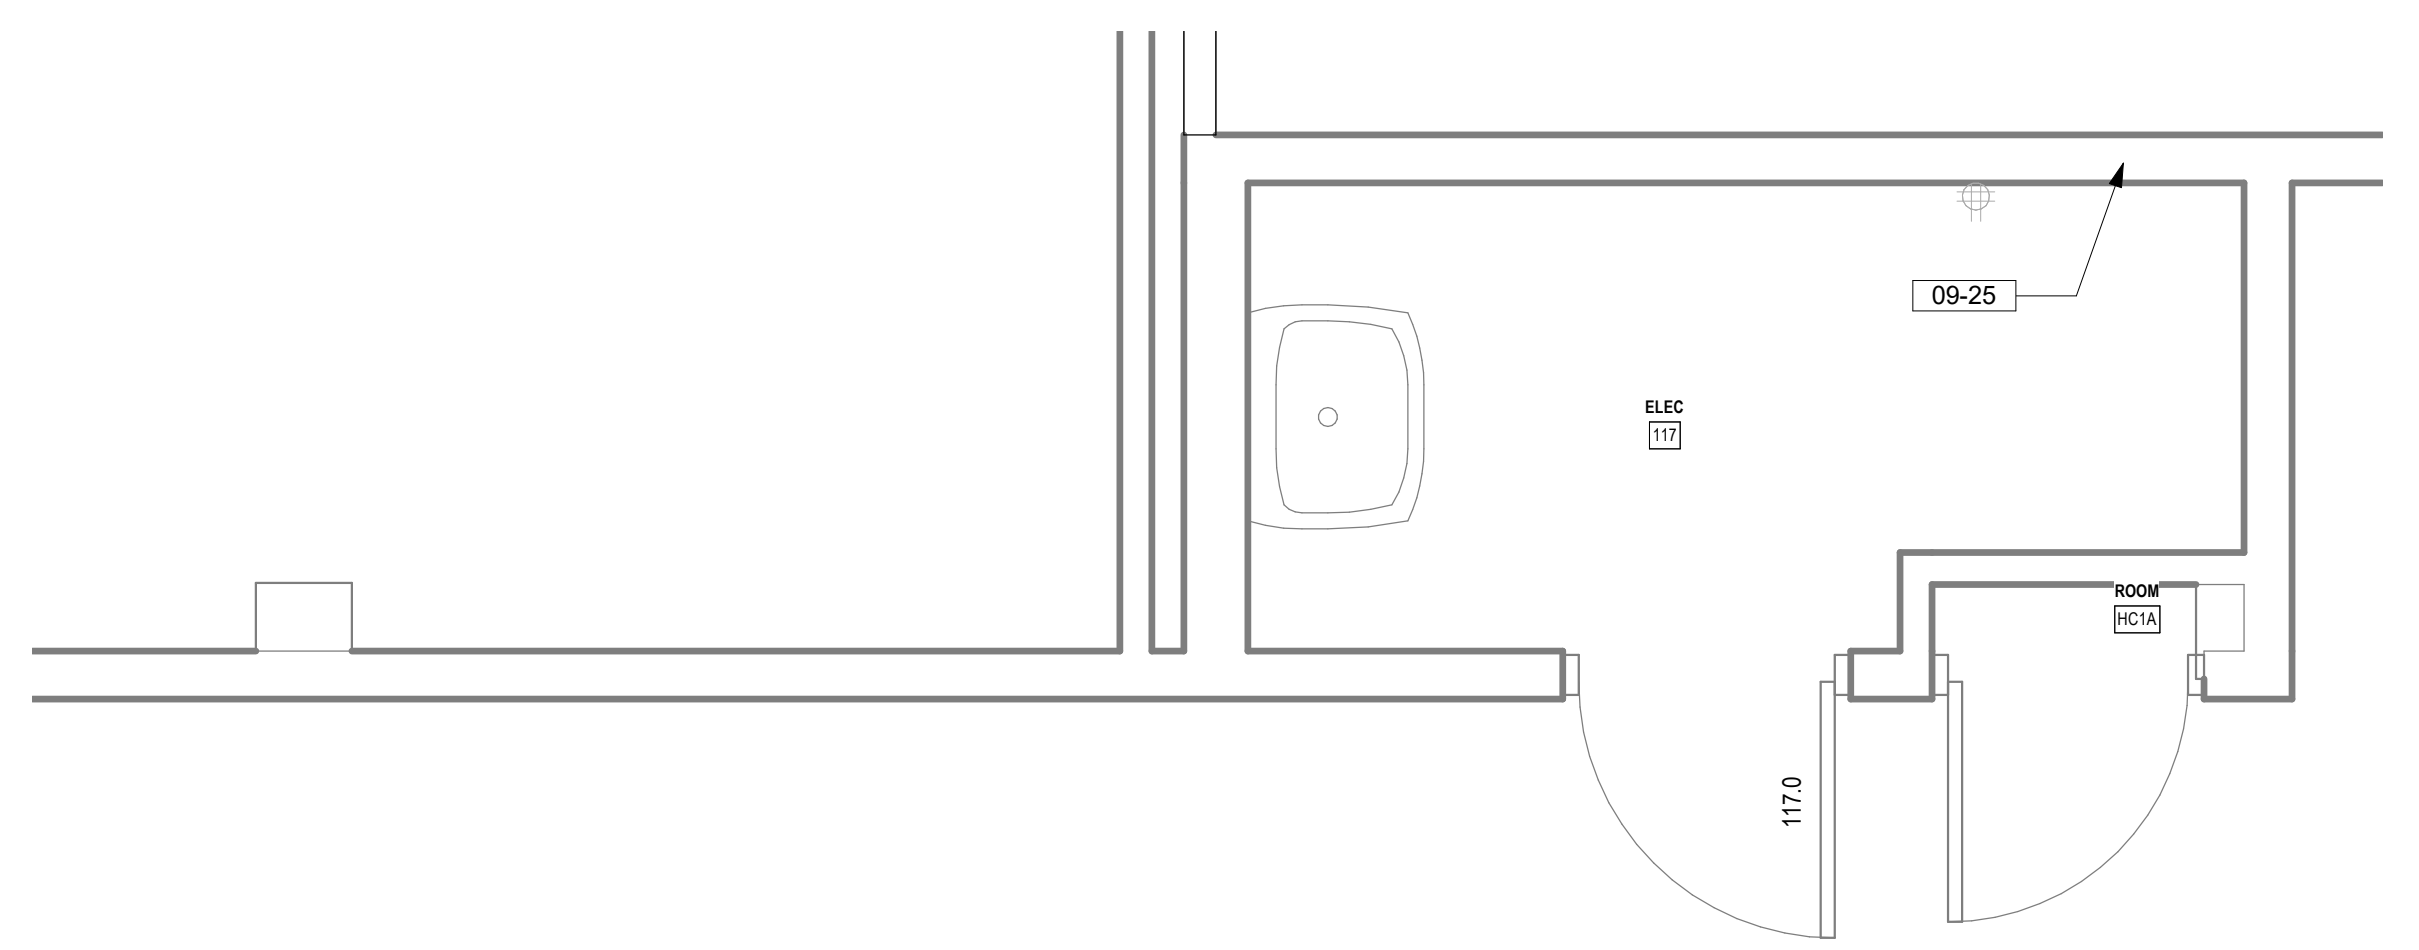

1 146 - 108 ENLARGED PLAN
1/2" = 1'-0"

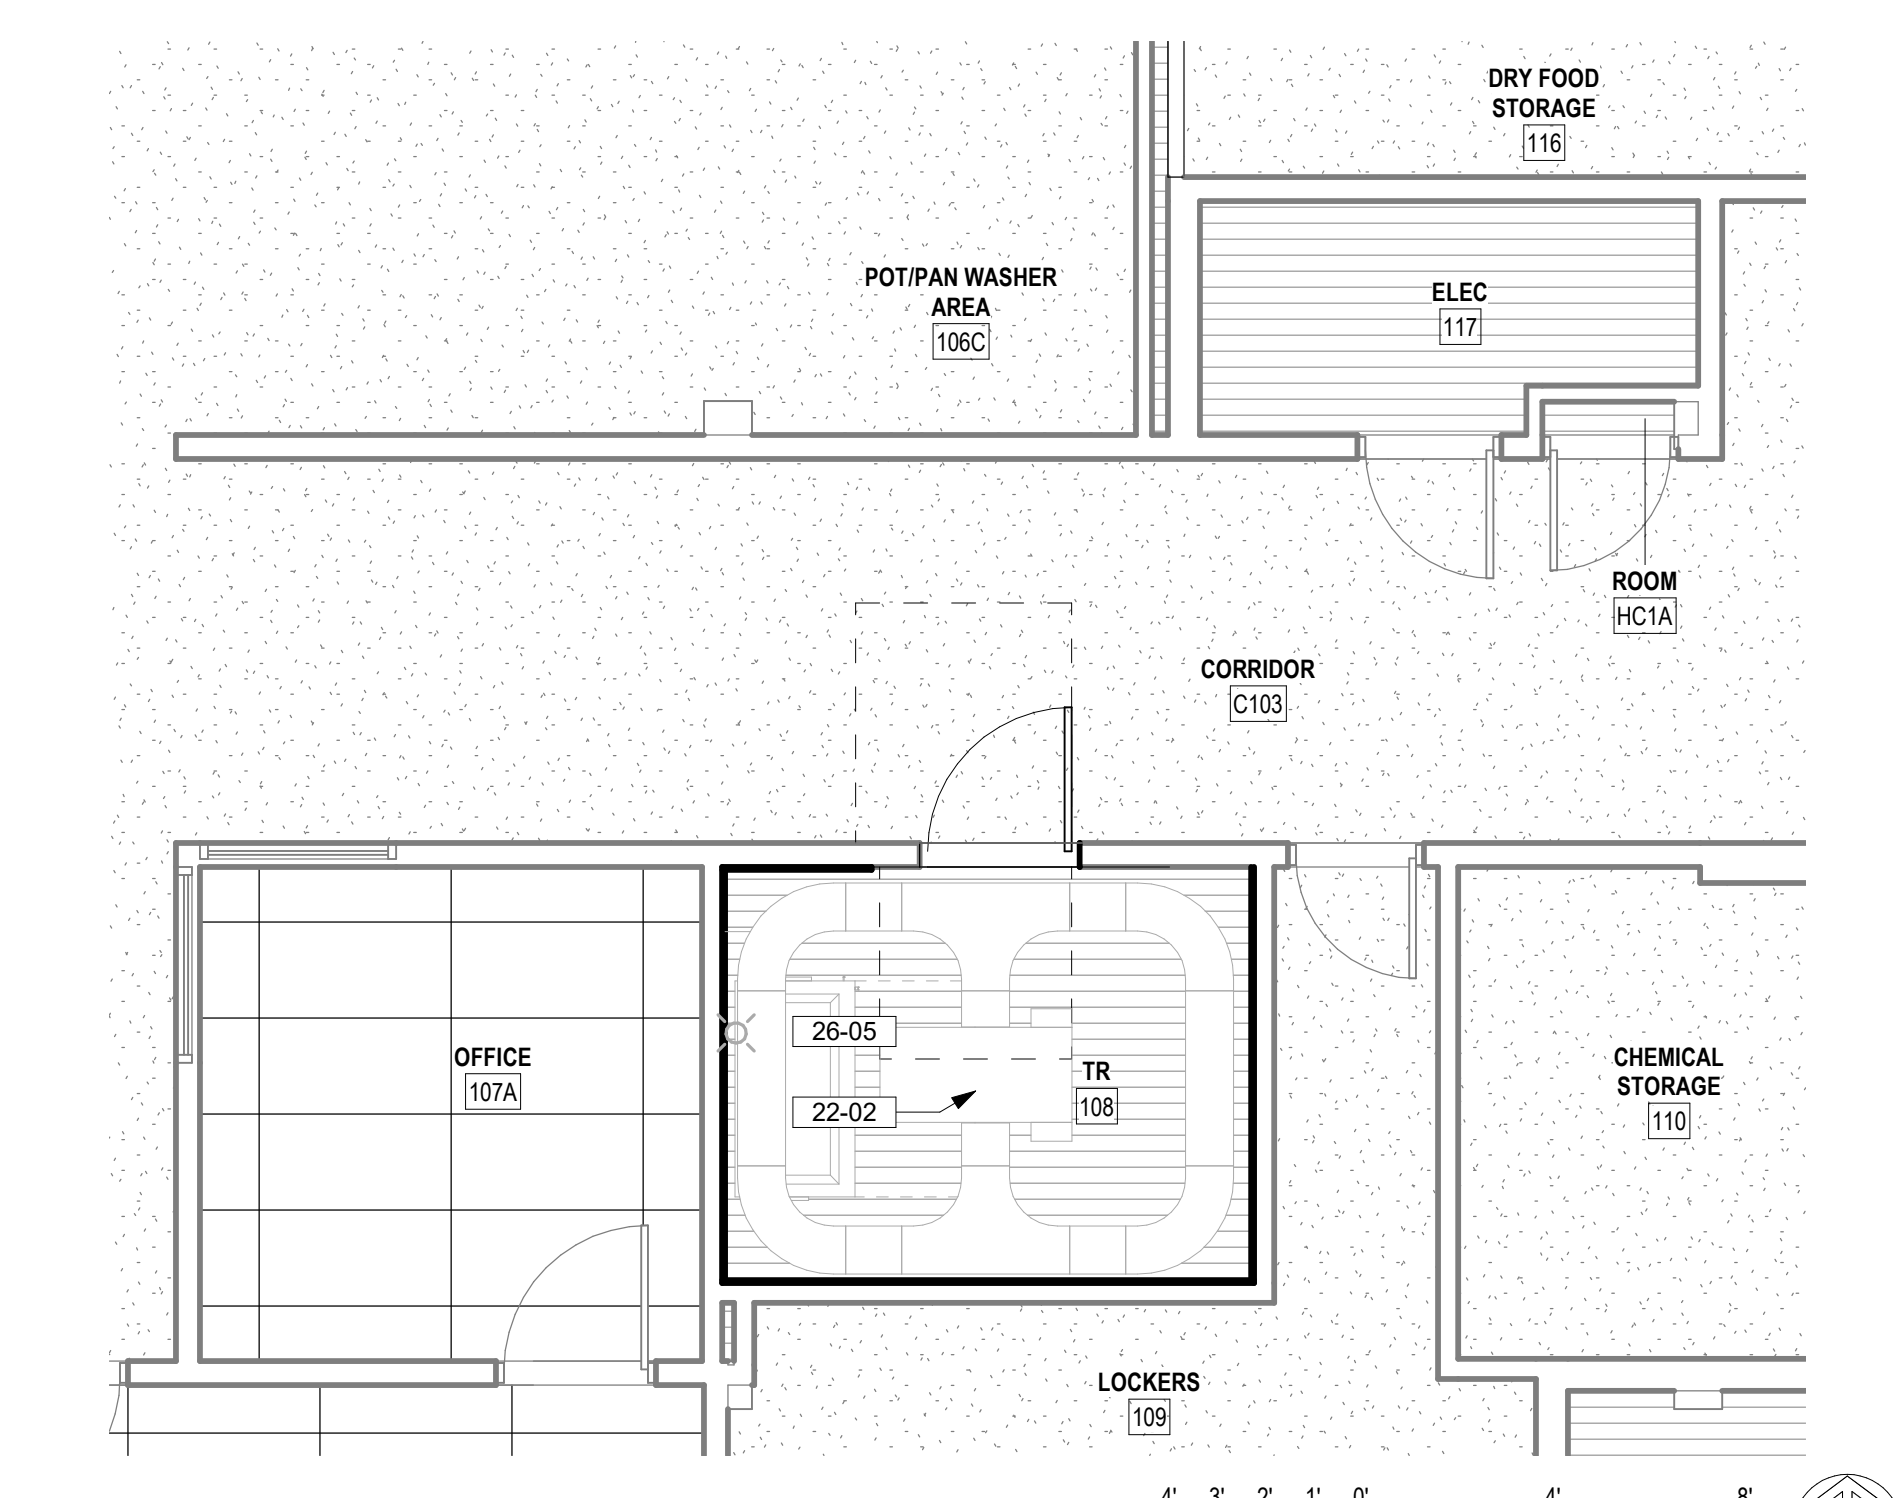

4 146 - 108 ENLARGED CEILING PLAN
1/4" = 1'-0"

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Revisions:	Date:

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PROGRAM CONTRACTING ACTIVITY CENTRAL (PCAC)

VA U.S. Department of Veterans Affairs

DRAWING TITLE
146-ENLARGED PLANS AND ELEVATIONS

APPROVED: Project Director

PHASE
100% CONSTRUCTION DOCUMENTS

FLS
FULLY SPRINKLERED

PROJECT TITLE EHRM INFRASTRUCTURE UPGRADES		PROJECT NUMBER 568-21-701	
LOCATION FORT MEADE, SOUTH DAKOTA		BUILDING NUMBER BLDG 146	
ISSUE DATE 04/15/2022	CHECKED BY TMP	DRAWN BY JPR	DRAWING NUMBER 146-AE-301



KEYNOTES

- 02-31 SEE TELECOM PLANS FOR PATH LOCATION. PREP CEILING FOR SURFACE MOUNT CONDUIT IN LOCATIONS W/O ACOUSTIC CEILING TILES
- 03-01 NEW HOUSEKEEPING PAD. COORDINATE WITH MECHANICAL DRAWINGS FOR SIZE AND CIVIL DRAWINGS FOR DETAILS
- 09-13 FOLLOW EXISTING CABLE ROUTING FOR REMOVAL OF EXISTING CABLE AND INSTALLATION OF NEW CABLES AT LOCATIONS AS NOTED IN TELECOM DRAWINGS
- 09-23 RE-INSTALL STORED FLOOR TILES, REPLACE MISSING OR DAMAGED TILES TO MATCH EXISTING
- 23-08 NEW REFRIGERANT PIPE LINES ROUTING SHOWN FOR REFERENCE ONLY. SEE MECHANICAL DRAWINGS FOR ACTUAL ROUTING. CONTRACTOR TO REMOVE CEILING TILES ALONG ROUTE OUTSIDE OF TR'S AND REPLACE WITHIN WORKING SHIFT. CONDUCT INFECTION PREVENTION MEASURES AS SPECIFIED.
- 26-13

ROOM ALLOCATION LEGEND


- PROPOSED NEW CABINET / TR / MCR LOCATION
- PROPOSED EXPANSION TO TR
- EXISTING TR WITH POWER AND FIBER UPGRADES, SEE TELECOM AND ELECTRICAL DRAWINGS
- ABANDONED ROOM
- ROOM TO REMAIN, NO WORK
- REMODEL REQUIRED DUE TO EHRM IMPACT

PROJECT KEY PLAN

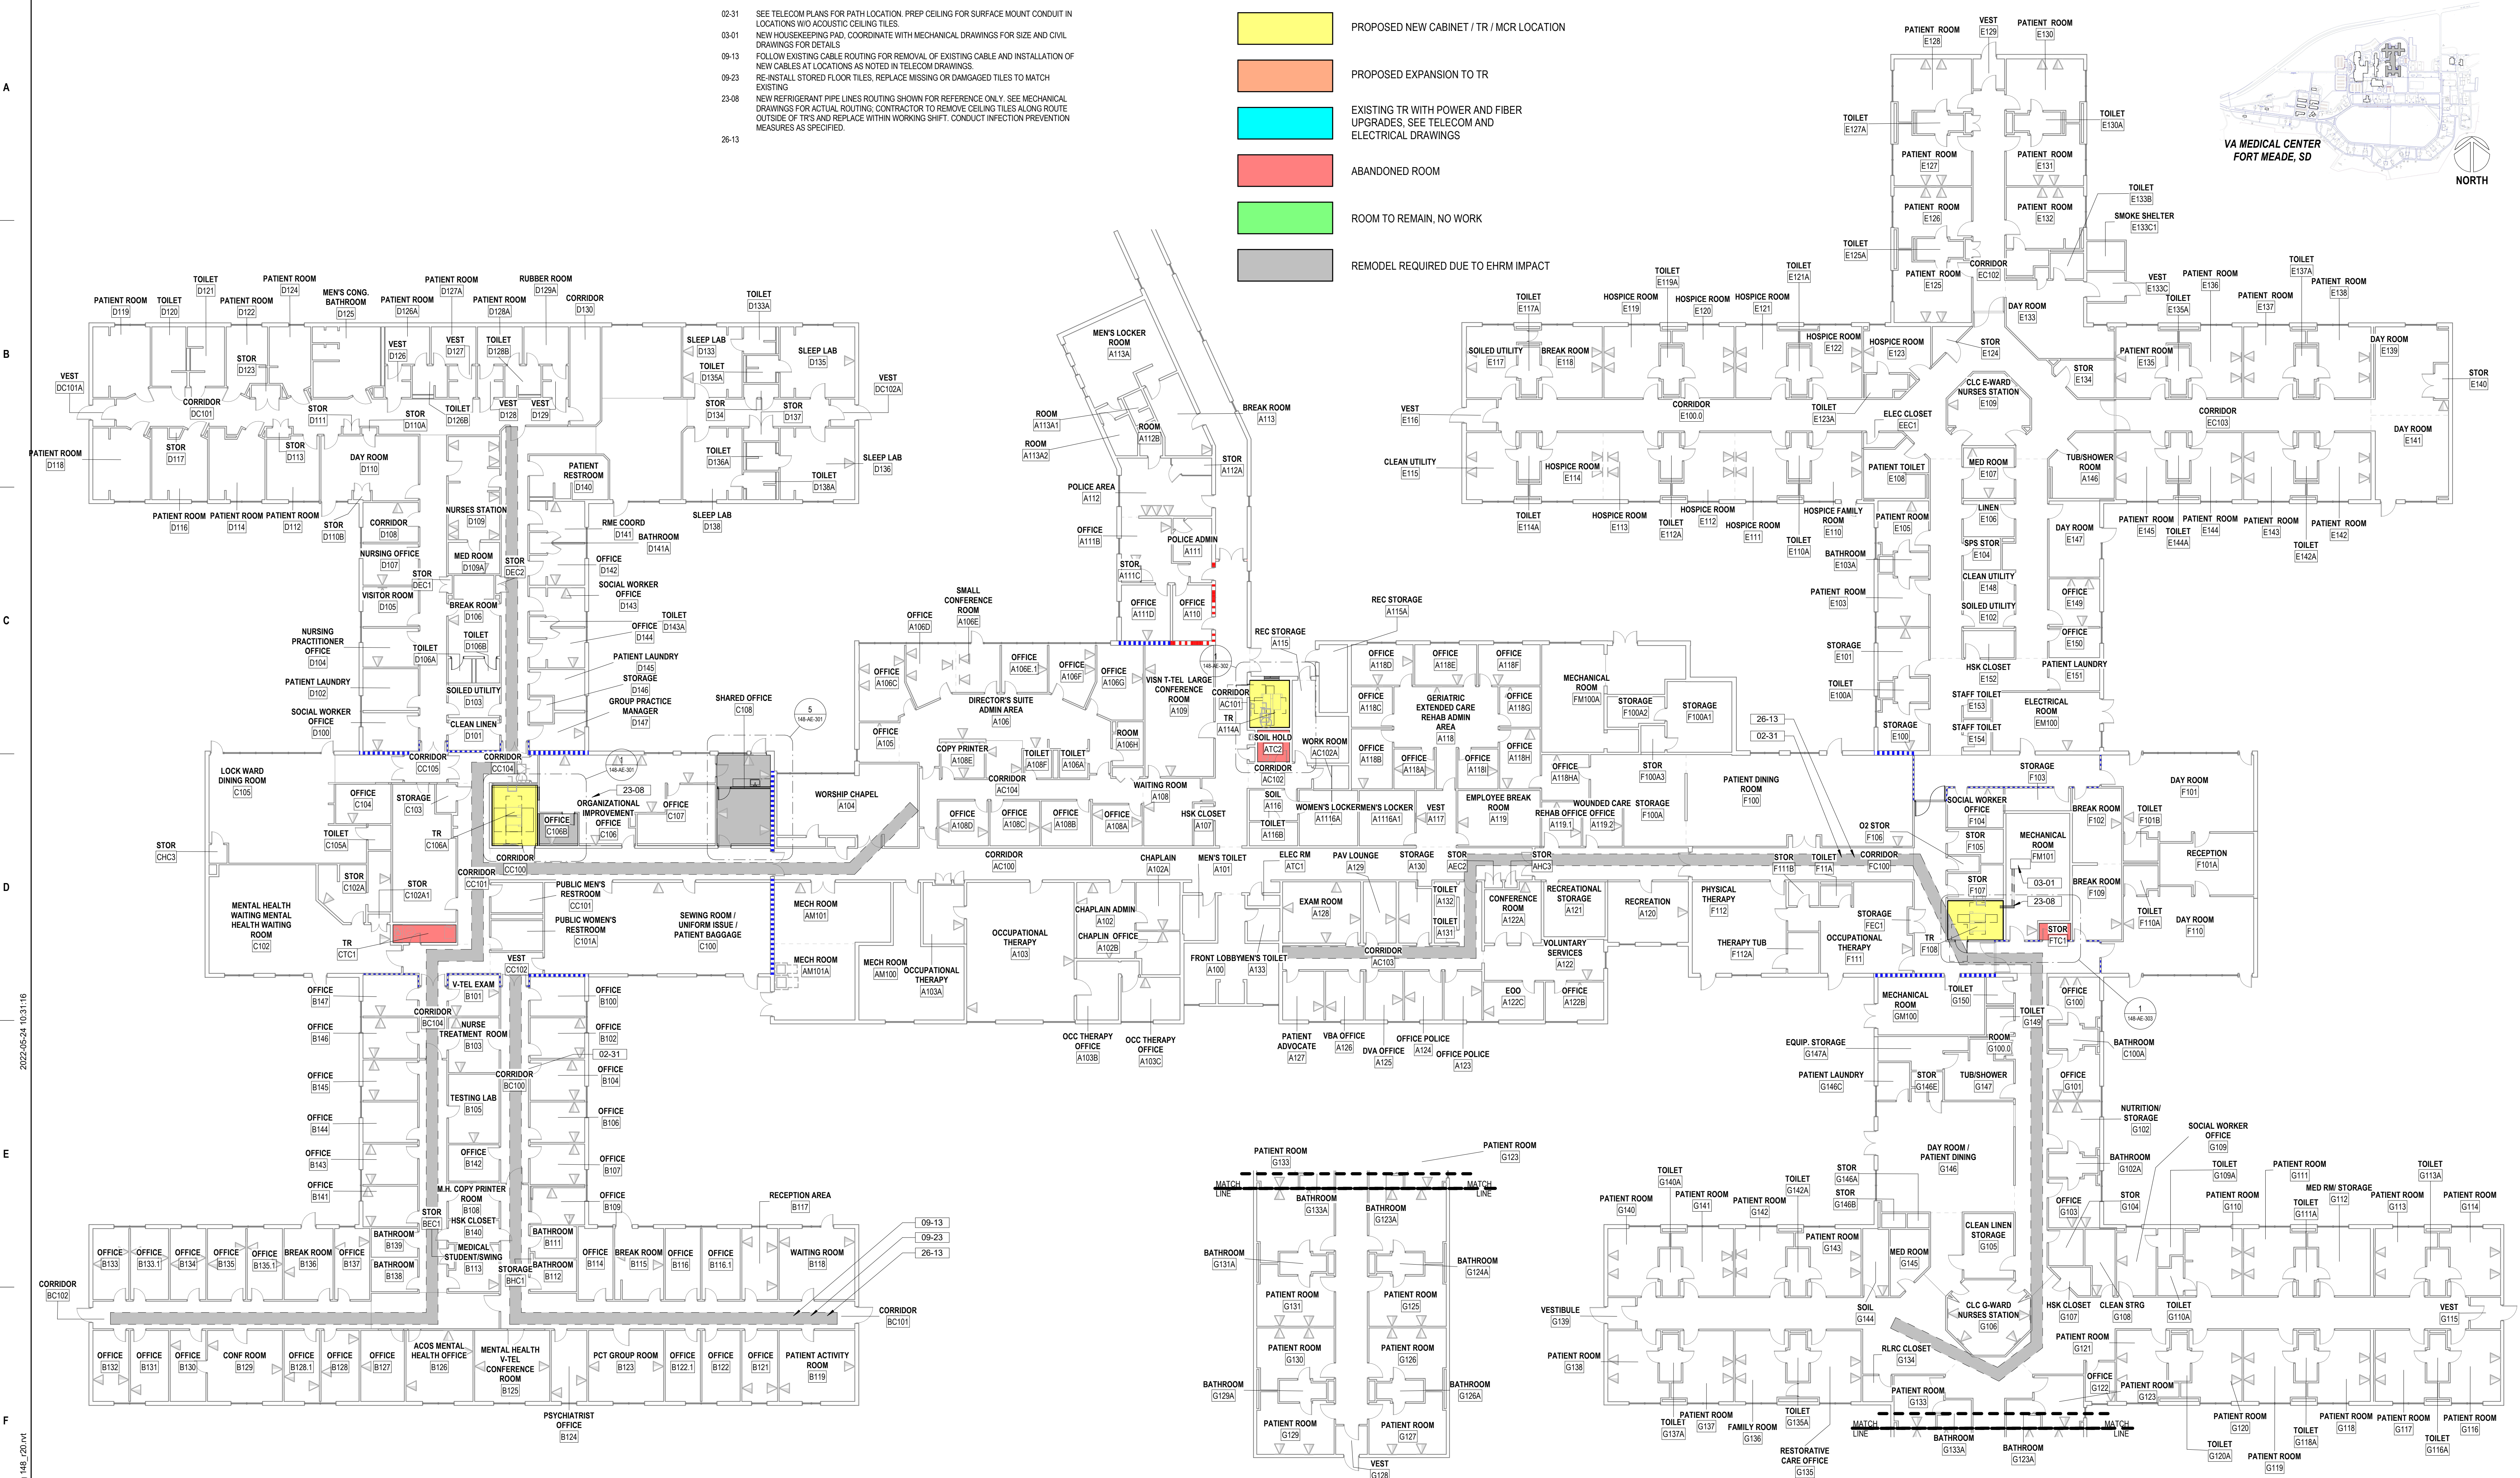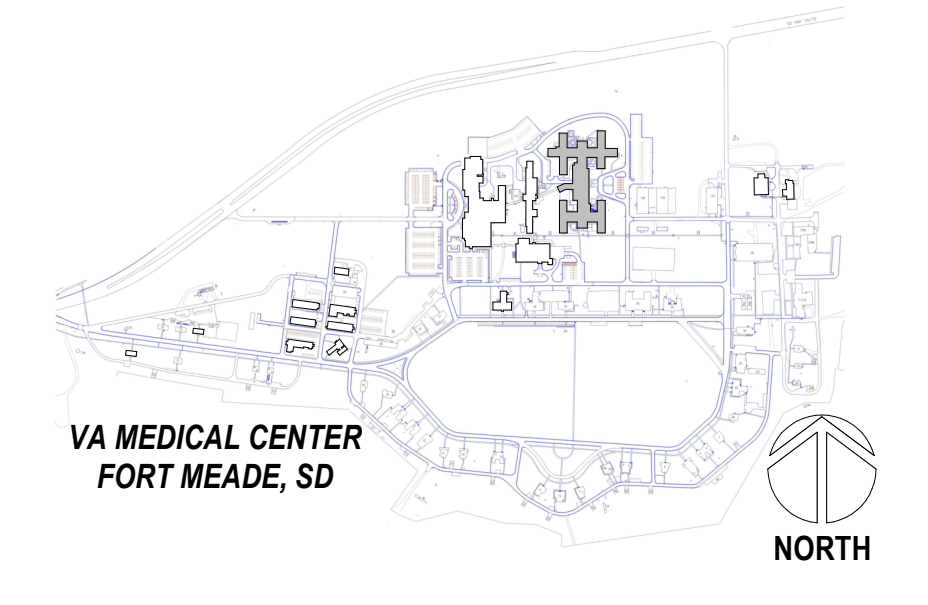

LEVEL 1 FLOOR PLAN

1/16" = 1'-0"

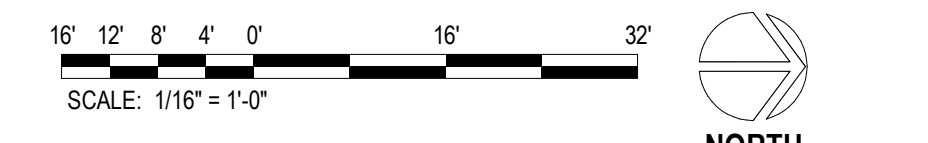

CONSULTANT A/E: GDM 1000 W STEUBEN ST. UNIT 3 BINGEN, WA 98605 541.436.4723 ADAM GODDIN, PE	ARCHITECT/ENGINEER OF RECORD ARCHITECT A&E DESIGN 124 NORTH 29TH STREET, #100 BILLINGS, MONTANA 59101 406.248.2633 T. MARCELLO PIERROTTET, AIA	STAMP 	PROGRAM CONTRACTING ACTIVITY CENTRAL (PCAC) U.S. Department of Veterans Affairs	DRAWING TITLE 148-LEVEL 1 FLOOR PLAN	PHASE 100% CONSTRUCTION DOCUMENTS	PROJECT TITLE EHRM INFRASTRUCTURE UPGRADES	PROJECT NUMBER 568-21-701
				APPROVED: Project Director	FLS FULLY SPRINKLERED	LOCATION FORT MEADE, SOUTH DAKOTA	BUILDING NUMBER BLDG 148
Revisions:	Date:			ISSUE DATE 04/15/2022	CHECKED BY TMP	DRAWN BY JPR	DRAWING NUMBER 148-AE-201



KEYNOTES

23-05 MECHANICAL UNITS, SEE MECH DRAWINGS FOR SIZE AND SPECS

ROOF NOTES


1. PROVIDE ROOF CRICKETS AT ALL UPSLOPE AREAS OF MECHANICAL EQUIPMENT, CURBS AND ROOF HATCHES.
2. CRICKETS TO SLOPE POSITIVELY 1/4" MINIMUM PER FOOT FROM HORIZONTAL PLANE.
3. MAINTAIN 1/8" PER FOOT MINIMUM FOR ALL CRICKET VALLEYS.
4. CRICKETS SHOWN ARE FOR REFERENCE ONLY. CONTRACTOR TO PROVIDE DETAILED LAYOUT PLAN FOR ARCHITECT'S REVIEW PRIOR TO INSTALLATION.
5. ROOF PENETRATIONS OF ANY KIND SHALL NOT BE LOCATED IN CRICKET VALLEYS.
6. IN ADDITION TO OPENING AND EQUIPMENT SHOWN ON THIS DRAWING, MECHANICAL AND ELECTRICAL DRAWINGS
7. INDICATE ADDITIONAL ITEMS PENETRATING THE ROOF ASSEMBLY; PROVIDE APPROPRIATE FLASHING.
8. REFERENCE MECH DRAWINGS FOR VENT LOCATIONS, EQUIPMENT LOCATIONS, AND ADDITIONAL INFORMATION, TYP.

PROJECT KEY PLAN

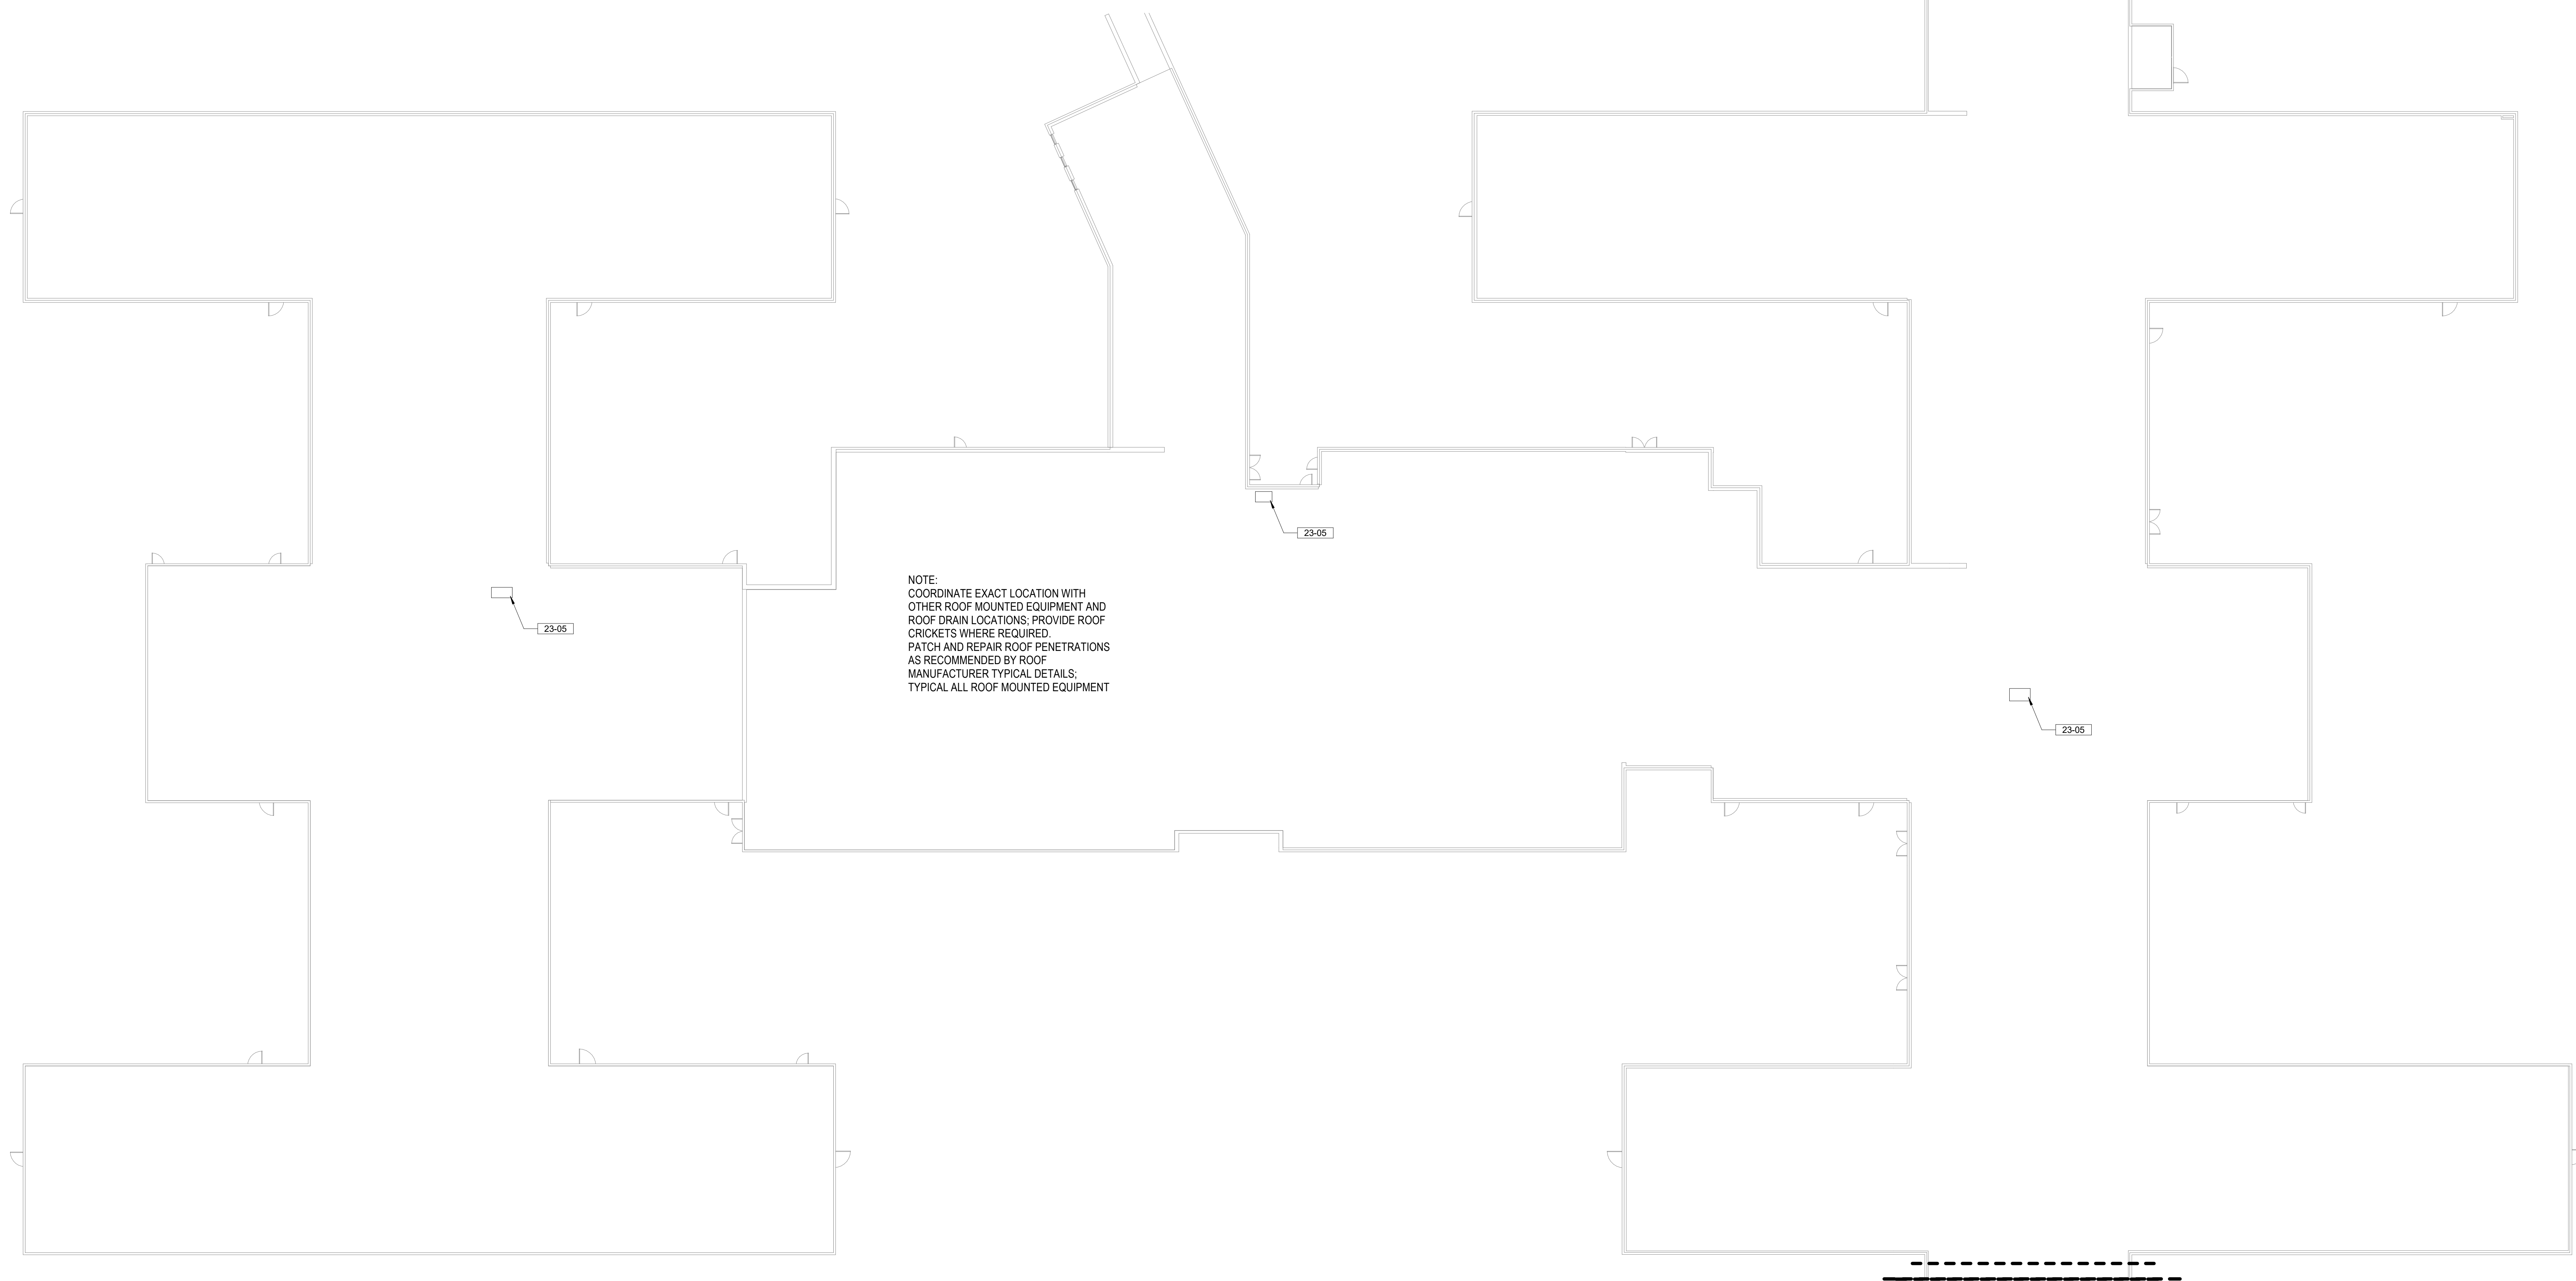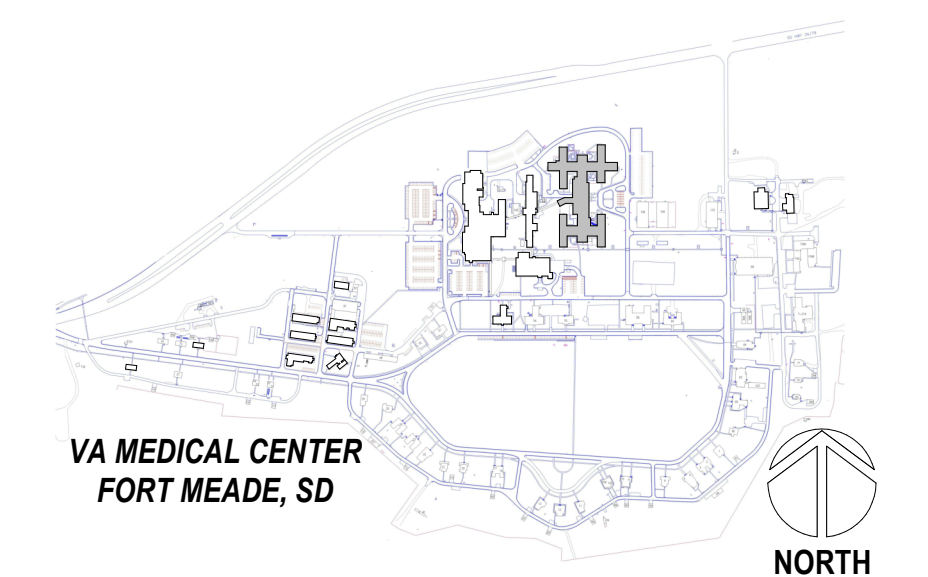

NOTE:
COORDINATE EXACT LOCATION WITH
OTHER ROOF MOUNTED EQUIPMENT AND
ROOF DRAIN LOCATIONS; PROVIDE ROOF
CRICKETS WHERE REQUIRED.
PATCH AND REPAIR ROOF PENETRATIONS
AS RECOMMENDED BY ROOF
MANUFACTURER TYPICAL DETAILS;
TYPICAL ALL ROOF MOUNTED EQUIPMENT

1 ROOF PLAN
1/16" = 1'-0"

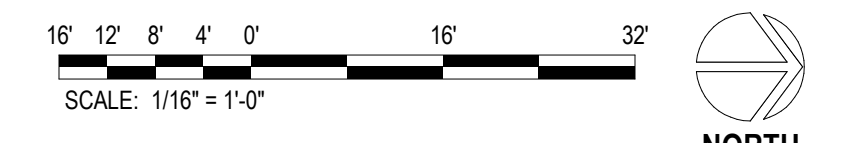

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 2022-05-24 10:31:18
 VA FORM 08 - 6231

Revisions:	Date:

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PROGRAM CONTRACTING ACTIVITY CENTRAL (PCAC)

VA U.S. Department of Veterans Affairs

DRAWING TITLE
148 ROOF PLAN

APPROVED: Project Director

PHASE
100% CONSTRUCTION DOCUMENTS

FLS
FULLY SPRINKLERED

PROJECT TITLE
EHRM INFRASTRUCTURE UPGRADES

LOCATION
FORT MEADE, SOUTH DAKOTA

ISSUE DATE: 04/15/2022


CHECKED BY:
DRAWN BY:
DATE:
DATE:
DATE:

PROJECT NUMBER
568-21-701


BUILDING NUMBER
BLDG 148

DRAWING NUMBER
148-AE-202


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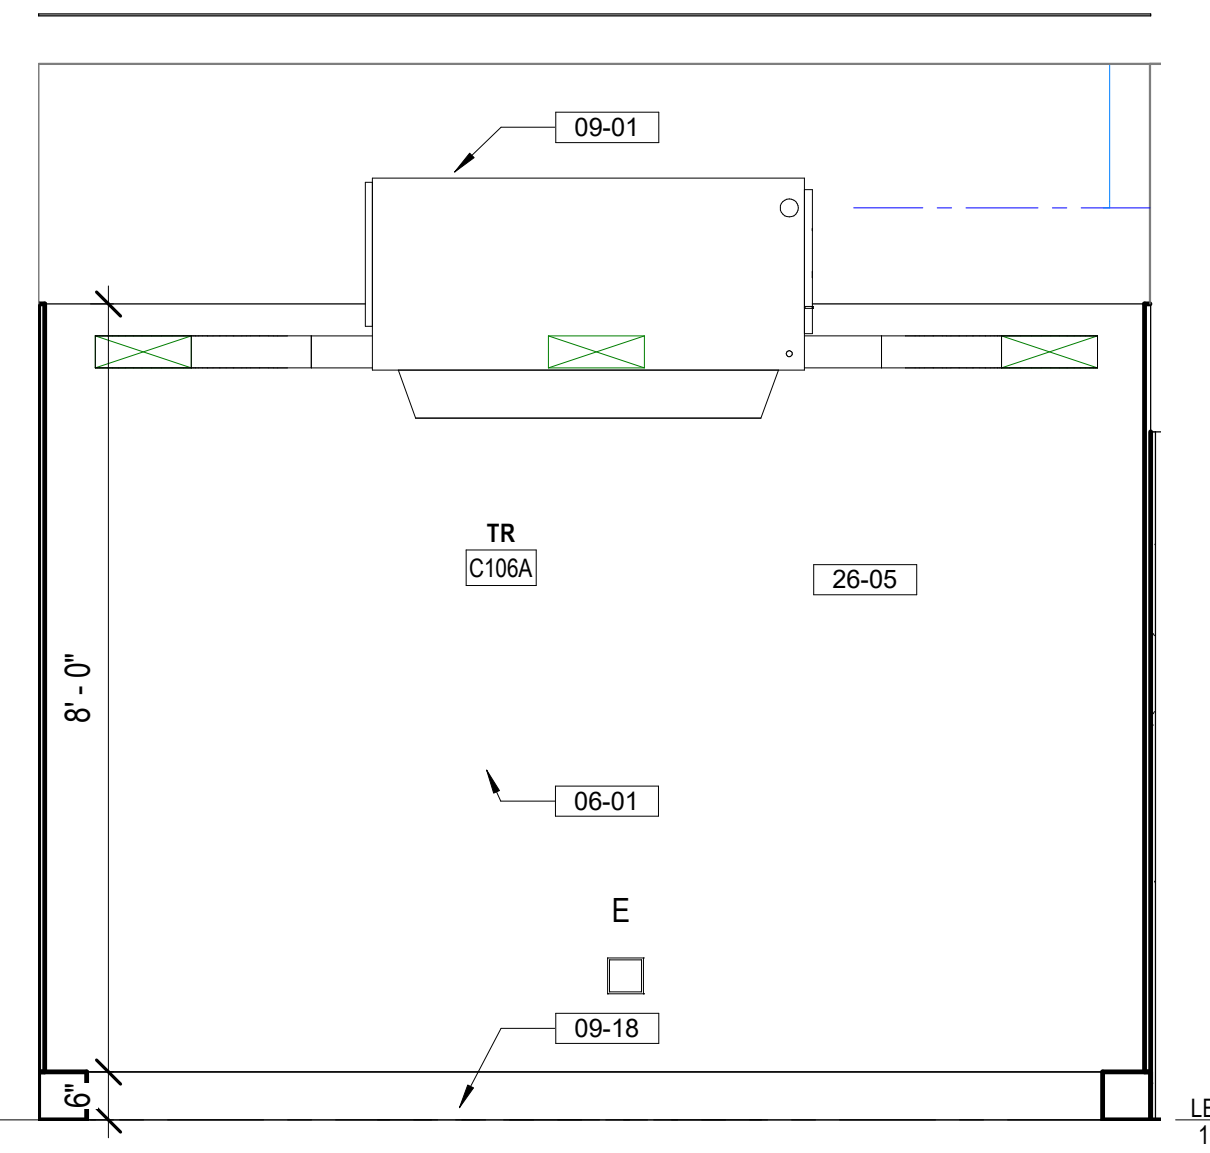
2 TR C106A EAST ELEVATION
1/2" = 1'-0"

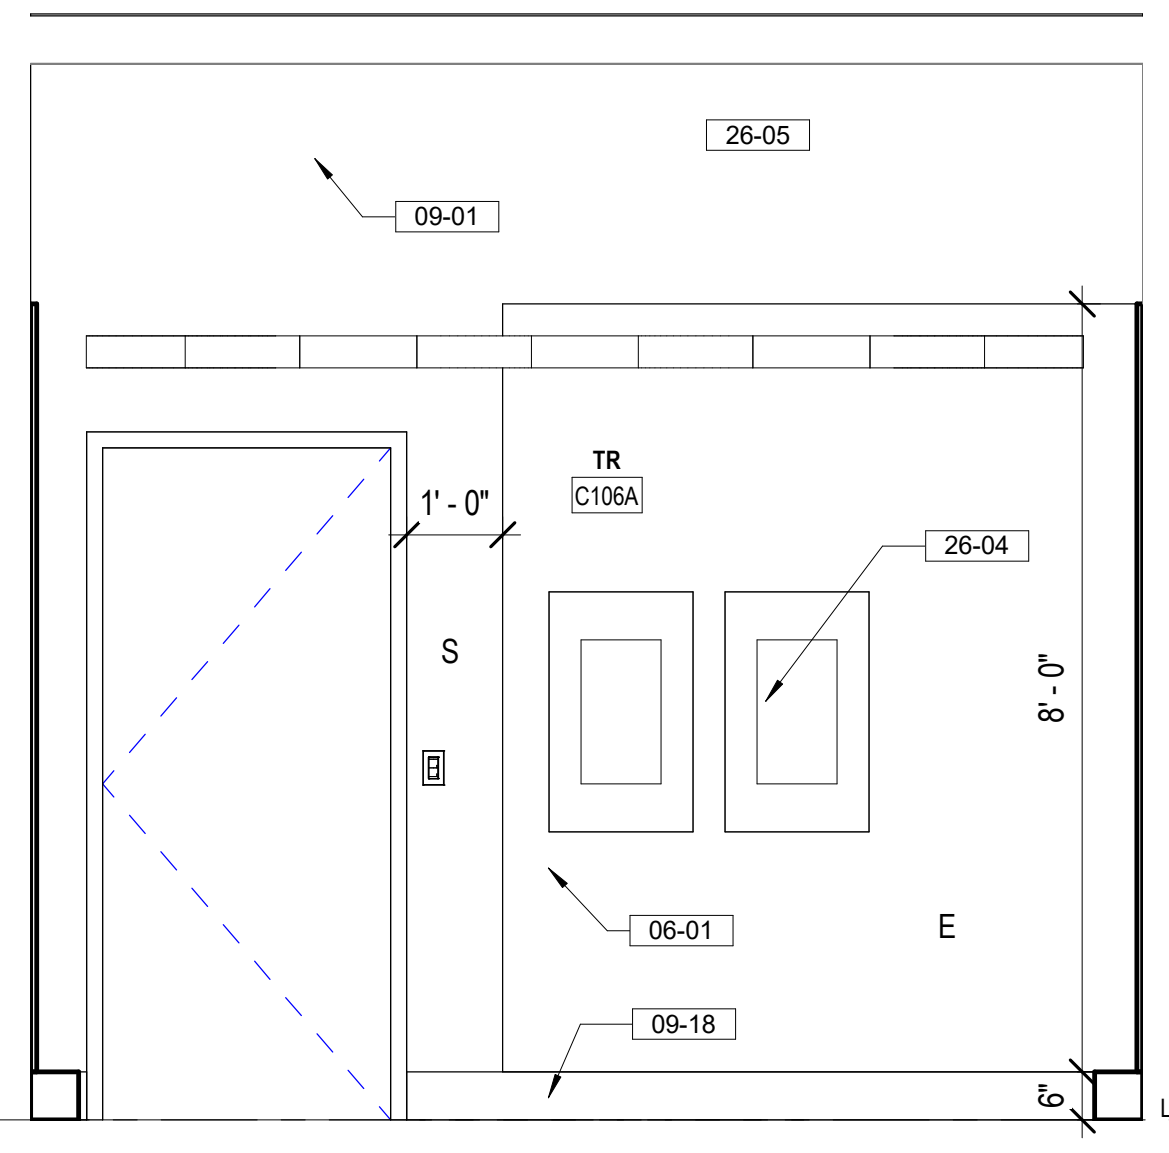

3 TR C106A NORTH ELEVATION
1/2" = 1'-0"

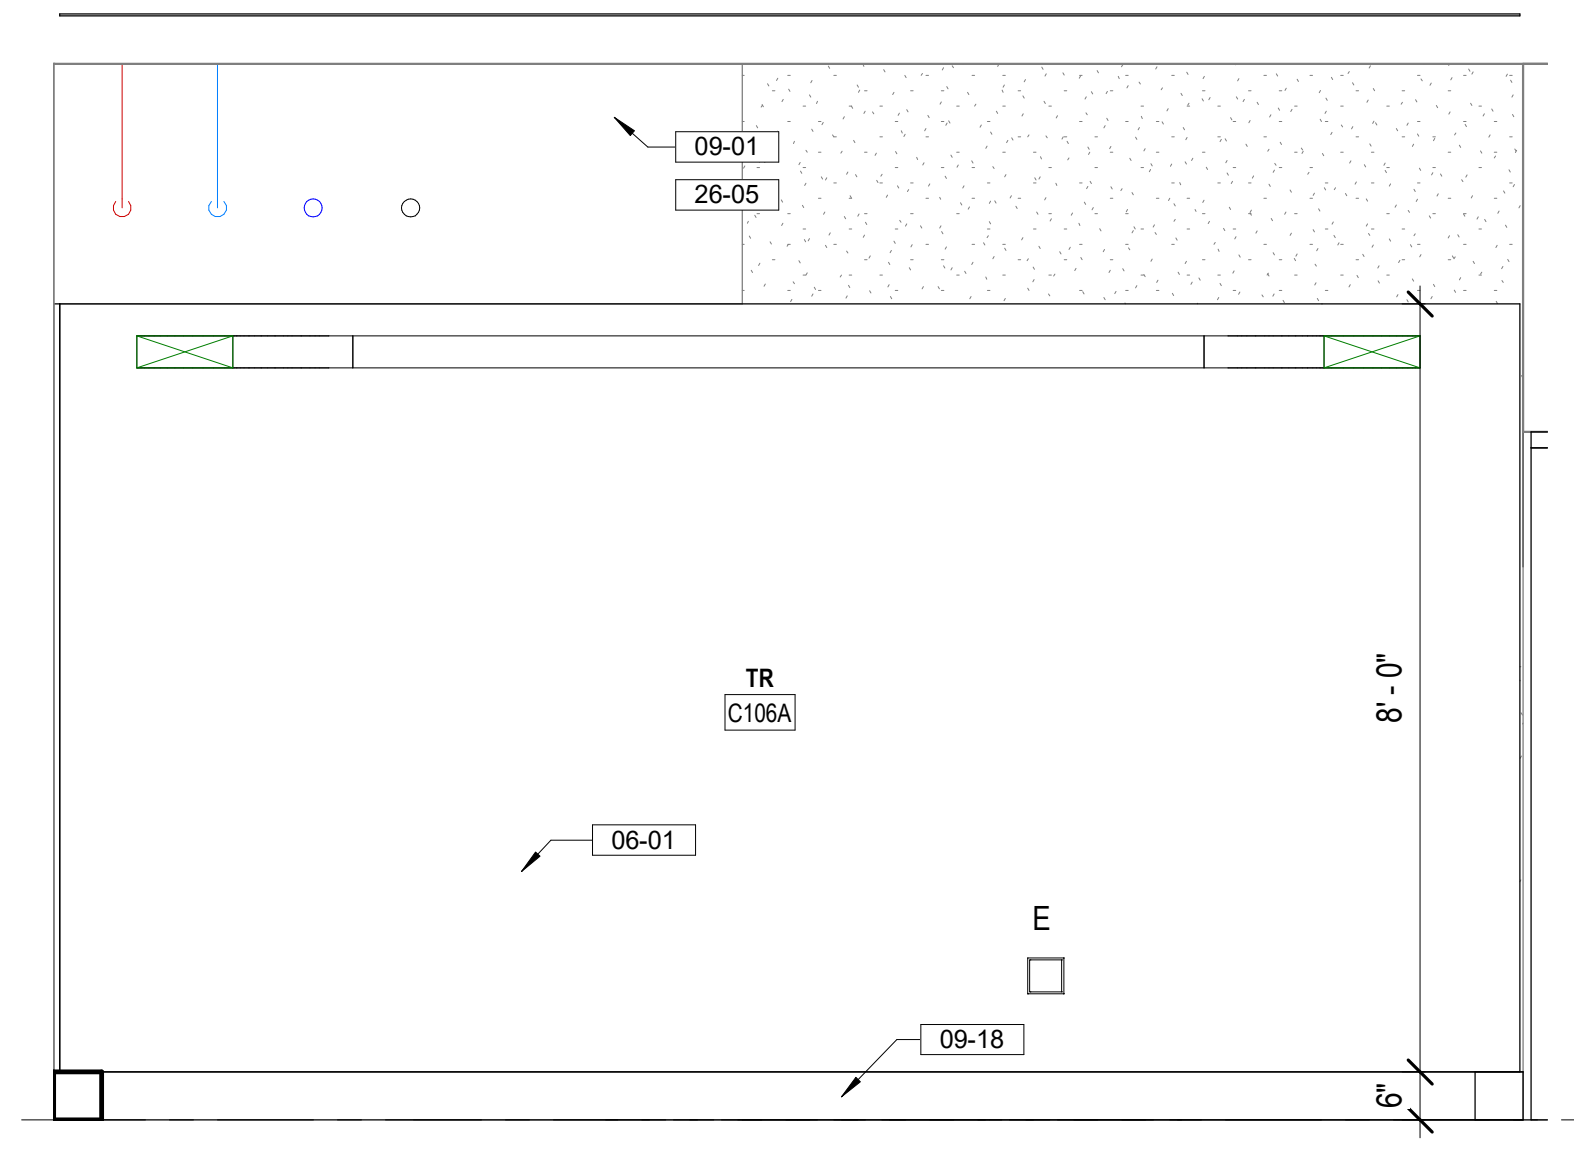

6 TR C106A SOUTH ELEVATION
1/2" = 1'-0"

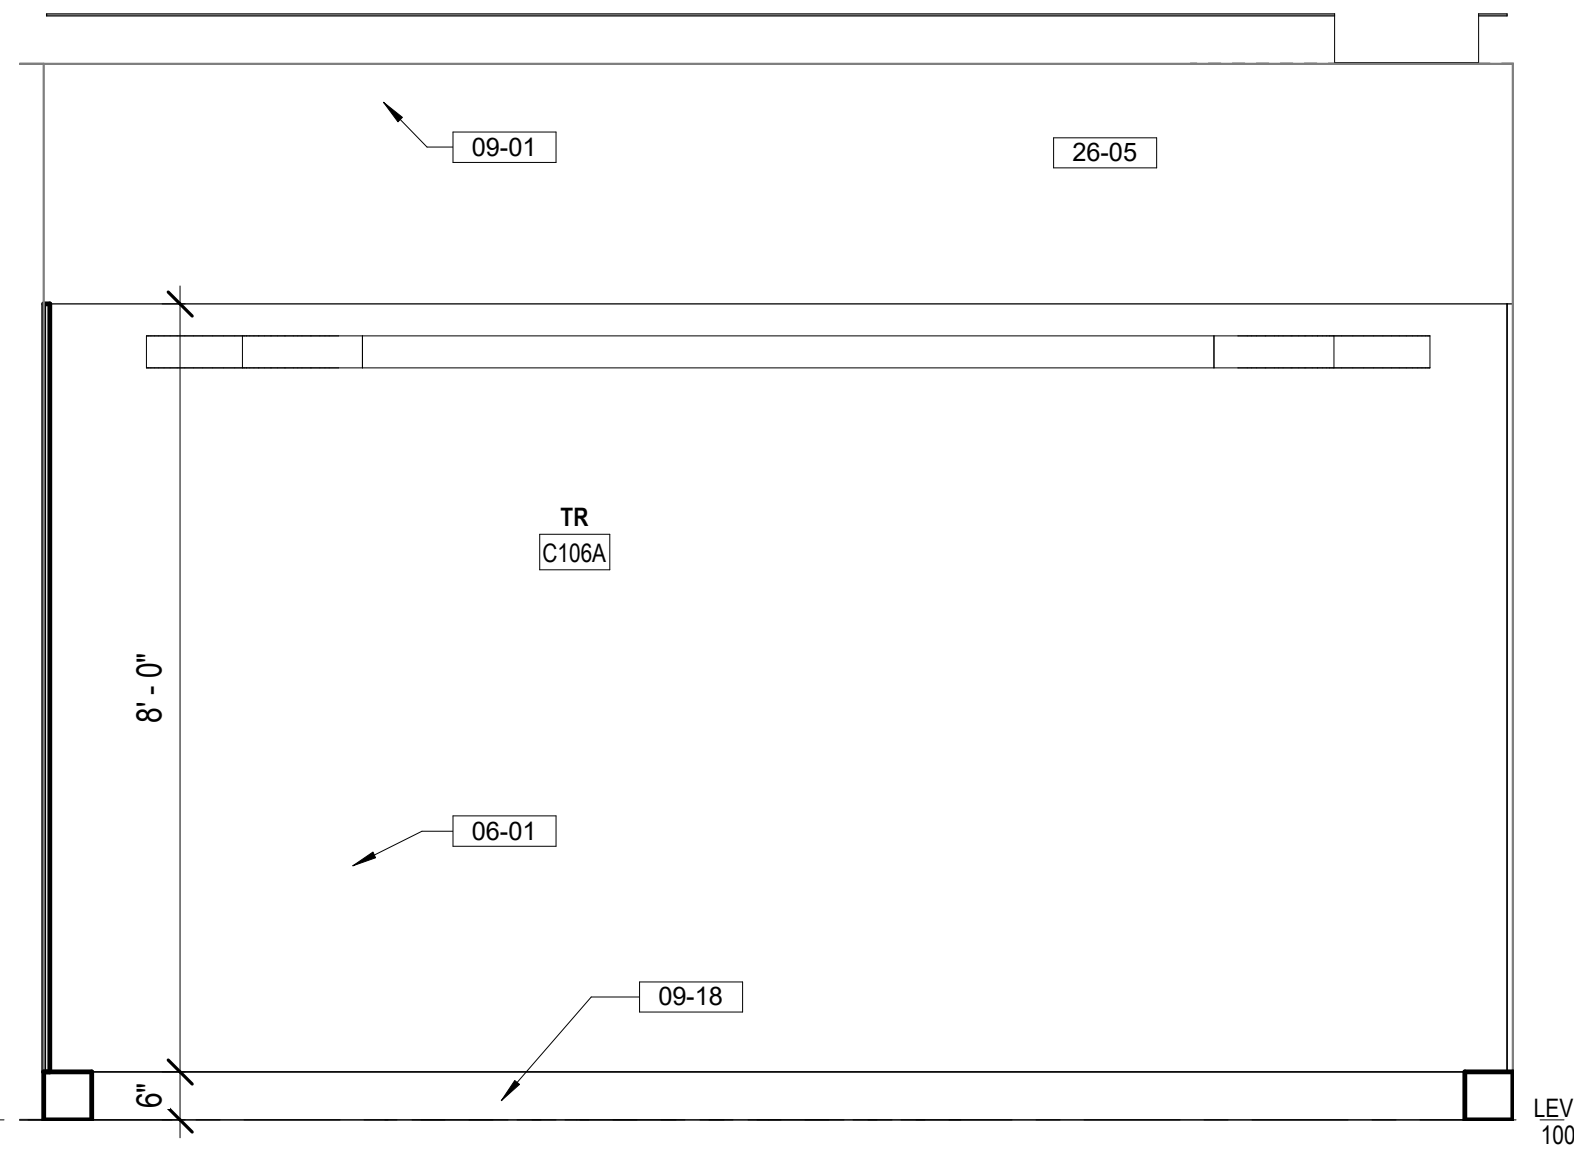

8 TR C106A WEST ELEVATION
1/2" = 1'-0"

FLOOR PLAN NOTES


- SEE G SERIES SHEETS FOR BALANCE OF FLOOR PLAN GENERAL NOTES.
- REFER TO STRUCTURAL, MECHANICAL, AND ELECTRICAL DRAWINGS FOR ADDITIONAL INFORMATION. ALL INFORMATION REGARDING EXISTING CONDITIONS IS BASED UPON OWNER-SUPPLIED DOCUMENTS AND MAY NOT PRECISELY REFLECT FIELD CONDITIONS.
- PROVIDE ALL BACKING FOR MILLWORK, GRAB BARS, AND ANY AND ALL WALL MOUNTED EQUIPMENT OR ACCESSORIES; COORDINATE LOCATIONS.
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- PROVIDE A SMOOTH AND LEVEL FINISH FLOOR, TYP. PATCH AND REPAIR ALL INCONSISTENCIES IN FLOOR ELEVATIONS.
- PATCH AND REPAIR ANY / ALL WALL SURFACES AS REQUIRED TO PROVIDE SUITABLE SUBSTRATE FOR FINISHES.
- REFER TO DOOR AND FRAME SCHEDULE FOR DOORS REQUIRING ADA ACCESS CONTROL.
- PROVIDE ACOUSTICAL SEALANT AROUND WALL EDGES, TOP AND BOTTOM, AND PENETRATIONS, AND INSTALL PUTTY PADS AROUND ELECTRICAL BOXES WHERE PARTITION CONTAINS ACOUSTICAL INSULATION.
- ALL TELECOMMUNICATION ROOMS ARE TO HAVE EXPOSED STRUCTURE UNLESS NOTED OTHERWISE, NO CEILINGS SPECIFIED.

FLOOR PLAN LEGEND



- CARD READER, REF TELECOM DRAWINGS
- DATA PORT, REF TELECOM DRAWINGS
- OUTLET, REF ELEC DRAWINGS
- WIRELESS ACCESS POINT, REF TELECOM DRAWINGS
- ELEC PANEL, REF ELEC DRAWINGS
- STRIP LIGHT FIXTURE, REF ELEC DRAWINGS

KEY NOTES


- 06-01 INSTALL 3/4" AC GRADE OR BETTER FIRE RETARDANT PLYWOOD, PAINT WITH TWO COATS OF SEMI-GLOSS BRIGHT WHITE FIRE RETARDANT PAINT; MOUNT BOTTOM OF PLYWOOD 6" A.F.F., TOP OF PLYWOOD AT 8'-0" A.F.F.; DO NOT PAINT OVER STAMPED PLYWOOD RATING
- 09-01 PAINT WALL ABOVE PLYWOOD WITH SEMI-GLOSS PAINT, COLOR TO MATCH PLYWOOD PAINT.
- 09-07 INSTALL STATIC DISSIPATIVE RESILIENT FLOORING
- 09-09 APPLY JOINT COMPOUND AND FEATHER A MINIMUM OF 3" HORIZONTALLY AS REQUIRED TO ACHIEVE A SMOOTH AND UNIFORM APPEARANCE
- 09-10 PAINT FULL LENGTH OF WALL TO NEAREST EXTERIOR OR INTERIOR CORNER, COLOR TO MATCH EXISTING WALLS.
- 09-11 INSTALL NEW WALL BASE TO MATCH TYPE, COLOR, AND PROFILE OF EXISTING WALL BASE
- 09-18 6" HIGH COVED RUBBER WALL BASE, COLOR TO BE SELECTED FROM MANUFACTURER'S STANDARD SELECTION
- 09-25 PATCH AND REPAIR ANY GYPSUM BOARD OPENINGS FOUND AT PERIMETER OF WALL ENSURING NO VISIBLE EVIDENCE OF PATCH, SEAL PERIMETER OF ROOM IN ITS ENTIRETY, PAINT.
- 09-29 INSTALL NEW FLOORING TO MATCH EXISTING SIMILAR USE ROOM
- 22-01 FIRE SUPPRESSION SPRINKLER HEAD SHOWN FOR REFERENCE ONLY; FIRE SUPPRESSION CONTRACTOR TO VERIFY ACTUAL QUANTITIES REQUIRED.
- 26-02 INSTALL SYMMETRICALLY CENTER IN TILE
- 26-03 3" PERIMETER CLEARANCE AROUND SERVER RACK SHOWN DASHED
- 26-04 TELECOMM RACK, SEE TELECOMMUNICATION DRAWINGS
- 26-05 ELECTRICAL PANELS, SEE ELECTRICAL DRAWINGS
- 26-05 CABLE TRAY, SEE TELECOMMUNICATION DRAWINGS

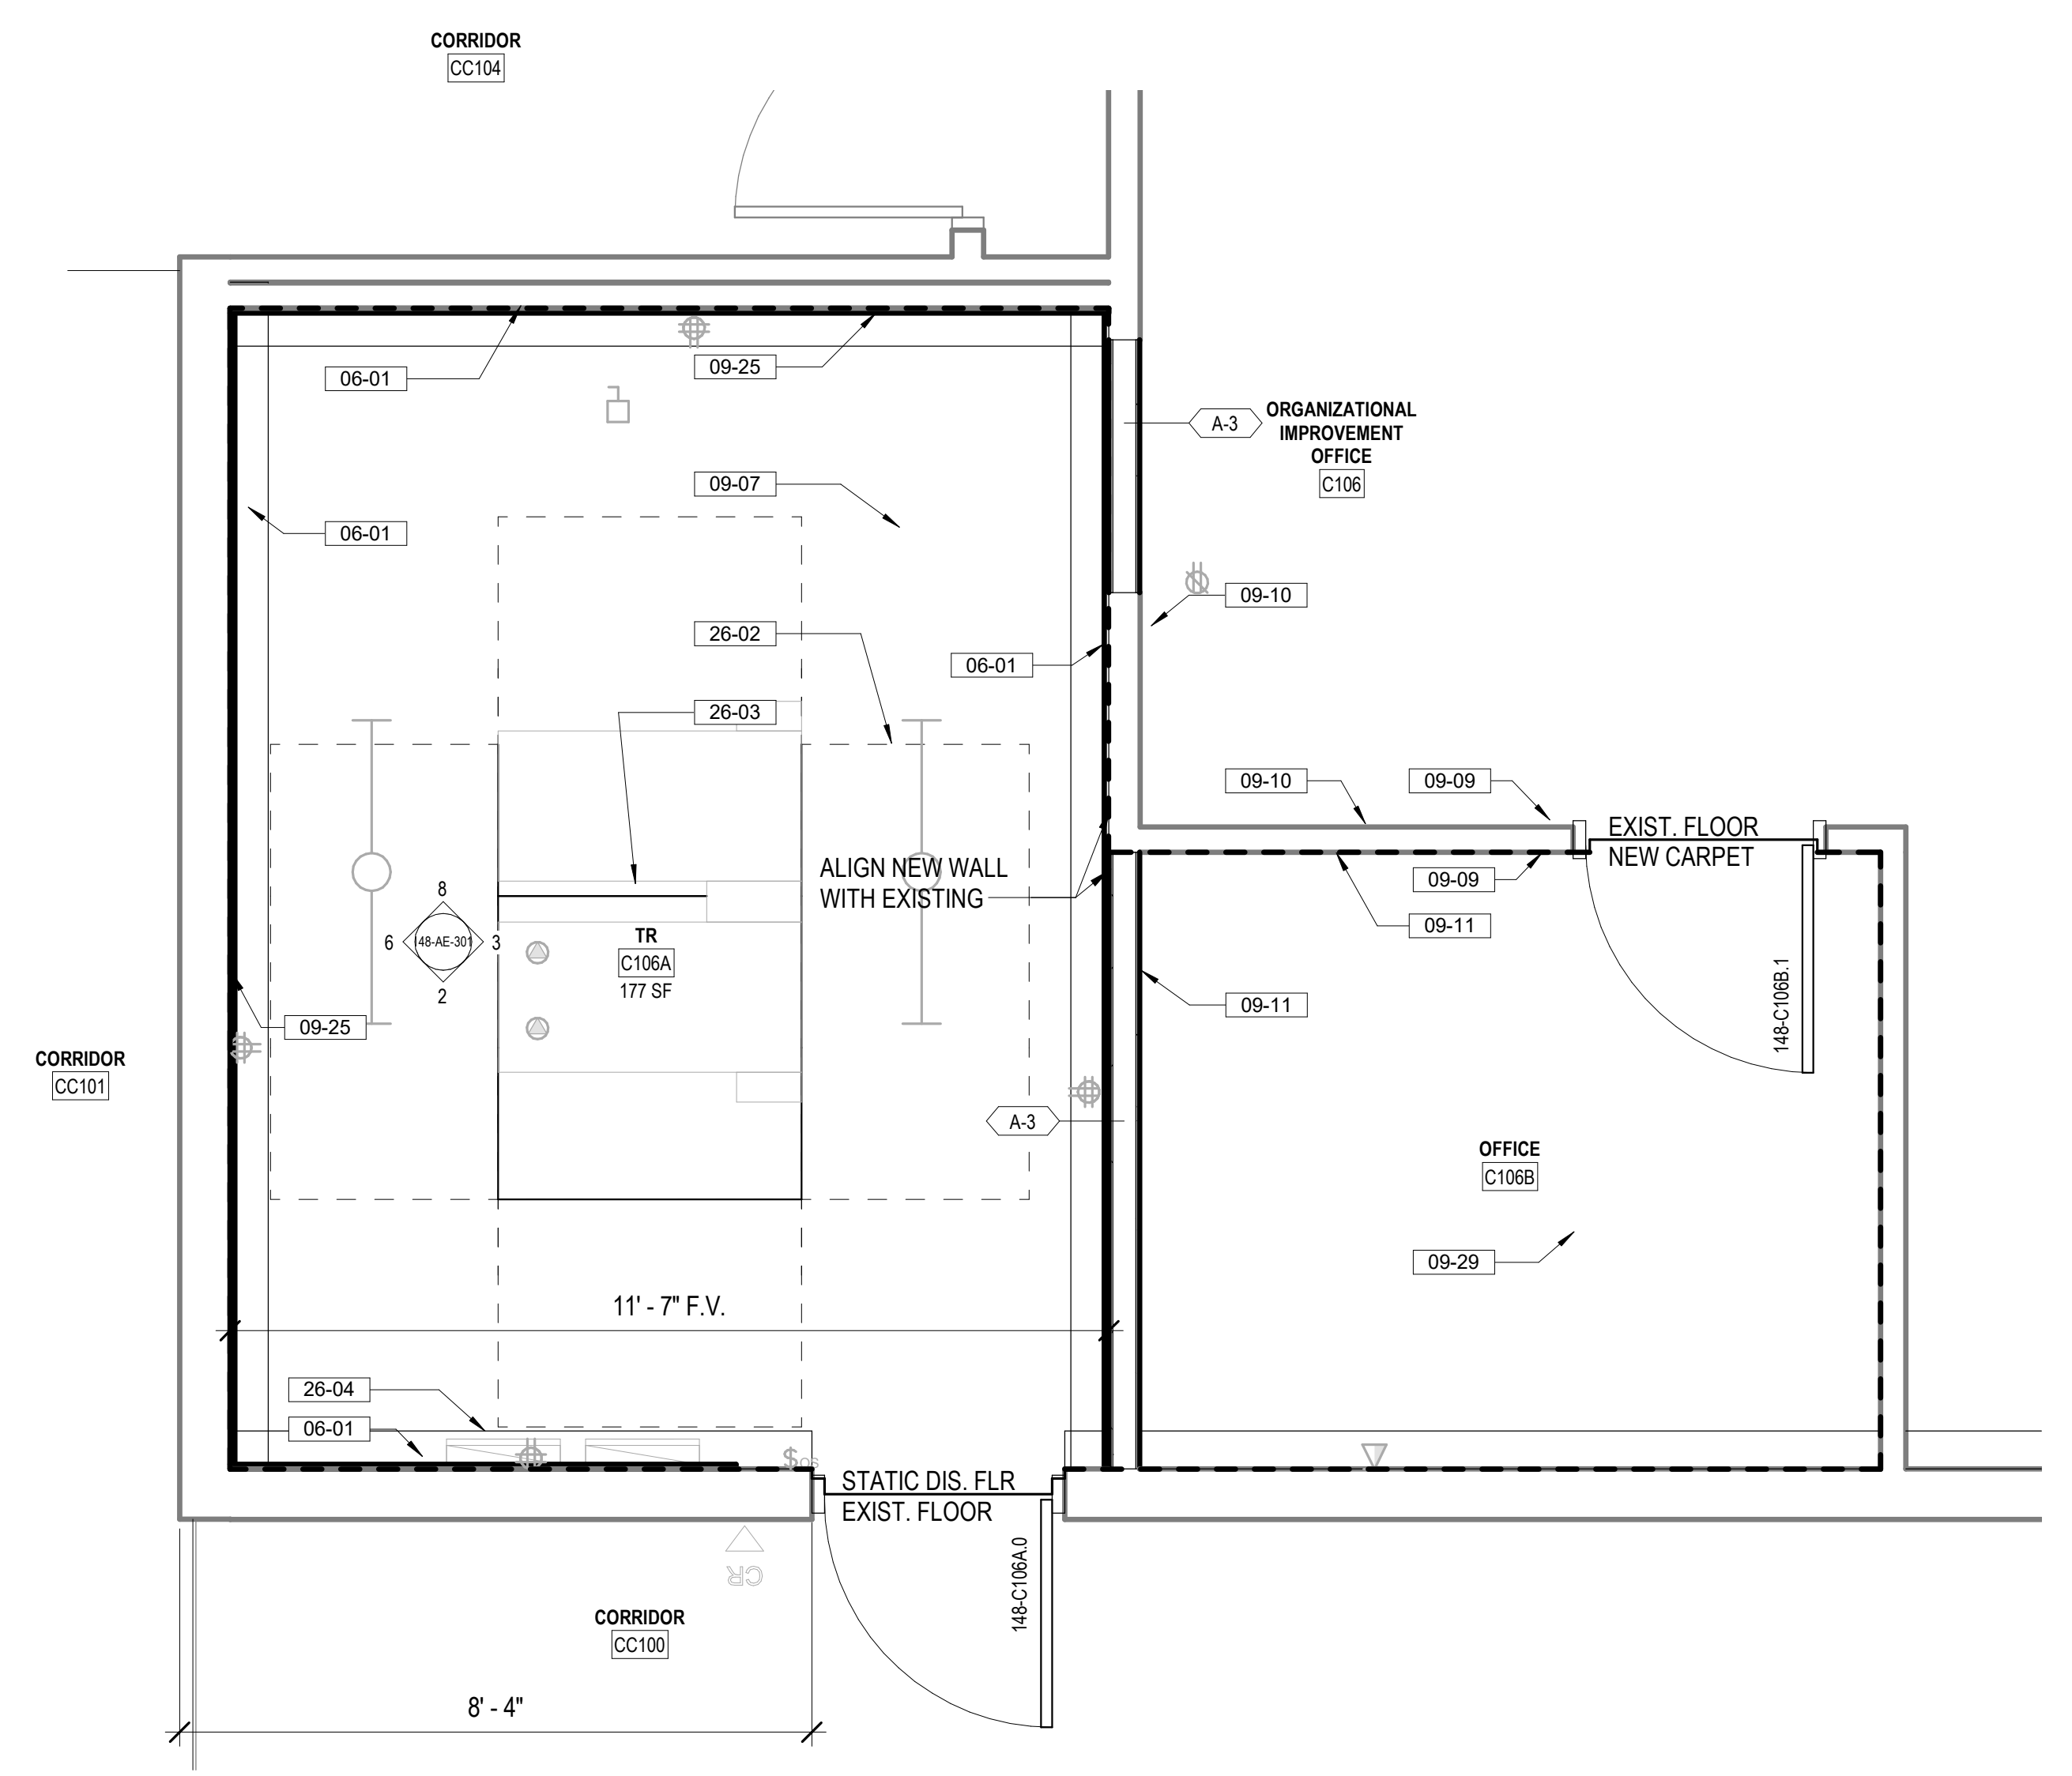

1 148 - C106A ENLARGED PLAN
1/2" = 1'-0"

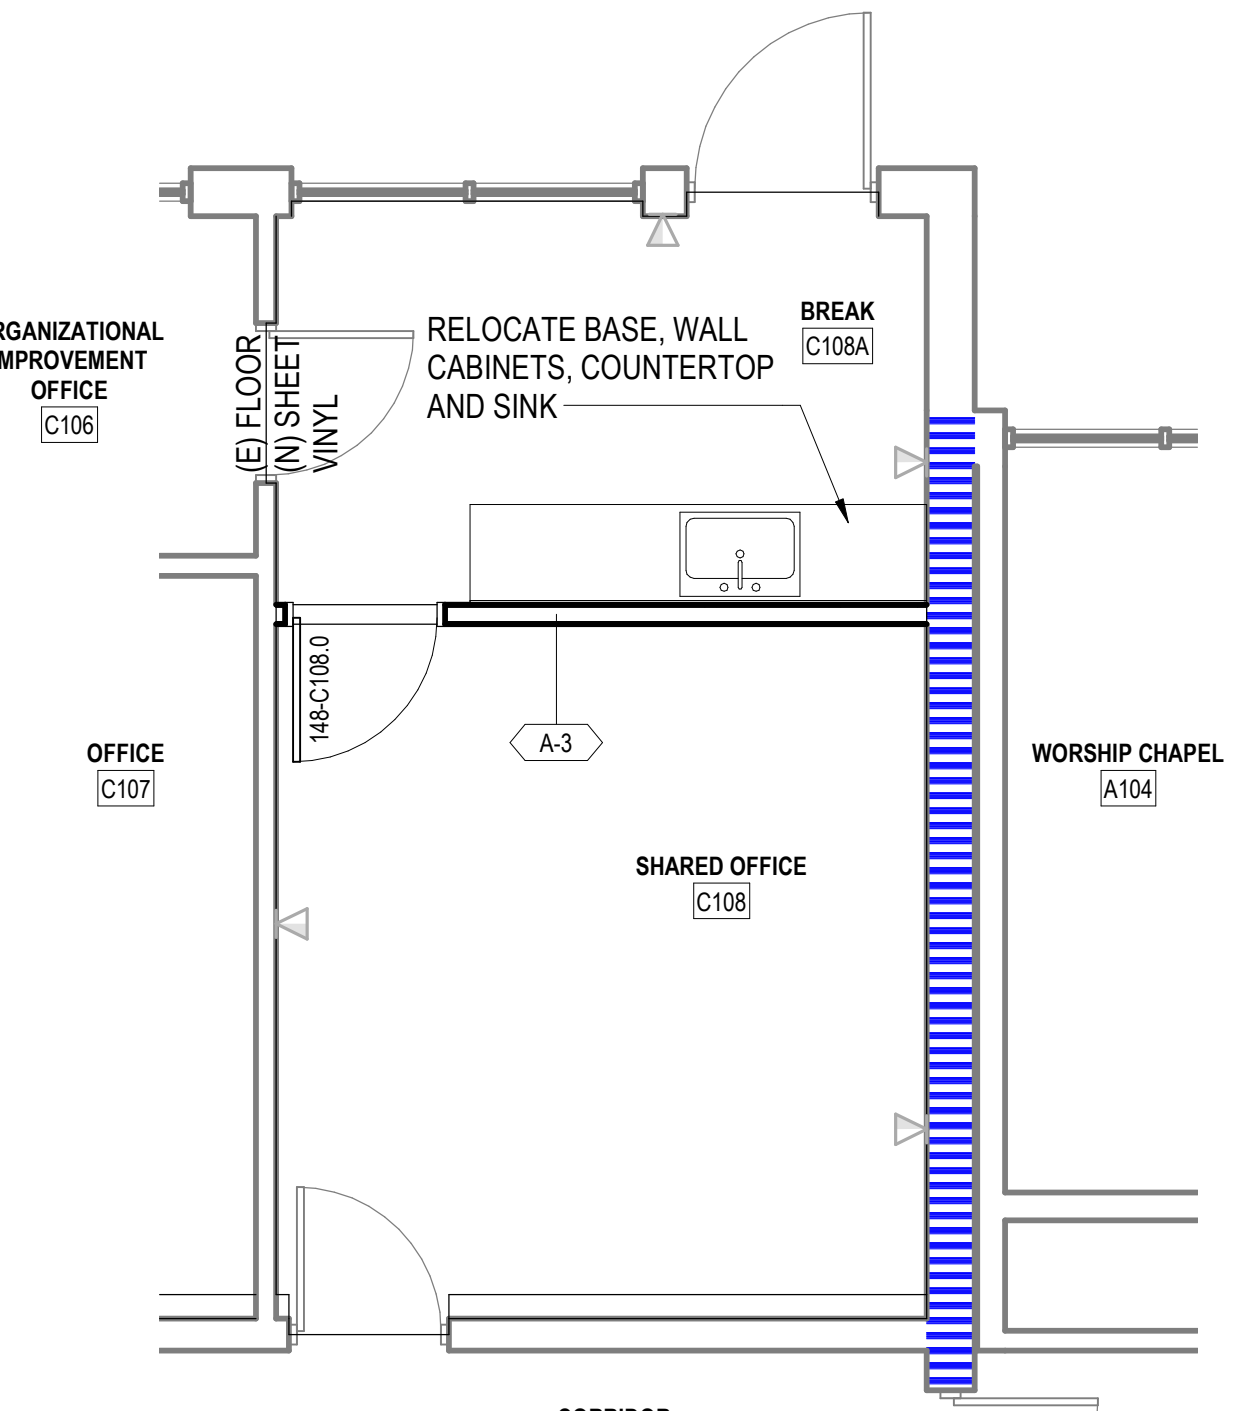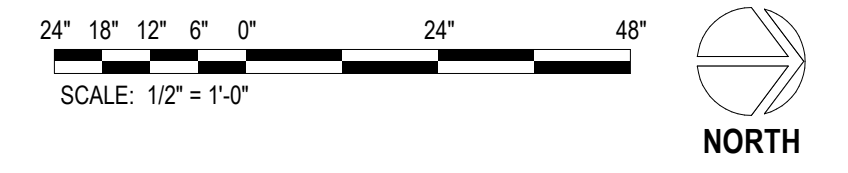

5 SHARED OFFICE FLOOR PLAN
1/4" = 1'-0"

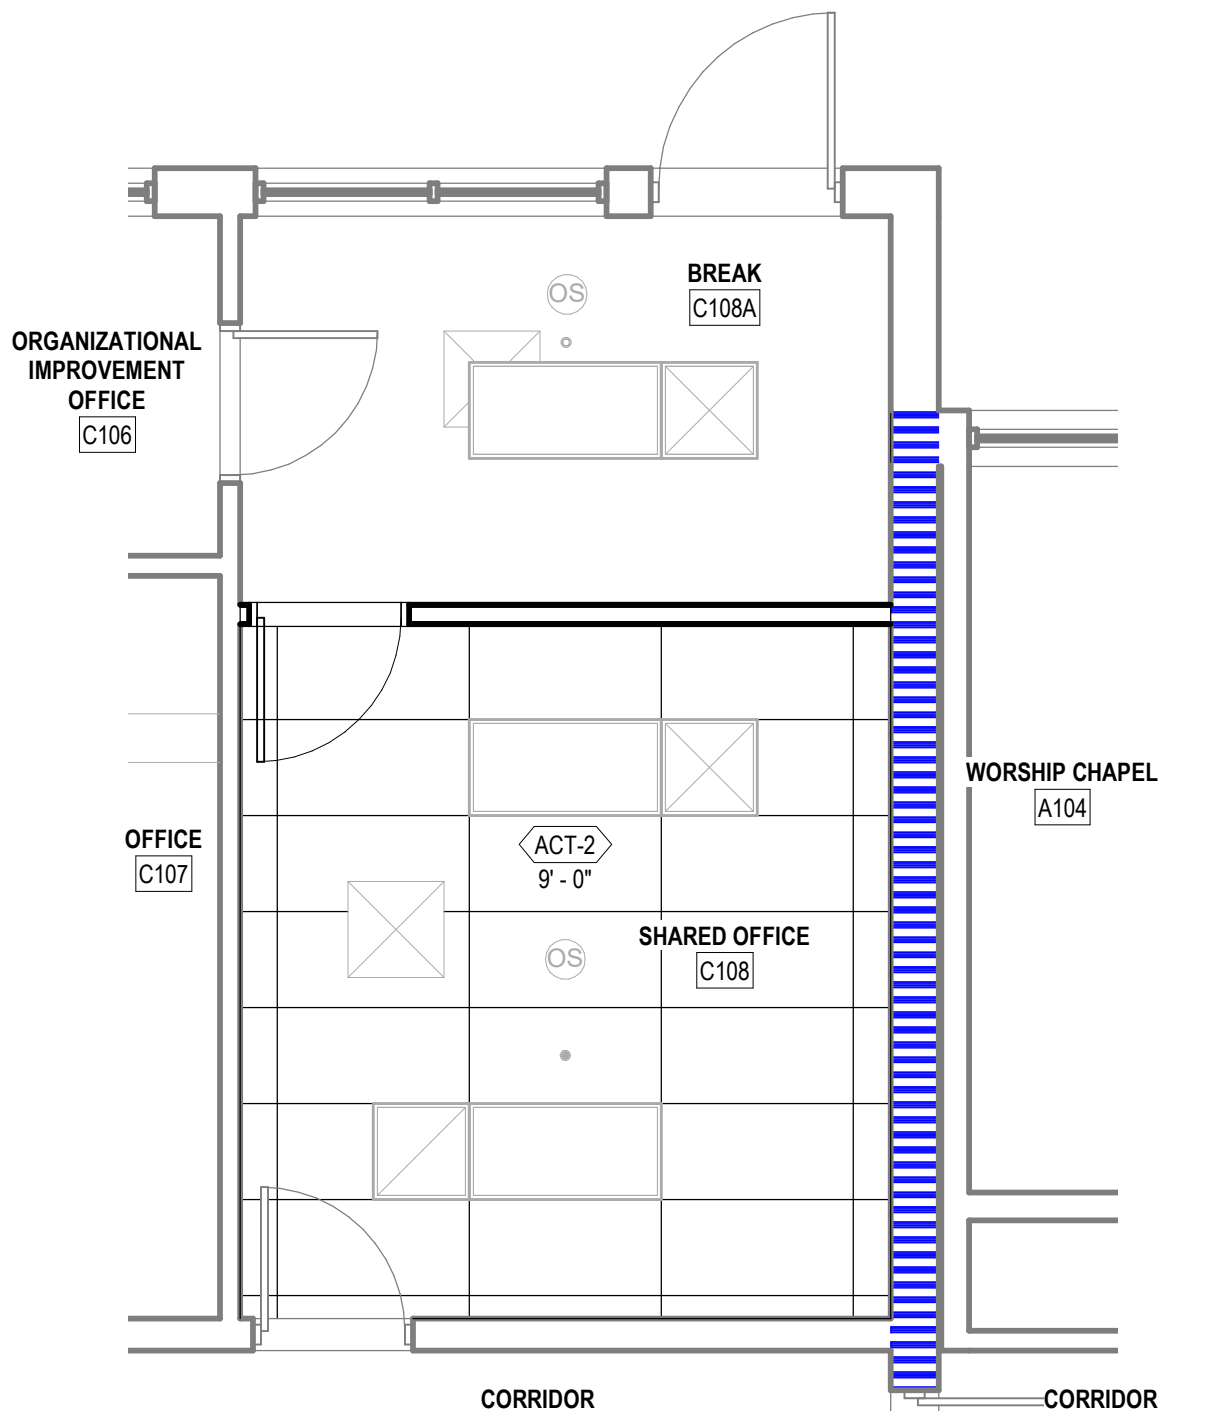

7 SHARED OFFICE REFLECTED CEILING PLAN
1/4" = 1'-0"



REFLECTED CEILING PLAN LEGEND

- 2x2 LIGHT FIXTURE
- 2x4 LIGHT FIXTURE
- STRIP LIGHT FIXTURE
- 6" RECESSED CAN LIGHT FIXTURE
- SUPPLY AIR DIFFUSER
- RETURN AIR VENT
- EXHAUST FAN
- 5/8" GYP. BOARD CEILING AFFIXED TO 3 5/8" MTL STUDS
- 2x2' SUSPENDED ACOUSTIC CEILING TILE CEILING
- 2x4' SUSPENDED ACOUSTIC CEILING TILE CEILING


REFLECTED CEILING PLAN NOTES

- REFER TO ELECTRICAL SHEETS FOR FIXTURE TYPES, SWITCHING, AND SPECIAL SYSTEMS.
- REFER TO MECHANICAL SHEETS FOR DIFFUSER AND DUCTING LAYOUTS.
- SEE SHEET 00-GI-006 FOR TYPICAL ACOUSTICAL PANEL CEILING DETAILS

PROJECT KEY PLAN

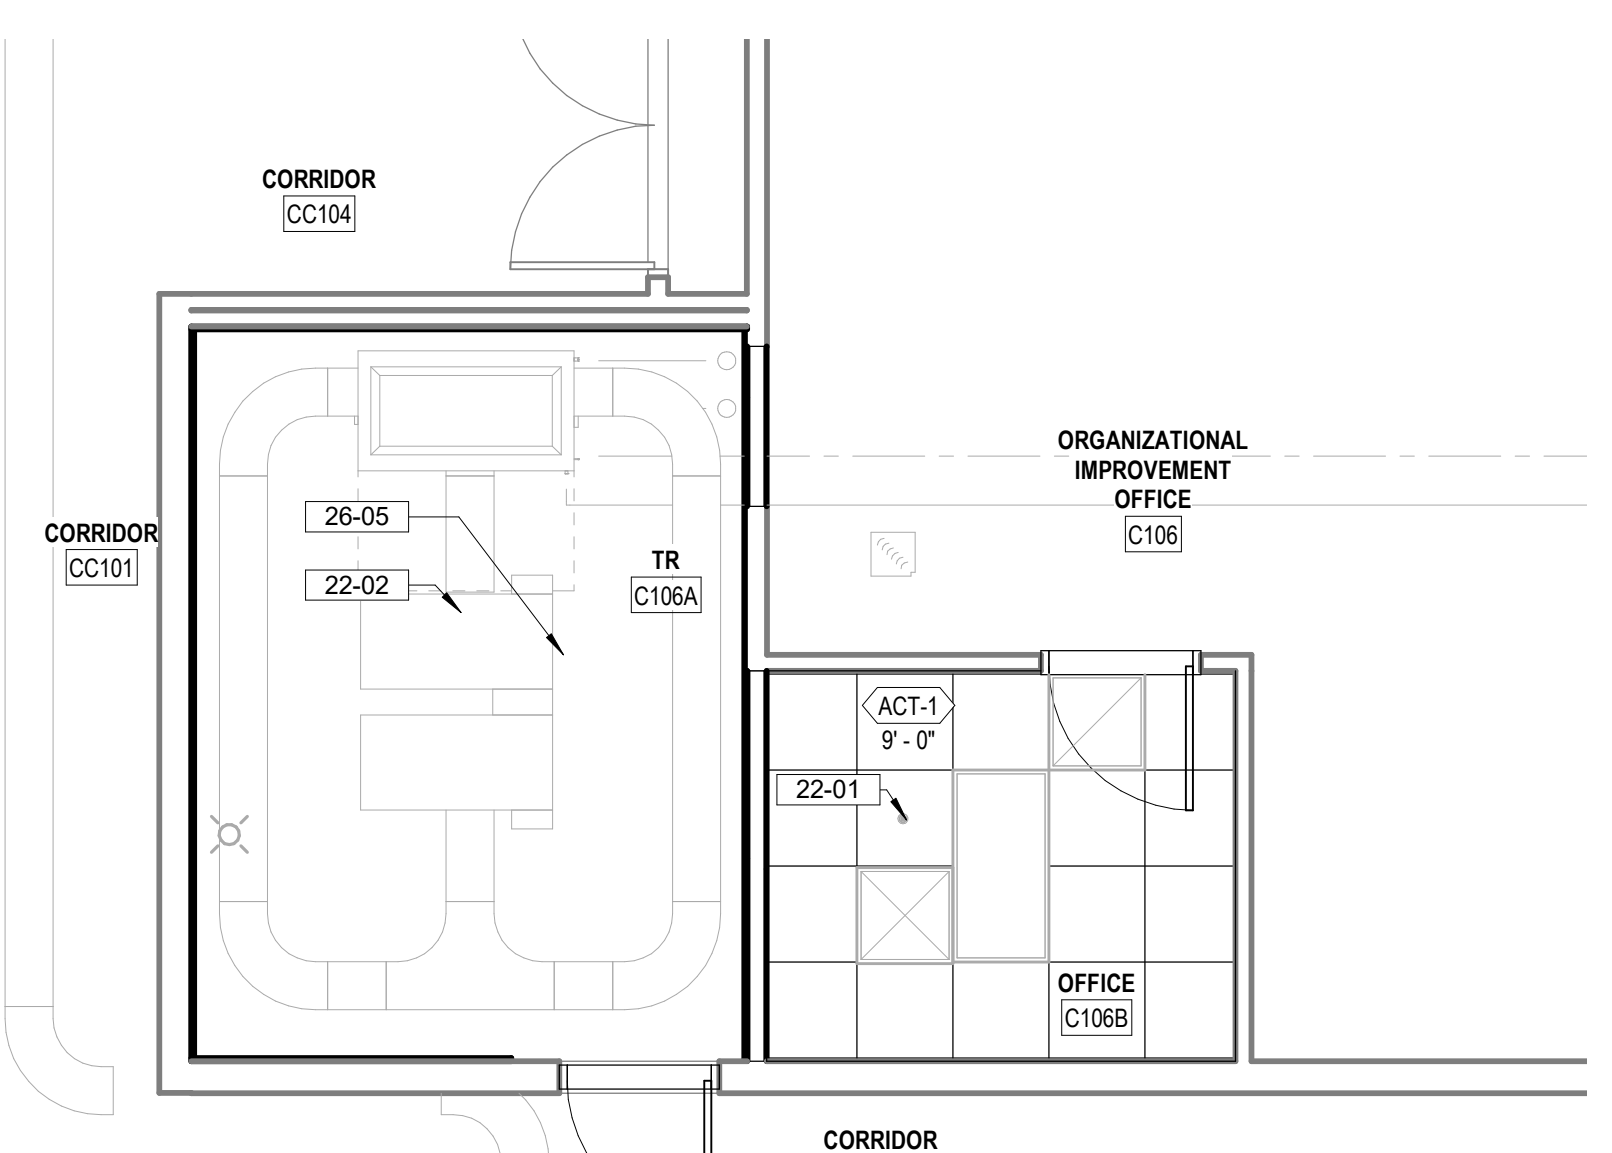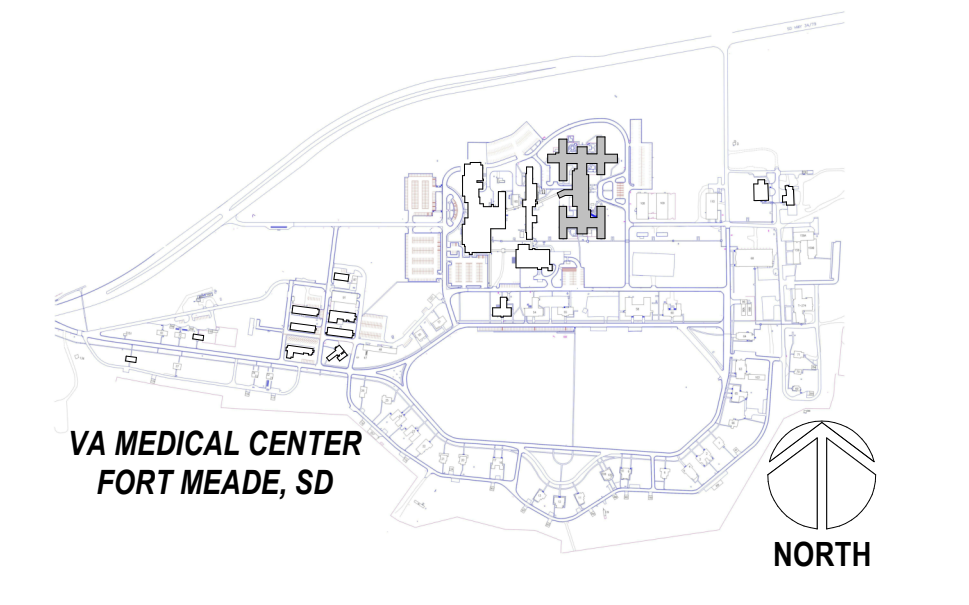

4 LEVEL 1 - TR C106A REFLECTED CEILING PLAN
1/4" = 1'-0"

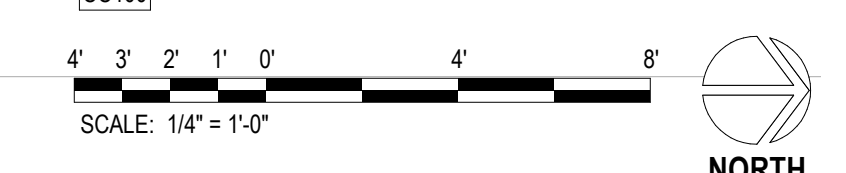

Revisions:	Date:

CONSULTANT
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541.436.4723
ADAM GODDIN, PE

ARCHITECT/ENGINEER OF RECORD
ARCHITECT
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124 NORTH 29TH STREET, #100
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406.248.2633
T. MARCELLO PIERROTTET, AIA

STAMP


PROGRAM CONTRACTING ACTIVITY CENTRAL (PCAC)
VA U.S. Department of Veterans Affairs

DRAWING TITLE
148-ENLARGED PLANS AND TR ELEVATIONS
APPROVED: Project Director


PHASE
100% CONSTRUCTION DOCUMENTS
FLS
FULLY SPRINKLERED

PROJECT TITLE
EHRM INFRASTRUCTURE UPGRADES
LOCATION
FORT MEADE, SOUTH DAKOTA
ISSUE DATE
04/15/2022
CHECKED BY
TMP
DRAWN BY
JPR


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BUILDING NUMBER
BLDG 148
DRAWING NUMBER
148-AE-301

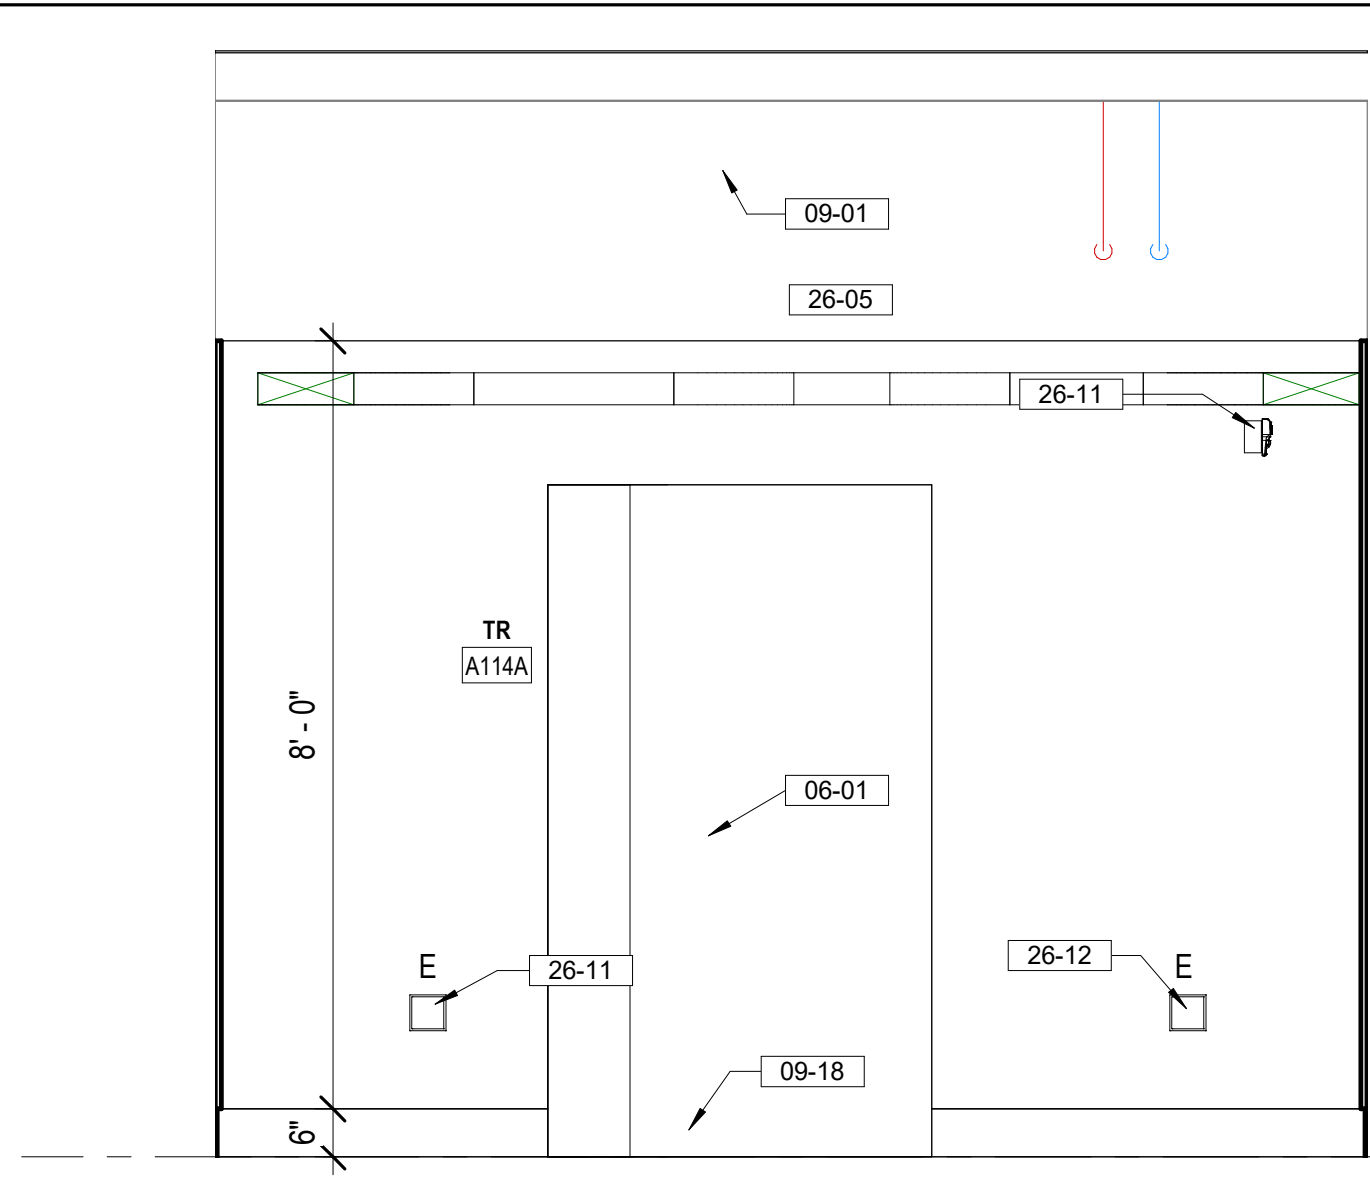


2 TR AC101A EAST ELEVATION
1/2" = 1'-0"

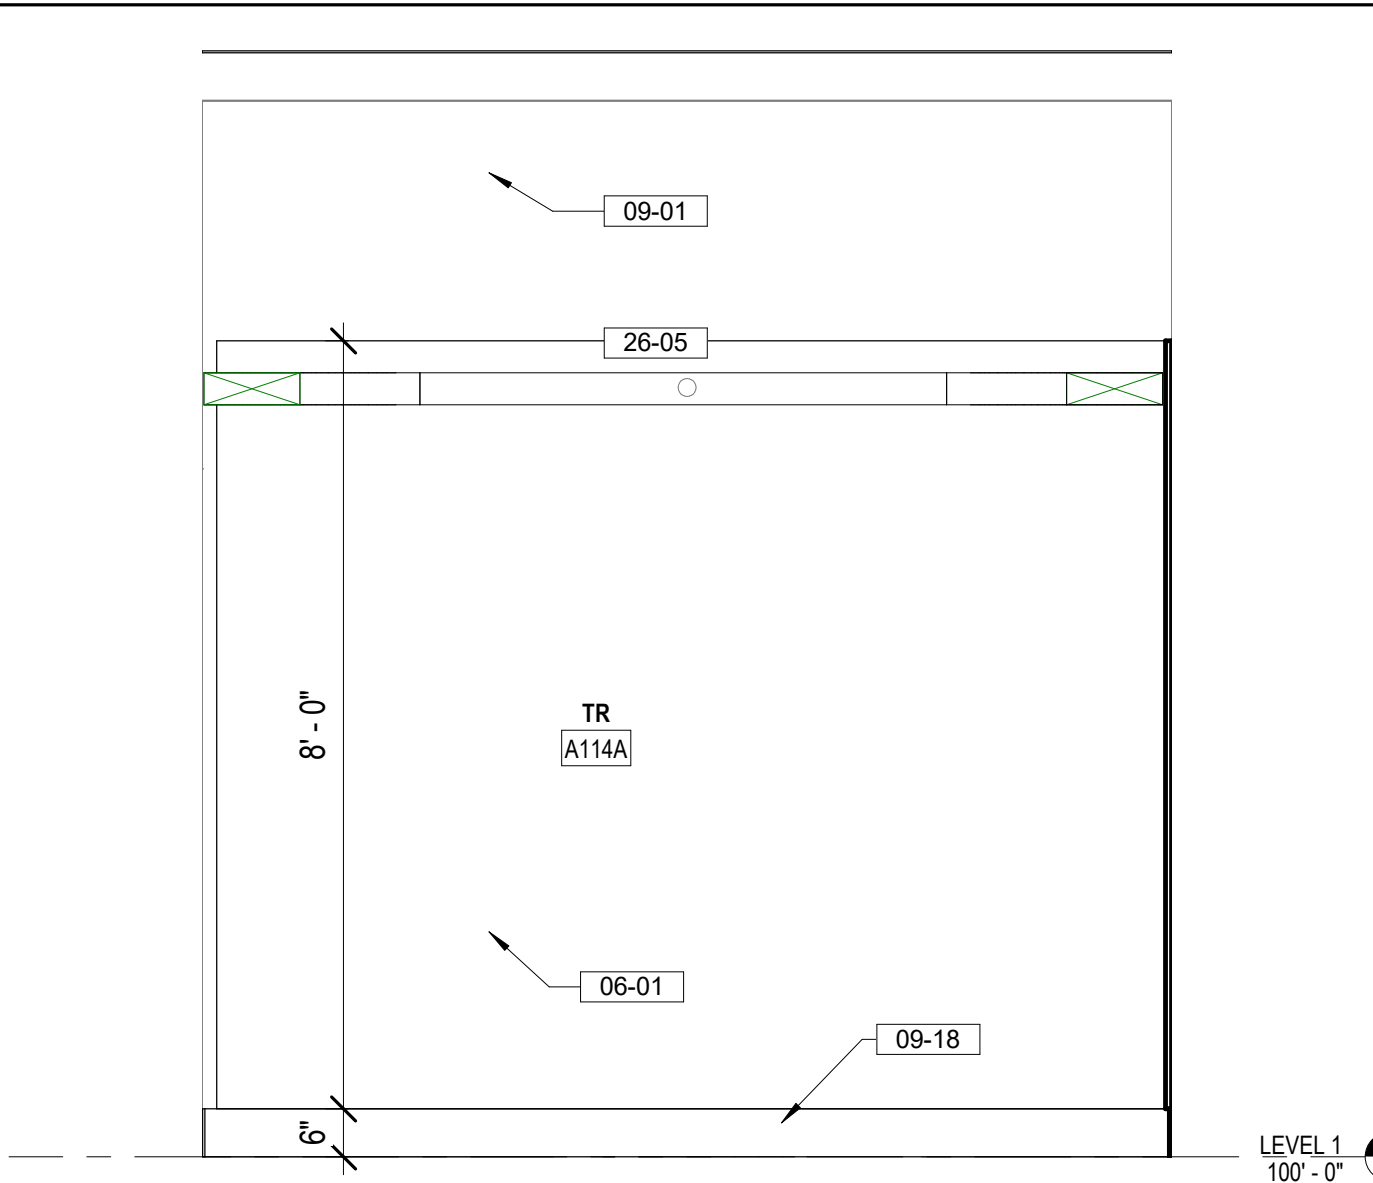

4 TR AC101A NORTH ELEVATION
1/2" = 1'-0"

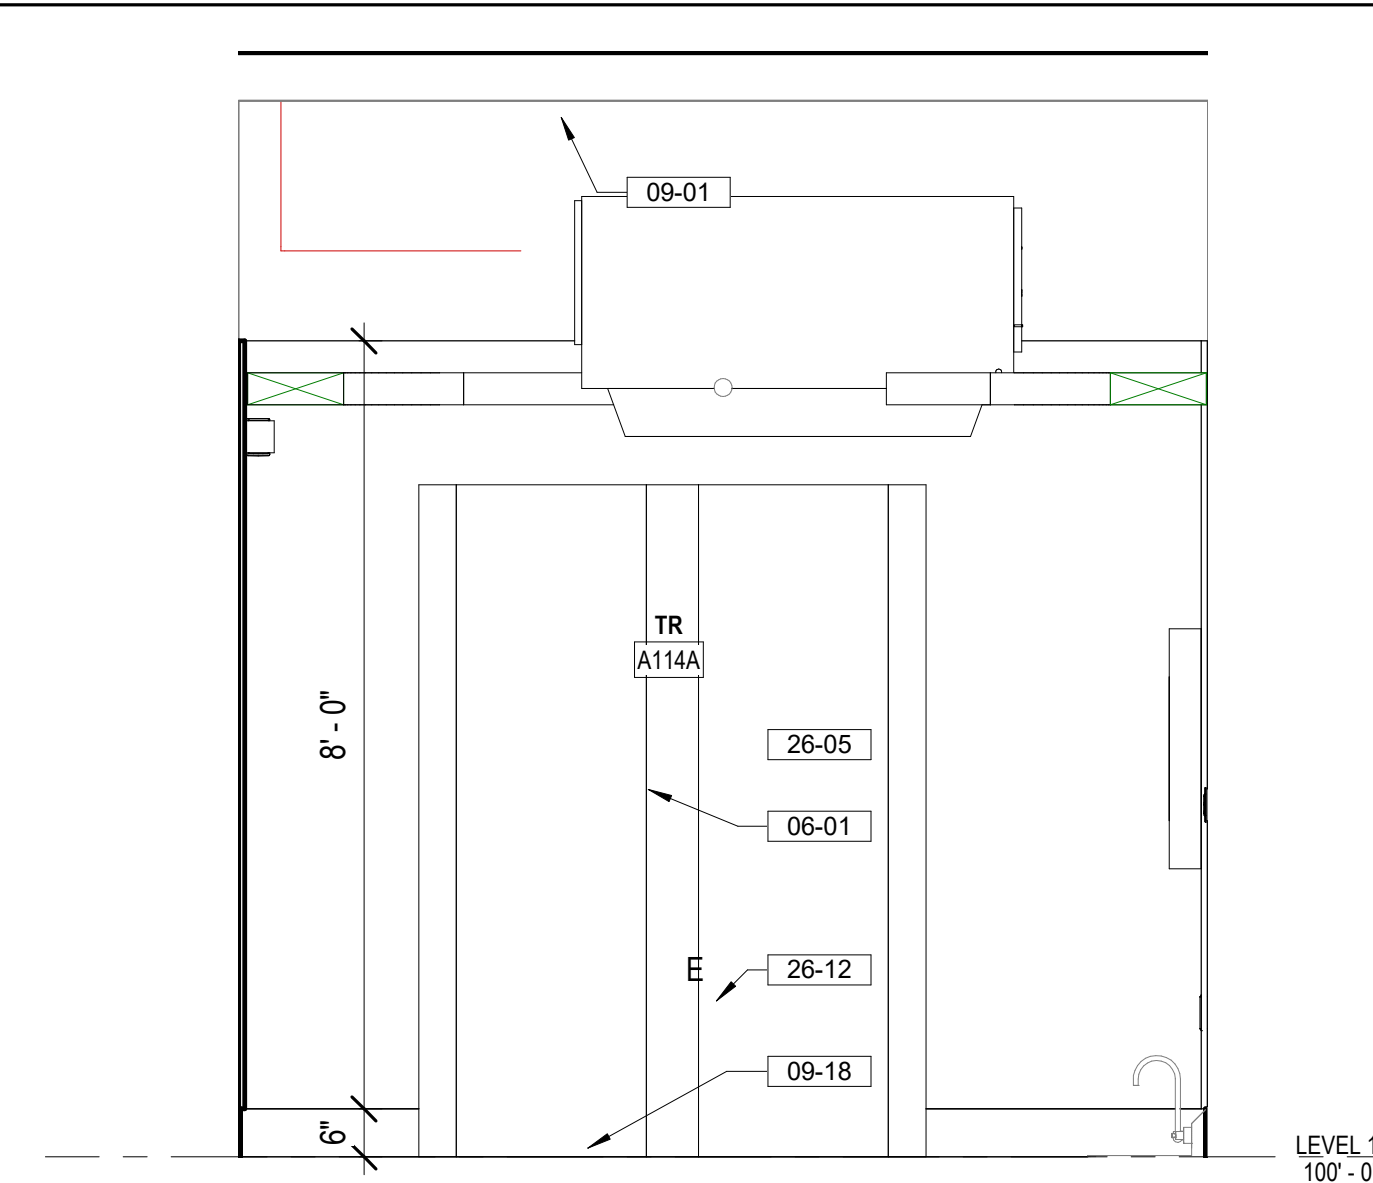

5 TR AC101A SOUTH ELEVATION
1/2" = 1'-0"

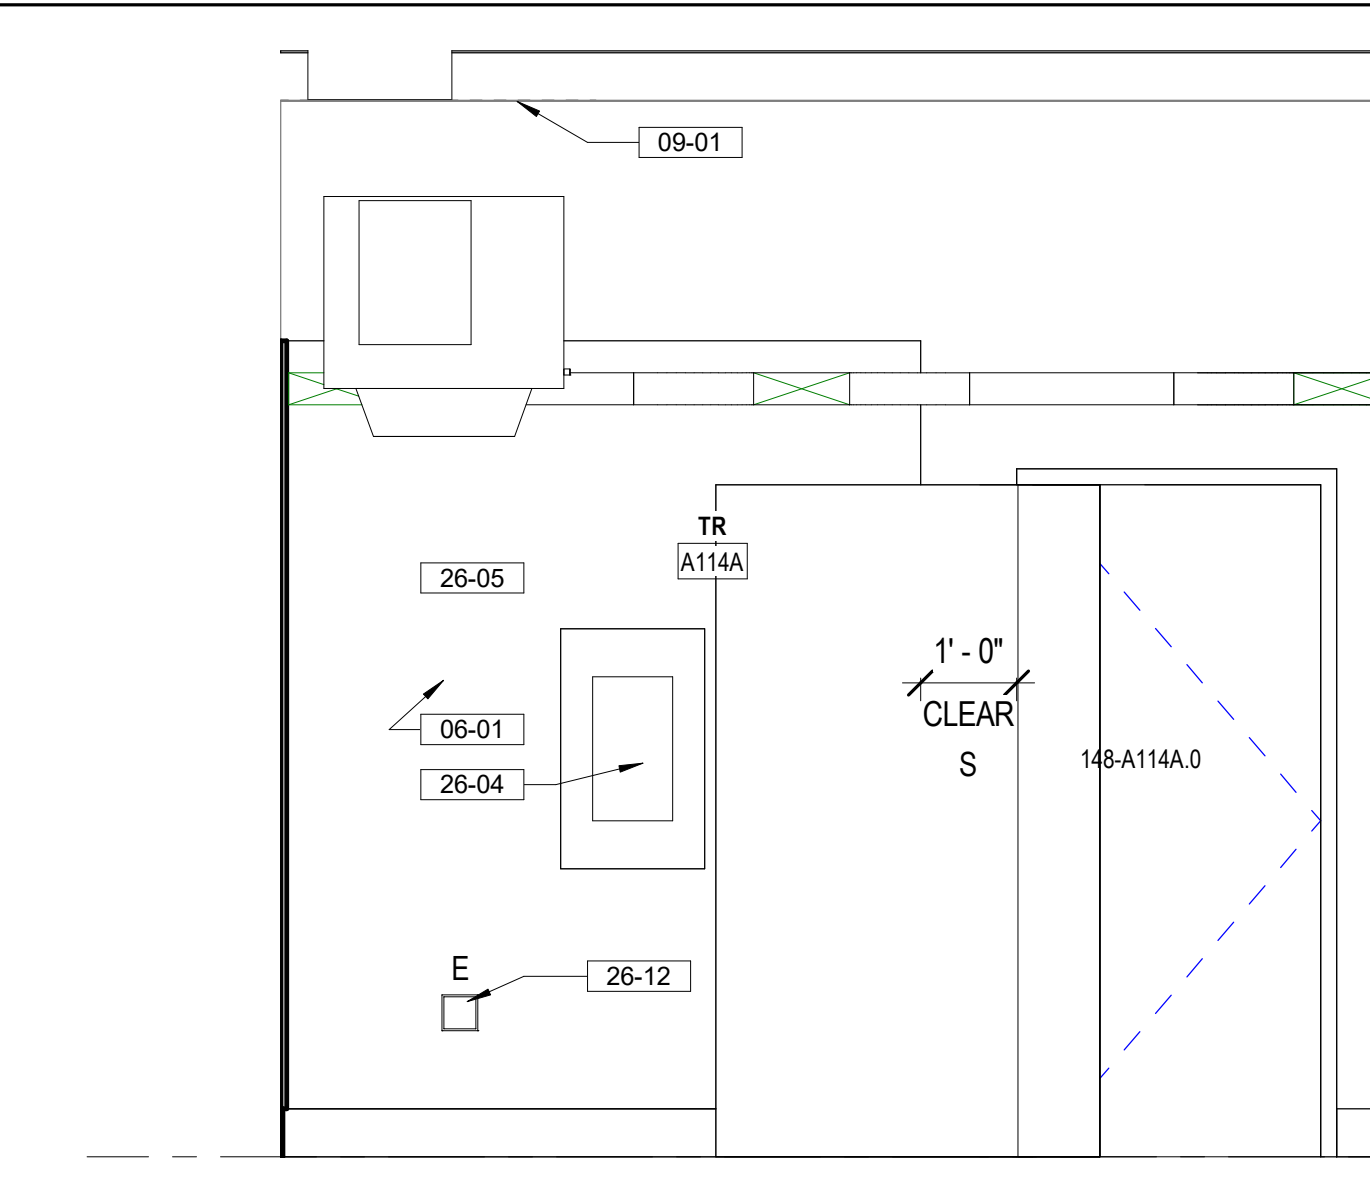

8 TR AC101A WEST ELEVATION
1/2" = 1'-0"

FLOOR PLAN NOTES


- SEE G SERIES SHEETS FOR BALANCE OF FLOOR PLAN GENERAL NOTES.
- REFER TO STRUCTURAL, MECHANICAL, AND ELECTRICAL DRAWINGS FOR ADDITIONAL INFORMATION. ALL INFORMATION REGARDING EXISTING CONDITIONS IS BASED UPON OWNER-SUPPLIED DOCUMENTS AND MAY NOT PRECISELY REFLECT FIELD CONDITIONS.
- PROVIDE ALL BACKING FOR MILLWORK, GRAB BARS, AND ANY AND ALL WALL MOUNTED EQUIPMENT OR ACCESSORIES, COORDINATE LOCATIONS.
- ALL DIMENSIONS ARE FROM STRUCTURAL OR UNFINISHED FACE OF STUD, UNLESS OTHERWISE NOTED.
- PROVIDE A SMOOTH AND LEVEL FINISH FLOOR. TYP. PATCH AND REPAIR ALL INCONSISTENCIES IN FLOOR ELEVATIONS.
- PATCH AND REPAIR ANY / ALL WALL SURFACES AS REQUIRED TO PROVIDE SUITABLE SUBSTRATE FOR FINISHES.
- REFER TO DOOR AND FRAME SCHEDULE FOR DOORS REQUIRING ADA ACCESS CONTROL.
- PROVIDE ACOUSTICAL SEALANT AROUND WALL EDGES, TOP AND BOTTOM, AND PENETRATIONS, AND INSTALL PUTTY PADS AROUND ELECTRICAL BOXES WHERE PARTITION CONTAINS ACOUSTICAL INSULATION.
- ALL TELECOMMUNICATION ROOMS ARE TO HAVE EXPOSED STRUCTURE UNLESS NOTED OTHERWISE, NO CEILINGS SPECIFIED.

KEY NOTES


- 06-01 INSTALL 3/4" AC GRADE OR BETTER FIRE RETARDANT PLYWOOD. PAINT WITH TWO COATS OF SEMI-GLOSS BRIGHT WHITE FIRE RETARDANT PAINT; MOUNT BOTTOM OF PLYWOOD 6" A.F.F., TOP OF PLYWOOD AT 8'-6" A.F.F.; DO NOT PAINT OVER STAMPED PLYWOOD RATING
- 09-01 PAINT WALL ABOVE PLYWOOD WITH SEMI-GLOSS PAINT, COLOR TO MATCH PLYWOOD PAINT.
- 09-07 INSTALL STATIC DISSIPATIVE RESILIENT FLOORING
- 09-18 6" HIGH COVERED RUBBER WALL BASE, COLOR TO BE SELECTED FROM MANUFACTURER'S STANDARD SELECTION
- 09-25 PATCH AND REPAIR ANY GYPSUM BOARD OPENINGS FOUND AT PERIMETER OF WALL ENSURING NO VISIBLE EVIDENCE OF PATCH, SEAL PERIMETER OF ROOM IN ITS ENTIRETY, PAINT.
- 09-29 INSTALL NEW FLOORING TO MATCH EXISTING SIMILAR USE ROOM
- 22-01 FIRE SUPPRESSION SPRINKLER HEAD SHOWN FOR REFERENCE ONLY; FIRE SUPPRESSION CONTRACTOR TO VERIFY ACTUAL QUANTITIES REQUIRED, INSTALL SYMMETRICALLY CENTER IN TILE.
- 22-02 UPRIGHT HEAD FIRE SUPPRESSION SPRINKLER HEAD SHOWN FOR REFERENCE ONLY; FIRE SUPPRESSION CONTRACTOR TO VERIFY ACTUAL QUANTITIES REQUIRED, COORDINATE INSTALLATION WITH MEPT DRAWINGS
- 23-08 NEW REFRIGERANT PIPE LINES ROUTING SHOWN FOR REFERENCE ONLY. SEE MECHANICAL DRAWINGS FOR ACTUAL ROUTING; CONTRACTOR TO REMOVE CEILING TILES ALONG ROUTE OUTSIDE OF TRS AND REPLACE WITHIN WORKING SHIFT. CONDUCT INSPECTION PREVENTION MEASURES AS SPECIFIED
- 26-02 3" PERIMETER CLEARANCE AROUND SERVER RACK SHOWN DASHED
- 26-03 TELECOMM RACK, SEE TELECOMMUNICATION DRAWINGS
- 26-04 ELECTRICAL PANELS, SEE ELECTRICAL DRAWINGS
- 26-11 STROBE LIGHT, SEE ELECTRICAL DRAWINGS
- 26-12 ELECTRICAL OUTLETS MOUNTED ON PLYWOOD

REFLECTED CEILING PLAN NOTES


- REFER TO ELECTRICAL SHEETS FOR FIXTURE TYPES, SWITCHING, AND SPECIAL SYSTEMS.
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- SEE SHEET 00-GI-006 FOR TYPICAL ACOUSTICAL PANEL CEILING DETAILS

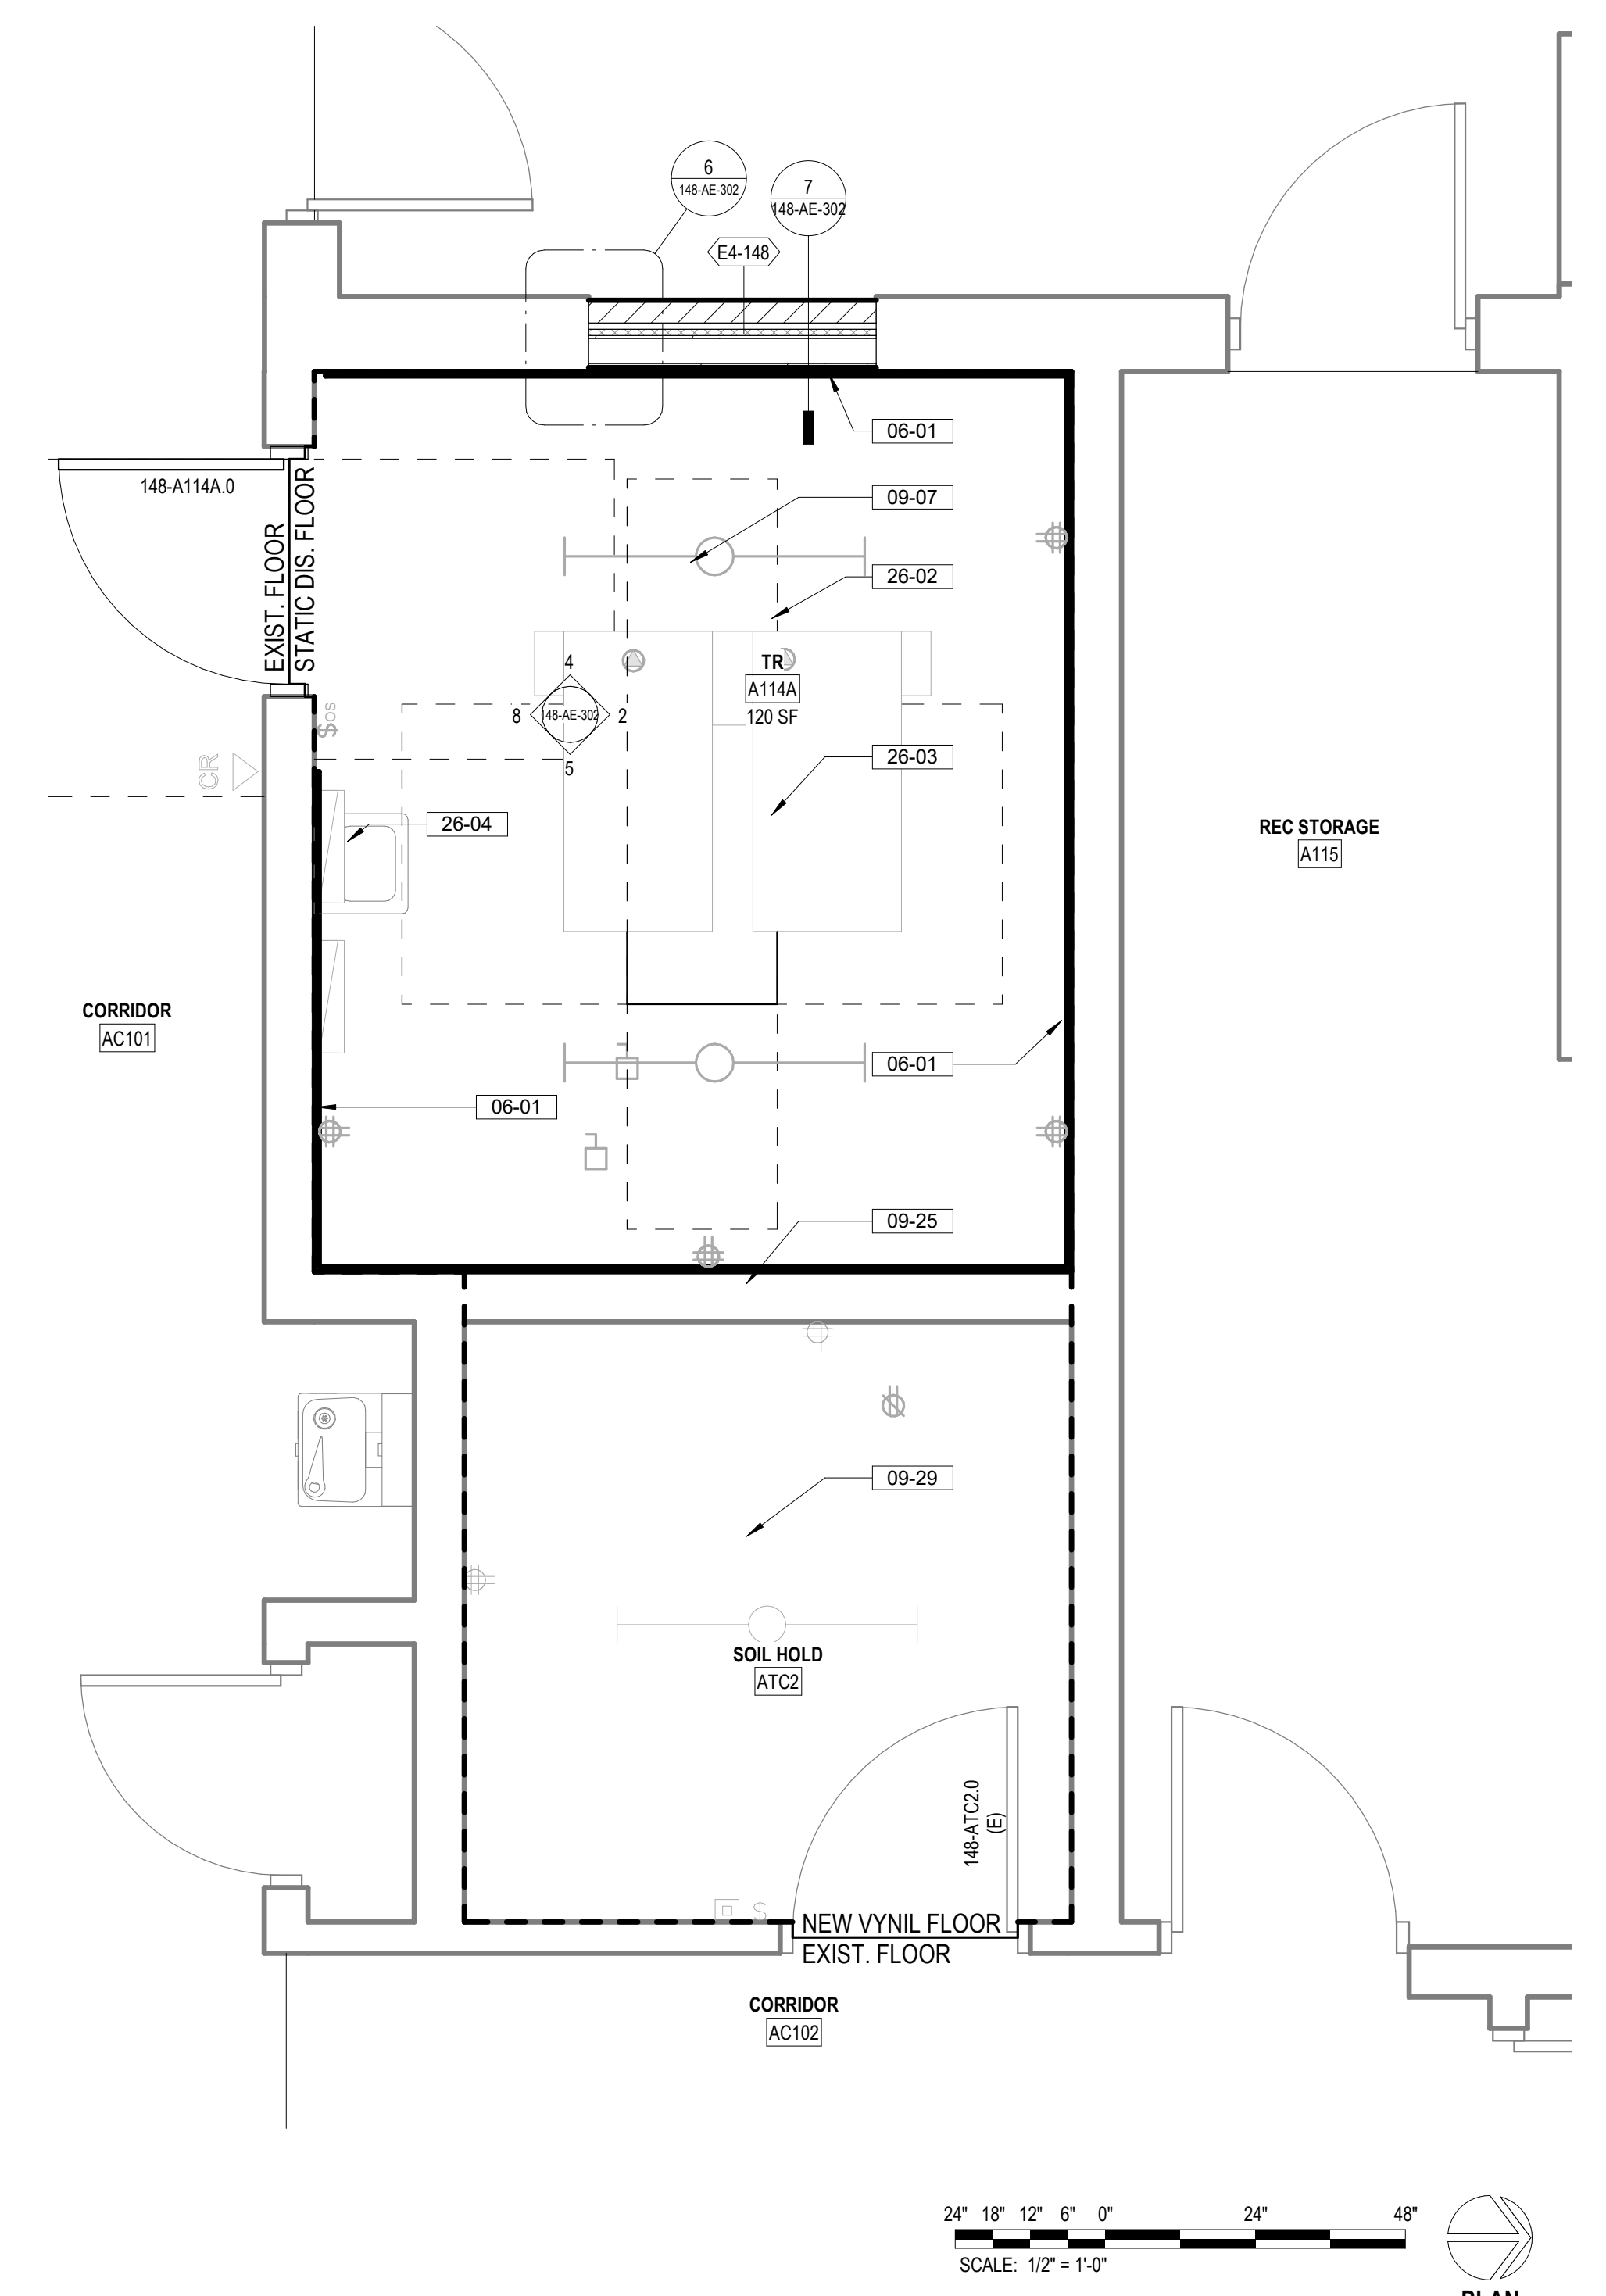


1 148 - ATC2 ENLARGED PLAN
1/2" = 1'-0"

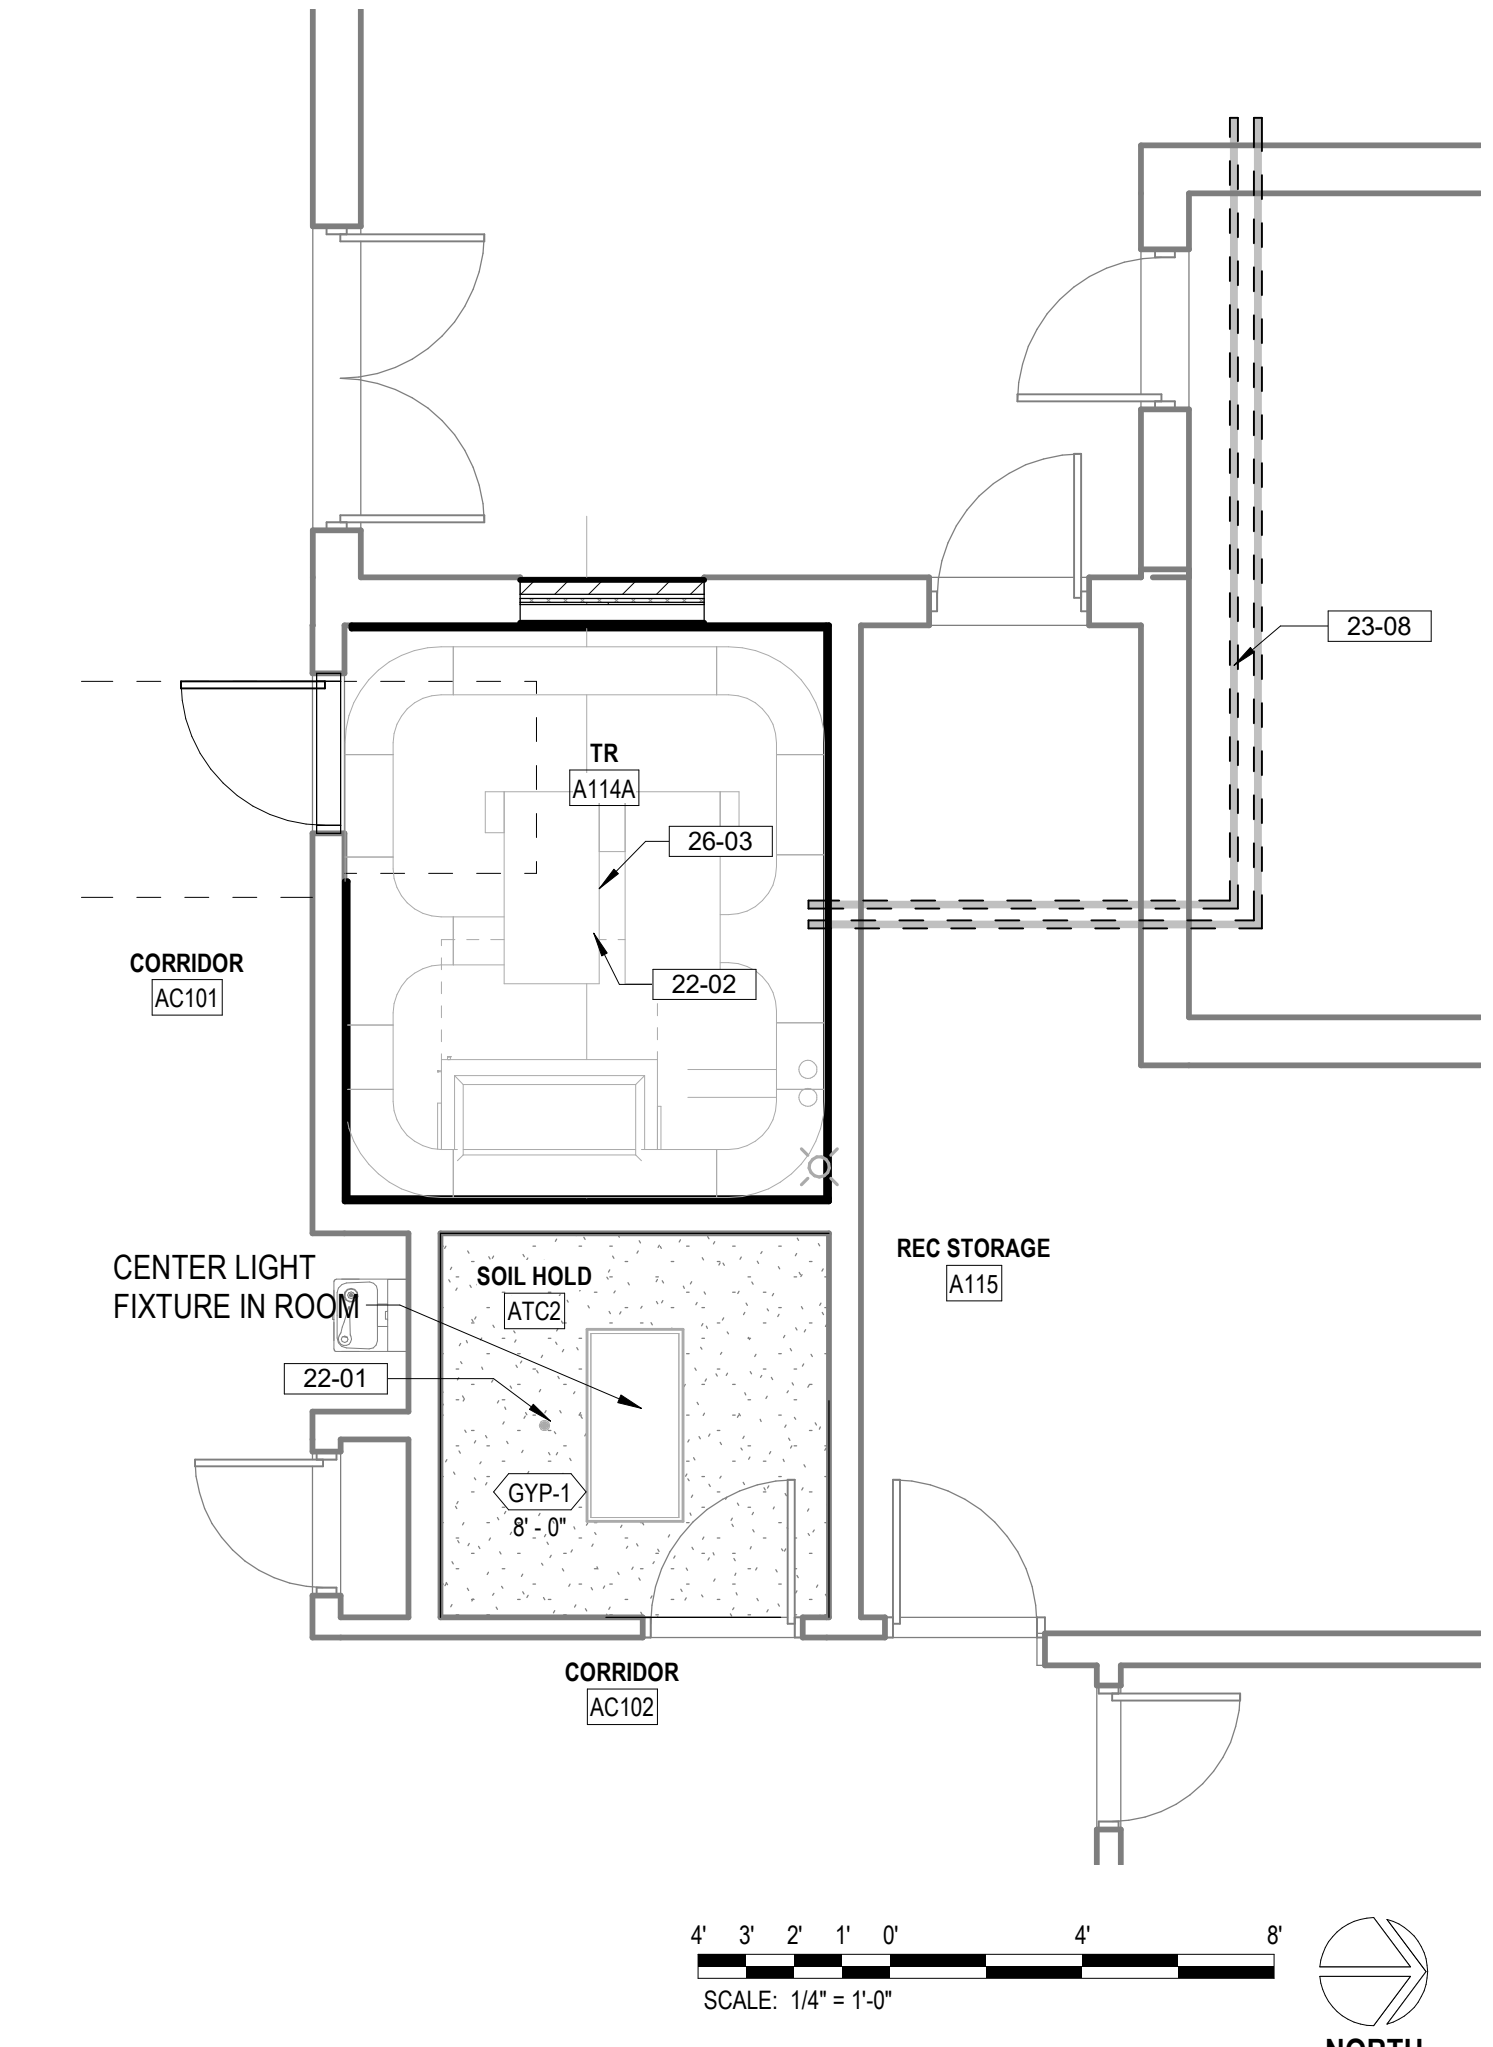

3 LEVEL 1 - ENLARGED REFLECTED CEILING PLAN
1/4" = 1'-0"

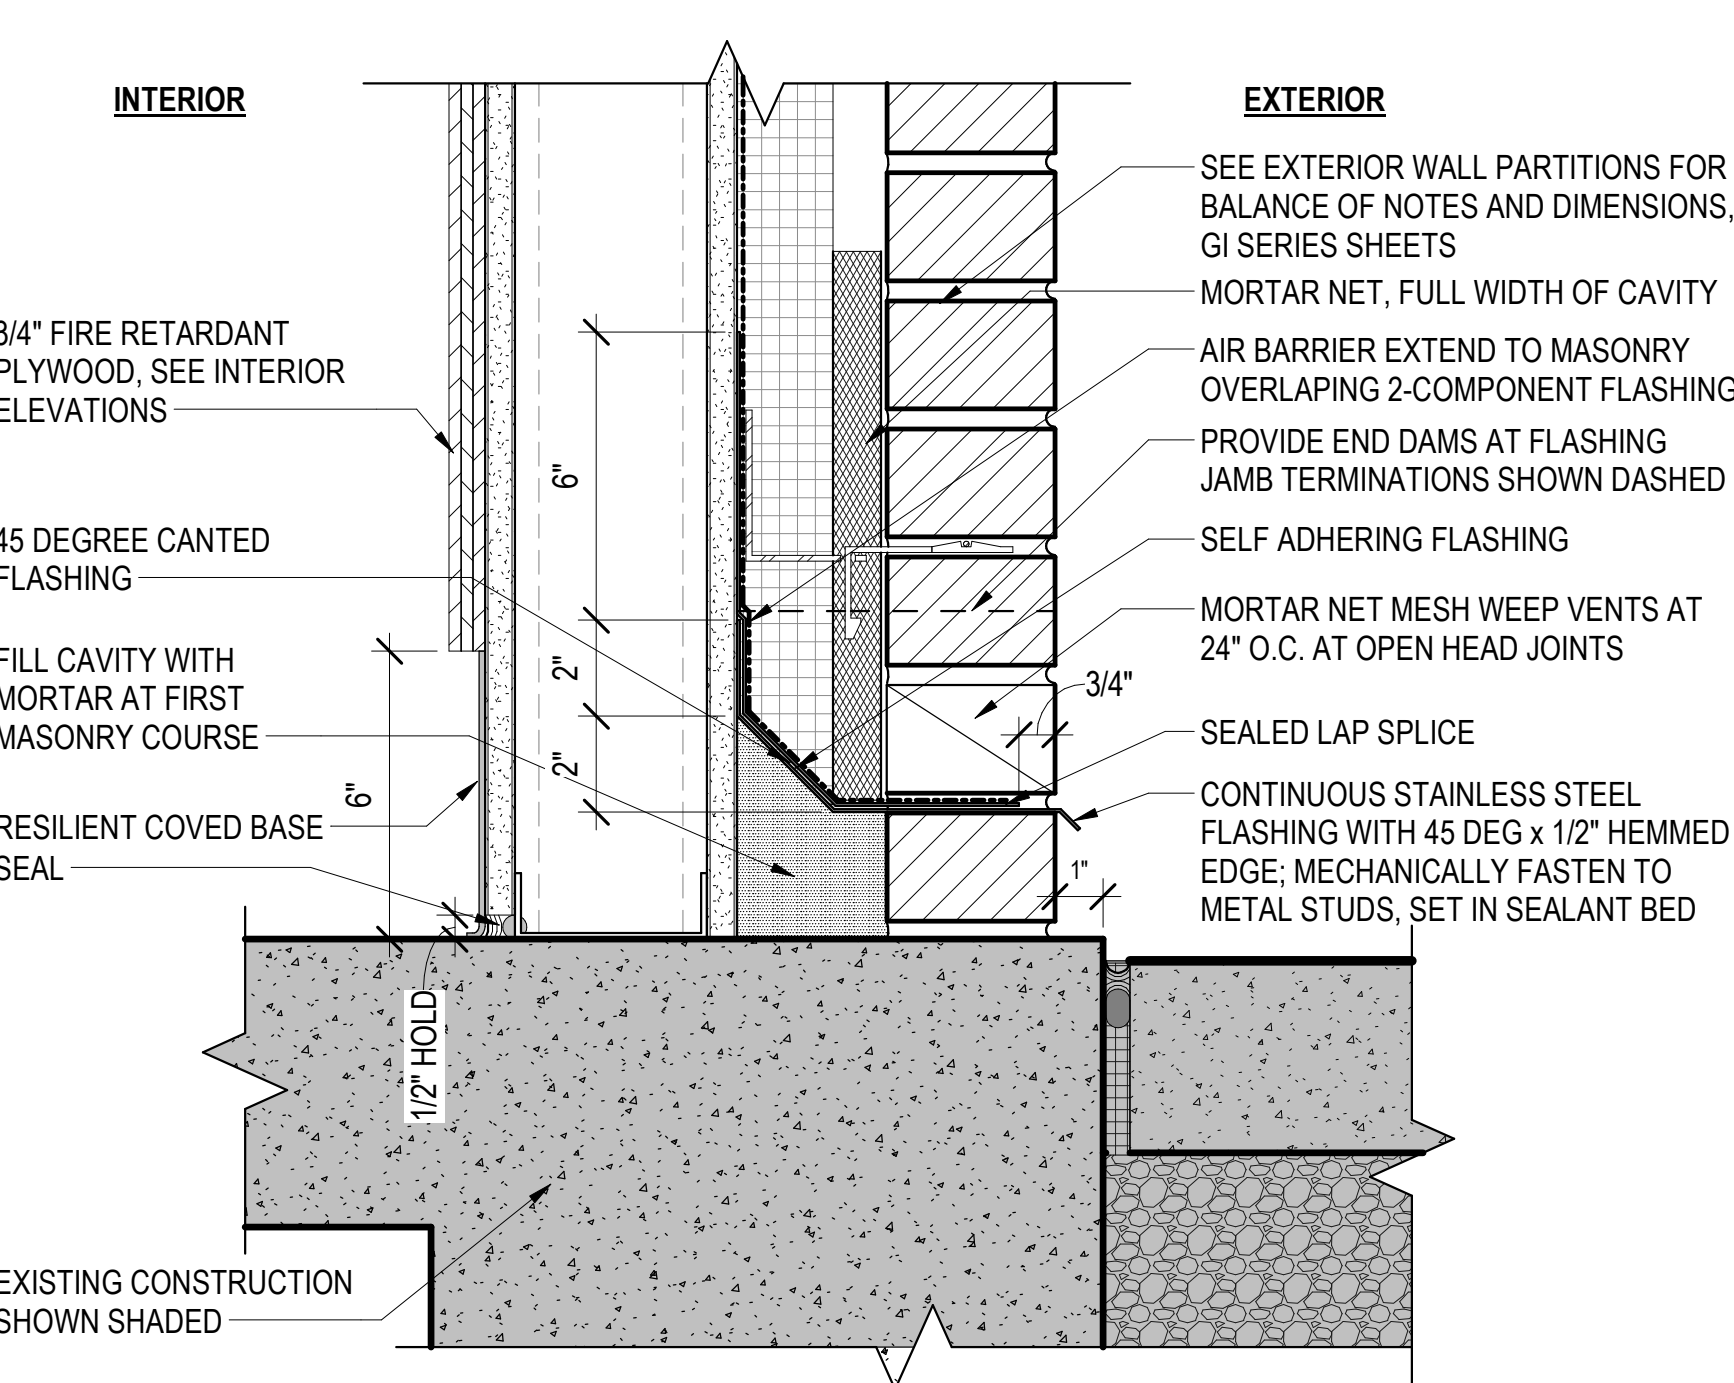

7 MASONRY BASE DETAIL AT BRICK INFIL
3" = 1'-0"

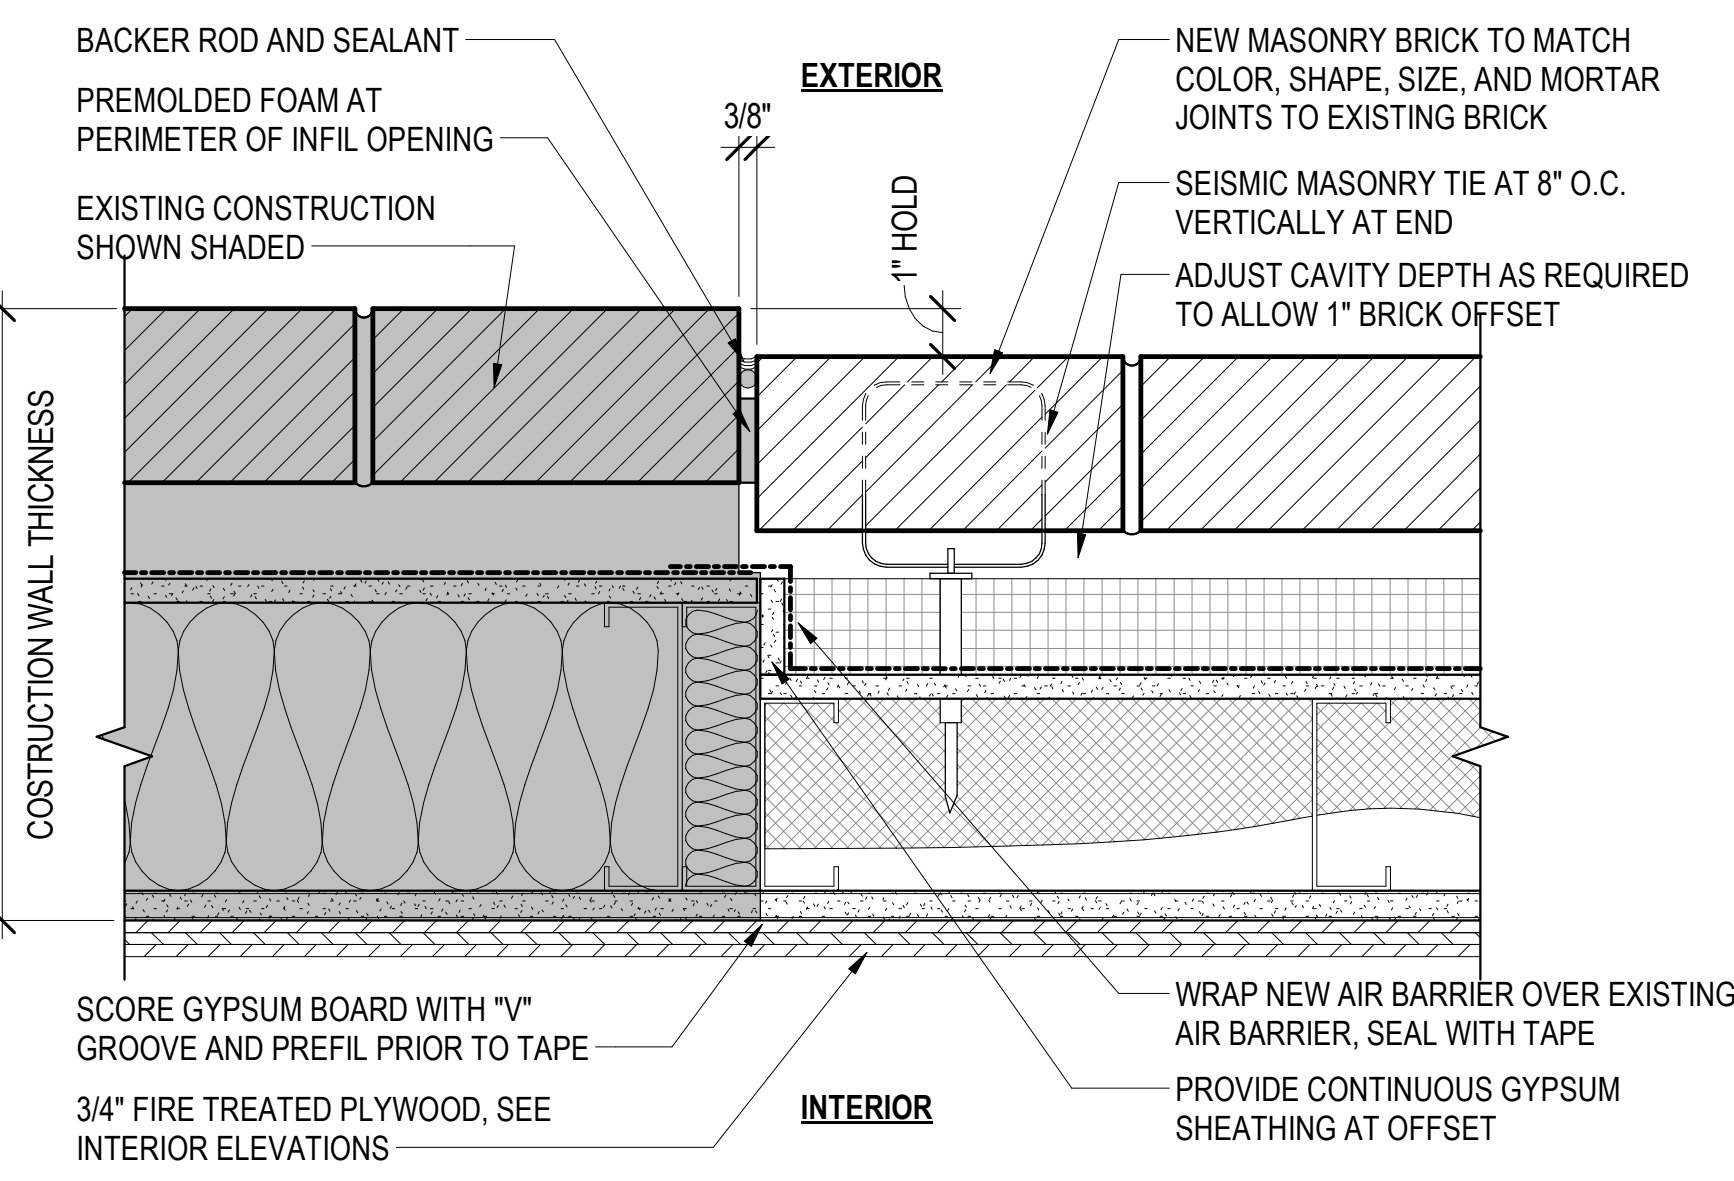

6 JAMB DETAIL AT BRICK INFIL
3" = 1'-0"


FLOOR PLAN LEGEND

- CARD READER, REF TELECOM DRAWINGS
- DATA PORT, REF TELECOM DRAWINGS
- OUTLET, REF ELEC DRAWINGS
- WIRELESS ACCESS POINT, REF TELECOM DRAWINGS
- ELEC PANEL, REF ELEC DRAWINGS
- STRIP LIGHT FIXTURE, REF ELEC DRAWINGS

REFLECTED CEILING PLAN LEGEND

- 2x2 LIGHT FIXTURE
- 2x4 LIGHT FIXTURE
- STRIP LIGHT FIXTURE
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- SUPPLY AIR DIFFUSER
- RETURN AIR VENT
- EXHAUST FAN
- 5/8" GYP. BOARD CEILING AFFIXED TO 3/8" MTL STUDS
- 2'x2' SUSPENDED ACOUSTIC CEILING TILE CEILING
- 2'x4' SUSPENDED ACOUSTIC CEILING TILE CEILING

PROJECT KEY PLAN

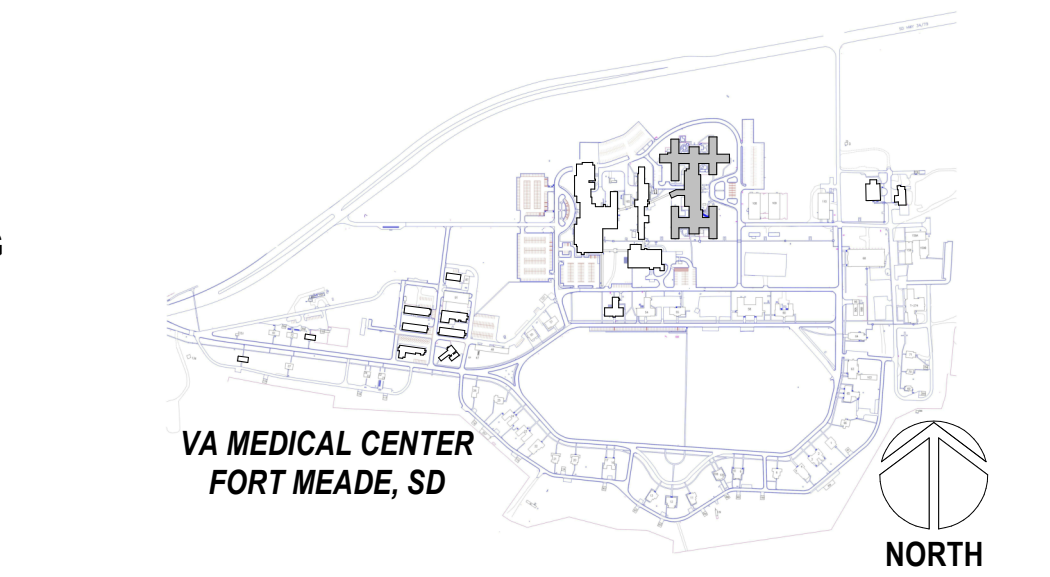

BIM 360/2/112_VA Medical Center - Ft Meade SD 2112_Bldg 148_148_20.rvt

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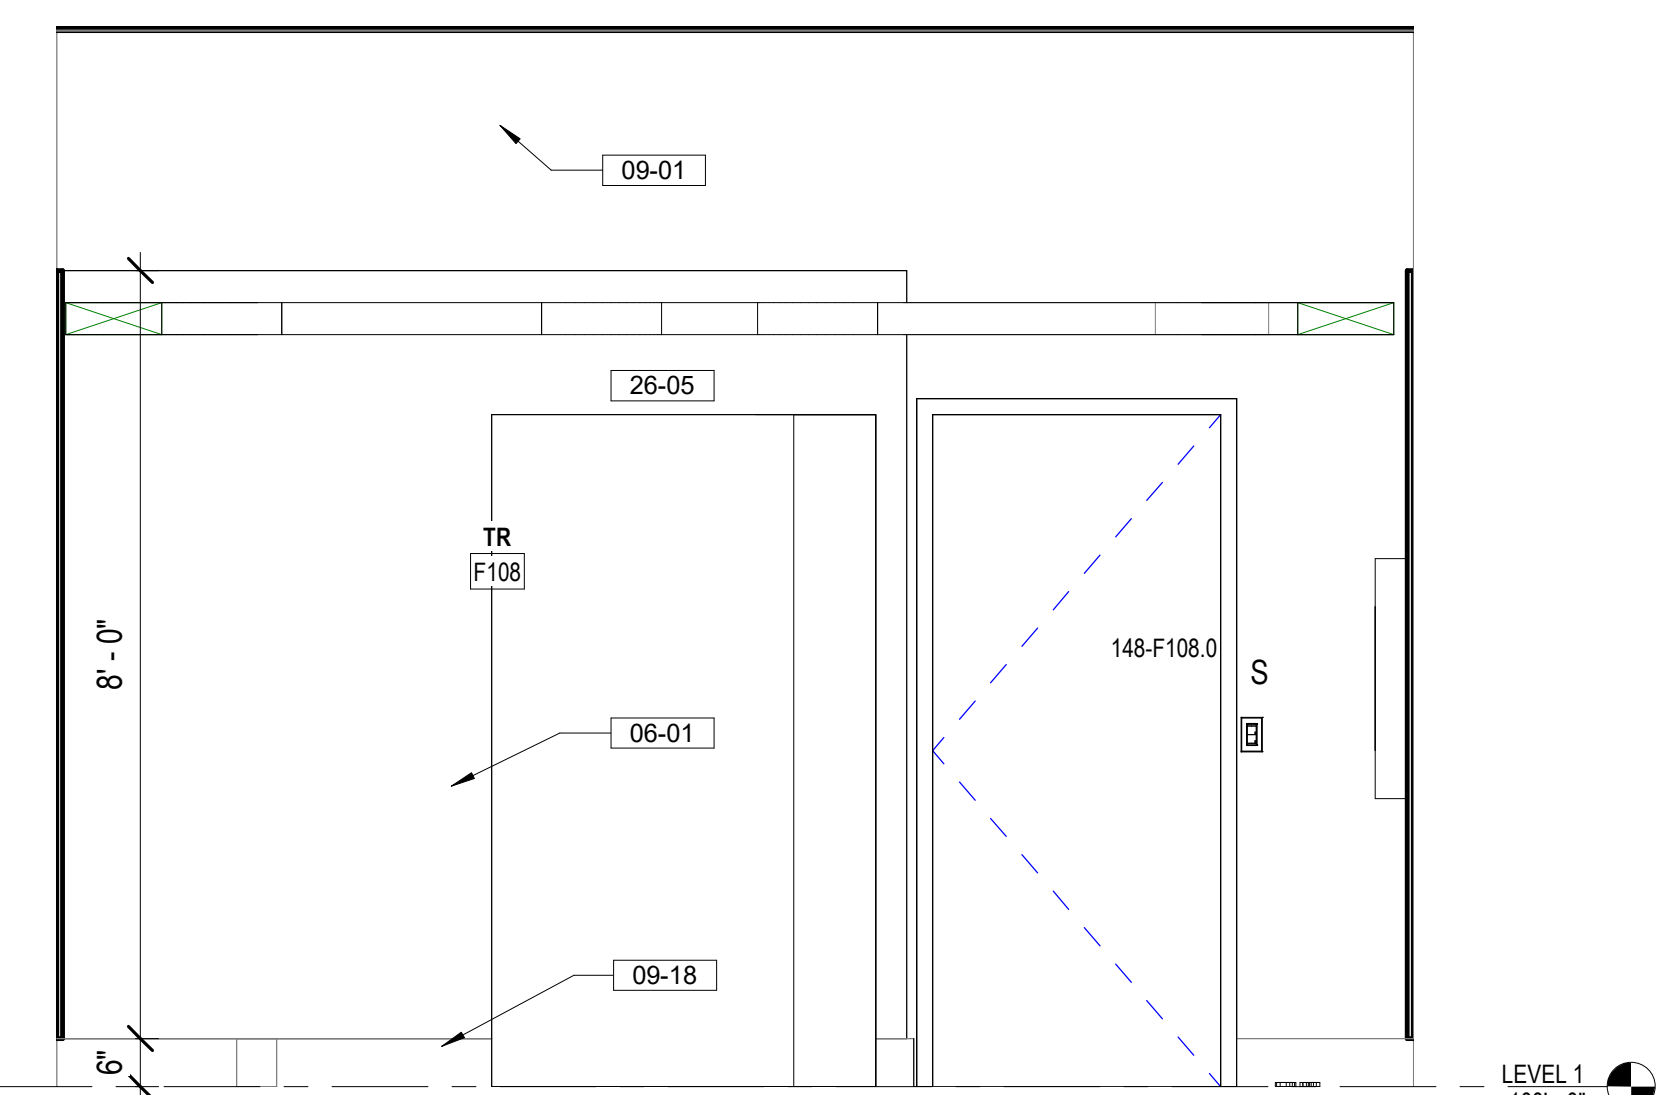
PROGRAM CONTRACTING ACTIVITY CENTRAL (PCAC)
U.S. Department of Veterans Affairs

DRAWING TITLE
148-ENLARGED PLANS AND TR ELEVATIONS
APPROVED: Project Director


PHASE
100% CONSTRUCTION DOCUMENTS
FLS
FULLY SPRINKLERED

PROJECT TITLE
EHRM INFRASTRUCTURE UPGRADES
LOCATION
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ISSUE DATE
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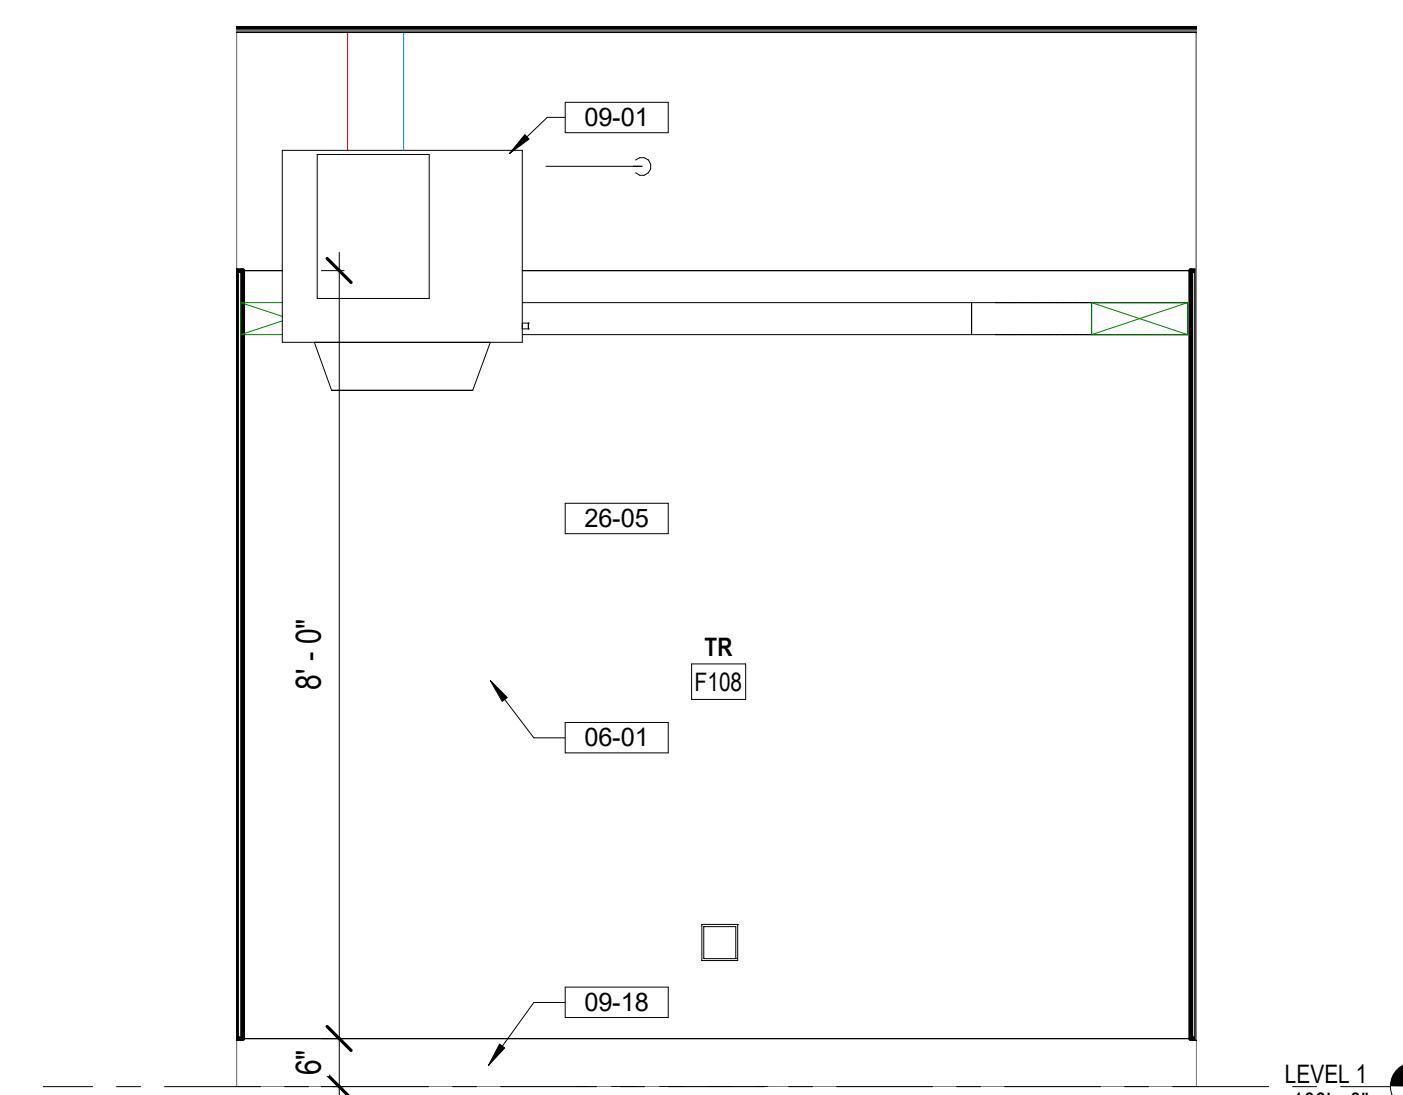
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BUILDING NUMBER
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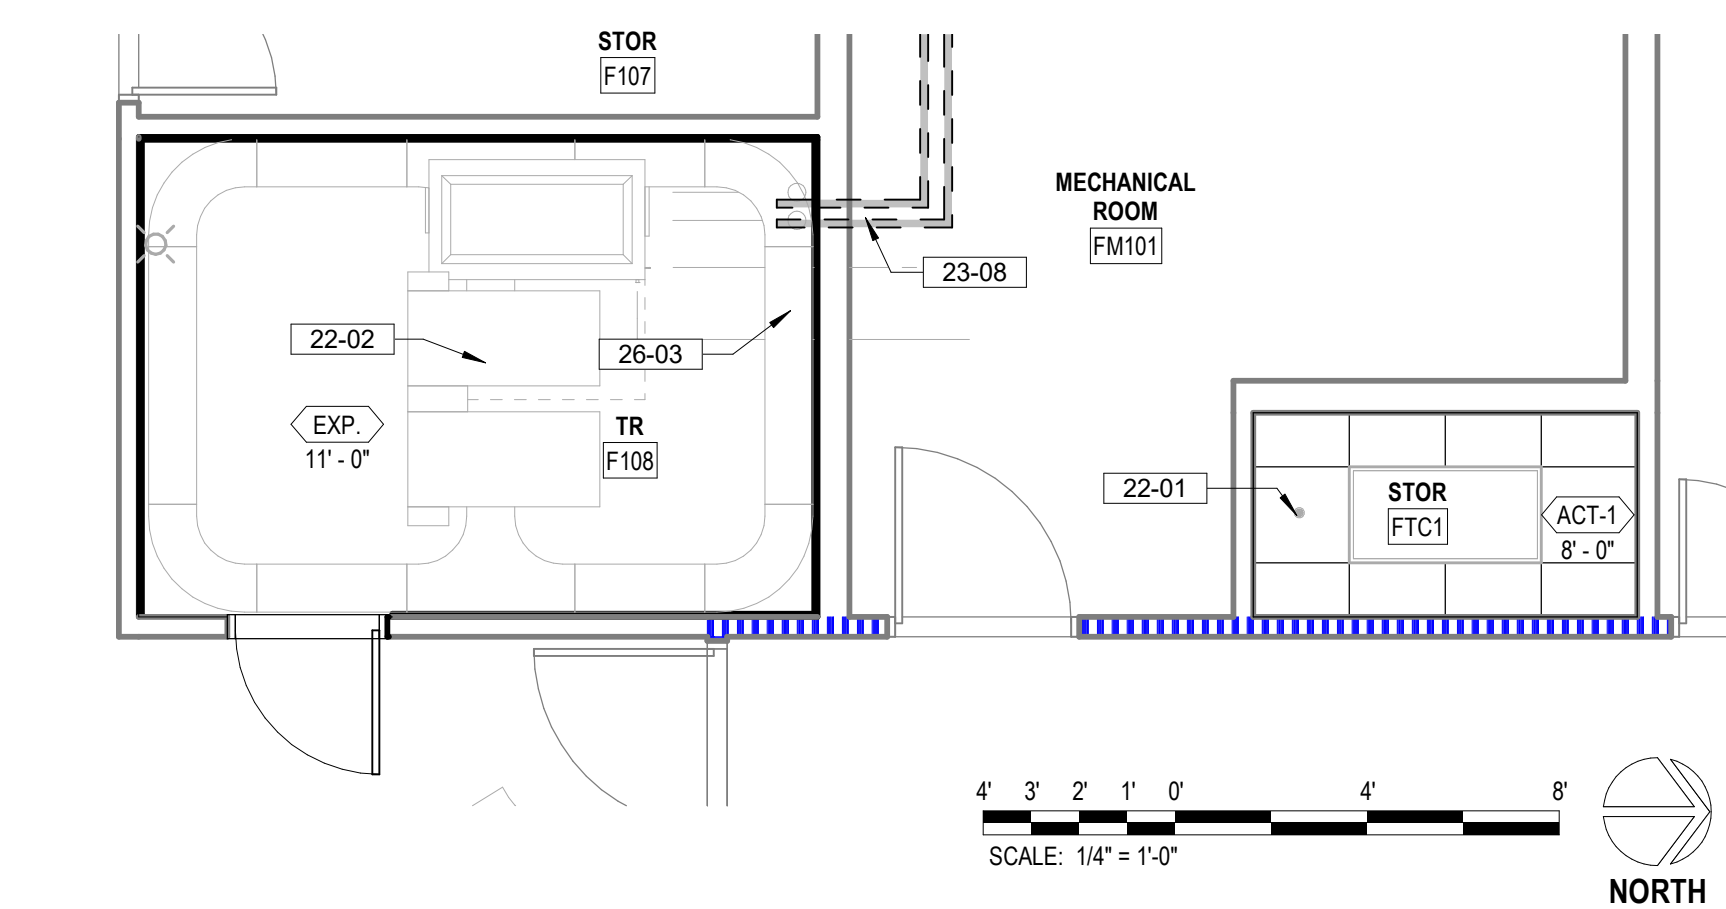
3 F108 EAST ELEVATION
1/2" = 1'-0"




4 TR F108 SOUTH ELEVATION
1/2" = 1'-0"

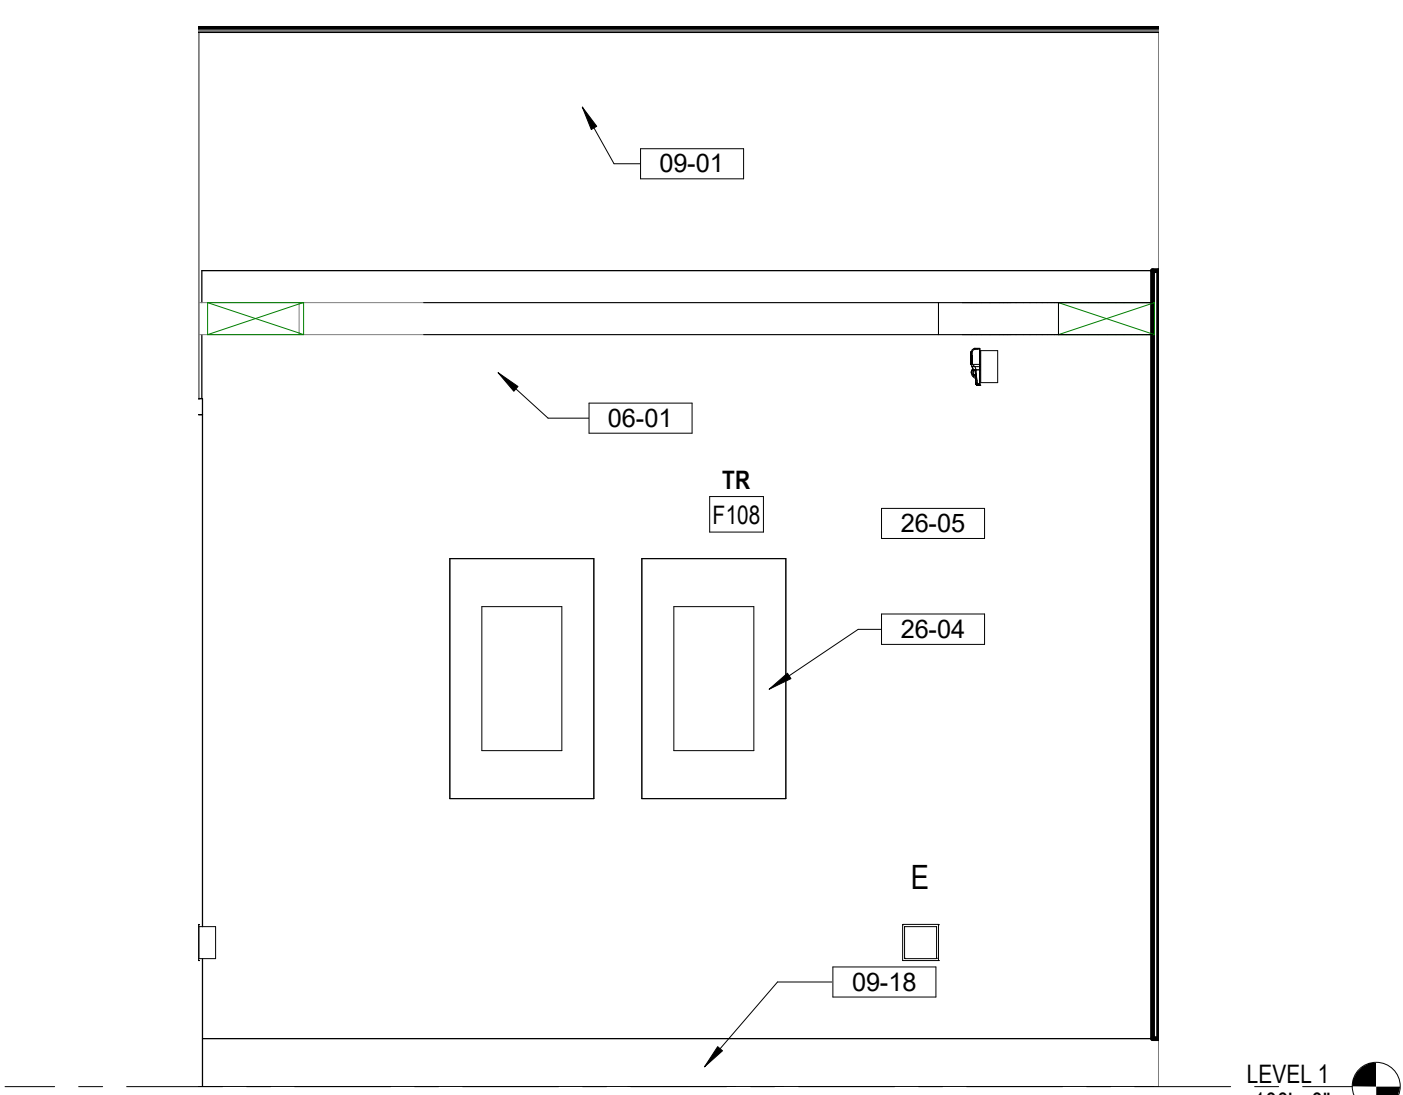


6 F108 NORTH ELEVATION
1/2" = 1'-0"



2 LEVEL 1 - ENLARGED TR F108 REFLECTED CEILING PLAN
1/4" = 1'-0"

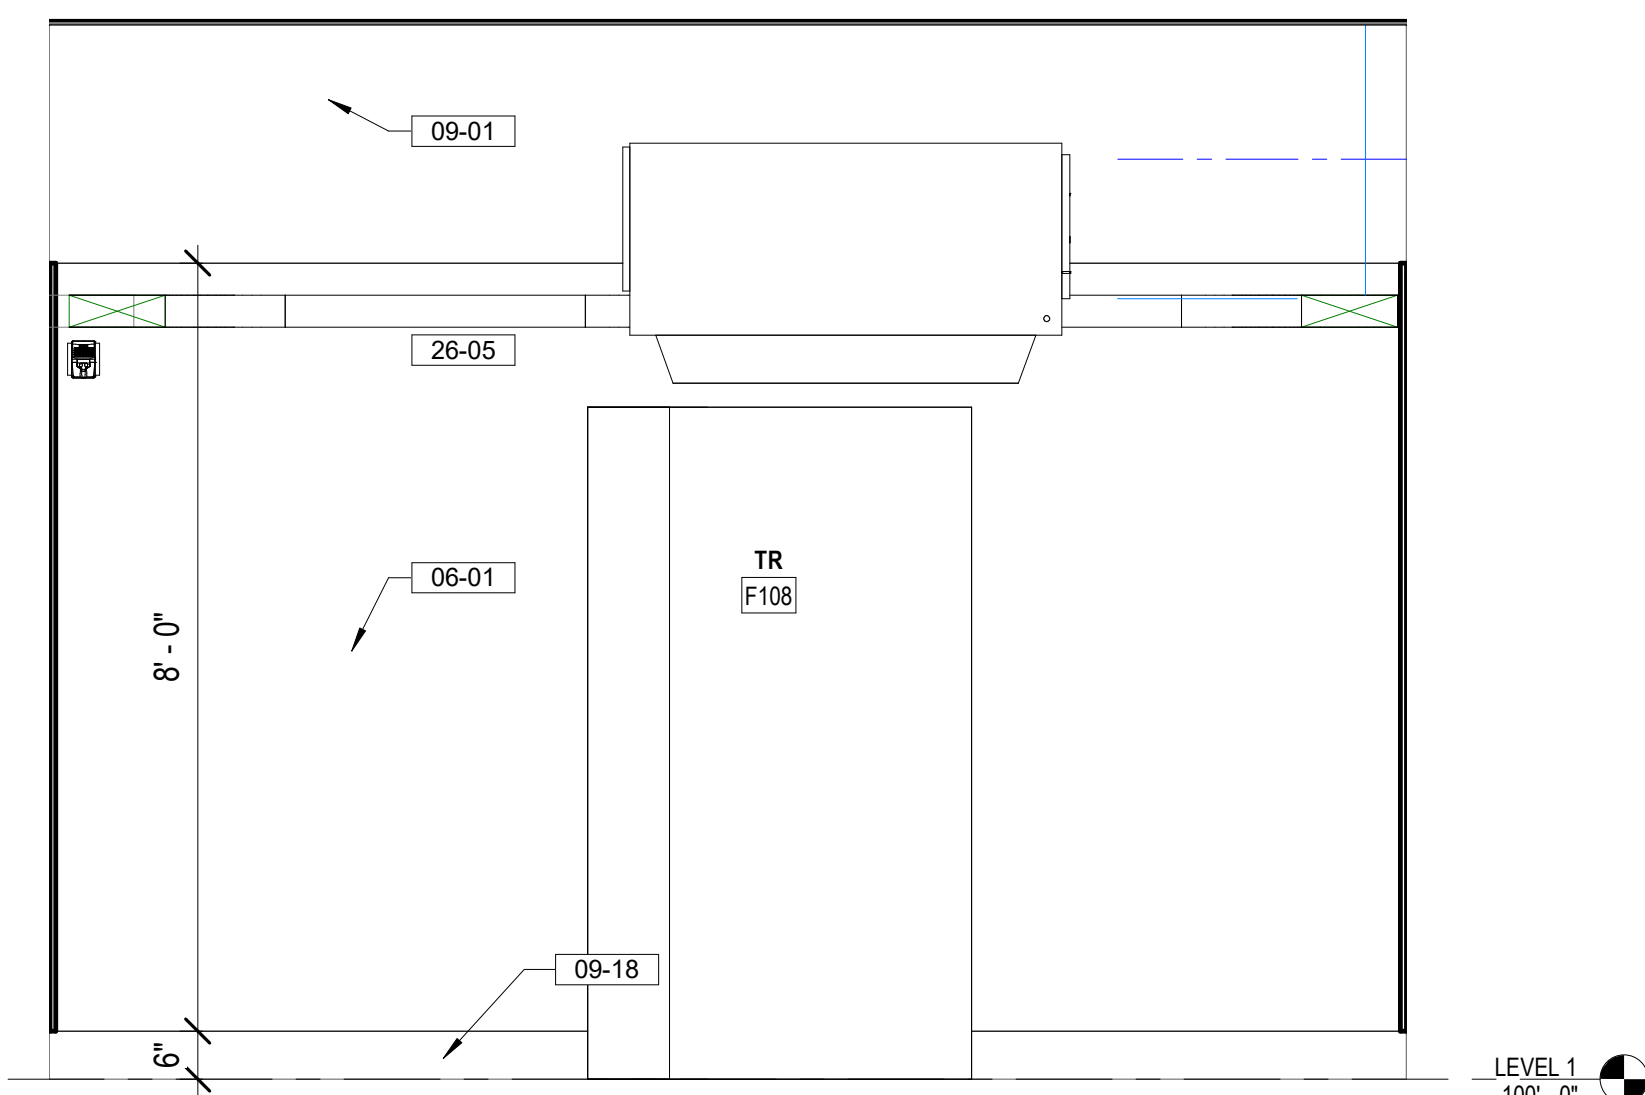

5 F108 WEST ELEVATION
1/2" = 1'-0"

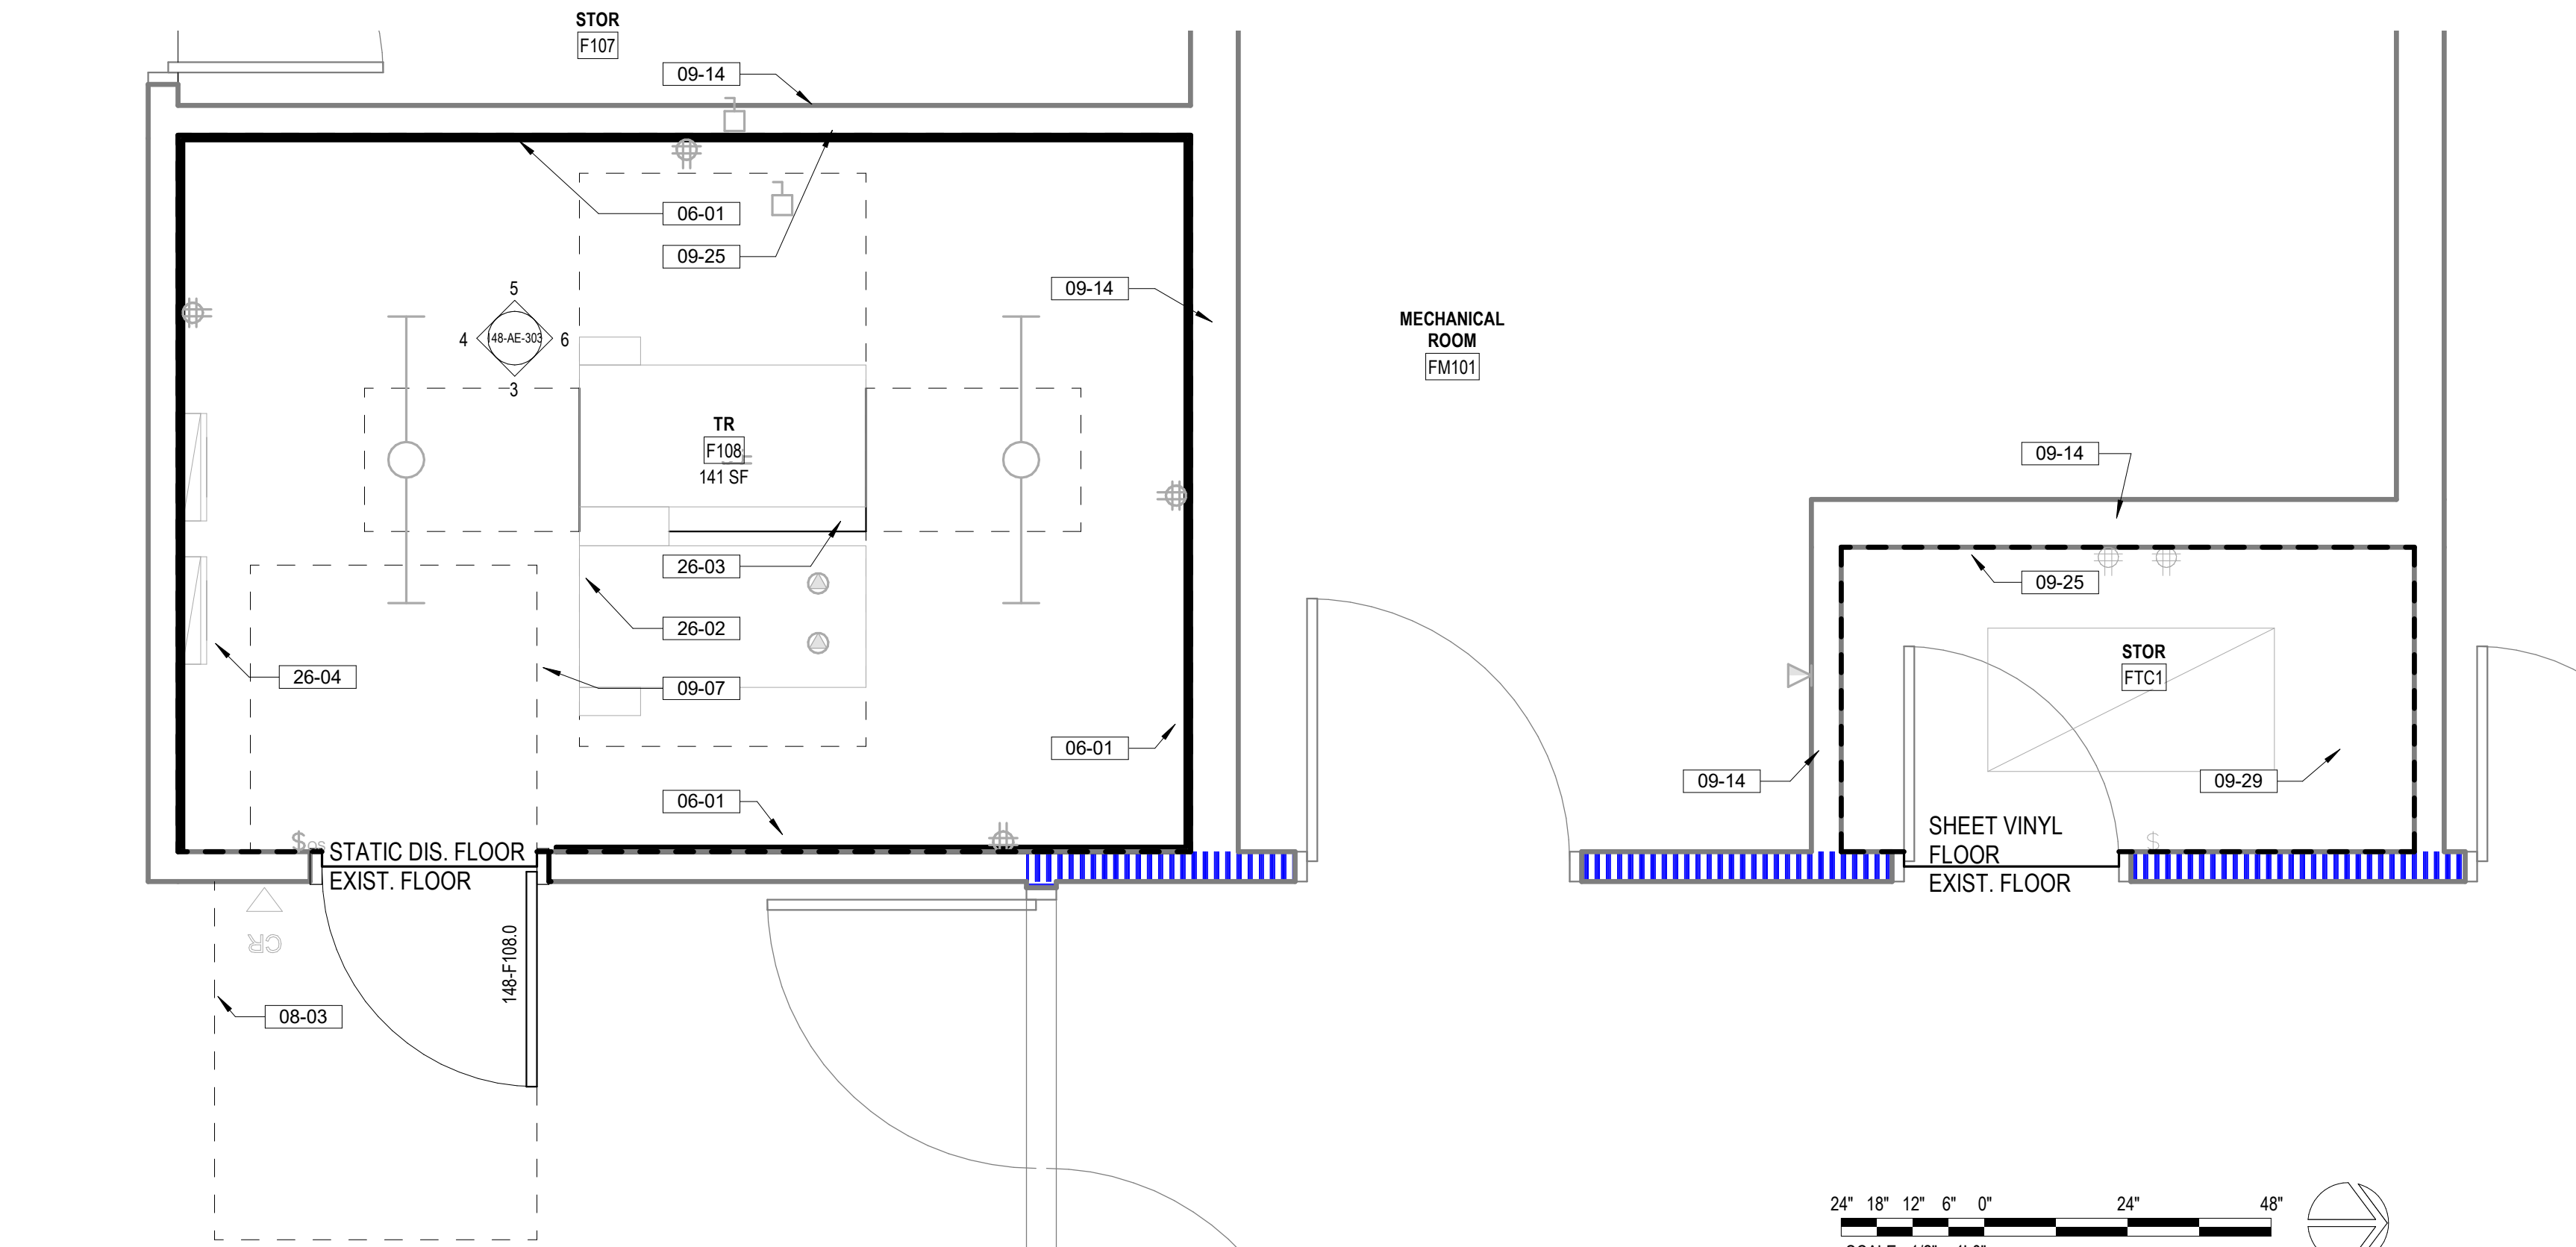

1 148 - F108 ENLARGED PLAN
1/2" = 1'-0"

FLOOR PLAN NOTES

- SEE G SERIES SHEETS FOR BALANCE OF FLOOR PLAN GENERAL NOTES.
- REFER TO STRUCTURAL, MECHANICAL, AND ELECTRICAL DRAWINGS FOR ADDITIONAL INFORMATION. ALL INFORMATION REGARDING EXISTING CONDITIONS IS BASED UPON OWNER-SUPPLIED DOCUMENTS AND MAY NOT PRECISELY REFLECT FIELD CONDITIONS.
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FLOOR PLAN LEGEND

- CARD READER, REF TELECOM DRAWINGS
- DATA PORT, REF TELECOM DRAWINGS
- OUTLET, REF ELEC DRAWINGS
- WIRELESS ACCESS POINT, REF TELECOM DRAWINGS
- ELEC PANEL, REF ELEC DRAWINGS
- STRIP LIGHT FIXTURE, REF ELEC DRAWINGS

KEY NOTES

- 06-01 INSTALL 3/4" AC GRADE OR BETTER FIRE RETARDANT PLYWOOD; PAINT WITH TWO COATS OF SEMI-GLOSS BRIGHT WHITE FIRE RETARDANT PAINT; MOUNT BOTTOM OF PLYWOOD 8" A.F.F. TOP OF PLYWOOD AT 8'-6" A.F.F.; DO NOT PAINT OVER STAMPED PLYWOOD RATING
- 08-03 ADA DOOR CLEARANCES SHOWN DASHED
- 09-01 PAINT WALL ABOVE PLYWOOD WITH SEMI-GLOSS PAINT, COLOR TO MATCH PLYWOOD PAINT.
- 09-07 INSTALL STATIC DISSIPATIVE RESILIENT FLOORING
- 09-14 CONTRACTOR TO FIRE STOP ALL PENETRATIONS INTO ROOM AND FIRE STOP TOP OF WALL TO COMPLY WITH A 2-HOUR FIRE RATING
- 09-18 6" HIGH COVER RUBBER WALL BASE, COLOR TO BE SELECTED FROM MANUFACTURER'S STANDARD SELECTION
- 09-25 PATCH AND REPAIR ANY GYPSUM BOARD OPENINGS FOUND AT PERIMETER OF WALL ENSURING NO VISIBLE EVIDENCE OF PATCH, SEAL PERIMETER OF ROOM IN ITS ENTIRETY, PAINT;
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- 26-02 3" PERIMETER CLEARANCE AROUND SERVER RACK SHOWN DASHED
- 26-03 TELECOMM RACK; SEE TELECOMMUNICATION DRAWINGS
- 26-04 ELECTRICAL PANELS; SEE ELECTRICAL DRAWINGS


REFLECTED CEILING PLAN LEGEND

- 2x2 LIGHT FIXTURE
- 2x4 LIGHT FIXTURE
- STRIP LIGHT FIXTURE
- 6" RECESSED CAN LIGHT FIXTURE
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- RETURN AIR VENT
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PROJECT KEY PLAN







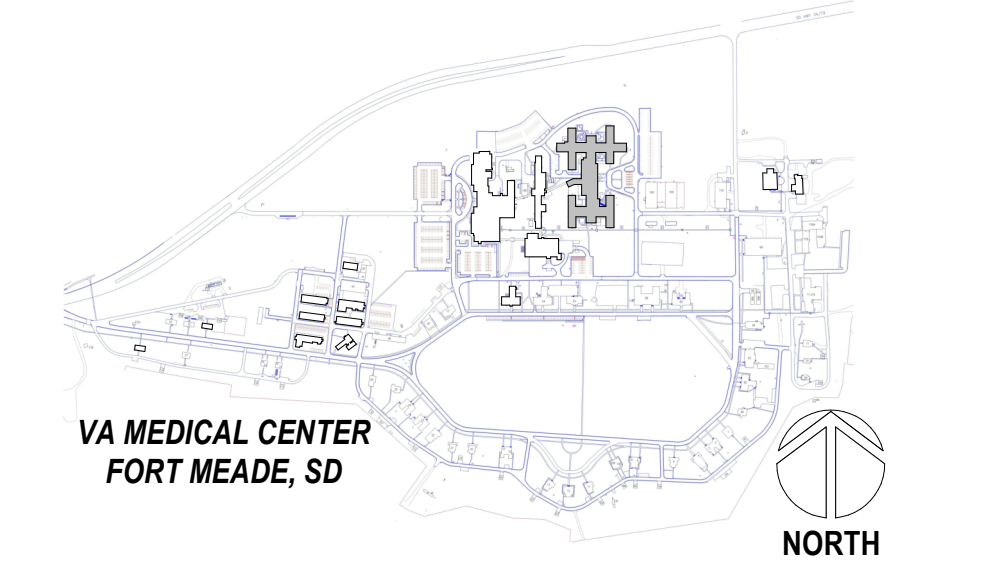

CONSULTANT A/E: GDM 1000 W STEUBEN ST. UNIT 3 BINGEN, WA 98605 541.436.4723 ADAM GODDIN, PE	ARCHITECT/ENGINEER OF RECORD ARCHITECT A&E DESIGN 124 NORTH 29TH STREET, #100 BILLINGS, MONTANA 59101 406.248.2633 T. MARCELLO PIERROTTET, AIA	STAMP 	PROGRAM CONTRACTING ACTIVITY CENTRAL (PCAC) VA U.S. Department of Veterans Affairs	DRAWING TITLE 148-ENLARGED PLANS AND TR ELEVATIONS	PHASE 100% CONSTRUCTION DOCUMENTS	PROJECT TITLE EHRM INFRASTRUCTURE UPGRADES	PROJECT NUMBER 568-21-701
				APPROVED: Project Director	FLS FULLY SPRINKLERED	LOCATION FORT MEADE, SOUTH DAKOTA	BUILDING NUMBER BLDG 148
Revisions:	Date:			ISSUE DATE 04/15/2022	CHECKED BY TMP	DRAWN BY JPR	DRAWING NUMBER 148-AE-303

FLOOR PLAN NOTES


- SEE G SERIES SHEETS FOR BALANCE OF FLOOR PLAN GENERAL NOTES.
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FLOOR PLAN LEGEND


-  CARD READER, REF TELECOM DRAWINGS
-  DATA PORT, REF TELECOM DRAWINGS
-  OUTLET, REF ELEC DRAWINGS
-  WIRELESS ACCESS POINT, REF TELECOM DRAWINGS
-  ELEC PANEL, REF ELEC DRAWINGS
-  STRIP LIGHT FIXTURE, REF ELEC DRAWINGS

KEYNOTES

- 08-03 ADA DOOR CLEARANCES SHOWN DASHED
- 09-13 FOLLOW EXISTING CABLE ROUTING FOR REMOVAL OF EXISTING CABLE AND INSTALLATION OF NEW CABLES AT LOCATIONS AS NOTED IN TELECOM DRAWINGS.
- 13-01 ICRA CLASS 1; SEE SPEC SECTION 01 35 26 FOR REQUIREMENTS AND WORKING HOURS RESTRICTIONS
- 26-04 ELECTRICAL PANELS, SEE ELECTRICAL DRAWINGS
- 26-09 30" CLEARANCE AT WALL MOUNTED SERVER RACK SHOWN DASHED

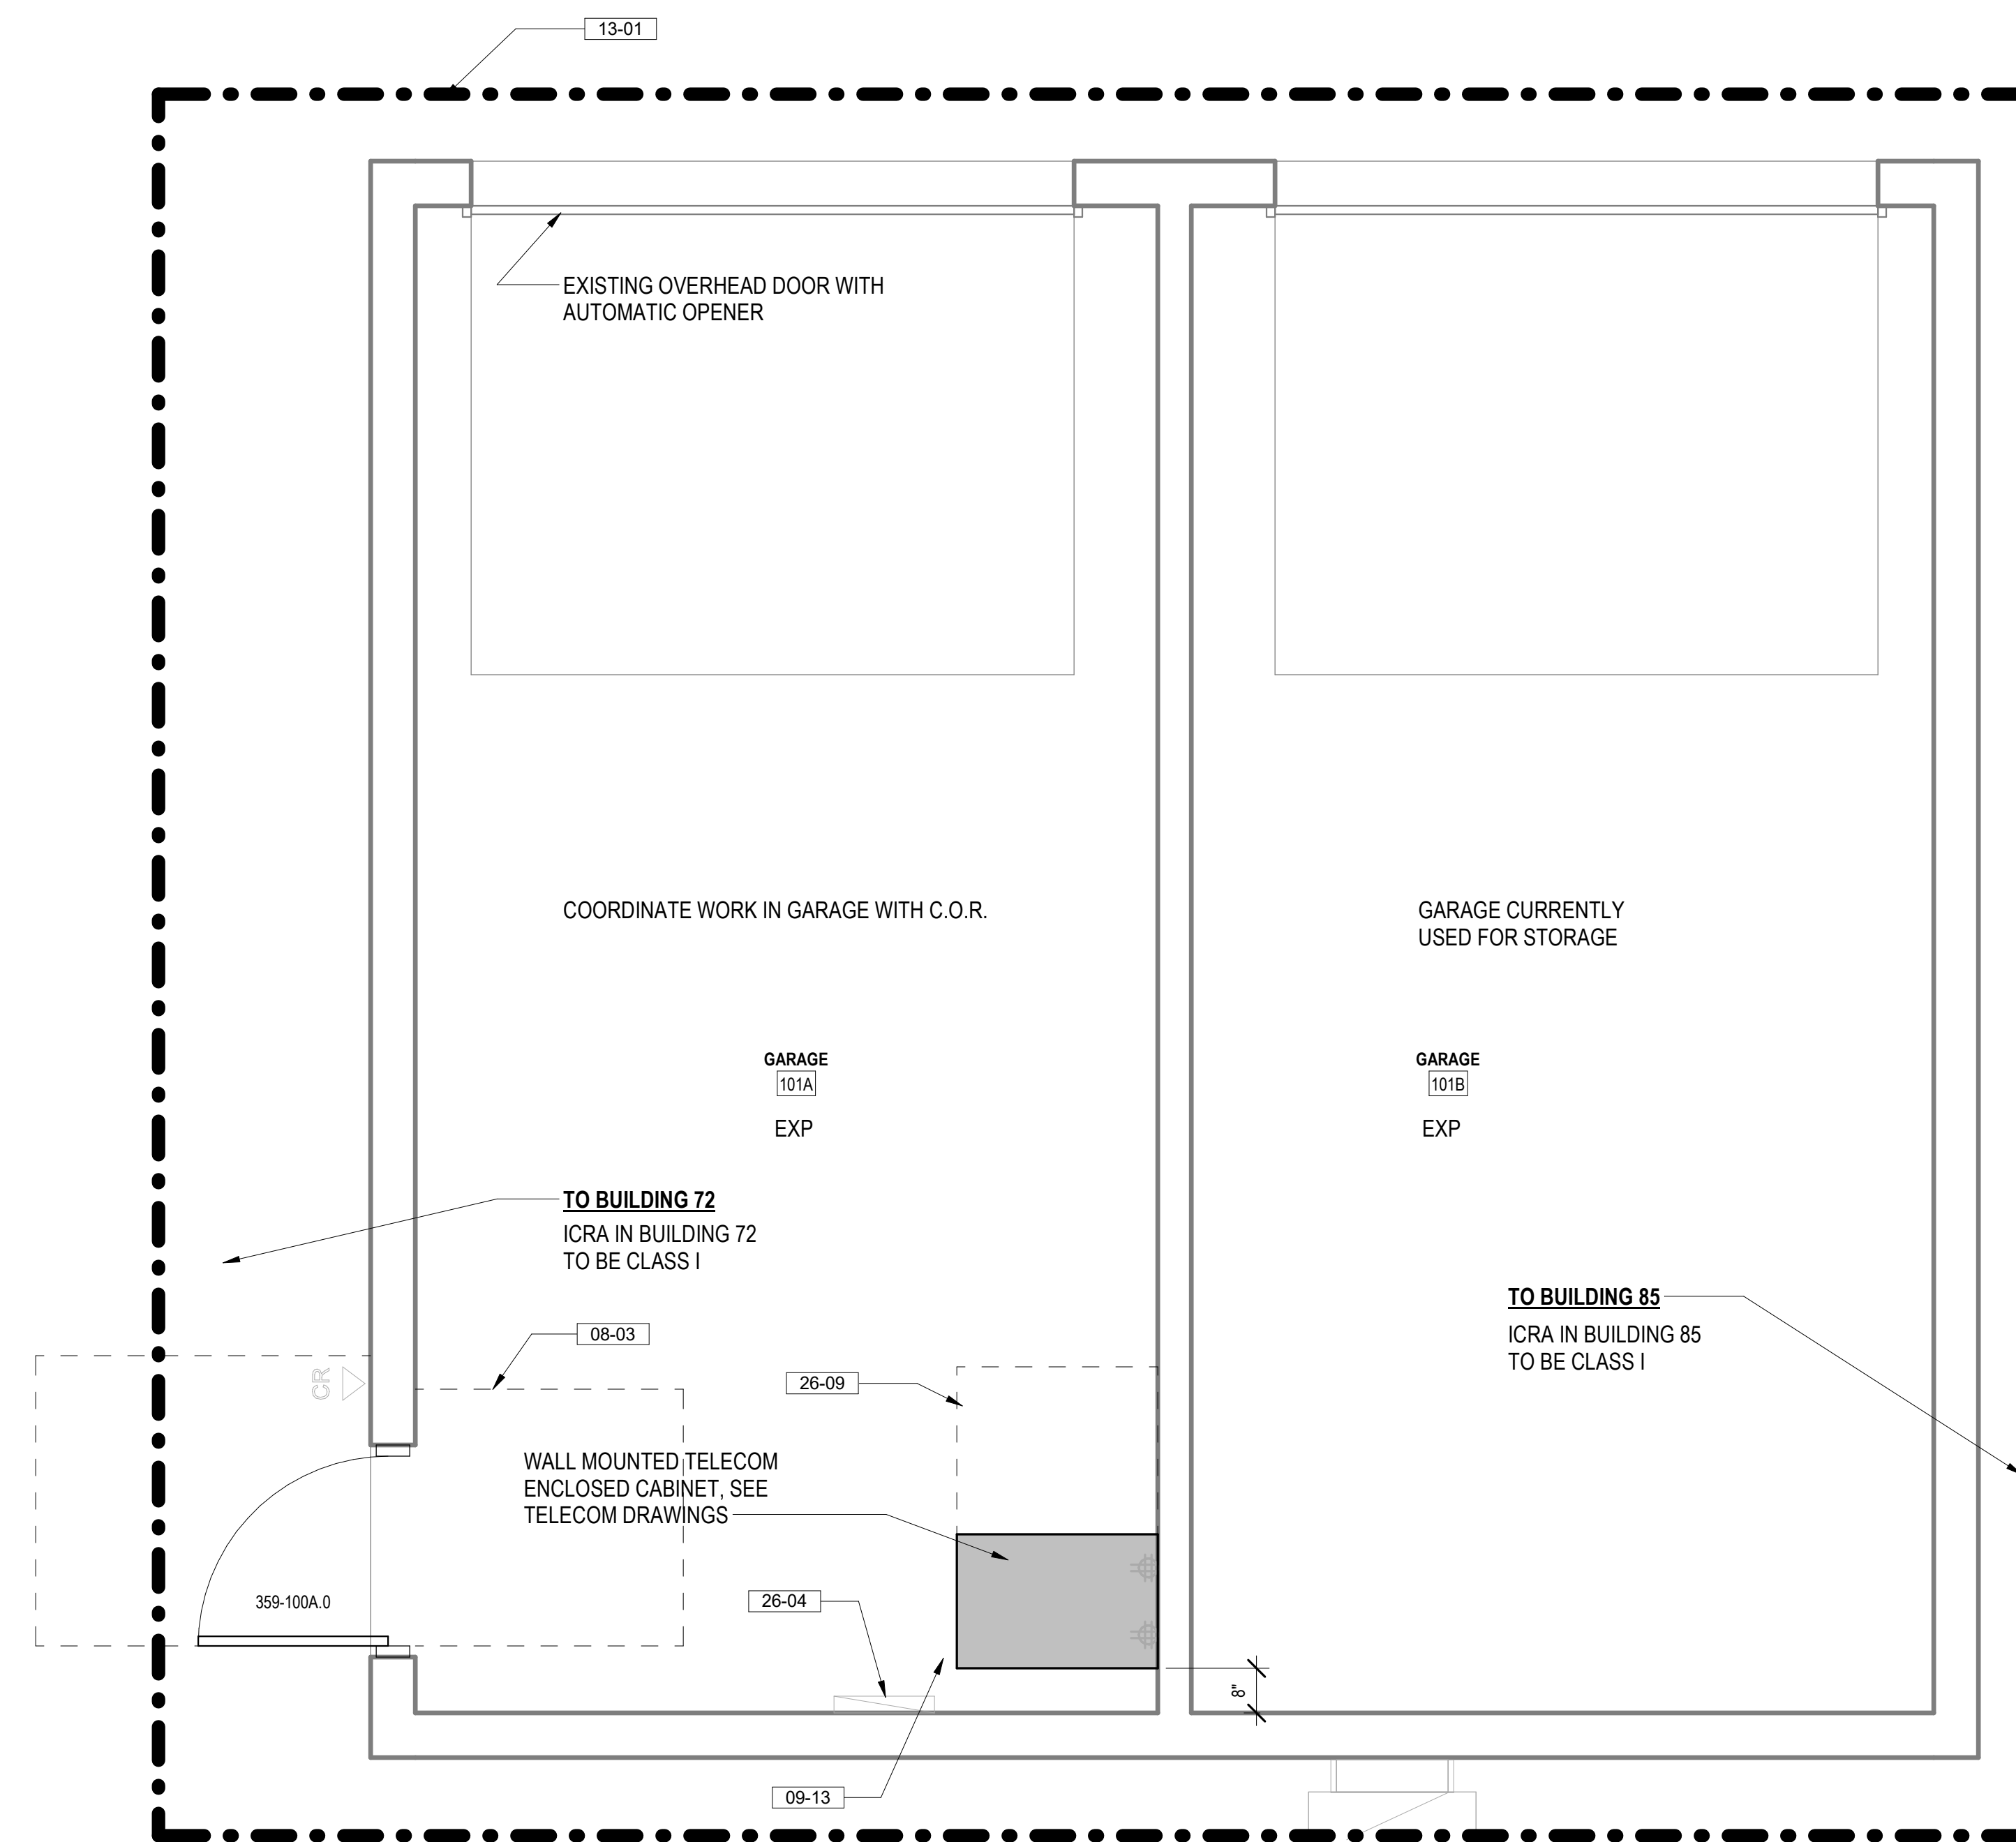


1 359 - LEVEL 1 FLOOR PLAN
1/2" = 1'-0"

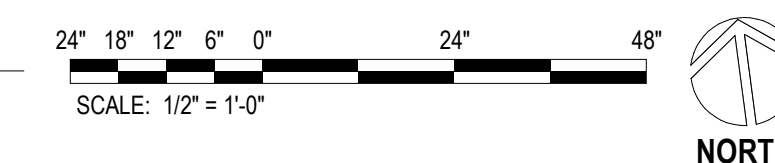

PROJECT KEY PLAN

BLACK HILLS VA HEALTHCARE SYSTEM
BLACK HILLS NETWORK ##
113 COMANCHE ROAD | FORT MEADE, SD 57741

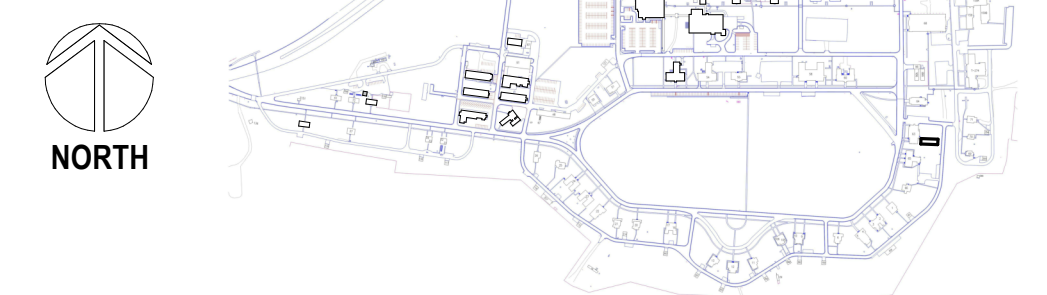

2022-05-24 10:34:29

B:\M\36012112_VA Medical Center - Ft Meade SD\21112_Bldg 359_20.nvt

Revisions:	Date:


CONSULTANT

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541.436.4723
ADAM GODDIN, PE




ARCHITECT/ENGINEER OF RECORD

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STAMP



PROGRAM CONTRACTING ACTIVITY CENTRAL (PCAC)

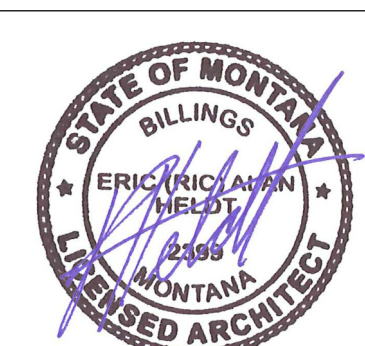VA U.S. Department of Veterans Affairs

DRAWING TITLE
359-FLOOR PLANS

APPROVED: Project Director

PHASE
100% CONSTRUCTION DOCUMENTS

FLS
NON SPRINKLERED

PROJECT TITLE
EHRM INFRASTRUCTURE UPGRADES

LOCATION
FORT MEADE, SOUTH DAKOTA

ISSUE DATE
04/15/2022

CHECKED BY
TMP

DRAWN BY
JPR

PROJECT NUMBER
568-21-701







BUILDING NUMBER
359

DRAWING NUMBER
359-AE-201

FLOOR PLAN NOTES



- SEE G SERIES SHEETS FOR BALANCE OF PLAN GENERAL NOTES.
- REFER TO STRUCTURAL, MECHANICAL, AND ELECTRICAL DRAWINGS FOR ADDITIONAL INFORMATION. ALL INFORMATION REGARDING EXISTING CONDITIONS IS BASED UPON OWNER-SUPPLIED DOCUMENTS AND MAY NOT PRECISELY REFLECT FIELD CONDITIONS.
- PROVIDE ALL BACKING FOR MILLWORK, GRAB BARS, AND ANY AND ALL WALL MOUNTED EQUIPMENT OR ACCESSORIES; COORDINATE LOCATIONS.
- ALL DIMENSIONS ARE FROM STRUCTURAL OR UNFINISHED FACE OF STUD, UNLESS OTHERWISE NOTED.
- PROVIDE A SMOOTH AND LEVEL FINISH FLOOR, TYP. PATCH AND REPAIR ALL INCONSISTENCIES IN FLOOR ELEVATIONS.
- PATCH AND REPAIR ANY / ALL WALL SURFACES AS REQUIRED TO PROVIDE SUITABLE SUBSTRATE FOR FINISHES.
- REFER TO DOOR AND FRAME SCHEDULE FOR DOORS REQUIRING ADA ACCESS CONTROL.
- PROVIDE ACOUSTICAL SEALANT AROUND WALL EDGES, TOP AND BOTTOM, AND PENETRATIONS, AND INSTALL PUTTY PADS AROUND ELECTRICAL BOXES WHERE PARTITION CONTAINS ACOUSTICAL INSULATION.
- ALL TELECOMMUNICATION ROOMS ARE TO HAVE EXPOSED STRUCTURE UNLESS NOTED OTHERWISE, NO CEILINGS SPECIFIED.

FLOOR PLAN LEGEND


-  CARD READER, REF TELECOM DRAWINGS
-  DATA PORT, REF TELECOM DRAWINGS
-  OUTLET, REF ELEC DRAWINGS
-  WIRELESS ACCESS POINT, REF TELECOM DRAWINGS
-  ELEC PANEL, REF ELEC DRAWINGS
-  STRIP LIGHT FIXTURE, REF ELEC DRAWINGS

KEYNOTES

- 01-01 CLEAN UP AREA AROUND PROPOSED WALL MOUNTED CABINET LOCATION; COORDINATE WITH C.O.R. FOR RELOCATION OR REMOVAL OF INSTALLATION OBSTRUCTING ITEMS.
- 08-03 ADA DOOR CLEARANCES SHOWN DASHED
- 09-10 PAINT FULL LENGTH OF WALL TO NEAREST EXTERIOR OR INTERIOR CORNER, COLOR TO MATCH EXISTING WALLS.
- 09-18 6" HIGH COVERED RUBBER WALL BASE, COLOR TO BE SELECTED FROM MANUFACTURER'S STANDARD SELECTION
- 09-28 PAINT ENTIRE ROOM, COLOR TO MATCH EXISTING
- 13-01 ICRA CLASS I, SEE SPEC SECTION 01 35 26 FOR REQUIREMENTS AND WORKING HOURS RESTRICTIONS
- 26-09 30" CLEARANCE AT WALL MOUNTED SERVER RACK SHOWN DASHED
- 26-10 WALL MOUNTED TELECOM CABINET, SEE TELECOM DRAWINGS

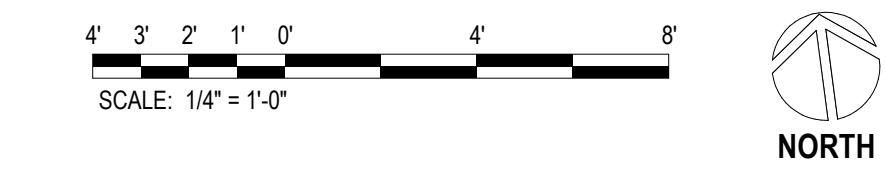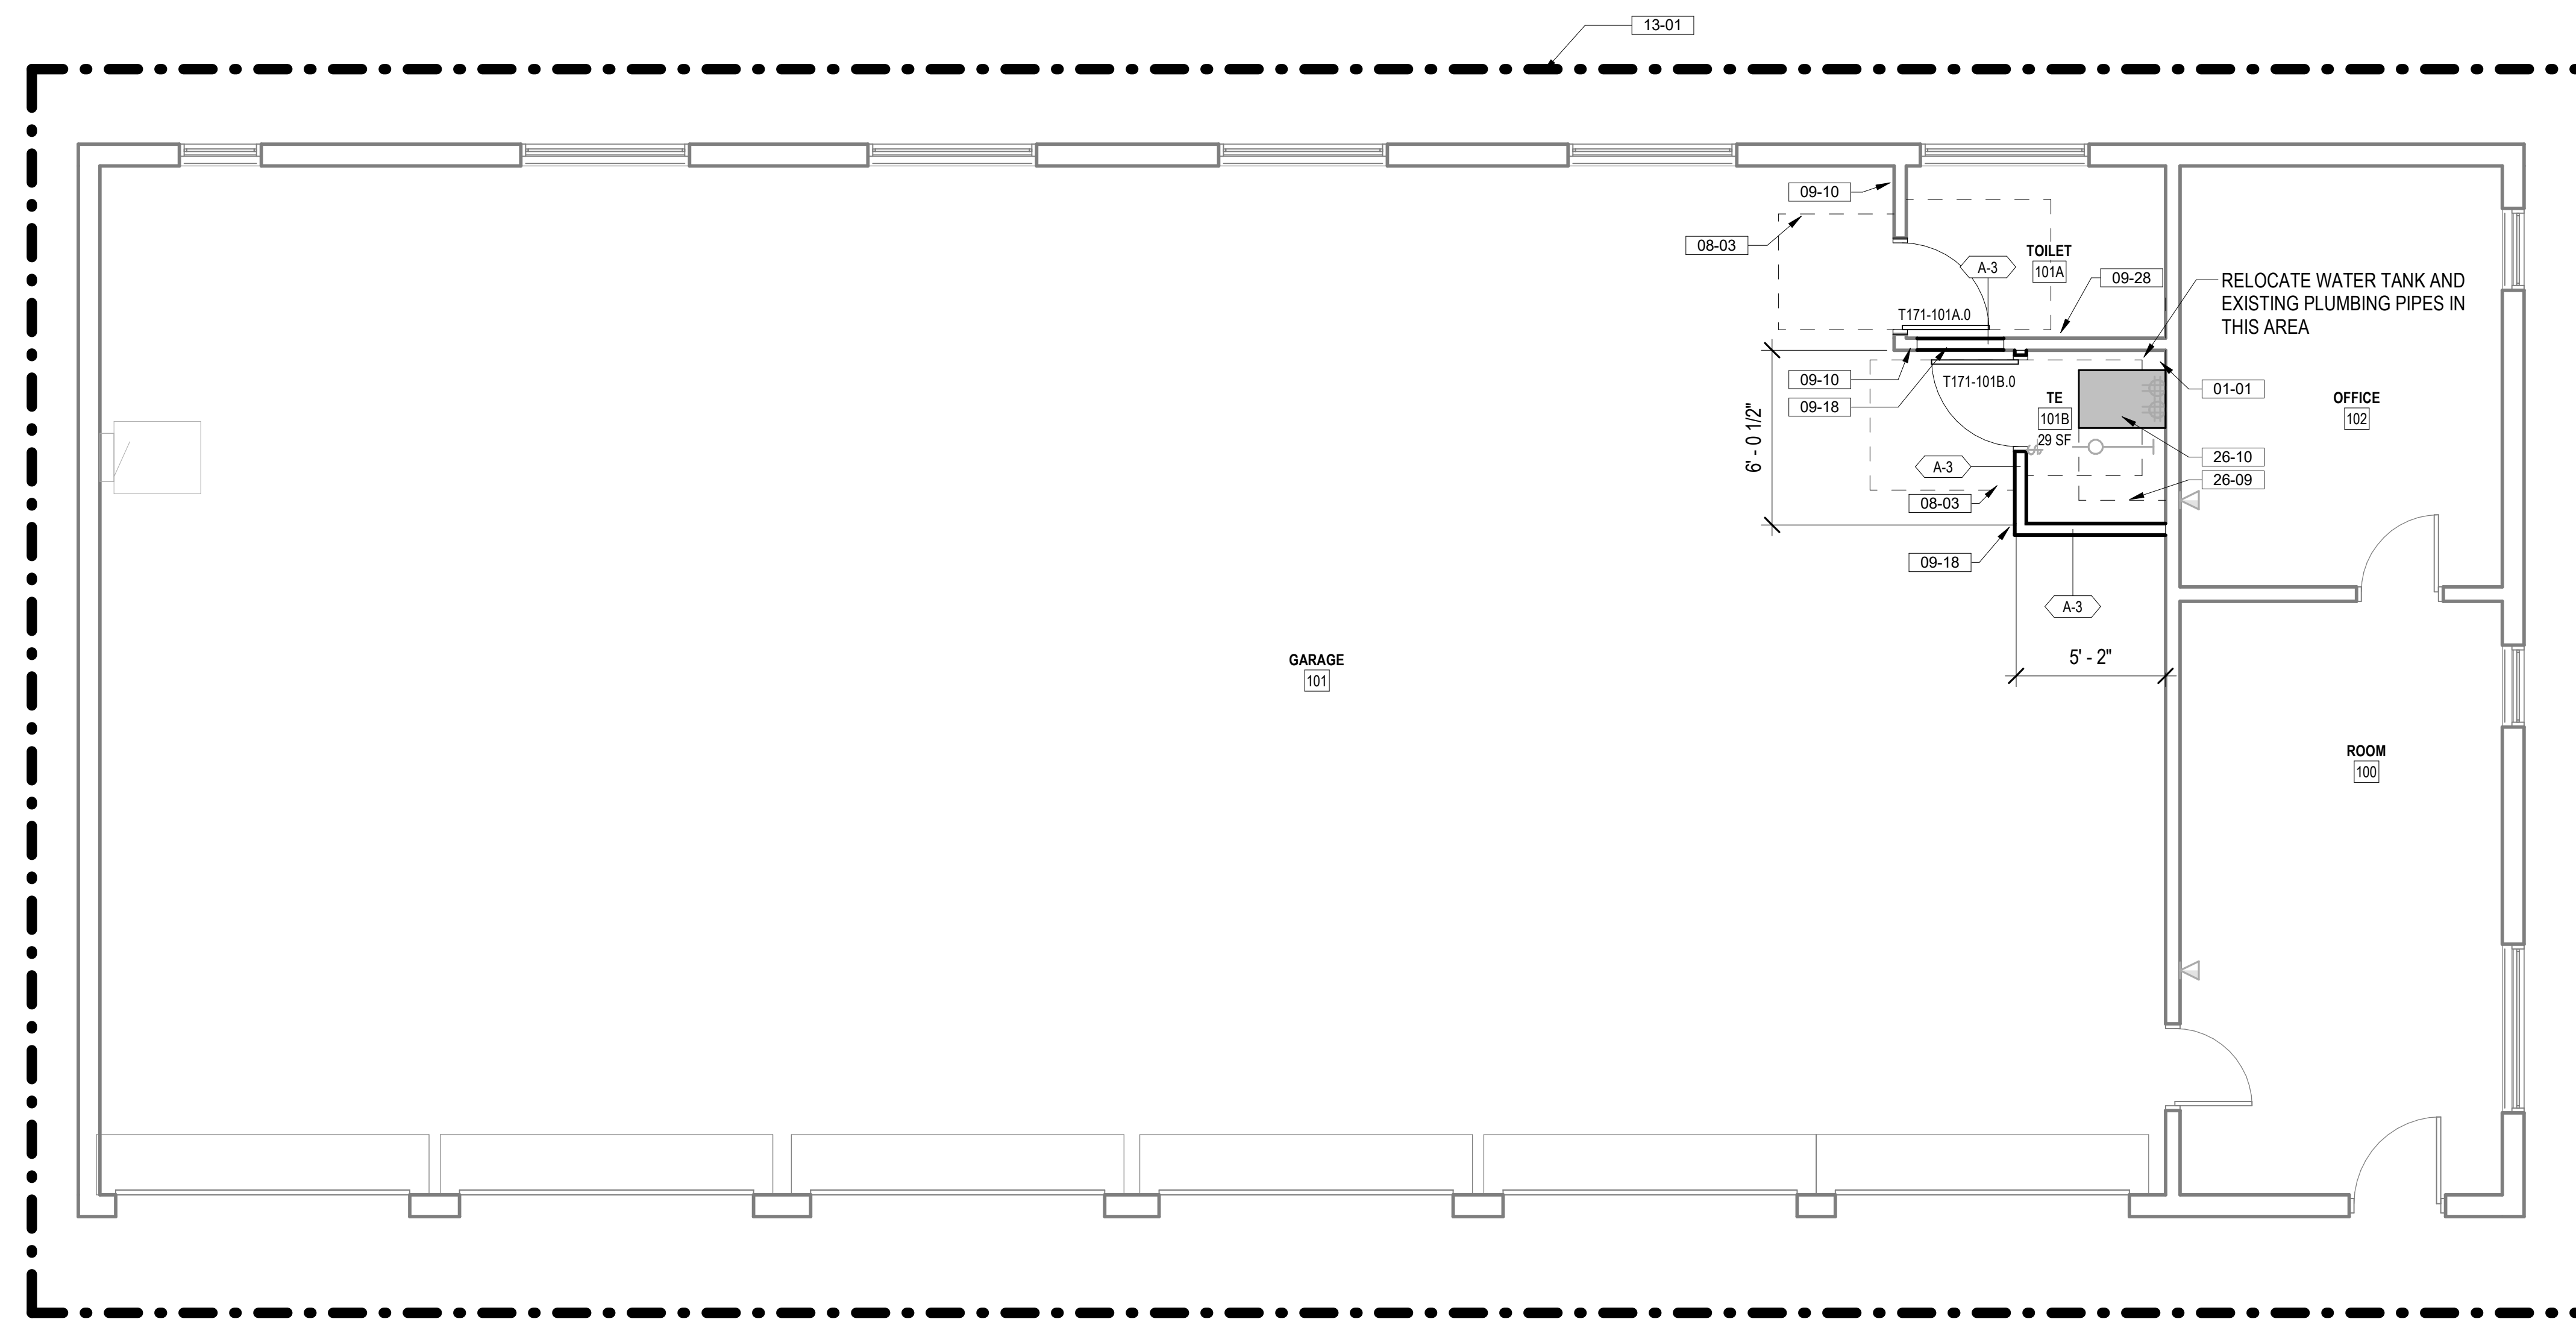

PROJECT KEY PLAN

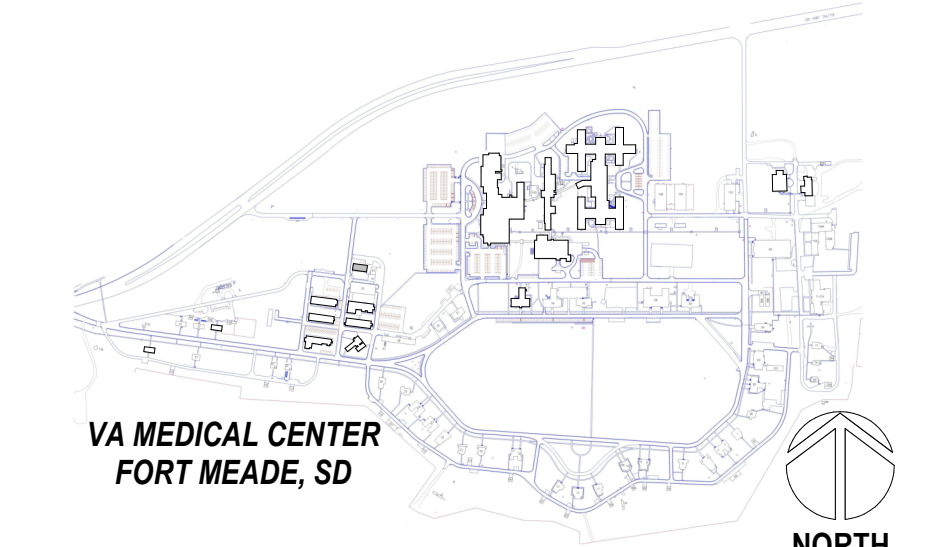

1 T171 - LEVEL 1 FLOOR PLAN
1/4" = 1'-0"

Revisions:	Date:


CONSULTANT

A/E:
GDM
1000 W STEUBEN ST. UNIT 3
BINGEN, WA 98605
541.436.4723
ADAM GODDIN, PE




ARCHITECT/ENGINEER OF RECORD

ARCHITECT
A&E DESIGN
124 NORTH 29TH STREET, #100
BILLINGS, MONTANA 59101
406.248.2633
T. MARCELLO PIERROTTET, AIA



STAMP

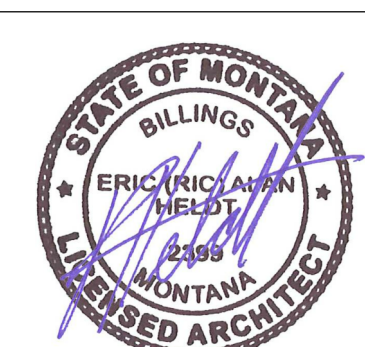

PROGRAM CONTRACTING ACTIVITY CENTRAL (PCAC)

VA U.S. Department of Veterans Affairs

DRAWING TITLE
T171-FLOOR PLANS

APPROVED: Project Director

PHASE
100% CONSTRUCTION DOCUMENTS

FLS
FULLY SPRINKLERED

PROJECT TITLE
EHRM INFRASTRUCTURE UPGRADES

LOCATION
FORT MEADE, SOUTH DAKOTA


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CHECKED BY: TMP
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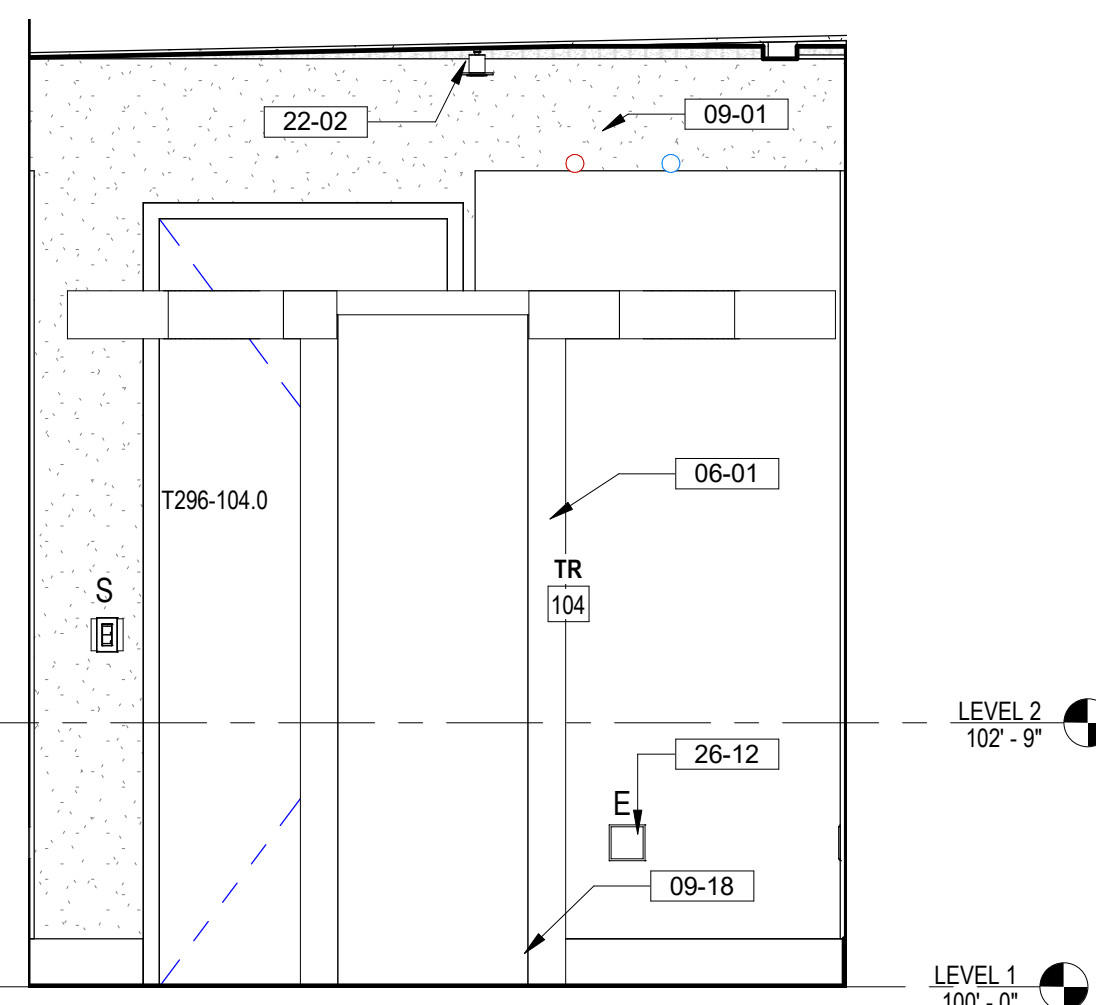
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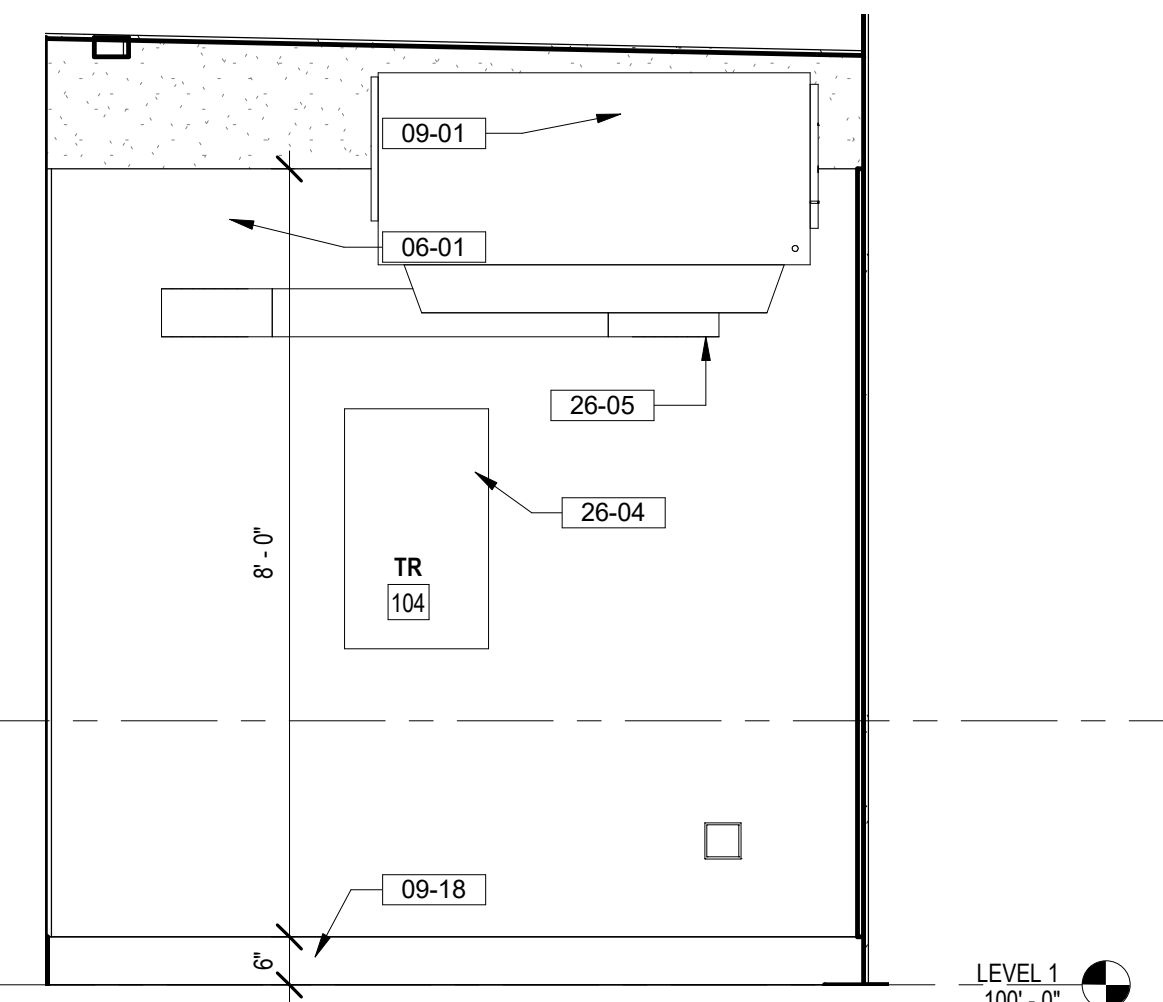
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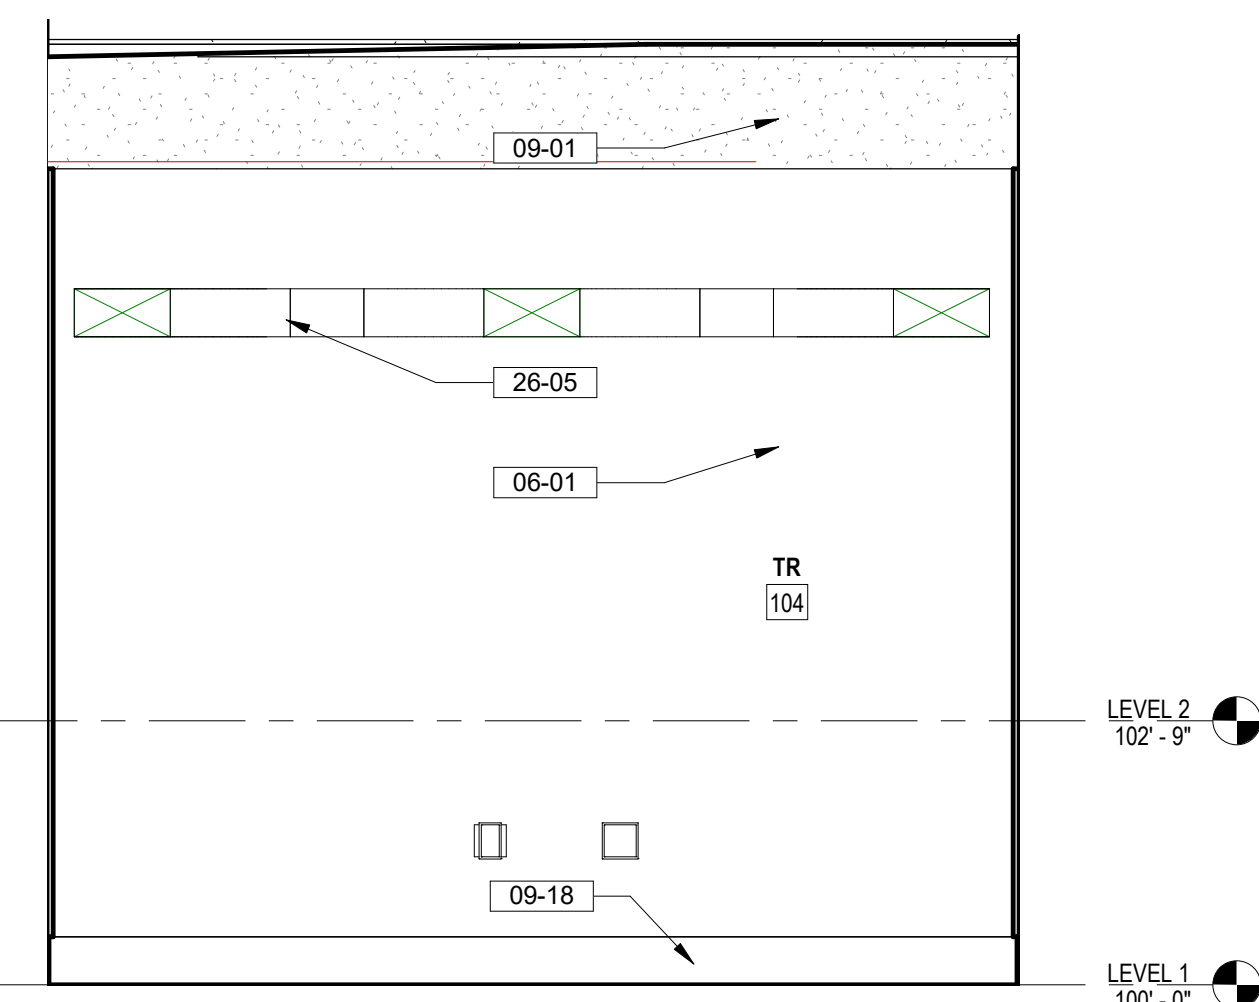
3 TR 104 SOUTH ELEVATION
1/2" = 1'-0"




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1/2" = 1'-0"




2 TR 104 EAST ELEVATION
1/2" = 1'-0"

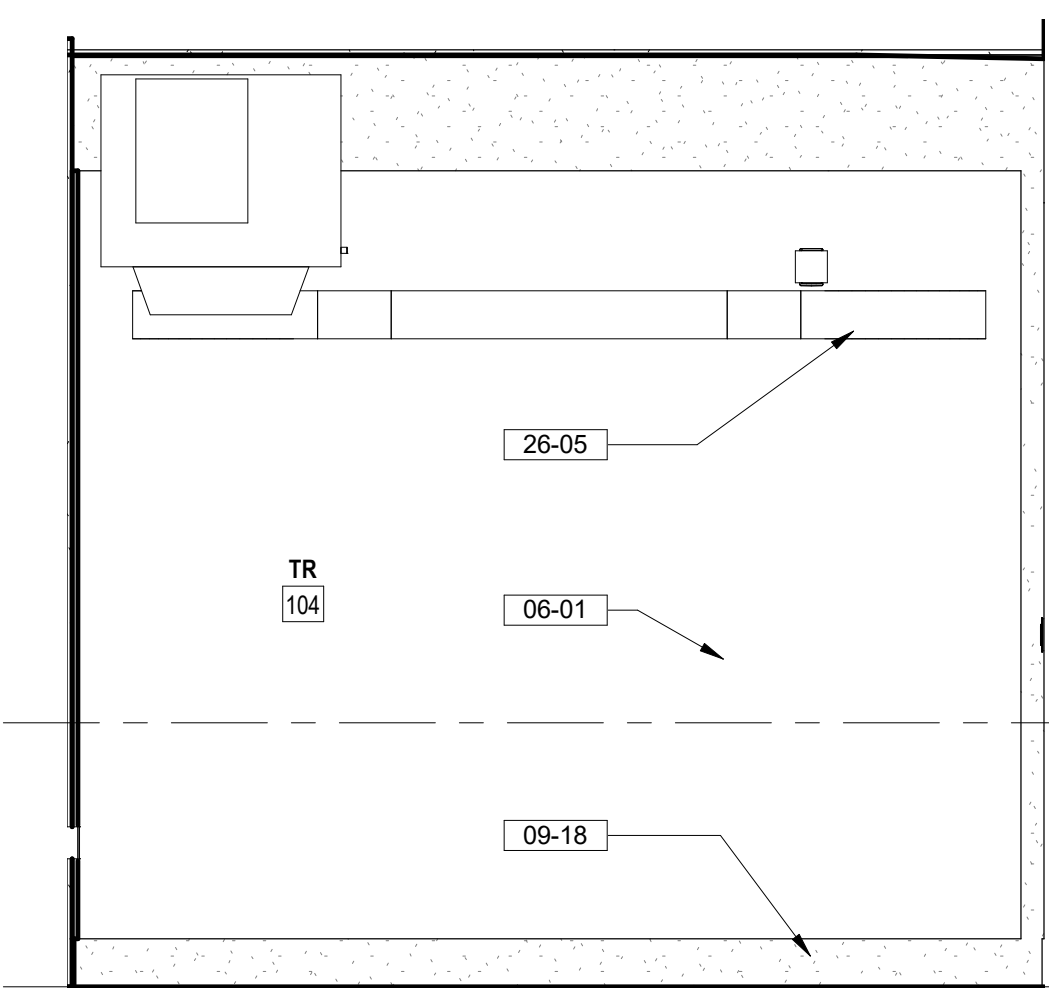


4 TR 104 NORTH ELEVATION
1/2" = 1'-0"

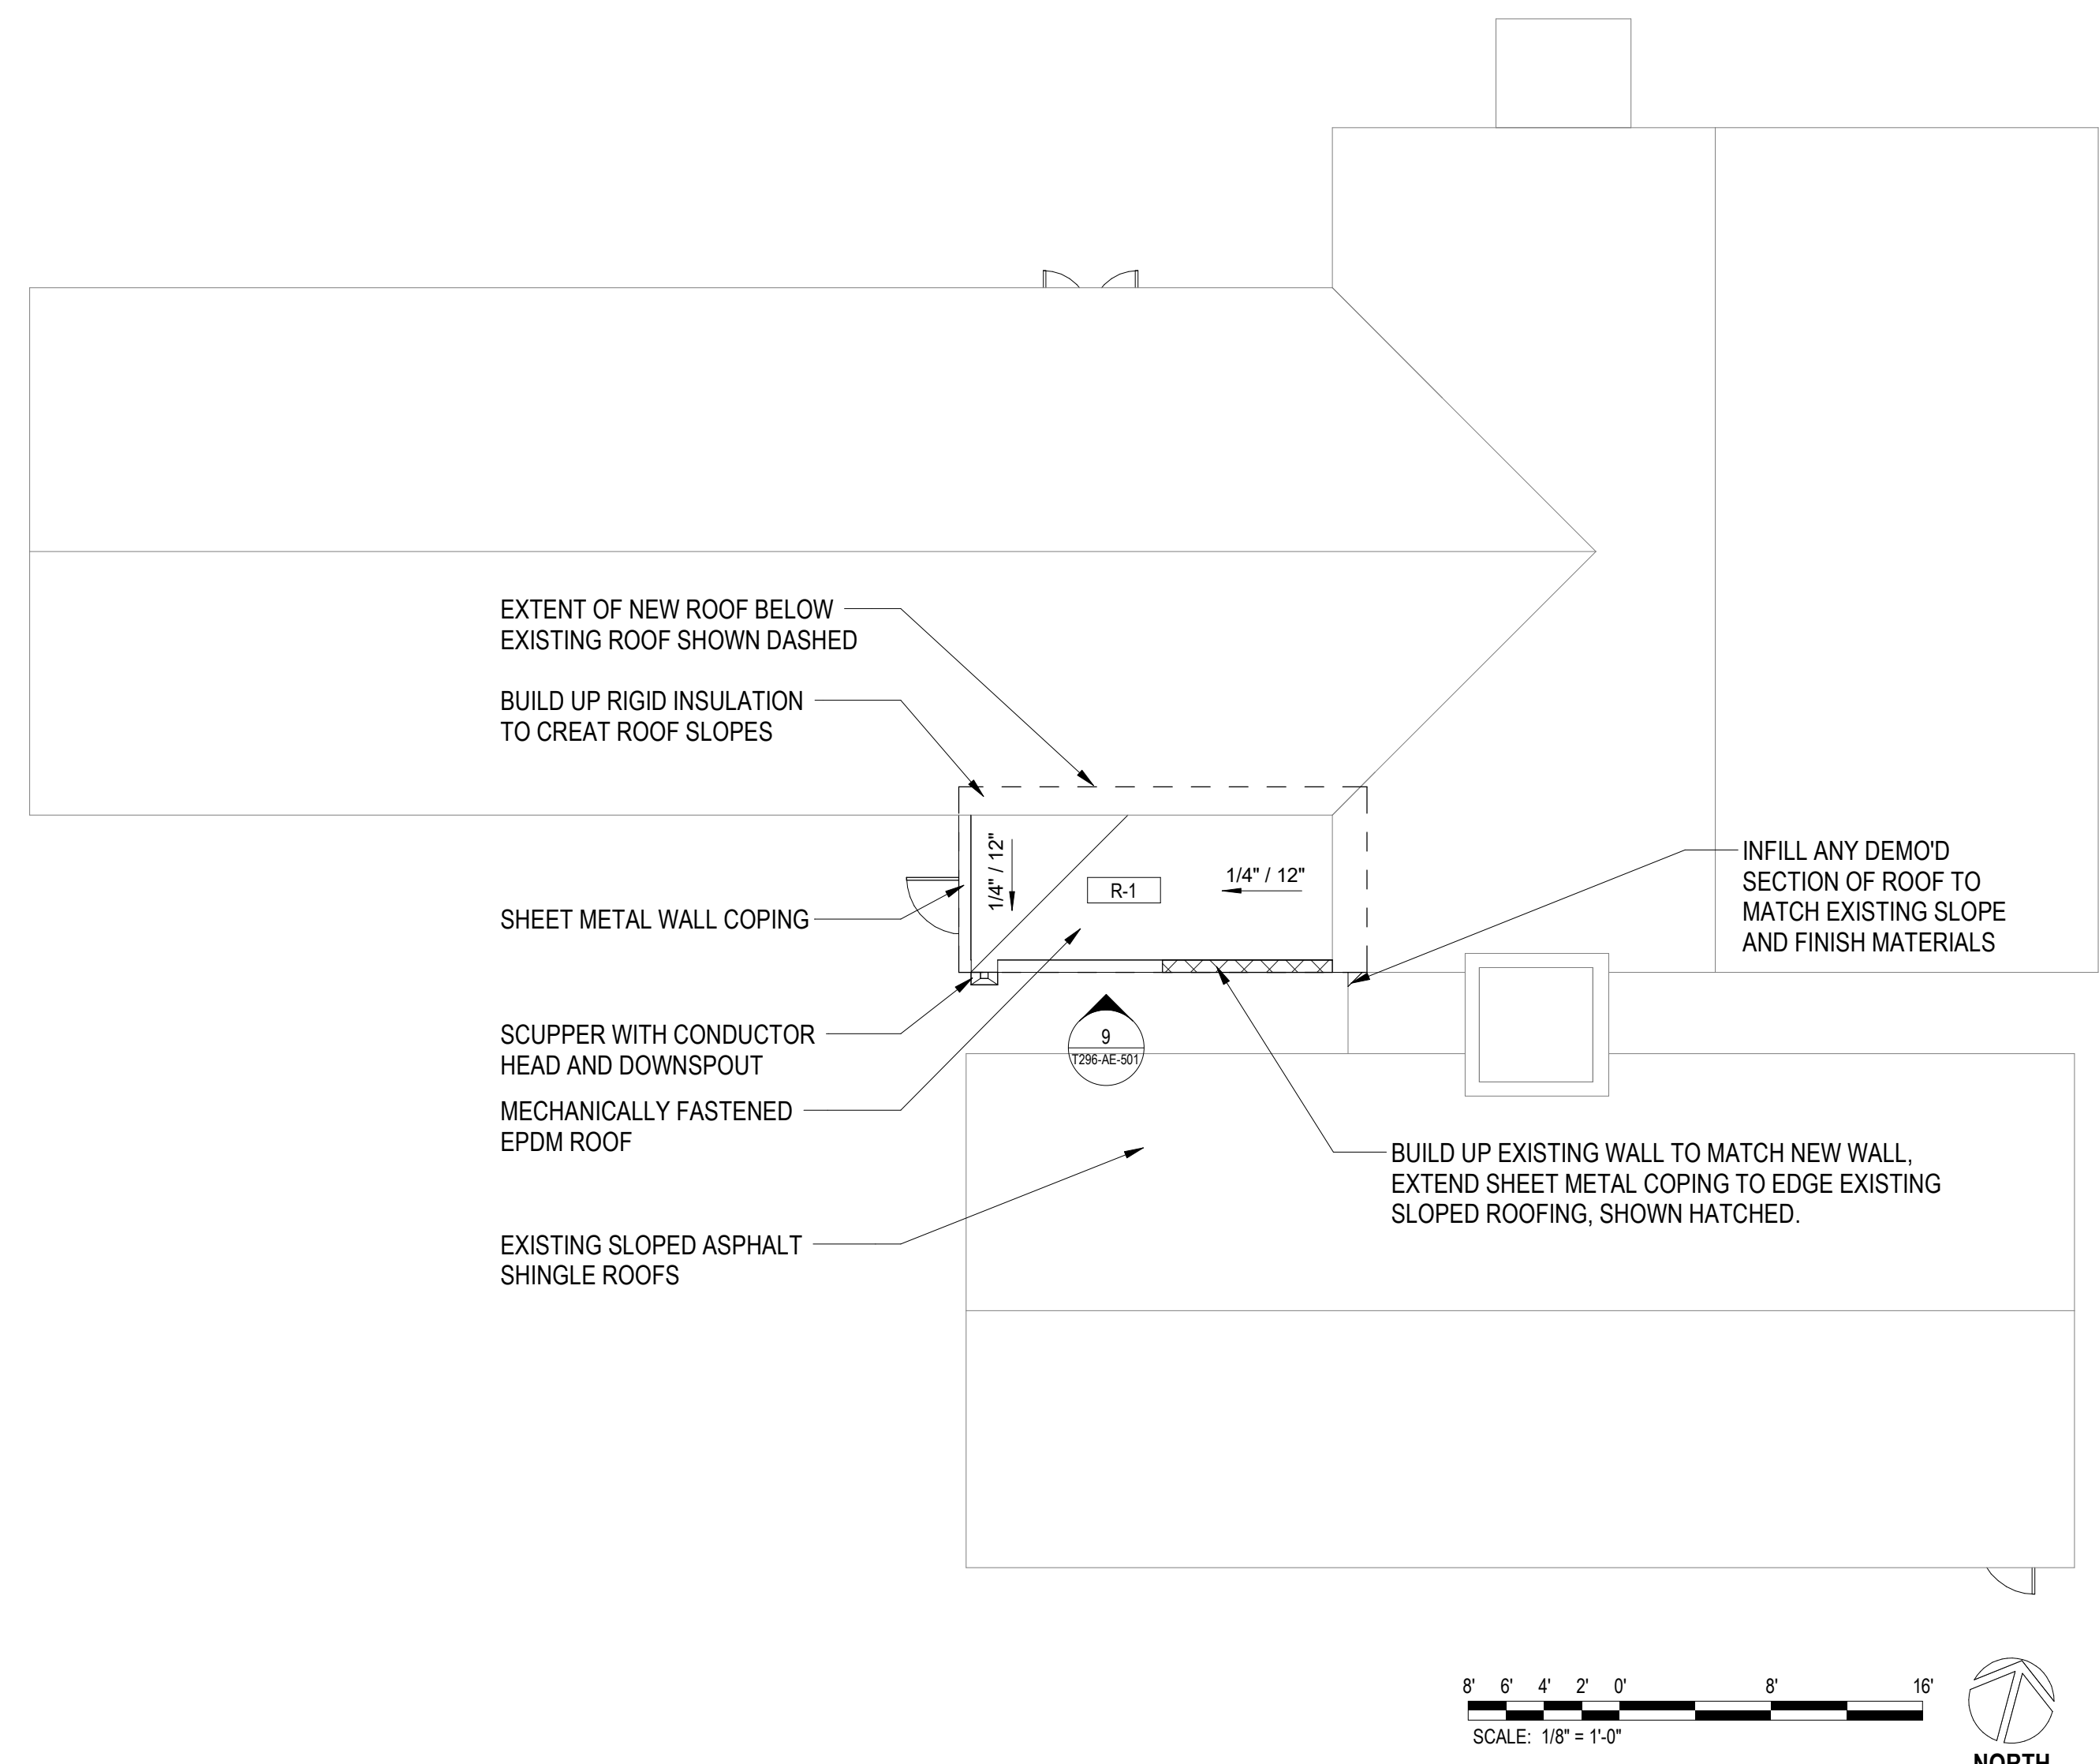

7 ROOF PLAN
1/8" = 1'-0"

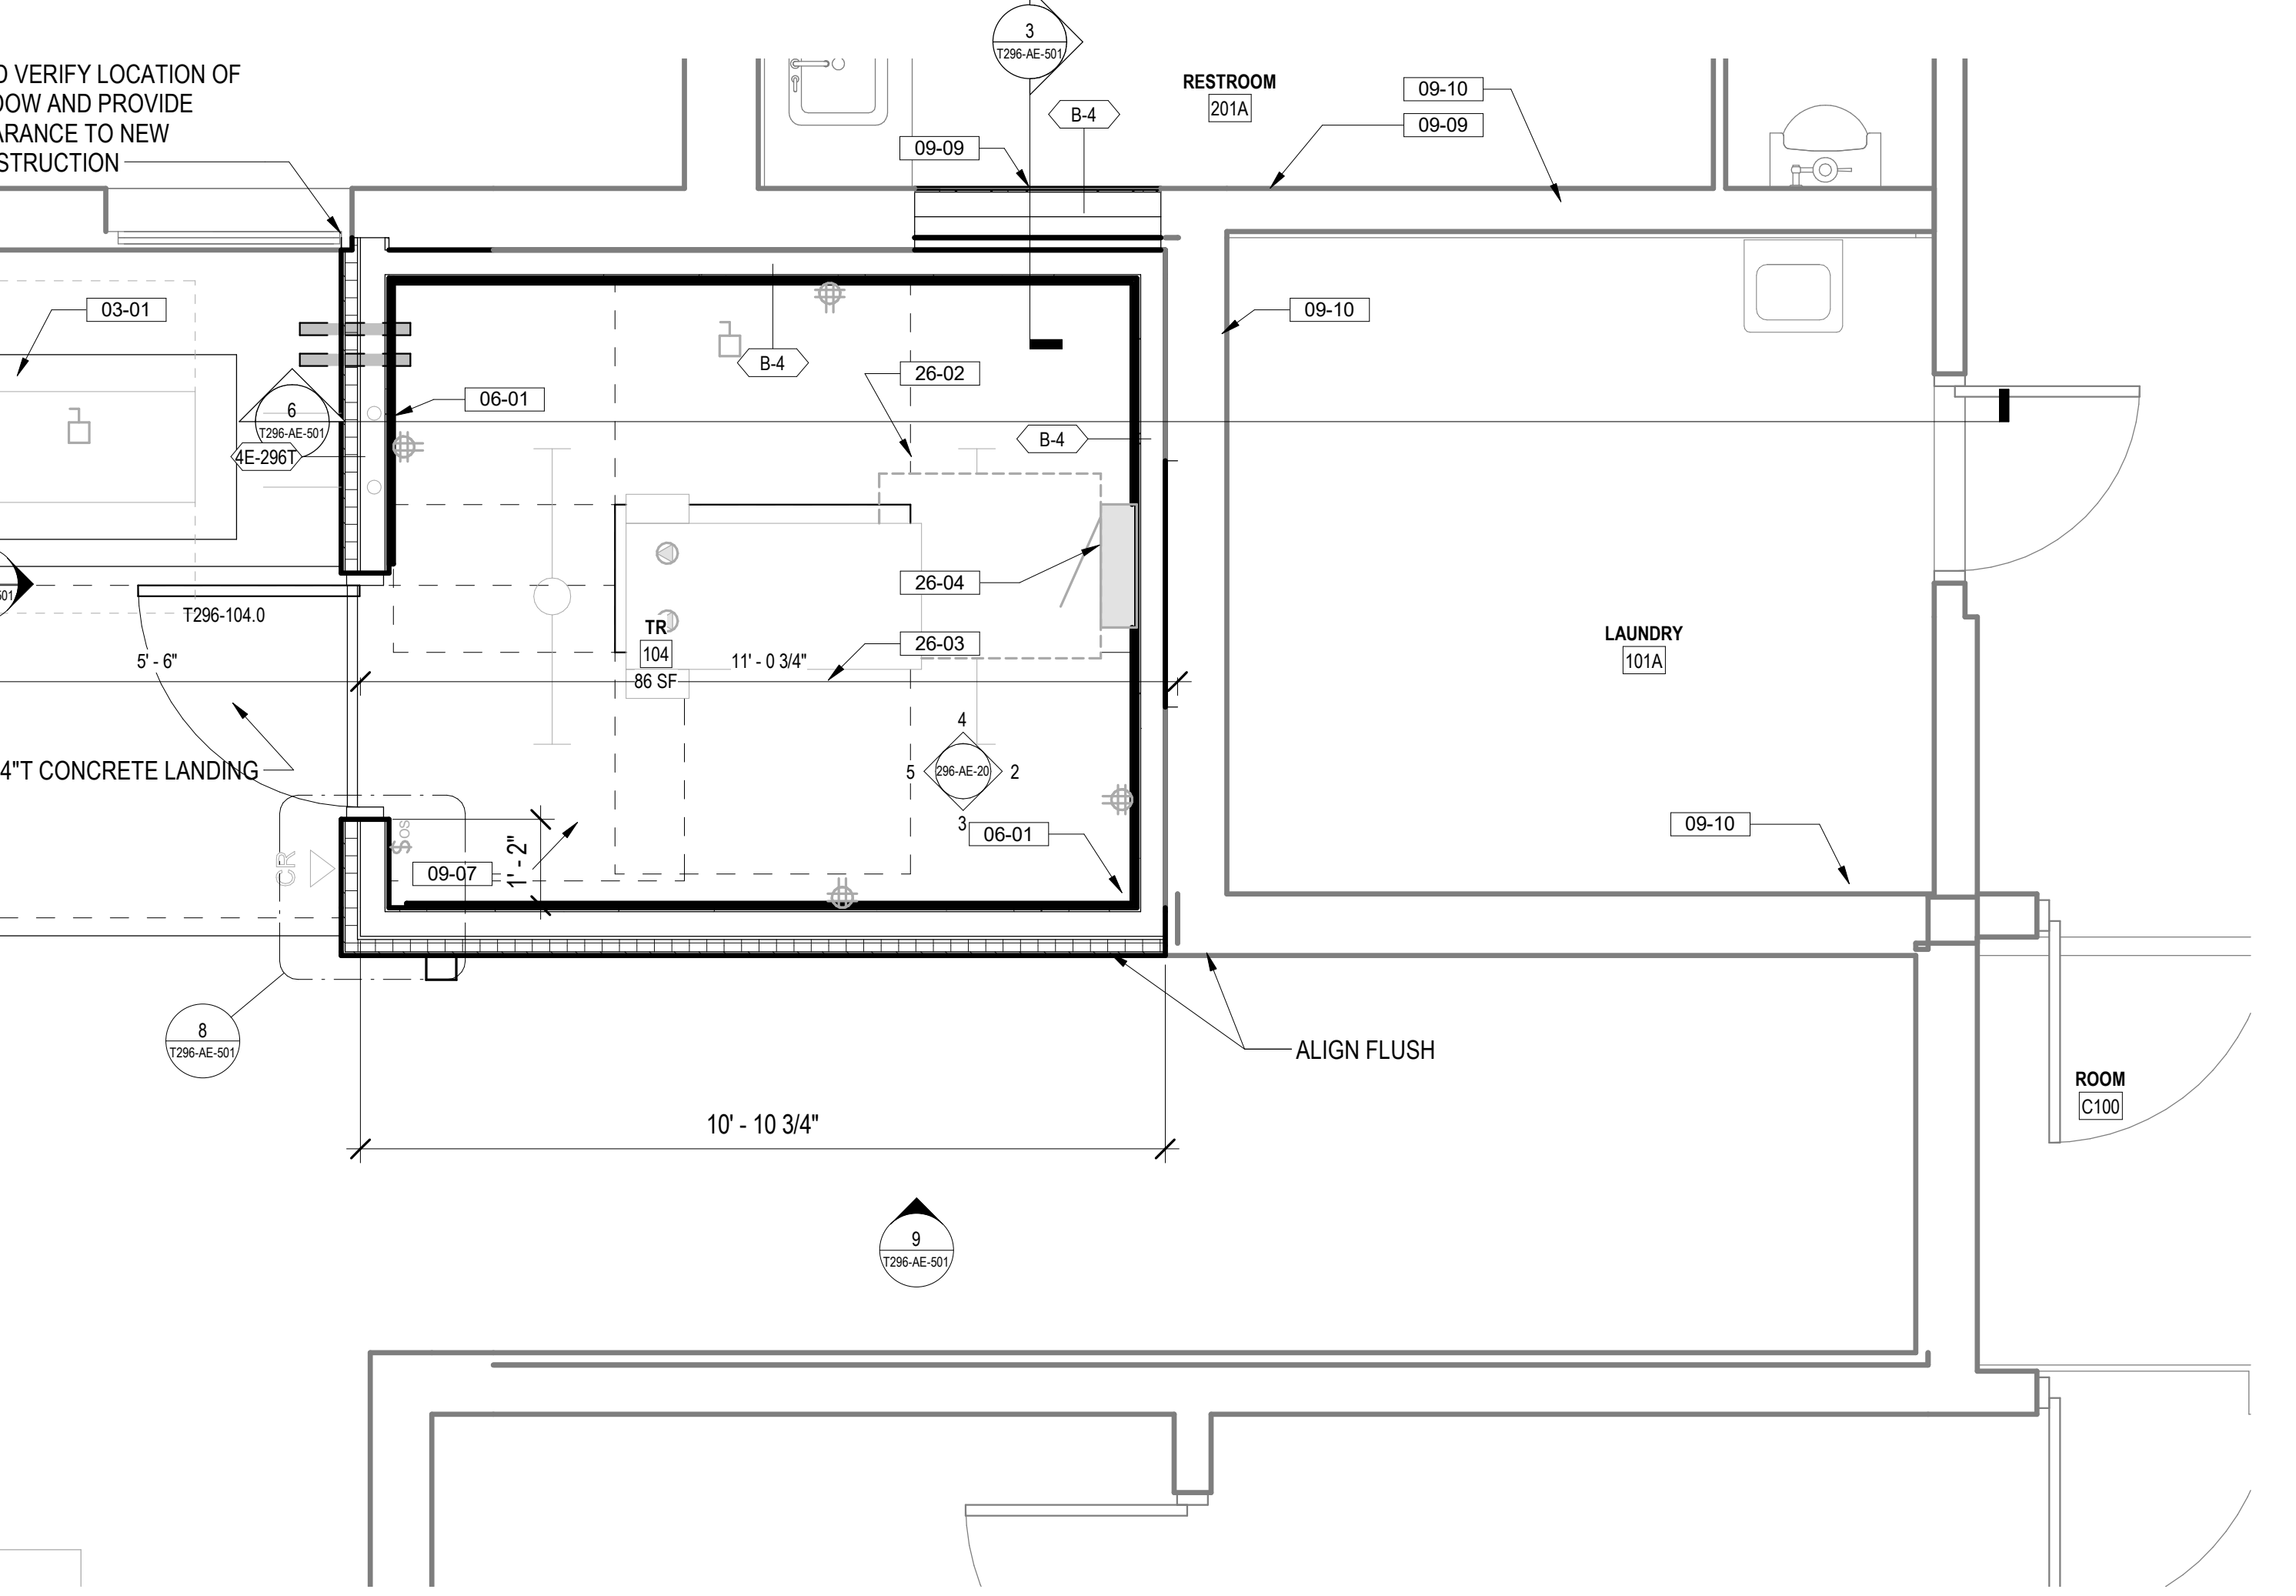

1 TR 104 ENLARGED PLAN
1/2" = 1'-0"

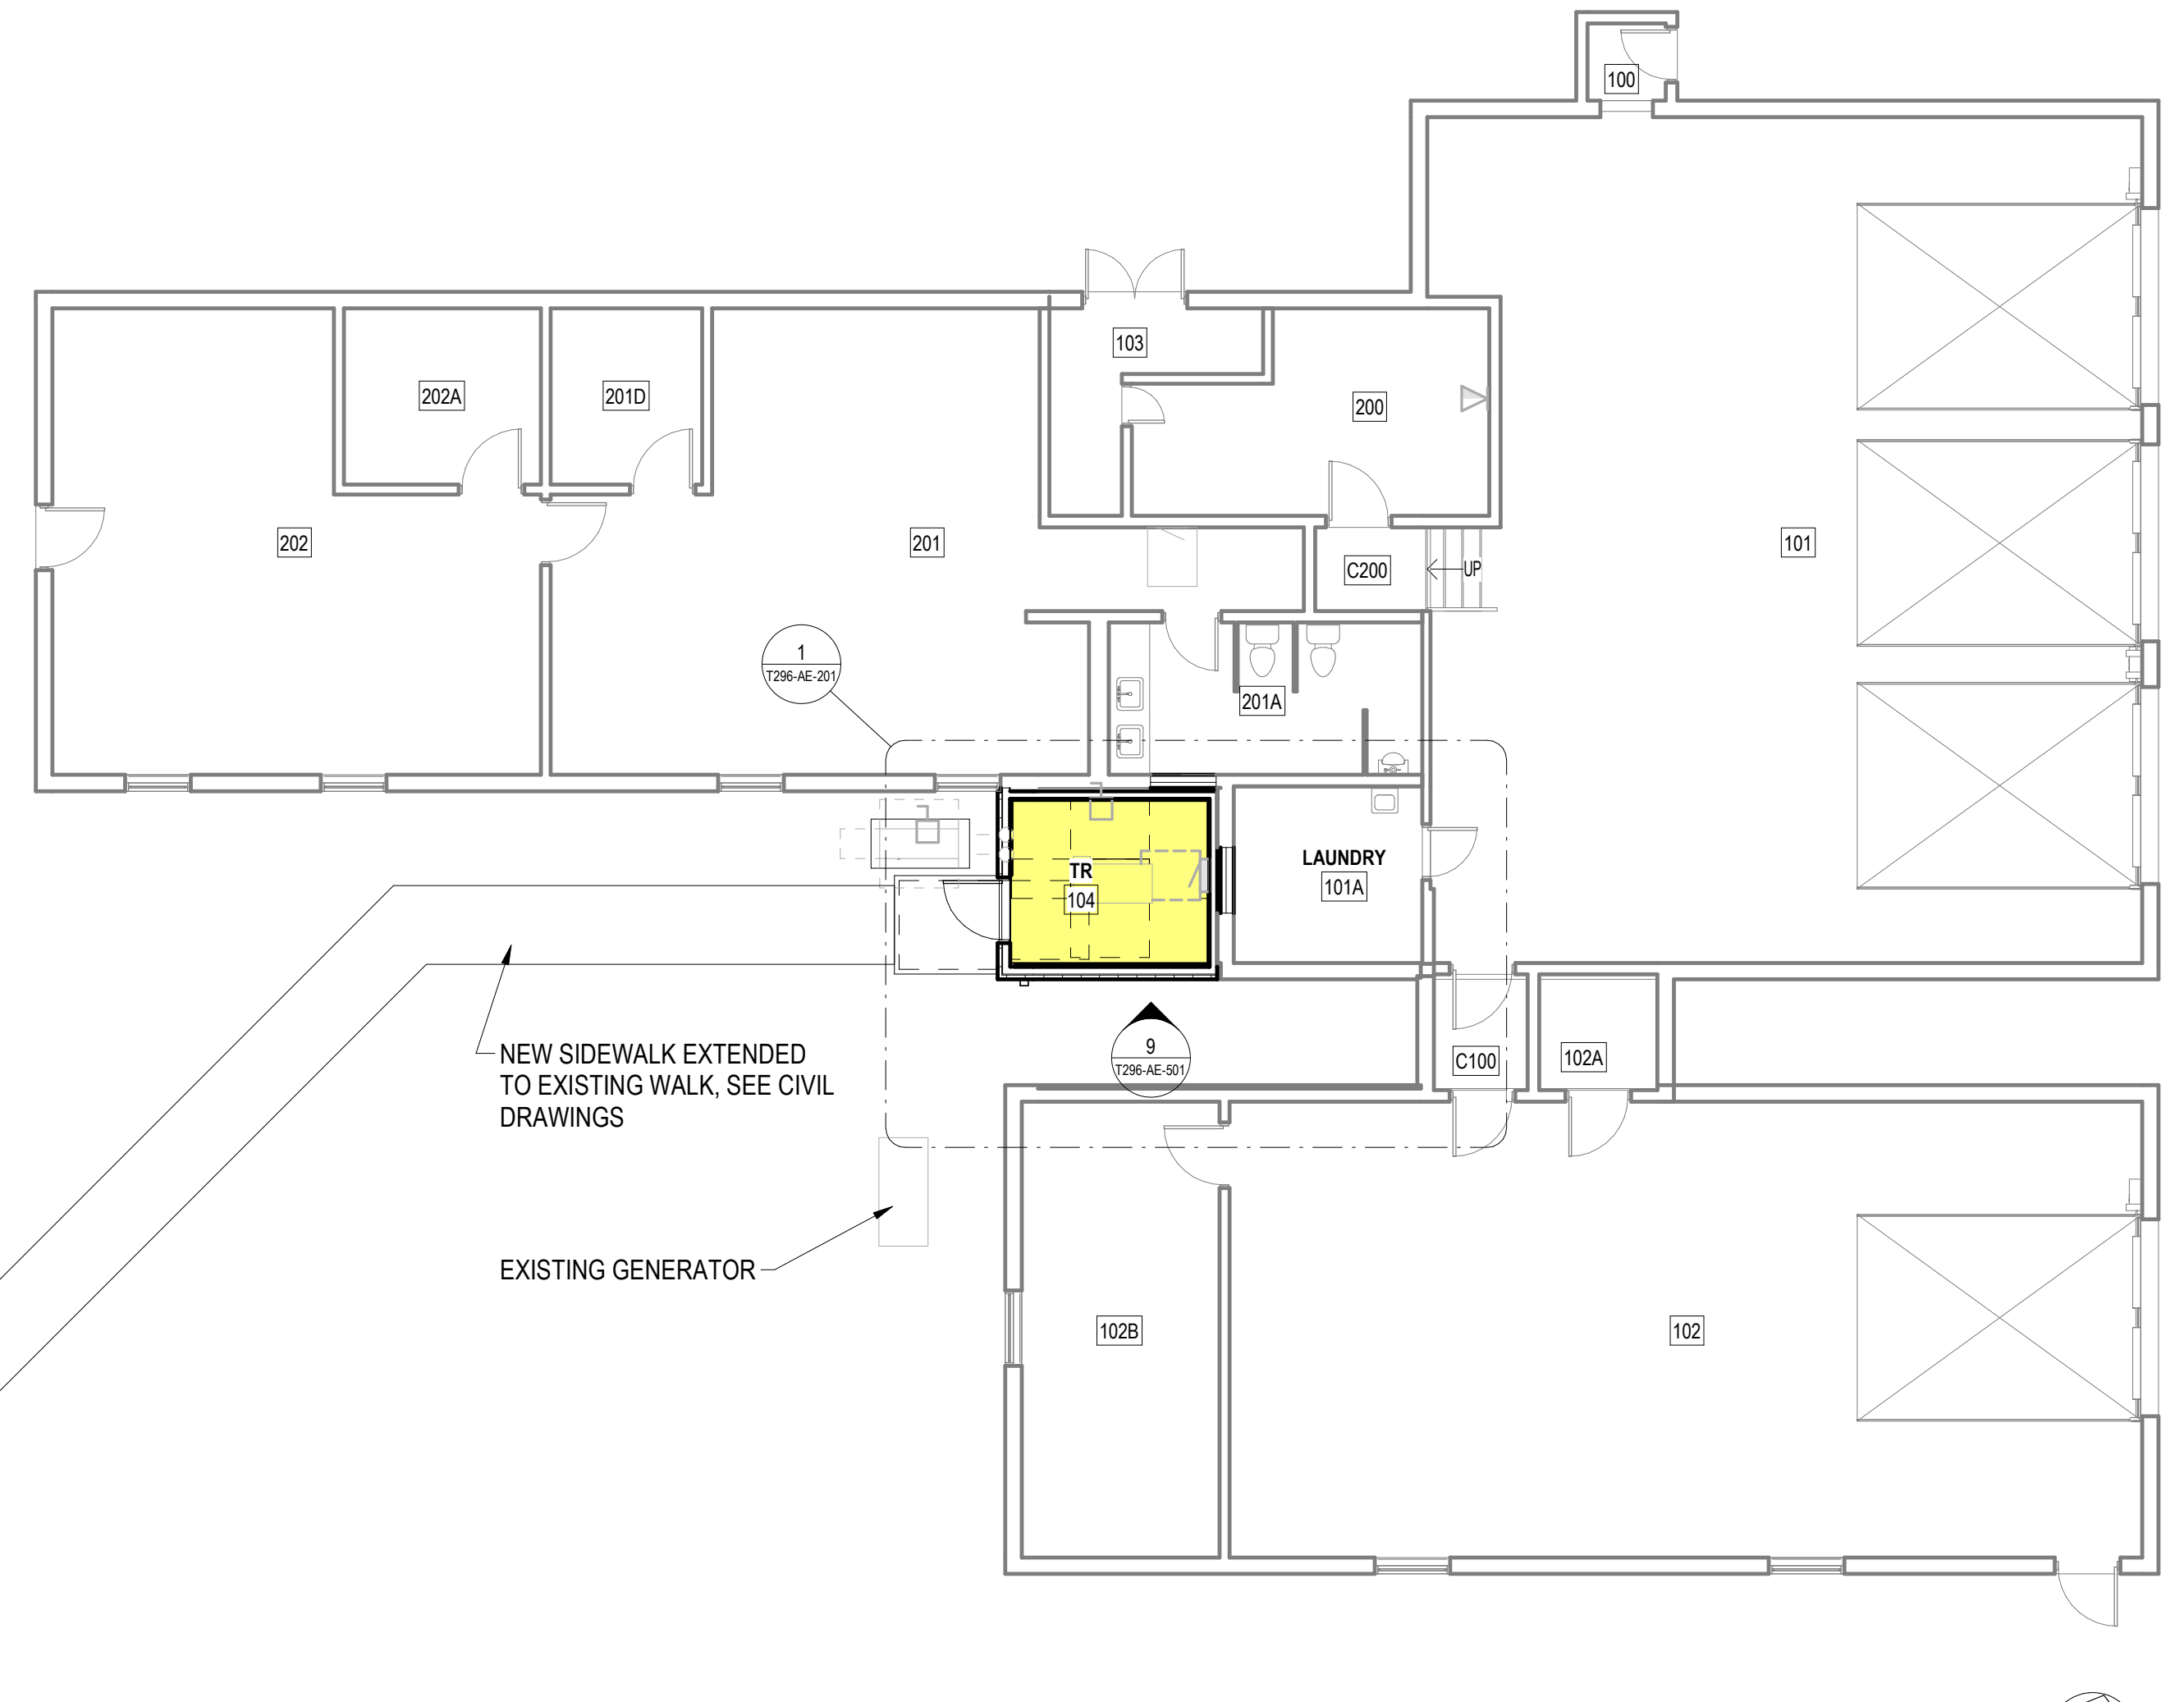

6 LEVEL 1 FLOOR PLAN
1/8" = 1'-0"

FLOOR PLAN NOTES

- 1. SEE G SERIES SHEETS FOR BALANCE OF PLAN GENERAL NOTES.
2. REFER TO STRUCTURAL, MECHANICAL, AND ELECTRICAL DRAWINGS FOR ADDITIONAL INFORMATION.
3. PROVIDE ALL BACKING FOR MILLWORK, GRAB BARS, AND ANY AND ALL WALL MOUNTED EQUIPMENT OR ACCESSORIES.
4. ALL DIMENSIONS ARE FROM STRUCTURAL OR UNFINISHED FACE OF STUD, UNLESS OTHERWISE NOTED.
5. PROVIDE A SMOOTH AND LEVEL FINISH FLOOR, TYP. PATCH AND REPAIR ALL INCONSISTENCIES IN FLOOR ELEVATIONS.
6. PATCH AND REPAIR ANY / ALL WALL SURFACES AS REQUIRED TO PROVIDE SUITABLE SUBSTRATE FOR FINISHES.
7. REFER TO DOOR AND FRAME SCHEDULE FOR DOORS REQUIRING ADA ACCESS CONTROL.
8. PROVIDE ACOUSTICAL SEALANT AROUND WALL EDGES, TOP AND BOTTOM, AND PENETRATIONS, AND INSTALL PUTTY PADS AROUND ELECTRICAL BOXES WHERE PARTITION CONTAINS ACOUSTICAL INSULATION.
9. ALL TELECOMMUNICATION ROOMS ARE TO HAVE EXPOSED STRUCTURE UNLESS NOTED OTHERWISE, NO CEILINGS SPECIFIED.

ROOF PLAN NOTES

- 1. PROVIDE ROOF CRICKETS AT ALL UPSLOPE AREAS OF MECHANICAL EQUIPMENT, CURBS AND ROOF HATCHES.
2. CRICKETS TO SLOPE POSITIVELY 1/2" MINIMUM PER FOOT FROM HORIZONTAL PLANE.
3. MAINTAIN 1/8" PER FOOT MINIMUM FOR ALL CRICKET VALLEYS.
4. CRICKETS SHOWN ARE FOR REFERENCE ONLY; CONTRACTOR TO PROVIDE DETAILED LAYOUT PLAN FOR ARCHITECT'S REVIEW PRIOR TO INSTALLATION.
5. ROOF PENETRATIONS OF ANY KIND SHALL NOT BE LOCATED IN CRICKET VALLEYS.
6. IN ADDITION TO OPENING AND EQUIPMENT SHOWN ON THIS DRAWING, MECHANICAL AND ELECTRICAL DRAWINGS.
7. INDICATE ADDITIONAL ITEMS PENETRATING THE ROOF ASSEMBLY; PROVIDE APPROPRIATE FLASHING.
8. REFERENCE MECH DRAWINGS FOR VENT LOCATIONS, EQUIPMENT LOCATIONS, AND ADDITIONAL INFORMATION, TYP.

FLOOR PLAN LEGEND

- CARD READER, REF TELECOM DRAWINGS
DATA PORT, REF TELECOM DRAWINGS
OUTLET, REF ELEC DRAWINGS
WIRELESS ACCESS POINT, REF TELECOM DRAWINGS
ELEC PANEL, REF ELEC DRAWINGS
STRIP LIGHT FIXTURE, REF ELEC DRAWINGS

KEY NOTES

- 03-01 NEW HOUSEKEEPING PAD, COORDINATE WITH MECHANICAL DRAWINGS FOR SIZE AND CIVIL DRAWINGS FOR DETAILS.
06-01 INSTALL 3/4" AC GRADE OR BETTER FIRE RETARDANT PLYWOOD; PAINT WITH TWO COATS OF SEMI-GLOSS BRIGHT WHITE FIRE RETARDANT PAINT; MOUNT BOTTOM OF PLYWOOD AT 4" F.F., TOP OF PLYWOOD AT 8" F.F.
09-01 PAINT WALL ABOVE PLYWOOD WITH SEMI-GLOSS PAINT, COLOR TO MATCH PLYWOOD PAINT.
09-07 INSTALL STATIC DISSIPATIVE RESILIENT FLOORING
09-09 ADH'S JOINT COMPOUND AND FEATHER A MINIMUM OF 3" HORIZONTALLY AS REQUIRED TO ACHIEVE A SMOOTH AND UNIFORM APPEARANCE.
09-10 PAINT FULL LENGTH OF WALL TO NEAREST EXTERIOR OR INTERIOR CORNER, COLOR TO MATCH EXISTING WALLS.
09-18 8" HIGH COVERED RUBBER WALL BASE, COLOR TO BE SELECTED FROM MANUFACTURERS STANDARD SELECTION.
22-02 UPRIGHT HEAD FIRE SUPPRESSION SPRINKLER HEAD SHOWN FOR REFERENCE ONLY; FIRE SUPPRESSION CONTRACTOR TO VERIFY ACTUAL QUANTITIES REQUIRED; COORDINATE INSTALLATION WITH MECH DRAWINGS.
23-05 MECHANICAL UNITS, SEE MECH DRAWINGS FOR SIZE AND SPECS.
25-02 3" PERIMETER CLEARANCE AROUND SERVER RACK SHOWN DASHED.
25-03 TELECOMM RACK, SEE TELECOMMUNICATION DRAWINGS.
25-04 ELECTRICAL PANELS, SEE ELECTRICAL DRAWINGS.
25-05 CABLE TRAY, SEE TELECOMMUNICATION DRAWINGS.
25-12 ELECTRICAL OUTLETS MOUNTED ON PLYWOOD.

PROJECT KEY PLAN




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CONSULTANT: A/E: GDM, 1000 W STEUBEN ST. UNIT 3, BINGEN, WA 98605, 541.436.4723, ADAM GODDIN, PE. Includes GDM ARCHITECTS - ENGINEERS logo.

ARCHITECT/ENGINEER OF RECORD: ARCHITECT: A&E DESIGN, 124 NORTH 29TH STREET, #100, BILLINGS, MONTANA 59101, 406.248.2633, T. MARCELLO PIERROTTET, AIA. Includes a&e logo.


STAMP: STATE OF MONTANA, ERIC PIERROTTET, ARCHITECT, LICENSED ARCHITECT. Includes professional seal.

PROGRAM CONTRACTING ACTIVITY CENTRAL (PCAC) U.S. Department of Veterans Affairs. Includes VA logo.

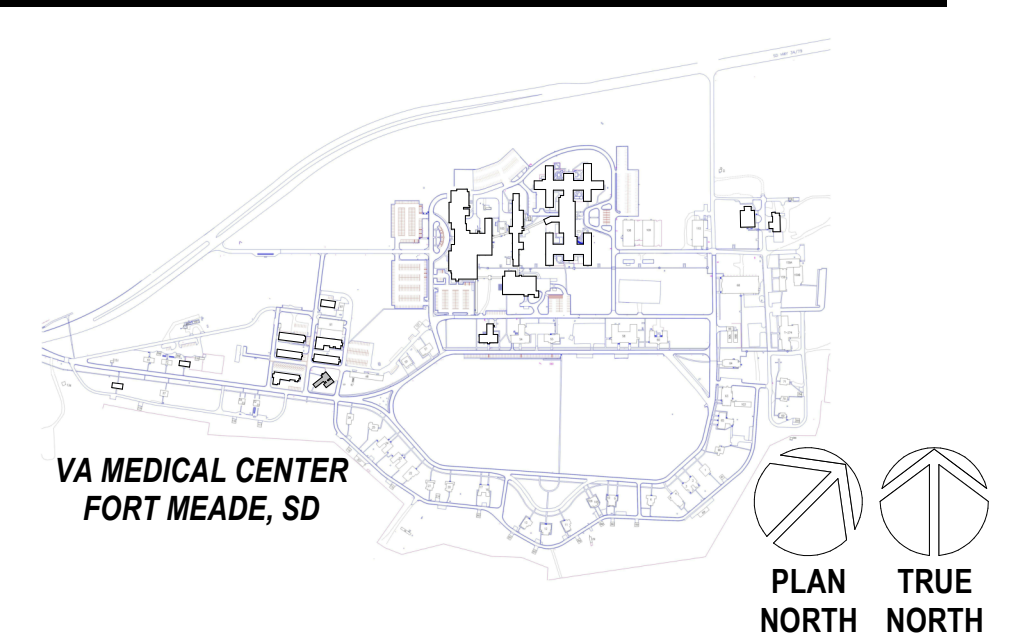
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PHASE: 100% CONSTRUCTION DOCUMENTS. FLS: FULLY SPRINKLERED.


PROJECT TITLE: EHRM INFRASTRUCTURE UPGRADES. PROJECT NUMBER: 568-21-701. BUILDING NUMBER: BLDG T296. DRAWING NUMBER: T296-AE-201. LOCATION: FORT MEADE, SOUTH DAKOTA. ISSUE DATE: 04/15/2022. CHECKED BY: TMP. DRAWN BY: JPR.

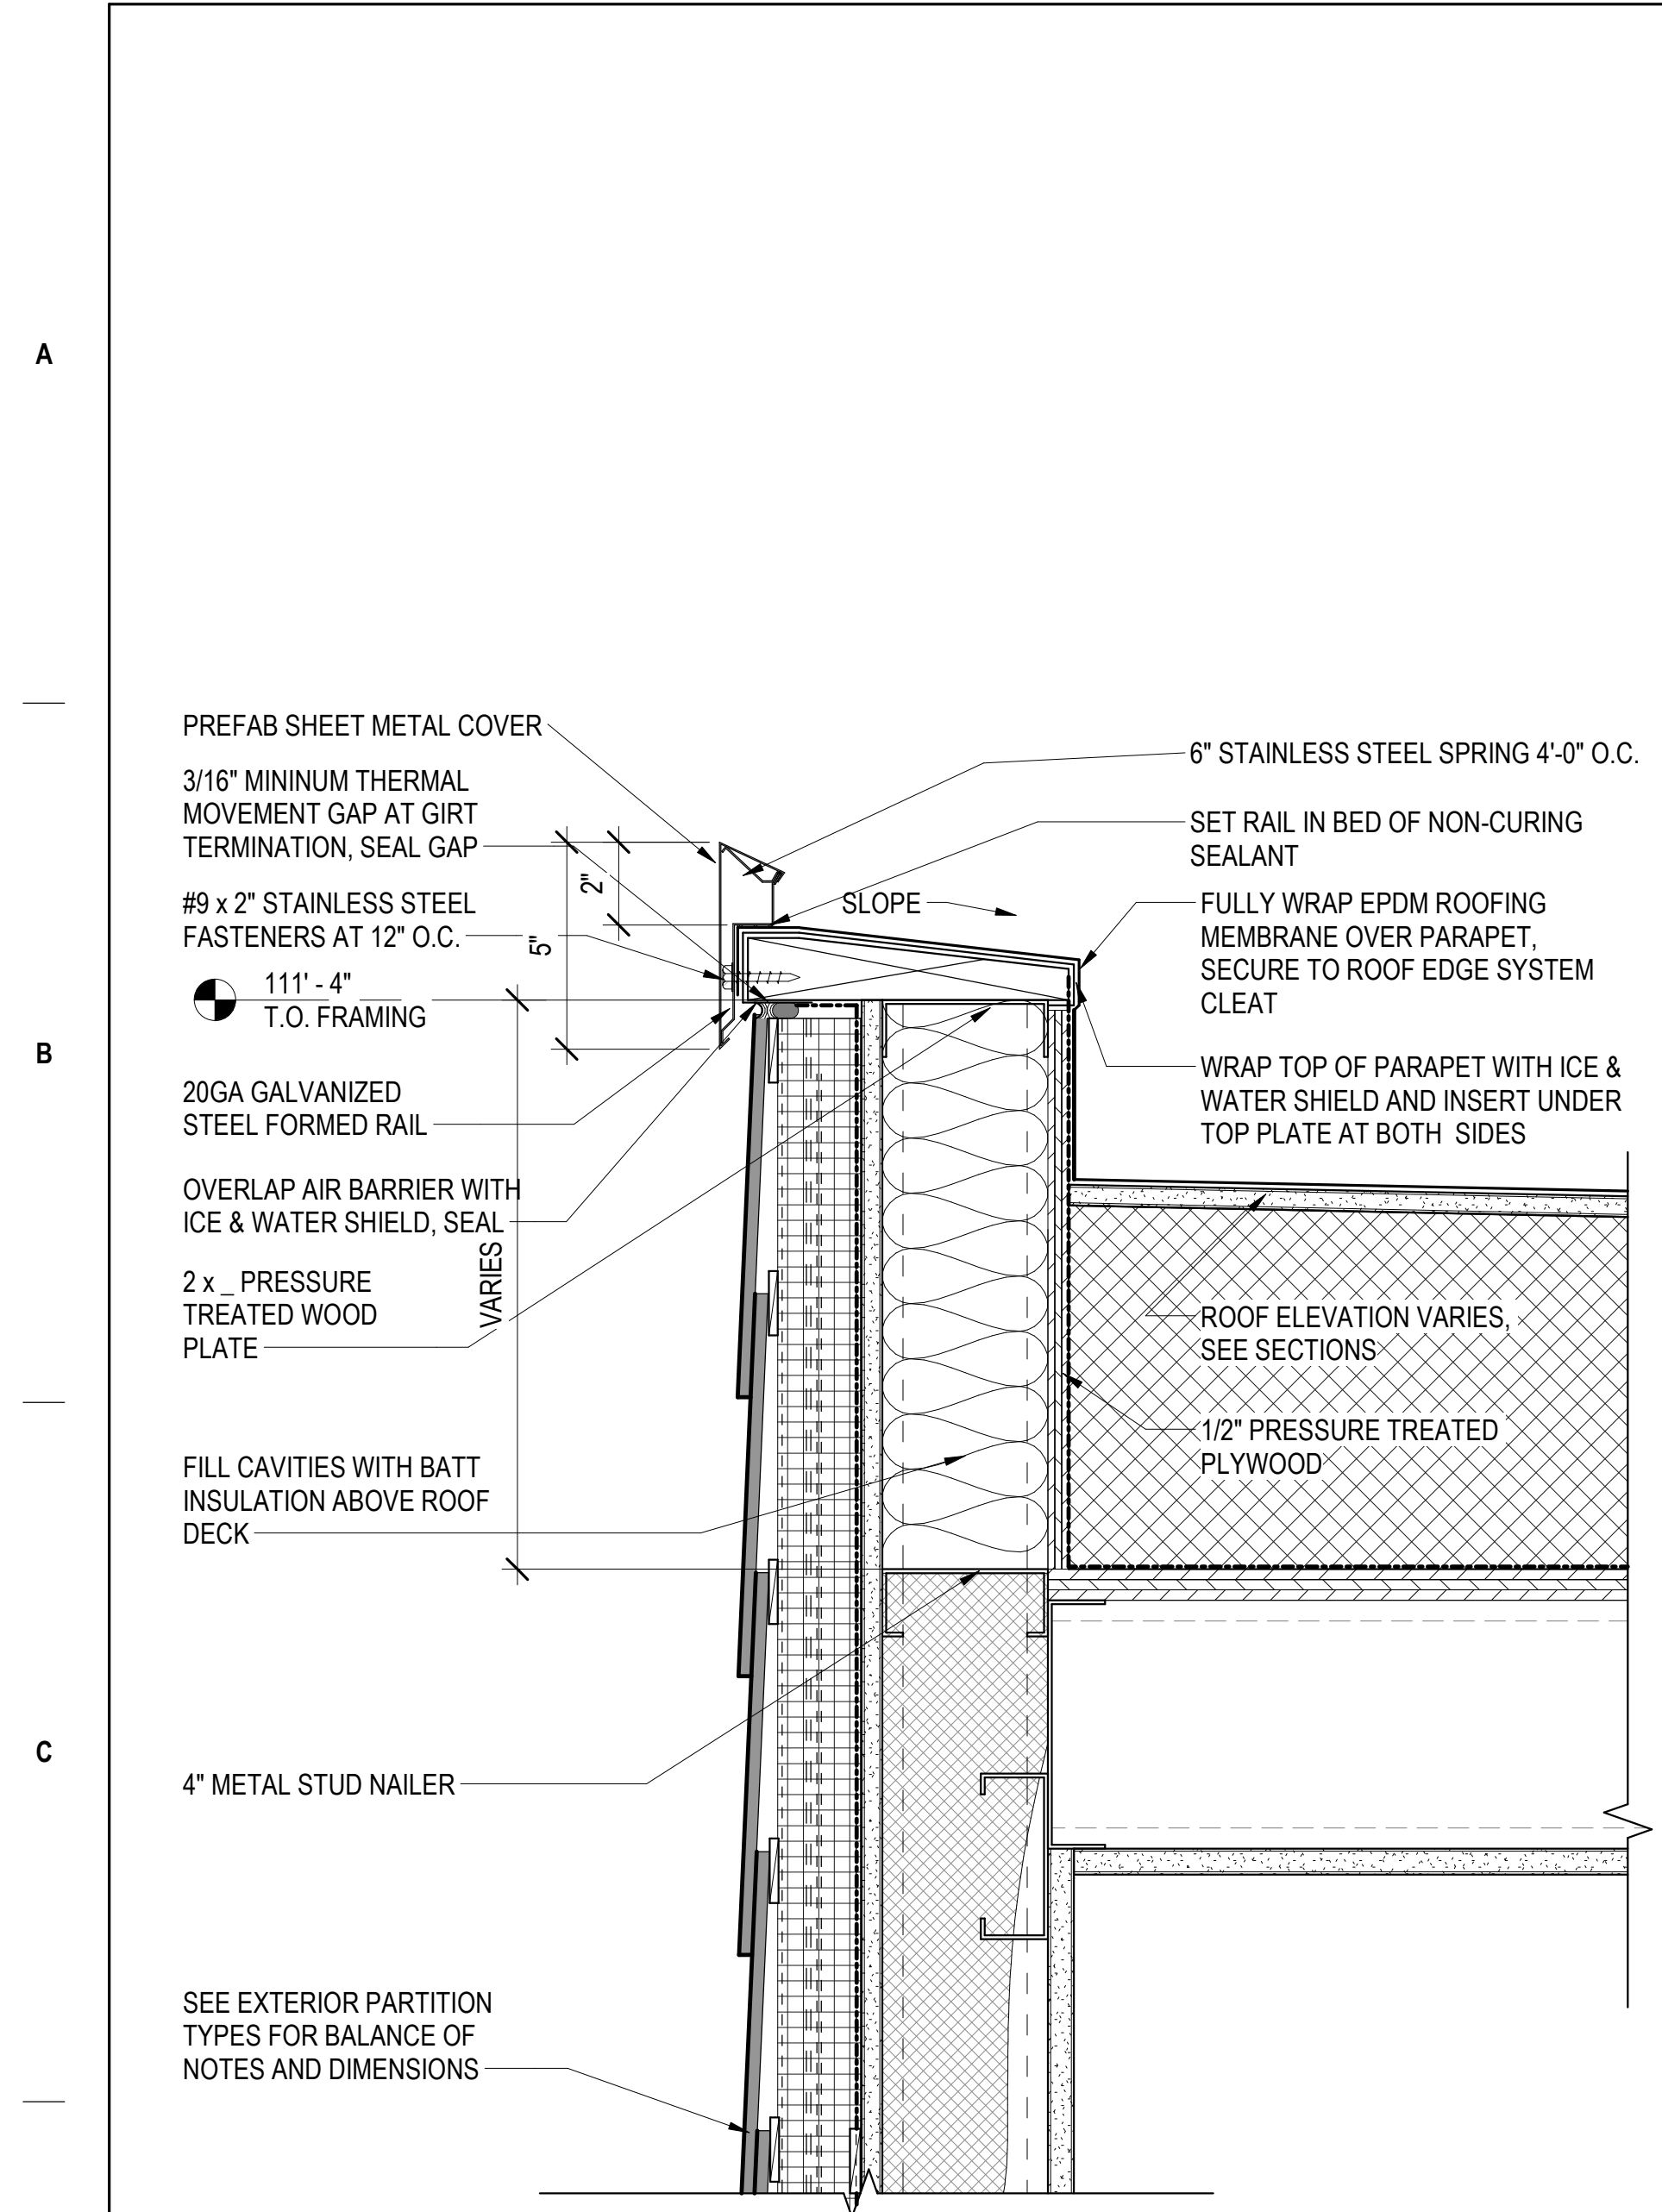


2 TYPICAL PARAPET COPING SECTION DETAIL
3" = 1'-0"

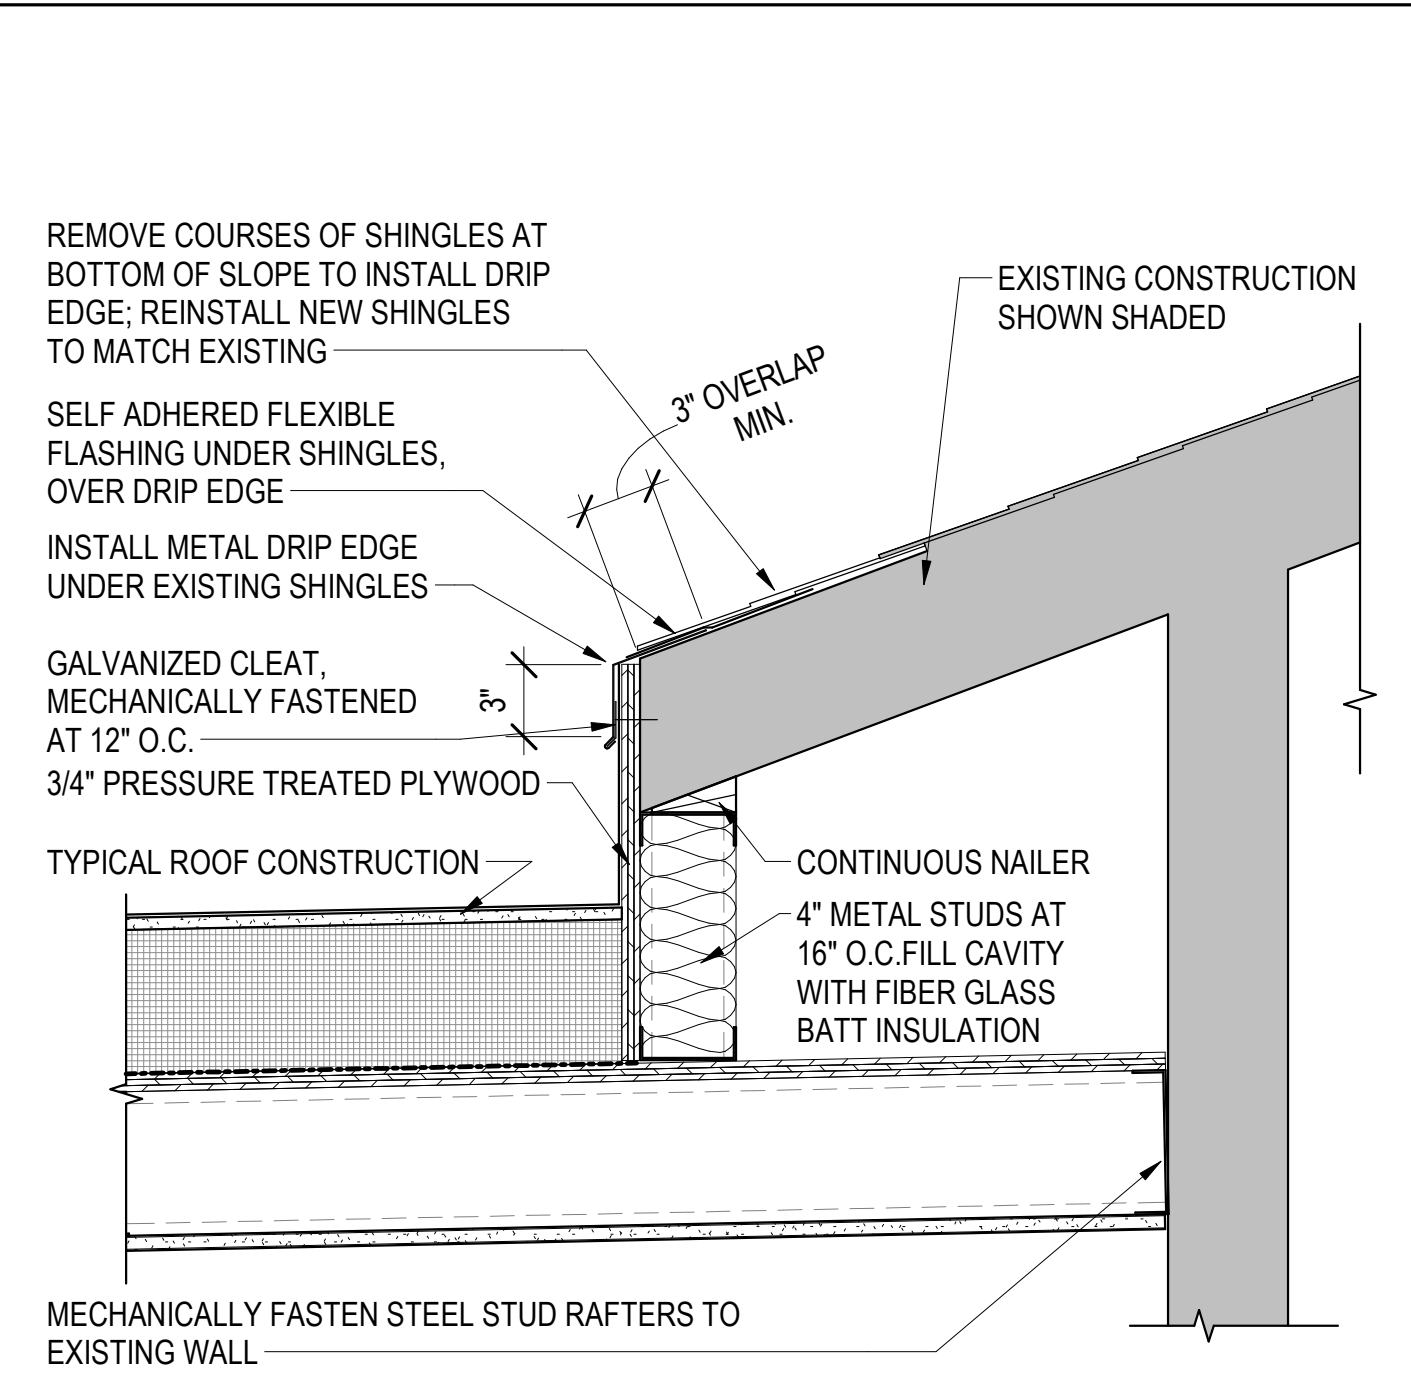


5 NEW / EXISTING ROOF TRANSITION DETAIL
1 1/2" = 1'-0"

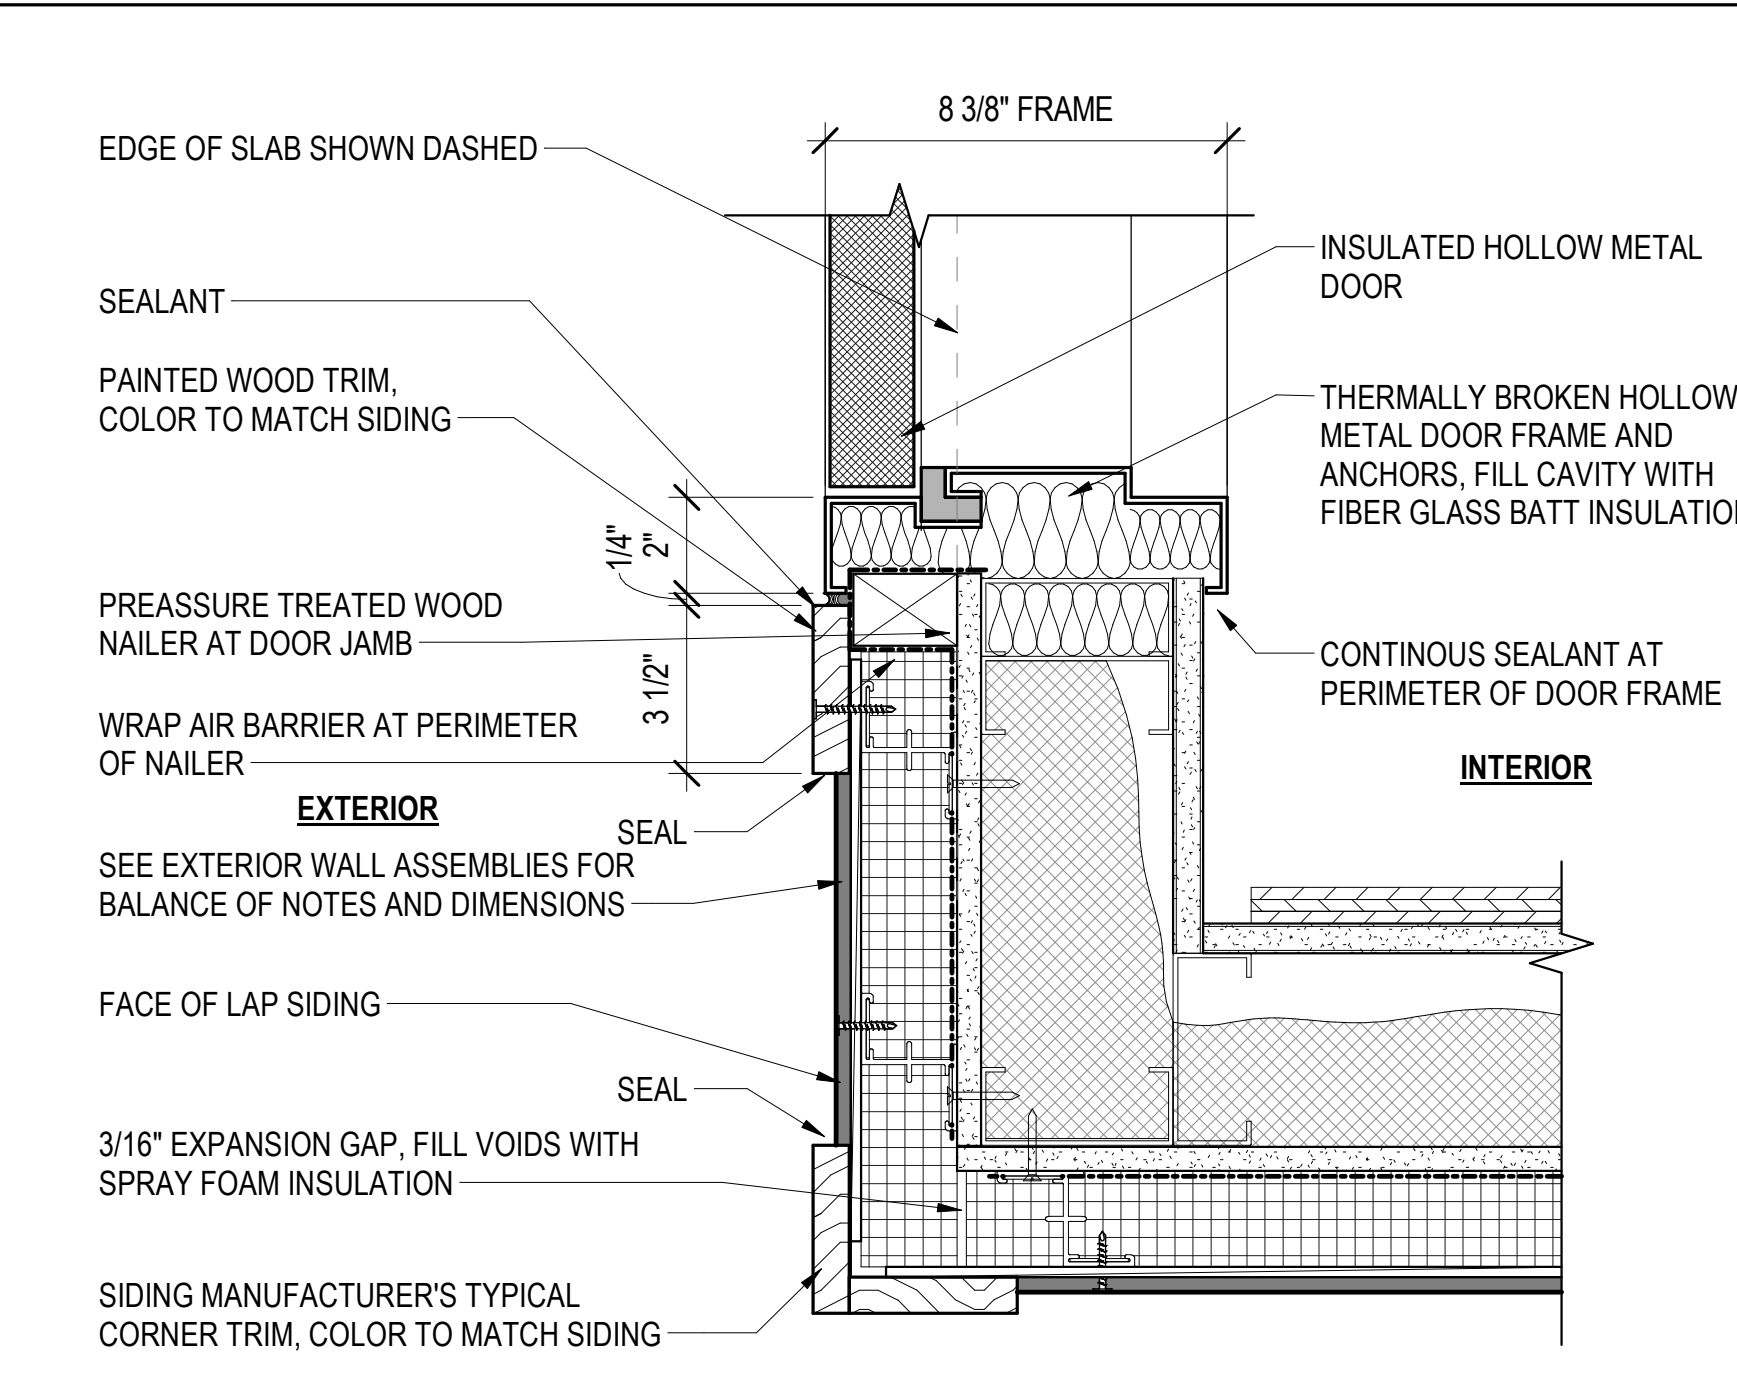


8 TYPICAL JAMB AT HM DOOR
3" = 1'-0"

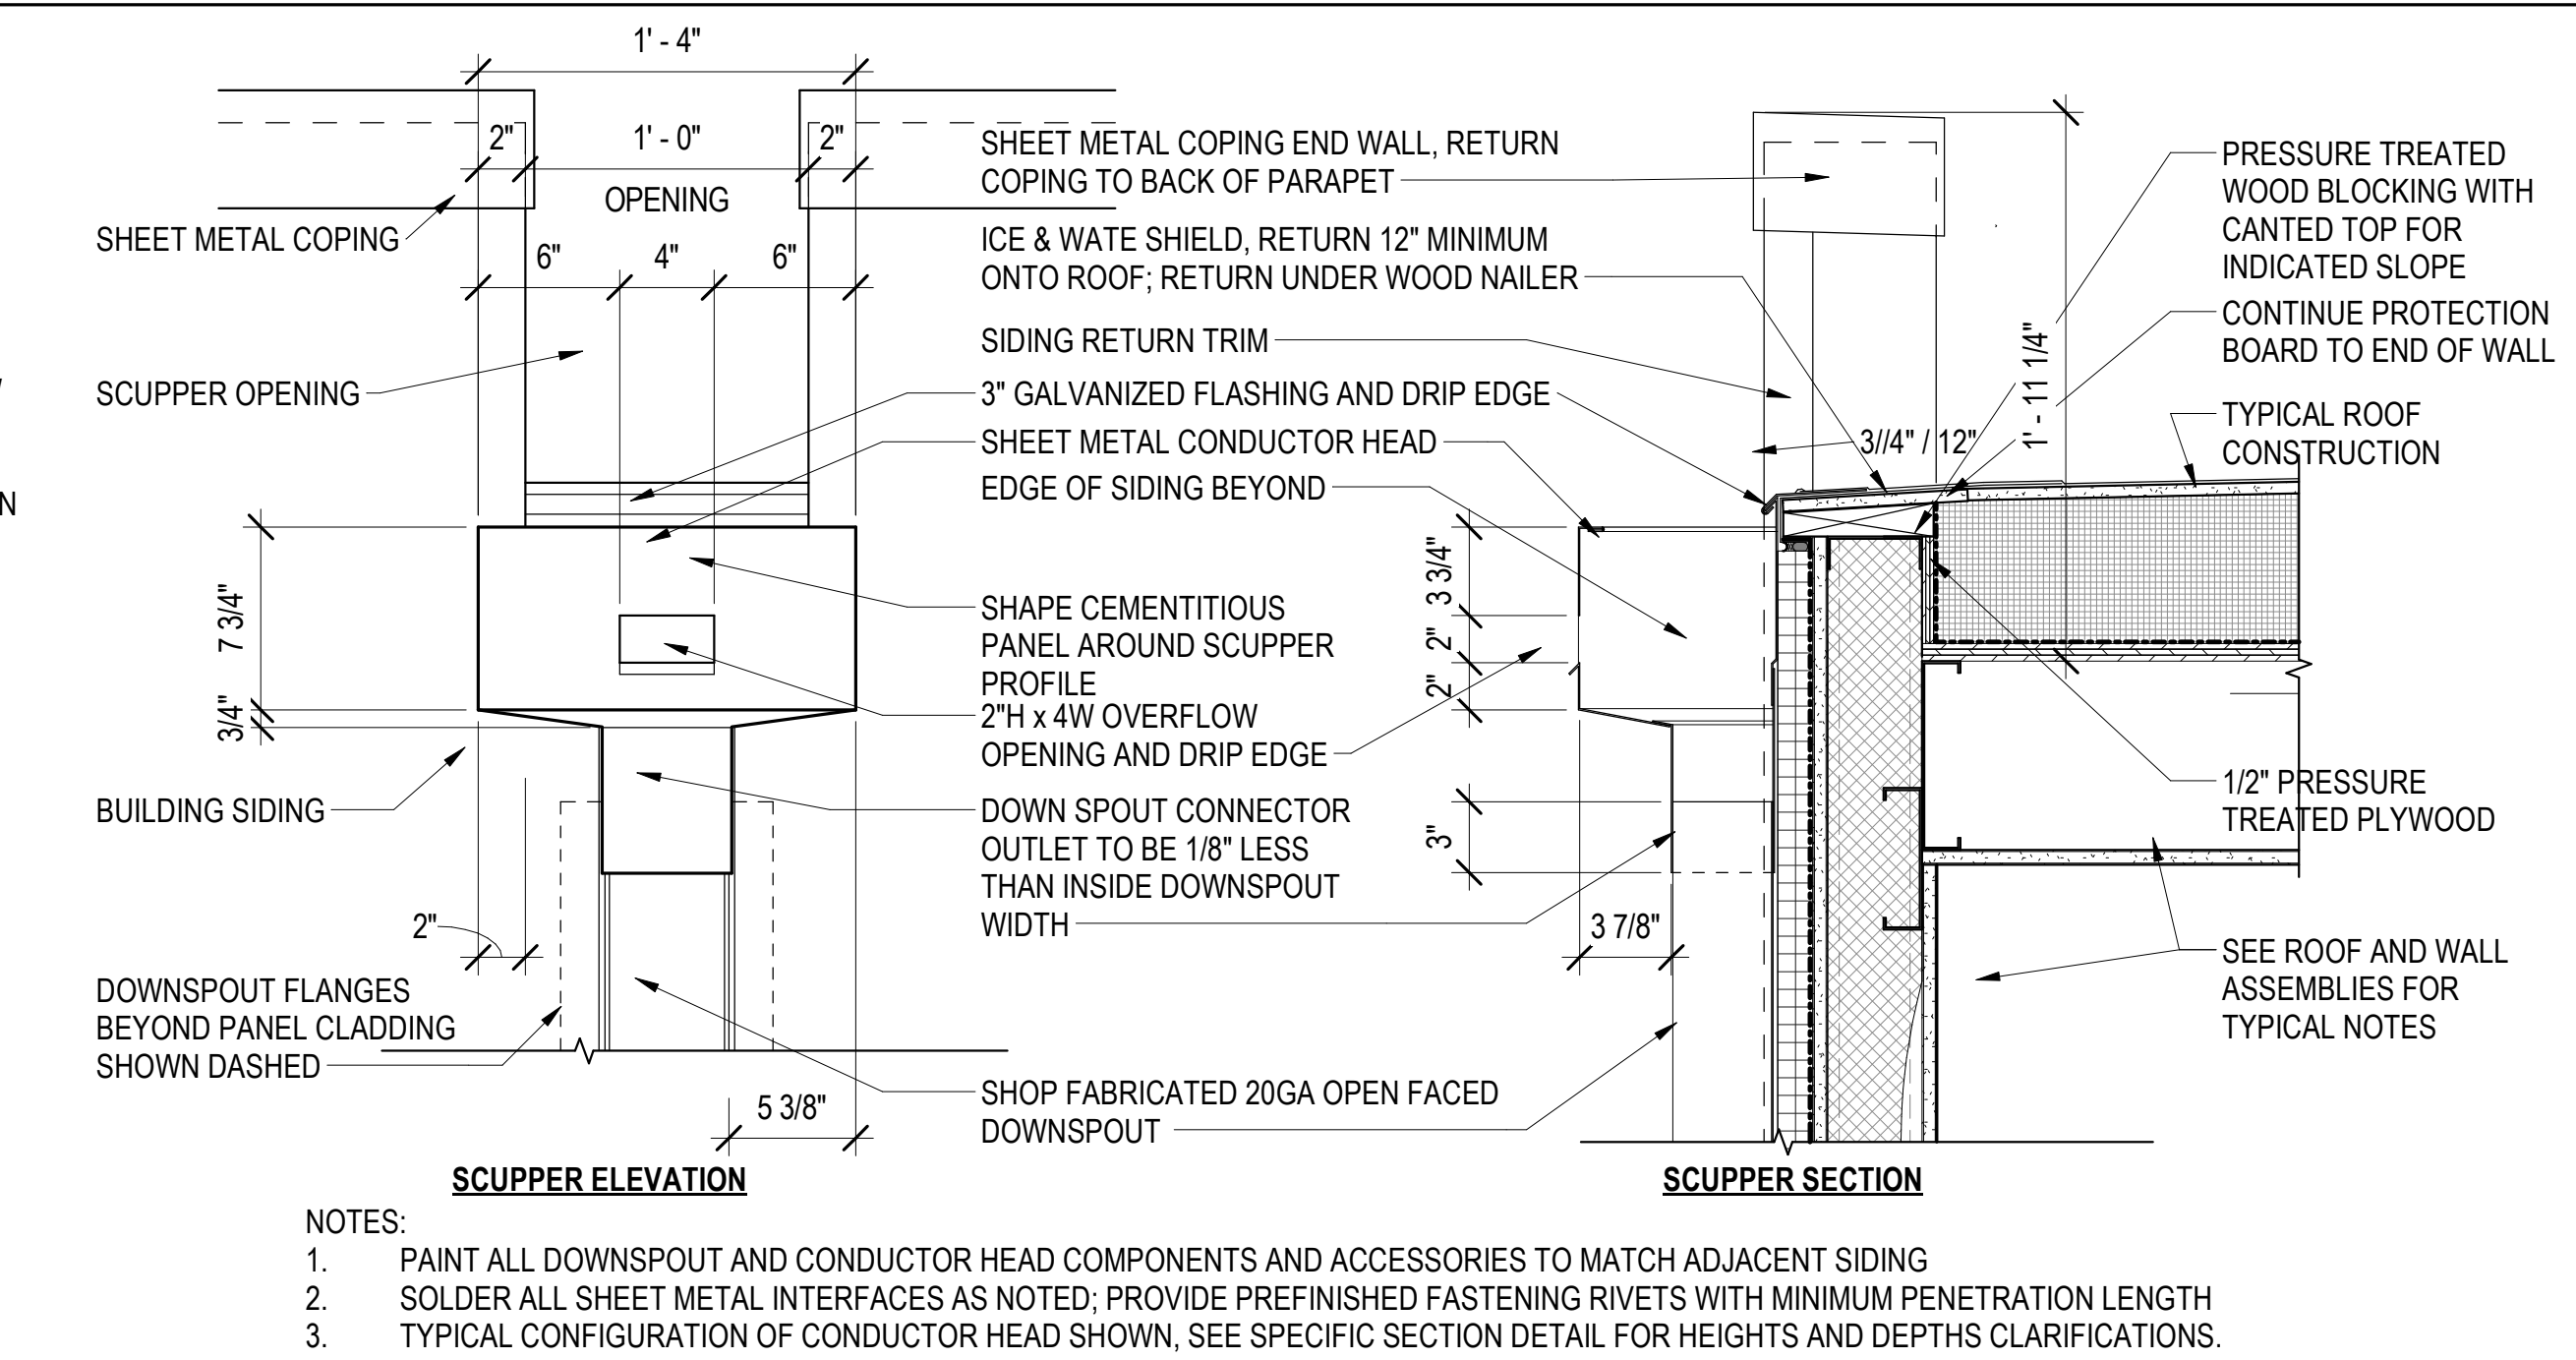


10 CONDUCTOR HEAD SECTION
1 1/2" = 1'-0"

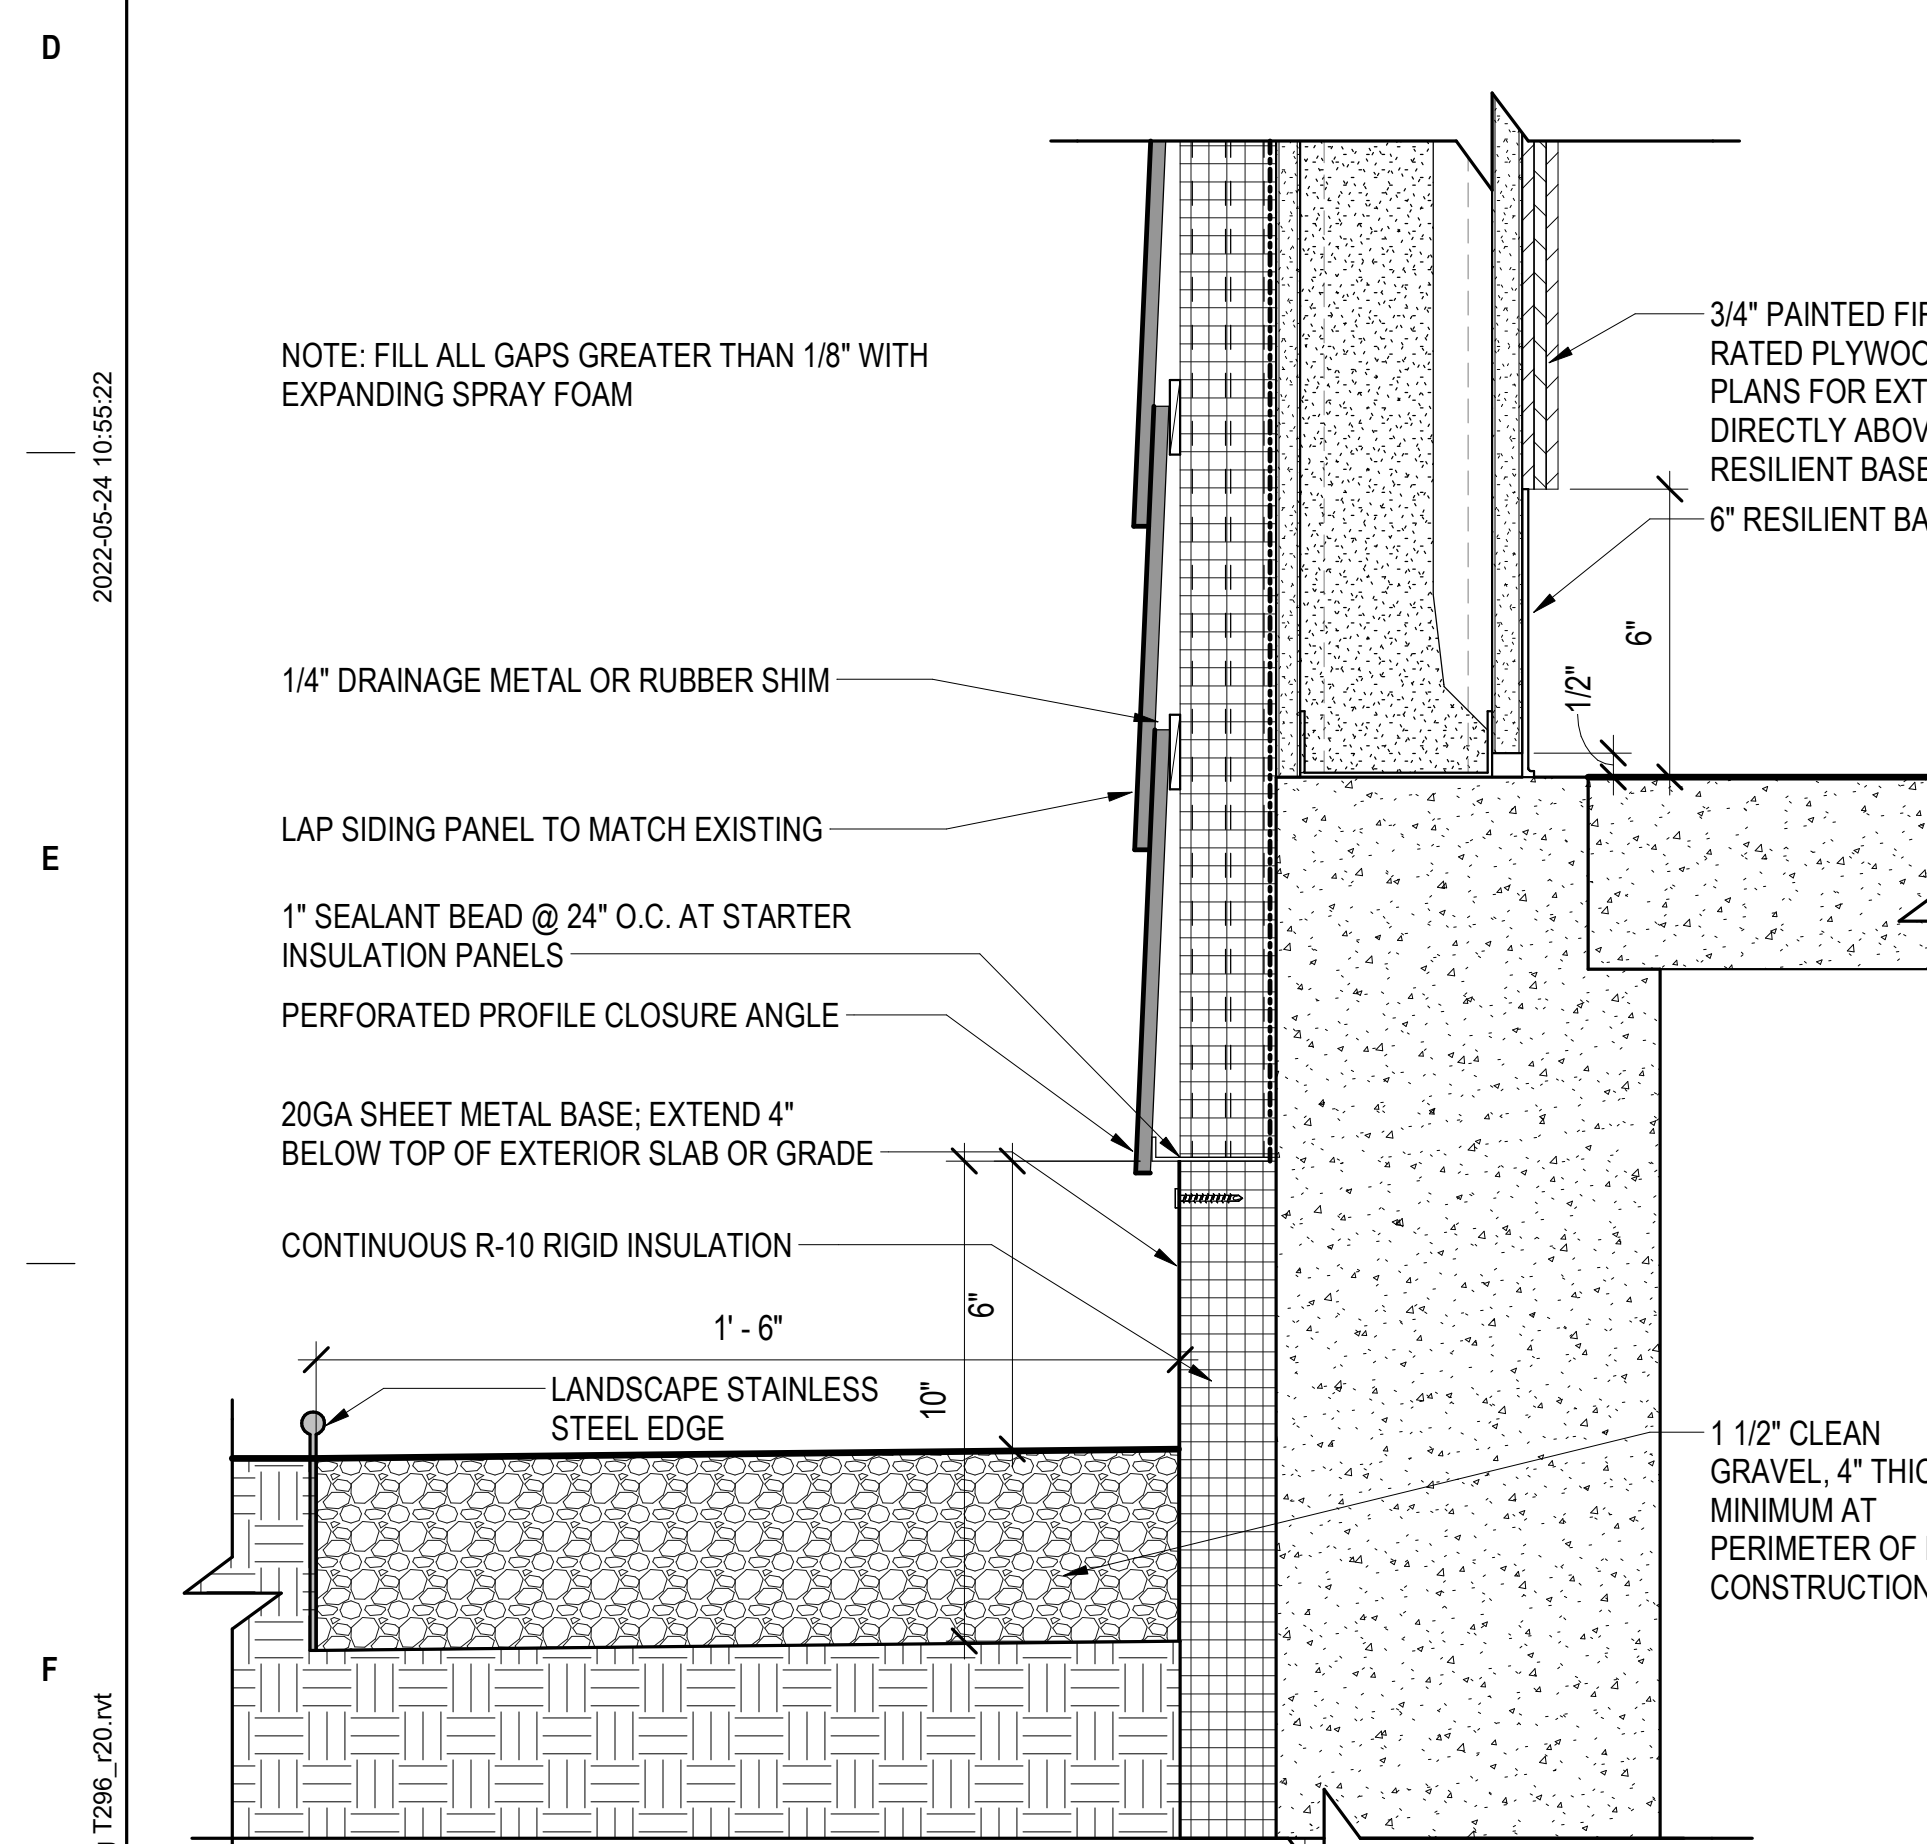


1 EXTERIOR WALL BASE DETAIL
3" = 1'-0"

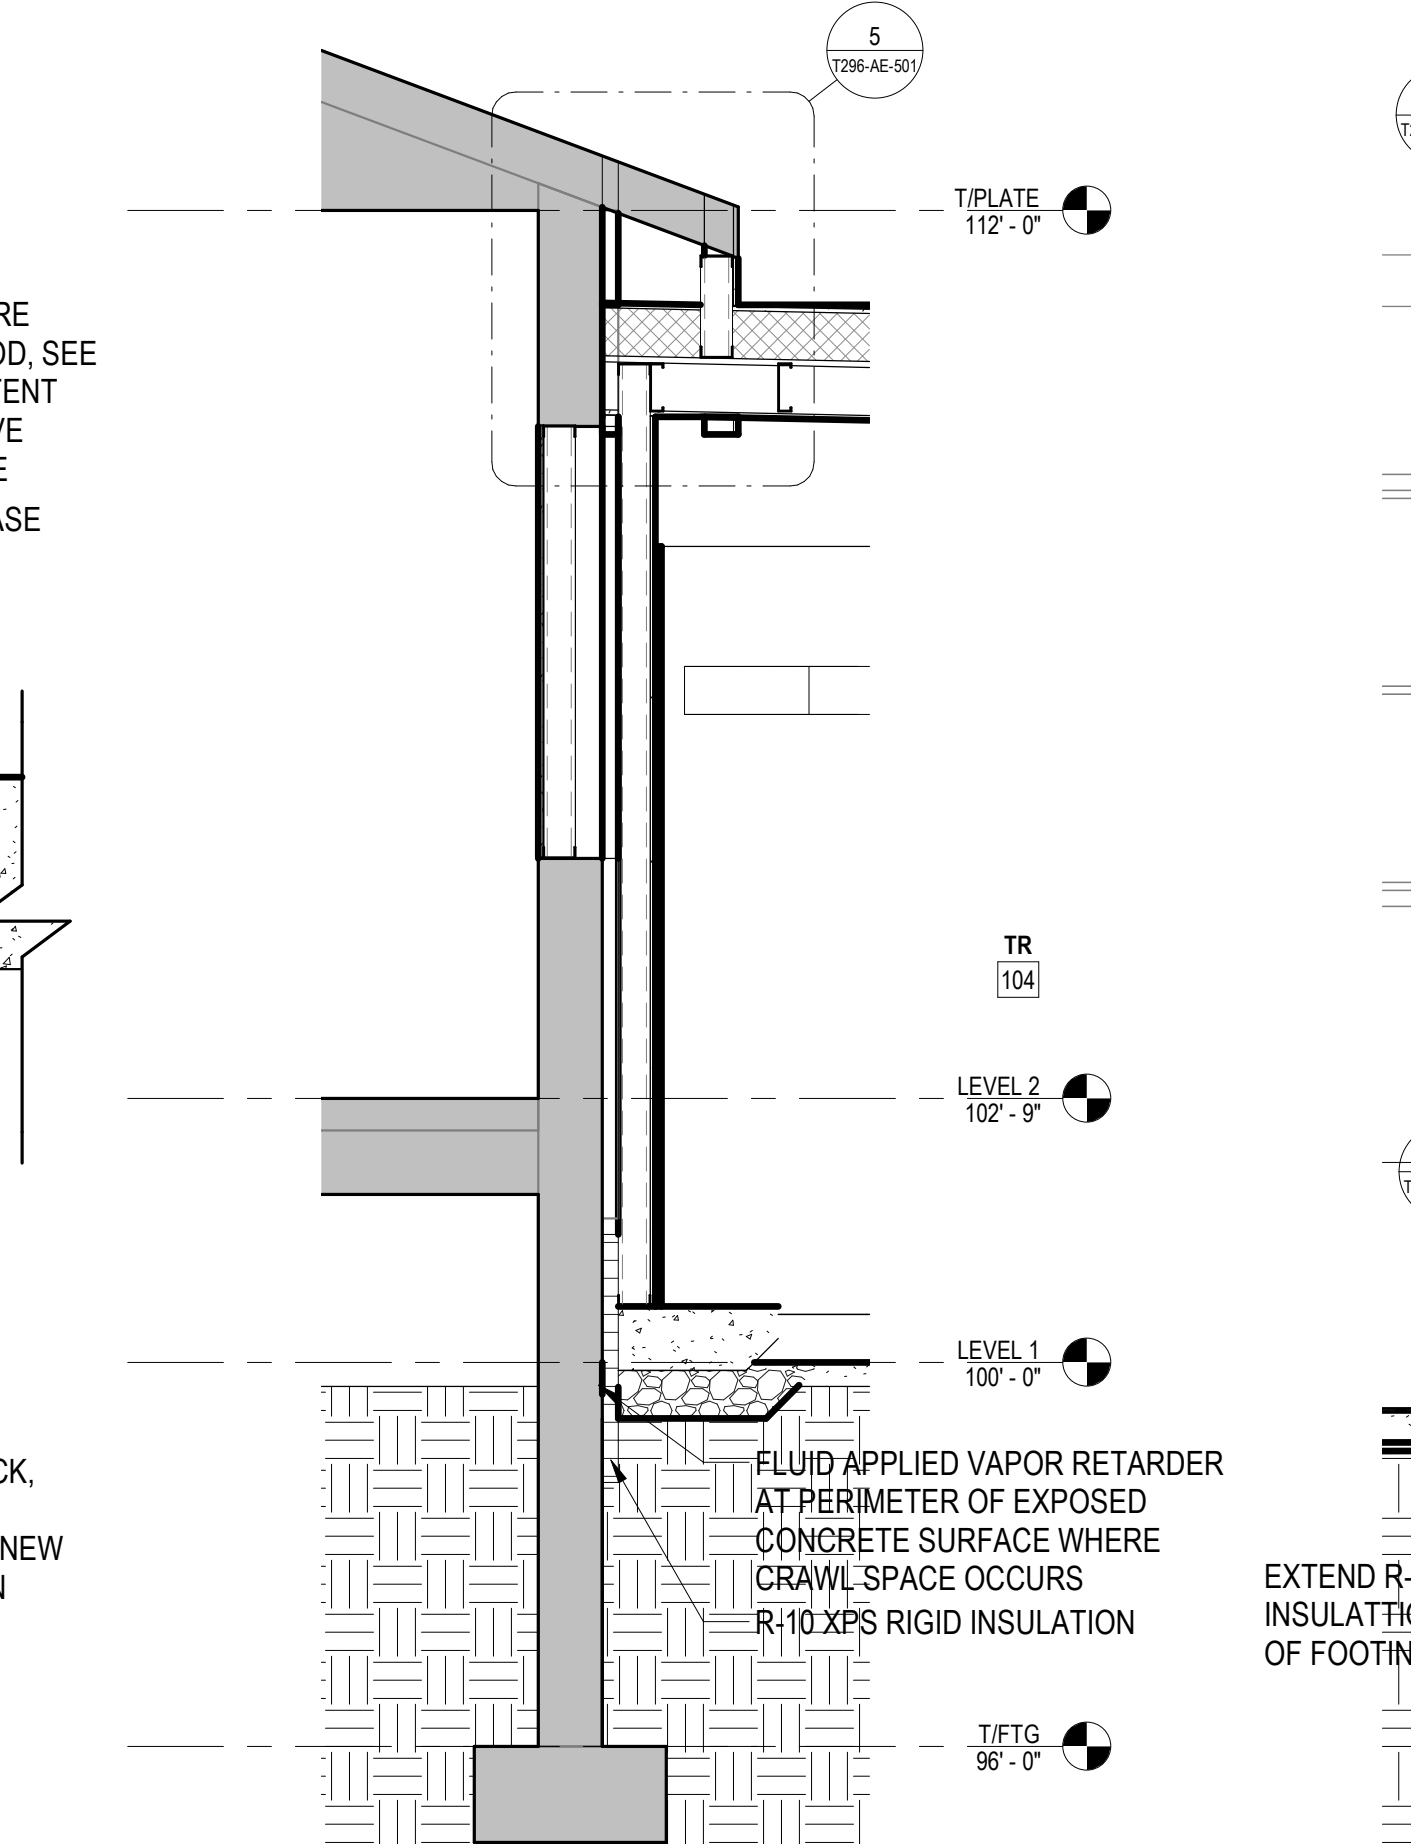


3 NORTH WALL SECTION
1/2" = 1'-0"

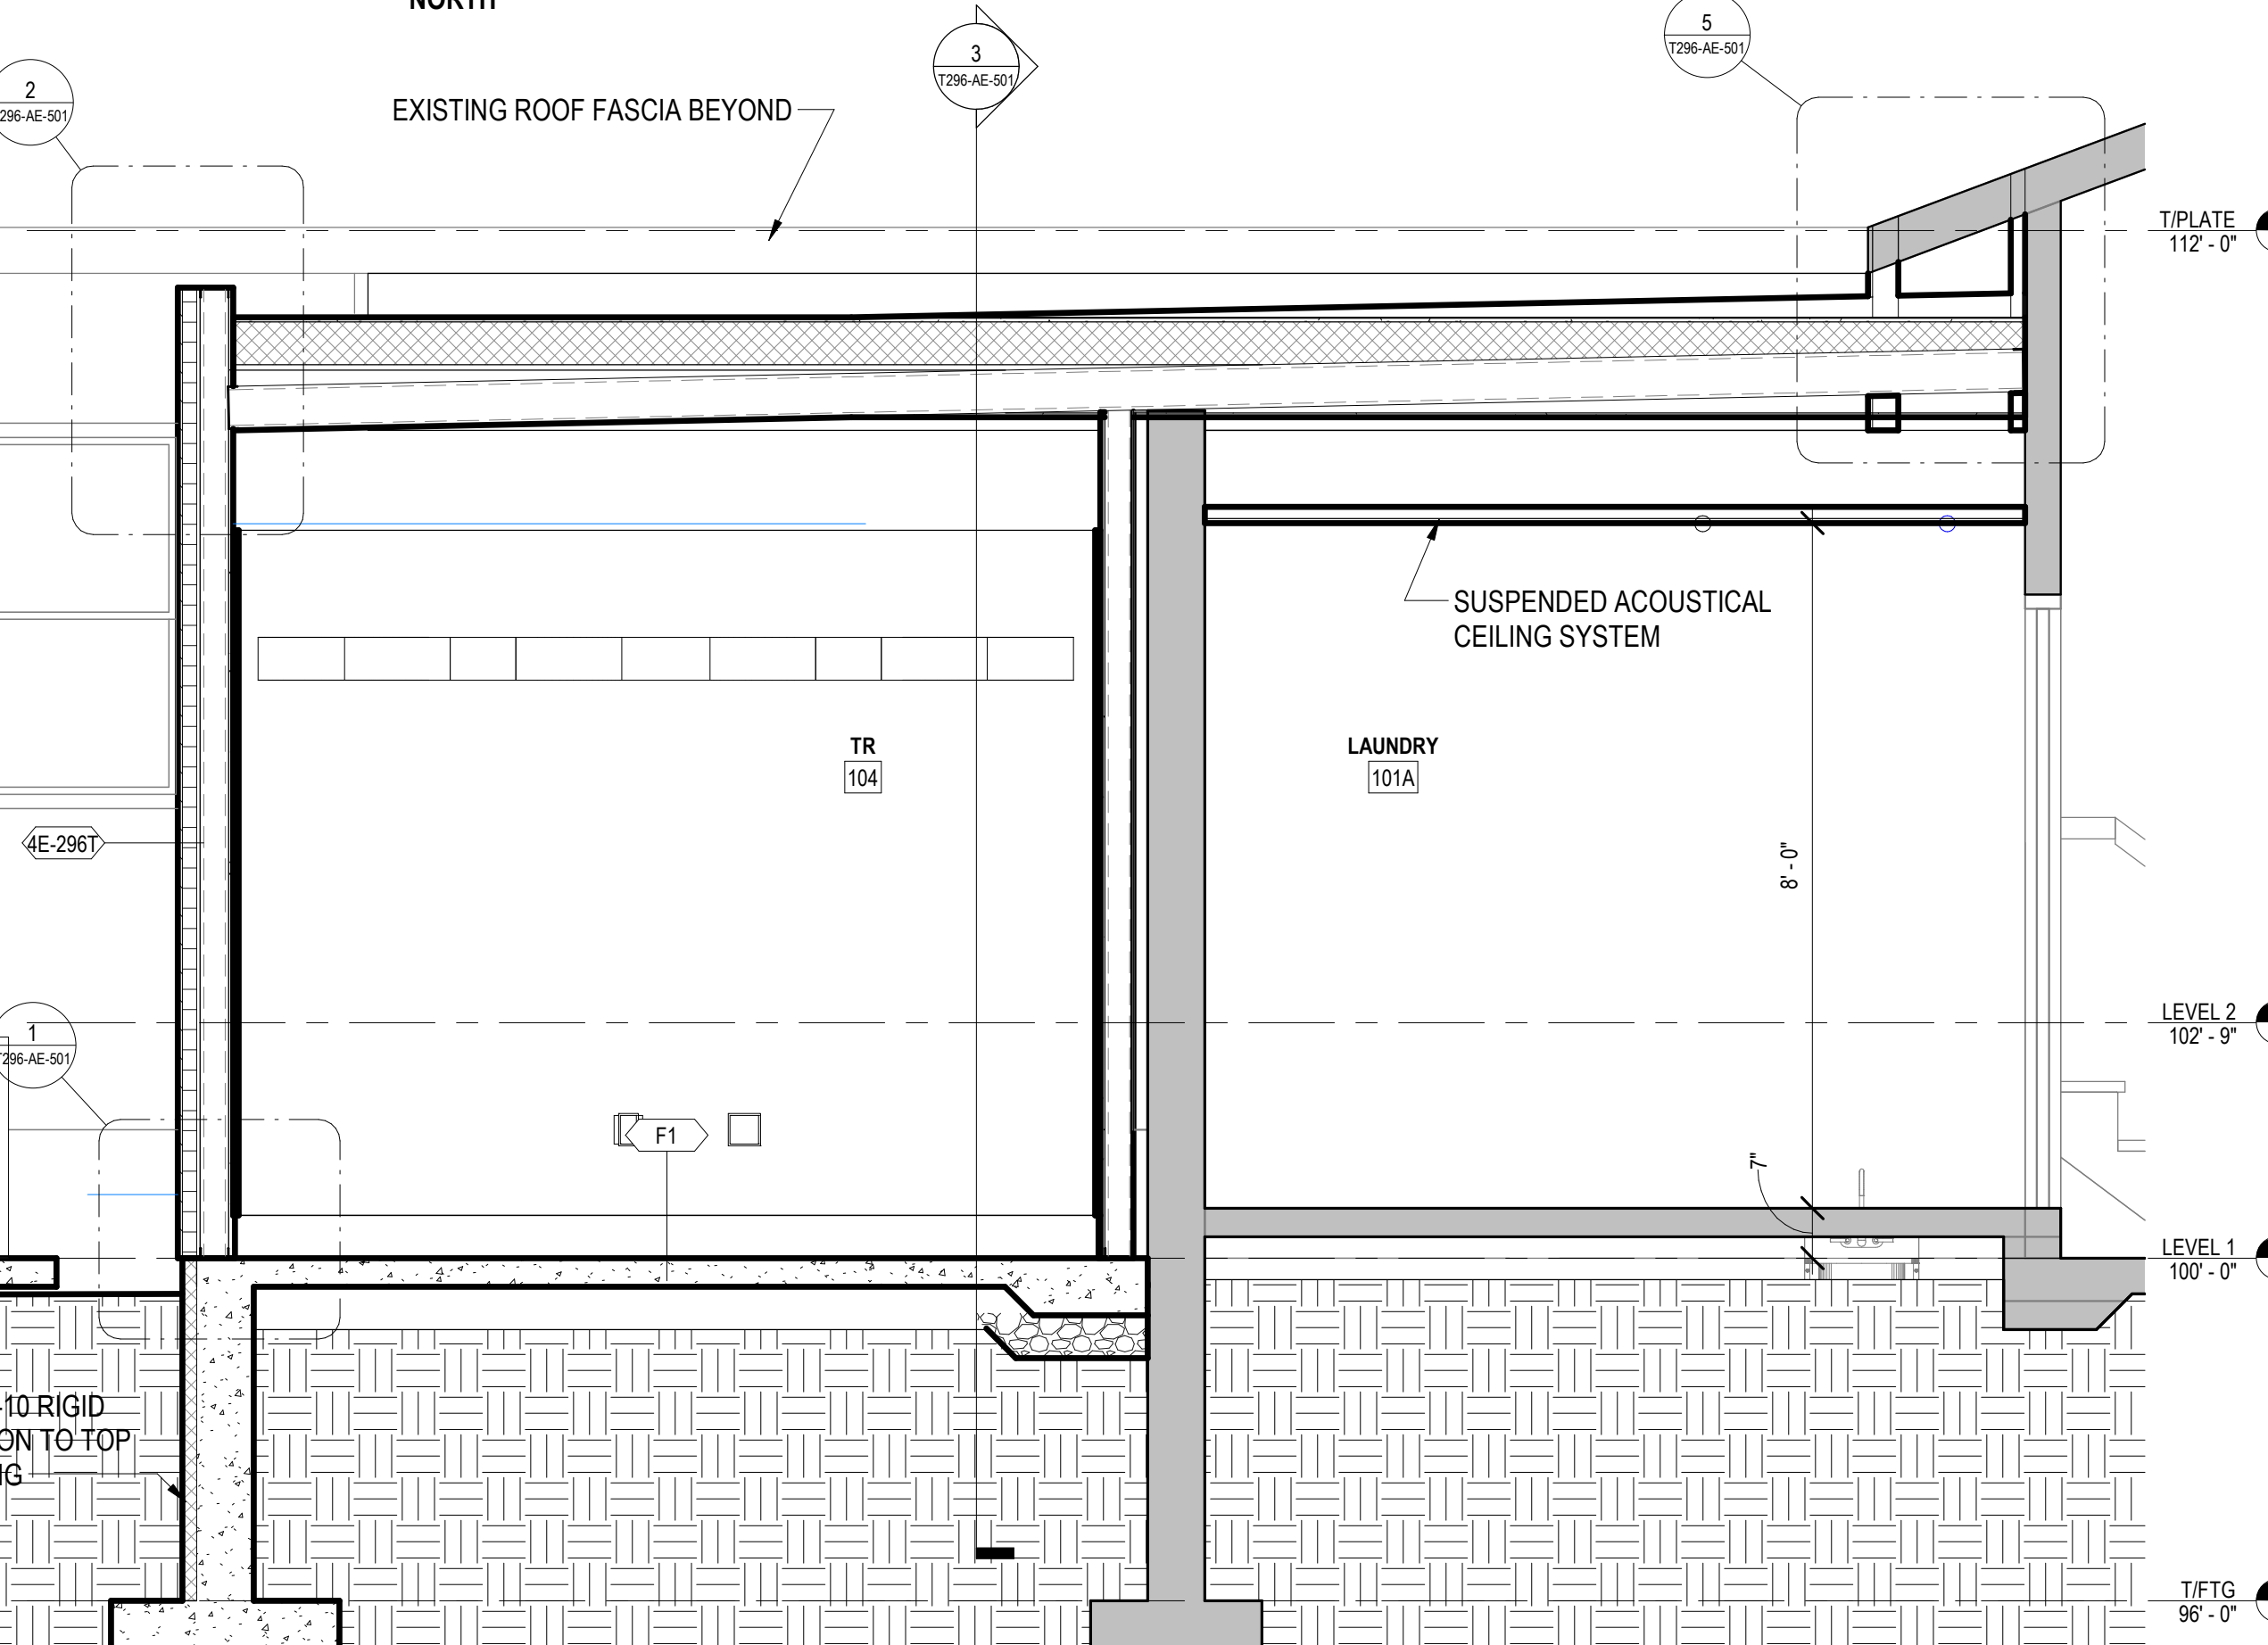


6 EAST WALL SECTION
1/2" = 1'-0"

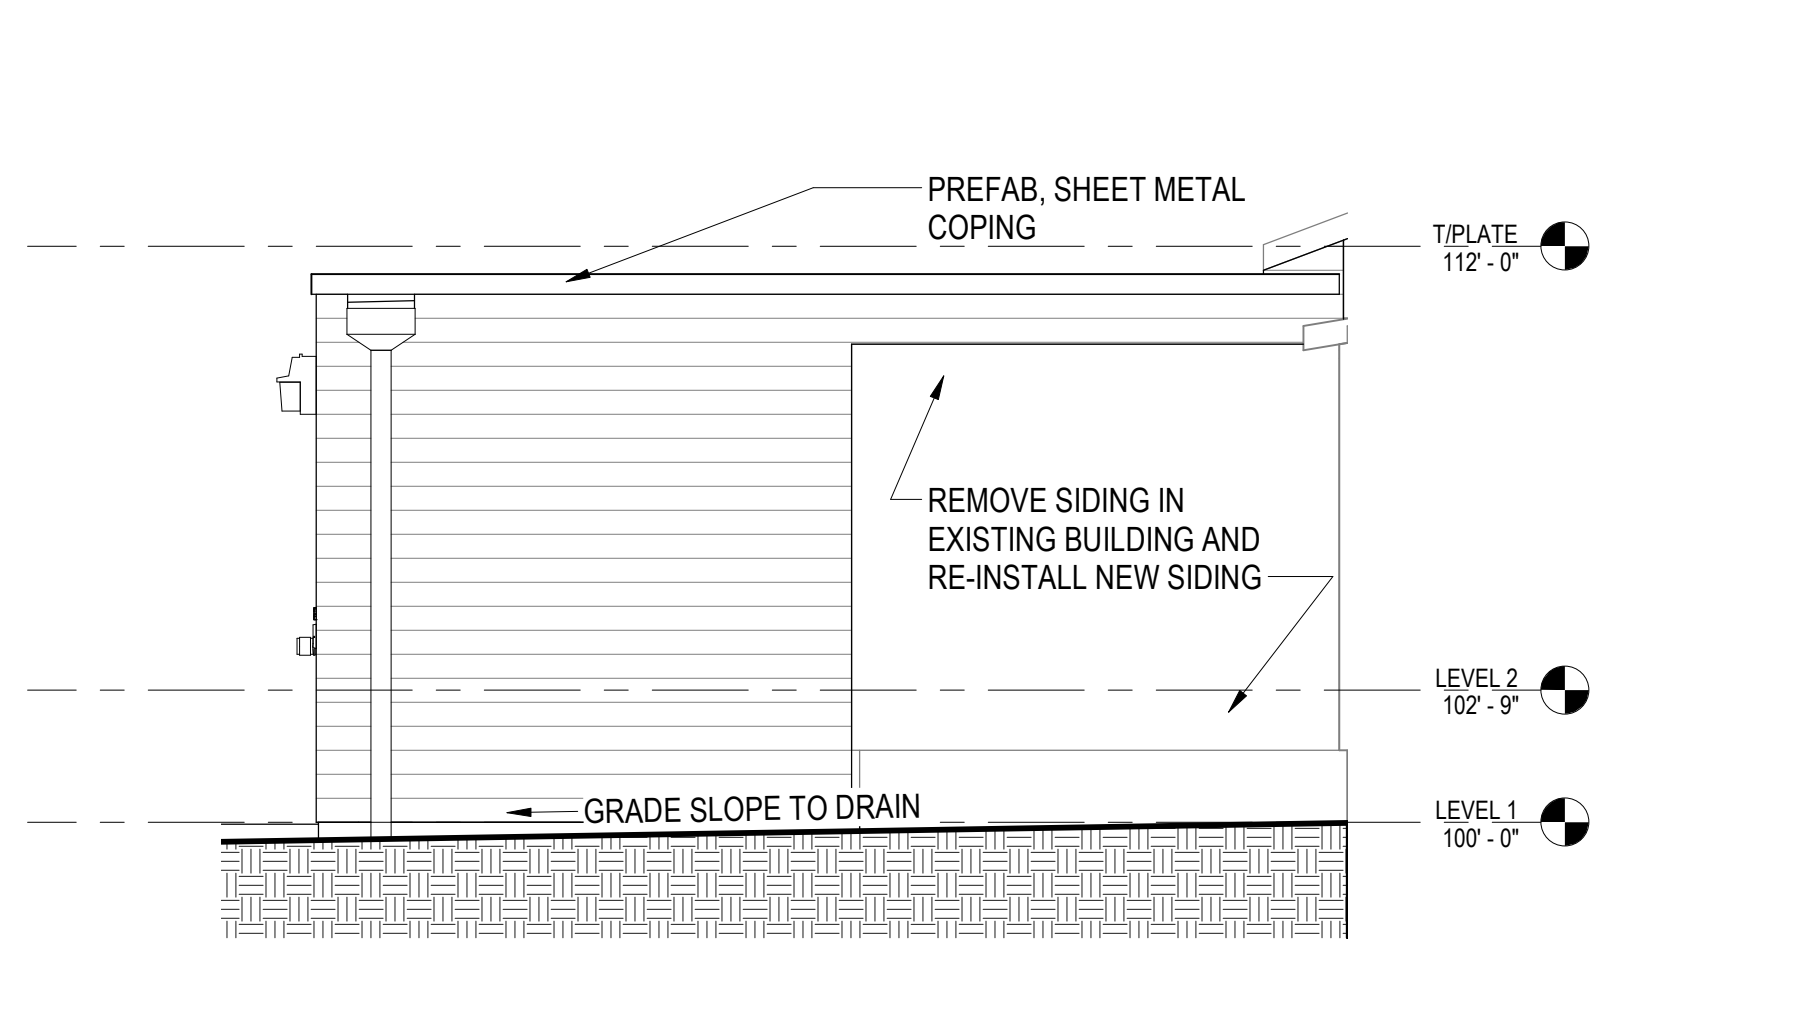

9 SOUTH EXTERIOR ELEVATION
1/4" = 1'-0"

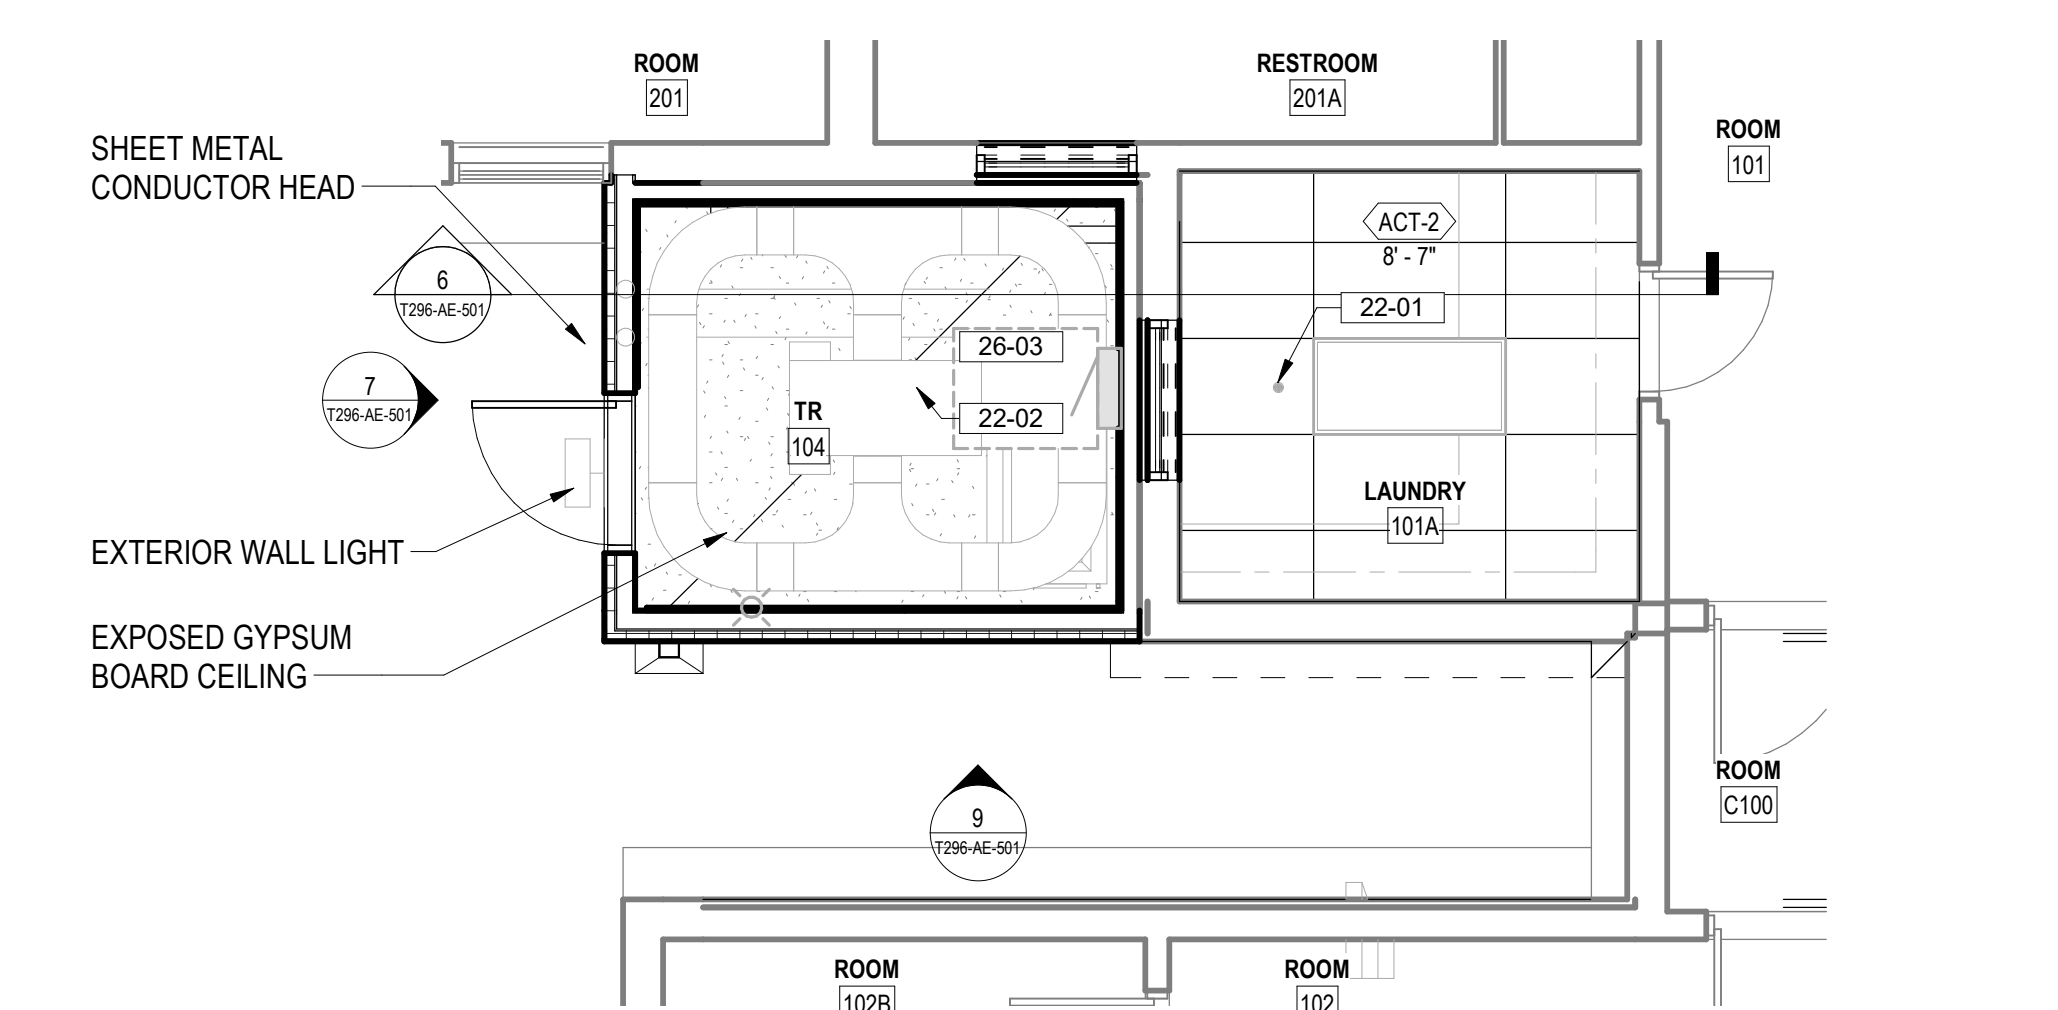

4 TR 104 REFLECTED CEILING PLAN
1/4" = 1'-0"

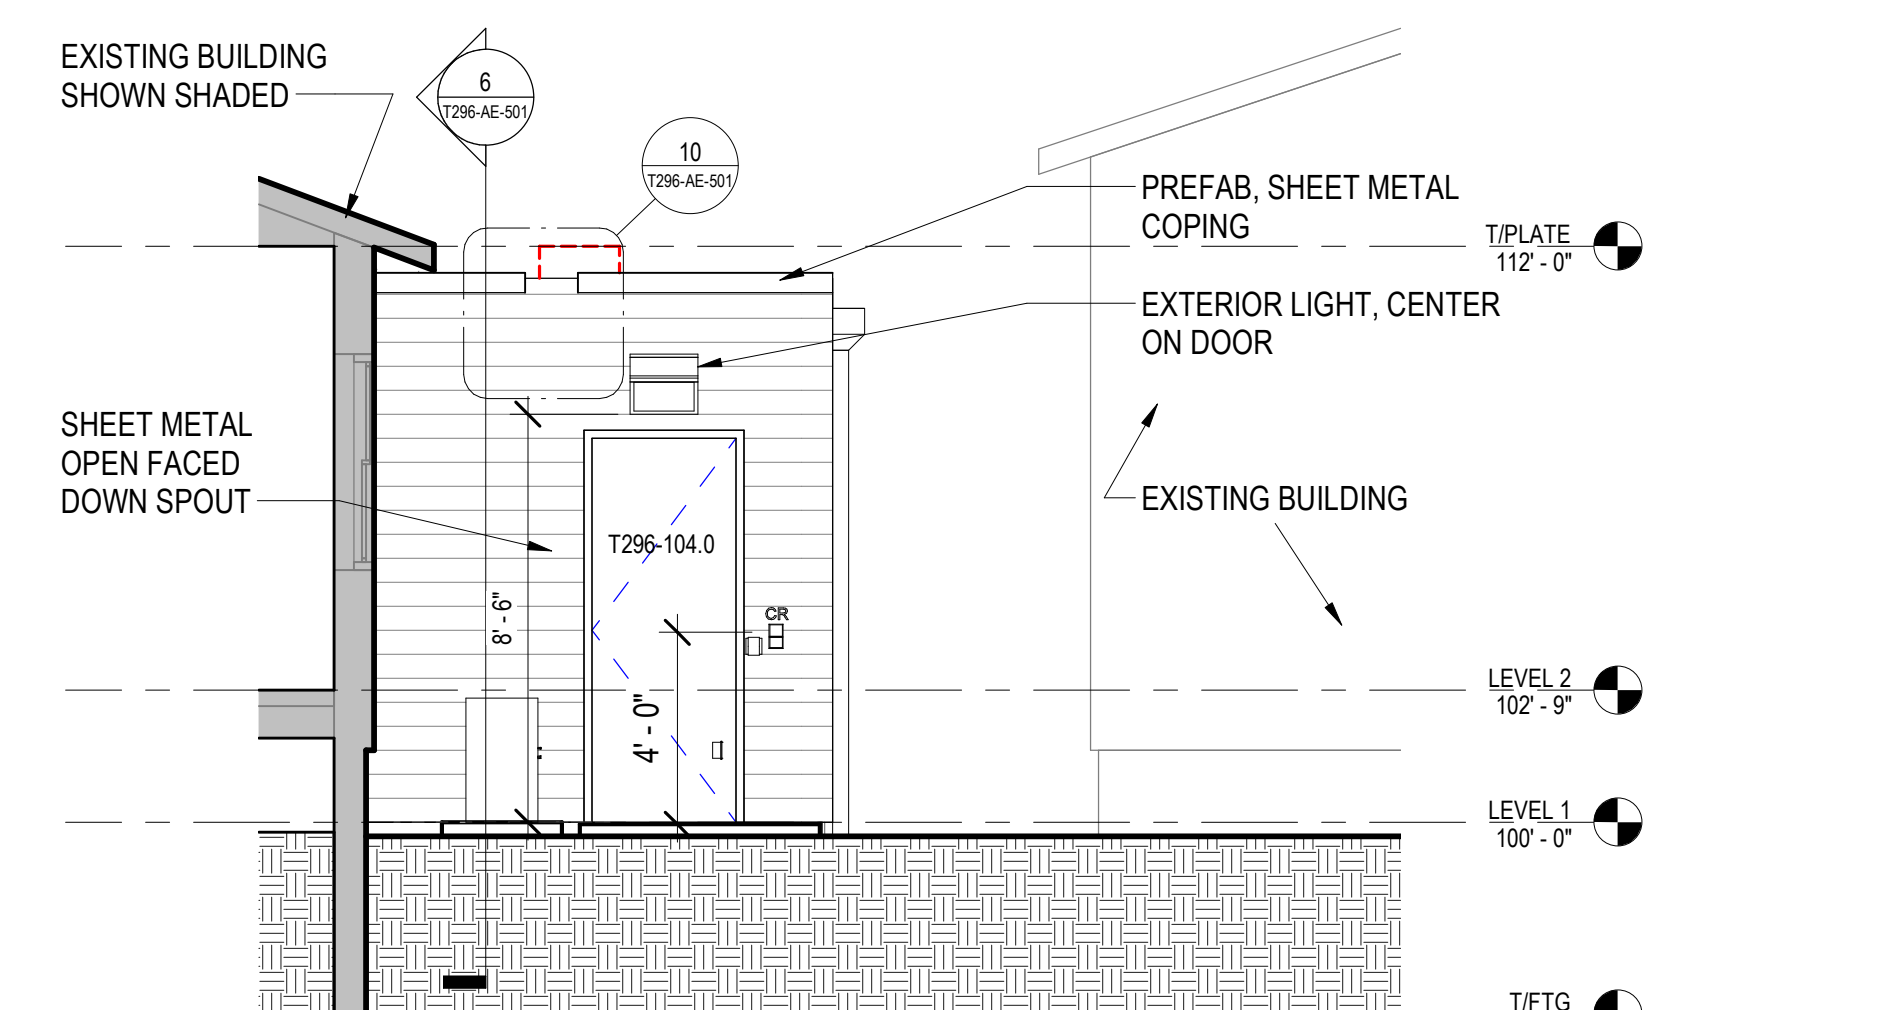


7 EAST EXTERIOR ELEVATION
1/4" = 1'-0"

REFLECTED CEILING PLAN NOTES

- REFER TO ELECTRICAL SHEETS FOR FIXTURE TYPES, SWITCHING, AND SPECIAL SYSTEMS.
- REFER TO MECHANICAL SHEETS FOR DIFFUSER AND DUCTING LAYOUTS.

REFLECTED CEILING PLAN LEGEND

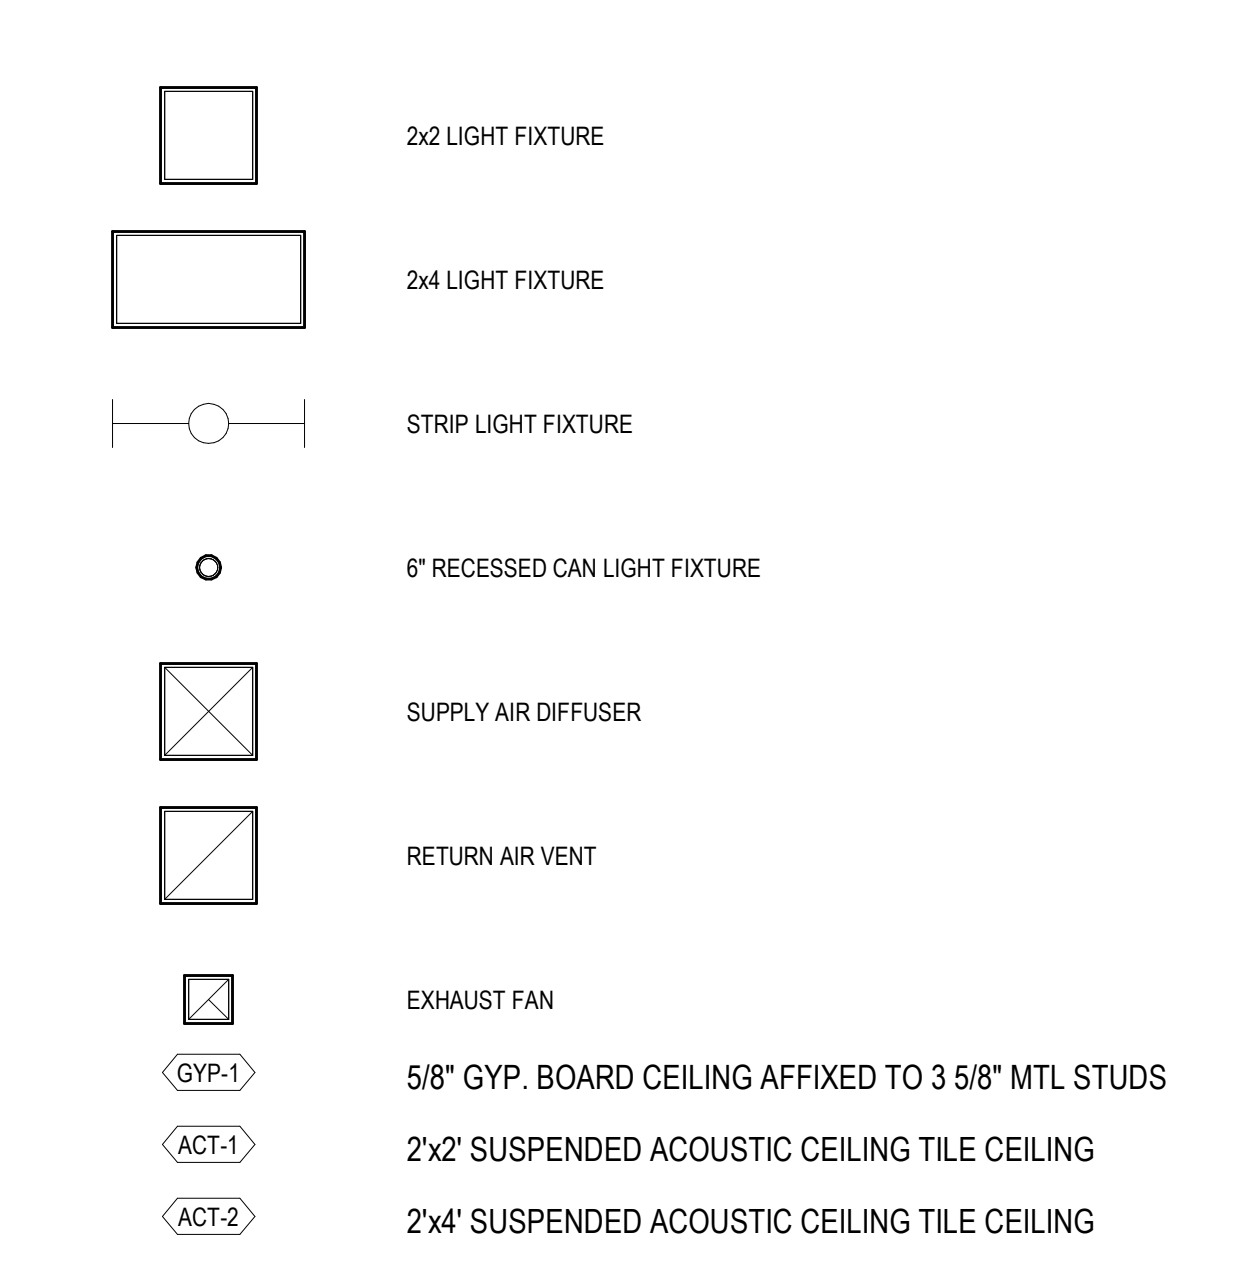

Revisions:	Date:

CONSULTANT
A/E:
GDM
1000 W STEUBEN ST. UNIT 3
BINGEN, WA 98605
541.436.4723
ADAM GODDIN, PE

ARCHITECT/ENGINEER OF RECORD
ARCHITECT
A&E DESIGN
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BILLINGS, MONTANA 59101
406.248.2633
T. MARCELLO PIERROTTET, AIA

STAMP

PROGRAM CONTRACTING ACTIVITY CENTRAL (PCAC)
U.S. Department of Veterans Affairs

DRAWING TITLE
T296- BUILDING ELEVATIONS AND DETAILS
APPROVED: Project Director

PHASE
100% CONSTRUCTION DOCUMENTS
FLS
FULLY SPRINKLERED

PROJECT TITLE EHRM INFRASTRUCTURE UPGRADES	PROJECT NUMBER 568-21-701
LOCATION FORT MEADE, SOUTH DAKOTA	BUILDING NUMBER BLDG T296
ISSUE DATE 04/15/2022	DRAWING NUMBER T296-AE-501
CHECKED BY TMP	DRAWN BY JPR

PIPING LEGEND

Table with 2 columns: Symbol and Description. Includes symbols for demolition, waste, vent piping, cold water, hot water, pipe up/down, tee up/down, cap, union, direction of flow, ball valve, gate valve, check valve, balance valve, flexible piping connector, hose bibb, pump, cleanout, and strainer w/ blowdown.

LOGIC

Table with 2 columns: Symbol and Description. Includes symbols for point of connection, detail number, sheet located on, direction of view, section number, radiation designator, length, GPM, sheet notes, connection, and diffuser/grille type.

ABBREVIATIONS

Large table with 4 columns listing abbreviations and their full names. Includes terms like AAV (Automatic Air Vent), ADA (Americans with Disabilities Act), AFM (Air Flow Monitoring Station), etc.

DUCTWORK LEGEND

Table with 3 columns: Symbol, Description, and Diagram. Includes symbols for thermostat, sensor, supply/return/exhaust air, volume damper, motorized control damper, sound lined ductwork, exterior insulated ductwork, externally insulated ductwork, turning vanes, flexible duct, fire damper, smoke damper, VAV box, and coil if required.

GENERAL PROJECT NOTES:

- 27. ALL ELECTRICAL WORK SHALL BE PERFORMED IN ACCORDANCE WITH NFPA 70 STANDARDS AND LOCAL REQUIREMENTS.
28. ALL FIELD WIRING SHALL REQUIRE AN ELECTRICAL PERMIT AND SHALL BE PERFORMED BY A LICENSED ELECTRICIAN.
29. A SHORT DASH IN A SCHEDULE TABLE CELL INDICATES THAT THE COLUMN HEADING IS NOT USED OR NOT APPLICABLE TO THAT SCHEDULED ITEM.
30. MAINTAIN AND RESTORE (IF INTERRUPTED) ALL CONDUITS & CONDUCTORS, PIPING, & DUCTWORK PASSING THROUGH RENOVATED AREAS AND SERVING UNDISTURBED AREAS.
31. REMOVE ALL ABANDONED DUCTWORK, PIPING, CONTROLS, WIRING ETC., WHERE ACCESSIBLE IN RENOVATED AREAS.
32. WHERE CONTROLS ARE DEMOLISHED, REMOVE WIRING BACK TO NEAREST CONTROL PANEL OR JUNCTION BOX. REMOVE ACCESSIBLE CONDUIT, JUNCTION BOXES, ETC.
33. OWNER SHALL HAVE FIRST RIGHT OF REFUSAL FOR ALL EQUIPMENT AND COMPONENTS REMOVED DURING DEMOLITION.
34. CONTRACTOR SHALL BE RESPONSIBLE FOR PROVIDING ALL CUTTING & RESTORATION WORK NECESSARY IN EXISTING AREAS OF THE BUILDINGS WHERE WORK IS SHOWN ON THESE DOCUMENTS. RESTORATION SHALL INCLUDE PATCHING TO MATCH EXISTING SURROUNDING CONSTRUCTION AND FINISHES. PATCHED AREAS SHALL BE RE-PAINTED FULL HEIGHT OF WALL, FROM CORNER TO WALL CORNER.

Table with 2 columns: Revisions and Date. Includes a table for tracking changes to the drawing.

CONSULTANT information block including GDM ARCHITECTS • ENGINEERS logo, address (1000 W STEUBEN ST. UNIT 3 BINGEN, WA 98605), phone (541.436.4723), and name (ADAM GOODIN, P.E.).

ARCHITECT/ENGINEER OF RECORD information block including MECHANICAL ENGINEER title, RSA ENGINEERING, INC. logo, address (670 W. FIREWEED LN, SUITE 200 ANCHORAGE, ALASKA 99503), phone (907.276.0521), and name (M.R. BAUMGARTNER, P.E.).


STAMP information block featuring the official seal of the State of Alaska Professional Engineers, Mechanical and Electrical Consulting Engineers, M.R. BAUMGARTNER, No. 152453.

OFFICE OF CONSTRUCTION AND FACILITIES MANAGEMENT logo and U.S. Department of Veterans Affairs logo.

DRAWING TITLE: MECHANICAL LEGENDS & ABBREVIATIONS. APPROVED: [Signature]

PHASE: 100% CONSTRUCTION DOCUMENTS. FULLY SPRINKLERED.

PROJECT TITLE: EHRM INFRASTRUCTURE UPGRADES. PROJECT NUMBER: 568-21-701. BUILDING NUMBER: [Blank]. DRAWING NUMBER: MG-001. LOCATION: FORT MEADE, SOUTH DAKOTA. ISSUE DATE: 4/15/2022. CHECKED BY: EMM/MRB. DRAWN BY: MEM/NSK.

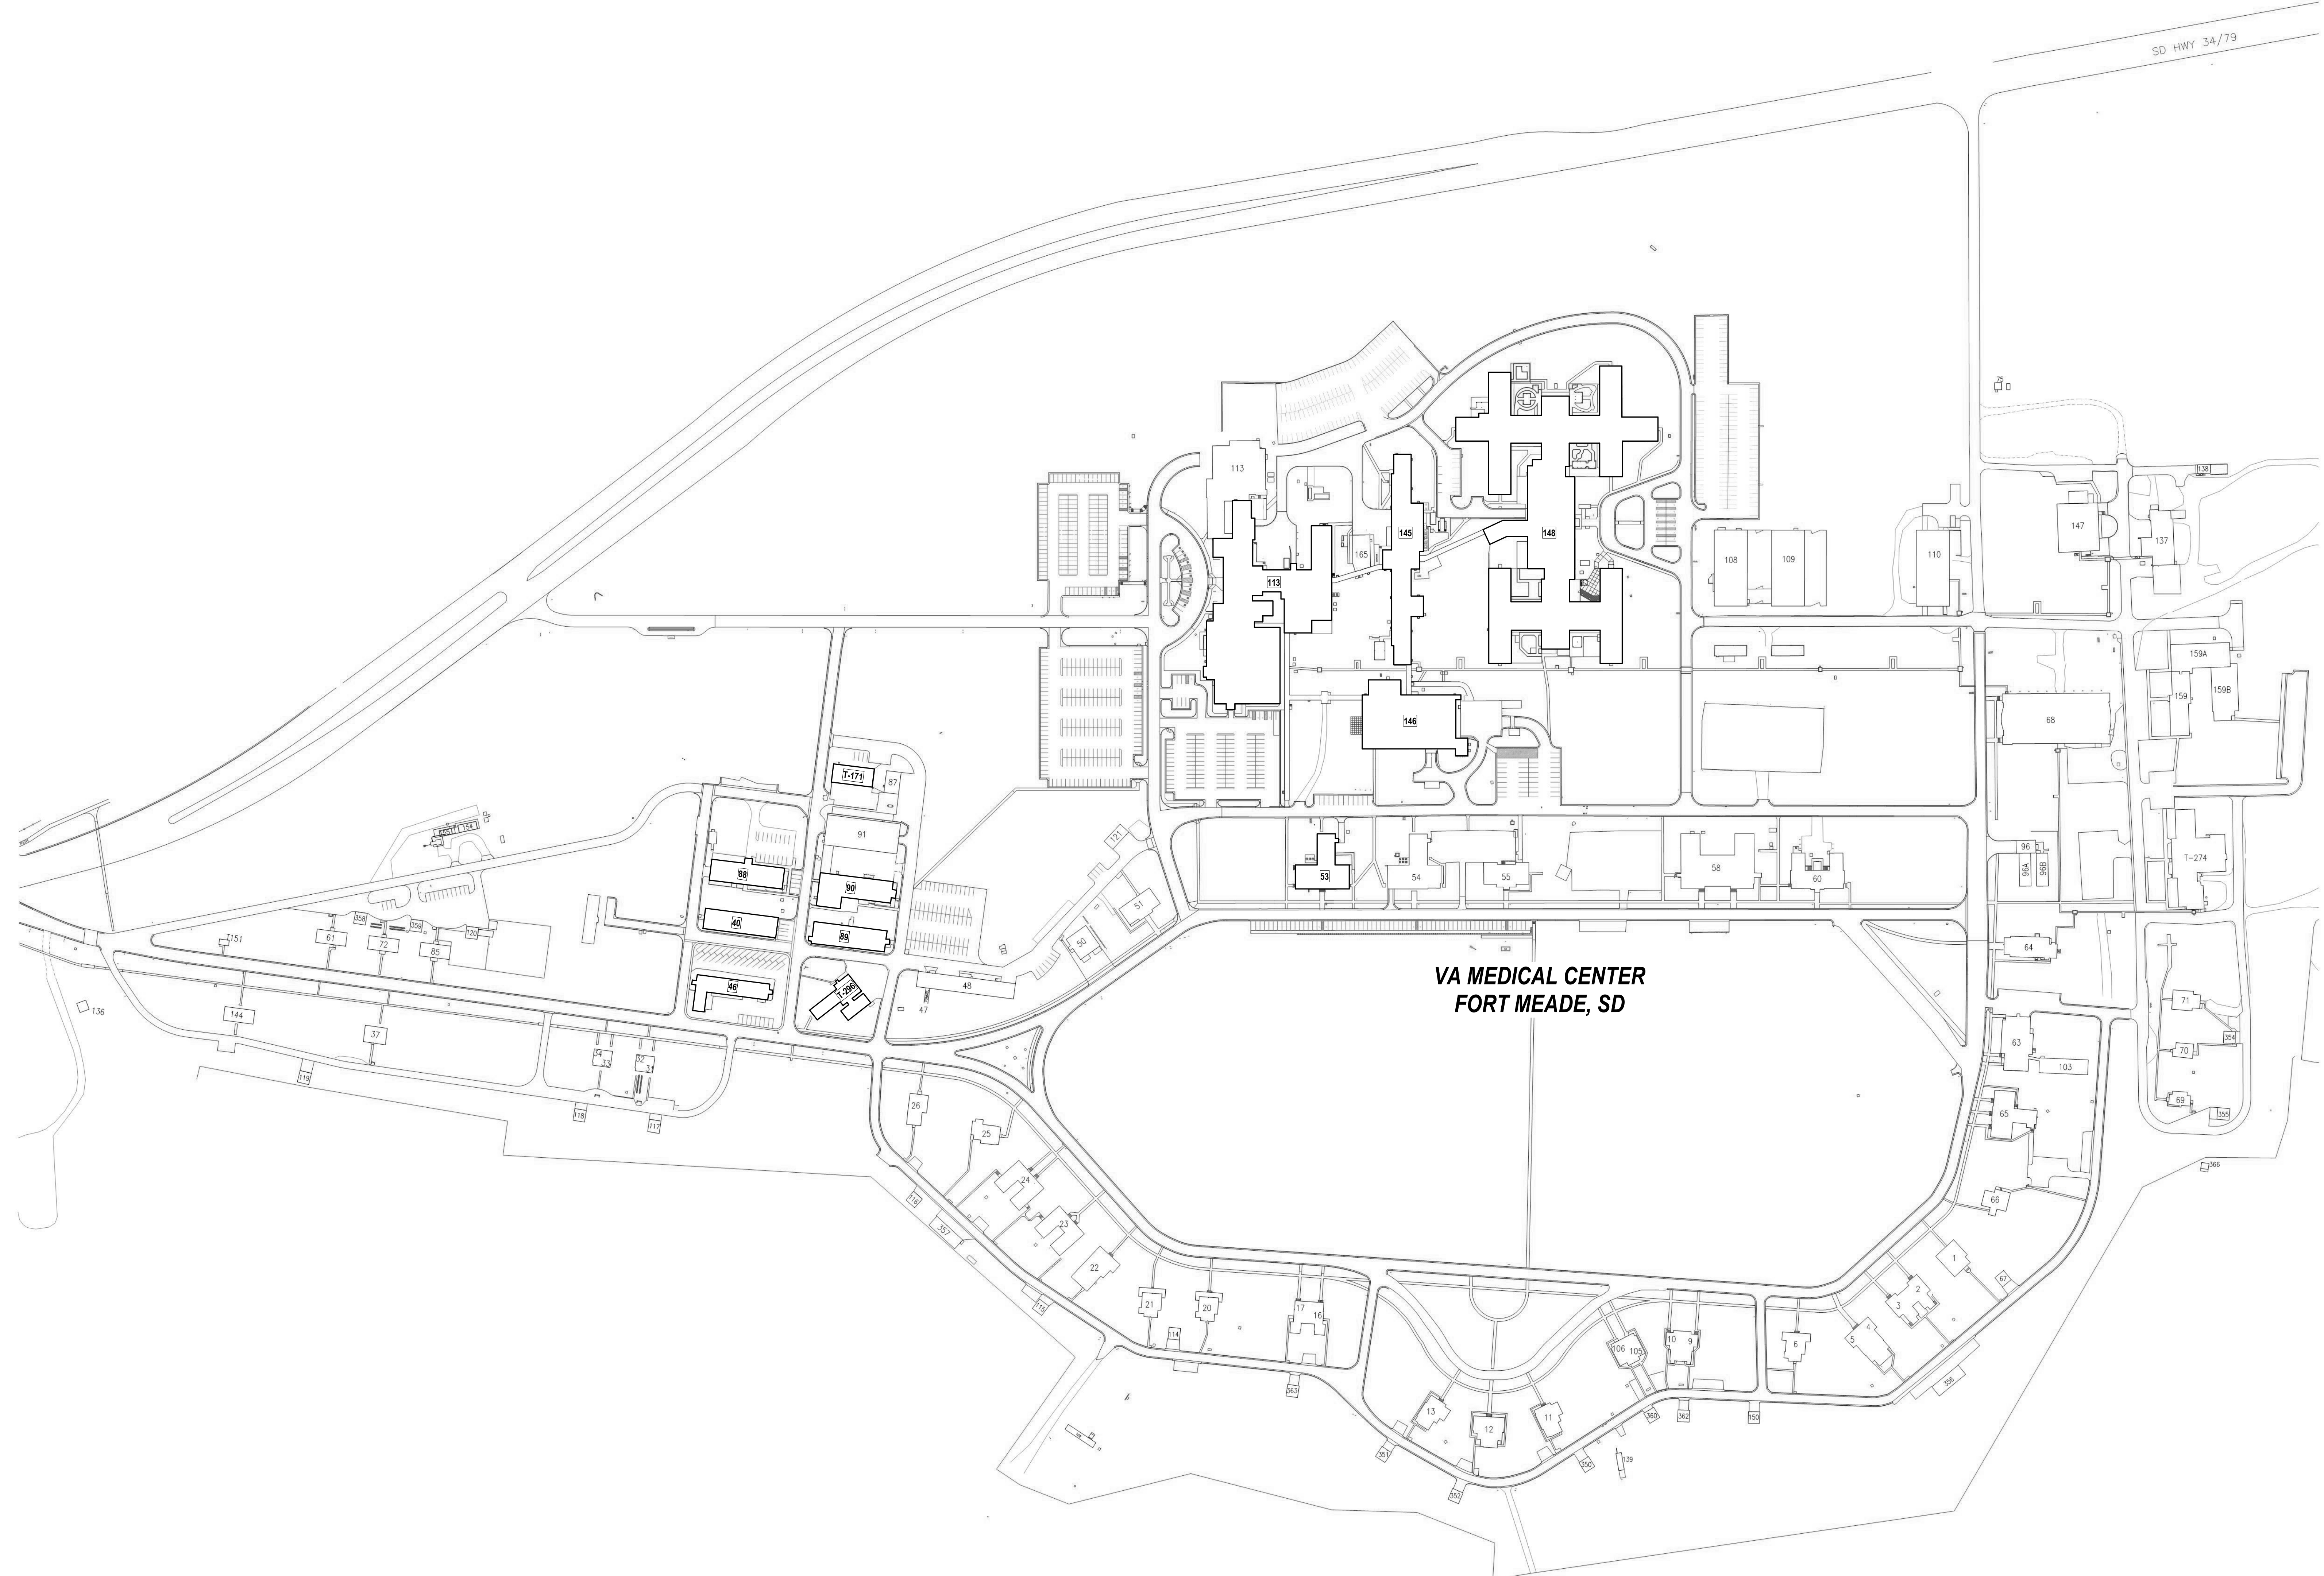

VA MEDICAL CENTER
FORT MEADE, SD

1 Site Plan
NOT TO SCALE




Revisions:	Date:

CONSULTANT
A/E:
GDM
1000 W STEUBEN ST. UNIT 3
BINGEN, WA 98605
541.436.4723
ADAM GOODIN, P.E.



ARCHITECT/ENGINEER OF RECORD
MECHANICAL ENGINEER
RSA ENGINEERING, INC.
670 W. FIREWEED LN, SUITE 200
ANCHORAGE, ALASKA 99503
907.276.0521
M.R. BAUMGARTNER, P.E.

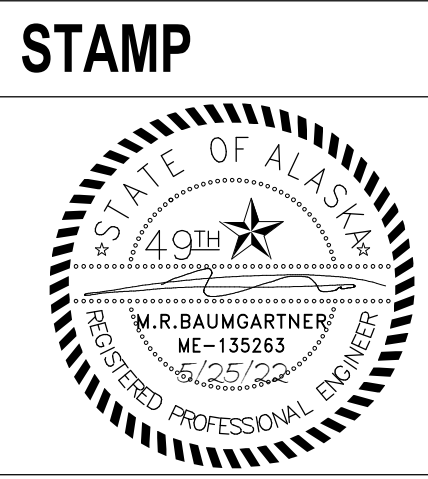

**OFFICE OF
CONSTRUCTION
AND FACILITIES
MANAGEMENT**
VA U.S. Department
of Veterans Affairs


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MECHANICAL SITE PLAN
APPROVED:

PHASE
100% CONSTRUCTION
DOCUMENTS
FLS
FULLY SPRINKLERED


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EHRM INFRASTRUCTURE
UPGRADES
LOCATION
FORT MEADE, SOUTH DAKOTA
ISSUE DATE
4/15/2022
CHECKED BY
EMM/MRB
DRAWN BY
MEM/NSK

PROJECT NUMBER
568-21-701
BUILDING NUMBER
DRAWING NUMBER
MG-003


A
B
C
D
E
F

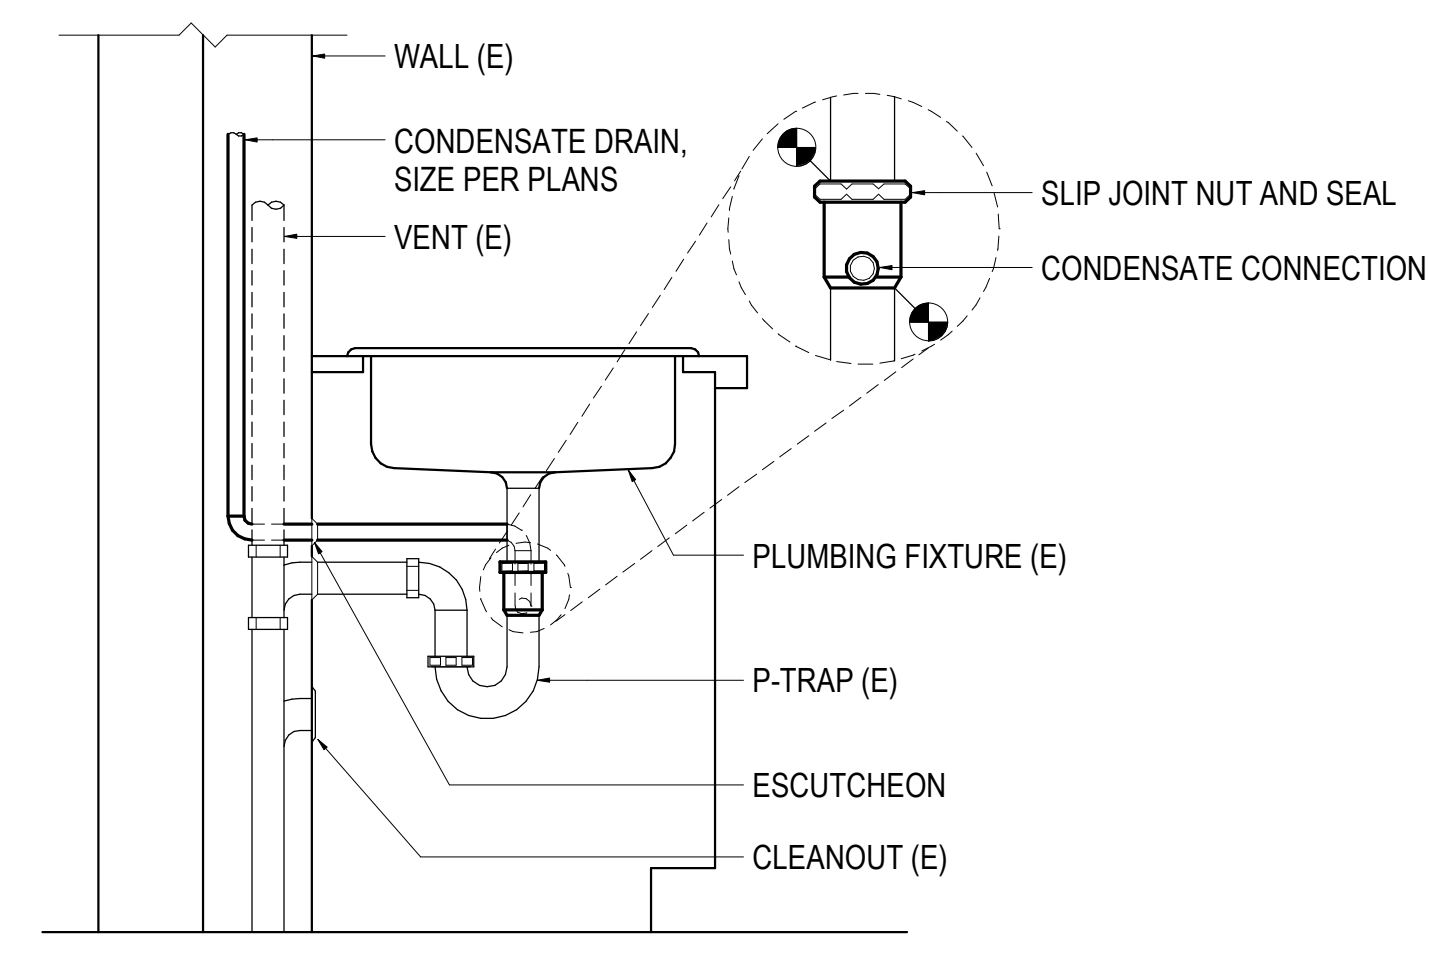

1 INDIRECT DRAIN DETAIL
NOT TO SCALE

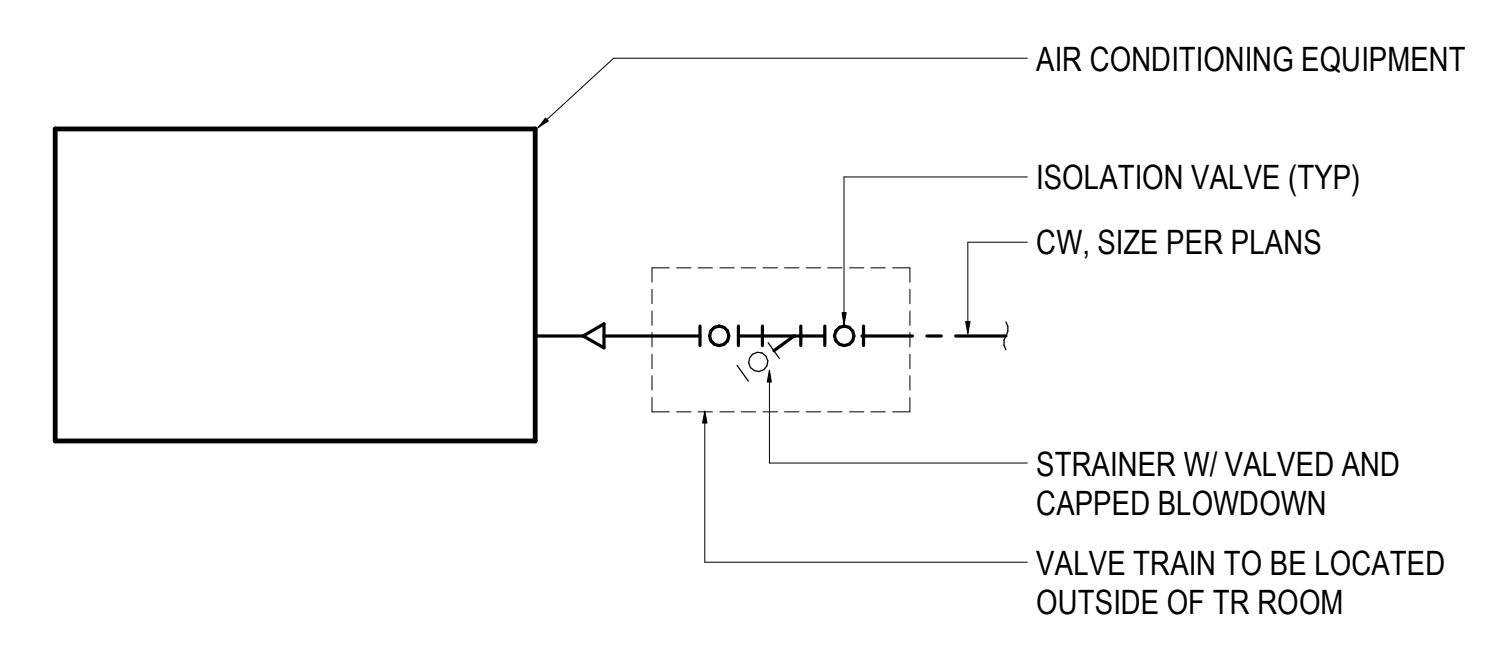


2 HUMIDIFIER WATER CONNECTION DETAIL
NOT TO SCALE

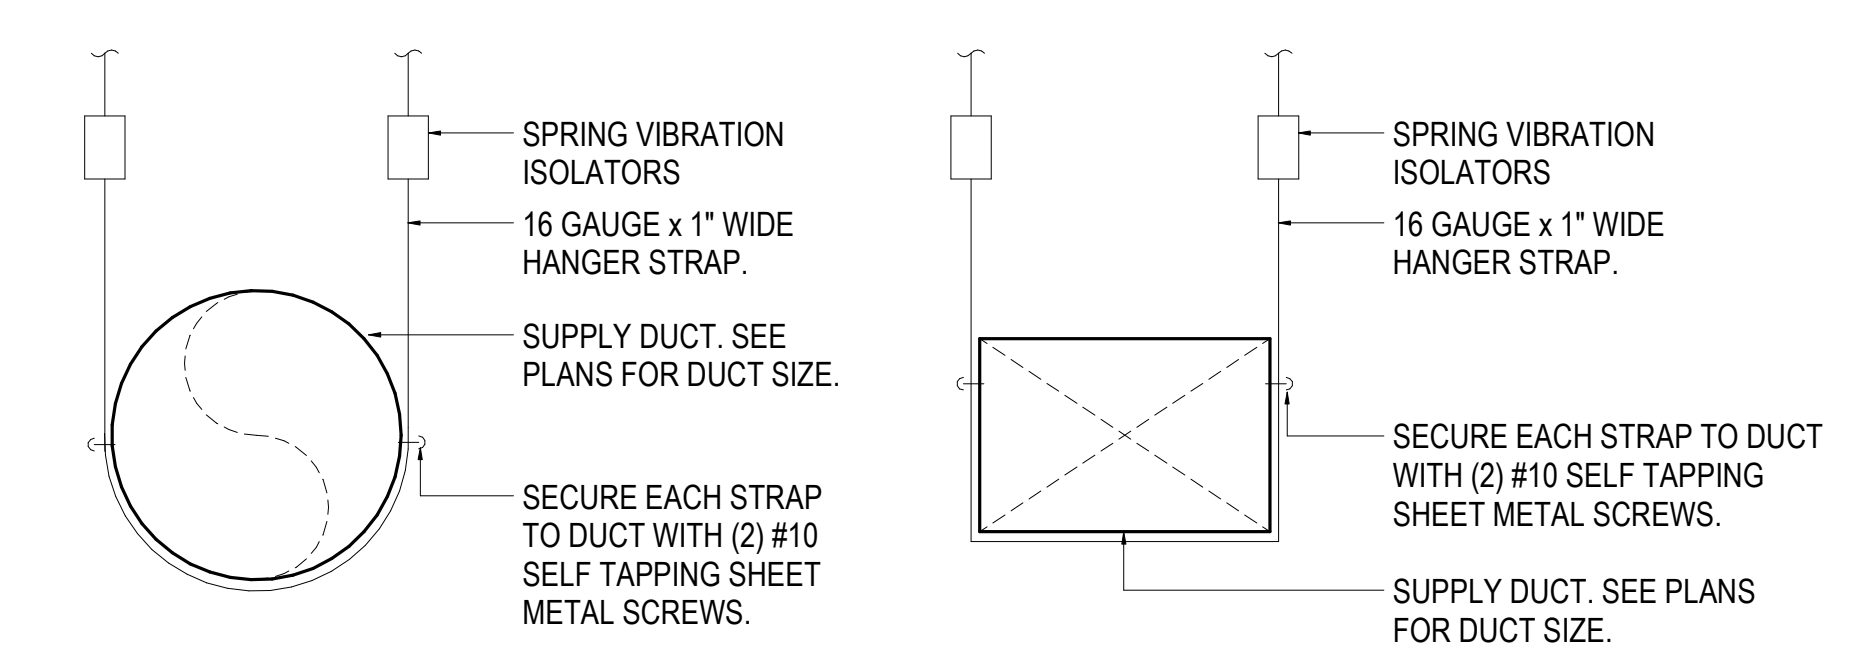


NOTE:
1. PROVIDE AND CONSTRUCT DUCT HANGERS AND SUPPORTS PER 2006 SMACNA HVAC DUCT CONSTRUCTION STANDARDS FIGURE 5-5.
2. LENGTH OF SUPPORTS, STRAP SIZES, AND SIZES OF STEEL ANGLES AS REQUIRED FOR DUCT SIZE AND CONFIGURATION.
3. MAXIMUM 10' SPACING BETWEEN SUPPORTS.


3 TYPICAL DUCT SUPPORT DETAIL
NOT TO SCALE

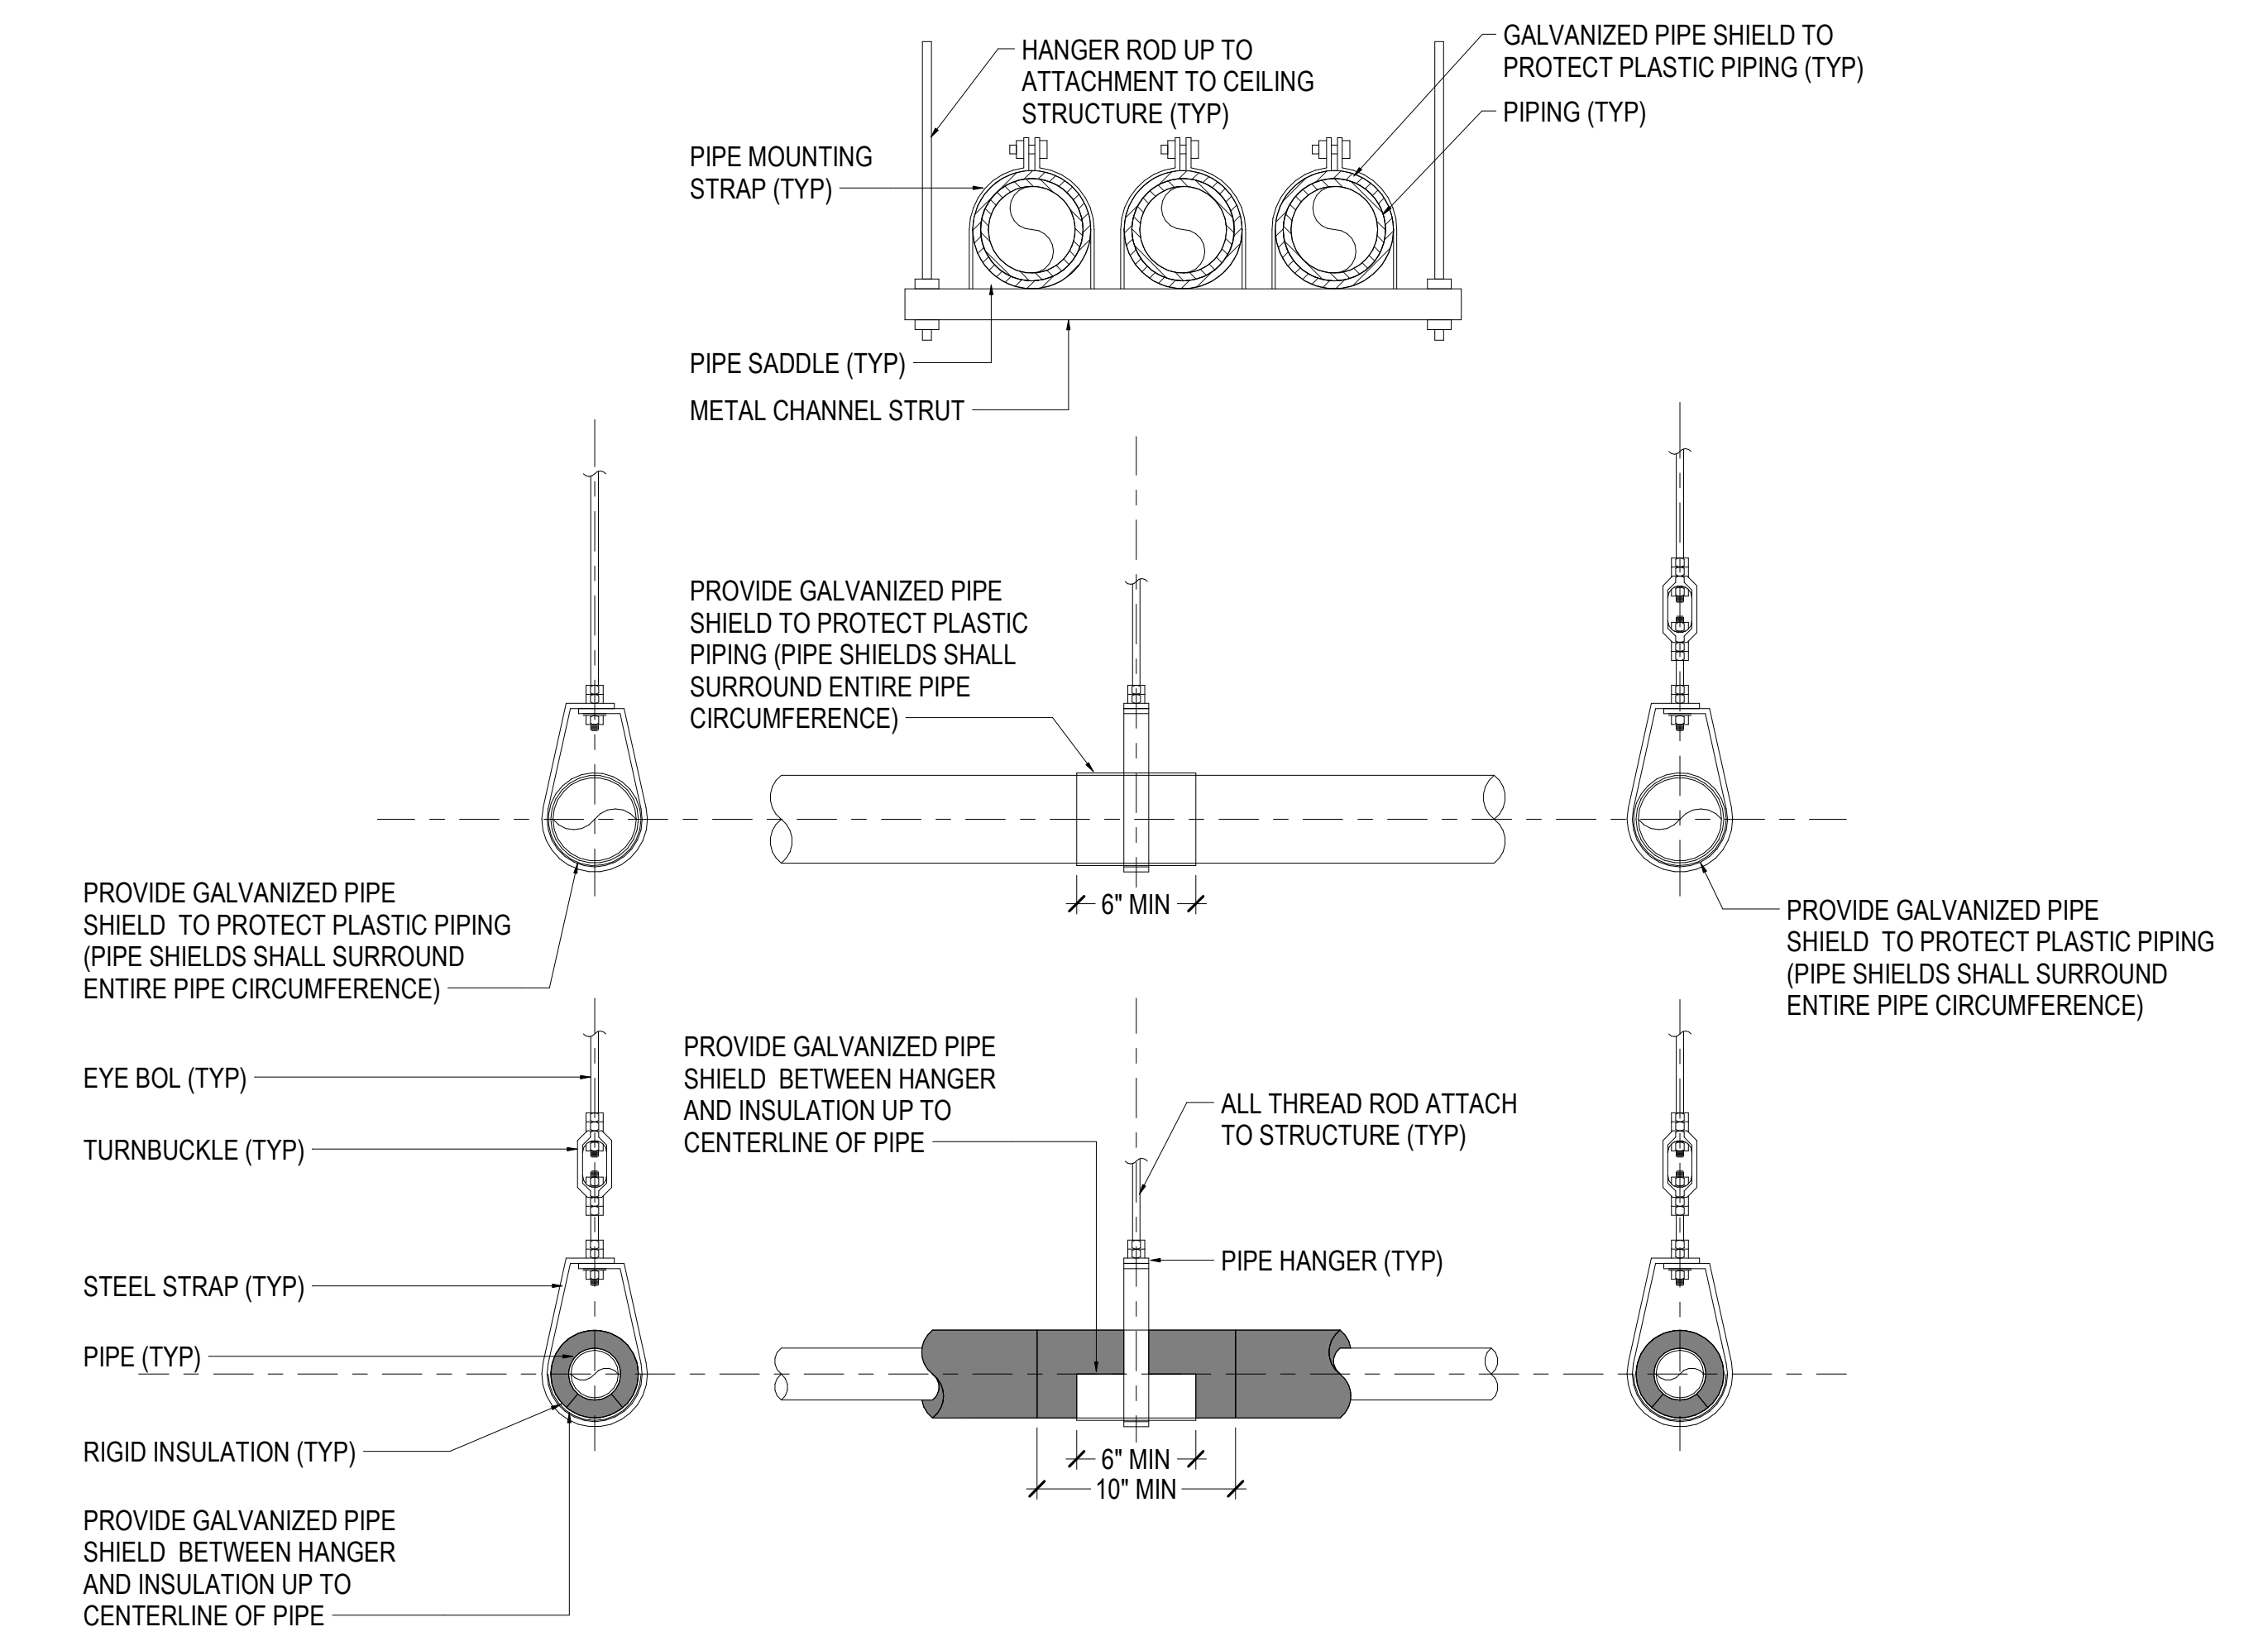


4 TYPICAL PIPE SUPPORT DETAIL
NOT TO SCALE

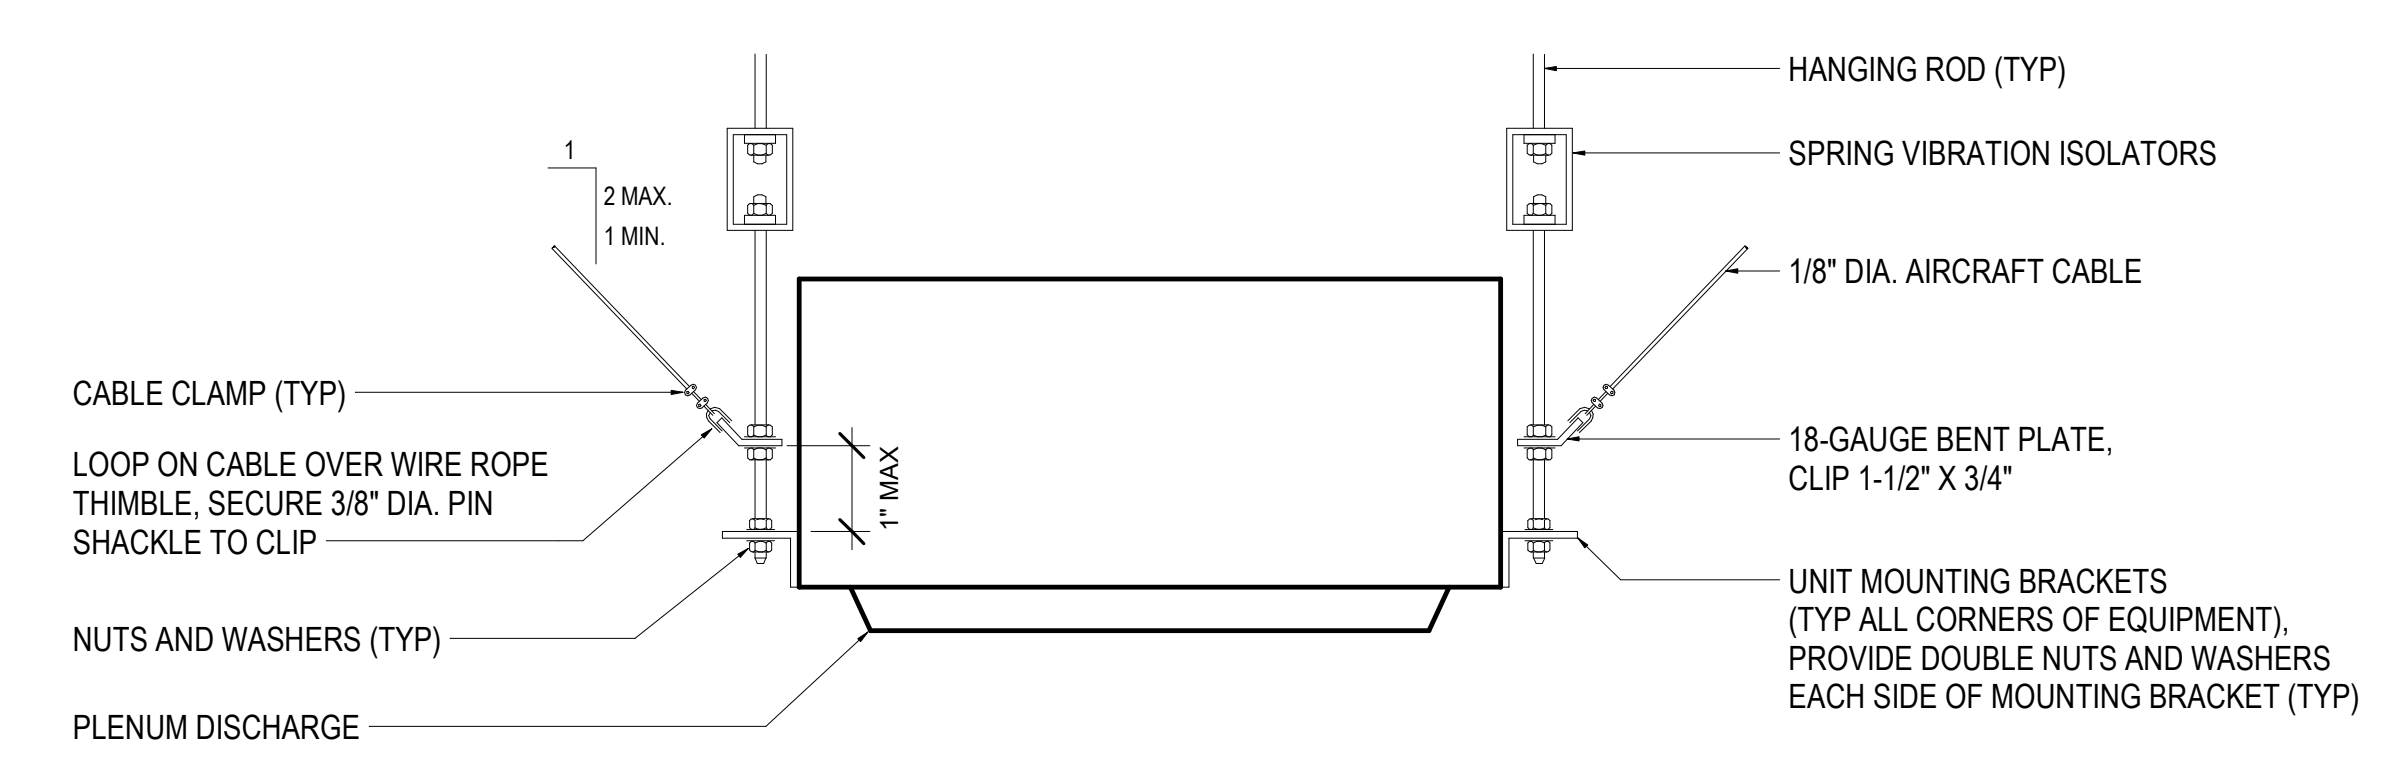

5 INDOOR UNIT WITH PLENUM MOUNTING DETAIL
NOT TO SCALE

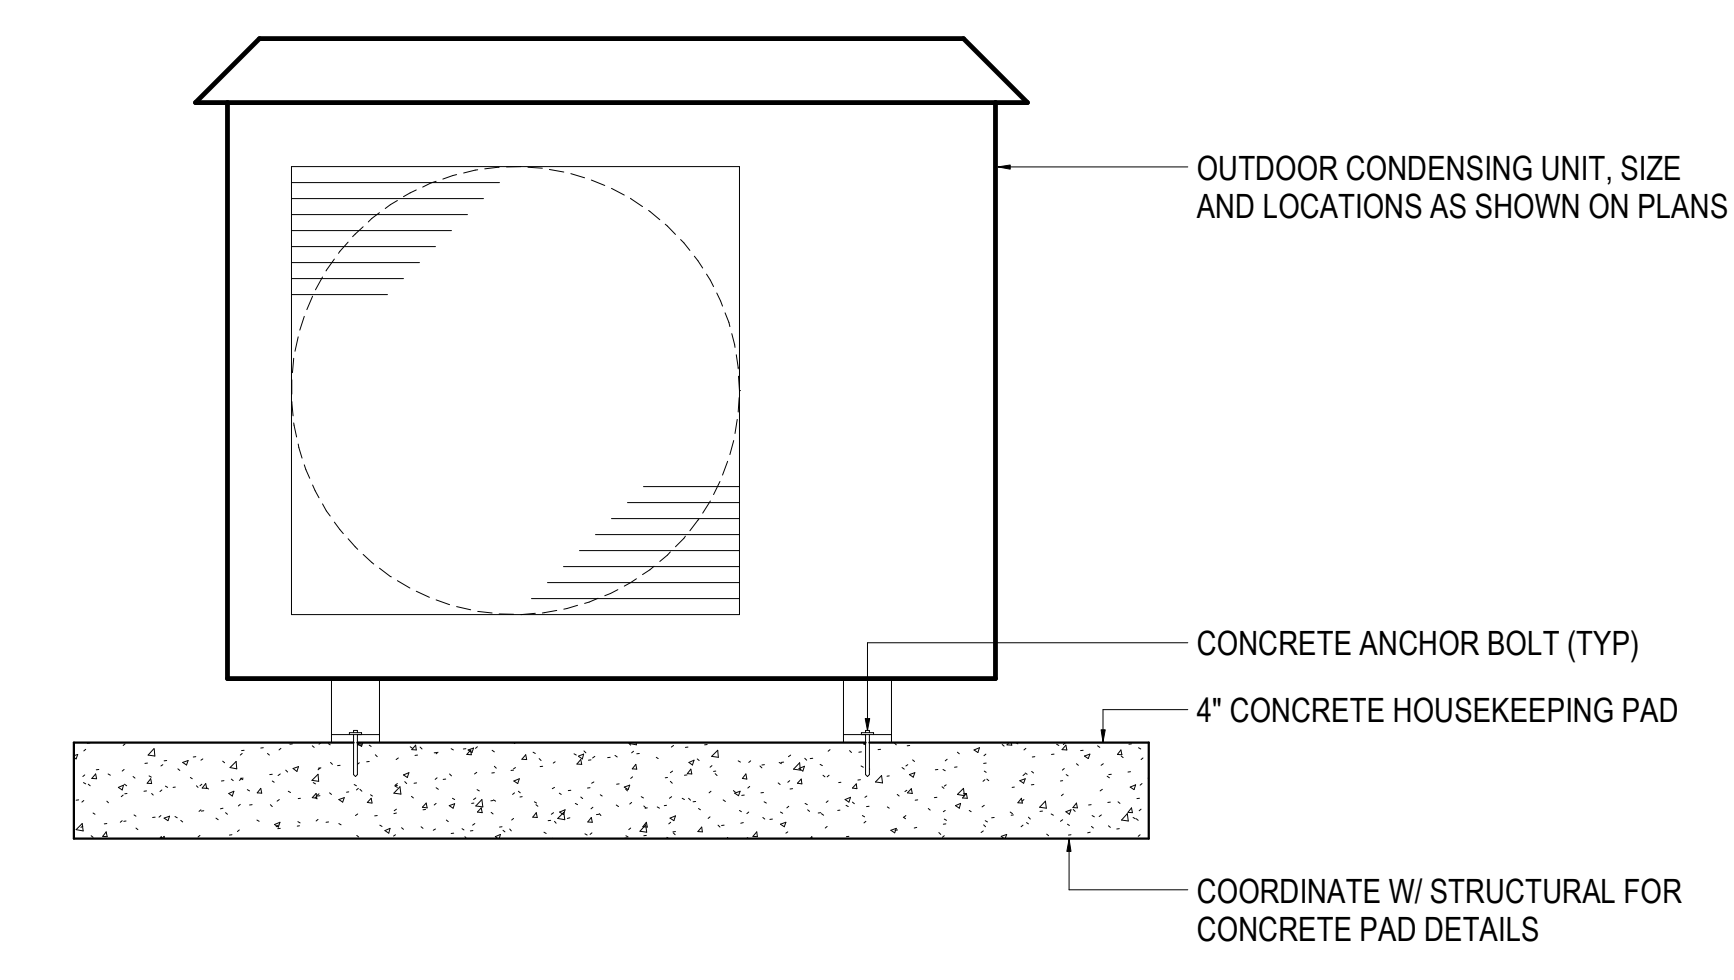

6 OUTDOOR CONDENSING UNIT PAD INSTALLATION DETAIL
NOT TO SCALE

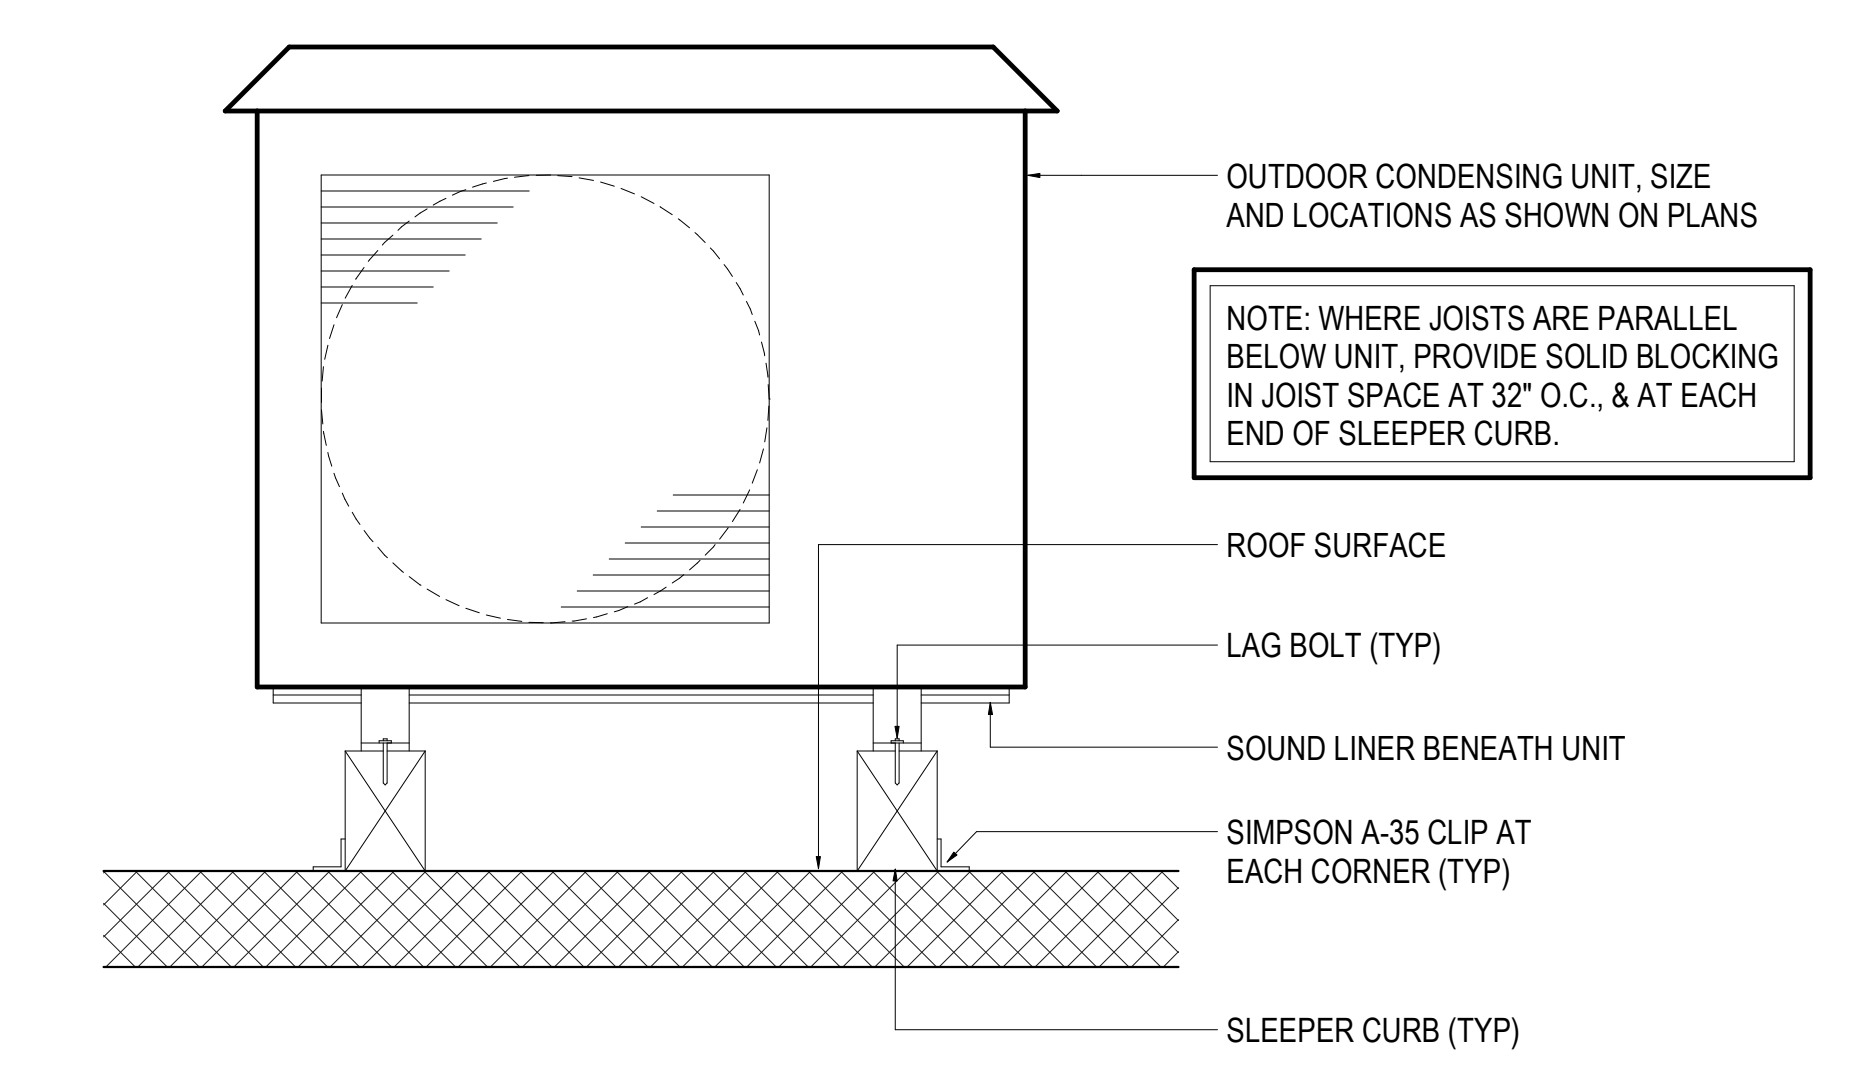

7 OUTDOOR CONDENSING UNIT ROOF INSTALLATION DETAIL
NOT TO SCALE

Revisions:	Date:

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REGISTERED PROFESSIONAL ENGINEER

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U.S. Department of Veterans Affairs

DRAWING TITLE
MECHANICAL DETAILS
APPROVED:

PHASE
100% CONSTRUCTION DOCUMENTS
FULLY SPRINKLERED

PROJECT TITLE
EHRM INFRASTRUCTURE UPGRADES
LOCATION
FORT MEADE, SOUTH DAKOTA
ISSUE DATE
4/15/2022
CHECKED BY
EMM/MRB
DRAWN BY
MEM/NSK



PROJECT NUMBER
568-21-701
BUILDING NUMBER
DRAWING NUMBER
MG-004

GENERAL NOTES:


- A. THE INFORMATION SHOWN ON THIS DRAWING IS TAKEN FROM AS-BUILT DRAWINGS AND A NON-DESTRUCTIVE WALK THROUGH OF THE FACILITY. THERE IS NO WARRANTY OR GUARANTEE AS TO THE ACCURACY OF THE INFORMATION SHOWN HERE-IN. THE CONTRACTOR SHALL FIELD VERIFY ALL ITEMS SCHEDULED FOR DEMOLITION PRIOR TO START OF WORK.
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- D. ALL HVAC/PLUMBING EQUIPMENT AND PIPING CONVEYING FLUIDS IN THE NEW TR AREA SHALL BE RE-ROUTED OUTSIDE OF THIS AREA IF POSSIBLE. IF RE-ROUTING IS NOT POSSIBLE, PROVIDE WELDED SEAMLESS STAINLESS STEEL DRIP PAN BELOW PIPING.

SHEET NOTES:


- 1. APPROXIMATE OUTLINE OF NEW TR AREA. SEE REMODEL SHEETS FOR ALL DISCIPLINES FOR ADDITIONAL INFORMATION.
- 2. DEMOLISH CW PIPE DOWN TO FLUSH WITH FINISHED FLOOR, CAP, AND INFILL.
- 3. NO WORK IN THIS AREA. FLOOR PLAN INCLUDED FOR CLARITY.

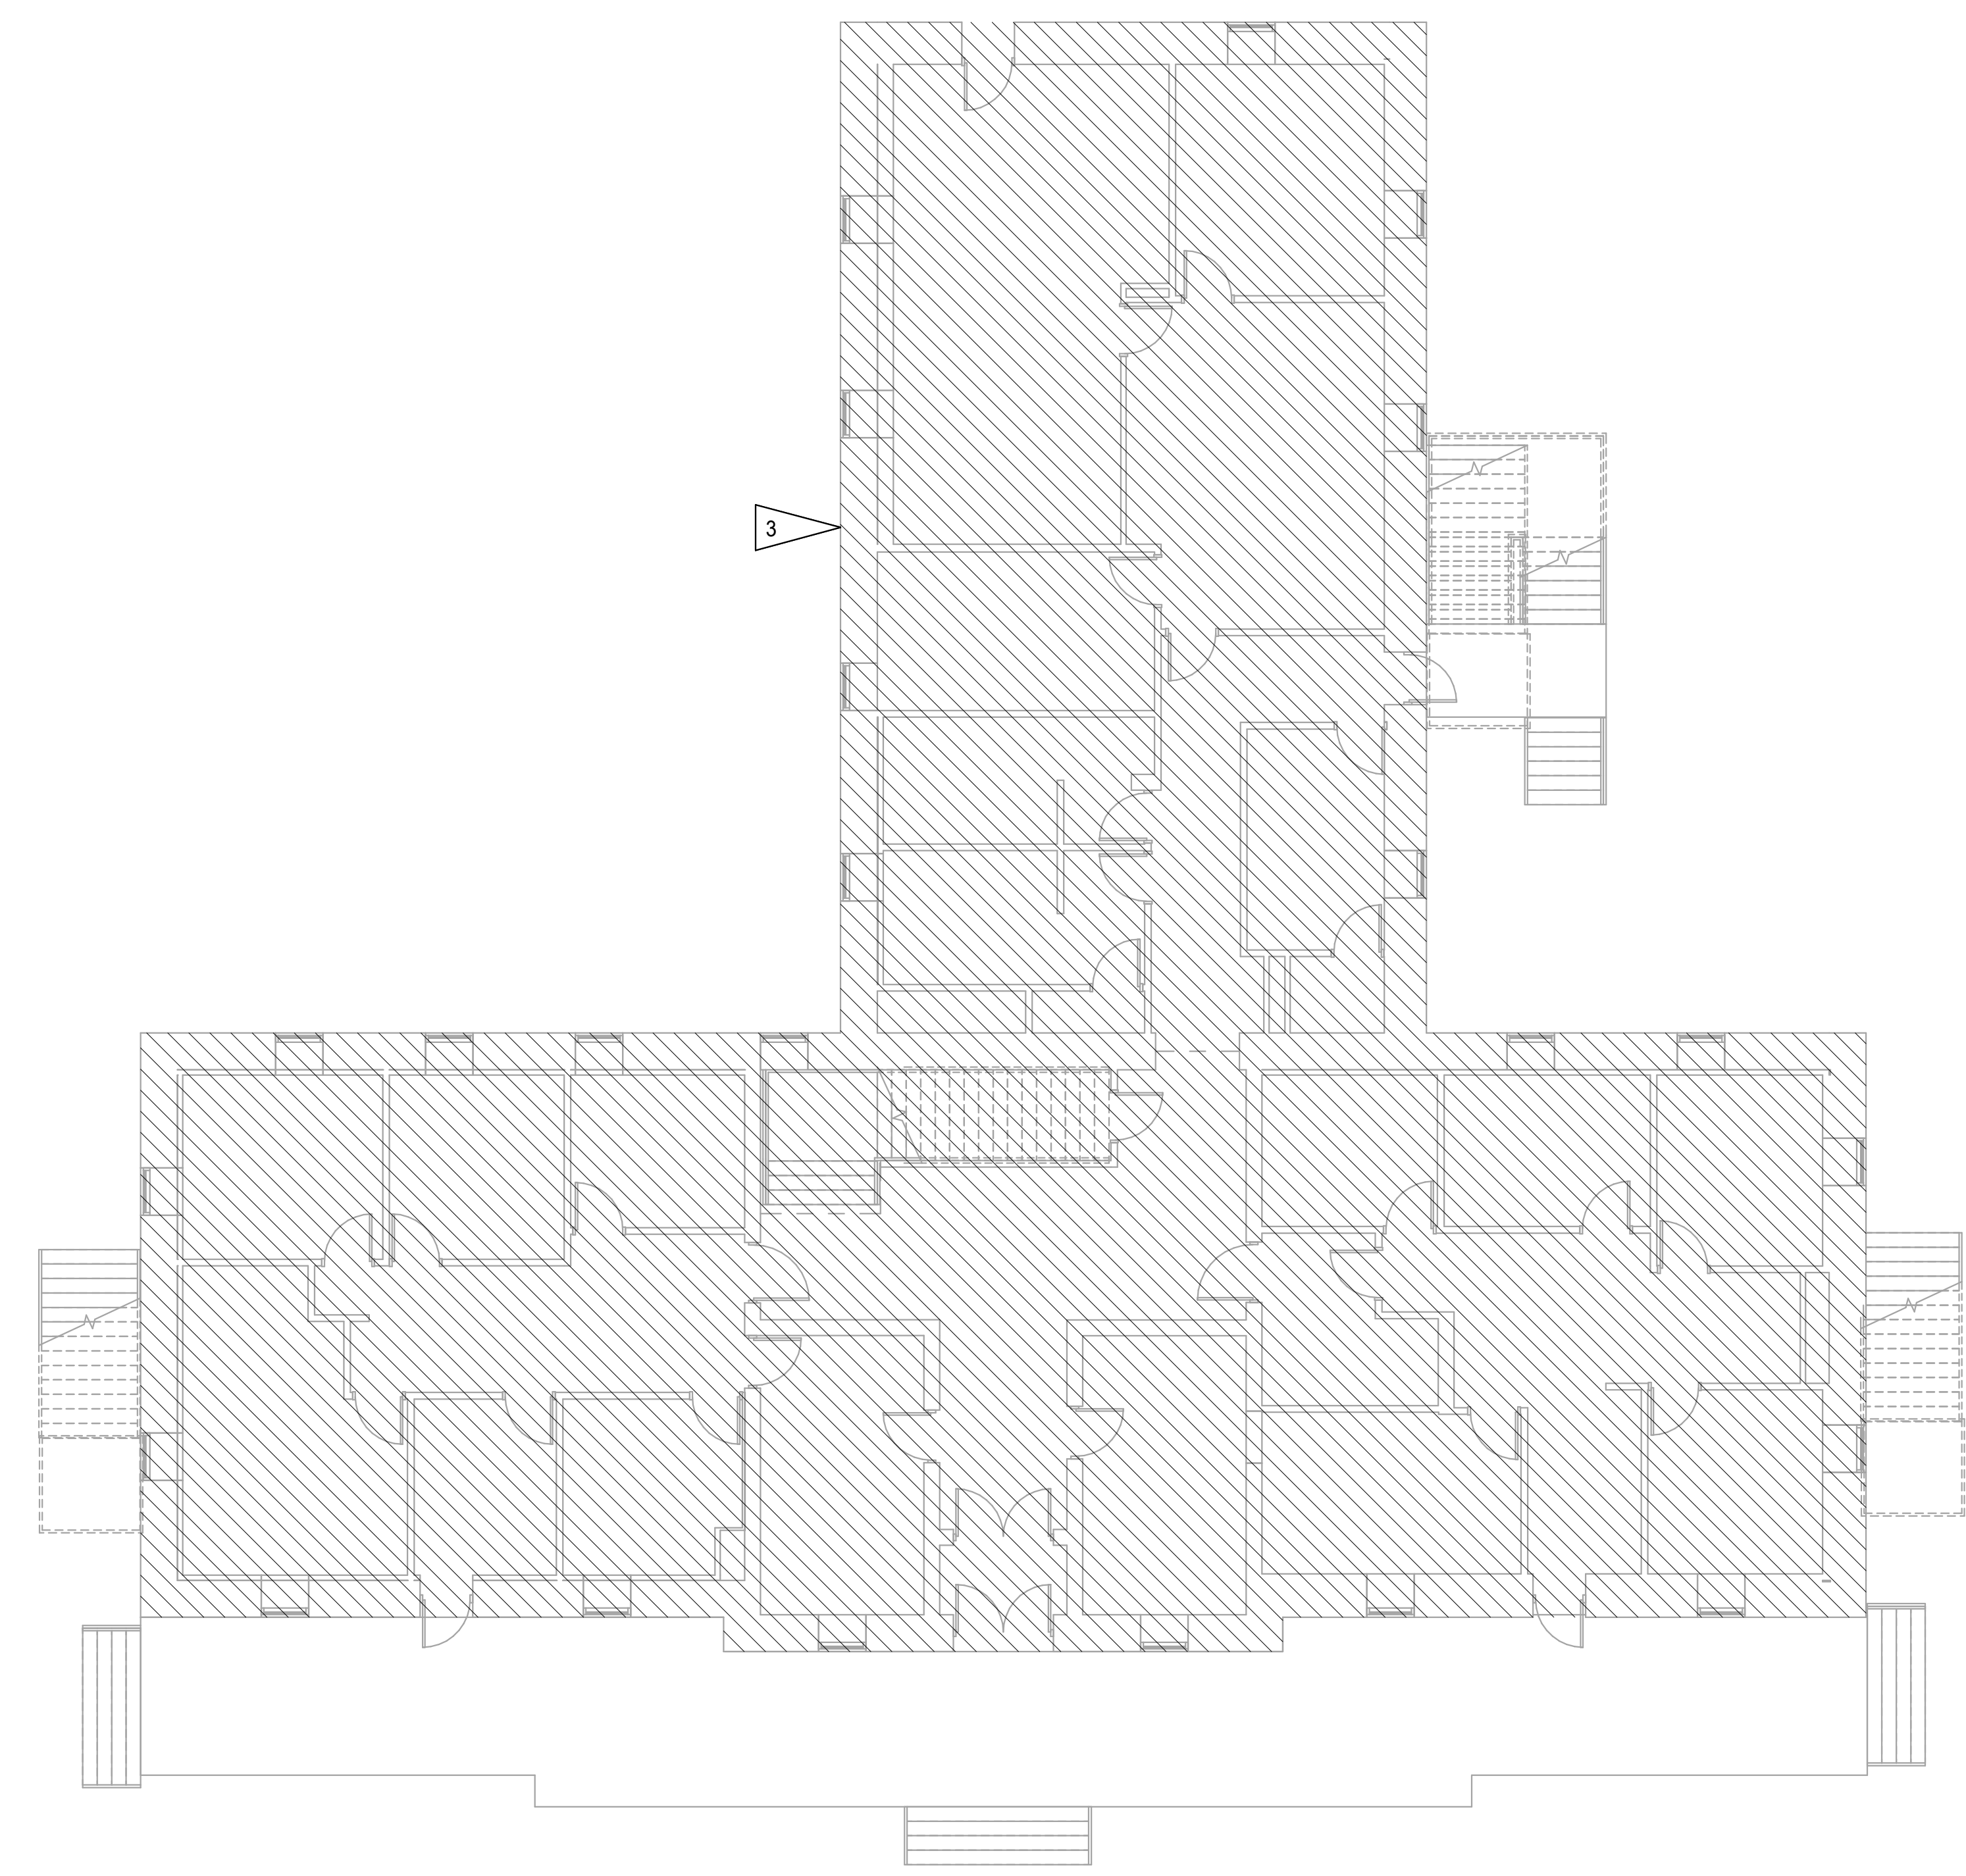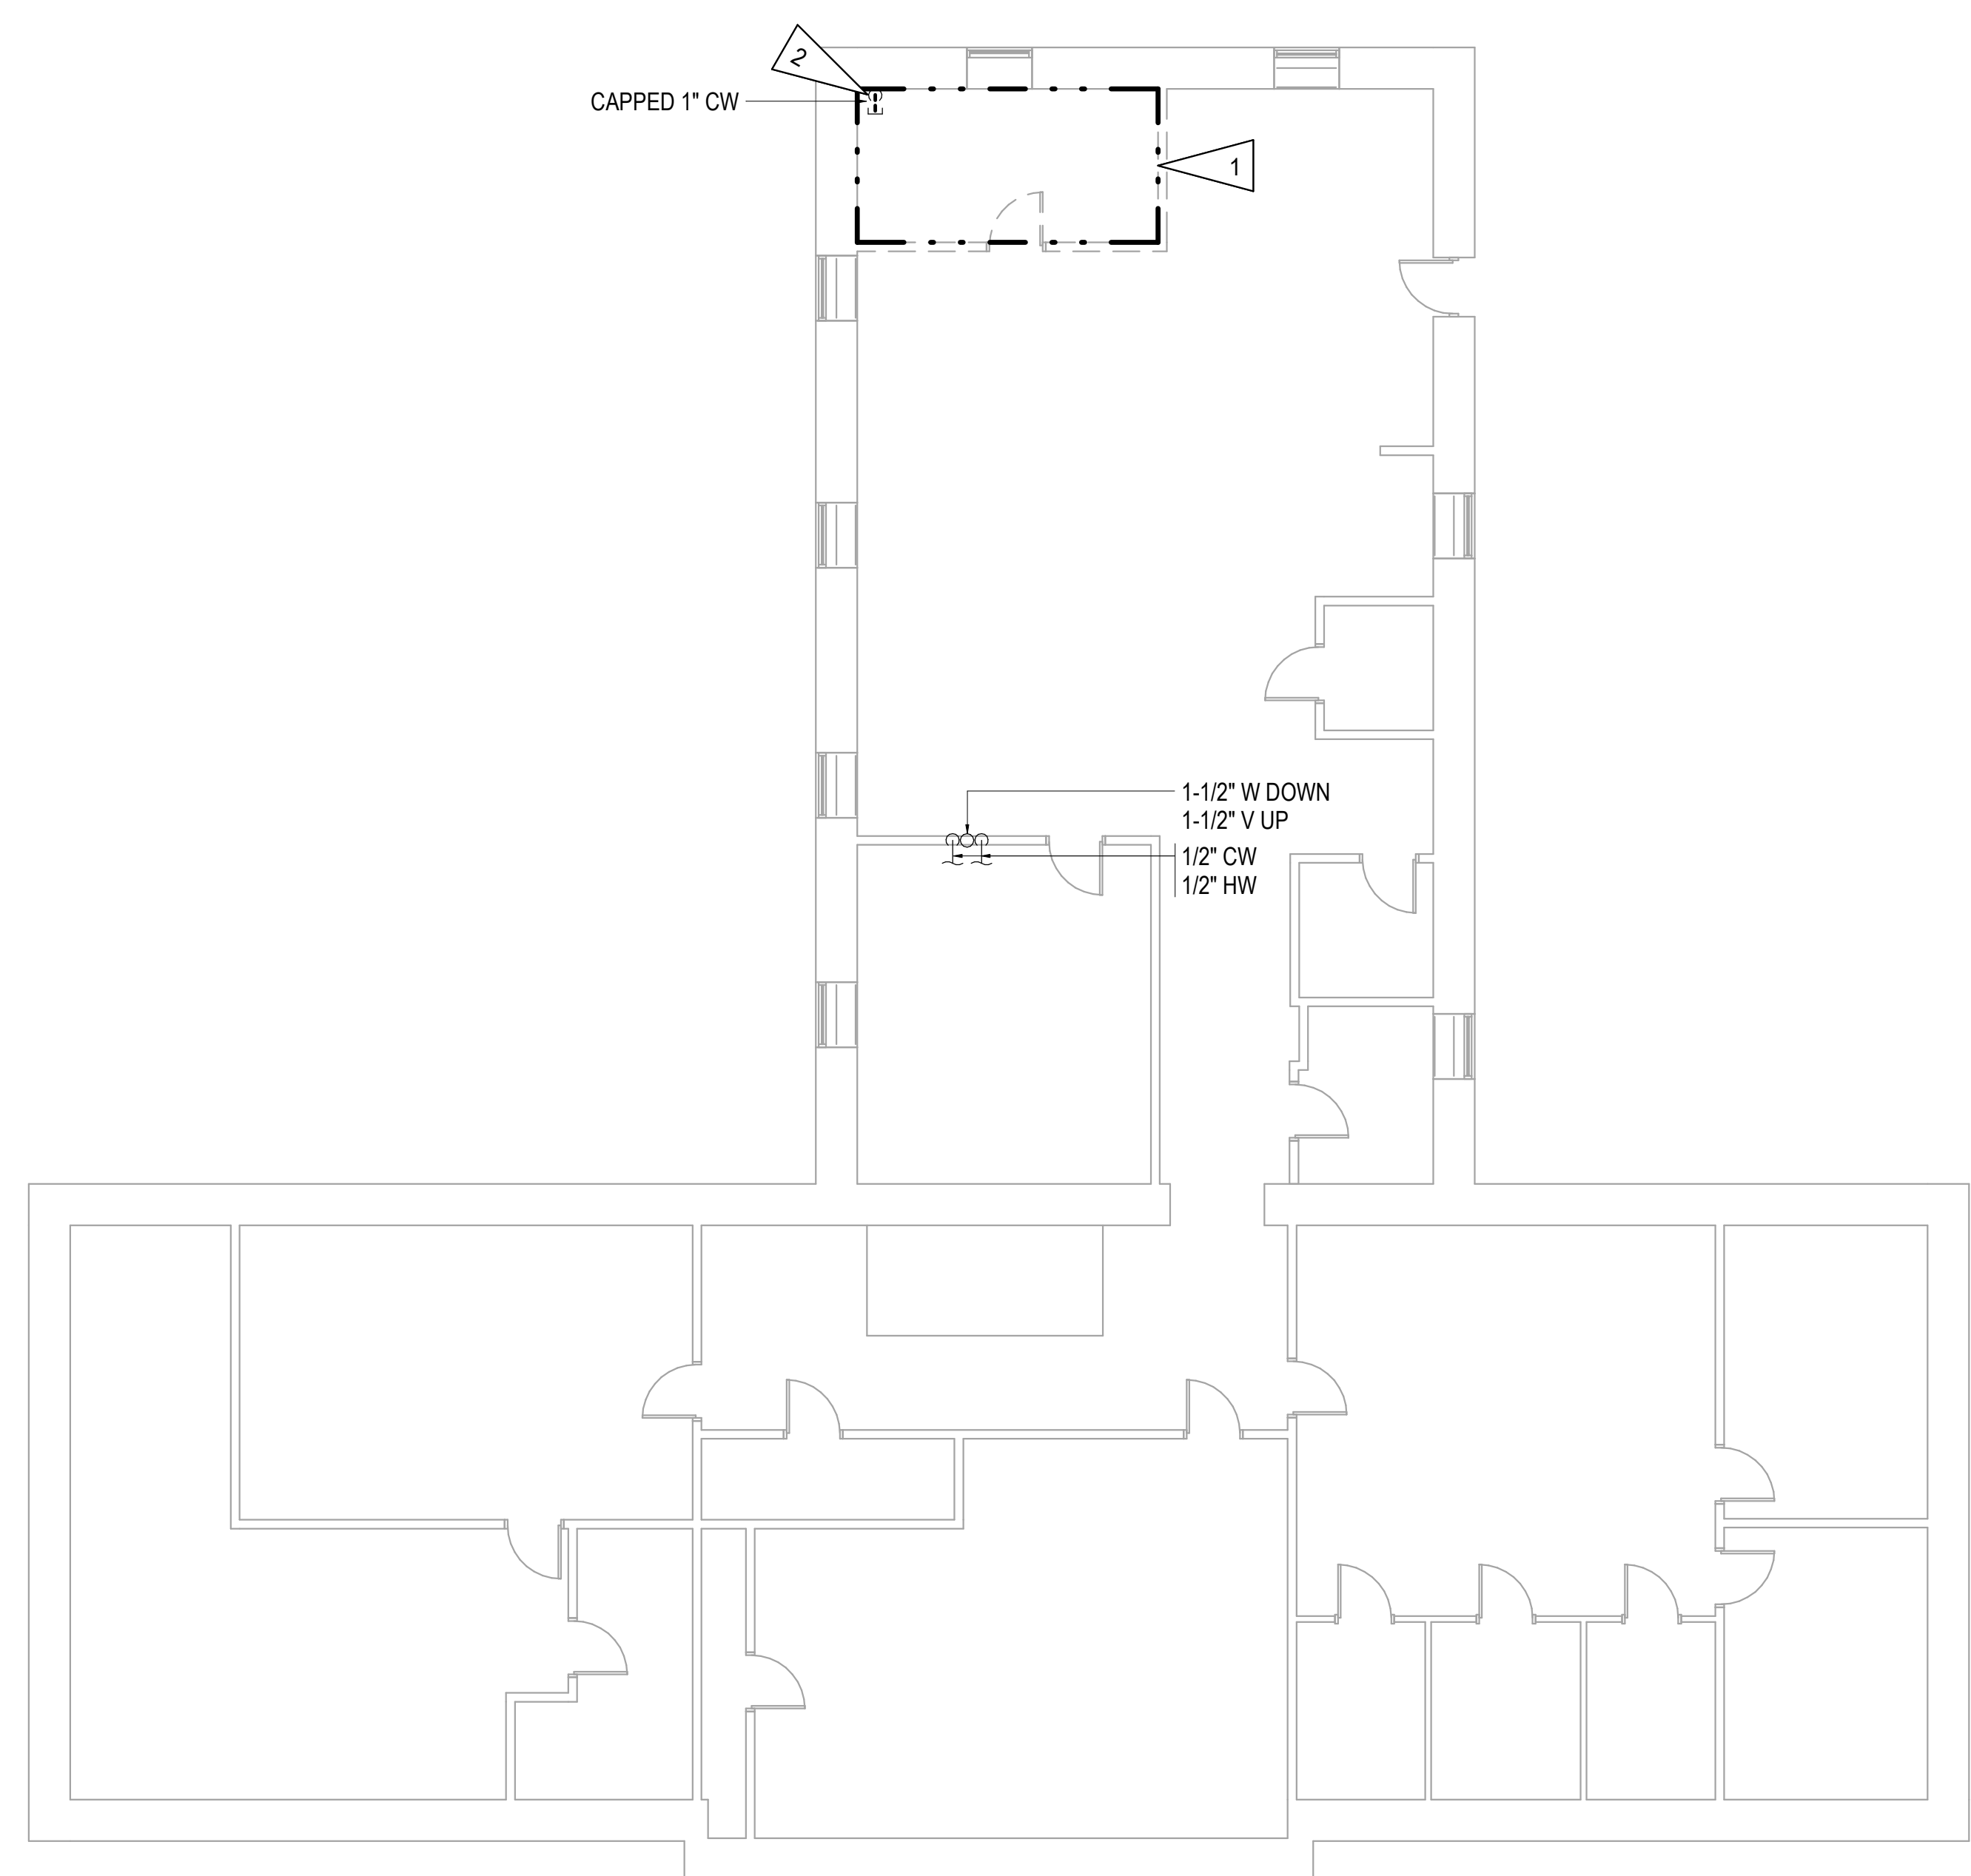

1 BUILDING 053 - BASEMENT DEMOLITION PLAN - OVERALL
1/8" = 1'-0"

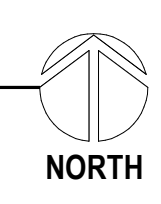

2 BUILDING 053 - FIRST FLOOR DEMOLITION PLAN - OVERALL
1/8" = 1'-0"

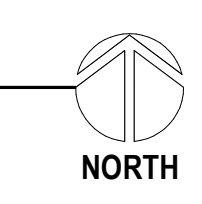

Revisions:	Date:

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OFFICE OF CONSTRUCTION AND FACILITIES MANAGEMENT

DRAWING TITLE
 053 - MECHANICAL DEMOLITION - OVERALL

APPROVED:

PHASE
 100% CONSTRUCTION DOCUMENTS

FLS
 FULLY SPRINKLERED

PROJECT TITLE
 EHRM INFRASTRUCTURE UPGRADES

LOCATION
 FORT MEADE, SOUTH DAKOTA

ISSUE DATE
 4/15/2022

CHECKED BY
 EMM/MRB

DRAWN BY
 MEM/NSK

PROJECT NUMBER
 568-21-701

BUILDING NUMBER
 BLDG 53


DRAWING NUMBER
053-MD-011

GENERAL NOTES:

- A. THE INFORMATION SHOWN ON THIS DRAWING IS TAKEN FROM AS-BUILT DRAWINGS AND A NON-DESTRUCTIVE WALK THROUGH OF THE FACILITY. THERE IS NO WARRANTY OR GUARANTEE AS TO THE ACCURACY OF THE INFORMATION SHOWN HERE-IN. THE CONTRACTOR SHALL FIELD VERIFY ALL ITEMS SCHEDULED FOR DEMOLITION PRIOR TO START OF WORK.
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SHEET NOTES:

- 1 APPROXIMATE OUTLINE OF NEW TR AREA. SEE REMODEL SHEETS FOR ALL DISCIPLINES FOR ADDITIONAL INFORMATION.
- 2 RELOCATE ELECTRIC UNIT HEATER OUTSIDE OF TR LOCATION. SEE ELECTRICAL FOR ADDITIONAL INFORMATION.

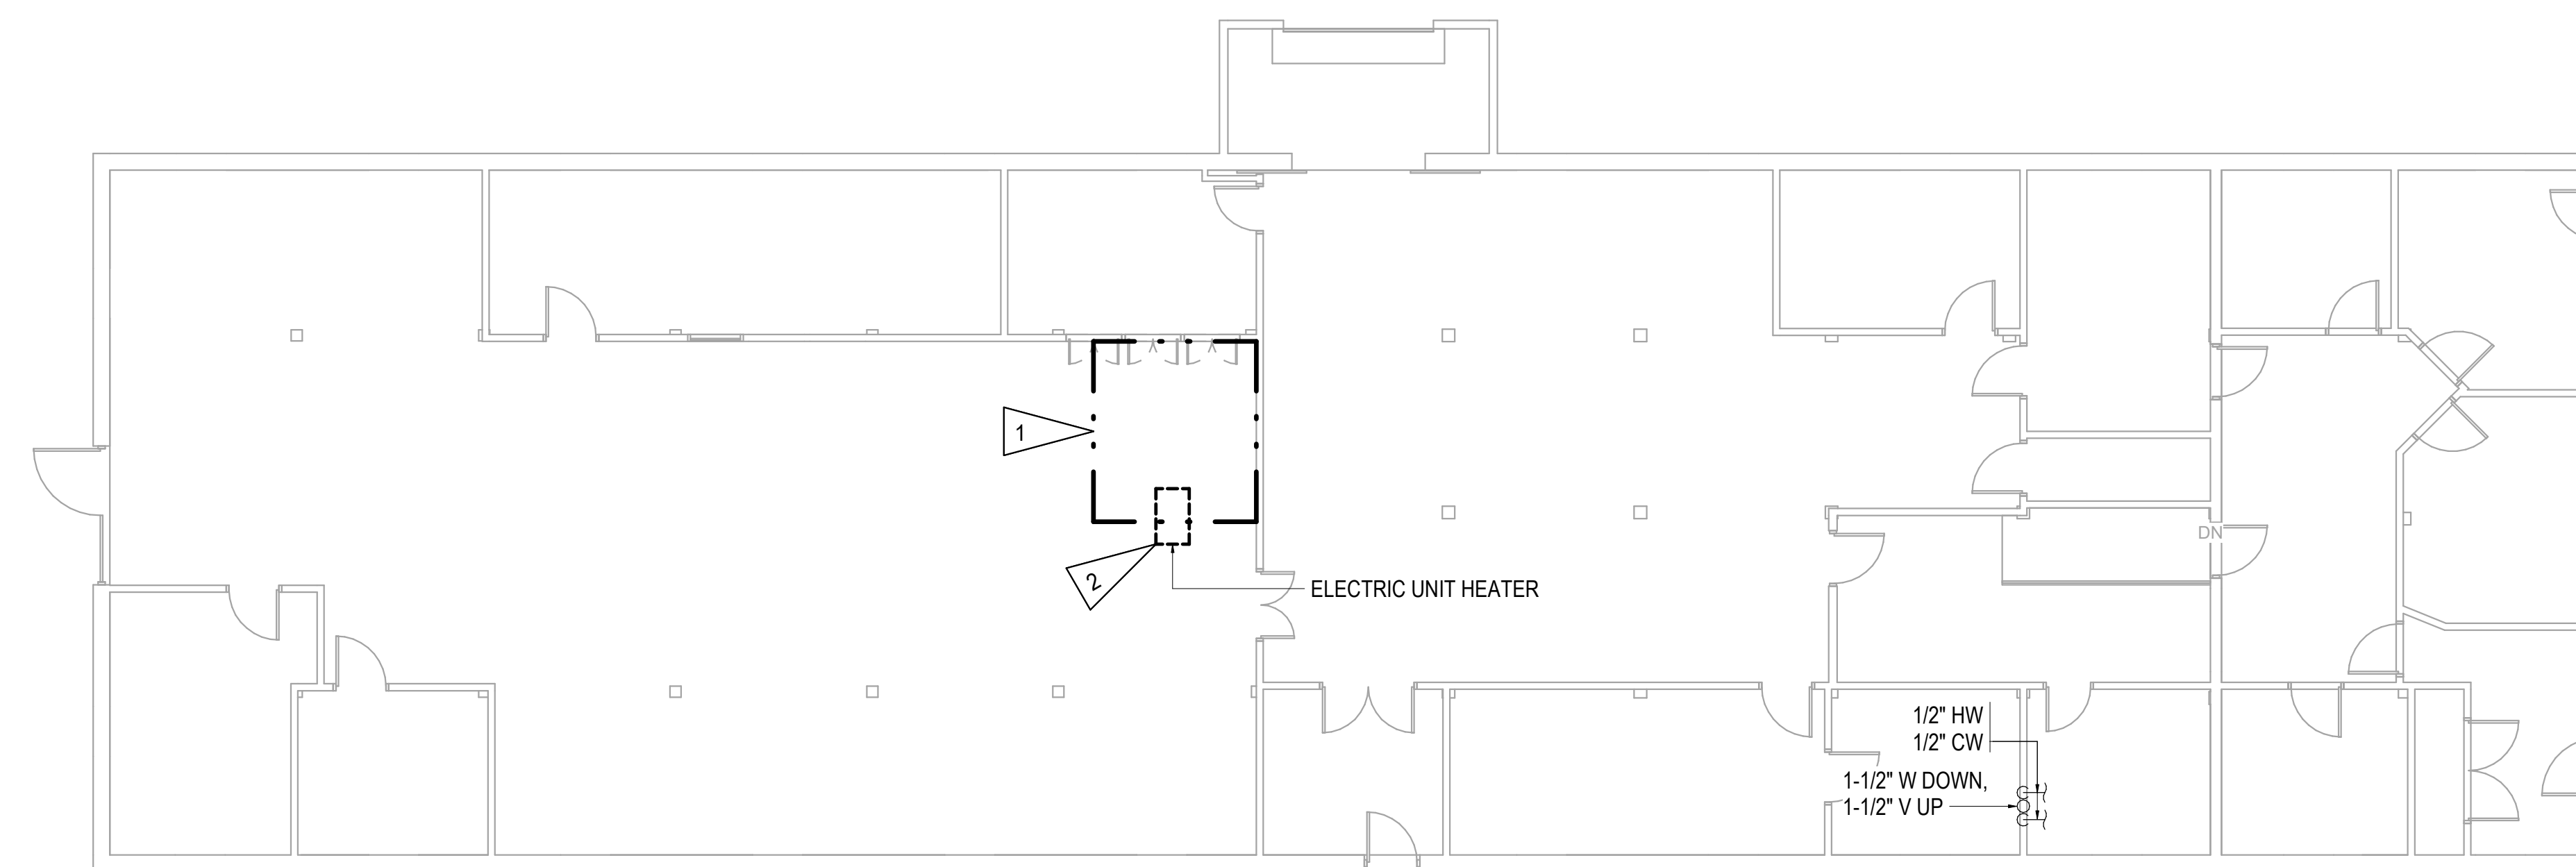

1 BUILDING 088 - FIRST FLOOR DEMOLITION PLAN - OVERALL
1/8" = 1'-0"



Revisions:	Date:

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OFFICE OF CONSTRUCTION AND FACILITIES MANAGEMENT

DRAWING TITLE
088 - MECHANICAL DEMOLITION - OVERALL

APPROVED:

PHASE
100% CONSTRUCTION DOCUMENTS

FLS
FULLY SPRINKLERED

PROJECT TITLE
EHRM INFRASTRUCTURE UPGRADES

LOCATION
FORT MEADE, SOUTH DAKOTA

ISSUE DATE
4/15/2022

CHECKED BY
EMM/MRB

DRAWN BY
MEM/NSK

PROJECT NUMBER
568-21-701

BUILDING NUMBER
BLDG 88


DRAWING NUMBER
088-MD-011

GENERAL NOTES:

- A. THE INFORMATION SHOWN ON THIS DRAWING IS TAKEN FROM AS-BUILT DRAWINGS AND A NON-DESTRUCTIVE WALK THROUGH OF THE FACILITY. THERE IS NO WARRANTY OR GUARANTEE AS TO THE ACCURACY OF THE INFORMATION SHOWN HERE-IN. THE CONTRACTOR SHALL FIELD VERIFY ALL ITEMS SCHEDULED FOR DEMOLITION PRIOR TO START OF WORK.
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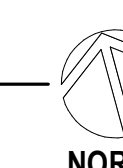
SHEET NOTES:

- 1 APPROXIMATE OUTLINE OF NEW TR AREA. SEE REMODEL SHEETS FOR ALL DISCIPLINES FOR ADDITIONAL INFORMATION.

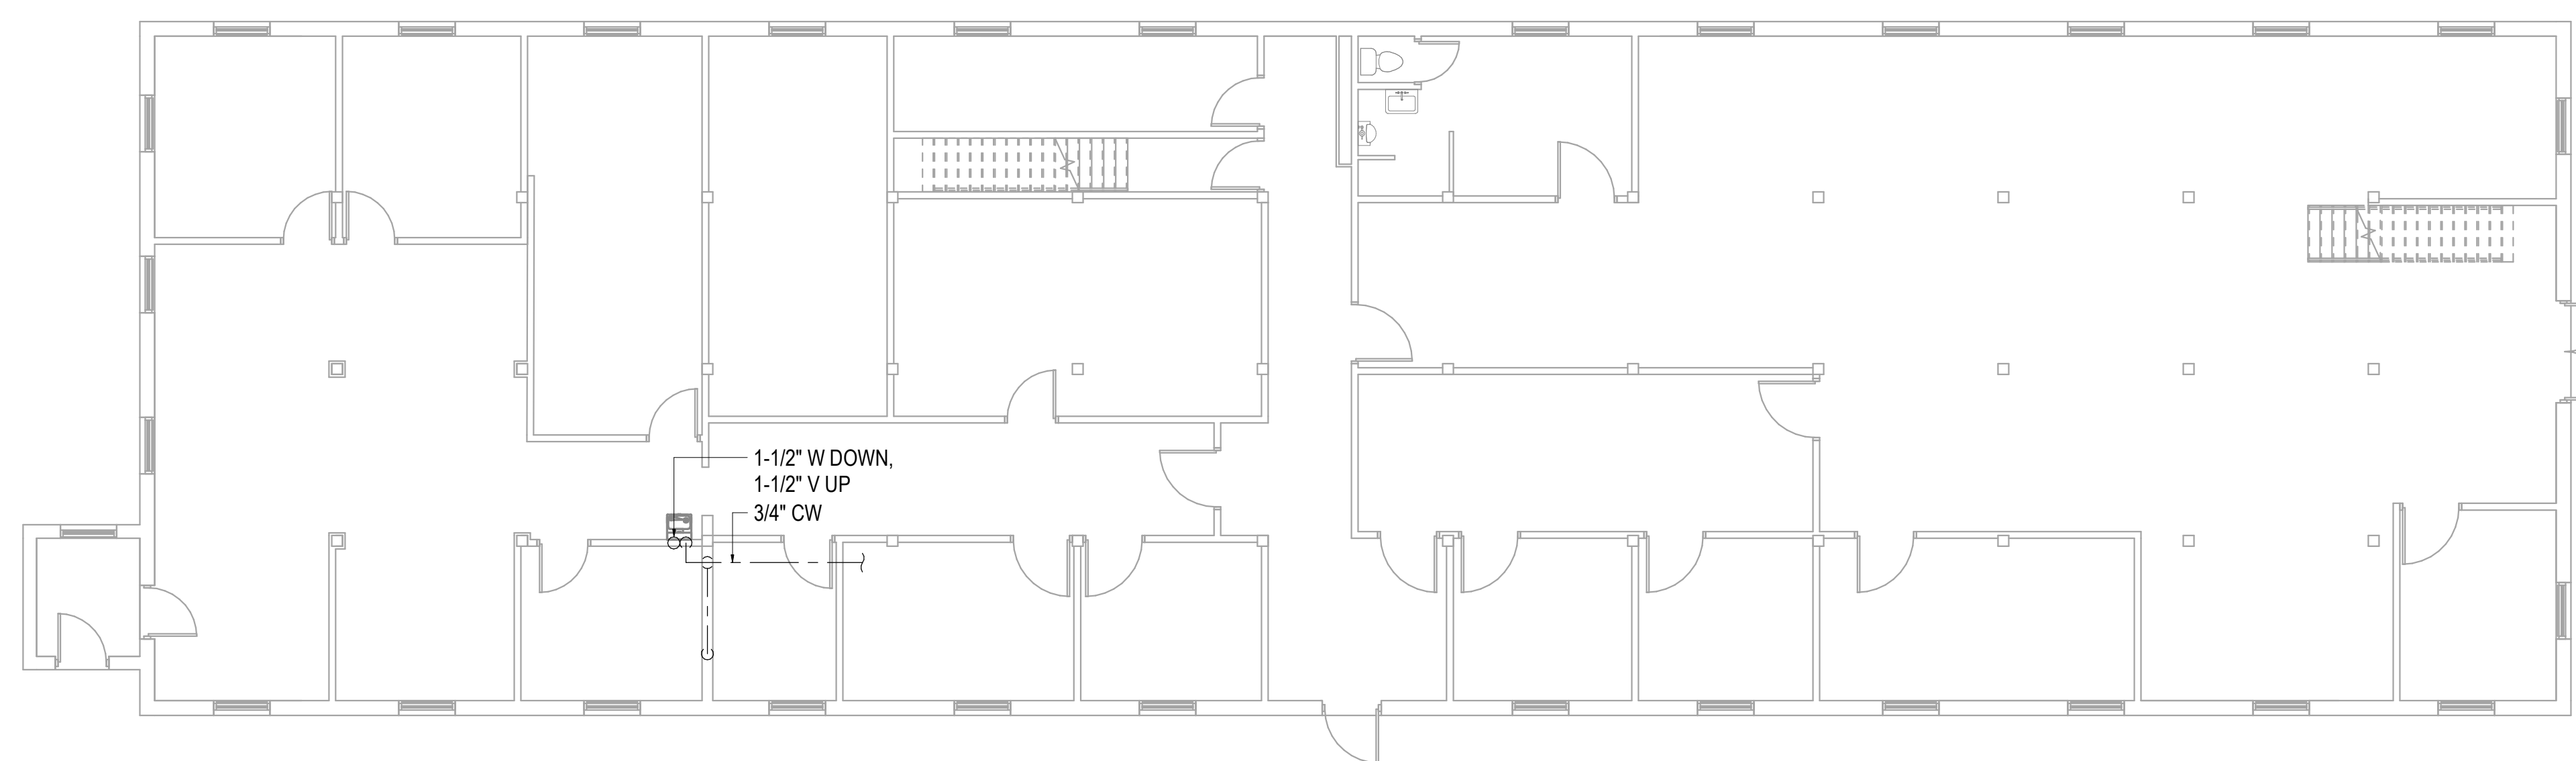


1 BUILDING 089 - FIRST FLOOR DEMOLITION PLAN - OVERALL

1/8" = 1'-0"



2 BUILDING 089 - SECOND FLOOR DEMOLITION PLAN - OVERALL

1/8" = 1'-0"

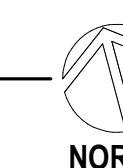

Revisions:	Date:


CONSULTANT

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


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OFFICE OF CONSTRUCTION AND FACILITIES MANAGEMENT



DRAWING TITLE
089 - MECHANICAL DEMOLITION - OVERALL

APPROVED:

PHASE
100% CONSTRUCTION DOCUMENTS

FLS
FULLY SPRINKLERED

PROJECT TITLE
EHRM INFRASTRUCTURE UPGRADES

LOCATION
FORT MEADE, SOUTH DAKOTA

ISSUE DATE
 4/15/2022

CHECKED BY
 EMM/MRB

DRAWN BY
 MEM/NSK

PROJECT NUMBER
 568-21-701

BUILDING NUMBER
 BLDG 8


DRAWING NUMBER
089-MD-011

GENERAL NOTES:

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SHEET NOTES:

- 1 APPROXIMATE OUTLINE OF NEW TR AREA. SEE REMODEL SHEETS FOR ALL DISCIPLINES FOR ADDITIONAL INFORMATION.
- 2 DEMOLISH EXISTING FIN TUBE, FIN TUBE ENCLOSURE, AND ASSOCIATED HYDRONIC BRANCH PIPING TO EXTENT NECESSARY FOR TR REMODEL. SALVAGE VALVE TRAIN FOR RE-USE IN REMODEL.
- 3 DEMOLISH HYDRONIC PIPE RISER TO ATTIC. PATCH AND SEAL FLOOR PENETRATION.

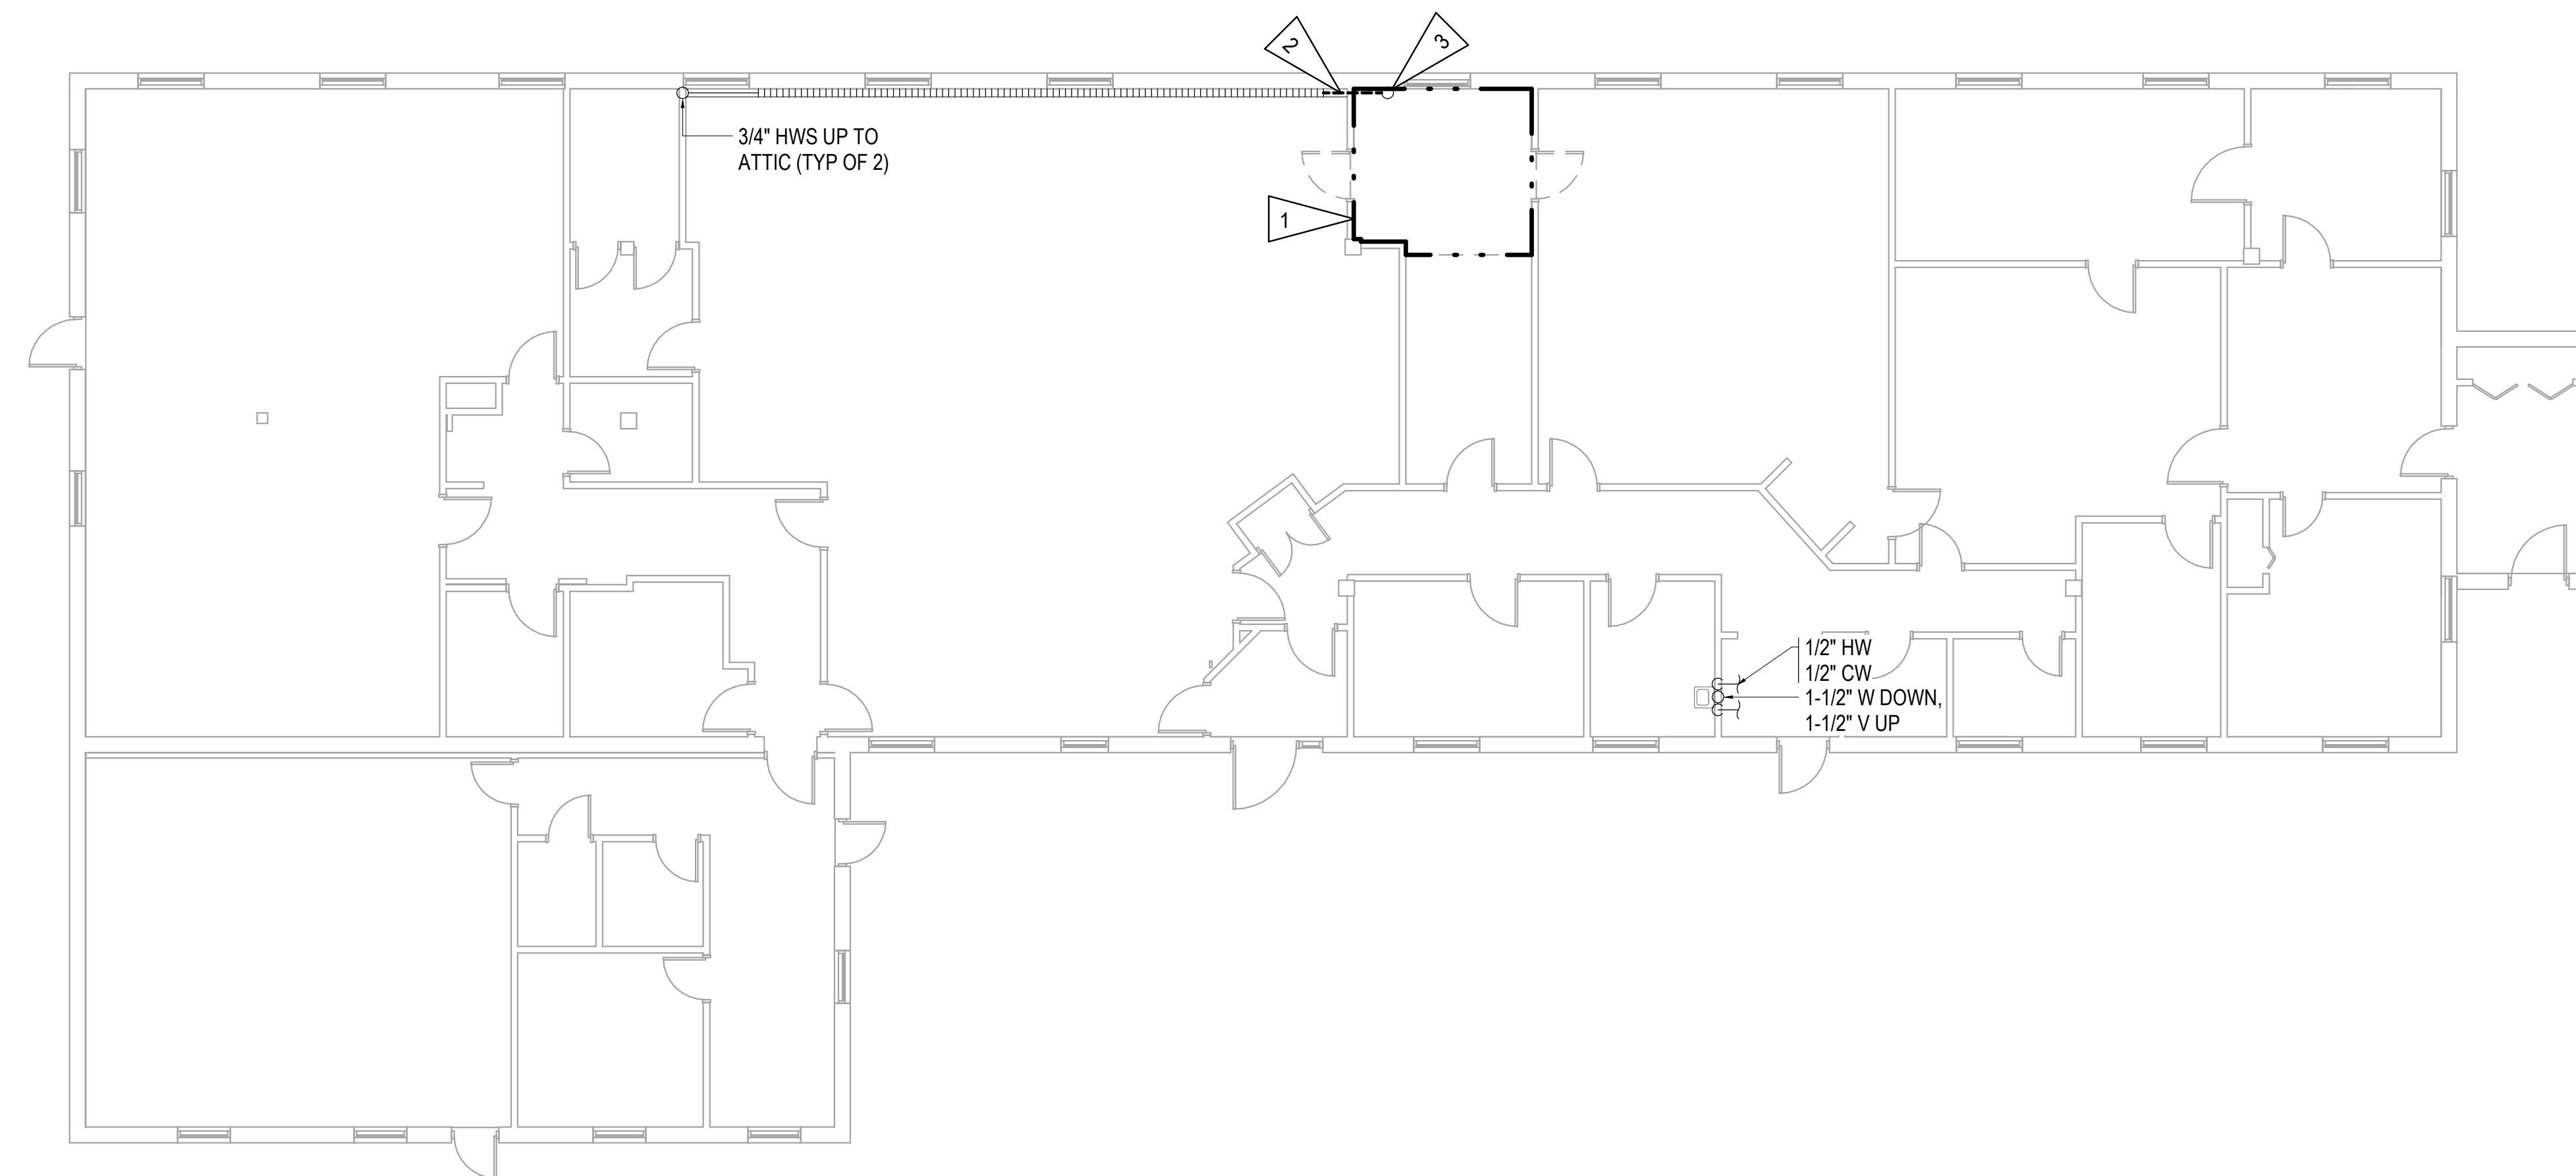

1 BUILDING 090 - FIRST FLOOR DEMOLITION PLAN - OVERALL
1/8" = 1'-0"



Revisions:	Date:

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OFFICE OF CONSTRUCTION AND FACILITIES MANAGEMENT

DRAWING TITLE
090 - MECHANICAL DEMOLITION - OVERALL

APPROVED:

PHASE
100% CONSTRUCTION DOCUMENTS

FLS
FULLY SPRINKLERED

PROJECT TITLE
EHRM INFRASTRUCTURE UPGRADES

LOCATION
FORT MEADE, SOUTH DAKOTA

ISSUE DATE
4/15/2022

CHECKED BY
EMM/MRB

DRAWN BY
MEM/NSK


PROJECT NUMBER
568-21-701

BUILDING NUMBER
BLDG 90

DRAWING NUMBER
090-MD-011

GENERAL NOTES:

- A. THE INFORMATION SHOWN ON THIS DRAWING IS TAKEN FROM AS-BUILT DRAWINGS AND A NON-DESTRUCTIVE WALK THROUGH OF THE FACILITY. THERE IS NO WARRANTY OR GUARANTEE AS TO THE ACCURACY OF THE INFORMATION SHOWN HERE-IN. THE CONTRACTOR SHALL FIELD VERIFY ALL ITEMS SCHEDULED FOR DEMOLITION PRIOR TO START OF WORK.
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1 BUILDING 113 - BASEMENT DEMOLITION PLAN - OVERALL
1/16" = 1'-0"

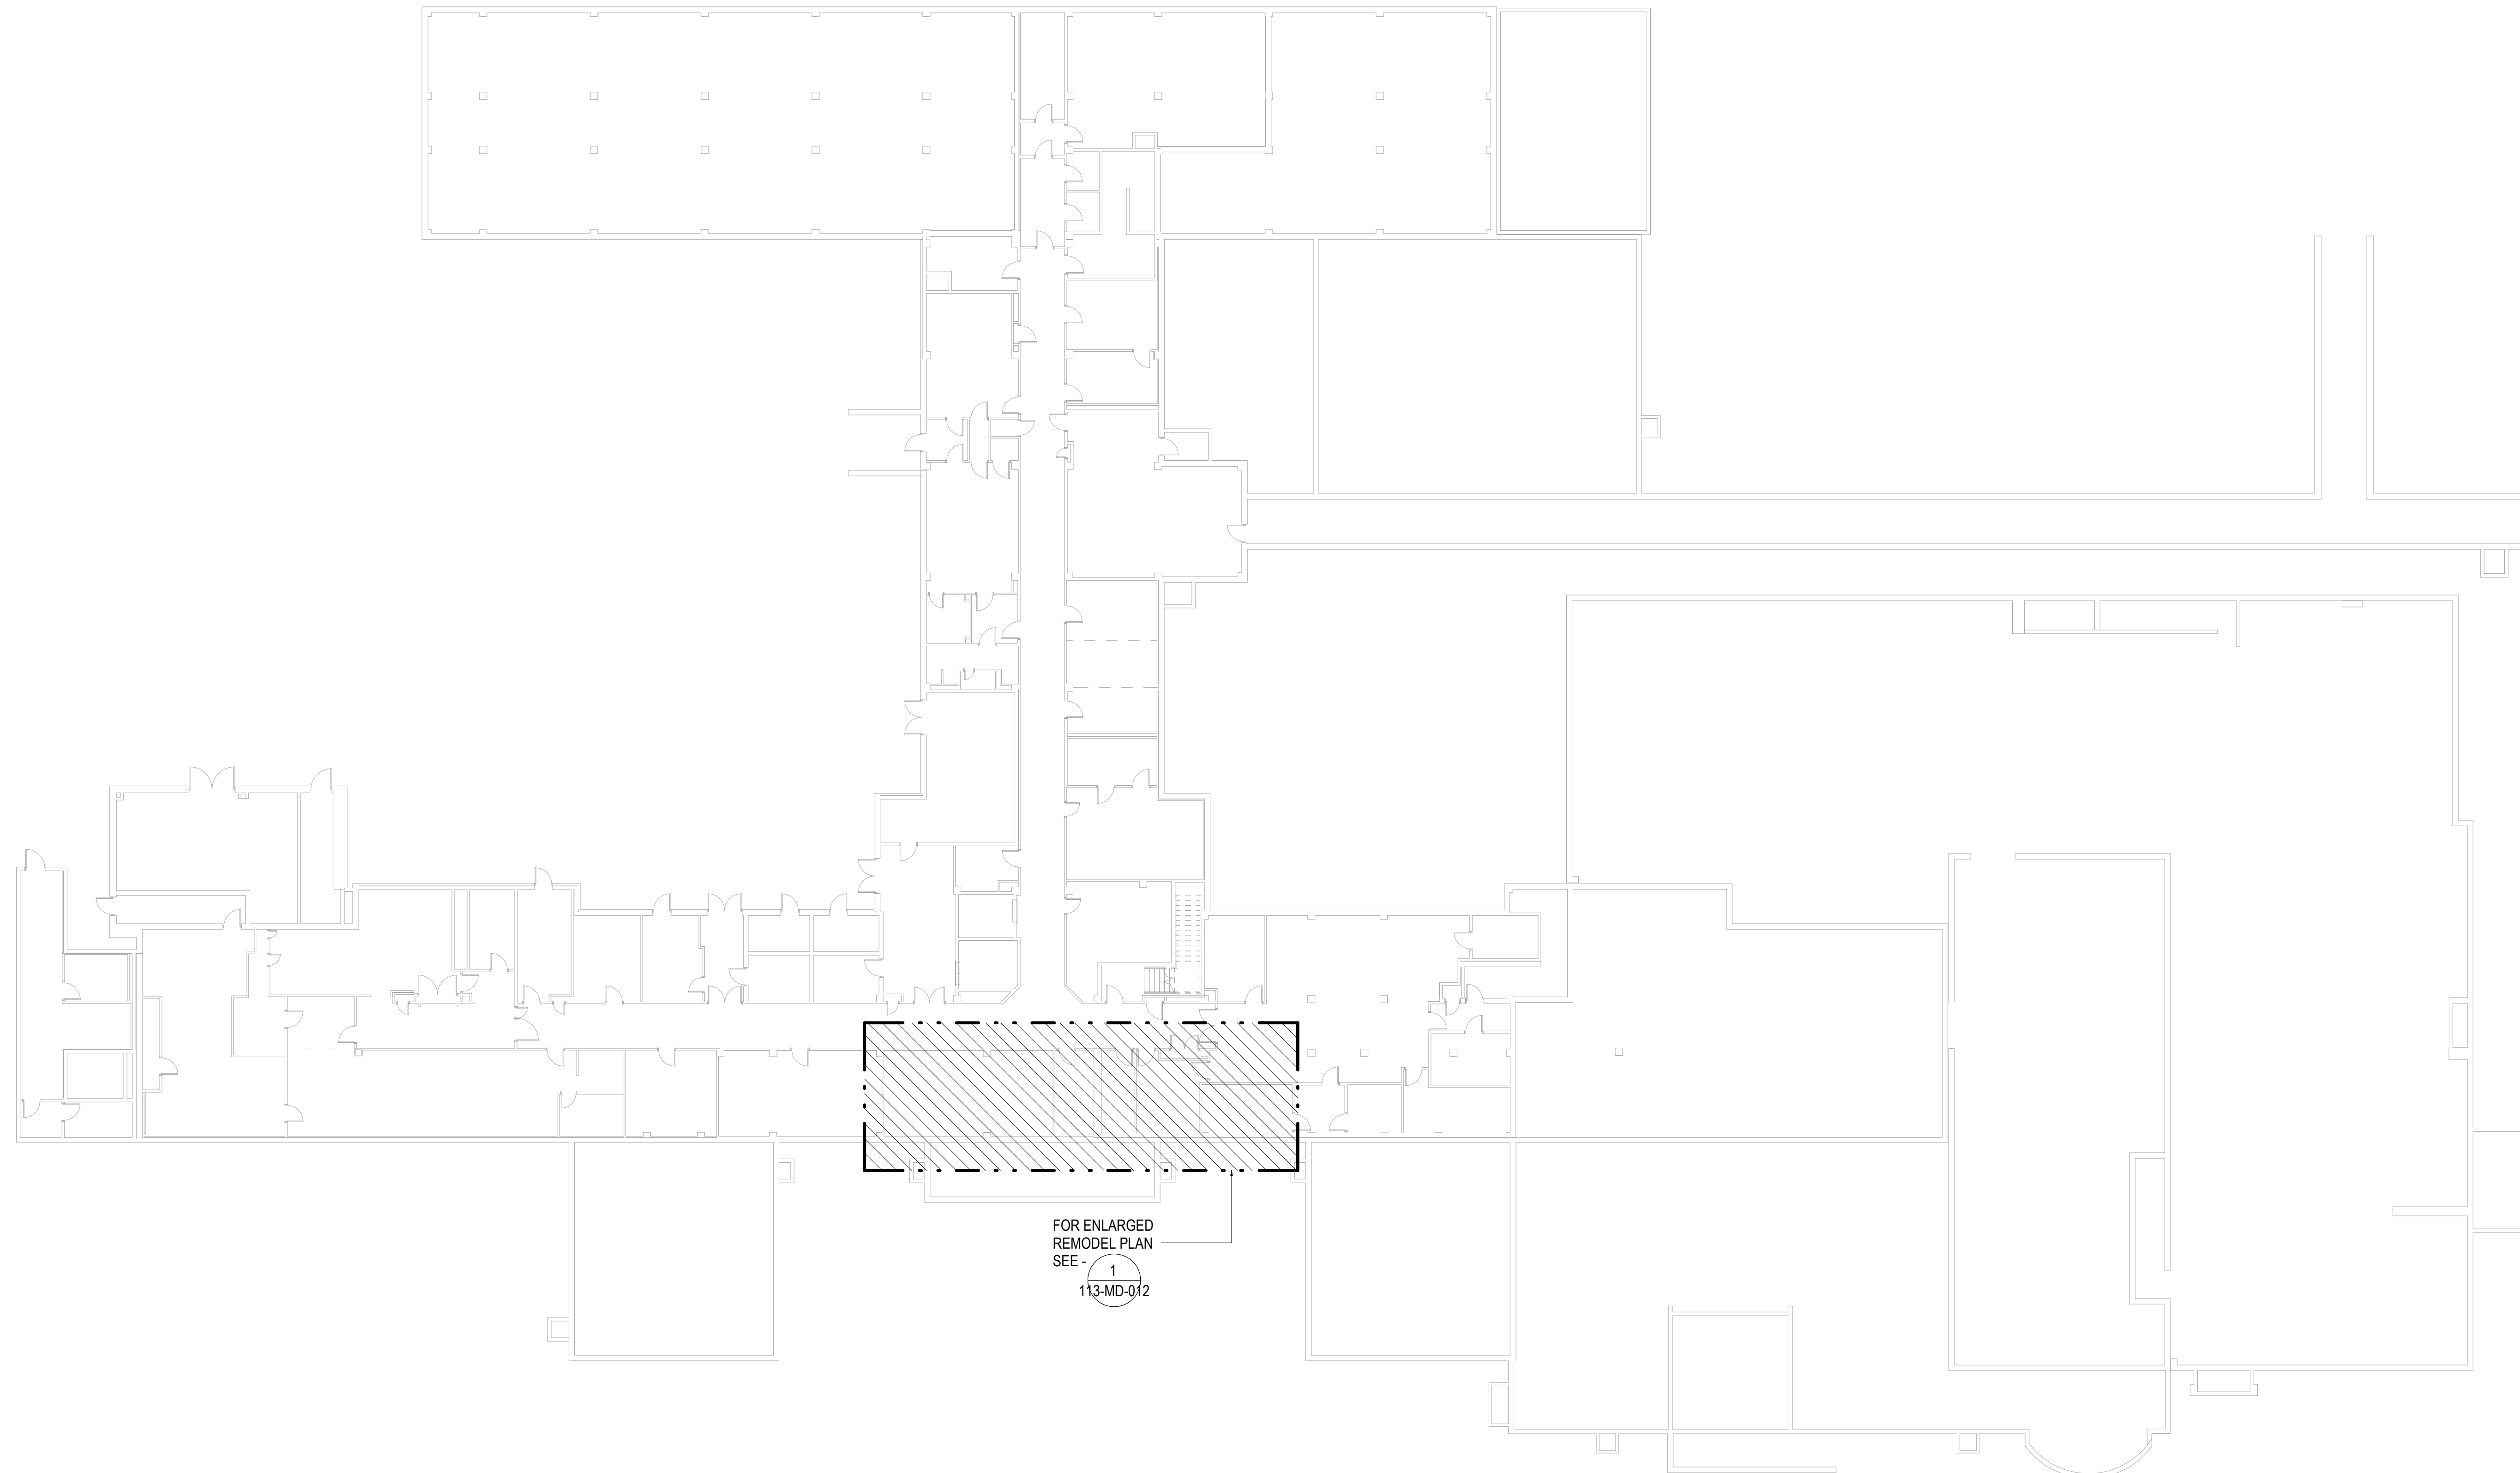



Revisions:	Date:

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OFFICE OF CONSTRUCTION AND FACILITIES MANAGEMENT
 VA U.S. Department of Veterans Affairs

DRAWING TITLE
 113 - MECHANICAL DEMOLITION - BASEMENT - OVERALL

APPROVED:

PHASE
 100% CONSTRUCTION DOCUMENTS

FLS
 FULLY SPRINKLERED

PROJECT TITLE
 EHRM INFRASTRUCTURE UPGRADES

LOCATION
 FORT MEADE, SOUTH DAKOTA

ISSUE DATE
 4/15/2022

CHECKED BY
 EMM/MRB

DRAWN BY
 MEM/NSK


PROJECT NUMBER
 568-21-701

BUILDING NUMBER
 BLDG 113


DRAWING NUMBER
113-MD-001

GENERAL NOTES:

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1 BUILDING 113 - FIRST FLOOR DEMOLITION PLAN - OVERALL
1/16" = 1'-0"

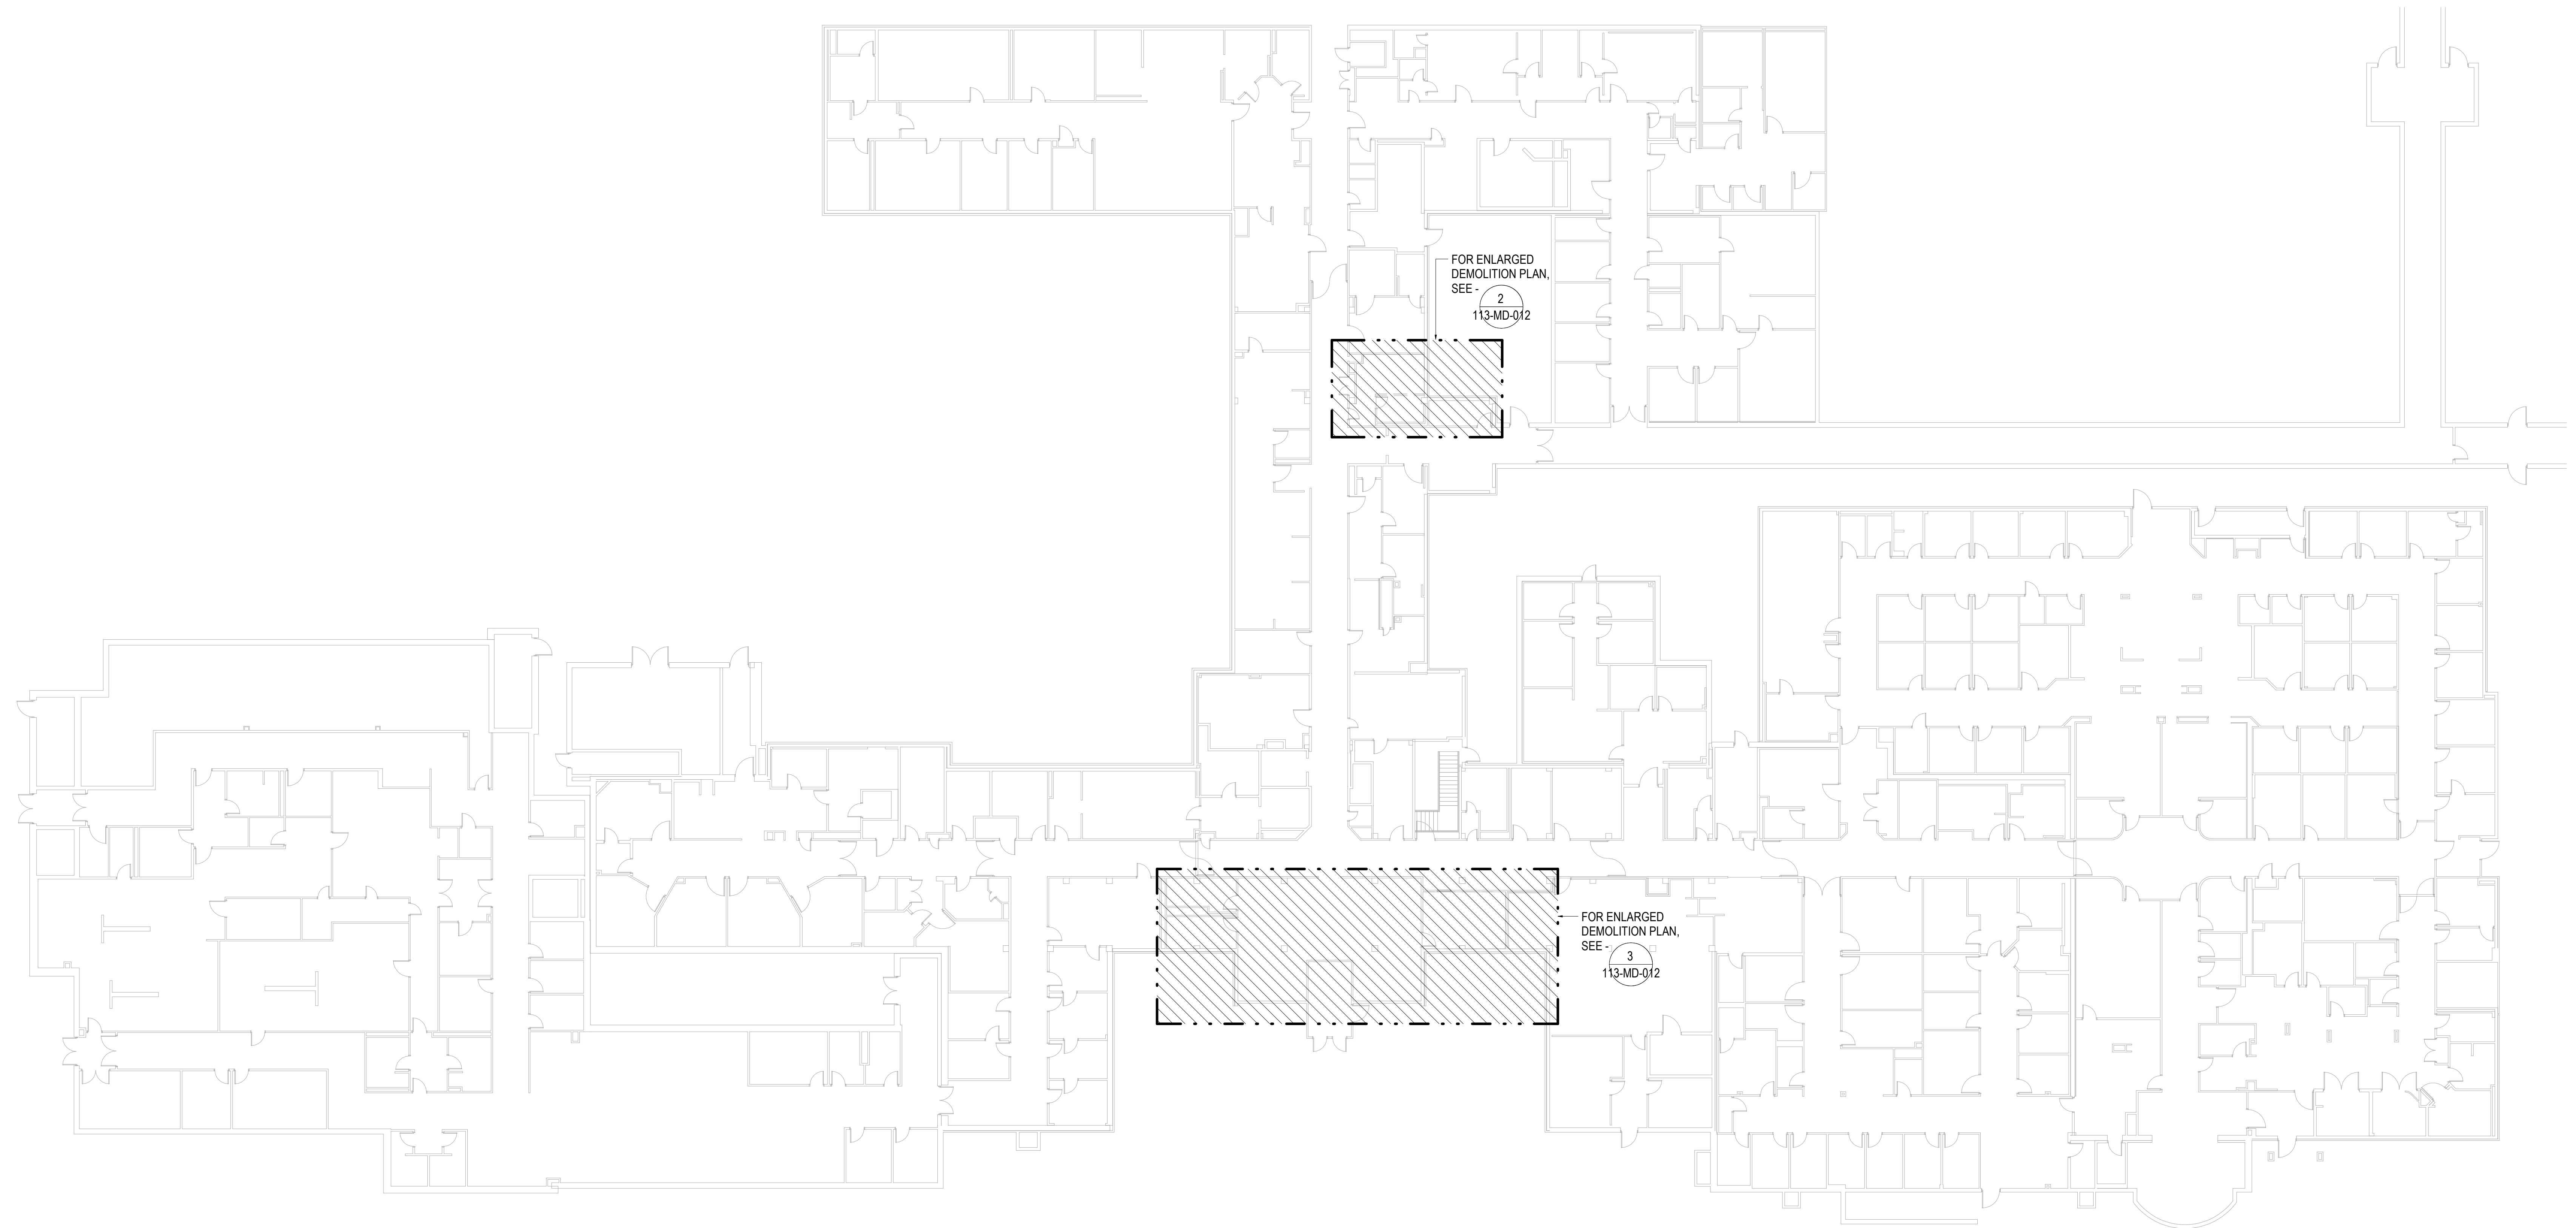


Revisions:	Date:

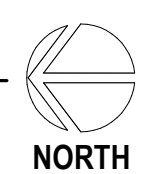
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OFFICE OF CONSTRUCTION AND FACILITIES MANAGEMENT
 VA U.S. Department of Veterans Affairs

DRAWING TITLE
 113 - MECHANICAL DEMOLITION - FIRST FLOOR - OVERALL

APPROVED:

PHASE
 100% CONSTRUCTION DOCUMENTS

FLS
 FULLY SPRINKLERED

PROJECT TITLE
 EHRM INFRASTRUCTURE UPGRADES

LOCATION
 FORT MEADE, SOUTH DAKOTA

ISSUE DATE
 4/15/2022

CHECKED BY
 EMM/MRB

DRAWN BY
 MEM/NSK

PROJECT NUMBER
 568-21-701

BUILDING NUMBER
 BLDG 113


DRAWING NUMBER
 113-MD-011

GENERAL NOTES:



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SHEET NOTES:


- 1 APPROXIMATE OUTLINE OF NEW TR AREA. SEE REMODEL SHEETS FOR ALL DISCIPLINES FOR ADDITIONAL INFORMATION.
- 2 DEMOLISH EXISTING WINDOW MOUNTED COOLING UNIT. DEMOLISH EXISTING ELECTRIC CABINET UNIT HEATER BELOW WINDOW.
- 3 SALVAGE EXISTING CEILING CASSETTE FOR RELOCATION.
- 4 DEMOLISH CW PIPING AS SHOWN AND CAP.

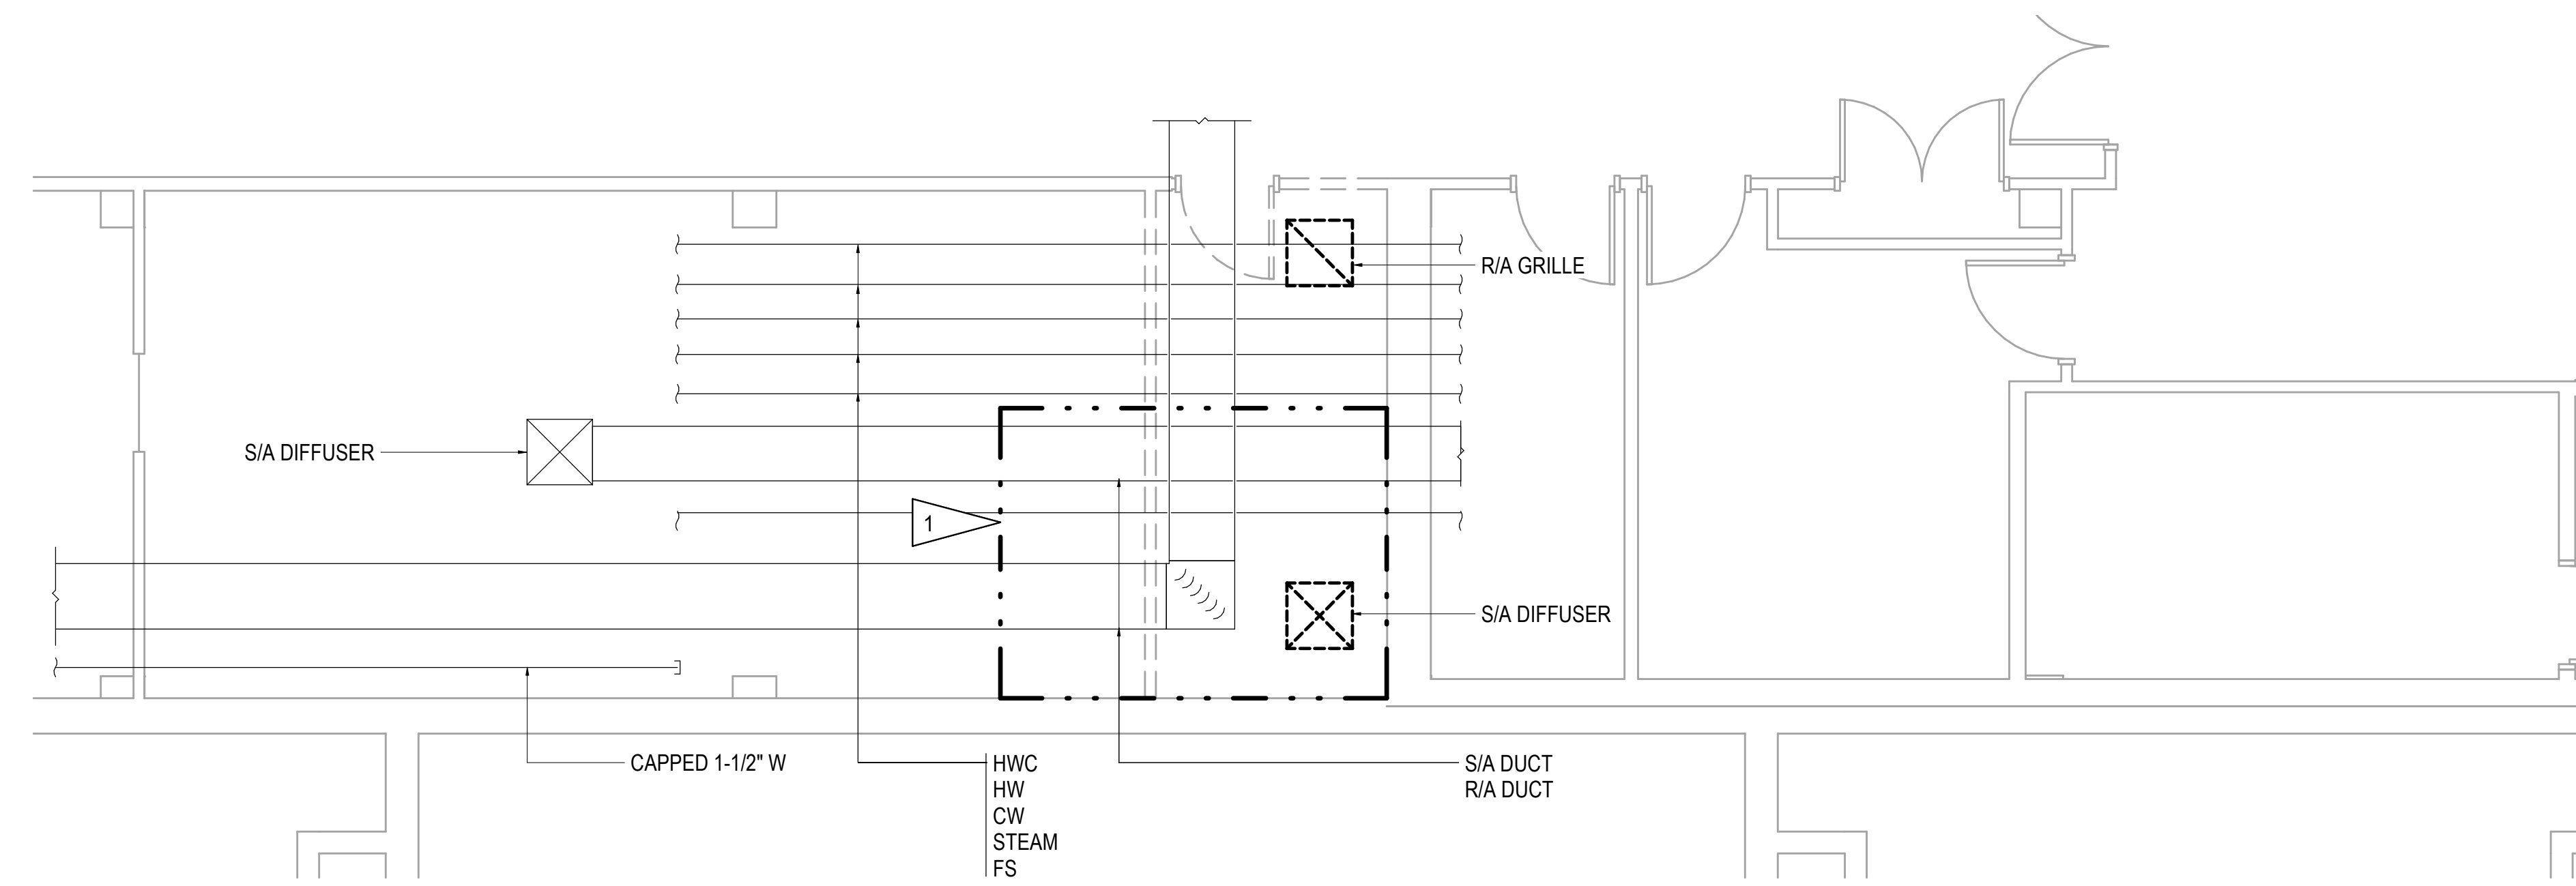


1 BUILDING 113 - ENLARGED BASEMENT DEMOLITION PLAN
1/4" = 1'-0"

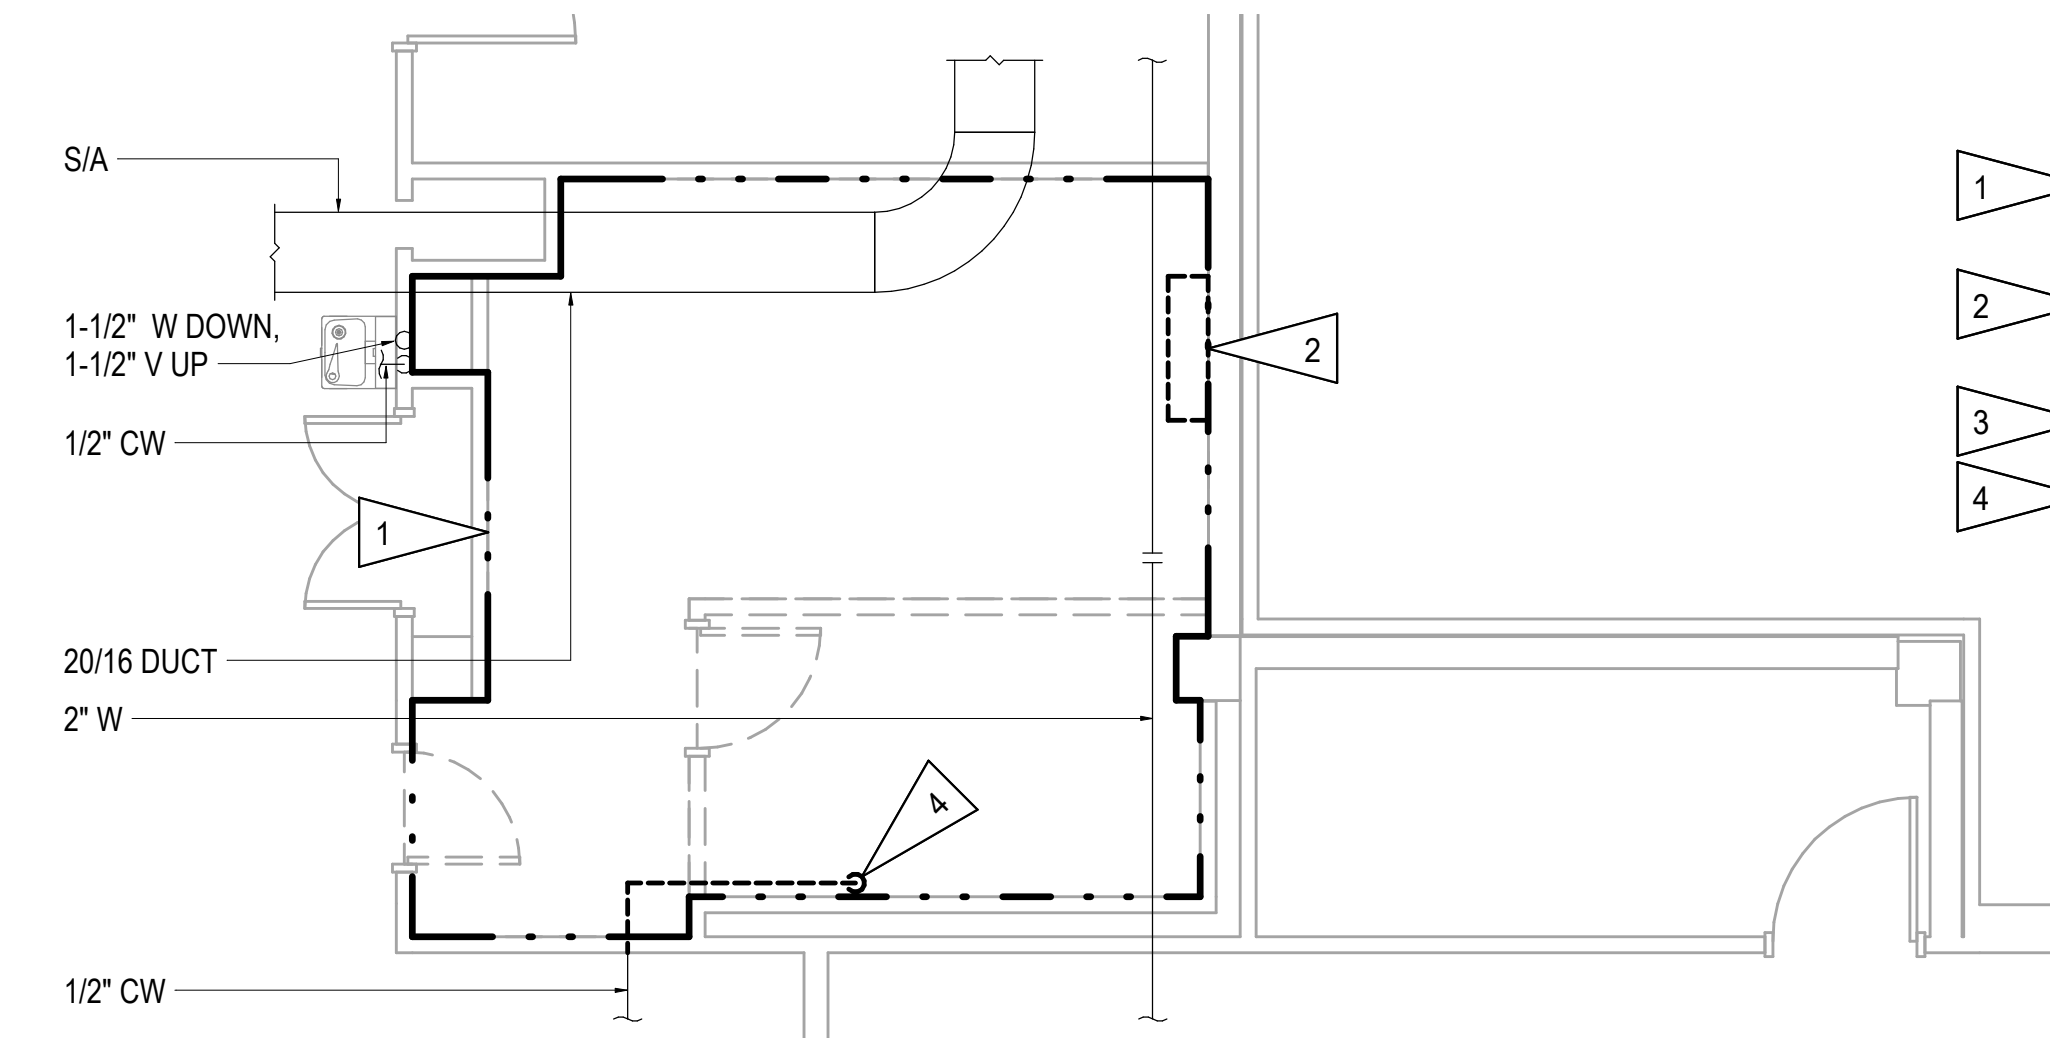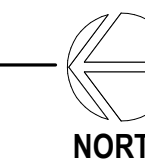

2 BUILDING 113 - ENLARGED FIRST FLOOR DEMOLITION PLAN - 169
1/4" = 1'-0"

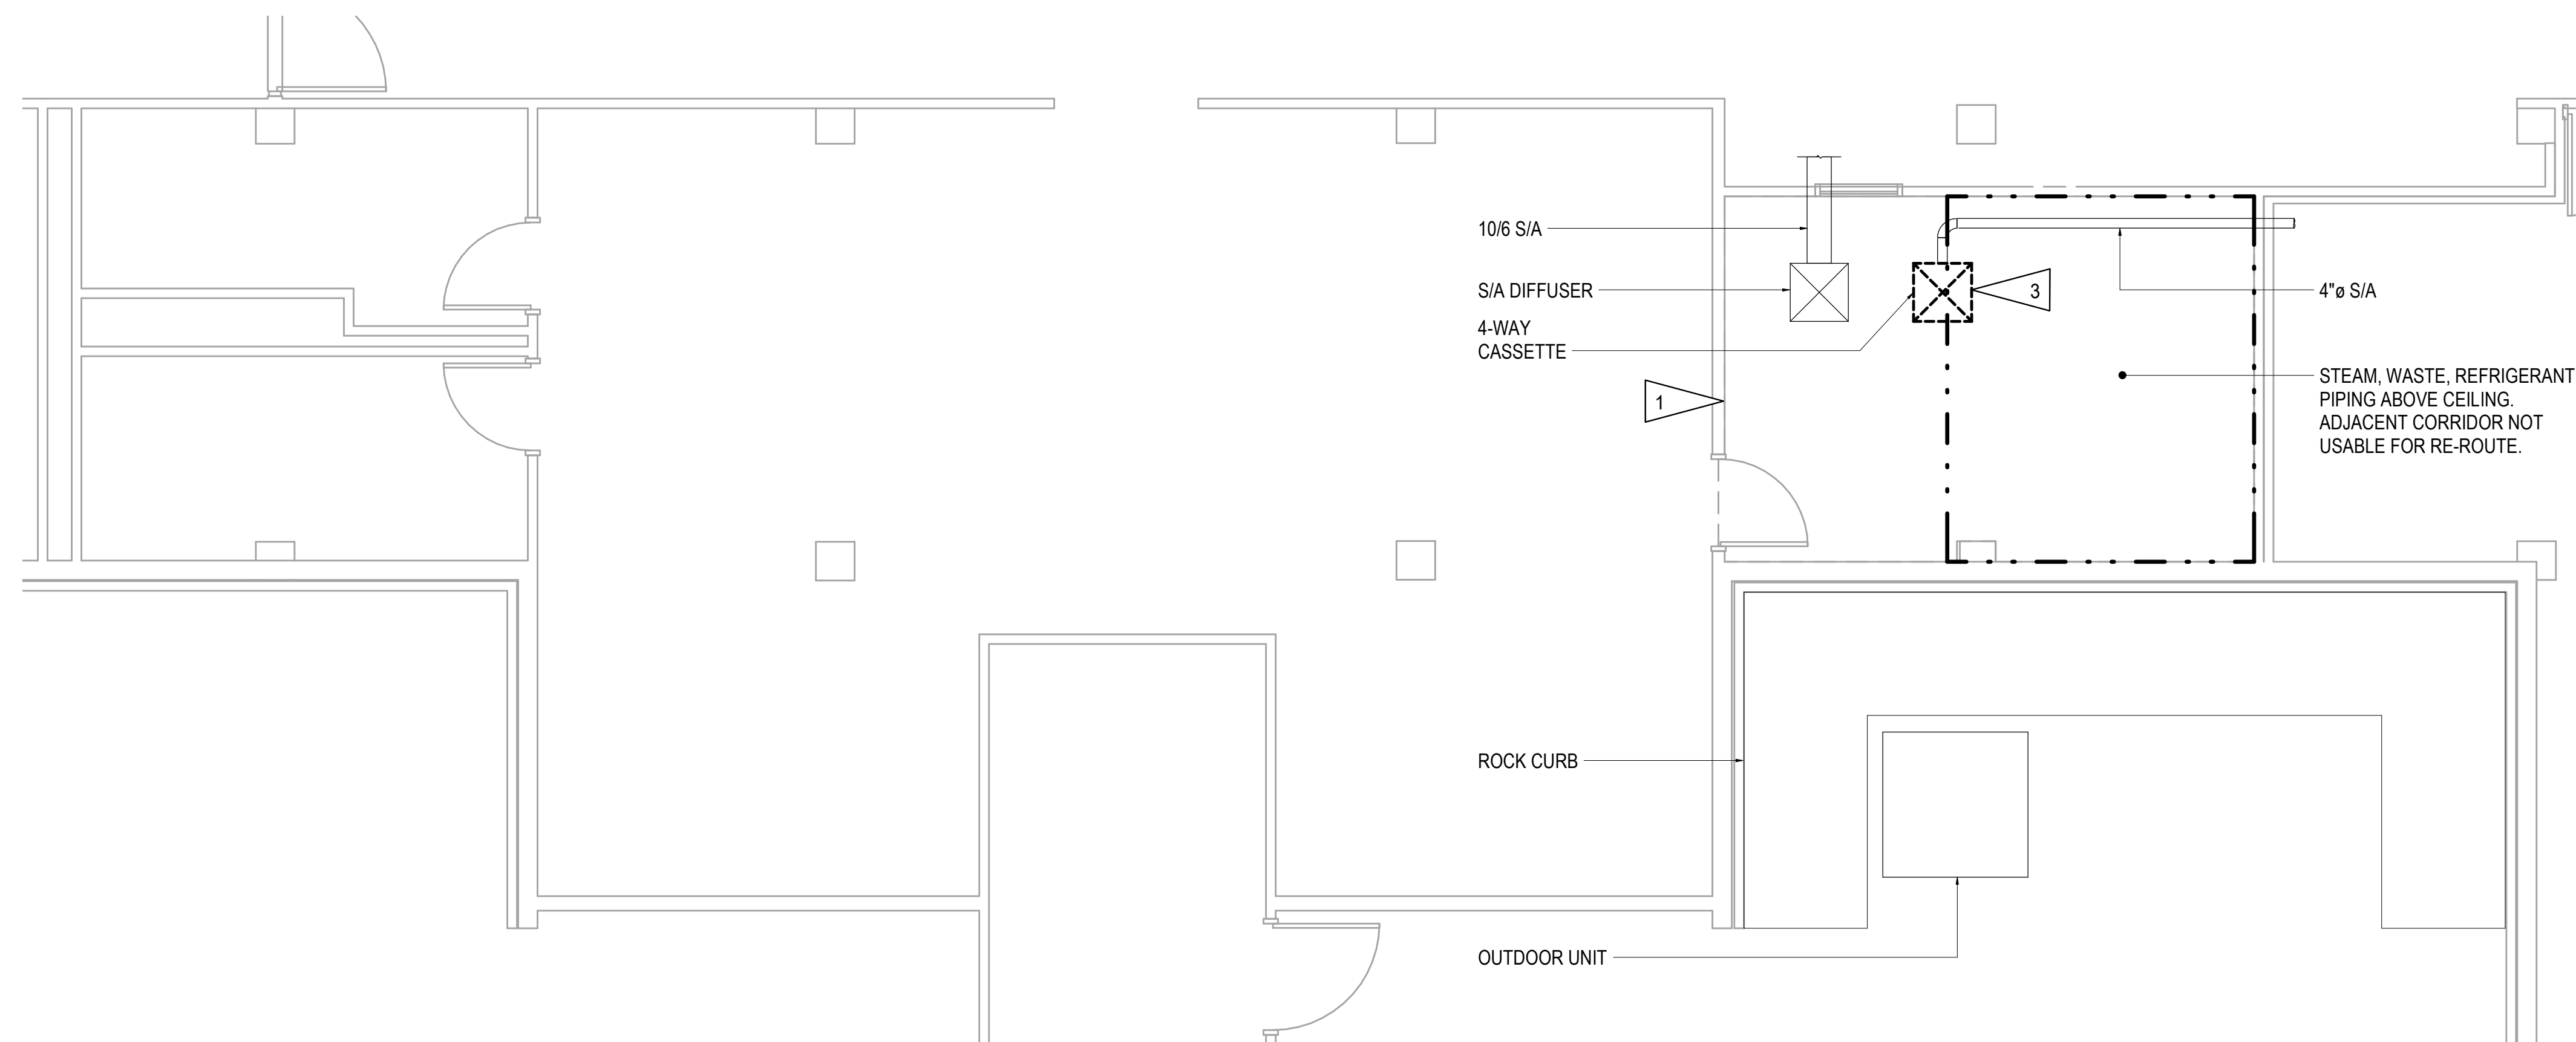

3 BUILDING 113 - ENLARGED FIRST FLOOR DEMOLITION PLAN - 192
1/4" = 1'-0"

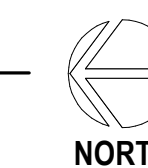

Revisions:	Date:

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OFFICE OF CONSTRUCTION AND FACILITIES MANAGEMENT

VA U.S. Department of Veterans Affairs

DRAWING TITLE
113 - ENLARGED DEMOLITION PLANS

APPROVED:

PHASE
100% CONSTRUCTION DOCUMENTS

FLS
FULLY SPRINKLERED

PROJECT TITLE
EHRM INFRASTRUCTURE UPGRADES

LOCATION
FORT MEADE, SOUTH DAKOTA

ISSUE DATE
4/15/2022

CHECKED BY
EMM/MRB

DRAWN BY
MEM/NSK

PROJECT NUMBER
568-21-701

BUILDING NUMBER


DRAWING NUMBER
113-MD-012

GENERAL NOTES:



- A. THE INFORMATION SHOWN ON THIS DRAWING IS TAKEN FROM AS-BUILT DRAWINGS AND A NON-DESTRUCTIVE WALK THROUGH OF THE FACILITY. THERE IS NO WARRANTY OR GUARANTEE AS TO THE ACCURACY OF THE INFORMATION SHOWN HERE-IN. THE CONTRACTOR SHALL FIELD VERIFY ALL ITEMS SCHEDULED FOR DEMOLITION PRIOR TO START OF WORK.
- B. THE OWNER SHALL HAVE FIRST RIGHT OF REFUSAL ON ALL SALVAGEABLE MATERIALS. THE CONTRACTOR SHALL DELIVER THE SALVAGED MATERIALS TO A LOCATION AS DIRECTED BY THE OWNER IN ACCORDANCE WITH THE CONTRACT DOCUMENTS.
- C. DASHED OR DOTTED BOLD LINES INDICATE ITEMS TO BE REMOVED. UN-BOLDED LINES INDICATE EXISTING ITEMS TO REMAIN.
- D. ALL HVAC/PLUMBING EQUIPMENT AND PIPING CONVEYING FLUIDS IN THE NEW TR AREA SHALL BE RE-ROUTED OUTSIDE OF THIS AREA IF POSSIBLE. IF RE-ROUTING IS NOT POSSIBLE, PROVIDE WELDED SEAMLESS STAINLESS STEEL DRIP PAN BELOW PIPING.

SHEET NOTES:


- 1 DEMOLISH ALL MCR MECHANICAL COOLING EQUIPMENT AND ASSOCIATED OUTDOOR UNITS. ALL ASSOCIATED PIPING AND ALL OTHER APPURTENANCES. PATCH EXTERIOR WALL PENETRATIONS TO MATCH SURROUNDING. COORDINATE DEMOLITION OF ALL UNITS WITH PHASING OF NEW MCR. NEW MCR SHALL BE FULLY OPERATIONAL AND CONTRACTOR SHALL RECEIVE OIT APPROVAL BEFORE PROCEEDING WITH DEMOLITION.
- 2 DEMOLISH DRY COOLERS SERVING EXISTING COOLING UNITS INSIDE SERVER ROOM. COORDINATE DEMOLITION OF ALL UNITS WITH PHASING OF NEW MCR. NEW MCR SHALL BE FULLY OPERATIONAL AND CONTRACTOR SHALL RECEIVE OIT APPROVAL BEFORE PROCEEDING WITH DEMOLITION.
- 3 DEMOLISH S/A DIFFUSER AND ASSOCIATED S/A DUCTWORK TO EXTENT SHOWN.

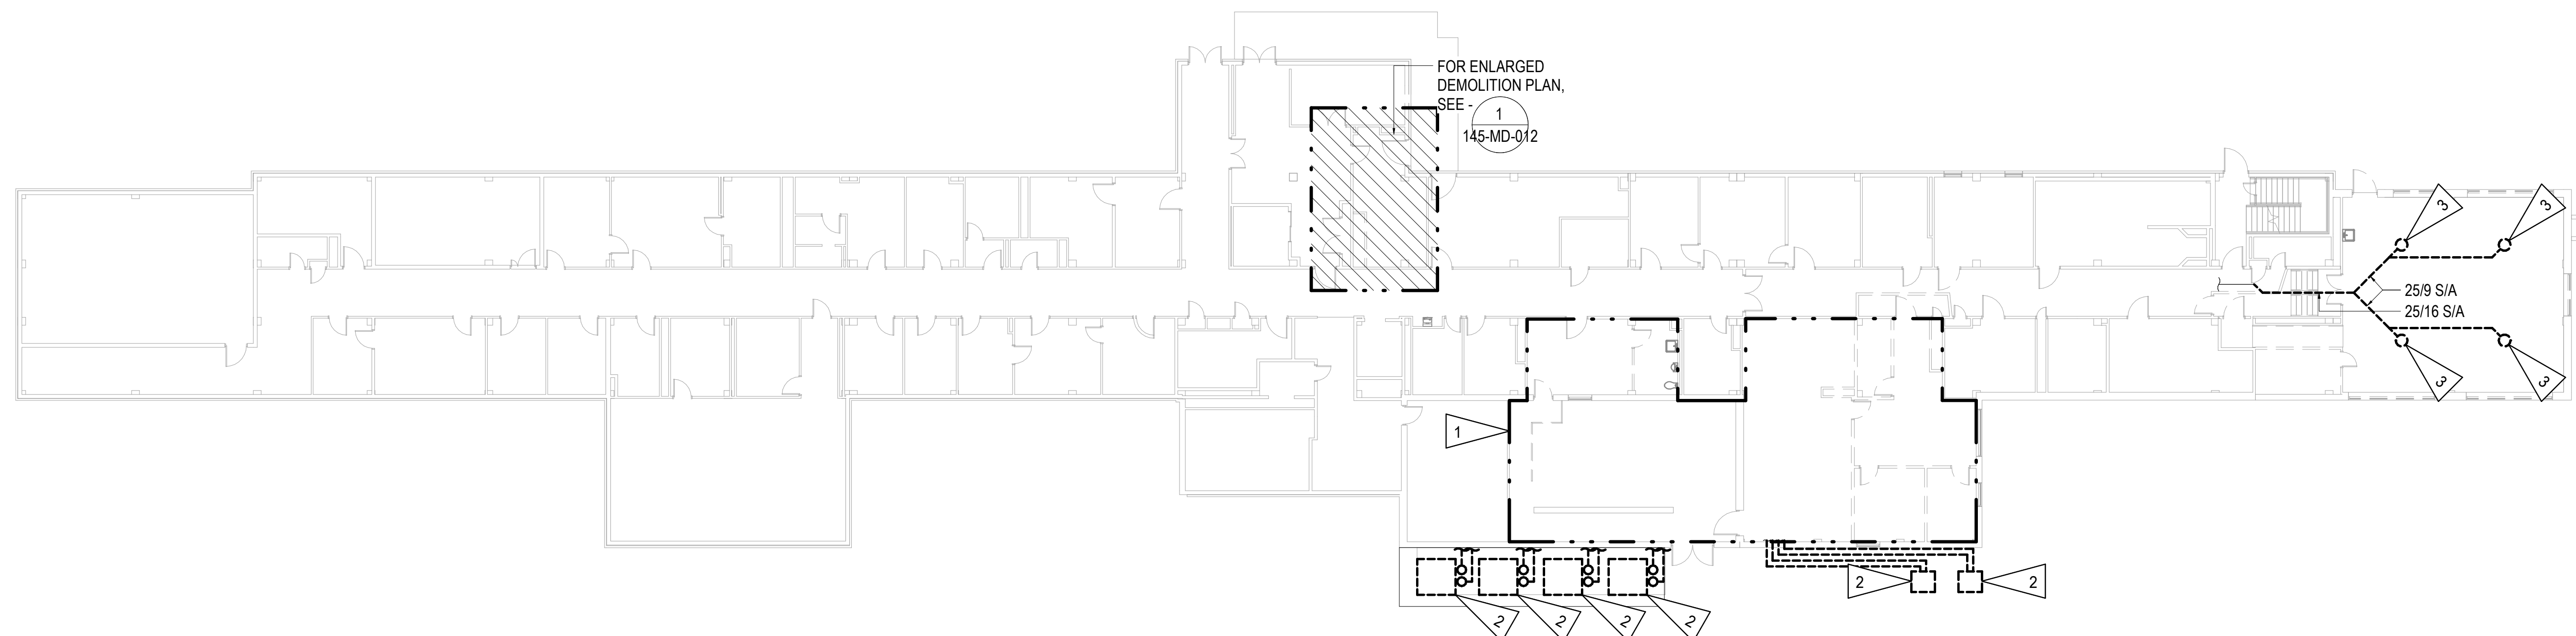

1 BUILDING 145 - FIRST FLOOR DEMOLITION PLAN - OVERALL
1/16" = 1'-0"

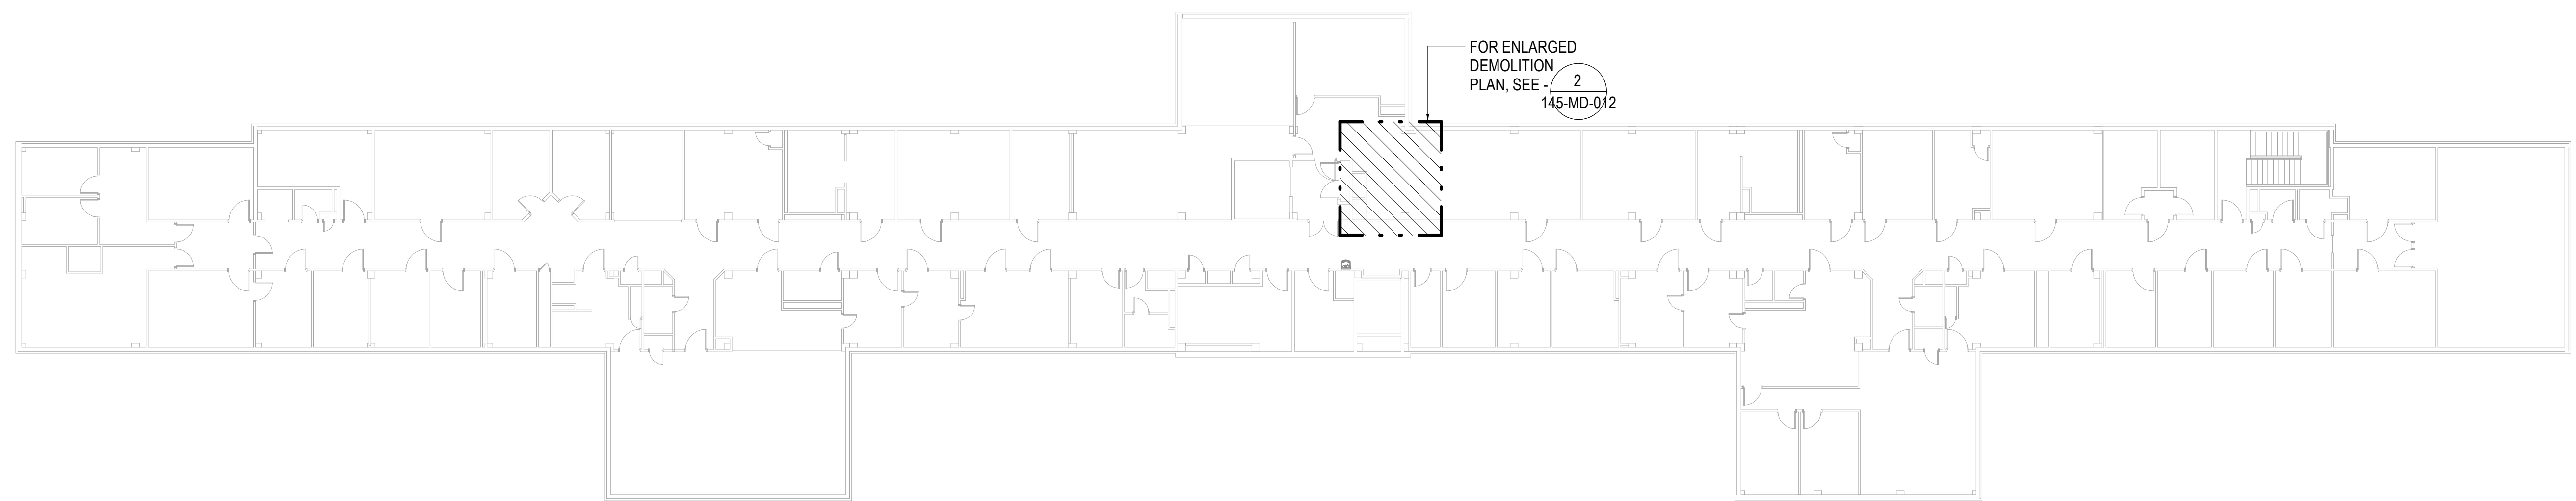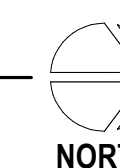

2 BUILDING 145 - SECOND FLOOR DEMOLITION PLAN - OVERALL
1/16" = 1'-0"

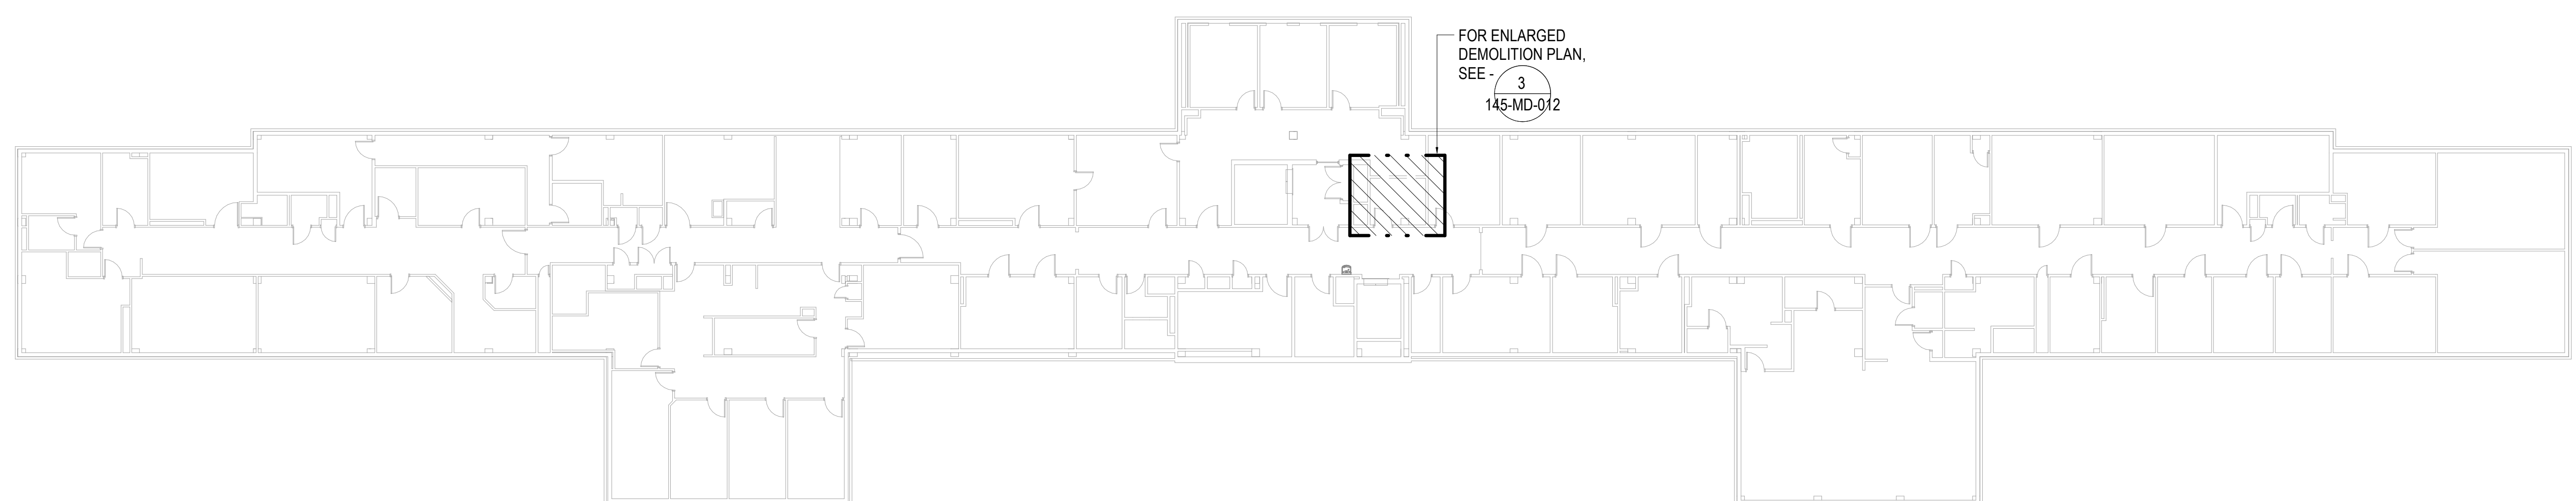

3 BUILDING 145 - THIRD FLOOR DEMOLITION PLAN - OVERALL
1/16" = 1'-0"



Revisions:	Date:

CONSULTANT
A/E:
GDM
1000 W STEUBEN ST. UNIT 3
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541.436.4723
ADAM GOODIN, P.E.

ARCHITECT/ENGINEER OF RECORD
MECHANICAL ENGINEER
RSA ENGINEERING, INC.
670 W. FIREWEED LN, SUITE 200
ANCHORAGE, ALASKA 99503
907.276.0521
M.R. BAUMGARTNER, P.E.

STAMP

OFFICE OF CONSTRUCTION AND FACILITIES MANAGEMENT
U.S. Department of Veterans Affairs

DRAWING TITLE
145 - MECHANICAL DEMOLITION - OVERALL

APPROVED:

PHASE
100% CONSTRUCTION DOCUMENTS

FLS
FULLY SPRINKLERED

PROJECT TITLE
EHRM INFRASTRUCTURE UPGRADES

LOCATION
FORT MEADE, SOUTH DAKOTA

ISSUE DATE 4/15/2022	CHECKED BY EMM/MRB	DRAWN BY MEM/NSK
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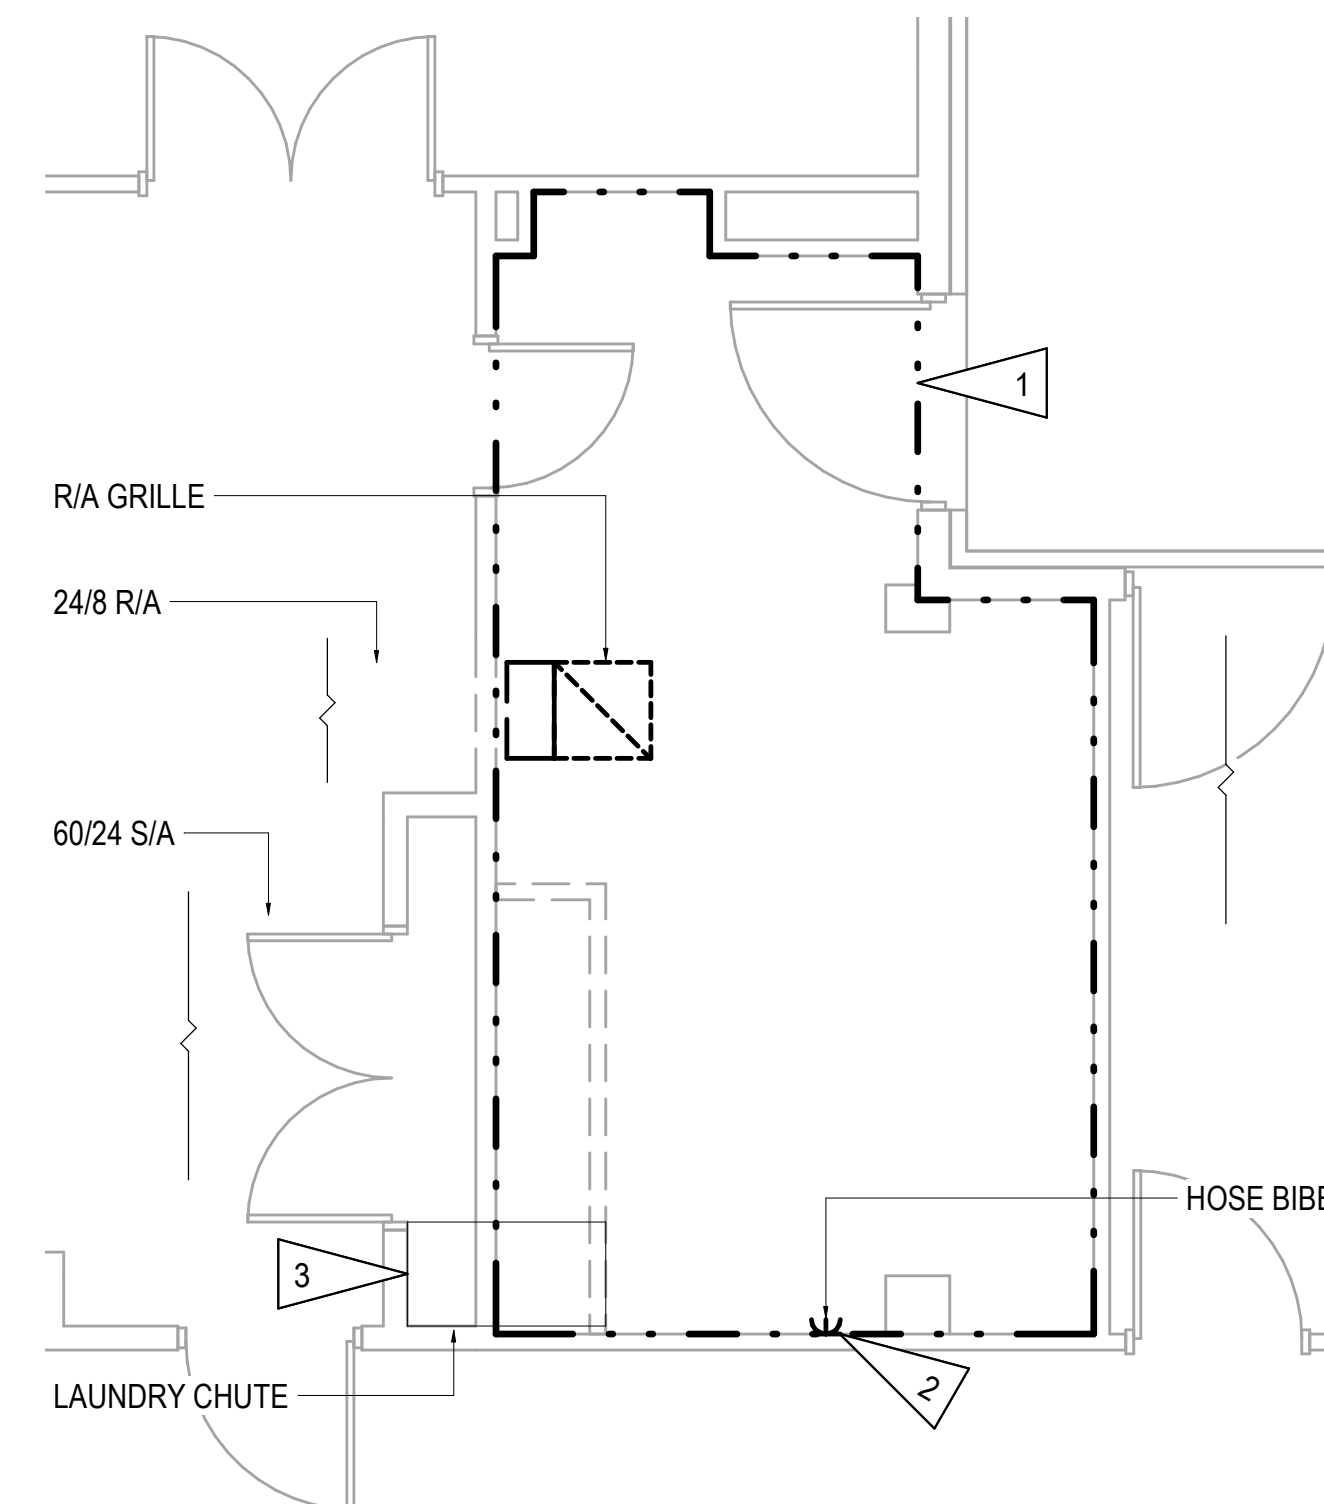
PROJECT NUMBER 568-21-701
BUILDING NUMBER BLDG 145
DRAWING NUMBER 145-MD-011

GENERAL NOTES:


- A. THE INFORMATION SHOWN ON THIS DRAWING IS TAKEN FROM AS-BUILT DRAWINGS AND A NON-DESTRUCTIVE WALK THROUGH OF THE FACILITY. THERE IS NO WARRANTY OR GUARANTEE AS TO THE ACCURACY OF THE INFORMATION SHOWN HERE-IN. THE CONTRACTOR SHALL FIELD VERIFY ALL ITEMS SCHEDULED FOR DEMOLITION PRIOR TO START OF WORK.
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- C. DASHED OR DOTTED BOLD LINES INDICATE ITEMS TO BE REMOVED. UN-BOLDED LINES INDICATE EXISTING ITEMS TO REMAIN.
- D. ALL HVAC/PLUMBING EQUIPMENT AND PIPING CONVEYING FLUIDS IN THE NEW TR AREA SHALL BE RE-ROUTED OUTSIDE OF THIS AREA IF POSSIBLE. IF RE-ROUTING IS NOT POSSIBLE, PROVIDE WELDED SEAMLESS STAINLESS STEEL DRIP PAN BELOW PIPING.

SHEET NOTES:


- 1 APPROXIMATE OUTLINE OF NEW TR AREA. SEE REMODEL SHEETS FOR ALL DISCIPLINES FOR ADDITIONAL INFORMATION.
- 2 DEMOLISH HOSE BIBB BACK INTO WALL, ISOLATE, AND CAP.
- 3 BLOCK OFF AND WALL OVER EXISTING LAUNDRY CHUTE.



1 BUILDING 145 - ENLARGED FIRST FLOOR DEMOLITION PLAN
1/4" = 1'-0"

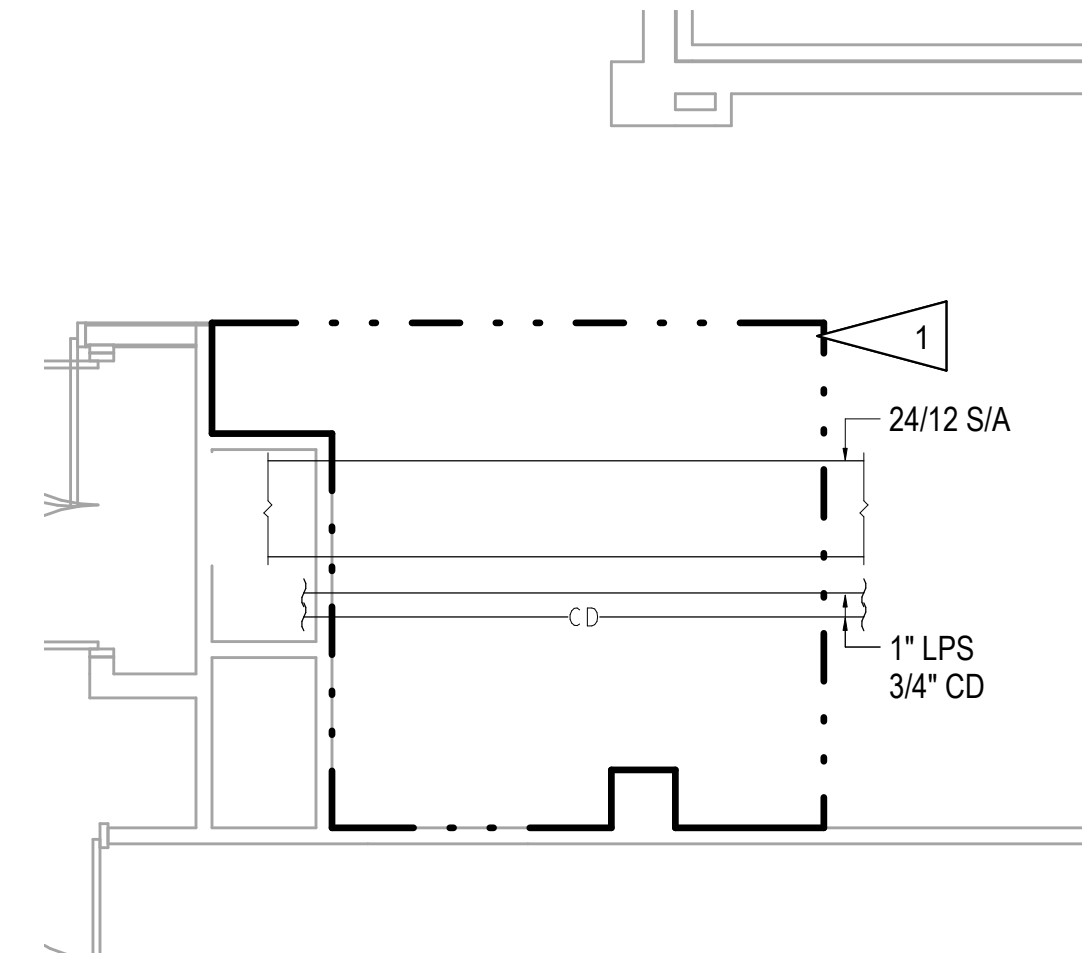

2 BUILDING 145 - ENLARGED SECOND FLOOR DEMOLITION PLAN
1/4" = 1'-0"

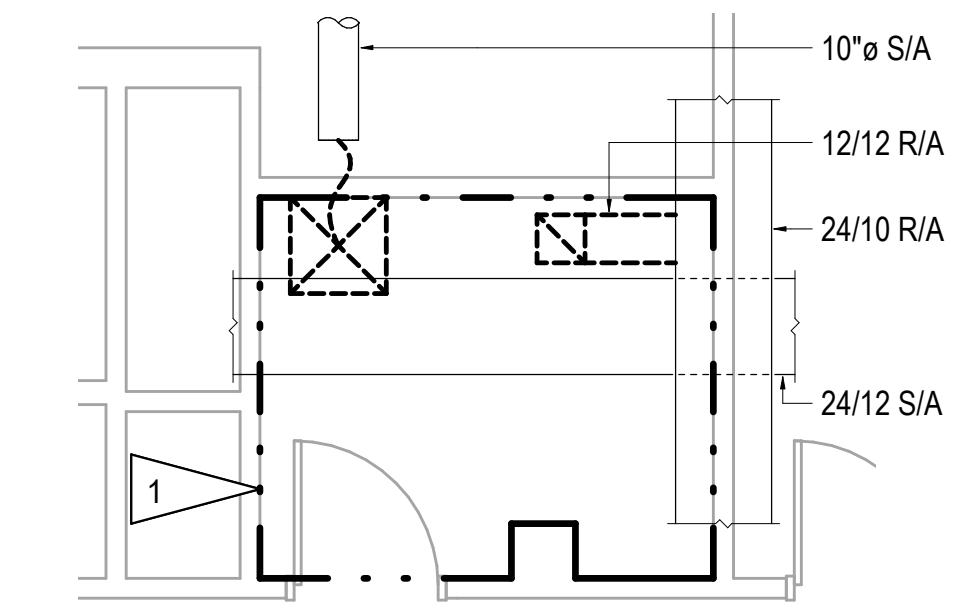

3 BUILDING 145 - ENLARGED THIRD FLOOR DEMOLITION PLAN
1/4" = 1'-0"

Revisions:	Date:

CONSULTANT
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 541.436.4723
 ADAM GOODIN, P.E.

ARCHITECT/ENGINEER OF RECORD
 MECHANICAL ENGINEER
 RSA ENGINEERING, INC.
 670 W. FIREWEED LN, SUITE 200
 ANCHORAGE, ALASKA 99503
 907.276.0521
 M.R. BAUMGARTNER, P.E.

STAMP

OFFICE OF CONSTRUCTION AND FACILITIES MANAGEMENT
 U.S. Department of Veterans Affairs

DRAWING TITLE
 145 - ENLARGED DEMOLITION PLANS

APPROVED:

PHASE
 100% CONSTRUCTION DOCUMENTS

FLS
 FULLY SPRINKLERED

PROJECT TITLE
 EHRM INFRASTRUCTURE UPGRADES

LOCATION
 FORT MEADE, SOUTH DAKOTA

ISSUE DATE
 4/15/2022

CHECKED BY
 EMM/MRB

DRAWN BY
 MEM/NSK

PROJECT NUMBER
 568-21-701

BUILDING NUMBER


DRAWING NUMBER
 145-MD-012

GENERAL NOTES:

- A. THE INFORMATION SHOWN ON THIS DRAWING IS TAKEN FROM AS-BUILT DRAWINGS AND A NON-DESTRUCTIVE WALK THROUGH OF THE FACILITY. THERE IS NO WARRANTY OR GUARANTEE AS TO THE ACCURACY OF THE INFORMATION SHOWN HERE-IN. THE CONTRACTOR SHALL FIELD VERIFY ALL ITEMS SCHEDULED FOR DEMOLITION PRIOR TO START OF WORK.
- B. THE OWNER SHALL HAVE FIRST RIGHT OF REFUSAL ON ALL SALVAGEABLE MATERIALS. THE CONTRACTOR SHALL DELIVER THE SALVAGED MATERIALS TO A LOCATION AS DIRECTED BY THE OWNER IN ACCORDANCE WITH THE CONTRACT DOCUMENTS.
- C. DASHED OR DOTTED BOLD LINES INDICATE ITEMS TO BE REMOVED. UN-BOLDED LINES INDICATE EXISTING ITEMS TO REMAIN.
- D. ALL HVAC/PLUMBING EQUIPMENT AND PIPING CONVEYING FLUIDS IN THE NEW TR AREA SHALL BE RE-ROUTED OUTSIDE OF THIS AREA IF POSSIBLE. IF RE-ROUTING IS NOT POSSIBLE, PROVIDE WELDED SEAMLESS STAINLESS STEEL DRIP PAN BELOW PIPING.

SHEET NOTES:

- 1 APPROXIMATE OUTLINE OF NEW TR AREA. SEE REMODEL SHEETS FOR ALL DISCIPLINES FOR ADDITIONAL INFORMATION.
- 2 DEMOLISH S/A DIFFUSER AND PATCH AND SEAL OPENING AIRTIGHT. CAP S/A DUCT AT BRANCH LINE ABOVE HARD LID.

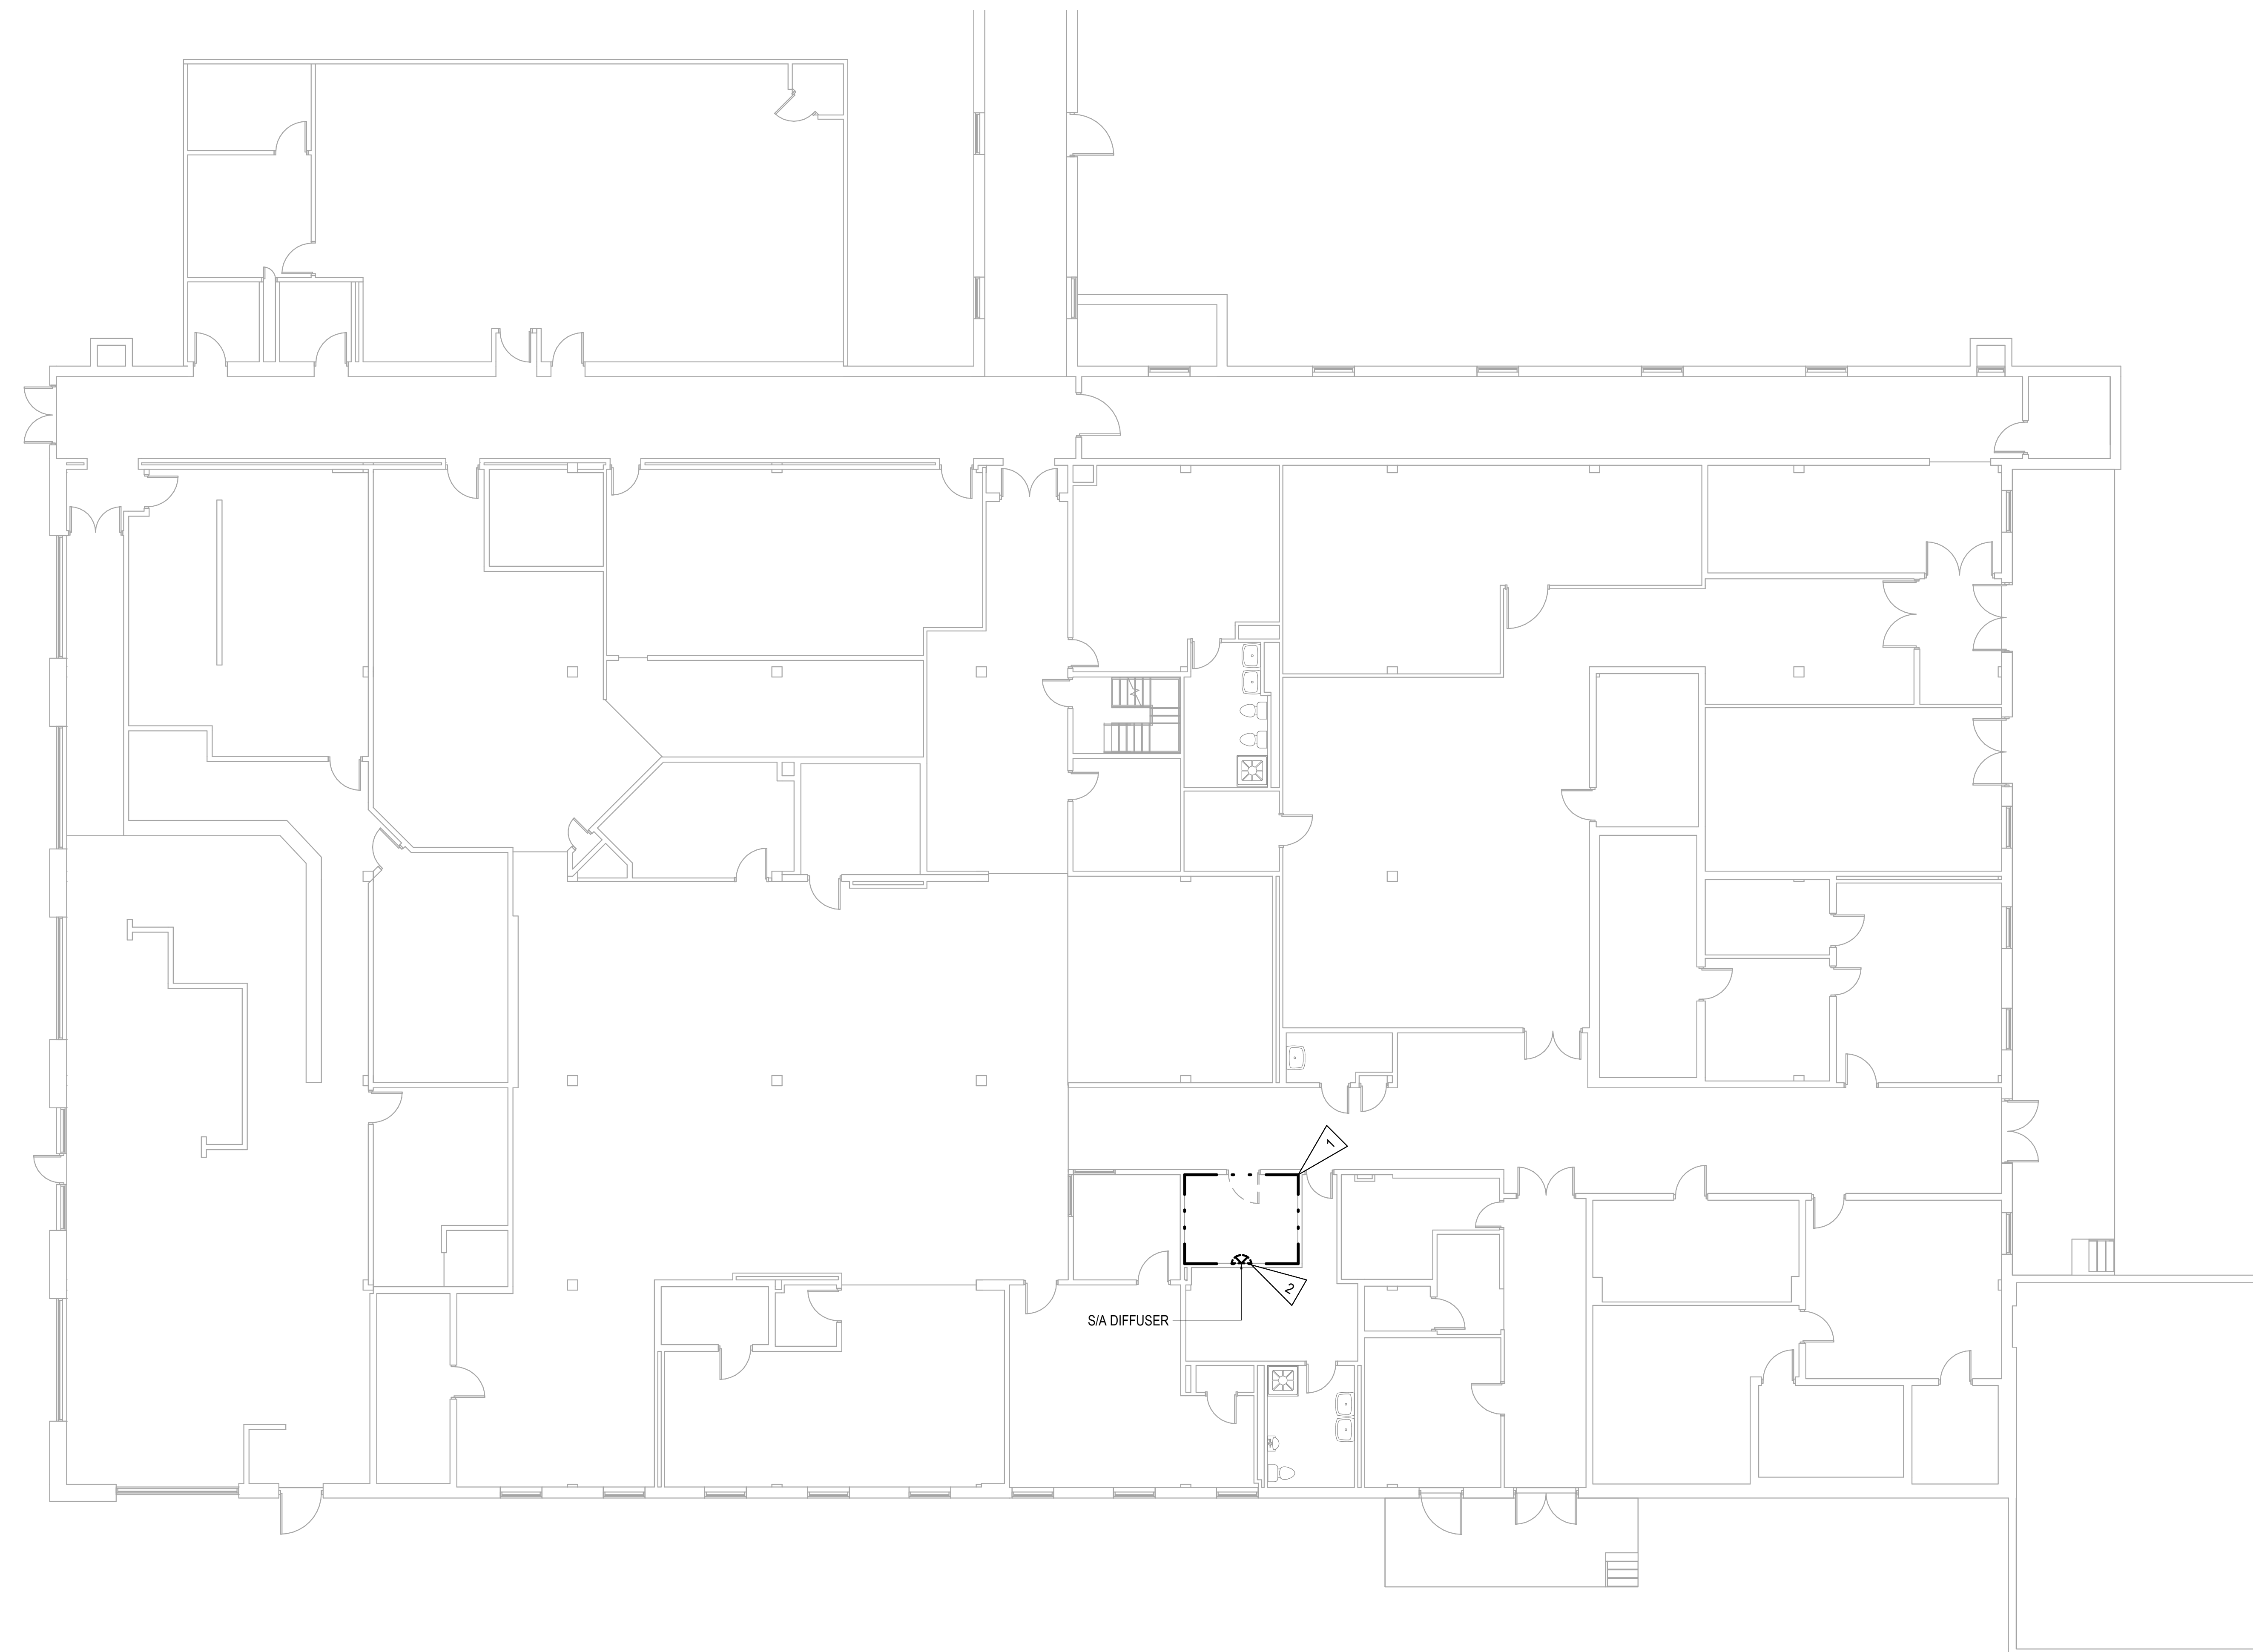


1 BUILDING 146 - FIRST FLOOR DEMOLITION PLAN - OVERALL
1/8" = 1'-0"




Revisions: Date:	CONSULTANT A/E: GDM 1000 W STEUBEN ST. UNIT 3 BINGEN, WA 98605 541.436.4723 ADAM GOODIN, P.E.	ARCHITECT/ENGINEER OF RECORD MECHANICAL ENGINEER RSA ENGINEERING, INC. 670 W. FIREWEED LN, SUITE 200 ANCHORAGE, ALASKA 99503 907.276.0521 M.R. BAUMGARTNER, P.E.	STAMP 	OFFICE OF CONSTRUCTION AND FACILITIES MANAGEMENT U.S. Department of Veterans Affairs	DRAWING TITLE 146 - MECHANICAL DEMOLITION - FIRST FLOOR - OVERALL APPROVED:	PHASE 100% CONSTRUCTION DOCUMENTS FLS FULLY SPRINKLERED	PROJECT TITLE EHRM INFRASTRUCTURE UPGRADES LOCATION FORT MEADE, SOUTH DAKOTA ISSUE DATE 4/15/2022	PROJECT NUMBER 568-21-701 BUILDING NUMBER BLDG 146 DRAWING NUMBER 146-MD-011	CHECKED BY EMM/MRB DRAWN BY MEM/NSK		
	GDM ARCHITECTS • ENGINEERS		RSA Mechanical and Electrical Consulting Engineers <small>1011 West Ethelbert Lane, Suite 200 Anchorage, AK 99503 (907) 276-0521 Corporate No.: AECC542</small>	VA U.S. Department of Veterans Affairs	DRAWING TITLE 146 - MECHANICAL DEMOLITION - FIRST FLOOR - OVERALL	PHASE 100% CONSTRUCTION DOCUMENTS	PROJECT TITLE EHRM INFRASTRUCTURE UPGRADES	PROJECT NUMBER 568-21-701	BUILDING NUMBER BLDG 146	DRAWING NUMBER 146-MD-011	
			MECHANICAL ENGINEER RSA ENGINEERING, INC. 670 W. FIREWEED LN, SUITE 200 ANCHORAGE, ALASKA 99503 907.276.0521 M.R. BAUMGARTNER, P.E.	STATE OF ALASKA M.R. BAUMGARTNER MECHANICAL ENGINEER LICENSE NO. 4916	OFFICE OF CONSTRUCTION AND FACILITIES MANAGEMENT U.S. Department of Veterans Affairs	DRAWING TITLE 146 - MECHANICAL DEMOLITION - FIRST FLOOR - OVERALL	PHASE 100% CONSTRUCTION DOCUMENTS	PROJECT TITLE EHRM INFRASTRUCTURE UPGRADES	PROJECT NUMBER 568-21-701	BUILDING NUMBER BLDG 146	DRAWING NUMBER 146-MD-011
			MECHANICAL ENGINEER RSA ENGINEERING, INC. 670 W. FIREWEED LN, SUITE 200 ANCHORAGE, ALASKA 99503 907.276.0521 M.R. BAUMGARTNER, P.E.	STATE OF ALASKA M.R. BAUMGARTNER MECHANICAL ENGINEER LICENSE NO. 4916	OFFICE OF CONSTRUCTION AND FACILITIES MANAGEMENT U.S. Department of Veterans Affairs	DRAWING TITLE 146 - MECHANICAL DEMOLITION - FIRST FLOOR - OVERALL	PHASE 100% CONSTRUCTION DOCUMENTS	PROJECT TITLE EHRM INFRASTRUCTURE UPGRADES	PROJECT NUMBER 568-21-701	BUILDING NUMBER BLDG 146	DRAWING NUMBER 146-MD-011

GENERAL NOTES:

- A. THE INFORMATION SHOWN ON THIS DRAWING IS TAKEN FROM AS-BUILT DRAWINGS AND A NON-DESTRUCTIVE WALK THROUGH OF THE FACILITY. THERE IS NO WARRANTY OR GUARANTEE AS TO THE ACCURACY OF THE INFORMATION SHOWN HERE-IN. THE CONTRACTOR SHALL FIELD VERIFY ALL ITEMS SCHEDULED FOR DEMOLITION PRIOR TO START OF WORK.
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- D. ALL HVAC/PLUMBING EQUIPMENT AND PIPING CONVEYING FLUIDS IN THE NEW TR AREA SHALL BE RE-ROUTED OUTSIDE OF THIS AREA IF POSSIBLE. IF RE-ROUTING IS NOT POSSIBLE, PROVIDE WELDED SEAMLESS STAINLESS STEEL DRIP PAN BELOW PIPING.

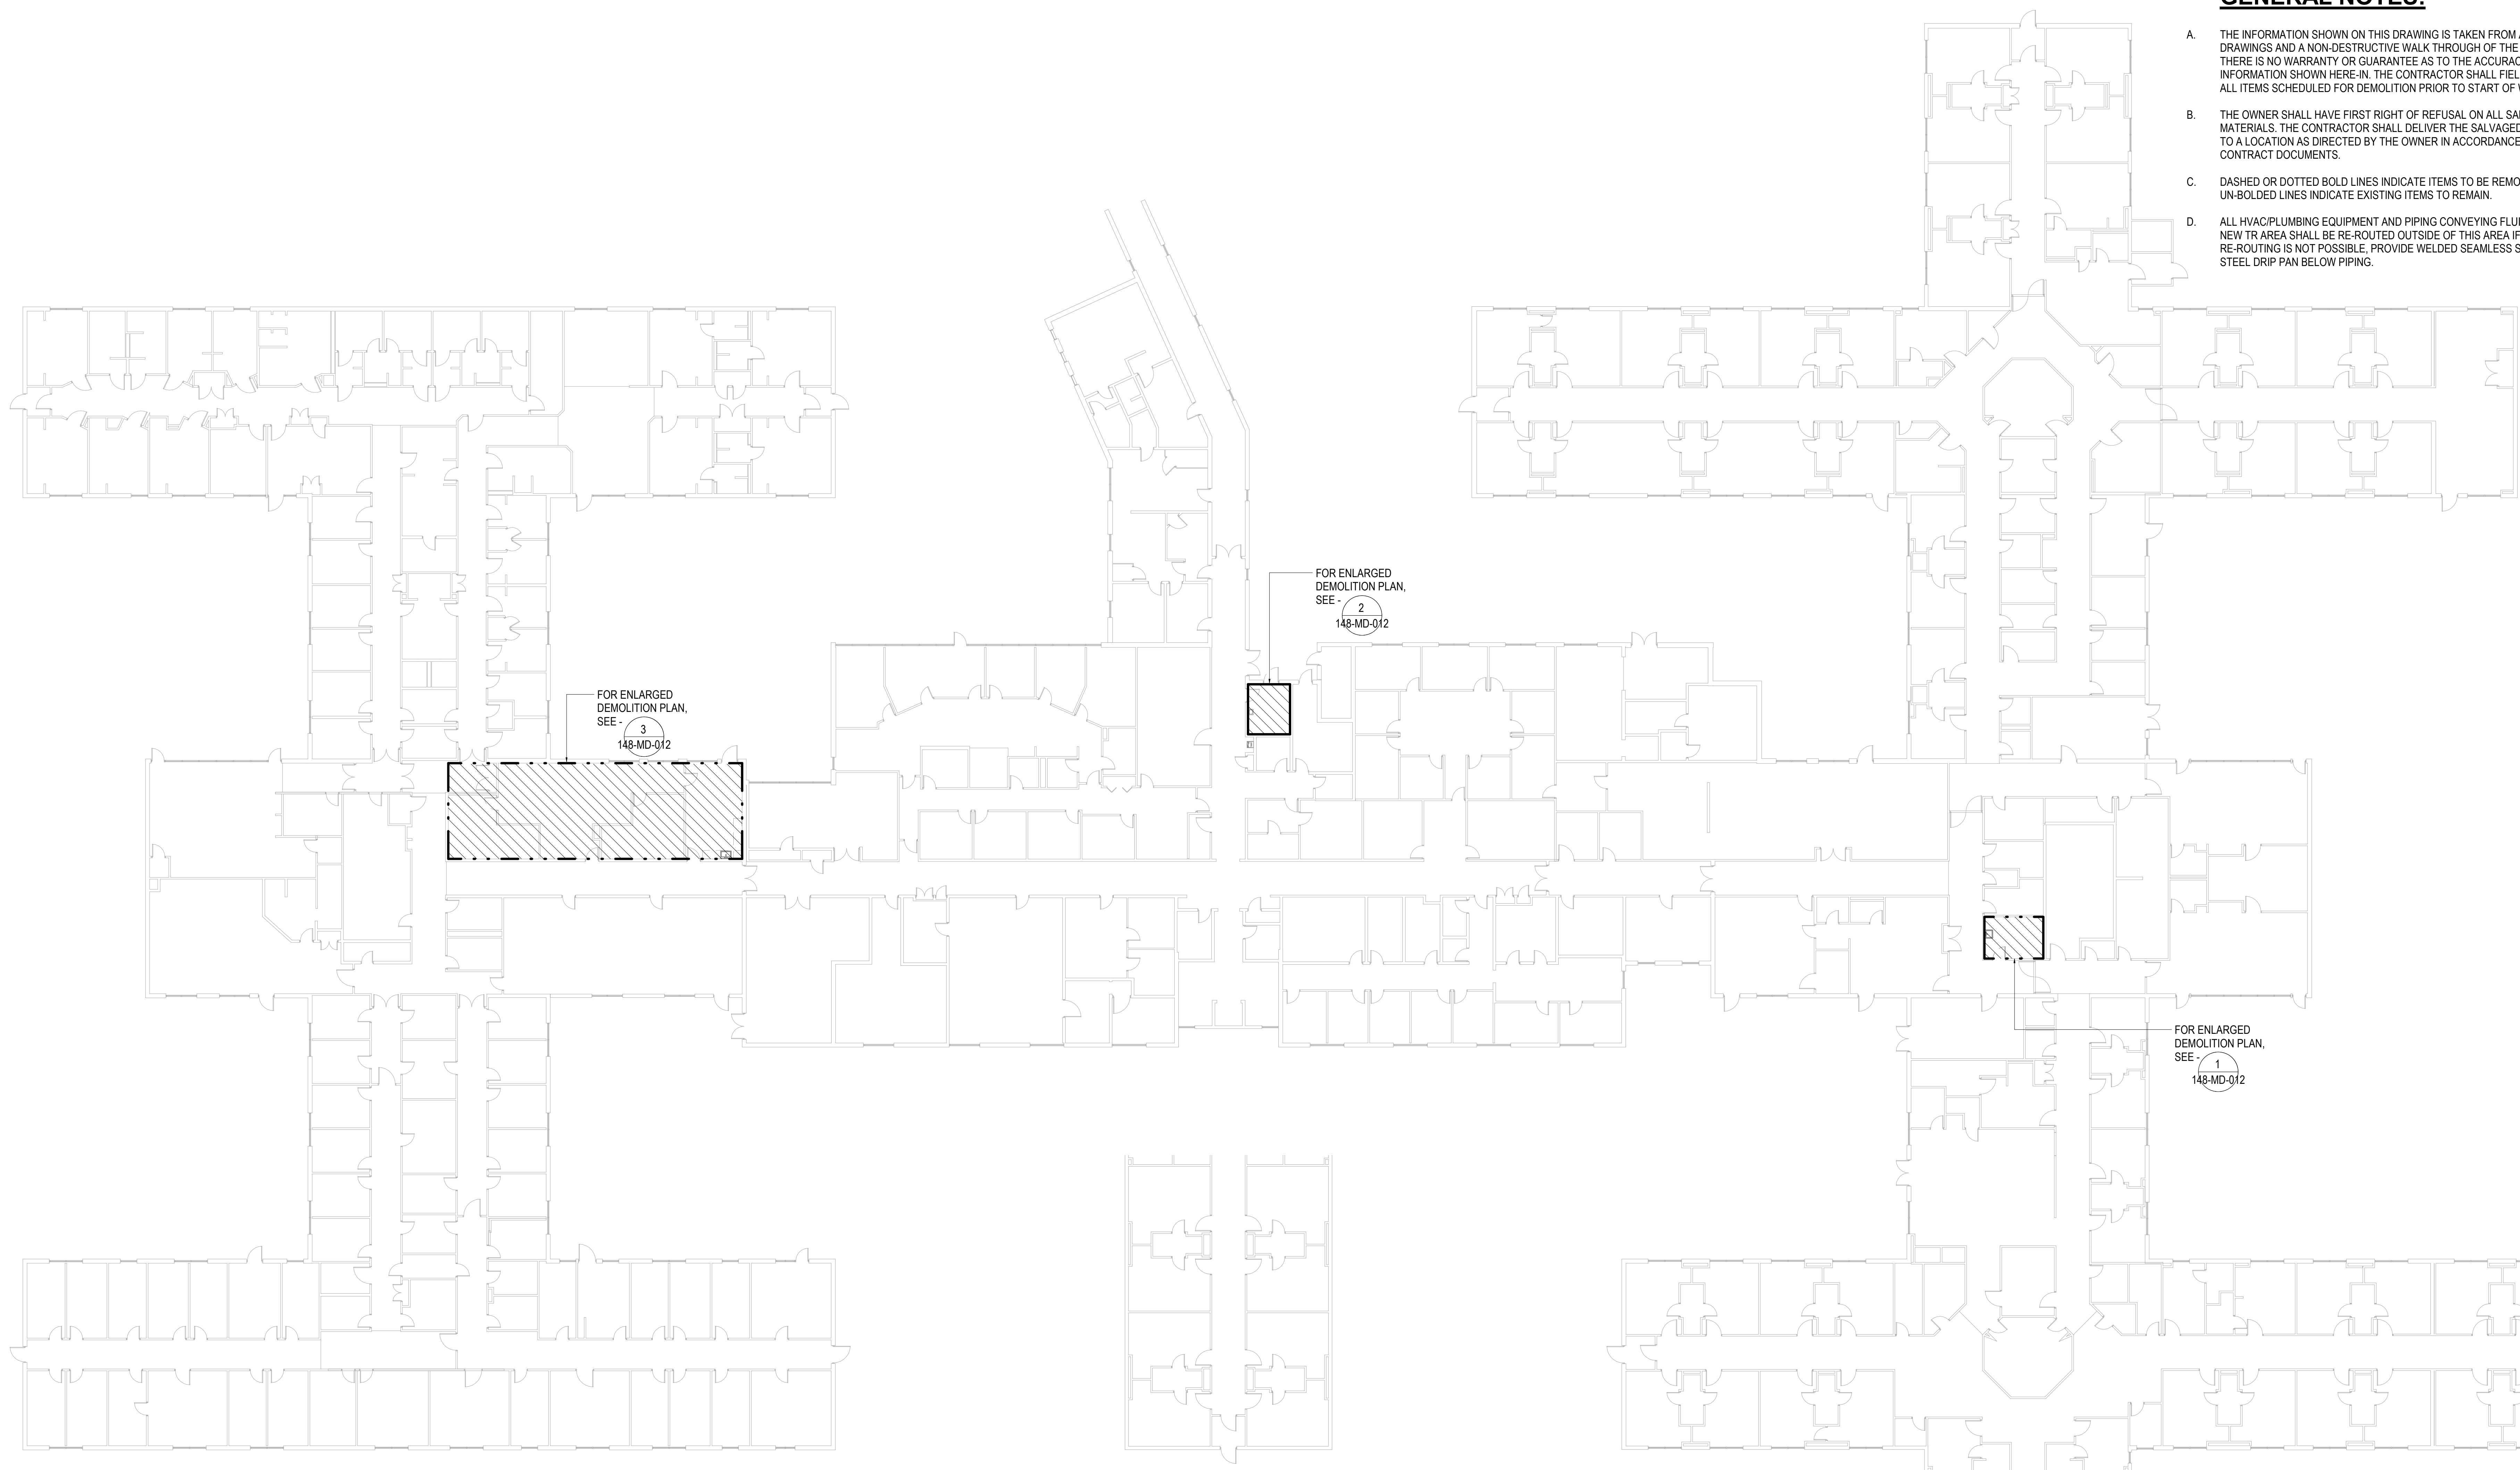

1 BUILDING 148 - FIRST FLOOR DEMOLITION PLAN - OVERALL
 NOT TO SCALE

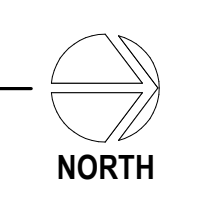


	CONSULTANT	ARCHITECT/ENGINEER OF RECORD	STAMP	OFFICE OF CONSTRUCTION AND FACILITIES MANAGEMENT	DRAWING TITLE 148 - MECHANICAL DEMOLITION - FIRST FLOOR - OVERALL	PHASE 100% CONSTRUCTION DOCUMENTS	PROJECT TITLE EHRM INFRASTRUCTURE UPGRADES	PROJECT NUMBER 568-21-701
Revisions:	A/E: GDM 1000 W STEUBEN ST. UNIT 3 BINGEN, WA 98605 541.436.4723 ADAM GOODIN, P.E.	MECHANICAL ENGINEER RSA ENGINEERING, INC. 670 W. FIREWEED LN, SUITE 200 ANCHORAGE, ALASKA 99503 907.276.0521 M.R. BAUMGARTNER, P.E.		U.S. Department of Veterans Affairs	APPROVED:	FLS FULLY SPRINKLERED	LOCATION FORT MEADE, SOUTH DAKOTA	BUILDING NUMBER BLDG 148
Date:							ISSUE DATE 4/15/2022	DRAWING NUMBER 148-MD-011
							CHECKED BY EMM/MRB	DRAWN BY MEM/NSK

GENERAL NOTES:


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SHEET NOTES:


- 1 APPROXIMATE OUTLINE OF NEW TR AREA. SEE REMODEL SHEETS FOR ALL DISCIPLINES FOR ADDITIONAL INFORMATION.
- 2 SALVAGE VAV BOX AND HEATING WATER PIPING VALVE TRAIN FOR RELOCATION. DEMOLISH LOW PRESSURE DUCTWORK, MEDIUM PRESSURE DUCTWORK, AND S/A DIFFUSER AS INDICATED. CAP MEDIUM PRESSURE DUCTWORK BRANCH AT MAIN TRUNK.
- 3 DEMOLISH AC UNIT, ASSOCIATED ROOF MOUNTED CONDENSING UNIT, REFRIGERANT PIPING, AND CONDENSATE PIPING AS INDICATED.
- 4 SALVAGE FAN COIL UNIT FOR RELOCATION. DEMOLISH S/A DUCTWORK, DIFFUSERS, CHILLED WATER PIPING, HEATING WATER PIPING, AND CONDENSATE PIPING AS INDICATED.
- 5 DEMOLISH DOMESTIC WATER, WASTE, AND VENT PIPING TO SINK AS NECESSARY TO ACCOMMODATE REMODEL WORK. SALVAGE SINK FOR RE-USE IN REMODEL.
- 6 DEMOLISH CONNECTED RETURN AIR DUCT BACK TO MAIN AND CAP. RETURN AIR GRILLE TO REMAIN

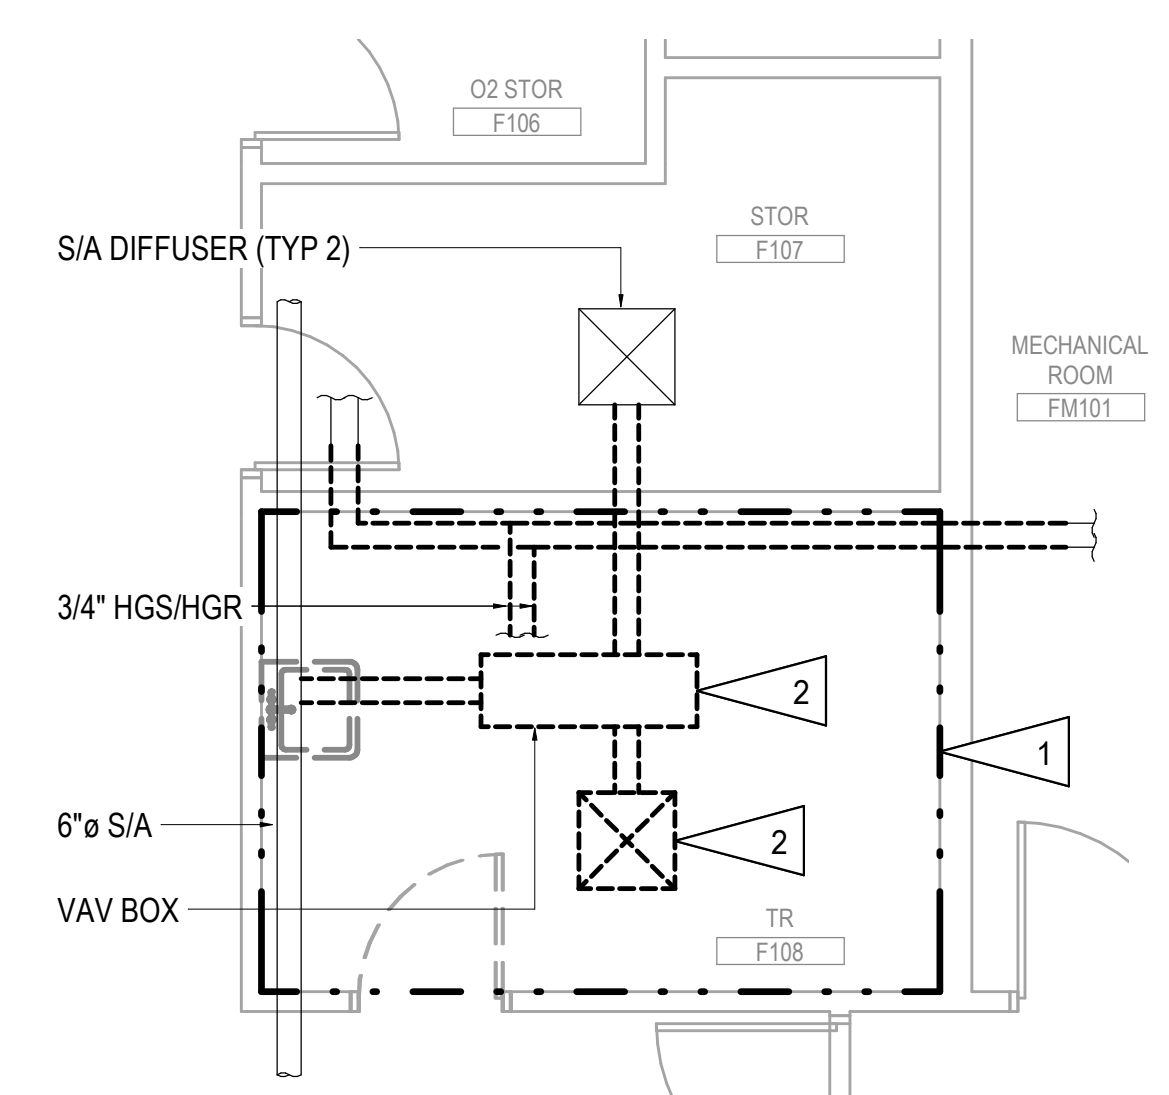

1 BUILDING 148 - ENLARGED FIRST FLOOR DEMOLITION PLAN - 108
1/4" = 1'-0" NORTH

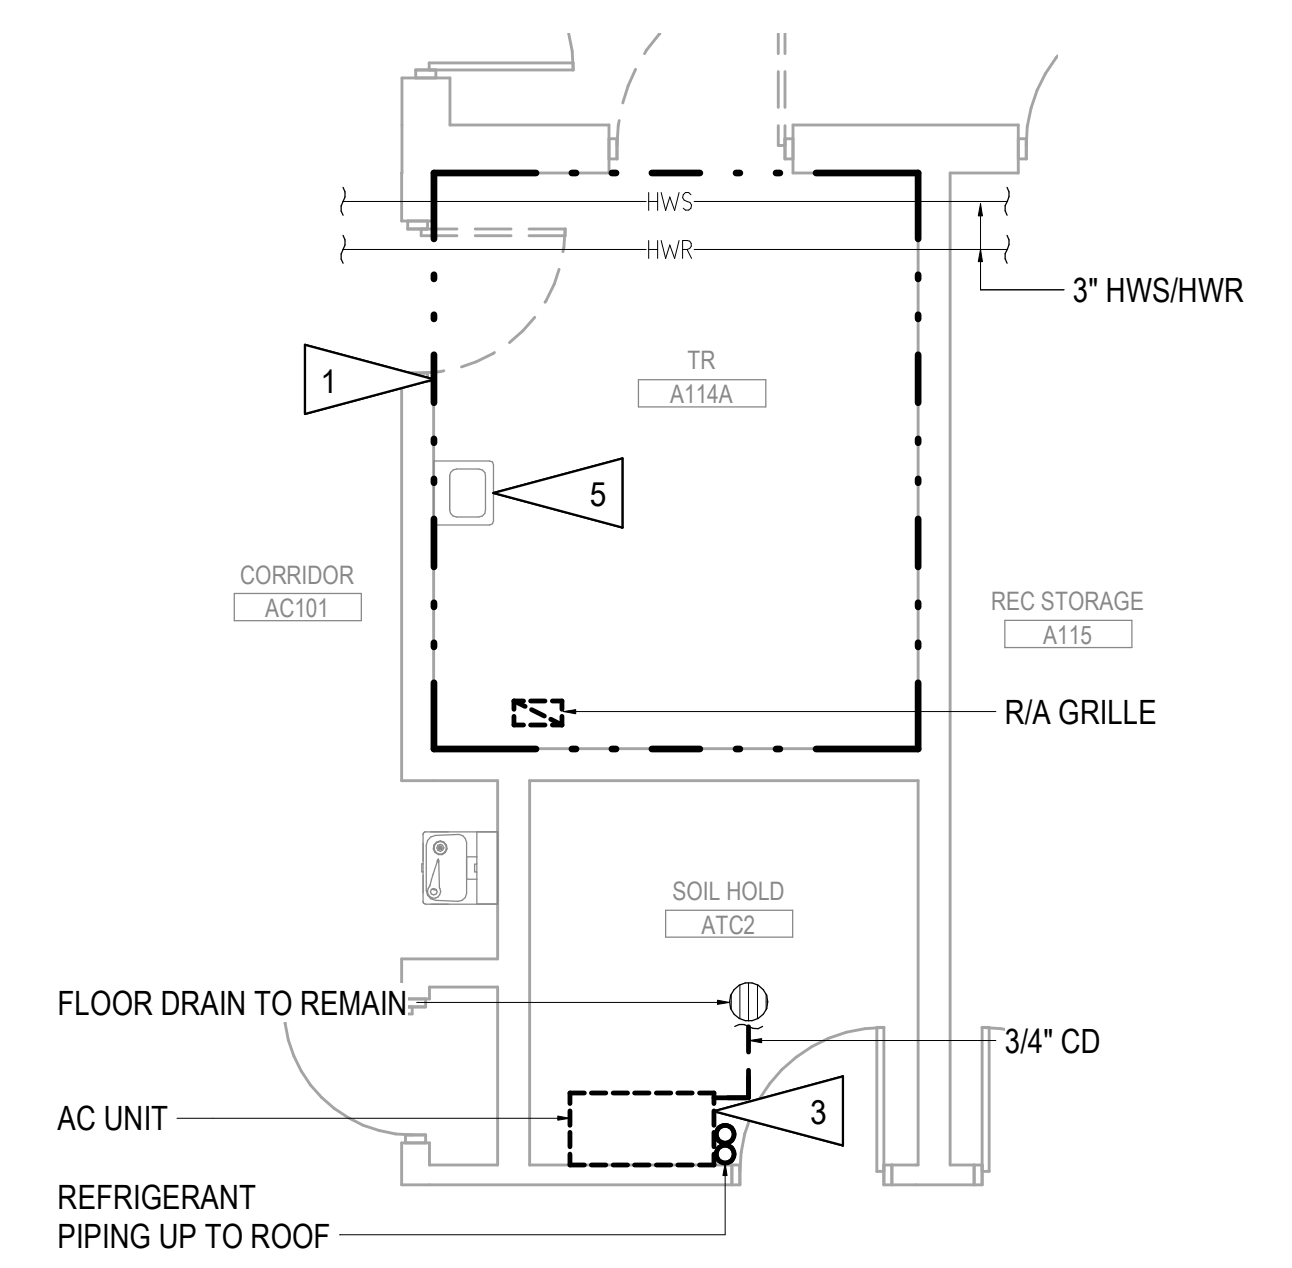

2 BUILDING 148 - ELARGED FIRST FLOOR DEMOLITION PLAN - 114
1/4" = 1'-0" NORTH

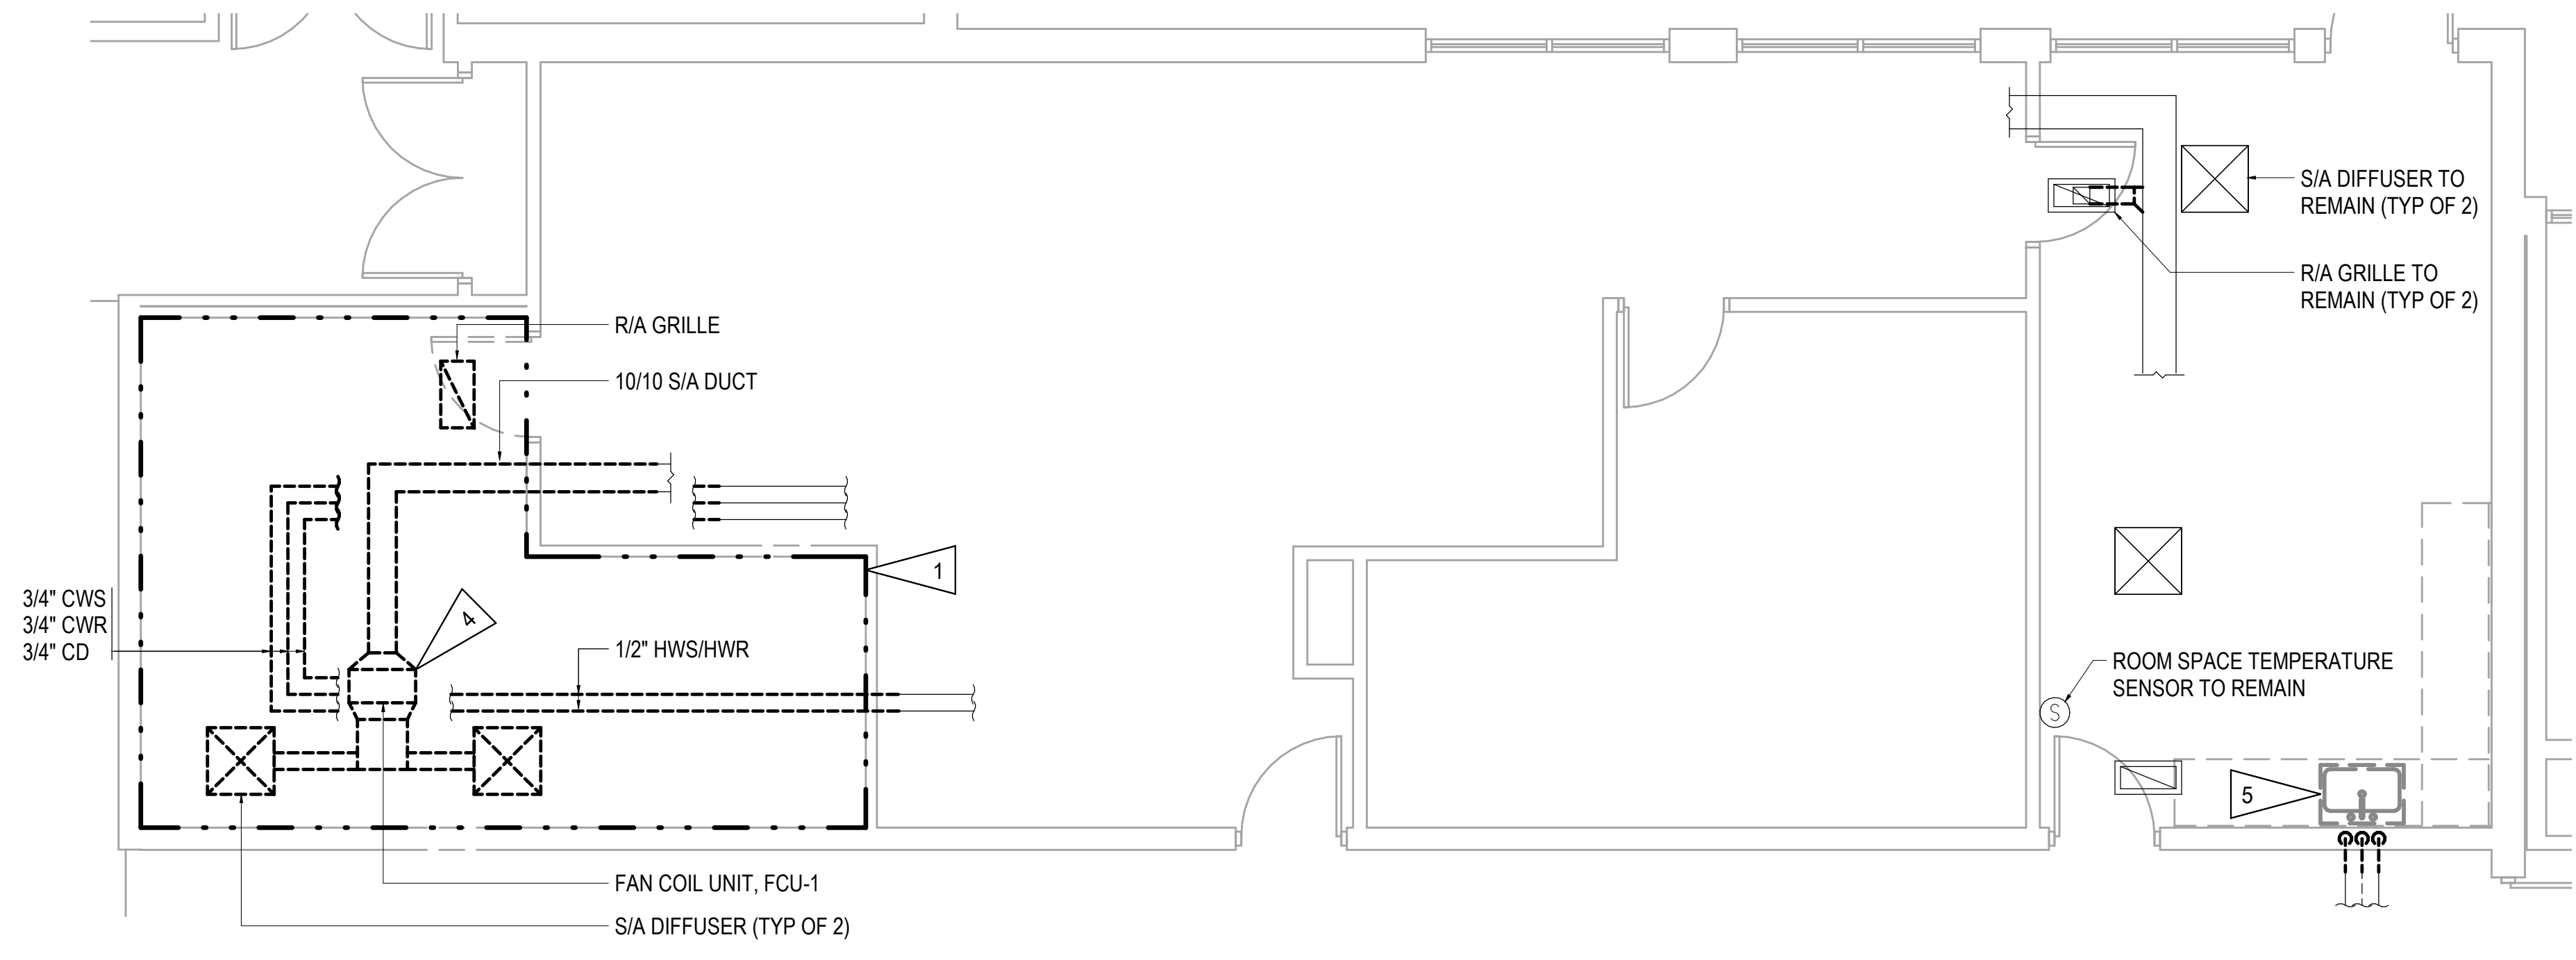

3 BUILDING 148 - ENLARGED FIRST FLOOR DEMOLITION PLAN - 106
1/4" = 1'-0" NORTH

Revisions:	Date:

CONSULTANT
A/E:
GDM
1000 W STEUBEN ST. UNIT 3
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ADAM GOODIN, P.E.

ARCHITECT/ENGINEER OF RECORD
MECHANICAL ENGINEER
RSA ENGINEERING, INC.
670 W. FIREWEED LN, SUITE 200
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907.276.0521
M.R. BAUMGARTNER, P.E.

STAMP
STATE OF ALASKA
W.R. BAUMGARTNER
ME-132413
REGISTERED PROFESSIONAL ENGINEER

OFFICE OF CONSTRUCTION AND FACILITIES MANAGEMENT
U.S. Department of Veterans Affairs

DRAWING TITLE
148 - ENLARGED MECHANICAL DEMOLITION PLANS

APPROVED:

PHASE
100% CONSTRUCTION DOCUMENTS

FLS
FULLY SPRINKLERED

PROJECT TITLE
EHRM INFRASTRUCTURE UPGRADES

PROJECT NUMBER
568-21-701

BUILDING NUMBER

DRAWING NUMBER
148-MD-012

LOCATION
FORT MEADE, SOUTH DAKOTA

ISSUE DATE
4/15/2022

CHECKED BY
EMM/MRB


DRAWN BY
MEM/NSK

GENERAL NOTES:

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SHEET NOTES:

- 1 APPROXIMATE OUTLINE OF NEW TR AREA. SEE REMODEL SHEETS FOR ALL DISCIPLINES FOR ADDITIONAL INFORMATION.
- 2 SALVAGE AND RELOCATE WATER HEATER. DEMOLISH CW AND HW PIPING FROM WATER HEATER TO PLUMBING FIXTURES TO EXTENT NECESSARY FOR REMODEL WORK. NO DOMESTIC WATER PIPING SHALL BE IN NEW IT CLOSET.
- 3 SALVAGE CEILING HUNG UNIT HEATER AND RELOCATE OUTSIDE OF NEW TR. EXISTING GAS PIPING AND VENT TO REMAIN FOR RECONNECTION.

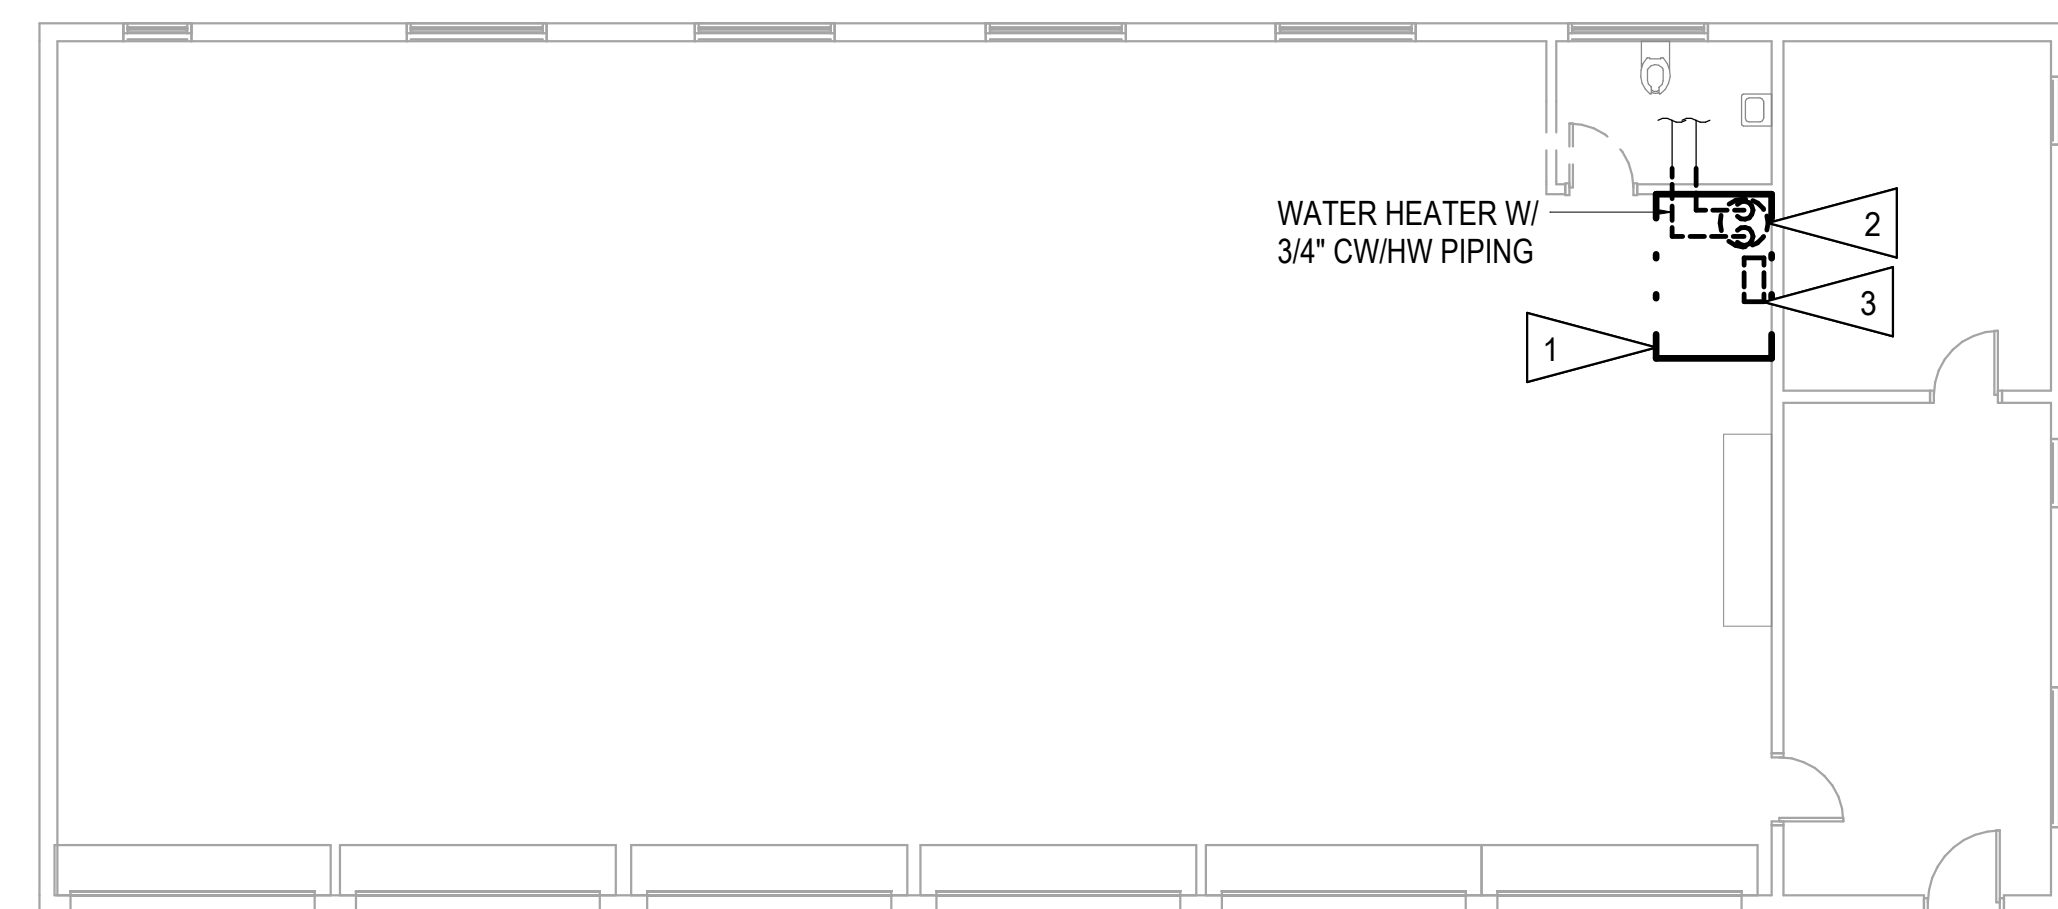

1 BUILDING T171 - FIRST FLOOR DEMOLITION PLAN - OVERALL
1/8" = 1'-0"



Revisions:	Date:

CONSULTANT

A/E:
GDM
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ADAM GOODIN, P.E.

ARCHITECT/ENGINEER OF RECORD

MECHANICAL ENGINEER
RSA ENGINEERING, INC.
670 W. FIREWEED LN, SUITE 200
ANCHORAGE, ALASKA 99503
907.276.0521
M.R. BAUMGARTNER, P.E.

STAMP

**OFFICE OF
CONSTRUCTION
AND FACILITIES
MANAGEMENT**

VA U.S. Department
of Veterans Affairs

DRAWING TITLE
T171 - MECHANICAL DEMOLITION -
OVERALL

APPROVED:

PHASE
100% CONSTRUCTION
DOCUMENTS

FLS
FULLY SPRINKLERED


PROJECT TITLE EHRM INFRASTRUCTURE UPGRADES	PROJECT NUMBER 568-21-701
LOCATION FORT MEADE, SOUTH DAKOTA	BUILDING NUMBER BLDG T171
ISSUE DATE 4/15/2022	CHECKED BY EMM/MRB
DRAWN BY MEM/NSK	DRAWING NUMBER T171-MD-011

GENERAL NOTES:

- A. THE INFORMATION SHOWN ON THIS DRAWING IS TAKEN FROM AS-BUILT DRAWINGS AND A NON-DESTRUCTIVE WALK THROUGH OF THE FACILITY. THERE IS NO WARRANTY OR GUARANTEE AS TO THE ACCURACY OF THE INFORMATION SHOWN HERE-IN. THE CONTRACTOR SHALL FIELD VERIFY ALL ITEMS SCHEDULED FOR DEMOLITION PRIOR TO START OF WORK.
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SHEET NOTES:

- 1 APPROXIMATE OUTLINE OF NEW TR AREA. SEE REMODEL SHEETS FOR ALL DISCIPLINES FOR ADDITIONAL INFORMATION.
- 2 DEMOLISH CLOTHES DRYER WALL CAP AND E/A DUCTWORK IN TO WALL. E/A DUCTWORK IN WALL TO REMAIN FOR RECONNECTION.

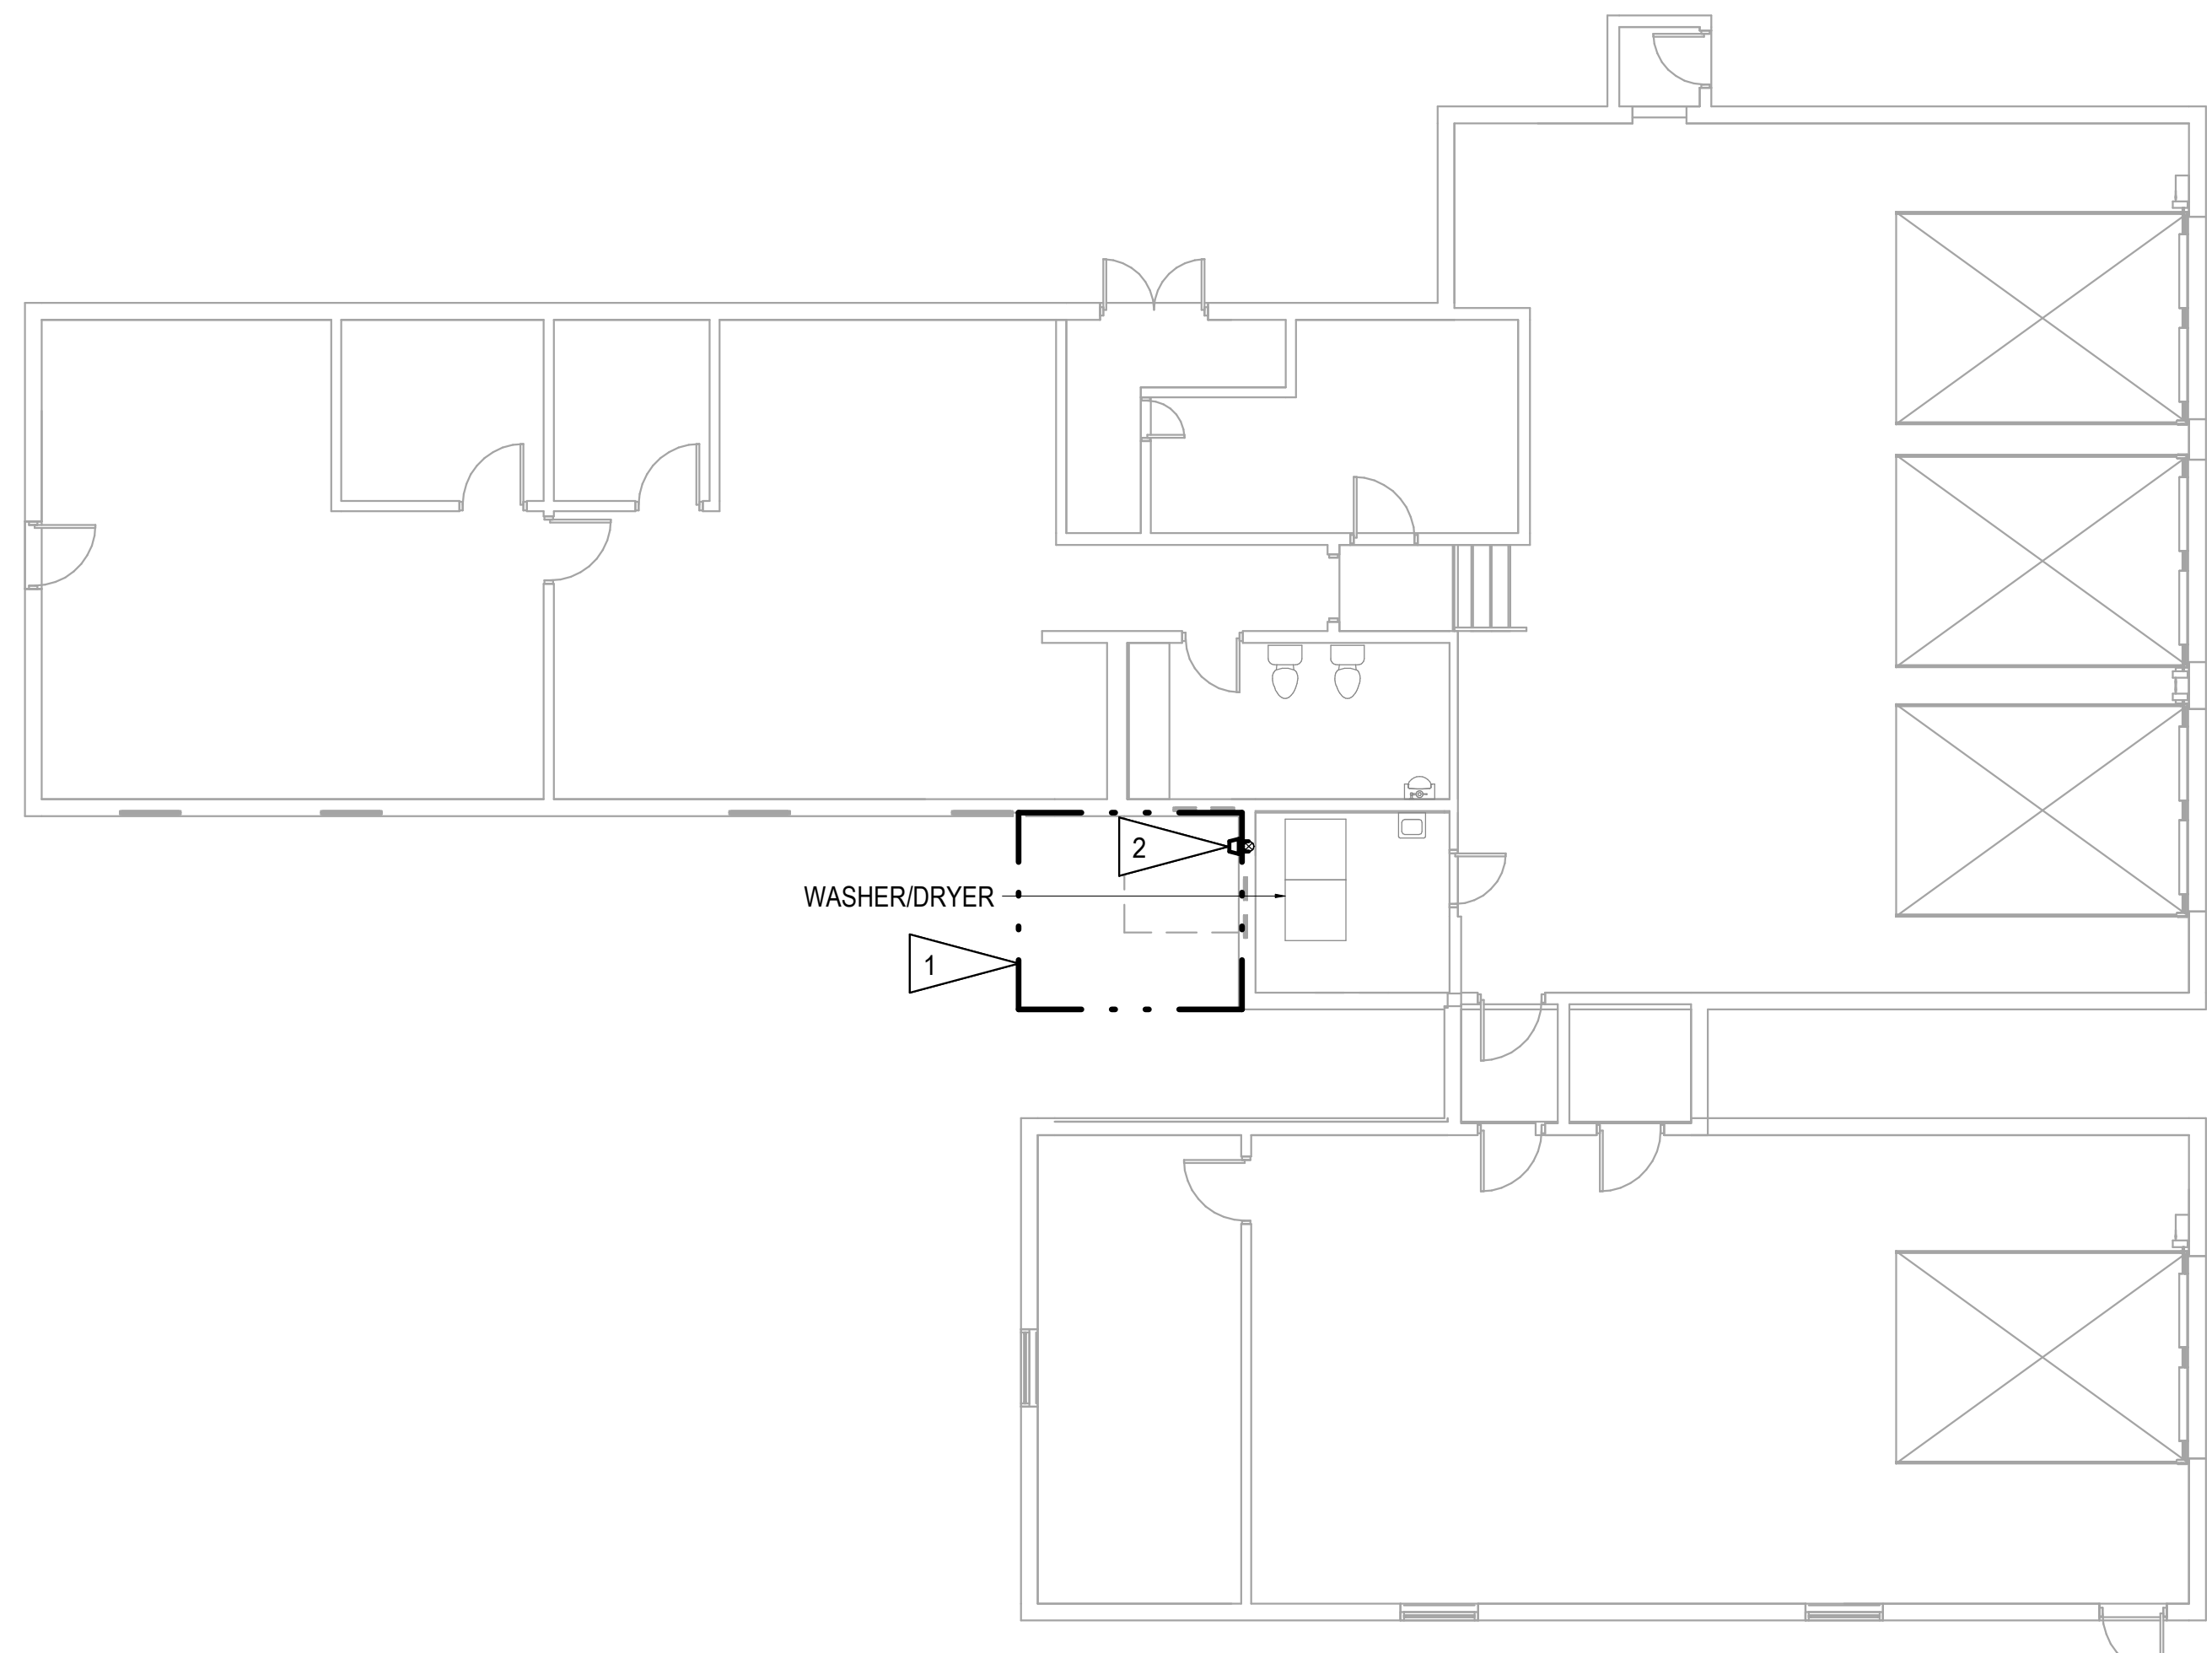

1 BUILDING T296 - FIRST FLOOR DEMOLITION PLAN - OVERALL
1/8" = 1'-0"
NORTH

Revisions:	Date:


CONSULTANT

A/E:
GDM
1000 W STEUBEN ST. UNIT 3
BINGEN, WA 98605
541.436.4723
ADAM GOODIN, P.E.




ARCHITECT/ENGINEER OF RECORD

MECHANICAL ENGINEER
RSA ENGINEERING, INC.
670 W. FIREWEED LN, SUITE 200
ANCHORAGE, ALASKA 99503
907.276.0521
M.R. BAUMGARTNER, P.E.



STAMP



OFFICE OF CONSTRUCTION AND FACILITIES MANAGEMENT



DRAWING TITLE
T296 - MECHANICAL DEMOLITION - OVERALL

APPROVED:

PHASE
100% CONSTRUCTION DOCUMENTS

FLS
FULLY SPRINKLERED

PROJECT TITLE
EHRM INFRASTRUCTURE UPGRADES

LOCATION
FORT MEADE, SOUTH DAKOTA

ISSUE DATE
4/15/2022

CHECKED BY
EMM/MRB

DRAWN BY
MEM/NSK

PROJECT NUMBER
568-21-701

BUILDING NUMBER
BLDG T296

DRAWING NUMBER
T296-MD-011

PIPING LEGEND

Table with 2 columns: Symbol and Description. Includes items like WASTE, VENT PIPING, COLD WATER, HOT WATER, etc.

LOGIC

Table with 2 columns: Symbol and Description. Includes items like POINT OF CONNECTION, DETAIL NUMBER, DIRECTION OF VIEW, etc.

ABBREVIATIONS

Table with 2 columns: Abbreviation and Full Name. Includes items like AAV AUTOMATIC AIR VENT, AVX ABOVE, etc.

DUCTWORK LEGEND

Table with 2 columns: Symbol and Description. Includes items like THERMOSTAT, SOUND LINED DUCTWORK, EXTERIALLY INSULATED DUCTWORK, etc.

GENERAL PROJECT NOTES:

- 27. ALL ELECTRICAL WORK SHALL BE PERFORMED IN ACCORDANCE WITH NFPA 70 STANDARDS AND LOCAL REQUIREMENTS.
28. ALL FIELD WIRING SHALL REQUIRE AN ELECTRICAL PERMIT AND SHALL BE PERFORMED BY A LICENSED ELECTRICIAN.
29. A SHORT DASH IN A SCHEDULE TABLE CELL INDICATES THAT THE COLUMN HEADING IS NOT USED OR NOT APPLICABLE TO THAT SCHEDULED ITEM.

Revisions table with columns for Revision number, Description, and Date.

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STAMP: STATE OF ALASKA. W.R. BAUMGARTNER, REGISTERED PROFESSIONAL ENGINEER.


OFFICE OF CONSTRUCTION AND FACILITIES MANAGEMENT. U.S. Department of Veterans Affairs.

DRAWING TITLE: MECHANICAL LEGENDS & ABBREVIATIONS. APPROVED:


PHASE: 100% CONSTRUCTION DOCUMENTS. FULLY SPRINKLERED.

PROJECT TITLE: EHRM INFRASTRUCTURE UPGRADES. PROJECT NUMBER: 568-21-701. BUILDING NUMBER: DRAWING NUMBER: MG-001.


A
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F

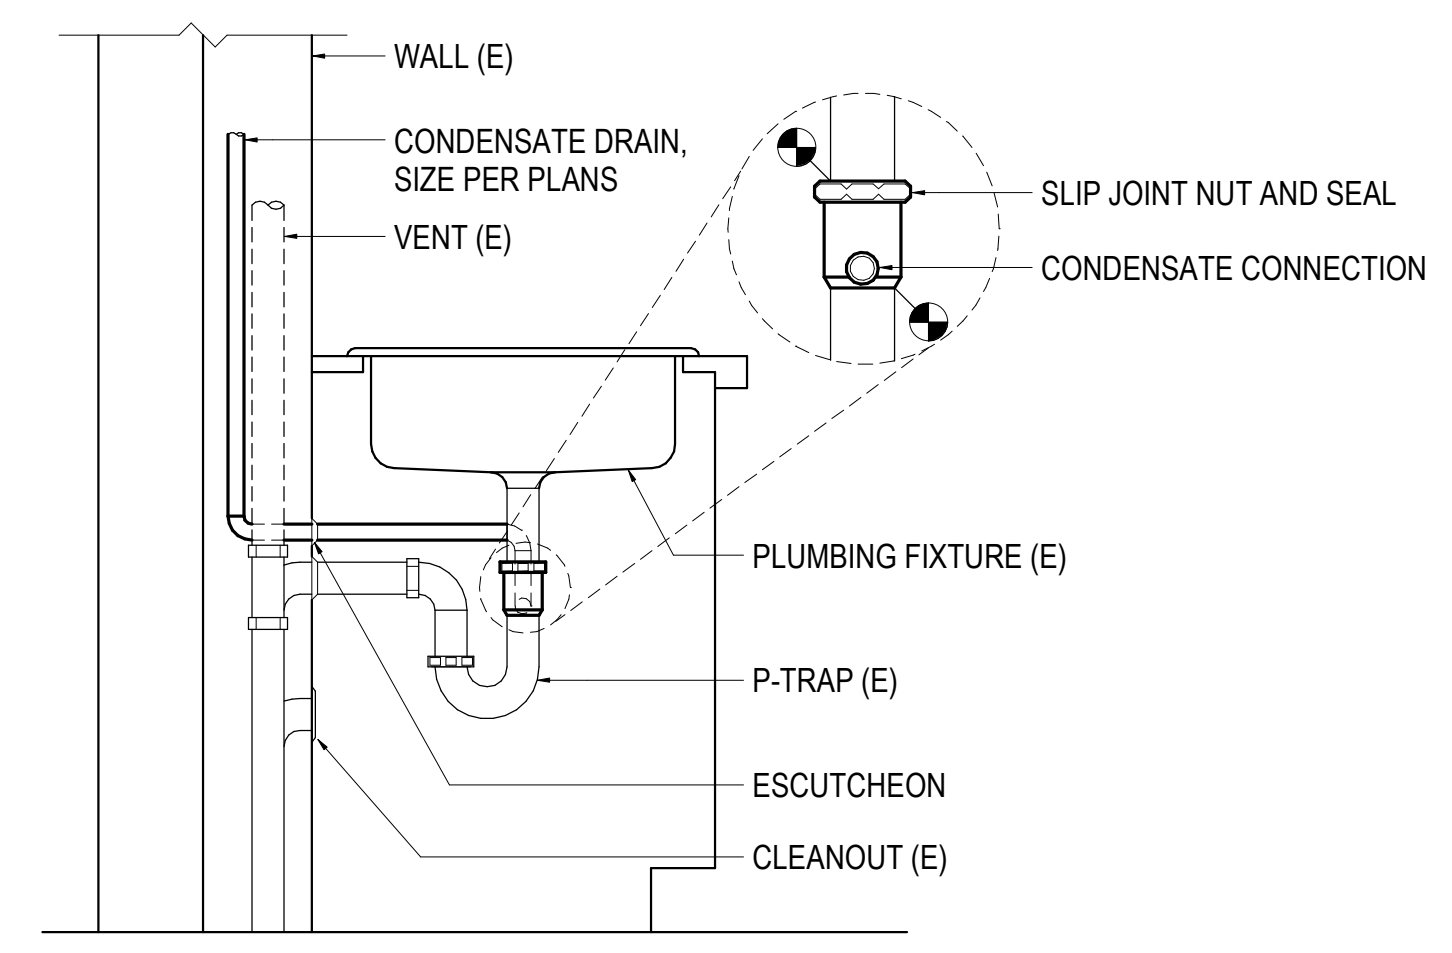

1 INDIRECT DRAIN DETAIL
NOT TO SCALE

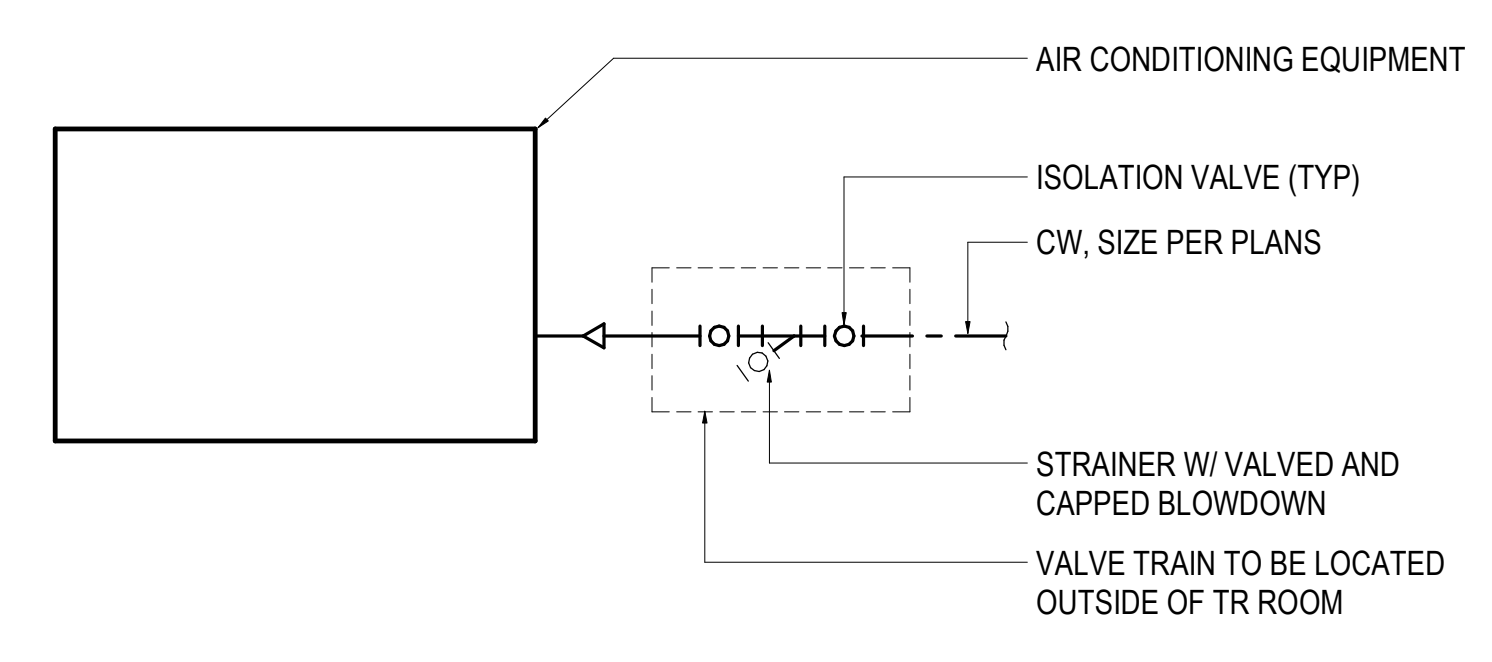


2 HUMIDIFIER WATER CONNECTION DETAIL
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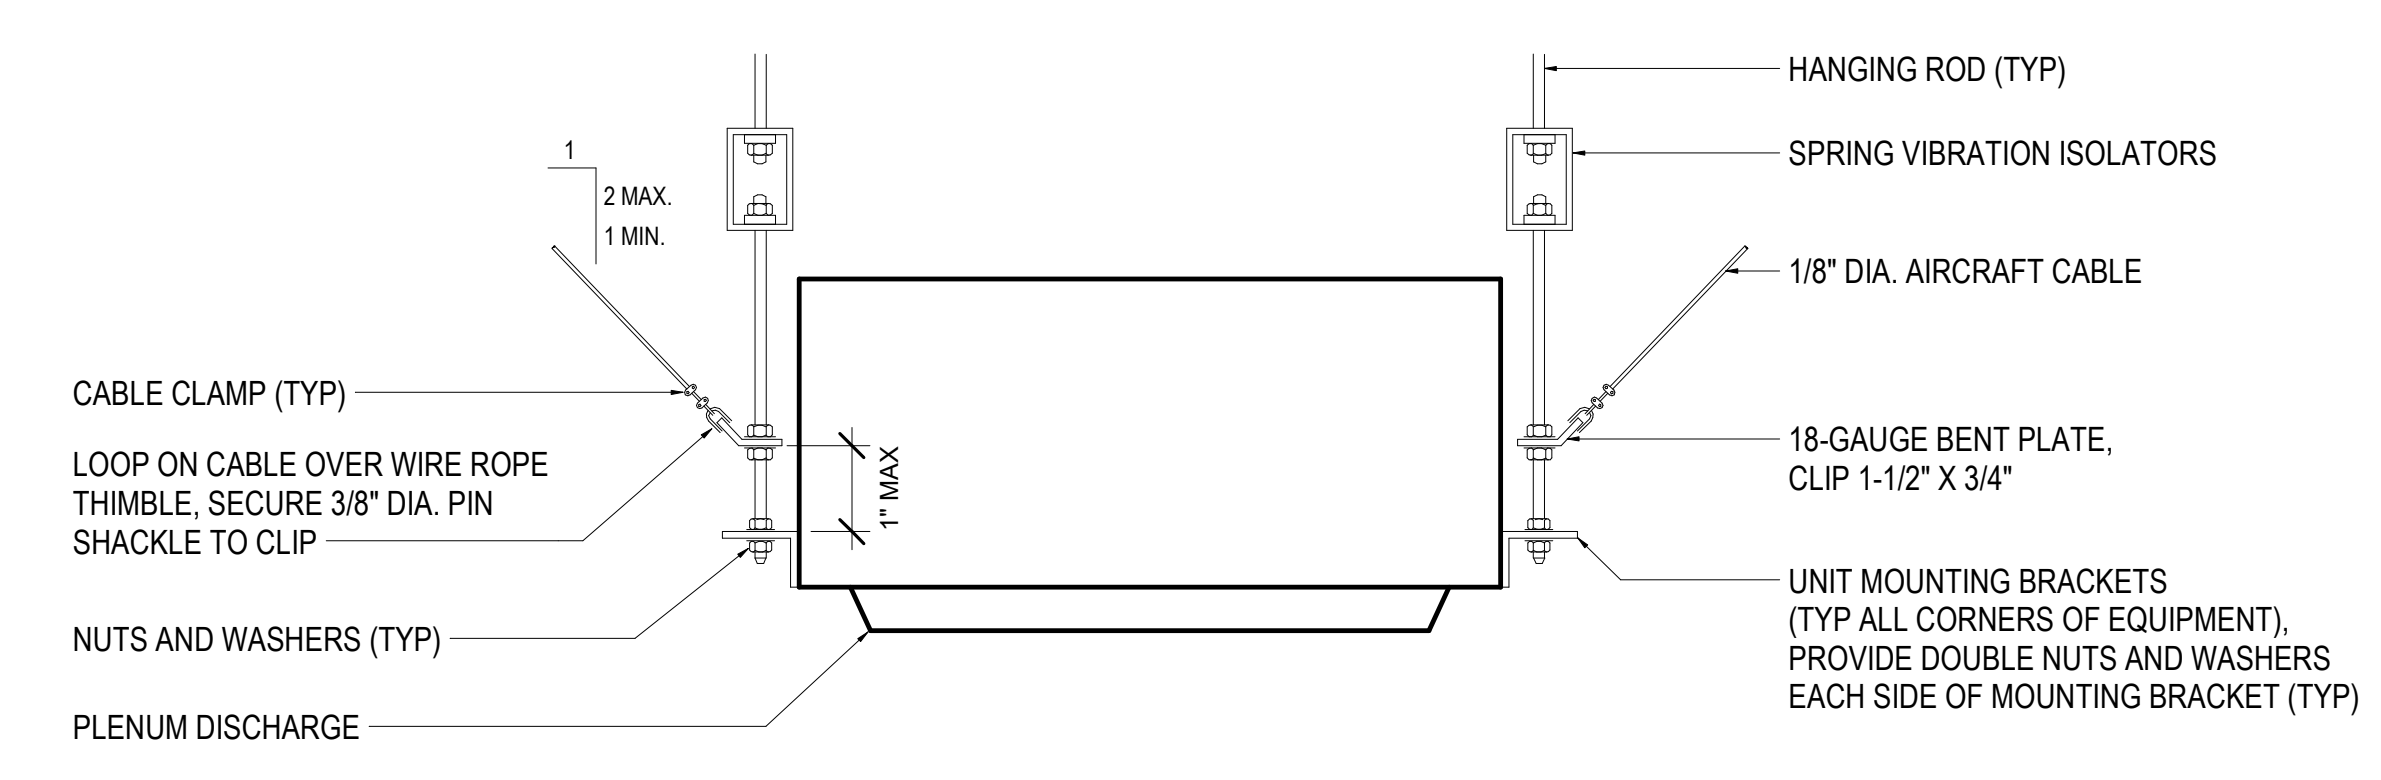


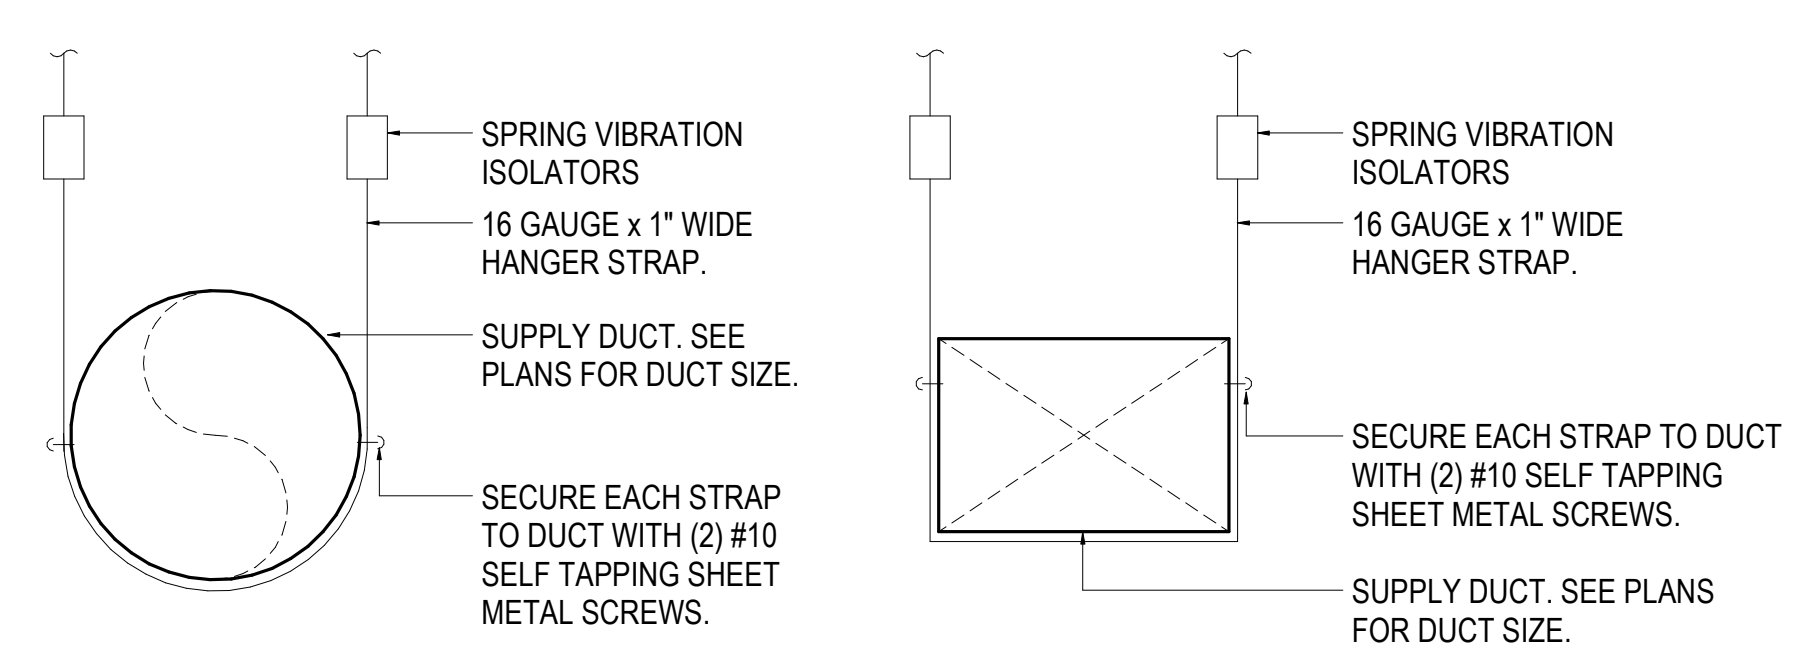NOTE:
1. PROVIDE AND CONSTRUCT DUCT HANGERS AND SUPPORTS PER 2006 SMACNA HVAC DUCT CONSTRUCTION STANDARDS FIGURE 5-5.
2. LENGTH OF SUPPORTS, STRAP SIZES, AND SIZES OF STEEL ANGLES AS REQUIRED FOR DUCT SIZE AND CONFIGURATION.
3. MAXIMUM 10' SPACING BETWEEN SUPPORTS.


3 TYPICAL DUCT SUPPORT DETAIL
NOT TO SCALE

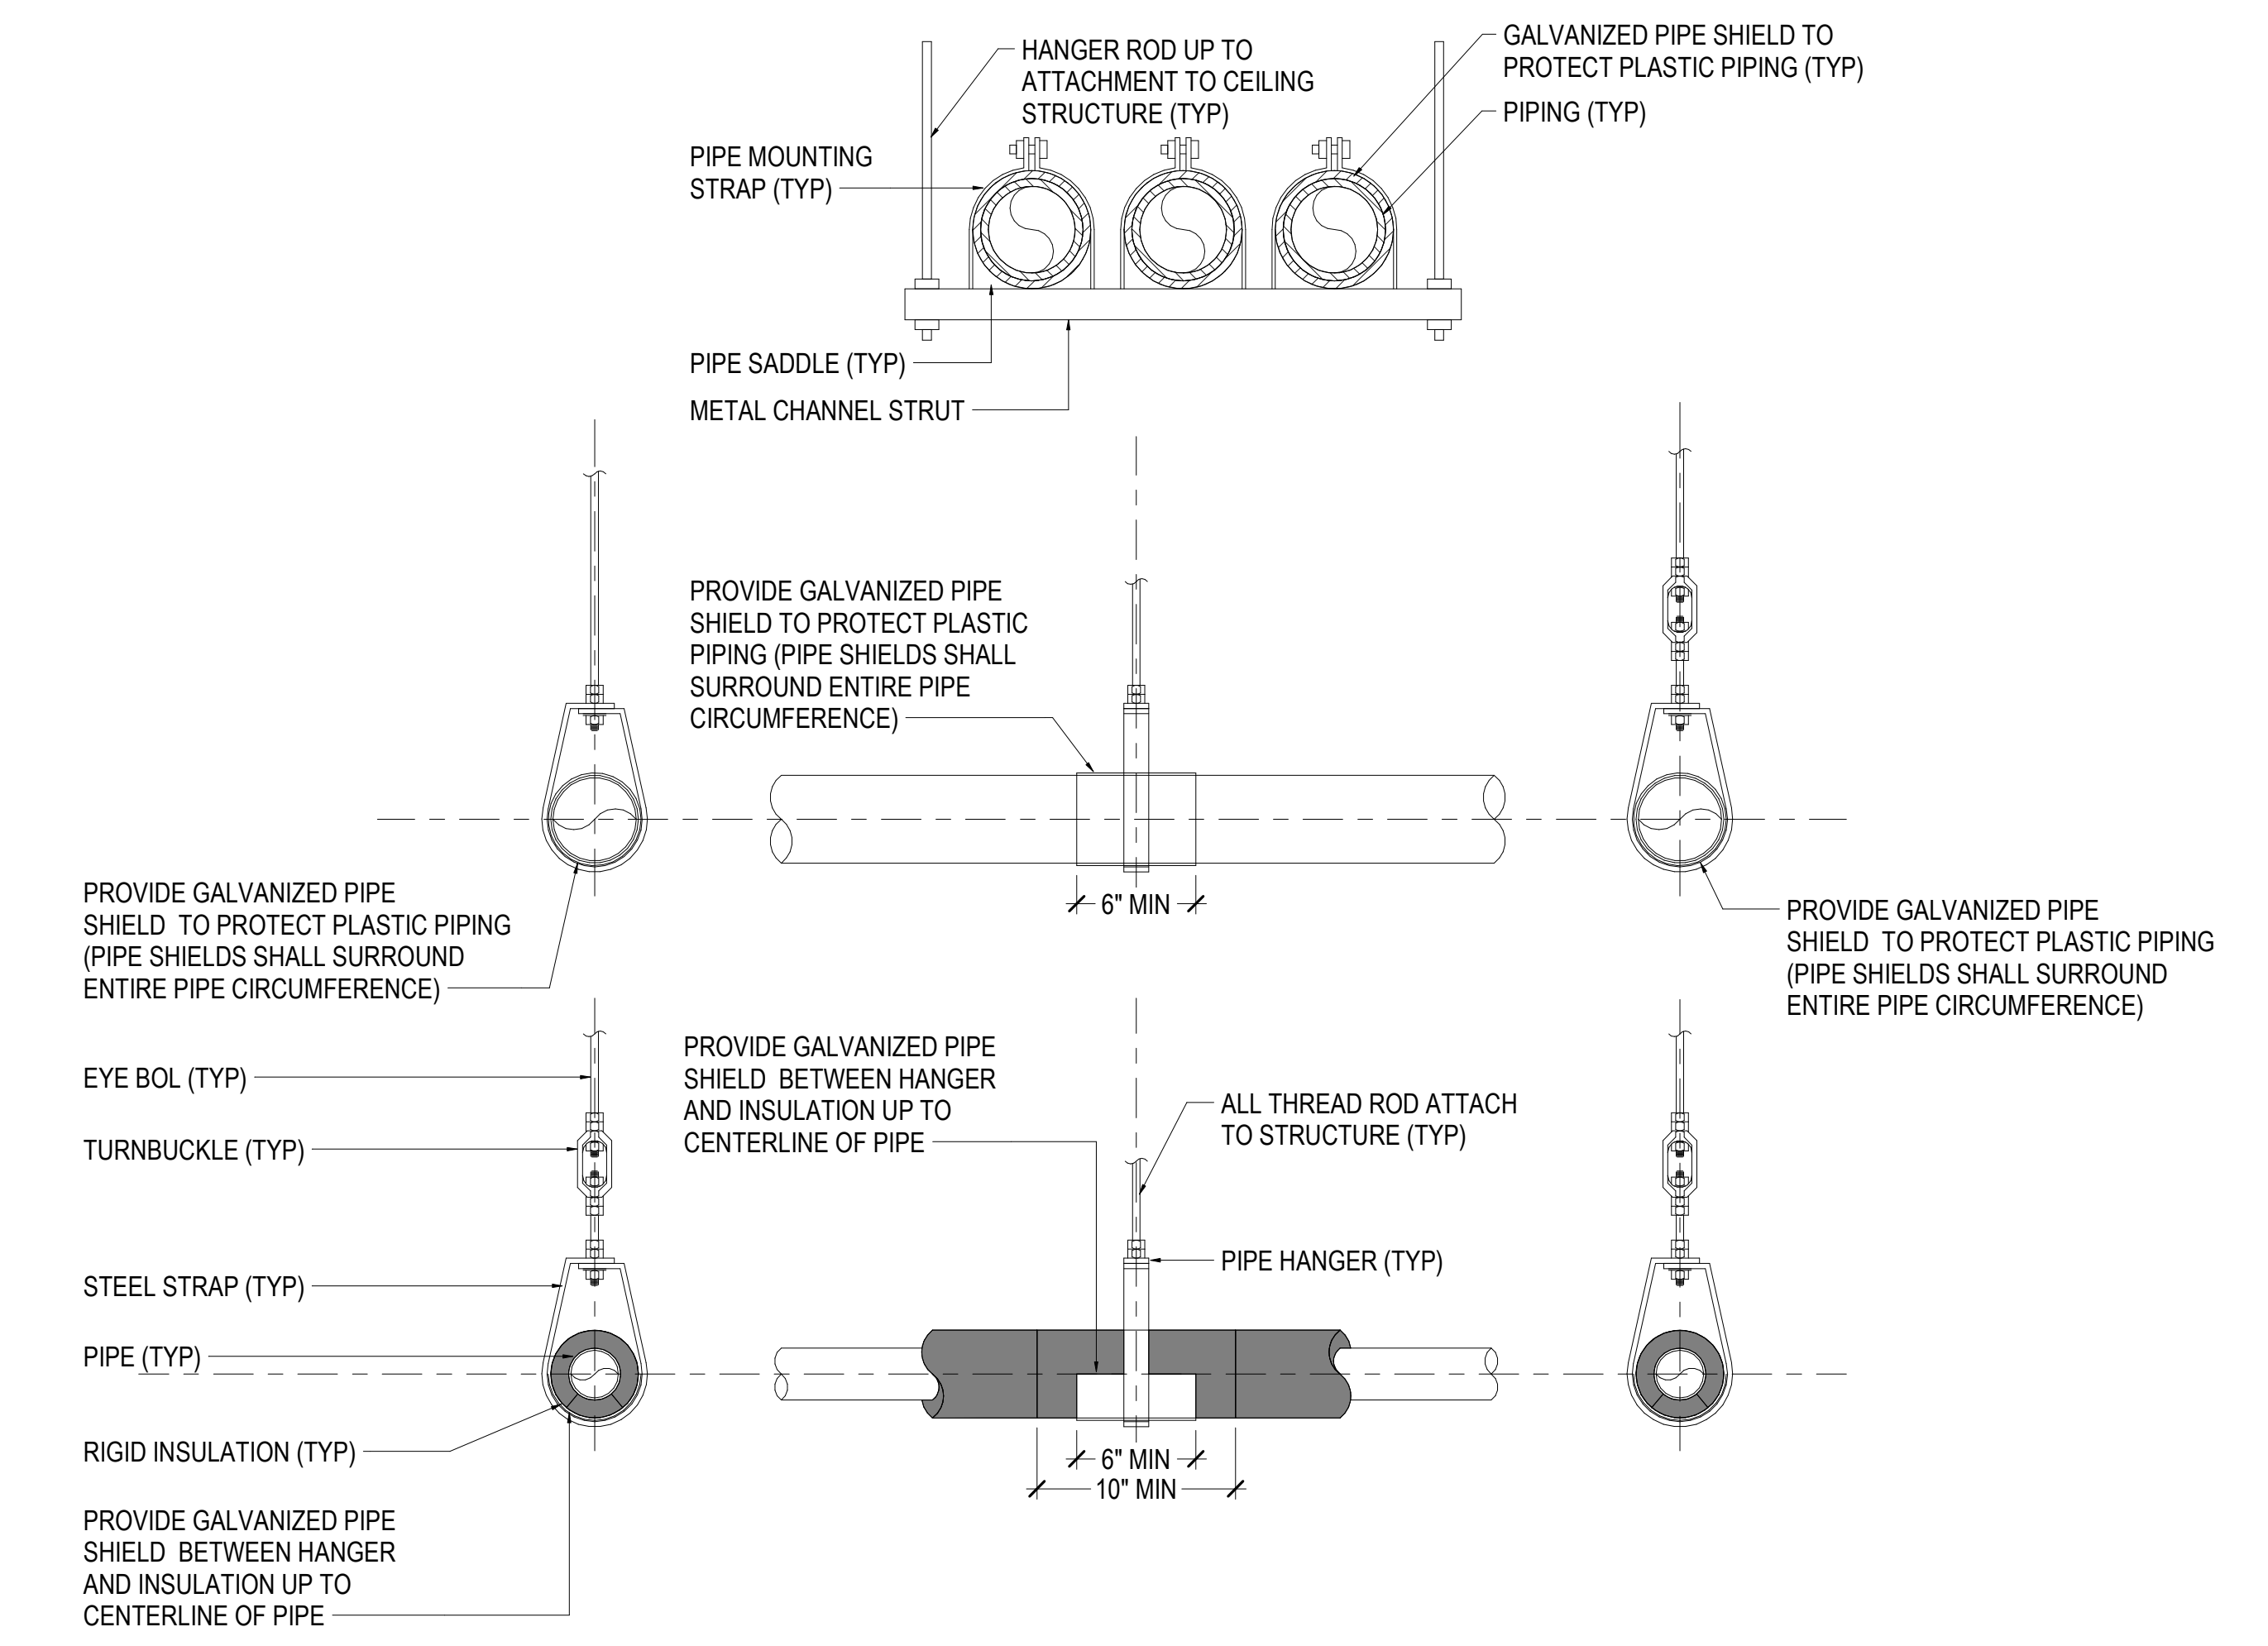


4 TYPICAL PIPE SUPPORT DETAIL
NOT TO SCALE



5 INDOOR UNIT WITH PLENUM MOUNTING DETAIL
NOT TO SCALE

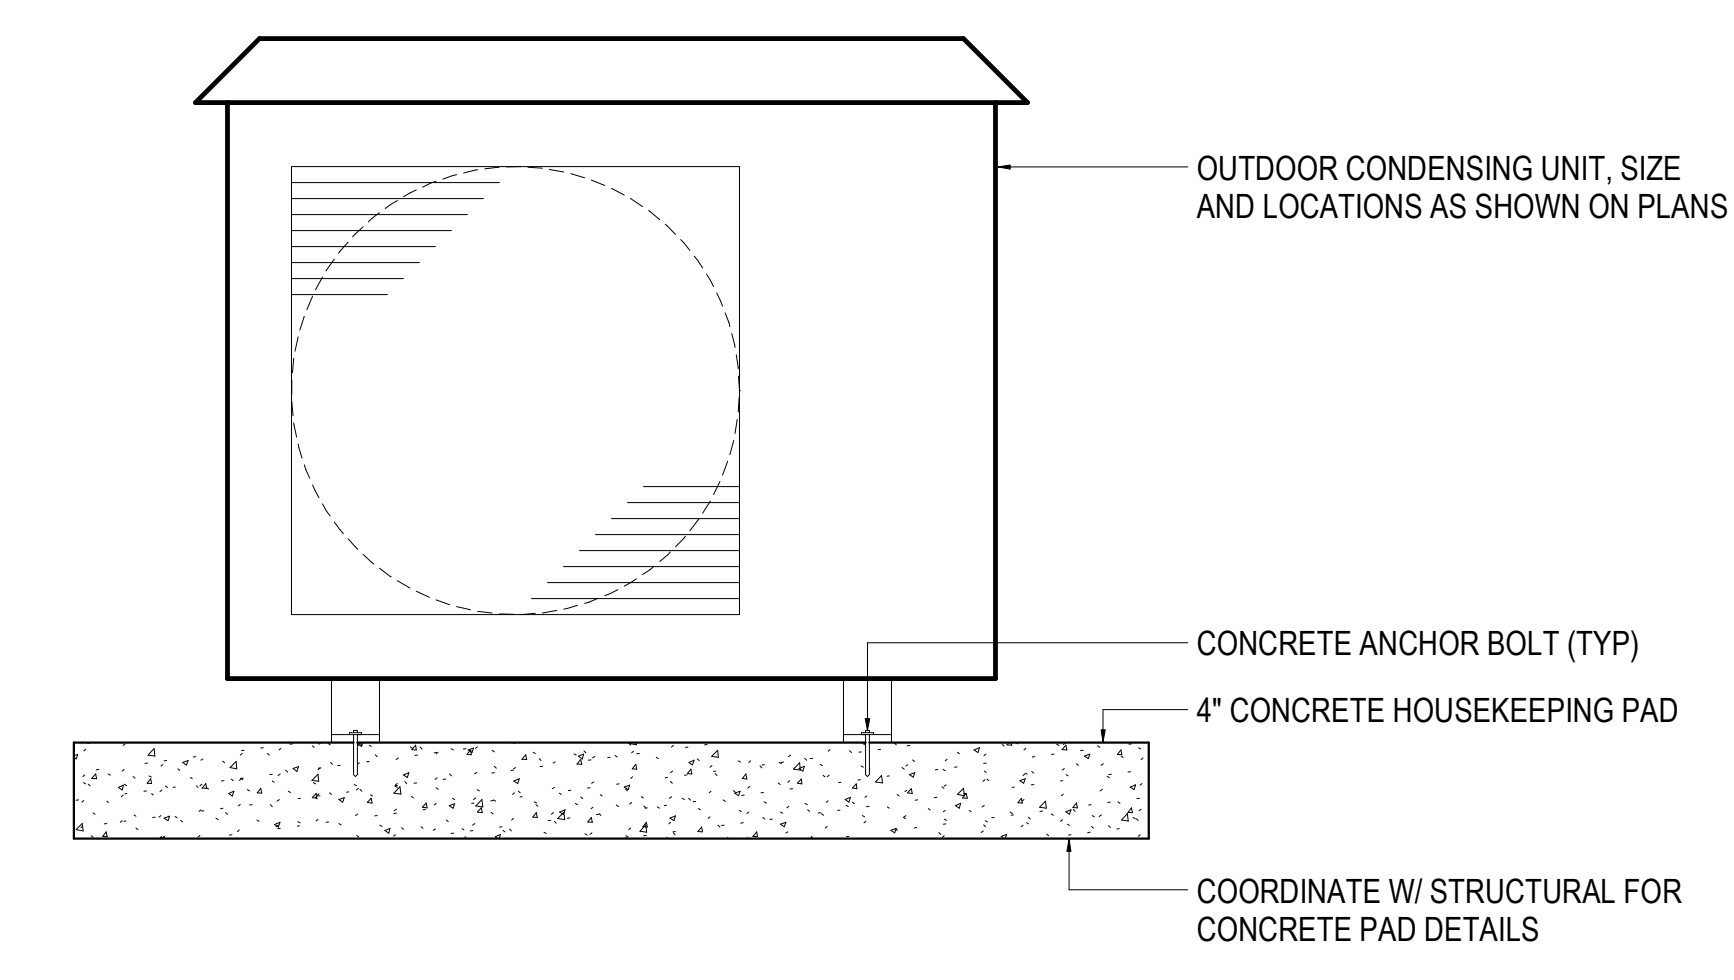

6 OUTDOOR CONDENSING UNIT PAD INSTALLATION DETAIL
NOT TO SCALE

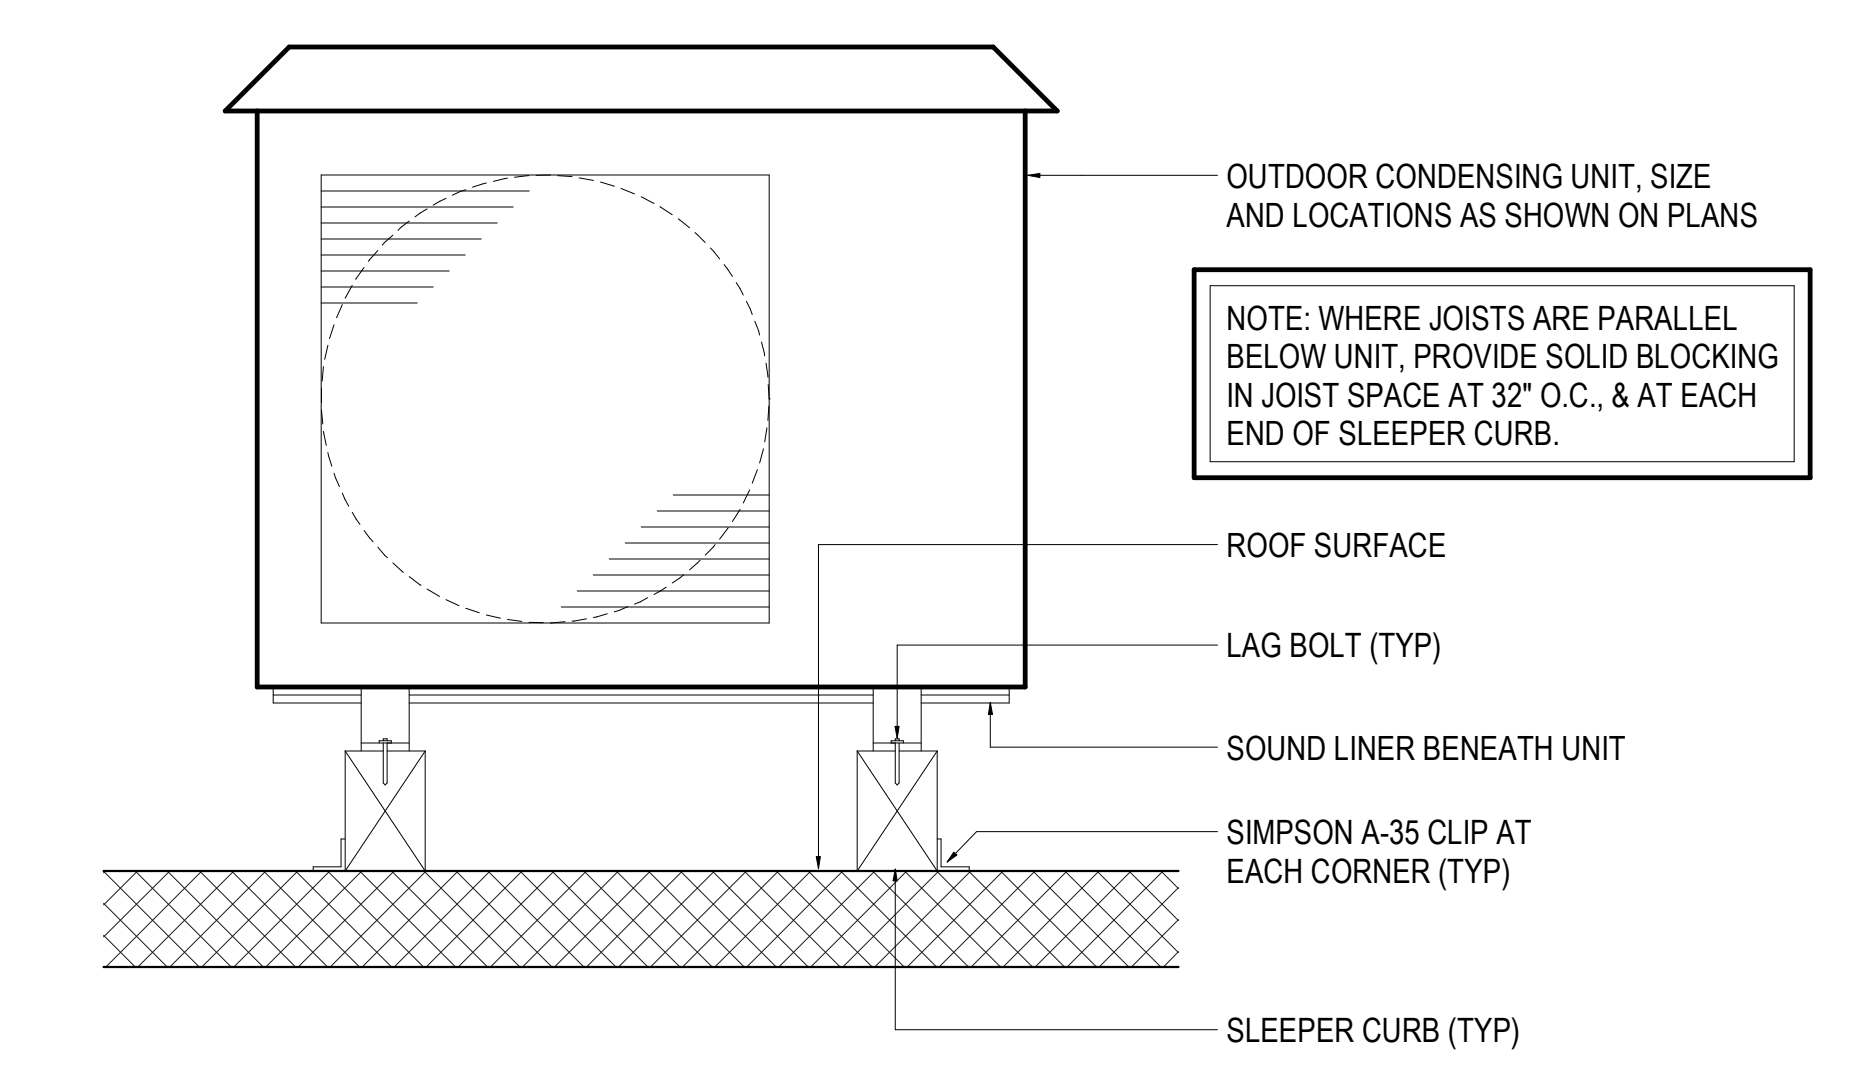

7 OUTDOOR CONDENSING UNIT ROOF INSTALLATION DETAIL
NOT TO SCALE

Revisions:	Date:

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DRAWING TITLE
MECHANICAL DETAILS

APPROVED:

PHASE
100% CONSTRUCTION DOCUMENTS

FLS
FULLY SPRINKLERED

PROJECT TITLE
EHRM INFRASTRUCTURE UPGRADES

LOCATION
FORT MEADE, SOUTH DAKOTA

ISSUE DATE
4/15/2022

CHECKED BY
EMM/MRB

DRAWN BY
MEM/NSK

PROJECT NUMBER
568-21-701

BUILDING NUMBER

DRAWING NUMBER
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