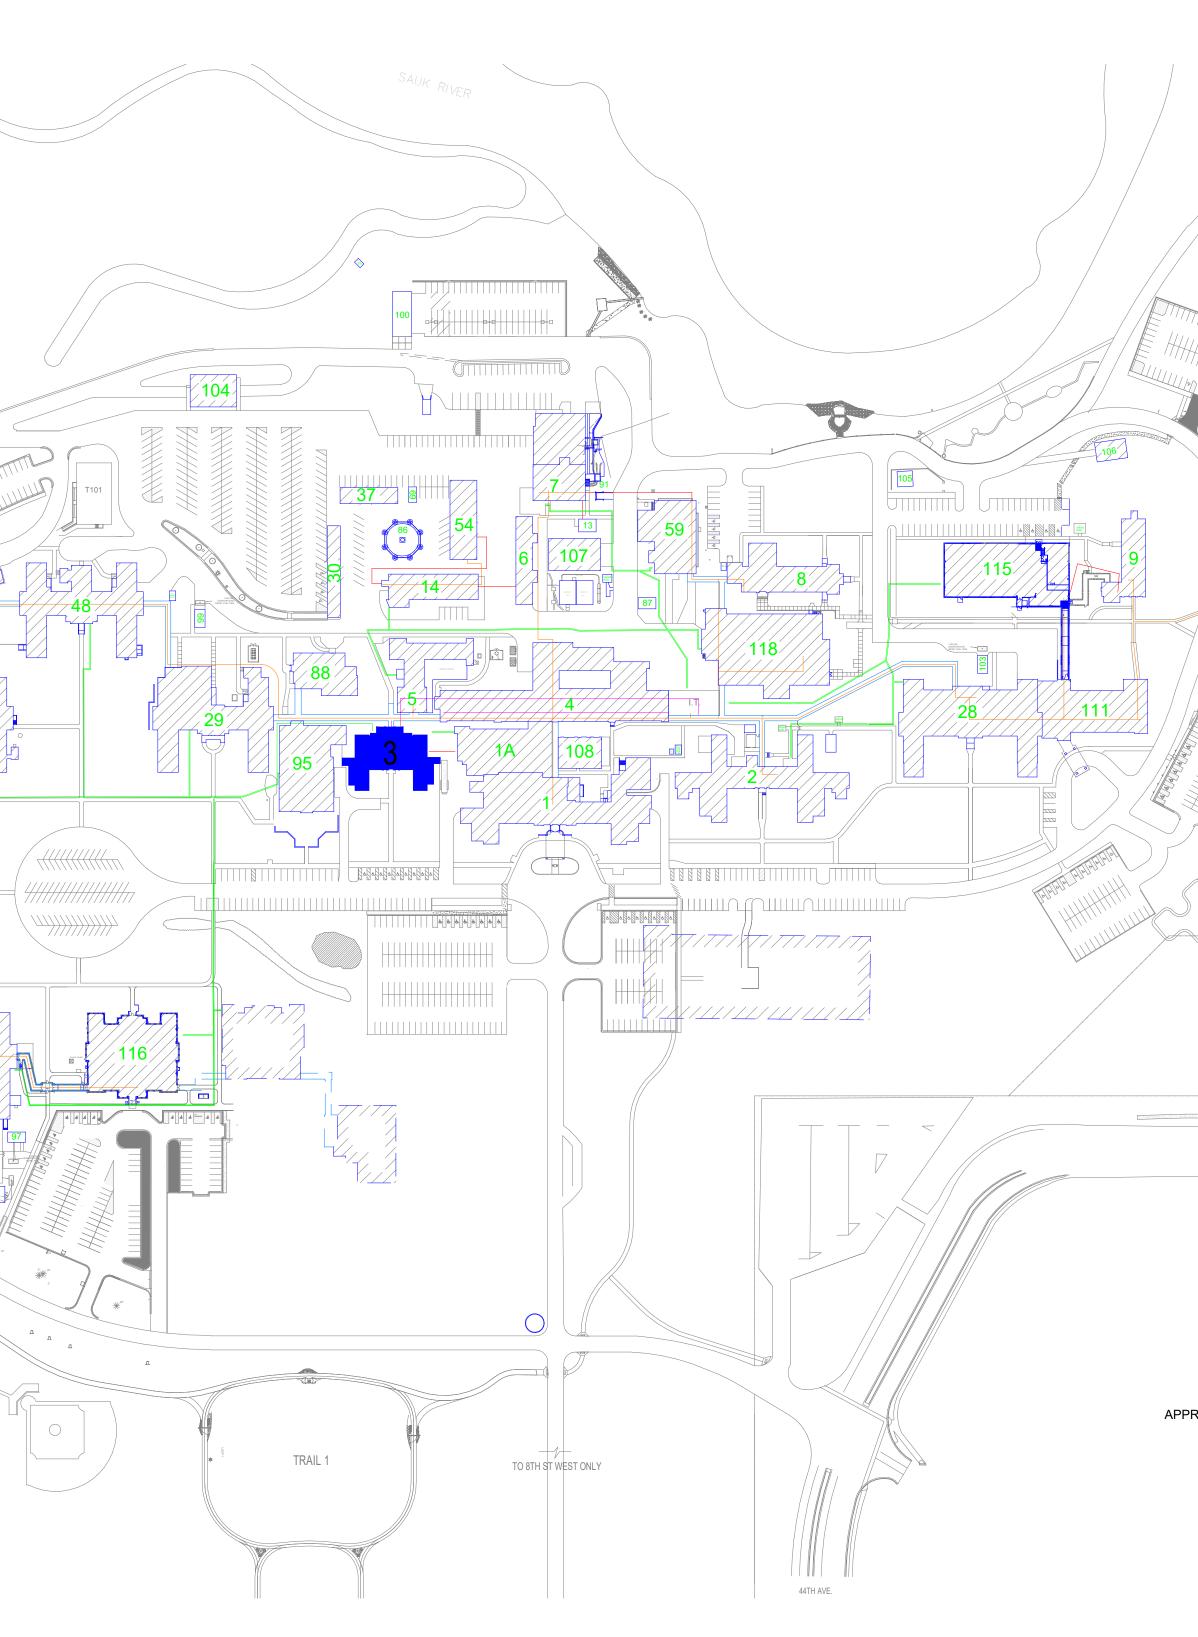
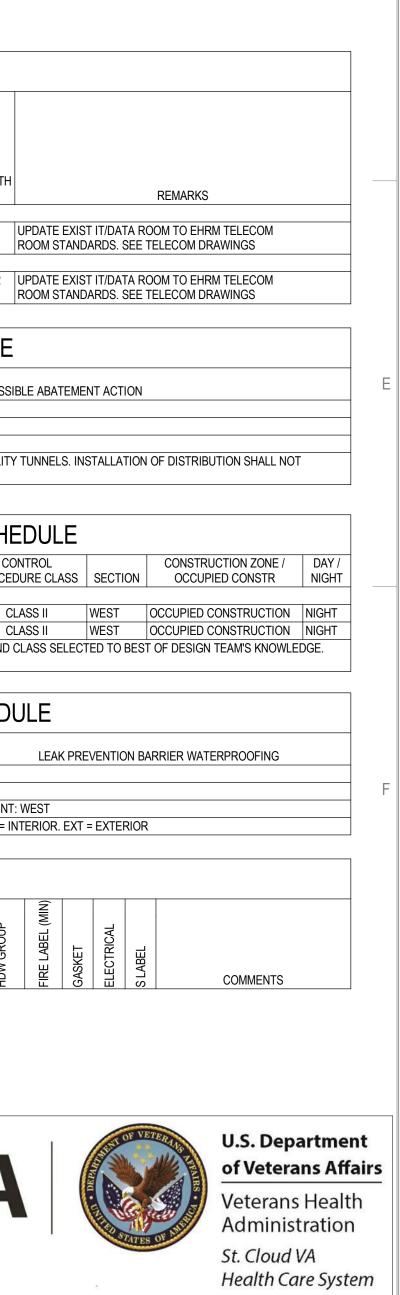
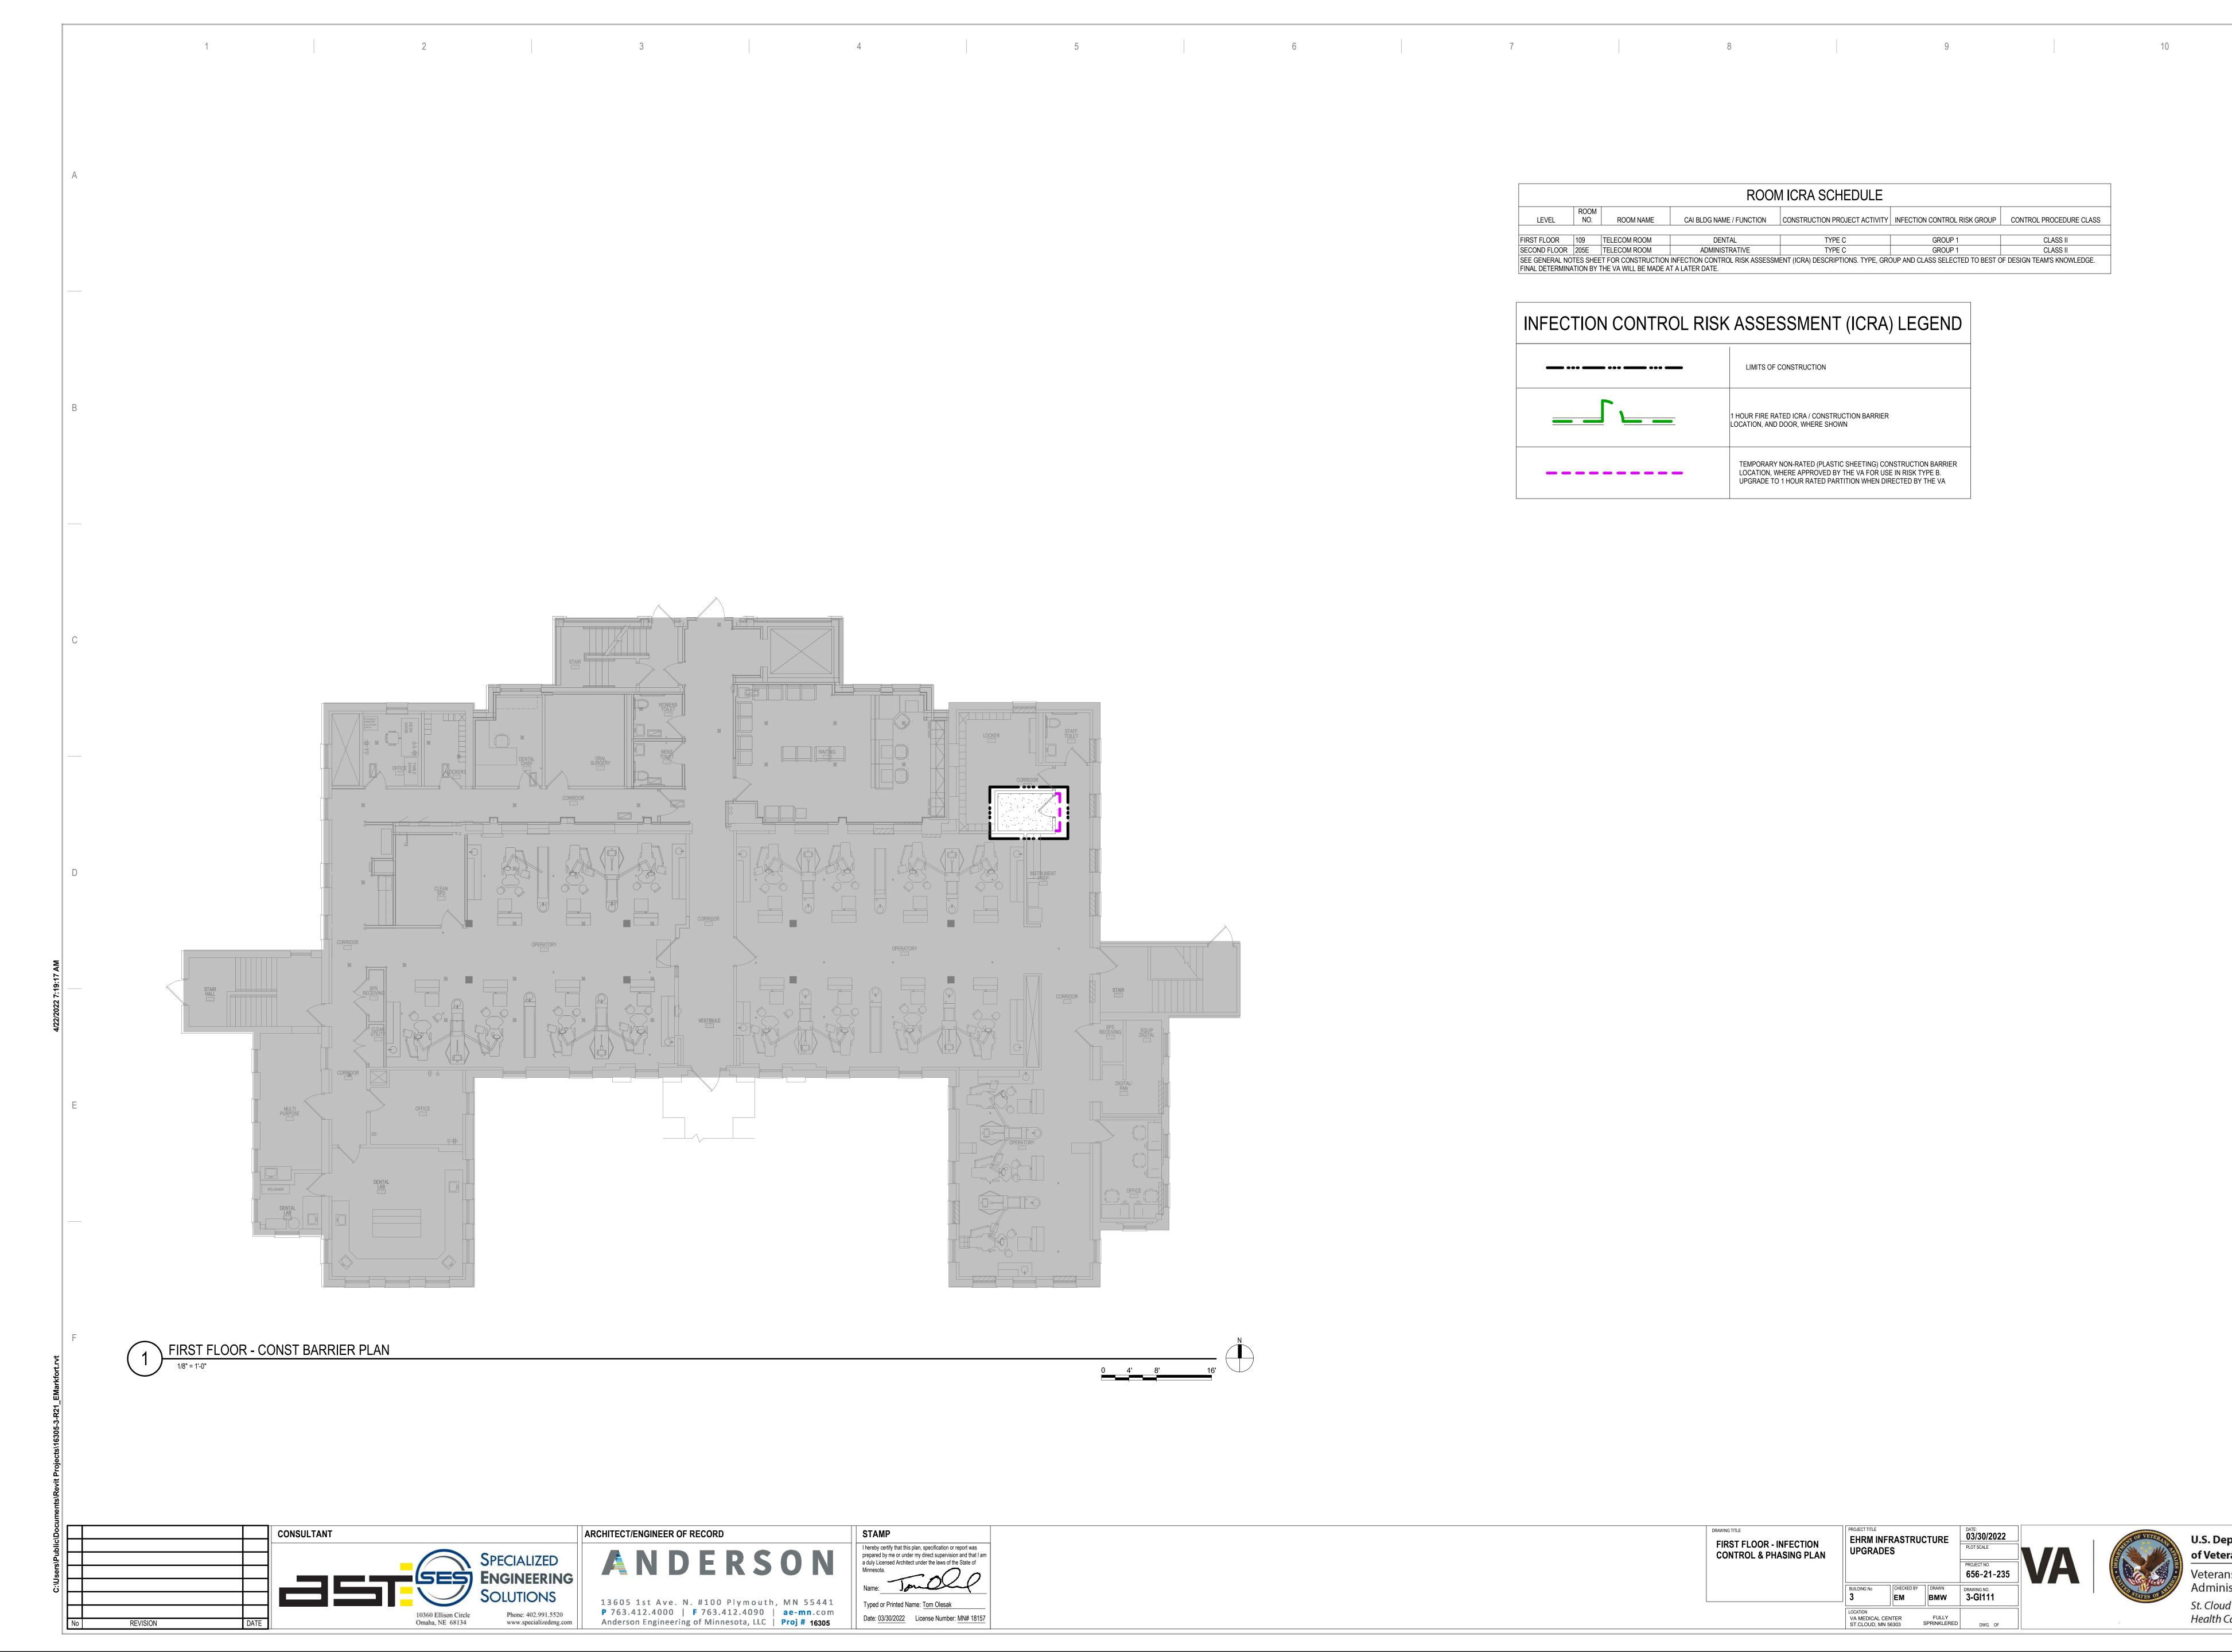
| | BUILDING 3 - EHRM INFRASTRUCTURE UPGRADES |
|-----------------------------------|--|
| | St. Cloud VA Health Care System Main Campus, St. Cloud, Minnesota |
| rojects\16305-3-R21_EMarkfort.rvt | |
| C:\Users\Public\Documents\Revit | |



| DATE: | APPROVED: EMS MANAGER DATE: APPROVED: M/O MANAGER DATE: | APPROVED: DIRECTOR FMS DATE: APPROVED: ASSOCIATE DIRECTOR DATE: | BUILDING 3 COVER SHEET & SHEET INDEX | PROJECT TITLE EHRM INFI UPGRADE | | CTURE | DATE: 03/30/2022 PLOT SCALE PROJECT NO. 656-21-235 | VA |
|-------|---|---|---|---|------------|----------------------|--|----|
| DATE: | APPROVED: PROJECTS SECTION MANAGER DATE: | APPROVED: NURSE EXECUTIVE DATE: | | BUILDING No | CHECKED BY | DRAWN EM | DRAWING NO. 3-GI000 | |
| DATE: | APPROVED: ASSISTANT CHIEF ENGINEER DATE: | APPROVED: CHIEF OF STAFF DATE: | APPROVED: MEDICAL CENTER DIRECTOR DATE: | LOCATION VA MEDICAL CENTER ST.CLOUD, MN 56303 | | FULLY SPRINKLERED | COVER DWG. OF | |






| | ROOM ICRA SCHEDULE | | | | | | | | | | | |
|--------------|--------------------|--------------------|--------------------------|-------------------------------------|----------------------------------|---------------------|--|--|--|--|--|--|
| LEVEL | ROOM NO. | ROOM NAME | CAI BLDG NAME / FUNCTION | CONSTRUCTION PROJECT ACTIVITY | INFECTION CONTROL RISK GROUP | CONTROL PROCEDU | | | | | | |
| FIRST FLOOR | 109 | TELECOM ROOM | DENTAL | TYPE C | GROUP 1 | CLASS II | | | | | | |
| SECOND FLOOR | 205E | TELECOM ROOM | ADMINISTRATIVE | TYPE C | GROUP 1 | CLASS II | | | | | | |
| | | T FOR CONSTRUCTION | | IENT (ICRA) DESCRIPTIONS. TYPE, GRO | DUP AND CLASS SELECTED TO BEST C | F DESIGN TEAM'S KNO | | | | | | |

| INFECTION CONTROL RISK ASSESSMENT (ICRA) LEGEND | | | | | |
|---|--|--|--|--|--|
| | LIMITS OF CONSTRUCTION | | | | |
| | 1 HOUR FIRE RATED ICRA / CONSTRUCTION BARRIER LOCATION, AND DOOR, WHERE SHOWN | | | | |
| | TEMPORARY NON-RATED (PLASTIC SHEETING) CONSTRUCTION BARRIER LOCATION, WHERE APPROVED BY THE VA FOR USE IN RISK TYPE B. UPGRADE TO 1 HOUR RATED PARTITION WHEN DIRECTED BY THE VA | | | | |

| | DRAWING TITLE FIRST FLOOR - INFECTION CONTROL & PHASING PLAN | PROJECT TITLE EHRM INFRASTRUCTURE UPGRADES | | | DATE: 03/30/2022 PLOT SCALE PROJECT NO. 656-21-235 | |
|--|--|--|------------|--------------|--|--|
| | | BUILDING No | CHECKED BY | DRAWN BMW | DRAWING NO. 3-GI111 | |
| | | LOCATION VA MEDICAL (ST.CLOUD, M | | FULLY | DWG. OF | |

| ROCEDURE CLASS |
|----------------|
| |
| LASS II |
| LASS II |
| I'S KNOWLEDGE. |
| |



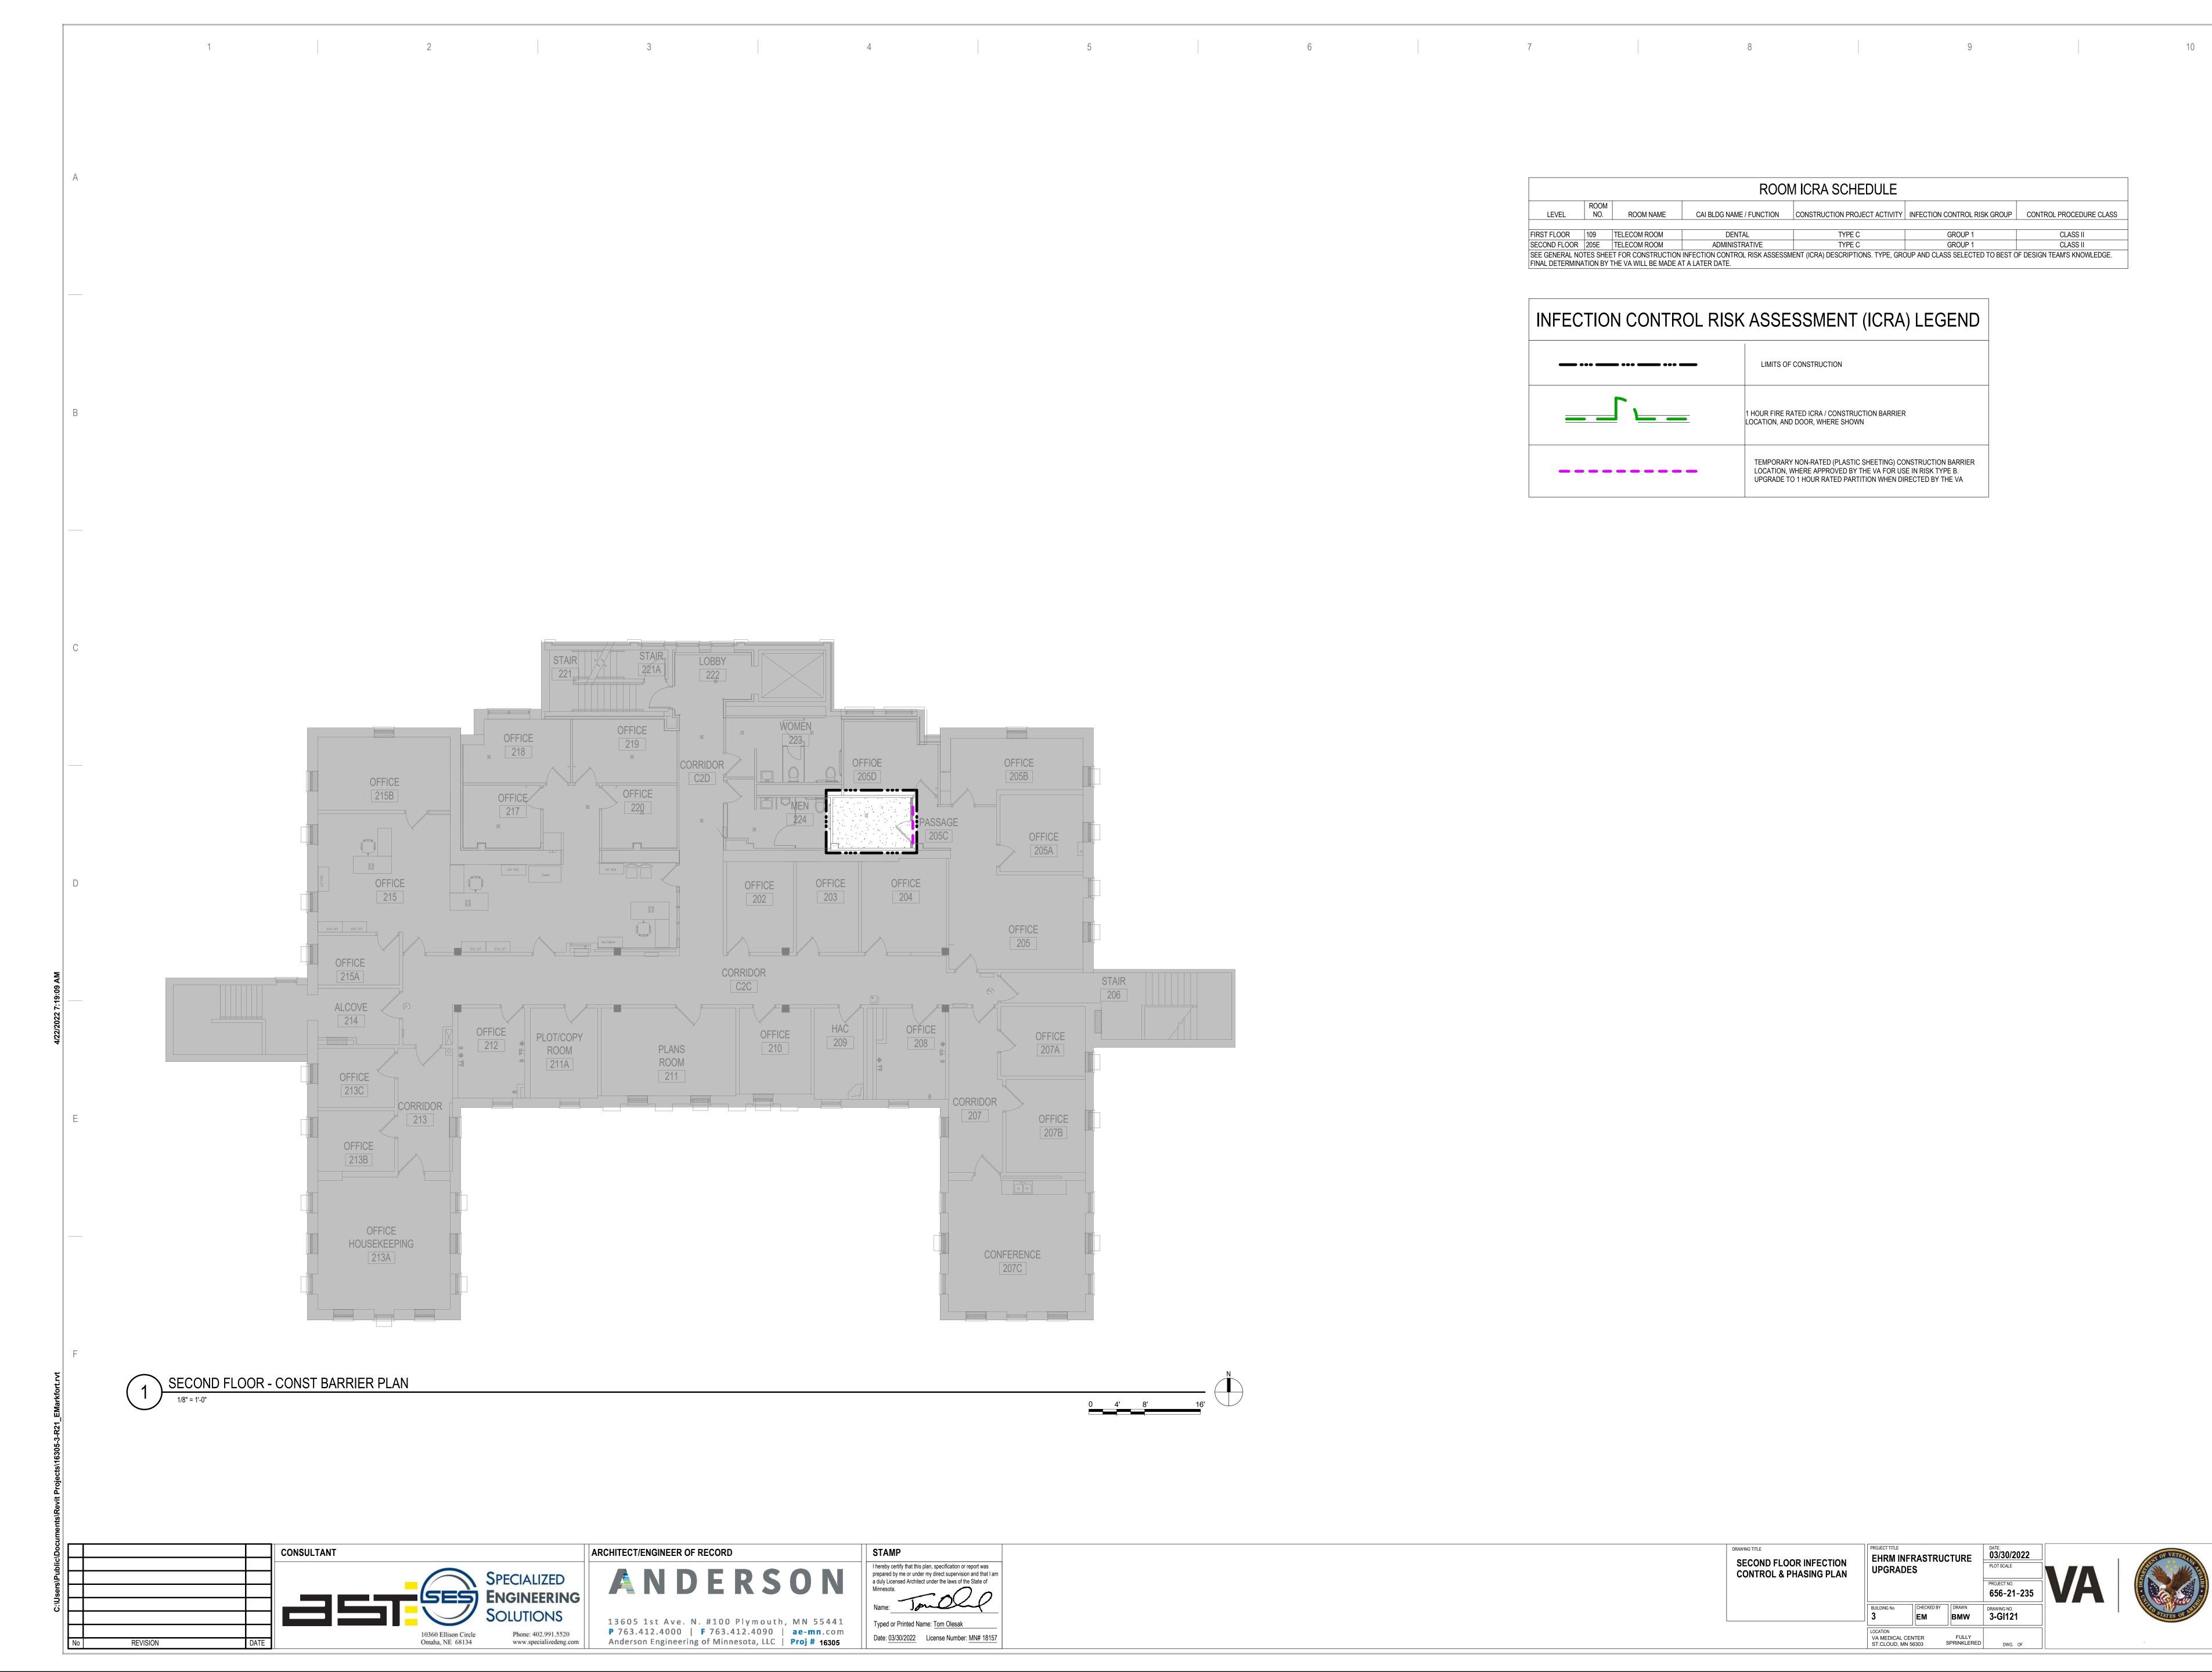

| ROOM ICRA SCHEDULE | | | | | | | | | | | |
|--------------------|-------------|---------------------|--------------------------|-------------------------------------|----------------------------------|-----------------------|--|--|--|--|--|
| LEVEL | ROOM NO. | ROOM NAME | CAI BLDG NAME / FUNCTION | CONSTRUCTION PROJECT ACTIVITY | INFECTION CONTROL RISK GROUP | CONTROL PROCEDURI | | | | | |
| FIRST FLOOR | 109 | TELECOM ROOM | DENTAL | TYPE C | GROUP 1 | CLASS II | | | | | |
| SECOND FLOOR | 205E | TELECOM ROOM | ADMINISTRATIVE | TYPE C | GROUP 1 | CLASS II | | | | | |
| | | ET FOR CONSTRUCTION | | MENT (ICRA) DESCRIPTIONS. TYPE, GRO | DUP AND CLASS SELECTED TO BEST C | F DESIGN TEAM'S KNOWL | | | | | |


INFECTION CONTROL RISK ASSESSMENT (ICRA) LEGEND

| •••• •••• | LIMITS OF CONSTRUCTION |
|-----------------------------------|--|
| | 1 HOUR FIRE RATED ICRA / CONSTRUCTION BARRIER LOCATION, AND DOOR, WHERE SHOWN |
| | TEMPORARY NON-RATED (PLASTIC SHEETING) CONSTRUCTION BARRIER LOCATION, WHERE APPROVED BY THE VA FOR USE IN RISK TYPE B. UPGRADE TO 1 HOUR RATED PARTITION WHEN DIRECTED BY THE VA |

| | DRAWING TITLE SECOND FLOOR INFECTION CONTROL & PHASING PLAN | EHRM INFRASTRUCTURE UPGRADES | | | DATE: 03/30/2022 PLOT SCALE PROJECT NO. 656-21-235 | |
|--|---|--|------------|----------------------|--|--|
| | | BUILDING No | CHECKED BY | DRAWN BMW | DRAWING NO. 3-GI121 | |
| | | LOCATION VA MEDICAL C ST.CLOUD, MM | | FULLY SPRINKLERED | DWG. OF | |

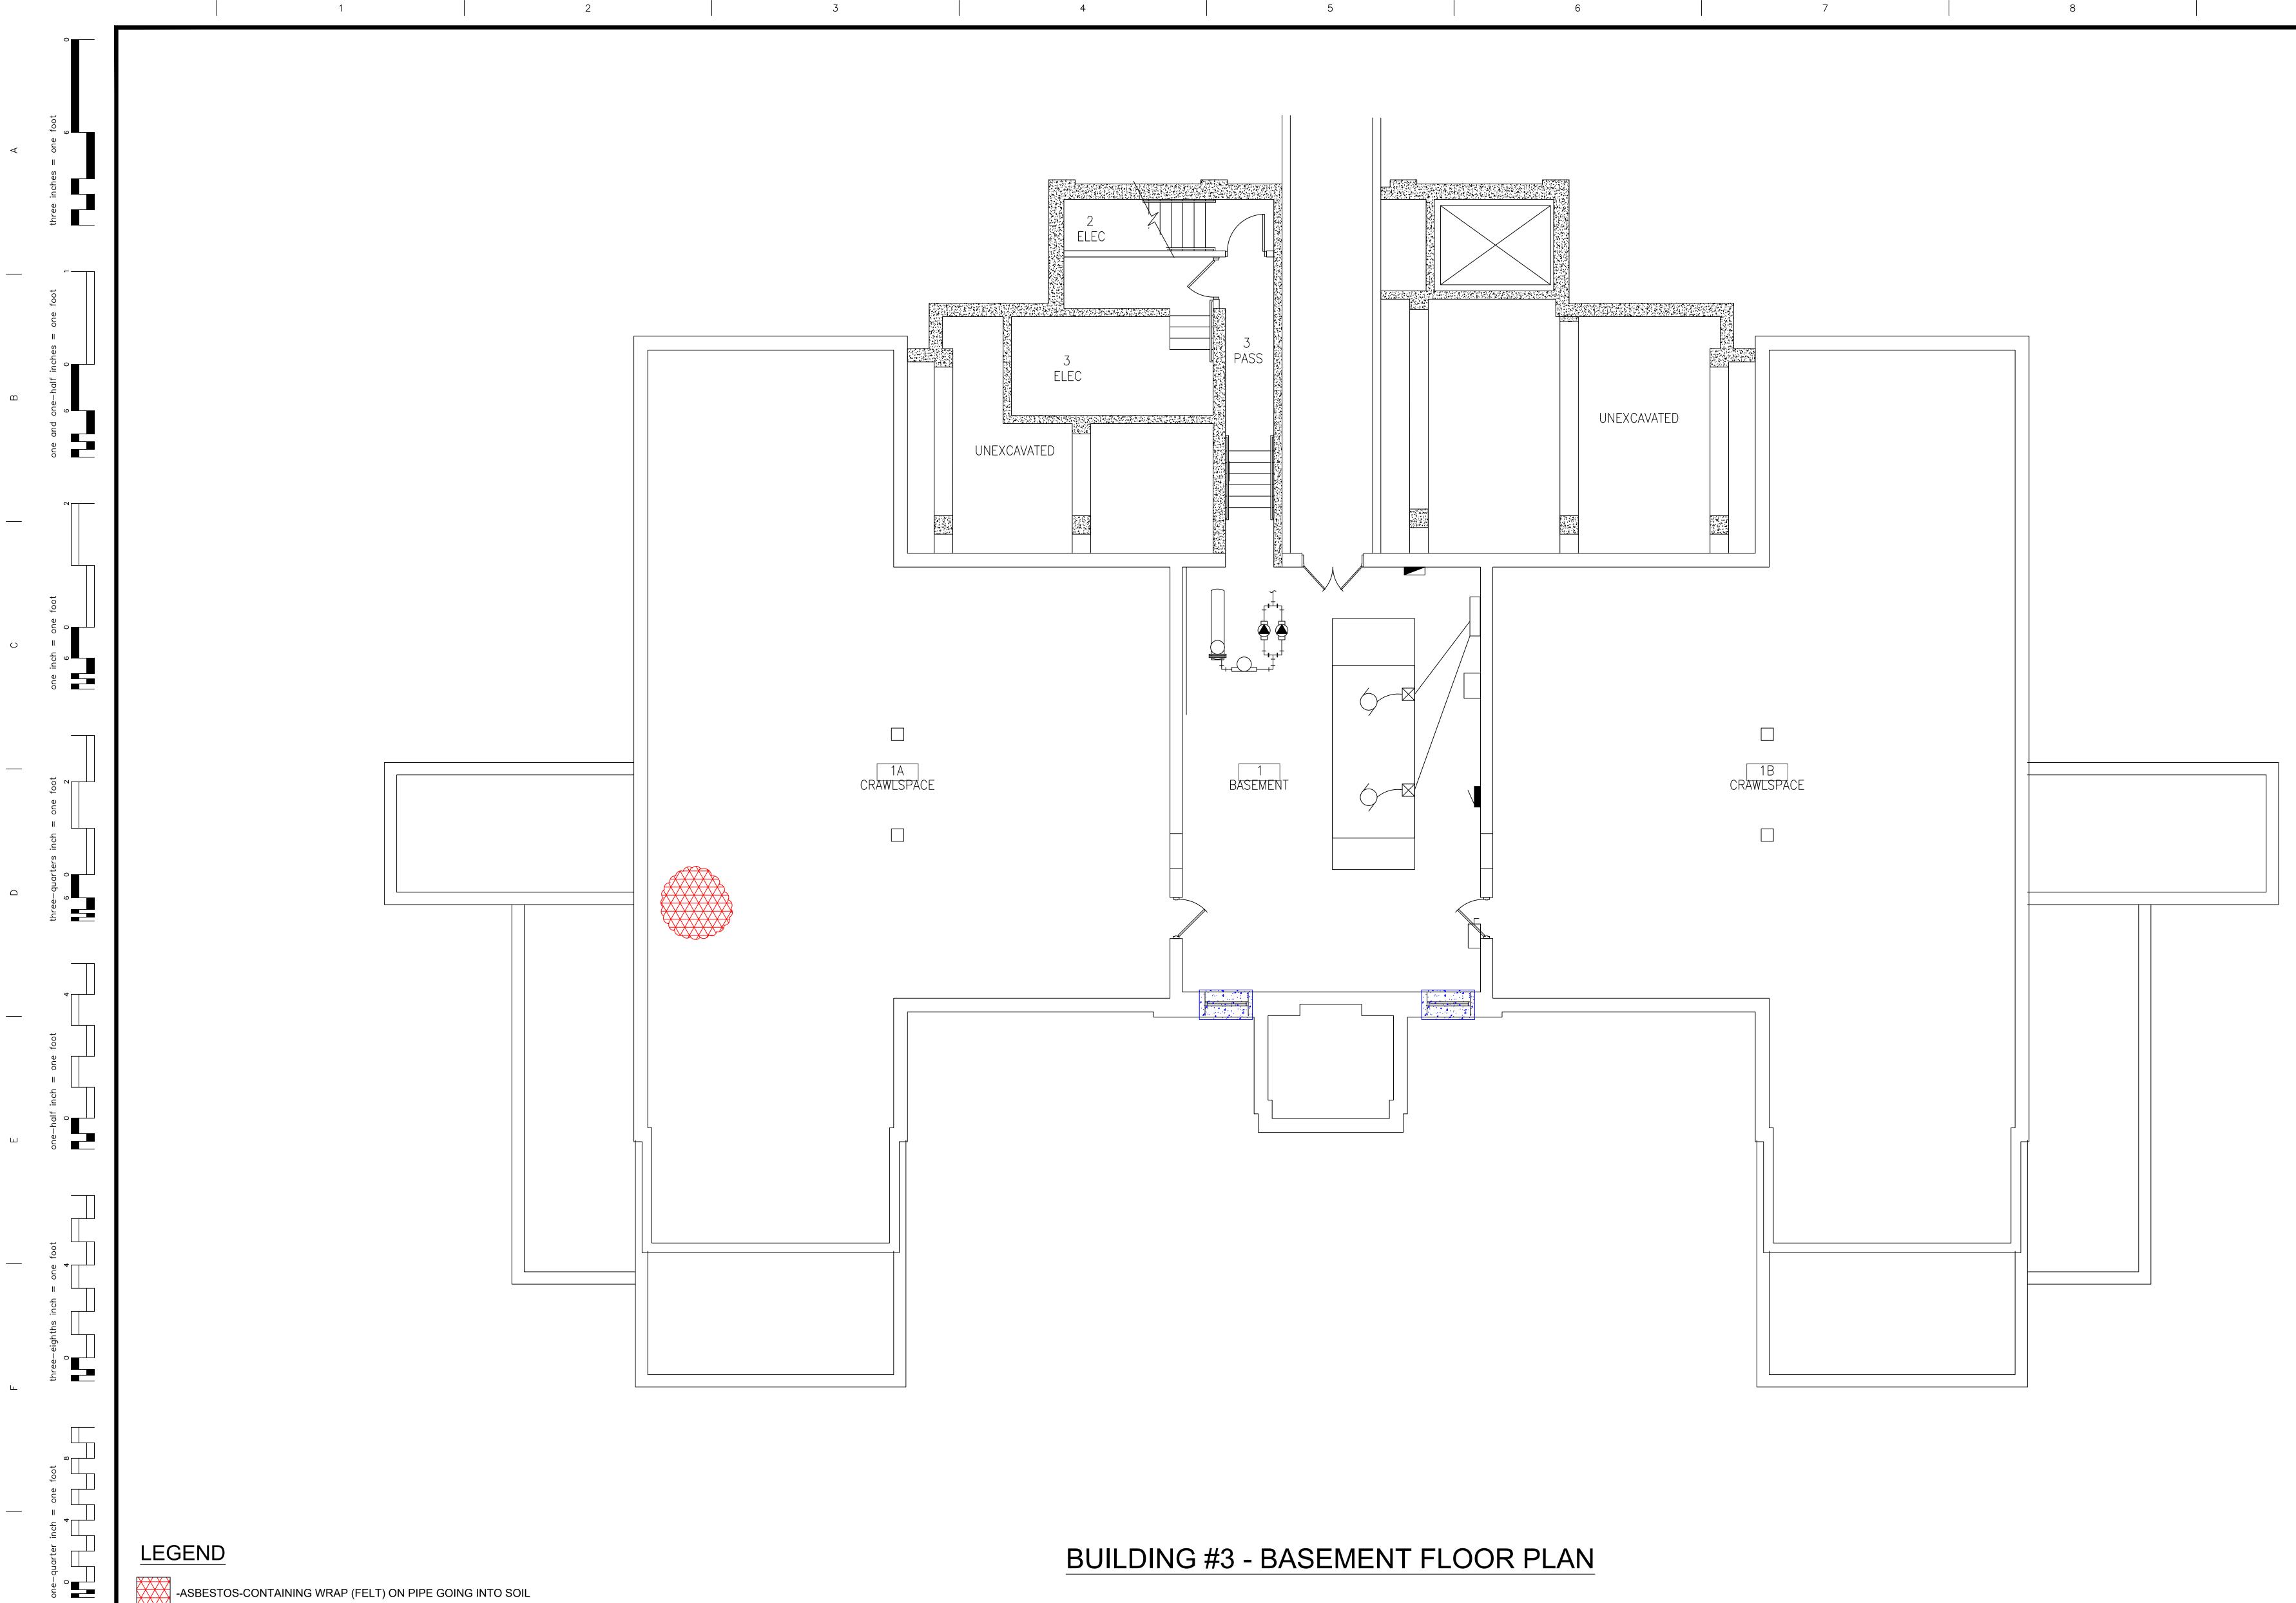DURE CLASS





 $\mathbf{X} \mathbf{X} \mathbf{X} \mathbf{X}$

Revisions

-ASBESTOS-CONTAINING WRAP (FELT) ON PIPE GOING INTO SOIL -ASBESTOS-CONTAINING WINDOW CAULK

Dates

1

ENVIRONMENTAL CONSULTANT: CASTLE HILL ASSOCIATES, LLC. 218–A MECHANIC STREET, WATERVILLE, OHIO 43566 Tel: (567) 952–0212




4

| North: | Drawing Title | Project Title | Date | | |
|--------|-----------------------------------|----------------------|--|--------------|-------------------------------------|
| Norm: | ARCHITECTURAL PLAN | | NOVEMBER 2019 | | |
| | BUILDING 3 Scale: 1/4" = 1'-0" | MEI | NS ADMINISTRA DICAL CENTER .OUD, MINNESC | | Project No. 36C26319P1003 |
| | Approved : Division Chief | Building Number | Checked BLB | Drawn AFS | Drawing No. |
| | Approved : Service Director | ST. CLOUD, MINNESOTA | | OTA | 1 A Sheet 09 of 71 |






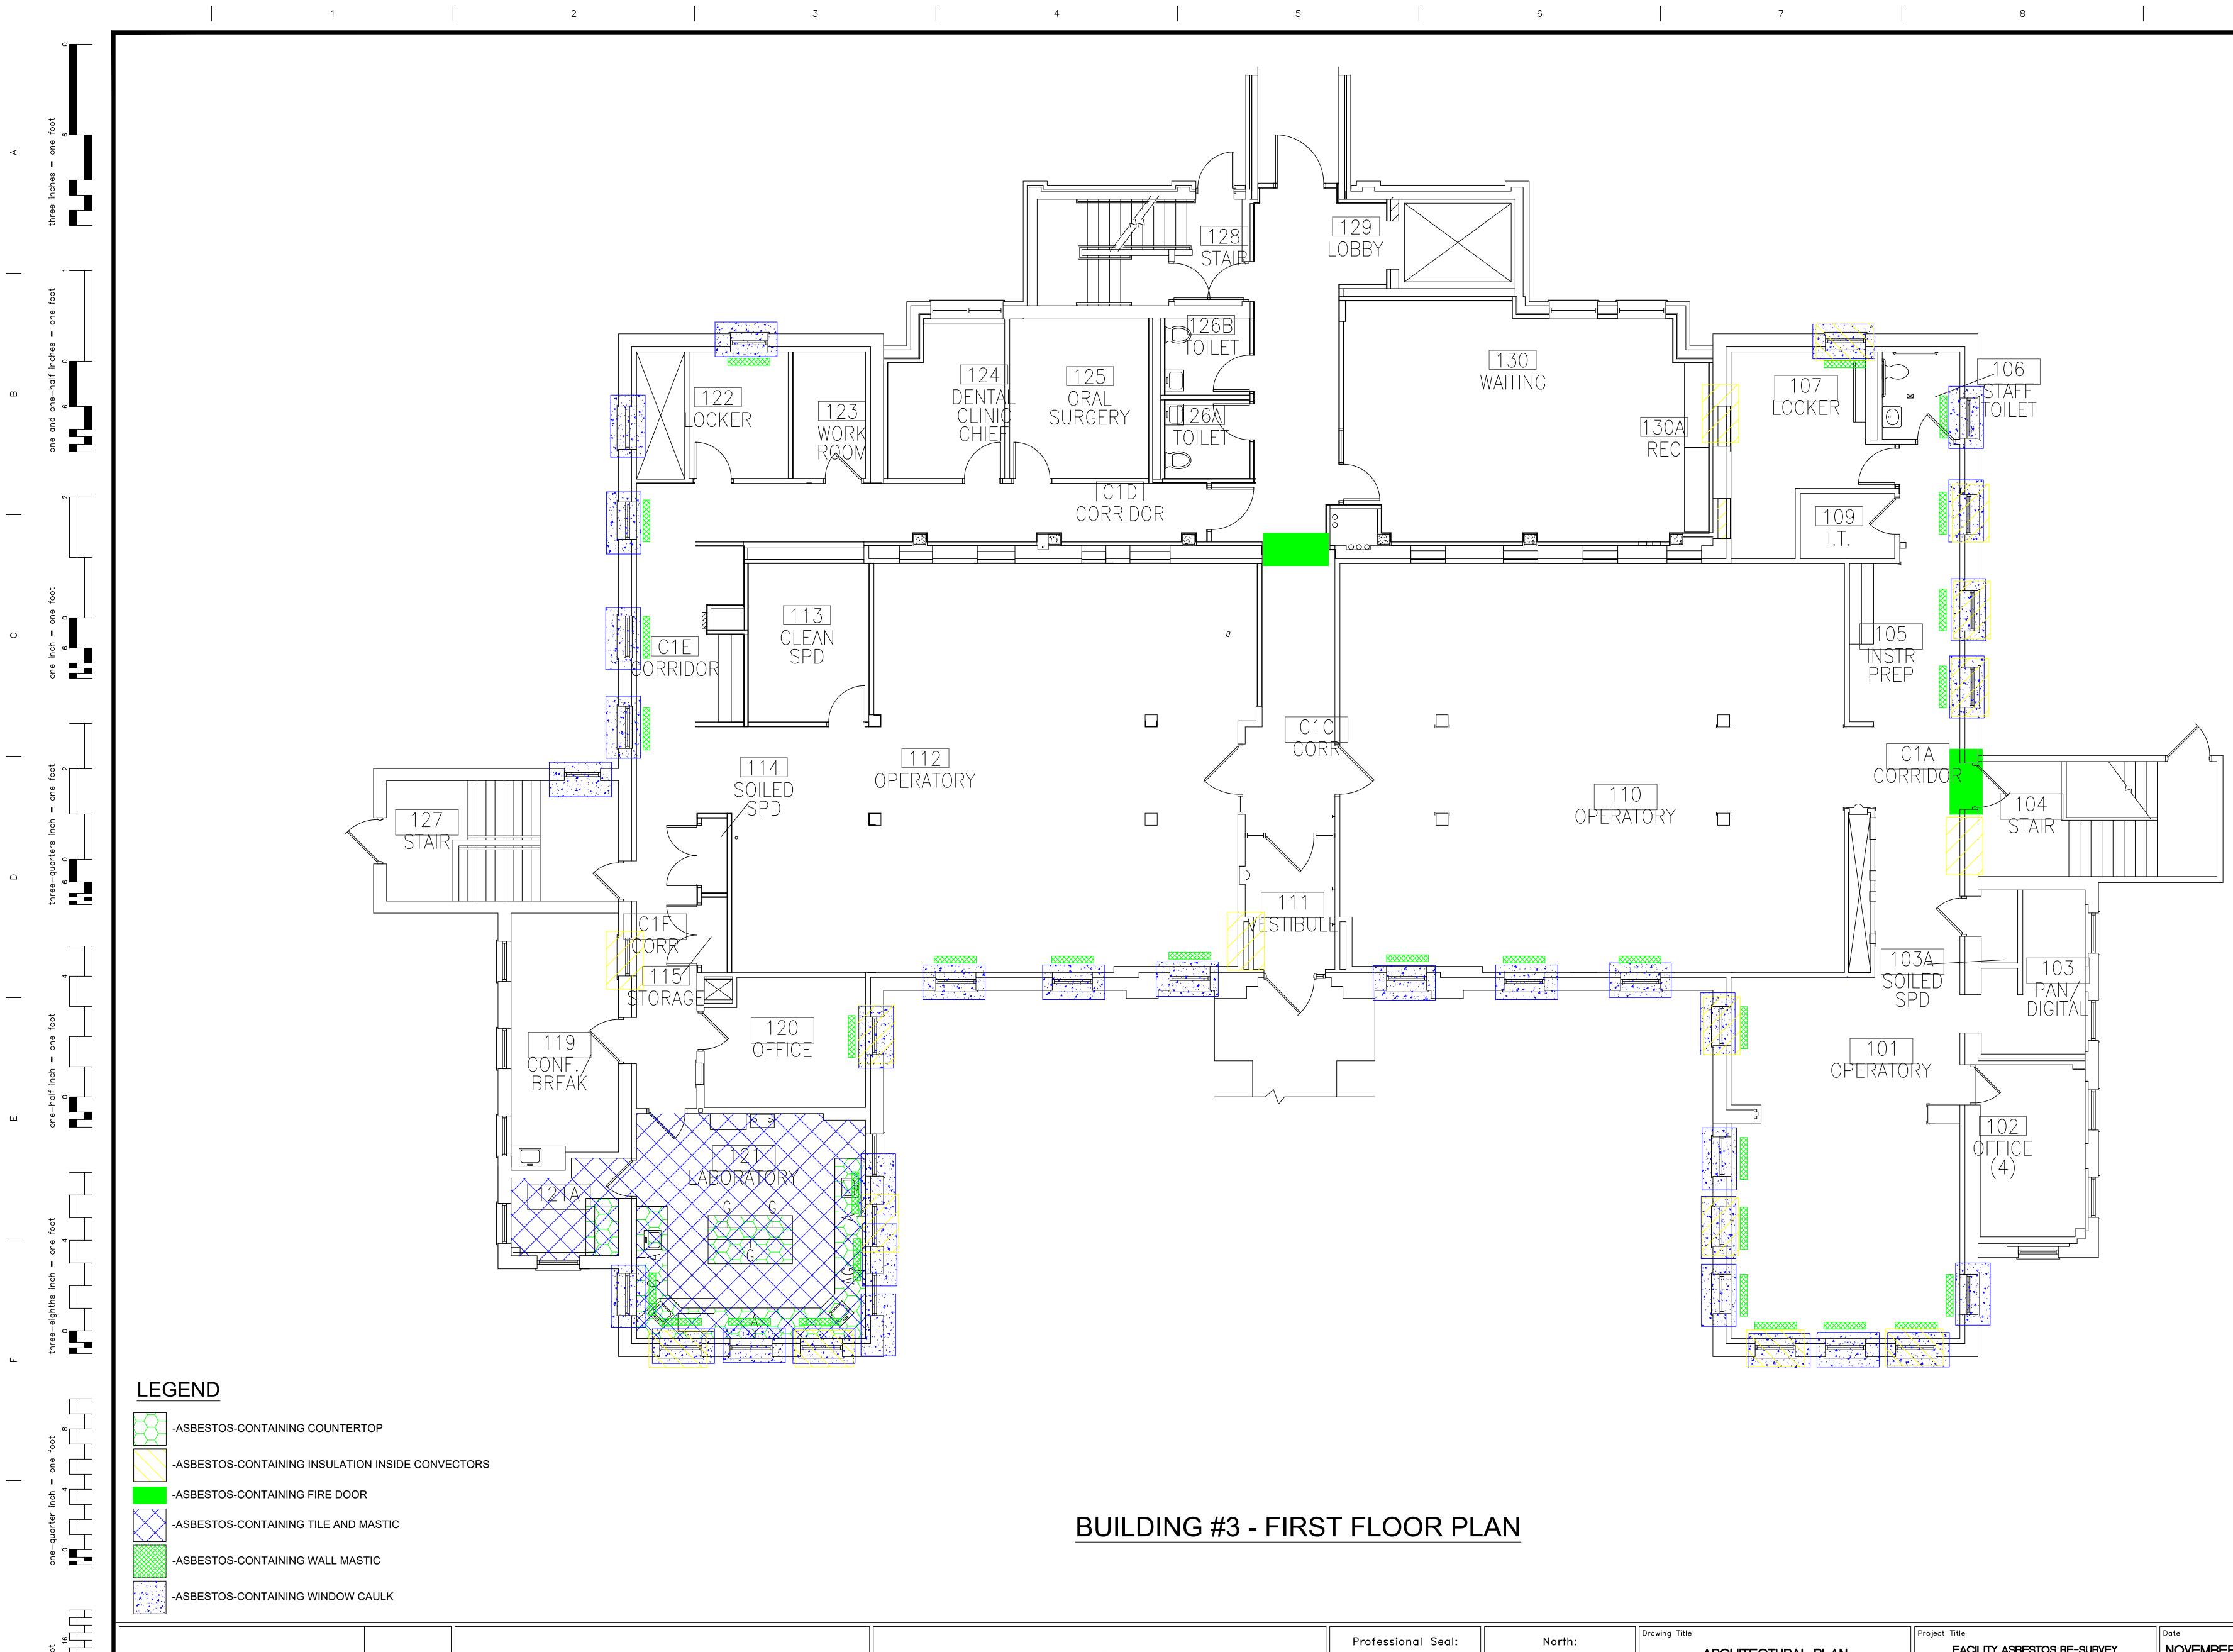

ENVIRONMENTAL CONSULTANT: CASTLE HILL ASSOCIATES, LLC. 218-A MECHANIC STREET, WATERVILLE, OHIO 43566 Tel: (567) 952-0212

Dates

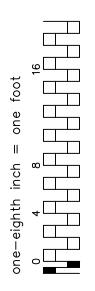1




Revisions



| North: | Drawing Title ARCHITECTURAL PLAN | Project Title FACILITY ASB VETERANS | Date NOVEMBER 2019 | | | |
|--------|-------------------------------------|---|-----------------------|--------------|-------------------------------------|--|
| | BUILDING 3 Scale: 1/4" = 1'-0" | MEDICAL CENTER ST. CLOUD, MINNESOTA | | | Project No. 36C26319P1003 | |
| | Approved : Division Chief | Building Number 003 | Checked BLB | Drawn AFS | Drawing No. | |
| S | Approved : Service Director | ST. CLOUD, MINNESOTA | | | CA Sheet 10 of 71 | |
| 0 | | | 2 | l | <u>^</u> | |






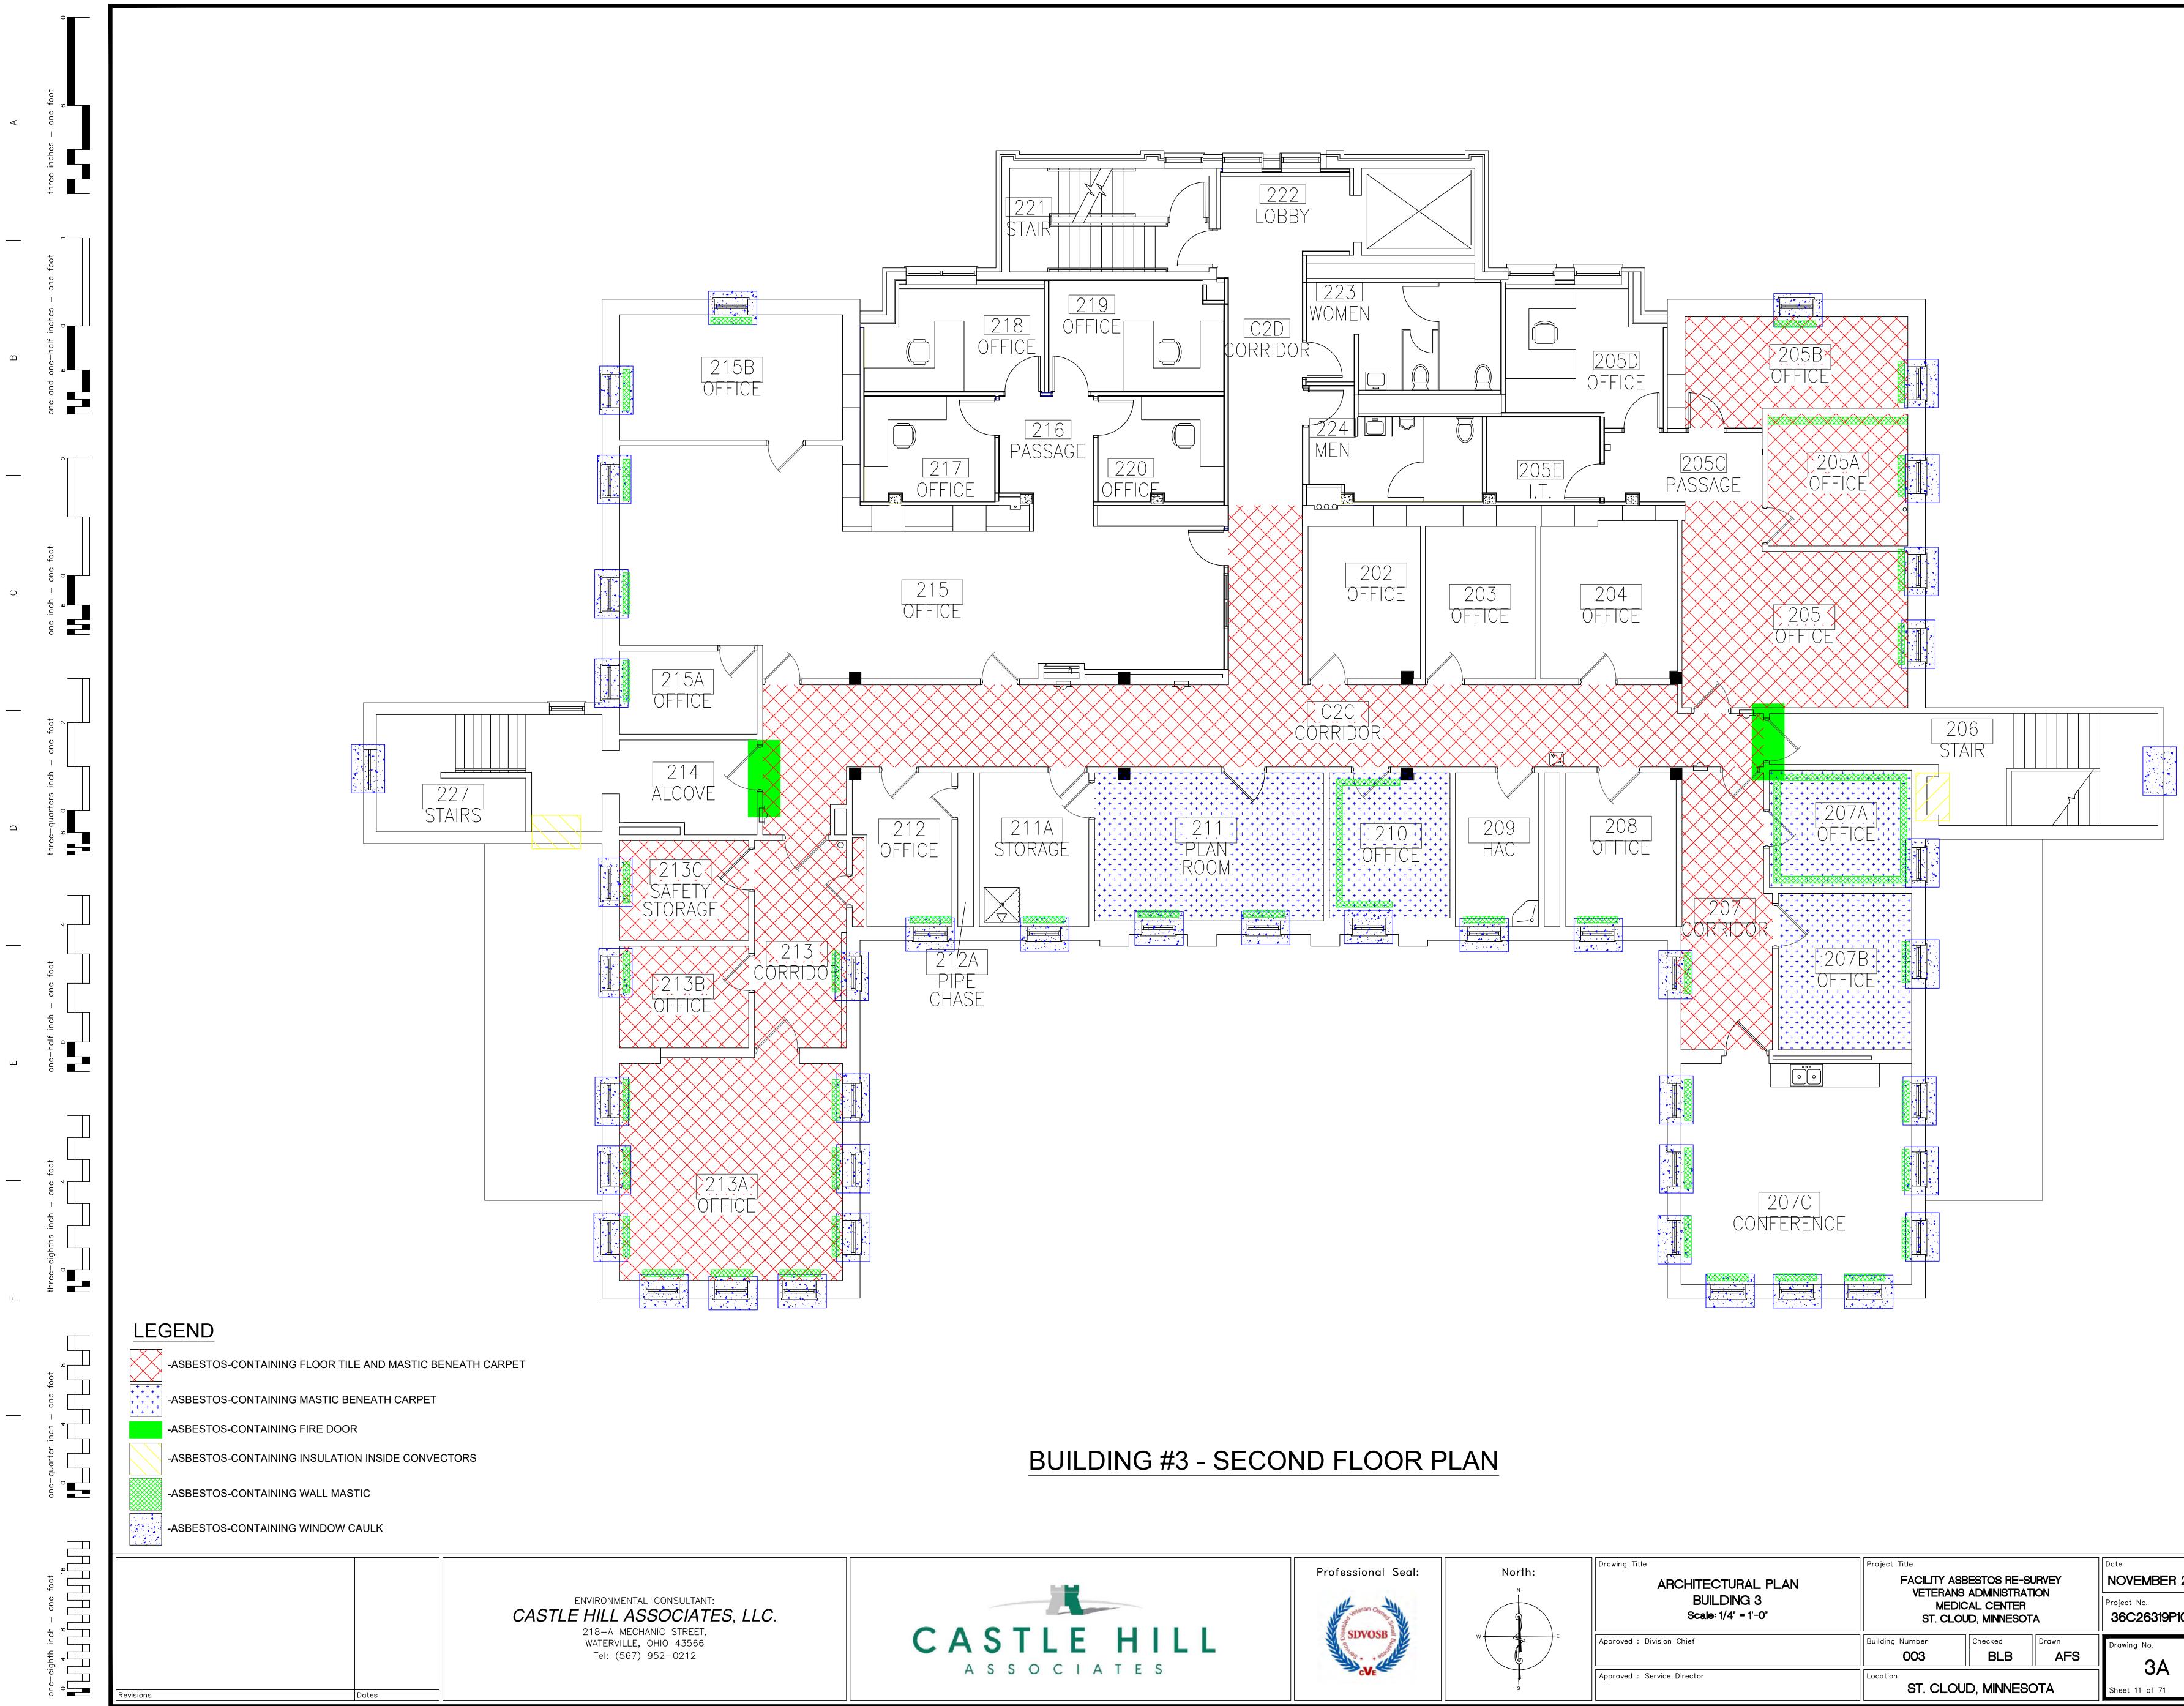

| North | Drawing Title | Project Title | Date NOVEMBER 2019 | | | |
|-------------|-----------------------------------|----------------------|---|--------------|-----------------------------|--|
| North: ∾ | ARCHITECTURAL PLAN | | | | | |
| W | BUILDING 3 Scale: 1/4" = 1'-0" | MEI | VETERANS ADMINISTRATION MEDICAL CENTER ST. CLOUD, MINNESOTA | | | |
| | Approved : Division Chief | Building Number | Checked BLB | Drawn AFS | Drawing No. | |
| | Approved : Service Director | ST. CLOUD, MINNESOTA | | | 3A Sheet 11 of 71 | |






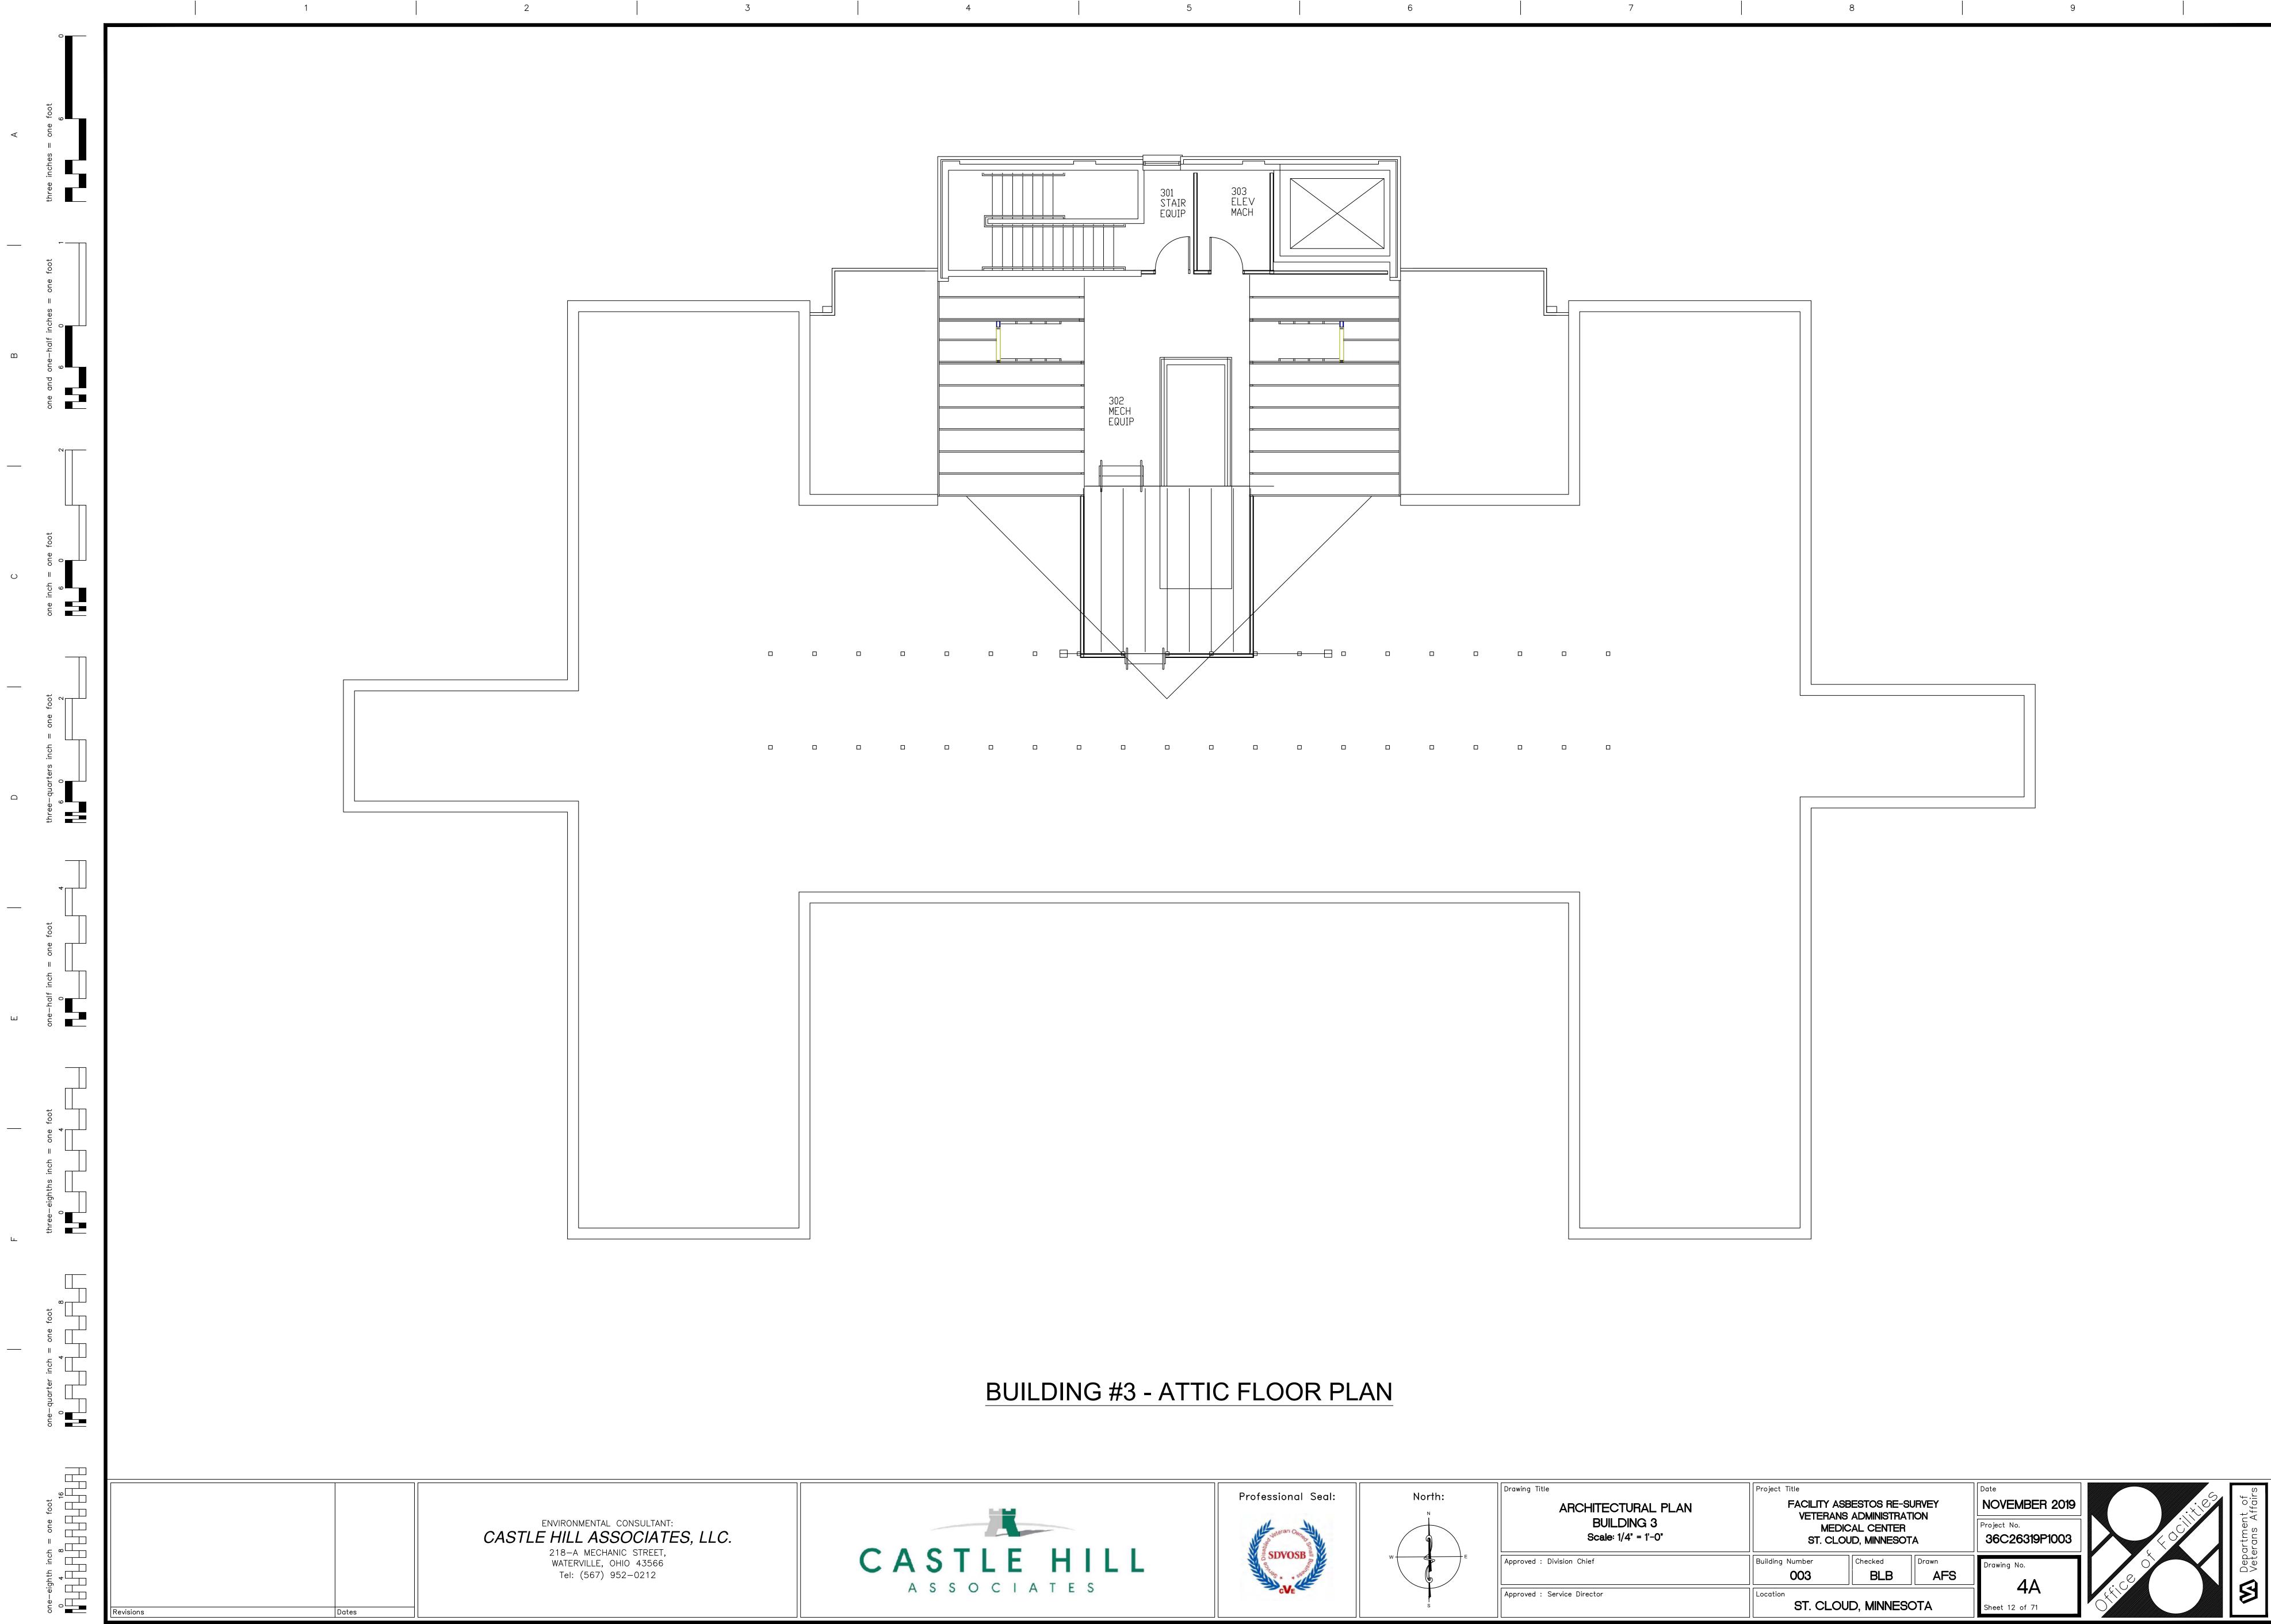

| North: | Drawing Title ARCHITECTURAL PLAN | Project Title FACILITY ASE VETERANS | NOVEMBER 2019 | | |
|--------|-------------------------------------|---|-------------------------------------|--------------|-----------------------------|
| | BUILDING 3 Scale: 1/4" = 1'-0" | MEDIC ST. CLOU | Project No. 36C26319P1003 | | |
| W E | Approved : Division Chief | Building Number 003 | Checked BLB | Drawn AFS | Drawing No. |
| s | Approved : Service Director | Location ST. CLOU | D, MINNES | OTA | 4A Sheet 12 of 71 |
| | | | | Í | |



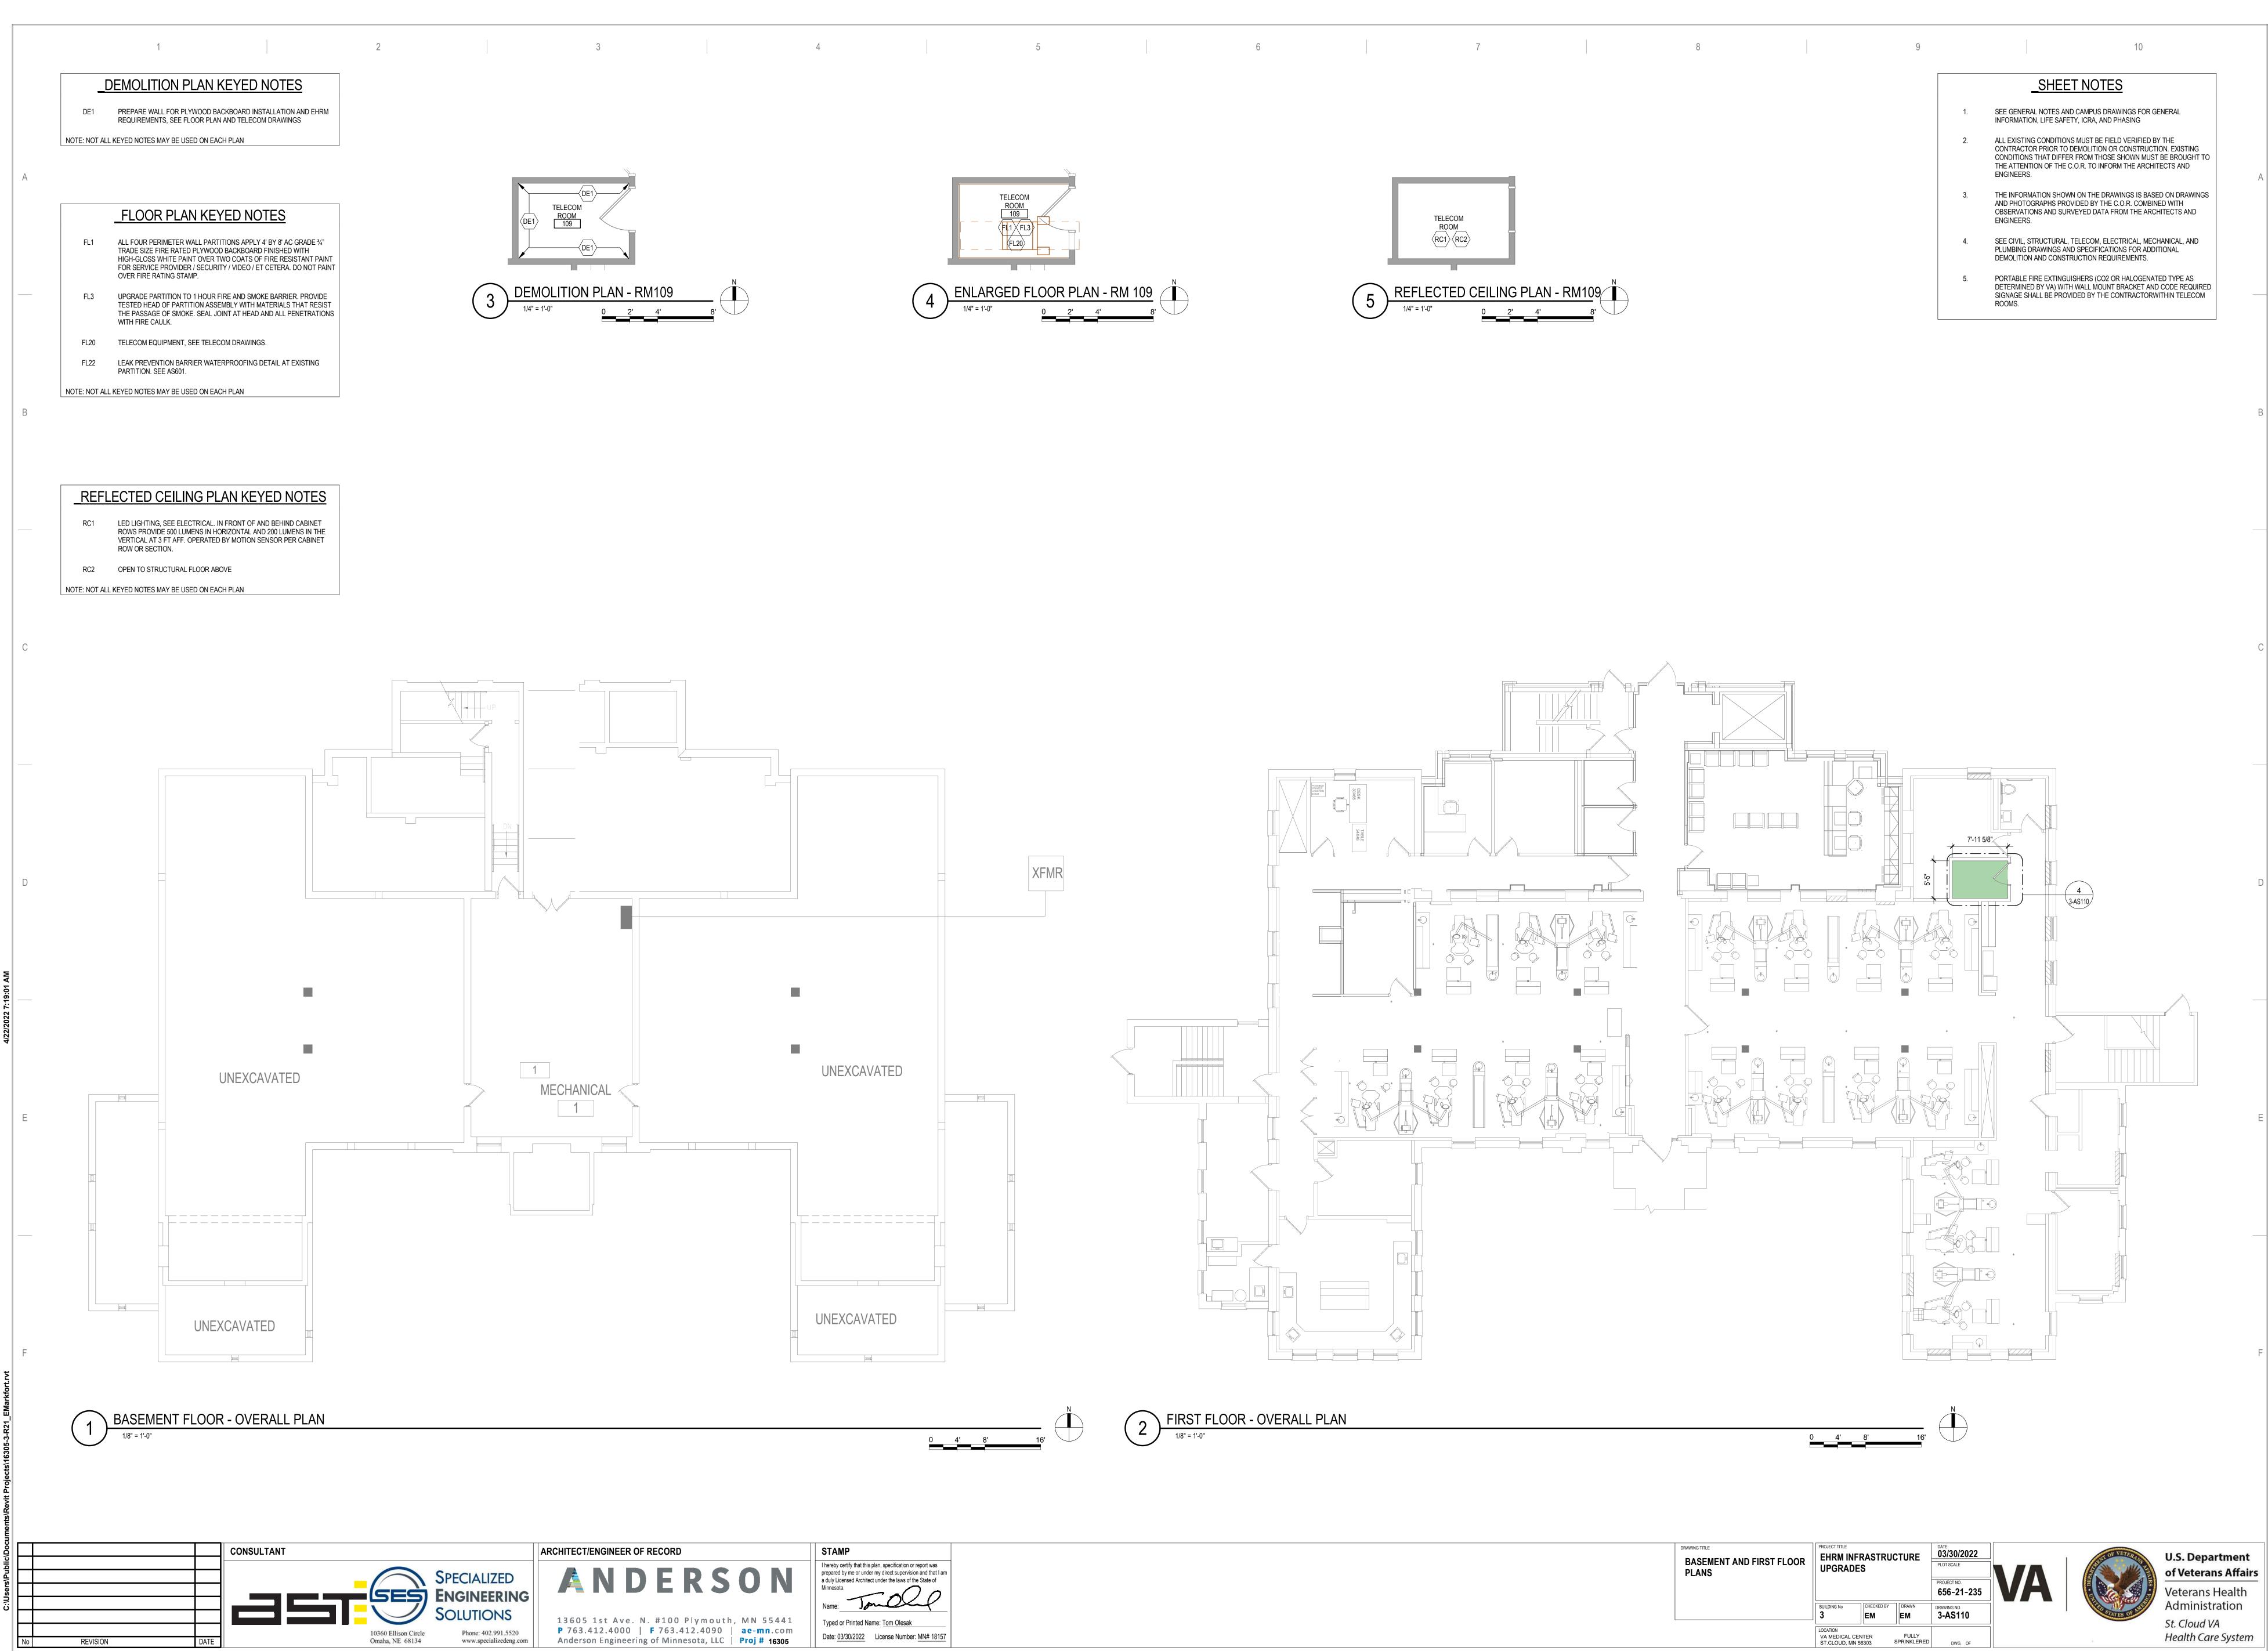


| DRAWING TITLE BASEMENT AND FIRST FLOOR PLANS | PROJECT TITLE EHRM INFRASTRUCTURE UPGRADES | | CTURE 03/30/2022 PLOT SCALE PROJECT NO. 656-21-235 | | VA |
|--|--|------------|--|------------------------|----|
| | BUILDING No | CHECKED BY | DRAWN EM | DRAWING NO. 3-AS110 | |
| | LOCATION VA MEDICAL CEI ST.CLOUD, MN 5 | | FULLY SPRINKLERED | DWG. OF | |









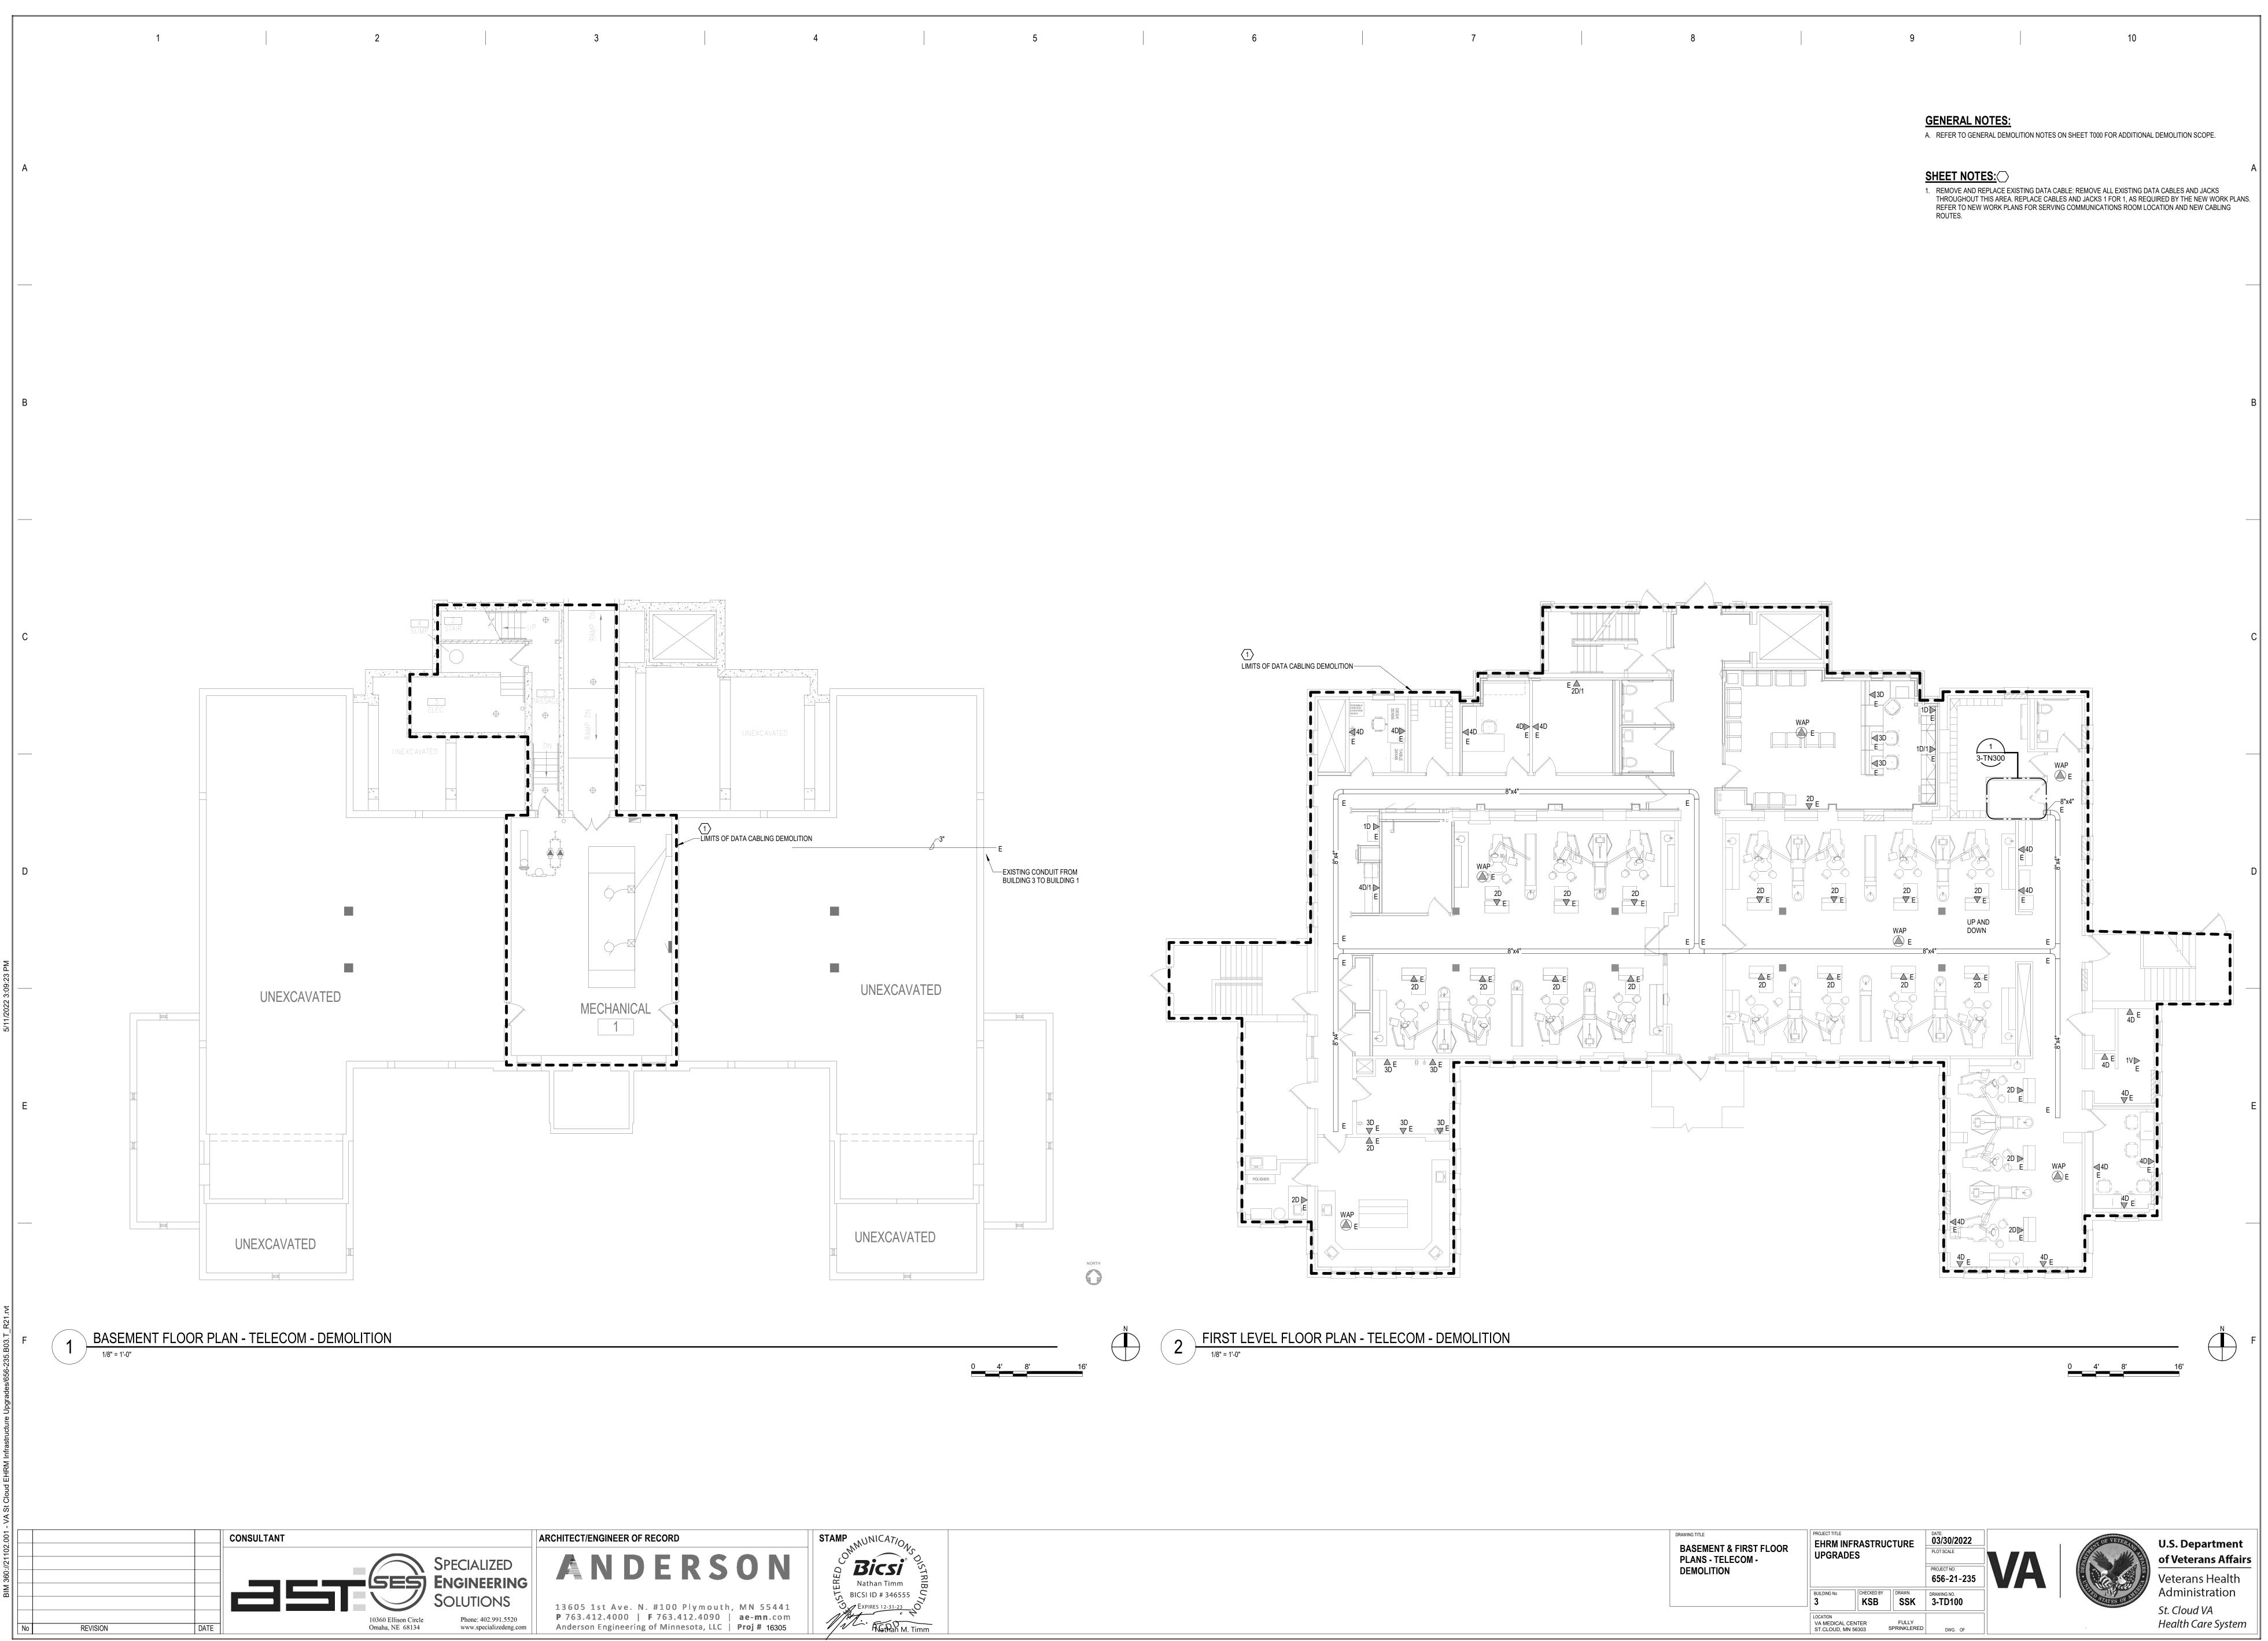


| DRAWING TITLE BASEMENT & FIRST FLOOR PLANS - TELECOM - DEMOLITION | EHRM INF | | CTURE | DATE: 03/30/2022 PLOT SCALE PROJECT NO. 656-21-235 | VA |
|--|---|------------|----------------------|--|----|
| | BUILDING No 3 | CHECKED BY | DRAWN SSK | DRAWING NO. 3-TD100 | |
| | LOCATION VA MEDICAL CE ST.CLOUD, MN | | FULLY SPRINKLERED | DWG. OF | |

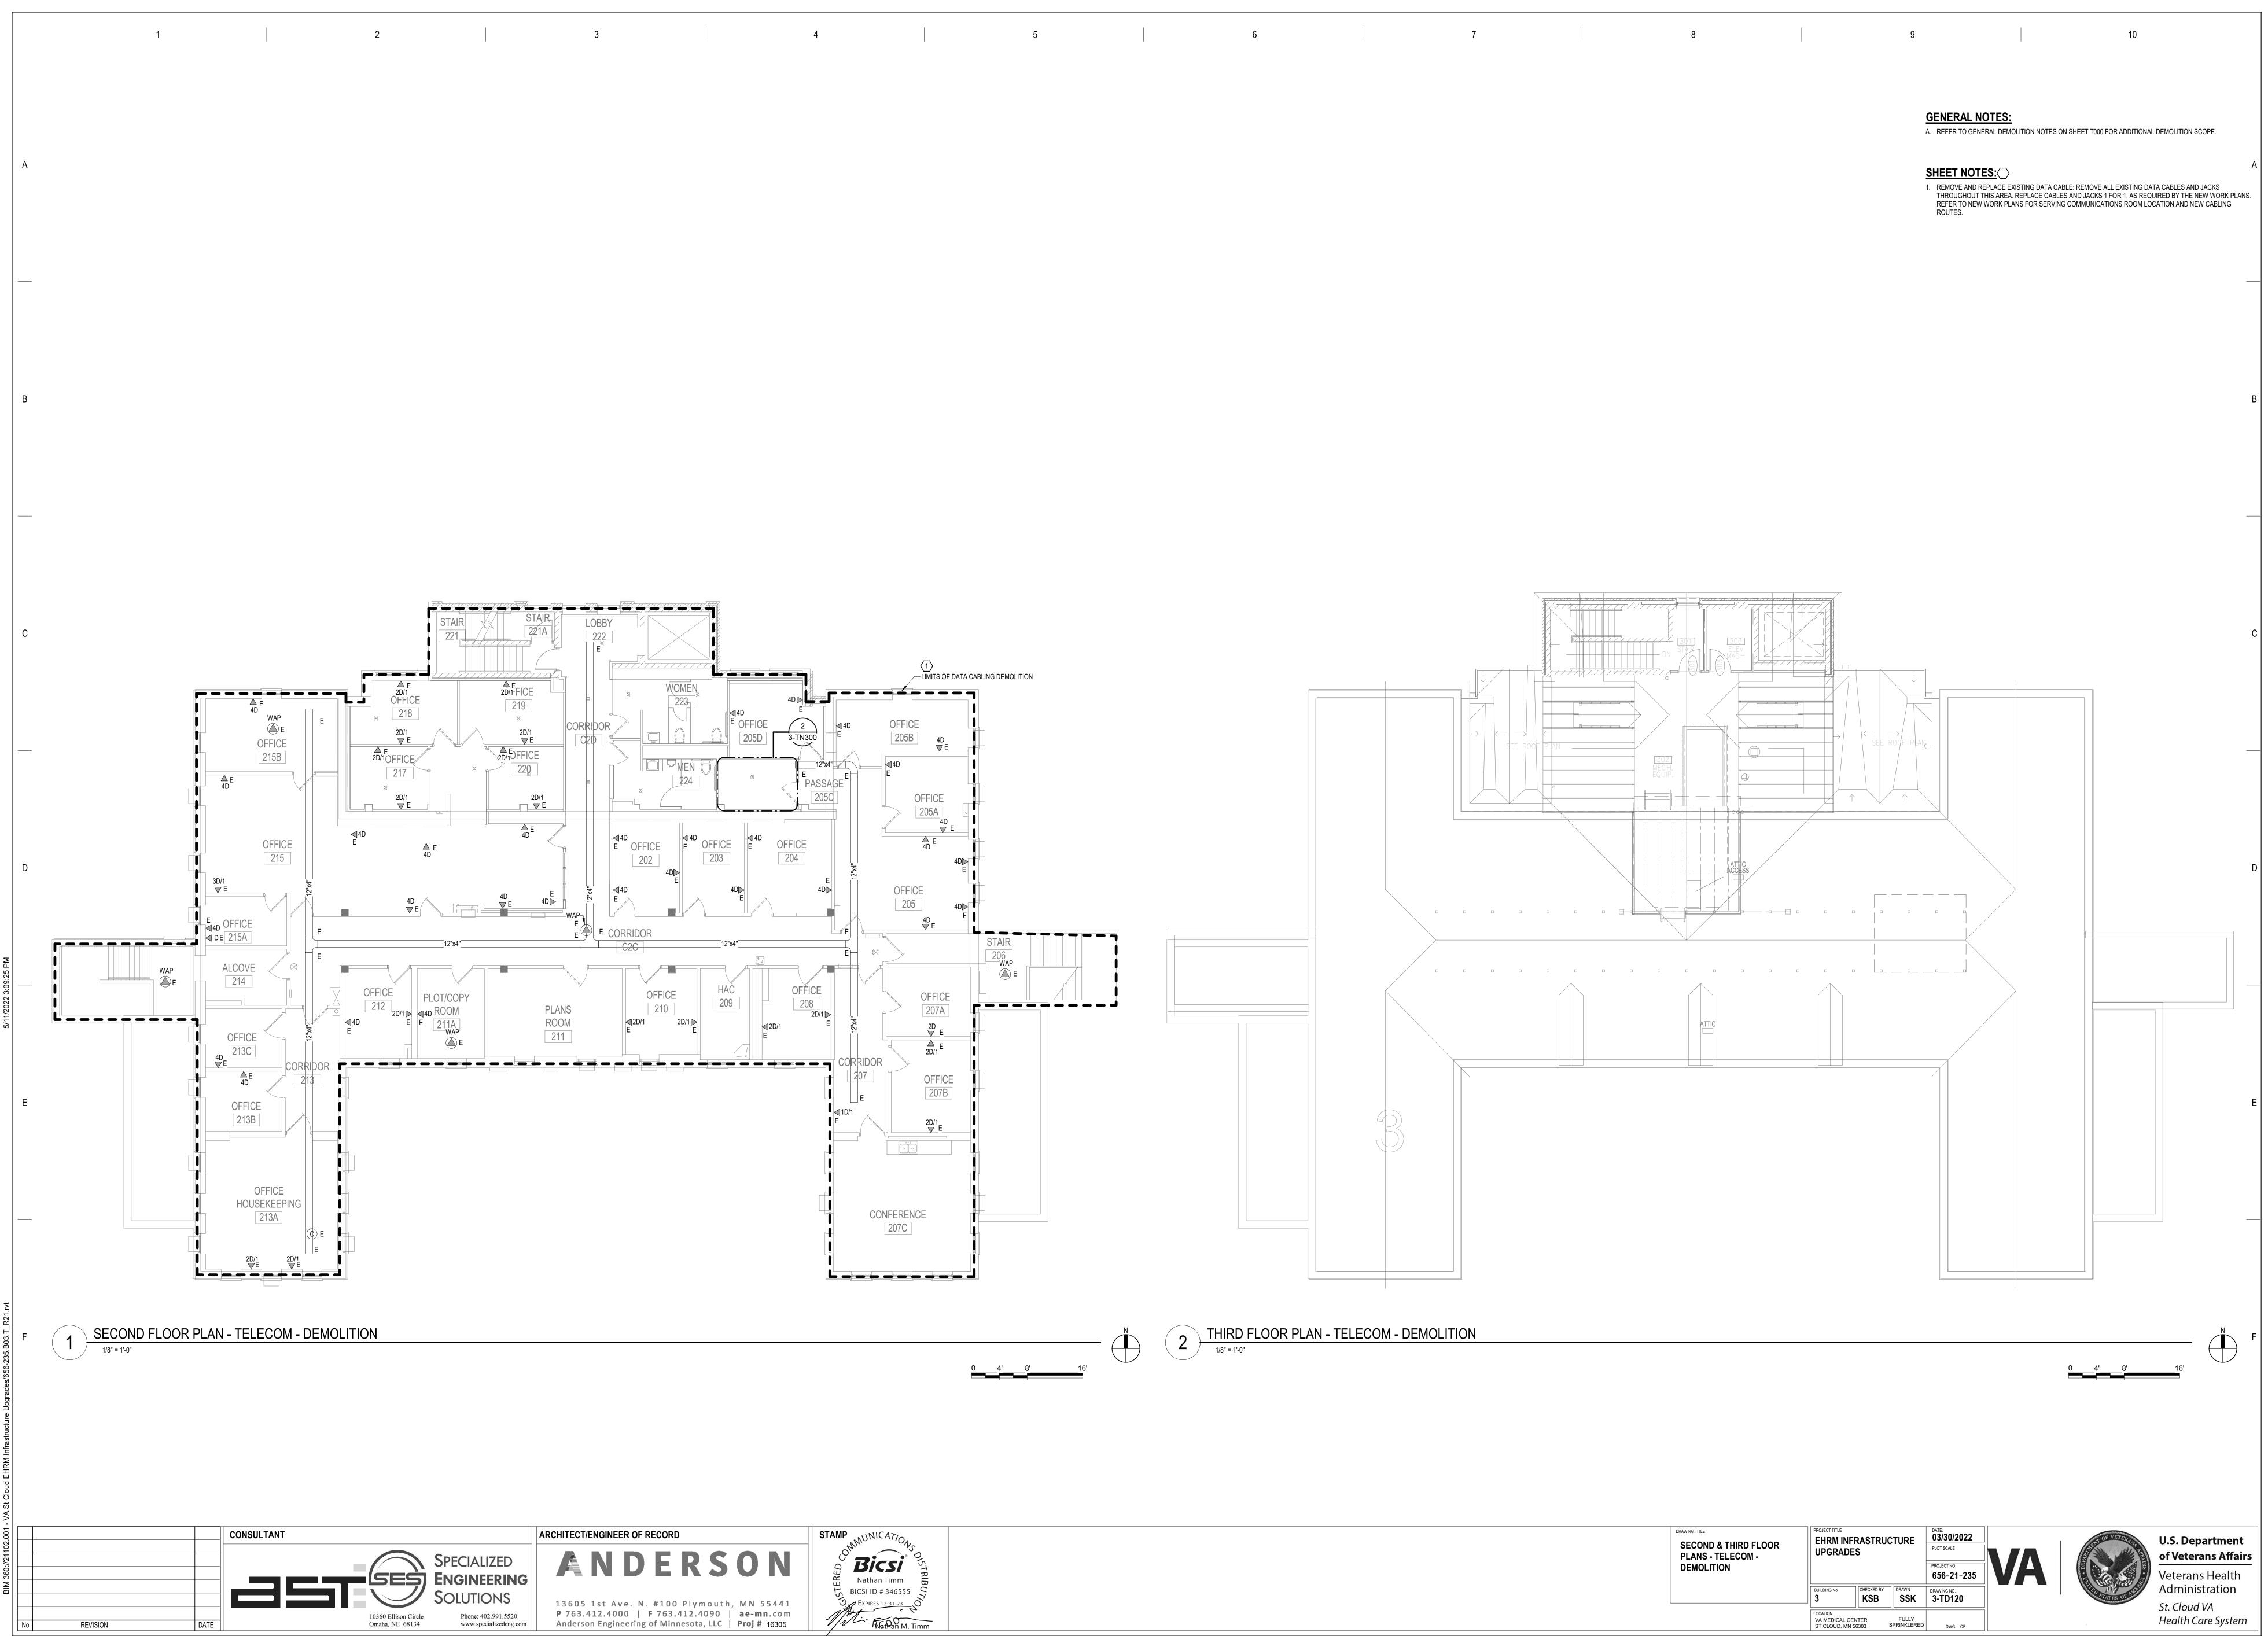


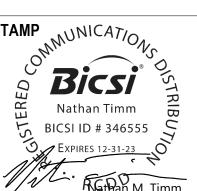

| DRAWING TITLE SECOND & THIRD FLOOR | PROJECT TITLE EHRM INF UPGRADE | | CTURE | DATE: 03/30/2022 PLOT SCALE | |
|---------------------------------------|---|------------|--------------|-----------------------------------|----|
| PLANS - TELECOM - DEMOLITION | OFGRAD | | | | VA |
| | BUILDING No 3 | CHECKED BY | DRAWN SSK | DRAWING NO. 3-TD120 | |
| | LOCATION VA MEDICAL CE ST.CLOUD, MN | | FULLY | DWG. OF | |

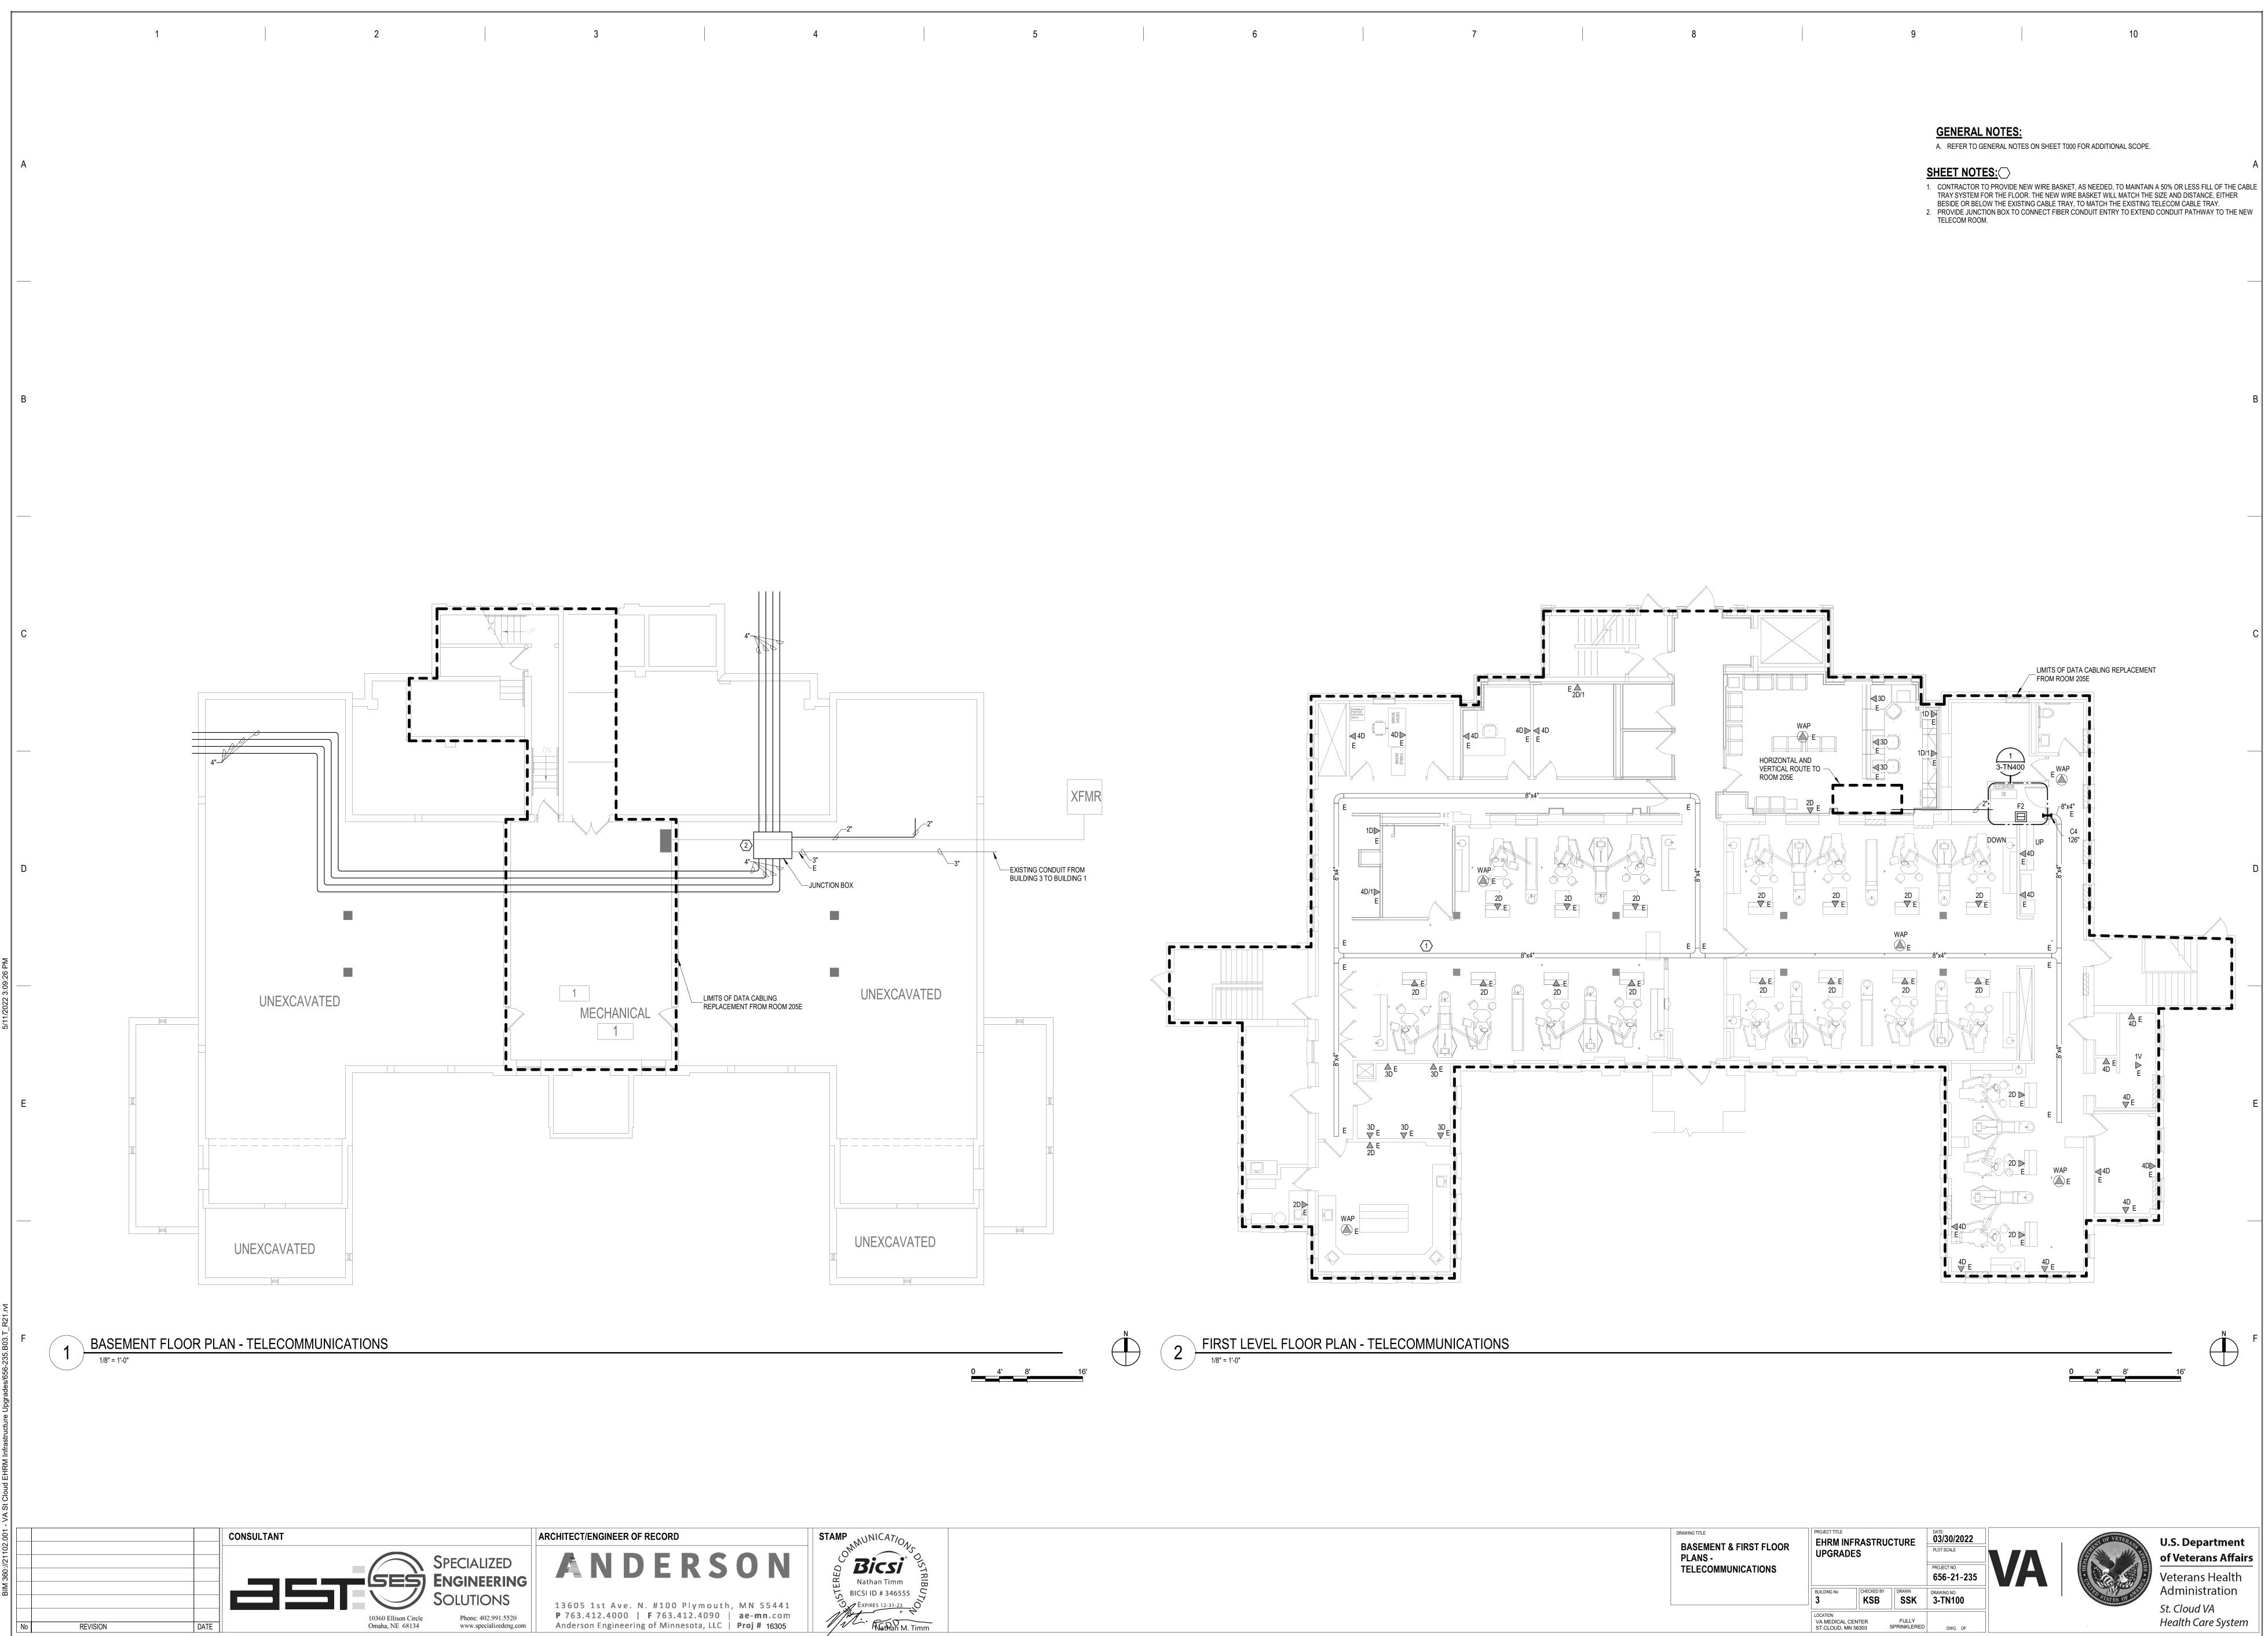



| DRAWING TITLE BASEMENT & FIRST FLOOR PLANS - TELECOMMUNICATIONS | | EHRM INF | | CTURE | DATE: 03/30/2022 PLOT SCALE PROJECT NO. 656-21-235 | VA |
|--|--|--|------------|----------------------|--|----|
| | | BUILDING No | CHECKED BY | DRAWN SSK | drawing no. 3-TN100 | |
| | | LOCATION VA MEDICAL C ST.CLOUD, MN | | FULLY SPRINKLERED | DWG. OF | |

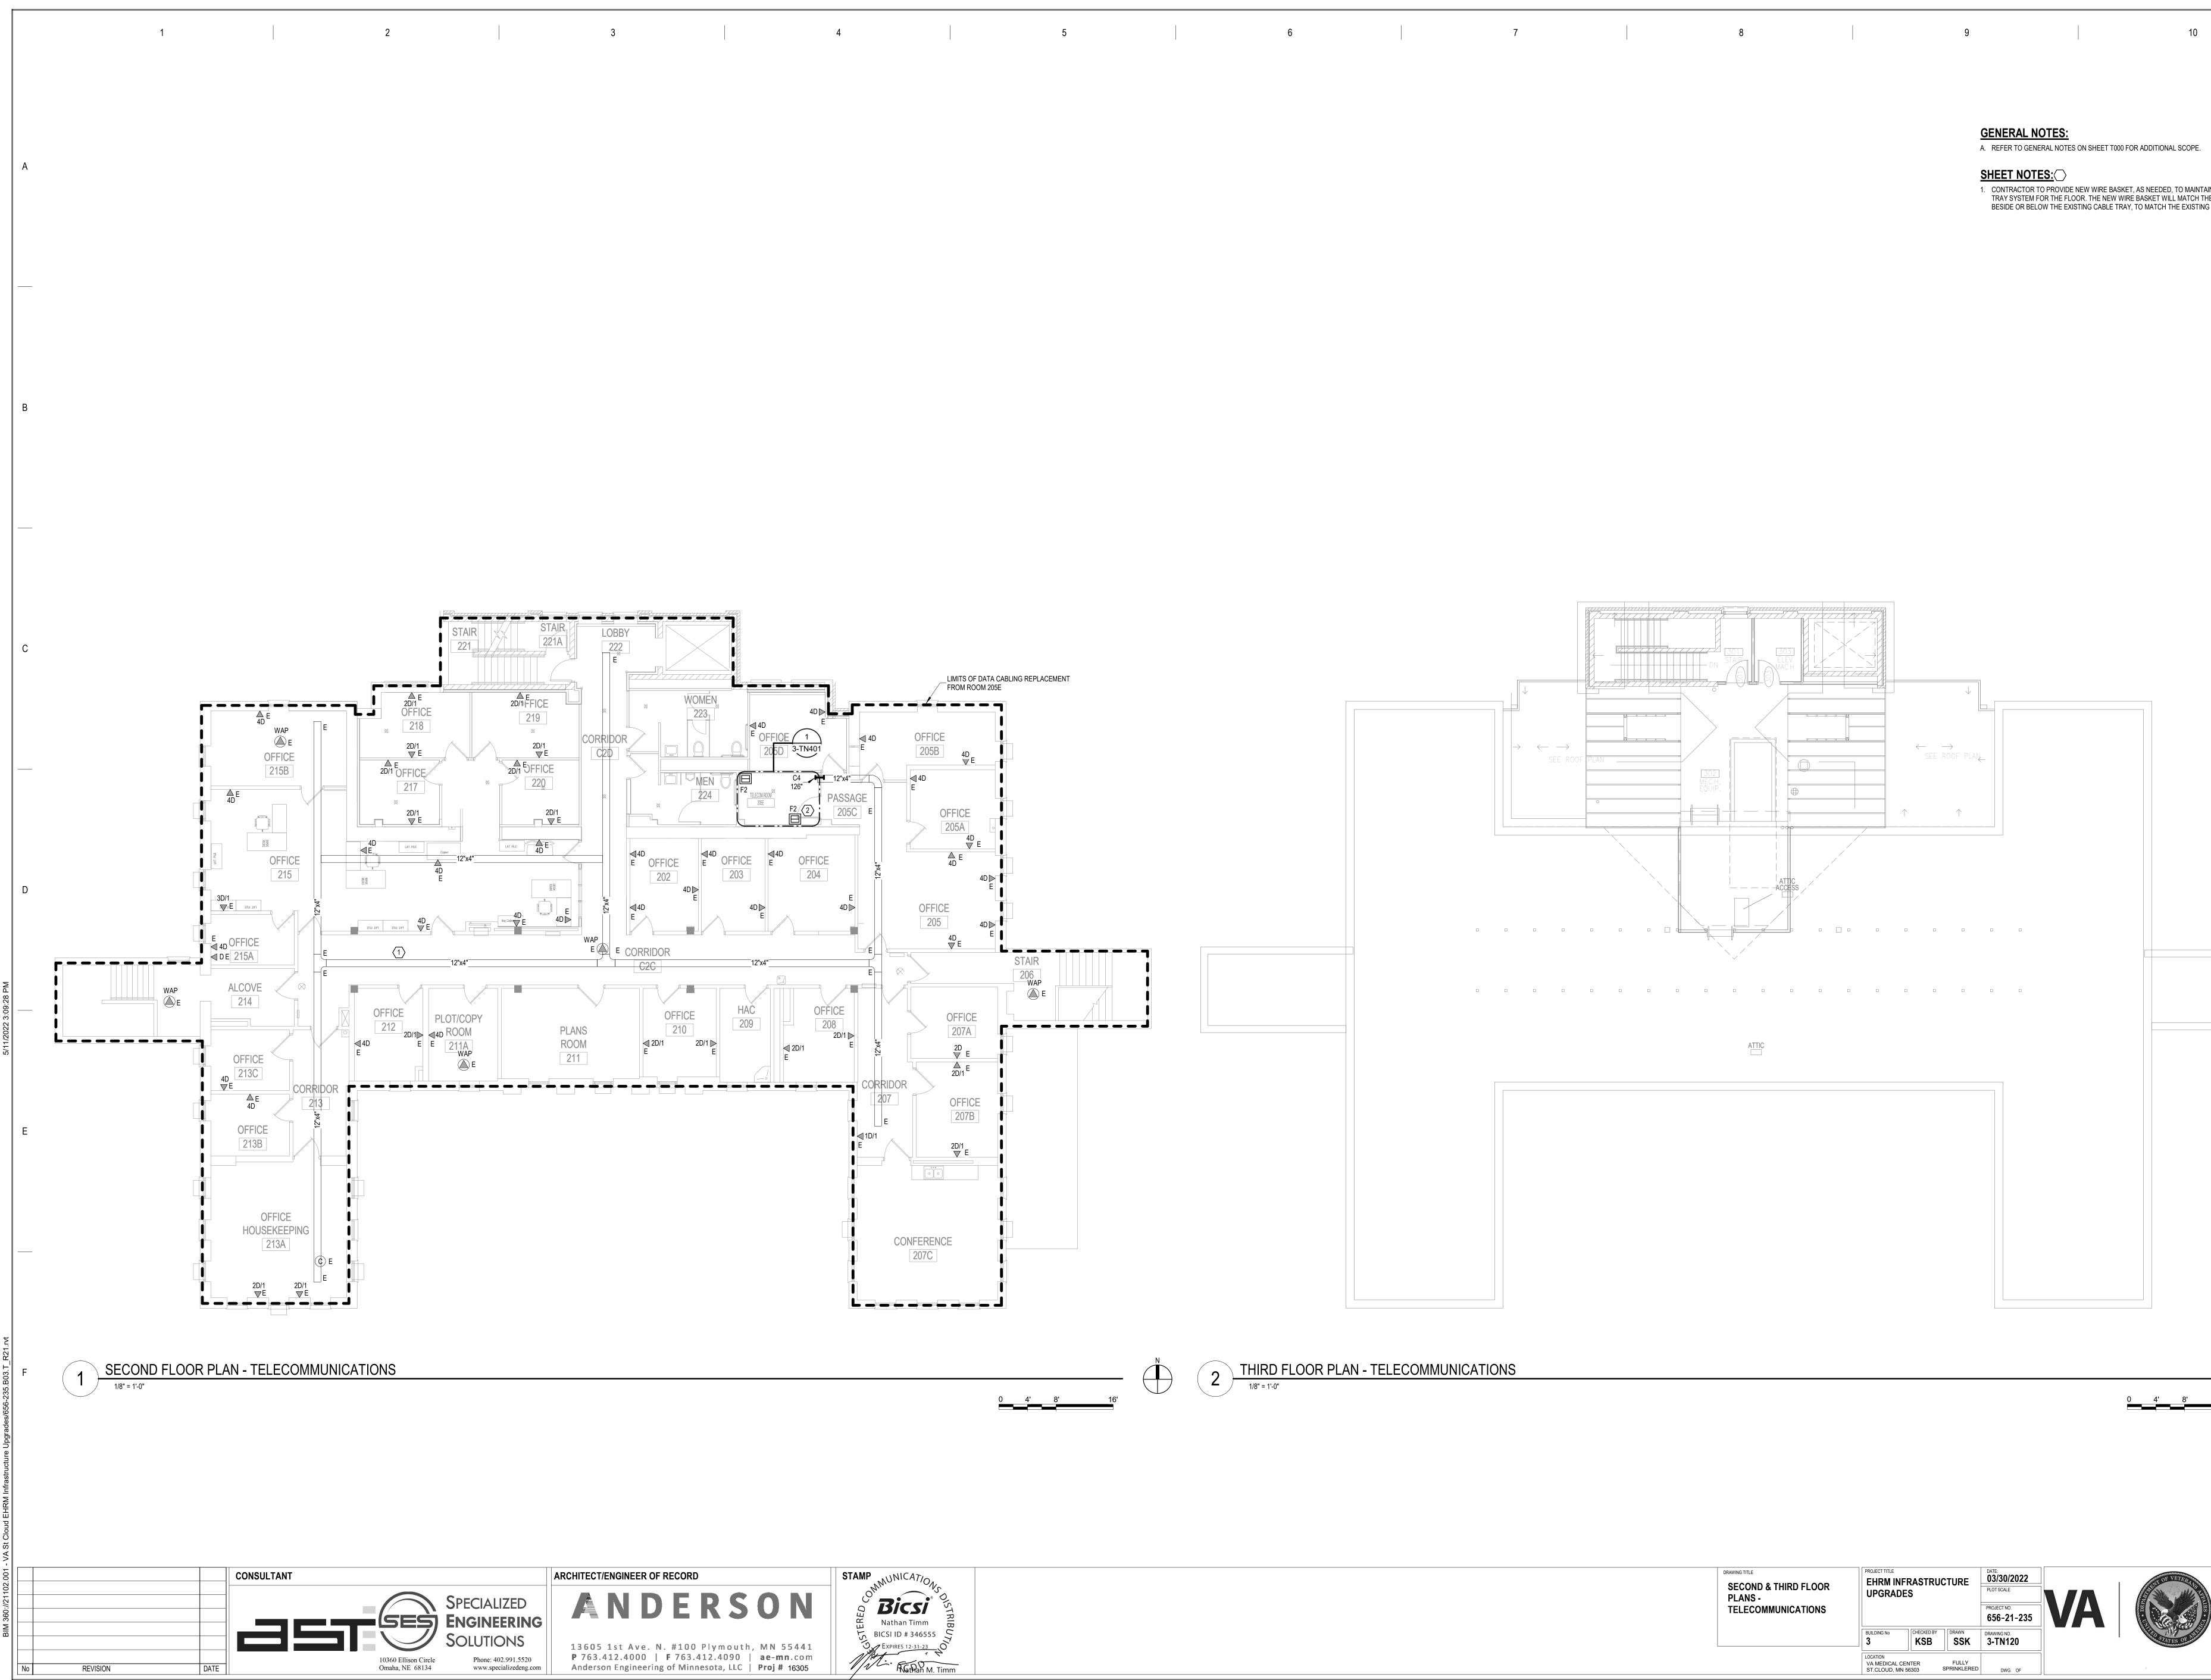




| DRAWING TITLE SECOND & THIRD FLOOR PLANS - TELECOMMUNICATIONS | | EHRM INFRASTRUCTURE UPGRADES | | DATE: 03/30/2022 PLOT SCALE PROJECT NO. 656-21-235 | VA |
|--|---|---------------------------------|----------------------|--|----|
| | BUILDING No 3 | CHECKED BY | DRAWN SSK | drawing no. 3-TN120 | |
| | LOCATION VA MEDICAL CE ST.CLOUD, MN | | FULLY SPRINKLERED | DWG. OF | |

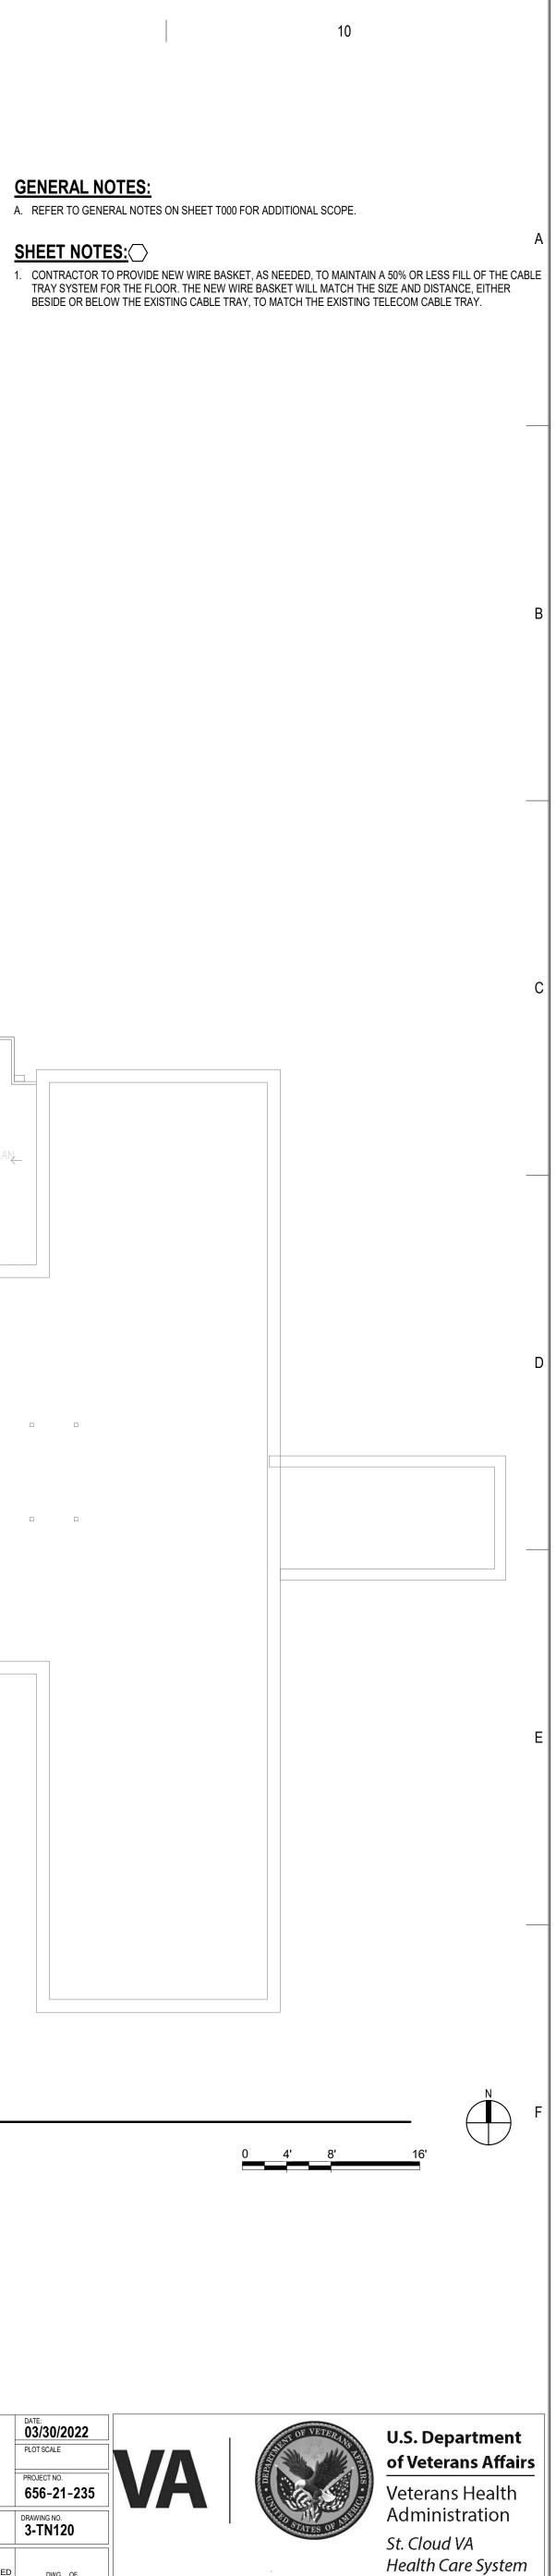

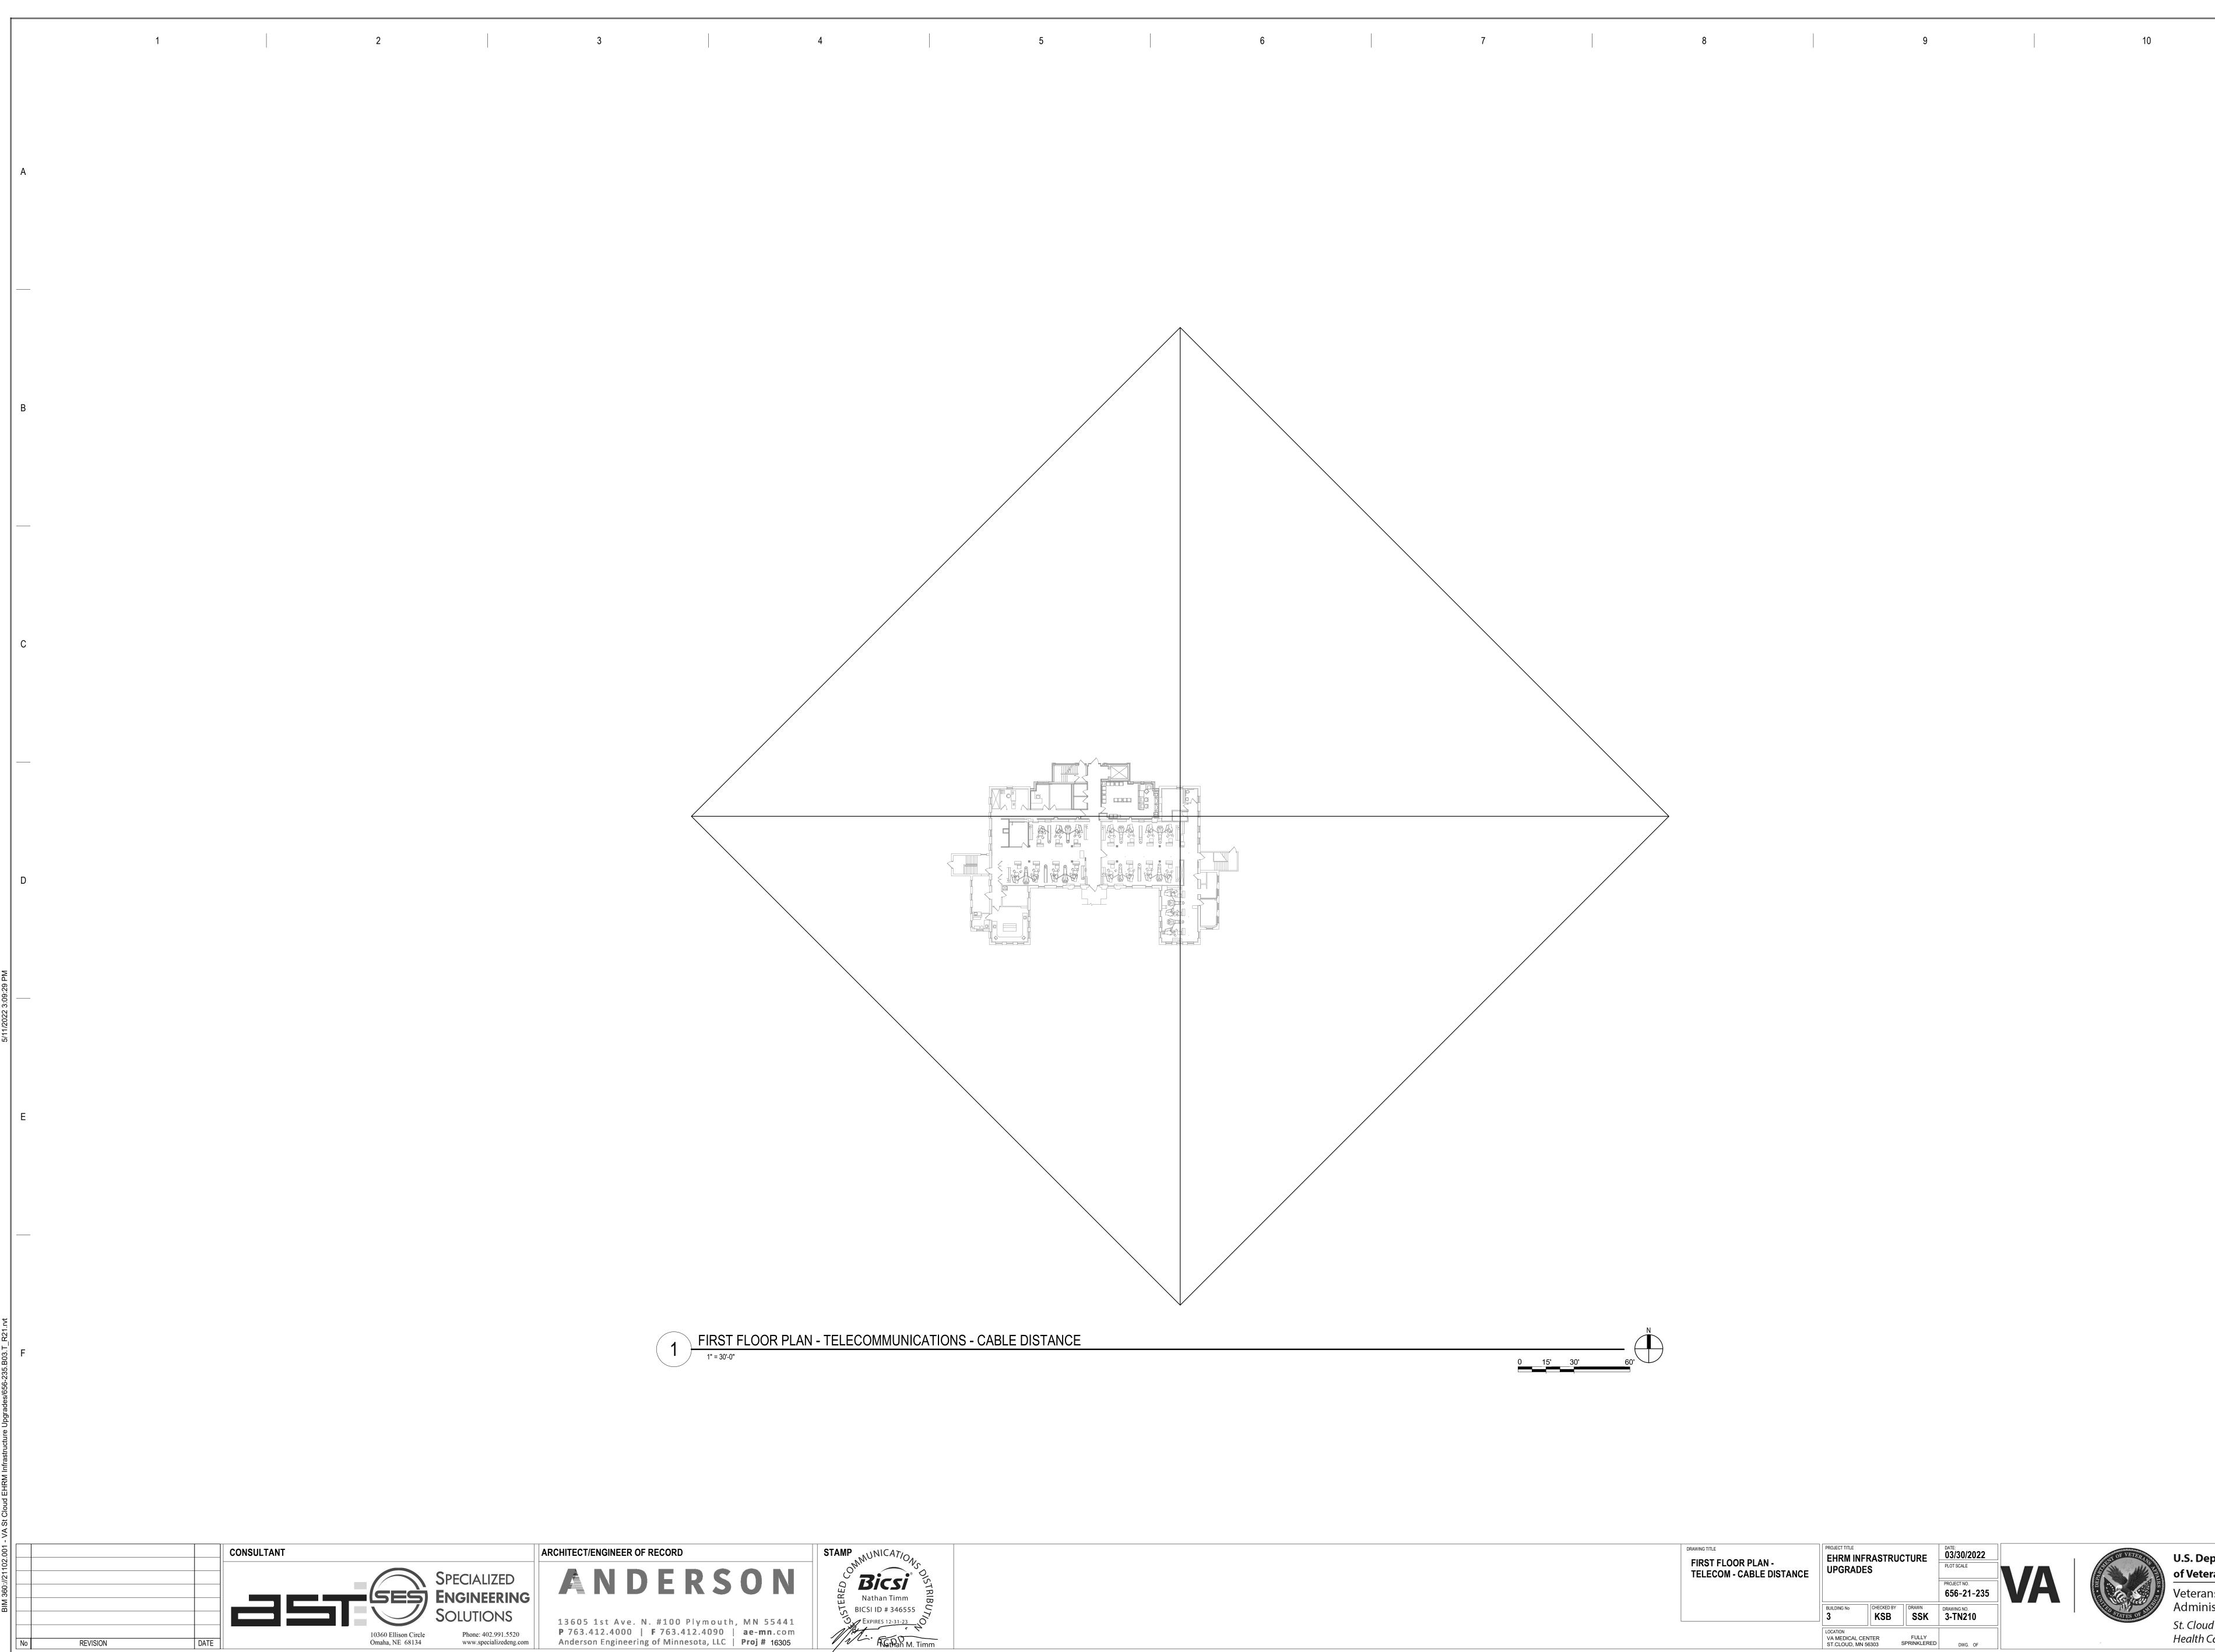


| DRAWING TITLE FIRST FLOOR PLAN - TELECOM - CABLE DISTANCE | PROJECT TITLE EHRM INFR UPGRADES | | TURE | DATE: 03/30/2022 PLOT SCALE PROJECT NO. 656-21-235 | VA |
|---|---|------------|----------------------|--|----|
| | BUILDING No 3 | CHECKED BY | DRAWN SSK | DRAWING NO. 3-TN210 | |
| | LOCATION VA MEDICAL CEN ST.CLOUD, MN 56 | | FULLY SPRINKLERED | DWG. OF | |



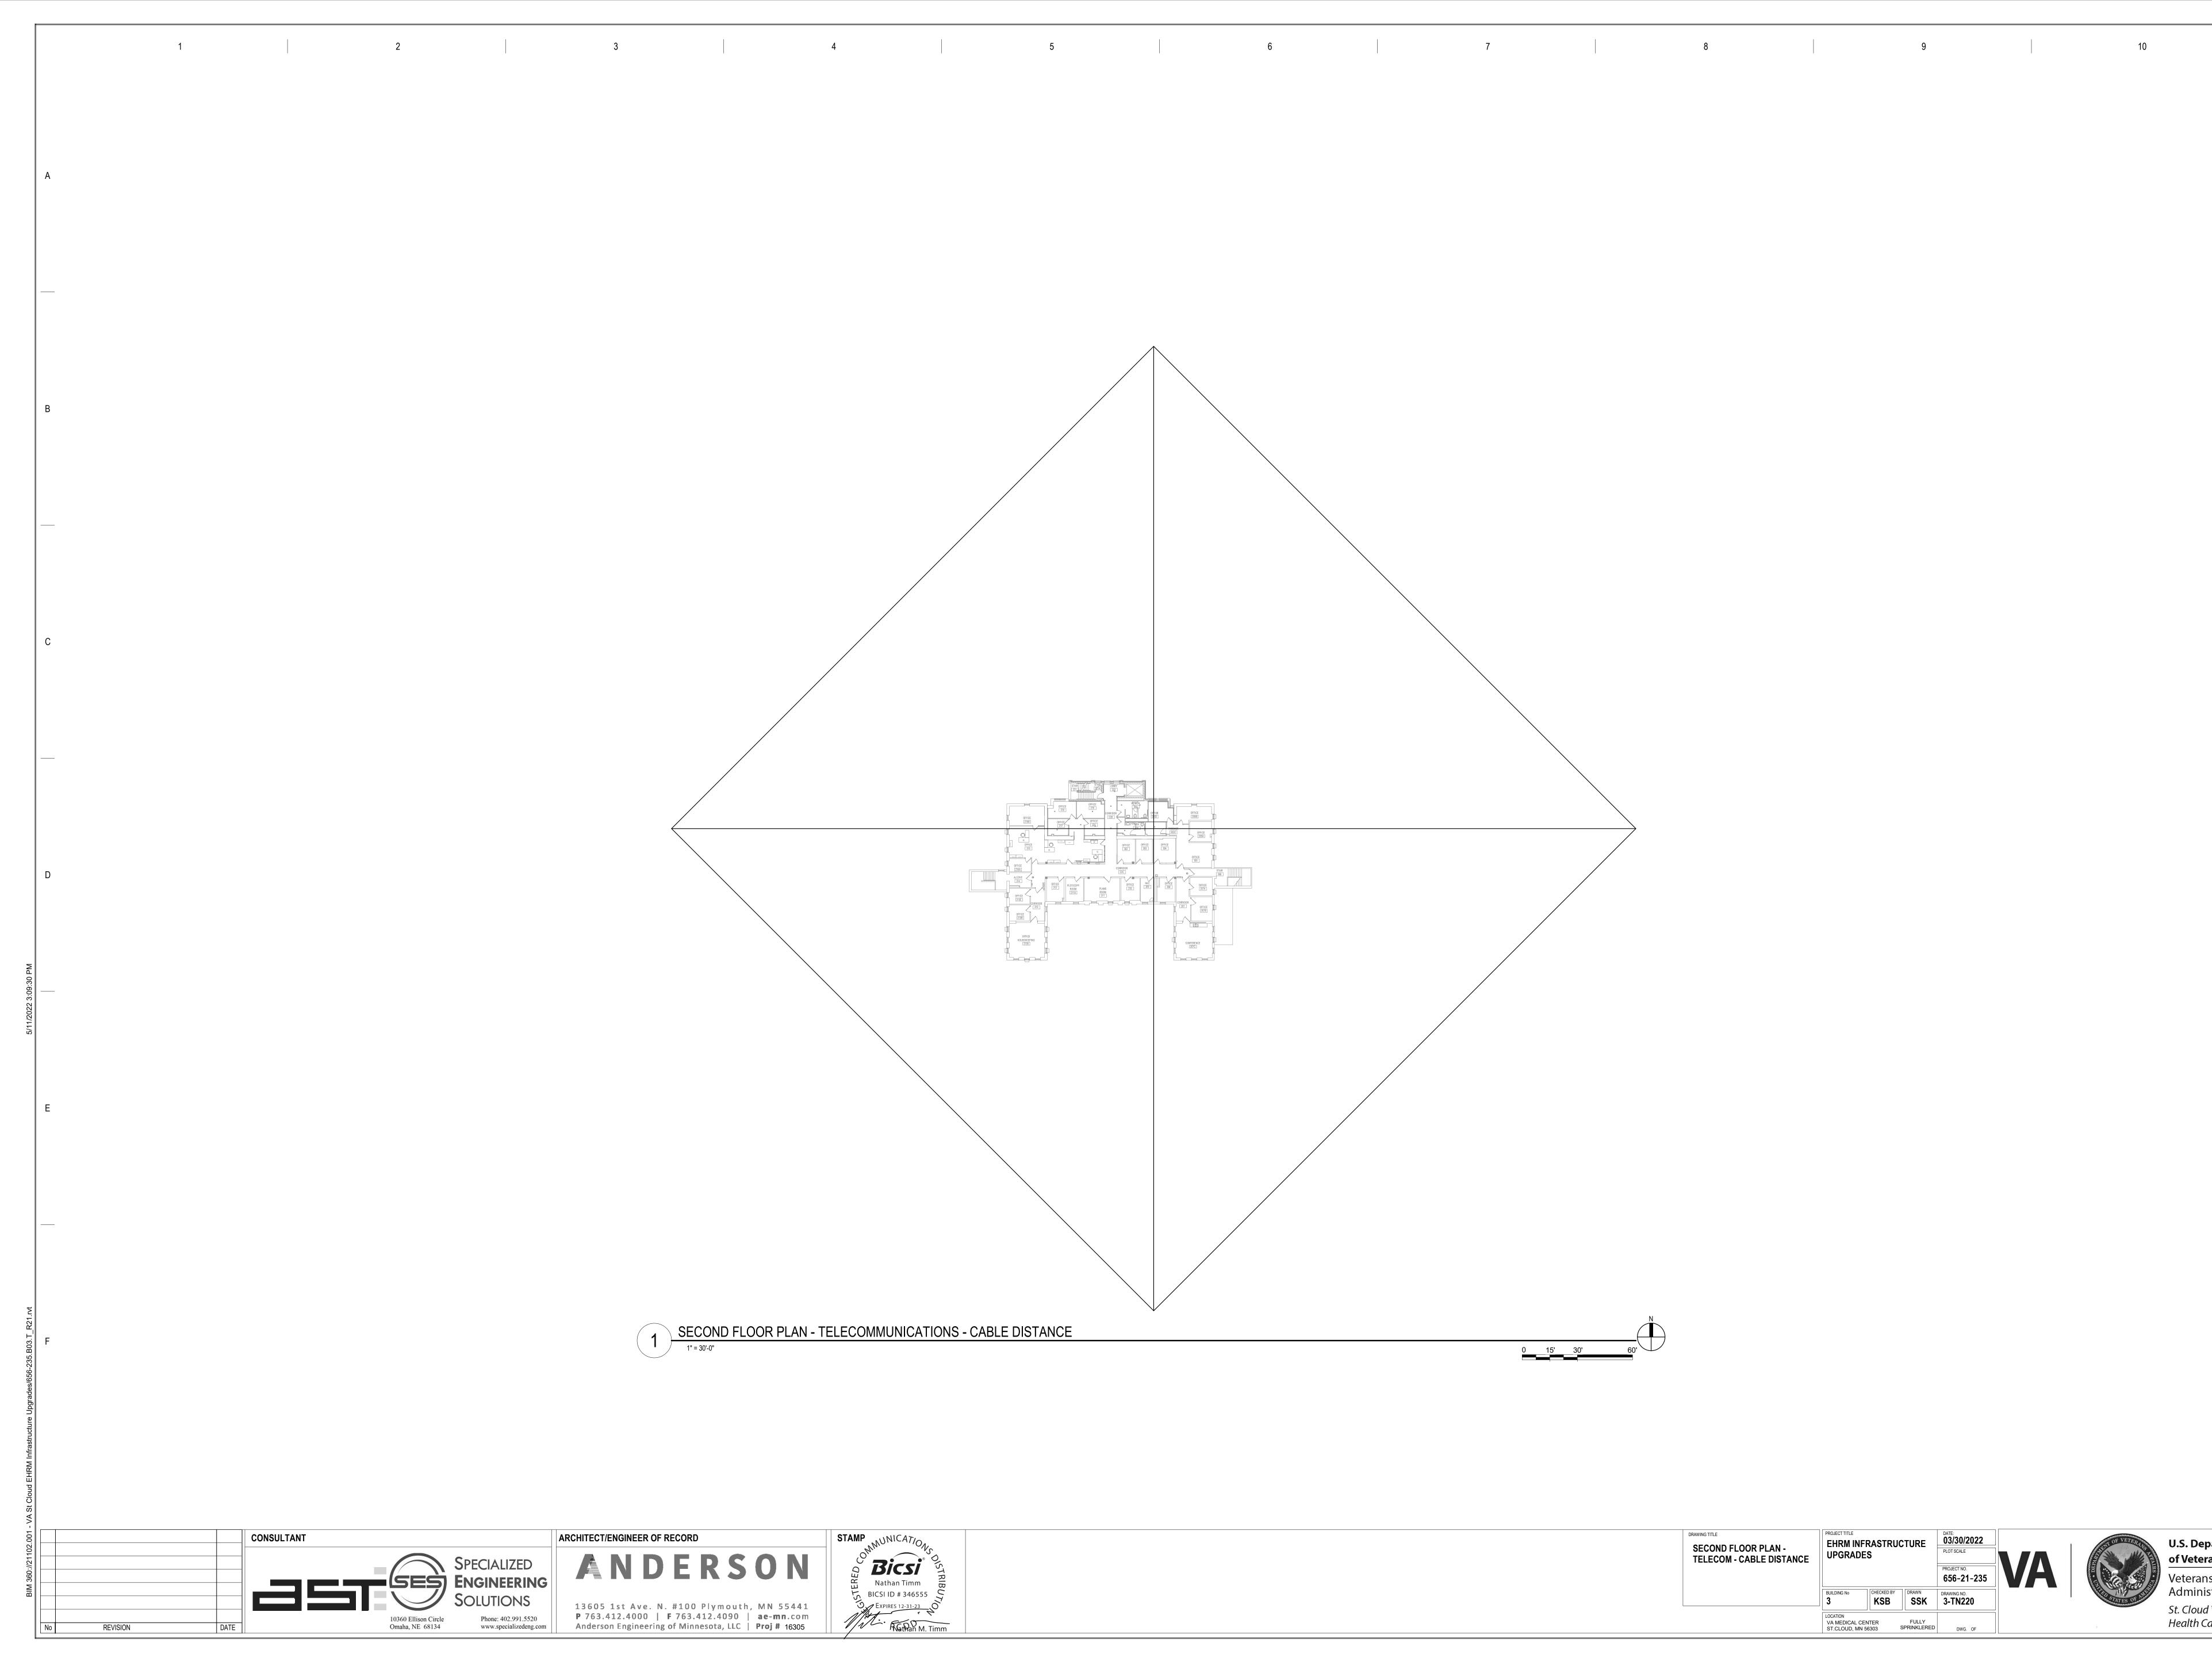

| | PROJECT TITLE | FRASTRU | CTURE | DATE: 03/30/2022 |] |
|---|--|------------|--------------|--------------------------------------|----|
| SECOND FLOOR PLAN - TELECOM - CABLE DISTANCE | UPGRADES | | | PLOT SCALE | |
| | | | | | VA |
| | BUILDING No | CHECKED BY | DRAWN SSK | 656-21-235 DRAWING NO. 3-TN220 | |
| | LOCATION VA MEDICAL C ST.CLOUD, MI | | FULLY | DWG. OF | |



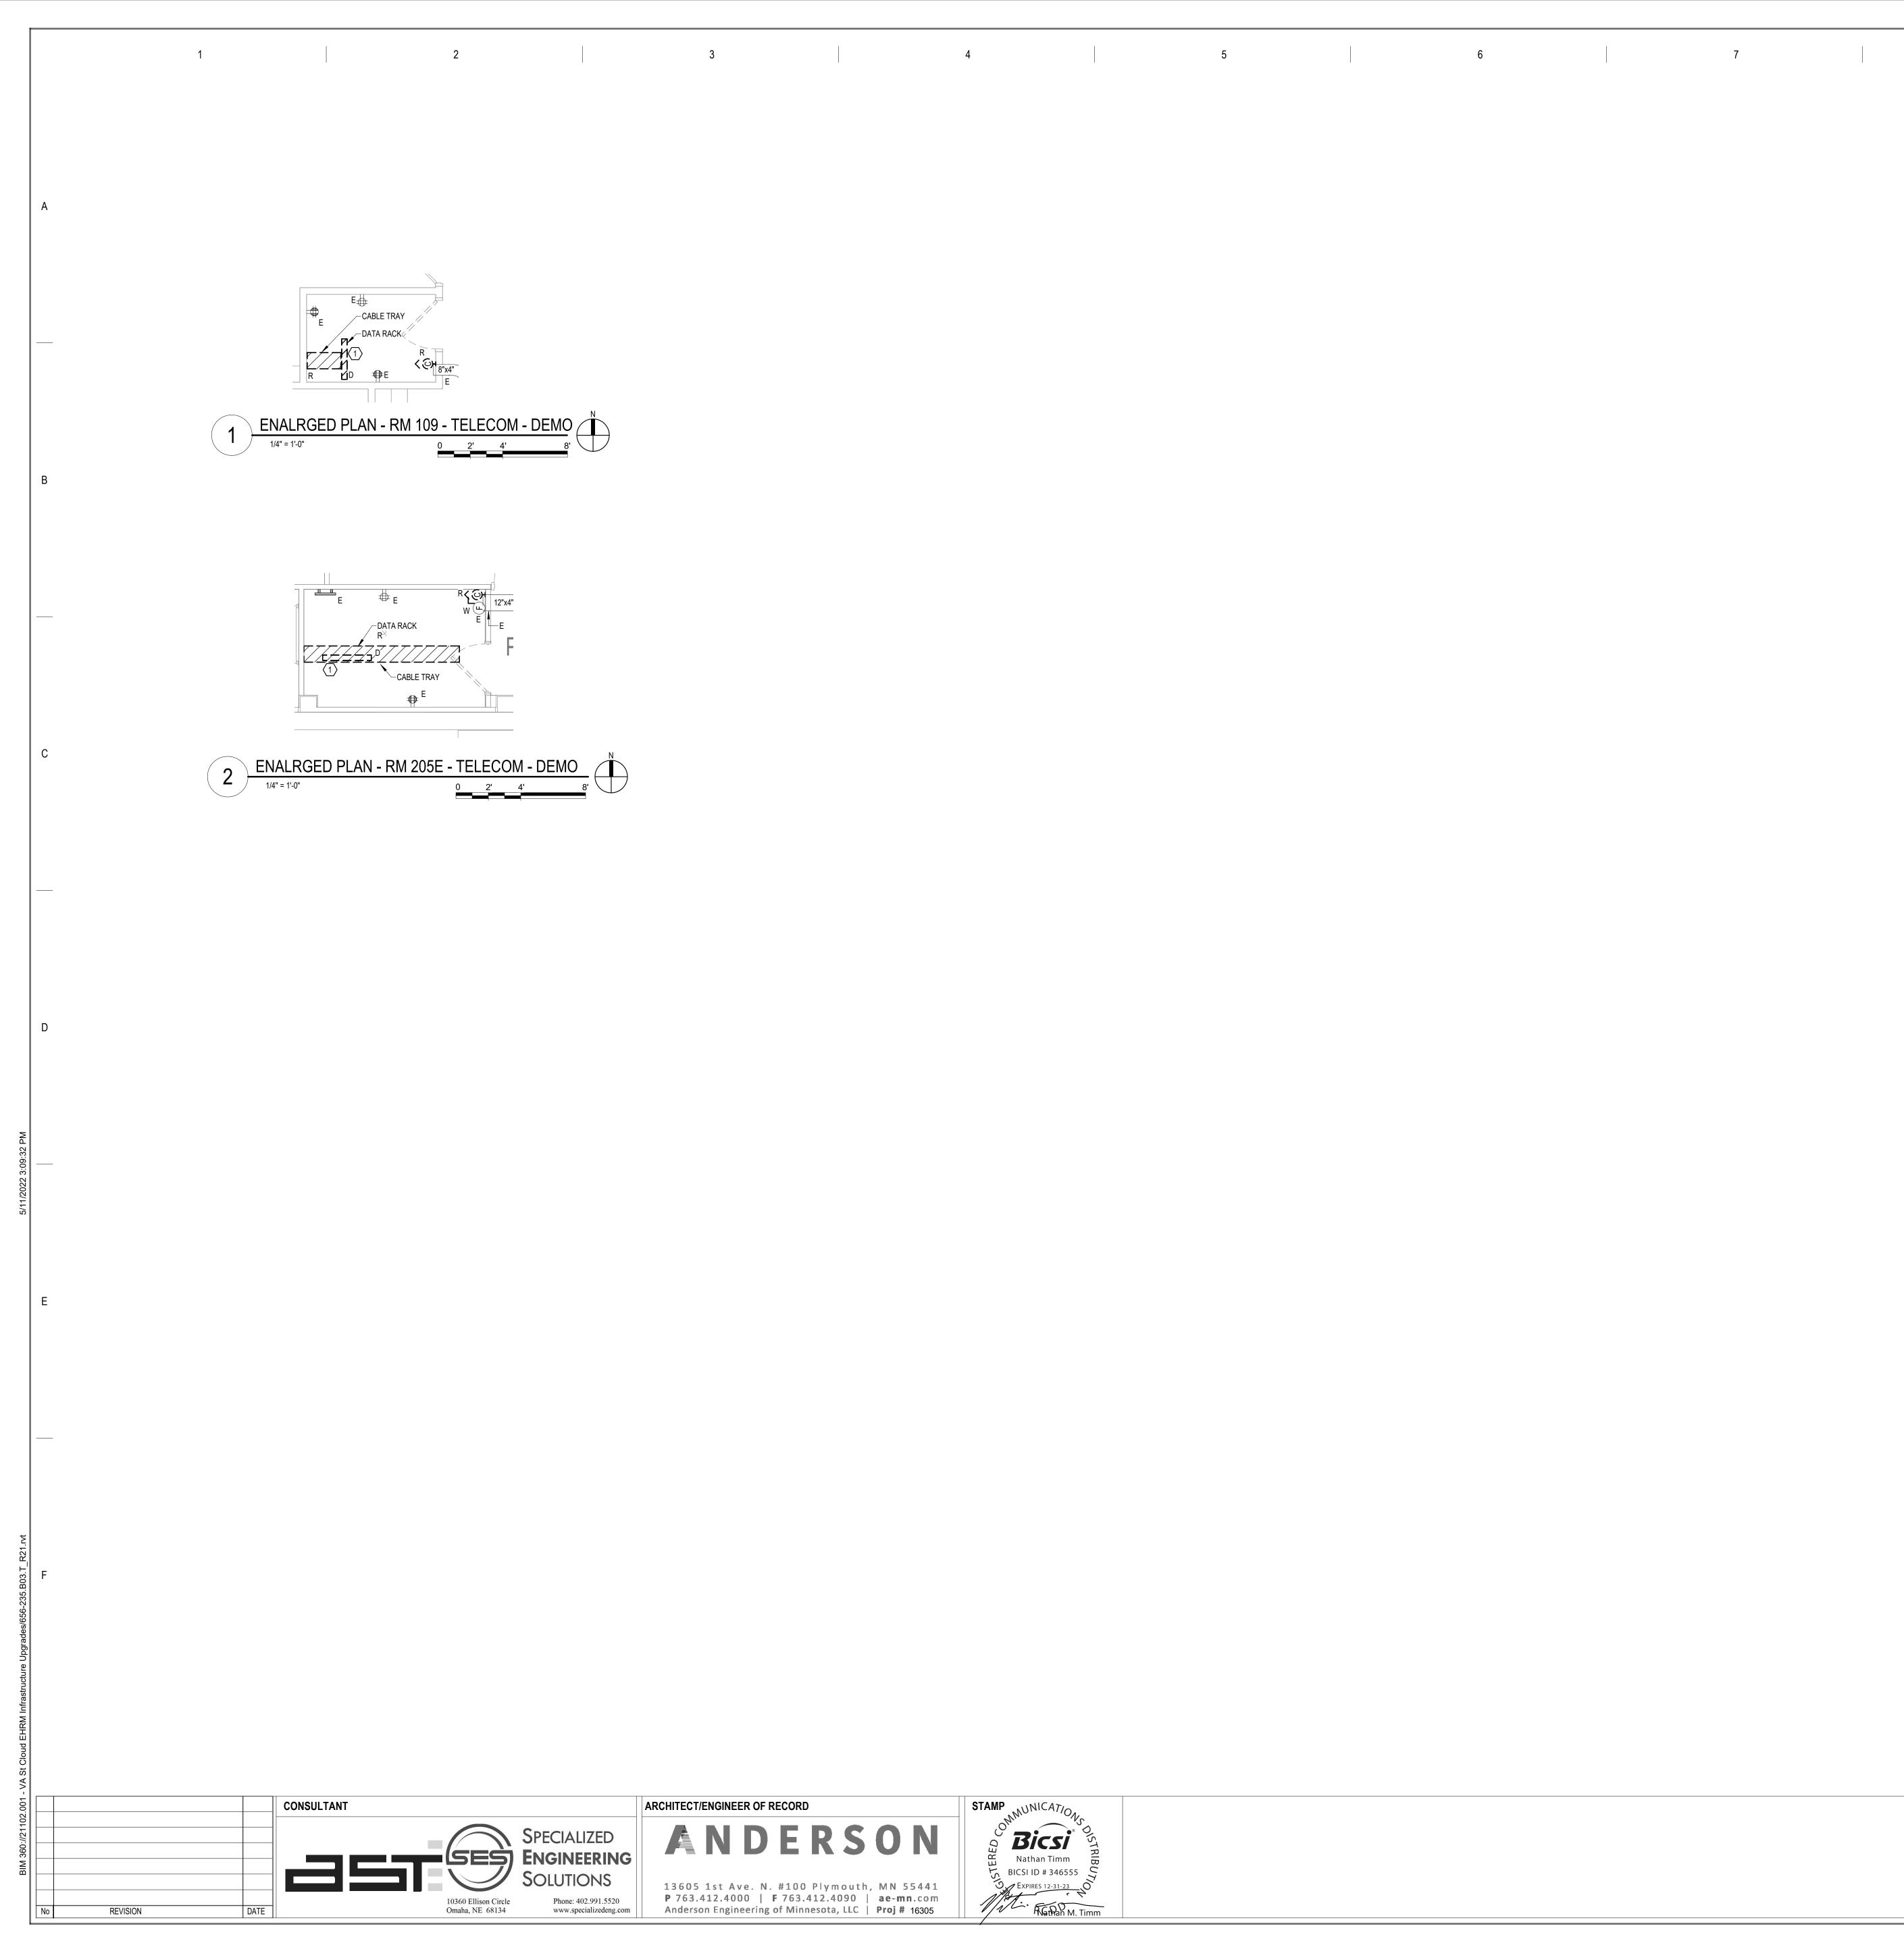



| 8 | 9 | | |
|---|---|---|--|
| | | | |
| | | GENERAL NOTES: A. REFER TO GENERAL DEMOLI | TION NOTES ON SF |
| | | SHEET NOTES: | CIATED OUTLETS ENT LOCATED WIT OR APPROXIMATE (|
| | | CABLING NOTE: | |
| | | CABLING NOTES: A. THE EXISTING CABLE COUNT RELOCATION COUNT ARE TH CABLE COUNT ARE THE CAB PROJECT. | E NEW OR RELOC |
| | | 1. <u>ROOM 109</u> EXISTING CABLE COUNT DATA (CAT6): 0 DATA (CAT5e): 185 DATA (CAT5): 0 DATA (CAT3): 0 | 2. <u>ROOM 205E</u> EXISTING CAI DATA (CAT6): DATA (CAT5e DATA (CAT5): DATA (CAT3): |
| | | CABLE RELOCATION COUNT DATA (CAT6): 0 DATA (CAT5e): 0 DATA (CAT5): 0 DATA (CAT3): 0 | CABLE RELO DATA (CAT6): DATA (CAT5e DATA (CAT5): DATA (CAT5): |

| DRAWING TITLE ENLARGED PLANS - TELECOMMUNICATIONS - DEMO | EHRM INFRASTRUCTURE UPGRADES | | CTURE | DATE: 03/30/2022 PLOT SCALE PROJECT NO. 656-21-235 | |
|---|--|------------|--------------|--|--|
| | BUILDING No | CHECKED BY | DRAWN SSK | drawing no. 3-TN300 | |
| | LOCATION VA MEDICAL C ST.CLOUD, MN | | FULLY | DWG. OF | |

SHEET T000 FOR ADDITIONAL DEMOLITION SCOPE.

10

ID RACK SHALL BE INCLUDED WITHIN THE SCOPE OF DEMOLITION. ETS SHALL BE REMOVED AND REPLACED 1 FOR 1 AND REFED WITHIN THE NEW TELECOMMUNICATIONS ROOM. REFER TO ATE QUANTITIES. REFER TO NEW WORK PLANS FOR SERVING IEW CABLING ROUTES.

LES CURRENTLY PRESENT IN THE SPACE. THE CABLE LOCATED CABLES TO BE FED FROM THE SPACE. THE FINAL BE PRESENT IN THE SPACE AT THE COMPLETION OF THE

CABLE COUNT F6): 0 5e): 192 [5): 0 [3): 0 LOCATION COUNT 6): 0 [5e): 0 T5): 0 [3]: 0 EXISTING CABLE TO REMAINEXISTING CABLE TO REMAINDATA (CAT6): 0DATA (CAT6): 0DATA (CAT5e): 0DATA (CAT5e): 0 DATA (CAT5): 0

DATA (CAT3): 0 FINAL CABLE COUNT DATA (CAT6): 0 DATA (CAT5e): 0 DATA (CAT5): 0 DATA (CAT3): 0

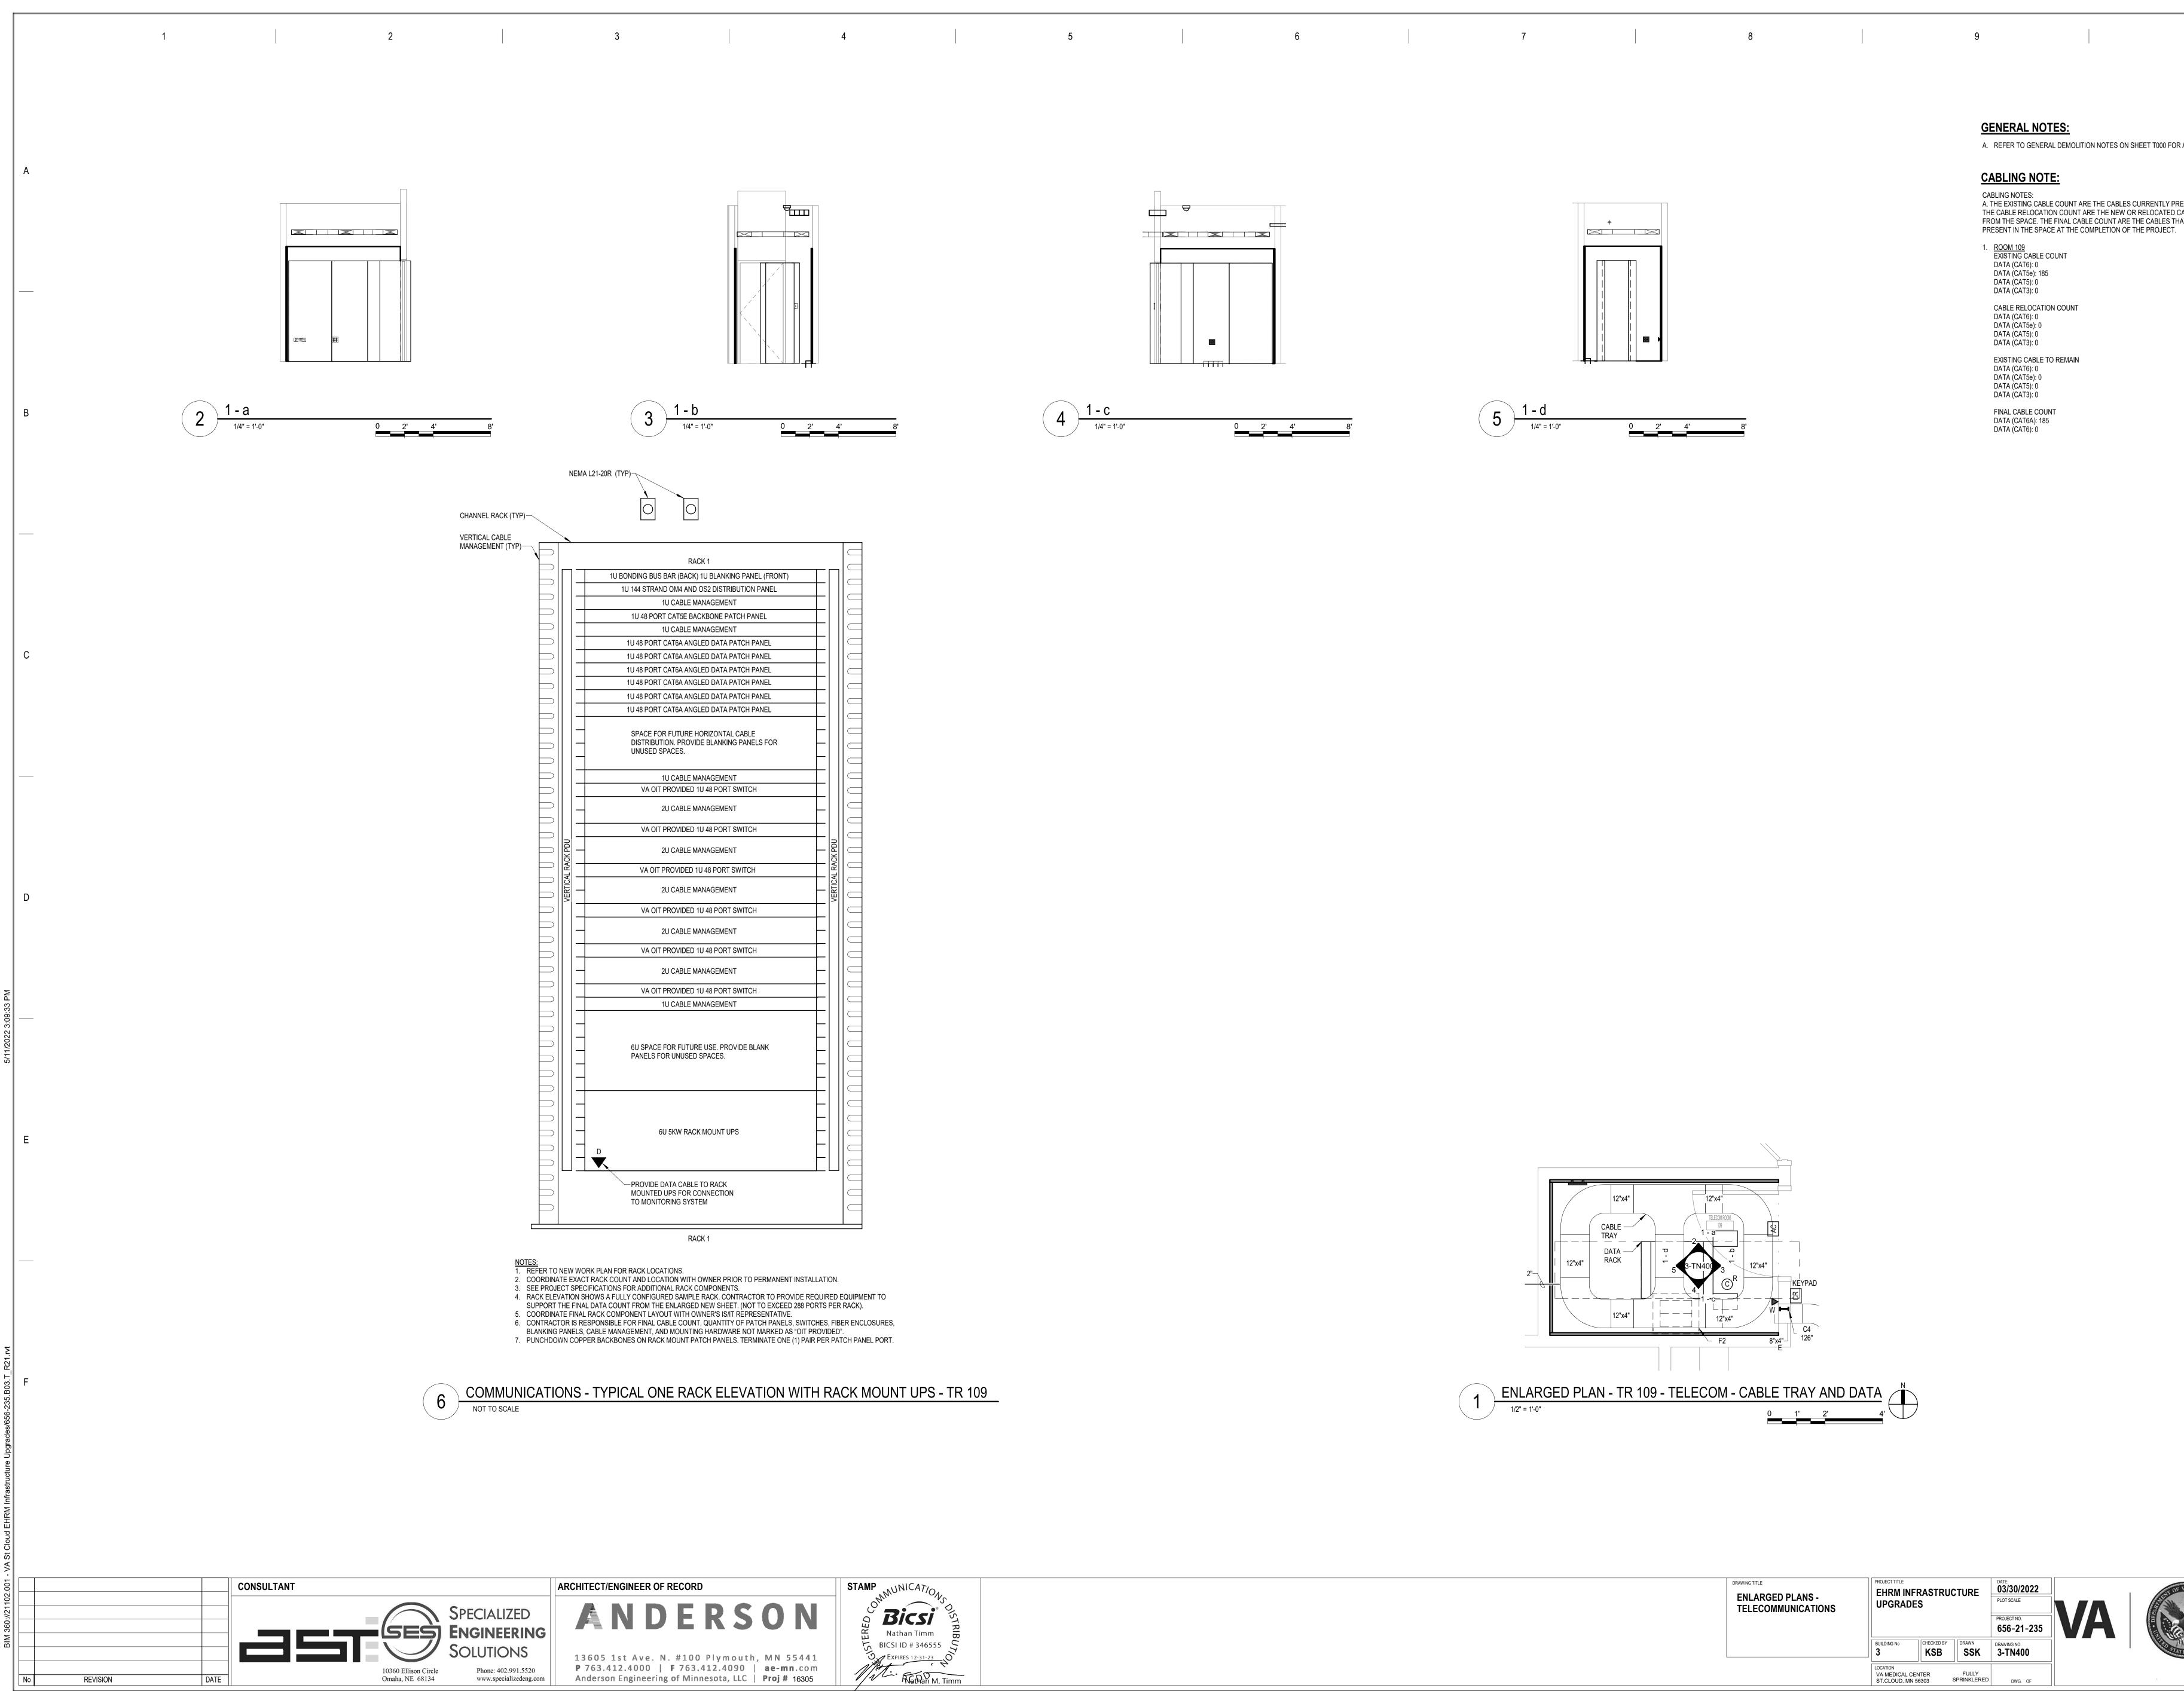
DATA (CAT6): 0 DATA (CAT5e): 0 DATA (CAT5): 0

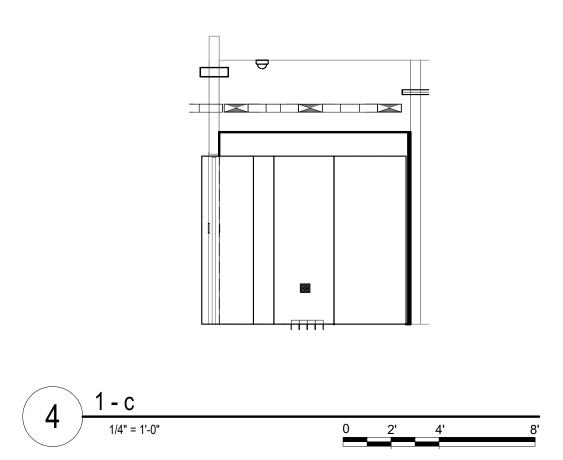
DATA (CAT3): 0

DATA (CAT5): 0 DATA (CAT3): 0

FINAL CABLE COUNT DATA (CAT6): 0 DATA (CAT5e): 0









| | | | 1 |
|--|-----------|-----------------|-----------|
| RACK 1 | | | |
| AR (BACK) 1U BLANKING PANEL (FRONT) | Γ | \square | |
| OM4 AND OS2 DISTRIBUTION PANEL | — | | |
| J CABLE MANAGEMENT | | | |
| CAT5E BACKBONE PATCH PANEL | | | \square |
| J CABLE MANAGEMENT | | | \square |
| AT6A ANGLED DATA PATCH PANEL | | | \square |
| AT6A ANGLED DATA PATCH PANEL | | | \square |
| AT6A ANGLED DATA PATCH PANEL | | | |
| AT6A ANGLED DATA PATCH PANEL | | | |
| AT6A ANGLED DATA PATCH PANEL | | | |
| AT6A ANGLED DATA PATCH PANEL | | | |
| | | | |
| | | | |
| DN. PROVIDE BLANKING PANELS FOR ACES. | | | \square |
| | | | \square |
| J CABLE MANAGEMENT | | | \square |
| ROVIDED 1U 48 PORT SWITCH | | | \square |
| J CABLE MANAGEMENT | | | |
| J CADLE MANAGEMENT | | | _ |
| ROVIDED 1U 48 PORT SWITCH | \square | | |
| | \square | В | |
| J CABLE MANAGEMENT | F | КР | |
| ROVIDED 1U 48 PORT SWITCH | \square | L RA | |
| | \square | RTICAL RACK PDI | \square |
| J CABLE MANAGEMENT | | VER. | \square |
| ROVIDED 1U 48 PORT SWITCH | | | \square |
| | | | \square |
| J CABLE MANAGEMENT | | | |
| ROVIDED 1U 48 PORT SWITCH | | | \square |
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| J CABLE MANAGEMENT | | | |
| ROVIDED 1U 48 PORT SWITCH | | | |
| J CABLE MANAGEMENT | | | |
| | | | \square |
| | | | \square |
| OR FUTURE USE. PROVIDE BLANK | | | \square |
| R UNUSED SPACES. | | | \square |
| | | | |
| | | | _ |
| | | | |
| | | | |
| | | | |
| 5KW RACK MOUNT UPS | | | |
| | | | \square |
| | Γ | | |
| | | | \square |
| ATA CABLE TO RACK IPS FOR CONNECTION | | | |
| RING SYSTEM | | | \square |
| | | | |

| DRAWING TITLE ENLARGED PLANS - TELECOMMUNICATIONS | PROJECT TITLE EHRM INFRASTRUCTURE UPGRADES | | | DATE: 03/30/2022 PLOT SCALE PROJECT NO. 656-21-235 | VA |
|---|--|------------|----------------------|--|----|
| | BUILDING No | CHECKED BY | DRAWN SSK | drawing no. 3-TN400 | |
| | LOCATION VA MEDICAL CEI ST.CLOUD, MN 5 | | FULLY SPRINKLERED | DWG. OF | |

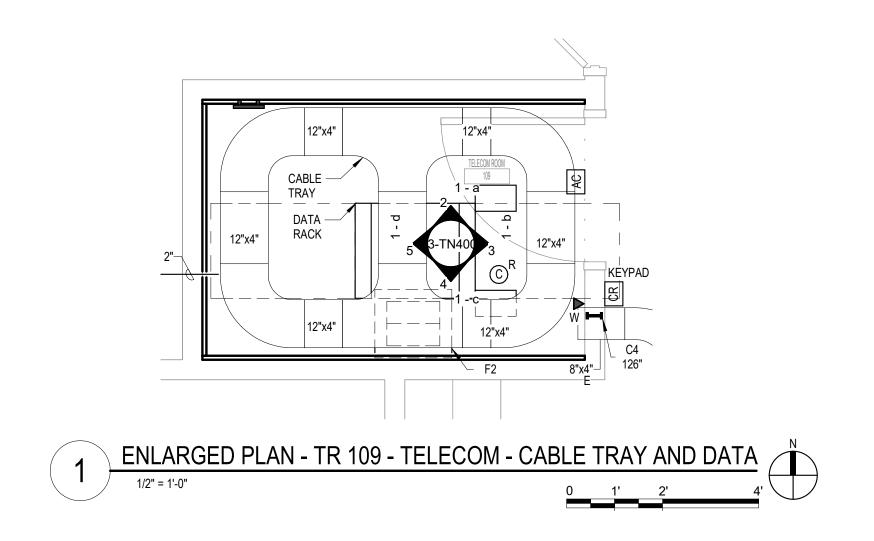

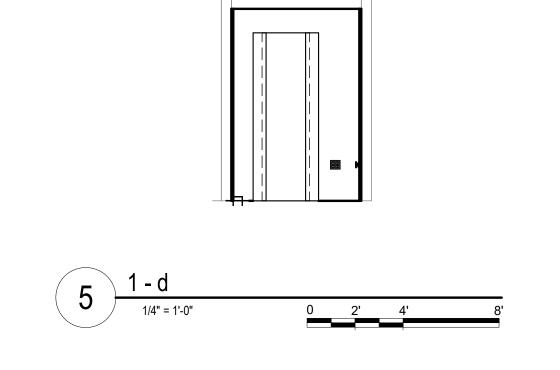

+

A. REFER TO GENERAL DEMOLITION NOTES ON SHEET T000 FOR ADDITIONAL DEMOLITION SCOPE. CABLING NOTE:

| CABLING NOTES: A. THE EXISTING CABLE COUNT ARE THE CABLES CURRENTLY PRESENT IN THE SPACE. THE CABLE RELOCATION COUNT ARE THE NEW OR RELOCATED CABLES TO BE FED FROM THE SPACE. THE FINAL CABLE COUNT ARE THE CABLES THAT WILL BE PRESENT IN THE SPACE AT THE COMPLETION OF THE PROJECT. |
|---|
| 1. ROOM 109 EXISTING CABLE COUNT DATA (CAT6): 0 DATA (CAT5e): 185 DATA (CAT5): 0 DATA (CAT3): 0 |
| CABLE RELOCATION COUNT DATA (CAT6): 0 DATA (CAT5e): 0 DATA (CAT5): 0 DATA (CAT3): 0 |


GENERAL NOTES:


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EXISTING CABLE TO REMAIN DATA (CAT6): 0 DATA (CAT5e): 0 DATA (CAT5): 0 DATA (CAT3): 0

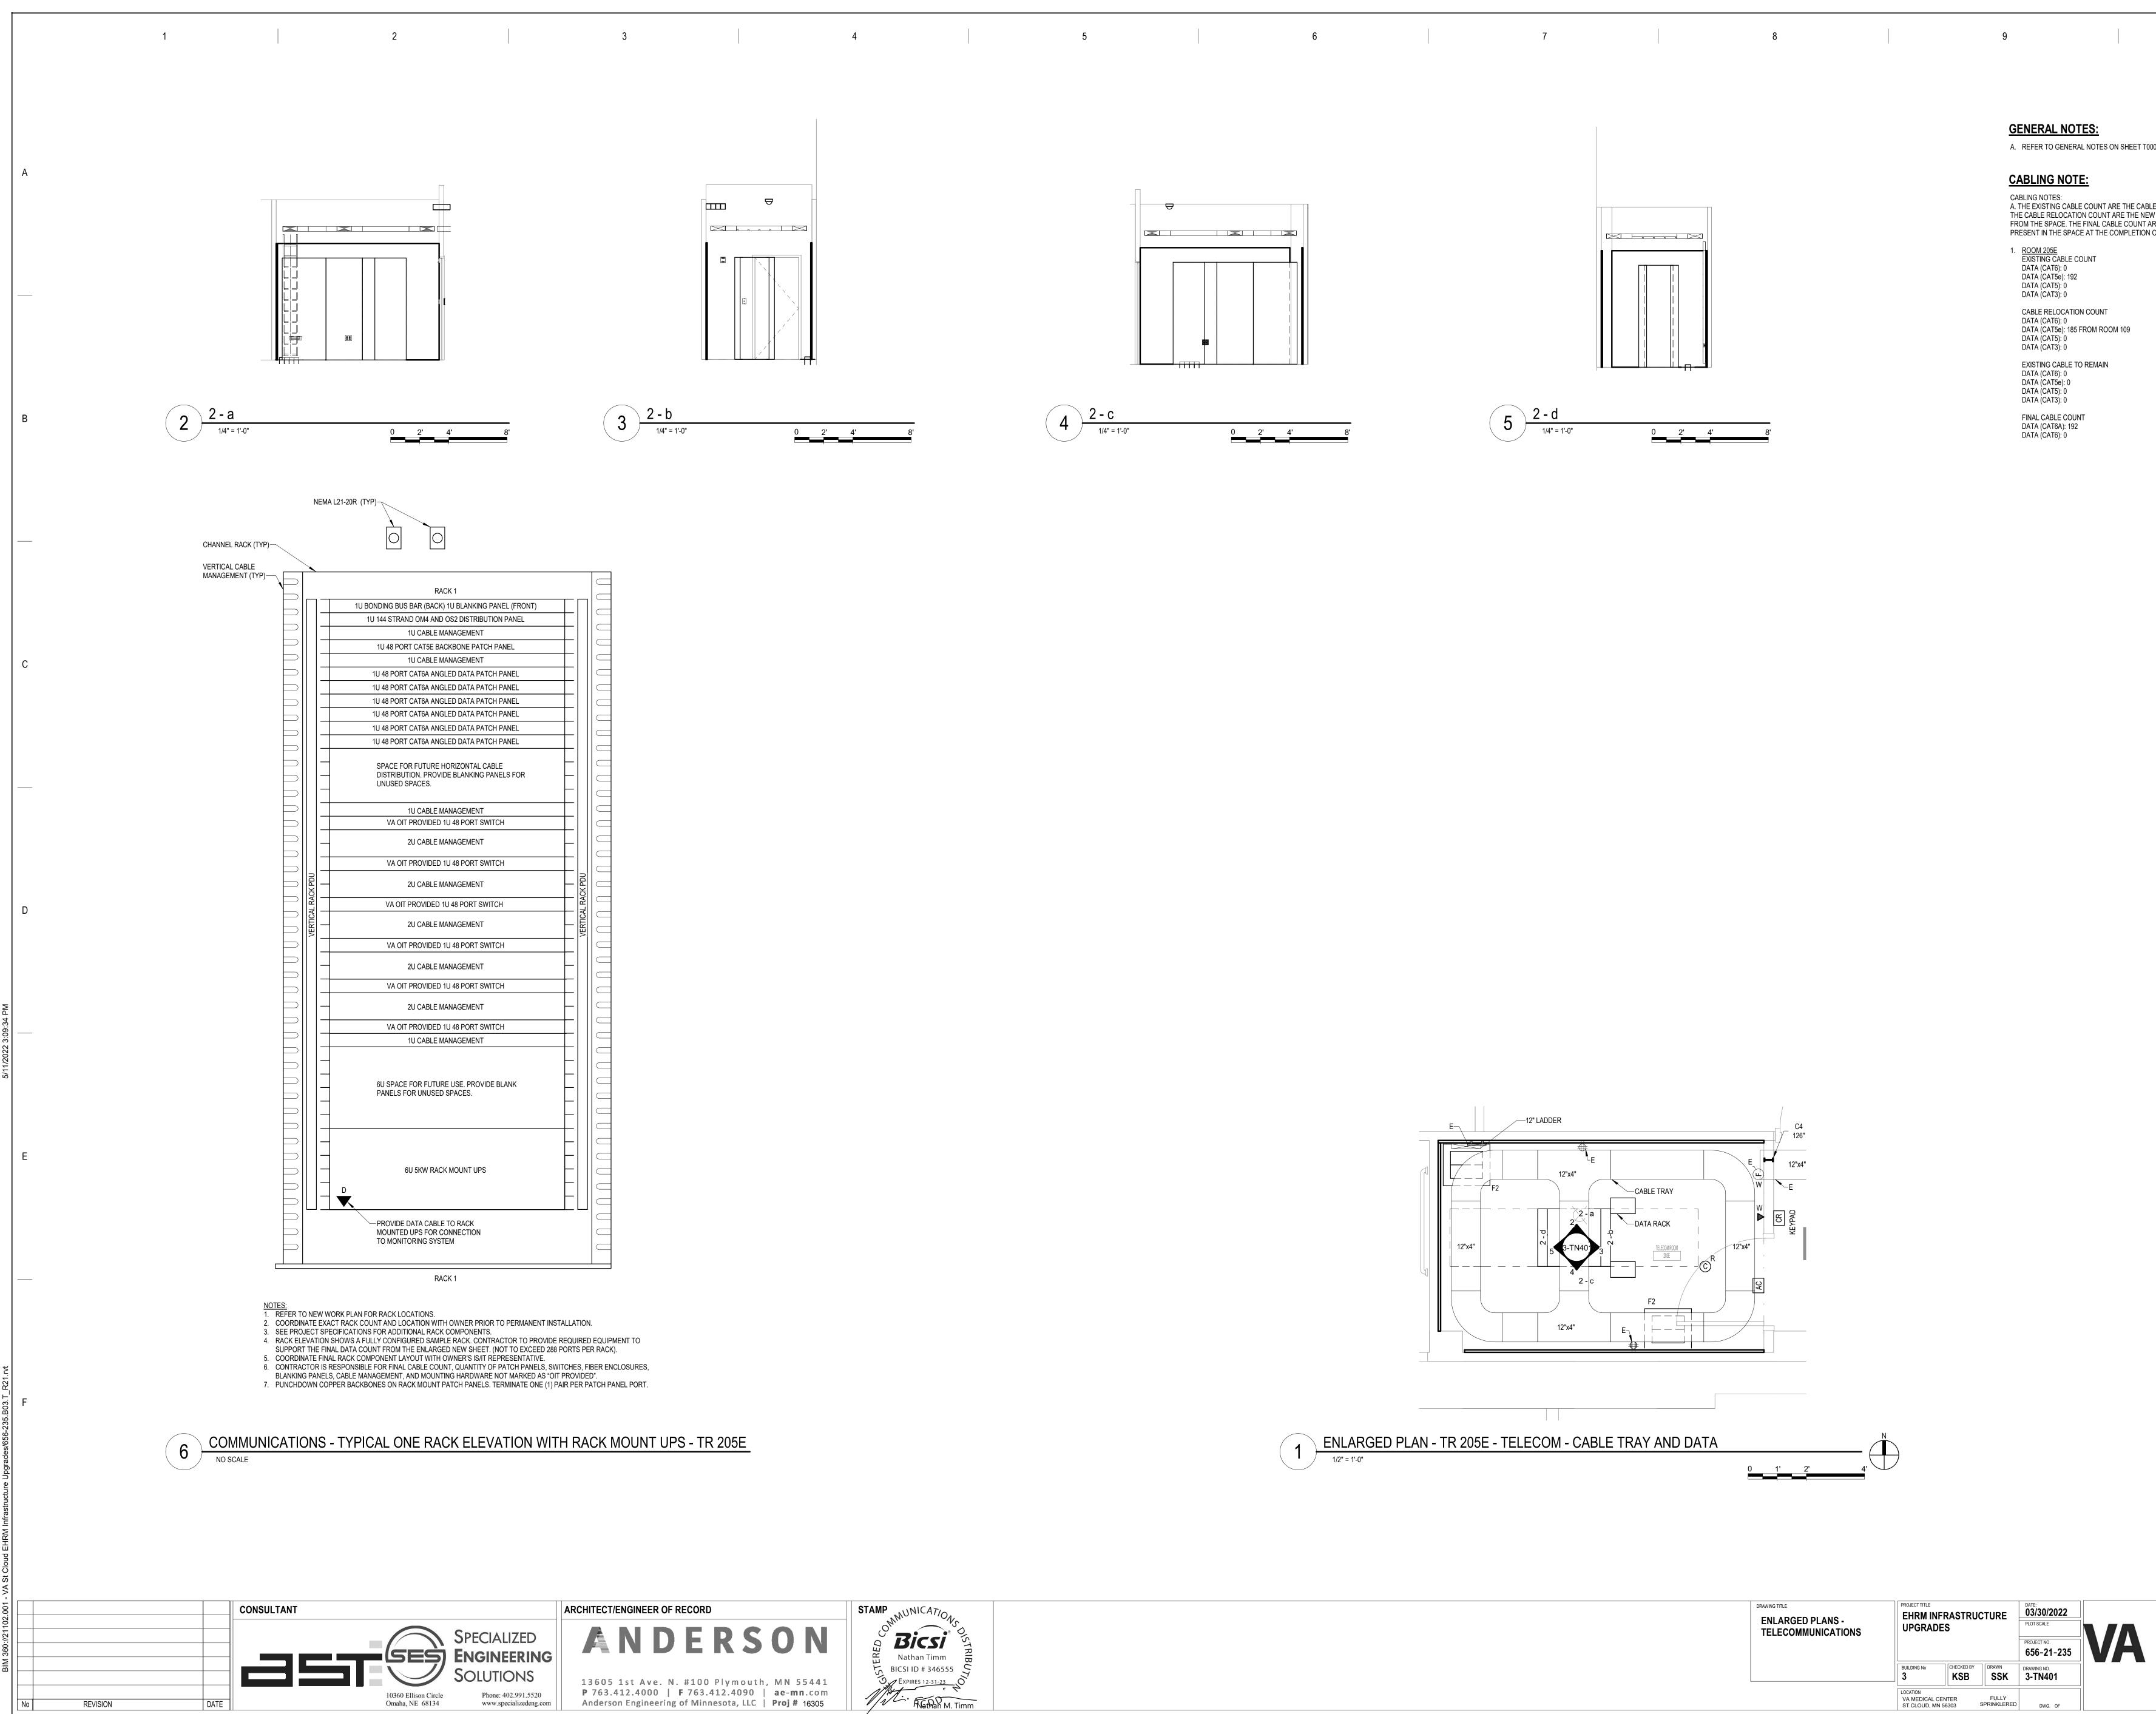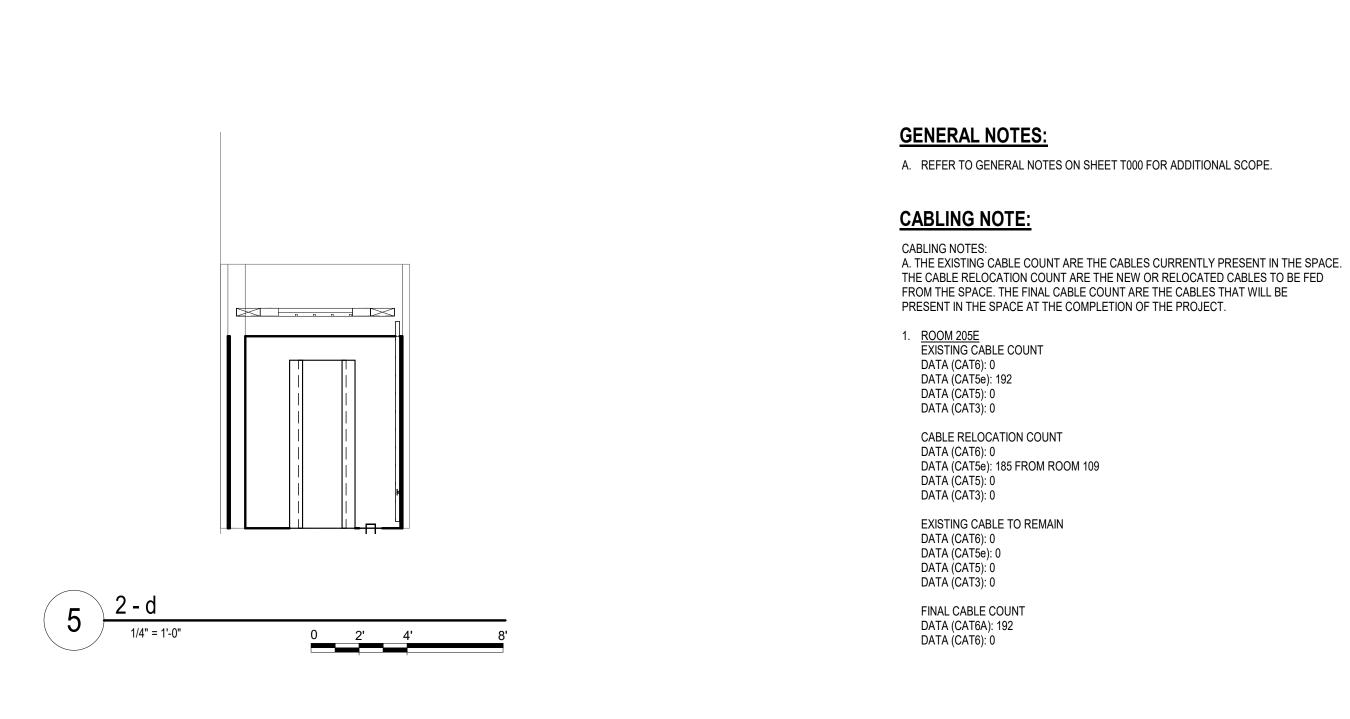FINAL CABLE COUNT DATA (CAT6A): 185 DATA (CAT6): 0








| DRAWING TITLE ENLARGED PLANS - TELECOMMUNICATIONS | | PROJECT TITLE EHRM INFRASTRUCTURE UPGRADES DATE: 03/30/2022 PLOT SCALE PROJECT NO. 6566-21-235 | | | |
|---|--|--|----------------------|-------------|--|
| | BUILDING No | CHECKED BY | DRAWN | DRAWING NO. | |
| | 3 | KSB | SSK | 3-TN401 | |
| | LOCATION VA MEDICAL CEN ST.CLOUD, MN 5 | | FULLY SPRINKLERED | DWG. OF | |




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656-21-235

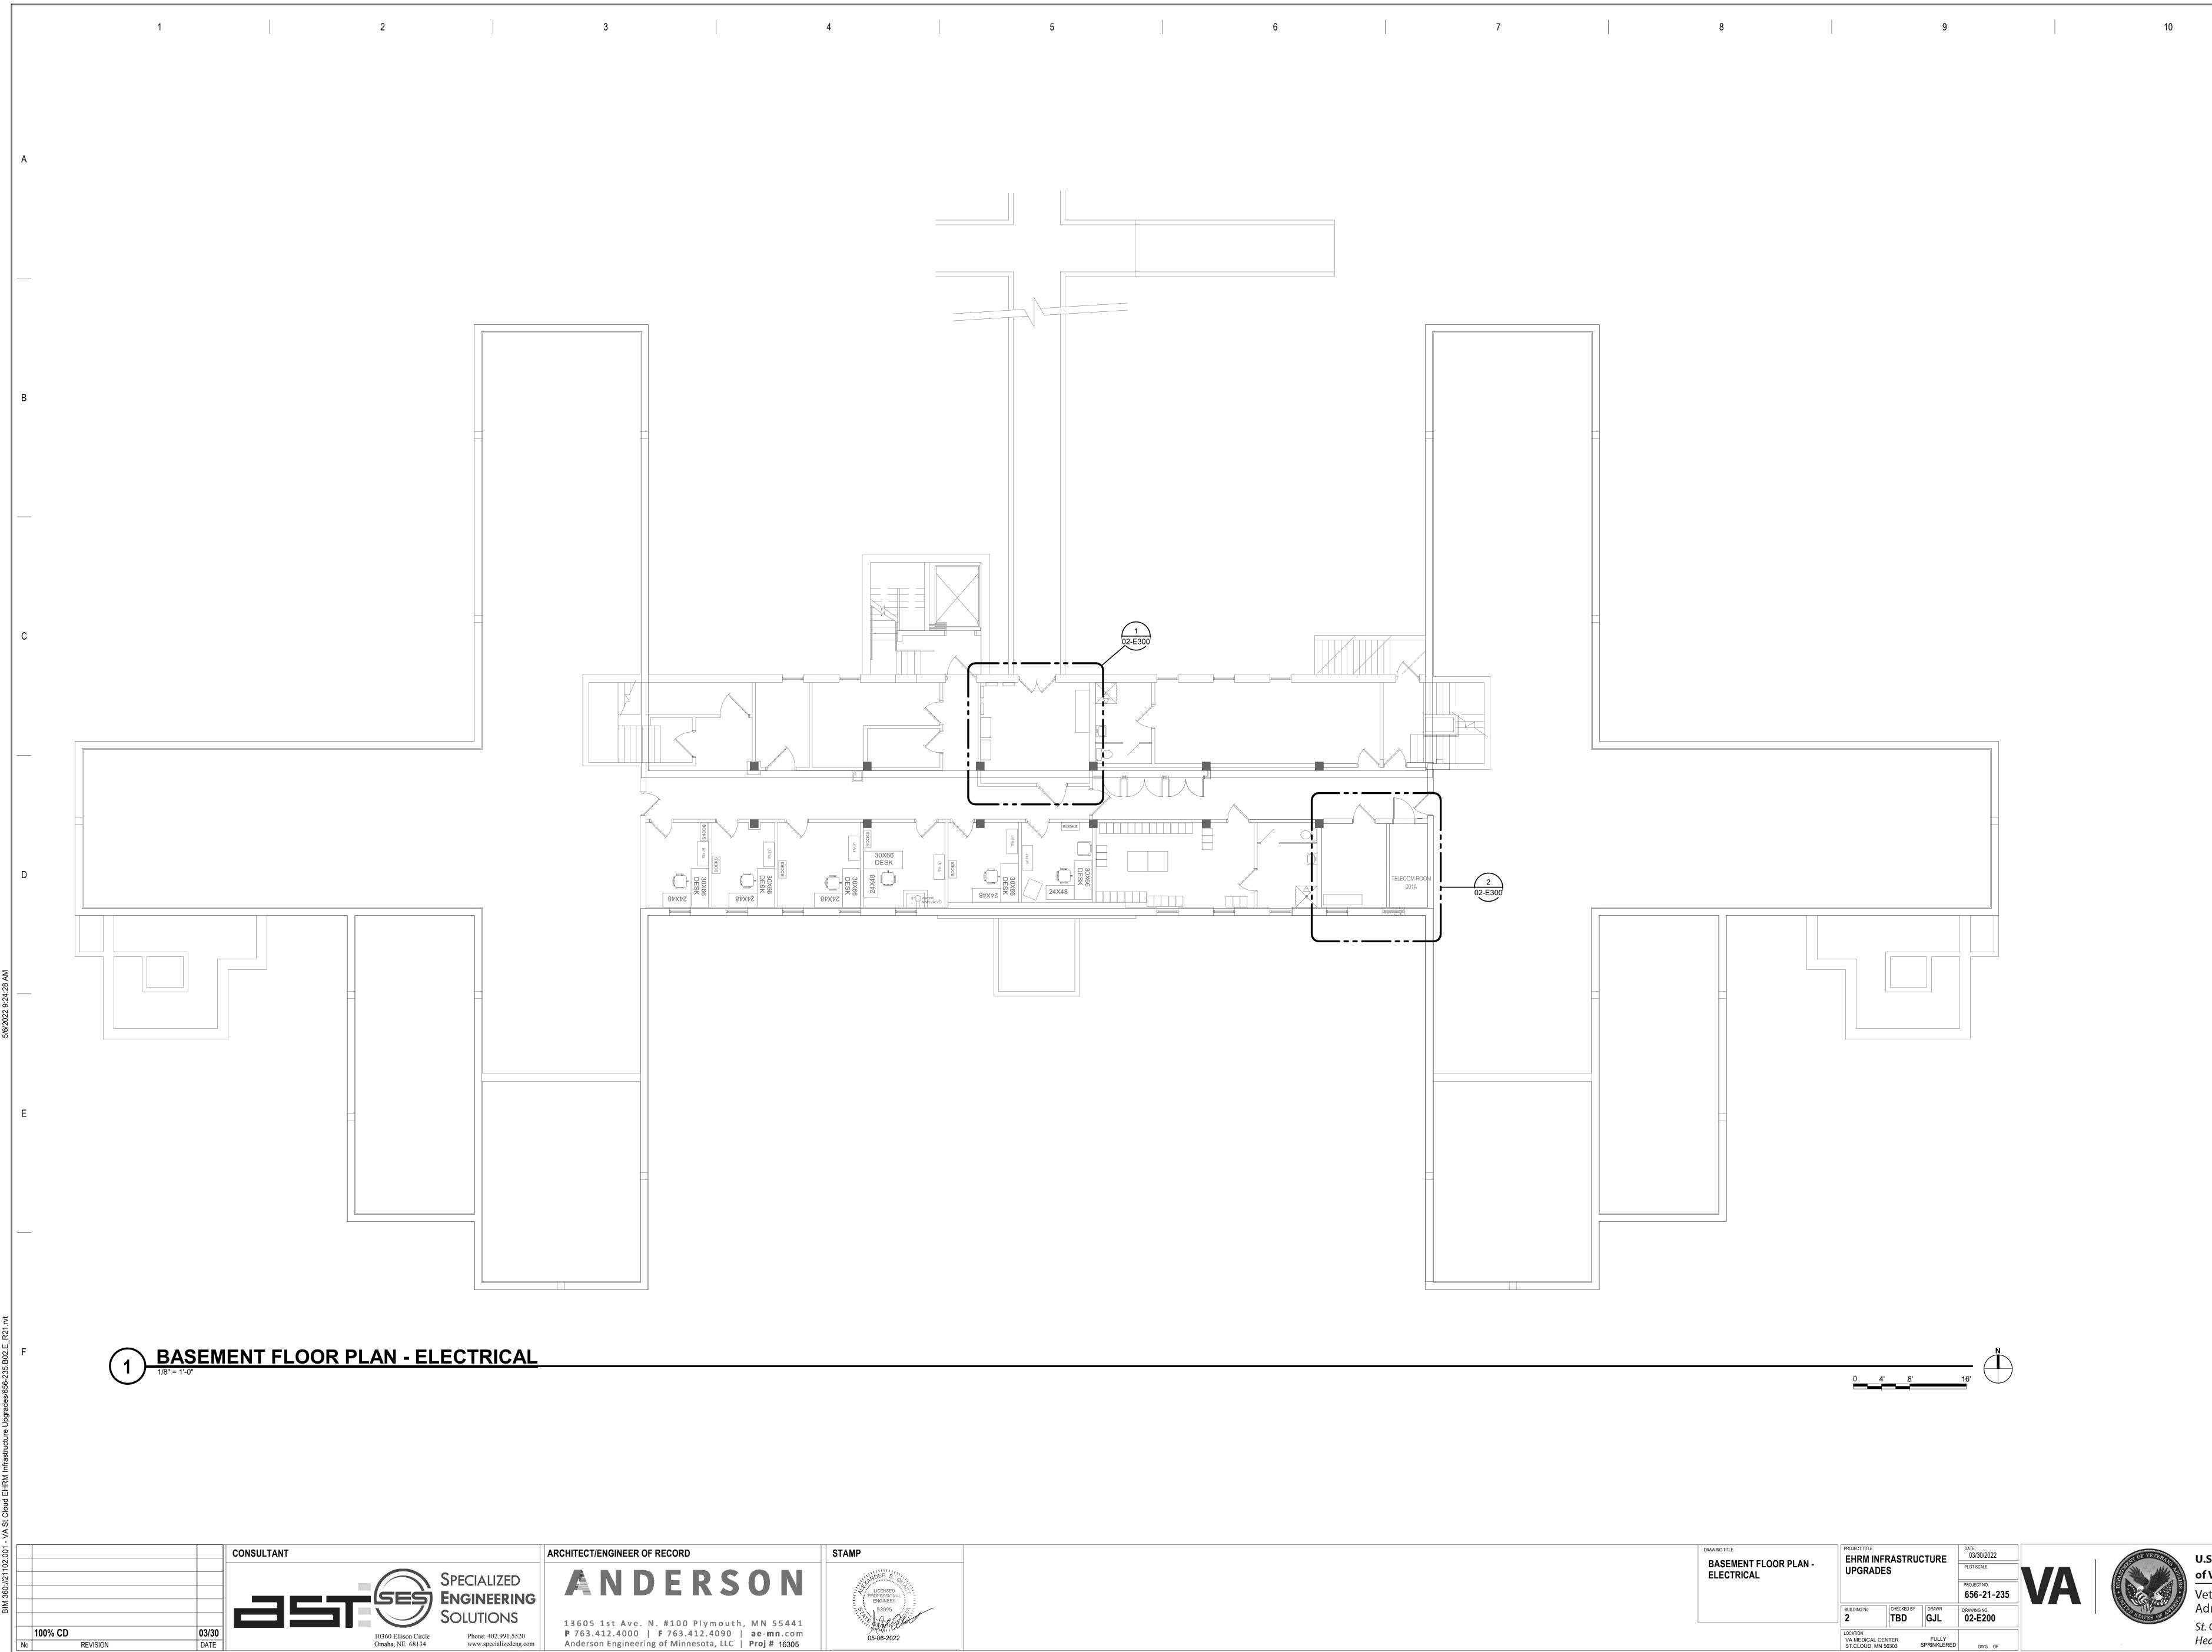




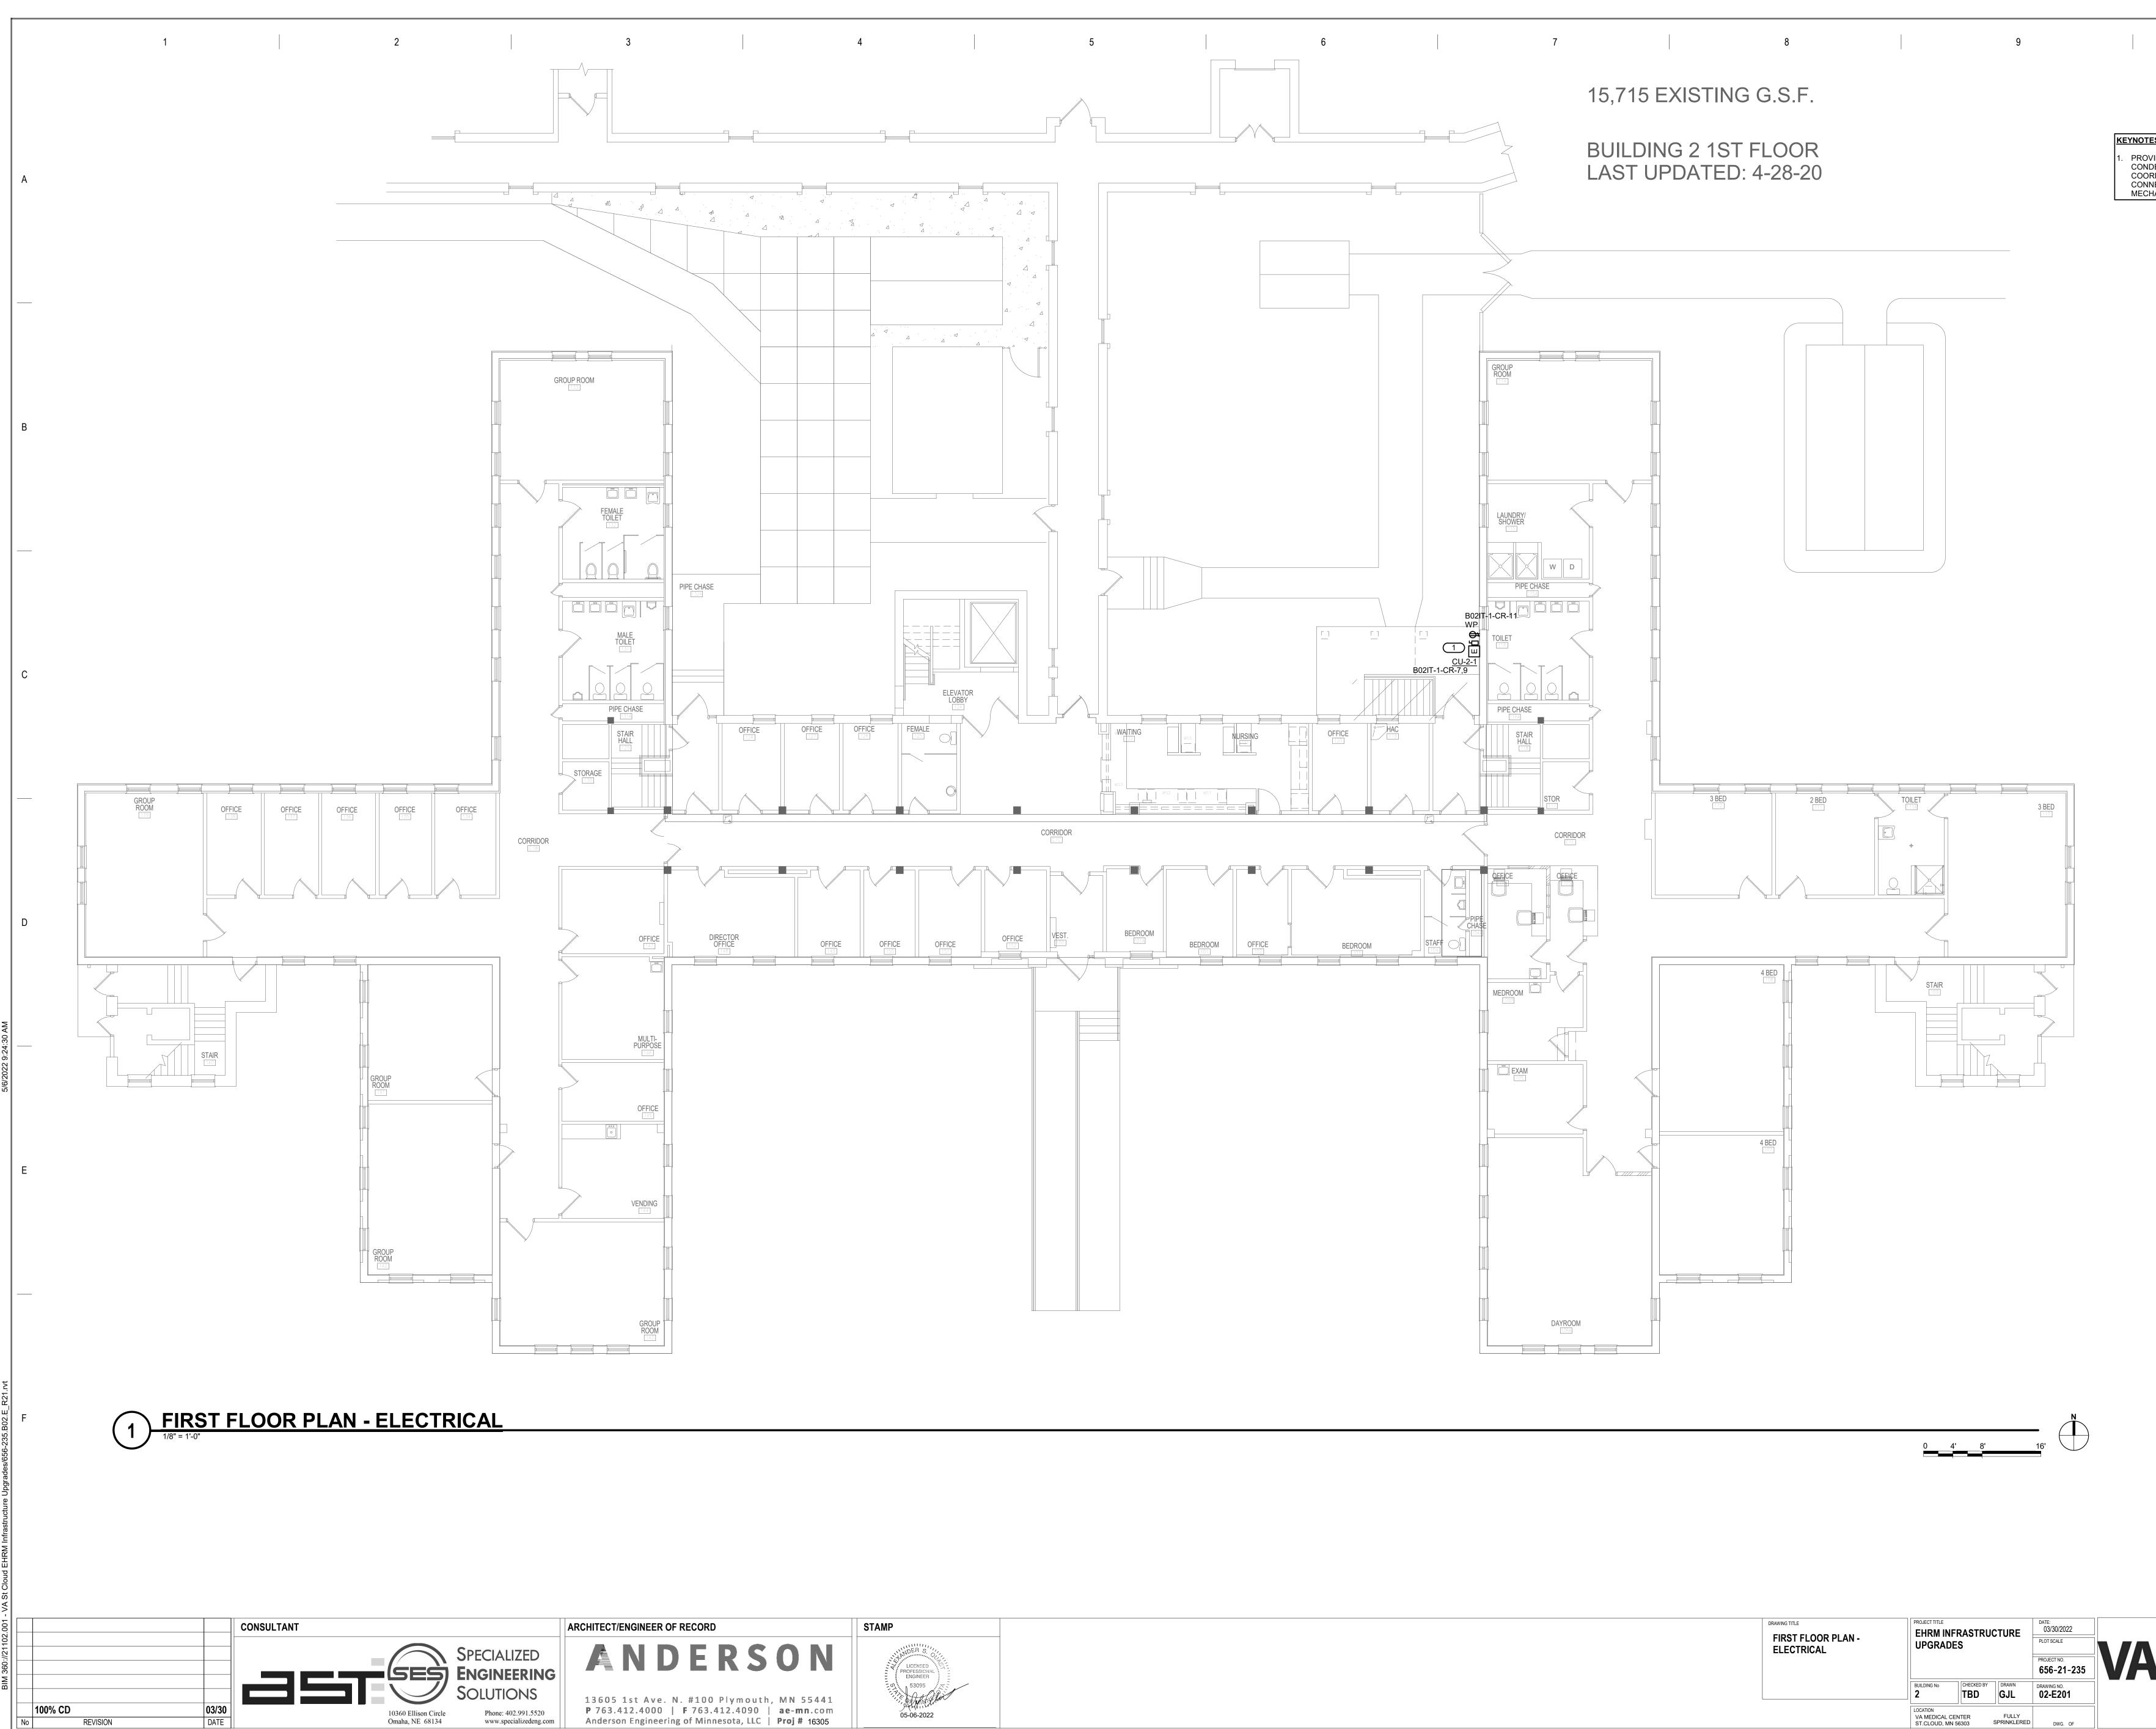KEYNOTES: # . PROVIDE ELECTRICAL CONNECTION TO CONDENSING UNIT, AS REQUIRED. COORDINATE FINAL LOCATION AND CONNECTION REQUIREMENTS WITH MECHANICAL.

10



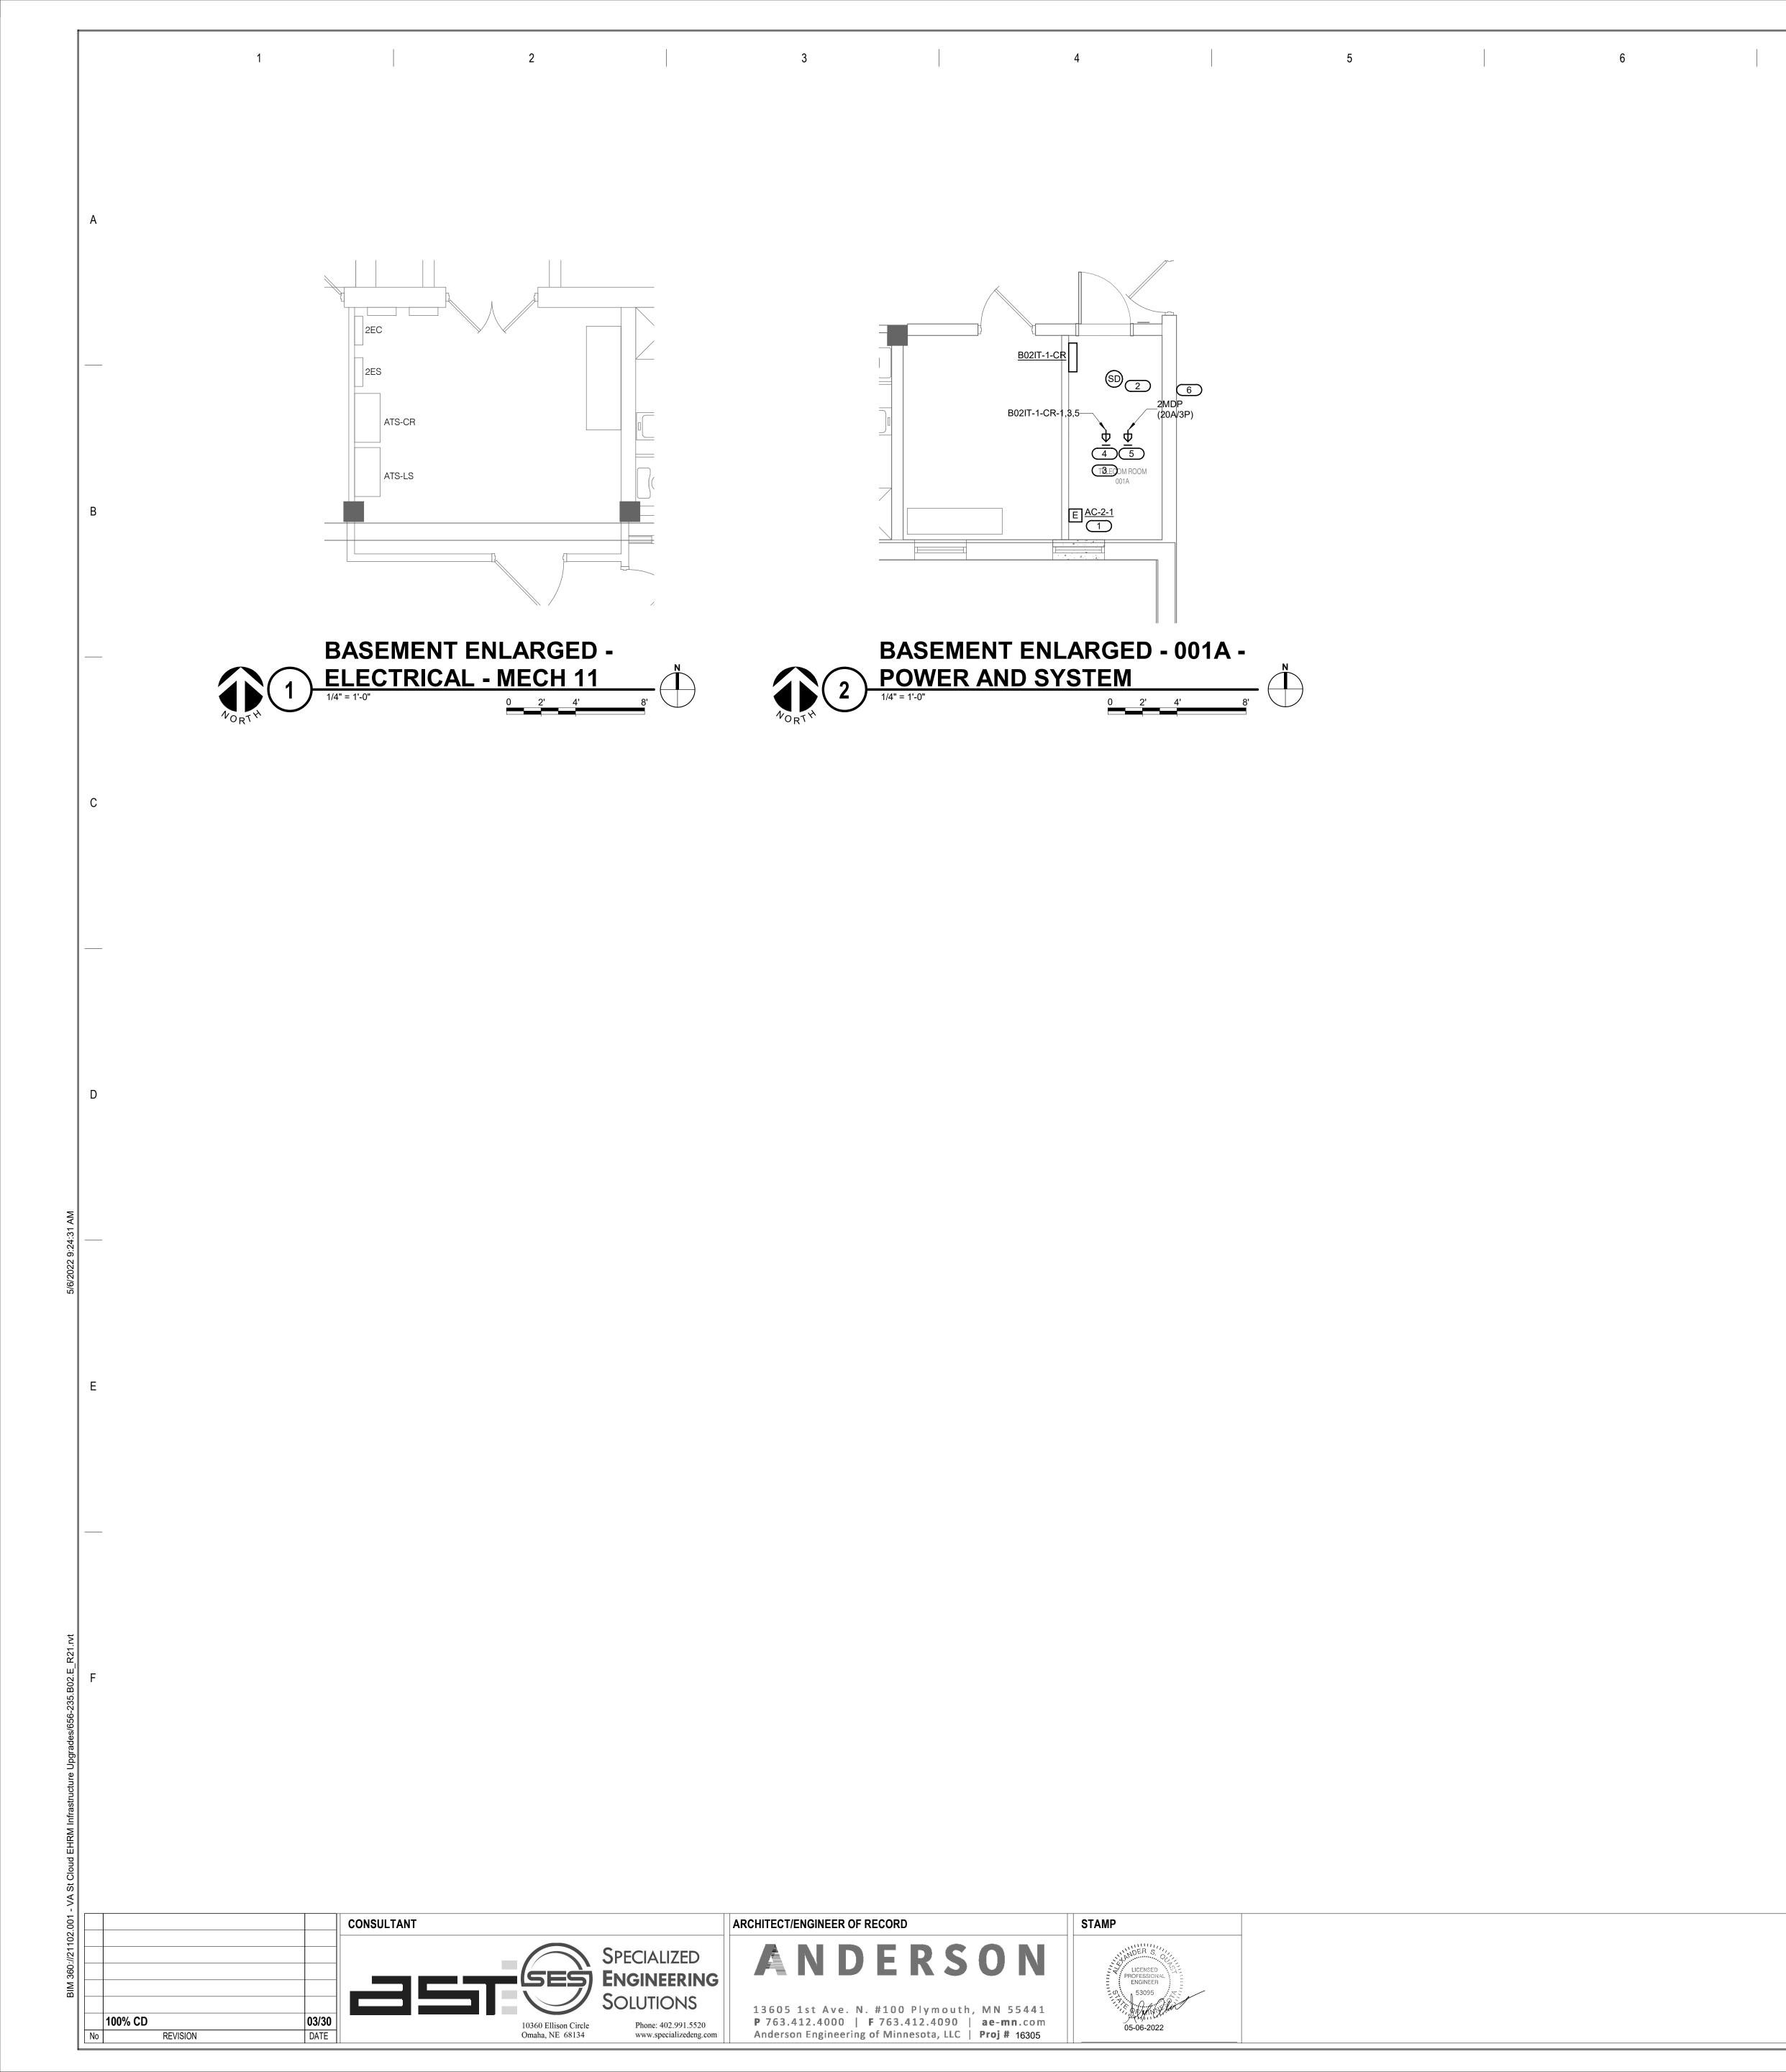

| 7 | 8 | 9 | |
|---|---|---|---|
| | | | SHEET NOTES: 1. REFER TO TE LAYOUT AND 2. REFER TO SH & ONE-LINE O KEYNOTES: # |
| | | | INDOOR UNIT UNIT. COORD M.C. CONNECT SM EXISTING SLC COORDINATE RECEPTACLE CONTRACTOF TO PANEL FO PROVIDE EAT PHASE,4-WIR RACK TOWEF |
| | | | 5. PROVIDE APC WITH L21-20P ZERO U, 5.7 K OUTLETS. PR PER MANUFA 6. VERIFY EXAC AND REARRA CONSECUTIV |

| DRAWING TITLE ELECTRICAL ENLARGED PLANS | PROJECT TITLE EHRM IN UPGRAD | FRASTRU(ES | CTURE | DATE: 03/30/2022 PLOT SCALE PROJECT NO. | |
|---|--|-------------------|----------------------|--|--|
| | BUILDING No 2 | CHECKED BY TBD | DRAWN GJL | 656-21-235 DRAWING NO. 02-E300 | |
| | LOCATION VA MEDICAL O ST.CLOUD, MI | | FULLY SPRINKLERED | DWG. OF | |

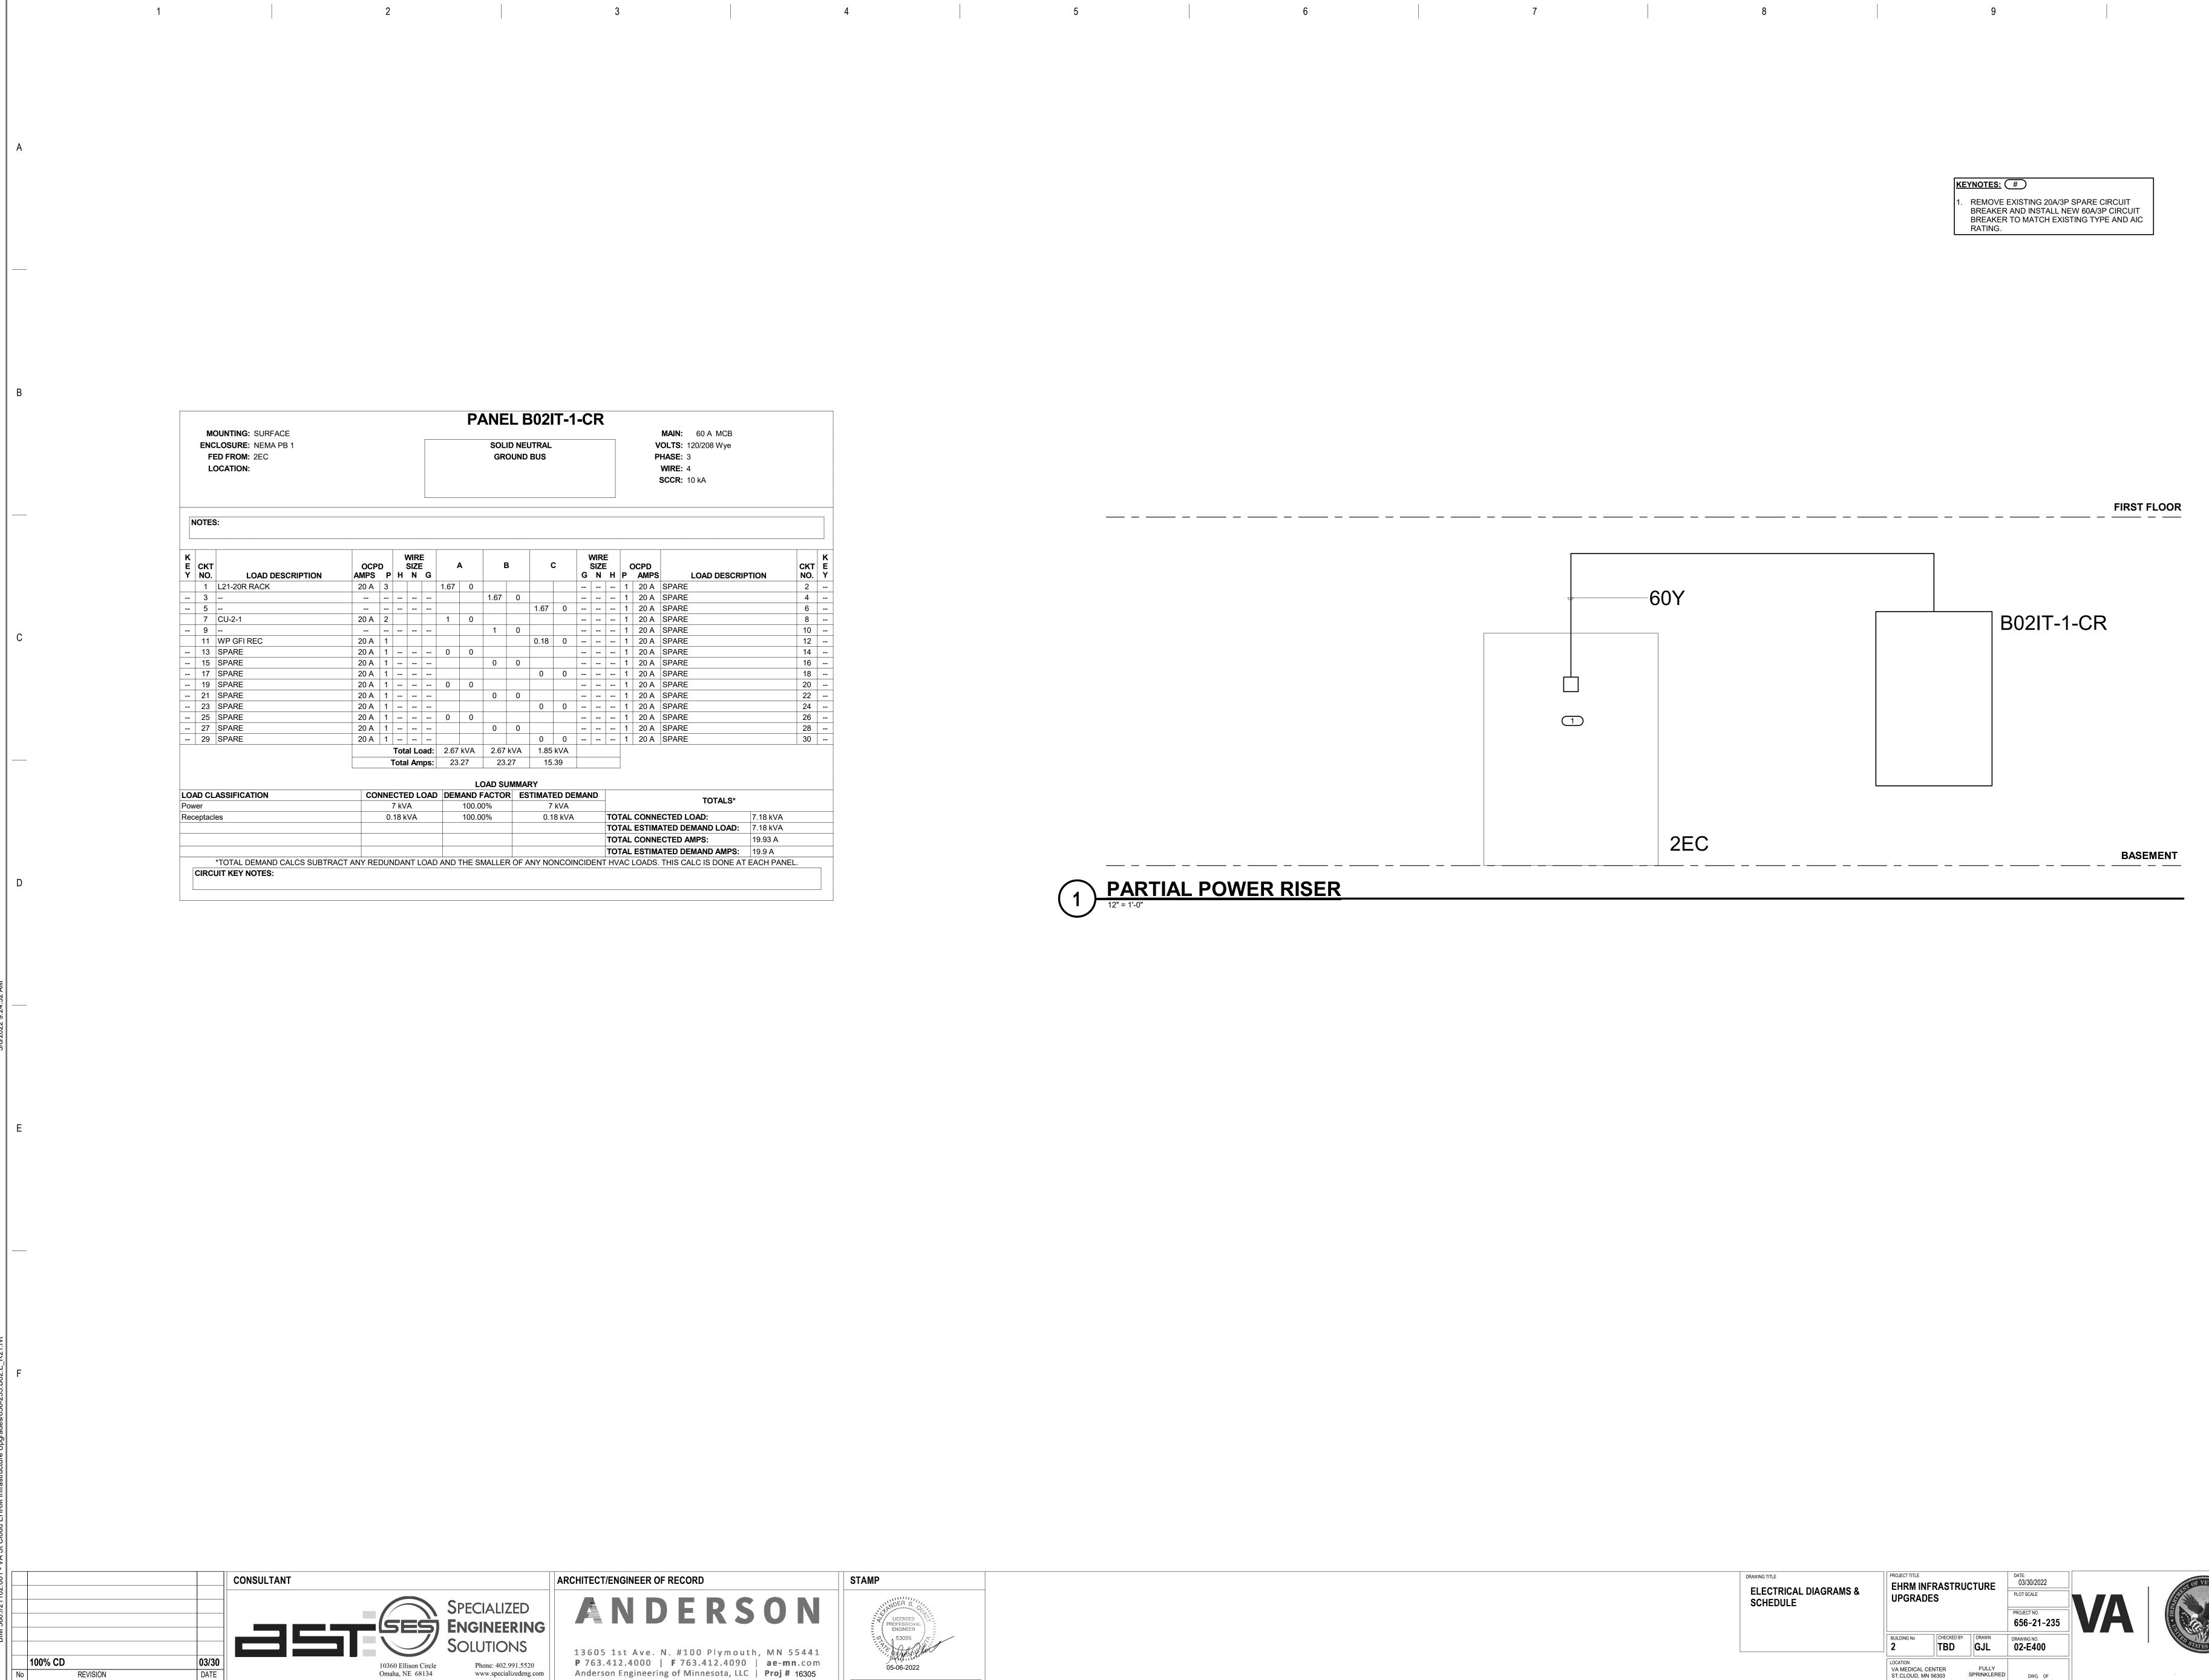
R TO TECHNOLOGY PLANS FOR IT ROOM JT AND RACK LAYOUT/DETAILS. R TO SHEET 0-GE400 DETAIL FOR LAYOUT E-LINE OF RACK.

R UNIT TO BE POWERED BY OUTDOOR COORDINATE EXACT LOCATION WITH ECT SMOKE DETECTOR TO NEAREST ING SLC. DINATE FINAL LOCATION OF

TING SLC. RDINATE FINAL LOCATION OF EPTACLE L21-20R WITH TELECOM TRACTOR. PROVIDE 3/4"C-4#12, 1#12 GND ANEL FOR EACH RECEPTACLE. VIDE EATON BLADEUPS, 5KW, 120/208V, 3-SE,4-WIRE RACK MOUNTED UPS FOR EACH < TOWER. VIDE APC#AP8861 RPDU RACK PDU 2G


VIDE APC#AP8861 RPDU RACK PDU 2G L21-20P CORD. (120/208V, 3-PHASE, 20A, 0 U, 5.7 KW, 208V, (36) C13 (6) C19 (2) 5-20R ETS. PROVIDE TWO PER RACK, MOUNTED MANUFACTURER'S REQUIREMENTS. FY EXACT CIRCUIT AVAILABILITY IN PANEL REARRANGE BREAKERS TO ALLOW 3 SECUTIVE SPACES.






| IAIN: 60 A MCB LTS: 120/208 Wye ASE: 3 IIRE: 4 CCR: 10 kA | | | |
|---|----------|------------|-------------|
| LOAD DESCRIP | TION | CKT NO. | K E Y |
| PARE | | 2 | |
| PARE | | 4 | |
| PARE | | 6 | |
| PARE | | 8 | |
| PARE | | 10 | |
| PARE | | 12 | |
| PARE | | 14 | |
| PARE | | 16 | |
| PARE | | 18 | |
| PARE | | 20 | |
| PARE | | 22 | |
| PARE | | 24 | |
| PARE | | 26 | |
| PARE | | 28 | |
| PARE | | 30 | |
| TOTALS* | | | |
| TED LOAD: | 7.18 kVA | | |
| ED DEMAND LOAD: | 7.18 kVA | | |
| TED AMPS: | 19.93 A | | |
| | | | |
| ED DEMAND AMPS: | 19.9 A | | |
| HIS CALC IS DONE AT I | | · | |

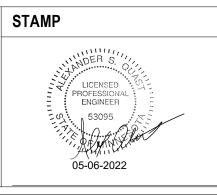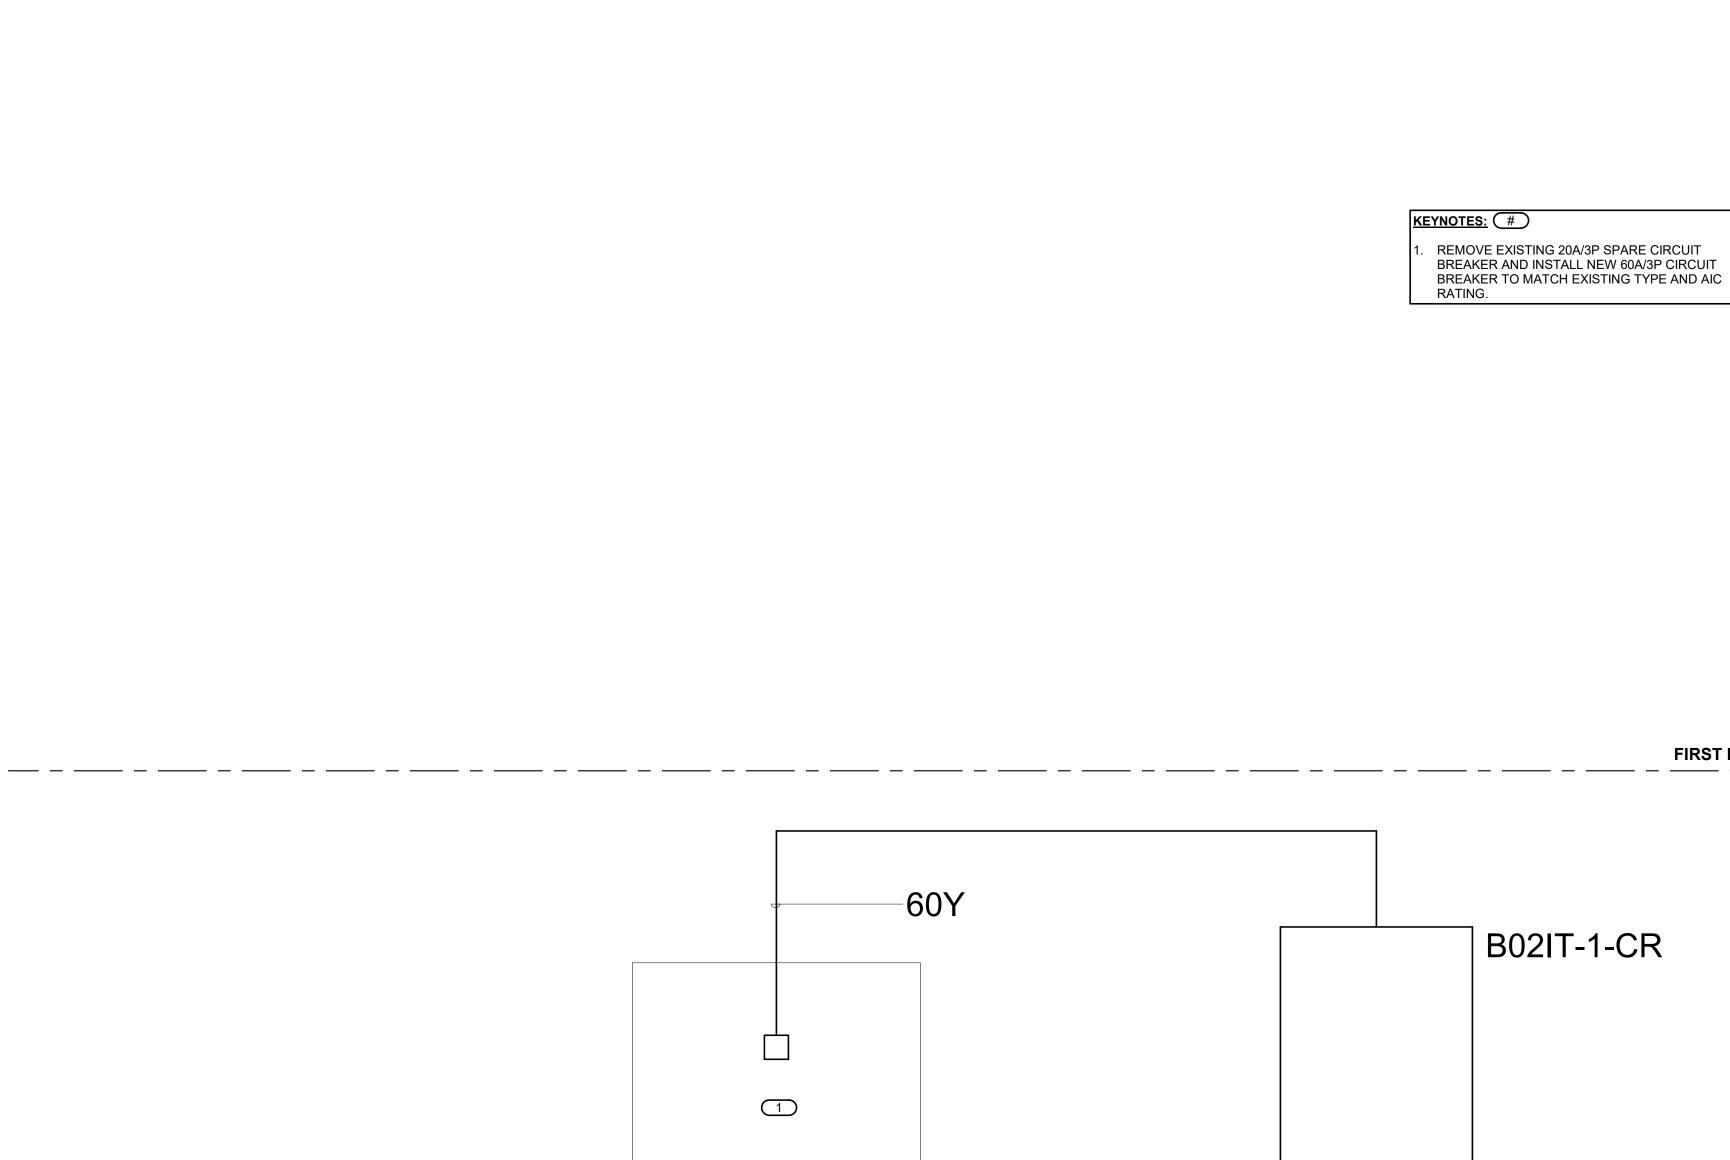1 PARTIAL POWER RISER






2EC

| DRAWING TITLE ELECTRICAL DIAGRAMS & SCHEDULE | PROJECT TITLE EHRM IN UPGRAD | | ICTURE | DATE: 03/30/2022 PLOT SCALE PROJECT NO. 656-21-235 | V |
|--|--|------------|--------------|--|---|
| | BUILDING No | CHECKED BY | DRAWN GJL | DRAWING NO. 02-E400 | |
| | LOCATION VA MEDICAL C ST.CLOUD, MN | | FULLY | DWG. OF | |

FIRST FLOOR

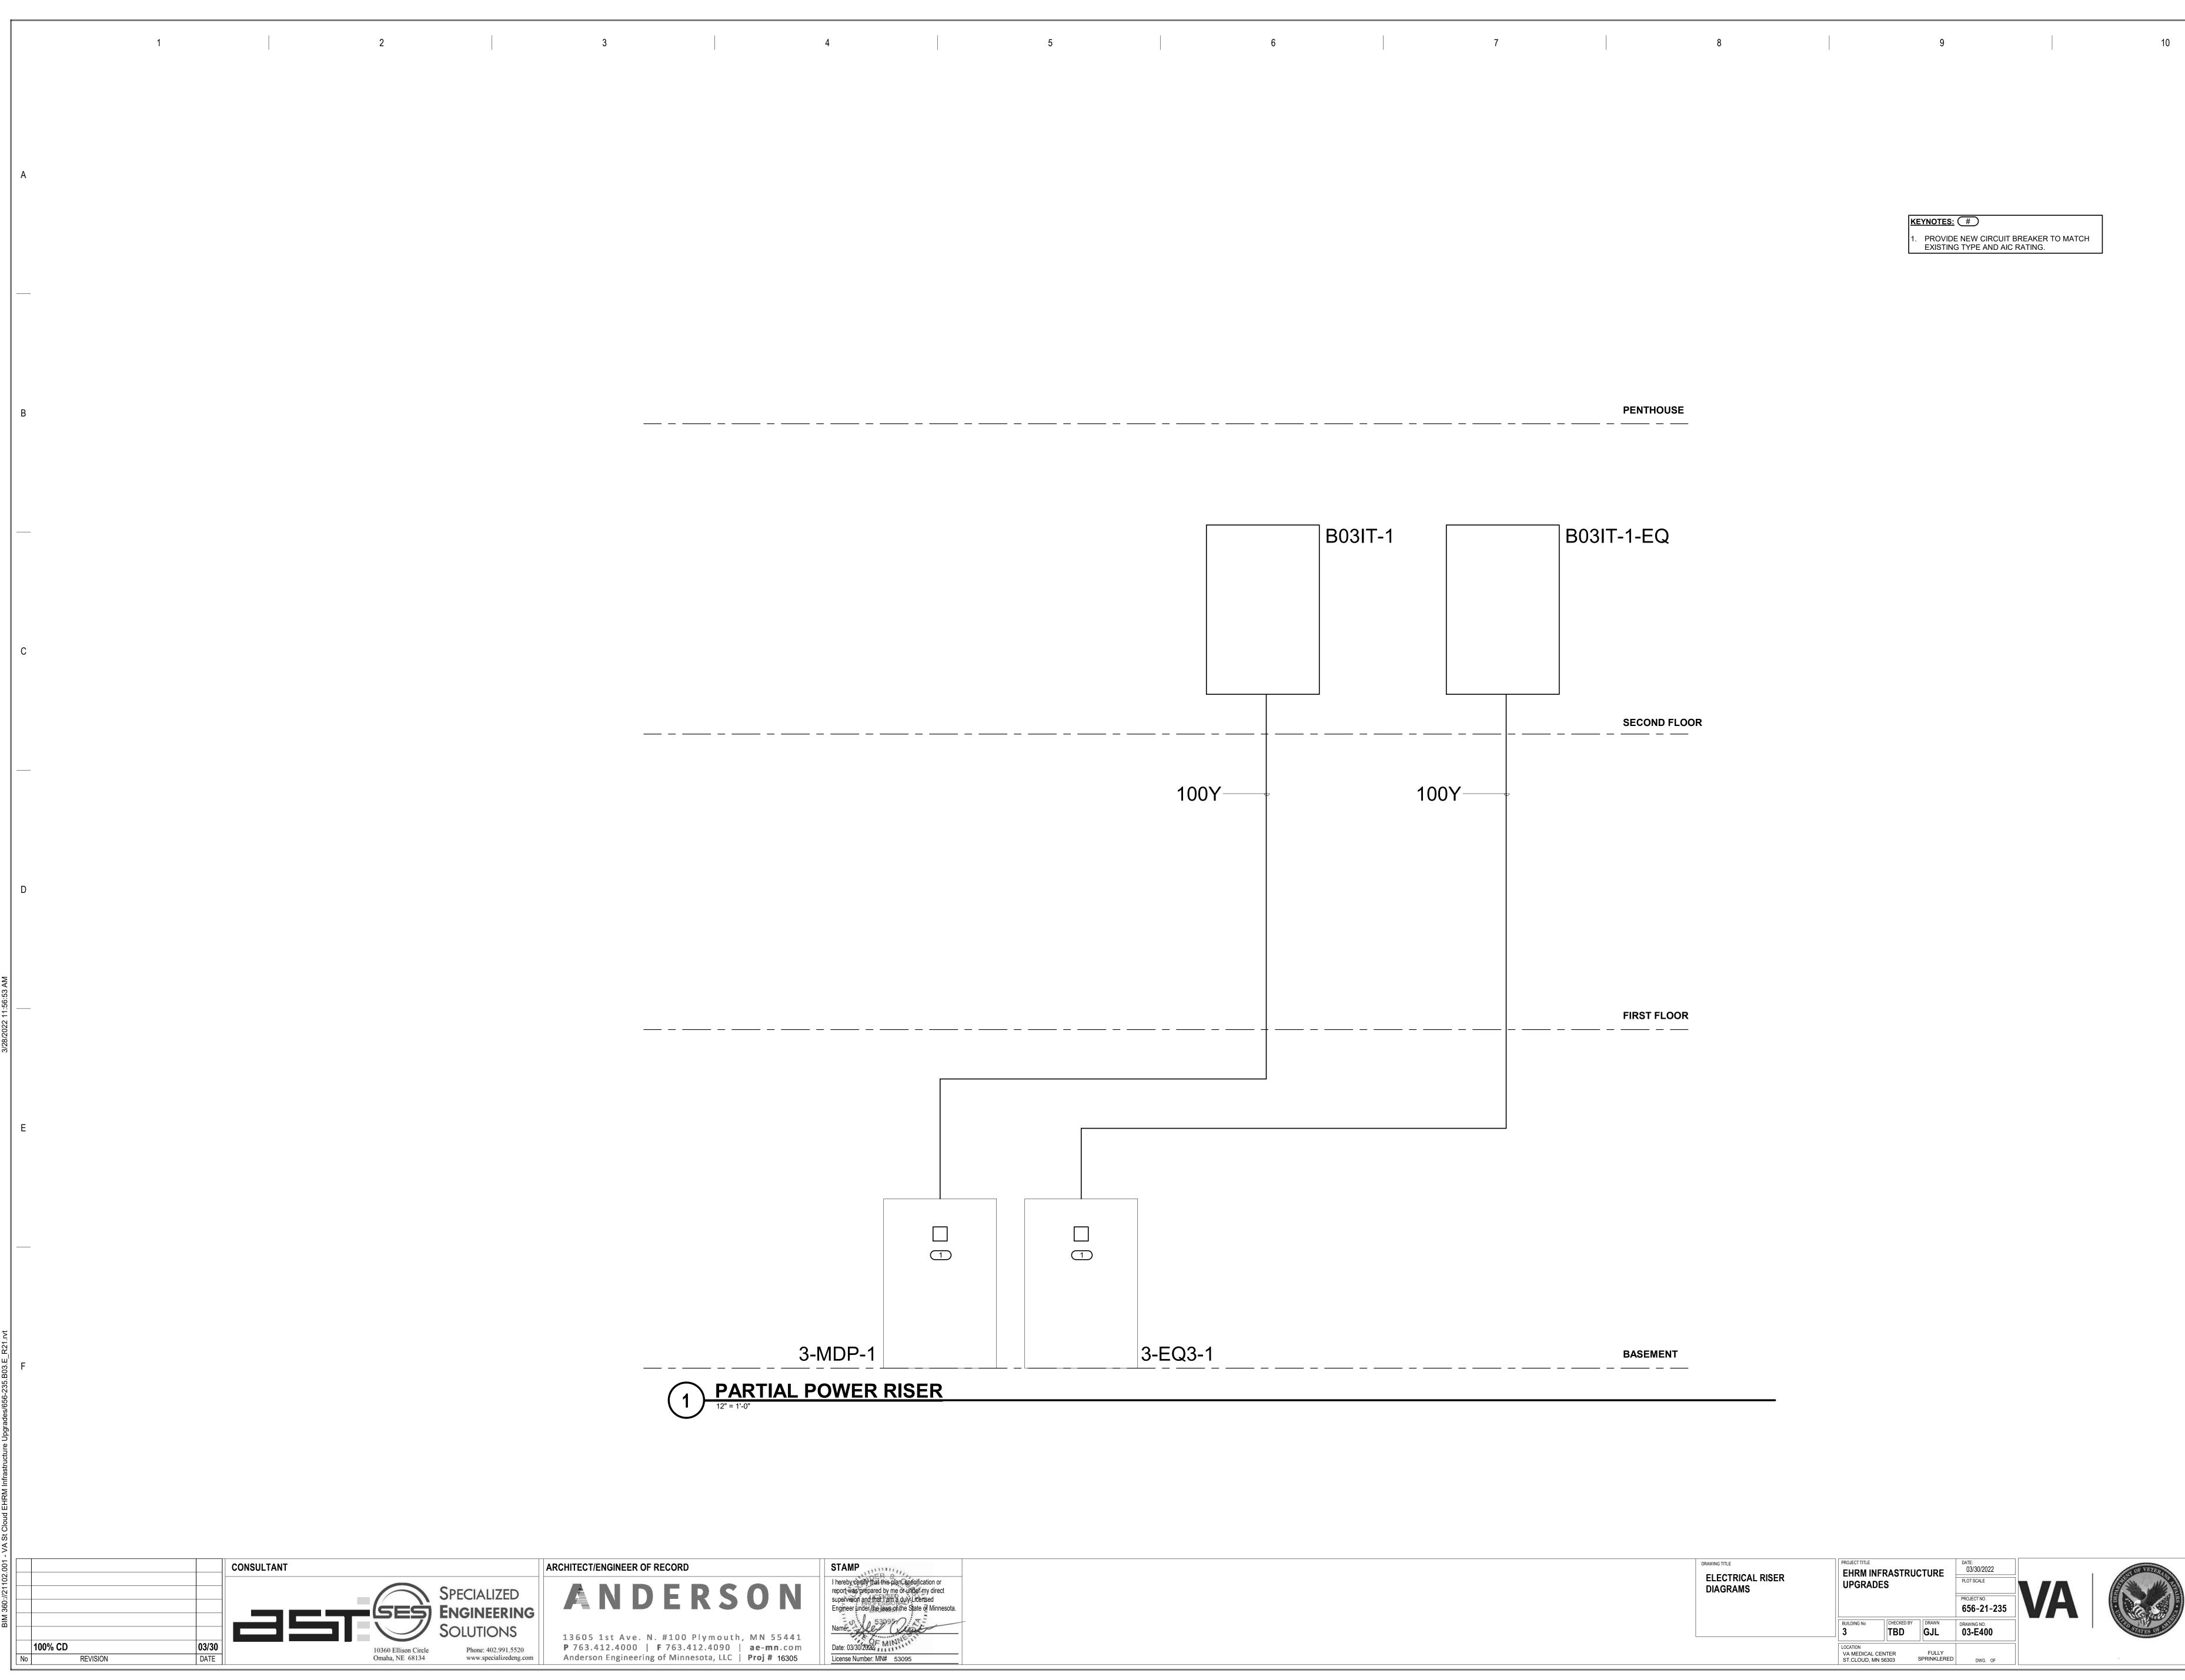BASEMENT






KEYNOTES: # . PROVIDE NEW CIRCUIT BREAKER TO MATCH EXISTING TYPE AND AIC RATING.

| DRAWING TITLE ELECTRICAL RISER DIAGRAMS | PROJECT TITLE EHRM INF UPGRAD | | ICTURE | DATE: 03/30/2022 PLOT SCALE PROJECT NO. 656-21-235 | |
|---|--|------------|--------------|--|--|
| | BUILDING No 3 | CHECKED BY | drawn GJL | DRAWING NO. 03-E400 | |
| | LOCATION VA MEDICAL C ST.CLOUD, MN | | FULLY | DWG. OF | |



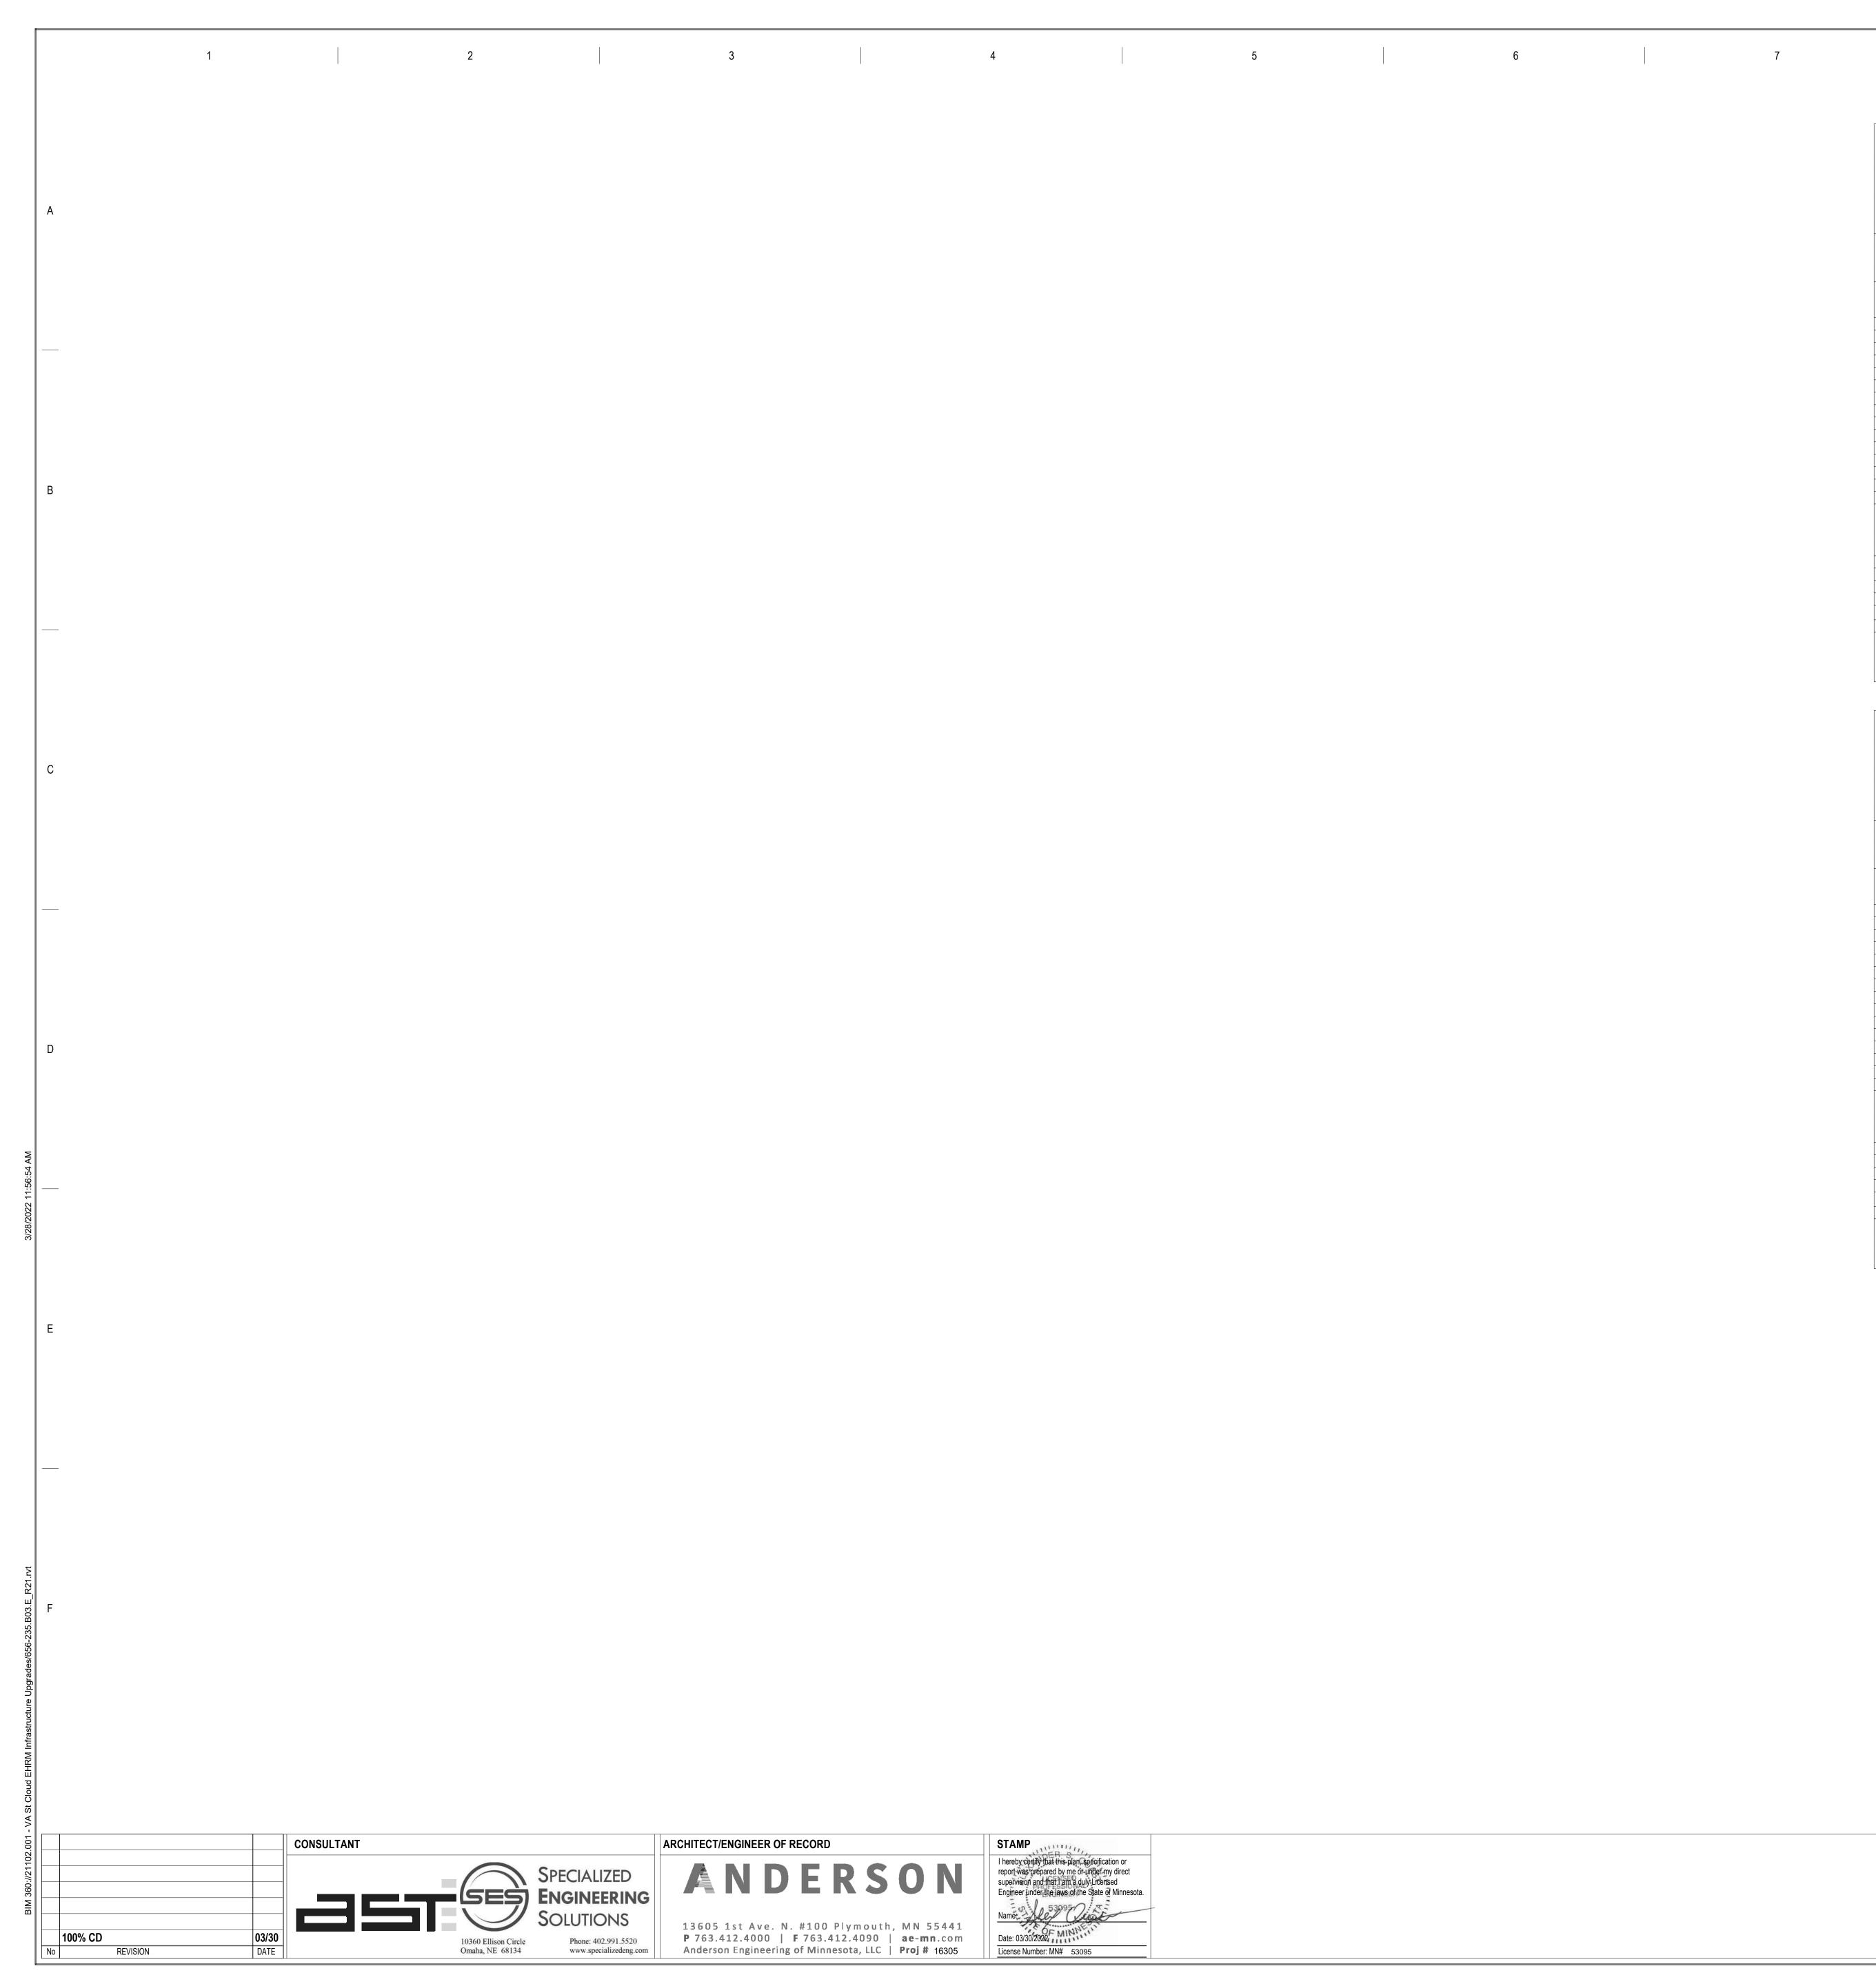

STAMP I hereby certify that this plan, specification or report was prepared by me or under my direct supervision and that I am a duly Licensed Engineer under the laws of the State of Minnesota. License Number: MN# 53095

| Solud NEUTRAL GROUND BUS SOLUD NEUTRAL GROUND BUS SOLUD NEUTRAL GROUND BUS NOTES: PROVIDE INTEGRAL ELECTRIC METER IN PANEL: K K VID. LOAD DESCRIPTION AMPS I INTEGRAL ELECTRIC METER IN PANEL: K K VID. LOAD DESCRIPTION AMPS I INTEGRAL ELECTRIC METER IN PANEL: K K C VID. LOAD DESCRIPTION AMPS I IT IS FARE 20A 1 10 Colspan="2">Colspan="2">10 13 SPARE 20A 1 10 Colspan="2">Colspan="2">Colspan="2">10 17 Colspan="2">Colspan="2">Colspan="2">Colspan="2">Colspan="2">Colspan="2" 10 | | м | DUNTING: SURFACE | | | | | | | P | ANE | ELE | 303 | IT-2 | 2 | | | | |
|--|---|--|--|--|---|--|---|---|-----------------------------|-------------------------------------|---|--------|--------------------------------|---------------------------|---|--------------------------------------|---|---|---|
| LOCATION: TELECOM ROOM 205E NOTES: PROVIDE INTEGRAL ELECTRIC METER IN PANEL K OCTO OCPO NIFE A B C WIRE OCPO NIFE NOTES: LODAD DESCRIPTION OCPO NIFE SZE A B C WIRE OCPO NIFE 1 TELECOM ROOM RCC. 201A 1 - 0 0 0 0 - - 1 2 2 2 2 3 SPARE 20A 1 - - 0 0 0 - - 1 20 | | ENC | LOSURE: NEMA PB 1 | | | | | | | | | | | | | | | | |
| NOTES: PROVIDE INTEGRAL ELECTRIC METER IN PANEL É CAT LOAD DESCRIPTION AMPS P N G B C WRE OCPU 1 11 12 0 0.36 0 1.67 1.67 1 | | | | | | | | | | | GR | OUND | BUS | | | | | | |
| K OKT LOAD DESCRIPTION AMPS P N SE A B C NURE SUE OCED SUE AMPS P N M G S C SUE G N H P AM 3 121-00R RACK 20A 3 - 1 | | _ | | | | | | | | | | | | | | | | | |
| K OKT LOAD DESCRIPTION AMPS P N SE A B C NURE SUE OCED SUE AMPS P N M G S C SUE G N H P AM 3 121-00R RACK 20A 3 - 1 | | | | | | | | | | | | | | | | | | | |
| E CM LOAD DESCRIPTION APP N G A B C Size S N PORE 1 121-008 RACK 20.4 1 0 0.3 0 <th>N</th> <th>IOTES</th> <th>5: PROVIDE INTEGRAL ELECTR</th> <th>IC METER</th> <th>IN</th> <th>PAN</th> <th>IEL.</th> <th></th> | N | IOTES | 5 : PROVIDE INTEGRAL ELECTR | IC METER | IN | PAN | IEL. | | | | | | | | | | | | |
| E CM LOAD DESCRIPTION APP N G A B C Size S N PORE 1 121-008 RACK 20.4 1 0 0.3 0 <th></th> | | | | | | | | | | | | | | | | | | | |
| I I D 28 D <thd< th=""> D D D</thd<> | E | | | | | | SIZ | E | | Α | | В | | С | | SIZE | Ξ | | |
| B 21-20R RACK 20 A 3 - 1 20 1 - - - 1 20 1 - - 1 20 1 - - 1 20 1 1 20 1 20 1 20 1 20 1 20 1 20 1 20 <td>Y</td> <td></td> <td></td> <td></td> <td></td> <td></td> <td>- N</td> <td>G</td> <td></td> <td>0</td> <td></td> <td></td> <td></td> <td></td> <td>G</td> <td>N</td> <td>н</td> <td>-</td> <td></td> | Y | | | | | | - N | G | | 0 | | | | | G | N | н | - | |
| - - - - - - 167 0 0 0.18 0 1 1 20 1 MP GIT REC. 20 A 1 - - 0 0 0.18 0 - - 1 20 - 13 SPARE 20 A 1 - - 0 0 0 - - 1 20 - 13 SPARE 20 A 1 - - 0 0 0 - - 1 20 - 19 SPARE 20 A 1 - - 0 0 0 - - 1 20 - 23 SPARE 20 A 1 - - 0 0 0 - - 1 20 20 20 1 - - 0 0 0 - - 1 20 20 1 - - 0 0 0 - 1 1 20 1 - -< | | • | | | _ | | | | 0.00 | | 1.67 | 0 | | | | | | | |
| Image: Second | | | | | | | | | 4.07 | | | | 1.67 | 0 | | | | | |
| II WP GFIREC. 20 A I | | | LIGHTING | | - | | - | | 1.67 | 0 | 0 | 0 18 | | | | | | - | |
| Is SPARE 20 A 1 - - 0 0 0 - - 1 1 2 1 2 1 2 1 2 1 2 1 2 1 2 1 2 1 2 1 2 1 1 2 1 1 2 1 1 2 1 1 2 1 1 2 1 1 1 2 1 1 2 1 1 2 1 1 2 1 1 2 1 1 2 1 1 2 1 1 2 1 1 2 1 2 1 2 1 2 1 2 1 2 1 2 1 1 2 1 1 2 1 1 2 1 2 1 2 1 2 1 2 2 1 <th2< td=""><td>+</td><td>-</td><td></td><td></td><td>-</td><td></td><td></td><td></td><td></td><td></td><td></td><td>0.10</td><td>0.18</td><td>0</td><td></td><td></td><td></td><td>-</td><td>207</td></th2<> | + | - | | | - | | | | | | | 0.10 | 0.18 | 0 | | | | - | 207 |
| Image: sparage 20 A 1 - - 0 0 0 - - 1 1 20 1 - - 1 0 0 0 0 - - 1 20 21 SPARE 20 A 1 - - 0 0 0 - - 1 20 23 SPARE 20 A 1 - - 0 0 0 - - 1 20 23 SPARE 20 A 1 - - 0 0 0 - - 1 20 1 20 1 20 1 20 1 20 1 1 20 1 20 1 1 20 1 1 20 1 1 20 1 1 20 1 1 20 1 1 20 1 1 20 1 1 20 | | | | | | - | - | | 0 | 0 | | | | | | | | 1 | 20 / |
| - 10 SPARE 20 A 1 - - 0 0 - - - 1 20 21 SPARE 20 A 1 - - - 0 0 0 - - - 1 20 23 SPARE 20 A 1 - - 0 0 0 - - 1 20 23 SPARE 20 A 1 - - 0 0 0 - - 1 20 23 SPARE 20 A 1 - - 0 0 0 - - 1 20 20 A 1 - - 0 0 0 0 0 - - 1 1 20 1040 OA 10.00% 5 10.00% 5 10 10 10 10 10 10 10 10 10 | | - | | | _ | | | | | | 0 | 0 | 0 | 0 | | | | | 20 |
| - 21 SPARE 20 A 1 - - 0 0 0 - - 1 1 20 23 SPARE 20 A 1 - - 0 0 0 - - - 1 120 25 SPARE 20 A 1 - - - 0 0 0 - - 1 120 29 SPARE 20 A 1 - - - 0 0 0 - - 1 1 20 Total Lost: 20.3 kVA 1.95 kVA 1.95 kVA 1.95 kVA 1.95 kVA 1.95 kVA 1.95 kVA 1.92 kVA <td></td> <td></td> <td></td> <td></td> <td></td> <td></td> <td>_</td> <td>-</td> <td>0</td> <td>0</td> <td></td> <td></td> <td>0</td> <td></td> <td>-</td> <td></td> <td></td> <td>1</td> <td>20 /</td> | | | | | | | _ | - | 0 | 0 | | | 0 | | - | | | 1 | 20 / |
| - 25 SPARE 20 A 1 - - - 0 0 - - - 1 1 20 0 0 0 - - - 1 1 20 1 1 1 20 0 0 0 0 0 0 1 1 1 20 0 0 0 0 0 1 1 1 20 1 1 1 20 1 1 1 20 1 1 1 20 1 1 1 20 1 | | 21 | SPARE | 20 A | | 1 - | | | | | 0 | 0 | | | | | | - | 20 |
| - 27 SPARE 20 A 1 - - 0 0 0 - - - 1 10 0 0 0 - - 1 10 0 0 0 0 - - 1 10 0 0 0 0 0 0 0 0 0 0 0 0 0 0 1 1 10 10 10 0 0 0 0 1 1 10 10 10 0 0 0 1 1 10 | | | | | _ | _ | | | | 0 | | | 0 | 0 | | | | 1 | 20 |
| - 29 SPARE 20 A 1 - - - 0 0 - - - 1 20 Total Load: 2.03 kVA 1.85 kVA 1.00.0% 0 kVA 0.00% 0.84 kVA 1.00 kVA 0.00% 0.72 kVA 1074L CON CONCOLORS 1.85 kVA 1074L CON 1.05 kVA 100 kVA 1.05 | | - | | | | | | | 0 | U | 0 | 0 | | | | | | 1 | 20 |
| Total Amps: 16.89 15.39 15.39 LOAD SUMMARY LOAD SUMMARY Lighting 0 kVA 000% 0 kVA Power 5 kVA 100.00% 5 kVA TOTAL CON Receptacles 0.72 kVA 100.00% 0 kVA TOTAL CON ** 0 0.72 kVA 100.00% 0.72 kVA TOTAL CON ** 0 0.72 kVA 100.00% 0.72 kVA TOTAL CON ** 0 0.72 kVA 100.00% 0.72 kVA TOTAL CON ** 0 0 0.72 kVA TOTAL CON TOTAL CON ** 0 0 0.72 kVA TOTAL CON TOTAL CON ** 0 0.72 kVA TOTAL CON TOTAL SO TOTAL CON CIRCUIT KEY NOTES: ** C SOLID NEUTRAL SOLID NEUTRAL FED FROM: 3-62.31 LOCATION: TELECOM ROOM 205E SOLID NEUTRAL SOLID NEUTRAL SOLID NEUTRAL ** NOTES: ** NMP P MAPS P H< | | | | | - | | | | | | - | | 0 | 0 | | | | 1 | 20 |
| LOAD SUMMARY LOAD CLASSIFICATION CONNECTED LOAD DEMAND FACTOR ESTIMATED DEMAND Power 5 kVA 100.00% 5 kVA TOTAL CON Receptacles 0.72 kVA 100.00% 5 kVA TOTAL CON Image: Constraint of the state of the | | | | | | | | | | | | | | | | | | | |
| LOAD CLASSIFICATION CONNECTED LOAD DEMAND FACTOR ESTIMATED DEMAND Lighting 0 KVA 0.00% 0 KVA 0 KVA Power 5 KVA 100.00% 5 KVA TOTAL CON Receptacles 0.72 KVA 1000.00% 0.72 KVA TOTAL CON *TOTAL DEMAND CALCS SUBTRACT ANY REDUNDANT LOAD AND THE SMALLER OF ANY NONCOINCIDENT HVAC LOAD TOTAL CON TOTAL CON CIRCUIT KEY NOTES: SOLID NEUTRAL SOLID NEUTRAL SOLID NEUTRAL SOLID NEUTRAL FED FROM: 3-EQ3.1 LOCATION: TELECOM ROOM 205E MIRE A B C WIRE NO 1 LOAD DESCRIPTION AMPS P H N G I 3 0 3< | | | | | | 10 | tal A | nps | : 16 | .89 | 15 | .39 | 15 | .39 | | | | | |
| Lighting O KVA 0.00% O KVA TOTAL CON Receptacles 0.72 kVA 100.00% 5 kVA TOTAL CON "TOTAL DEMAND CALCS SUBTRACT ANY REDUNDANT LOAD AND THE SMALLER OF ANY NONCOINCIDENT HVAC LOAD TOTAL EST TOTAL EST "TOTAL DEMAND CALCS SUBTRACT ANY REDUNDANT LOAD AND THE SMALLER OF ANY NONCOINCIDENT HVAC LOAD CIRCUIT KEY NOTES: SOLID NEUTRAL GROUND BUS SOLID NEUTRAL GROUND BUS SOLID NEUTRAL GROUND BUS NOTES: NOTES: SOLID NEUTRAL GROUND BUS 3 20 1 L21-20R RACK 20 A 3 1.67 0 - - - - 3 - - - - - 1.67 0 - | | | | | | | | | _ | | | | | | | | | | |
| Power 5 kVA 100.00% 5 kVA TOTAL CON Receptacies 0.72 kVA 100.00% 0.72 kVA TOTAL CON *TOTAL DEMAND CALCS SUBTRACT ANY REDUNDANT LOAD AND THE SMALLER OF ANY NONCOINCIDENT HVAC LOAD TOTAL CON TOTAL CON *TOTAL DEMAND CALCS SUBTRACT ANY REDUNDANT LOAD AND THE SMALLER OF ANY NONCOINCIDENT HVAC LOAD SOLID NEUTRAL SOLID NEUTRAL CIRCUIT KEY NOTES: ************************************ | | | ASSIFICATION | | NN | 1FC | | LUA | DIDEN | IAND | FACIO | R ES | SIIMAI | ED DE | :MAr | UV | | | |
| TOTAL CON TOTAL EST TOTAL CON TOTAL EST **TOTAL DEMAND CALCS SUBTRACT ANY REDUNDANT LOAD AND THE SMALLER OF ANY NONCOINCIDENT HVAC LOAD CIRCUIT KEY NOTES: FORMEL B03IT-2-EQ MOUNTING: SURFACE ENCLOSURE: NEMA PB 1 FED FROM: 3-E03-1 LOCATION: TELECOM ROOM 205E SOLID NEUTRAL GROUND BUS SOLID NEUTRAL GROUND BUS NOTES: SOLID NEUTRACE I LOCATION: TELECOM ROOM 205E SOLID NEUTRAL GROUND BUS SOLID NEUTRAL GROUND BUS 1 L21-20R RACK 20 A 1 1.67 0 - - - - - 3 - - - - - 1.87 0 - | Power | | | | | 01 | | - | | 0.00 | | | |) kVA | | | 1 | | |
| *TOTAL DEMAND CALCS SUBTRACT ANY REDUNDANT LOAD AND THE SMALLER OF ANY NONCOINCIDENT HVAC LOAD CIRCUIT KEY NOTES: MOUNTING: SURFACE ENCLOSURE: NEMA PB 1 FED FROM: 3-E03-1 SOLID NEUTRAL LOCATION: TELECOM ROOM 205E WIRE AMPS P H N G E VIRE G NOTES: K CKT LOAD DESCRIPTION OCPD AMPS P WIRE A B C SIZE G N P P AMPS P H N G A B C SIZE G N P P AMPS P H N G A B C SIZE G N P A B C SIZE G N P <td>Powe</td> <td>/er</td> <td></td> <td></td> <td></td> <td>5 I</td> <td>κVΑ «VA</td> <td></td> <td></td> <td>100.0</td> <td>)%)0%</td> <td></td> <td>0 5</td> <td>i kVA</td> <td></td> <td></td> <td></td> <td></td> <td></td> | Powe | /er | | | | 5 I | κVΑ «VA | | | 100.0 |)%)0% | | 0 5 | i kVA | | | | | |
| CIRCUIT KEY NOTES: PANEL B03IT-2-EQ SOLID NEUTRAL GROUND BUS NOTES: NOTES: T LOAD DESCRIPTION 1 QCPD AMPS P H NG MIRE SIZE SIZE 1 A B C VIRE G N H P AM 1 LIGAD DESCRIPTION AMPS P H NG 1 1.67 0 - - C VIRE G N H P AM 1 LIGAD DESCRIPTION AMPS P H NG - - - - - - 1 L21-20R RACK 20A 3 0 1.67 0 - - - - - - - - - - - -< | Powe | /er | es | | | 5 I | κVΑ «VA | | | 100.0 |)%)0% | | 0 5 | i kVA | | | то | TAL | EST |
| K | Powe | ver eptacl | *TOTAL DEMAND CALCS SUBTRA | | | 5 I 0.72 | <va <va 2 kVA</va </va | | D AND | 100.0 100.0 |)%)0%)0% | R OF / | 0 5 0.7 | 5 kVA 72 kVA | | DEN | ТО ТО ТО | TAL TAL TAL | ESTI CON ESTI |
| 7 TELECOM ROOM REC. 20 A 1 0.36 0 1 20 9 Lighting 20 A 1 0 0 0 1 20 11 CU-3-1 20 A 20 A 2 1 0 1 20 13 1 0 1 20 15 SPARE 20 A 1 1 0 1 20 15 SPARE 20 A 1 1 0 1 20 17 SPARE 20 A 1 1 20 1 20 19 | Powe | rer eptacl CIRCI CIRCI ENC FI | *TOTAL DEMAND CALCS SUBTRA UIT KEY NOTES: DUNTING: SURFACE CLOSURE: NEMA PB 1 ED FROM: 3-EQ3-1 | | | 5 I 0.72 | <va <va 2 kVA</va </va | | D AND | 100.0 100.0 THE S |)%)0%)0% MALLE ANE SOL | EL E | 0 5 0.7 ANY NC B03 | 5 kVA 72 kVA DNCOII | NCIE | | то то то | TAL TAL TAL | ESTI CON ESTI |
| 9 Lighting 20 A 1 1 20 11 CU-3-1 20 A 2 1 0 1 20 13 1 0 1 20 13 1 0 1 20 13 1 0 1 20 15 SPARE 20 A 1 1 0 1 20 17 SPARE 20 A 1 0 0 0 1 20 19 SPARE 20 A 1 < | | rer eptacl CIRCI ENC ENC FE LC IOTES IOTES | *TOTAL DEMAND CALCS SUBTRA UIT KEY NOTES: DUNTING: SURFACE LOSURE: NEMA PB 1 ED FROM: 3-EQ3-1 DCATION: TELECOM ROOM 205E S: LOAD DESCRIPTION L21-20R RACK | | DU. | 5 0.72 JND P 3 | | | | 100.0 100.0 THE S | 0% 00% MALLE SOL GR | | | | | | | TAL TAL (AC I | |
| 11 CU-3-1 20 A 2 - - - - 1 0 1 20 13 1 0 1 20 13 1 0 1 20 15 SPARE 20 A 1 0 0 0 1 20 17 SPARE 20 A 1 0 0 0 1 20 17 SPARE 20 A 1 0 0 0 1 20 19 SPARE 20 A 1 0 0 0 1 20 21 SPARE 20 A | | rer eptacl CIRCI ENC FI LC IOTES IOTES | *TOTAL DEMAND CALCS SUBTRA UIT KEY NOTES: DUNTING: SURFACE LOSURE: NEMA PB 1 ED FROM: 3-EQ3-1 DCATION: TELECOM ROOM 205E S: LOAD DESCRIPTION L21-20R RACK | CT ANY RE | EDU N N N N N N N N | 5 0.72 JND P B | (VA (VA 2 kVA ANT ANT SIZ SIZ H N | | 1.67 | 100.0 100.0 THE S | 0% 00% MALLE SOL GR | | | | | | | TAL TAL (AC I AC I AC I AC I AC I AC I AC I AC I | |
| 15 SPARE 20 A 1 0 0 0 1 20 17 SPARE 20 A 1 0 0 0 1 20 17 SPARE 20 A 1 0 0 0 1 20 19 SPARE 20 A 1 0 0 0 1 20 21 SPARE 20 A 1 0 0 0 1 20 21 SPARE 20 A 1 0 0 0 1 20 | | rer eptacl CIRCI ENC ENC FE LC IOTES OCKT NO. 1 3 5 7 | *TOTAL DEMAND CALCS SUBTRA UIT KEY NOTES: DUNTING: SURFACE ELOSURE: NEMA PB 1 ED FROM: 3-EQ3-1 DCATION: TELECOM ROOM 205E S: LOAD DESCRIPTION L21-20R RACK TELECOM ROOM REC. | CT ANY RE | P P I 33 1 | 5 0.72 JND P 3 1 | (VA (VA 2 kVA ANT ANT SIZ SIZ H N | | 1.67 | 100.0 100.0 THE S | 0% 00% 00% MALLE SOL GR | EL E | | | | | | TAL TAL (AC I P 3 1 | |
| 17 SPARE 20 A 1 0 0 0 1 20 19 SPARE 20 A 1 0 0 1 20 21 SPARE 20 A 1 0 0 0 1 20 | | rer eptacl CIRCI ENC ENC FIE LO IOTES OCKT NO. 1 3 5 7 9 | *TOTAL DEMAND CALCS SUBTRA UIT KEY NOTES: DUNTING: SURFACE CLOSURE: NEMA PB 1 ED FROM: 3-EQ3-1 DCATION: TELECOM ROOM 205E S: LOAD DESCRIPTION L21-20R RACK TELECOM ROOM REC. Lighting | CT ANY RE | P I 3 1 1 | 5 0.72 JND P 3 1 1 | (VA (VA 2 kVA ANT ANT SIZ SIZ H N | | 1.67 | 100.0 100.0 THE S | 0% 00% 00% MALLE SOL GR | EL E | 0 5 0.7 ANY NC BUS | | NCIE 2-E | EQ WIR SIZE N | | TAL TAL (AC I /AC I /ACI | |
| 19 SPARE 20 A 1 0 0 1 20 21 SPARE 20 A 1 0 0 0 1 20 | | rer eptacl CIRCI ENC FE LC IOTES IOTES IOTES | *TOTAL DEMAND CALCS SUBTRA UIT KEY NOTES: DUNTING: SURFACE ELOSURE: NEMA PB 1 ED FROM: 3-EQ3-1 DCATION: TELECOM ROOM 205E S: LOAD DESCRIPTION L21-20R RACK TELECOM ROOM REC. Lighting CU-3-1 | CT ANY RE | PD I 33 1 1 22 | 5 0.72 JND P P 3 1 1 2 | (VA (VA (VA (VA (VA ANT ANT SIZ I - - - - - - - - - - - - - - - - - | | 1.67 | 100.0 100.0 THE S P | 0% 00% 00% MALLE SOL GR | | 0 5 0.7 ANY NC BUS | | NCIE 2-E G G | VIR SIZE N | | TAL T | EST CON EST _OAI |
| | | /er eptacl CIRCI ENC ENC FE L(IOTES IOTES IOTES IOTES IOTES | *TOTAL DEMAND CALCS SUBTRA UIT KEY NOTES: DUNTING: SURFACE CLOSURE: NEMA PB 1 ED FROM: 3-EQ3-1 DCATION: TELECOM ROOM 205E CATION: TELECOM ROOM 205E CLOAD DESCRIPTION L21-20R RACK TELECOM ROOM REC. Lighting CU-3-1 SPARE | CT ANY RE | P I 3 1 1 2 1 | 5 0.72 JND P P B - 1 1 1 | (VA (VA 2) (VA 2) (V | | 1.67 | 100.0 100.0 THE S P | 0% 00% 00% MALLE SOL GR | | 0 5 0.7 ANY NC BUS | | CIL 2-E G G | VIR SIZE N | | TAL T | EST CON EST _OAI |
| 23 SPARE 20 A 1 0 0 0 | Powe Rece K F Y | rer eptacl CIRCI CIRCI ENC FI LC IOTES IOTES CKT NO. 1 3 5 7 9 11 13 5 7 9 11 13 15 17 | *TOTAL DEMAND CALCS SUBTRA UIT KEY NOTES: DUNTING: SURFACE LOSURE: NEMA PB 1 ED FROM: 3-EQ3-1 DCATION: TELECOM ROOM 205E S: LOAD DESCRIPTION L21-20R RACK TELECOM ROOM REC. Lighting CU-3-1 SPARE SPARE | CT ANY RE | P P I 3 1 1 1 1 1 1 1 1 1 1 | 5 0.72 JND JND P 1 - - - - - - - - - - - - - - - - - | (VA (VA (VA 2) kVA ANT ANT ANT - - - - - - - - - - - - - - - - - - - | LOA | 1.67 | 100.0 100.0 THE S P | 0% 00% 00% MALLE SOL GR | | 0 5 0.7 ANY NC BUS | | RCIE 2-E | VIR SIZE N | | TAL T | EST CON EST _OAI |
| 25 SPARE 20 A 1 0 0 0 1 20 | Power Rece | rer eptacl CIRCI CIRCI ENC FE LO IOTES OCKT NO. 1 3 5 7 9 11 13 5 7 9 11 13 15 17 19 21 | *TOTAL DEMAND CALCS SUBTRA UIT KEY NOTES: DUNTING: SURFACE ELOSURE: NEMA PB 1 ED FROM: 3-EQ3-1 DCATION: TELECOM ROOM 205E S: LOAD DESCRIPTION L21-20R RACK TELECOM ROOM REC. Lighting CU-3-1 SPARE SPARE SPARE SPARE SPARE SPARE | CT ANY RE CT ANY RE | PD 1 2 1 1 1 1 1 1 1 1 | 5 0.72 JND JND P P P 1 - 1 - 1 - - - - - - - - - - - | (VA (VA) (VA | LOA E E G | 1.67 0.36 1 1 0 | 100.0 100.0 THE S P | 0% 00% 00% MALLE SOL GR | | 0 5 0.7 ANY NC BUS | | NCIE 2-E G G | VIR SIZE N | TO TO TO TO TO TO TO TO TO TO TO TO TO T | TAL T | EST CON EST _OAI 20 20 20 20 20 20 20 20 20 20 20 20 20 |
| 27 SPARE 20 A 1 1 20 | Powe Rece K F Y | rer eptacl CIRCI CIRCI ENC FI LC IOTES OTES OTES OTES OTES OTES OTES OTES | *TOTAL DEMAND CALCS SUBTRA UIT KEY NOTES: DUNTING: SURFACE LOSURE: NEMA PB 1 ED FROM: 3-EQ3-1 DCATION: TELECOM ROOM 205E CATION: TELECOM ROOM 205E LOAD DESCRIPTION L21-20R RACK TELECOM ROOM REC. Lighting CU-3-1 SPARE SPARE SPARE SPARE SPARE SPARE SPARE SPARE SPARE | CT ANY RE CT ANY RE | PD PD I 3 3 1 1 1 1 1 1 1 1 | 5 0.72 JND JND P 1 - - - - - - - - - - - - - - - - - | (VA (VA (VA (VA (VA ANT ANT ANT ANT - | LOA E G I I I I I I I I I I I I I I I I I I | | 100.0 100.0 THE S P | 0% 00% 00% MALLE SOL GR | | 0 5 0.7 ANY NC BUS | | NCIE 2-E 3 3 4 4 5 5 5 5 5 5 5 5 5 5 5 5 5 5 5 5 | VIR SIZE N | | TAL T | EST CON EST _OAI 20 20 20 20 20 20 20 20 20 20 20 20 20 |

| | Total Load: | 3.03 kVA | 1.67 kV | /A 2.67 kVA | | | |
|---|----------------|----------|---------|------------------|------------------------------|----------|--|
| | Total Amps: | 26.50 | 13.89 | 23.50 | | | |
| | | · | | | | | |
| | | L | DAD SUM | IMARY | | | |
| LOAD CLASSIFICATION | CONNECTED LOAD | DEMAND F | ACTOR | ESTIMATED DEMAND | TOTALS* | | |
| Lighting | 0 kVA | 0.00 | % | 0 kVA | TOTALS | | |
| Power | 7 kVA | 100.0 | 0% | 7 kVA | TOTAL CONNECTED LOAD: | 7.36 kVA | |
| Receptacles | 0.36 kVA | 100.0 | 0% | 0.36 kVA | TOTAL ESTIMATED DEMAND LOAD: | 7.36 kVA | |
| | | | | | TOTAL CONNECTED AMPS: | 20.43 A | |
| | | | | | TOTAL ESTIMATED DEMAND AMPS: | 20.4 A | |
| *TOTAL DEMAND CALCS SUBTRACT ANY REDUNDANT LOAD AND THE SMALLER OF ANY NONCOINCIDENT HVAC LOADS. THIS CALC IS DONE AT EAC | | | | | | | |
| CIRCUIT KEY NOTES: | | | | | | | |
| | | | | | | | |

| DRAWING TITLE ELECTRICAL SCHEDULES | PROJECT TITLE EHRM INI UPGRAD | | CTURE | DATE: 03/30/2022 PLOT SCALE PROJECT NO. 656-21-235 | |
|---------------------------------------|--|------------|----------------------|--|--|
| | BUILDING No | CHECKED BY | drawn GJL | DRAWING NO. 03-E500 | |
| | LOCATION VA MEDICAL C ST.CLOUD, MN | | FULLY SPRINKLERED | DWG. OF | |


| I: 100 A MCB S: 120/208 Wye E: 3 E: 4 R: 10 kA | | |
|--|------------|-------------|
| | | |
| LOAD DESCRIPTION | CKT NO. | K E Y |
| 20R | 2 | |
| | 4 | |
| | 6 | |
| ing | 8 | |
| GFI | 10 | |
| RE | 12 | |
| RE | 14 | |
| RE | 16 | |
| RE | 18 | |
| RE | 20 | |
| RE | 22 | |
| RE | 24 | |
| RE | 26 | |
| RE | 28 | |
| RE | 30 | |
| | | |


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| TOTALS* | |
|-------------------|-------------|
| D LOAD: | 5.72 kVA |
| DEMAND LOAD: | 5.72 kVA |
| D AMPS: | 15.88 A |
| DEMAND AMPS: | 15.9 A |
| CALC IS DONE AT E | EACH PANEL. |
| | |
| | |

| MAIN: 100 A MCB | | | |
|--------------------------|----------|------------|--------|
| DLTS: 120/208 Wye | | | |
| IASE: 3 | | | |
| VIRE: 4 | | | |
| CCR: 10 kA | | | |
| | | | |
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| | | | |
| | | OVT | K |
| LOAD DESCRIP | | CKT NO. | E Y |
| _21-20R | | 2 | • |
| | | 4 | |
| - | | 6 | |
| _ighting | | 8 | |
| SPARE | | 10 | |
| SPARE | | 12 | |
| SPARE | | 14 | |
| SPARE | | 16 | |
| SPARE | | 18 | |
| SPARE | | 20 | |
| SPARE | | 22 | |
| SPARE | | 24 | |
| SPARE | | 26 | |
| SPARE | | 28 | |
| SPARE | | 30 | |
| | | | |
| | | | |
| | | | |
| | | | |
| TOTALS* | | | |
| CTED LOAD: | 7.36 kVA | | |
| TED DEMAND LOAD: | 7.36 kVA | | |
| CTED AMPS: | 20.43 A | | |
| | | | |






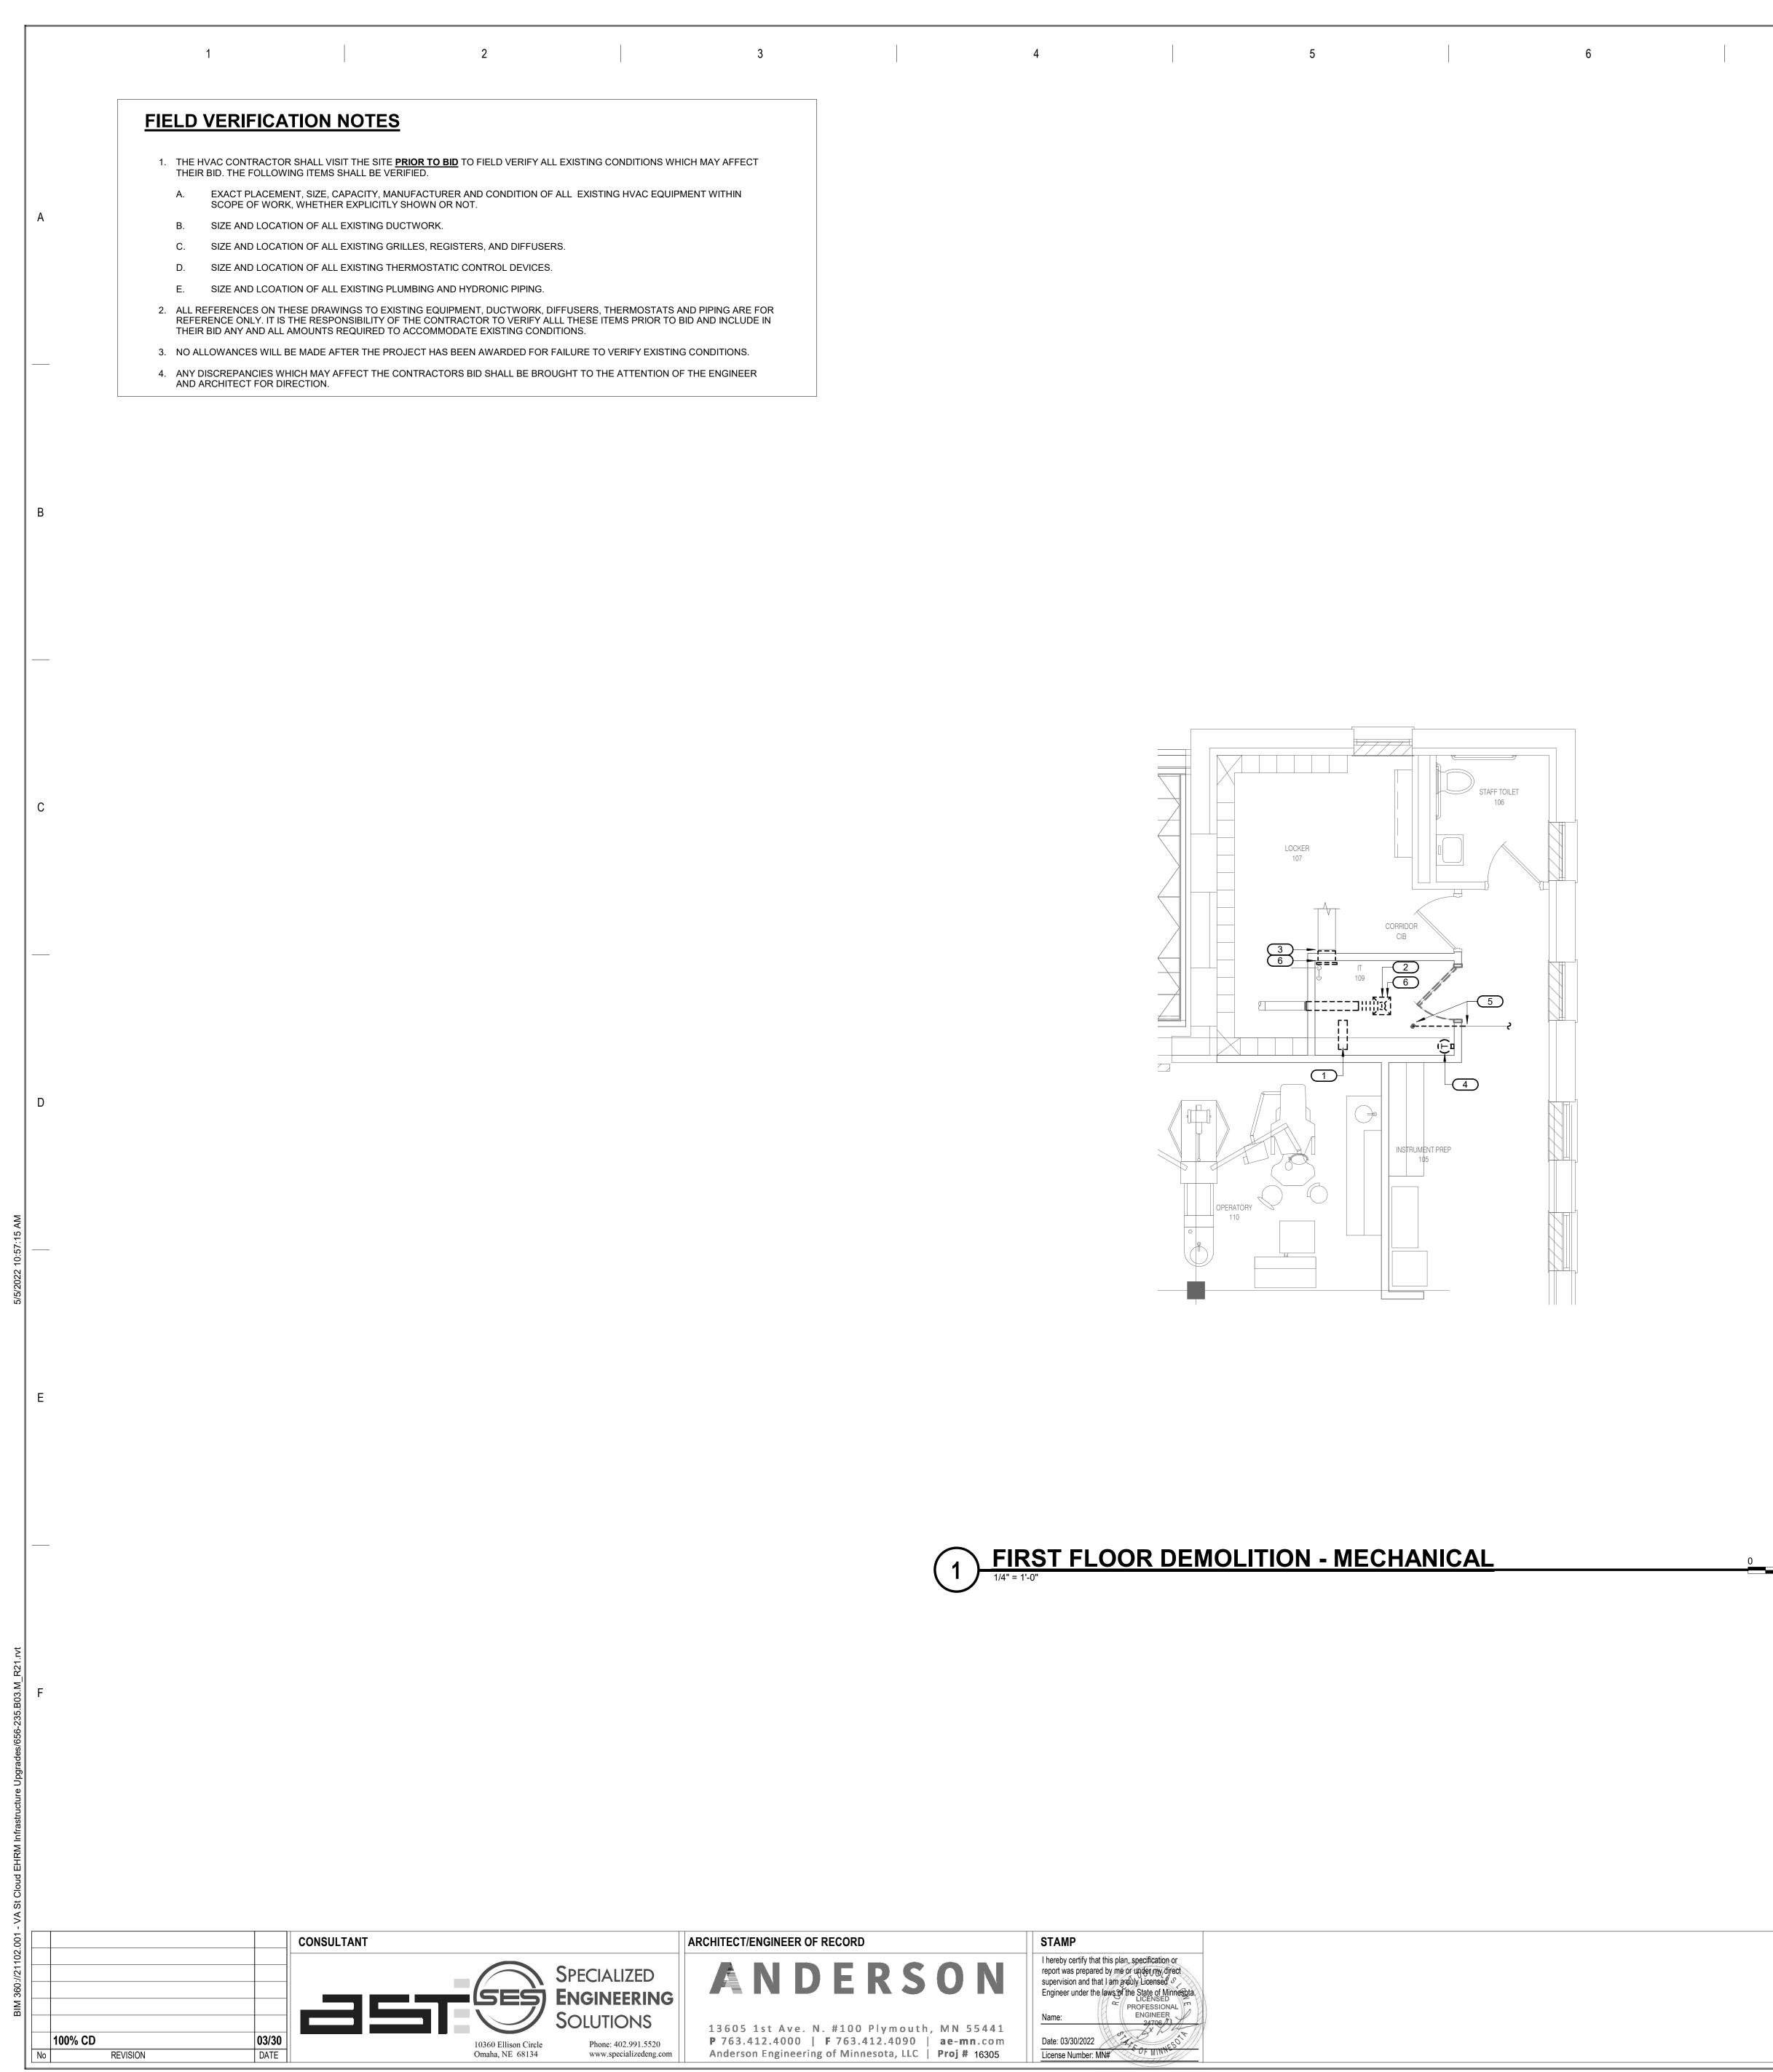


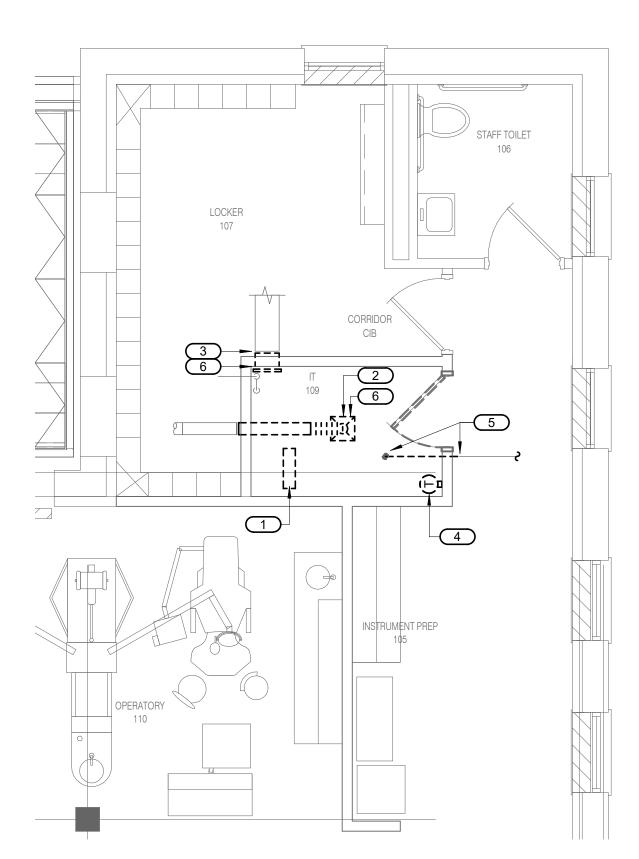1 FIRST FLOOR DEMOLITION - MECHANICAL



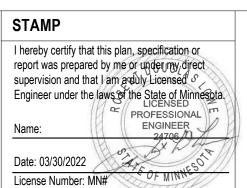

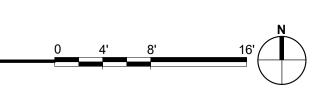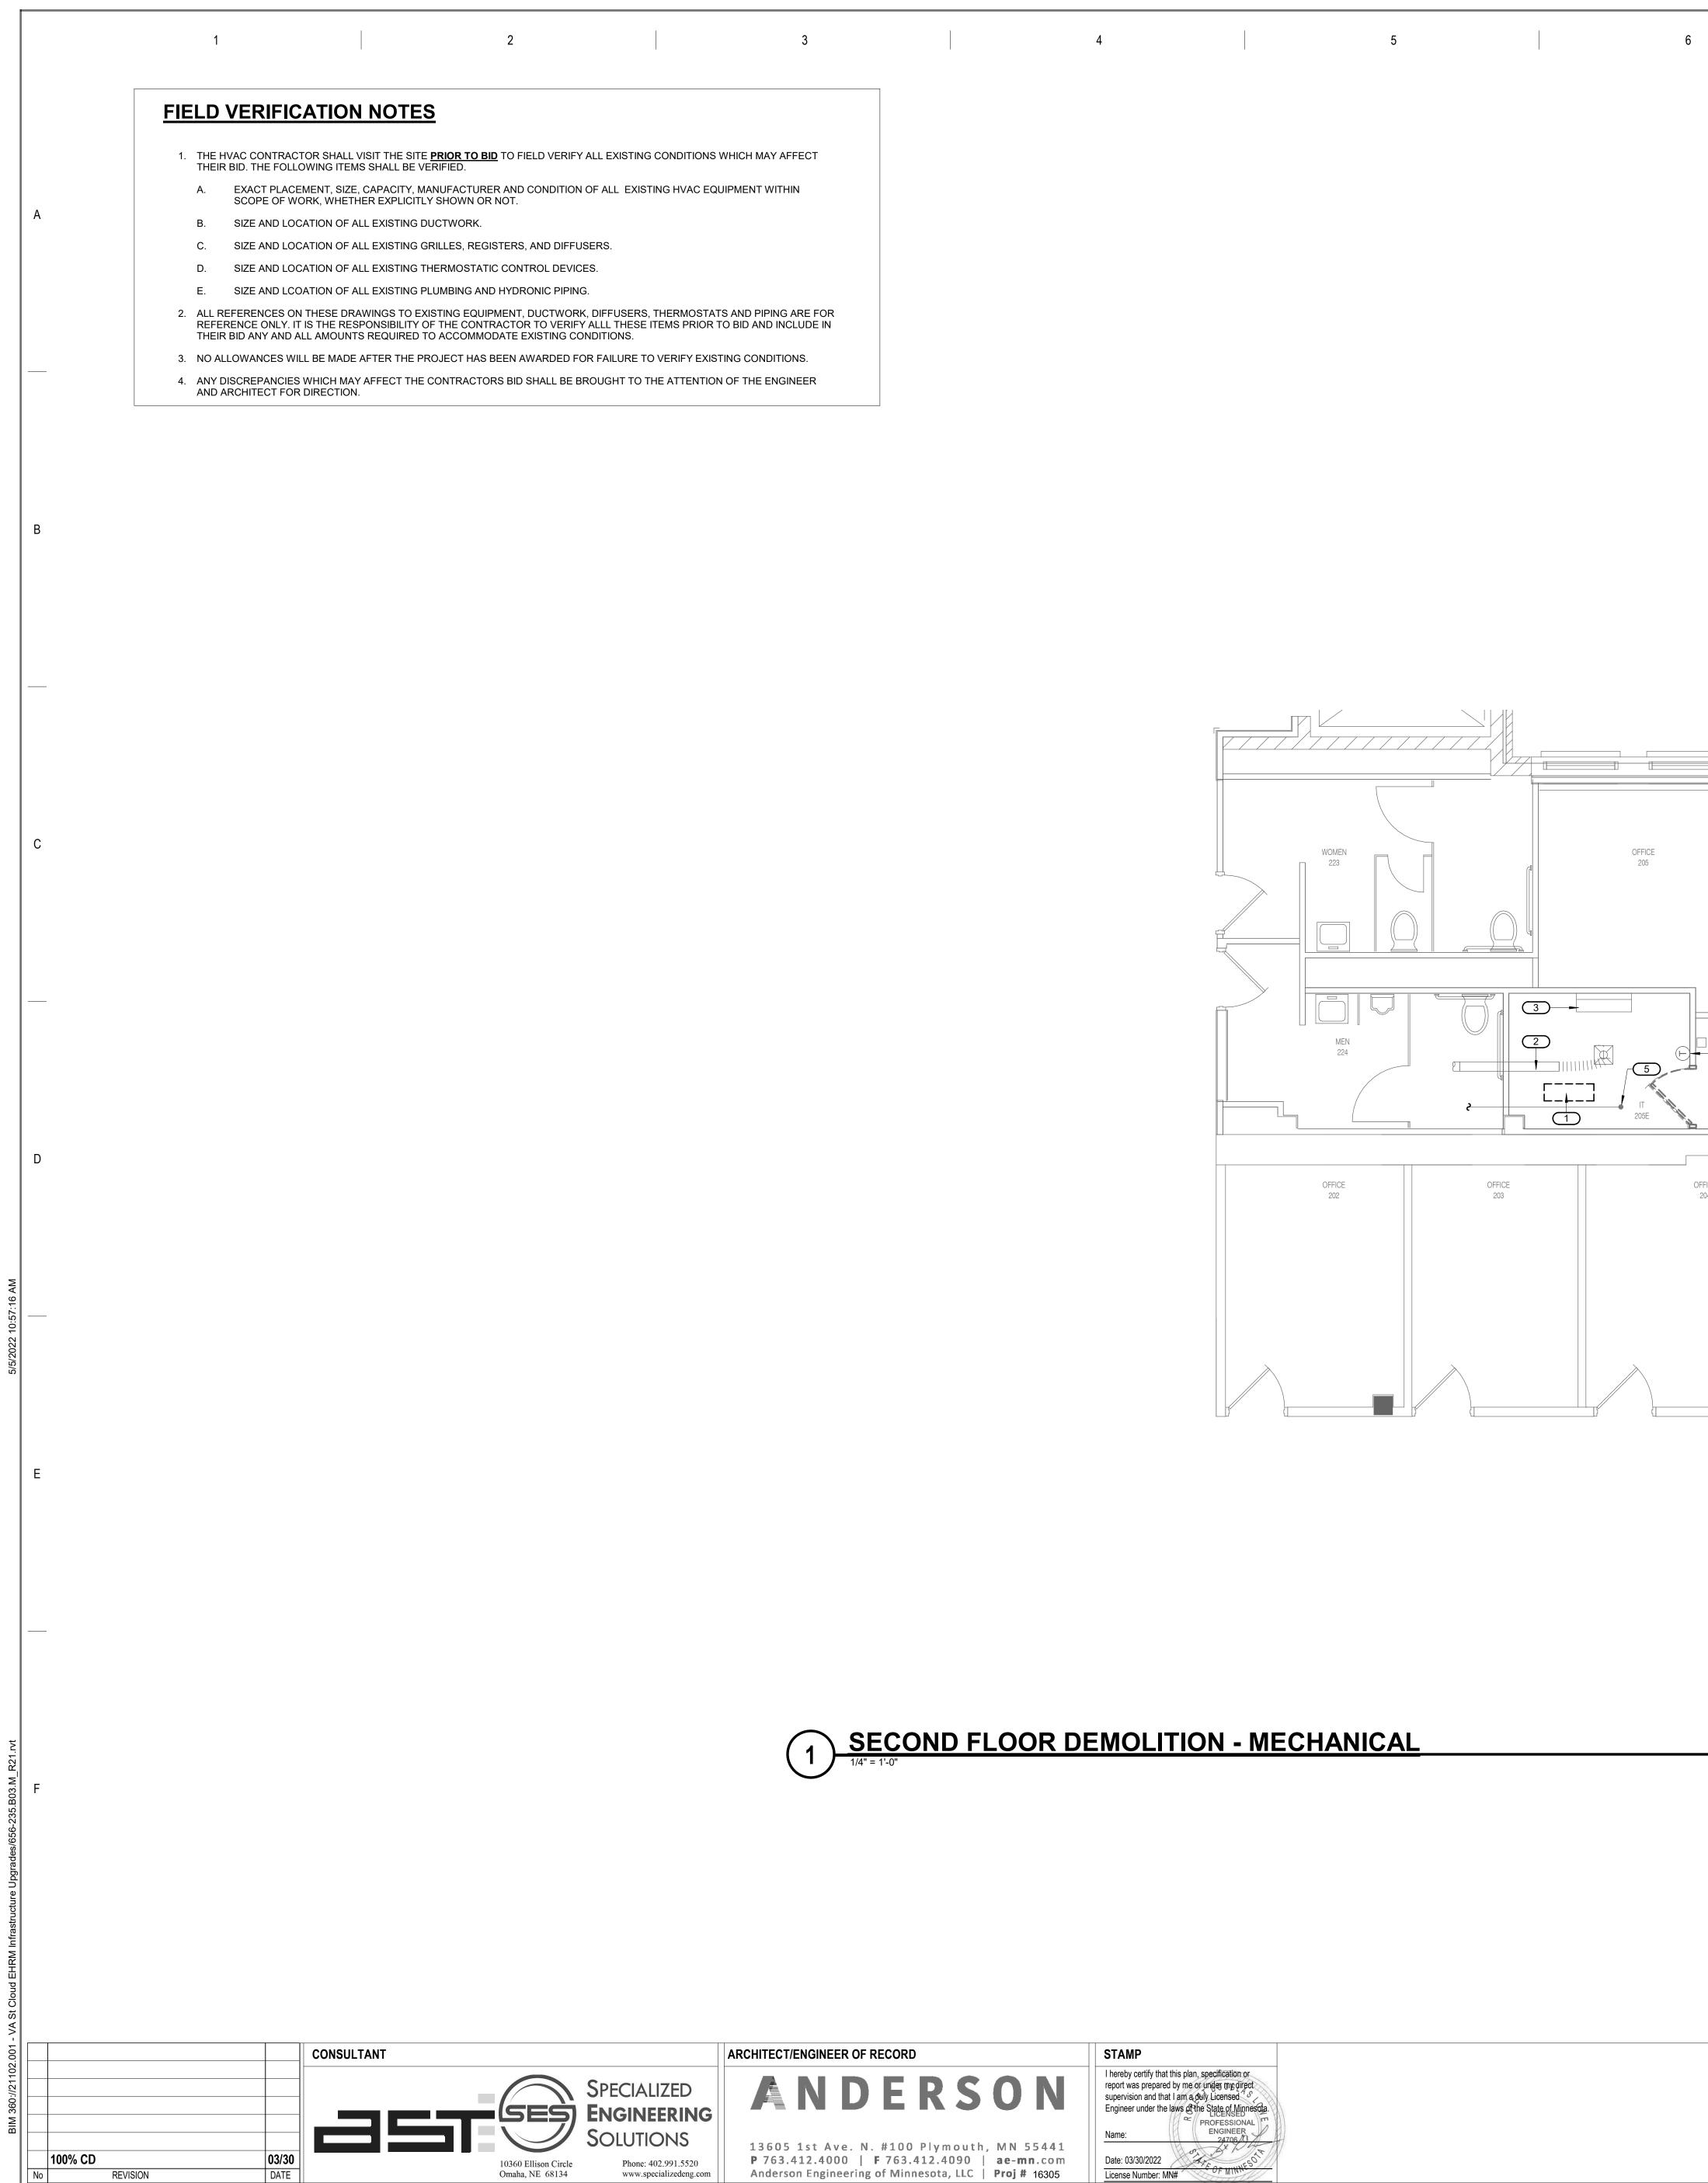
| KEYNOTES 1/03-M101: | | | | |
|--|---------------------|--|-----------|--|
| 1. EXISTING DATA RACK L | OCATION. UNIT TO BE | E DEMOLISHED BY OTHERS | З. | |
| 2. EXISTING SUPPLY AIR I SHOWN AND CAP. COC | | WORK. REMOVE BACK TO L CHING WITH GENERAL CON | | |
| 3. EXISTING RETURN AIR SHOWN AND CAP. COC | | ORK. REMOVE BACK TO LOO CHING WITH GENERAL CON | | |
| 4. REMOVE AND DISPOSE | OF EXISTING THERM | IOSTATS AND ASSOCIATED |) WIRING. | |
| 5. REMOVE EXISTING SPF SHOWN FOR RE-ROUT CONTRACTOR. | | BRANCH LINE BACK TO LOC ALL PATCHING WITH GENER | | |
| 6. CONTRACTOR TO PRE- | -MEASURE EXISTING | AIRFLOWS FOR TERMINAL | UNIT. | |
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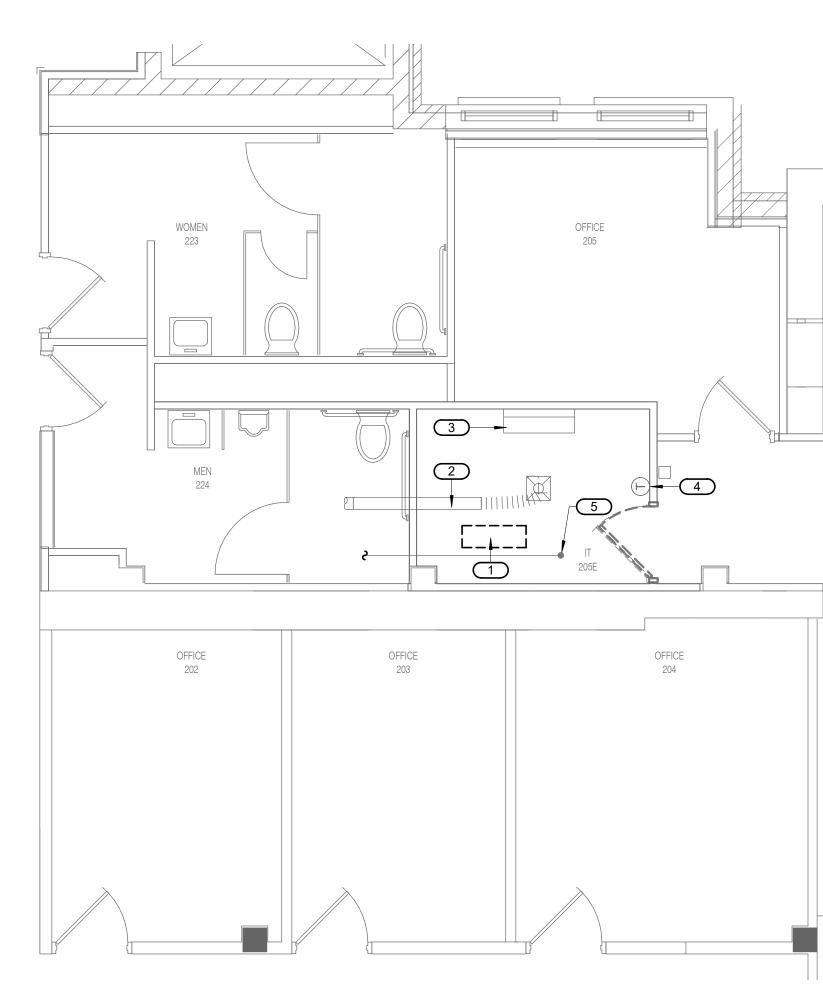


| FIRST FLOOR DEMOLITION - MECHANICAL | | PROJECT TITLE EHRM INFRASTRUCTURE UPGRADES | | | VA |
|--|---|--|----------------------|---------------------|----|
| | BUILDING No | CHECKED BY | DRAWN JCL | DRAWING NO. 03-M101 | |
| | LOCATION VA MEDICAL CE ST.CLOUD, MN | | FULLY SPRINKLERED | DWG. OF | |

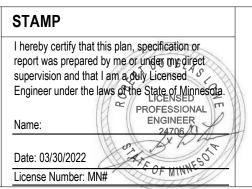


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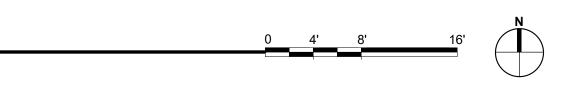




SECOND FLOOR DEMOLITION - MECHANICAL



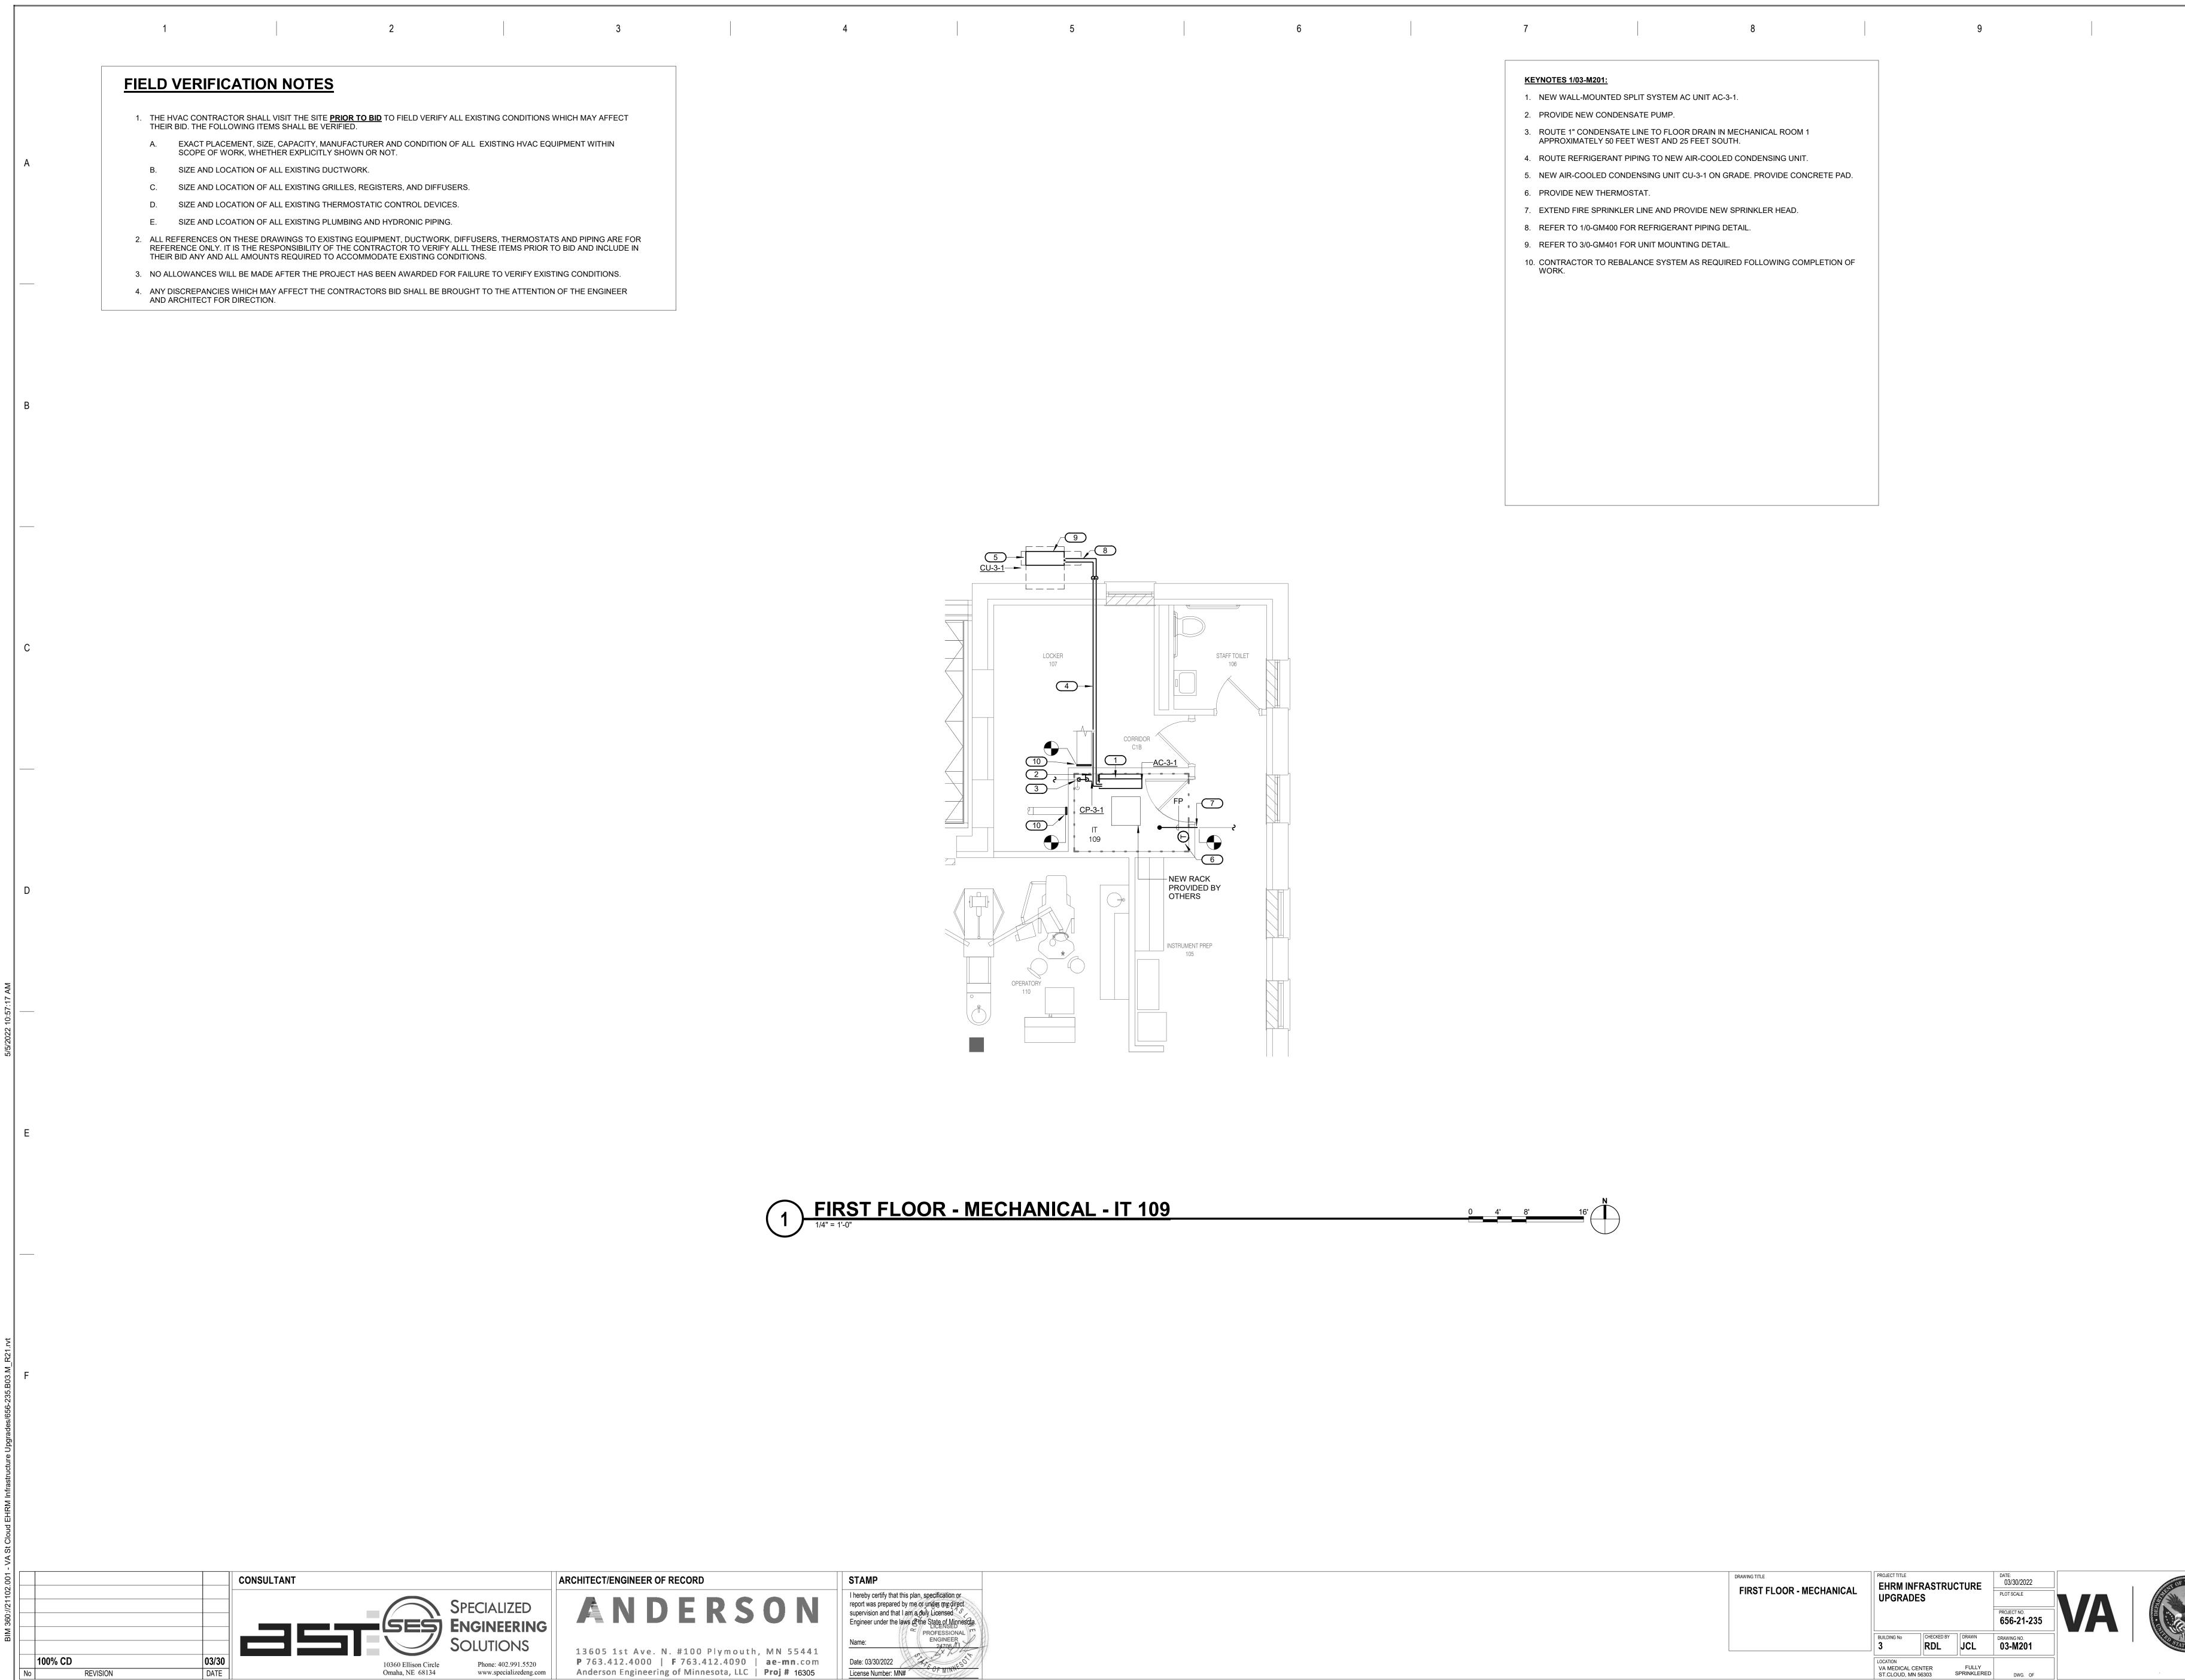
| INVESTIGATION INVESTIGATION <td< th=""><th>7</th><th></th><th>8</th><th>9</th><th></th></td<> | 7 | | 8 | 9 | |
|---|---------------------------|---------------------------------|---------|---|--|
| EXISTING DATA RACK. UNIT TO BE DEMOLISHED BY OTHERS. EXISTING DIFFUSER AND DUCTWORK TO REMAIN. EXISTING SPLIT SYSTEM COOLING UNIT TO REMAIN. EXISTING THERMOSTAT TO REMAIN. | <u>KEYNOTES 1/03-M102</u> | | | | |
| 3. EXISTING SPLIT SYSTEM COOLING UNIT TO REMAIN. 4. EXISTING THERMOSTAT TO REMAIN. | | | IERS. | | |
| 4. EXISTING THERMOSTAT TO REMAIN. | 2. EXISTING DIFFUS | R AND DUCTWORK TO REMAIN. | | | |
| | 3. EXISTING SPLIT S | STEM COOLING UNIT TO REMAIN. | | | |
| | 4. EXISTING THERM | OSTAT TO REMAIN. | | | |
| | 5. EXISTING FIRE SP | RINKLER HEAD AND BRANCH LINE TO | REMAIN. | | |
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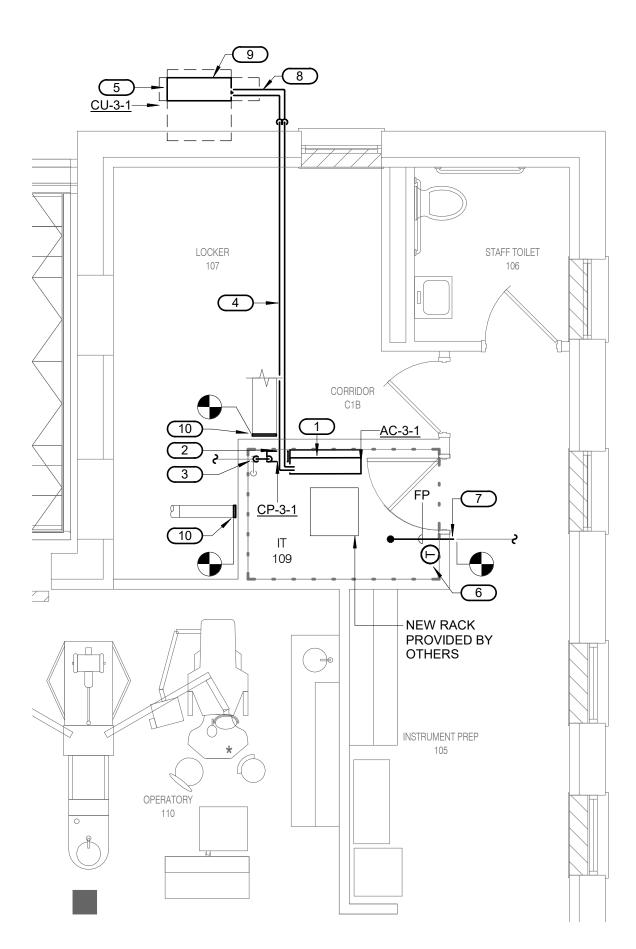


| DRAWING TITLE SECOND FLOOR DEMO MECHANICAL | LITION - EHRM INFRASTRUCTURE UPGRADES | | DATE: 03/30/2022 PLOT SCALE | | |
|--|--|------------|-----------------------------------|---------------------------|----|
| | | | | PROJECT NO. 656-21-235 | VA |
| | BUILDING No | CHECKED BY | DRAWN JCL | drawing no. | |
| | LOCATION VA MEDICAL ST.CLOUD, I | | FULLY SPRINKLERED | DWG. OF | |

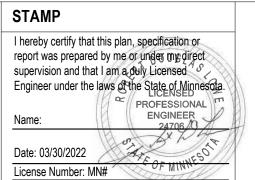


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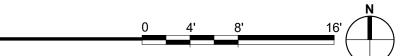
| KEY | NOTES | 1/03-M201: |
|-----|--------------|------------|
| | | |

- 1. NEW WALL-MOUNTED SPLIT SYSTEM AC UNIT AC-3-1.
- 3. ROUTE 1" CONDENSATE LINE TO FLOOR DRAIN IN MECHANICAL ROOM 1
- APPROXIMATELY 50 FEET WEST AND 25 FEET SOUTH.
- 4. ROUTE REFRIGERANT PIPING TO NEW AIR-COOLED CONDENSING UNIT. 5. NEW AIR-COOLED CONDENSING UNIT CU-3-1 ON GRADE. PROVIDE CONCRETE PAD.
- 6. PROVIDE NEW THERMOSTAT.

2. PROVIDE NEW CONDENSATE PUMP.


- 7. EXTEND FIRE SPRINKLER LINE AND PROVIDE NEW SPRINKLER HEAD.
- 8. REFER TO 1/0-GM400 FOR REFRIGERANT PIPING DETAIL.
- 9. REFER TO 3/0-GM401 FOR UNIT MOUNTING DETAIL.
- 10. CONTRACTOR TO REBALANCE SYSTEM AS REQUIRED FOLLOWING COMPLETION OF WORK.


| DRAWING TITLE FIRST FLOOR - MECHANICAL | EHRM INF | | ICTURE | DATE: 03/30/2022 PLOT SCALE | |
|---|---|------------|----------------------|-----------------------------------|----|
| | | | | PROJECT NO. 656-21-235 | VA |
| | BUILDING No | CHECKED BY | DRAWN JCL | DRAWING NO. 03-M201 | |
| | LOCATION VA MEDICAL CE ST.CLOUD, MN 5 | | FULLY SPRINKLERED | DWG. OF | |




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1 SECOND FLOOR REMODEL - MECHANICAL - TELECOM 205E

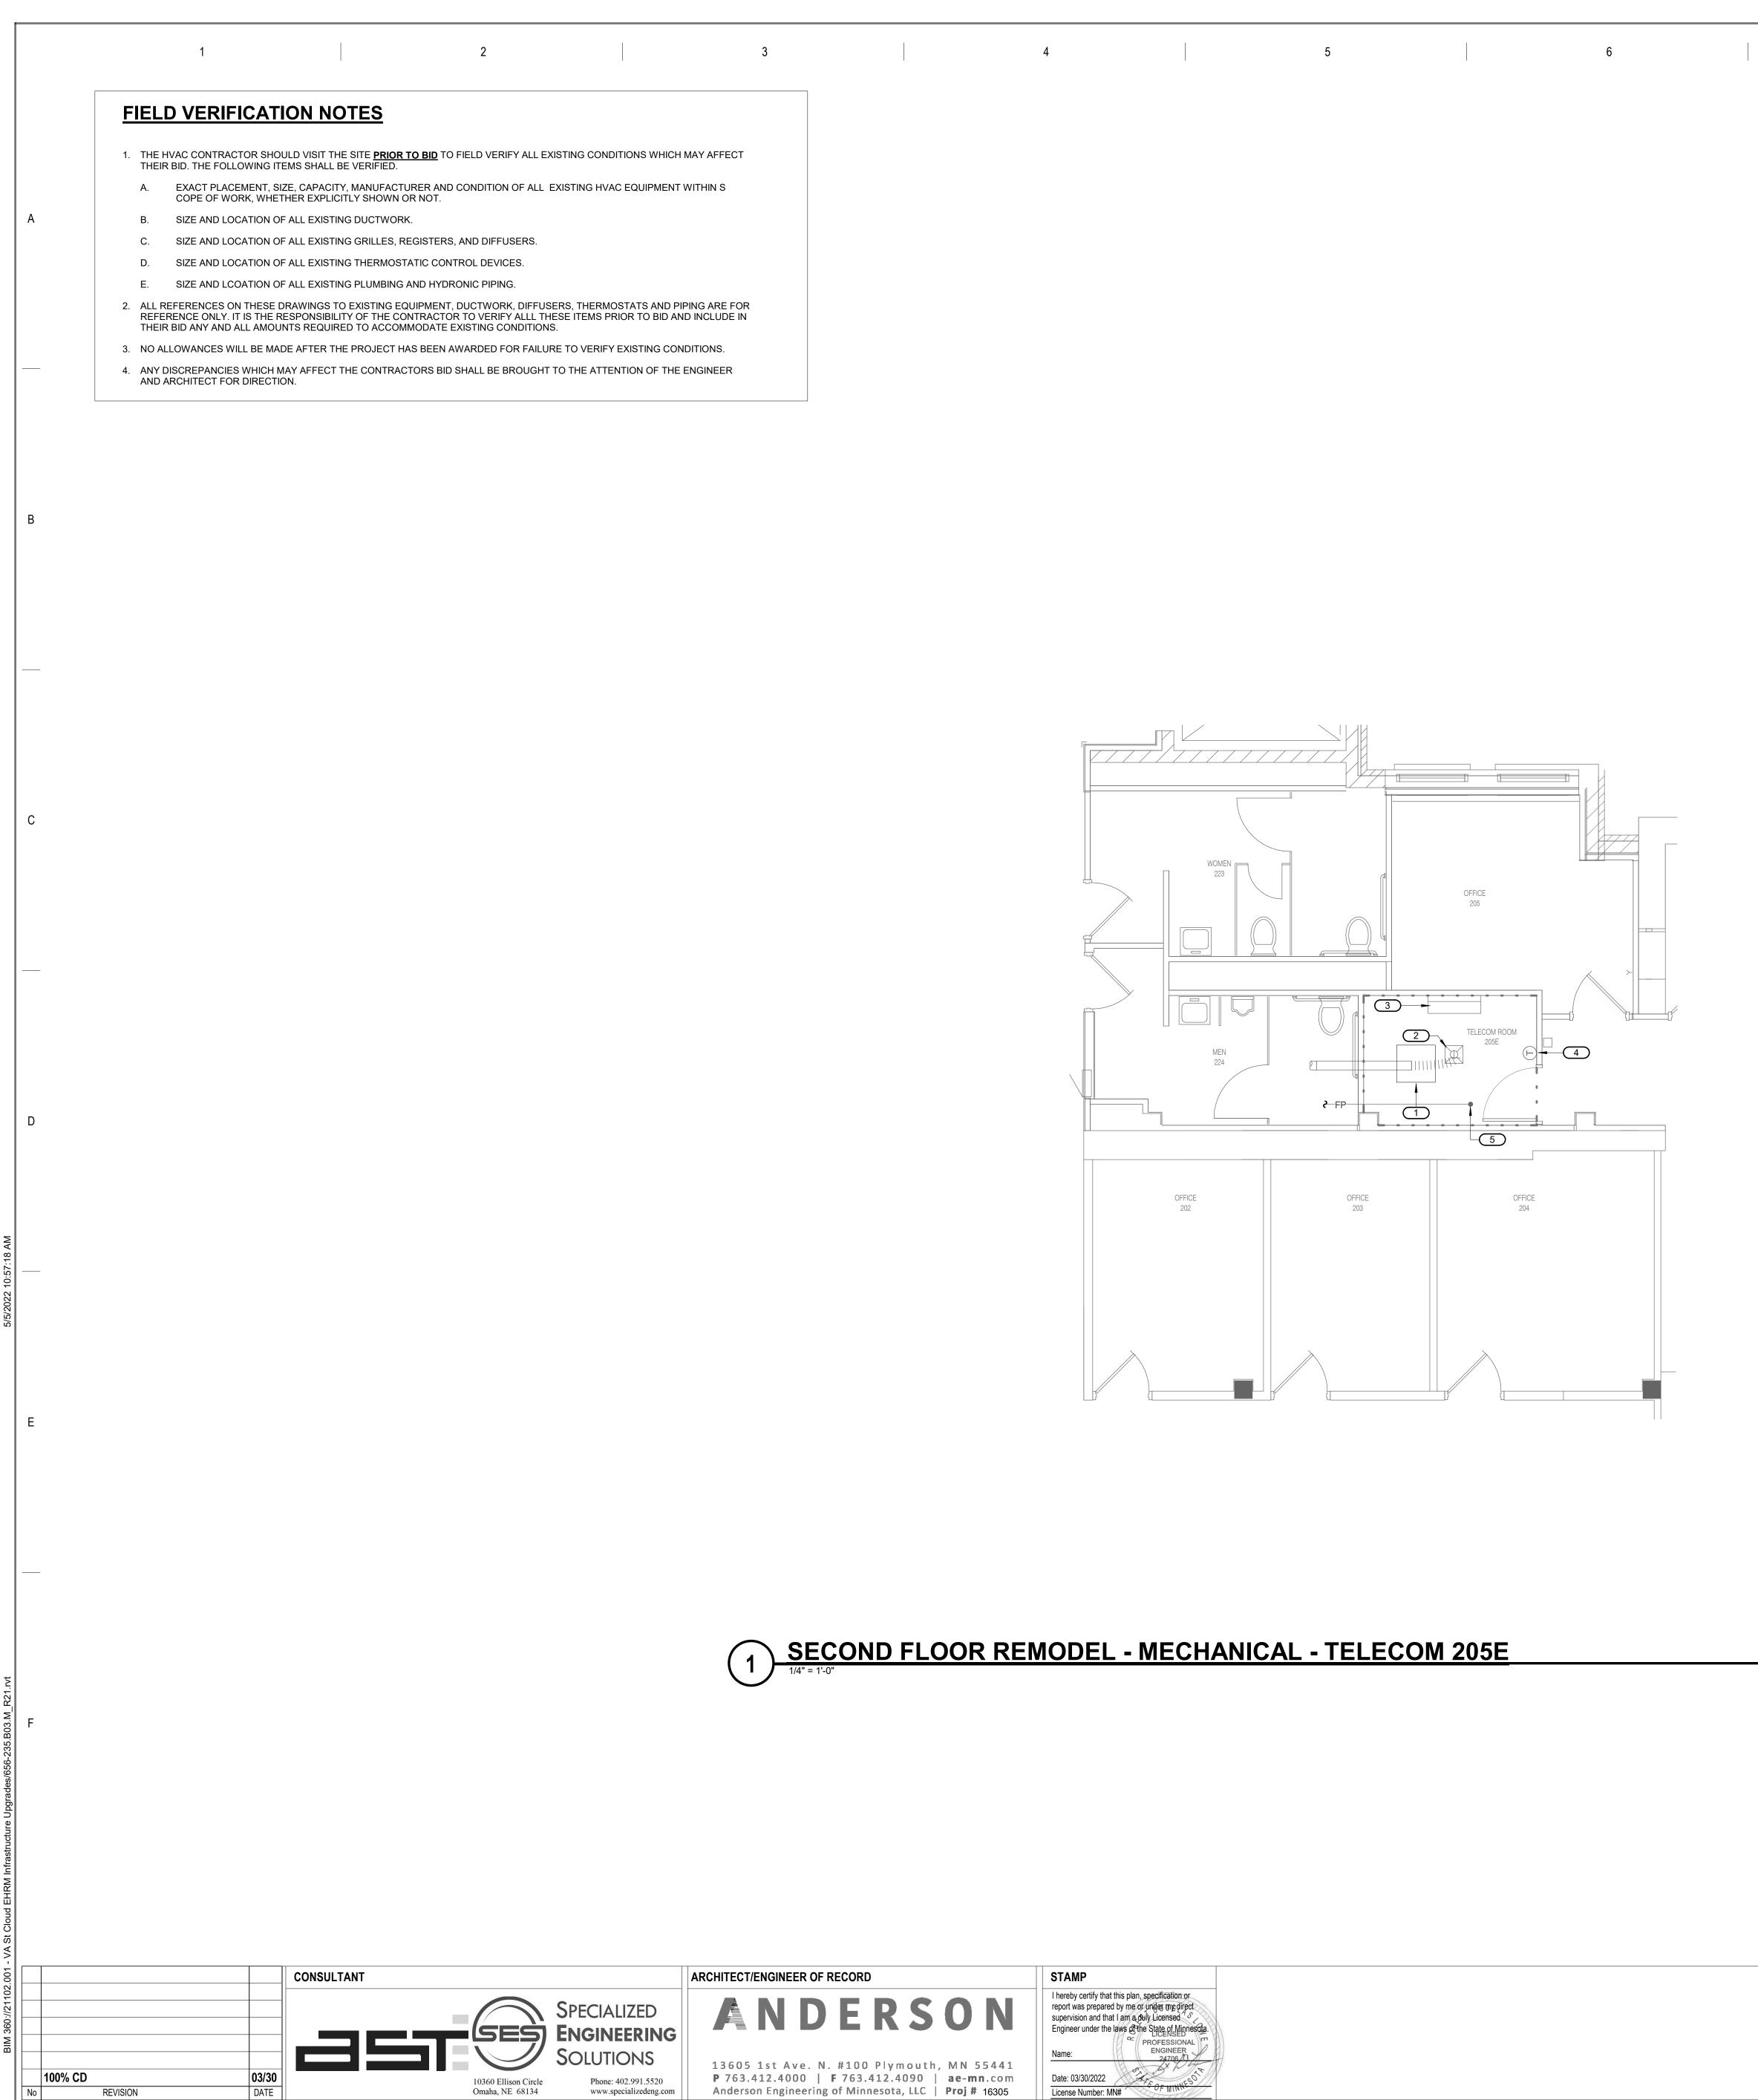

| KEYNOTES LIDAHZE; 1. NEW RACK LOCATION PROVIDED BY OTHERS. 2. EXISTING SUPPLY OFFUSIER AND DUCTWORK ADJUST DUCTWORK AD MEDICID TO ACCOMMODATE NEW RACK LAVOUT. FIELD VERMENTS. 3. EXISTING SPITE SYSTEM COLLING UNT TO REMAIN. 4. EXISTING FIRE SPRINKLER HEAD AND BRANCH I.INF. ADJUST AS NEEDED TO ACCOMMODATE NEW RACK LAVOUT. FIELD VERMENTS. 5. FIXISTING FIRE SPRINKLER HEAD AND BRANCH I.INF. ADJUST AS NEEDED TO ACCOMMODATE NEW RACK LAVOUT. FIELD VERMENTS. | 7 | 8 | 9 | |
|---|---|--|---|--|
| NEW RACK LOCATION PROVIDED BY OTHERS. EXISTING SUPPLY DIFFUSER AND DUCTWORK. ADJUST DUCTWORK AS NEEDED TO ACCOMMODATE NEW RACK LAYOUT. FIELD VERIFY REQUIREMENTS. EXISTING SPIT SYSTEM COOLING UNIT TO REMAIN. EXISTING THERMOSTAT TO REMAIN. EXISTING FIRE SPRINKLER HEAD AND BRANCH LINE. ADJUST AS NEEDED TO | KEYNOTES 1/03-M202 | | | |
| EXISTING SUPPLY DIFFUSER AND DUCTWORK. ADJUST DUCTWORK AS NEEDED TO ACCOMMODATE NEW RACK LAYOUT. FIELD VERIFY REQUIREMENTS. EXISTING SPIT SYSTEM COOLING UNIT TO REMAIN. EXISTING THERMOSTAT TO REMAIN. EXISTING FIRE SPRINKLER HEAD AND BRANCH LINE. ADJUST AS NEEDED TO | | OVIDED BY OTHERS. | | |
| EXISTING THERMOSTAT TO REMAIN. EXISTING FIRE SPRINKLER HEAD AND BRANCH LINE. ADJUST AS NEEDED TO | 2. EXISTING SUPPLY DIFFUS | SER AND DUCTWORK. ADJUST DUCTWORK AS NEEDED TO | | |
| 5. EXISTING FIRE SPRINKLER HEAD AND BRANCH LINE. ADJUST AS NEEDED TO | 3. EXISTING SPIT SYSTEM C | OOLING UNIT TO REMAIN. | | |
| EXISTING FIRES SPRINKLER HEAD AND BRANCH LINE. ADJUST AS NEEDED TO ACCOMMODATE NEW RACK LAYOUT. FIELD VERIFY REQUIREMENTS. | 4. EXISTING THERMOSTAT 7 | TO REMAIN. | | |
| | 5. EXISTING FIRE SPRINKLE ACCOMMODATE NEW RA | R HEAD AND BRANCH LINE. ADJUST AS NEEDED TO CK LAYOUT. FIELD VERIFY REQUIREMENTS. | | |
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| DRAWING TITLE SECOND FLOOR REMODEL - MECHANICAL | | | | DATE: 03/30/2022 PLOT SCALE PROJECT NO. 656-21-235 | |
|---|---|------------|----------------------|--|--|
| | BUILDING No | CHECKED BY | DRAWN JCL | DRAWING NO. 03-M202 | |
| | LOCATION VA MEDICAL CE ST.CLOUD, MN | | FULLY SPRINKLERED | DWG. OF | |

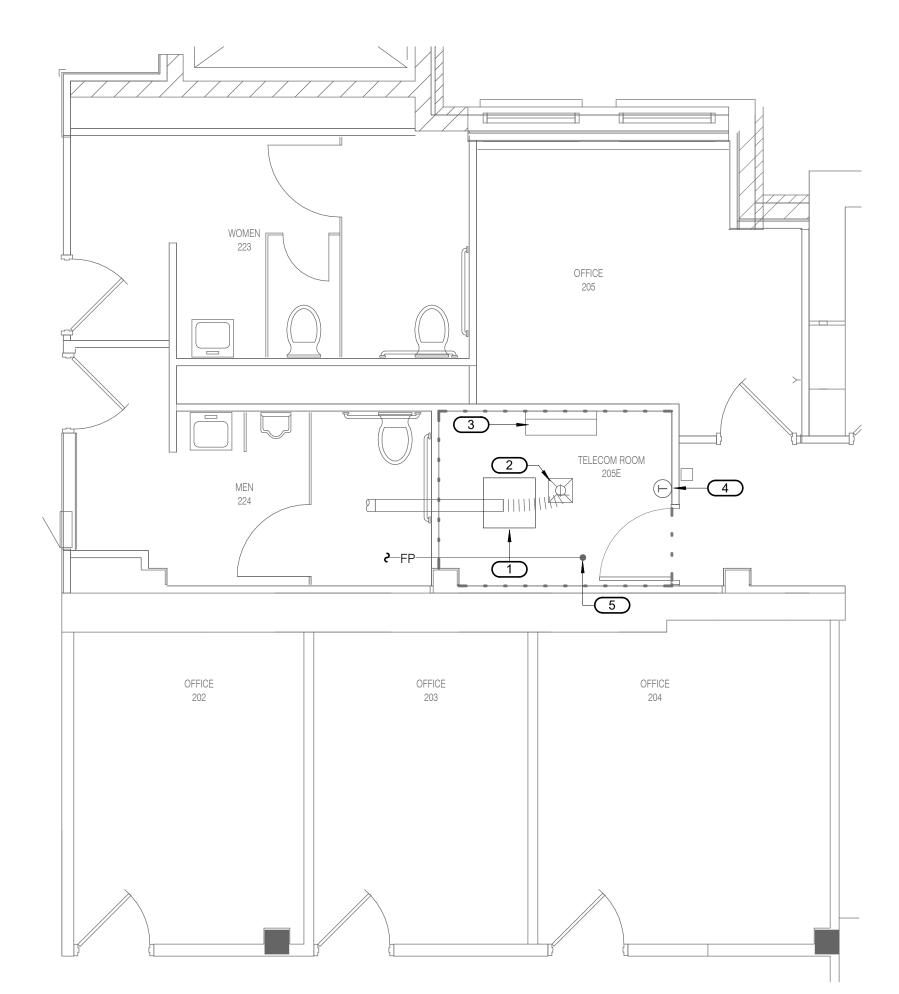
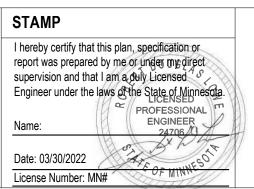
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