


	BUILDING 3 - EHRM INFRASTRUCTURE UPGRADES
	St. Cloud VA Health Care System Main Campus, St. Cloud, Minnesota
rojects\16305-3-R21_EMarkfort.rvt	
C:\Users\Public\Documents\Revit	

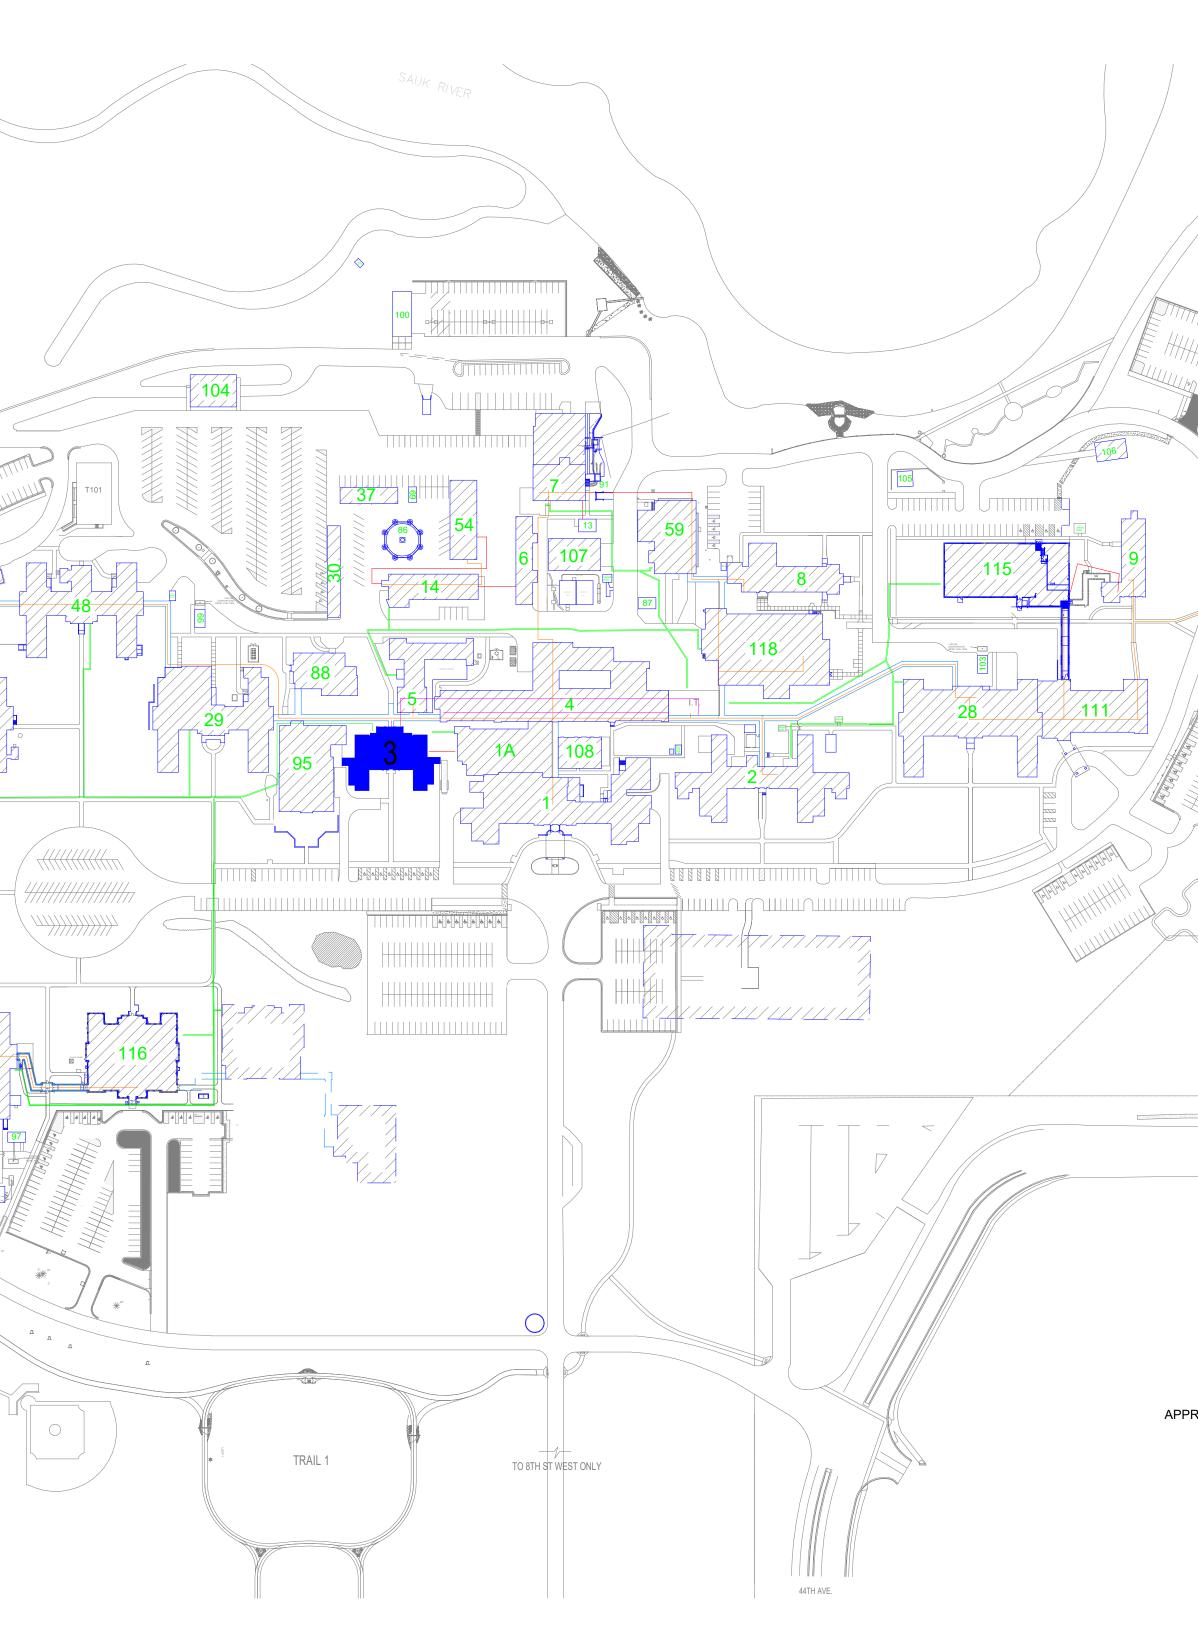

DATE:	APPROVED: EMS MANAGER DATE: APPROVED: M/O MANAGER DATE:	APPROVED: DIRECTOR FMS DATE: APPROVED: ASSOCIATE DIRECTOR DATE:	BUILDING 3 COVER SHEET & SHEET INDEX	PROJECT TITLE EHRM INFI UPGRADE		CTURE	DATE: 03/30/2022 PLOT SCALE PROJECT NO. 656-21-235	VA
DATE:	APPROVED: PROJECTS SECTION MANAGER DATE:	APPROVED: NURSE EXECUTIVE DATE:		BUILDING No	CHECKED BY	DRAWN EM	DRAWING NO. 3-GI000	
DATE:	APPROVED: ASSISTANT CHIEF ENGINEER DATE:	APPROVED: CHIEF OF STAFF DATE:	APPROVED: MEDICAL CENTER DIRECTOR DATE:	LOCATION VA MEDICAL CENTER ST.CLOUD, MN 56303		FULLY SPRINKLERED	COVER DWG. OF	

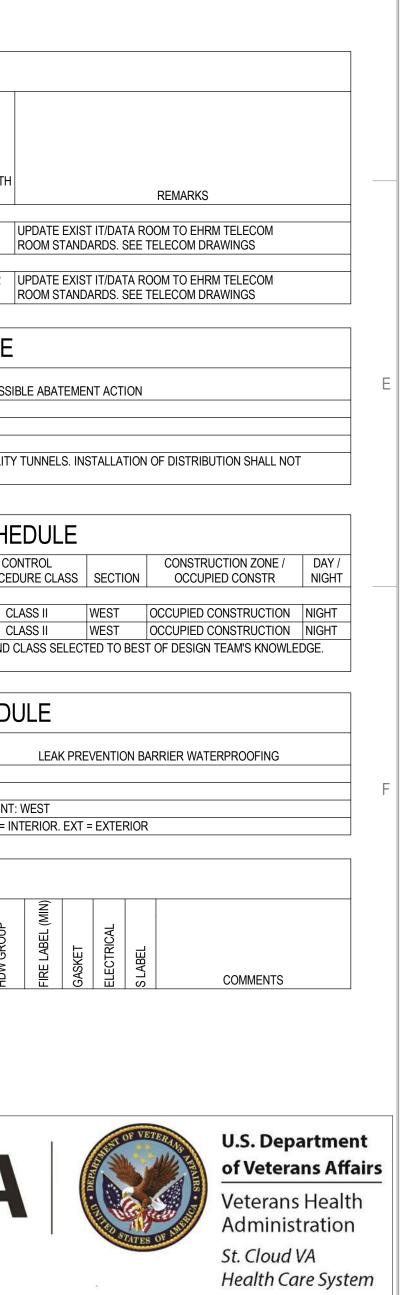

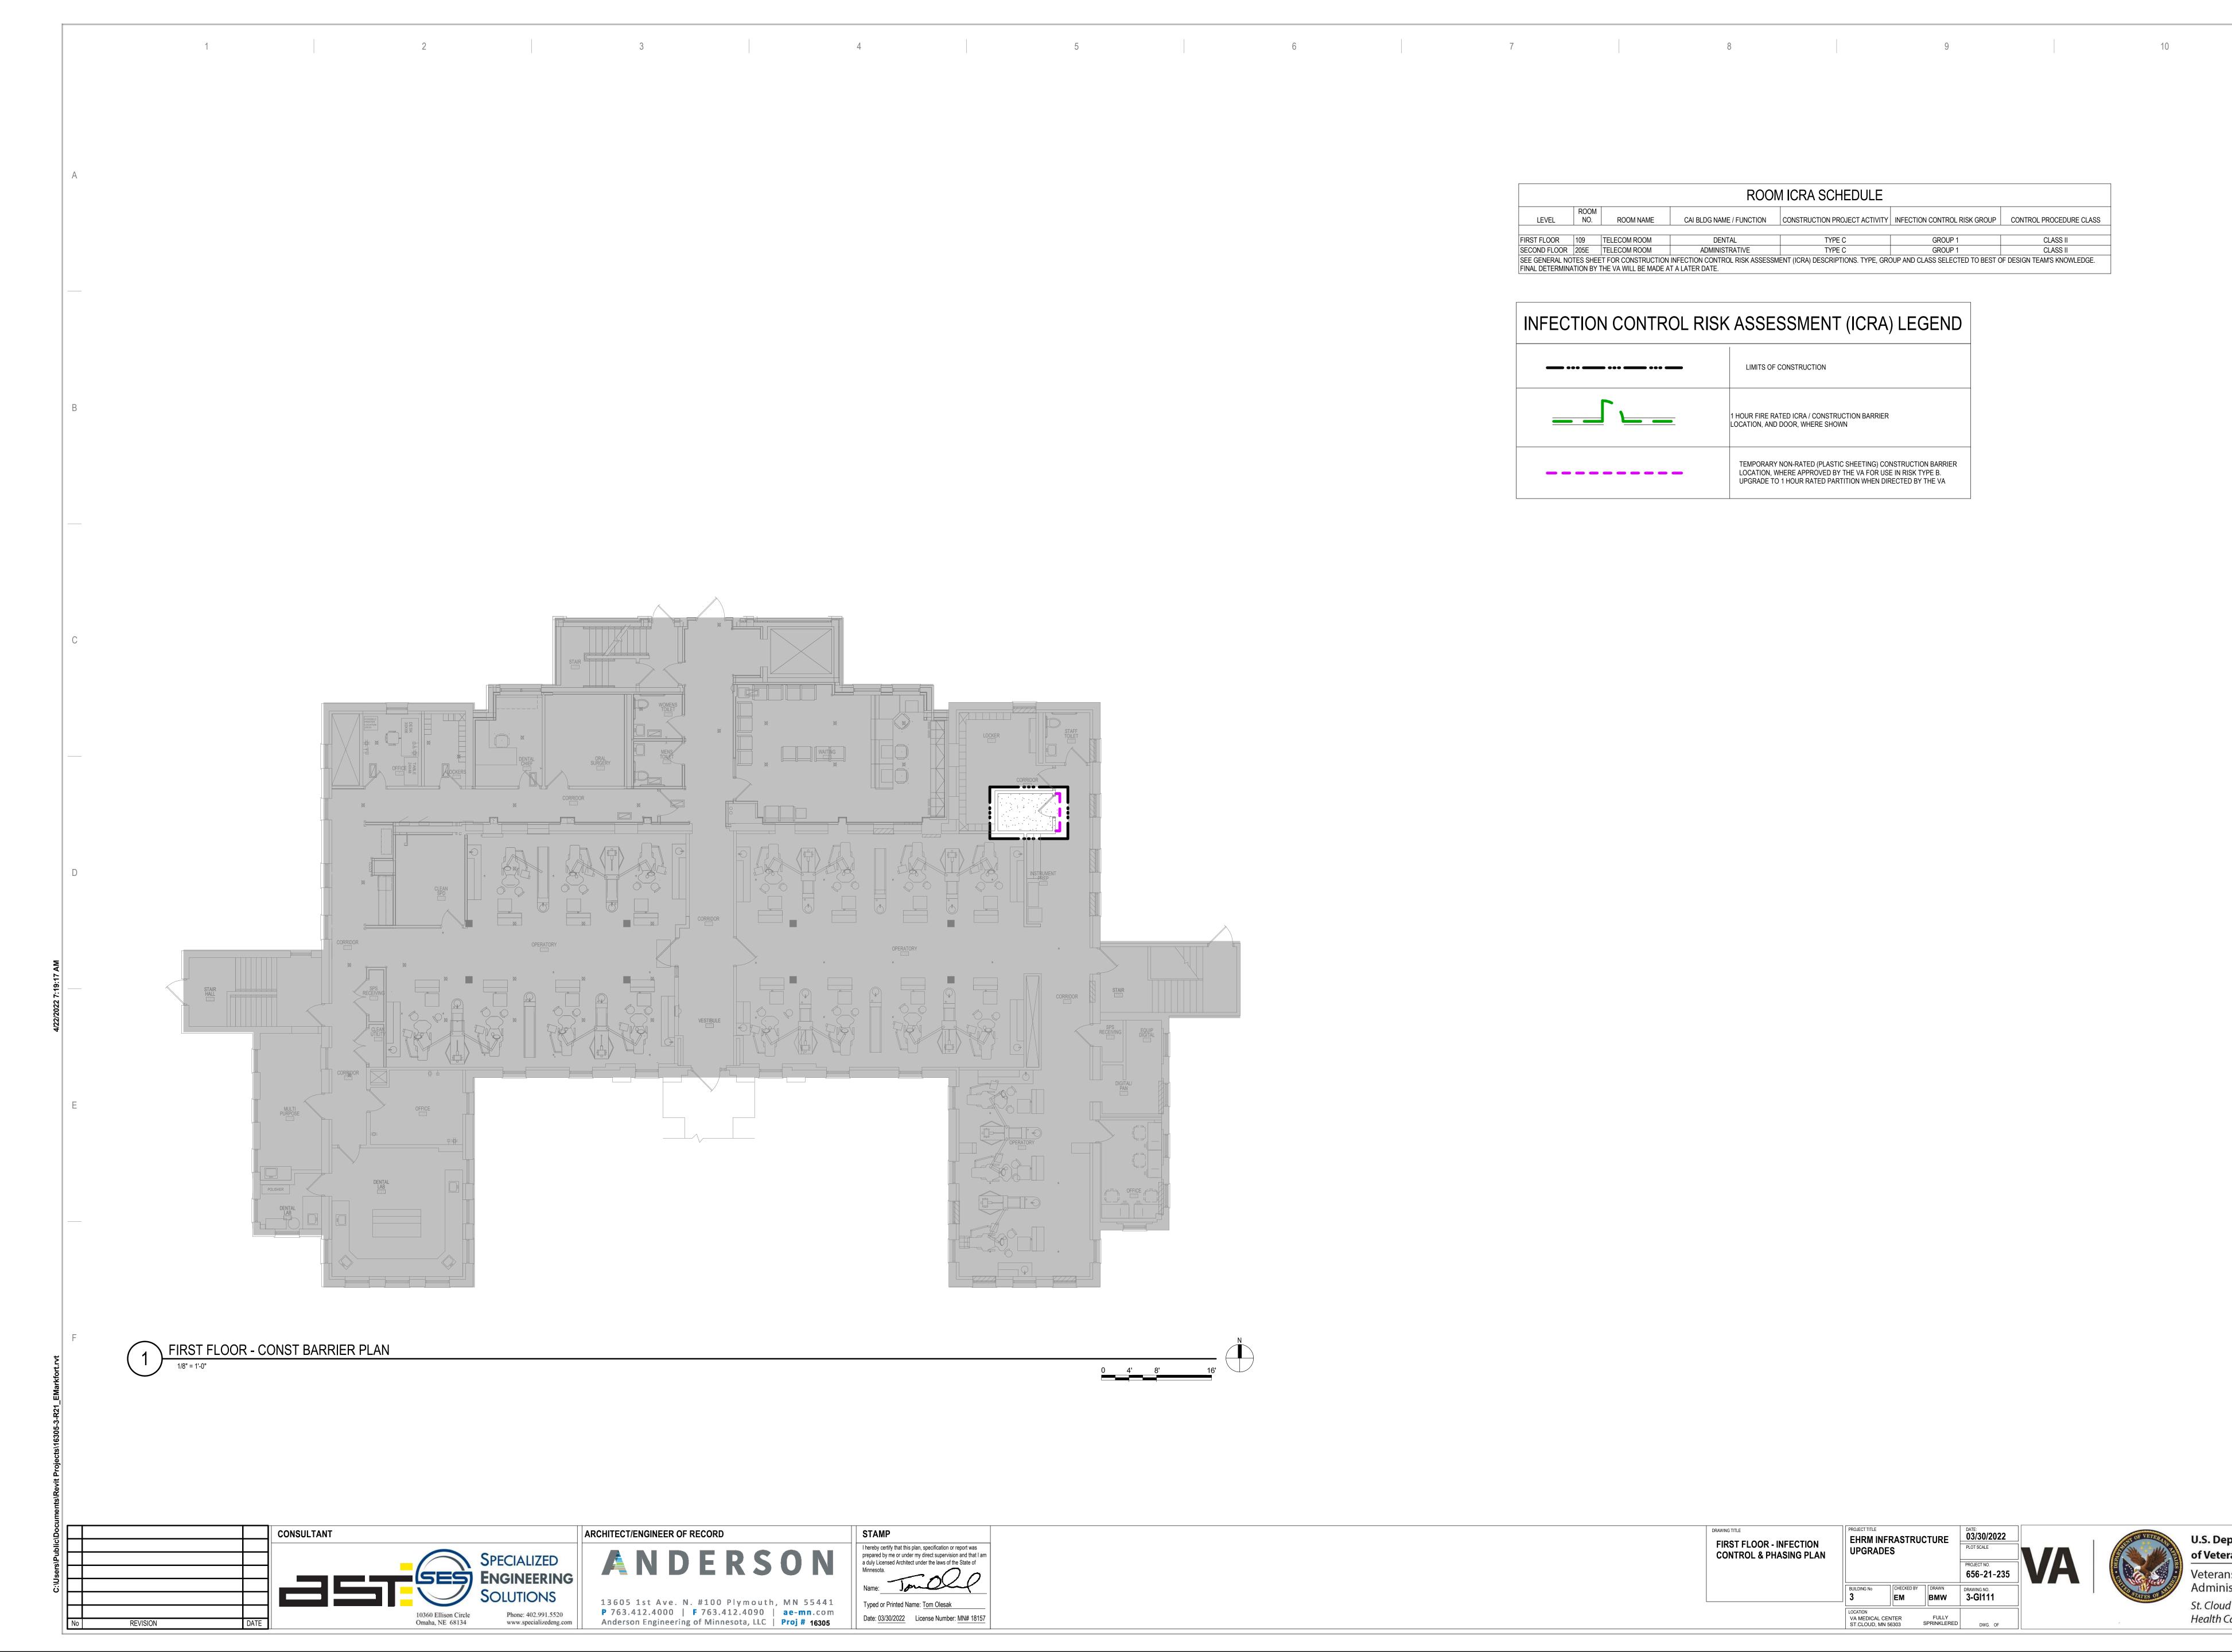


	ROOM ICRA SCHEDULE											
LEVEL	ROOM NO.	ROOM NAME	CAI BLDG NAME / FUNCTION	CONSTRUCTION PROJECT ACTIVITY	INFECTION CONTROL RISK GROUP	CONTROL PROCEDU						
FIRST FLOOR	109	TELECOM ROOM	DENTAL	TYPE C	GROUP 1	CLASS II						
SECOND FLOOR	205E	TELECOM ROOM	ADMINISTRATIVE	TYPE C	GROUP 1	CLASS II						
		T FOR CONSTRUCTION		IENT (ICRA) DESCRIPTIONS. TYPE, GRO	DUP AND CLASS SELECTED TO BEST C	F DESIGN TEAM'S KNO						

INFECTION CONTROL RISK ASSESSMENT (ICRA) LEGEND					
	LIMITS OF CONSTRUCTION				
	1 HOUR FIRE RATED ICRA / CONSTRUCTION BARRIER LOCATION, AND DOOR, WHERE SHOWN				
	TEMPORARY NON-RATED (PLASTIC SHEETING) CONSTRUCTION BARRIER LOCATION, WHERE APPROVED BY THE VA FOR USE IN RISK TYPE B. UPGRADE TO 1 HOUR RATED PARTITION WHEN DIRECTED BY THE VA				

	DRAWING TITLE FIRST FLOOR - INFECTION CONTROL & PHASING PLAN	PROJECT TITLE EHRM INFRASTRUCTURE UPGRADES			DATE: 03/30/2022 PLOT SCALE PROJECT NO. 656-21-235	
		BUILDING No	CHECKED BY	DRAWN BMW	DRAWING NO. 3-GI111	
		LOCATION VA MEDICAL (ST.CLOUD, M		FULLY	DWG. OF	

ROCEDURE CLASS
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LASS II
I'S KNOWLEDGE.



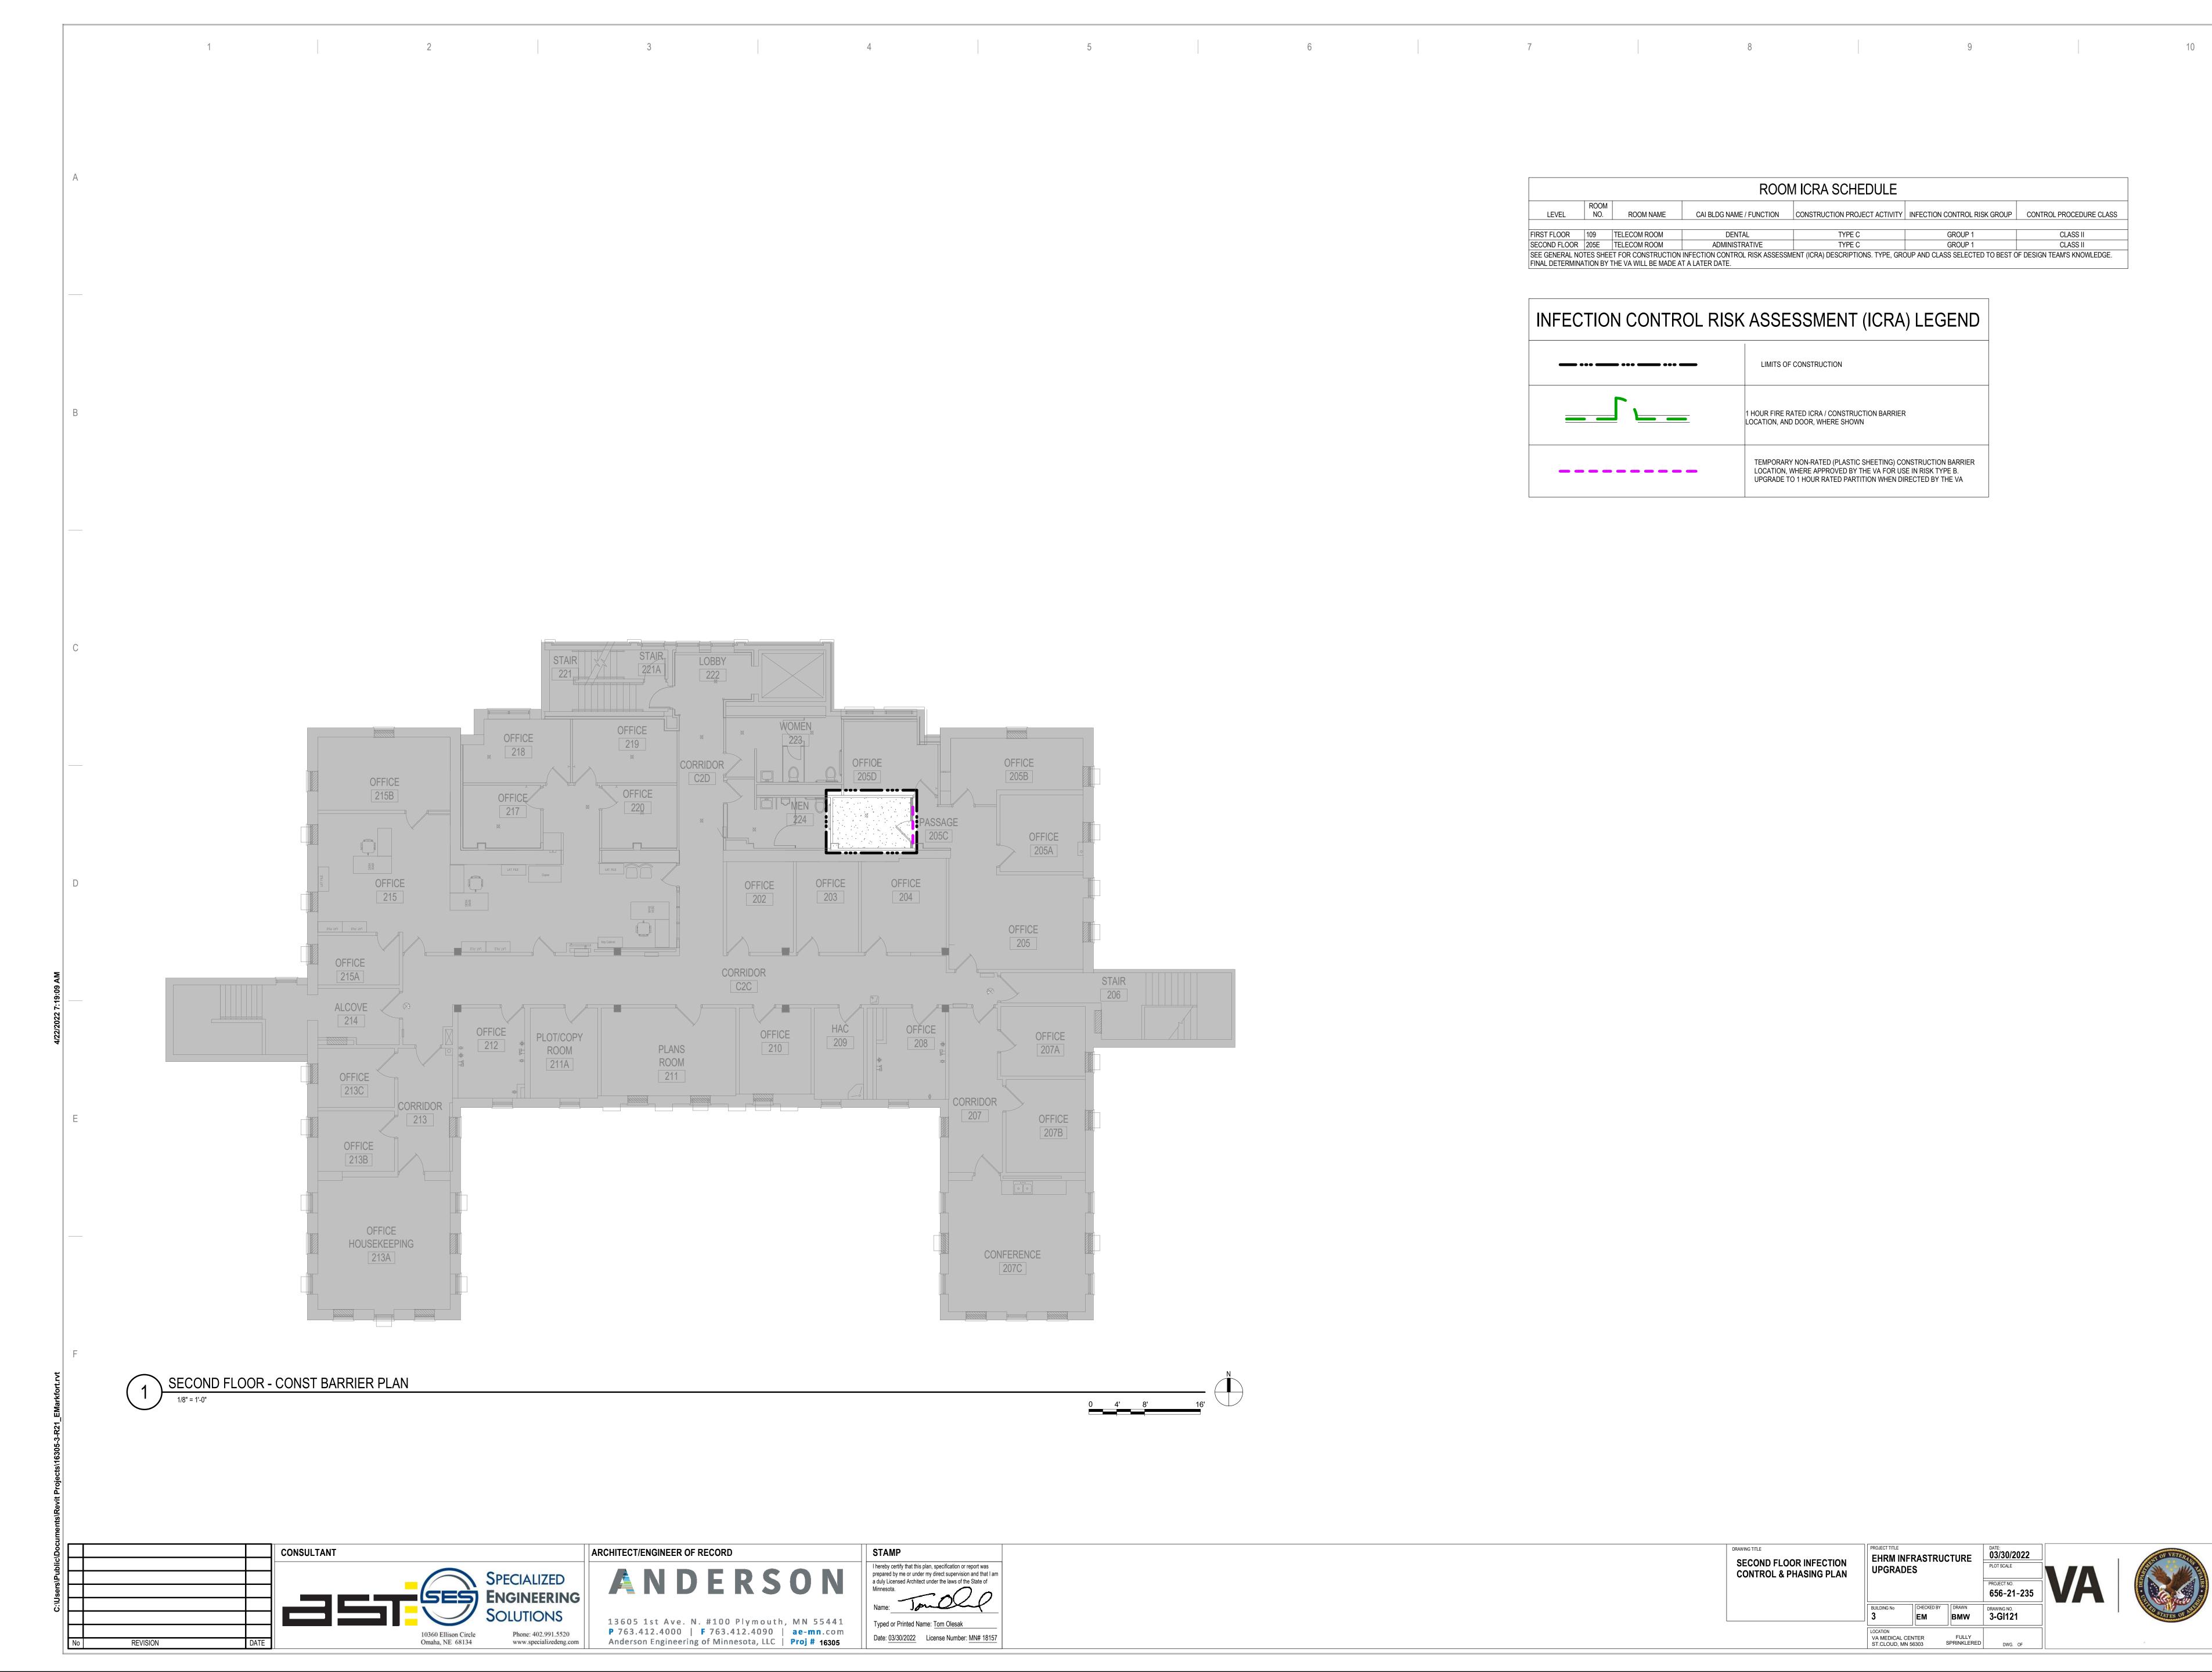

ROOM ICRA SCHEDULE											
LEVEL	ROOM NO.	ROOM NAME	CAI BLDG NAME / FUNCTION	CONSTRUCTION PROJECT ACTIVITY	INFECTION CONTROL RISK GROUP	CONTROL PROCEDURI					
FIRST FLOOR	109	TELECOM ROOM	DENTAL	TYPE C	GROUP 1	CLASS II					
SECOND FLOOR	205E	TELECOM ROOM	ADMINISTRATIVE	TYPE C	GROUP 1	CLASS II					
		ET FOR CONSTRUCTION		MENT (ICRA) DESCRIPTIONS. TYPE, GRO	DUP AND CLASS SELECTED TO BEST C	F DESIGN TEAM'S KNOWL					


INFECTION CONTROL RISK ASSESSMENT (ICRA) LEGEND

 •••• •••• 	LIMITS OF CONSTRUCTION
	1 HOUR FIRE RATED ICRA / CONSTRUCTION BARRIER LOCATION, AND DOOR, WHERE SHOWN
	TEMPORARY NON-RATED (PLASTIC SHEETING) CONSTRUCTION BARRIER LOCATION, WHERE APPROVED BY THE VA FOR USE IN RISK TYPE B. UPGRADE TO 1 HOUR RATED PARTITION WHEN DIRECTED BY THE VA

	DRAWING TITLE SECOND FLOOR INFECTION CONTROL & PHASING PLAN	EHRM INFRASTRUCTURE UPGRADES			DATE: 03/30/2022 PLOT SCALE PROJECT NO. 656-21-235	
		BUILDING No	CHECKED BY	DRAWN BMW	DRAWING NO. 3-GI121	
		LOCATION VA MEDICAL C ST.CLOUD, MM		FULLY SPRINKLERED	DWG. OF	

DURE CLASS



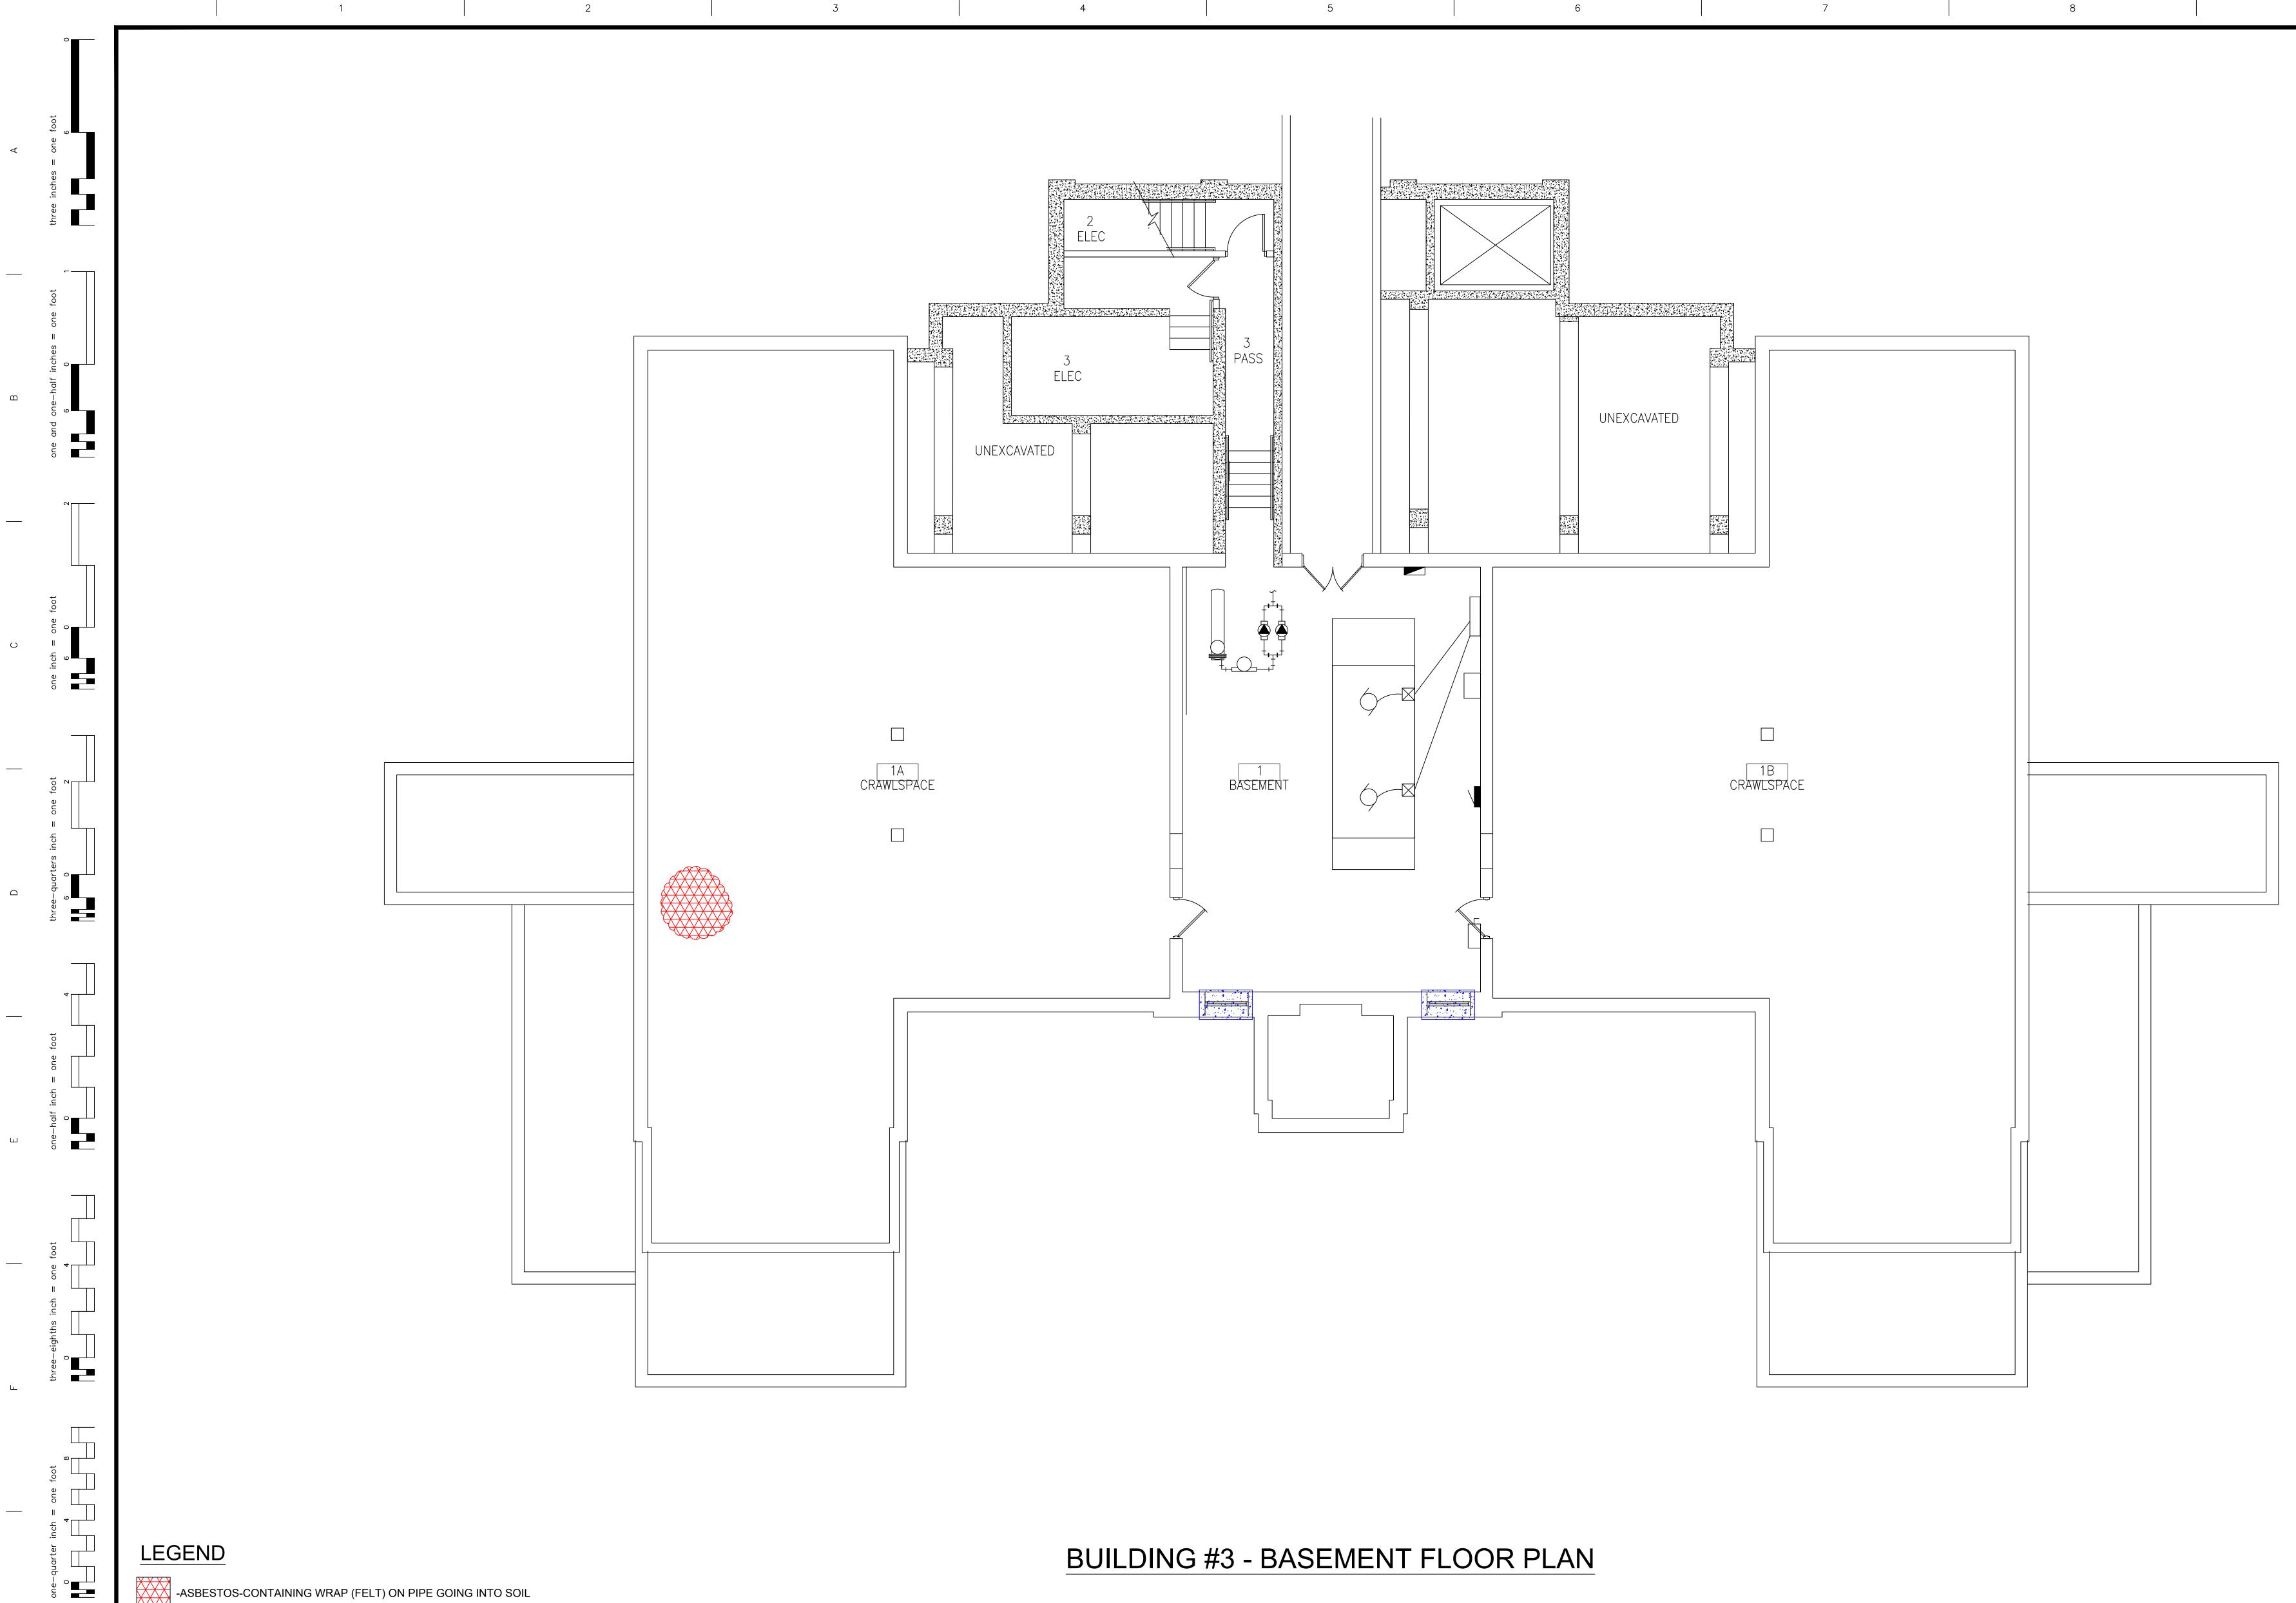

 $\mathbf{X} \mathbf{X} \mathbf{X} \mathbf{X}$

Revisions

-ASBESTOS-CONTAINING WRAP (FELT) ON PIPE GOING INTO SOIL -ASBESTOS-CONTAINING WINDOW CAULK

Dates

1

ENVIRONMENTAL CONSULTANT: CASTLE HILL ASSOCIATES, LLC. 218–A MECHANIC STREET, WATERVILLE, OHIO 43566 Tel: (567) 952–0212




4

North:	Drawing Title	Project Title	Date		
Norm:	ARCHITECTURAL PLAN		NOVEMBER 2019		
	BUILDING 3 Scale: 1/4" = 1'-0"	MEI	NS ADMINISTRA DICAL CENTER .OUD, MINNESC		Project No. 36C26319P1003
	Approved : Division Chief	Building Number	Checked BLB	Drawn AFS	Drawing No.
	Approved : Service Director	ST. CLOUD, MINNESOTA		OTA	1 A Sheet 09 of 71






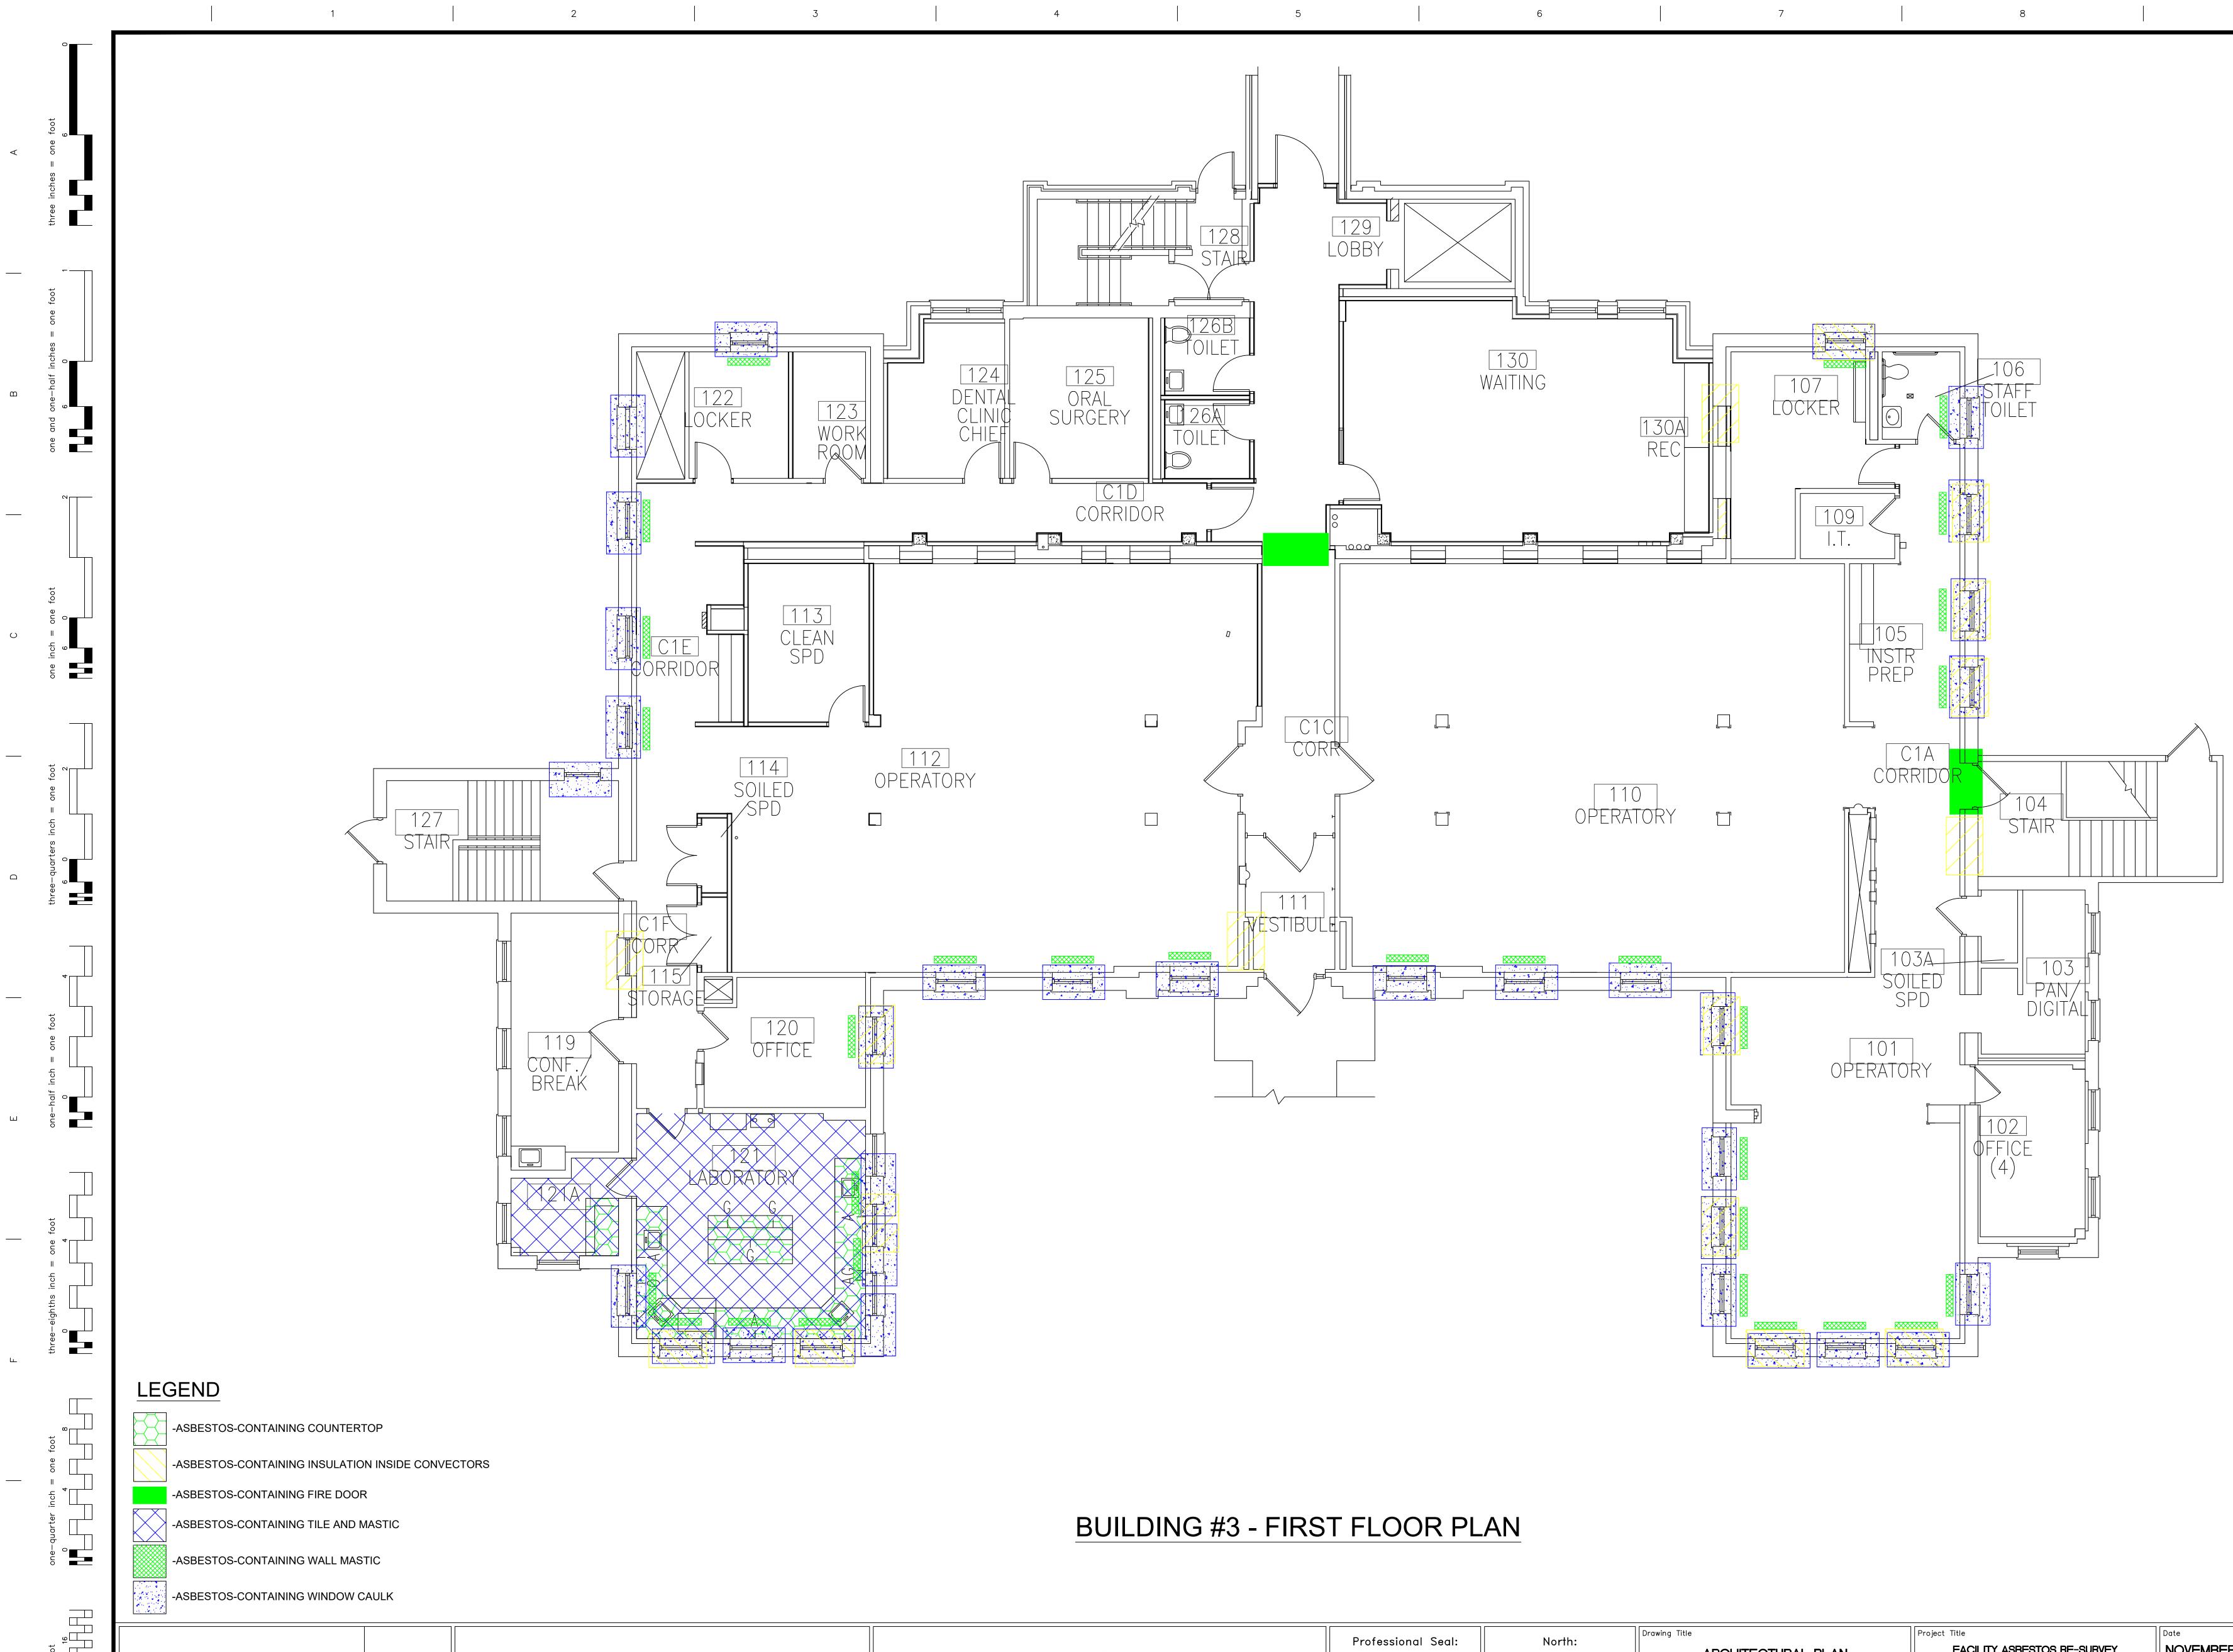

ENVIRONMENTAL CONSULTANT: CASTLE HILL ASSOCIATES, LLC. 218-A MECHANIC STREET, WATERVILLE, OHIO 43566 Tel: (567) 952-0212

Dates

1

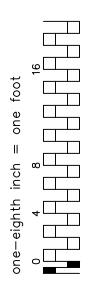


Revisions



North:	Drawing Title ARCHITECTURAL PLAN	Project Title FACILITY ASB VETERANS	Date NOVEMBER 2019			
	BUILDING 3 Scale: 1/4" = 1'-0"	MEDICAL CENTER ST. CLOUD, MINNESOTA			Project No. 36C26319P1003	
	Approved : Division Chief	Building Number 003	Checked BLB	Drawn AFS	Drawing No.	
S	Approved : Service Director	ST. CLOUD, MINNESOTA			CA Sheet 10 of 71	
0			2	l	<u>^</u>	






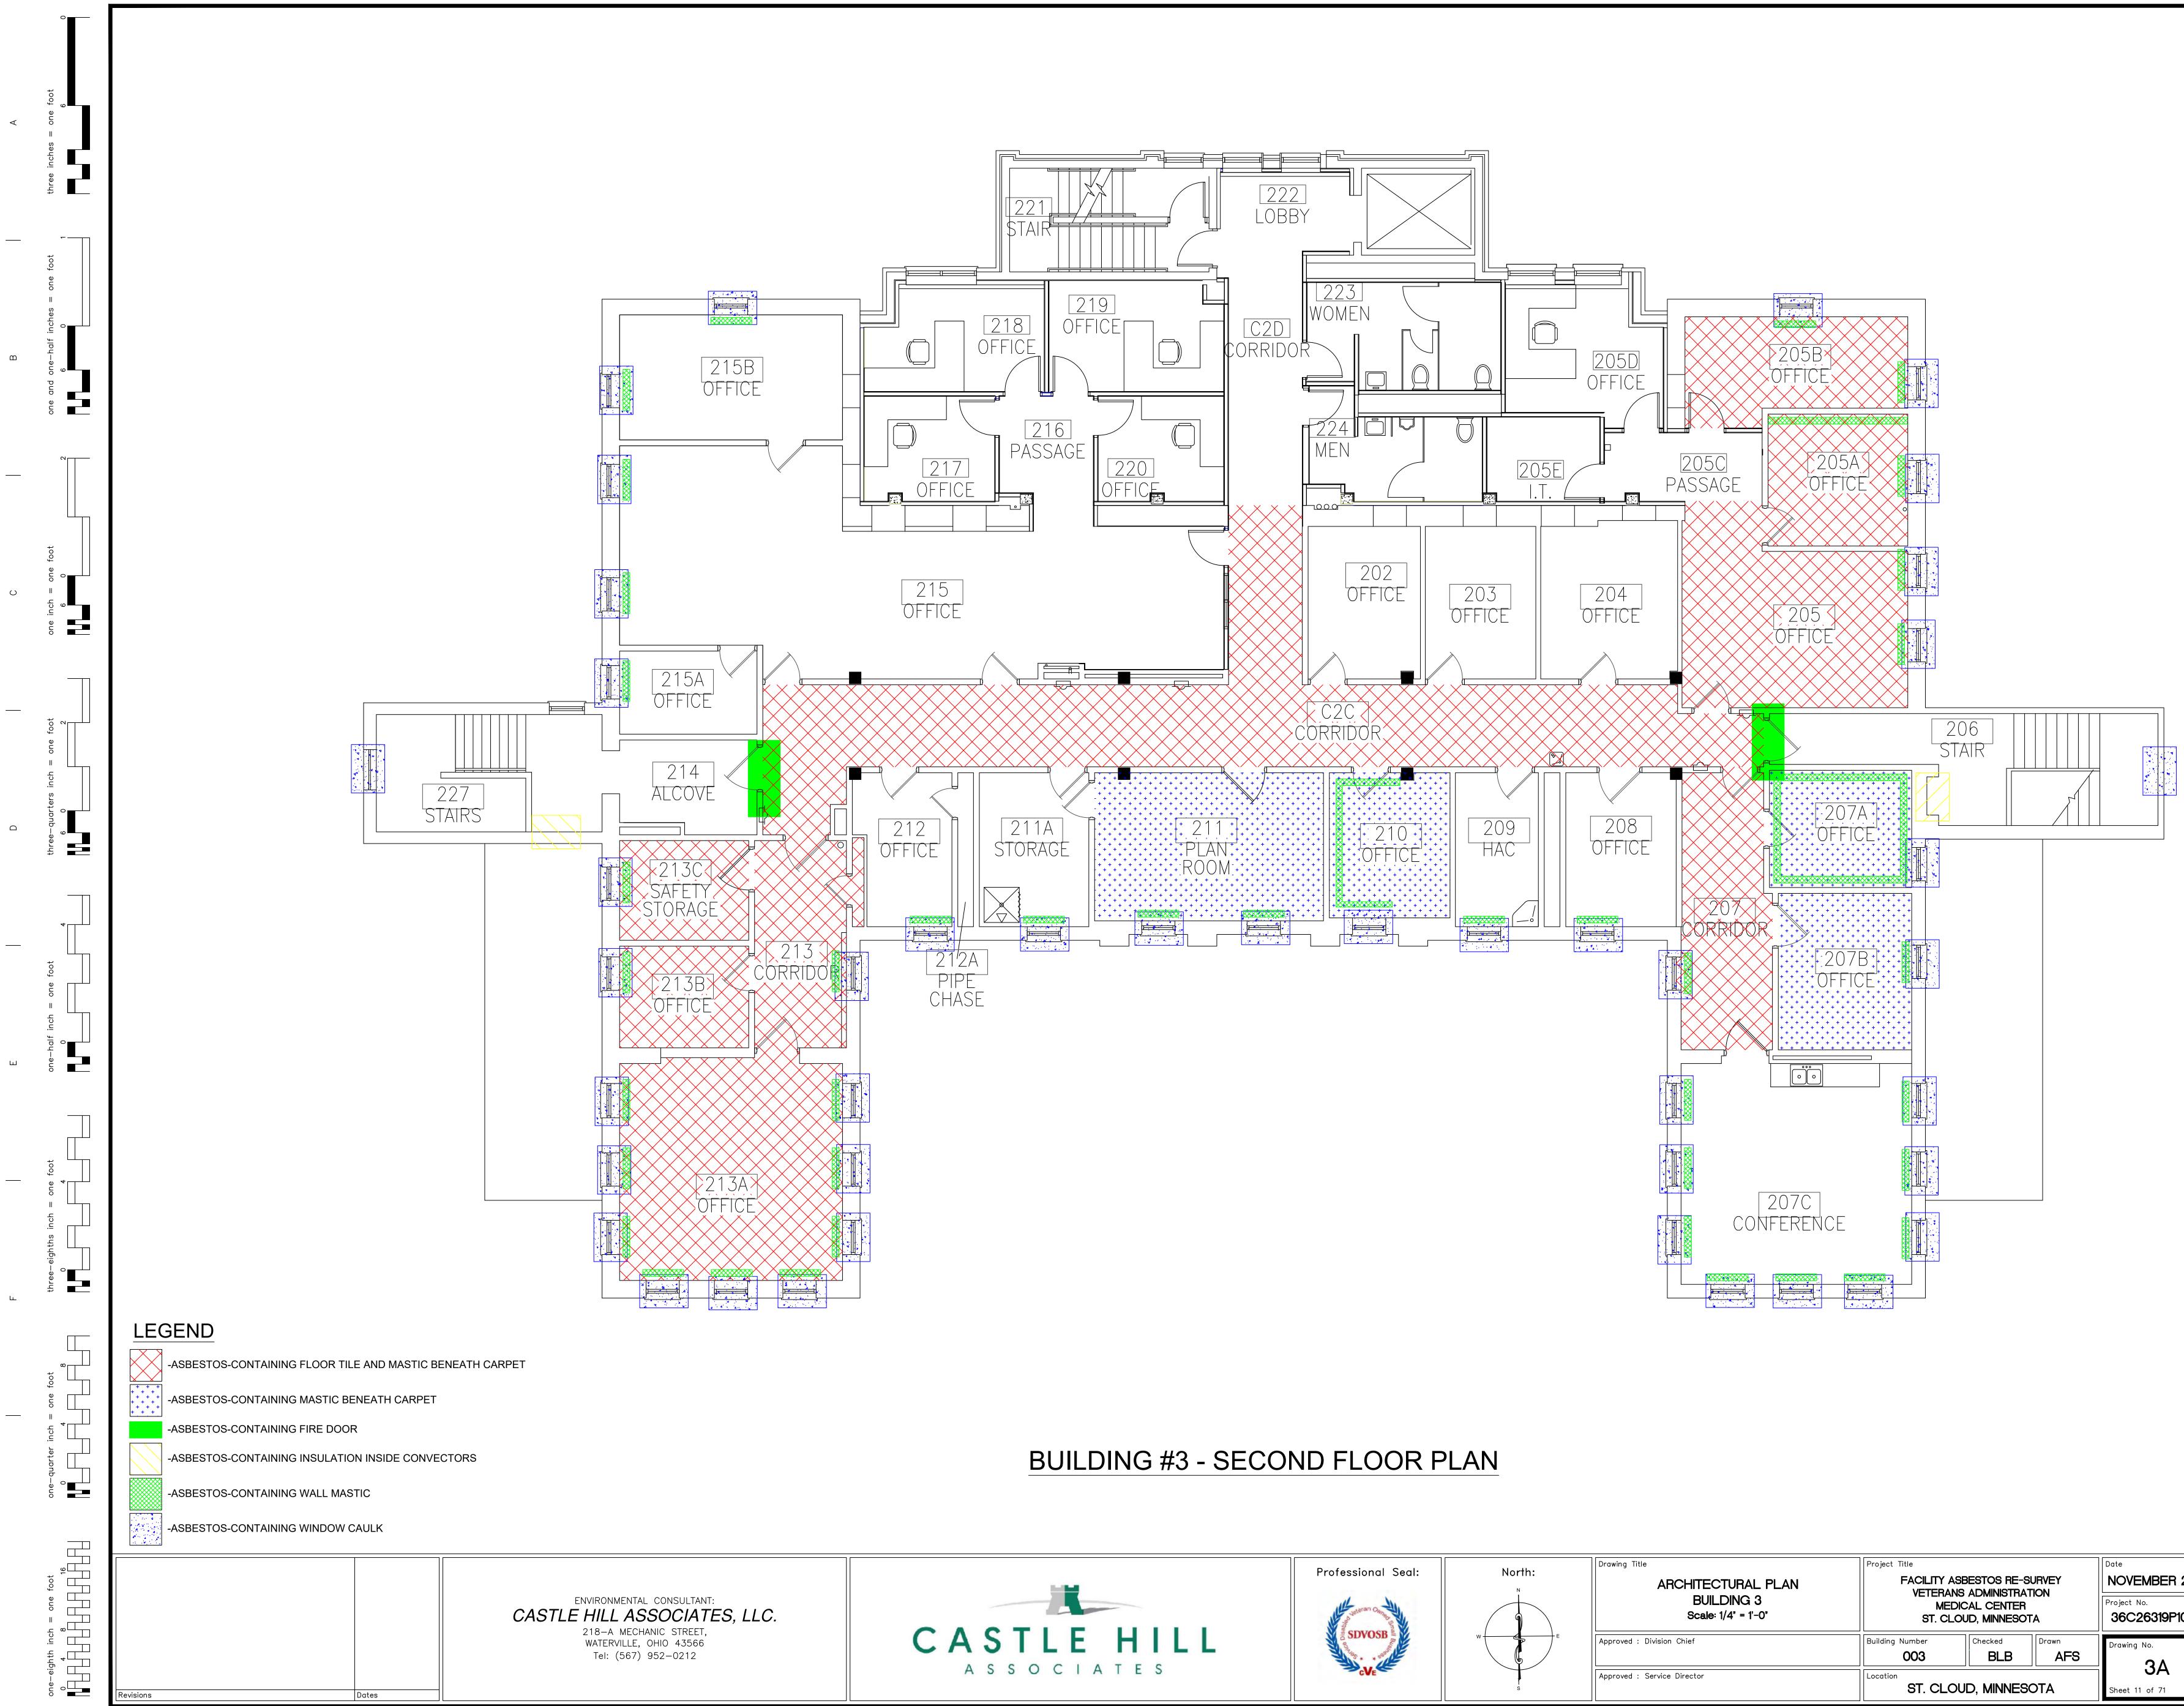

North	Drawing Title	Project Title	Date NOVEMBER 2019			
North: ∾	ARCHITECTURAL PLAN					
W	BUILDING 3 Scale: 1/4" = 1'-0"	MEI	VETERANS ADMINISTRATION MEDICAL CENTER ST. CLOUD, MINNESOTA			
	Approved : Division Chief	Building Number	Checked BLB	Drawn AFS	Drawing No.	
	Approved : Service Director	ST. CLOUD, MINNESOTA			3A Sheet 11 of 71	






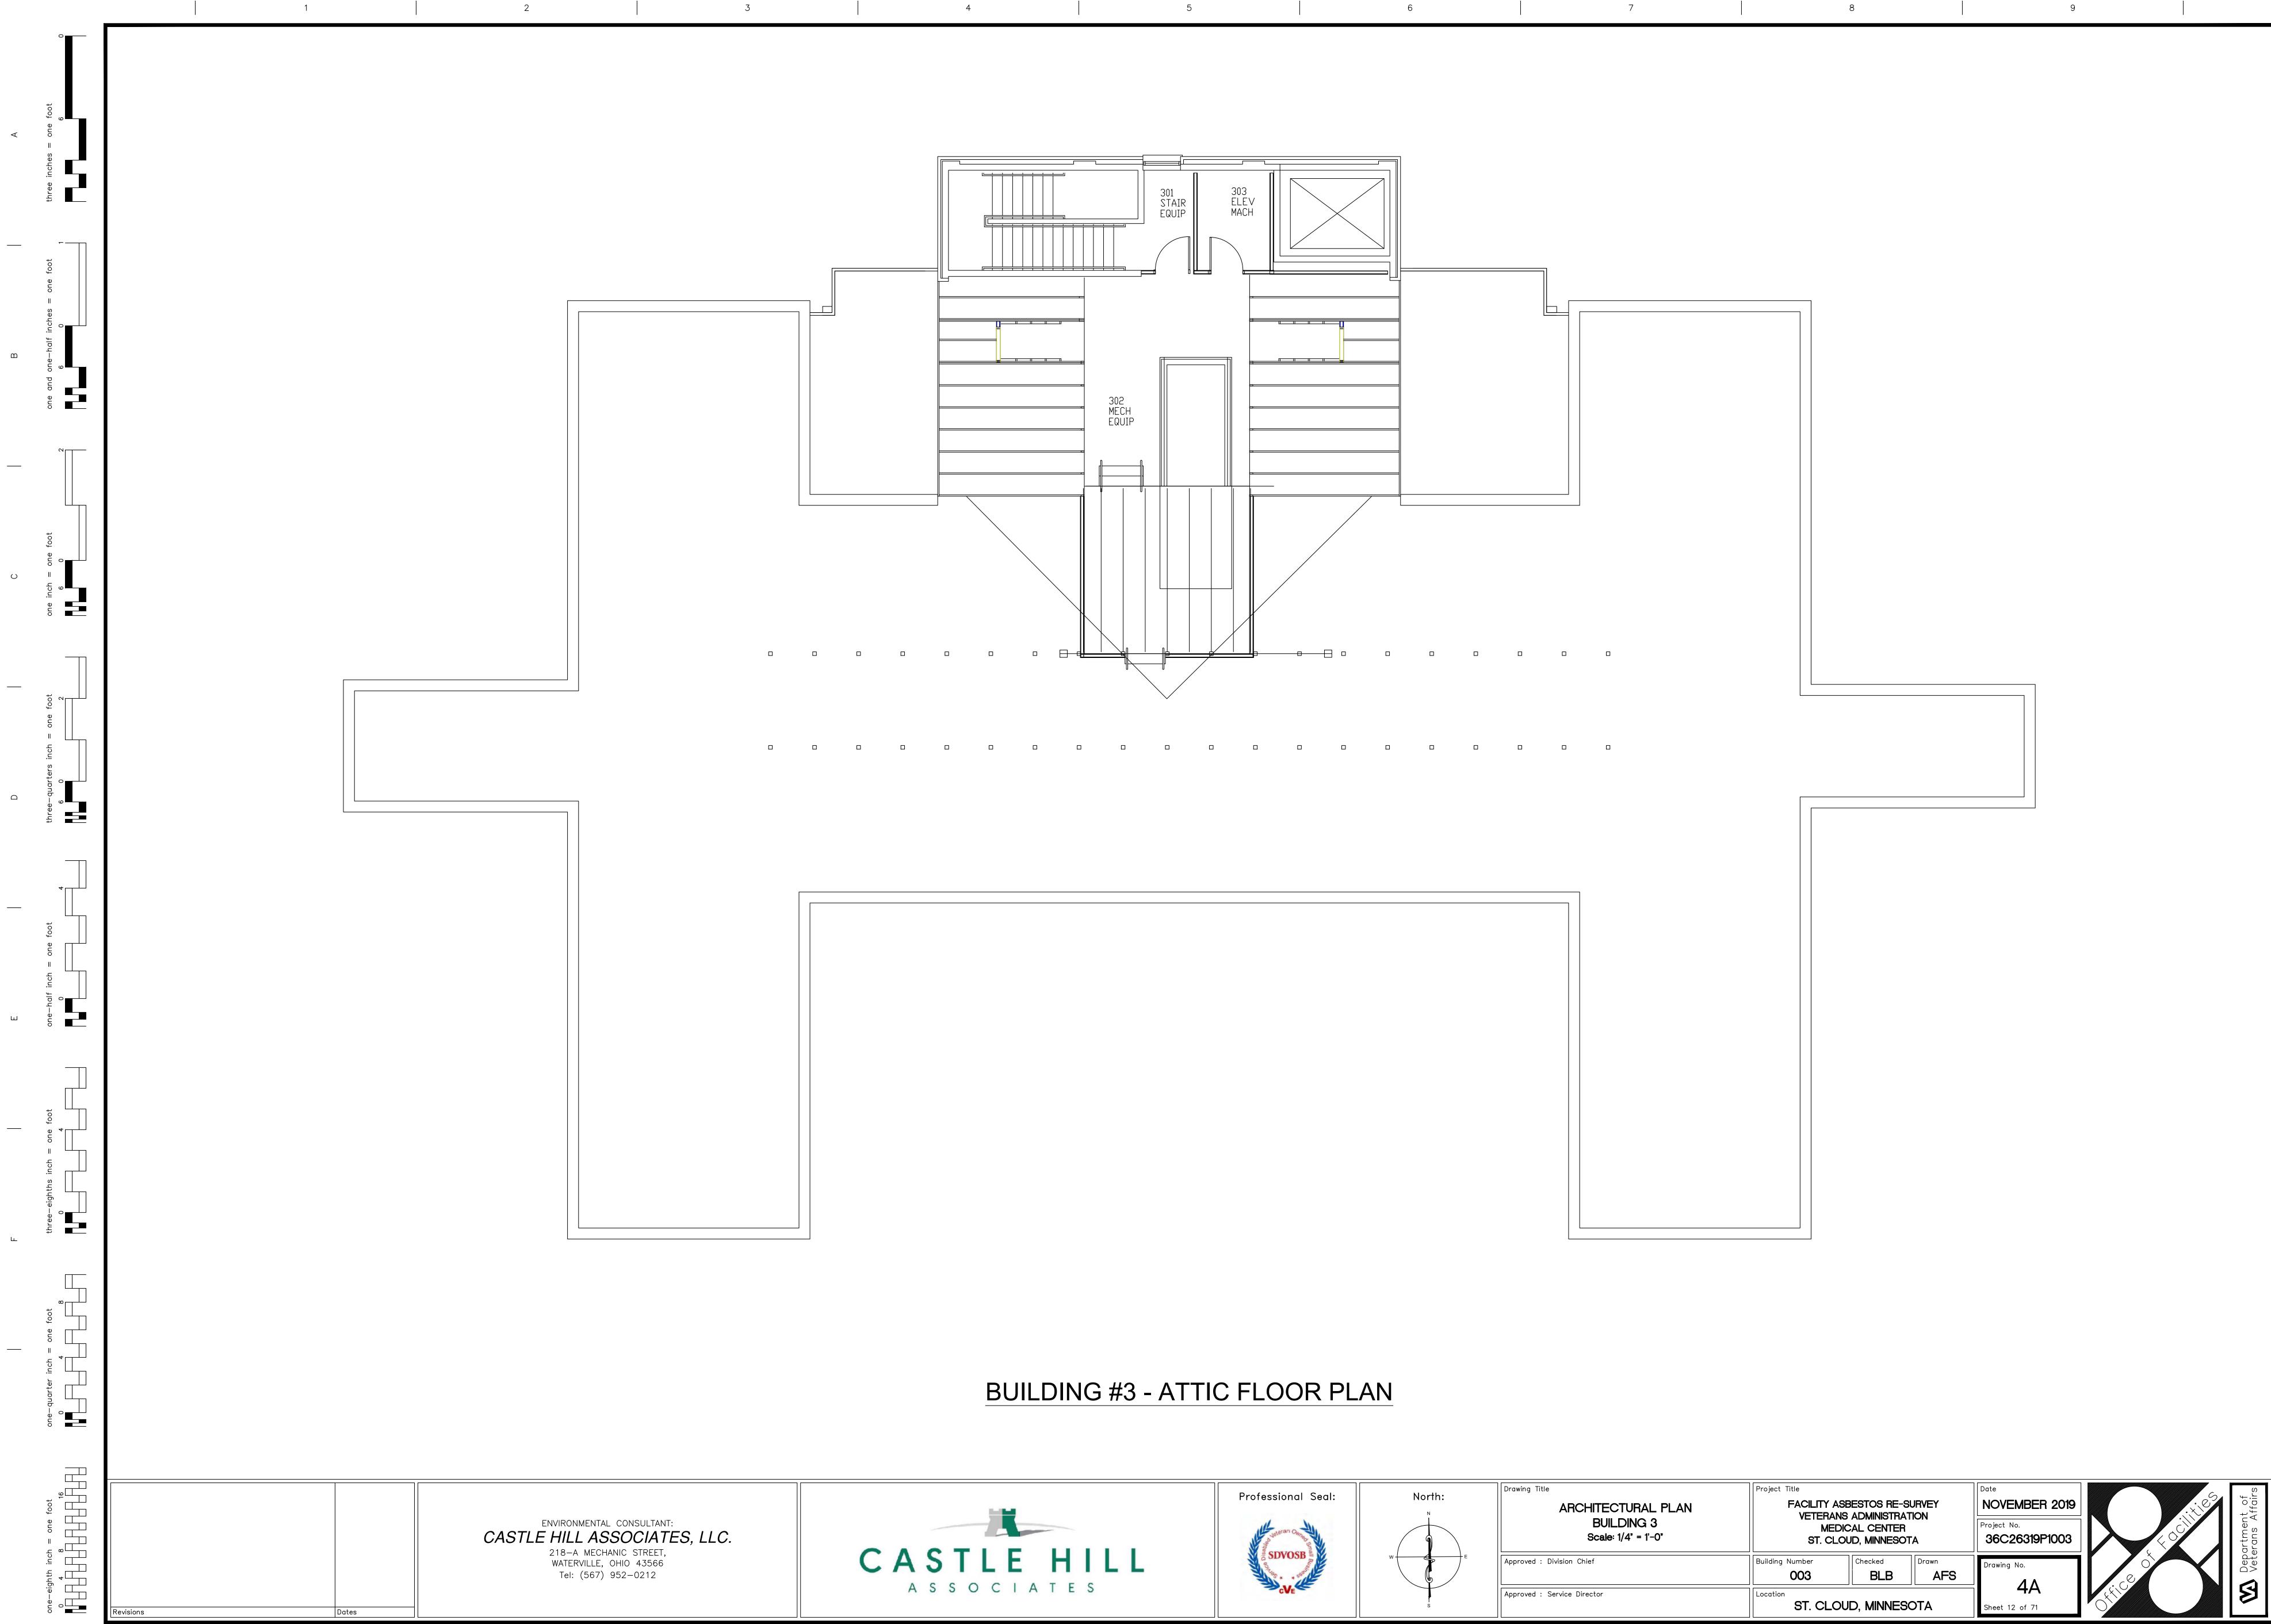

North:	Drawing Title ARCHITECTURAL PLAN	Project Title FACILITY ASE VETERANS	NOVEMBER 2019		
	BUILDING 3 Scale: 1/4" = 1'-0"	MEDIC ST. CLOU	Project No. 36C26319P1003		
W E	Approved : Division Chief	Building Number 003	Checked BLB	Drawn AFS	Drawing No.
s	Approved : Service Director	Location ST. CLOU	D, MINNES	OTA	4A Sheet 12 of 71
				Í	



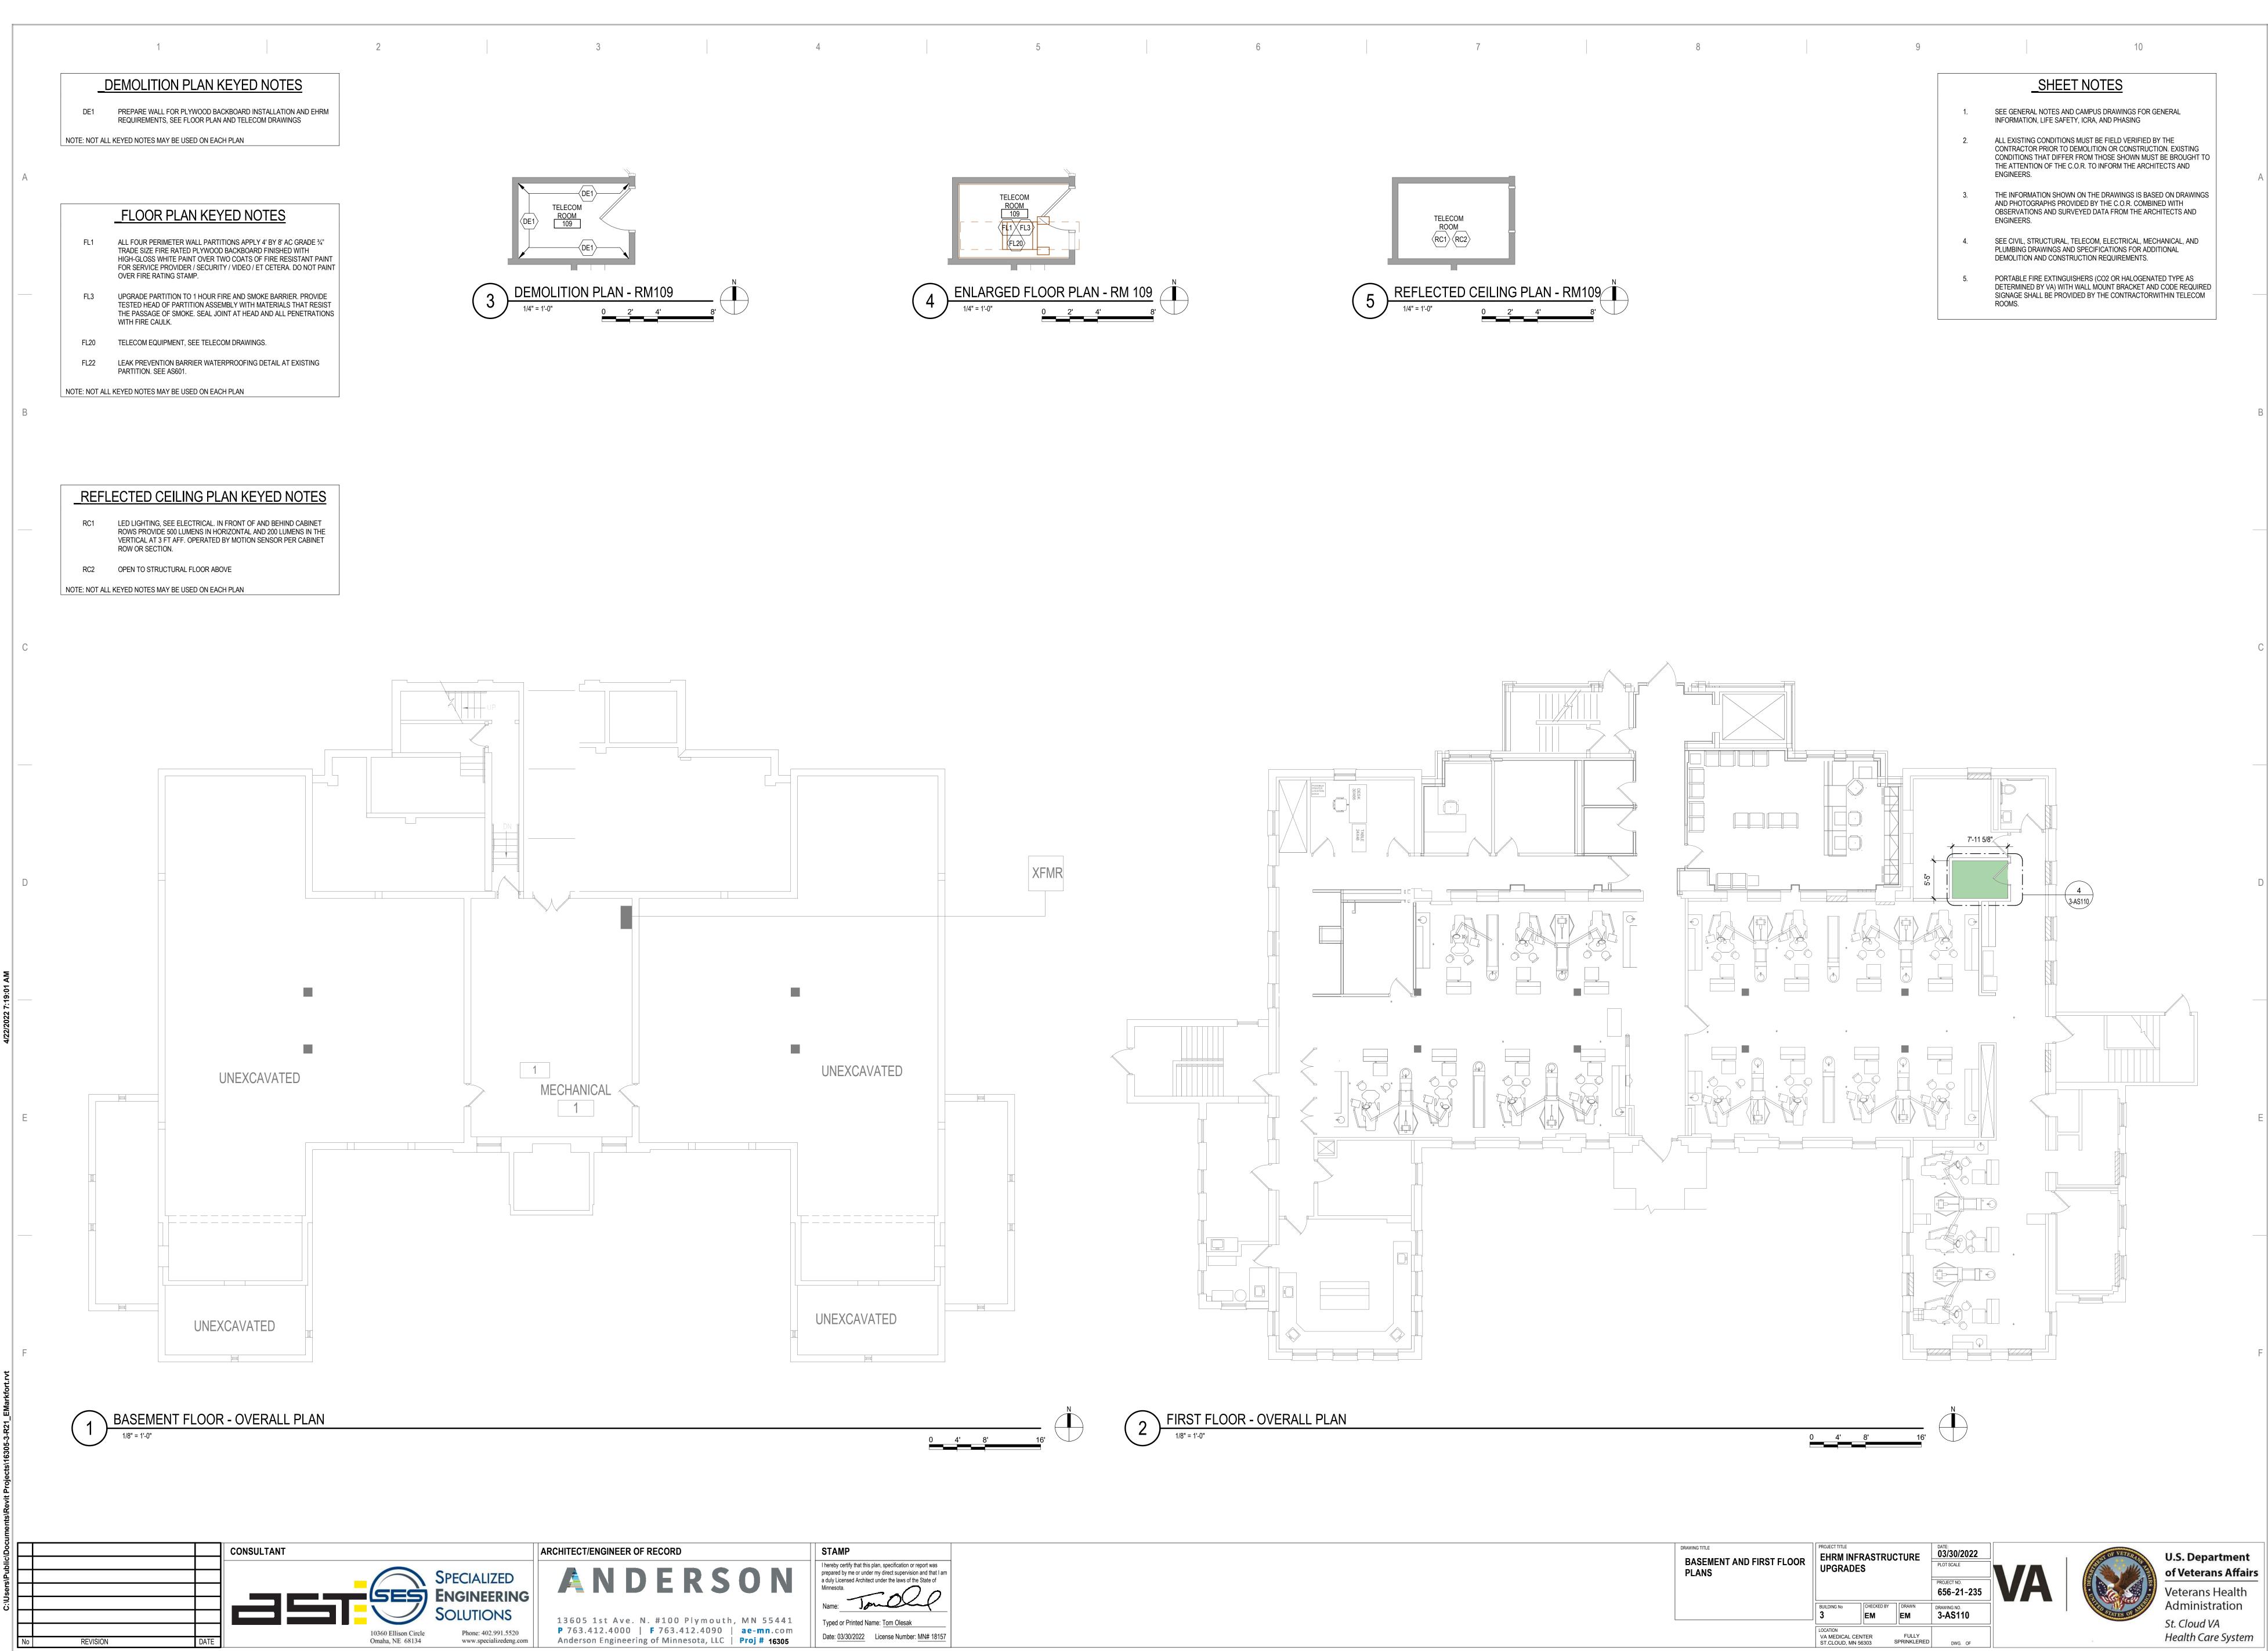


DRAWING TITLE BASEMENT AND FIRST FLOOR PLANS	PROJECT TITLE EHRM INFRASTRUCTURE UPGRADES		CTURE 03/30/2022 PLOT SCALE PROJECT NO. 656-21-235		VA
	BUILDING No	CHECKED BY	DRAWN EM	DRAWING NO. 3-AS110	
	LOCATION VA MEDICAL CEI ST.CLOUD, MN 5		FULLY SPRINKLERED	DWG. OF	









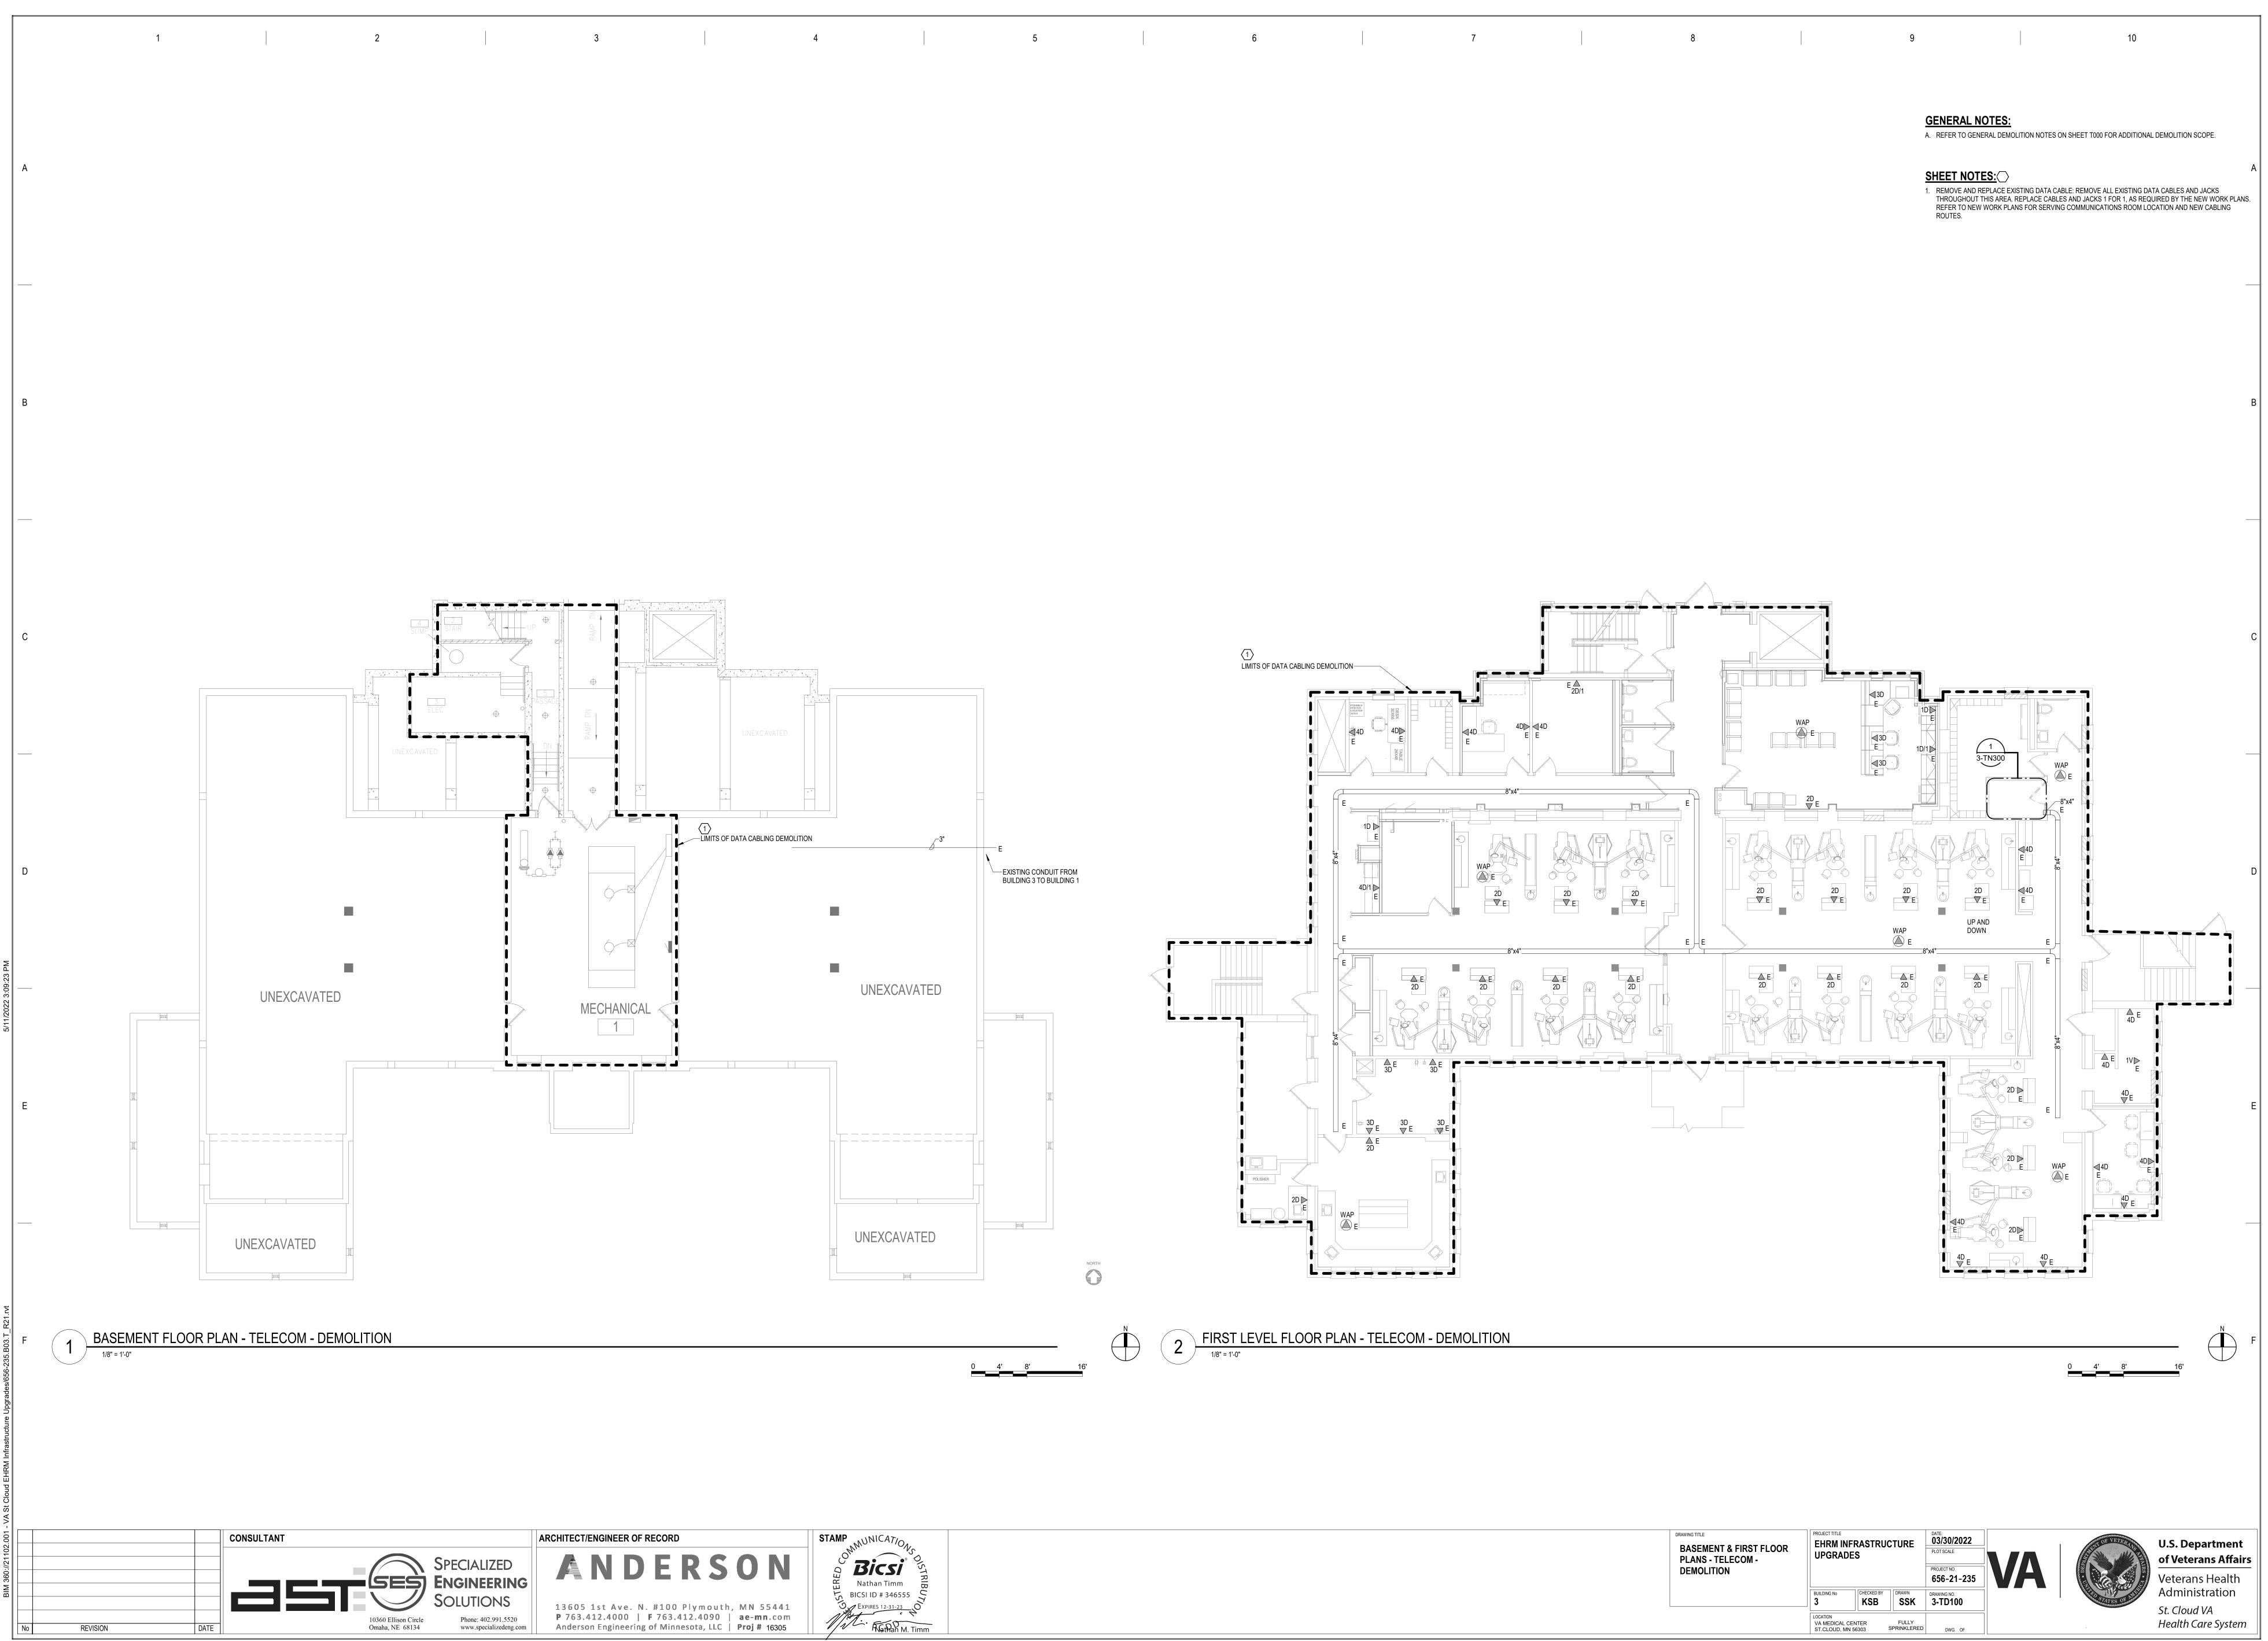


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	BUILDING No 3	CHECKED BY	DRAWN SSK	DRAWING NO. 3-TD100	
	LOCATION VA MEDICAL CE ST.CLOUD, MN		FULLY SPRINKLERED	DWG. OF	

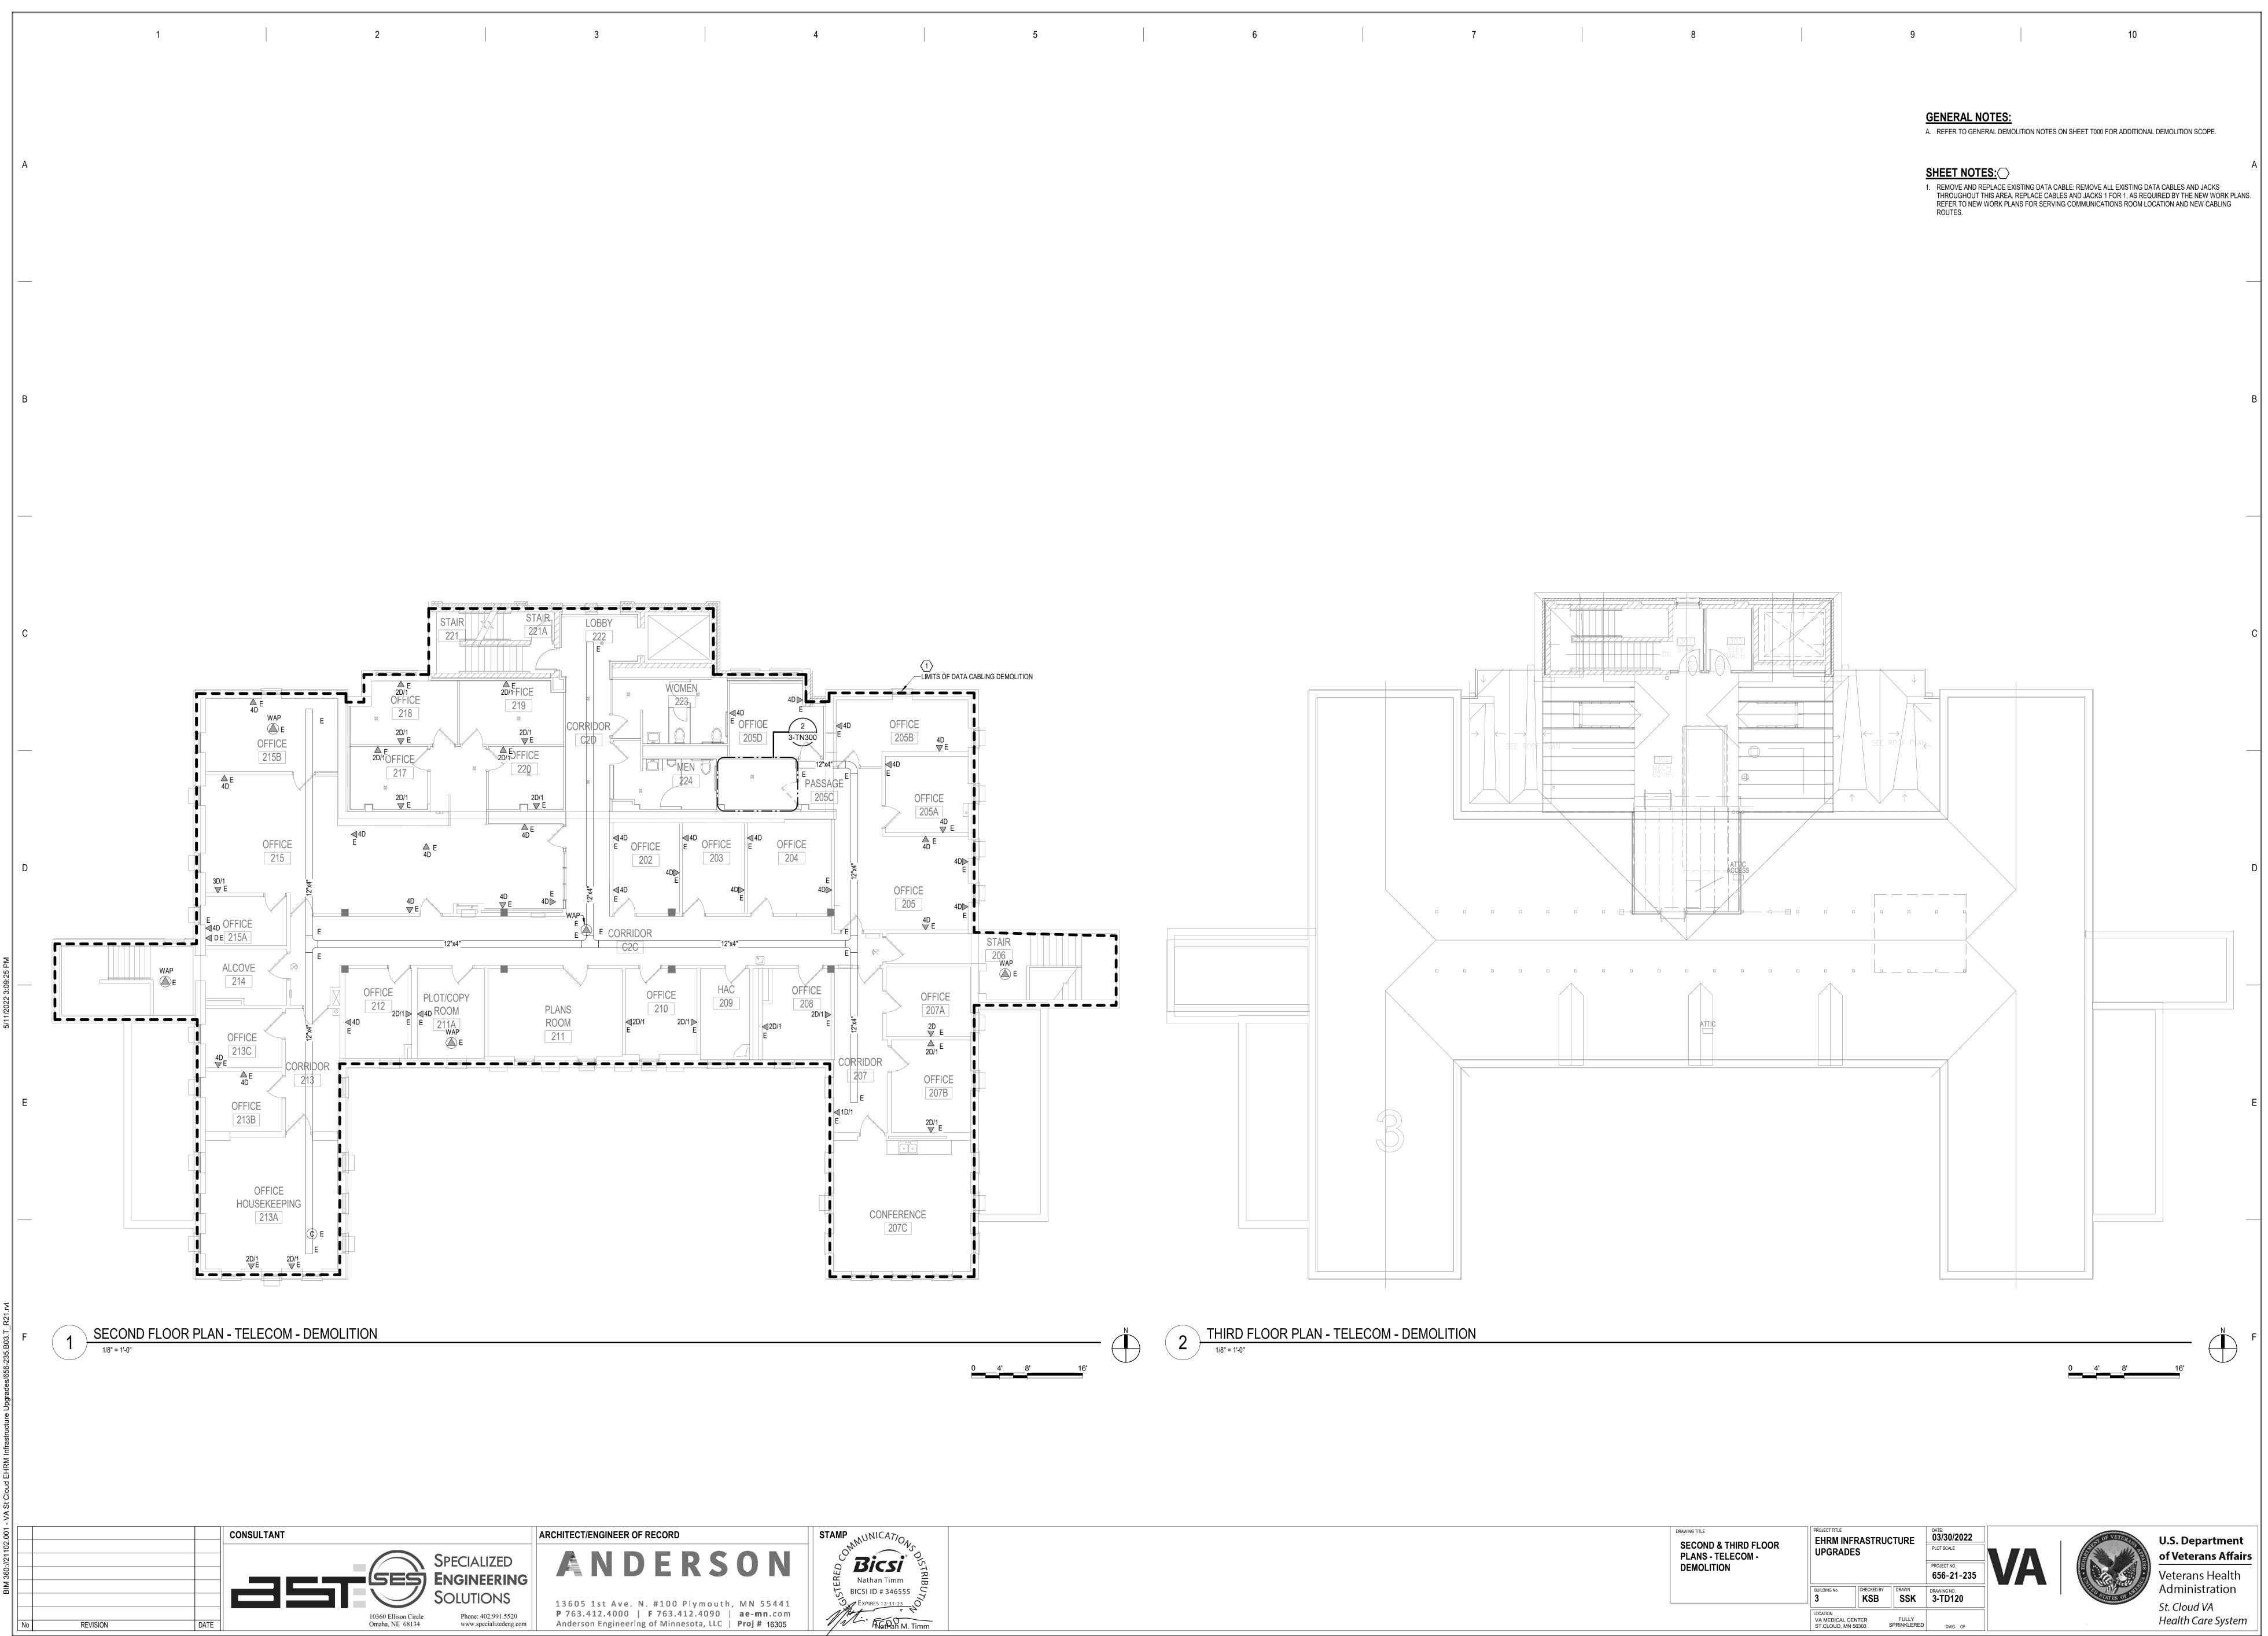


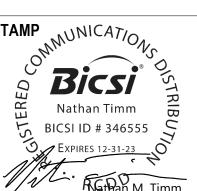

DRAWING TITLE SECOND & THIRD FLOOR	PROJECT TITLE EHRM INF UPGRADE		CTURE	DATE: 03/30/2022 PLOT SCALE	
PLANS - TELECOM - DEMOLITION	OFGRAD				VA
	BUILDING No 3	CHECKED BY	DRAWN SSK	DRAWING NO. 3-TD120	
	LOCATION VA MEDICAL CE ST.CLOUD, MN		FULLY	DWG. OF	

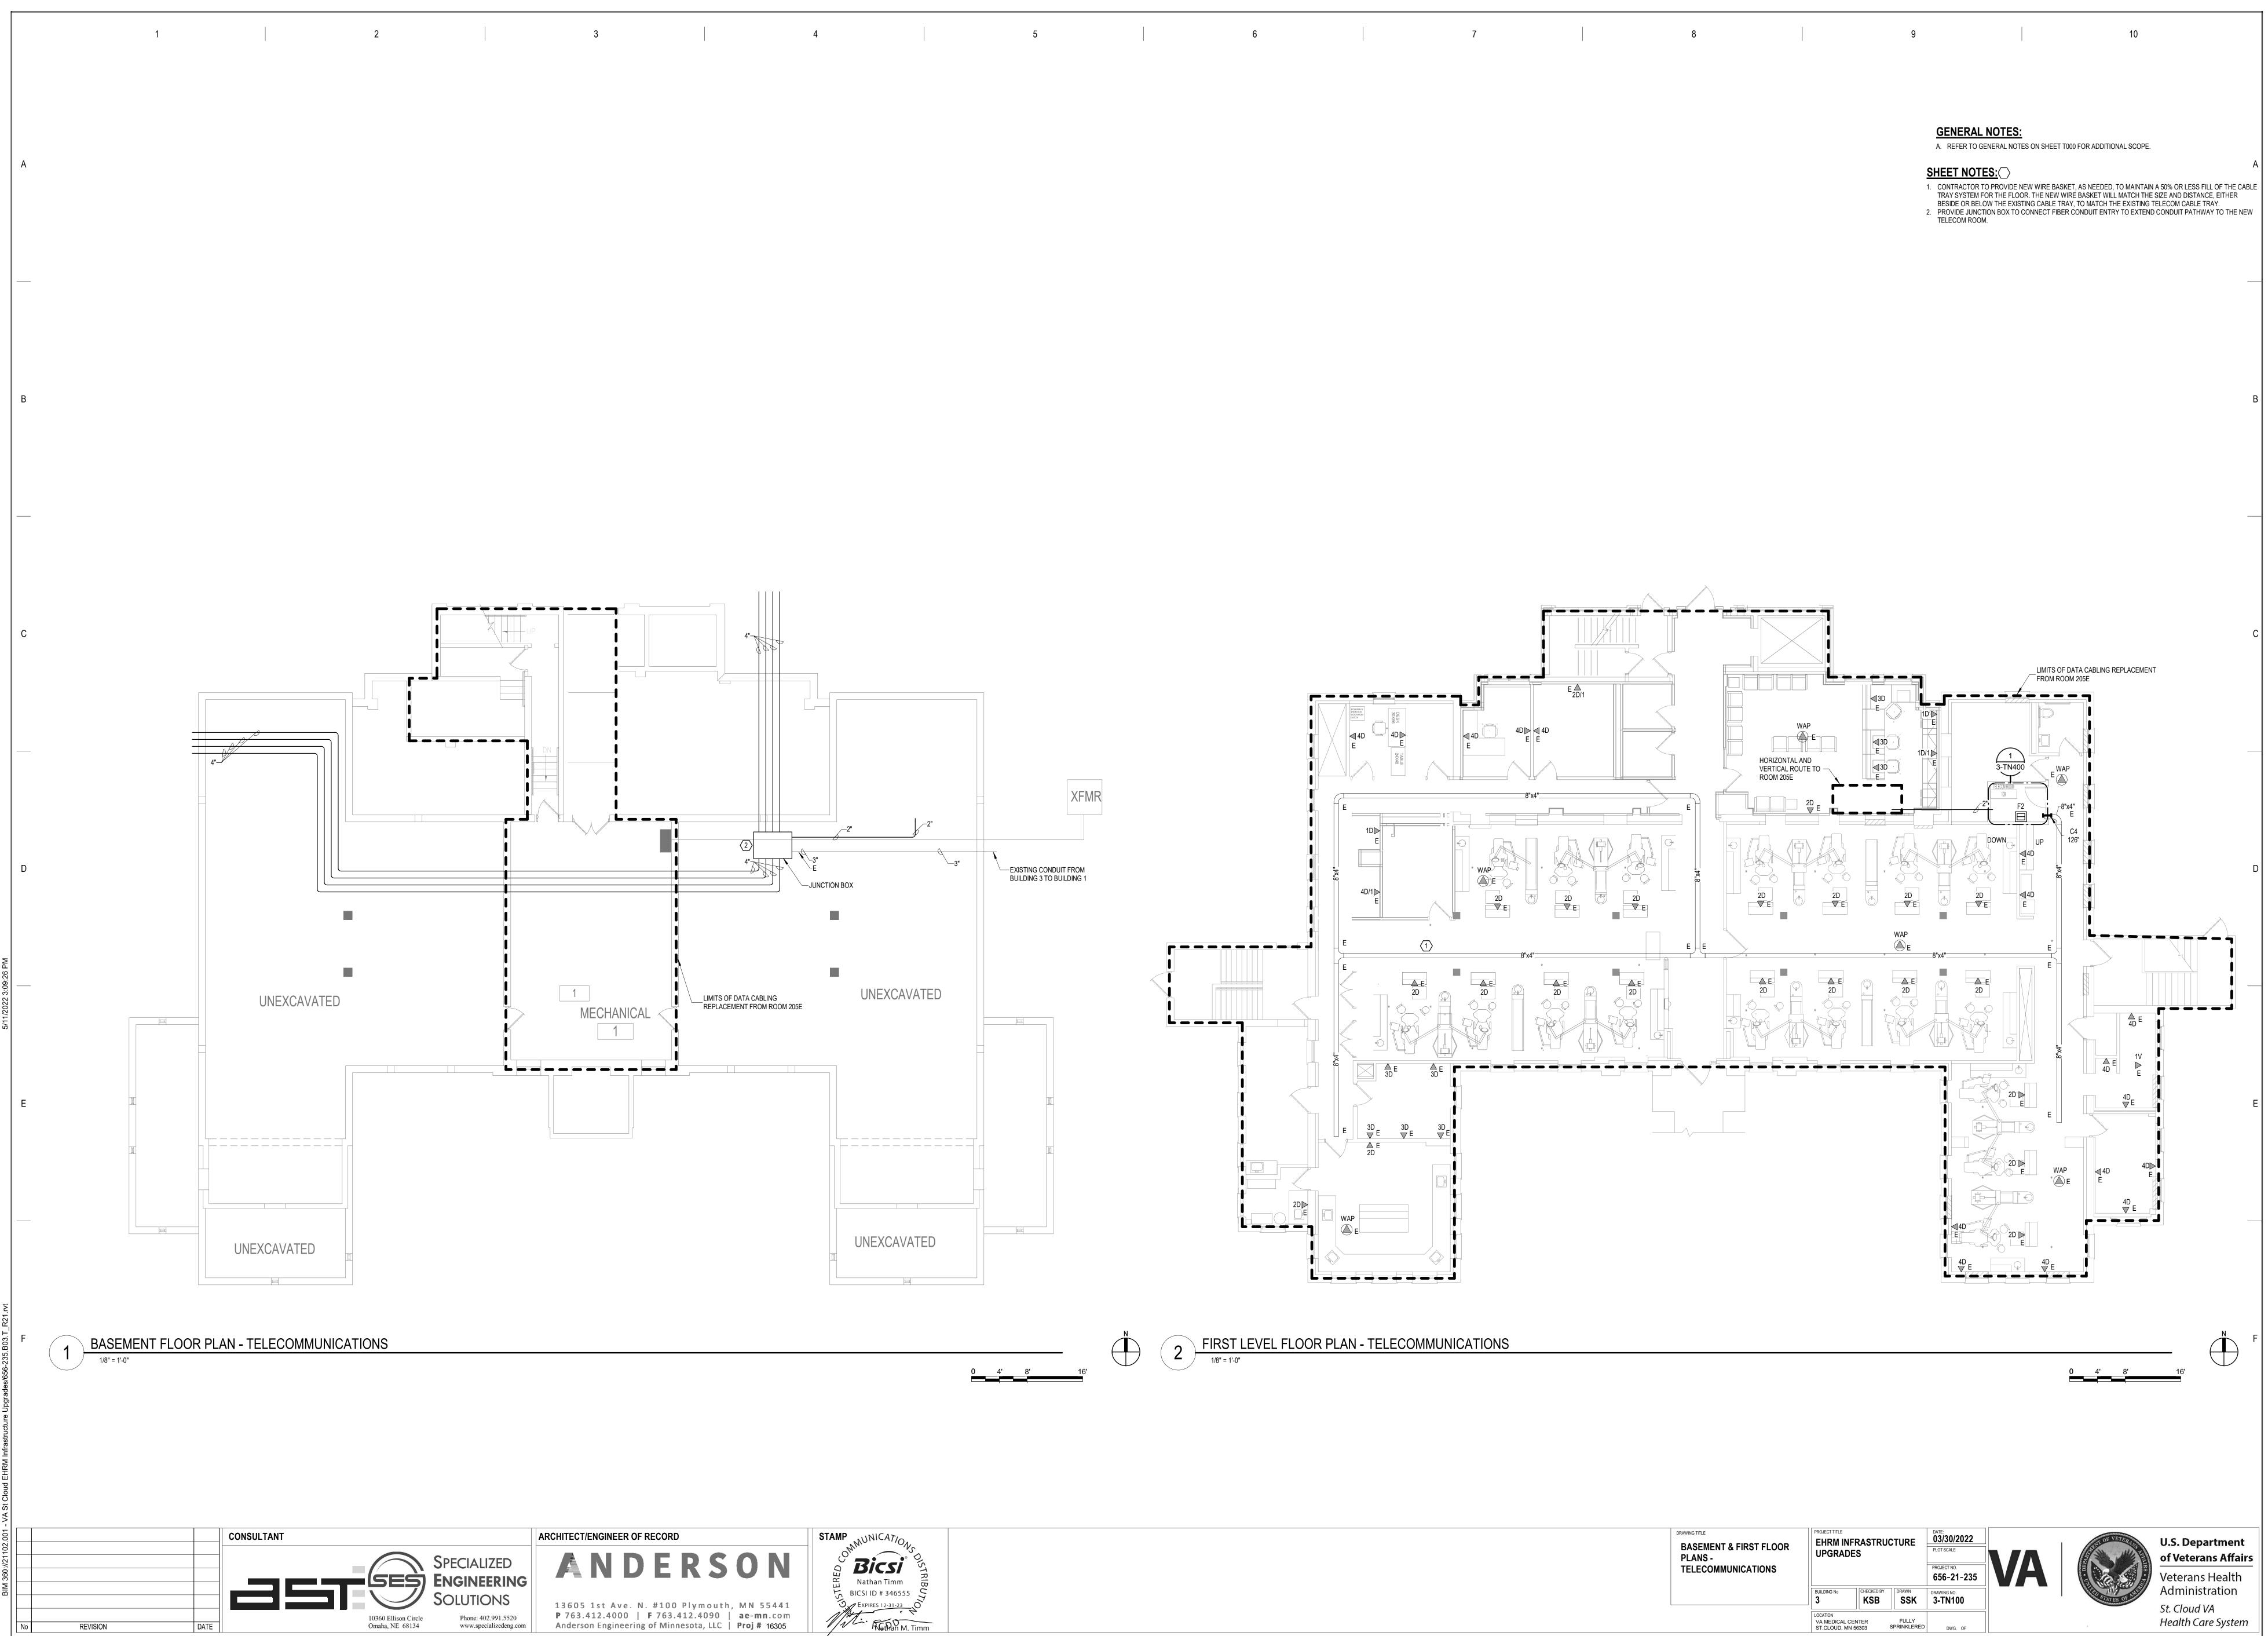



DRAWING TITLE BASEMENT & FIRST FLOOR PLANS - TELECOMMUNICATIONS		EHRM INF		CTURE	DATE: 03/30/2022 PLOT SCALE PROJECT NO. 656-21-235	VA
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		LOCATION VA MEDICAL C ST.CLOUD, MN		FULLY SPRINKLERED	DWG. OF	

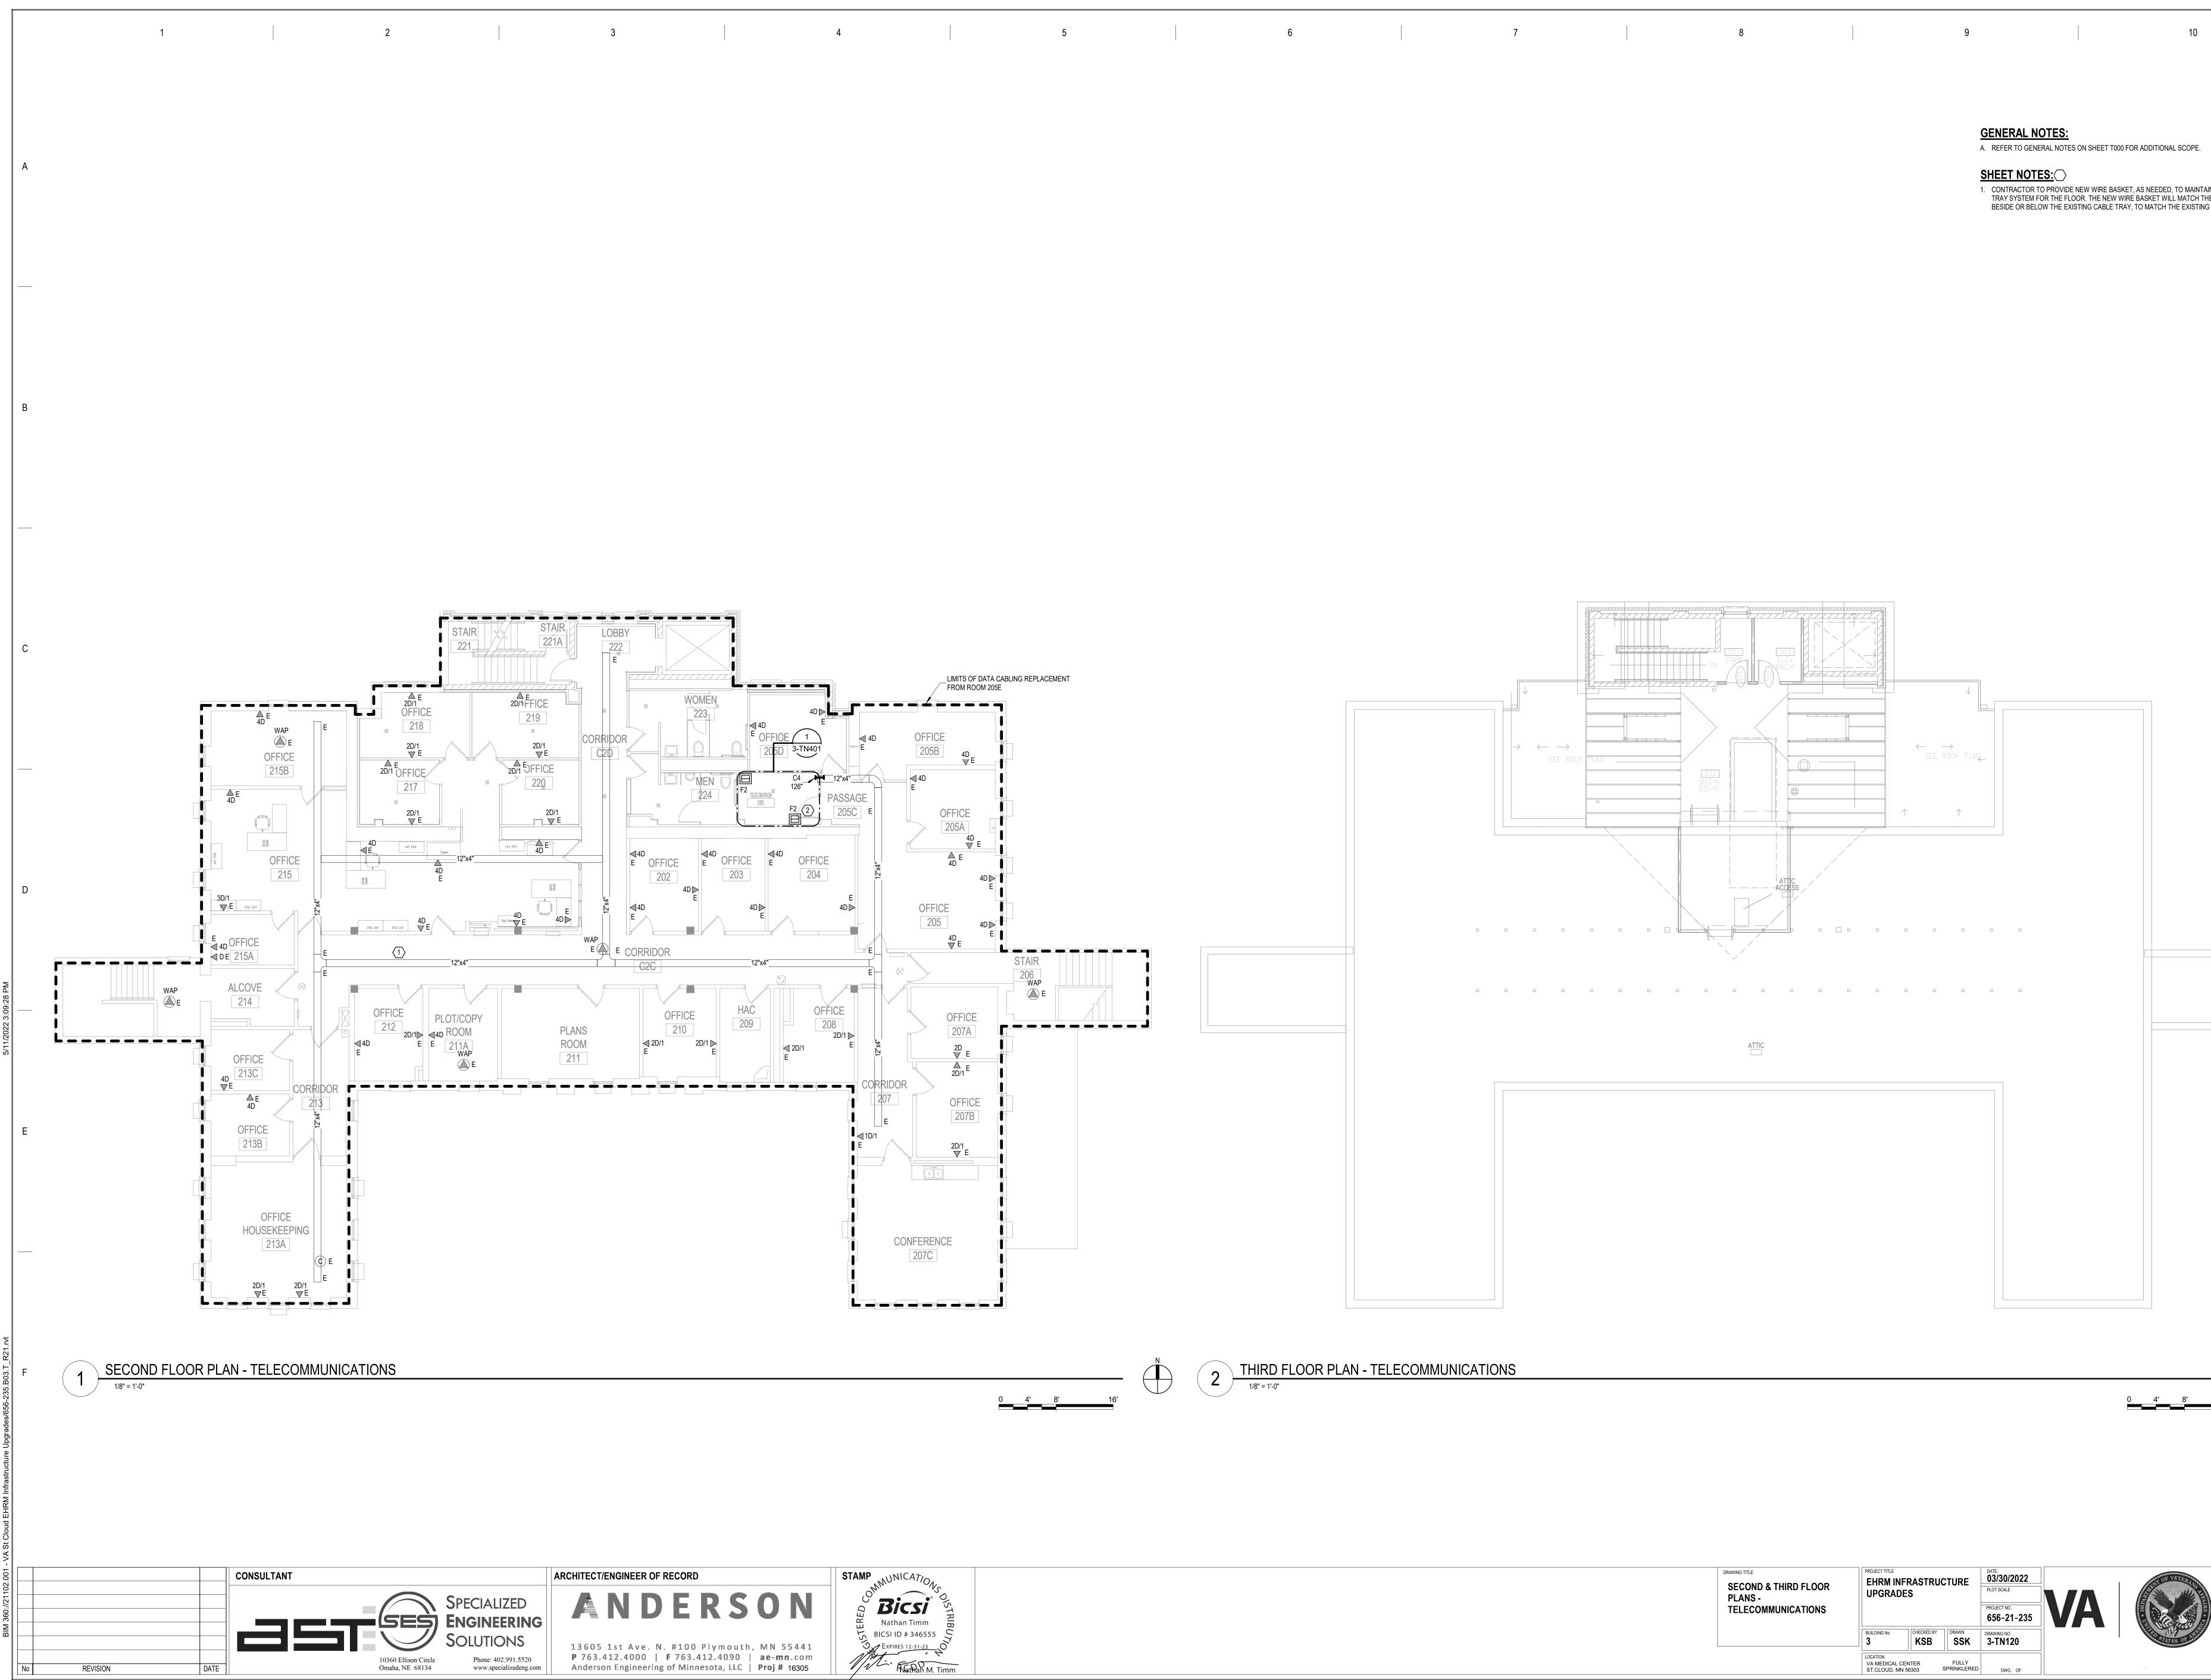




DRAWING TITLE SECOND & THIRD FLOOR PLANS - TELECOMMUNICATIONS		EHRM INFRASTRUCTURE UPGRADES		DATE: 03/30/2022 PLOT SCALE PROJECT NO. 656-21-235	VA
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	LOCATION VA MEDICAL CE ST.CLOUD, MN		FULLY SPRINKLERED	DWG. OF	

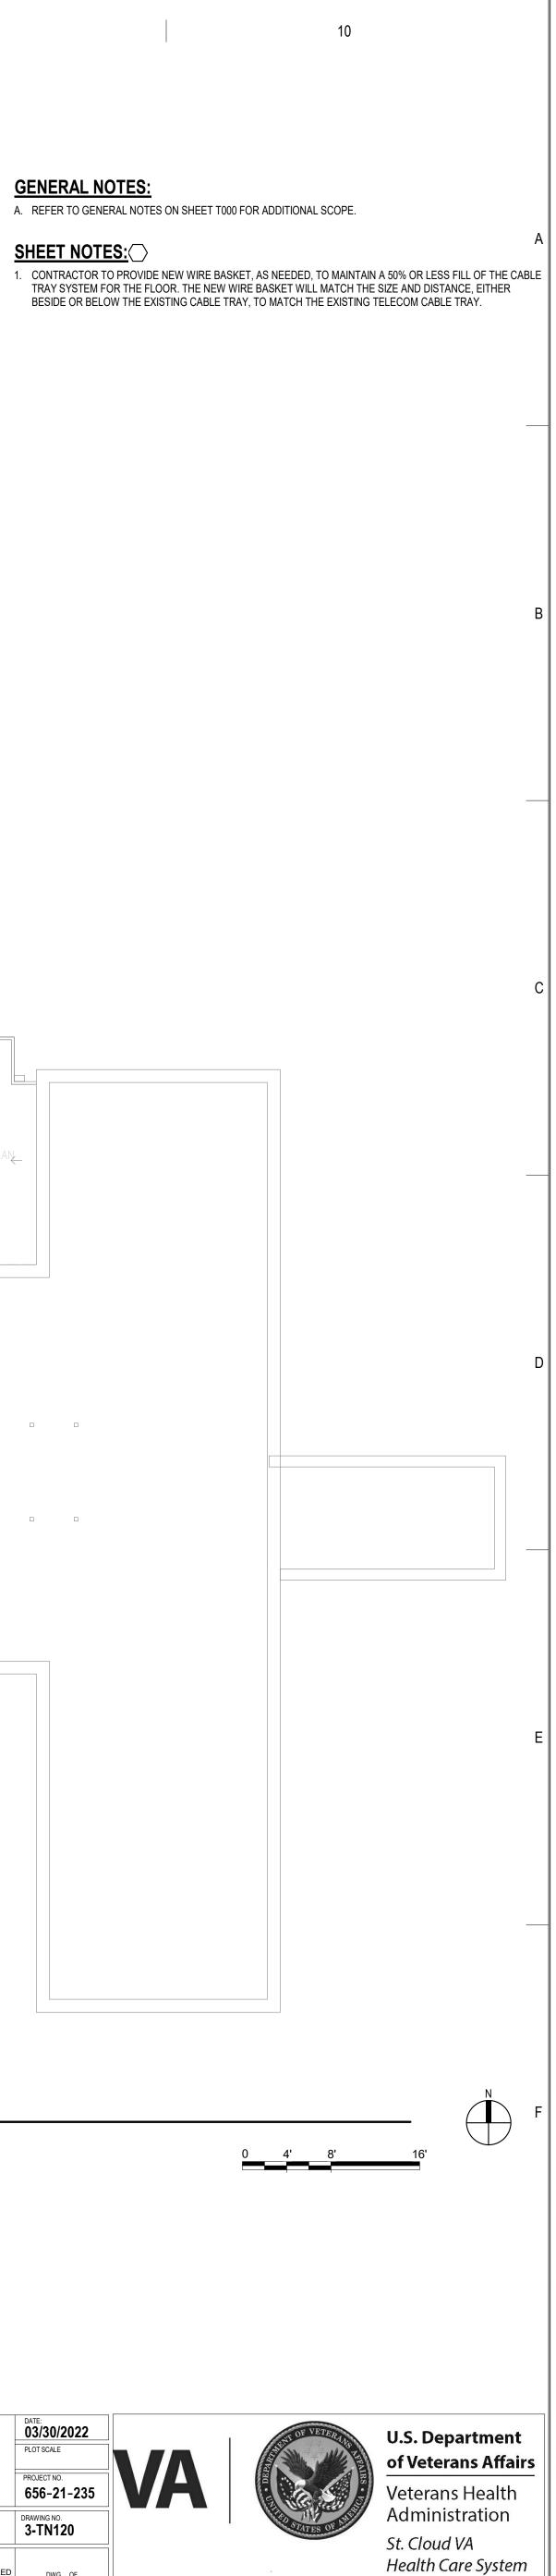

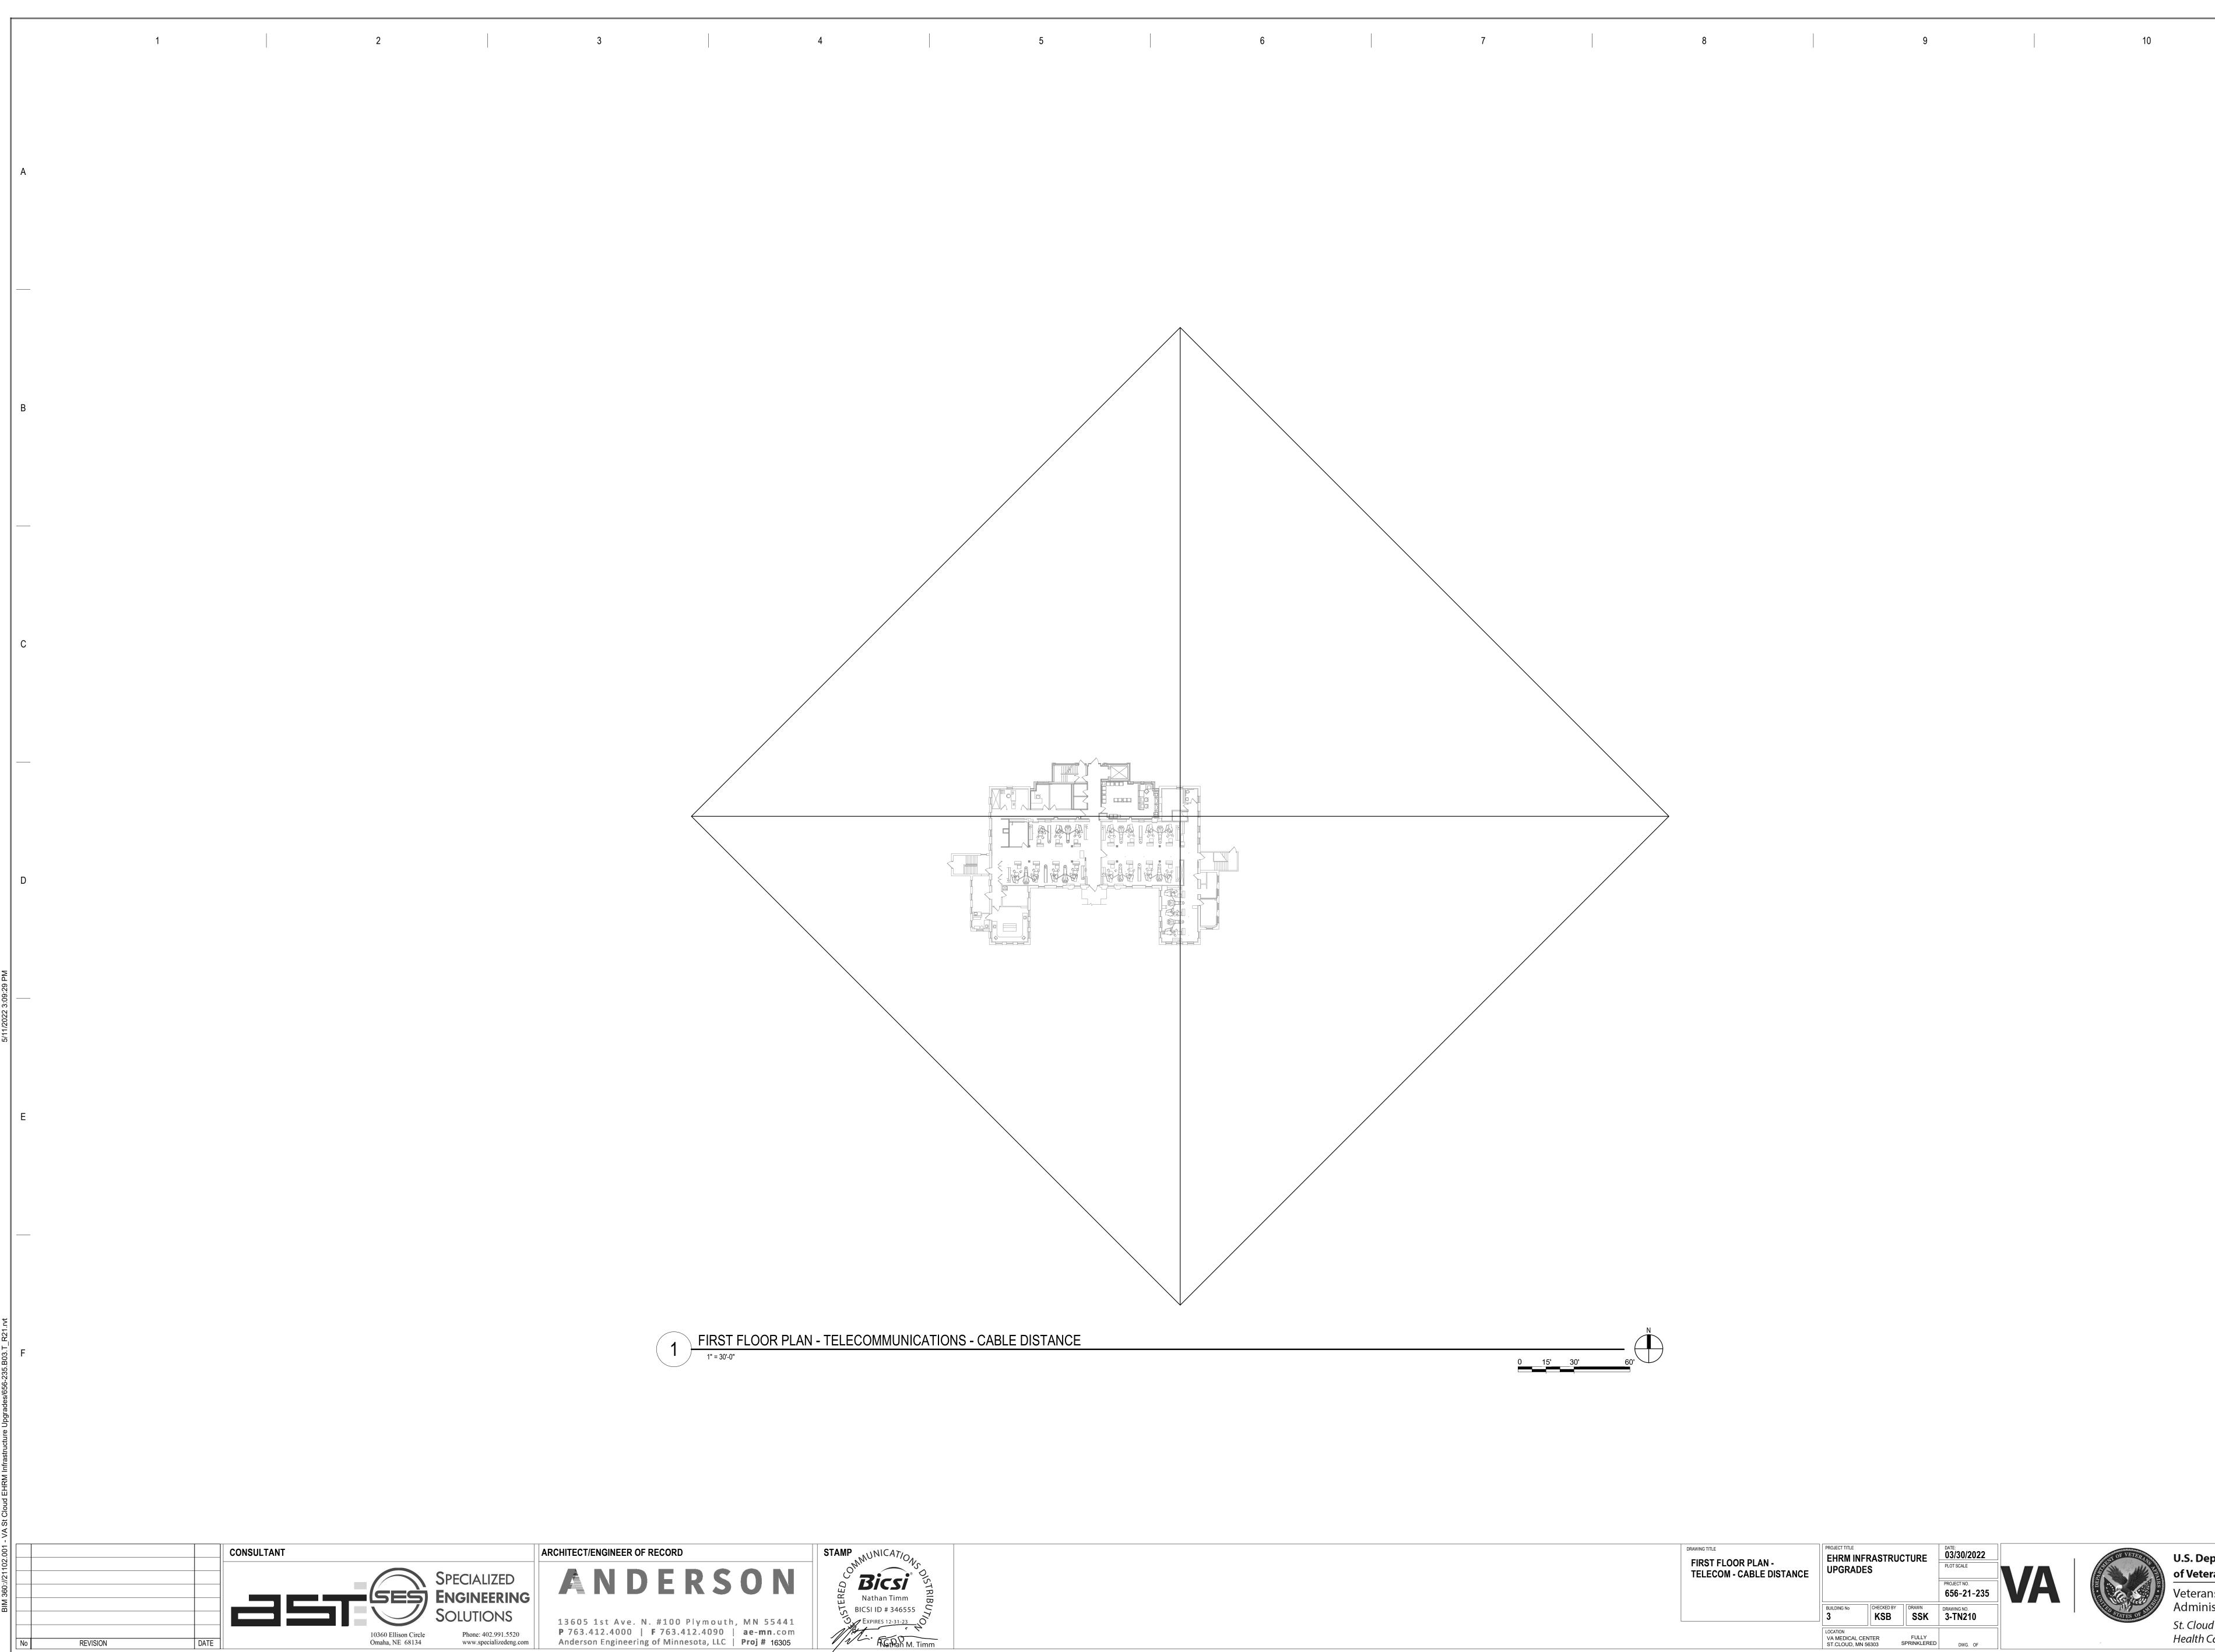


DRAWING TITLE FIRST FLOOR PLAN - TELECOM - CABLE DISTANCE	PROJECT TITLE EHRM INFR UPGRADES		TURE	DATE: 03/30/2022 PLOT SCALE PROJECT NO. 656-21-235	VA
	BUILDING No 3	CHECKED BY	DRAWN SSK	DRAWING NO. 3-TN210	
	LOCATION VA MEDICAL CEN ST.CLOUD, MN 56		FULLY SPRINKLERED	DWG. OF	



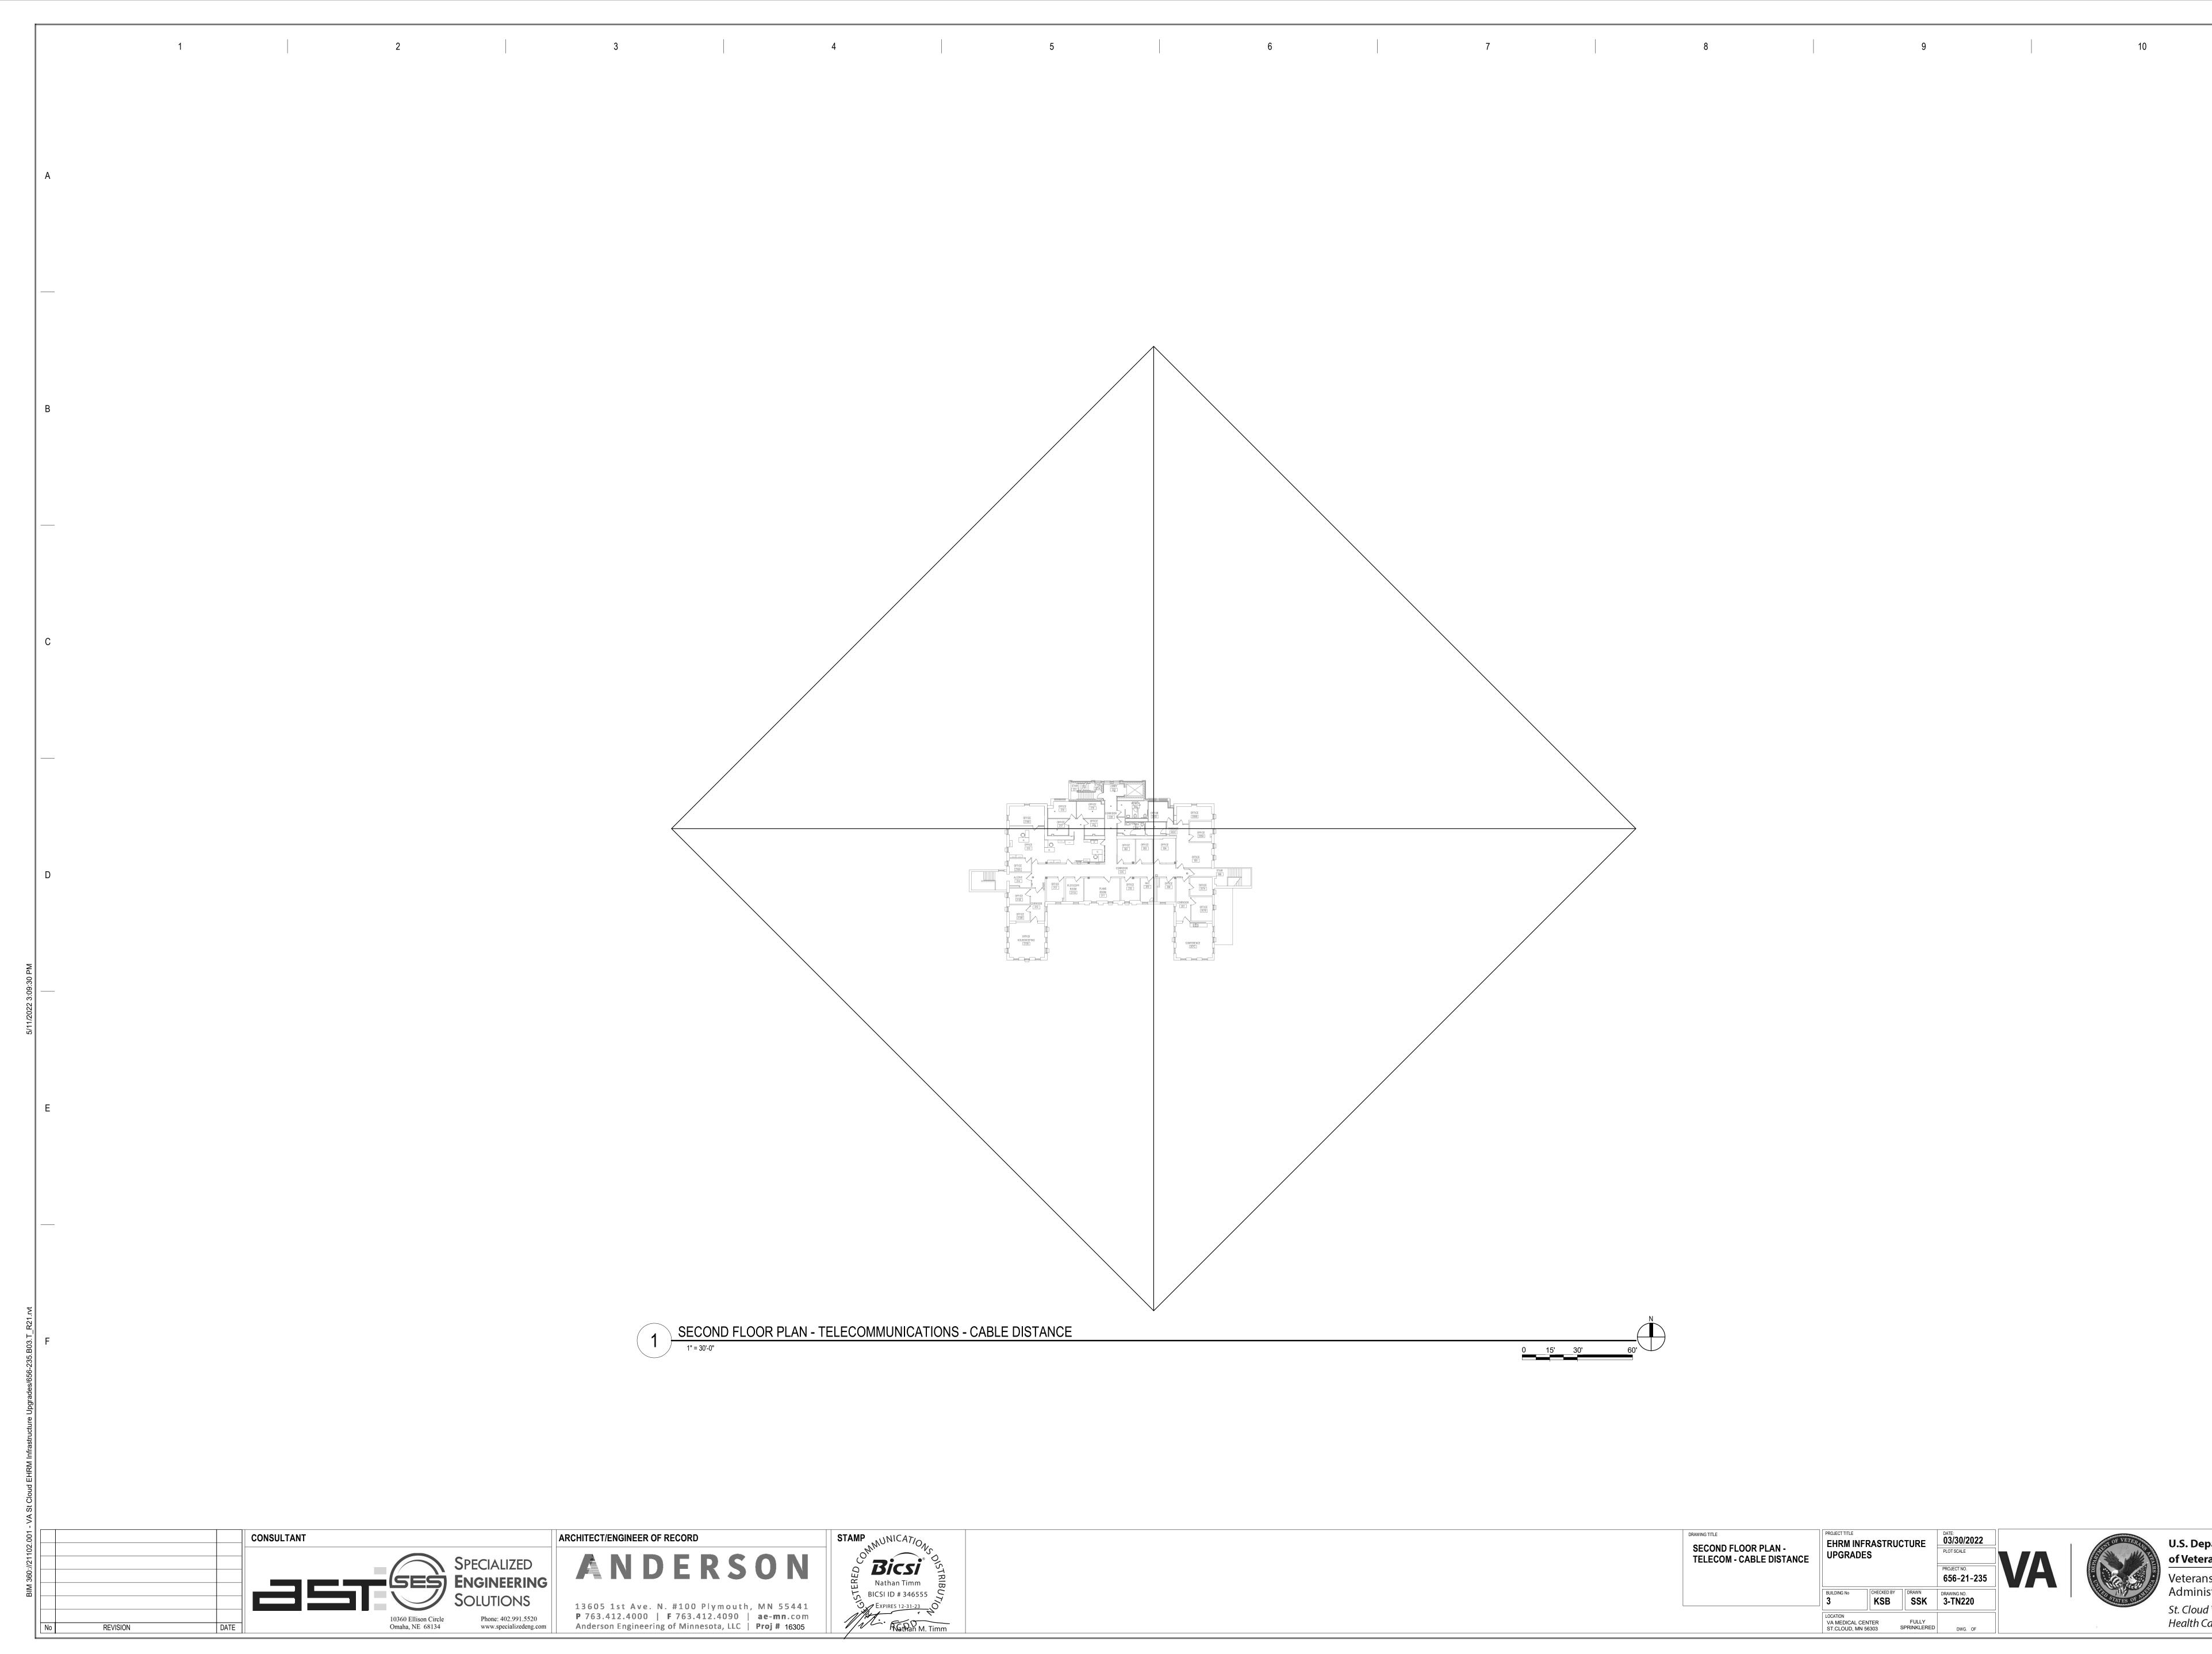

	PROJECT TITLE	FRASTRU	CTURE	DATE: 03/30/2022]
SECOND FLOOR PLAN - TELECOM - CABLE DISTANCE	UPGRADES			PLOT SCALE	
					VA
	BUILDING No	CHECKED BY	DRAWN SSK	656-21-235 DRAWING NO. 3-TN220	
	LOCATION VA MEDICAL C ST.CLOUD, MI		FULLY	DWG. OF	



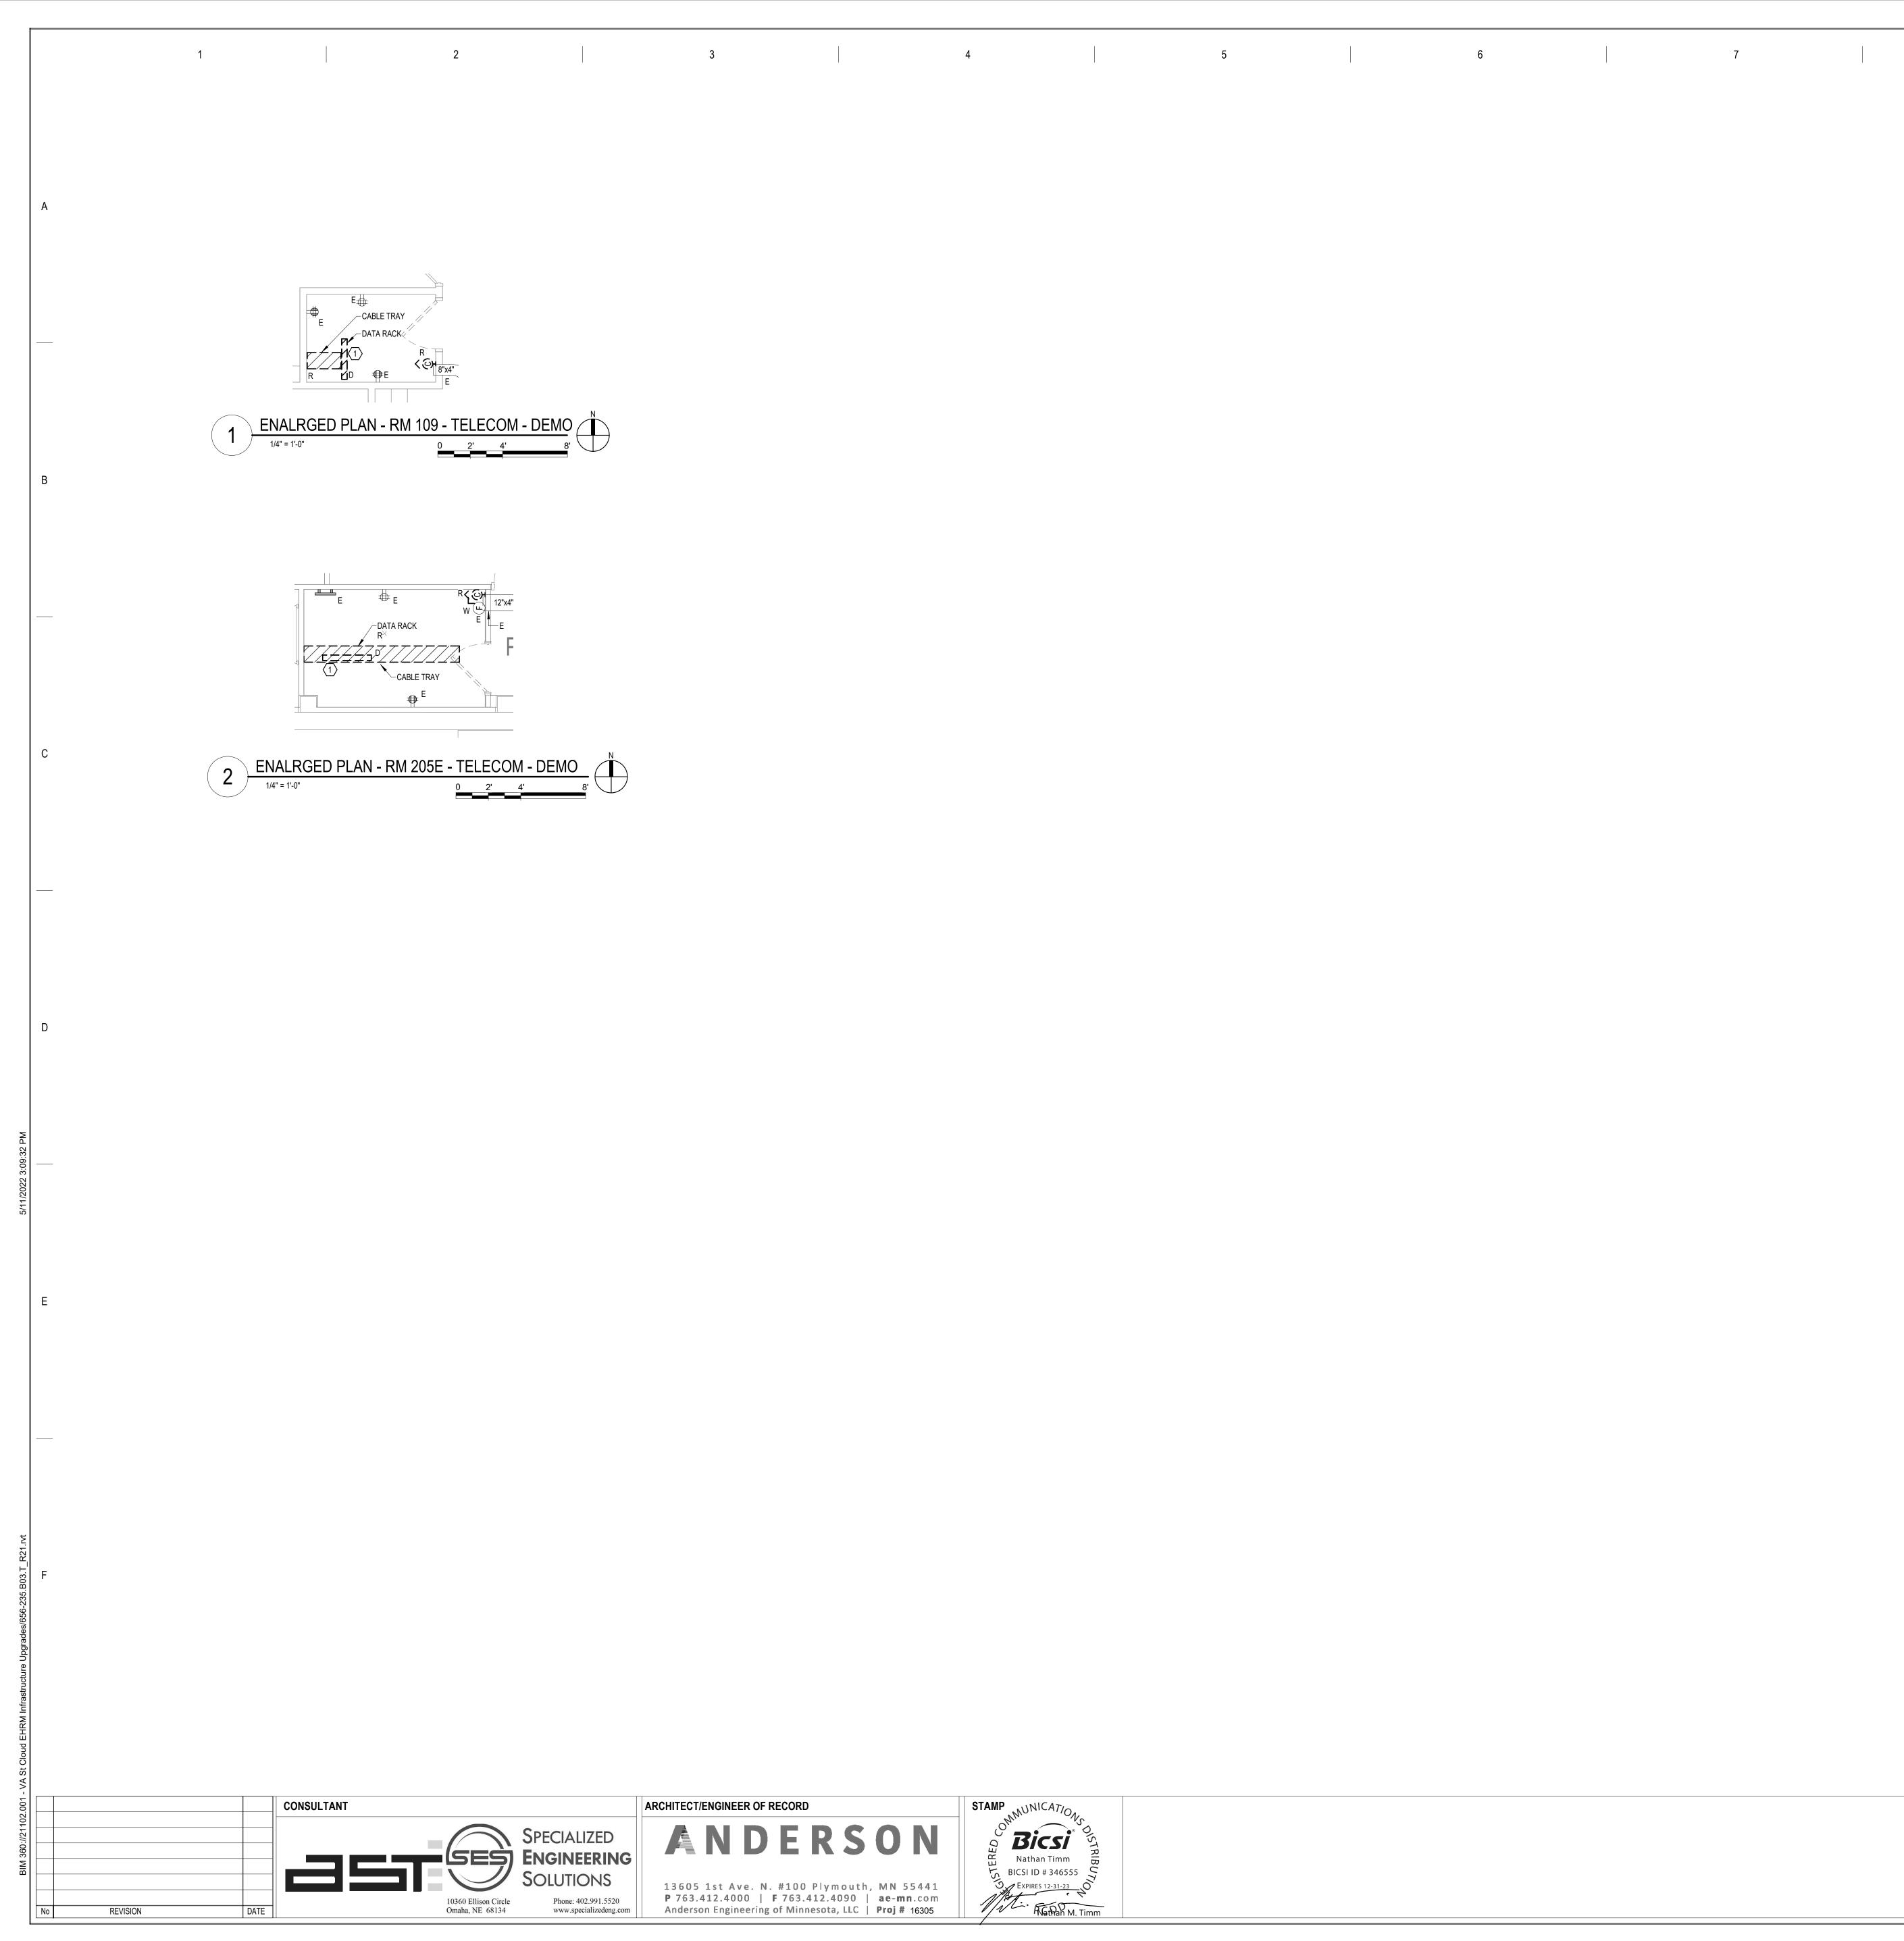



8	9		
		GENERAL NOTES: A. REFER TO GENERAL DEMOLI	TION NOTES ON SF
		SHEET NOTES:	CIATED OUTLETS ENT LOCATED WIT OR APPROXIMATE (
		CABLING NOTE:	
		CABLING NOTES: A. THE EXISTING CABLE COUNT RELOCATION COUNT ARE TH CABLE COUNT ARE THE CAB PROJECT.	E NEW OR RELOC
		1. <u>ROOM 109</u> EXISTING CABLE COUNT DATA (CAT6): 0 DATA (CAT5e): 185 DATA (CAT5): 0 DATA (CAT3): 0	2. <u>ROOM 205E</u> EXISTING CAI DATA (CAT6): DATA (CAT5e DATA (CAT5): DATA (CAT3):
		CABLE RELOCATION COUNT DATA (CAT6): 0 DATA (CAT5e): 0 DATA (CAT5): 0 DATA (CAT3): 0	CABLE RELO DATA (CAT6): DATA (CAT5e DATA (CAT5): DATA (CAT5):

DRAWING TITLE ENLARGED PLANS - TELECOMMUNICATIONS - DEMO	EHRM INFRASTRUCTURE UPGRADES		CTURE	DATE: 03/30/2022 PLOT SCALE PROJECT NO. 656-21-235	
	BUILDING No	CHECKED BY	DRAWN SSK	drawing no. 3-TN300	
	LOCATION VA MEDICAL C ST.CLOUD, MN		FULLY	DWG. OF	

SHEET T000 FOR ADDITIONAL DEMOLITION SCOPE.

10

ID RACK SHALL BE INCLUDED WITHIN THE SCOPE OF DEMOLITION. ETS SHALL BE REMOVED AND REPLACED 1 FOR 1 AND REFED WITHIN THE NEW TELECOMMUNICATIONS ROOM. REFER TO ATE QUANTITIES. REFER TO NEW WORK PLANS FOR SERVING IEW CABLING ROUTES.

LES CURRENTLY PRESENT IN THE SPACE. THE CABLE LOCATED CABLES TO BE FED FROM THE SPACE. THE FINAL BE PRESENT IN THE SPACE AT THE COMPLETION OF THE

CABLE COUNT F6): 0 5e): 192 [5): 0 [3): 0 LOCATION COUNT 6): 0 [5e): 0 T5): 0 [3]: 0 EXISTING CABLE TO REMAINEXISTING CABLE TO REMAINDATA (CAT6): 0DATA (CAT6): 0DATA (CAT5e): 0DATA (CAT5e): 0 DATA (CAT5): 0

DATA (CAT3): 0 FINAL CABLE COUNT DATA (CAT6): 0 DATA (CAT5e): 0 DATA (CAT5): 0 DATA (CAT3): 0


DATA (CAT6): 0 DATA (CAT5e): 0 DATA (CAT5): 0


DATA (CAT3): 0

DATA (CAT5): 0 DATA (CAT3): 0

FINAL CABLE COUNT DATA (CAT6): 0 DATA (CAT5e): 0




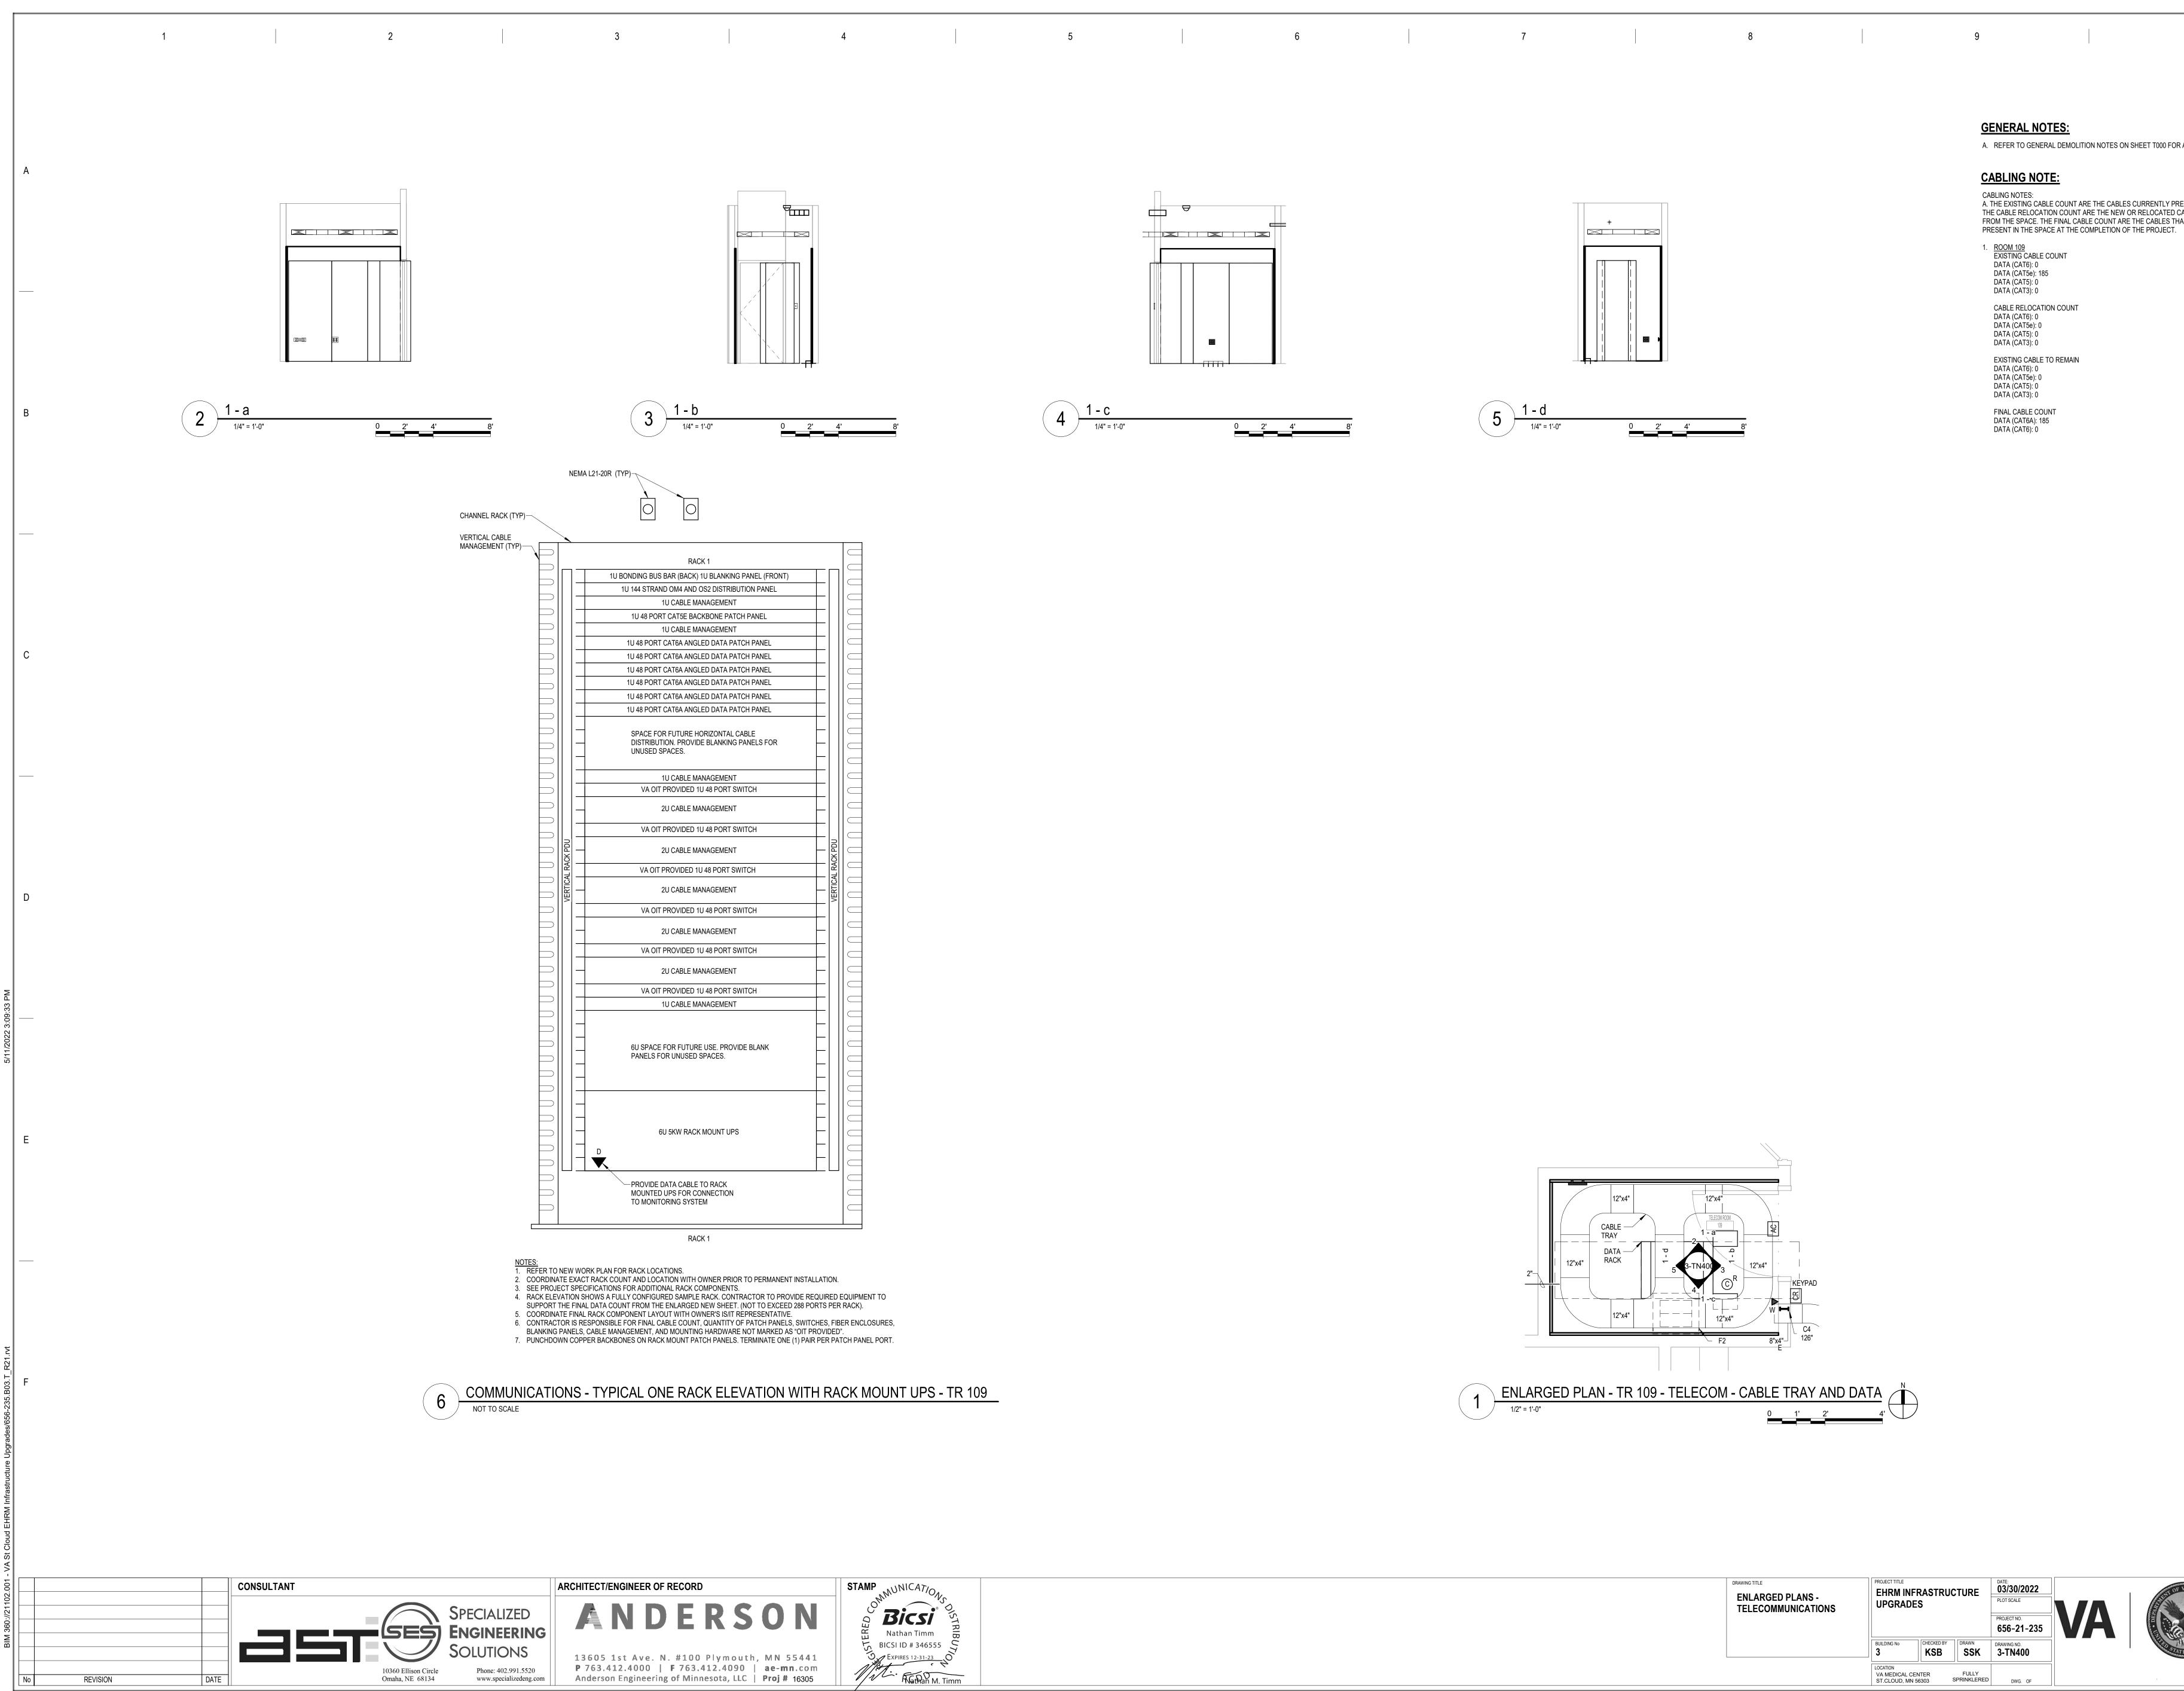


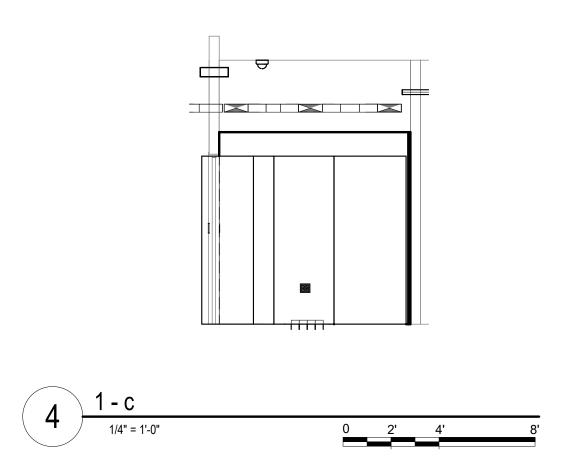

			1
RACK 1			
AR (BACK) 1U BLANKING PANEL (FRONT)	Γ	\square	
OM4 AND OS2 DISTRIBUTION PANEL	—		
J CABLE MANAGEMENT			
CAT5E BACKBONE PATCH PANEL			\square
J CABLE MANAGEMENT			\square
AT6A ANGLED DATA PATCH PANEL			\square
AT6A ANGLED DATA PATCH PANEL			\square
AT6A ANGLED DATA PATCH PANEL			
AT6A ANGLED DATA PATCH PANEL			
AT6A ANGLED DATA PATCH PANEL			
AT6A ANGLED DATA PATCH PANEL			
DN. PROVIDE BLANKING PANELS FOR ACES.			\square
			\square
J CABLE MANAGEMENT			\square
ROVIDED 1U 48 PORT SWITCH			\square
J CABLE MANAGEMENT			
J CADLE MANAGEMENT			_
ROVIDED 1U 48 PORT SWITCH	\square		
	\square	В	
J CABLE MANAGEMENT	F	КР	
ROVIDED 1U 48 PORT SWITCH	\square	L RA	
	\square	RTICAL RACK PDI	\square
J CABLE MANAGEMENT		VER.	\square
ROVIDED 1U 48 PORT SWITCH			\square
			\square
J CABLE MANAGEMENT			
ROVIDED 1U 48 PORT SWITCH			\square
J CABLE MANAGEMENT			
ROVIDED 1U 48 PORT SWITCH			
J CABLE MANAGEMENT			
			\square
			\square
OR FUTURE USE. PROVIDE BLANK			\square
R UNUSED SPACES.			\square
			_
5KW RACK MOUNT UPS			
			\square
	Γ		
			\square
ATA CABLE TO RACK IPS FOR CONNECTION			
RING SYSTEM			\square

DRAWING TITLE ENLARGED PLANS - TELECOMMUNICATIONS	PROJECT TITLE EHRM INFRASTRUCTURE UPGRADES			DATE: 03/30/2022 PLOT SCALE PROJECT NO. 656-21-235	VA
	BUILDING No	CHECKED BY	DRAWN SSK	drawing no. 3-TN400	
	LOCATION VA MEDICAL CEI ST.CLOUD, MN 5		FULLY SPRINKLERED	DWG. OF	

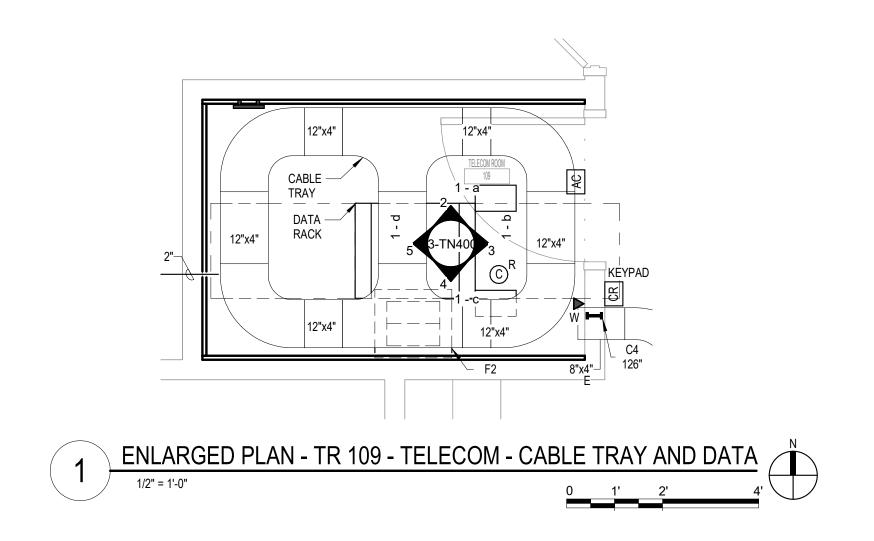

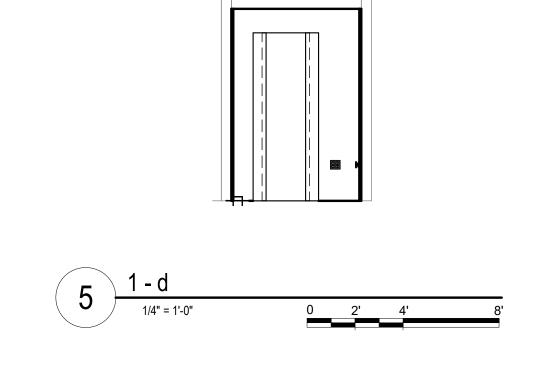

+

A. REFER TO GENERAL DEMOLITION NOTES ON SHEET T000 FOR ADDITIONAL DEMOLITION SCOPE. CABLING NOTE:

CABLING NOTES: A. THE EXISTING CABLE COUNT ARE THE CABLES CURRENTLY PRESENT IN THE SPACE. THE CABLE RELOCATION COUNT ARE THE NEW OR RELOCATED CABLES TO BE FED FROM THE SPACE. THE FINAL CABLE COUNT ARE THE CABLES THAT WILL BE PRESENT IN THE SPACE AT THE COMPLETION OF THE PROJECT.
1. ROOM 109 EXISTING CABLE COUNT DATA (CAT6): 0 DATA (CAT5e): 185 DATA (CAT5): 0 DATA (CAT3): 0
CABLE RELOCATION COUNT DATA (CAT6): 0 DATA (CAT5e): 0 DATA (CAT5): 0 DATA (CAT3): 0


GENERAL NOTES:


10

EXISTING CABLE TO REMAIN DATA (CAT6): 0 DATA (CAT5e): 0 DATA (CAT5): 0 DATA (CAT3): 0

FINAL CABLE COUNT DATA (CAT6A): 185 DATA (CAT6): 0



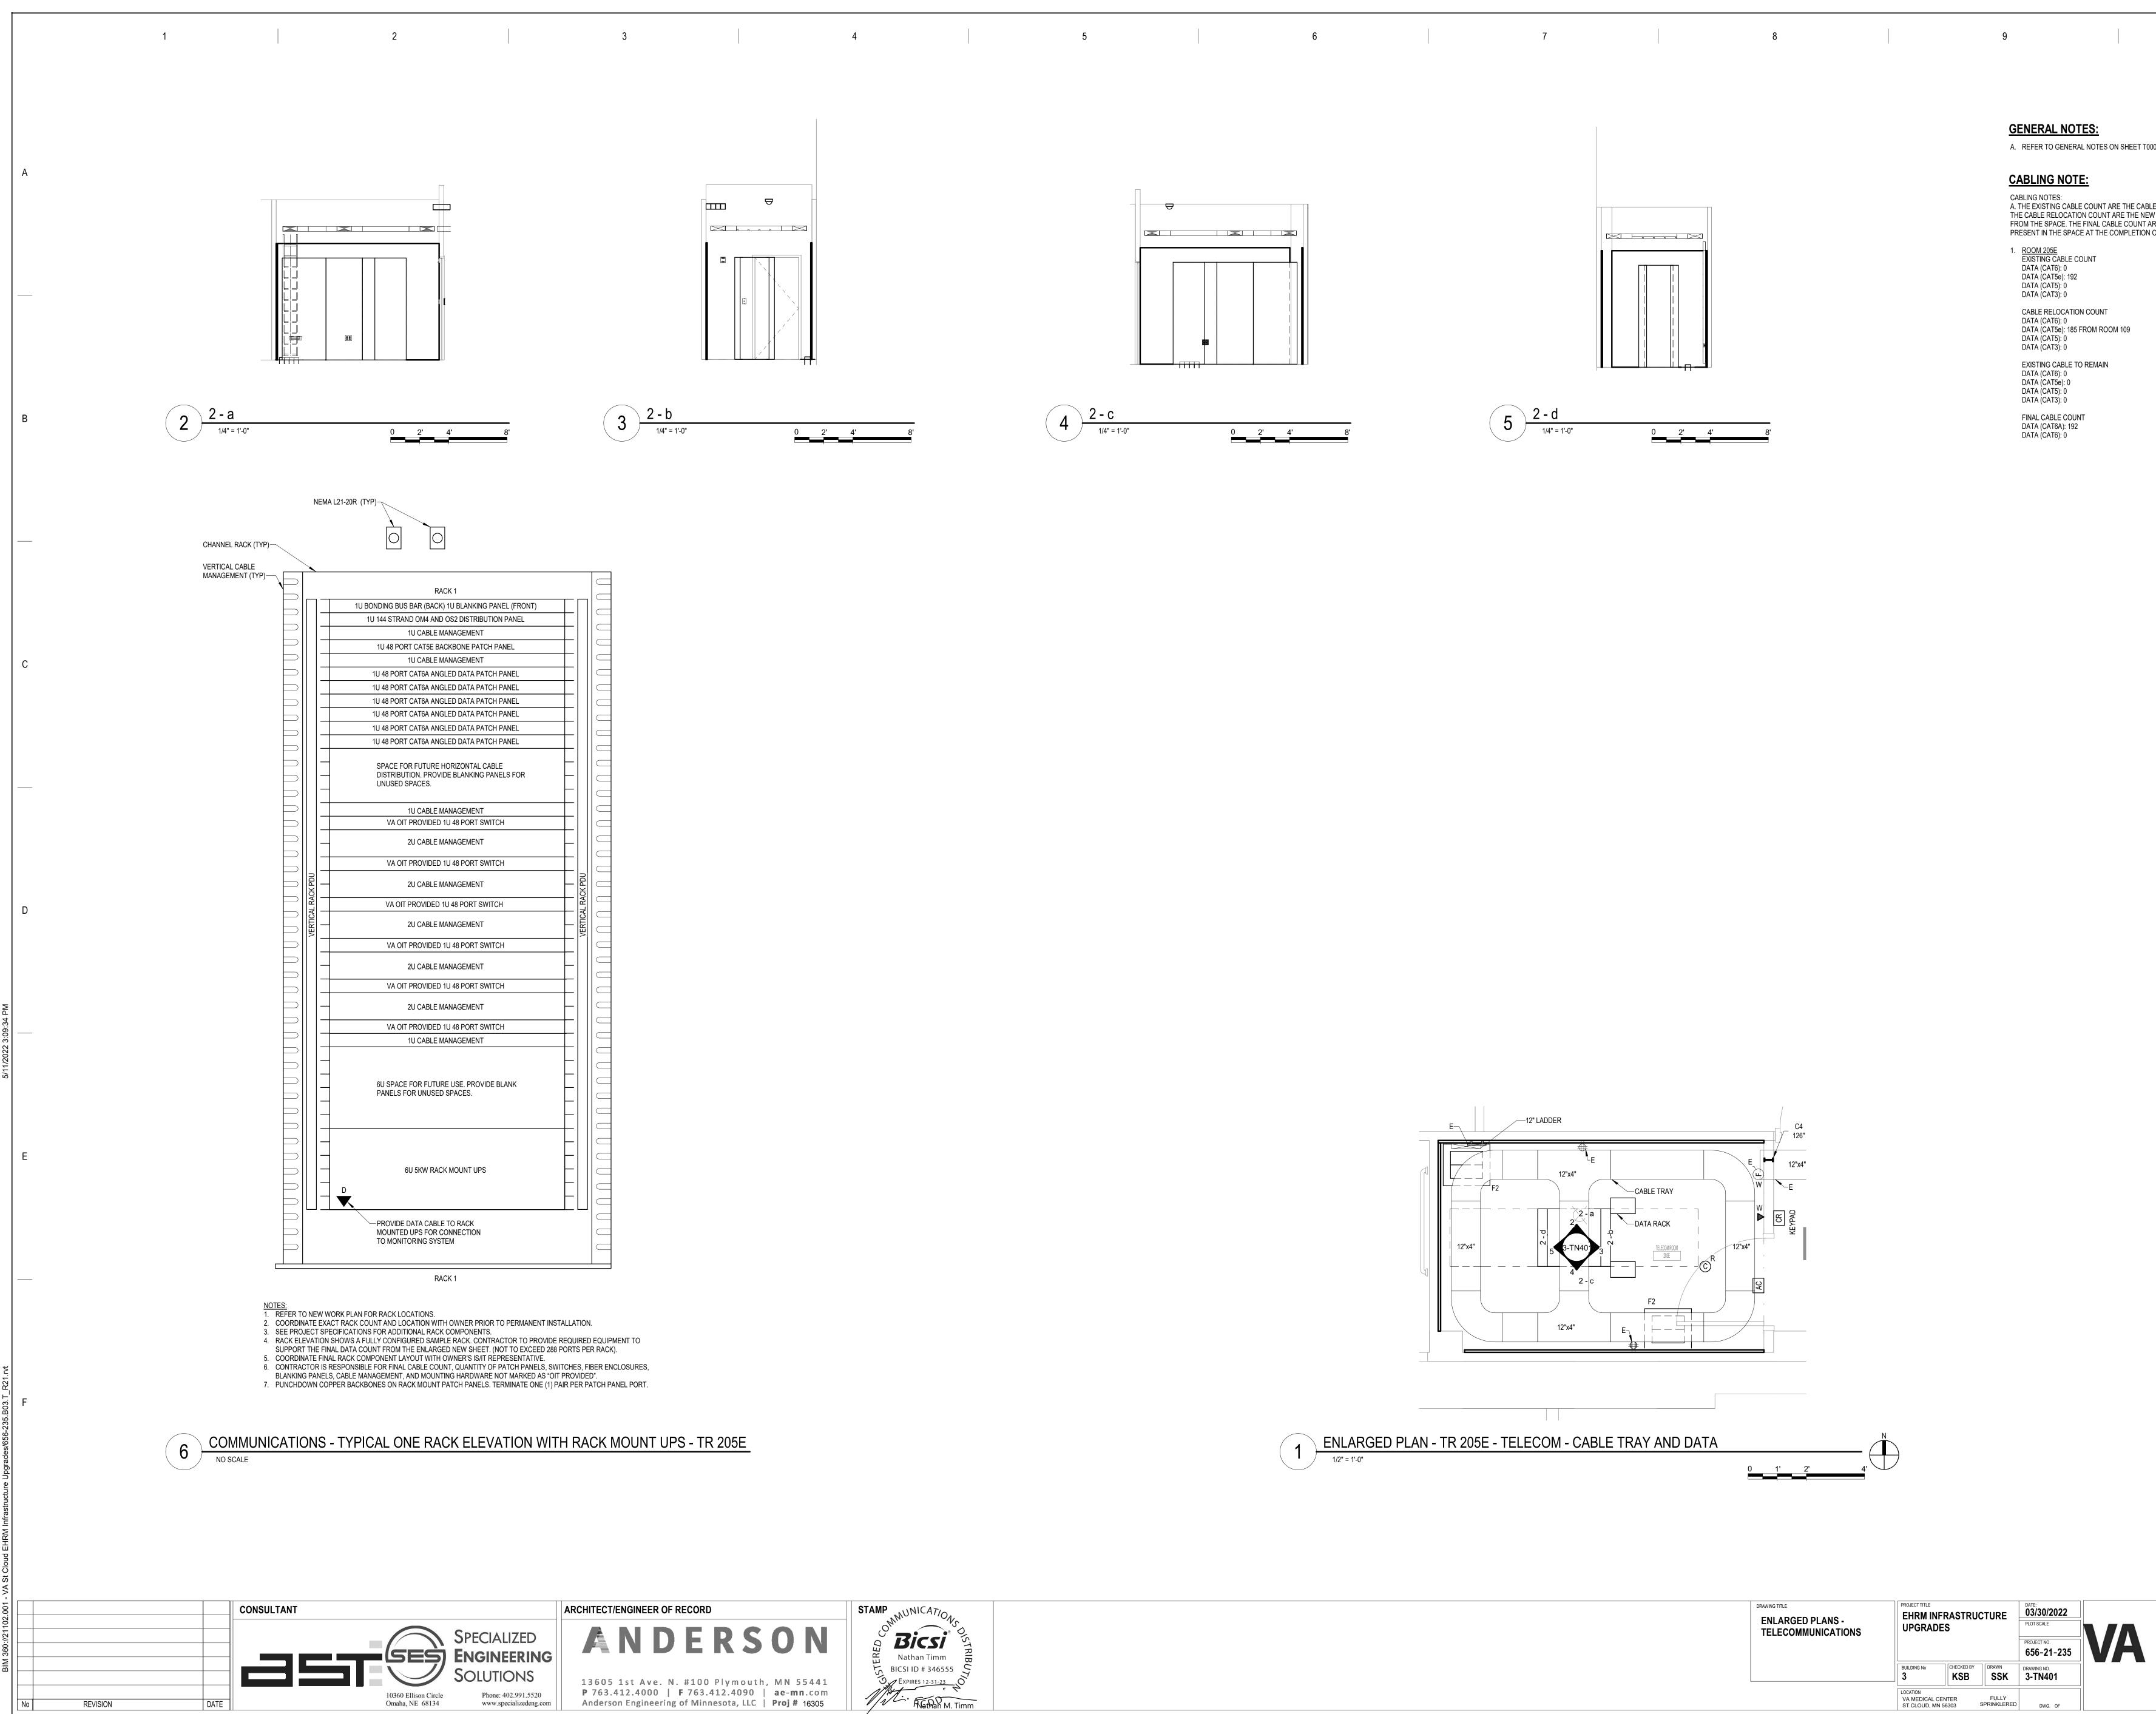


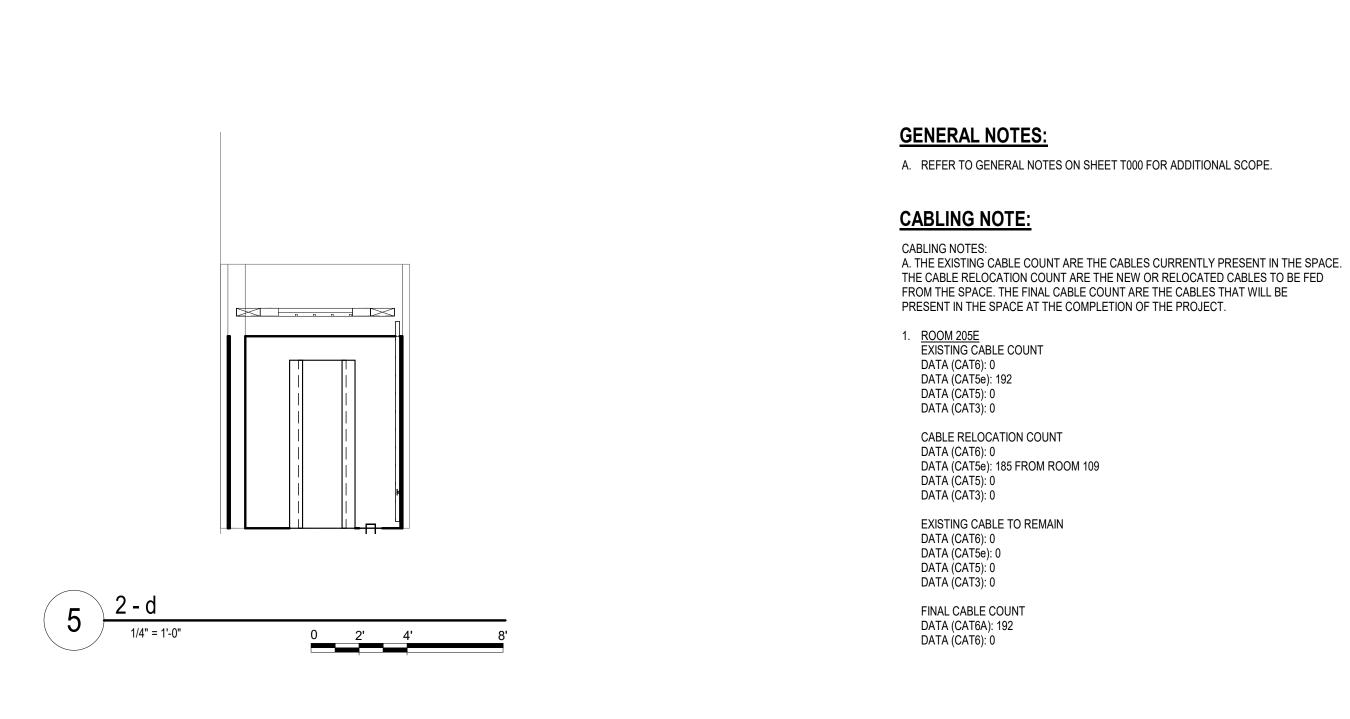

DRAWING TITLE ENLARGED PLANS - TELECOMMUNICATIONS		PROJECT TITLE EHRM INFRASTRUCTURE UPGRADES DATE: 03/30/2022 PLOT SCALE PROJECT NO. 6566-21-235			
	BUILDING No	CHECKED BY	DRAWN	DRAWING NO.	
	3	KSB	SSK	3-TN401	
	LOCATION VA MEDICAL CEN ST.CLOUD, MN 5		FULLY SPRINKLERED	DWG. OF	




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656-21-235

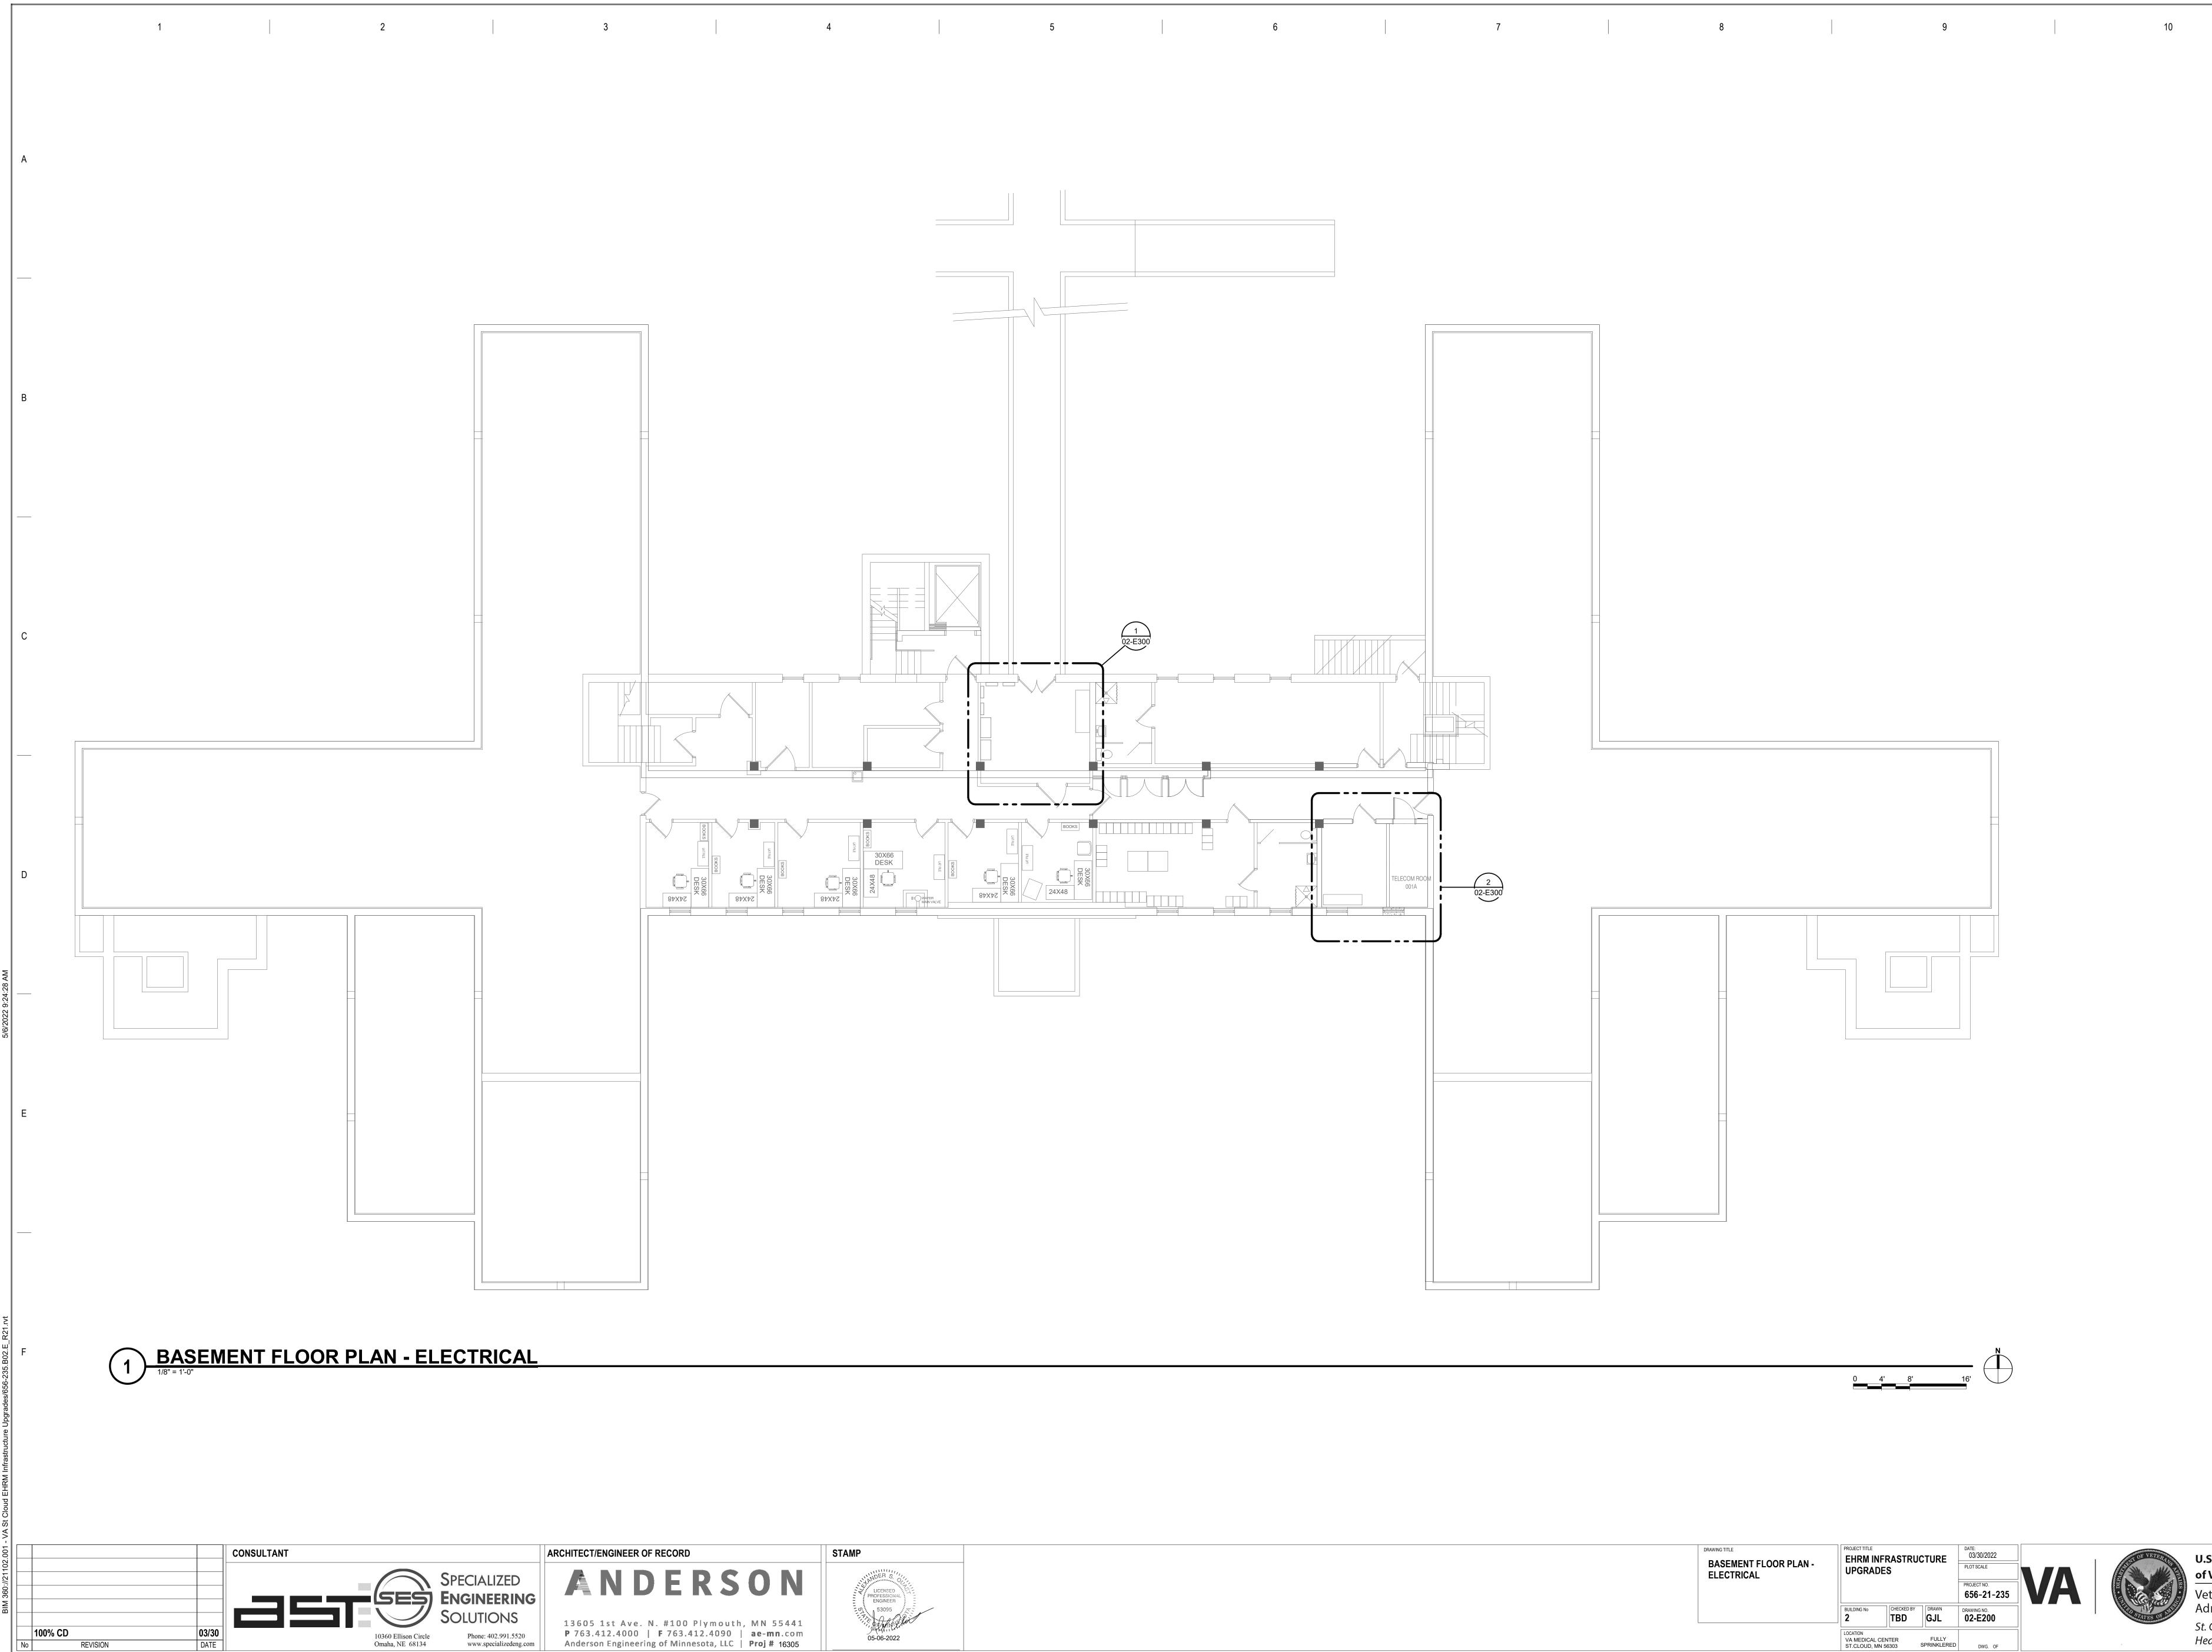




KEYNOTES: # . PROVIDE ELECTRICAL CONNECTION TO CONDENSING UNIT, AS REQUIRED. COORDINATE FINAL LOCATION AND CONNECTION REQUIREMENTS WITH MECHANICAL.
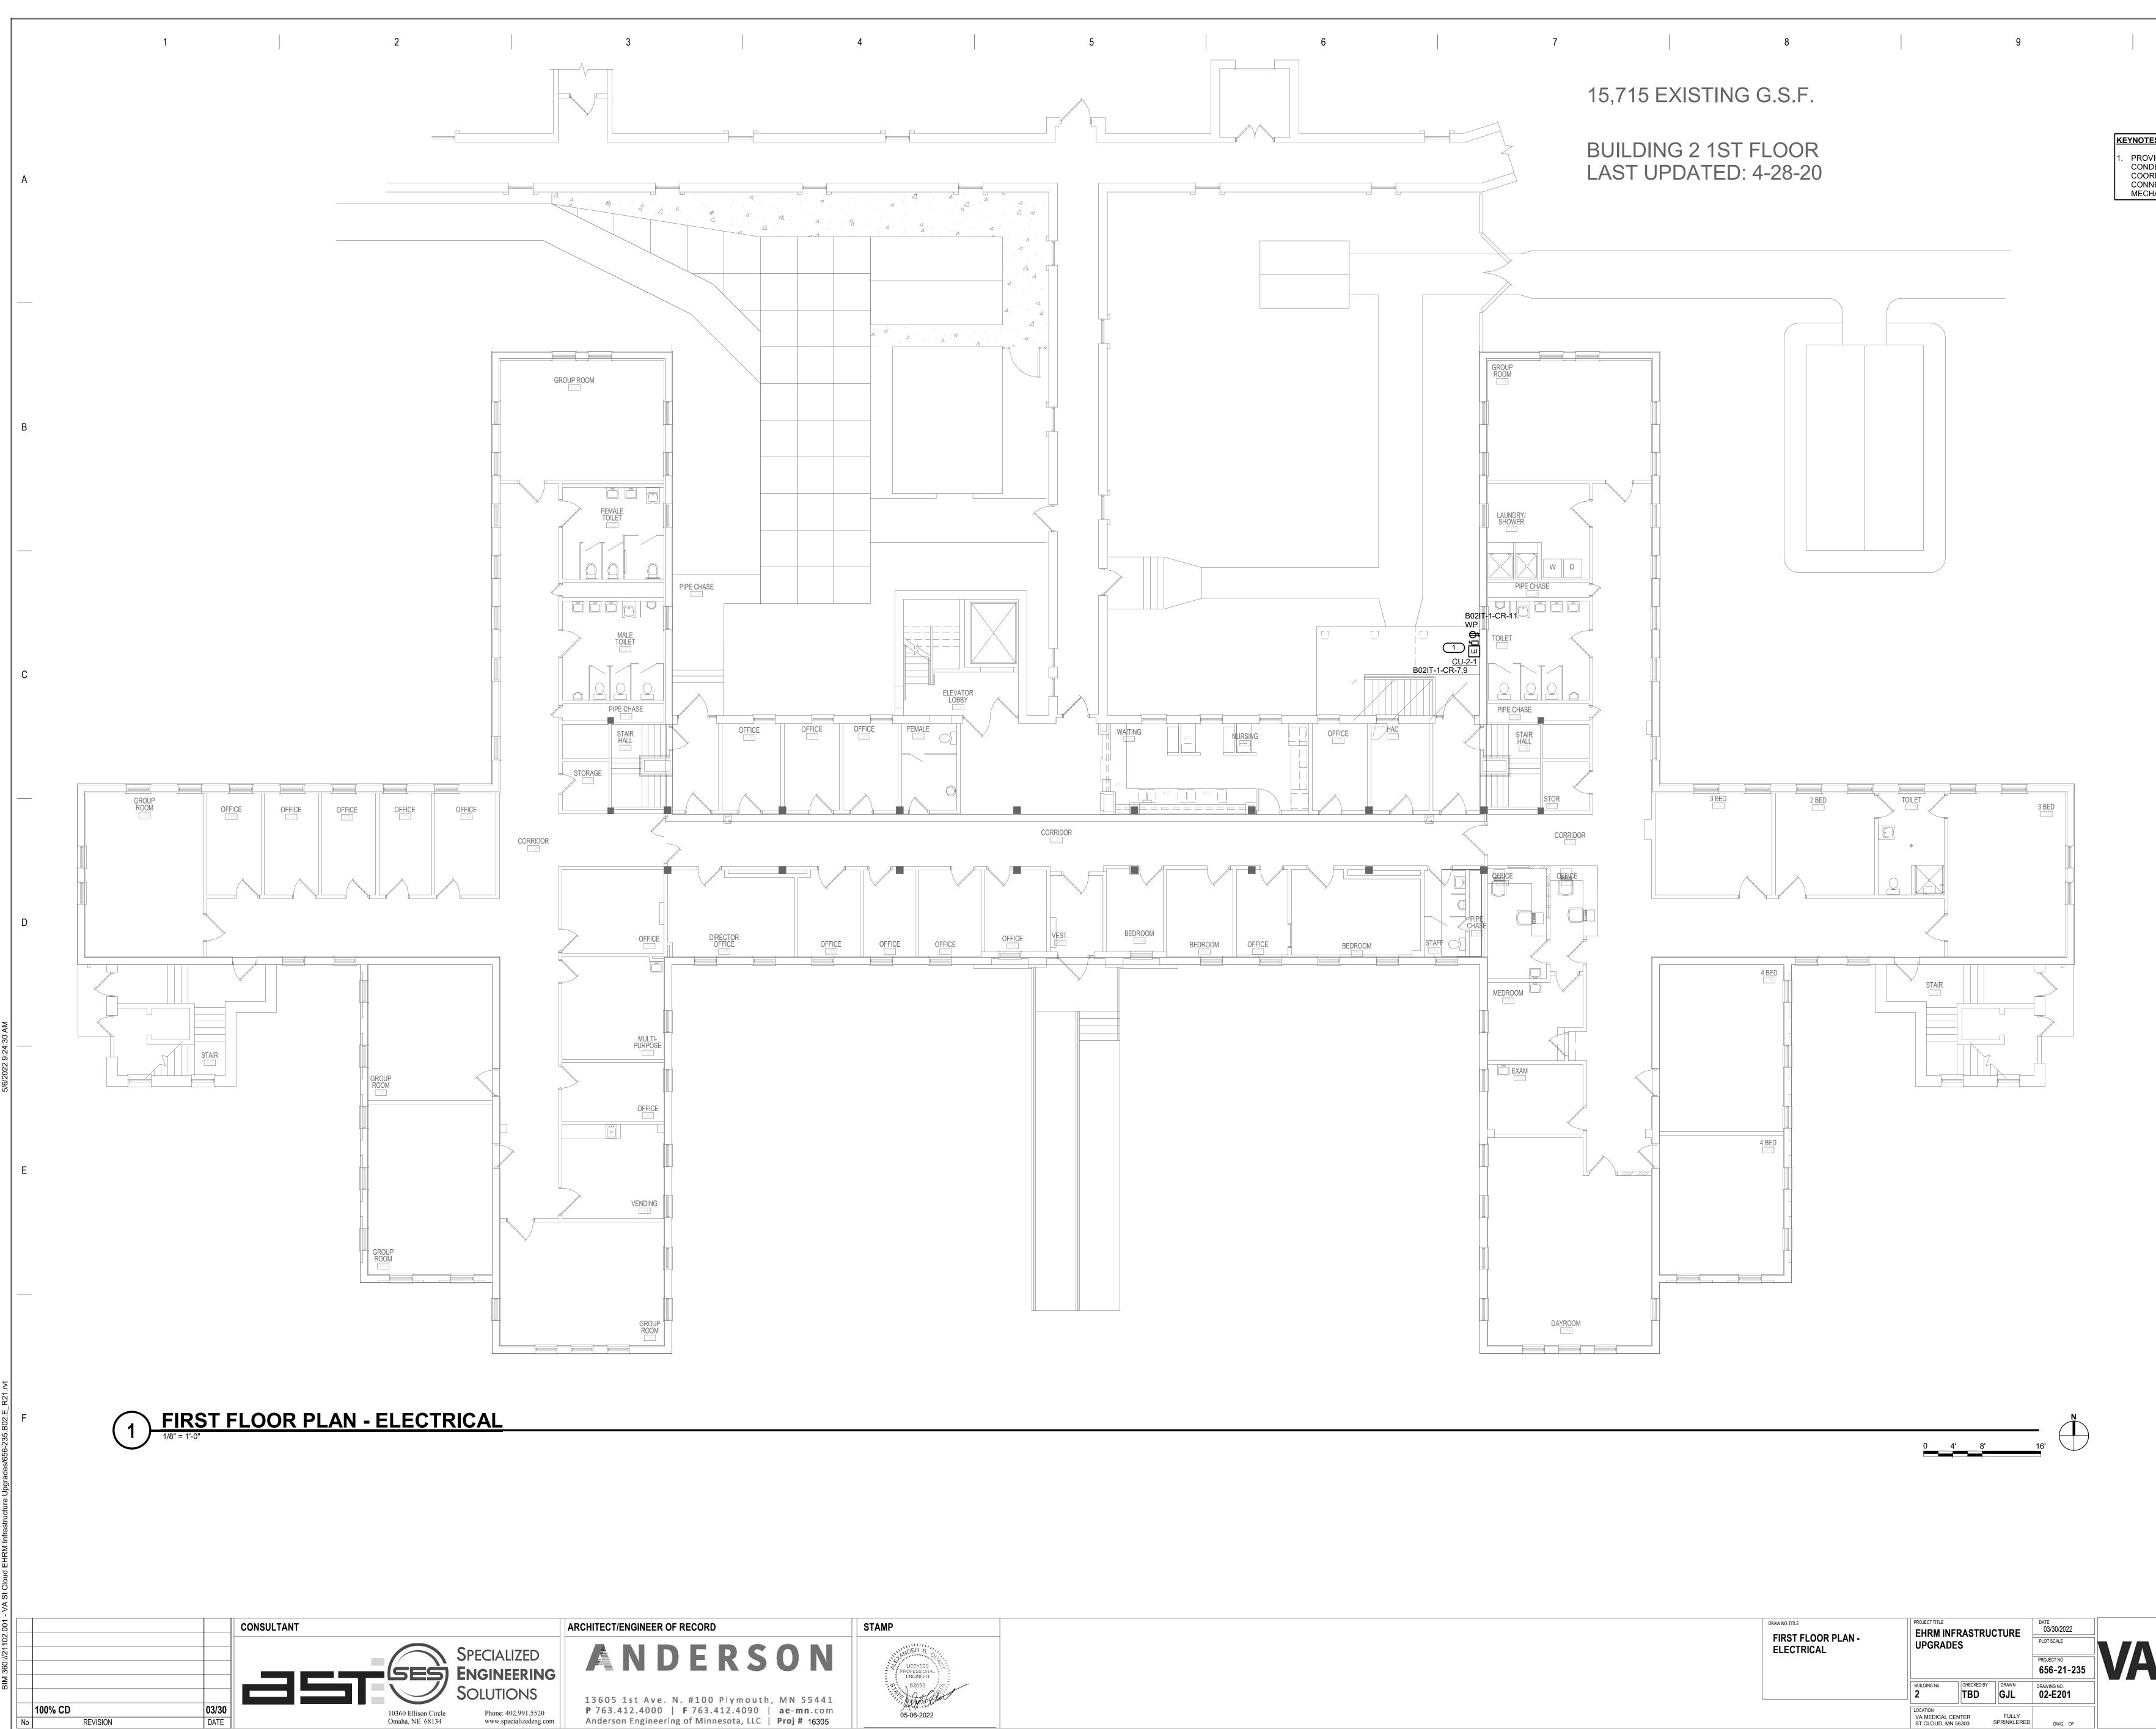
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			SHEET NOTES: 1. REFER TO TE LAYOUT AND 2. REFER TO SH & ONE-LINE O KEYNOTES: #
			 INDOOR UNIT UNIT. COORD M.C. CONNECT SM EXISTING SLC COORDINATE RECEPTACLE CONTRACTOF TO PANEL FO PROVIDE EAT PHASE,4-WIR RACK TOWEF
			 5. PROVIDE APC WITH L21-20P ZERO U, 5.7 K OUTLETS. PR PER MANUFA 6. VERIFY EXAC AND REARRA CONSECUTIV

DRAWING TITLE ELECTRICAL ENLARGED PLANS	PROJECT TITLE EHRM IN UPGRAD	FRASTRU(ES	CTURE	DATE: 03/30/2022 PLOT SCALE PROJECT NO.	
	BUILDING No 2	CHECKED BY TBD	DRAWN GJL	656-21-235 DRAWING NO. 02-E300	
	LOCATION VA MEDICAL O ST.CLOUD, MI		FULLY SPRINKLERED	DWG. OF	

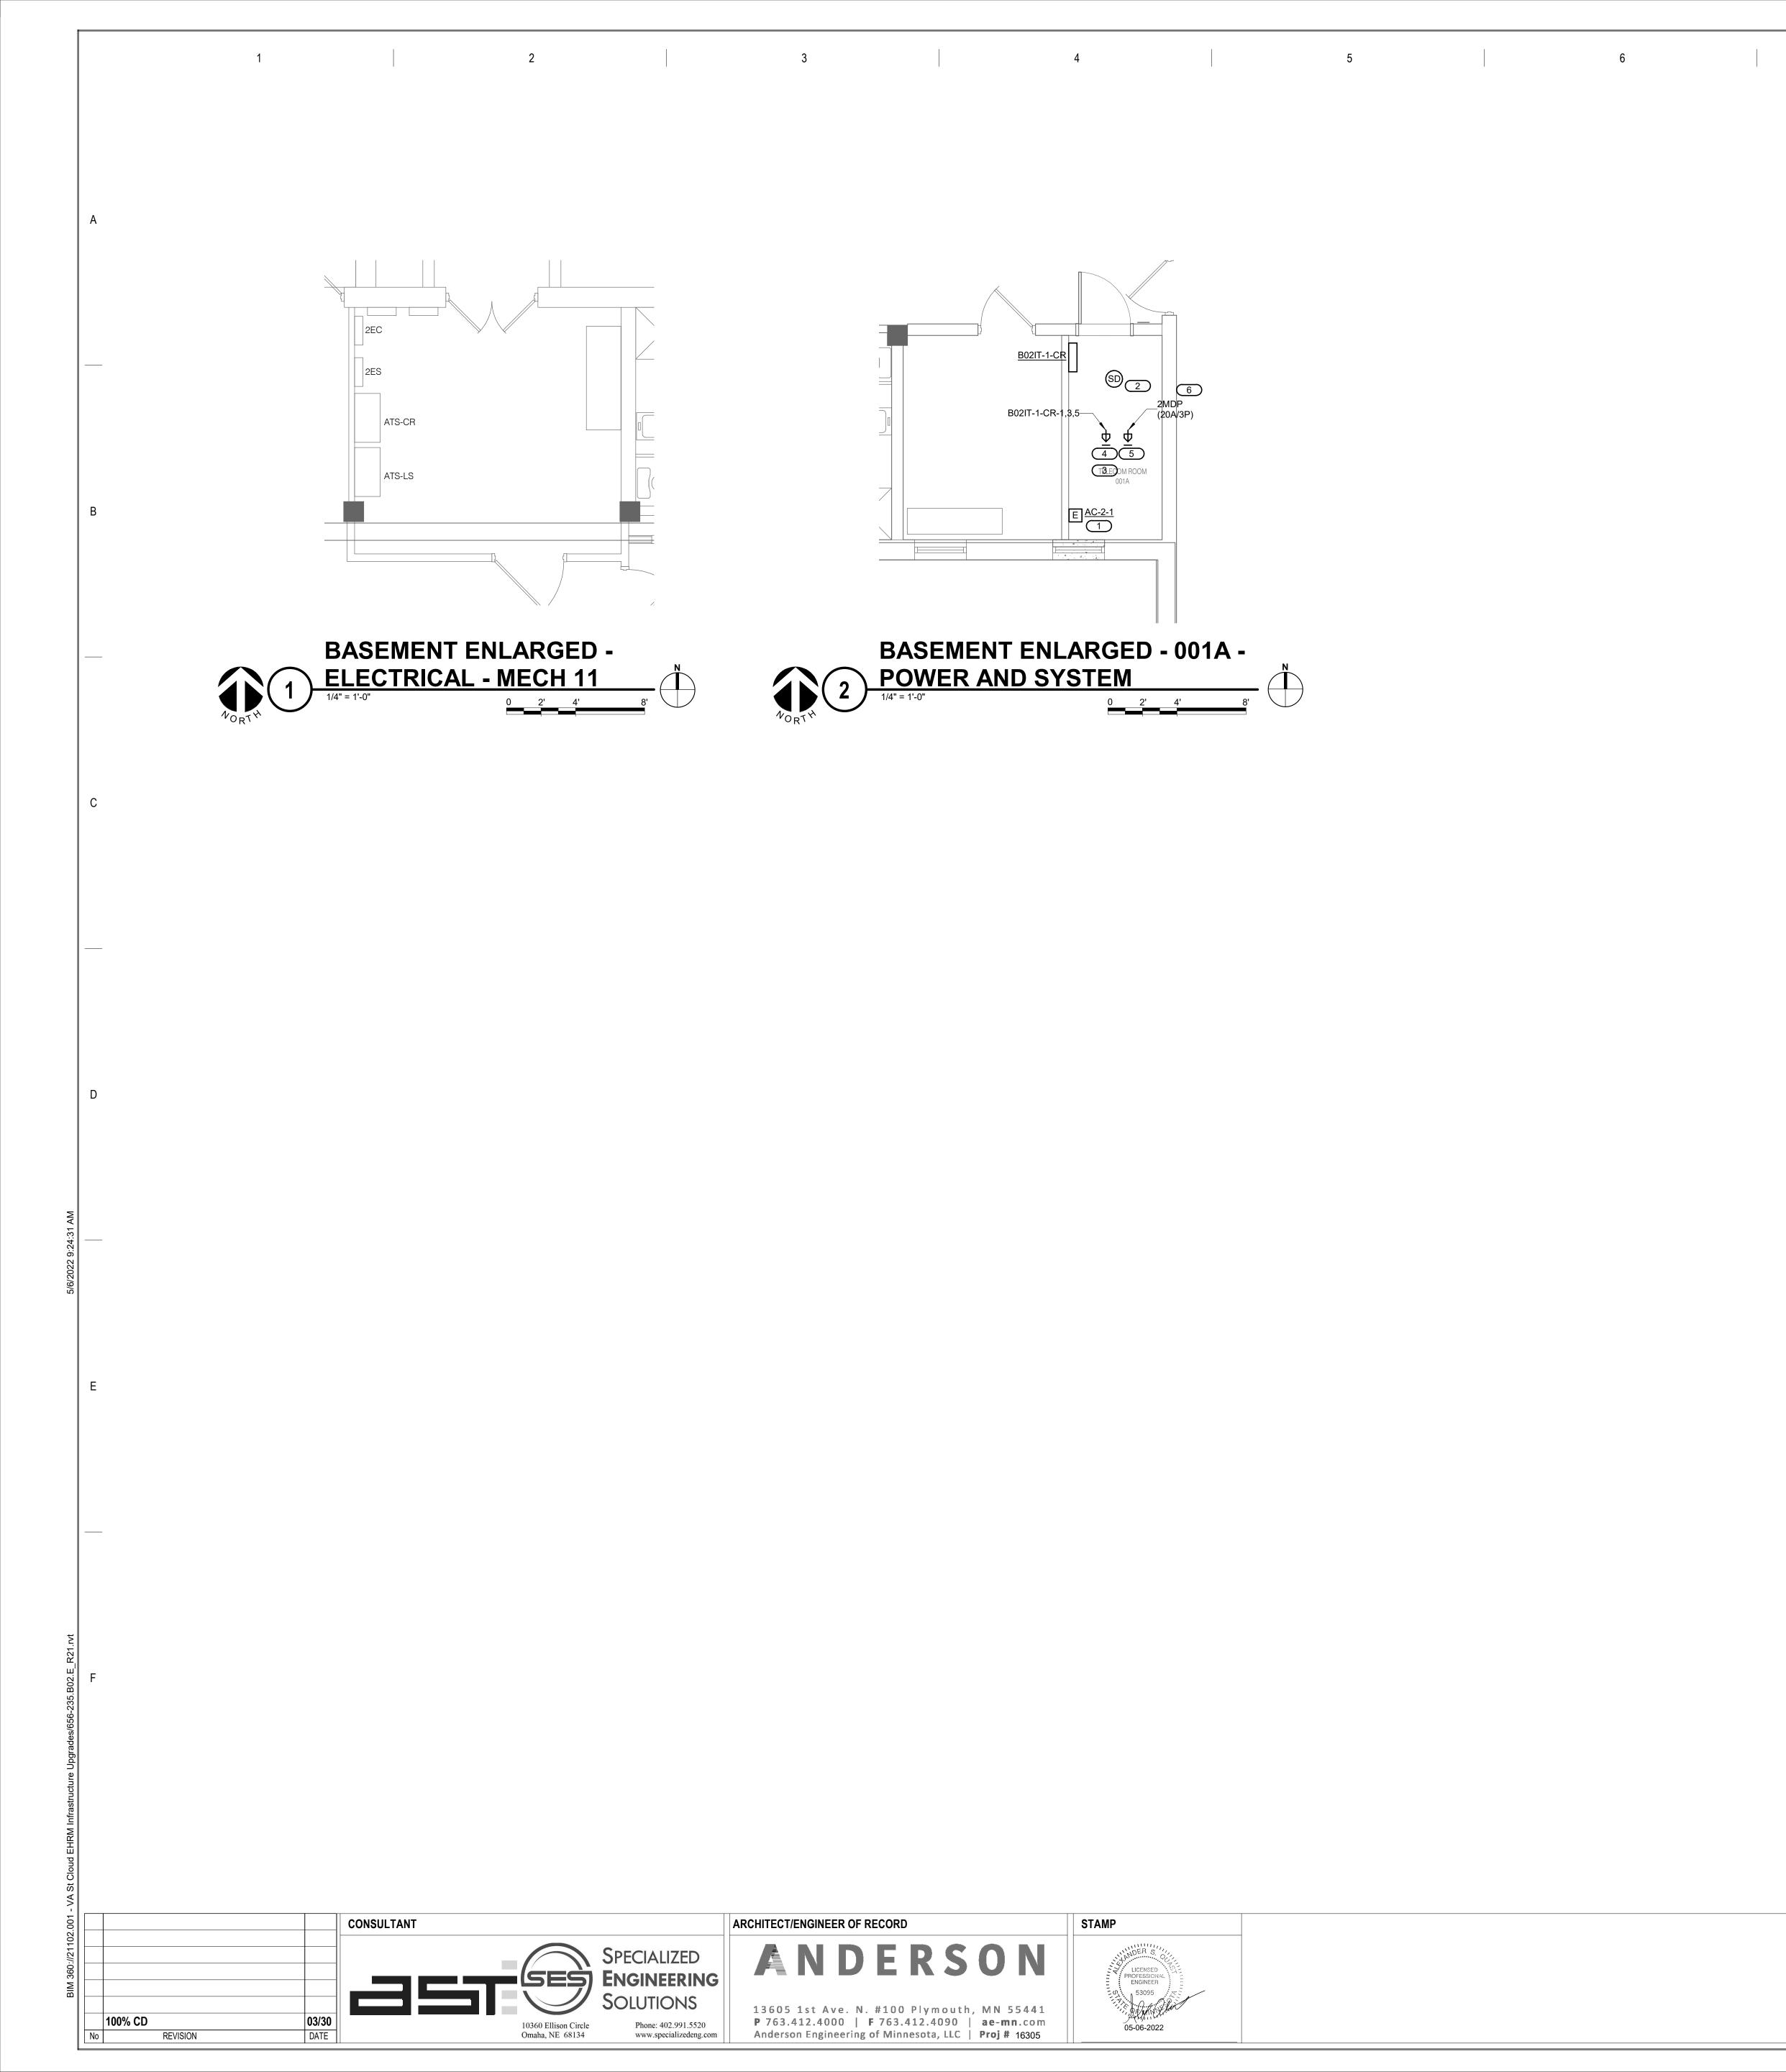
R TO TECHNOLOGY PLANS FOR IT ROOM JT AND RACK LAYOUT/DETAILS. R TO SHEET 0-GE400 DETAIL FOR LAYOUT E-LINE OF RACK.

R UNIT TO BE POWERED BY OUTDOOR COORDINATE EXACT LOCATION WITH ECT SMOKE DETECTOR TO NEAREST ING SLC. DINATE FINAL LOCATION OF

TING SLC. RDINATE FINAL LOCATION OF EPTACLE L21-20R WITH TELECOM TRACTOR. PROVIDE 3/4"C-4#12, 1#12 GND ANEL FOR EACH RECEPTACLE. VIDE EATON BLADEUPS, 5KW, 120/208V, 3-SE,4-WIRE RACK MOUNTED UPS FOR EACH < TOWER. VIDE APC#AP8861 RPDU RACK PDU 2G


VIDE APC#AP8861 RPDU RACK PDU 2G L21-20P CORD. (120/208V, 3-PHASE, 20A, 0 U, 5.7 KW, 208V, (36) C13 (6) C19 (2) 5-20R ETS. PROVIDE TWO PER RACK, MOUNTED MANUFACTURER'S REQUIREMENTS. FY EXACT CIRCUIT AVAILABILITY IN PANEL REARRANGE BREAKERS TO ALLOW 3 SECUTIVE SPACES.




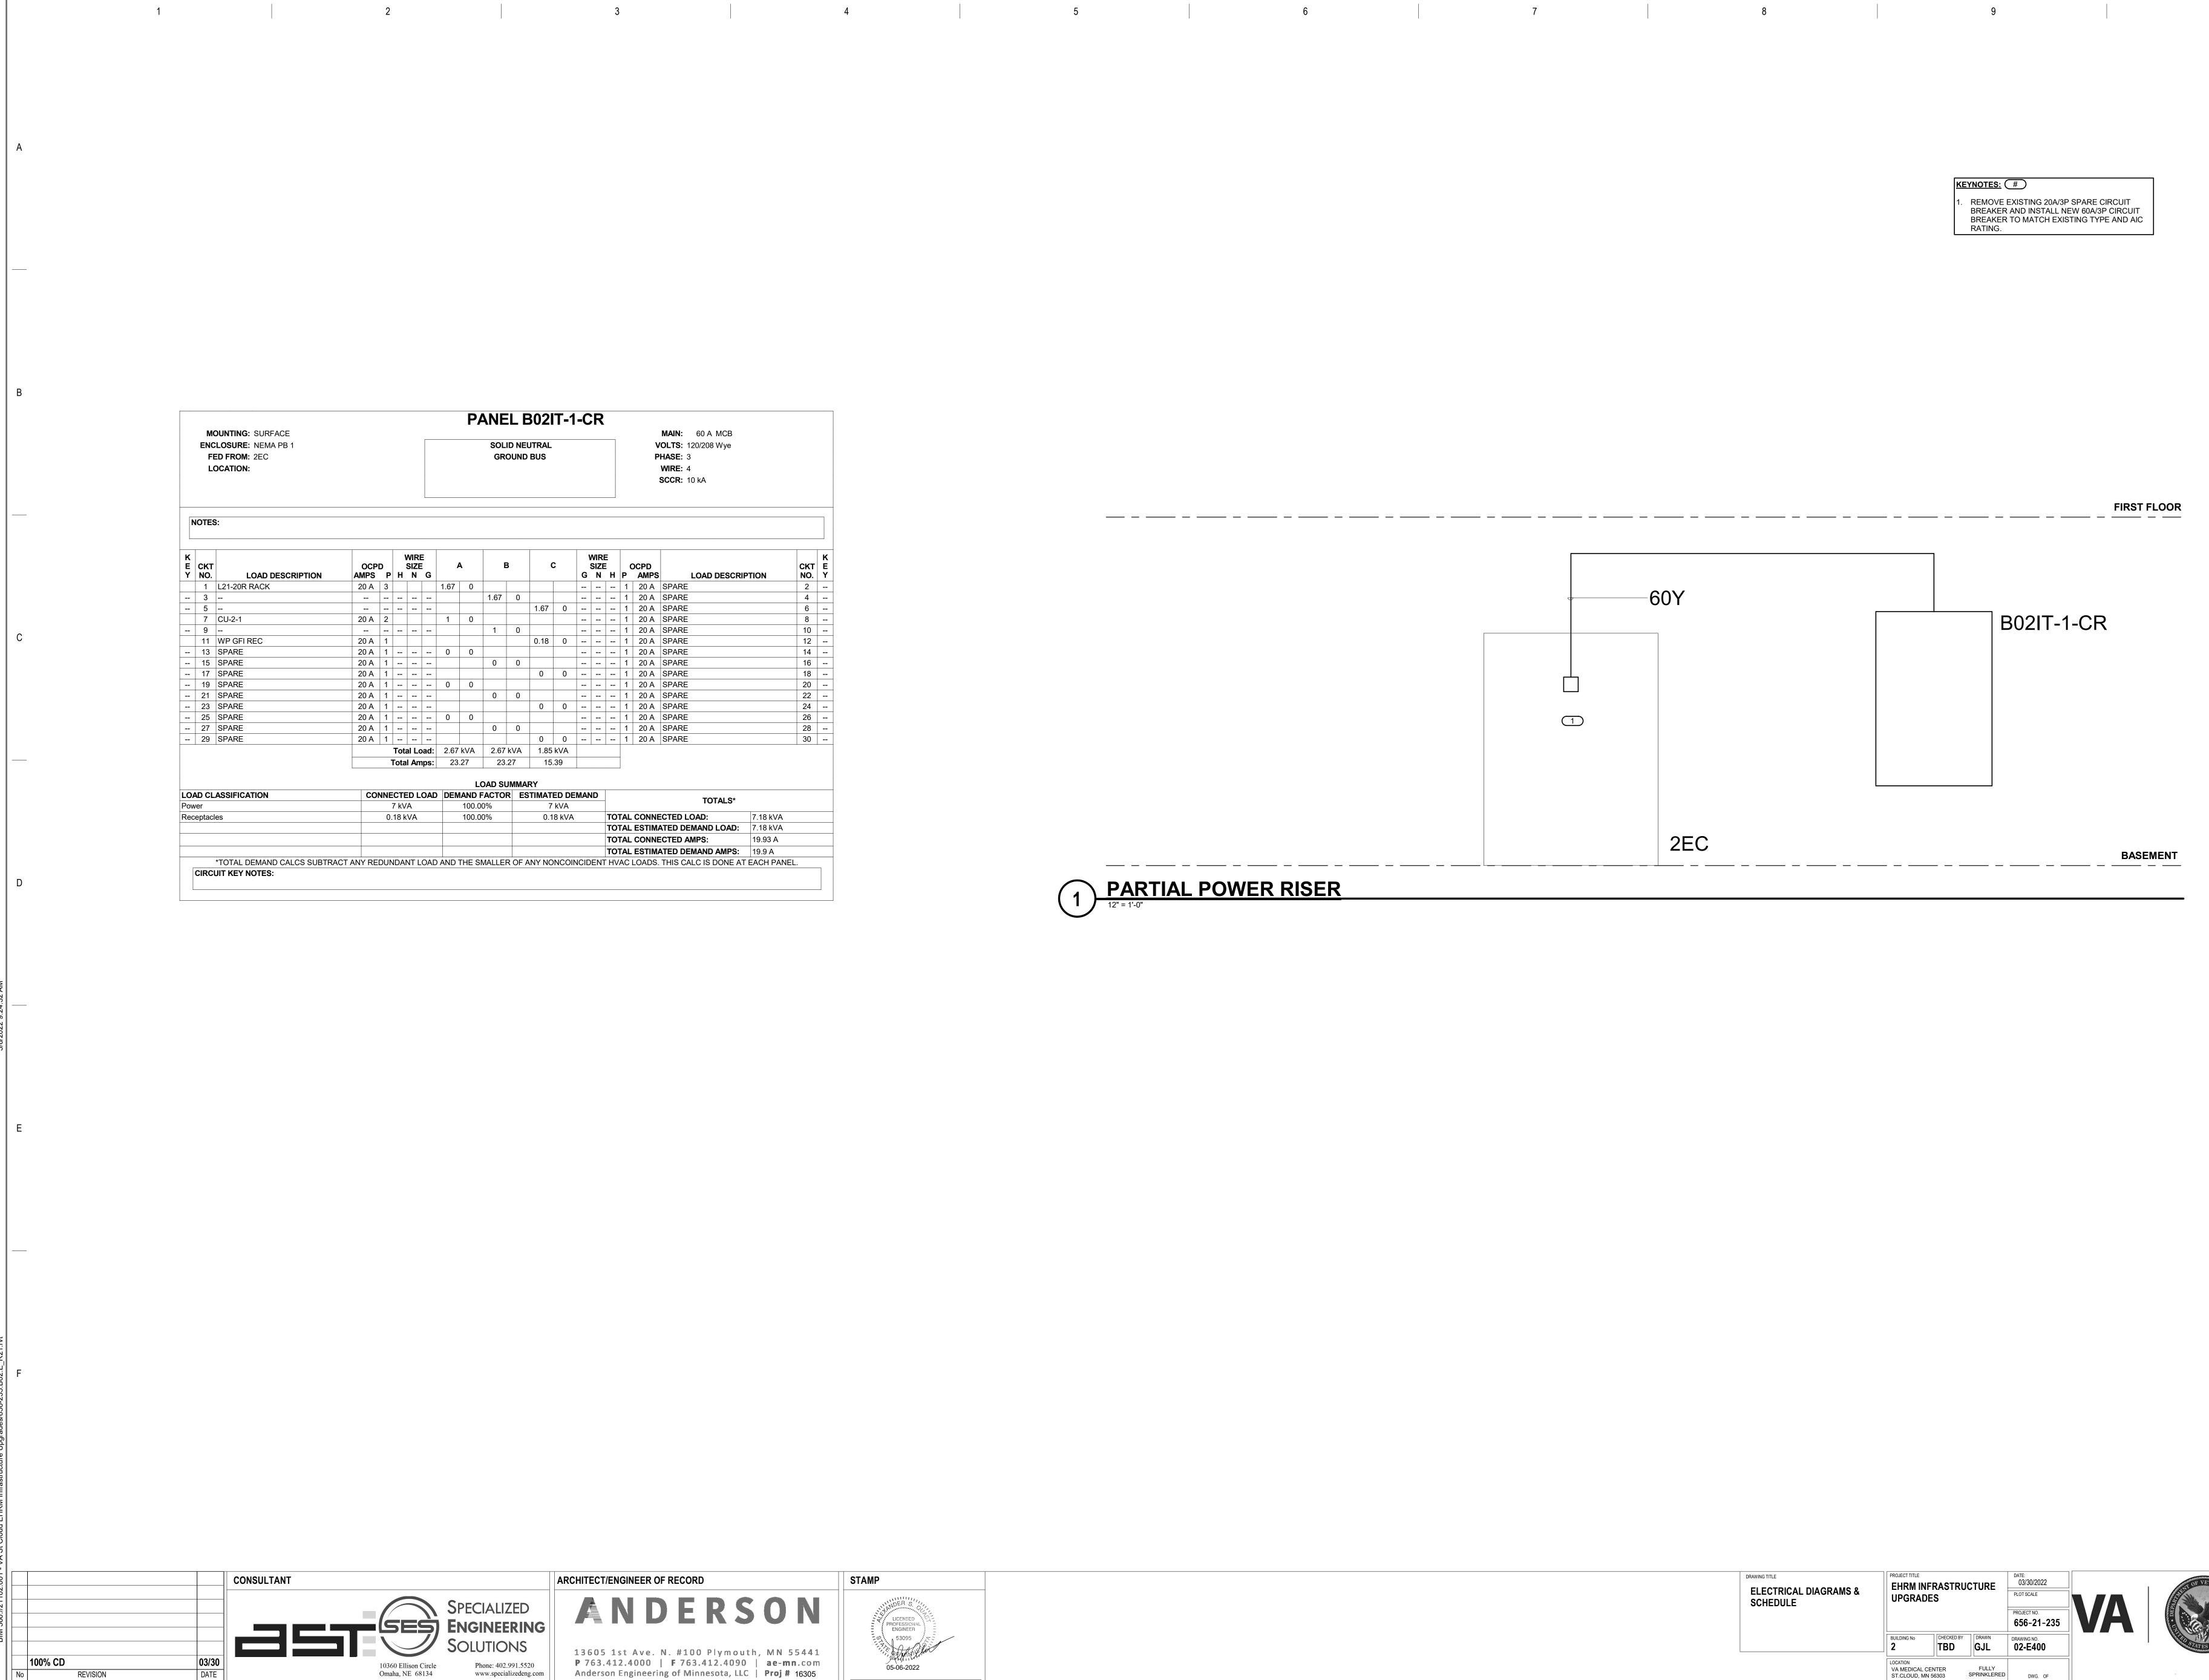

IAIN: 60 A MCB LTS: 120/208 Wye ASE: 3 IIRE: 4 CCR: 10 kA			
LOAD DESCRIP	TION	CKT NO.	K E Y
PARE		2	
PARE		4	
PARE		6	
PARE		8	
PARE		10	
PARE		12	
PARE		14	
PARE		16	
PARE		18	
PARE		20	
PARE		22	
PARE		24	
PARE		26	
PARE		28	
PARE		30	
TOTALS*			
TED LOAD:	7.18 kVA		
ED DEMAND LOAD:	7.18 kVA		
TED AMPS:	19.93 A		
ED DEMAND AMPS:	19.9 A		
HIS CALC IS DONE AT I		·	

1 PARTIAL POWER RISER

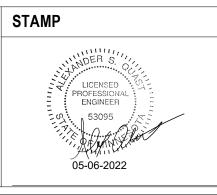

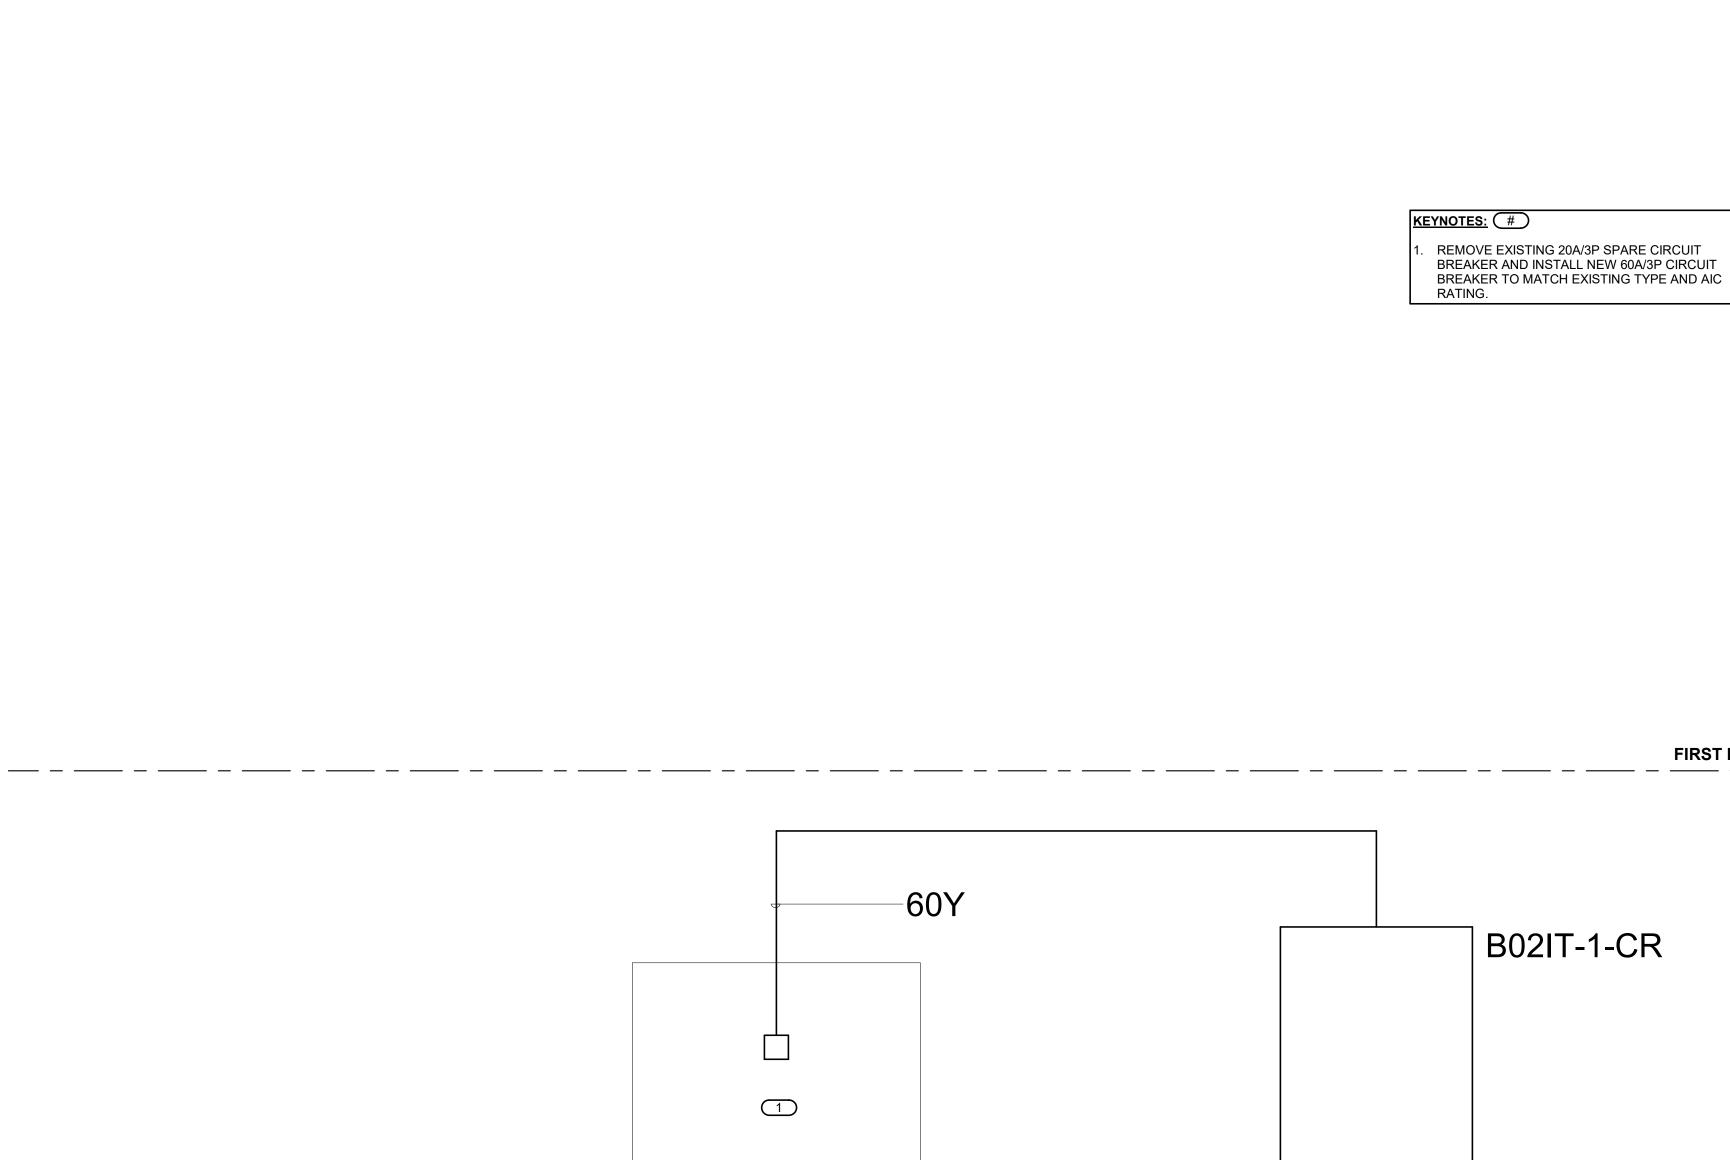


2EC

DRAWING TITLE ELECTRICAL DIAGRAMS & SCHEDULE	PROJECT TITLE EHRM IN UPGRAD		ICTURE	DATE: 03/30/2022 PLOT SCALE PROJECT NO. 656-21-235	V
	BUILDING No	CHECKED BY	DRAWN GJL	DRAWING NO. 02-E400	
	LOCATION VA MEDICAL C ST.CLOUD, MN		FULLY	DWG. OF	

FIRST FLOOR

BASEMENT




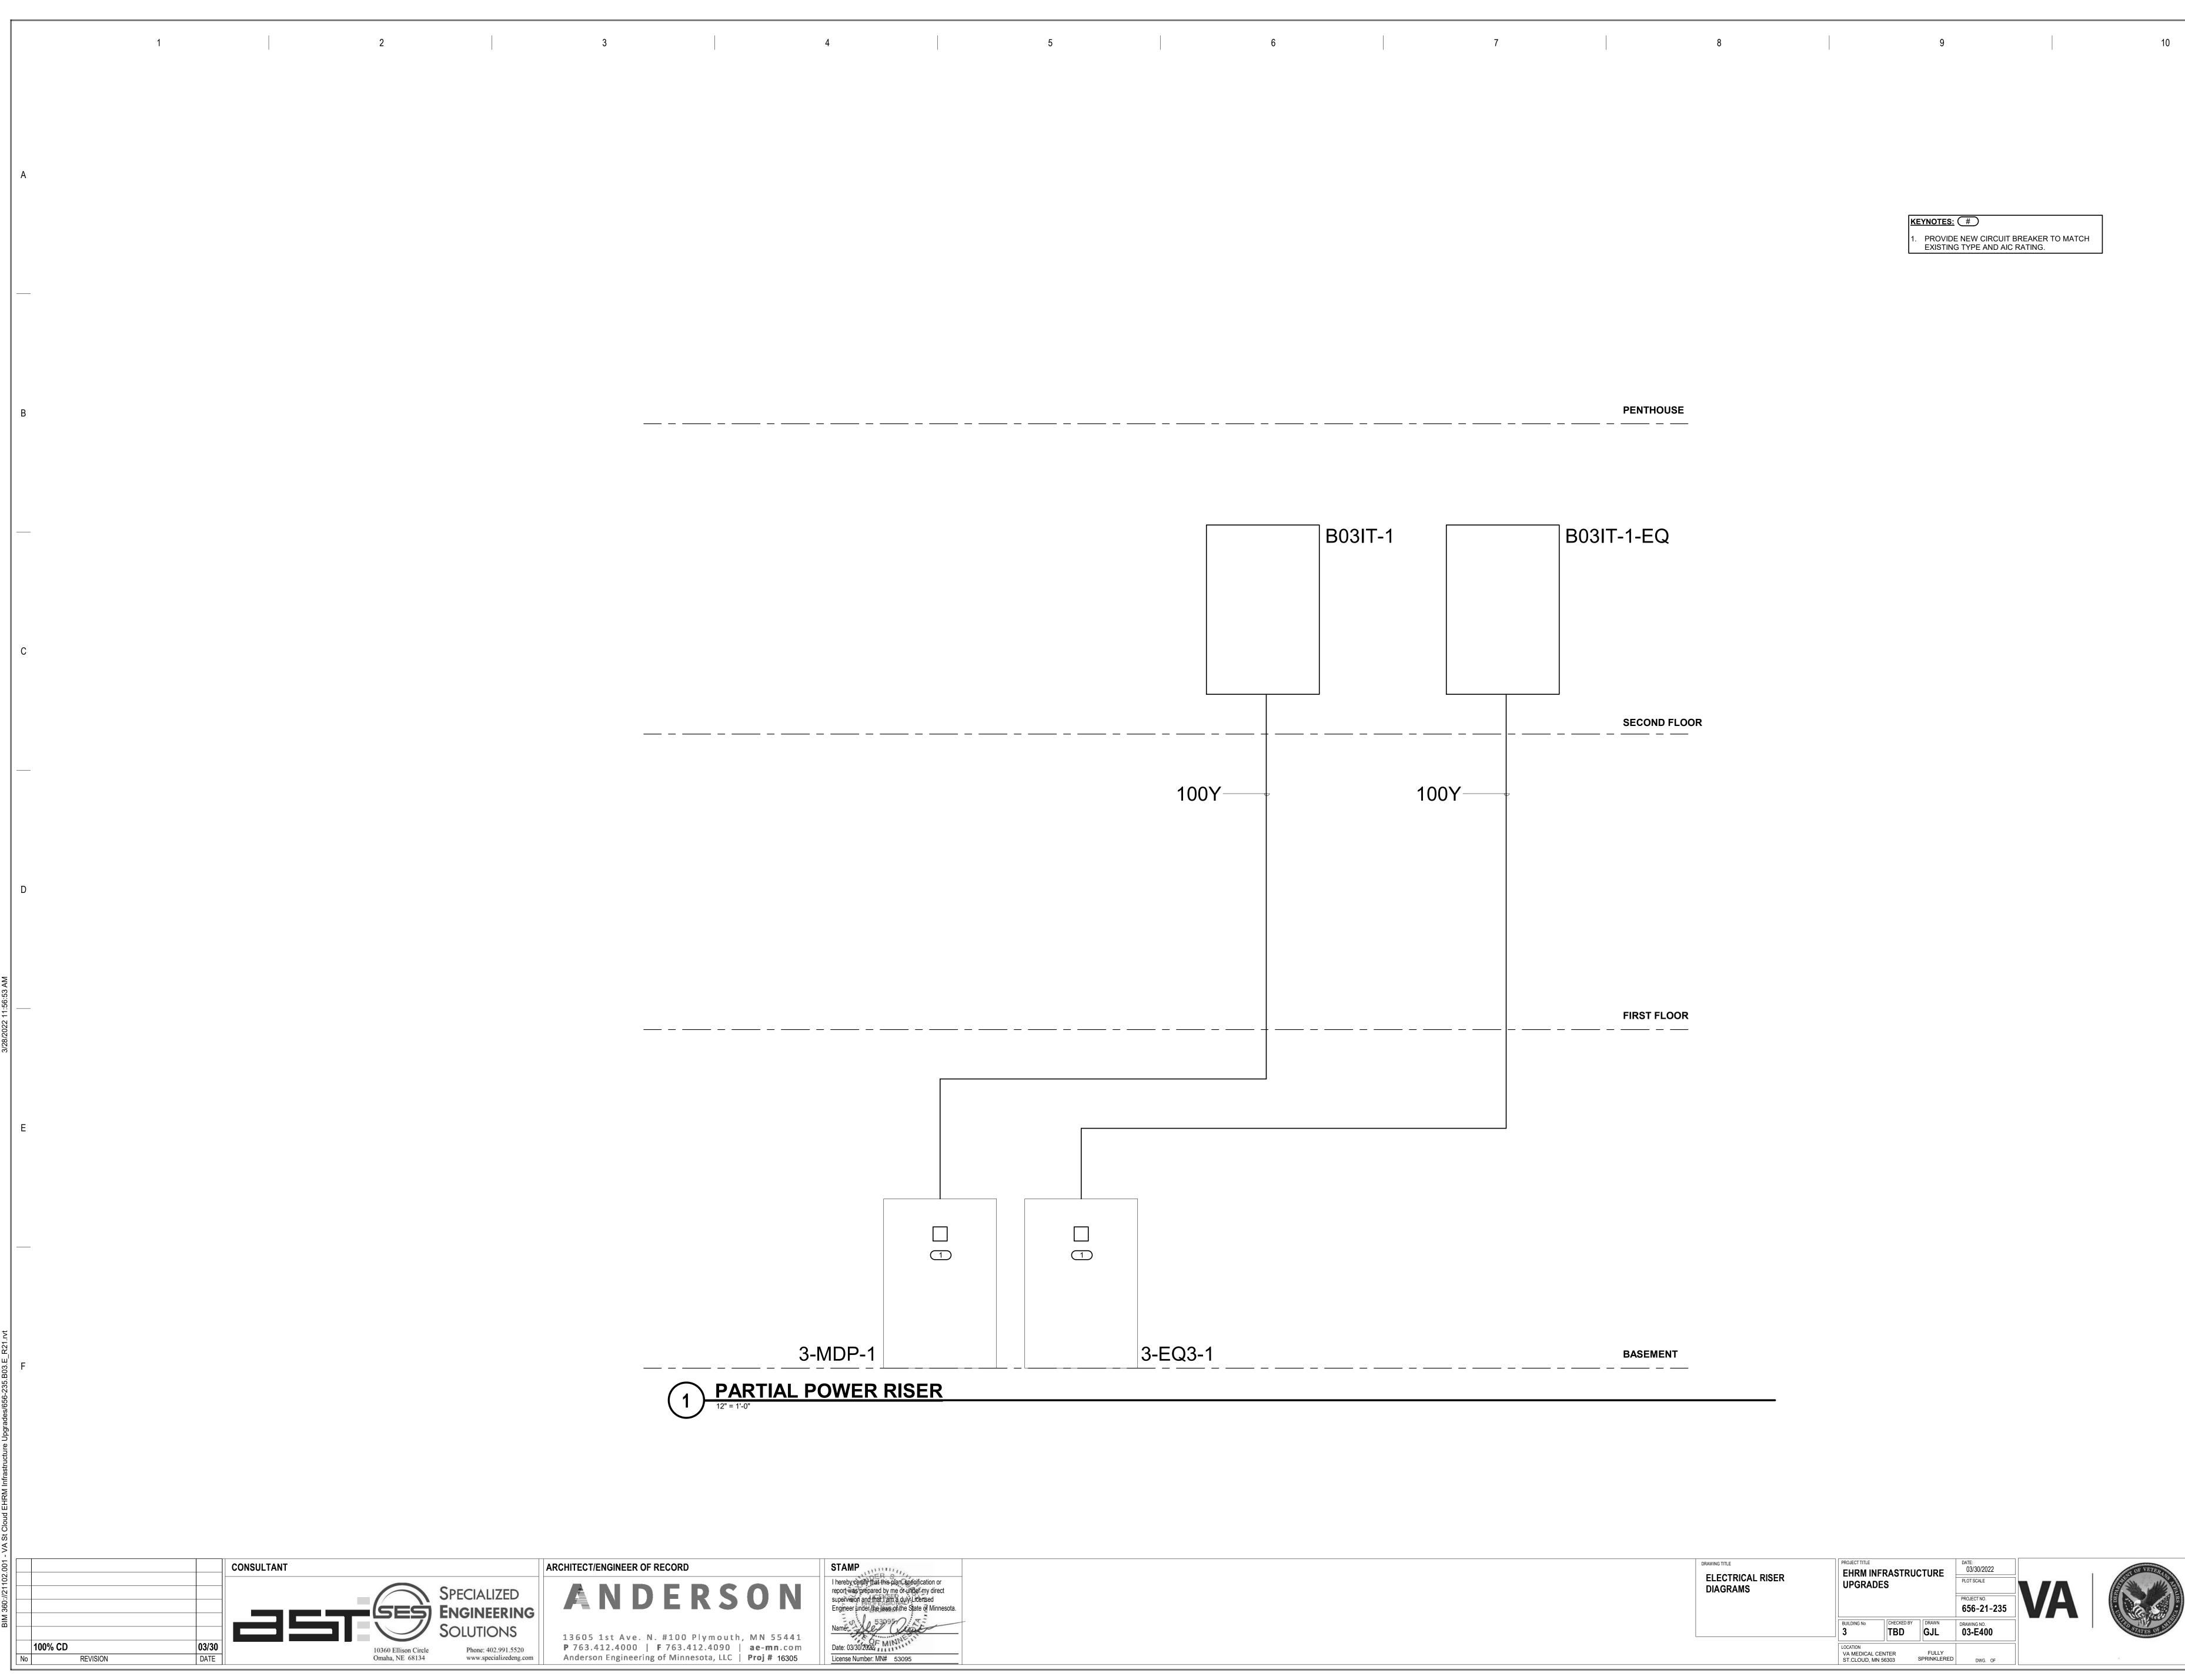

KEYNOTES: # . PROVIDE NEW CIRCUIT BREAKER TO MATCH EXISTING TYPE AND AIC RATING.

DRAWING TITLE ELECTRICAL RISER DIAGRAMS	PROJECT TITLE EHRM INF UPGRAD		ICTURE	DATE: 03/30/2022 PLOT SCALE PROJECT NO. 656-21-235	
	BUILDING No 3	CHECKED BY	drawn GJL	DRAWING NO. 03-E400	
	LOCATION VA MEDICAL C ST.CLOUD, MN		FULLY	DWG. OF	



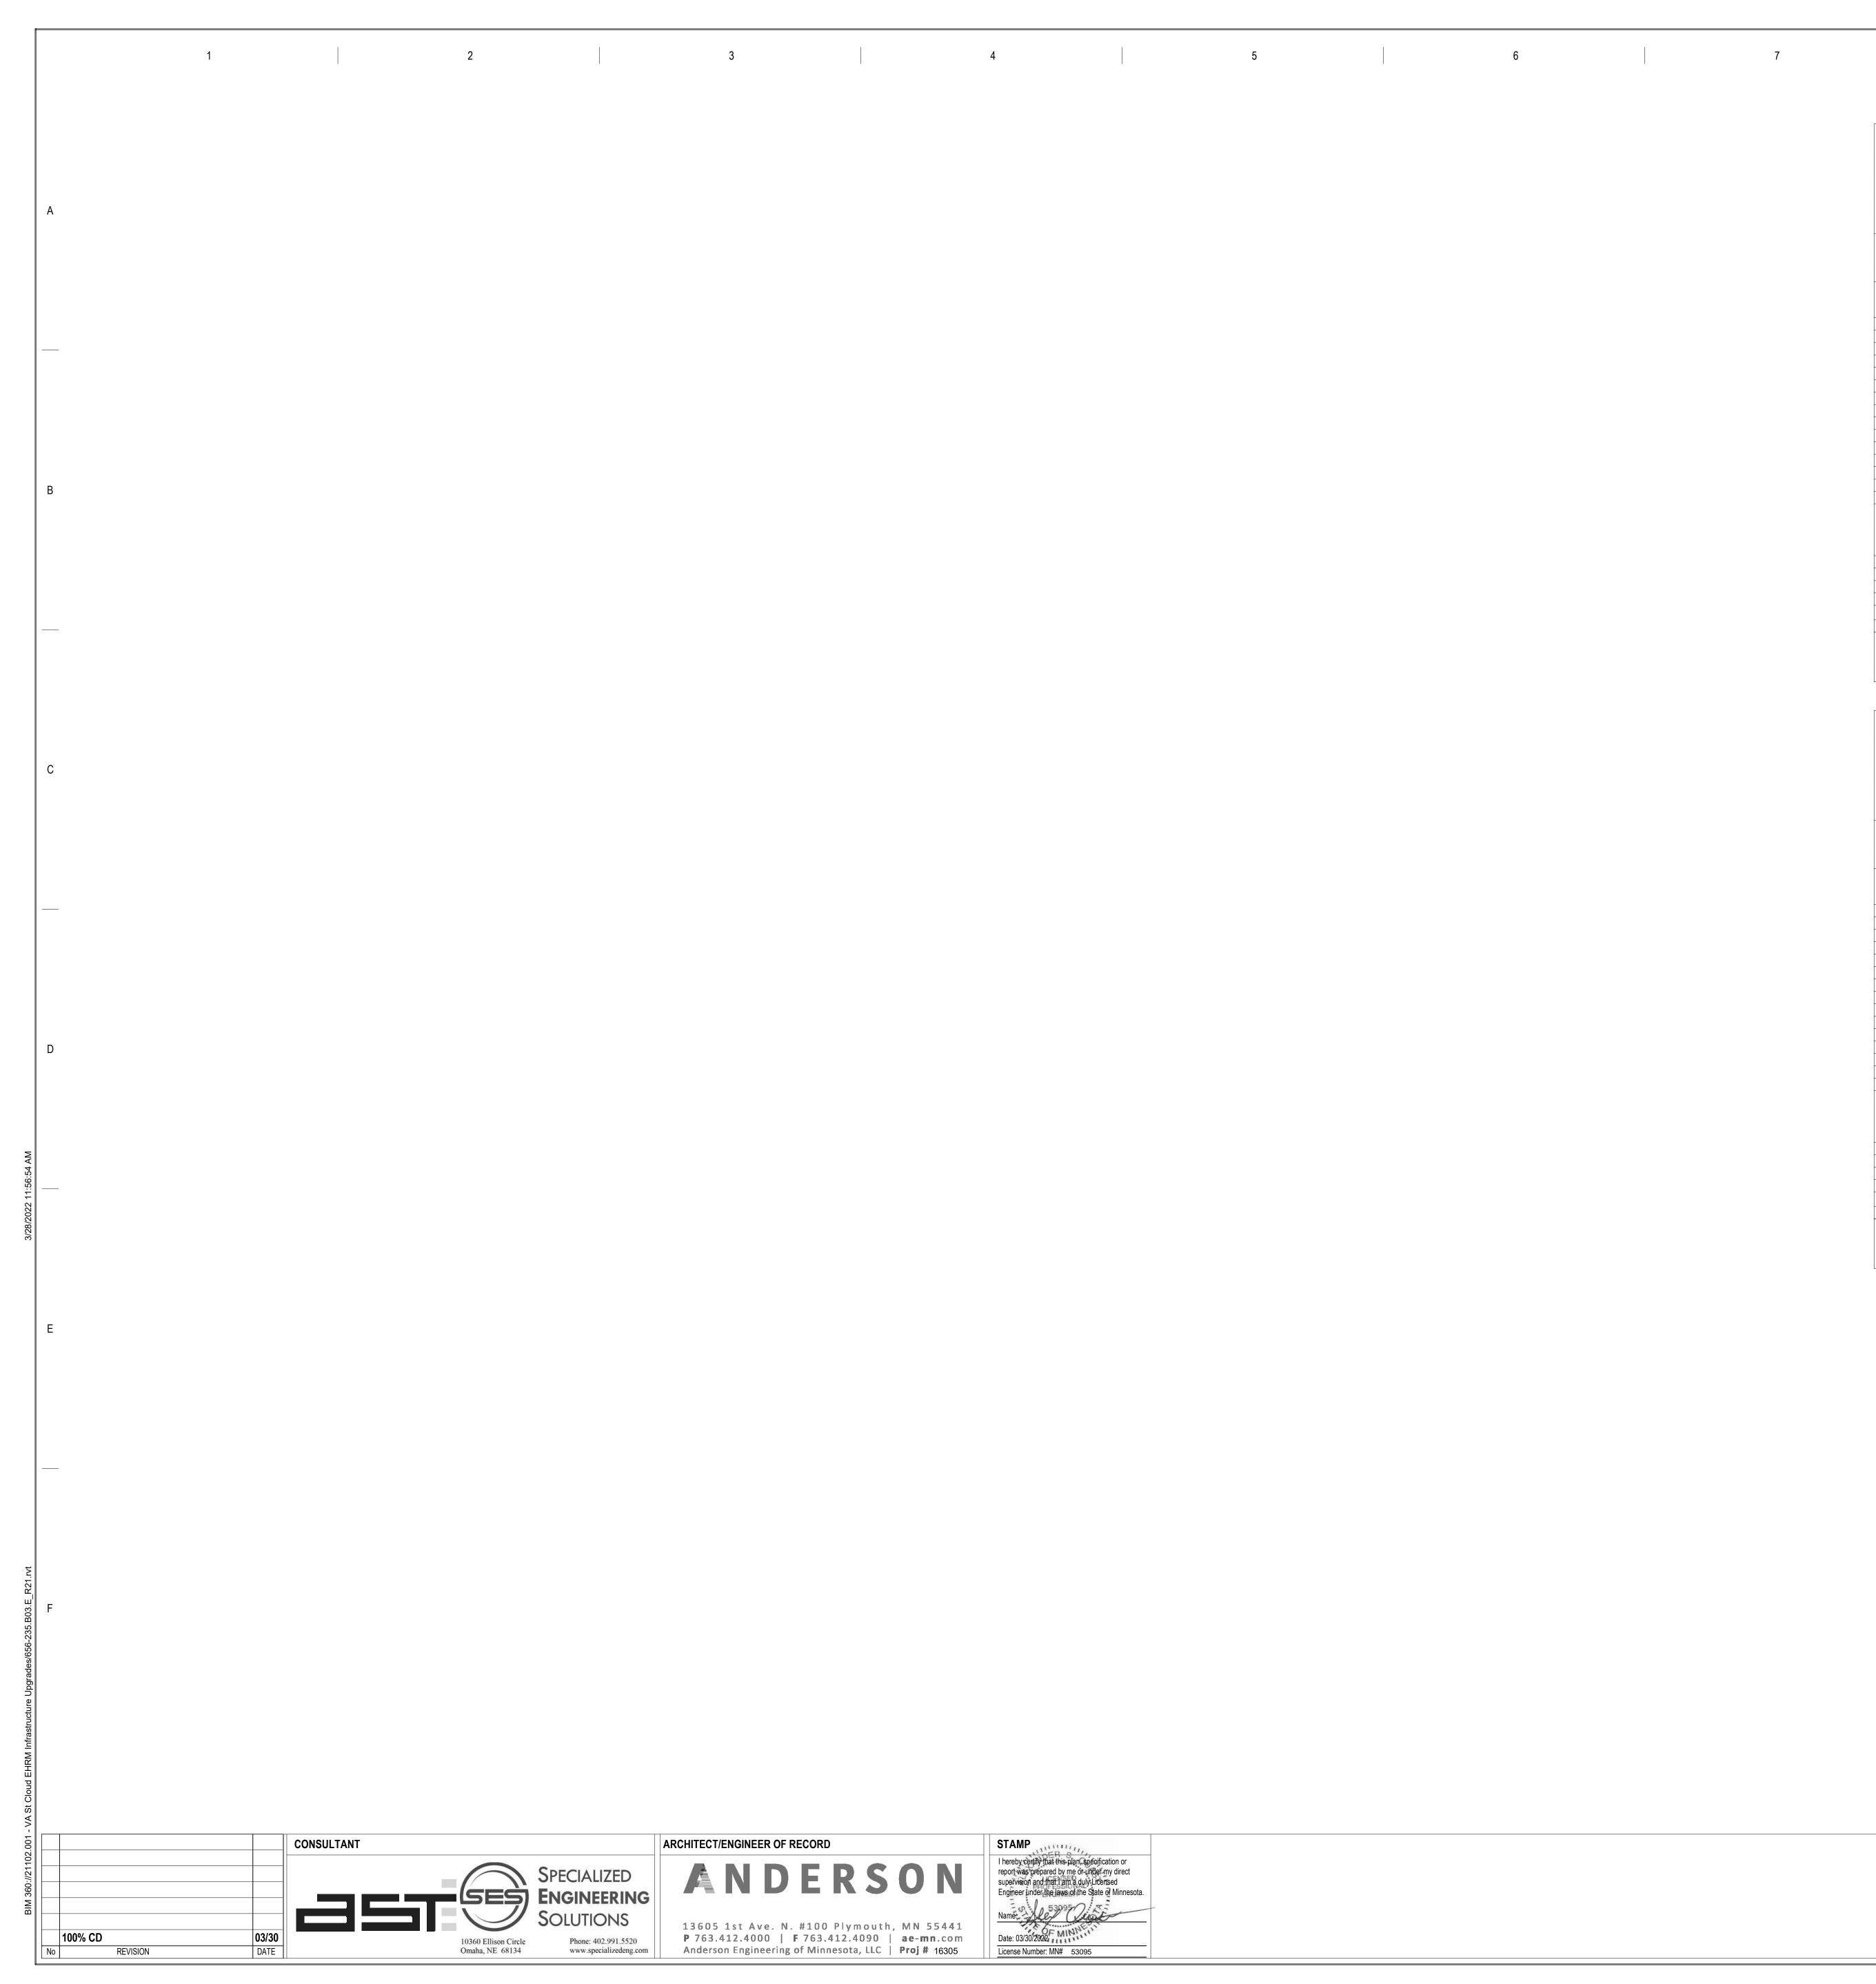

STAMP I hereby certify that this plan, specification or report was prepared by me or under my direct supervision and that I am a duly Licensed Engineer under the laws of the State of Minnesota. License Number: MN# 53095

Solud NEUTRAL GROUND BUS SOLUD NEUTRAL GROUND BUS SOLUD NEUTRAL GROUND BUS NOTES: PROVIDE INTEGRAL ELECTRIC METER IN PANEL: K K VID. LOAD DESCRIPTION AMPS I INTEGRAL ELECTRIC METER IN PANEL: K K VID. LOAD DESCRIPTION AMPS I INTEGRAL ELECTRIC METER IN PANEL: K K C VID. LOAD DESCRIPTION AMPS I IT IS FARE 20A 1 10 Colspan="2">Colspan="2">10 13 SPARE 20A 1 10 Colspan="2">Colspan="2">Colspan="2">10 17 Colspan="2">Colspan="2">Colspan="2">Colspan="2">Colspan="2">Colspan="2" 10		м	DUNTING: SURFACE							P	ANE	ELE	303	IT-2	2				
LOCATION: TELECOM ROOM 205E NOTES: PROVIDE INTEGRAL ELECTRIC METER IN PANEL K OCTO OCPO NIFE A B C WIRE OCPO NIFE NOTES: LODAD DESCRIPTION OCPO NIFE SZE A B C WIRE OCPO NIFE 1 TELECOM ROOM RCC. 201A 1 - 0 0 0 0 - - 1 2 2 2 2 3 SPARE 20A 1 - - 0 0 0 - - 1 20		ENC	LOSURE: NEMA PB 1																
NOTES: PROVIDE INTEGRAL ELECTRIC METER IN PANEL É CAT LOAD DESCRIPTION AMPS P N G B C WRE OCPU 1 11 12 0 0.36 0 1.67 1.67 1											GR	OUND	BUS						
K OKT LOAD DESCRIPTION AMPS P N SE A B C NURE SUE OCED SUE AMPS P N M G S C SUE G N H P AM 3 121-00R RACK 20A 3 - 1		_																	
K OKT LOAD DESCRIPTION AMPS P N SE A B C NURE SUE OCED SUE AMPS P N M G S C SUE G N H P AM 3 121-00R RACK 20A 3 - 1																			
E CM LOAD DESCRIPTION APP N G A B C Size S N PORE 1 121-008 RACK 20.4 1 0 0.3 0 <th>N</th> <th>IOTES</th> <th>5: PROVIDE INTEGRAL ELECTR</th> <th>IC METER</th> <th>IN</th> <th>PAN</th> <th>IEL.</th> <th></th>	N	IOTES	5 : PROVIDE INTEGRAL ELECTR	IC METER	IN	PAN	IEL.												
E CM LOAD DESCRIPTION APP N G A B C Size S N PORE 1 121-008 RACK 20.4 1 0 0.3 0 <th></th>																			
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II WP GFIREC. 20 A I			 LIGHTING		-		-		1.67	0	0	0 18						-	
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- 21 SPARE 20 A 1 - - 0 0 0 - - 1 1 20 23 SPARE 20 A 1 - - 0 0 0 - - - 1 120 25 SPARE 20 A 1 - - - 0 0 0 - - 1 120 29 SPARE 20 A 1 - - - 0 0 0 - - 1 1 20 Total Lost: 20.3 kVA 1.95 kVA 1.95 kVA 1.95 kVA 1.95 kVA 1.95 kVA 1.95 kVA 1.92 kVA <td></td> <td></td> <td></td> <td></td> <td></td> <td></td> <td>_</td> <td>-</td> <td>0</td> <td>0</td> <td></td> <td></td> <td>0</td> <td></td> <td>-</td> <td></td> <td></td> <td>1</td> <td>20 /</td>							_	-	0	0			0		-			1	20 /
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- 27 SPARE 20 A 1 - - 0 0 0 - - - 1 10 0 0 0 - - 1 10 0 0 0 0 - - 1 10 0 0 0 0 0 0 0 0 0 0 0 0 0 0 1 1 10 10 10 0 0 0 0 1 1 10 10 10 0 0 0 1 1 10					_	_				0			0	0				1	20
- 29 SPARE 20 A 1 - - - 0 0 - - - 1 20 Total Load: 2.03 kVA 1.85 kVA 1.00.0% 0 kVA 0.00% 0.84 kVA 1.00 kVA 0.00% 0.72 kVA 1074L CON CONCOLORS 1.85 kVA 1074L CON 1.05 kVA 100 kVA 1.05		-							0	U	0	0						1	20
Total Amps: 16.89 15.39 15.39 LOAD SUMMARY LOAD SUMMARY Lighting 0 kVA 000% 0 kVA Power 5 kVA 100.00% 5 kVA TOTAL CON Receptacles 0.72 kVA 100.00% 0 kVA TOTAL CON ** 0 0.72 kVA 100.00% 0.72 kVA TOTAL CON ** 0 0.72 kVA 100.00% 0.72 kVA TOTAL CON ** 0 0.72 kVA 100.00% 0.72 kVA TOTAL CON ** 0 0 0.72 kVA TOTAL CON TOTAL CON ** 0 0 0.72 kVA TOTAL CON TOTAL CON ** 0 0.72 kVA TOTAL CON TOTAL SO TOTAL CON CIRCUIT KEY NOTES: ** C SOLID NEUTRAL SOLID NEUTRAL FED FROM: 3-62.31 LOCATION: TELECOM ROOM 205E SOLID NEUTRAL SOLID NEUTRAL SOLID NEUTRAL ** NOTES: ** NMP P MAPS P H<					-						-		0	0				1	20
LOAD SUMMARY LOAD CLASSIFICATION CONNECTED LOAD DEMAND FACTOR ESTIMATED DEMAND Power 5 kVA 100.00% 5 kVA TOTAL CON Receptacles 0.72 kVA 100.00% 5 kVA TOTAL CON Image: Constraint of the state of the																			
LOAD CLASSIFICATION CONNECTED LOAD DEMAND FACTOR ESTIMATED DEMAND Lighting 0 KVA 0.00% 0 KVA 0 KVA Power 5 KVA 100.00% 5 KVA TOTAL CON Receptacles 0.72 KVA 1000.00% 0.72 KVA TOTAL CON *TOTAL DEMAND CALCS SUBTRACT ANY REDUNDANT LOAD AND THE SMALLER OF ANY NONCOINCIDENT HVAC LOAD TOTAL CON TOTAL CON CIRCUIT KEY NOTES: SOLID NEUTRAL SOLID NEUTRAL SOLID NEUTRAL SOLID NEUTRAL FED FROM: 3-EQ3.1 LOCATION: TELECOM ROOM 205E MIRE A B C WIRE NO 1 LOAD DESCRIPTION AMPS P H N G I 3 0 3<						10	tal A	nps	: 16	.89	15	.39	15	.39					
Lighting O KVA 0.00% O KVA TOTAL CON Receptacles 0.72 kVA 100.00% 5 kVA TOTAL CON "TOTAL DEMAND CALCS SUBTRACT ANY REDUNDANT LOAD AND THE SMALLER OF ANY NONCOINCIDENT HVAC LOAD TOTAL EST TOTAL EST "TOTAL DEMAND CALCS SUBTRACT ANY REDUNDANT LOAD AND THE SMALLER OF ANY NONCOINCIDENT HVAC LOAD CIRCUIT KEY NOTES: SOLID NEUTRAL GROUND BUS SOLID NEUTRAL GROUND BUS SOLID NEUTRAL GROUND BUS NOTES: NOTES: SOLID NEUTRAL GROUND BUS 3 20 1 L21-20R RACK 20 A 3 1.67 0 - - - - 3 - - - - - 1.67 0 -									_										
Power 5 kVA 100.00% 5 kVA TOTAL CON Receptacies 0.72 kVA 100.00% 0.72 kVA TOTAL CON *TOTAL DEMAND CALCS SUBTRACT ANY REDUNDANT LOAD AND THE SMALLER OF ANY NONCOINCIDENT HVAC LOAD TOTAL CON TOTAL CON *TOTAL DEMAND CALCS SUBTRACT ANY REDUNDANT LOAD AND THE SMALLER OF ANY NONCOINCIDENT HVAC LOAD SOLID NEUTRAL SOLID NEUTRAL CIRCUIT KEY NOTES: ************************************			ASSIFICATION		NN	1FC		LUA	DIDEN	IAND	FACIO	R ES	SIIMAI	ED DE	:MAr	UV			
TOTAL CON TOTAL EST TOTAL CON TOTAL EST **TOTAL DEMAND CALCS SUBTRACT ANY REDUNDANT LOAD AND THE SMALLER OF ANY NONCOINCIDENT HVAC LOAD CIRCUIT KEY NOTES: FORMEL B03IT-2-EQ MOUNTING: SURFACE ENCLOSURE: NEMA PB 1 FED FROM: 3-E03-1 LOCATION: TELECOM ROOM 205E SOLID NEUTRAL GROUND BUS SOLID NEUTRAL GROUND BUS NOTES: SOLID NEUTRACE I LOCATION: TELECOM ROOM 205E SOLID NEUTRAL GROUND BUS SOLID NEUTRAL GROUND BUS 1 L21-20R RACK 20 A 1 1.67 0 - - - - - 3 - - - - - 1.87 0 -	Power					01		-		0.00) kVA			1		
*TOTAL DEMAND CALCS SUBTRACT ANY REDUNDANT LOAD AND THE SMALLER OF ANY NONCOINCIDENT HVAC LOAD CIRCUIT KEY NOTES: MOUNTING: SURFACE ENCLOSURE: NEMA PB 1 FED FROM: 3-E03-1 SOLID NEUTRAL LOCATION: TELECOM ROOM 205E WIRE AMPS P H N G E VIRE G NOTES: K CKT LOAD DESCRIPTION OCPD AMPS P WIRE A B C SIZE G N P P AMPS P H N G A B C SIZE G N P P AMPS P H N G A B C SIZE G N P A B C SIZE G N P <td>Powe</td> <td>/er</td> <td></td> <td></td> <td></td> <td>5 I</td> <td>κVΑ «VA</td> <td></td> <td></td> <td>100.0</td> <td>)%)0%</td> <td></td> <td>0 5</td> <td>i kVA</td> <td></td> <td></td> <td></td> <td></td> <td></td>	Powe	/er				5 I	κVΑ «VA			100.0)%)0%		0 5	i kVA					
CIRCUIT KEY NOTES: PANEL B03IT-2-EQ SOLID NEUTRAL GROUND BUS NOTES: NOTES: T LOAD DESCRIPTION 1 QCPD AMPS P H NG MIRE SIZE SIZE 1 A B C VIRE G N H P AM 1 LIGAD DESCRIPTION AMPS P H NG 1 1.67 0 - - C VIRE G N H P AM 1 LIGAD DESCRIPTION AMPS P H NG - - - - - - 1 L21-20R RACK 20A 3 0 1.67 0 - - - - - - - - - - - -<	Powe	/er	es			5 I	κVΑ «VA			100.0)%)0%		0 5	i kVA			то	TAL	EST
K K	Powe	ver eptacl	*TOTAL DEMAND CALCS SUBTRA			5 I 0.72	<va <va 2 kVA</va </va 		D AND	100.0 100.0)%)0%)0%	R OF /	0 5 0.7	5 kVA 72 kVA		DEN	ТО ТО ТО	TAL TAL TAL	ESTI CON ESTI
7 TELECOM ROOM REC. 20 A 1 0.36 0 1 20 9 Lighting 20 A 1 0 0 0 1 20 11 CU-3-1 20 A 20 A 2 1 0 1 20 13 1 0 1 20 15 SPARE 20 A 1 1 0 1 20 15 SPARE 20 A 1 1 0 1 20 17 SPARE 20 A 1 1 20 1 20 19	Powe	rer eptacl CIRCI CIRCI ENC FI	*TOTAL DEMAND CALCS SUBTRA UIT KEY NOTES: DUNTING: SURFACE CLOSURE: NEMA PB 1 ED FROM: 3-EQ3-1			5 I 0.72	<va <va 2 kVA</va </va 		D AND	100.0 100.0 THE S)%)0%)0% MALLE ANE SOL	EL E	0 5 0.7 ANY NC B03	5 kVA 72 kVA DNCOII	NCIE		то то то	TAL TAL TAL	ESTI CON ESTI
9 Lighting 20 A 1 1 20 11 CU-3-1 20 A 2 1 0 1 20 13 1 0 1 20 13 1 0 1 20 13 1 0 1 20 15 SPARE 20 A 1 1 0 1 20 17 SPARE 20 A 1 0 0 0 1 20 19 SPARE 20 A 1 <		rer eptacl CIRCI ENC ENC FE LC IOTES IOTES	*TOTAL DEMAND CALCS SUBTRA UIT KEY NOTES: DUNTING: SURFACE LOSURE: NEMA PB 1 ED FROM: 3-EQ3-1 DCATION: TELECOM ROOM 205E S: LOAD DESCRIPTION L21-20R RACK		DU.	5 0.72 JND P 3				100.0 100.0 THE S	0% 00% MALLE SOL GR							TAL TAL (AC I	
11 CU-3-1 20 A 2 - - - - 1 0 1 20 13 1 0 1 20 13 1 0 1 20 15 SPARE 20 A 1 0 0 0 1 20 17 SPARE 20 A 1 0 0 0 1 20 17 SPARE 20 A 1 0 0 0 1 20 19 SPARE 20 A 1 0 0 0 1 20 21 SPARE 20 A		rer eptacl CIRCI ENC FI LC IOTES IOTES	*TOTAL DEMAND CALCS SUBTRA UIT KEY NOTES: DUNTING: SURFACE LOSURE: NEMA PB 1 ED FROM: 3-EQ3-1 DCATION: TELECOM ROOM 205E S: LOAD DESCRIPTION L21-20R RACK 	CT ANY RE	EDU N N N N N N N N	5 0.72 JND P B 	(VA (VA 2 kVA ANT ANT SIZ SIZ H N		1.67	100.0 100.0 THE S	0% 00% MALLE SOL GR							TAL TAL (AC I AC I AC I AC I AC I AC I AC I AC I	
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		/er eptacl CIRCI ENC ENC FE L(IOTES IOTES IOTES IOTES IOTES	*TOTAL DEMAND CALCS SUBTRA UIT KEY NOTES: DUNTING: SURFACE CLOSURE: NEMA PB 1 ED FROM: 3-EQ3-1 DCATION: TELECOM ROOM 205E CATION: TELECOM ROOM 205E CLOAD DESCRIPTION L21-20R RACK TELECOM ROOM REC. Lighting CU-3-1 SPARE	CT ANY RE	P I 3 1 1 2 1	5 0.72 JND P P B - 1 1 1 	(VA (VA 2) (VA 2) (V		1.67	100.0 100.0 THE S P	0% 00% 00% MALLE SOL GR		0 5 0.7 ANY NC BUS		CIL 2-E G G 	VIR SIZE N 		TAL T	EST CON EST _OAI
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25 SPARE 20 A 1 0 0 0 1 20	Power Rece	rer eptacl CIRCI CIRCI ENC FE LO IOTES OCKT NO. 1 3 5 7 9 11 13 5 7 9 11 13 15 17 19 21	*TOTAL DEMAND CALCS SUBTRA UIT KEY NOTES: DUNTING: SURFACE ELOSURE: NEMA PB 1 ED FROM: 3-EQ3-1 DCATION: TELECOM ROOM 205E S: LOAD DESCRIPTION L21-20R RACK TELECOM ROOM REC. Lighting CU-3-1 SPARE SPARE SPARE SPARE SPARE SPARE	CT ANY RE CT ANY RE	PD 1 2 1 1 1 1 1 1 1 1	5 0.72 JND JND P P P 1 - 1 - 1 - - - - - - - - - - -	(VA (VA) (VA	LOA E E G 	1.67 0.36 1 1 0	100.0 100.0 THE S P	0% 00% 00% MALLE SOL GR		0 5 0.7 ANY NC BUS		NCIE 2-E G G 	VIR SIZE N 	TO TO TO TO TO TO TO TO TO TO TO TO TO T	TAL T	EST CON EST _OAI 20 20 20 20 20 20 20 20 20 20 20 20 20
27 SPARE 20 A 1 1 20	Powe Rece K F Y 	rer eptacl CIRCI CIRCI ENC FI LC IOTES OTES OTES OTES OTES OTES OTES OTES	*TOTAL DEMAND CALCS SUBTRA UIT KEY NOTES: DUNTING: SURFACE LOSURE: NEMA PB 1 ED FROM: 3-EQ3-1 DCATION: TELECOM ROOM 205E CATION: TELECOM ROOM 205E LOAD DESCRIPTION L21-20R RACK TELECOM ROOM REC. Lighting CU-3-1 SPARE SPARE SPARE SPARE SPARE SPARE SPARE SPARE SPARE	CT ANY RE CT ANY RE	PD PD I 3 3 1 1 1 1 1 1 1 1	5 0.72 JND JND P 1 - - - - - - - - - - - - - - - - -	(VA (VA (VA (VA (VA ANT ANT ANT ANT -	LOA E G I I I I I I I I I I I I I I I I I I		100.0 100.0 THE S P	0% 00% 00% MALLE SOL GR		0 5 0.7 ANY NC BUS		NCIE 2-E 3 3 4 4 5 5 5 5 5 5 5 5 5 5 5 5 5 5 5 5	VIR SIZE N 		TAL T	EST CON EST _OAI 20 20 20 20 20 20 20 20 20 20 20 20 20

	Total Load:	3.03 kVA	1.67 kV	/A 2.67 kVA			
	Total Amps:	26.50	13.89	23.50			
		·					
		L	DAD SUM	IMARY			
LOAD CLASSIFICATION	CONNECTED LOAD	DEMAND F	ACTOR	ESTIMATED DEMAND	TOTALS*		
Lighting	0 kVA	0.00	%	0 kVA	TOTALS		
Power	7 kVA	100.0	0%	7 kVA	TOTAL CONNECTED LOAD:	7.36 kVA	
Receptacles	0.36 kVA	100.0	0%	0.36 kVA	TOTAL ESTIMATED DEMAND LOAD:	7.36 kVA	
					TOTAL CONNECTED AMPS:	20.43 A	
					TOTAL ESTIMATED DEMAND AMPS:	20.4 A	
*TOTAL DEMAND CALCS SUBTRACT ANY REDUNDANT LOAD AND THE SMALLER OF ANY NONCOINCIDENT HVAC LOADS. THIS CALC IS DONE AT EAC							
CIRCUIT KEY NOTES:							

DRAWING TITLE ELECTRICAL SCHEDULES	PROJECT TITLE EHRM INI UPGRAD		CTURE	DATE: 03/30/2022 PLOT SCALE PROJECT NO. 656-21-235	
	BUILDING No	CHECKED BY	drawn GJL	DRAWING NO. 03-E500	
	LOCATION VA MEDICAL C ST.CLOUD, MN		FULLY SPRINKLERED	DWG. OF	


I: 100 A MCB S: 120/208 Wye E: 3 E: 4 R: 10 kA		
LOAD DESCRIPTION	CKT NO.	K E Y
20R	2	
	4	
	6	
ing	8	
GFI	10	
RE	12	
RE	14	
RE	16	
RE	18	
RE	20	
RE	22	
RE	24	
RE	26	
RE	28	
RE	30	


10

TOTALS*	
D LOAD:	5.72 kVA
DEMAND LOAD:	5.72 kVA
D AMPS:	15.88 A
DEMAND AMPS:	15.9 A
CALC IS DONE AT E	EACH PANEL.

MAIN: 100 A MCB			
DLTS: 120/208 Wye			
IASE: 3			
VIRE: 4			
CCR: 10 kA			
		OVT	K
LOAD DESCRIP		CKT NO.	E Y
_21-20R		2	•
		4	
-		6	
_ighting		8	
SPARE		10	
SPARE		12	
SPARE		14	
SPARE		16	
SPARE		18	
SPARE		20	
SPARE		22	
SPARE		24	
SPARE		26	
SPARE		28	
SPARE		30	
TOTALS*			
CTED LOAD:	7.36 kVA		
TED DEMAND LOAD:	7.36 kVA		
CTED AMPS:	20.43 A		




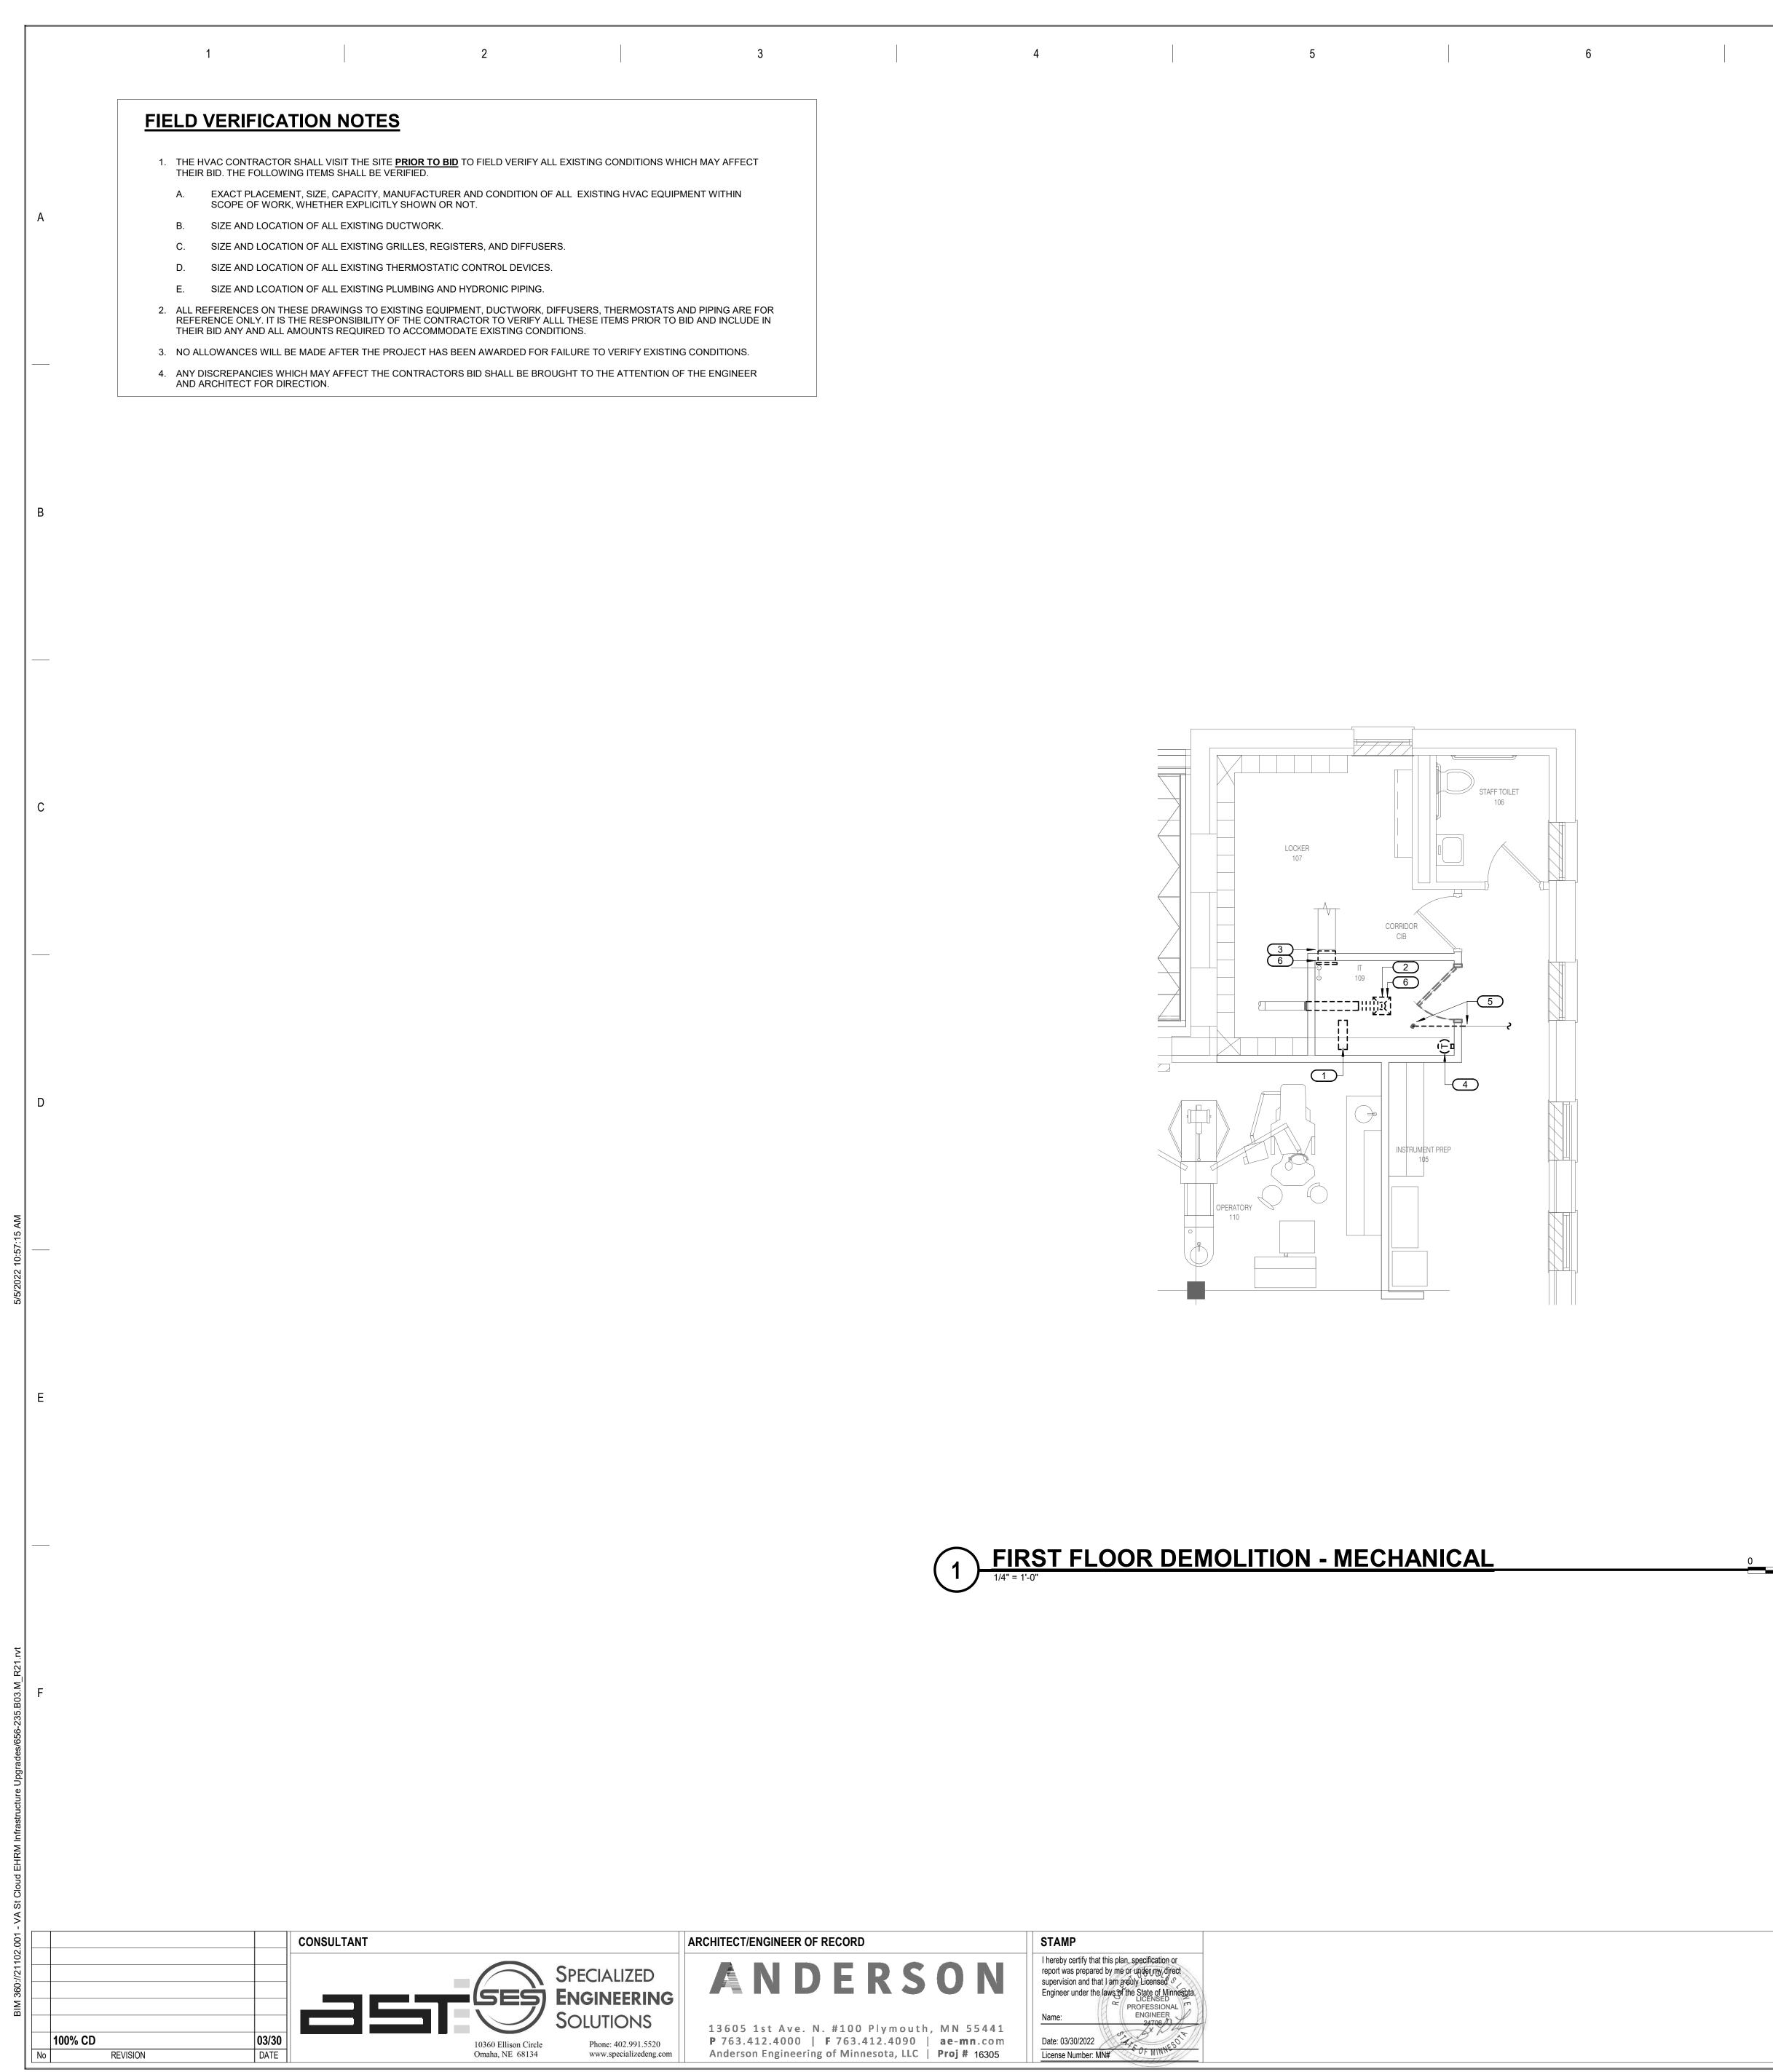

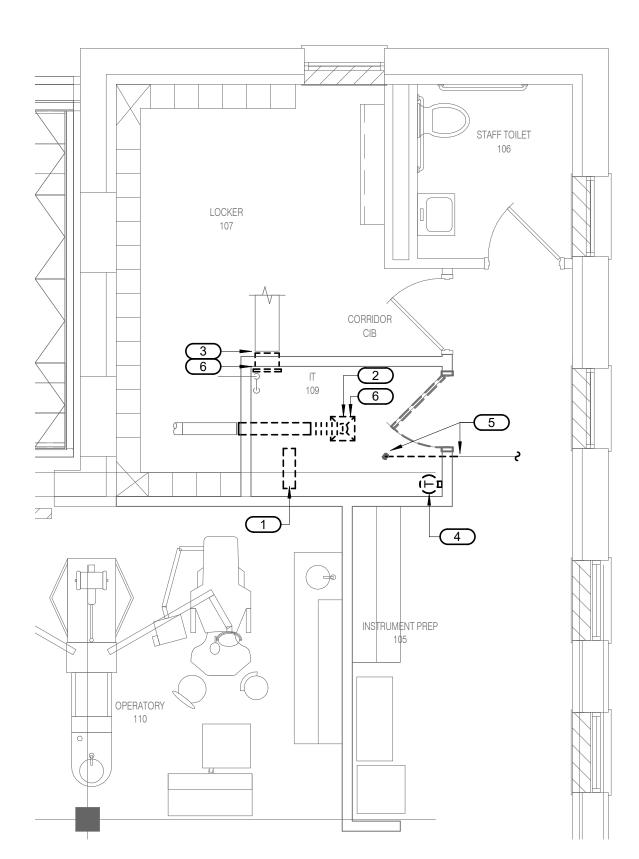


1 FIRST FLOOR DEMOLITION - MECHANICAL



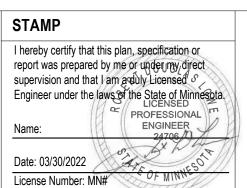


KEYNOTES 1/03-M101:				
1. EXISTING DATA RACK L	OCATION. UNIT TO BE	E DEMOLISHED BY OTHERS	З.	
2. EXISTING SUPPLY AIR I SHOWN AND CAP. COC		WORK. REMOVE BACK TO L CHING WITH GENERAL CON		
3. EXISTING RETURN AIR SHOWN AND CAP. COC		ORK. REMOVE BACK TO LOO CHING WITH GENERAL CON		
4. REMOVE AND DISPOSE	OF EXISTING THERM	IOSTATS AND ASSOCIATED) WIRING.	
5. REMOVE EXISTING SPF SHOWN FOR RE-ROUT CONTRACTOR.		BRANCH LINE BACK TO LOC ALL PATCHING WITH GENER		
6. CONTRACTOR TO PRE-	-MEASURE EXISTING	AIRFLOWS FOR TERMINAL	UNIT.	

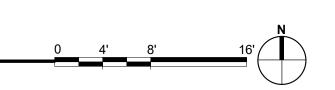


FIRST FLOOR DEMOLITION - MECHANICAL		PROJECT TITLE EHRM INFRASTRUCTURE UPGRADES			VA
	BUILDING No	CHECKED BY	DRAWN JCL	DRAWING NO. 03-M101	
	LOCATION VA MEDICAL CE ST.CLOUD, MN		FULLY SPRINKLERED	DWG. OF	




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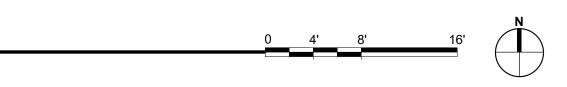


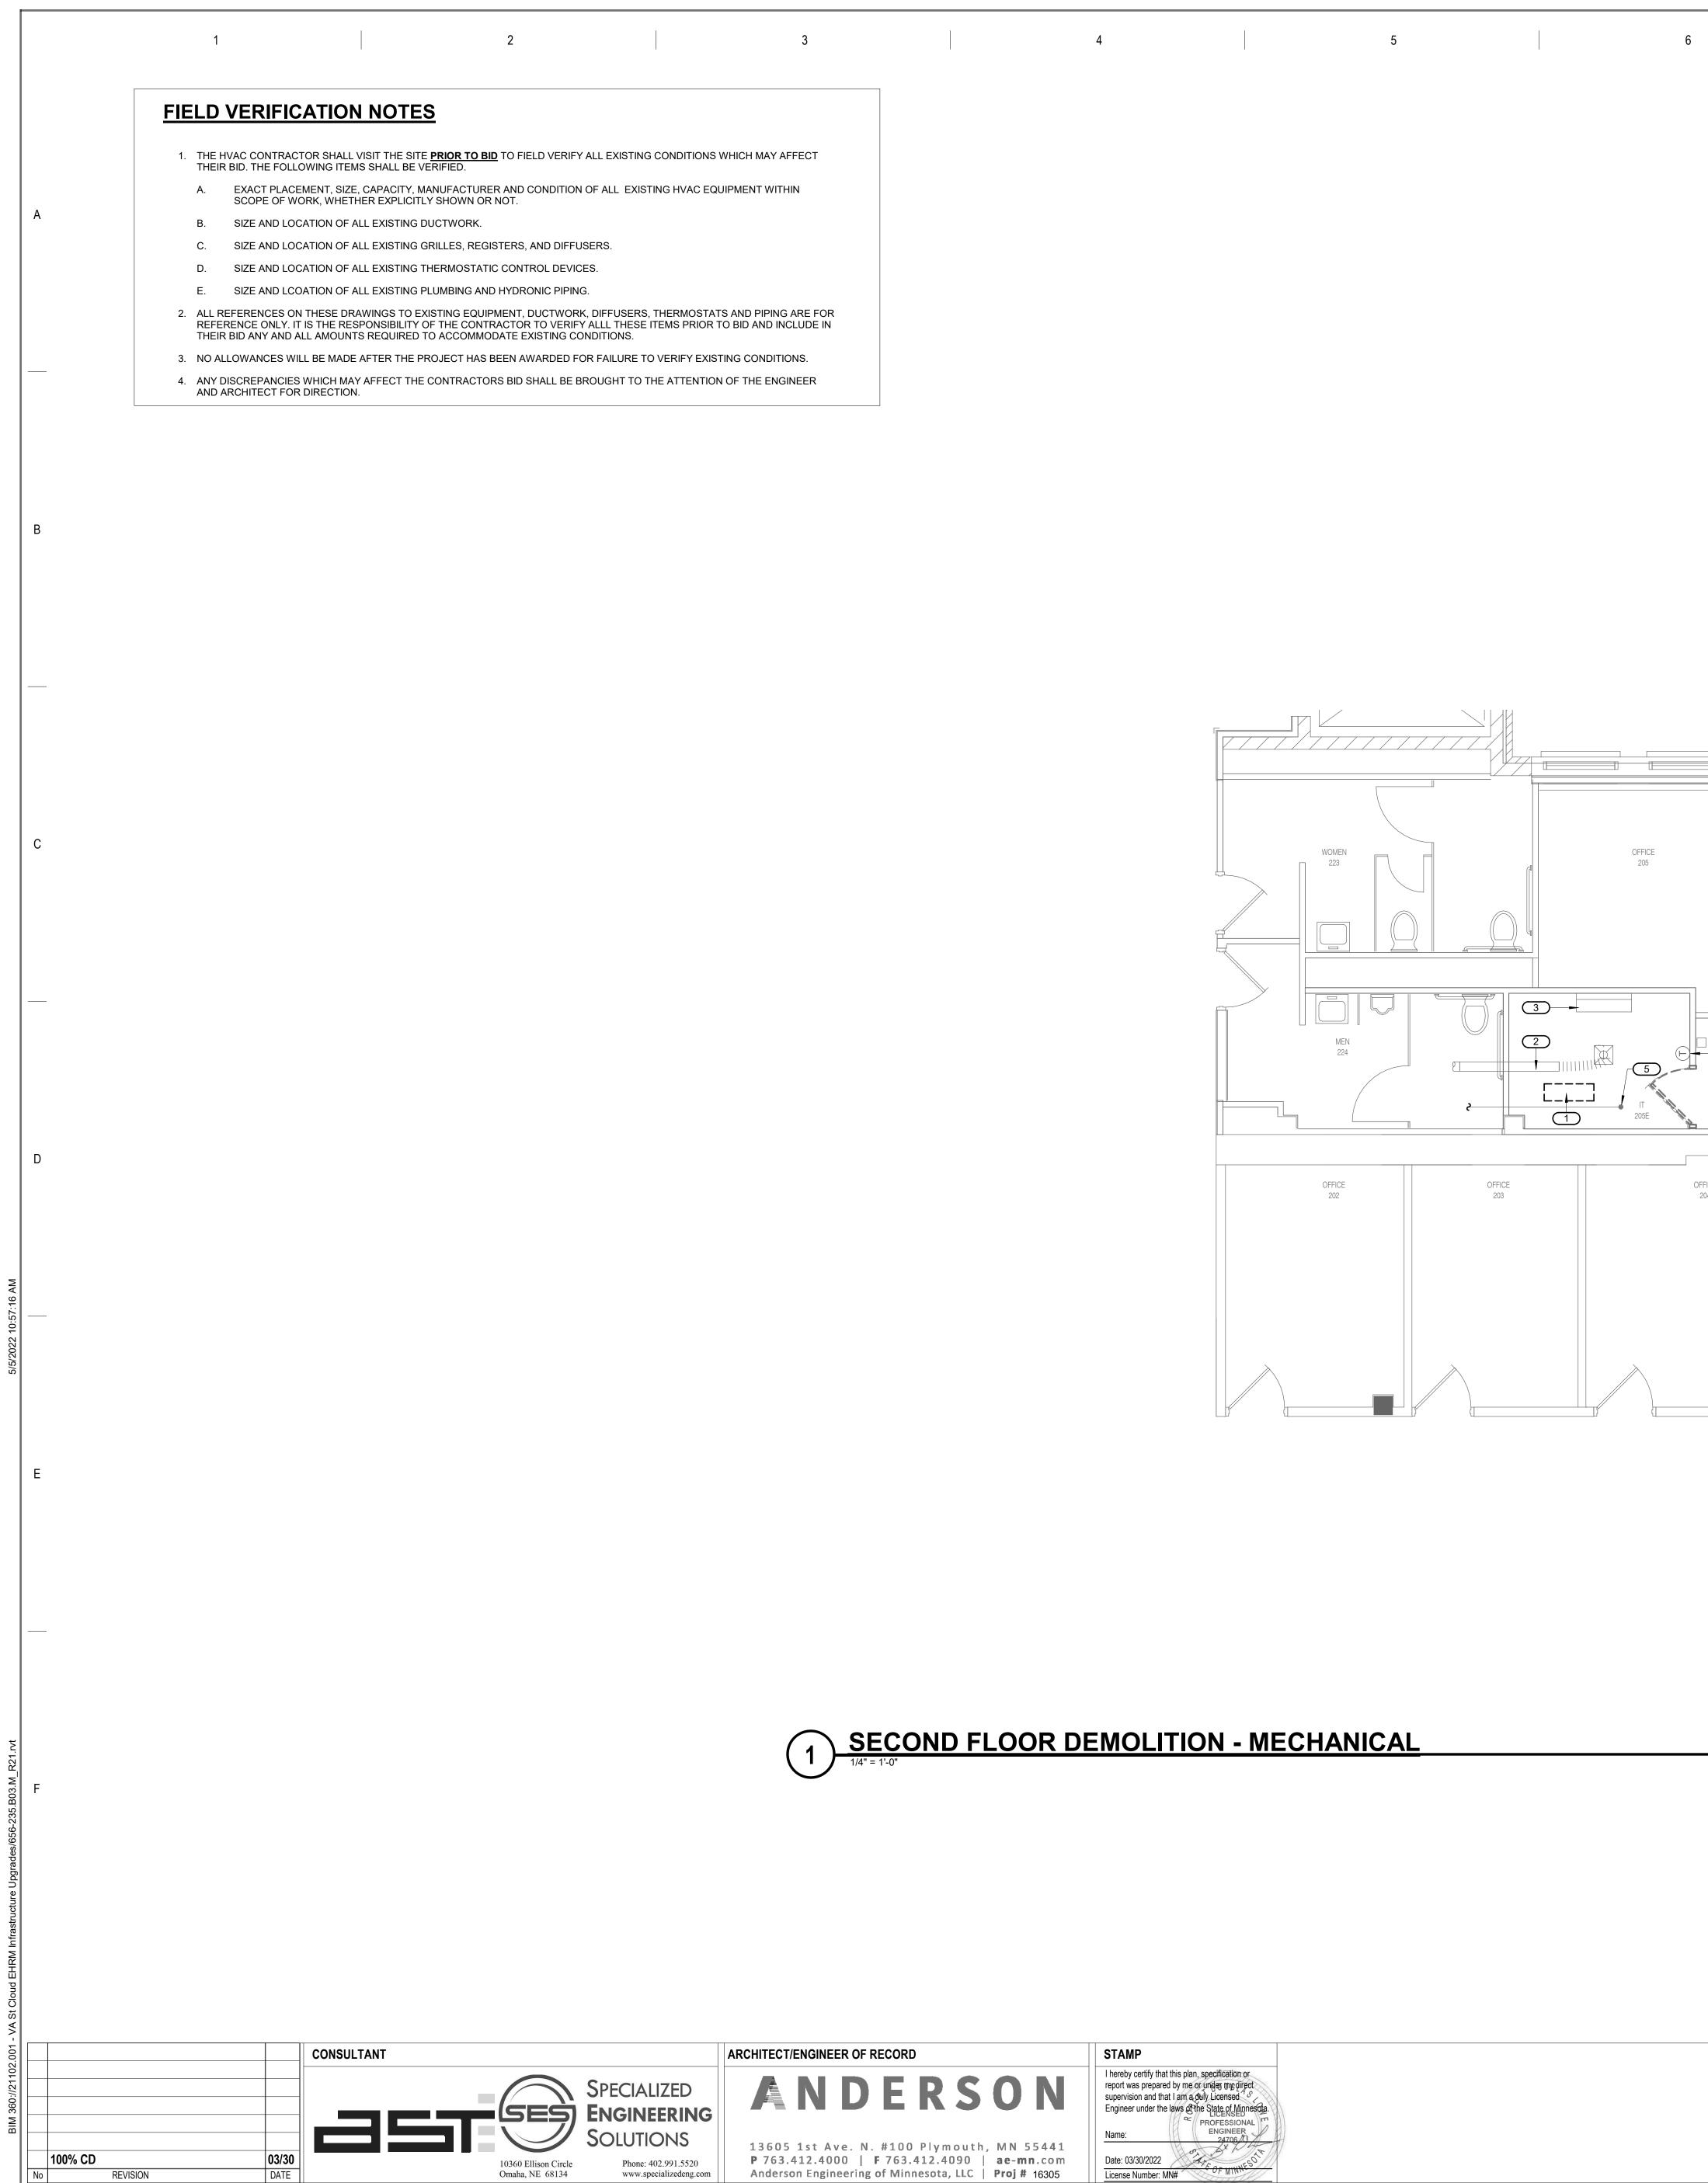

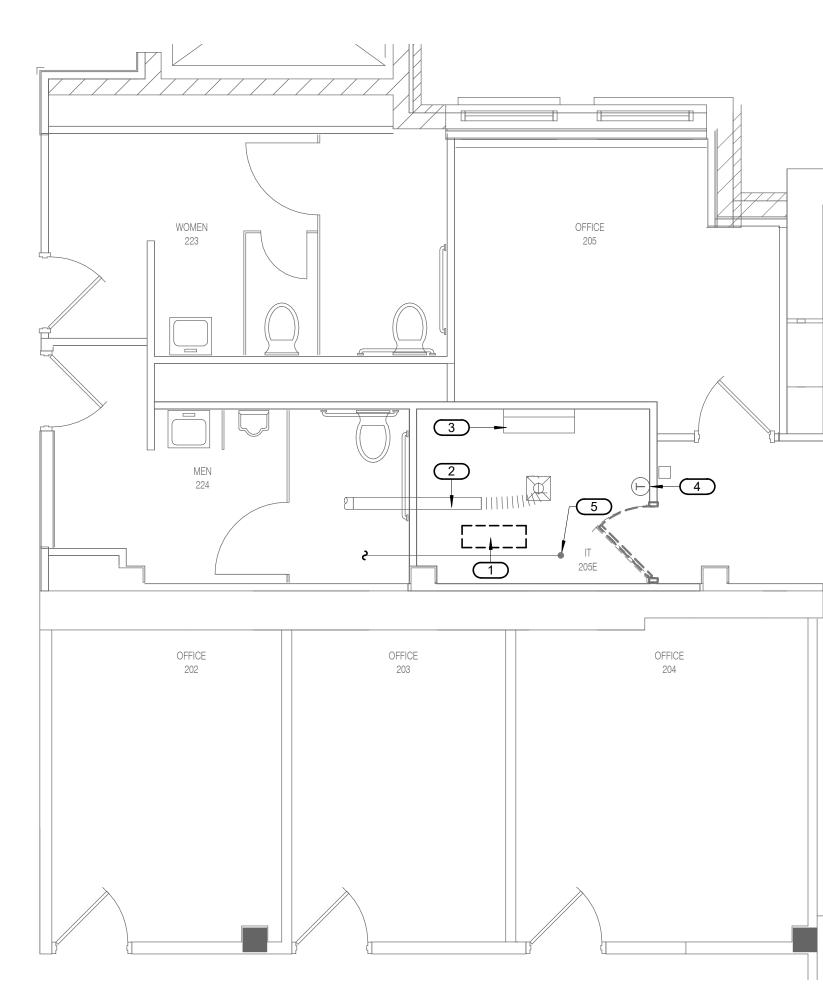SECOND FLOOR DEMOLITION - MECHANICAL

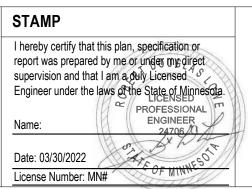


INVESTIGATION INVESTIGATION <td< th=""><th>7</th><th></th><th>8</th><th>9</th><th></th></td<>	7		8	9	
 EXISTING DATA RACK. UNIT TO BE DEMOLISHED BY OTHERS. EXISTING DIFFUSER AND DUCTWORK TO REMAIN. EXISTING SPLIT SYSTEM COOLING UNIT TO REMAIN. EXISTING THERMOSTAT TO REMAIN. 	<u>KEYNOTES 1/03-M102</u>				
 3. EXISTING SPLIT SYSTEM COOLING UNIT TO REMAIN. 4. EXISTING THERMOSTAT TO REMAIN. 			IERS.		
4. EXISTING THERMOSTAT TO REMAIN.	2. EXISTING DIFFUS	R AND DUCTWORK TO REMAIN.			
	3. EXISTING SPLIT S	STEM COOLING UNIT TO REMAIN.			
	4. EXISTING THERM	OSTAT TO REMAIN.			
	5. EXISTING FIRE SP	RINKLER HEAD AND BRANCH LINE TO	REMAIN.		




DRAWING TITLE SECOND FLOOR DEMO MECHANICAL	LITION - EHRM INFRASTRUCTURE UPGRADES		DATE: 03/30/2022 PLOT SCALE		
				PROJECT NO. 656-21-235	VA
	BUILDING No	CHECKED BY	DRAWN JCL	drawing no.	
	LOCATION VA MEDICAL ST.CLOUD, I		FULLY SPRINKLERED	DWG. OF	




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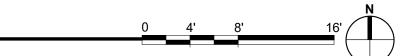
KEY	NOTES	1/03-M201:

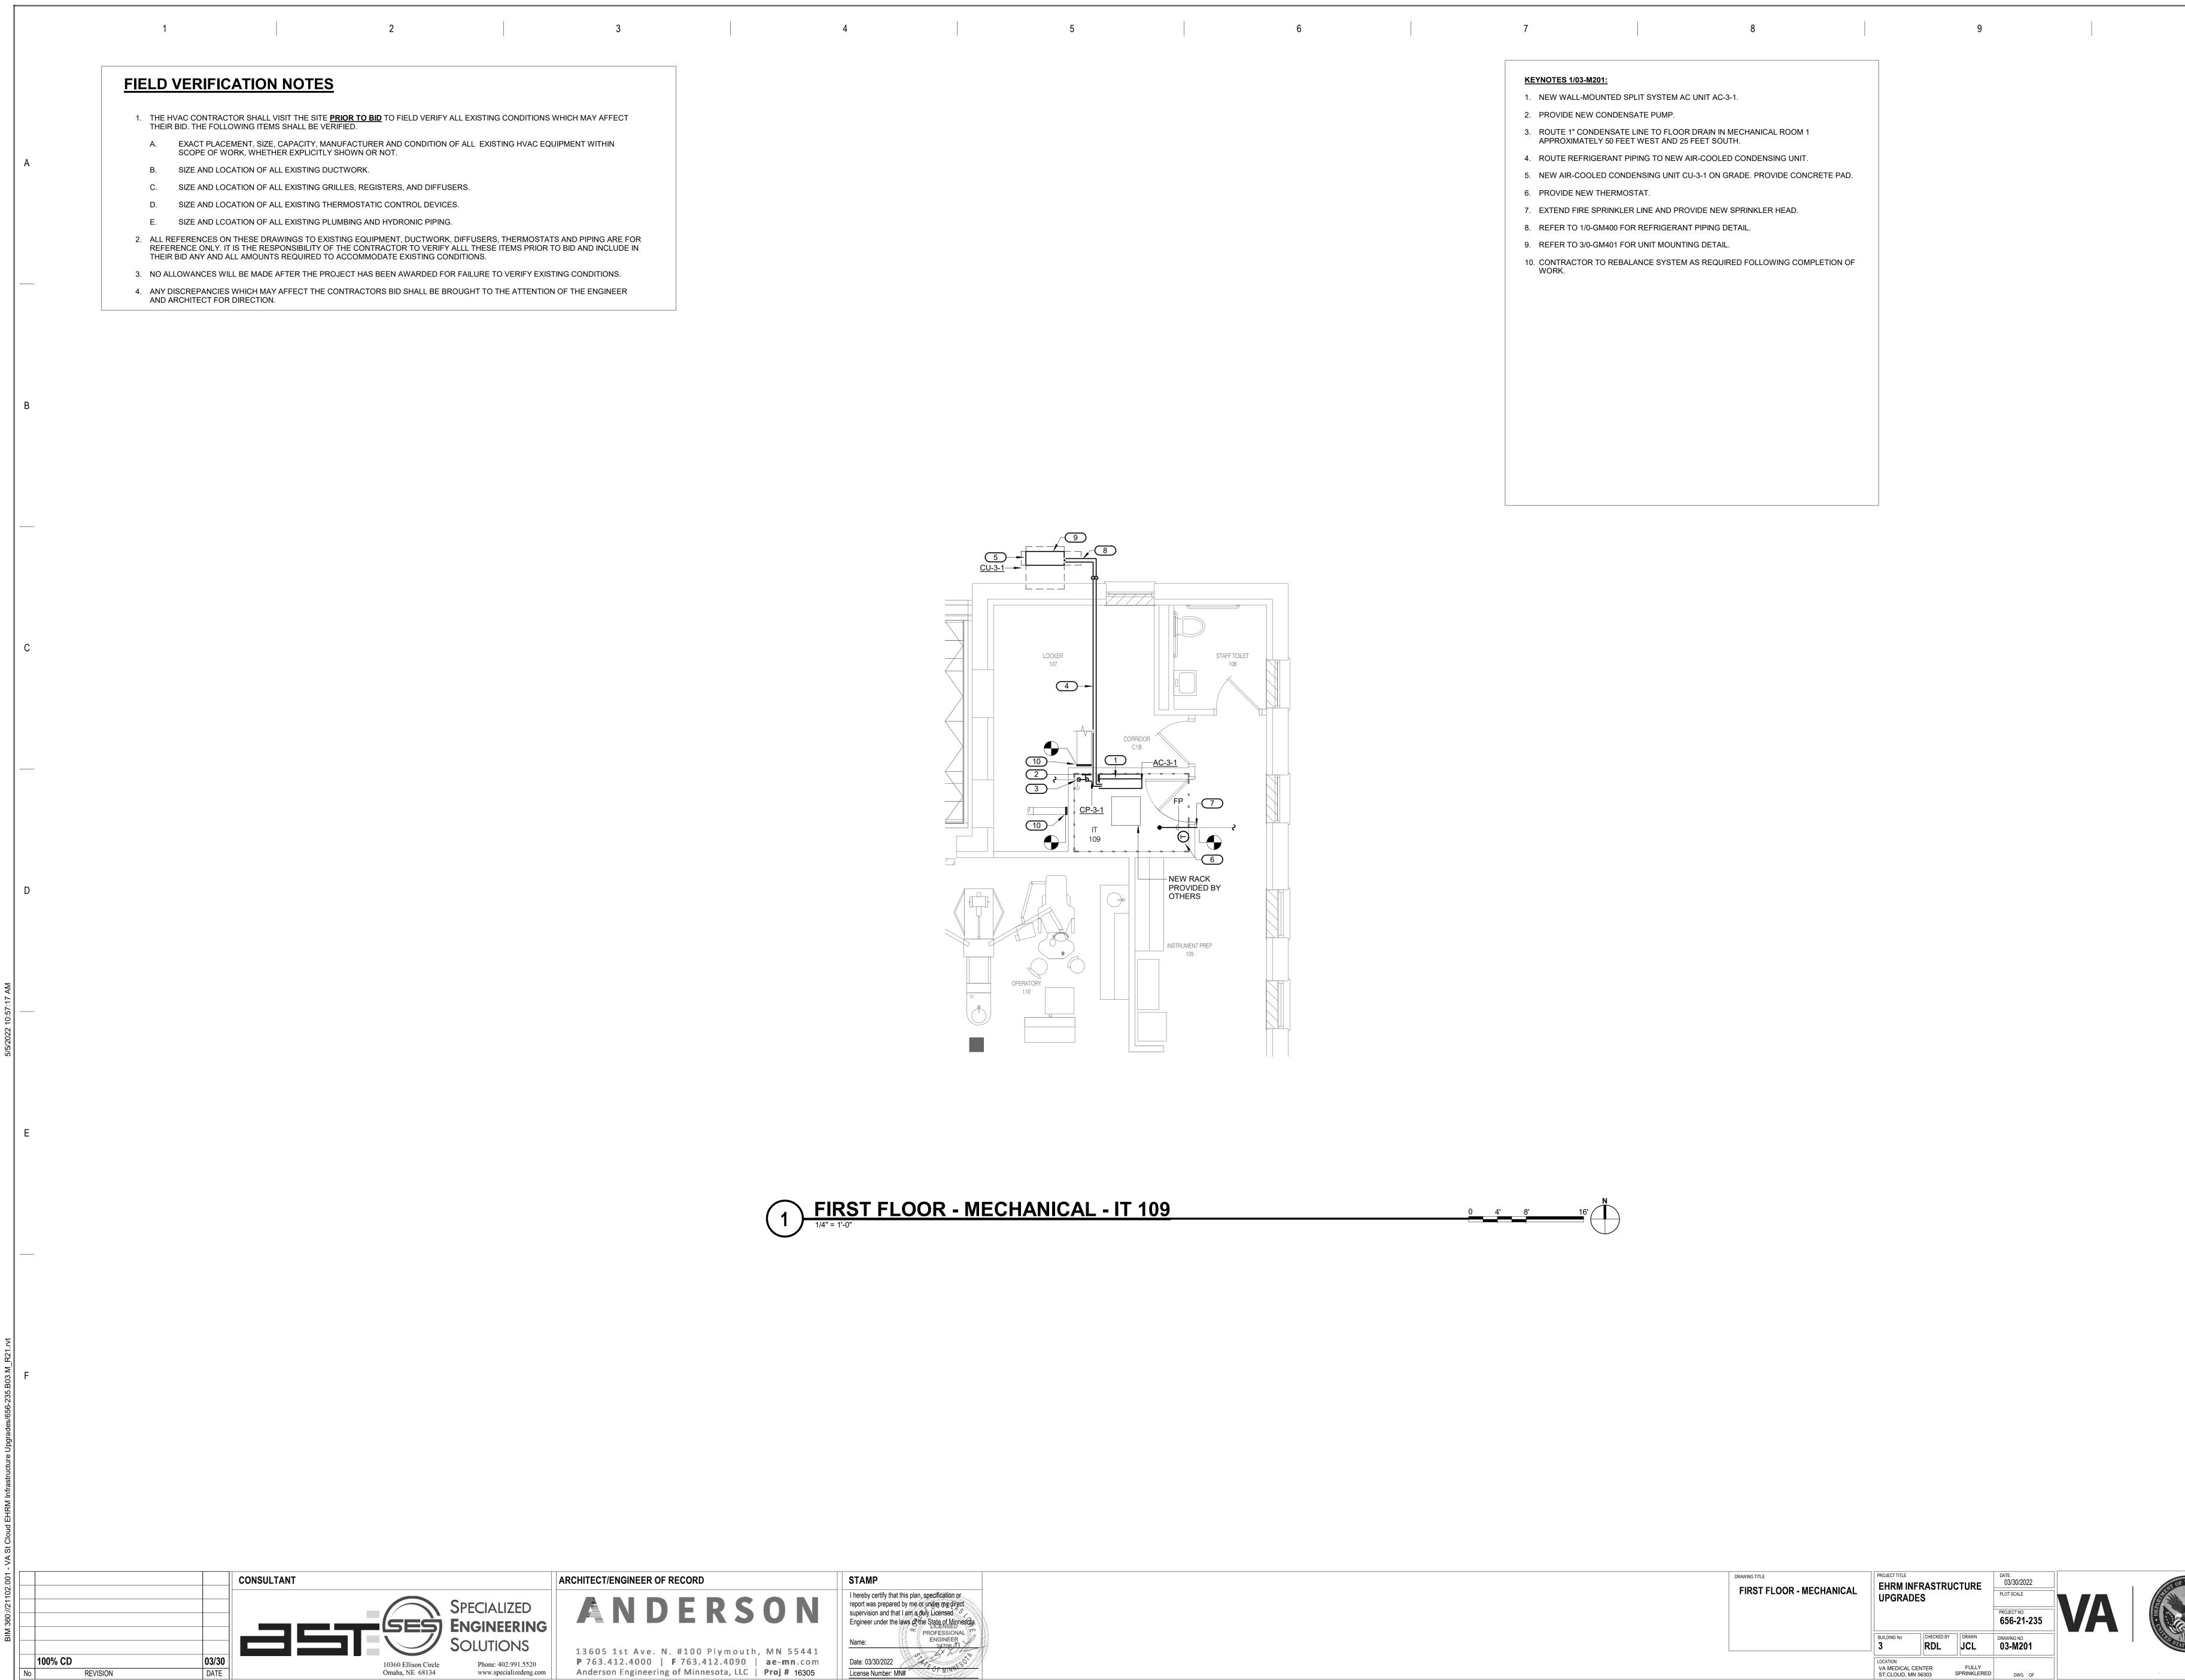- 1. NEW WALL-MOUNTED SPLIT SYSTEM AC UNIT AC-3-1.
- 3. ROUTE 1" CONDENSATE LINE TO FLOOR DRAIN IN MECHANICAL ROOM 1
- APPROXIMATELY 50 FEET WEST AND 25 FEET SOUTH.
- 4. ROUTE REFRIGERANT PIPING TO NEW AIR-COOLED CONDENSING UNIT. 5. NEW AIR-COOLED CONDENSING UNIT CU-3-1 ON GRADE. PROVIDE CONCRETE PAD.
- 6. PROVIDE NEW THERMOSTAT.

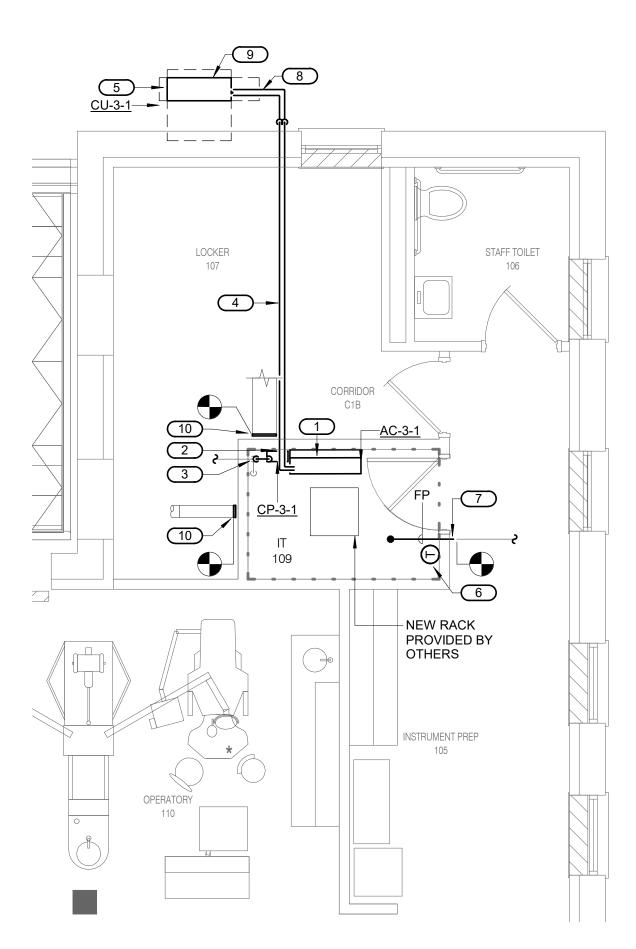2. PROVIDE NEW CONDENSATE PUMP.


- 7. EXTEND FIRE SPRINKLER LINE AND PROVIDE NEW SPRINKLER HEAD.
- 8. REFER TO 1/0-GM400 FOR REFRIGERANT PIPING DETAIL.
- 9. REFER TO 3/0-GM401 FOR UNIT MOUNTING DETAIL.
- 10. CONTRACTOR TO REBALANCE SYSTEM AS REQUIRED FOLLOWING COMPLETION OF WORK.

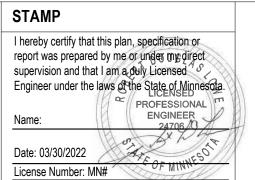
DRAWING TITLE FIRST FLOOR - MECHANICAL	EHRM INF		ICTURE	DATE: 03/30/2022 PLOT SCALE	
				PROJECT NO. 656-21-235	VA
	BUILDING No	CHECKED BY	DRAWN JCL	DRAWING NO. 03-M201	
	LOCATION VA MEDICAL CE ST.CLOUD, MN 5		FULLY SPRINKLERED	DWG. OF	




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1 SECOND FLOOR REMODEL - MECHANICAL - TELECOM 205E

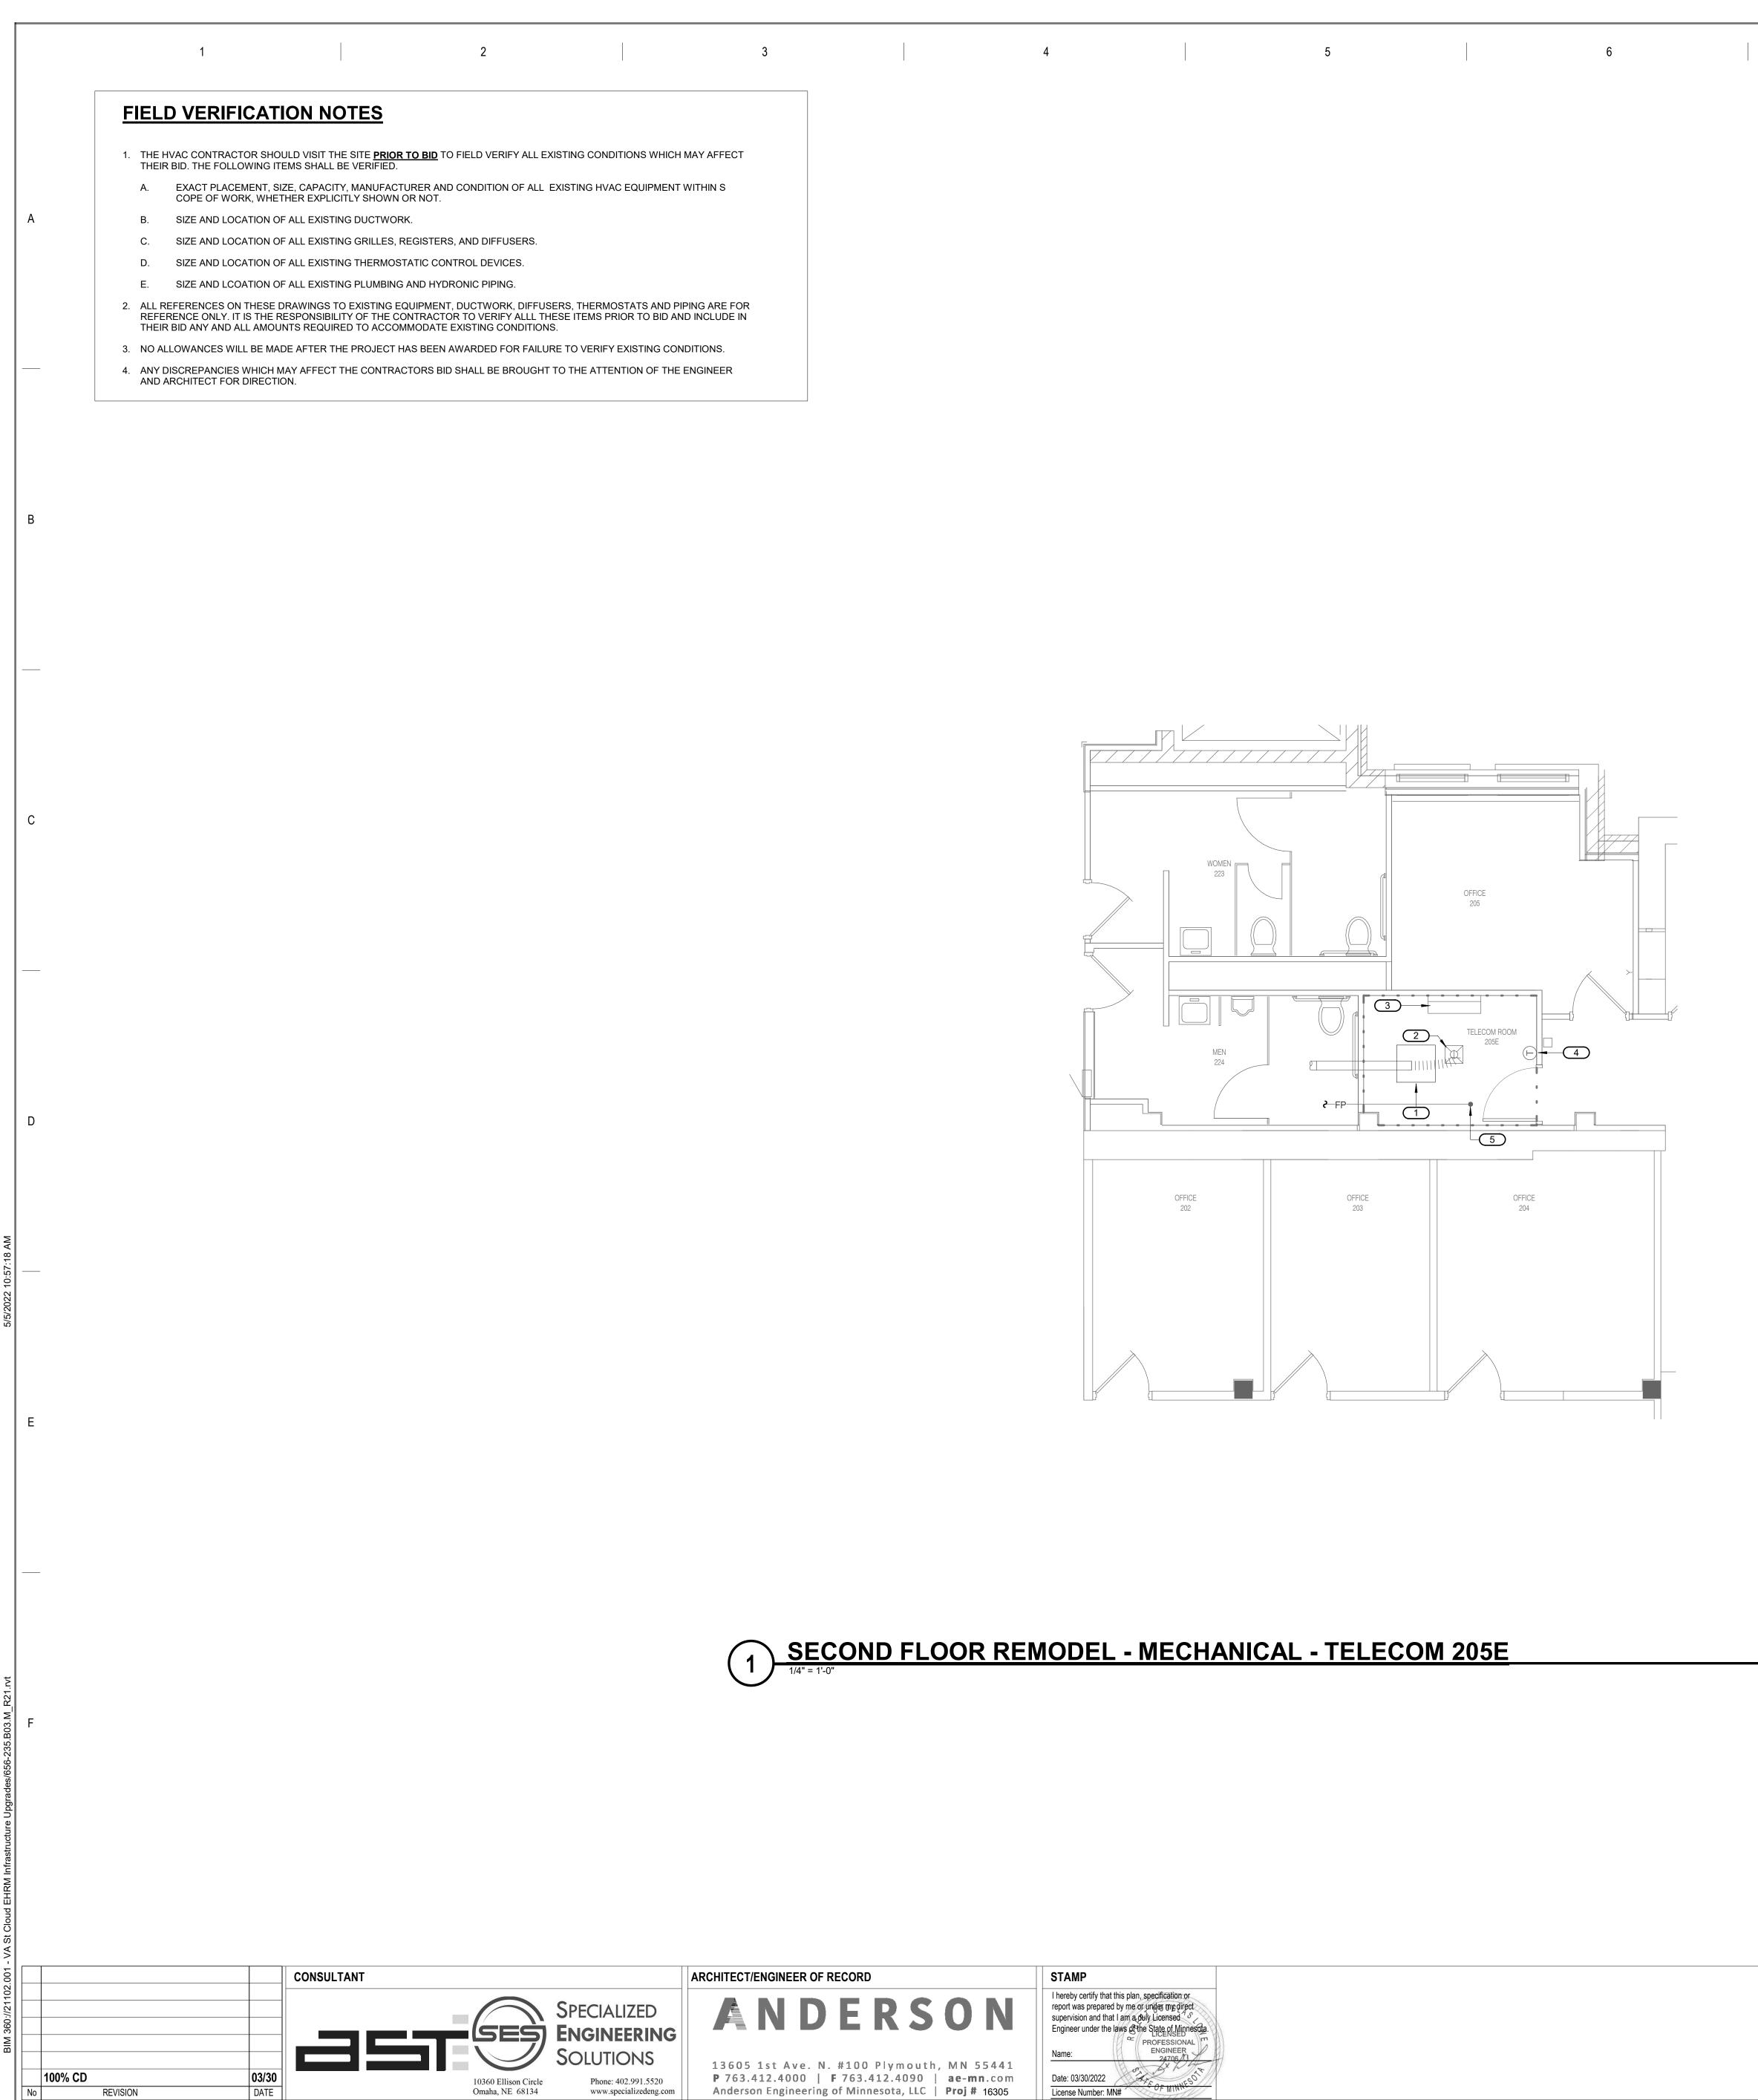

KEYNOTES LIDAHZE; 1. NEW RACK LOCATION PROVIDED BY OTHERS. 2. EXISTING SUPPLY OFFUSIER AND DUCTWORK ADJUST DUCTWORK AD MEDICID TO ACCOMMODATE NEW RACK LAVOUT. FIELD VERMENTS. 3. EXISTING SPITE SYSTEM COLLING UNT TO REMAIN. 4. EXISTING FIRE SPRINKLER HEAD AND BRANCH I.INF. ADJUST AS NEEDED TO ACCOMMODATE NEW RACK LAVOUT. FIELD VERMENTS. 5. FIXISTING FIRE SPRINKLER HEAD AND BRANCH I.INF. ADJUST AS NEEDED TO ACCOMMODATE NEW RACK LAVOUT. FIELD VERMENTS.	7	8	9	
 NEW RACK LOCATION PROVIDED BY OTHERS. EXISTING SUPPLY DIFFUSER AND DUCTWORK. ADJUST DUCTWORK AS NEEDED TO ACCOMMODATE NEW RACK LAYOUT. FIELD VERIFY REQUIREMENTS. EXISTING SPIT SYSTEM COOLING UNIT TO REMAIN. EXISTING THERMOSTAT TO REMAIN. EXISTING FIRE SPRINKLER HEAD AND BRANCH LINE. ADJUST AS NEEDED TO 	KEYNOTES 1/03-M202			
 EXISTING SUPPLY DIFFUSER AND DUCTWORK. ADJUST DUCTWORK AS NEEDED TO ACCOMMODATE NEW RACK LAYOUT. FIELD VERIFY REQUIREMENTS. EXISTING SPIT SYSTEM COOLING UNIT TO REMAIN. EXISTING THERMOSTAT TO REMAIN. EXISTING FIRE SPRINKLER HEAD AND BRANCH LINE. ADJUST AS NEEDED TO 		OVIDED BY OTHERS.		
 EXISTING THERMOSTAT TO REMAIN. EXISTING FIRE SPRINKLER HEAD AND BRANCH LINE. ADJUST AS NEEDED TO 	2. EXISTING SUPPLY DIFFUS	SER AND DUCTWORK. ADJUST DUCTWORK AS NEEDED TO		
5. EXISTING FIRE SPRINKLER HEAD AND BRANCH LINE. ADJUST AS NEEDED TO	3. EXISTING SPIT SYSTEM C	OOLING UNIT TO REMAIN.		
EXISTING FIRES SPRINKLER HEAD AND BRANCH LINE. ADJUST AS NEEDED TO ACCOMMODATE NEW RACK LAYOUT. FIELD VERIFY REQUIREMENTS.	4. EXISTING THERMOSTAT 7	TO REMAIN.		
	5. EXISTING FIRE SPRINKLE ACCOMMODATE NEW RA	R HEAD AND BRANCH LINE. ADJUST AS NEEDED TO CK LAYOUT. FIELD VERIFY REQUIREMENTS.		

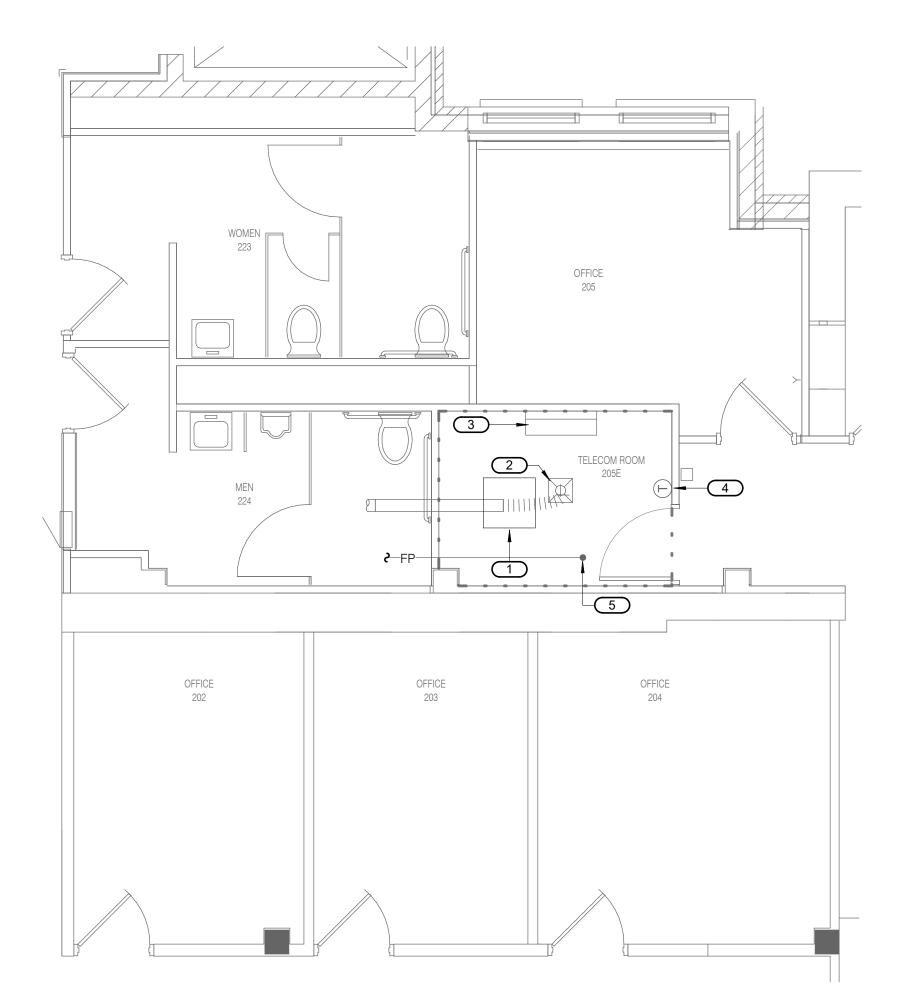DRAWING TITLE SECOND FLOOR REMODEL - MECHANICAL				DATE: 03/30/2022 PLOT SCALE PROJECT NO. 656-21-235	
	BUILDING No	CHECKED BY	DRAWN JCL	DRAWING NO. 03-M202	
	LOCATION VA MEDICAL CE ST.CLOUD, MN		FULLY SPRINKLERED	DWG. OF	

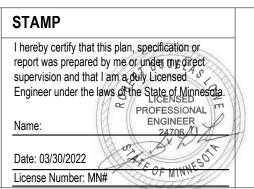

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