
BUILDING 116 - EHRM INFRASTRUCTURE UPGRADES

St. Cloud VA Health Care System Main Campus, St. Cloud, Minnesota

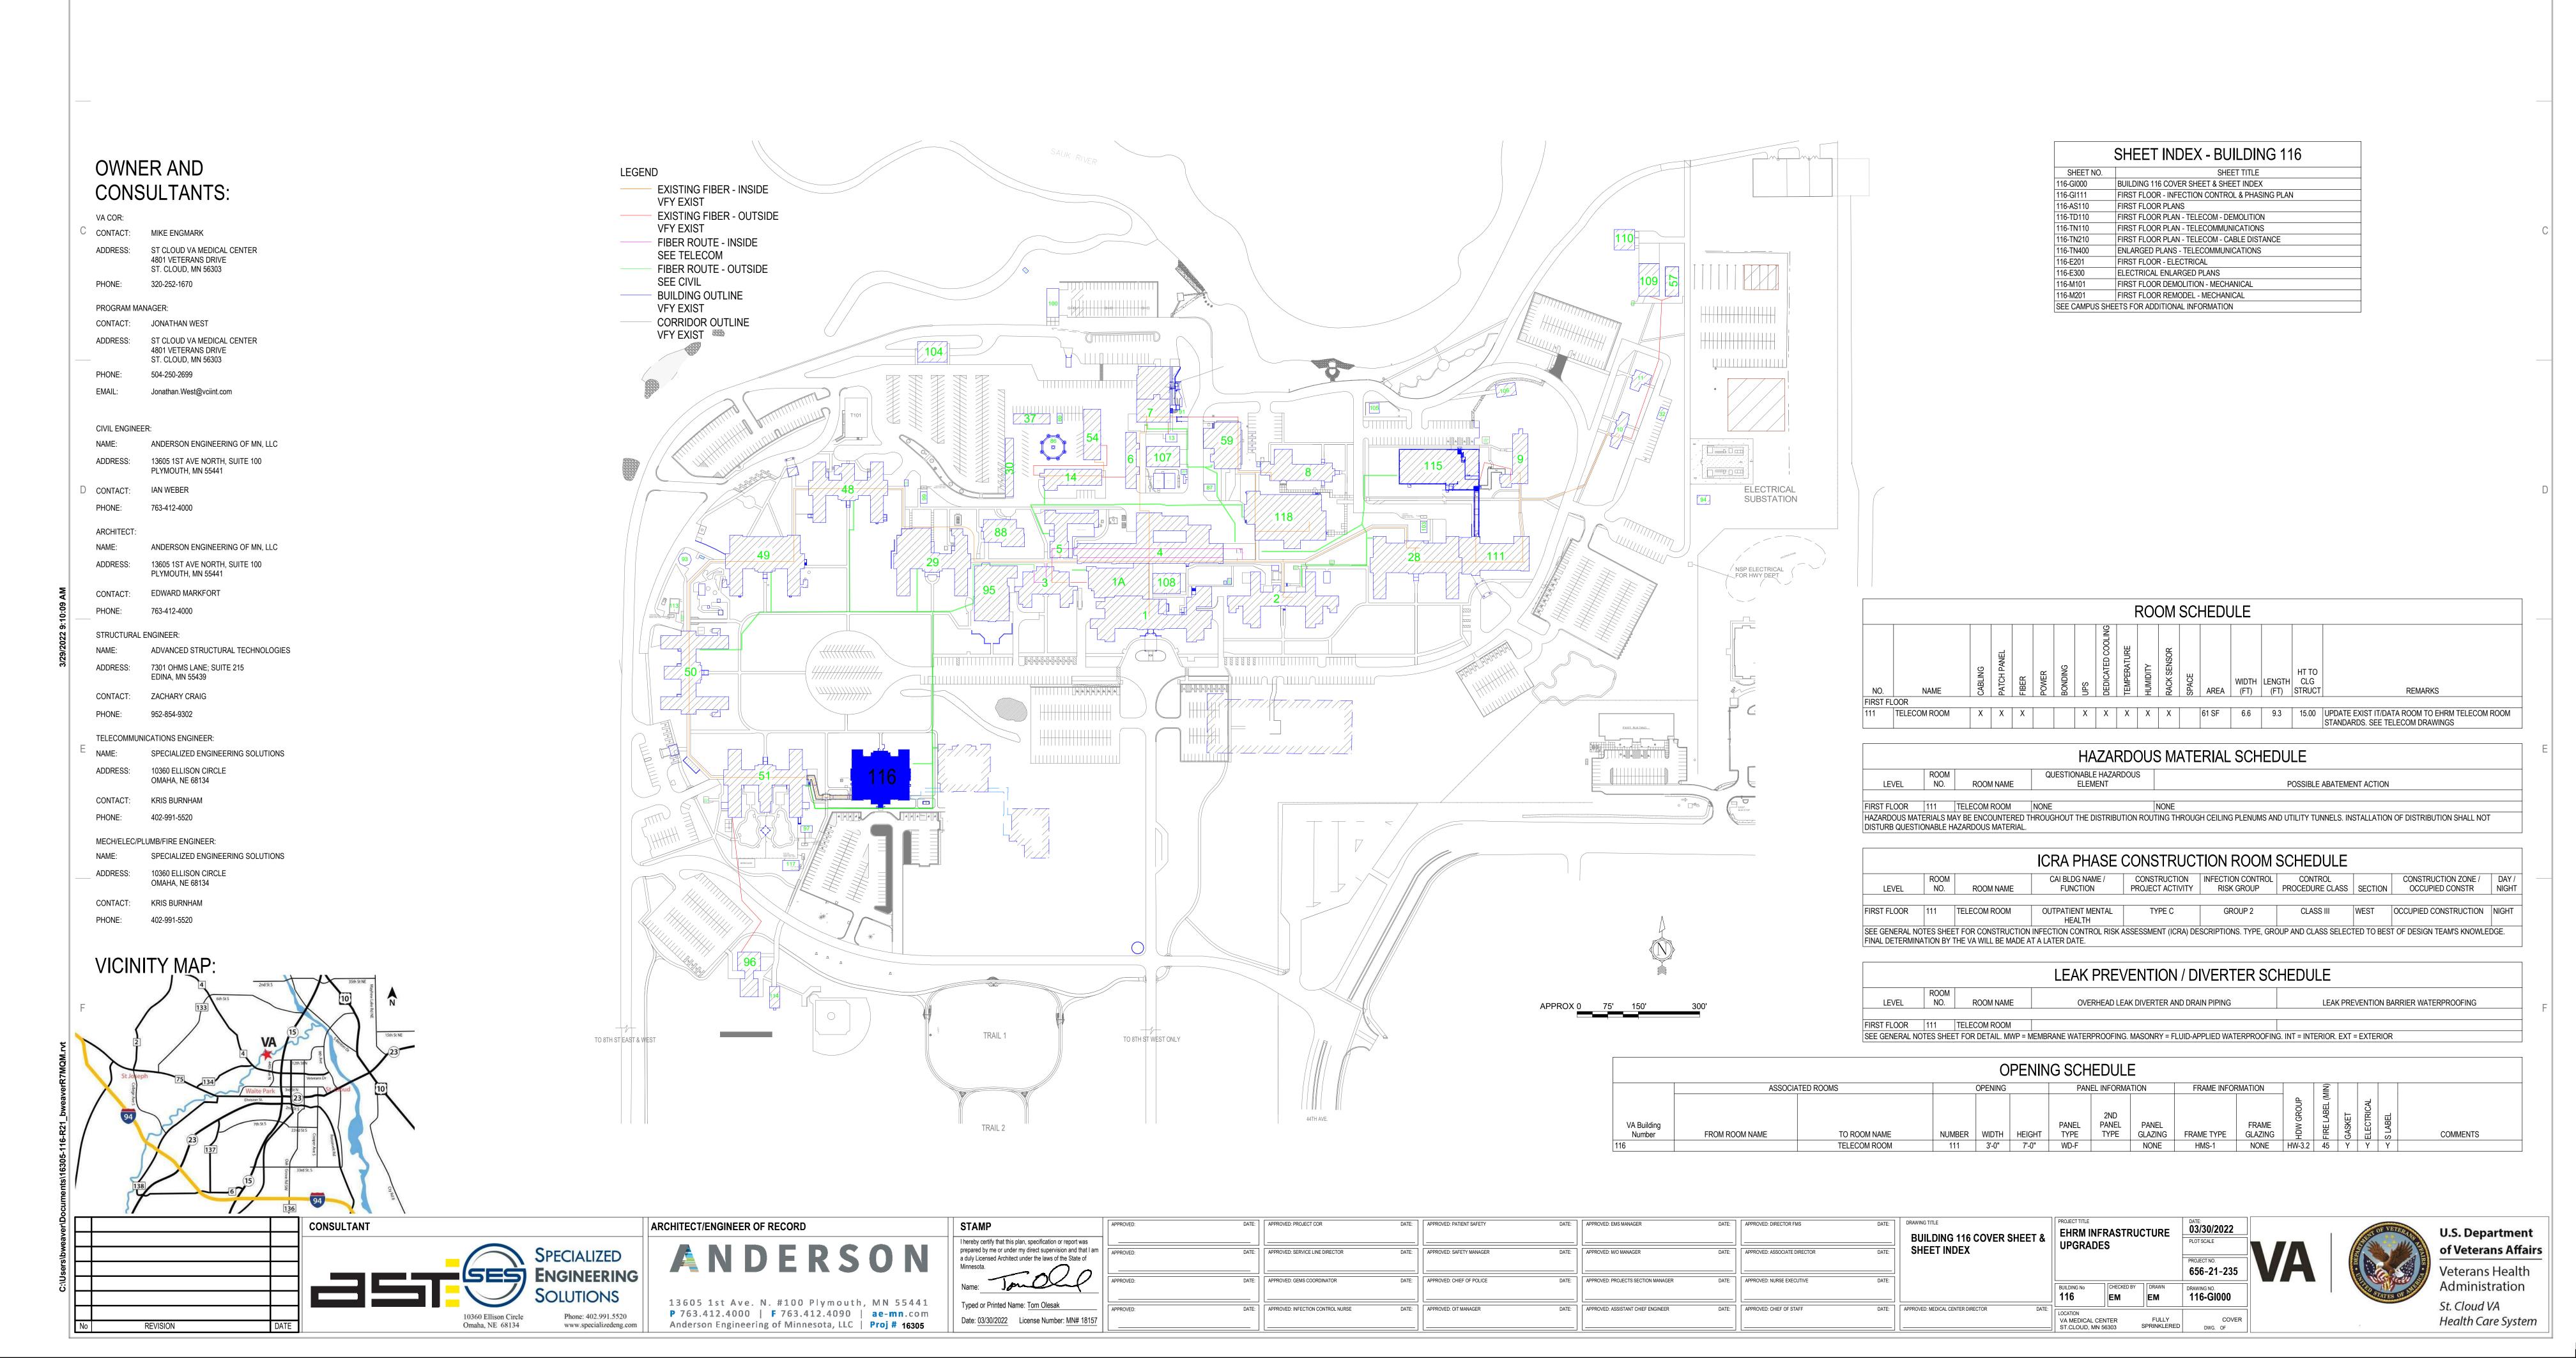

GROUP MTG ROOM PT GYM EQUIP STORAGE REF. ODW TREATMENT ROOM 4 TREATMENT ROOM 3 SOILED LINEN ELECTRICAL 114 ELECTRICAL CONSULTATION ROOM MECHANICAL 110

ROOM ICRA SCHEDULE CAI BLDG NAME / FUNCTION CONSTRUCTION PROJECT ACTIVITY INFECTION CONTROL RISK GROUP CONTROL PROCEDURE CLASS FIRST FLOOR 111 TELECOM ROOM OUTPATIENT MENTAL HEALTH TYPE C GROUP 2 CLASS III
SEE GENERAL NOTES SHEET FOR CONSTRUCTION INFECTION CONTROL RISK ASSESSMENT (ICRA) DESCRIPTIONS. TYPE, GROUP AND CLASS SELECTED TO BEST OF DESIGN TEAM'S KNOWLEDGE.
FINAL DETERMINATION BY THE VA WILL BE MADE AT A LATER DATE.

INFECTION CONTROL RISK ASSESSMENT (ICRA) LEGEND

THE LOTTON CONTINUE MICHAEL MONTH (10101) LECEND	
	LIMITS OF CONSTRUCTION
	1 HOUR FIRE RATED ICRA / CONSTRUCTION BARRIER LOCATION, AND DOOR, WHERE SHOWN
	TEMPORARY NON-RATED (PLASTIC SHEETING) CONSTRUCTION BARRIER LOCATION, WHERE APPROVED BY THE VA FOR USE IN RISK TYPE B. UPGRADE TO 1 HOUR RATED PARTITION WHEN DIRECTED BY THE VA

γ FIRST FLOOR - CONST BARRIER PLAN



 2
 4

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FIRST FLOOR - INFECTION CONTROL & PHASING PLAN


EHRM INFRASTRUCTURE


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_DEMOLITION PLAN KEYED NOTES

- DE1 PREPARE WALL FOR PLYWOOD BACKBOARD INSTALLATION AND EHRM REQUIREMENTS, SEE FLOOR PLAN AND TELECOM DRAWINGS
- REMOVE AND SALVAGE DOOR. PREPARE OPENING FOR DOOR WITH IMPROVED SECURITY. SEE FLOOR PLAN AND DOOR SCHEDULE

NOTE: NOT ALL KEYED NOTES MAY BE USED ON EACH PLAN

_FLOOR PLAN KEYED NOTES

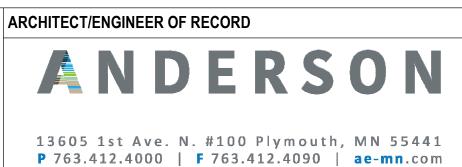- ALL FOUR PERIMETER WALL PARTITIONS APPLY 4' BY 8' AC GRADE 3/4" TRADE SIZE FIRE RATED PLYWOOD BACKBOARD FINISHED WITH HIGH-GLOSS WHITE PAINT OVER TWO COATS OF FIRE RESISTANT PAINT FOR SERVICE PROVIDER / SECURITY / VIDEO / ET CETERA. DO NOT PAINT OVER FIRE RATING STAMP.
- FL2 DOOR, SIZE AS SCHEDULED, FIRE RESISTANT AS SCHEDULED
- FL3 UPGRADE PARTITION TO 1 HOUR FIRE AND SMOKE BARRIER. PROVIDE TESTED HEAD OF PARTITION ASSEMBLY WITH MATERIALS THAT RESIST THE PASSAGE OF SMOKE. SEAL JOINT AT HEAD AND ALL PENETRATIONS WITH FIRE CAULK.
- FL4 PATCH TO MATCH FINISHES DISTURBED BY CONSTRUCTION TO MATCH EXISTING; FLOOR AND WALL. CONTRACTOR TO PROVIDE LABOR AND
- FL20 TELECOM EQUIPMENT, SEE TELECOM DRAWINGS.

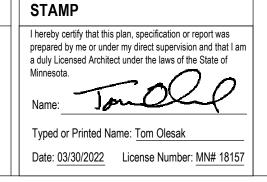NOTE: NOT ALL KEYED NOTES MAY BE USED ON EACH PLAN


REFLECTED CEILING PLAN KEYED NOTES

- RC1 LED LIGHTING, SEE ELECTRICAL. IN FRONT OF AND BEHIND CABINET ROWS PROVIDE 500 LUMENS IN HORIZONTAL AND 200 LUMENS IN THE VERTICAL AT 3 FT AFF. OPERATED BY MOTION SENSOR PER CABINET ROW OR SECTION.
- RC2 OPEN TO STRUCTURAL FLOOR ABOVE


NOTE: NOT ALL KEYED NOTES MAY BE USED ON EACH PLAN


SHEET NOTES


- SEE GENERAL NOTES AND CAMPUS DRAWINGS FOR GENERAL INFORMATION, LIFE SAFETY, ICRA, AND PHASING
- ALL EXISTING CONDITIONS MUST BE FIELD VERIFIED BY THE CONTRACTOR PRIOR TO DEMOLITION OR CONSTRUCTION. EXISTING CONDITIONS THAT DIFFER FROM THOSE SHOWN MUST BE BROUGHT TO THE ATTENTION OF THE C.O.R. TO INFORM THE ARCHITECTS AND ENGINEERS.
- THE INFORMATION SHOWN ON THE DRAWINGS IS BASED ON DRAWINGS AND PHOTOGRAPHS PROVIDED BY THE C.O.R. COMBINED WITH OBSERVATIONS AND SURVEYED DATA FROM THE ARCHITECTS AND
- SEE CIVIL, STRUCTURAL, TELECOM, ELECTRICAL, MECHANICAL, AND PLUMBING DRAWINGS AND SPECIFICATIONS FOR ADDITIONAL DEMOLITION AND CONSTRUCTION REQUIREMENTS.
- PORTABLE FIRE EXTINGUISHERS (CO2 OR HALOGENATED TYPE AS DETERMINED BY THE VA) WITH WALL MOUNT BRACKET AND CODE REQUIRED SIGNAGE SHALL BE PROVIDED BY THE CONTRACTOR WITHIN TELECOM ROOMS.

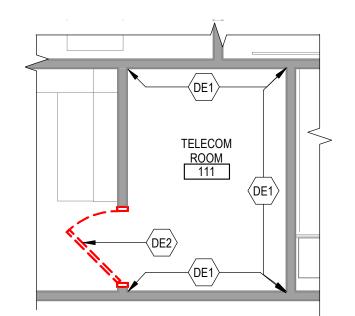




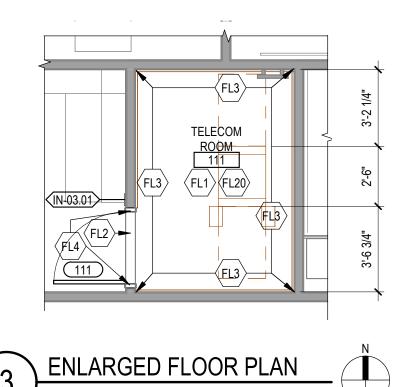

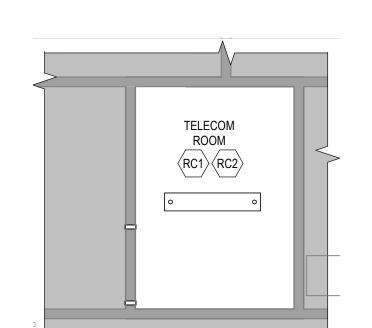

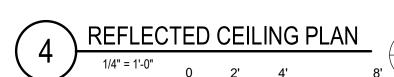

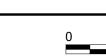




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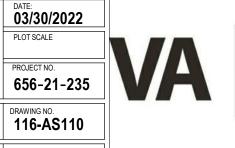
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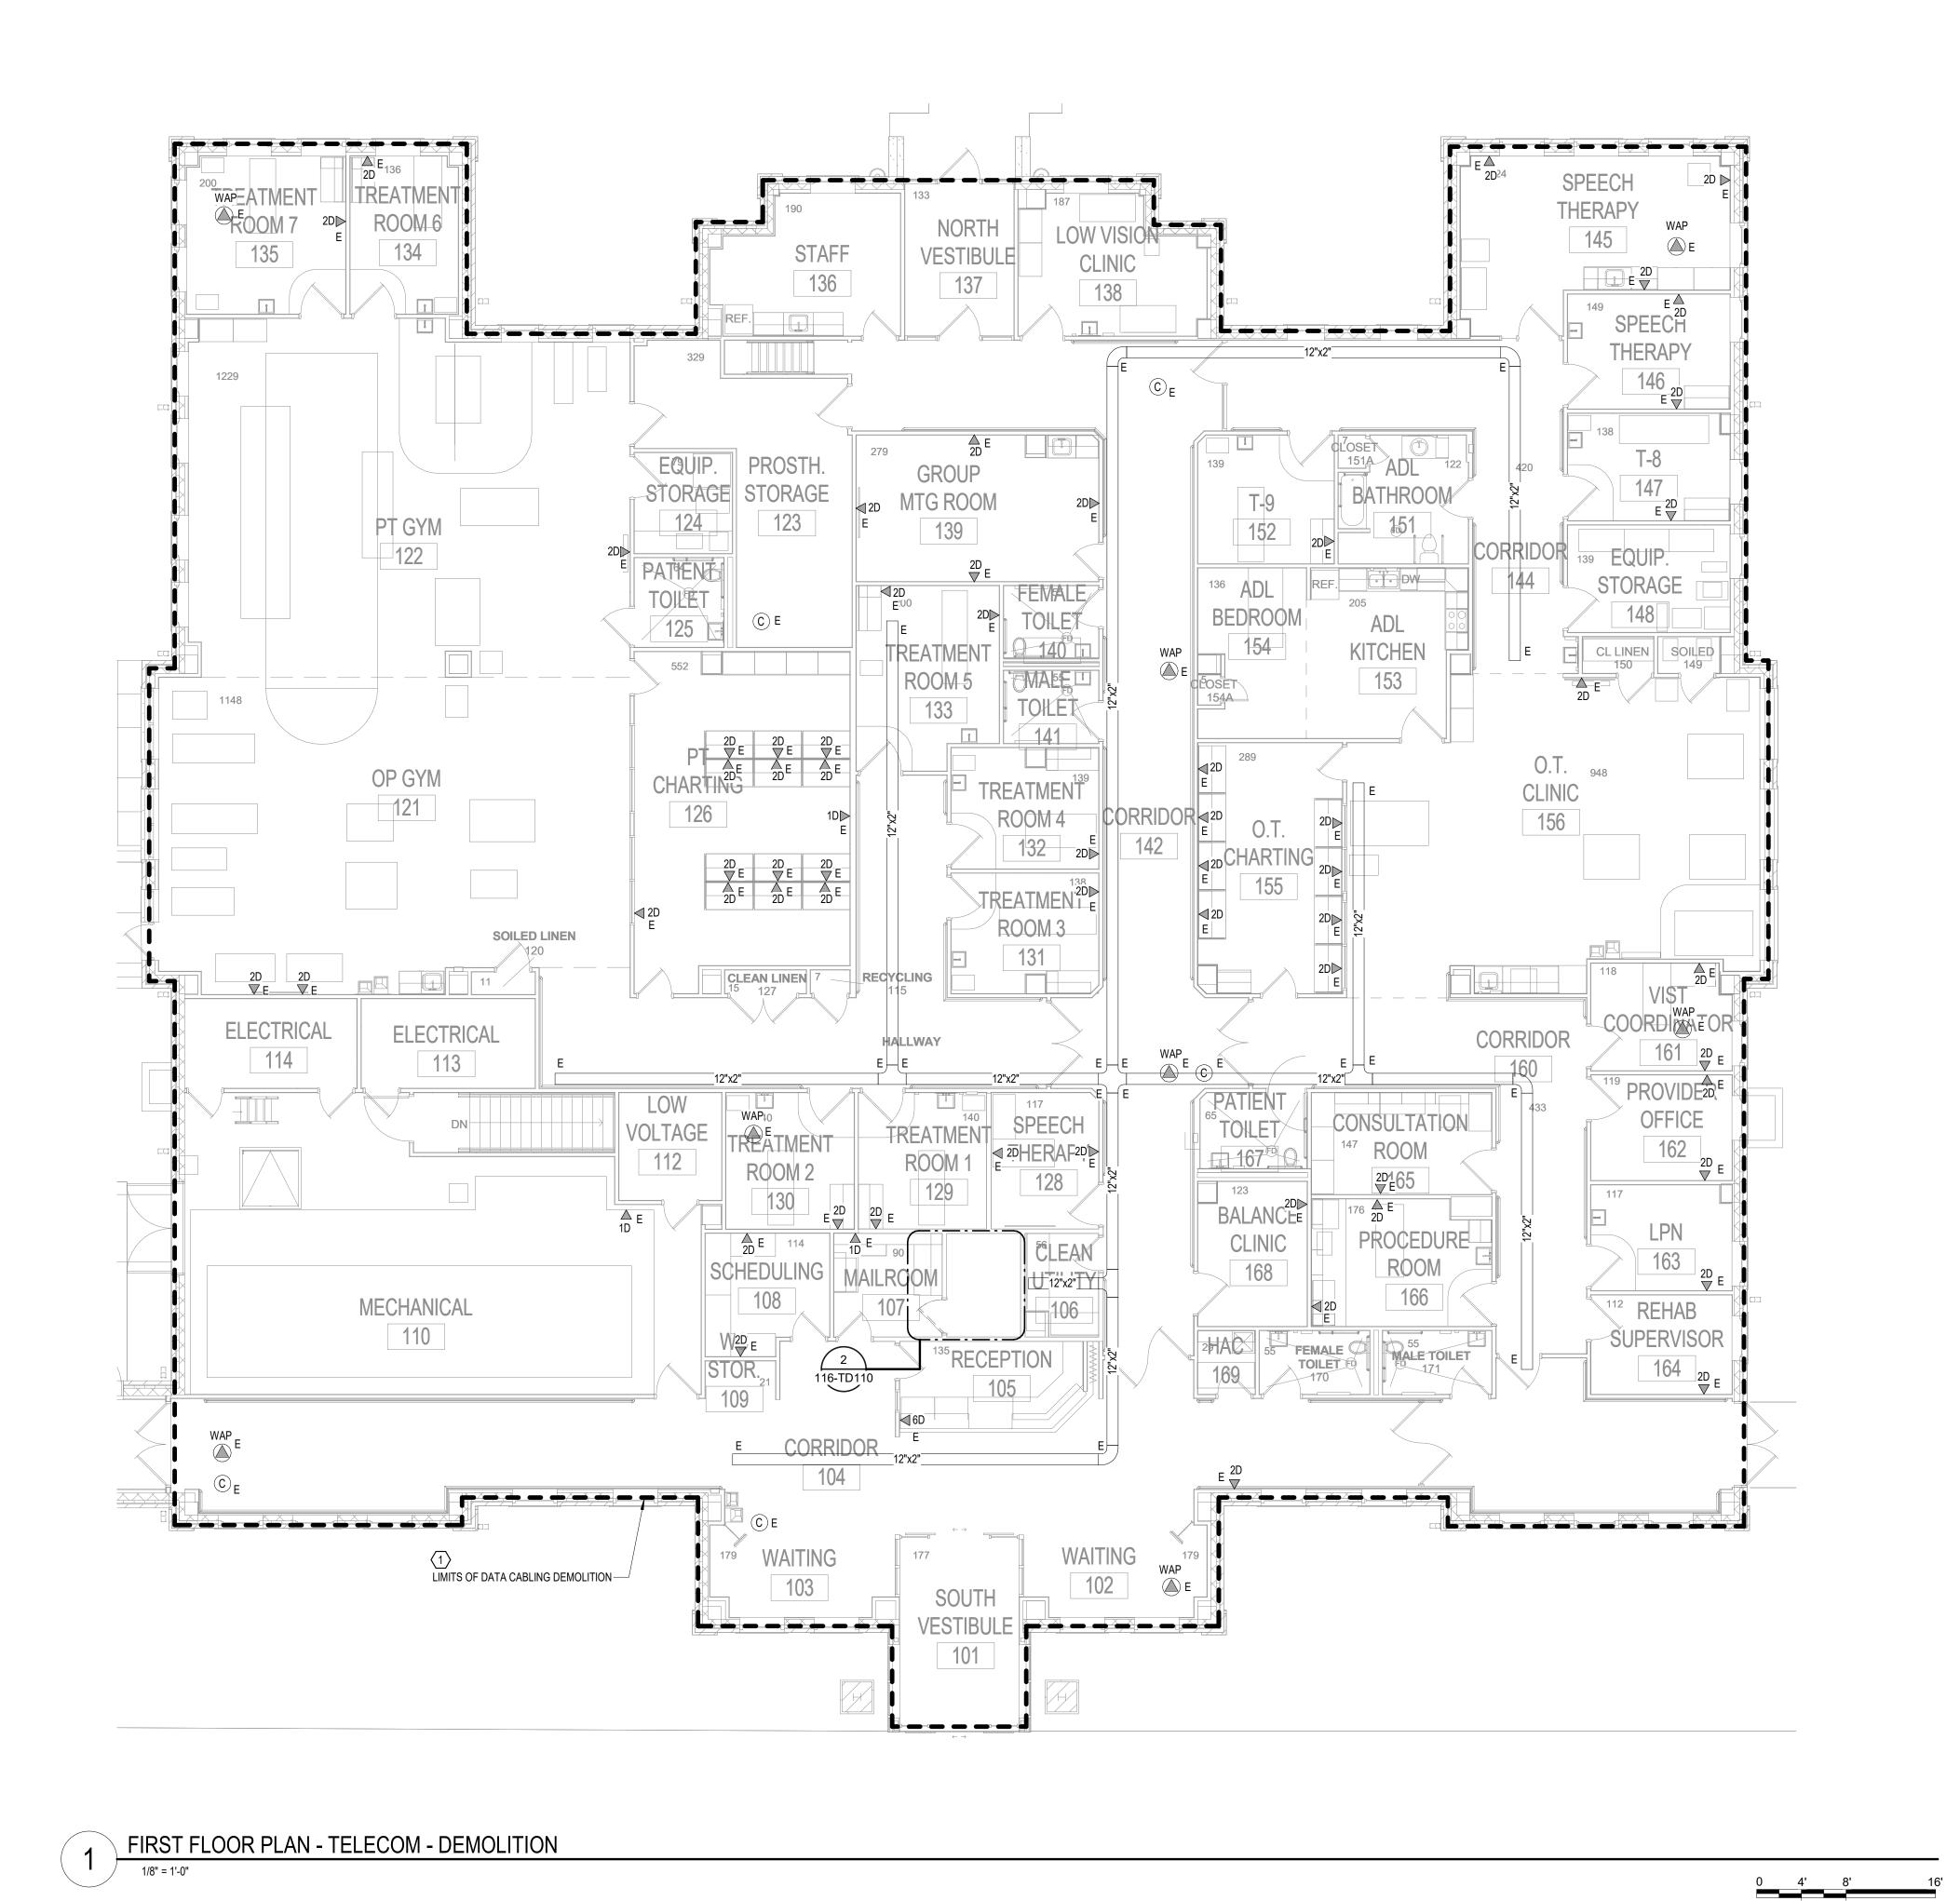


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GENERAL NOTES:

A. REFER TO GENERAL DEMOLITION NOTES ON SHEET T000 FOR ADDITIONAL DEMOLITION SCOPE.

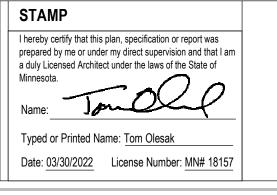SHEET NOTES:

1. EXISTING TELECOMMUNICATIONS CAGE AND RACK SHALL BE INCLUDED WITHIN THE SCOPE OF DEMOLITION. EXISTING CABLING AND ASSOCIATED OUTLETS SHALL BE REMOVED AND REPLACED 1 FOR 1 AND REFED FROM DISTRIBUTION EQUIPMENT LOCATED WITHIN THE NEW TELECOMMUNICATIONS ROOM. REFER TO GENERAL CABLING NOTES FOR APPROXIMATE QUANTITIES. REFER TO NEW WORK PLANS FOR SERVING COMMUNICATIONS ROOM LOCATION AND NEW CABLING ROUTES.

CABLING NOTE:

CABLING NOTES: A. THE EXISTING CABLE COUNT ARE THE CABLES CURRENTLY PRESENT IN THE SPACE. THE CABLE RELOCATION COUNT ARE THE NEW OR RELOCATED CABLES TO BE FED FROM THE SPACE. THE FINAL CABLE COUNT ARE THE CABLES THAT WILL BE PRESENT IN THE SPACE AT THE COMPLETION OF THE

ROOM 111 EXISTING CABLE COUNT DATA (CAT6): 0

DATA (CAT5e): 114 DATA (CAT5): 0

DATA (CAT3): 0

CABLE RELOCATION COUNT DATA (CAT6): 0 DATA (CAT5e): 0

DATA (CAT5): 0 DATA (CAT3): 0

EXISTING CABLE TO REMAIN DATA (CAT6): 0 DATA (CAT5e): 0

DATA (CAT5): 0 DATA (CAT3): 0


FINAL CABLE COUNT DATA (CAT6): 0


DATA (CAT5e): 0 DATA (CAT5): 0 DATA (CAT3): 0

2 ENLARGED PLAN - EXIST RM 111 - TELECOM - DEMO



REVISION

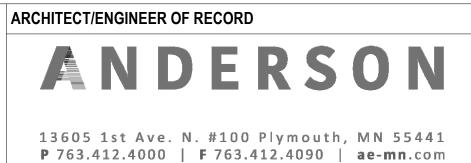

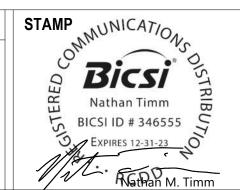

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1 2 5

GENERAL NOTES:

A. REFER TO GENERAL NOTES ON SHEET T000 FOR ADDITIONAL SCOPE.

SHEET NOTES:

- CONTRACTOR TO PROVIDE NEW WIRE BASKET OF EQUAL SIZE AND DISTANCE, EITHER BESIDE OR BELOW THE EXISTING CABLE TRAY, TO MATCH THE EXISTING TELECOM CABLE TRAY. NEW HORIZONTAL CABLE, NEW COPPER BACKBONE, AND B SIDE FIBER ARE TO BE RUN IN THE NEW WIRE
- 2. PROVIDE JUNCTION BOX TO CONNECT FIBER CONDUIT ENTRY TO EXTEND CONDUIT PATHWAY TO THE NEW TELECOM ROOM.

1 FIRST FLOOR PLAN - TELECOMMUNICATIONS

1/8" = 1'-0"

Phone: 402.991.5520

www.specializedeng.com

8' 16'

SPECIALIZE ENGINEER SOLUTION

Omaha, NE 68134


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ARCHITECT/ENGINEER OF RECORD

AND ERSON

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PROJECT TITLE

EHRM INFRASTRUCTURE

UPGRADES

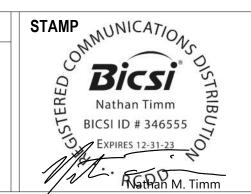BUILDING No 116

LOCATION


VA MEDICAL CENTER

ST.CLOUD, MN 56303

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| CHECKED BY KSB | DRAWN SSK | DRAWING NO. | 116-TN110 | CHECKED BY KSB | DRAWN SSK | DRAWING NO. | 116-TN110 | CHECKED BY KSB | DRAWN SSK | DRAWN SSK



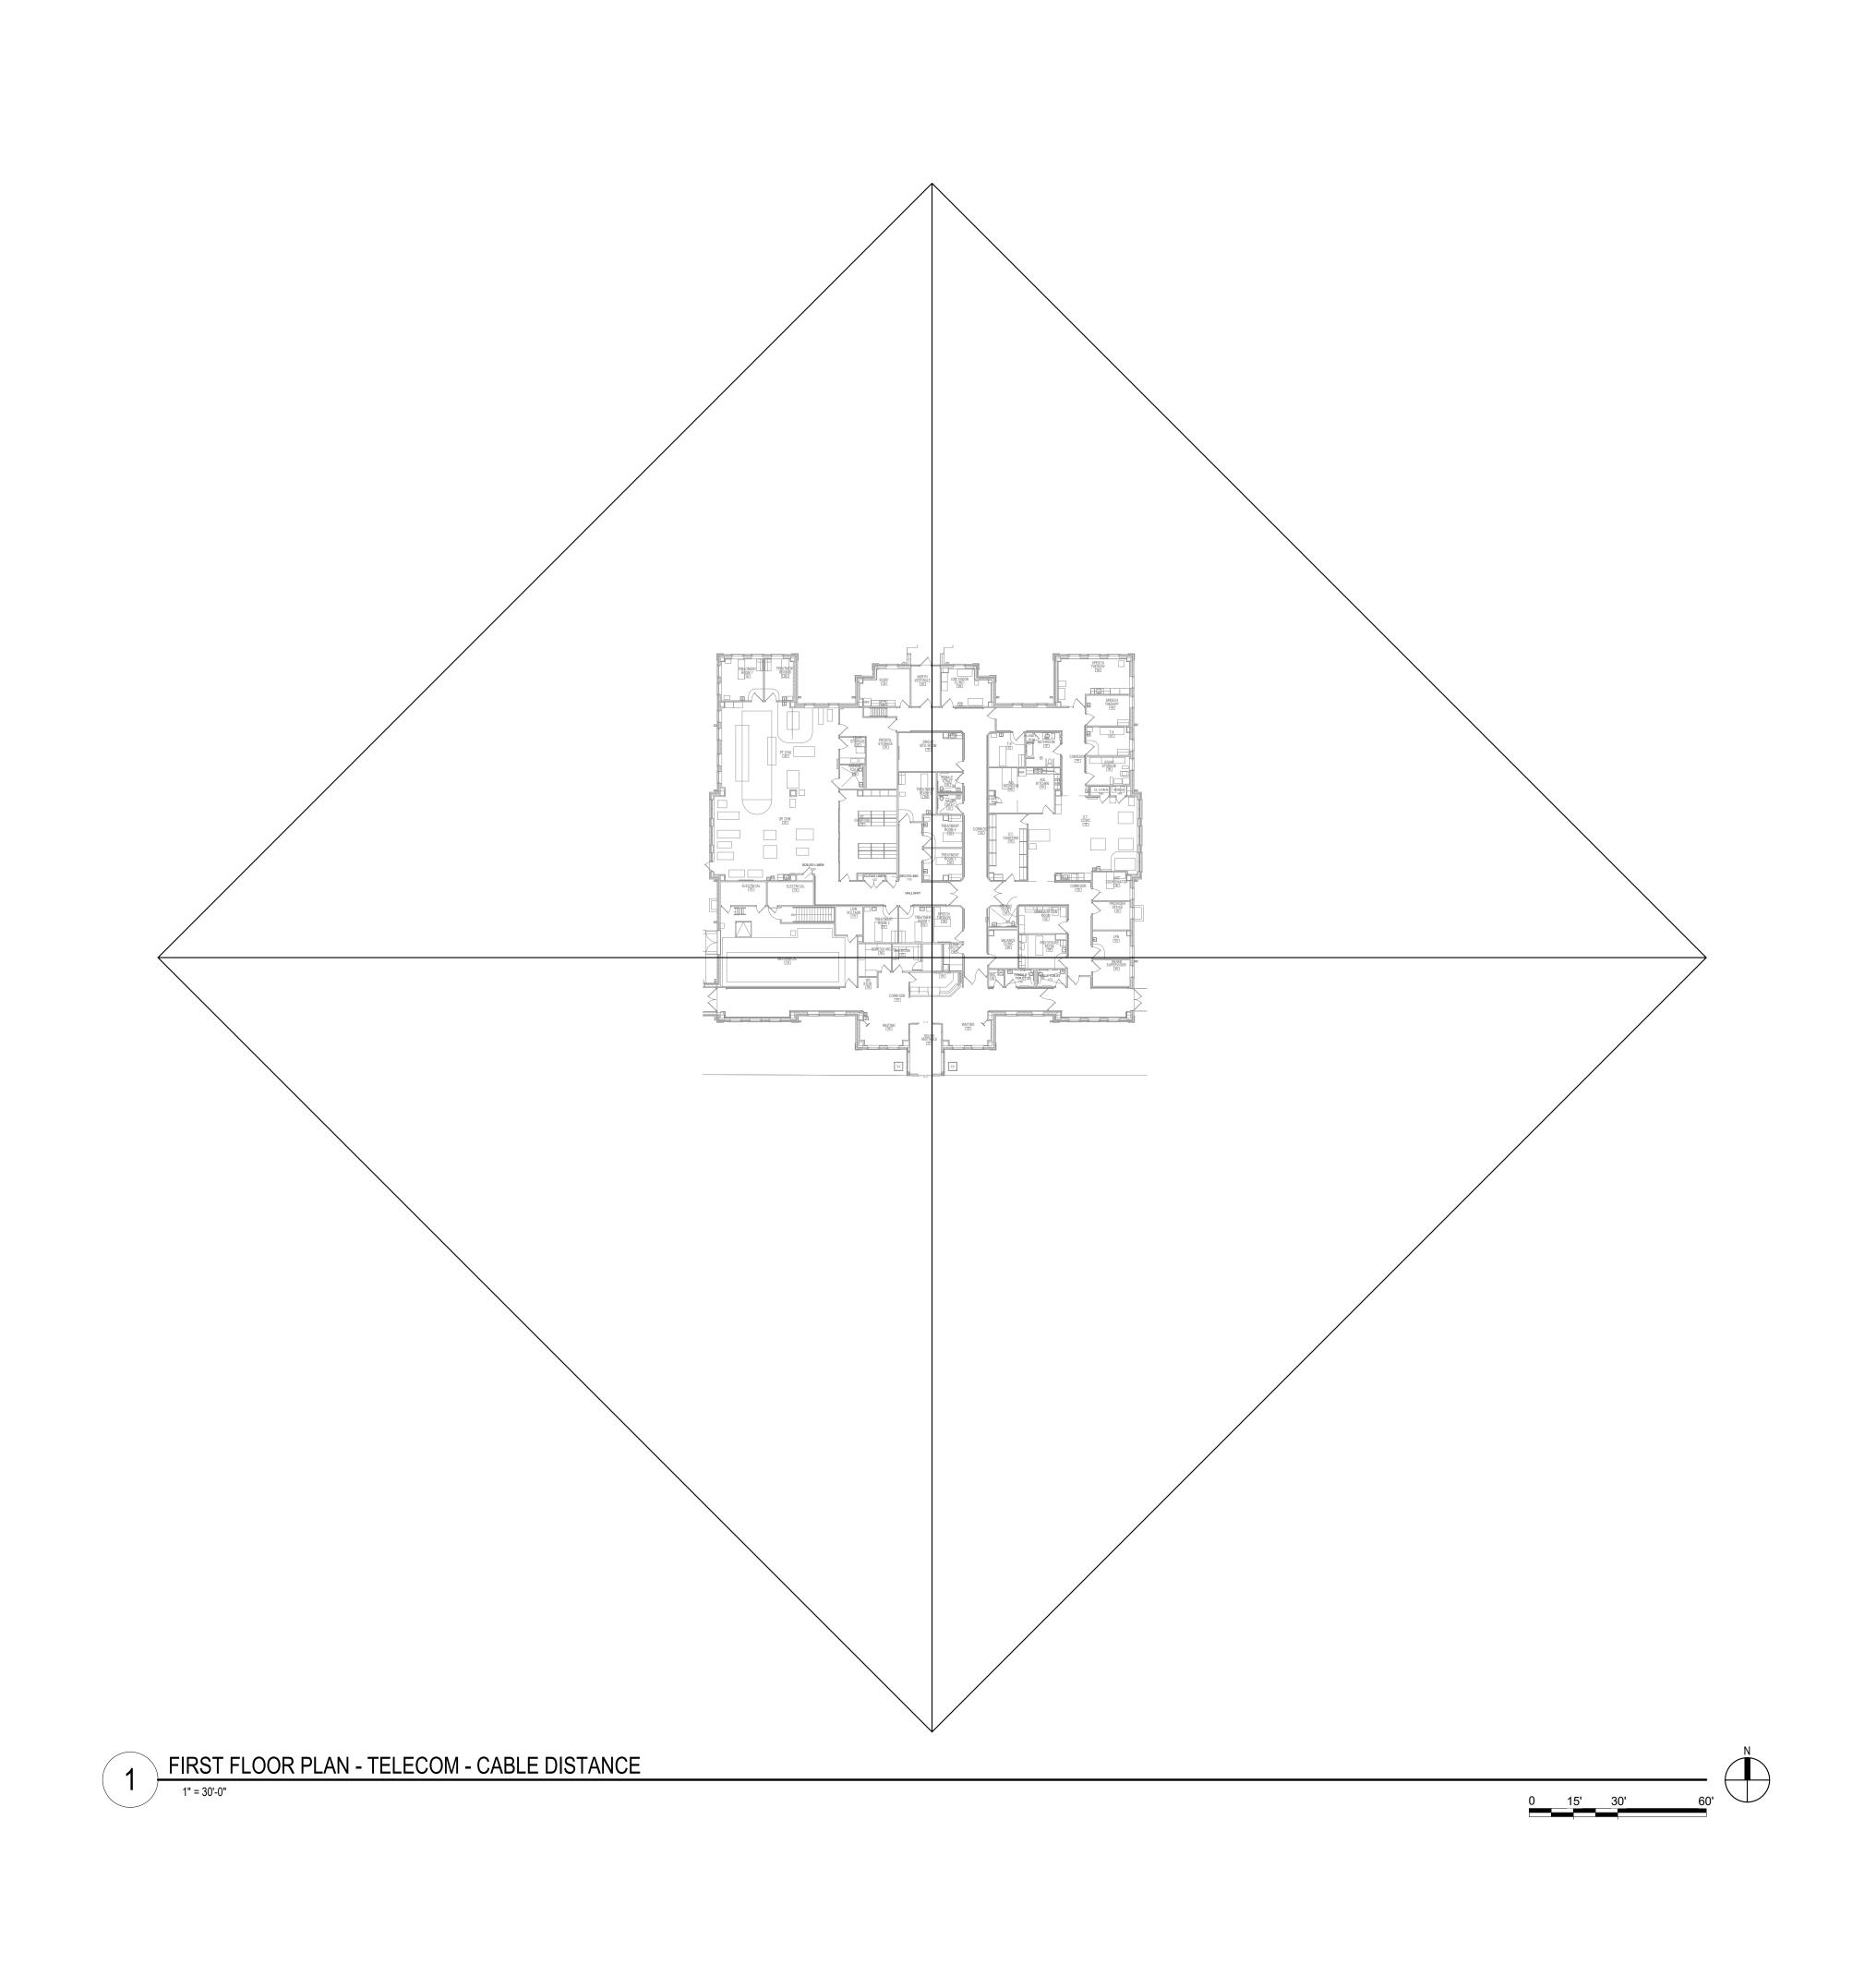

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CONSULTANT

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FIRST FLOOR PLAN TELECOM - CABLE DISTANCE

EHRM INFRASTRUCTURE UPGRADES


BUILDING No 116

LOCATION
VA MEDICAL CENTER
ST.CLOUD, MN 56303

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SPRINKLERED ______DWG. OF___



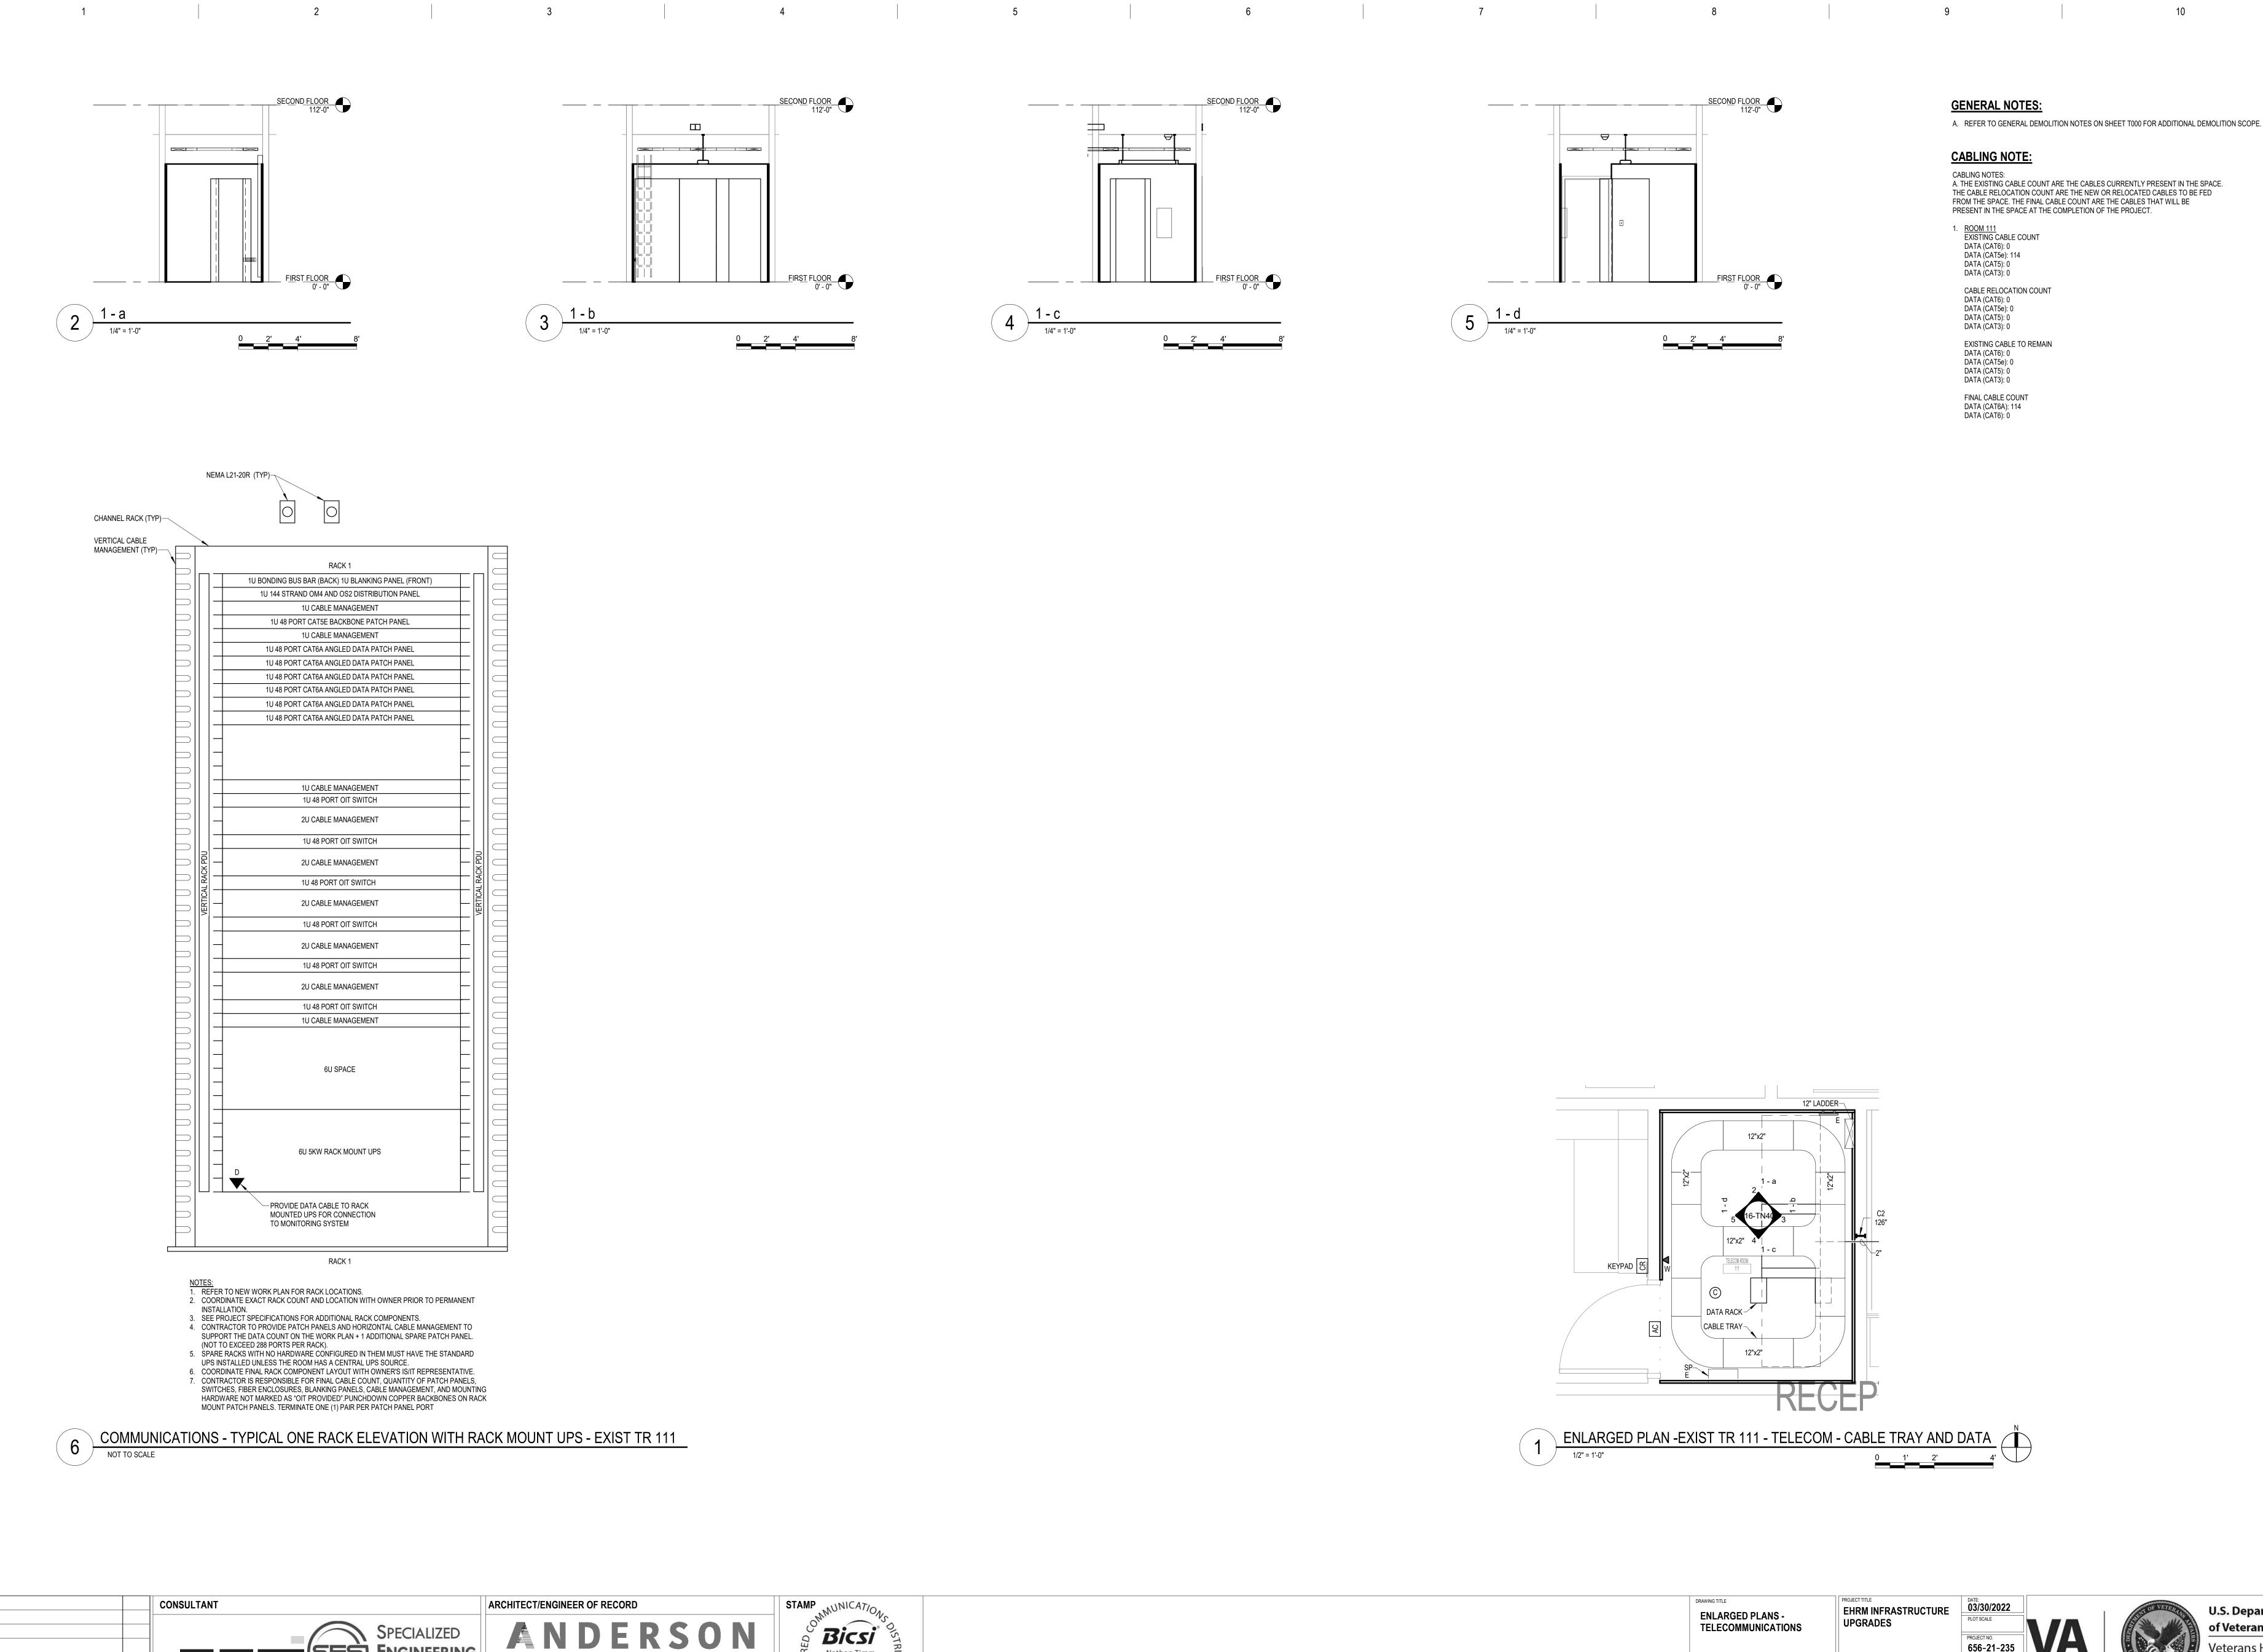

EXPIRES 12-31-23

Nathan M. Timm

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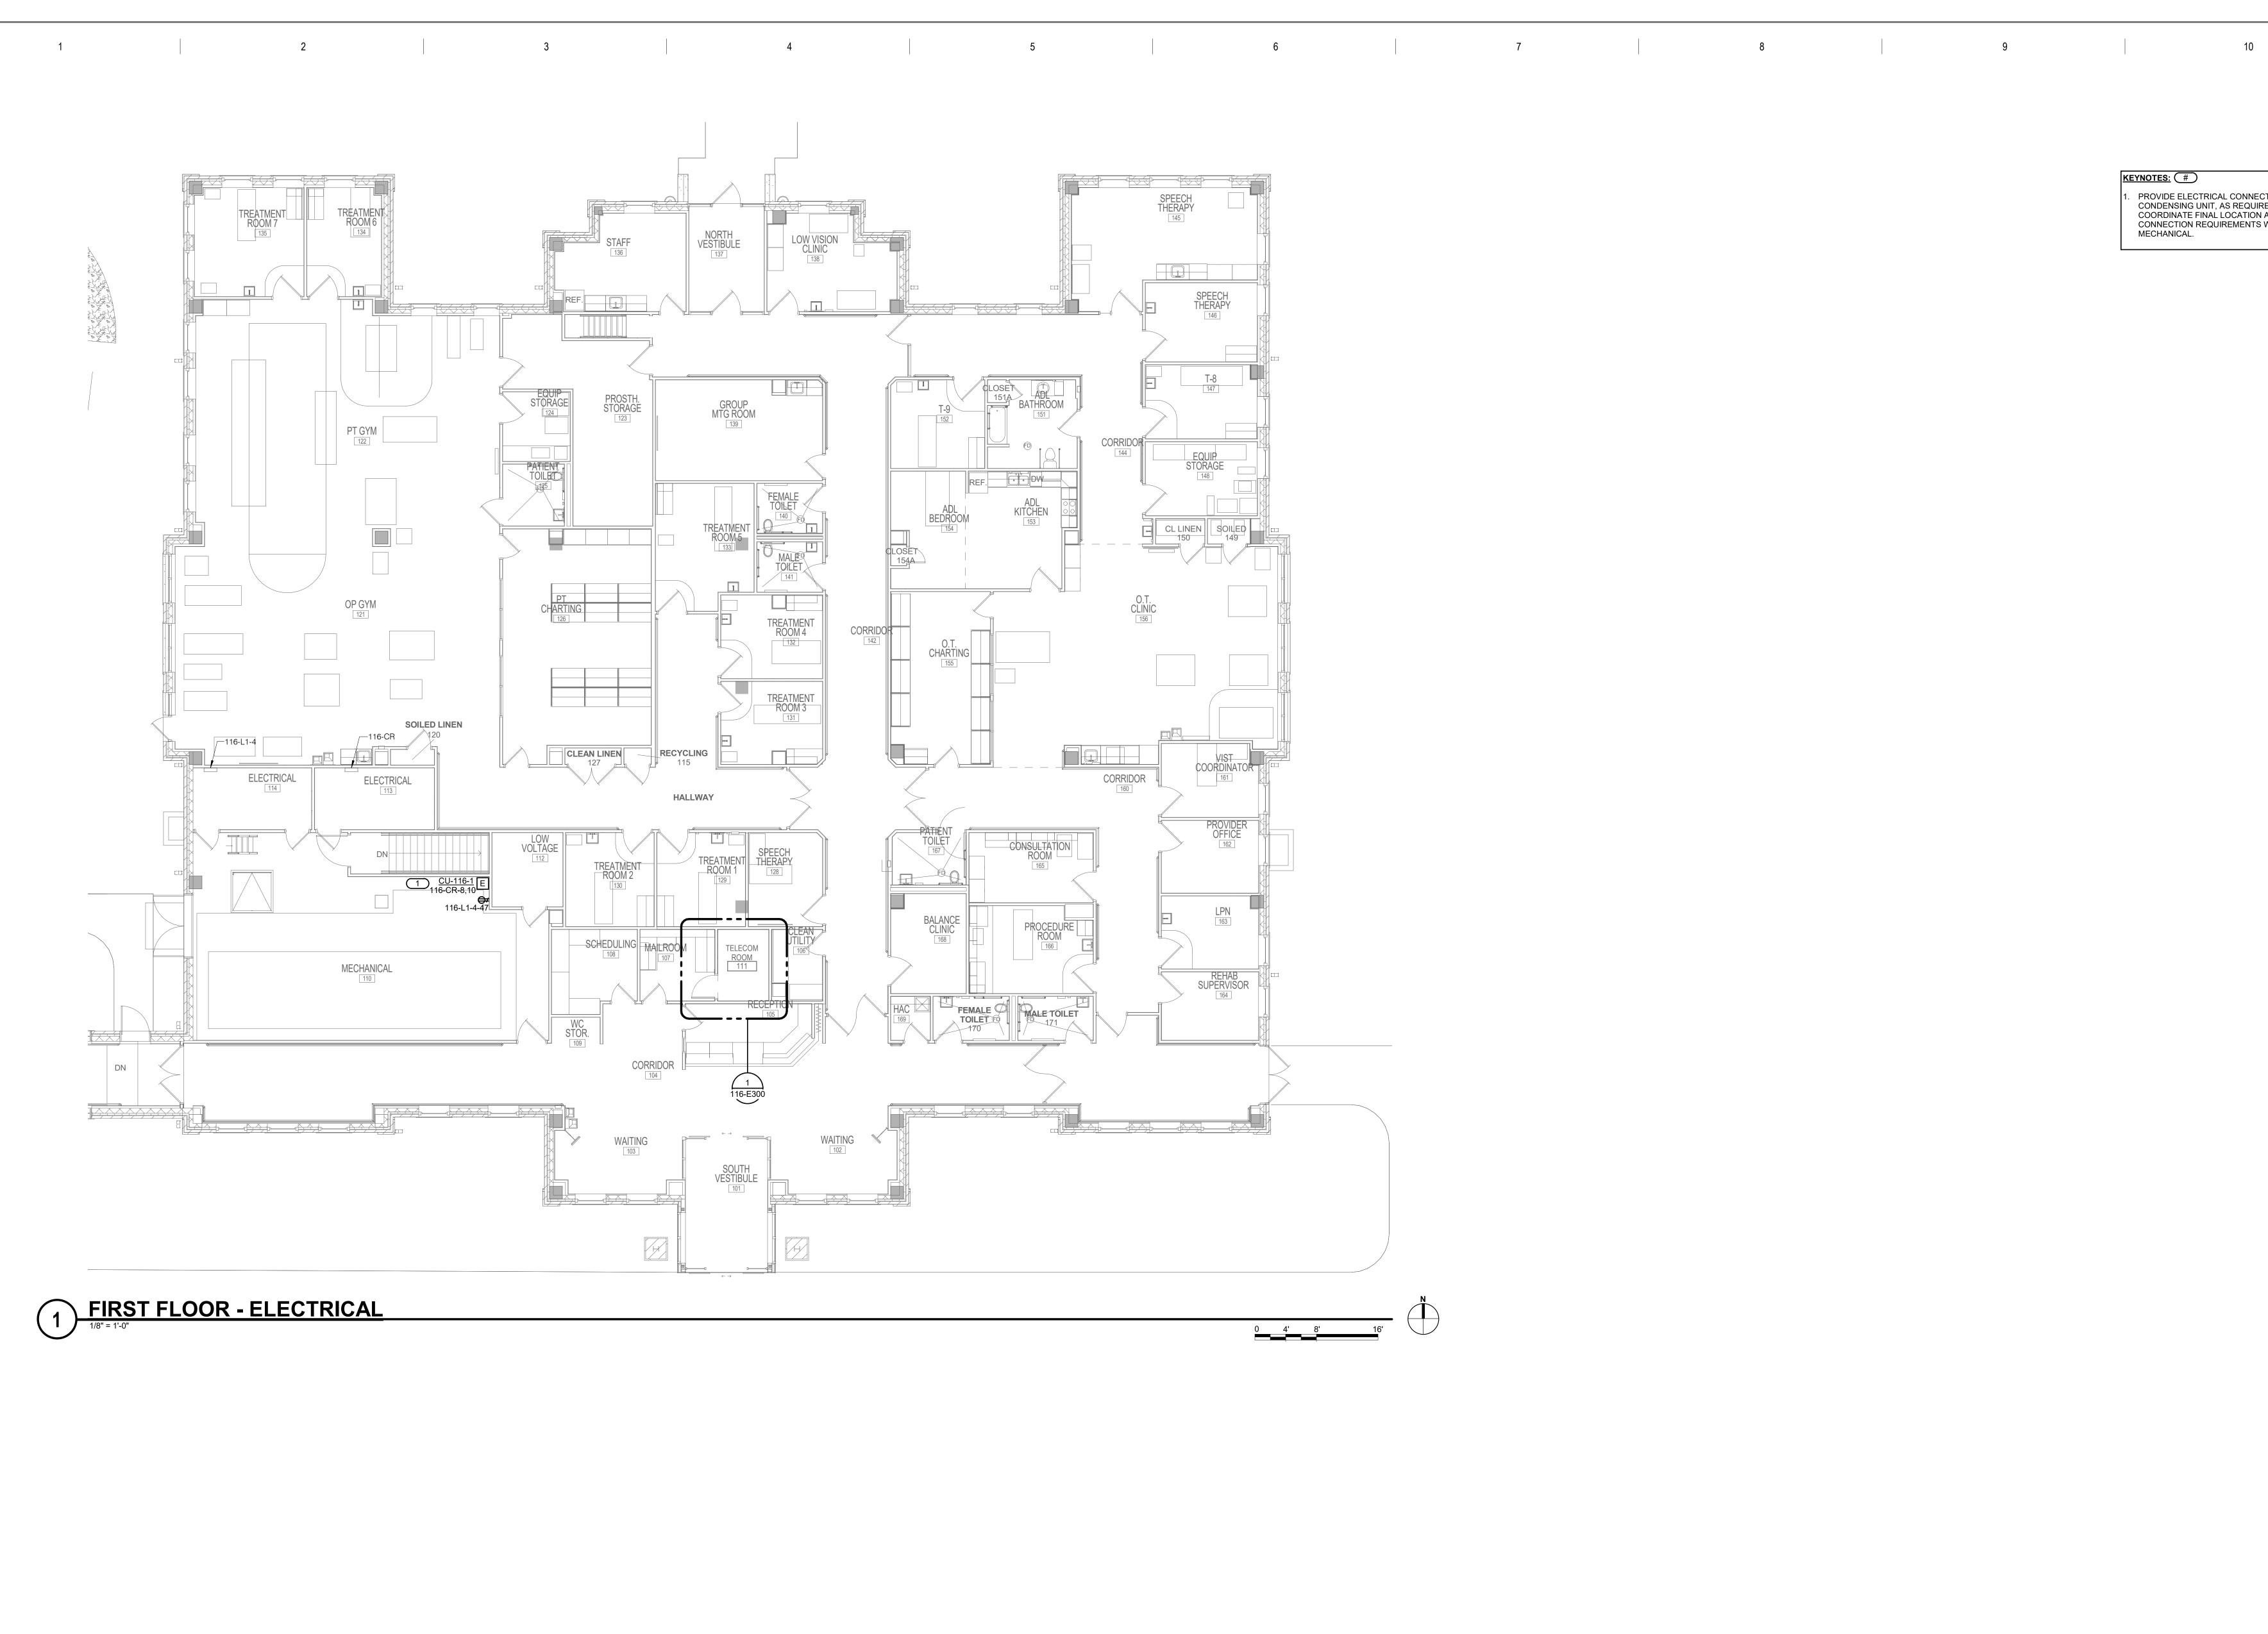
U.S. Department
of Veterans Affairs

Veterans Health
Administration

St. Cloud VA
Health Care System

KSB SSK 116-TN400

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KEYNOTES: # PROVIDE ELECTRICAL CONNECTION TO CONDENSING UNIT, AS REQUIRED.
COORDINATE FINAL LOCATION AND
CONNECTION REQUIREMENTS WITH

MECHANICAL.

FIRST FLOOR - ELECTRICAL

EHRM INFRASTRUCTURE 03/30/2022 DRAWING NO. 116-E201 116 TBD GJL

VA MEDICAL CENTER ST.CLOUD, MN 56303

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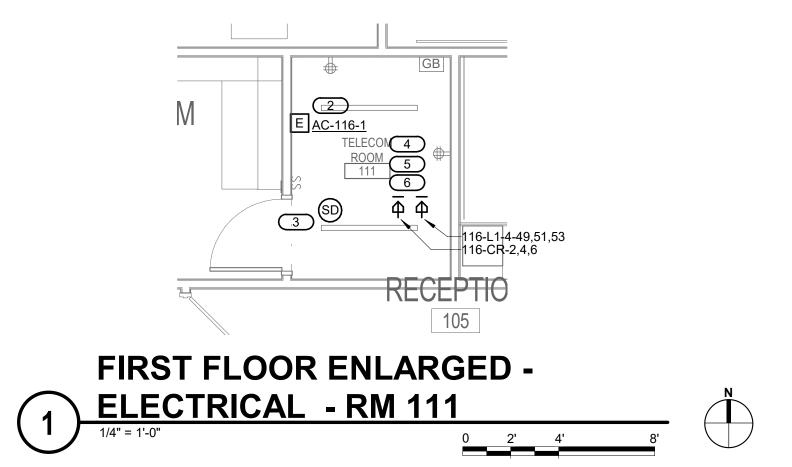





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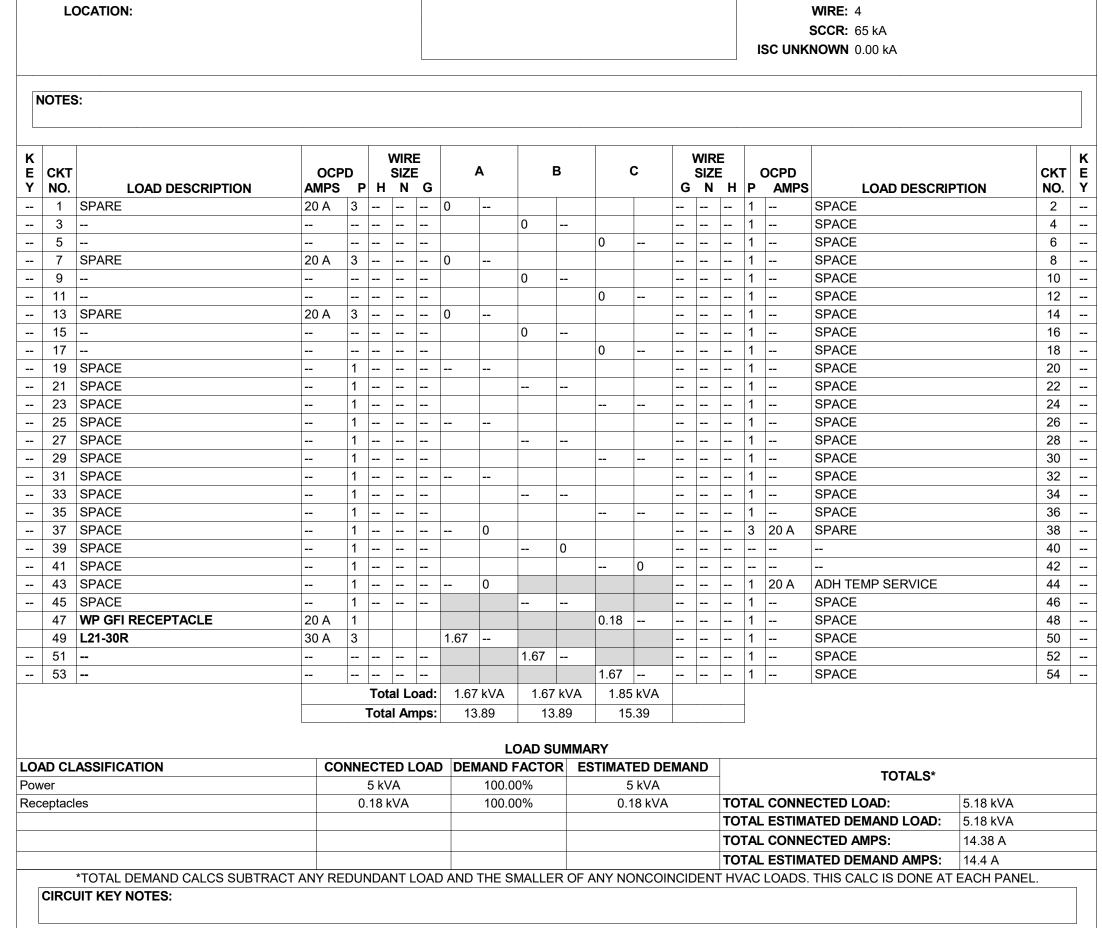
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 REFER TO TECHNOLOGY PLANS FOR IT ROOM LAYOUT AND RACK LAYOUT/DETAILS.
 REFER TO SHEET 0-GE400 DETAIL LAYOUT & ONE-LINE OF RACK.

KEYNOTES:


- DISCONNECT AND REMOVE LIGHTS AND RECEPTACLES IN AREA OF NEW IT ROOM.
- MAINTAIN CIRCUIT CONTINUITY TO ADJOINING SPACES.
 INDOOR UNIT TO BE POWERED BY OUTDOOR
- UNIT. COORDINATE EXACT LOCATION WITH M.C.
- CONNECT SMOKE DETECTOR TO NEAREST EXISTING SLC.
- COORDINATE FINAL LOCATION OF RECEPTACLE L21-20R WITH TELECOM
- CONTRACTOR. PROVIDE 3/4"C-4#10, 1#12 GND

PER MANUFACTURER'S REQUIREMENTS.

- TO PANEL FOR EACH RECEPTACLE.

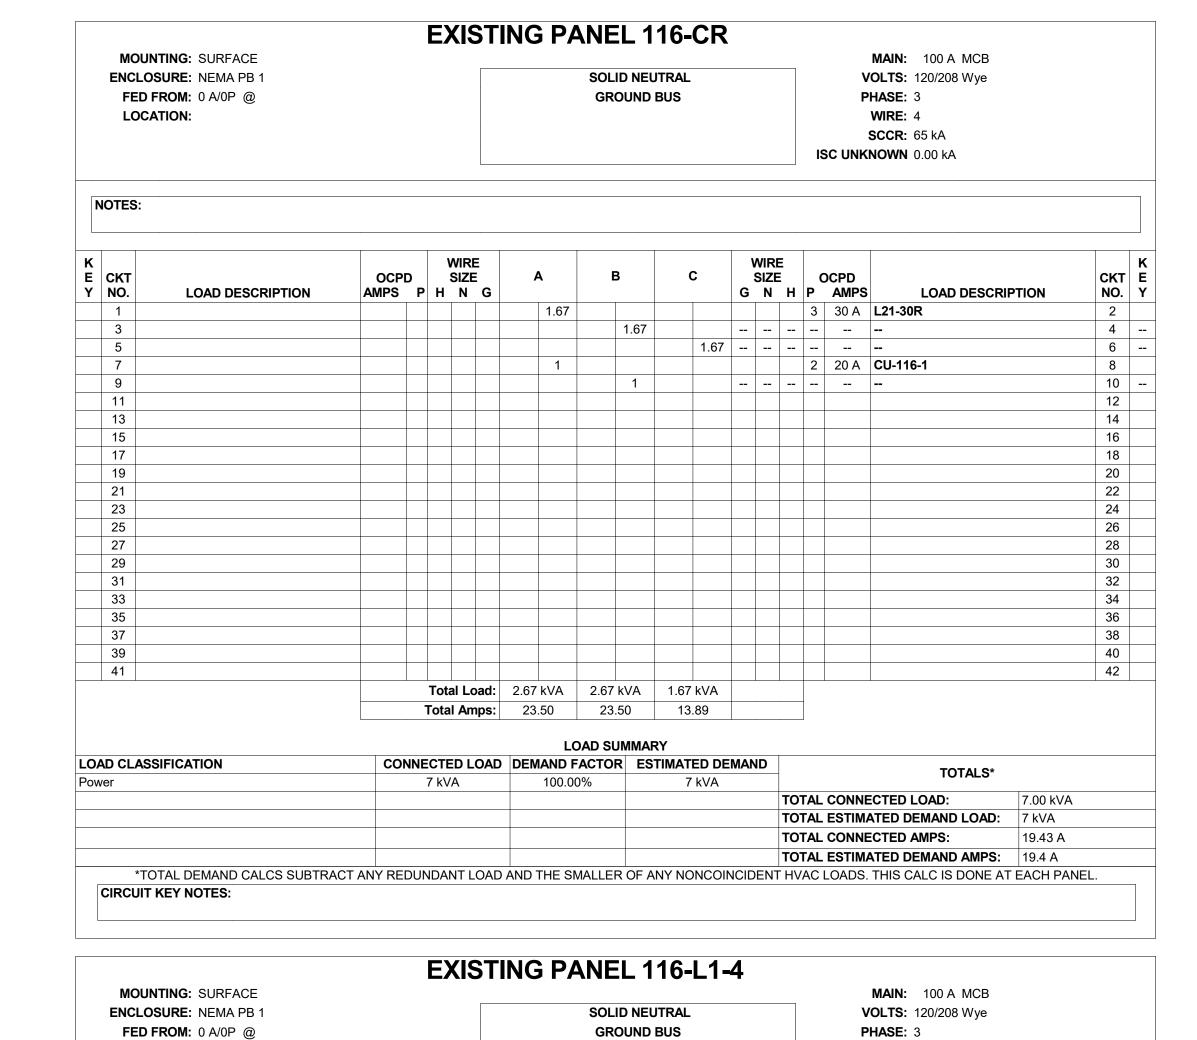 5. PROVIDE EATON BLADEUPS, 5KW, 120/208V, 3
 PHASE,4-WIRE RACK MOUNTED UPS FOR
- EACH RACK TOWER.

 6. PROVIDE APC#AP8861 RPDU RACK PDU 2G
 WITH L21-20P CORD. (120/208V, 3-PHASE, 20A,
 ZERO U, 5.7 KW, 208V, (36) C13 (6) C19 (2) 5-20R
 OUTLETS. PROVIDE TWO PER RACK, MOUNTED

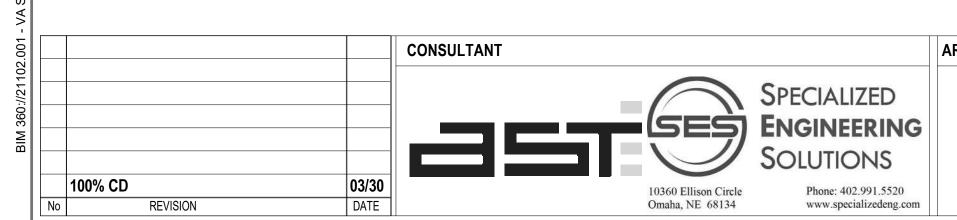










GJL

SPRINKLERED

TBD

116

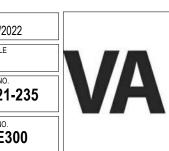



FIELD VERIFICATION NOTES

- 1. THE HVAC CONTRACTOR SHOULD VISIT THE SITE PRIOR TO BID TO FIELD VERIFY ALL EXISTING CONDITIONS WHICH MAY AFFECT THEIR BID. THE FOLLOWING ITEMS SHALL BE FIELD VERIFIED:
- A. EXACT PLACEMENT, SIZE, CAPACITY, MANUFACTURER AND CONDITION OF ALL EXISTING HVAC EQUIPMENT WITHIN SCOPE OF
- WORK, WHETHER EXPLICITLY SHOWN OR NOT.
- B. SIZE AND LOCATION OF ALL EXISTING DUCTWORK.
- C. SIZE AND LOCATION OF ALL EXISTING GRILLES, REGISTERS AND DIFFUSERS. D. SIZE AND LOCATION OF EXISTING THERMOSTATIC CONTROL DEVICES.
- E. SIZE AND LOCATION OF EXISTING PLUMBING AND HYDRONIC PIPING.
- 2. ALL REFERENCES ON THESE DRAWINGS TO EXISTING EQUIPMENT, DUCTWORK, DIFFUSERS, THERMOSTATS, AND PIPING ARE FOR REFERENCE ONLY. IT IS THE RESONSIBILITY OF THE CONTRACTOR TO VERIFY ALL THESE ITEMS PRIOR TO THEIR BID AND INCLUDE IN THEIR BID ANY AND ALL AMOUNTS REQUIRED TO ACCOMMODATE EXISTING CONDITIONS.
- ANY DISCREPANCIES WHICH MAY AFFECT CONTRACTORS BID SHALL BE BROUGHT TO THE ATTENTION OF THE ENGINEER AND ARCHITECT FOR DIRECTION.

SOILED LINEN RECYCLING 113 **HALLWAY** 112 TREATMENT 128 129 EXISTING SA REGISTER — CLEAN 56 ITILITY 2" STUBBED & **MECHANICAL** 110 EXISTING RA GRILLE **EXISTING** 1 1/4" SPRINKLER -CORRIDOR 104

1) FIRST FLOOR DEMOLITION - MECHANICAL - EXIST RM 111

KEYNOTES 1/116-M101:

- REMOVE EXISTING REGISTER AND CAP DUCT.
- REMOVE EXISTING GRILLE AND CAP DUCT.
- EXISTING FIRE SPRINKLER BRANCH LINE TO BE RE-ROUTED. DEMO 2" STUBBED AND CAPPED SANITARY PIPE TO OUTSIDE
- OF ROOM AND CAP. REMOVE EXISTING THERMOSTAT.

MECHANICAL GENERAL NOTES:

- THESE NOTES APPLY TO ALL MECHANICAL SHEETS AND TRADES, INCLUDING BUT NOT LIMITED TO, FIRE PROTECTION, PLUMBING, VENTILATION, PIPING AND TEMPERATURE CONTROL.
- 1. DRAWINGS SHOWING LOCATIONS OF EQUIPMENT, DUCTWORK, PIPING, ETC. ARE DIAGRAMMATIC AND MAY NOT ALWAYS REFLECT EXACT INSTALLATION CONDITIONS. DRAWINGS SHOW THE GENERAL ARRANGEMENT OF DUCTWORK, PIPING, EQUIPMENT, ETC., AND MAY NOT INCLUDE ALL OFFSETS AND FITTINGS REQUIRED FOR COMPLETE INSTALLATION. THE DRAWINGS SHALL BE FOLLOWED AS CLOSELY AS ACTUAL BUILDING
- 2. DO NOT SCALE DRAWINGS. VERIFY ALL DIMENSIONS AND CLEARANCES FROM ARCHITECTURAL, STRUCTURAL, SUBMITTALS, AND OTHER APPROPRIATE DRAWINGS OR PHYSICALLY AT SITE. REVIEW ALL DRAWINGS, INCLUDING THOSE OF OTHER TRADES.

CONSTRUCTION AND THE WORK OF OTHERS WILL PERMIT.

- 3. COORDINATE ALL WORK WITH ALL OTHER TRADES AND COR PRIOR TO INSTALLATION TO PROVIDE CLEARANCES REQUIRED FOR OPERATION, MAINTENANCE, CODE COMPLIANCE, AND TO VERIFY NON-INTERFERENCE WITH OTHER WORK. DO NOT FABRICATE PRIOR TO VERIFICATION OF NECESSARY CLEARANCES FOR ALL TRADES. BRING ANY INTERFERENCES OR CONFLICTS TO THE ATTENTION OF THE COR AND THE ARCHITECT/ENGINEER BEFORE PROCEEDING WITH FABRICATION OR EQUIPMENT ORDERS.
- 4. REVIEW SPACE REQUIREMENTS OF EQUIPMENT SPECIFIED OR SUBSTITUTED AND MAKE REASONABLE ACCOMMODATIONS IN LAYOUT AND POSITIONING TO PROVIDE PROPER ACCESS. FINAL LOCATIONS TO BE ACCURATELY DESCRIBED IN AS-BUILTS.
- 5. ANY CHANGES REQUIRED TO ELIMINATE CONFLICTS OR THAT RESULT FROM A FAILURE TO COORDINATE SHALL BE MADE BY THE CONTRACTOR WITHOUT ADDITIONAL COST, TIME OR EXPENSE TO OTHERS.
- 6. EACH CONTRACTOR IS RESPONSIBLE FOR ALL COSTS ASSOCIATED WITH ELECTRICAL CHANGES REQUIRED FOR EQUIPMENT PROPOSED THAT DIFFERS FROM THE BASIS OF
- 7. REFER TO CONTRACT DOCUMENTS, TO INCLUDE BUT NOT LIMITED TO, THE ARCHITECTURAL REFLECTED CEILING PLAN, ELECTRICAL, TECHNOLOGY AUDIO/VISUAL, AND OTHER MECHANICAL PLANS FOR EXACT LOCATIONS OF ALL CEILING MOUNTED DEVICES, OTHER THAN SPRINKLERS.
- 8. EACH CONTRACTOR IS RESPONSIBLE FOR DAMAGE CAUSED BY THEIR ACTIONS TO WALLS, FLOORS, CEILINGS, AND ROOFS. THE CONTRACTOR WHOSE WORK CAUSES DAMAGE IS RESPONSIBLE FOR PATCHING TO THE SATISFACTION OF THE COR TO MATCH ORIGINAL CONSTRUCTION, FIRE RATING, AND FINISH.
- 9. IN AREAS WITH DRYWALL CEILINGS COORDINATE LOCATIONS OF ACCESS PANELS WITH THE COR FOR ACCESS TO VALVES, DUCTWORK ACCESSORIES, DAMPERS, ETC. COORDINATE PANEL TYPE AND COLOR WITH ARCHITECT. NOTIFY THE COR OF THE REQUIRED ACCESS PANELS PRIOR TO BIDDING.
- 10. SEAL ALL FLOOR, WALL, AND ROOF PENETRATIONS AIRTIGHT WHERE CONDUITS, PIPING, AND DUCTS PENETRATE, BOTH NEW AND EXISTING. PENETRATIONS THROUGH EXTERIOR WALLS AND ROOF SHALL BE SEALED AIRTIGHT WITH WATERPROOFING MATERIALS RECOMMENDED BY MANUFACTURER FOR OUTDOOR USE.
- 11. CAULK ALL PIPE AND DUCT PENETRATIONS OF FULL HEIGHT NON-FIRE RATED WALL, PARTITION, FLOOR, AND ROOF ASSEMBLIES, BOTH NEW AND EXISTING. THIS IS ESSENTIAL TO PREVENT NOISE TRANSMISSION FROM ONE ROOM TO ANOTHER AND TO PROVIDE THE DESIRED NC LEVELS WITHIN ROOMS.
- 12. WHERE PIPES AND DUCTS ARE SHOWN TO PENETRATE FLOORS, PROVIDE SLEEVED OPENINGS WITH THE TOP EDGE RAISED ABOVE FLOOR SURFACE IN ACCORDANCE WITH ALL RELEVANT SPEC SECTIONS. SEAL SLEEVE PERIMETER TO BE WATERTIGHT.
- 13. EQUIPMENT SIZES AND SERVICE CLEARANCE REQUIREMENTS VARY AMONG DIFFERENT MANUFACTURERS. CONSULT APPROVED SHOP DRAWINGS FOR EQUIPMENT SIZES AND REQUIRED SERVICE CLEARANCES. COORDINATE WITH LAYOUT OF EQUIPMENT PADS, PIPING, DUCTWORK, ETC.
- 14. DO NOT BLOCK TUBE PULL OR EQUIPMENT SERVICE CLEARANCES.
- 15. MAINTAIN MINIMUM 3'-6" CLEARANCE IN FRONT OF ALL ELECTRICAL PANELS, MOTOR STARTERS, SWITCHES, AND DISCONNECTS.
- 16. PROVIDE CONCRETE EQUIPMENT PAD FOR ALL FLOOR MOUNTED EQUIPMENT. PAD SHALL EXTEND MINIMUM 6" BEYOND ALL SIDES OF EQUIPMENT.
- 17. DO NOT SUPPORT EQUIPMENT, PIPING, OR DUCTWORK FROM METAL DECKING OR OTHER NON-STRUCTURAL BUILDING ELEMENTS. ANCHORS EMBEDDED IN CONCRETE SHALL BE CRACKED CONCRETE APPROVED IN ACCORDANCE WITH SPECIFICATIONS.
- 18. CONTRACTOR TO COORDINATE SCHEDULE OF ANY NOISE-PRODUCING WORK SCOPE WITH COR NOT LESS THAN 10 DAYS PRIOR TO COMMENCING WORK.
- 19. ALL CARTS, EQUIPMENT, MATERIAL AND TOOLS AS WELL AS ALL TOOL BAGS/BOXES AND LADDERS ARE TO BE LABELED, CLEARLY IDENTIFYING THE CONTRACTOR/SUBCONTRACTOR
- 20. STORAGE OF TOOLS, EQUIPMENT AND MATERIALS IS ONLY AUTHORIZED IN APPROVED

FIRST FLOOR DEMOLITION -**MECHANICAL**

EHRM INFRASTRUCTURE

RDL

JCL

SPRINKLERED

116

VA MEDICAL CENTER

03/30/2022



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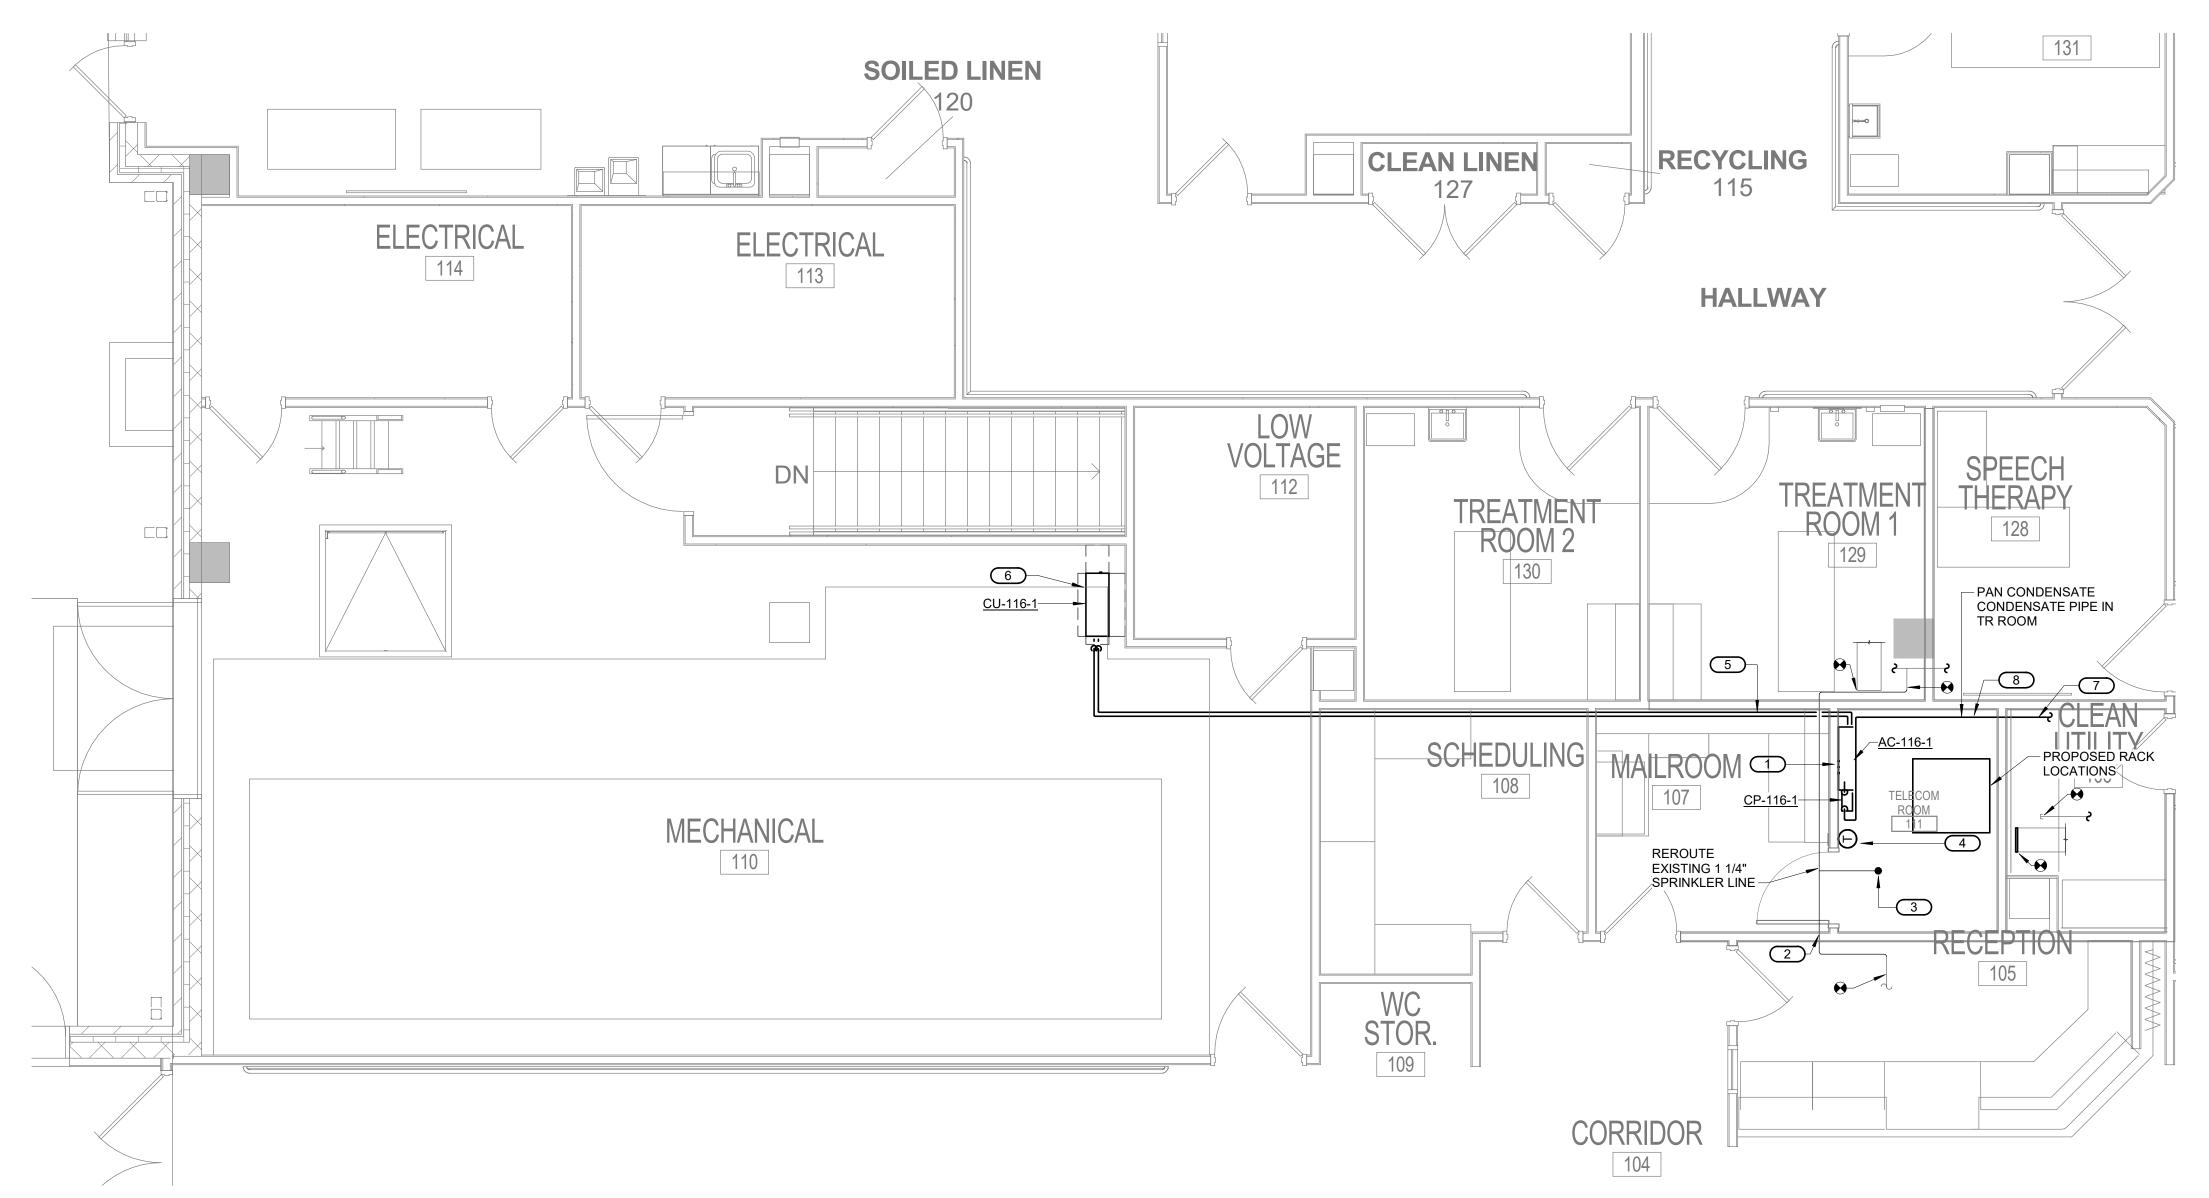
DATE

ARCHITECT/ENGINEER OF RECORD 13605 1st Ave. N. #100 Plymouth, MN 55441 P 763.412.4000 | F 763.412.4090 | ae-mn.com Anderson Engineering of Minnesota, LLC | Proj # 16305

STAMP DOUGLAS I hereby Certify that this plan, specification or report was prepared by me or under my direct supervision and that I am a duly Licensed Engineer under the laws of the State of Minnesota. Name: 24708, Date: 03/30/2022 MINNESO License Number: MN# 24706

FIELD VERIFICATION NOTES

- 1. THE HVAC CONTRACTOR SHOULD VISIT THE SITE PRIOR TO BID TO FIELD VERIFY ALL EXISTING CONDITIONS WHICH MAY AFFECT THEIR BID. THE FOLLOWING ITMES SHALL BE FIELD VERIFIED:
- A. EXACT PLACEMENT, SIZE, CAPACITY, MANUFACTURER AND CONDITION OF ALL EXISTING HVAC EQUIPMENT WITHIN SCOPE OF WORK, WHETHER EXPLICITLY SHOWN OR NOT.
- B. SIZE AND LOCATION OF ALL EXISTING DUCTWORK.
- C. SIZE AND LOCATION OF ALL EXISTING GRILLES, REGISTERS AND DIFFUSERS.
- D. SIZE AND LOCATION OF EXISTING THERMOSTATIC CONTROL DEVICES.
- E. SIZE AND LOCATION OF EXISTING PLUMBING AND HYDRONIC PIPING.
- 2. ALL REFERENCES ON THESE DRAWINGS TO EXISTING EQUIPMENT, DUCTWORK, DIFFUSERS, THERMOSTATS, AND PIPING ARE FOR REFERENCE ONLY. IT IS THE RESONSIBILITY OF THE CONTRACTOR TO VERIFY ALL THESE ITEMS PRIOR TO THEIR BID AND INCLUDE IN THEIR BID ANY AND ALL AMOUNTS REQUIRED TO ACCOMMODATE EXISTING CONDITIONS.
- 3. ANY DISCREPANCIES WHICH MAY AFFECT CONTRACTORS BID SHALL BE BROUGHT TO THE ATTENTION OF THE ENGINEER AND ARCHITECT FOR DIRECTION.



1 FIRST FLOOR - MECHANICAL - EXIST RM 111

KEYNOTES 1/116-M201: #

- NEW SPLIT SYSTEM AC UNIT.
 REROUTED FIRE SPRINKLER BRANCH LINE. FIELD
- VERIFY REQUIREMENTS.

 NEW FIRE SPRINKLER HEAD.
- 4. NEW THERMOSTAT.
- 5. ROUTE REFRIGERANT PIPING TO NEW AIR-COOLED CONDENSING UNIT LOCATED AT WEST EXTERIOR OF BUILDING. FIELD VERIFY ROUTING.
- 6. NEW AIR-COOLED CONDENSING UNIT. PROVIDE CONCRETE PAD OR WALL STAND.
- 7. ROUTE 1" CONDENSATE LINE TO MOP SINK IN HAC ROOM LOCATED APPROXIMATELY 30 FT EAST. FIELD VERIFY ROUTING.
- PROVIDE DRIP PAN FOR CONDENSATE LINE IN TR
 ROOM. SEE DETAIL FOR REQUIREMENTS.

MECHANICAL GENERAL NOTES:

THESE NOTES APPLY TO ALL MECHANICAL SHEETS AND TRADES, INCLUDING BUT NOT LIMITED TO, FIRE PROTECTION, PLUMBING, VENTILATION, PIPING AND TEMPERATURE CONTROL.

1. DRAWINGS SHOWING LOCATIONS OF EQUIPMENT, DUCTWORK, PIPING, ETC. ARE DIAGRAMMATIC AND MAY NOT ALWAYS REFLECT EXACT INSTALLATION CONDITIONS. DRAWINGS SHOW THE GENERAL ARRANGEMENT OF DUCTWORK, PIPING, EQUIPMENT, ETC., AND MAY NOT INCLUDE ALL OFFSETS AND FITTINGS REQUIRED FOR COMPLETE INSTALLATION. THE DRAWINGS SHALL BE FOLLOWED AS CLOSELY AS ACTUAL BUILDING

CONSTRUCTION AND THE WORK OF OTHERS WILL PERMIT.

- 2. DO NOT SCALE DRAWINGS. VERIFY ALL DIMENSIONS AND CLEARANCES FROM ARCHITECTURAL, STRUCTURAL, SUBMITTALS, AND OTHER APPROPRIATE DRAWINGS OR PHYSICALLY AT SITE. REVIEW ALL DRAWINGS, INCLUDING THOSE OF OTHER TRADES.
- 3. COORDINATE ALL WORK WITH ALL OTHER TRADES AND COR PRIOR TO INSTALLATION TO PROVIDE CLEARANCES REQUIRED FOR OPERATION, MAINTENANCE, CODE COMPLIANCE, AND TO VERIFY NON-INTERFERENCE WITH OTHER WORK. DO NOT FABRICATE PRIOR TO VERIFICATION OF NECESSARY CLEARANCES FOR ALL TRADES. BRING ANY INTERFERENCES OR CONFLICTS TO THE ATTENTION OF THE COR AND THE ARCHITECT/ENGINEER BEFORE PROCEEDING WITH FABRICATION OR EQUIPMENT ORDERS.
- 4. REVIEW SPACE REQUIREMENTS OF EQUIPMENT SPECIFIED OR SUBSTITUTED AND MAKE REASONABLE ACCOMMODATIONS IN LAYOUT AND POSITIONING TO PROVIDE PROPER ACCESS. FINAL LOCATIONS TO BE ACCURATELY DESCRIBED IN AS-BUILTS.
- 5. ANY CHANGES REQUIRED TO ELIMINATE CONFLICTS OR THAT RESULT FROM A FAILURE TO COORDINATE SHALL BE MADE BY THE CONTRACTOR WITHOUT ADDITIONAL COST, TIME OR
- 6. EACH CONTRACTOR IS RESPONSIBLE FOR ALL COSTS ASSOCIATED WITH ELECTRICAL CHANGES REQUIRED FOR EQUIPMENT PROPOSED THAT DIFFERS FROM THE BASIS OF
- 7. REFER TO CONTRACT DOCUMENTS, TO INCLUDE BUT NOT LIMITED TO, THE ARCHITECTURAL REFLECTED CEILING PLAN, ELECTRICAL, TECHNOLOGY AUDIO/VISUAL, AND OTHER MECHANICAL PLANS FOR EXACT LOCATIONS OF ALL CEILING MOUNTED DEVICES, OTHER THAN SPRINKLERS.
- 8. EACH CONTRACTOR IS RESPONSIBLE FOR DAMAGE CAUSED BY THEIR ACTIONS TO WALLS, FLOORS, CEILINGS, AND ROOFS. THE CONTRACTOR WHOSE WORK CAUSES DAMAGE IS RESPONSIBLE FOR PATCHING TO THE SATISFACTION OF THE COR TO MATCH ORIGINAL CONSTRUCTION, FIRE RATING, AND FINISH.
- 9. IN AREAS WITH DRYWALL CEILINGS COORDINATE LOCATIONS OF ACCESS PANELS WITH THE COR FOR ACCESS TO VALVES, DUCTWORK ACCESSORIES, DAMPERS, ETC. COORDINATE PANEL TYPE AND COLOR WITH ARCHITECT. NOTIFY THE COR OF THE REQUIRED ACCESS PANELS PRIOR TO BIDDING.
- 10. SEAL ALL FLOOR, WALL, AND ROOF PENETRATIONS AIRTIGHT WHERE CONDUITS, PIPING, AND DUCTS PENETRATE, BOTH NEW AND EXISTING. PENETRATIONS THROUGH EXTERIOR WALLS AND ROOF SHALL BE SEALED AIRTIGHT WITH WATERPROOFING MATERIALS RECOMMENDED BY MANUFACTURER FOR OUTDOOR USE.
- TO PREVENT NOISE TRANSMISSION FROM ONE ROOM TO ANOTHER AND TO PROVIDE THE DESIRED NC LEVELS WITHIN ROOMS.

 12. WHERE PIPES AND DUCTS ARE SHOWN TO PENETRATE FLOORS, PROVIDE SLEEVED

OPENINGS WITH THE TOP EDGE RAISED ABOVE FLOOR SURFACE IN ACCORDANCE WITH ALL

PARTITION, FLOOR, AND ROOF ASSEMBLIES, BOTH NEW AND EXISTING. THIS IS ESSENTIAL

11. CAULK ALL PIPE AND DUCT PENETRATIONS OF FULL HEIGHT NON-FIRE RATED WALL,

RELEVANT SPEC SECTIONS. SEAL SLEEVE PERIMETER TO BE WATERTIGHT.


- 13. EQUIPMENT SIZES AND SERVICE CLEARANCE REQUIREMENTS VARY AMONG DIFFERENT MANUFACTURERS. CONSULT APPROVED SHOP DRAWINGS FOR EQUIPMENT SIZES AND REQUIRED SERVICE CLEARANCES. COORDINATE WITH LAYOUT OF EQUIPMENT PADS, PIPING, DUCTWORK, ETC.
- 14. DO NOT BLOCK TUBE PULL OR EQUIPMENT SERVICE CLEARANCES.
- 15. MAINTAIN MINIMUM 3'-6" CLEARANCE IN FRONT OF ALL ELECTRICAL PANELS, MOTOR STARTERS, SWITCHES, AND DISCONNECTS.
- 16. PROVIDE CONCRETE EQUIPMENT PAD FOR ALL FLOOR MOUNTED EQUIPMENT. PAD SHALL EXTEND MINIMUM 6" BEYOND ALL SIDES OF EQUIPMENT.
- 17. DO NOT SUPPORT EQUIPMENT, PIPING, OR DUCTWORK FROM METAL DECKING OR OTHER NON-STRUCTURAL BUILDING ELEMENTS. ANCHORS EMBEDDED IN CONCRETE SHALL BE CRACKED CONCRETE APPROVED IN ACCORDANCE WITH SPECIFICATIONS.
- 18. CONTRACTOR TO COORDINATE SCHEDULE OF ANY NOISE-PRODUCING WORK SCOPE WITH COR NOT LESS THAN 10 DAYS PRIOR TO COMMENCING WORK.
- 19. ALL CARTS, EQUIPMENT, MATERIAL AND TOOLS AS WELL AS ALL TOOL BAGS/BOXES AND LADDERS ARE TO BE LABELED, CLEARLY IDENTIFYING THE CONTRACTOR/SUBCONTRACTOR NAME AND PROJECT.
- 20. STORAGE OF TOOLS, EQUIPMENT AND MATERIALS IS ONLY AUTHORIZED IN APPROVED LOCATIONS.

MECHANICAL RENOVATION NOTES:


THESE NOTES APPLY TO ALL MECHANICAL SHEETS AND TRADES, INCLUDING BUT NOT LIMITED TO, FIRE PROTECTION, PLUMBING, VENTILATION, PIPING AND TEMPERATURE CONTROL.

- 1. EXISTING CONDITIONS ARE SHOWN BASED ON INFORMATION OBTAINED FROM FIELD SURVEYS, EXISTING BUILDING DOCUMENTS, AND STAFF. VERIFY EXISTING CONDITIONS AND REPORT ANY CONFLICTS BEFORE PROCEEDING.
- NOT ALL EXISTING DUCTWORK AND PIPING IS SHOWN. VERIFY EXISTING CONDITIONS BEFORE STARTING WORK. NOTIFY COR AND ENGINEER OF ANY CONFLICTS WITH NEW WORK.
- 3. FIELD VERIFY THE AVAILABLE CLEARANCES FOR DUCTWORK AND PIPING BEFORE FABRICATION. RISES AND DROPS MAY BE NECESSARY BECAUSE OF EXISTING FIELD CONDITIONS.
- 4. EACH CONTRACTOR SHALL FIELD VERIFY ACCESSIBILITY TO THE AREA OF HIS/HER WORK AND SHALL NOTIFY THE COR AND ENGINEER PRIOR TO BIDDING IF OTHER UTILITIES ARE REQUIRED TO BE REMOVED OR RELOCATED TO ALLOW ACCESS TO HIS/HER AREA OF WORK
- 5. THE GENERAL CONTRACTOR IS RESPONSIBLE FOR CUTTING, REMOVAL AND PATCHING OF ROOFS, WALLS, AND FLOORS ASSOCIATED WITH WORK BY ALL CONTRACTORS.

 CONTRACTORS SHALL NOTIFY THE COR AND ENGINEER OF AFFECTED AREAS PRIOR TO
- 6. THE GENERAL CONTRACTOR IS RESPONSIBLE FOR REMOVAL AND REPLACEMENT OF CEILINGS, CEILING TILES, AND CEILING GRIDS ASSOCIATED WITH AREAS OF WORK BY ALL CONTRACTORS. NOTIFY THE GENERAL CONTRACTOR OF AFFECTED AREAS PRIOR TO BIDDING.
- 7. WHERE EXISTING MECHANICAL SYSTEMS ARE LOCATED IN AREAS THAT CONFLICT WITH NEW EQUIPMENT, PIPING, OR DUCTWORK TO BE INSTALLED, EACH CONTRACTOR SHALL EITHER ARRANGE NEW EQUIPMENT, PIPING, OR DUCTWORK IN SUCH A FASHION THAT IT DOES NOT CONFLICT WITH EXISTING SYSTEMS, OR REWORK EXISTING SYSTEMS TO ALLOW FOR INSTALLATION OF NEW EQUIPMENT, PIPING, OR DUCTWORK.
- 8. PROVIDE TEMPORARY CONNECTIONS TO MAINTAIN EXISTING SYSTEMS IN SERVICE DURING CONSTRUCTION. MAINTAIN ACCESS TO EXISTING MECHANICAL INSTALLATIONS THAT REMAIN ACTIVE.
- 9. OBTAIN PERMISSION FROM OWNER BEFORE SHUTTING DOWN ANY SYSTEM FOR ANY REASON. MAINTAIN SERVICE TO ALL COMPONENTS THAT ARE TO REMAIN UNTIL NEW SYSTEMS ARE INSTALLED.
- 10. MAINTAIN EXISTING SYSTEM IN SERVICE UNTIL NEW SYSTEM IS COMPLETE AND READY FOR TIE IN AND SWITCHOVER. DRAIN SYSTEM ONLY TO MAKE SWITCHOVERS AND CONNECTIONS. OBTAIN PERMISSION FROM OWNER BEFORE PARTIALLY OR COMPLETELY DRAINING SYSTEM. MAKE CHANGEOVER TO NEW SYSTEMS WITH MINIMUM OUTAGE.

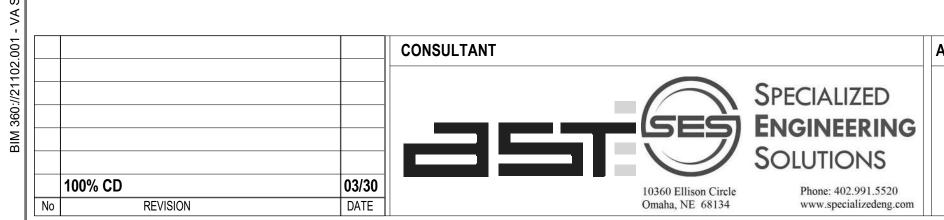



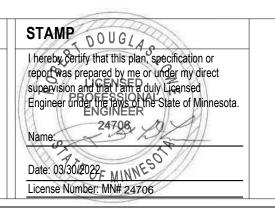





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