


BUILDING 48 - EHRM INFRASTRUCTURE UPGRADES

St. Cloud VA Health Care System Main Campus, St. Cloud, Minnesota

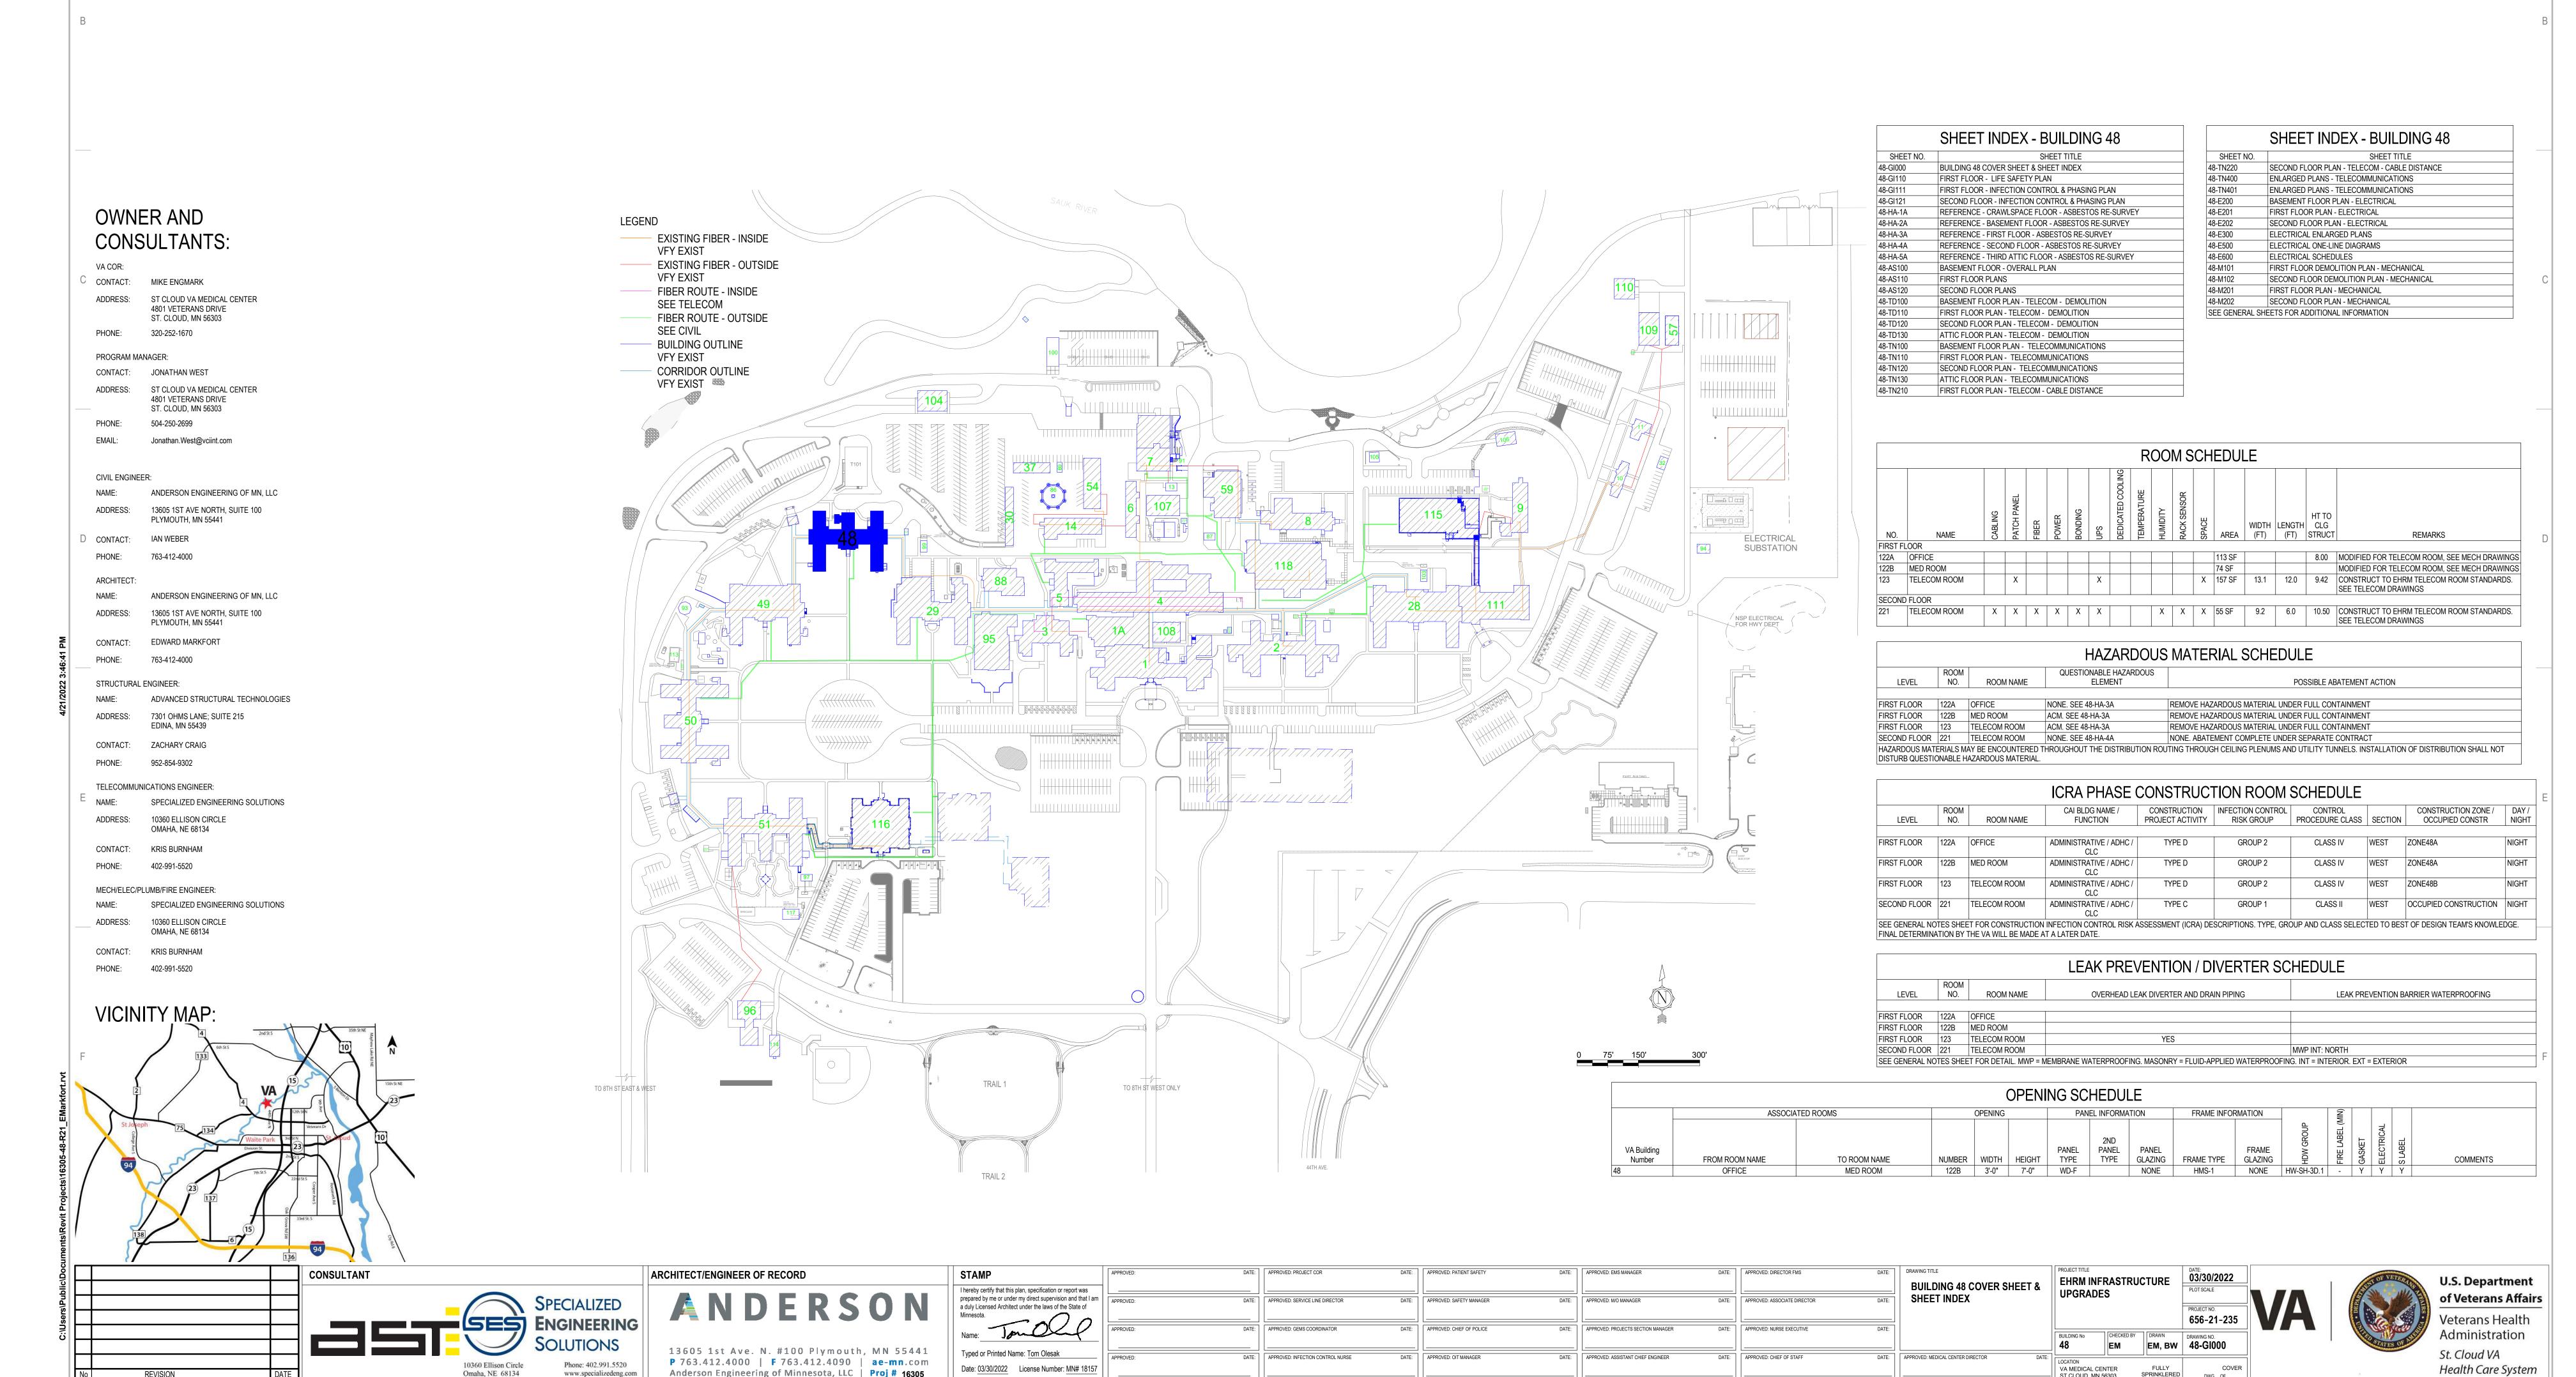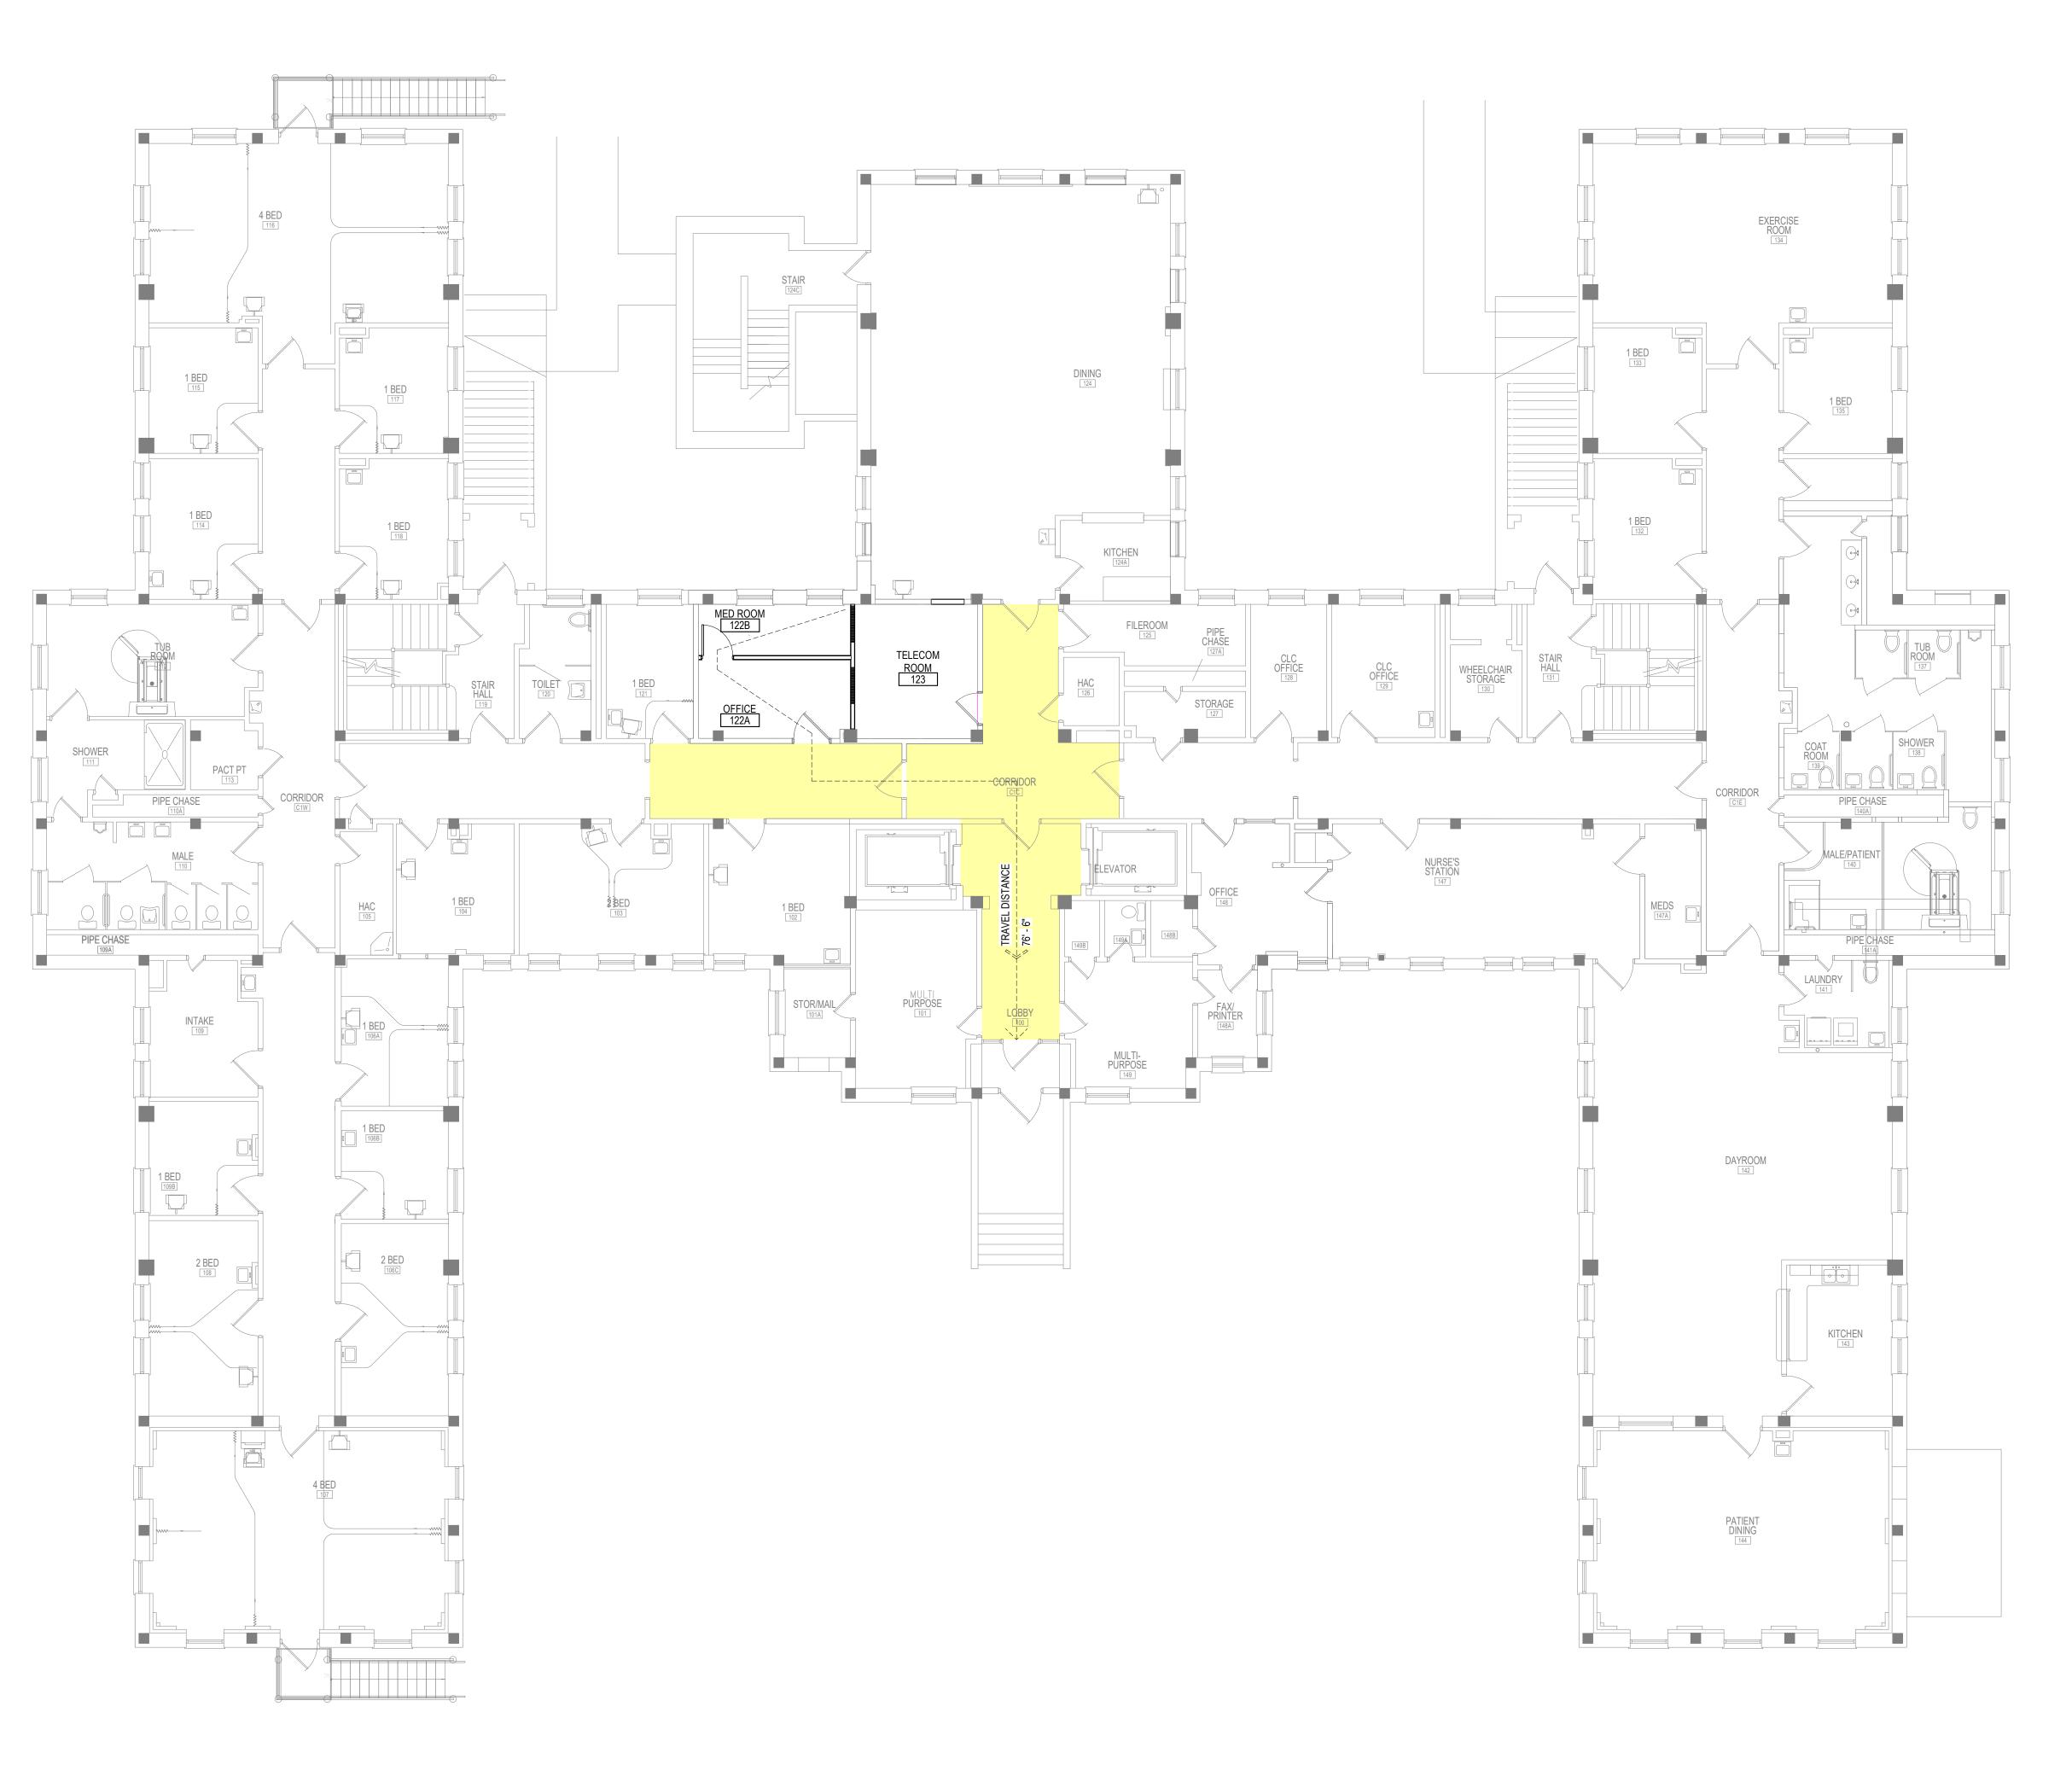

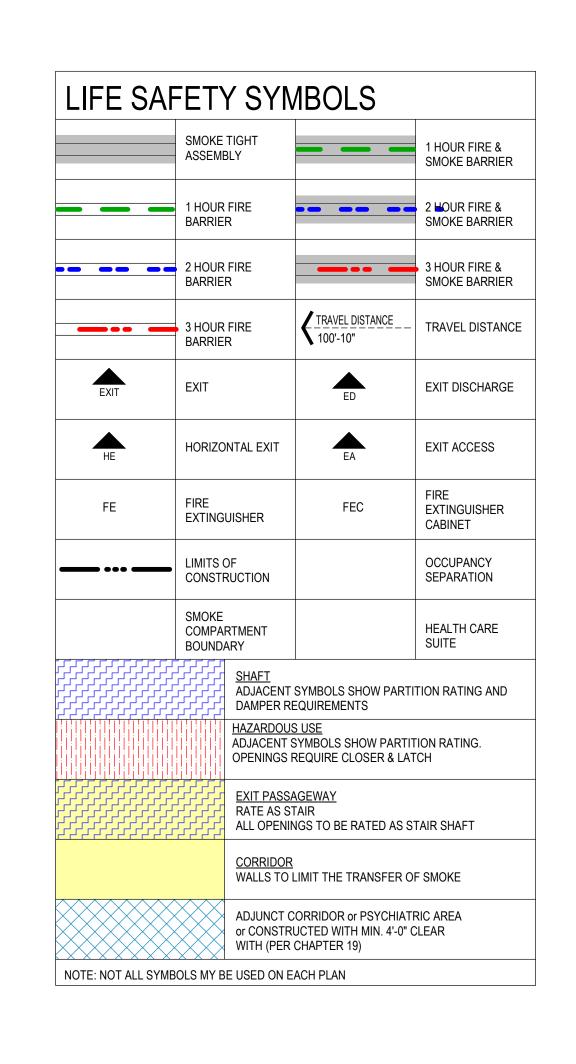

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FIRST FLOOR - LIFE SAFETY PLAN

1/8" = 1'-0"

DATE

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Omaha, NE 68134


Phone: 402.991.5520


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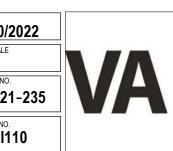
PROJECT TITLE

EHRM INFRASTRUCTURE


UPGRADES

PROJECT NO
656-2

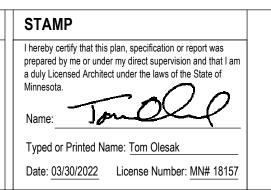VA MEDICAL CENTER ST.CLOUD, MN 56303

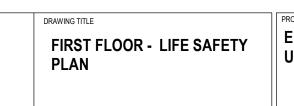



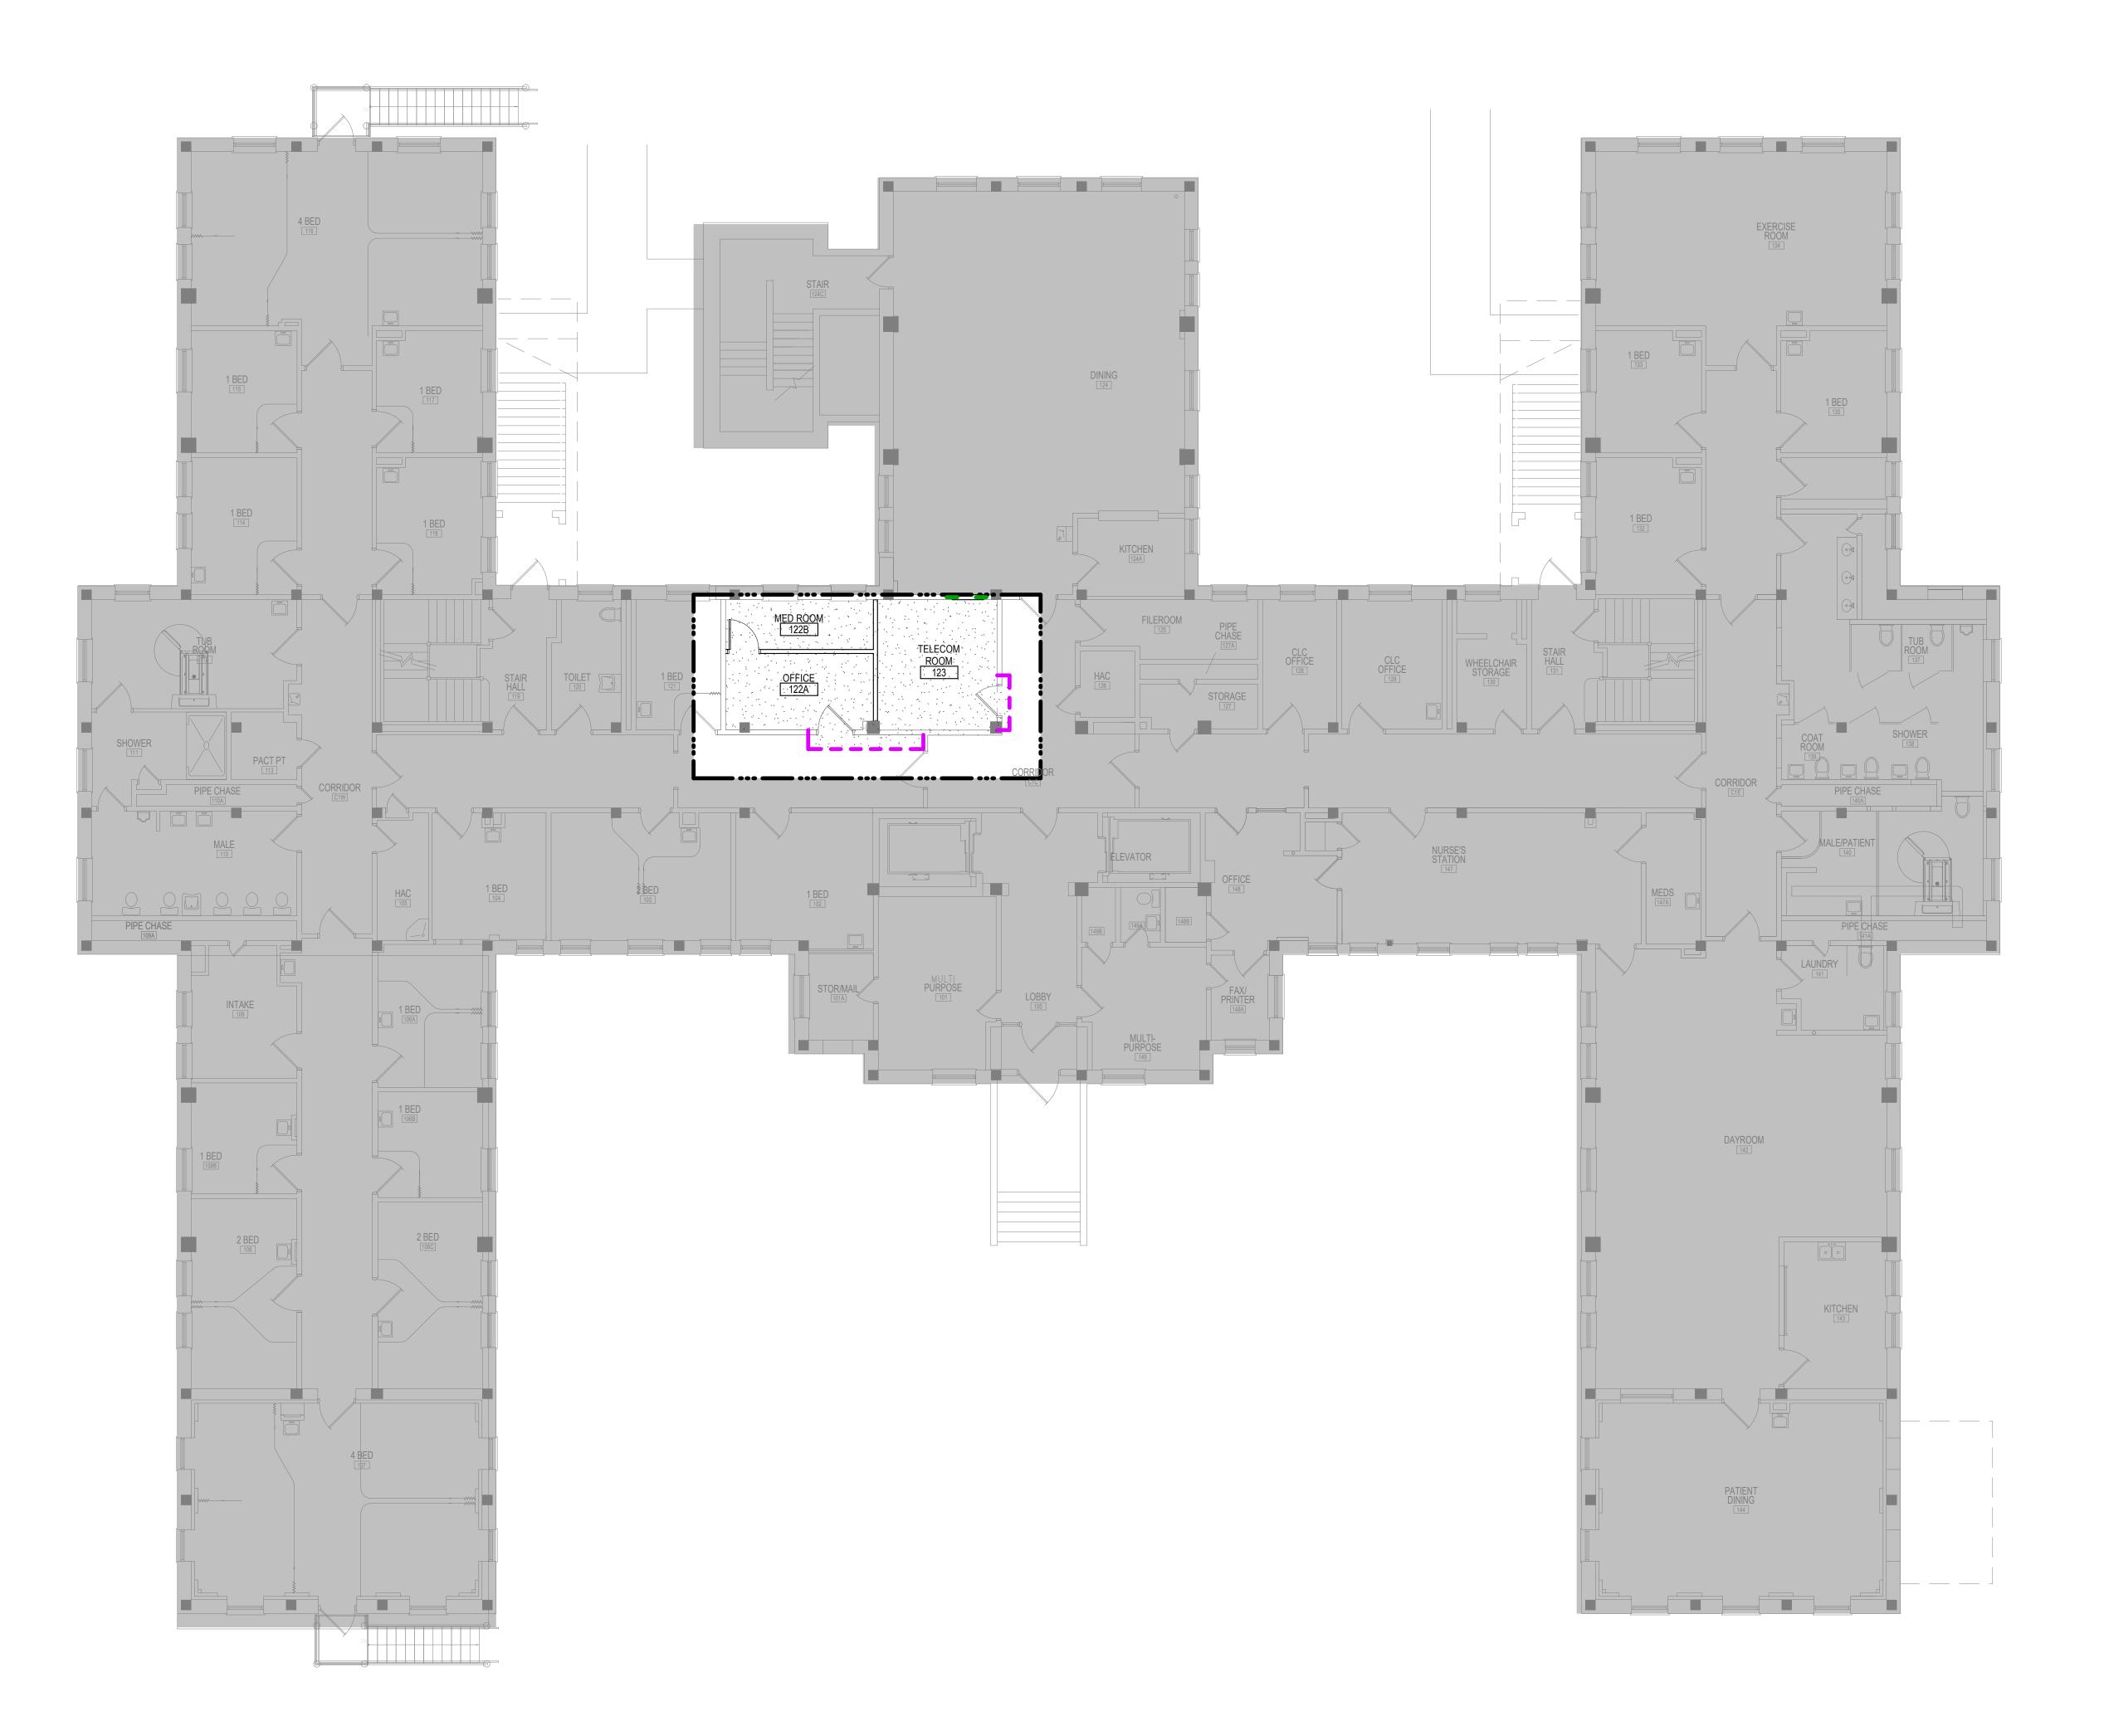

1 7 9

ROOM ICRA SCHEDULE CAI BLDG NAME / FUNCTION CONSTRUCTION PROJECT ACTIVITY INFECTION CONTROL RISK GROUP CONTROL PROCEDURE CLASS FIRST FLOOR 122A OFFICE
FIRST FLOOR 122B MED ROOM
FIRST FLOOR 123 TELECOM ROOM CLASS IV GROUP 2 ADMINISTRATIVE / ADHC / CLC GROUP 2 CLASS IV SEE GENERAL NOTES SHEET FOR CONSTRUCTION INFECTION CONTROL RISK ASSESSMENT (ICRA) DESCRIPTIONS. TYPE, GROUP AND CLASS SELECTED TO BEST OF DESIGN TEAM'S KNOWLEDGE.

1 HOUR FIRE RATED ICRA / CONSTRUCTION BARRIER

LOCATION, AND DOOR, WHERE SHOWN

INFECTION CONTROL RISK ASSESSMENT (ICRA) LEGEND LIMITS OF CONSTRUCTION


> TEMPORARY NON-RATED (PLASTIC SHEETING) CONSTRUCTION BARRIER LOCATION, WHERE APPROVED BY THE VA FOR USE IN RISK TYPE B. UPGRADE TO 1 HOUR RATED PARTITION WHEN DIRECTED BY THE VA

FIRST FLOOR - CONST BARRIER PLAN


REVISION



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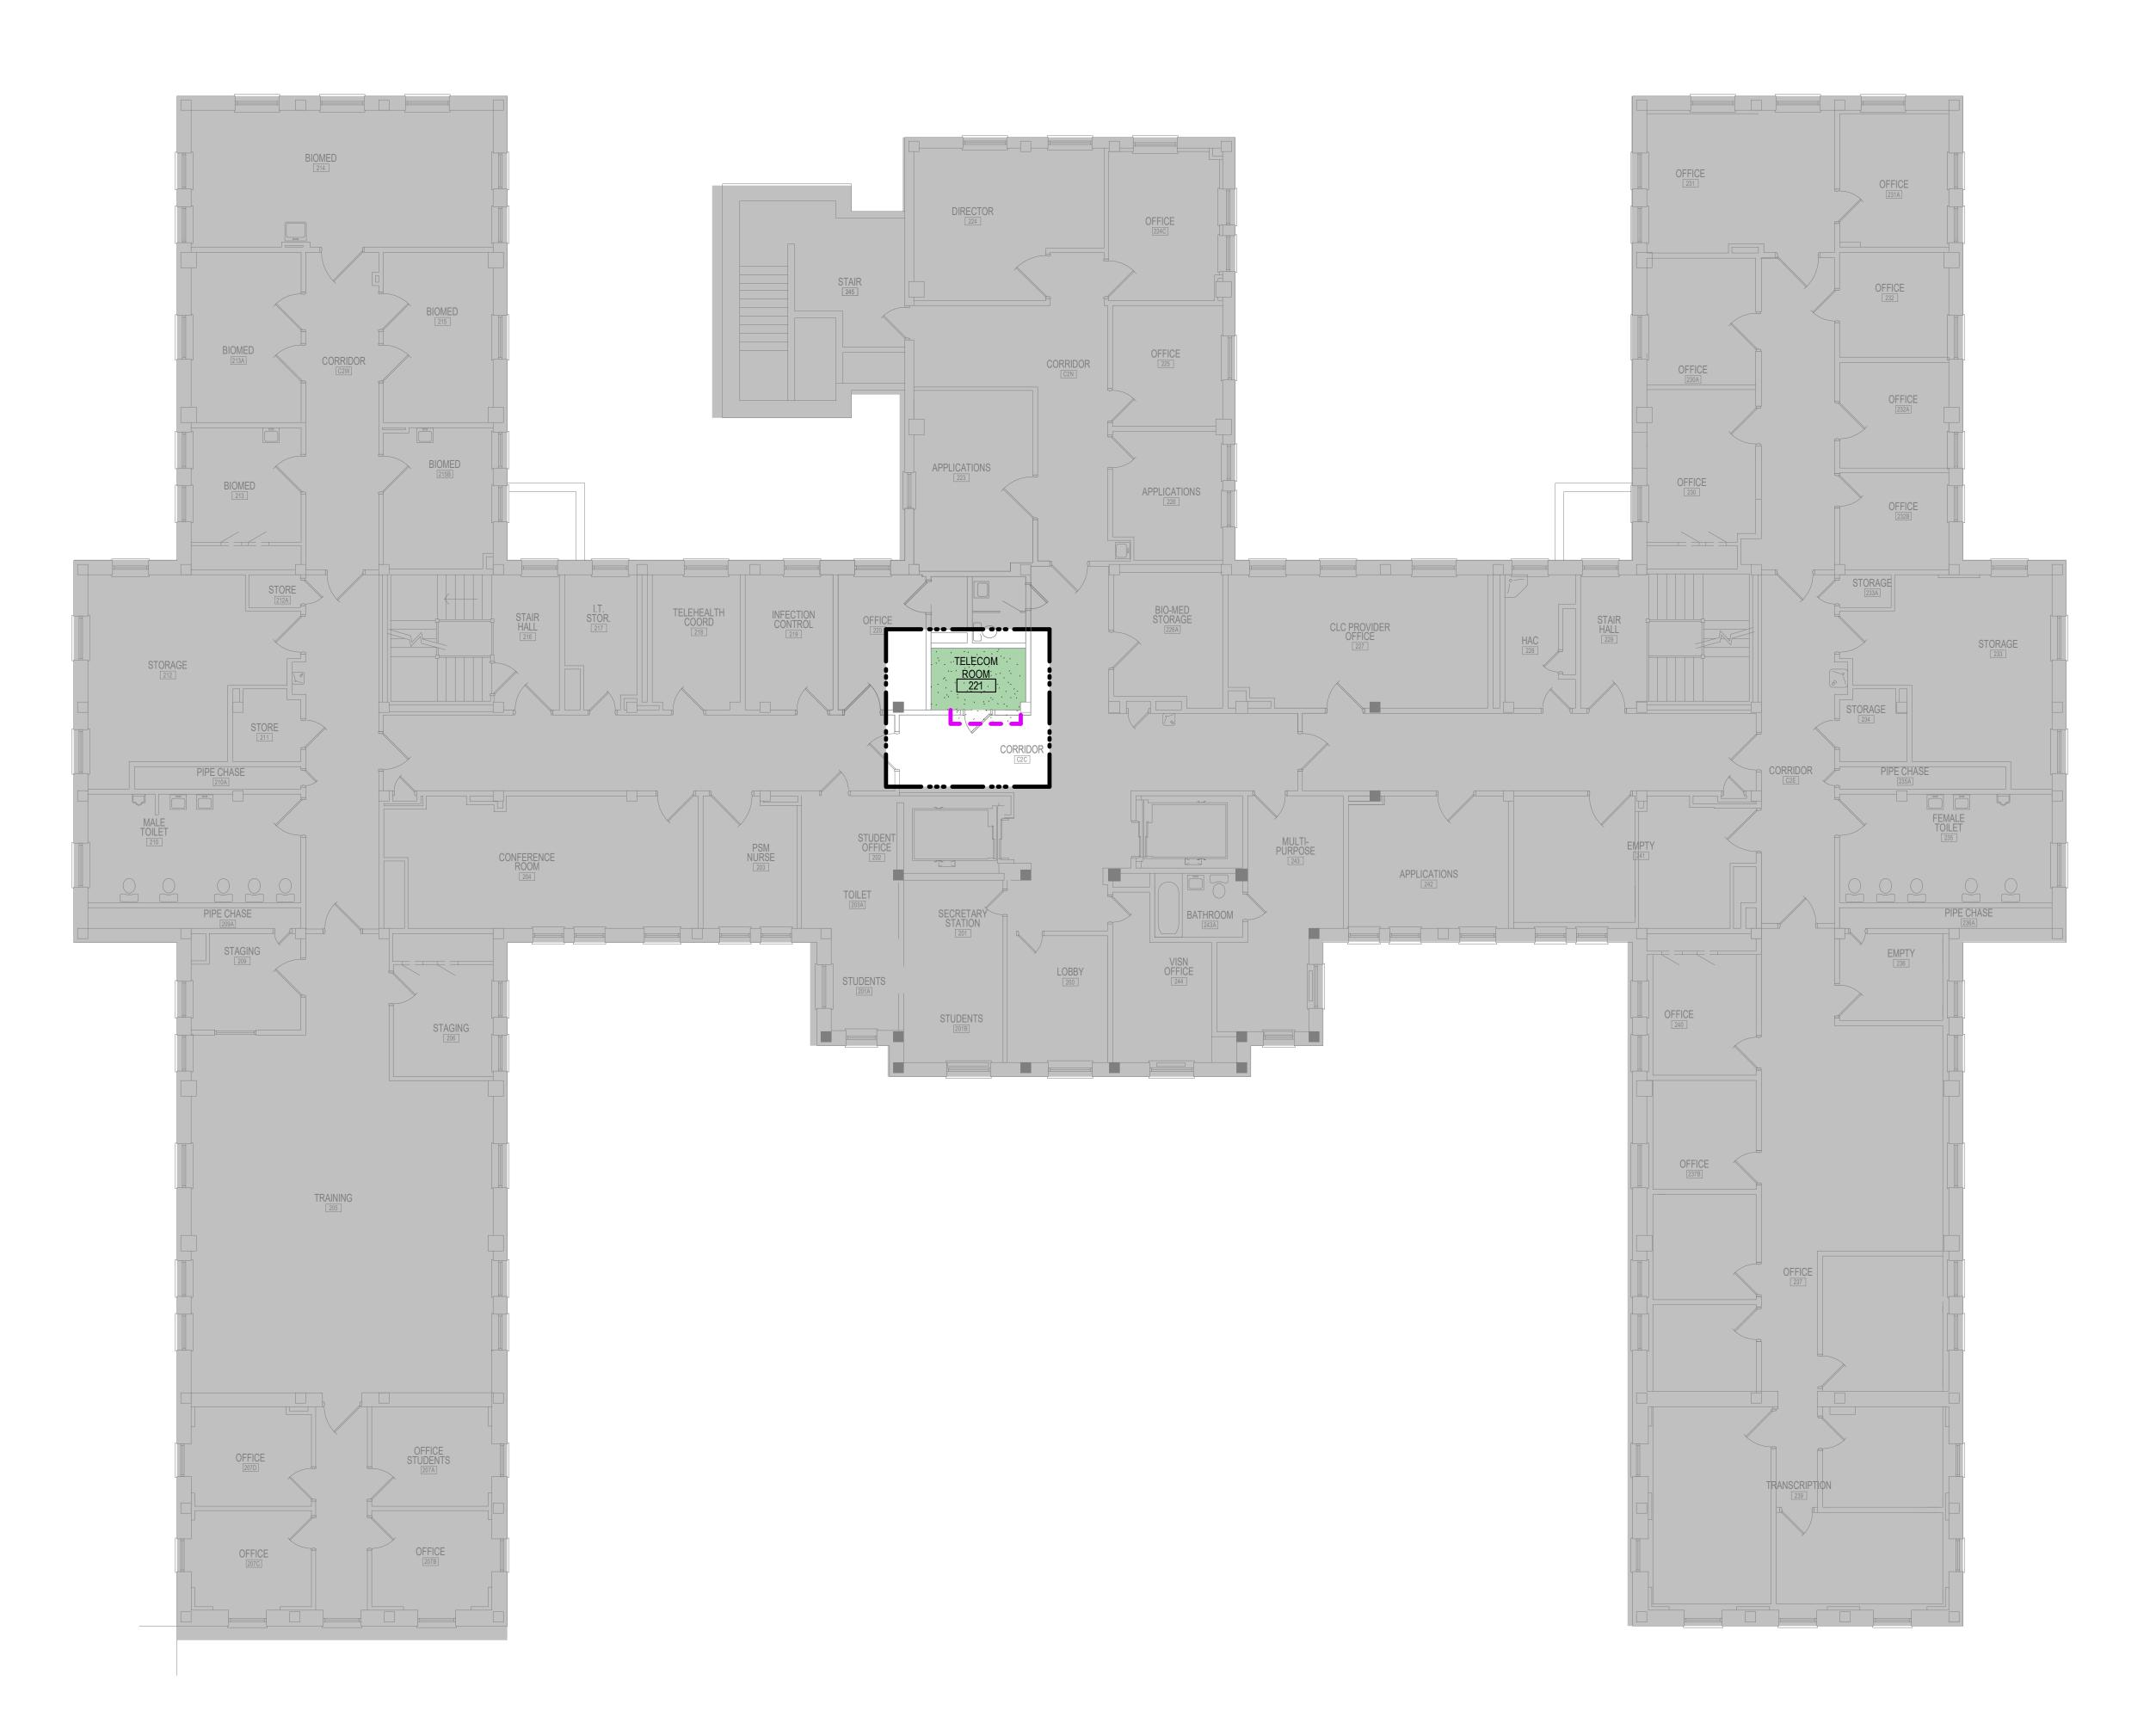


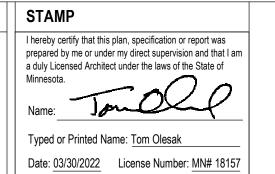FULLY SPRINKLERED

VA MEDICAL CENTER ST.CLOUD, MN 56303

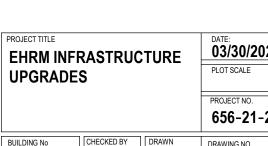





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 2

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			ROOM	MICRA SCHEDULE		
LEVEL	ROOM NO.	ROOM NAME	CAI BLDG NAME / FUNCTION	CONSTRUCTION PROJECT ACTIVITY	INFECTION CONTROL RISK GROUP	CONTROL PROCEDURE CLASS
FIDOT FLOOD	1004	OFFICE	ADMINISTRATIVE / ADUC / CLO	TVDE D	CDOLID 1	CLACC IV
FIRST FLOOR FIRST FLOOR	122A 122B	OFFICE MED ROOM	ADMINISTRATIVE / ADHC / CLC ADMINISTRATIVE / ADHC / CLC	TYPE D TYPE D	GROUP 2 GROUP 2	CLASS IV CLASS IV
FIRST FLOOR	123	TELECOM ROOM	ADMINISTRATIVE / ADHC / CLC	TYPE D	GROUP 2	CLASS IV
SECOND FLOOR		TELECOM ROOM	ADMINISTRATIVE / ADHC / CLC	TYPE C	GROUP 1	CLASS II
		T FOR CONSTRUCTION THE VA WILL BE MADE A		IENT (ICRA) DESCRIPTIONS. TYPE, GRO	DUP AND CLASS SELECTED TO BEST C	F DESIGN TEAM'S KNOWLEDGE.

INFECTION CONTROL RISK ASSESSMENT (ICRA) LEGEND


 LIMITS OF CONSTRUCTION
 1 HOUR FIRE RATED ICRA / CONSTRUCTION BARRIER LOCATION, AND DOOR, WHERE SHOWN
 TEMPORARY NON-RATED (PLASTIC SHEETING) CONSTRUCTION BARRIER LOCATION, WHERE APPROVED BY THE VA FOR USE IN RISK TYPE B. UPGRADE TO 1 HOUR RATED PARTITION WHEN DIRECTED BY THE VA

SECOND FLOOR - CONST BARRIER PLAN


REVISION






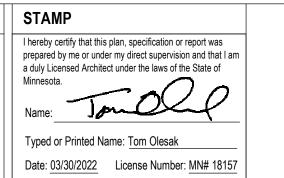




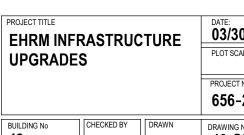

VA MEDICAL CENTER ST.CLOUD, MN 56303

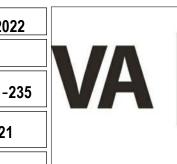



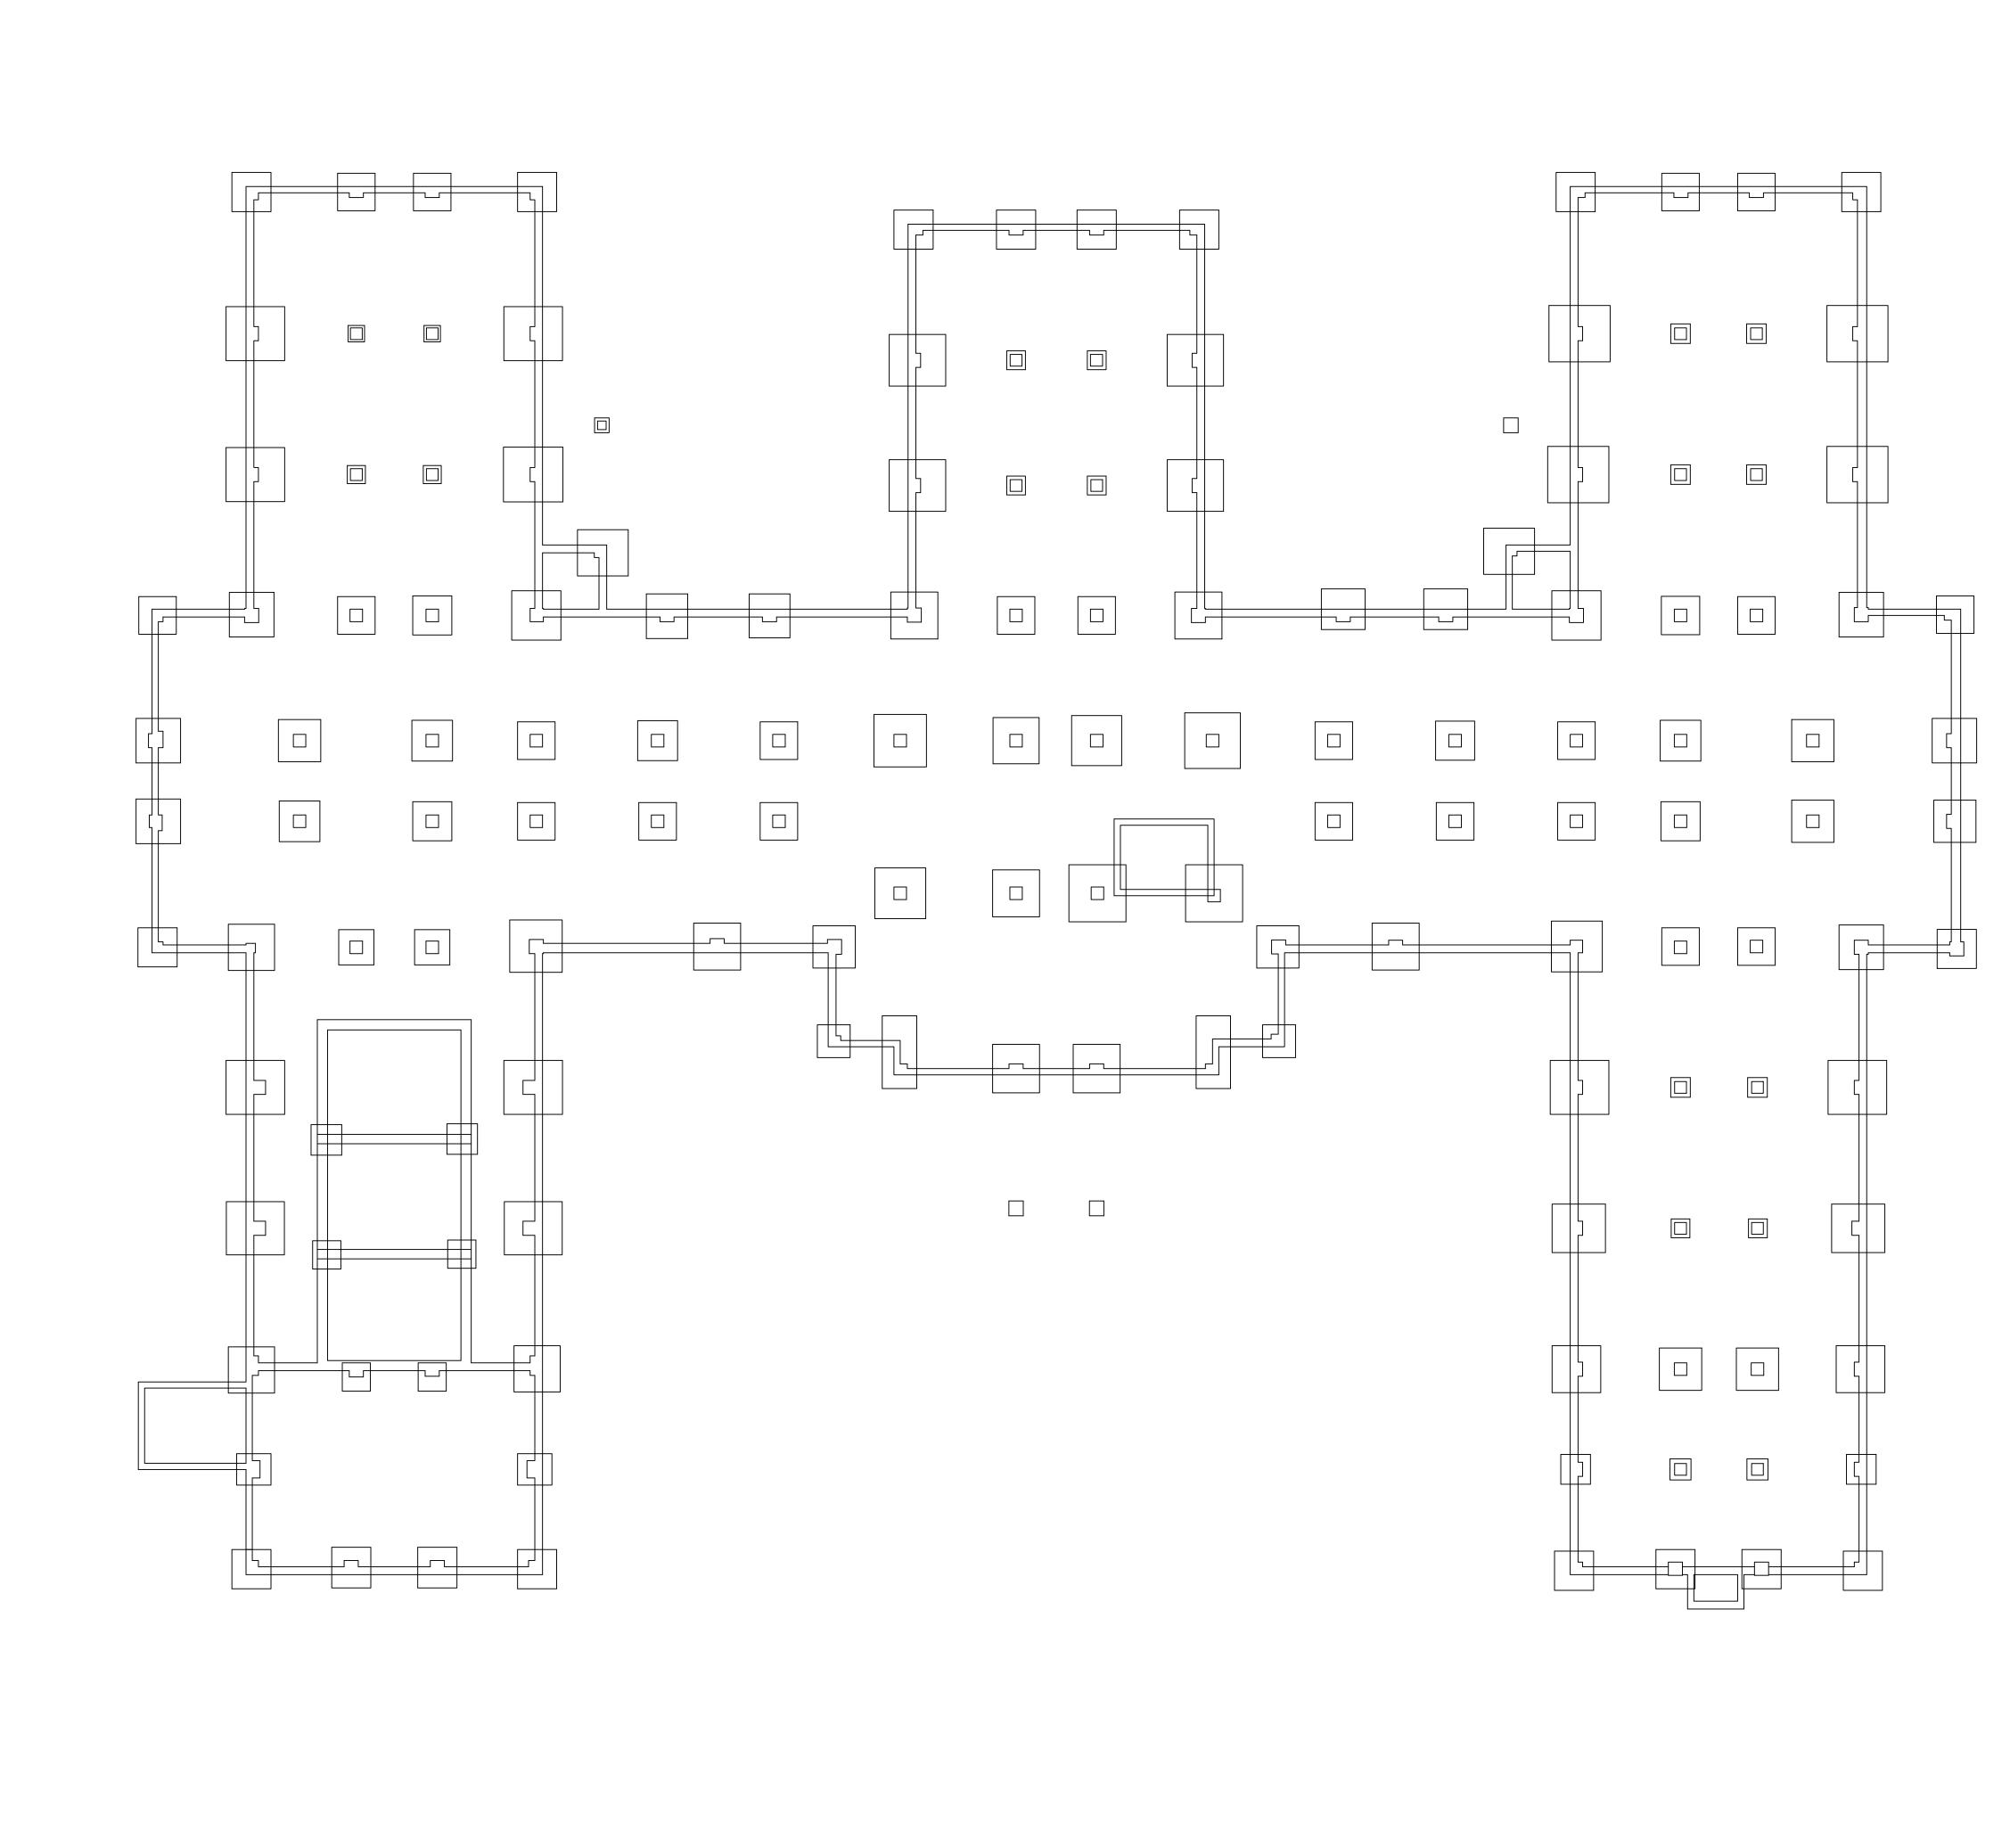

BUILDING #48 - CRAWLSPACE FLOOR PLAN

NO ACM

ENVIRONMENTAL CONSULTANT:

CASTLE HILL ASSOCIATES, LLC.


218-A MECHANIC STREET,

WATERVILLE, OHIO 43566

Tel: (567) 952-0212





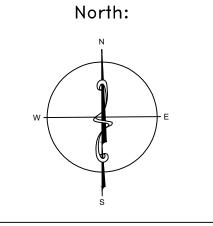

Approved : Service Director


ARCHITECTURAL PLAN BUILDING 48 Scale: 1/8" = 1'-0"	MEDIC	ESTOS RE-SU ADMINISTRAT CAL CENTER ID, MINNESOT	ION
Approved : Division Chief	Building Number	Checked	Drawn
	048	BLB	AF


NOVEMBER 2019
Project No.
36C26319P1003


Drawn
AFS


Drawing No.
1A


ST. CLOUD, MINNESOTA

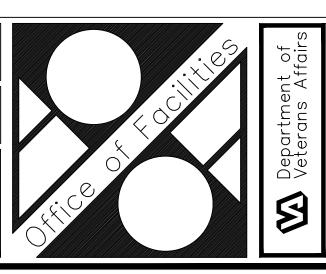


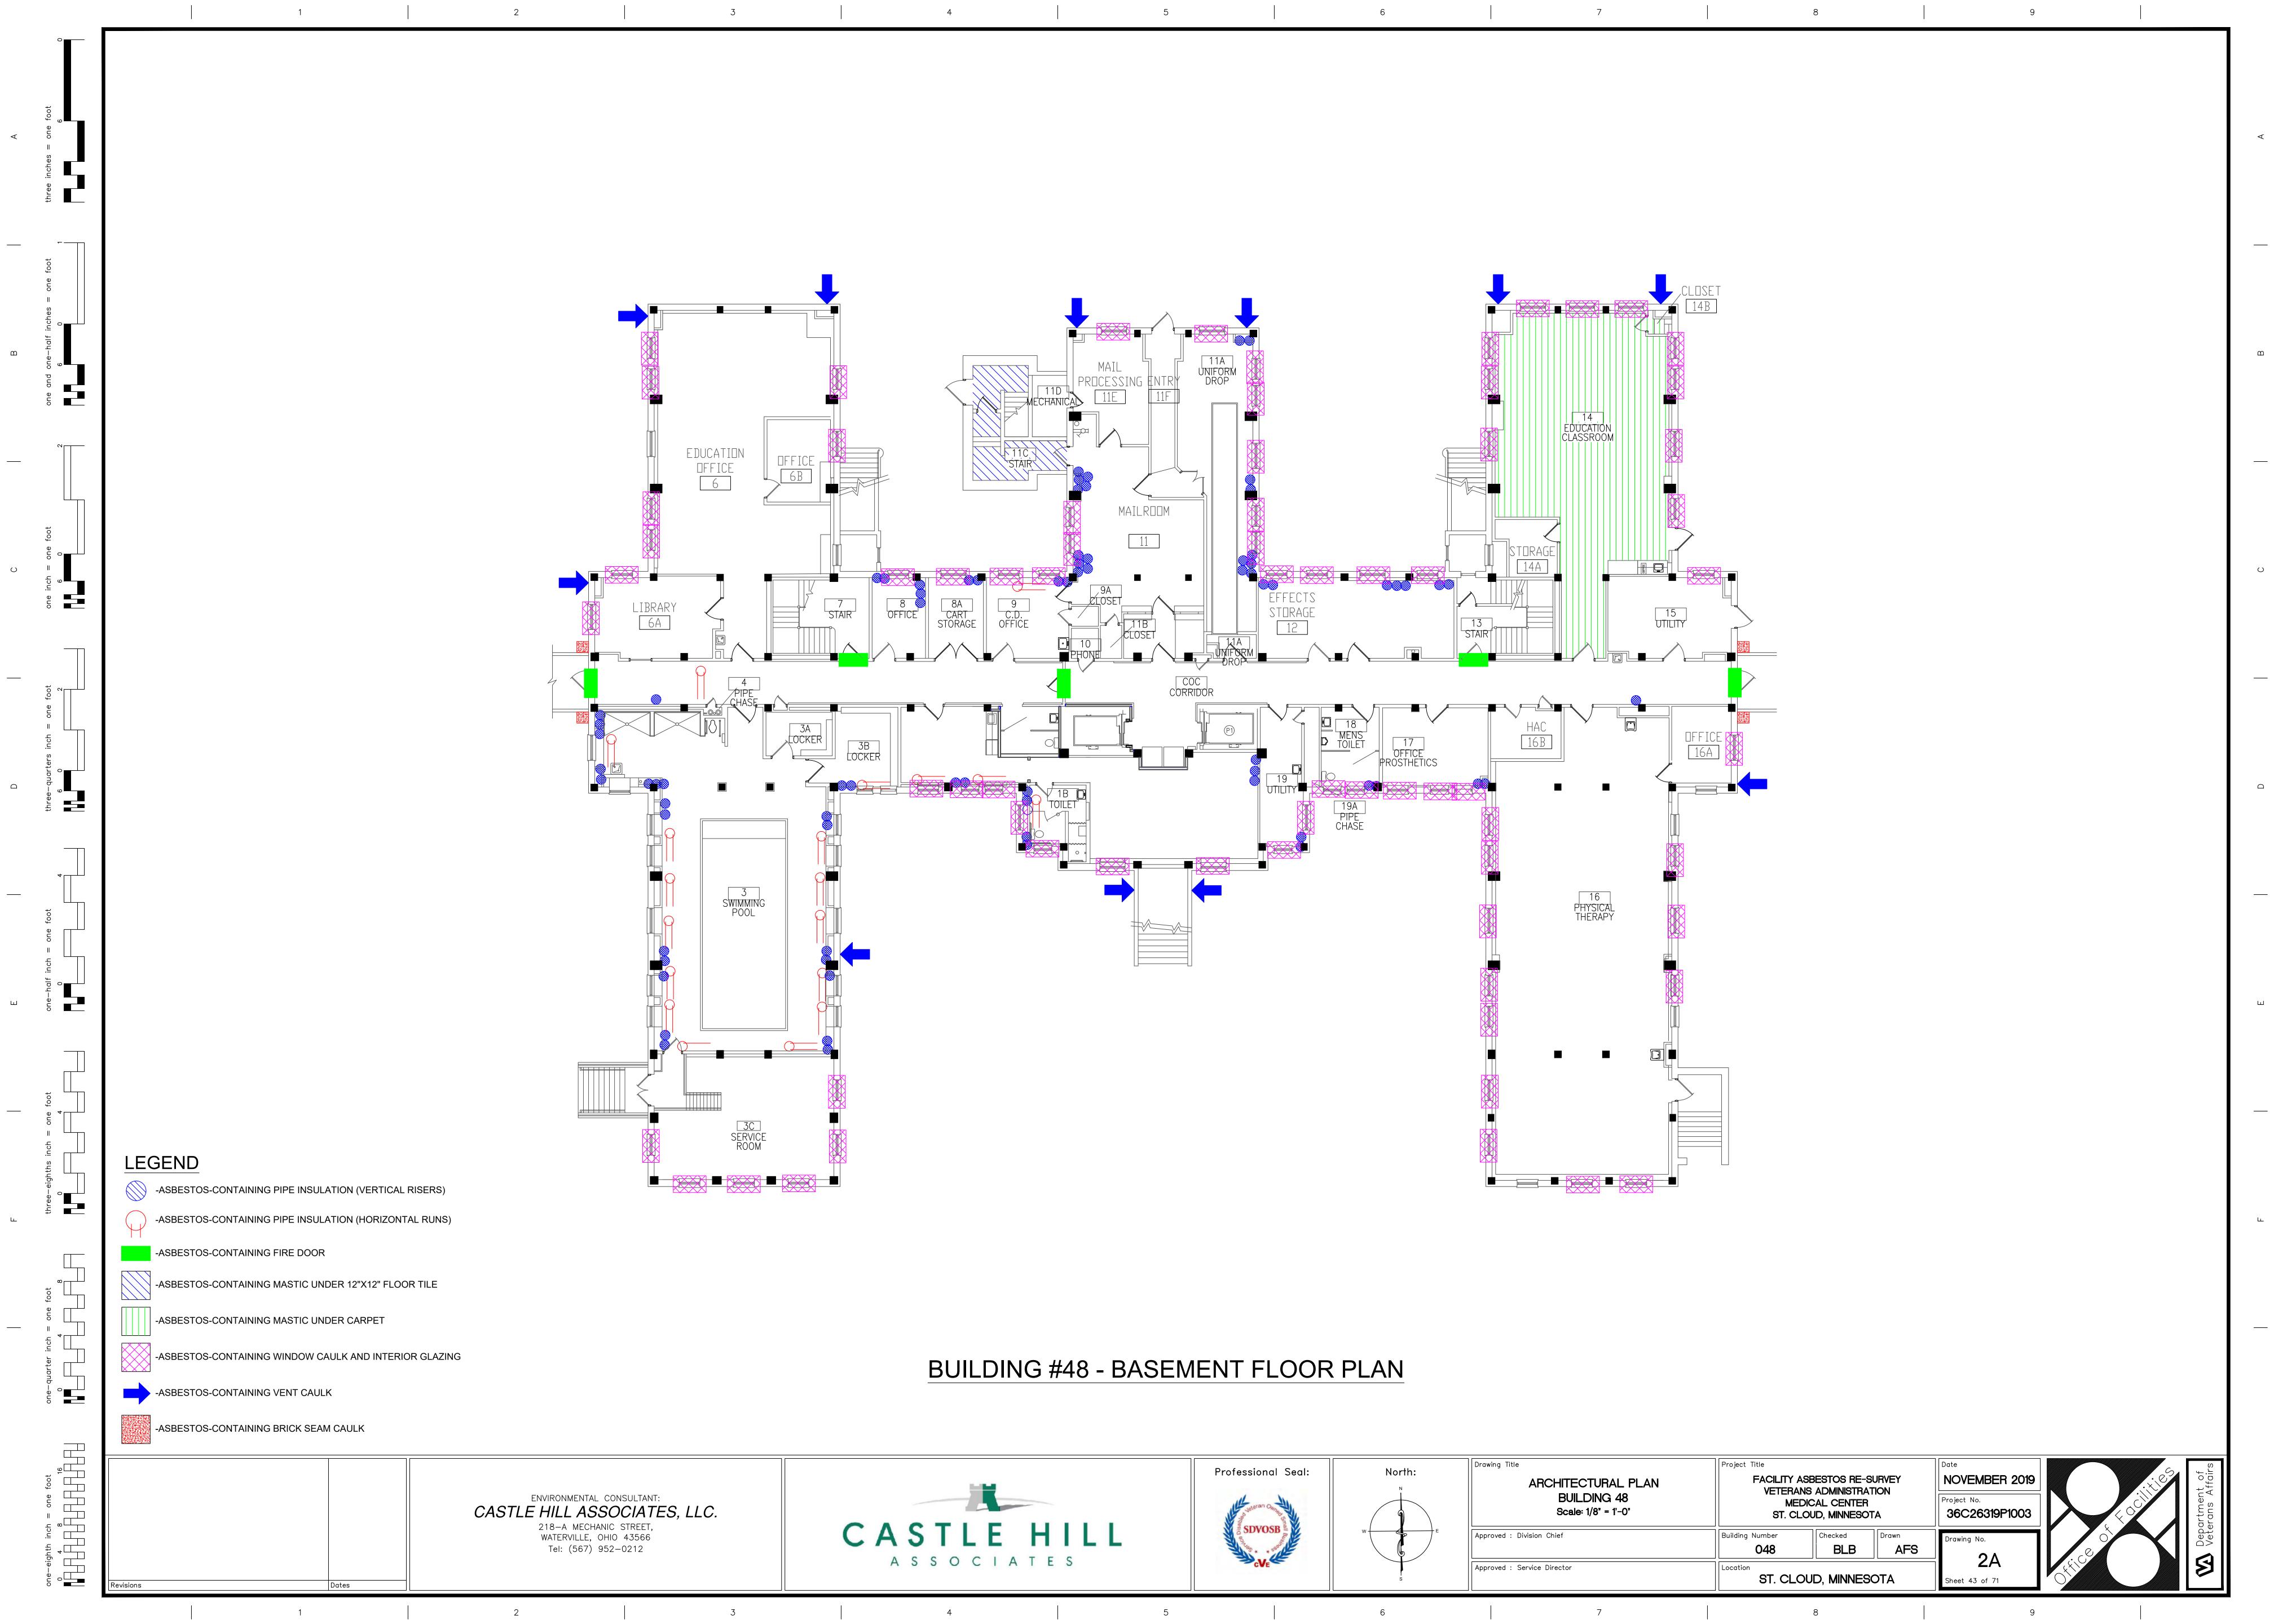

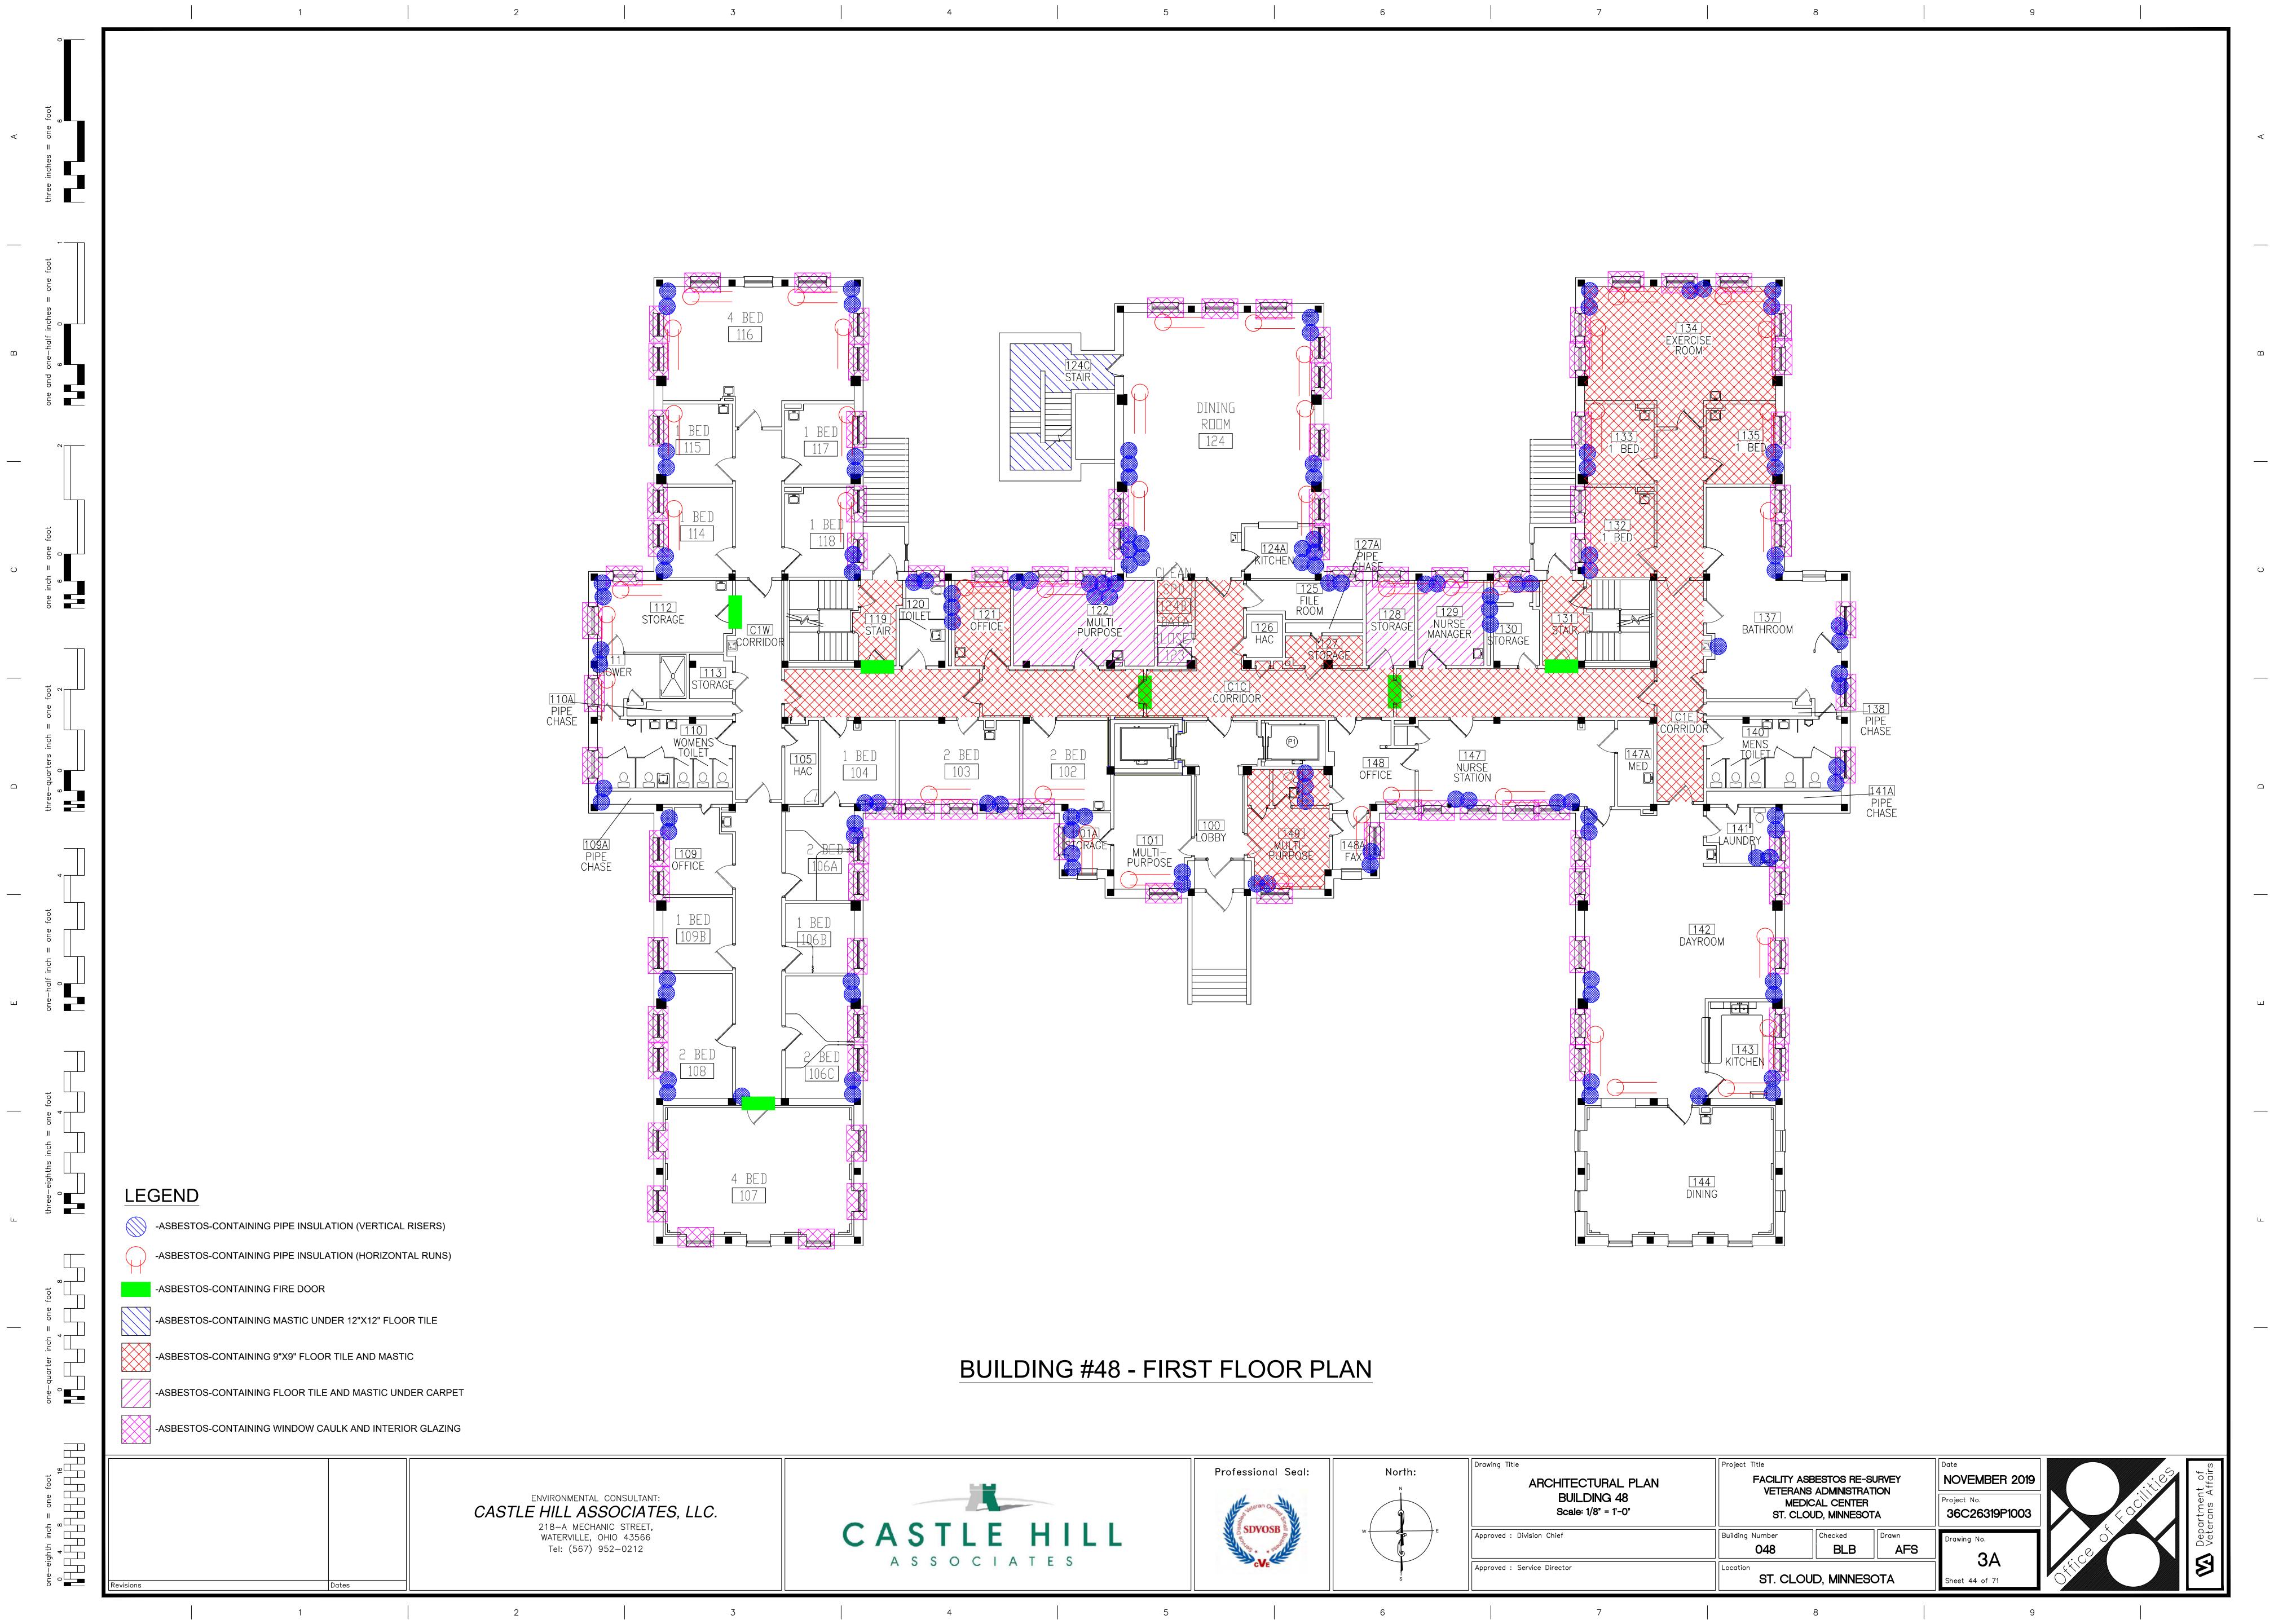

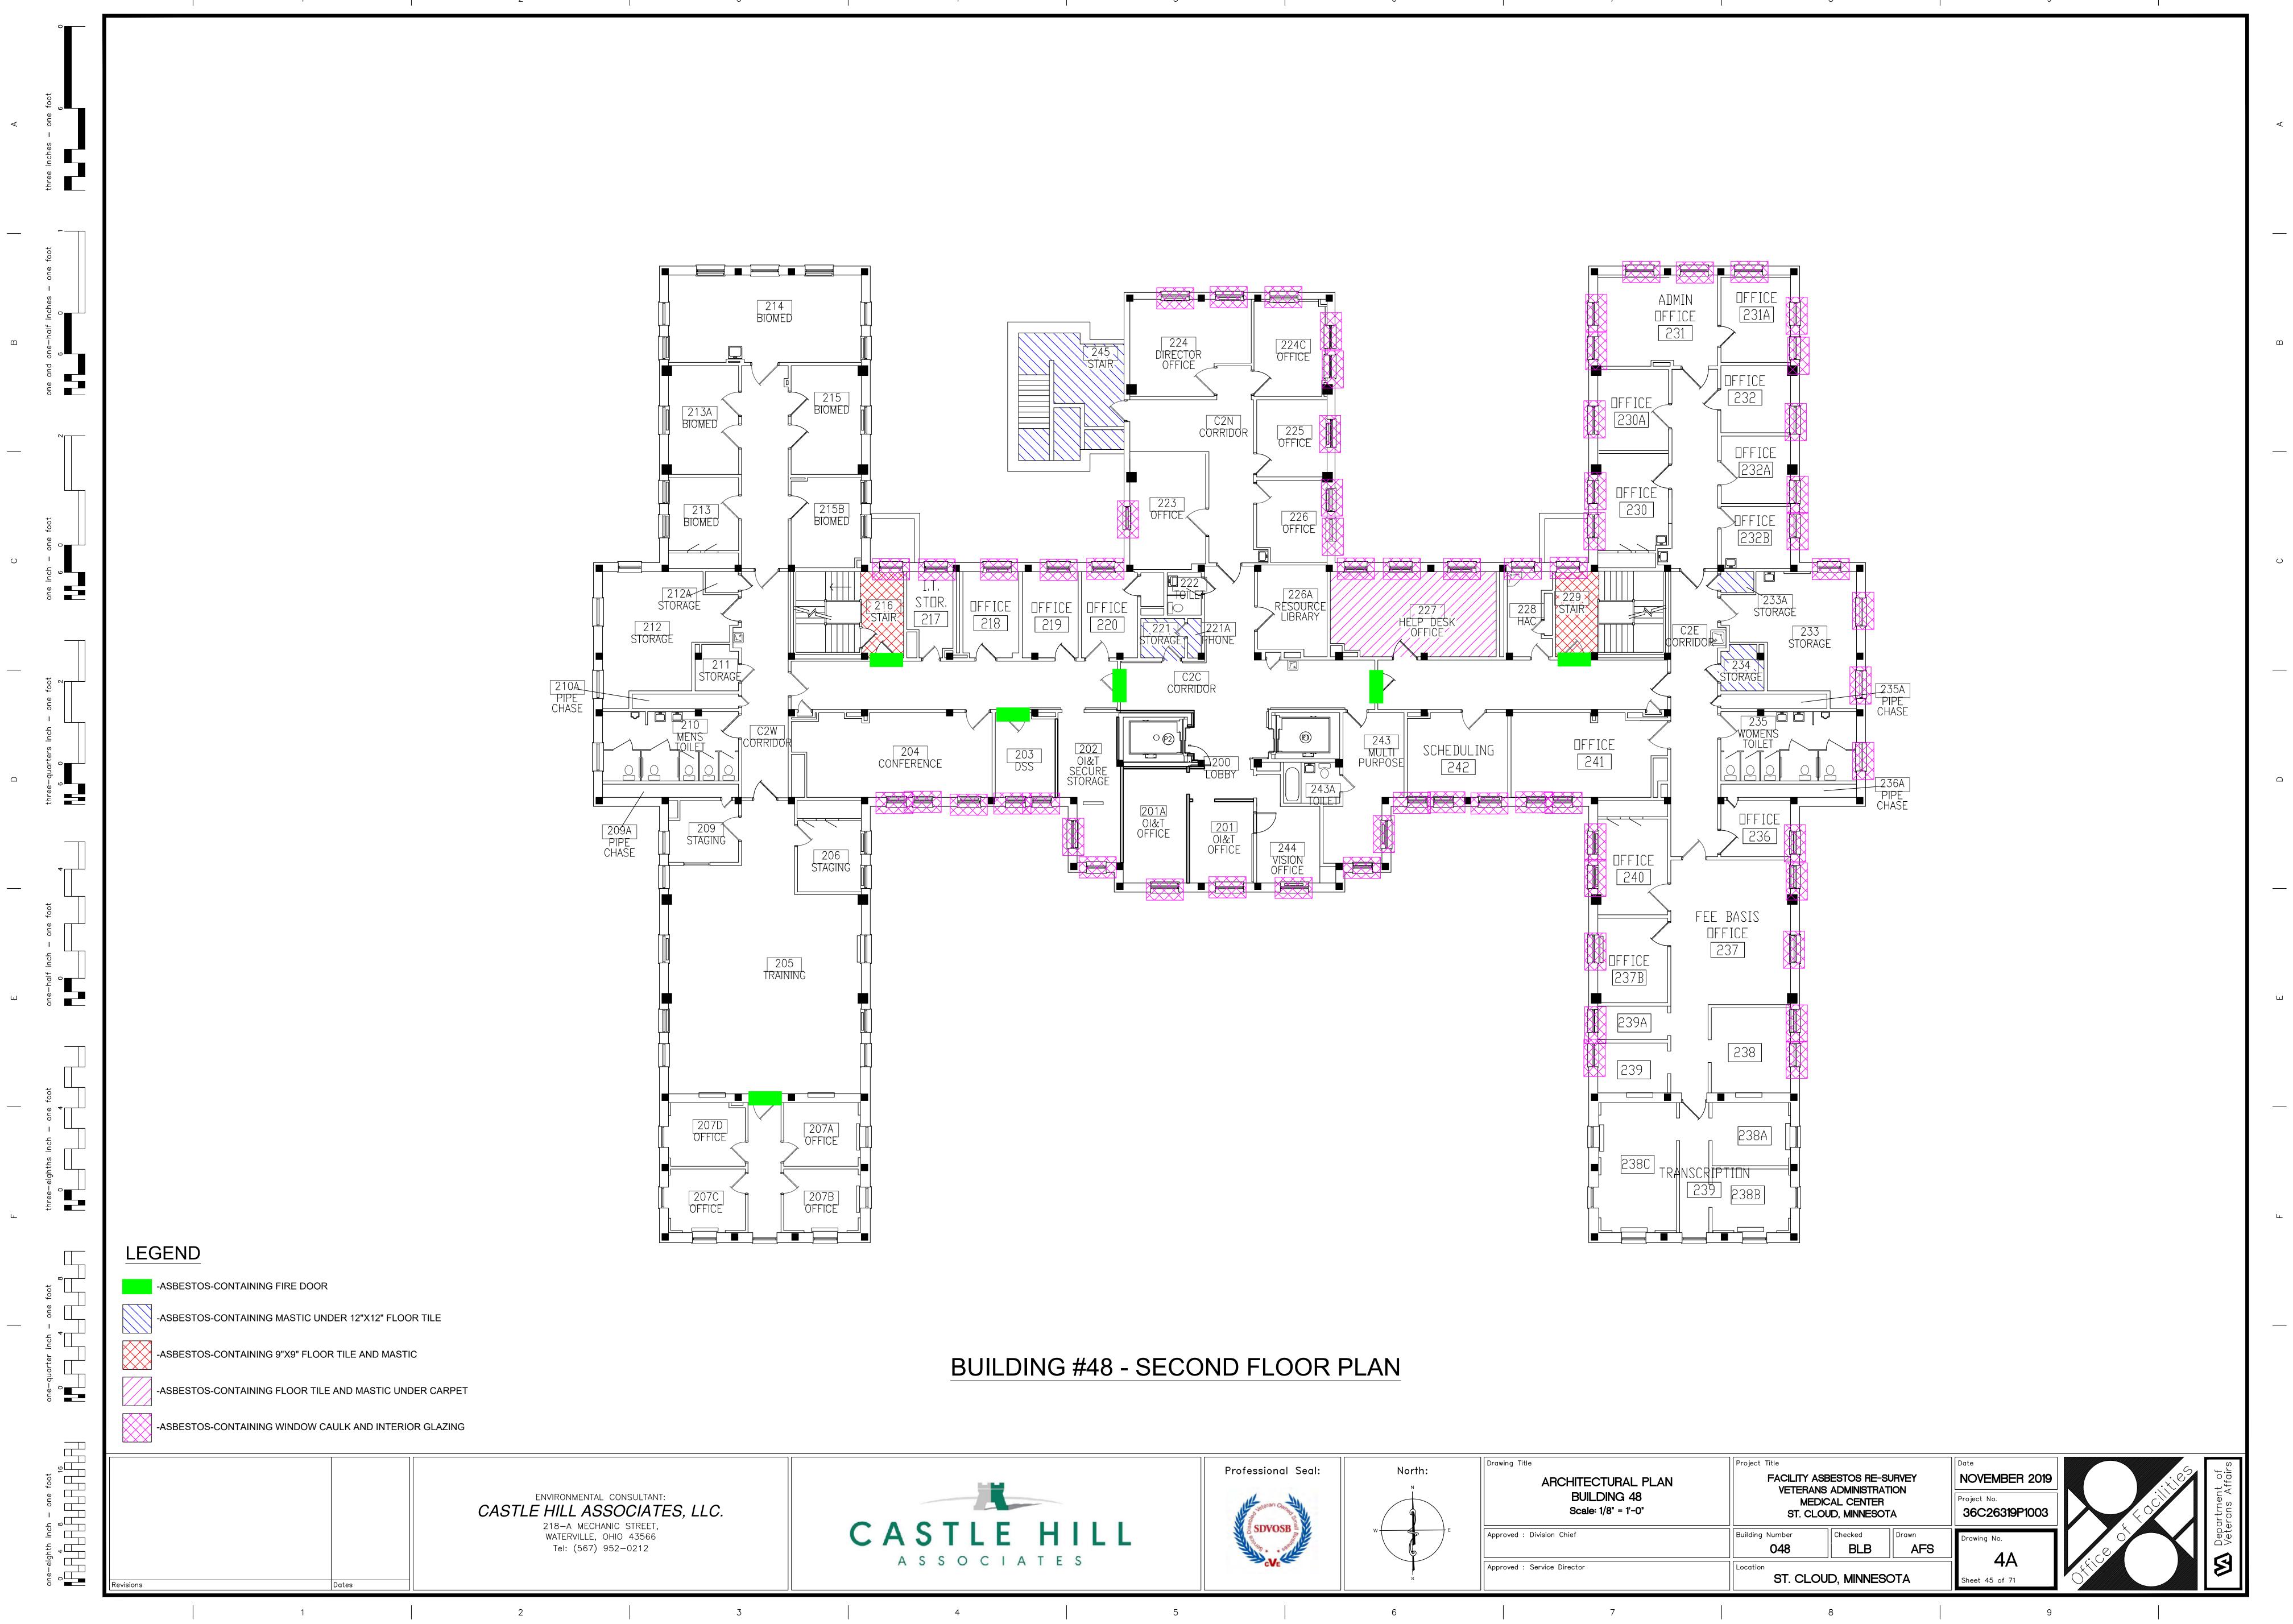

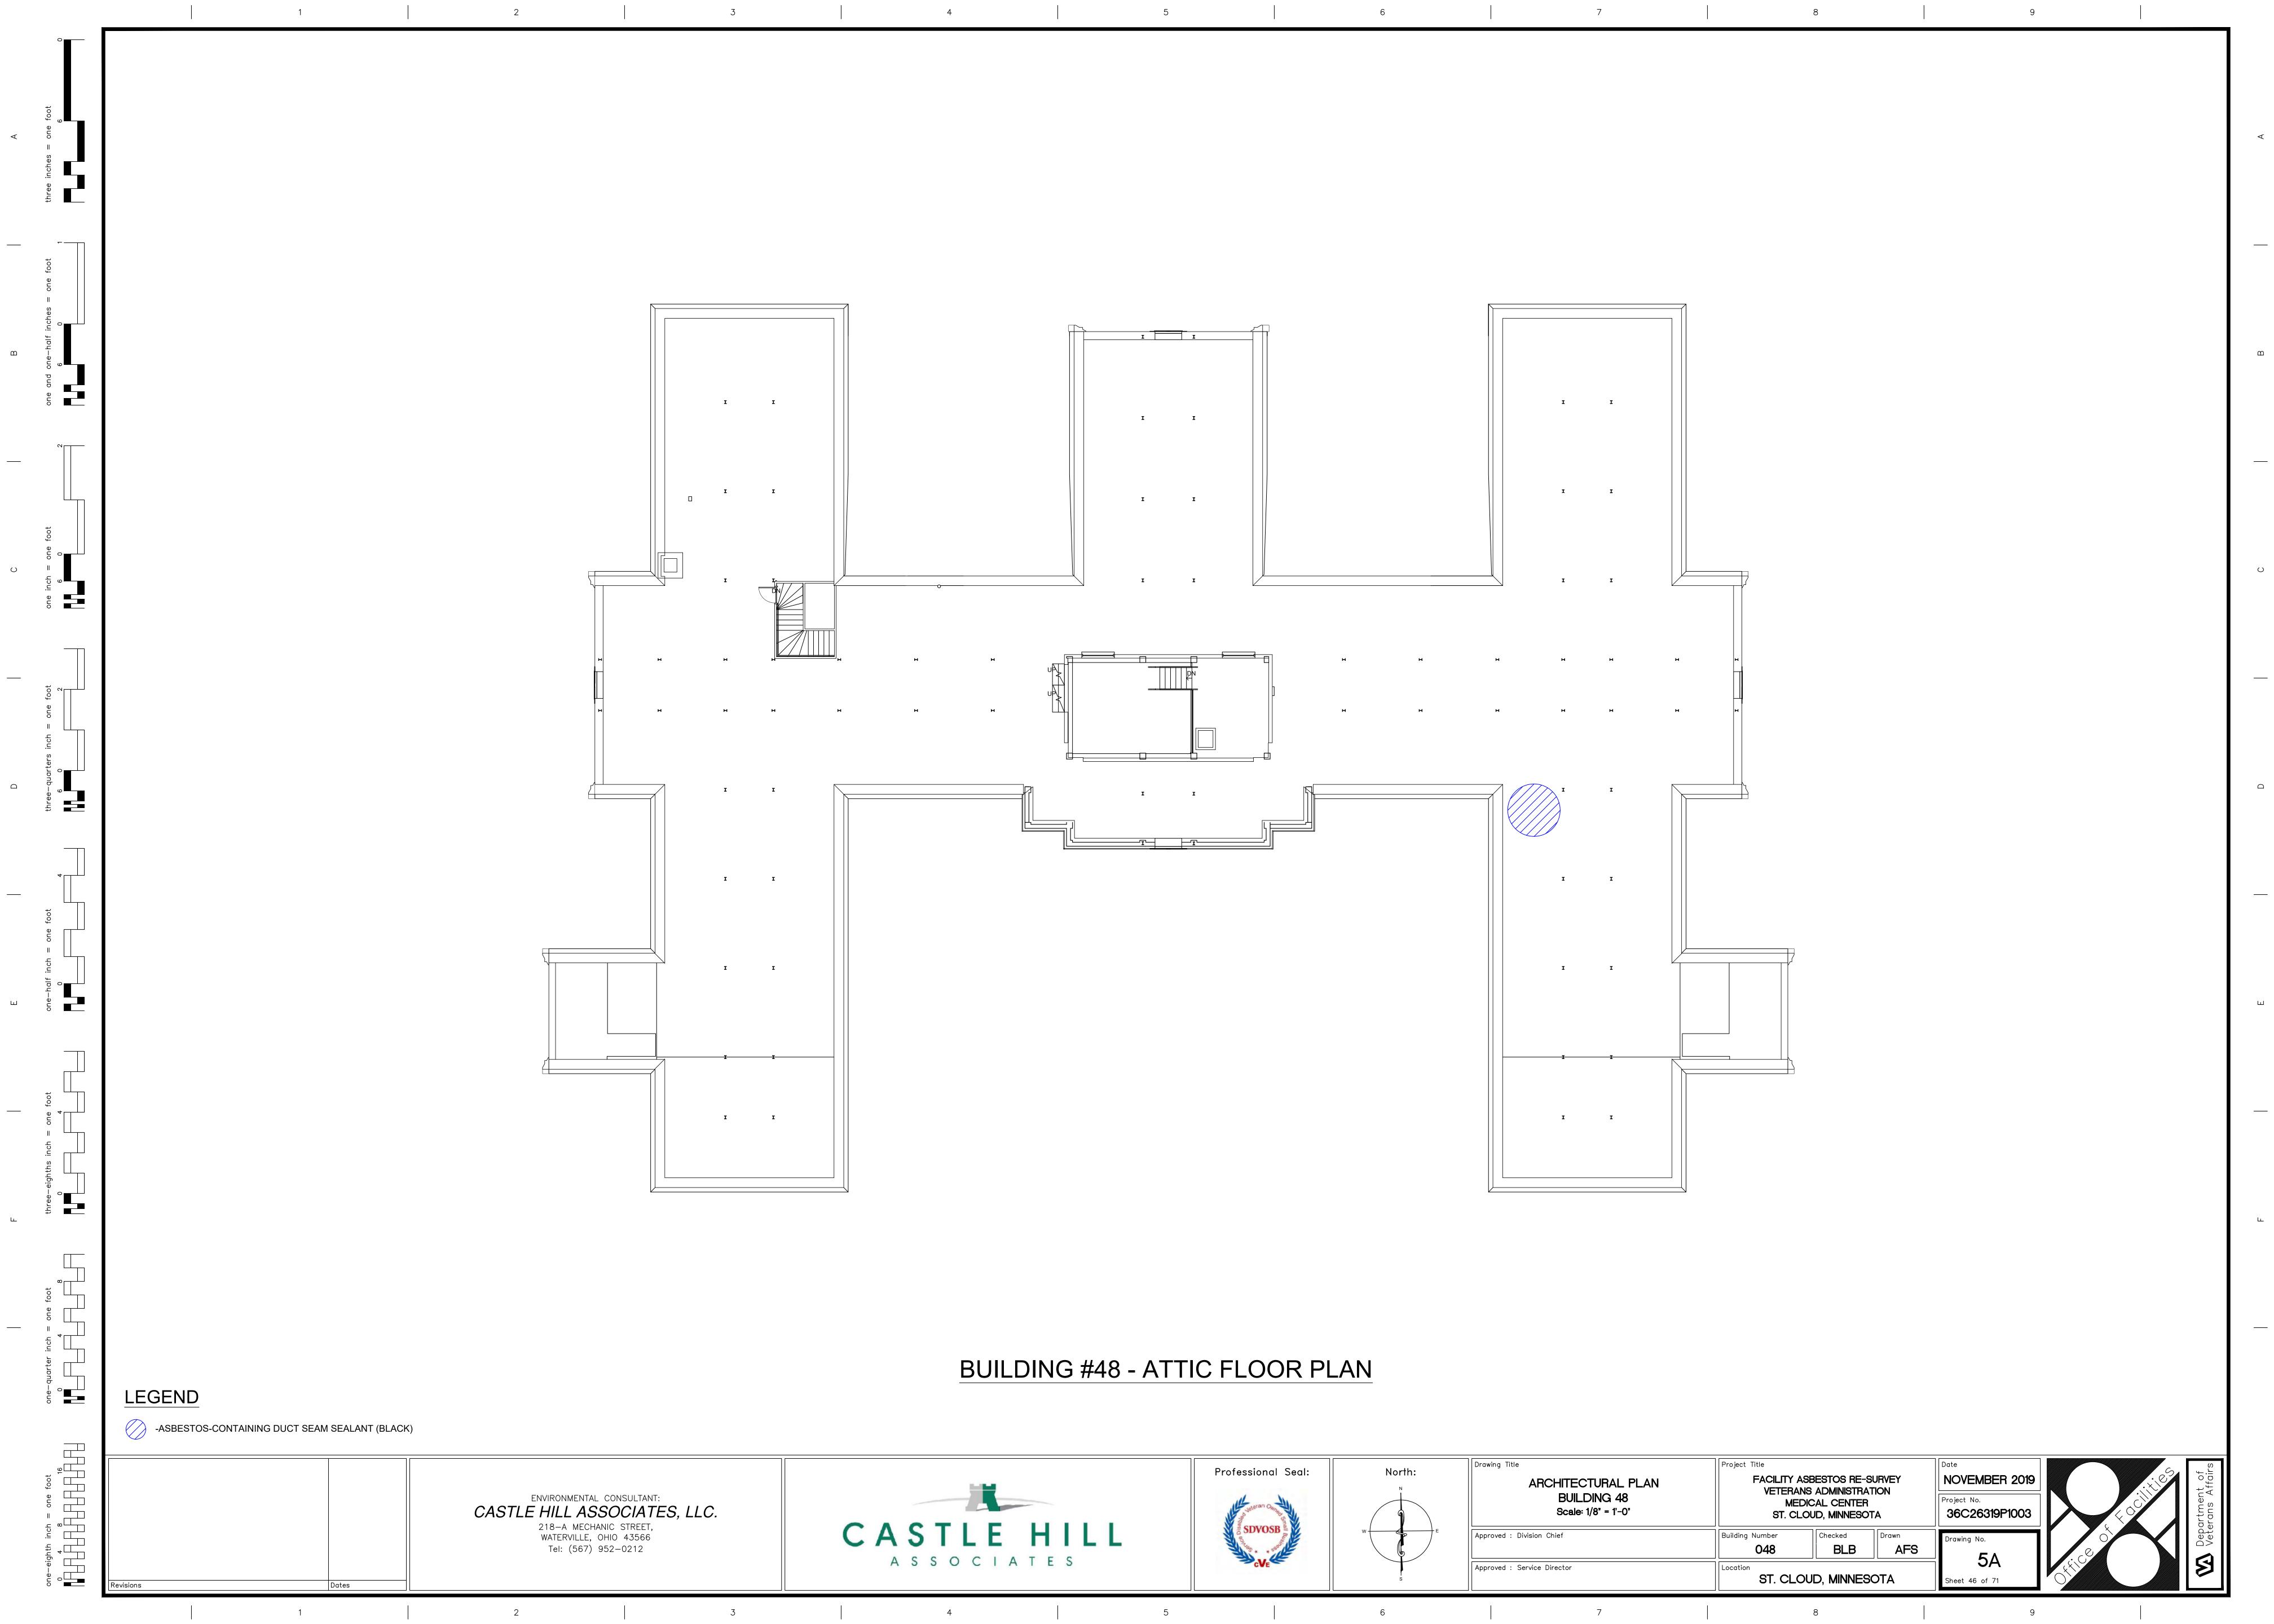

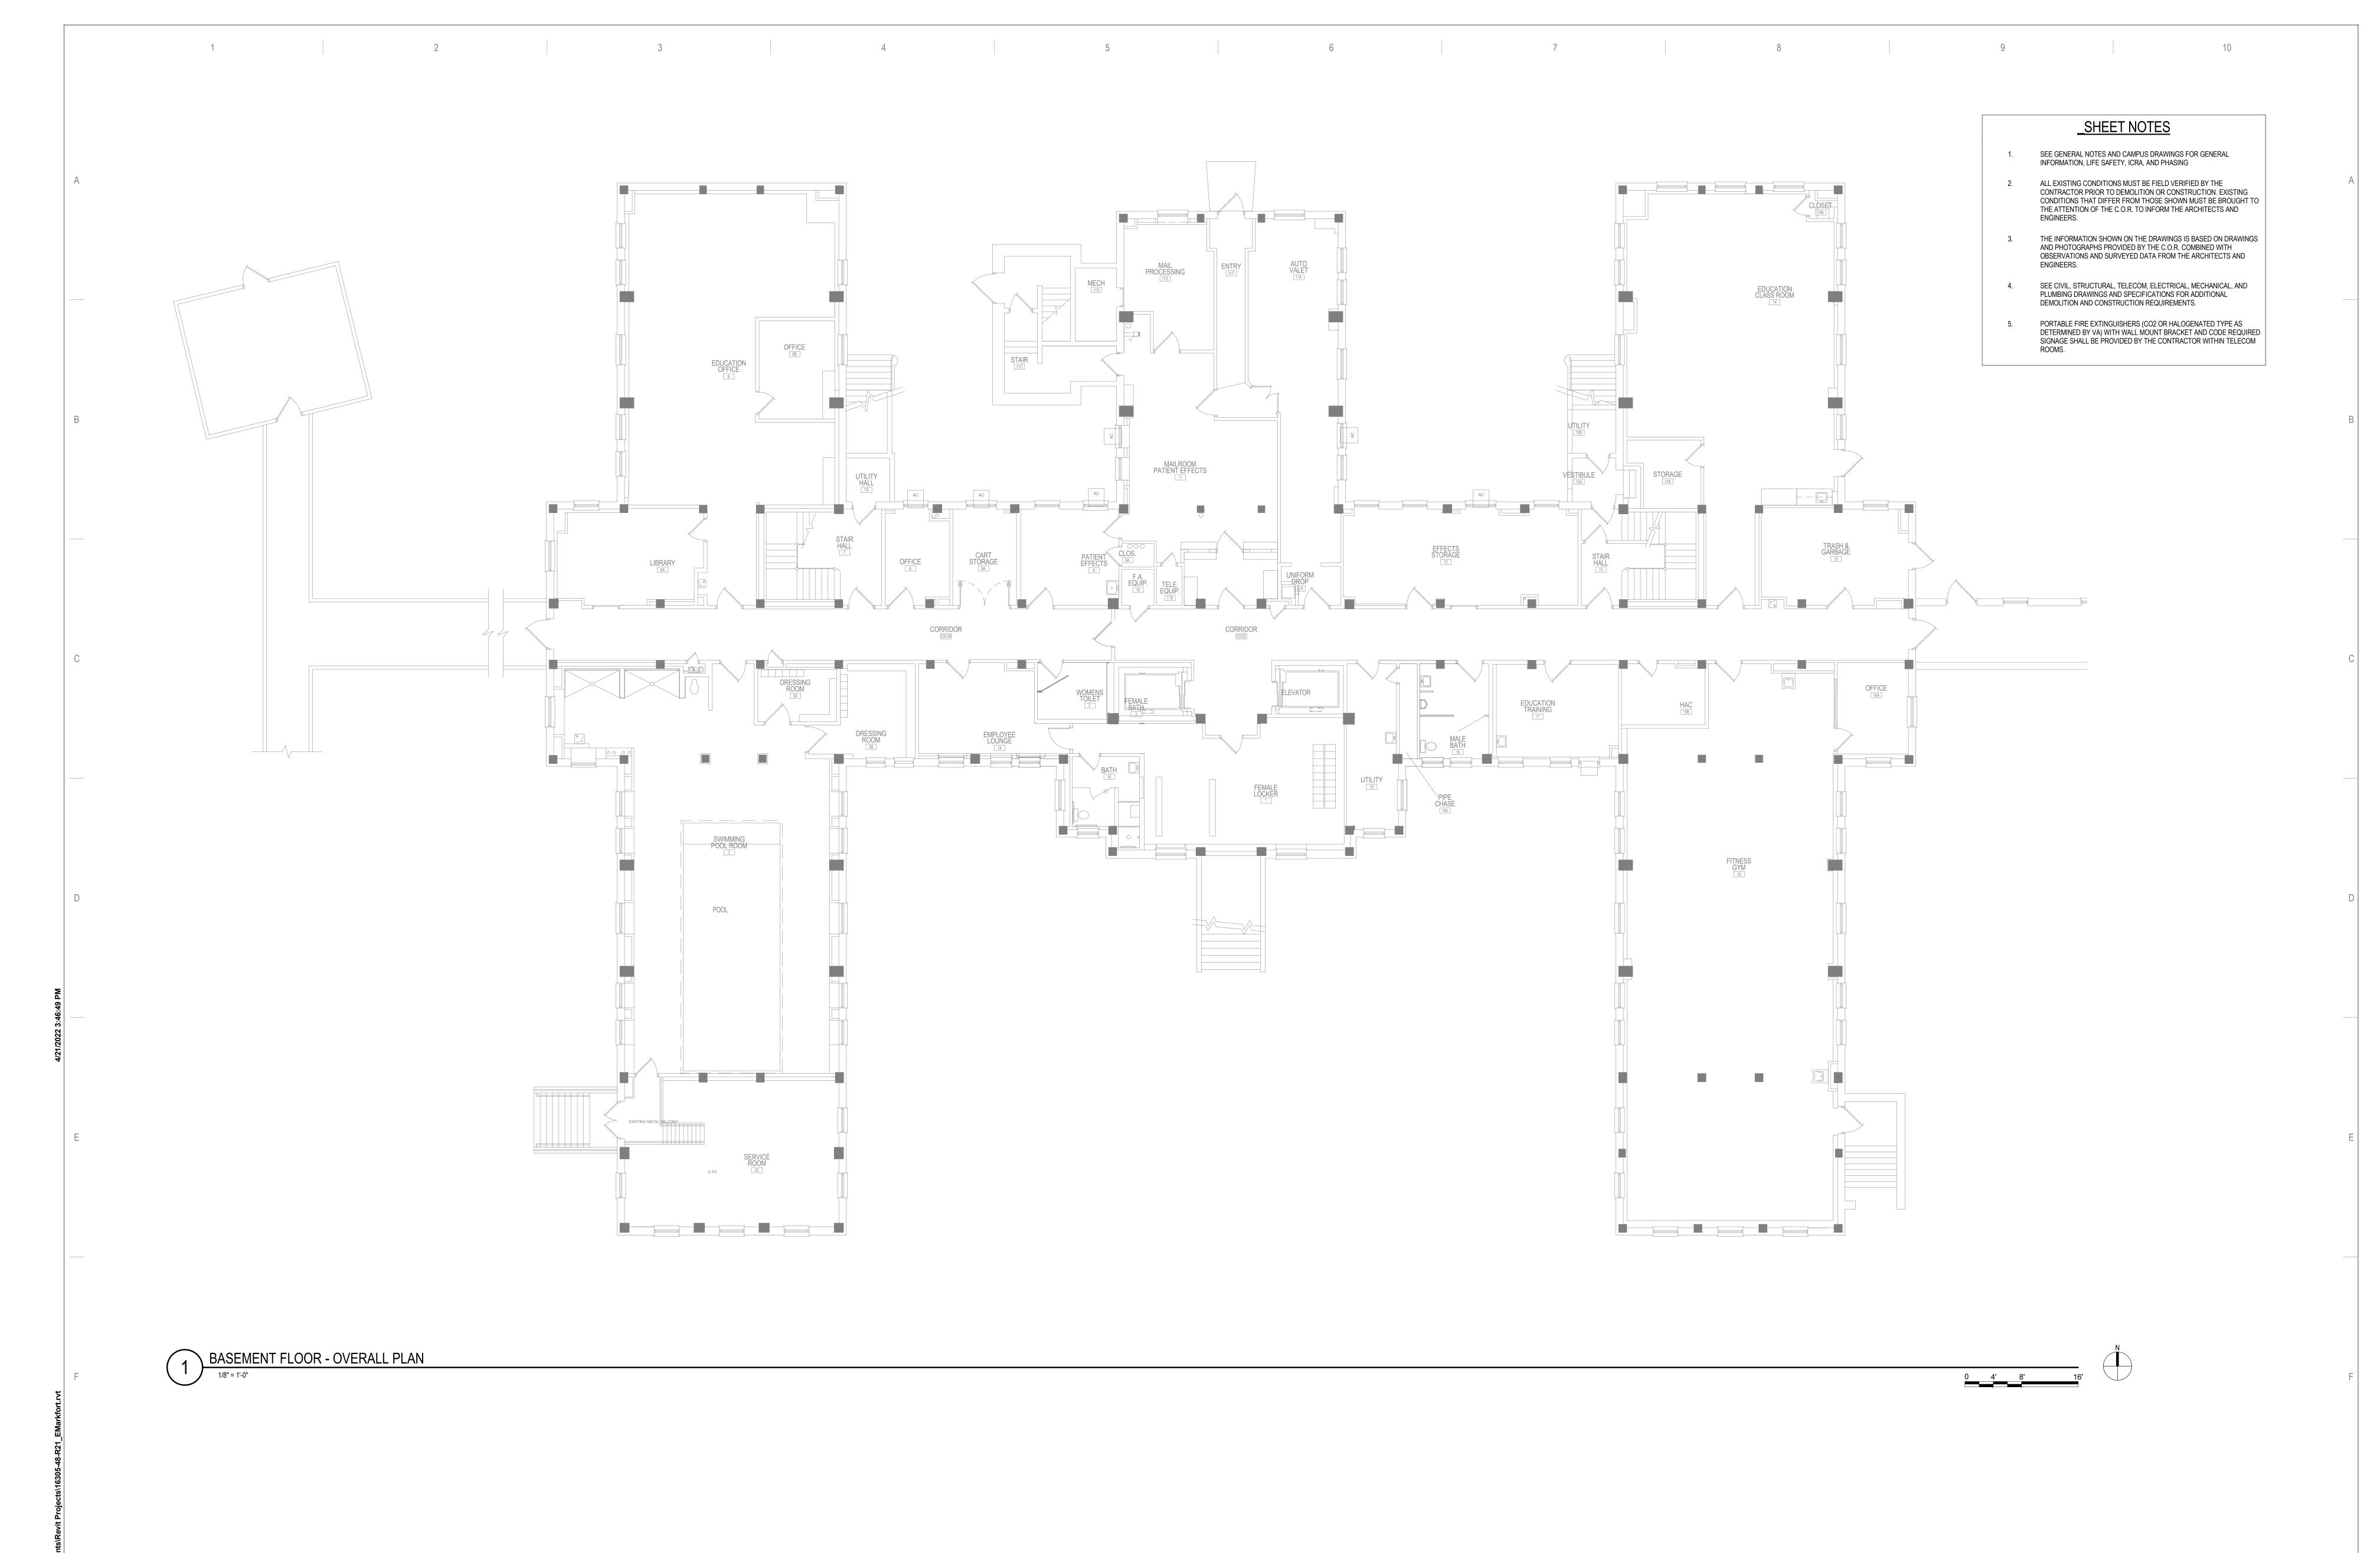

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No REVISION

DATE

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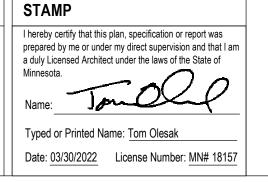
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PROJECT TITLE

EHRM INFRASTRUCTURE
UPGRADES


DATE:
03/30/20
PLOT SCALE

PROJECT NO.
656-21-

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VA MEDICAL CENTER ST.CLOUD, MN 56303 A PROPERTY OF VALUE O







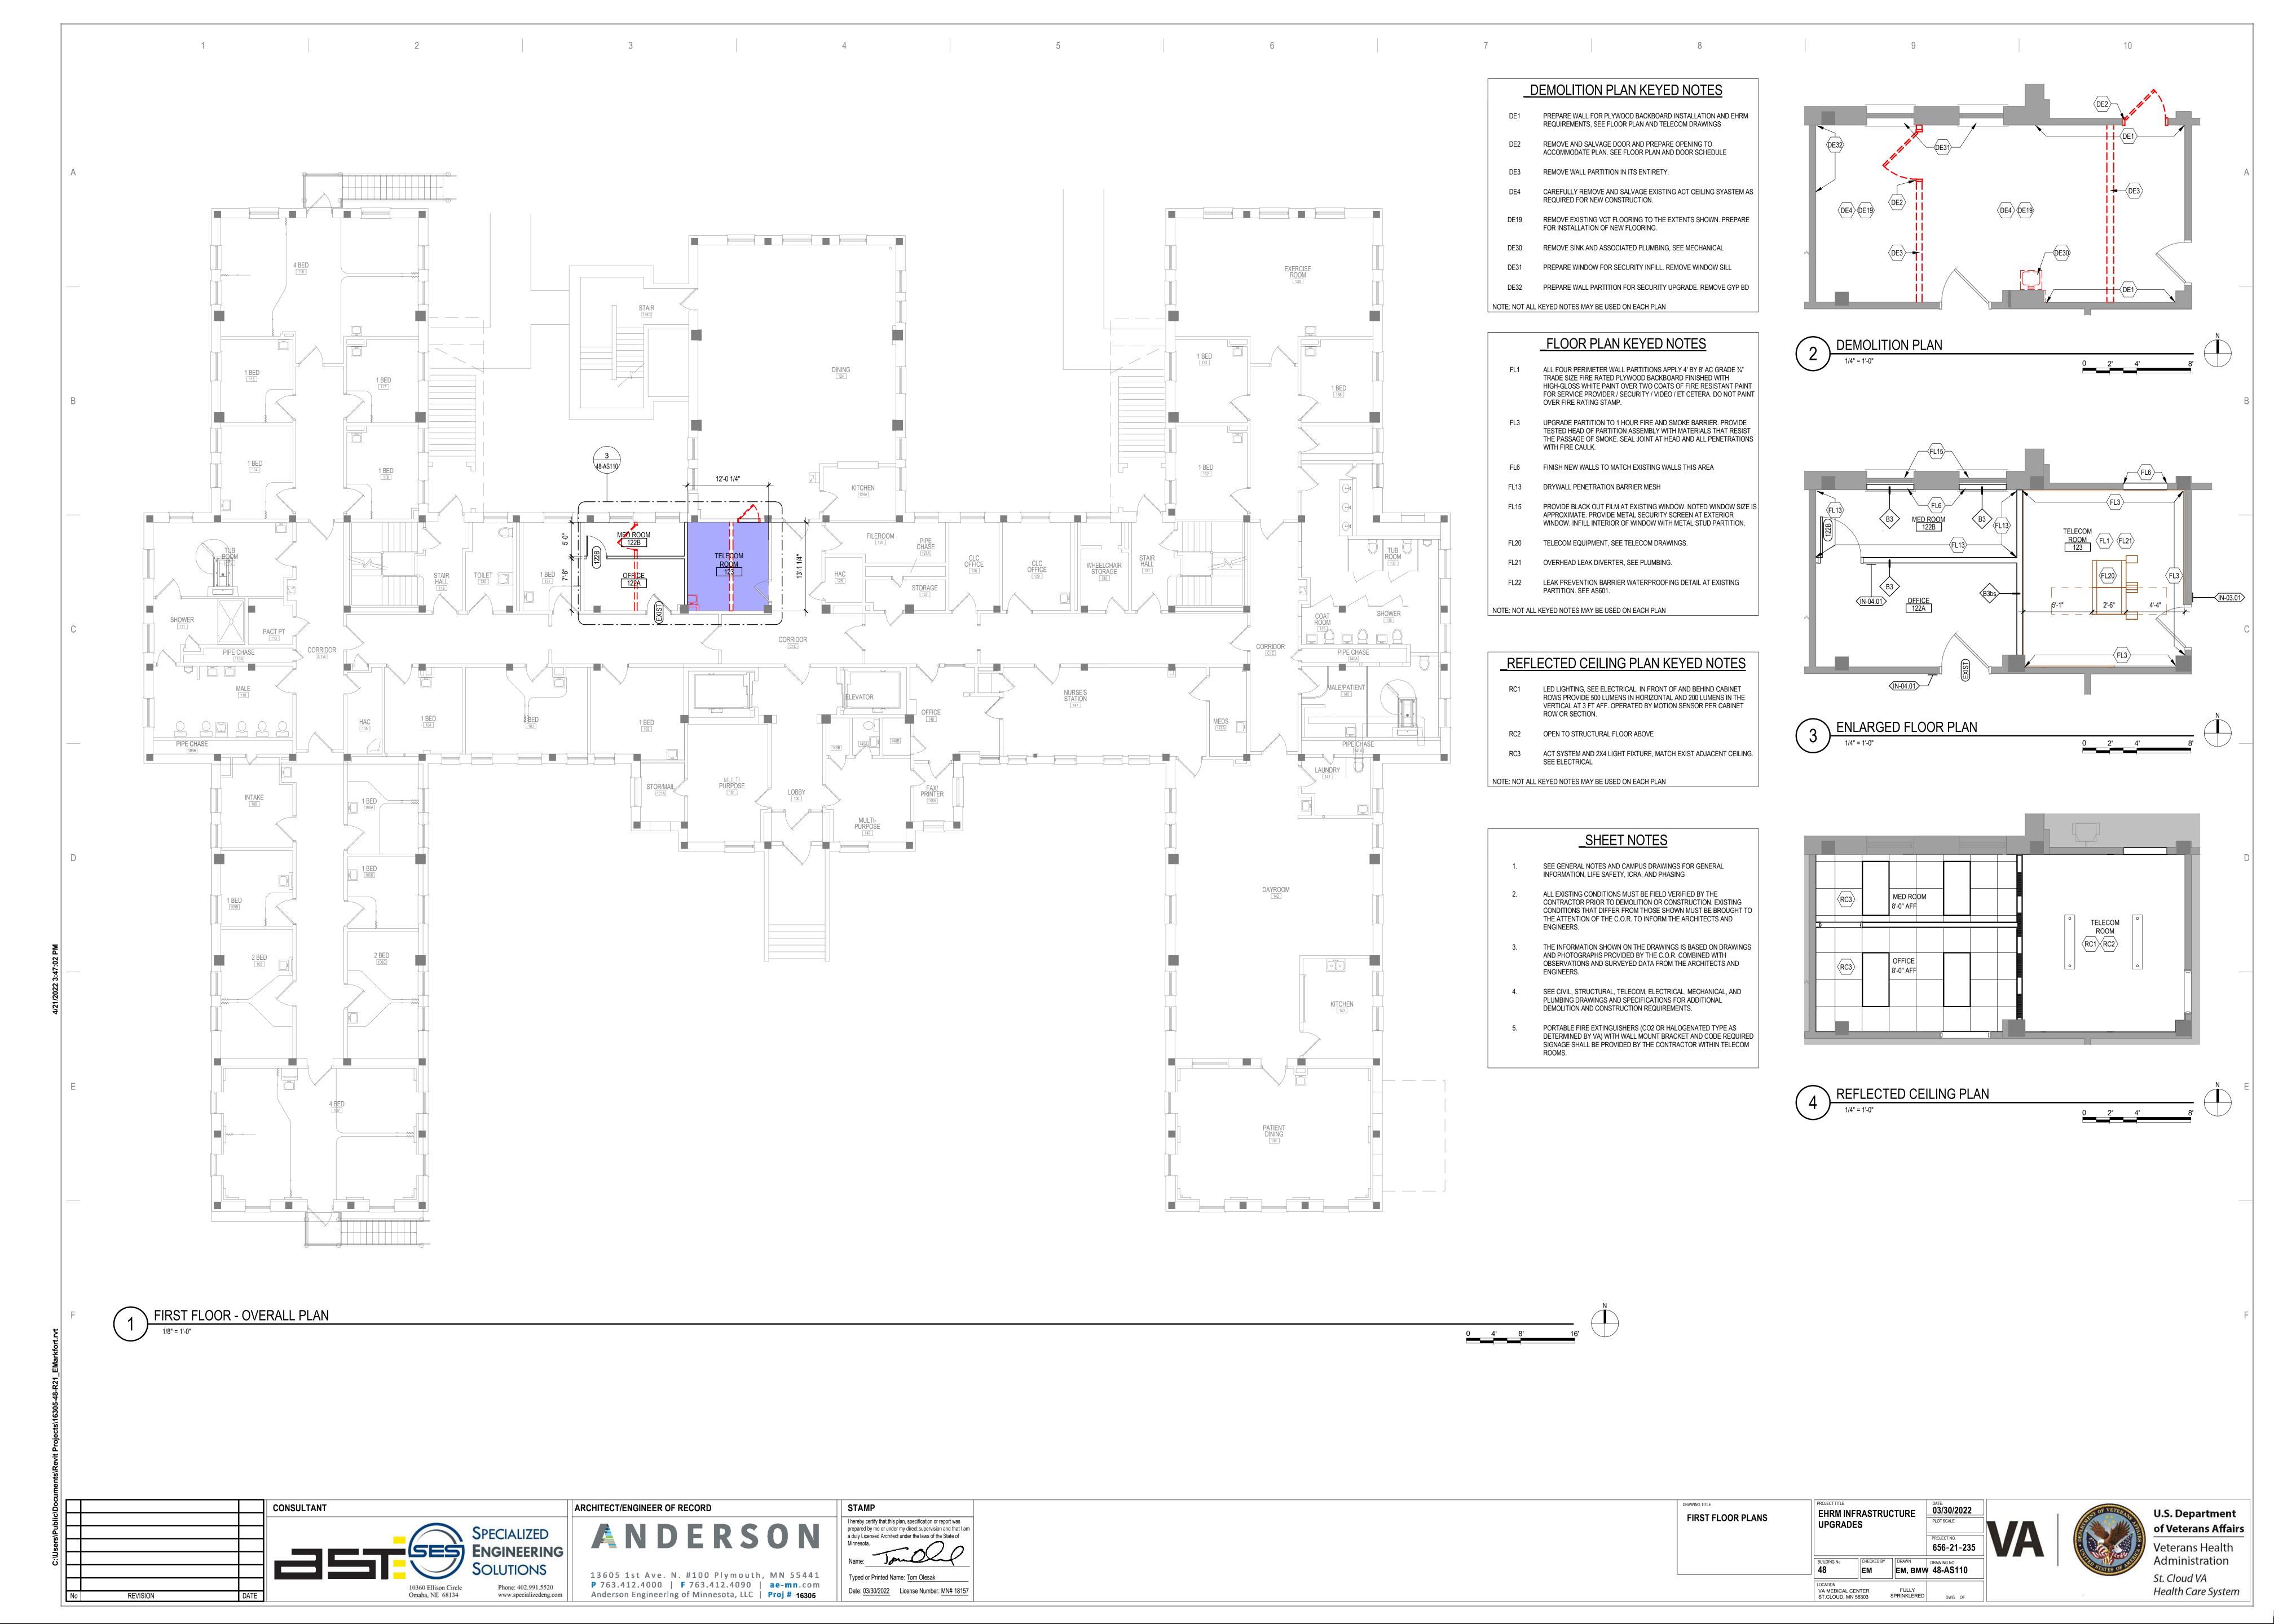

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TELECOM $\langle RC1 \rangle \langle RC2 \rangle$

EHRM INFRASTRUCTURE SECOND FLOOR PLANS

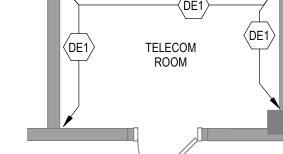VA MEDICAL CENTER ST.CLOUD, MN 56303
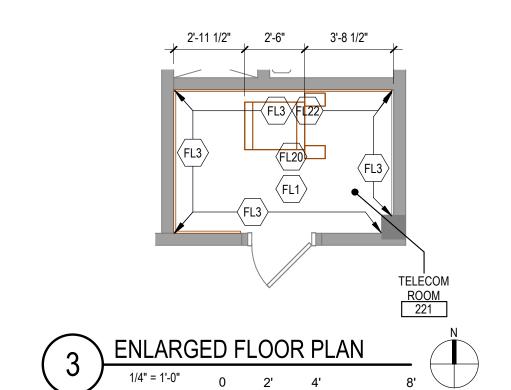
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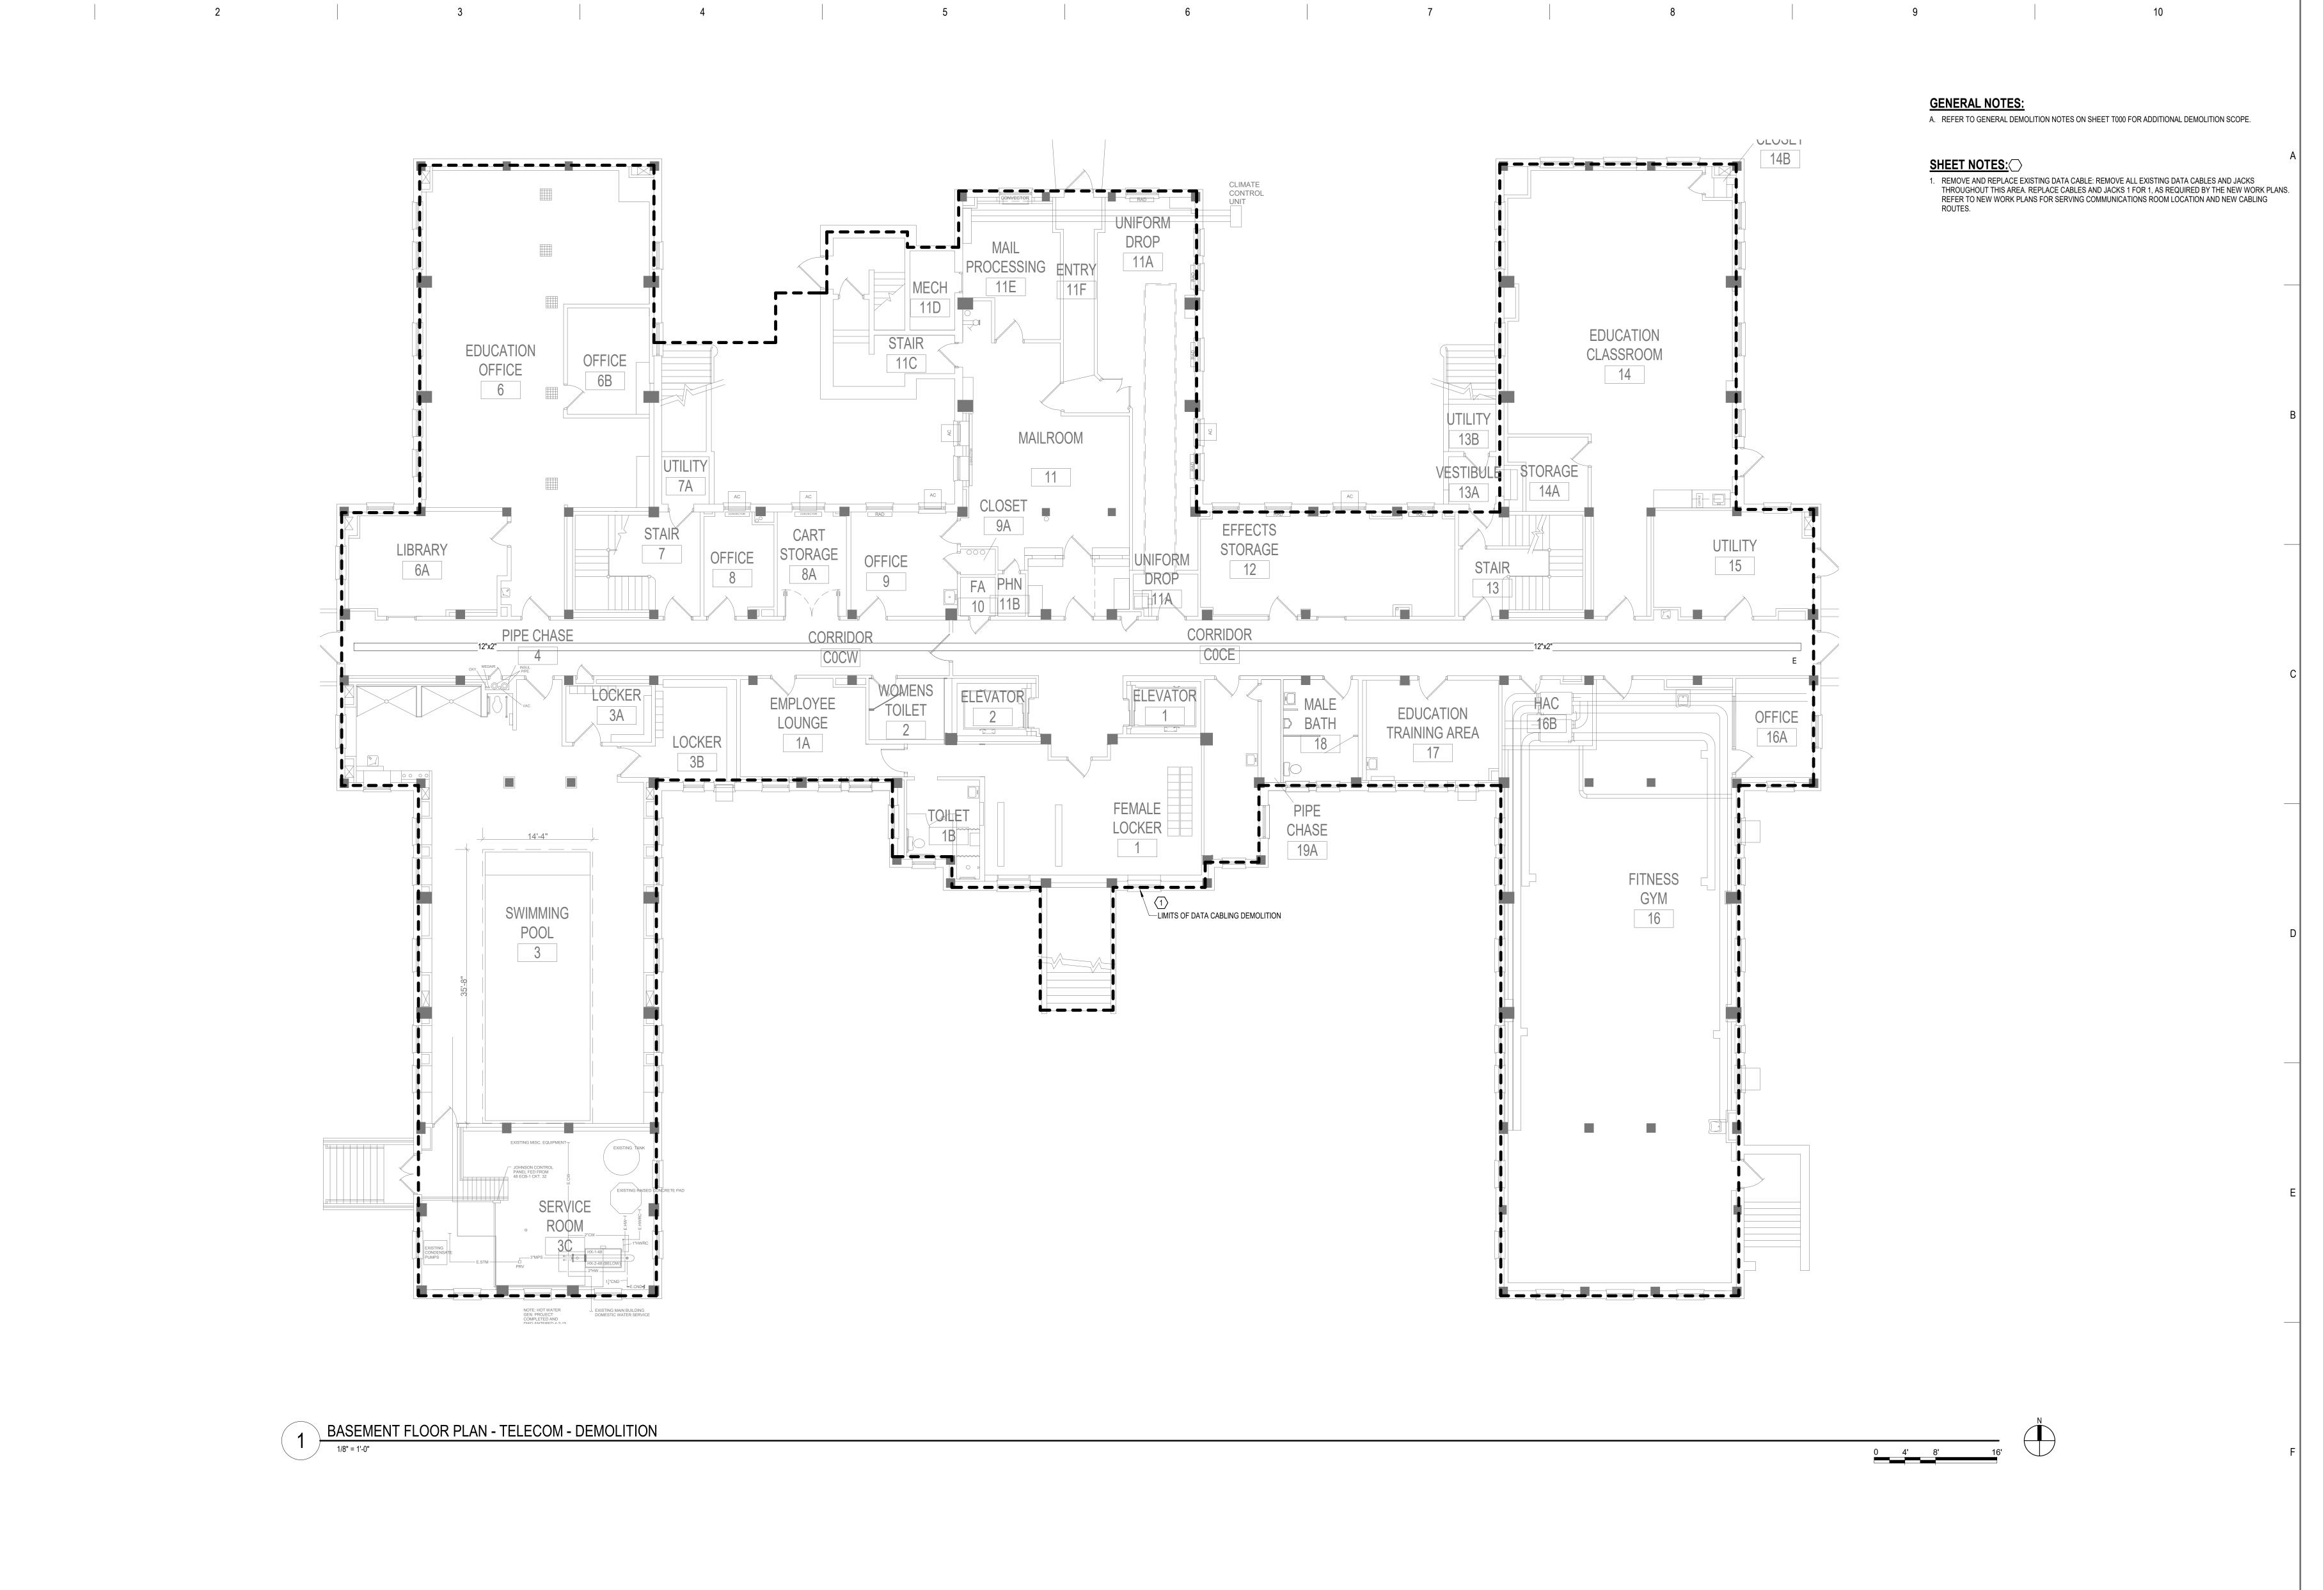
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DATE

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BASEMENT FLOOR PLAN -TELECOM - DEMOLITION


EHRM INFRASTRUCTURE

VA MEDICAL CENTER ST.CLOUD, MN 56303

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03/30/2022 KSB SSK 48-TD100



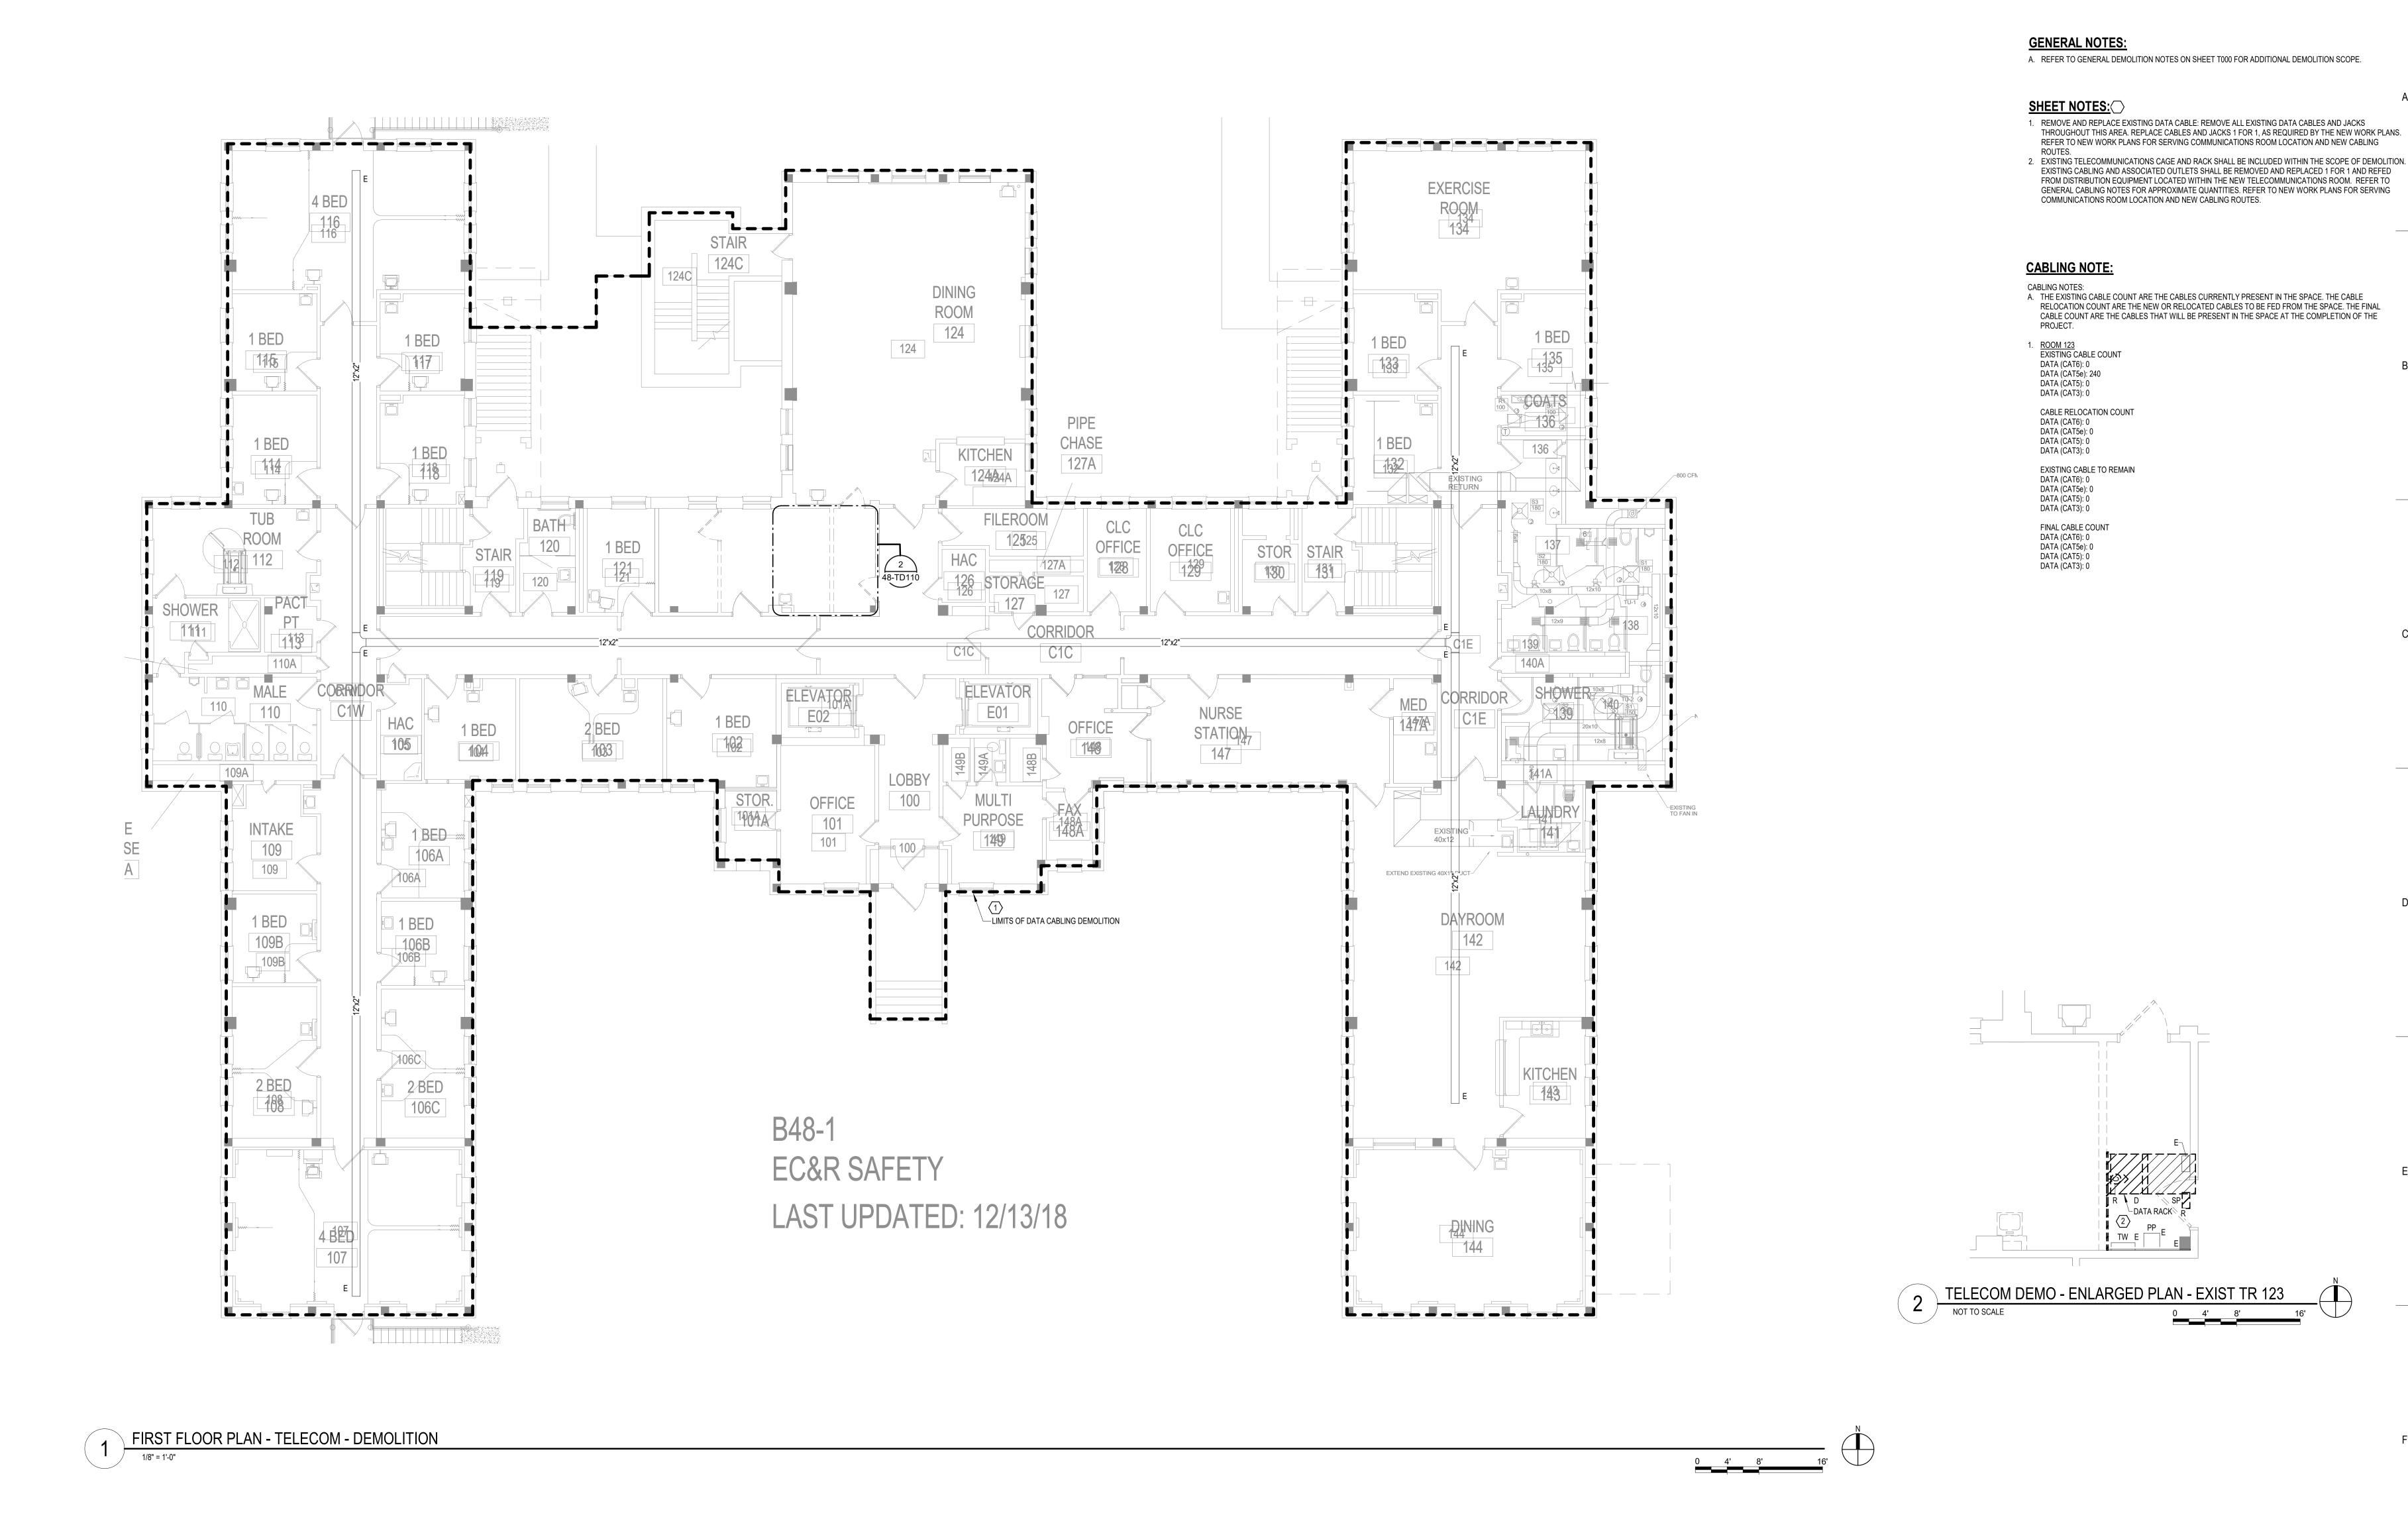

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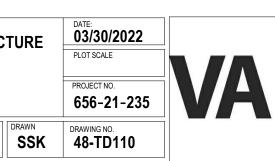





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GENERAL NOTES:

A. REFER TO GENERAL DEMOLITION NOTES ON SHEET T000 FOR ADDITIONAL DEMOLITION SCOPE.

SHEET NOTES:

1. REMOVE AND REPLACE EXISTING DATA CABLE: REMOVE ALL EXISTING DATA CABLES AND JACKS THROUGHOUT THIS AREA. REPLACE CABLES AND JACKS 1 FOR 1, AS REQUIRED BY THE NEW WORK PLANS.

REFER TO NEW WORK PLANS FOR SERVING COMMUNICATIONS ROOM LOCATION AND NEW CABLING

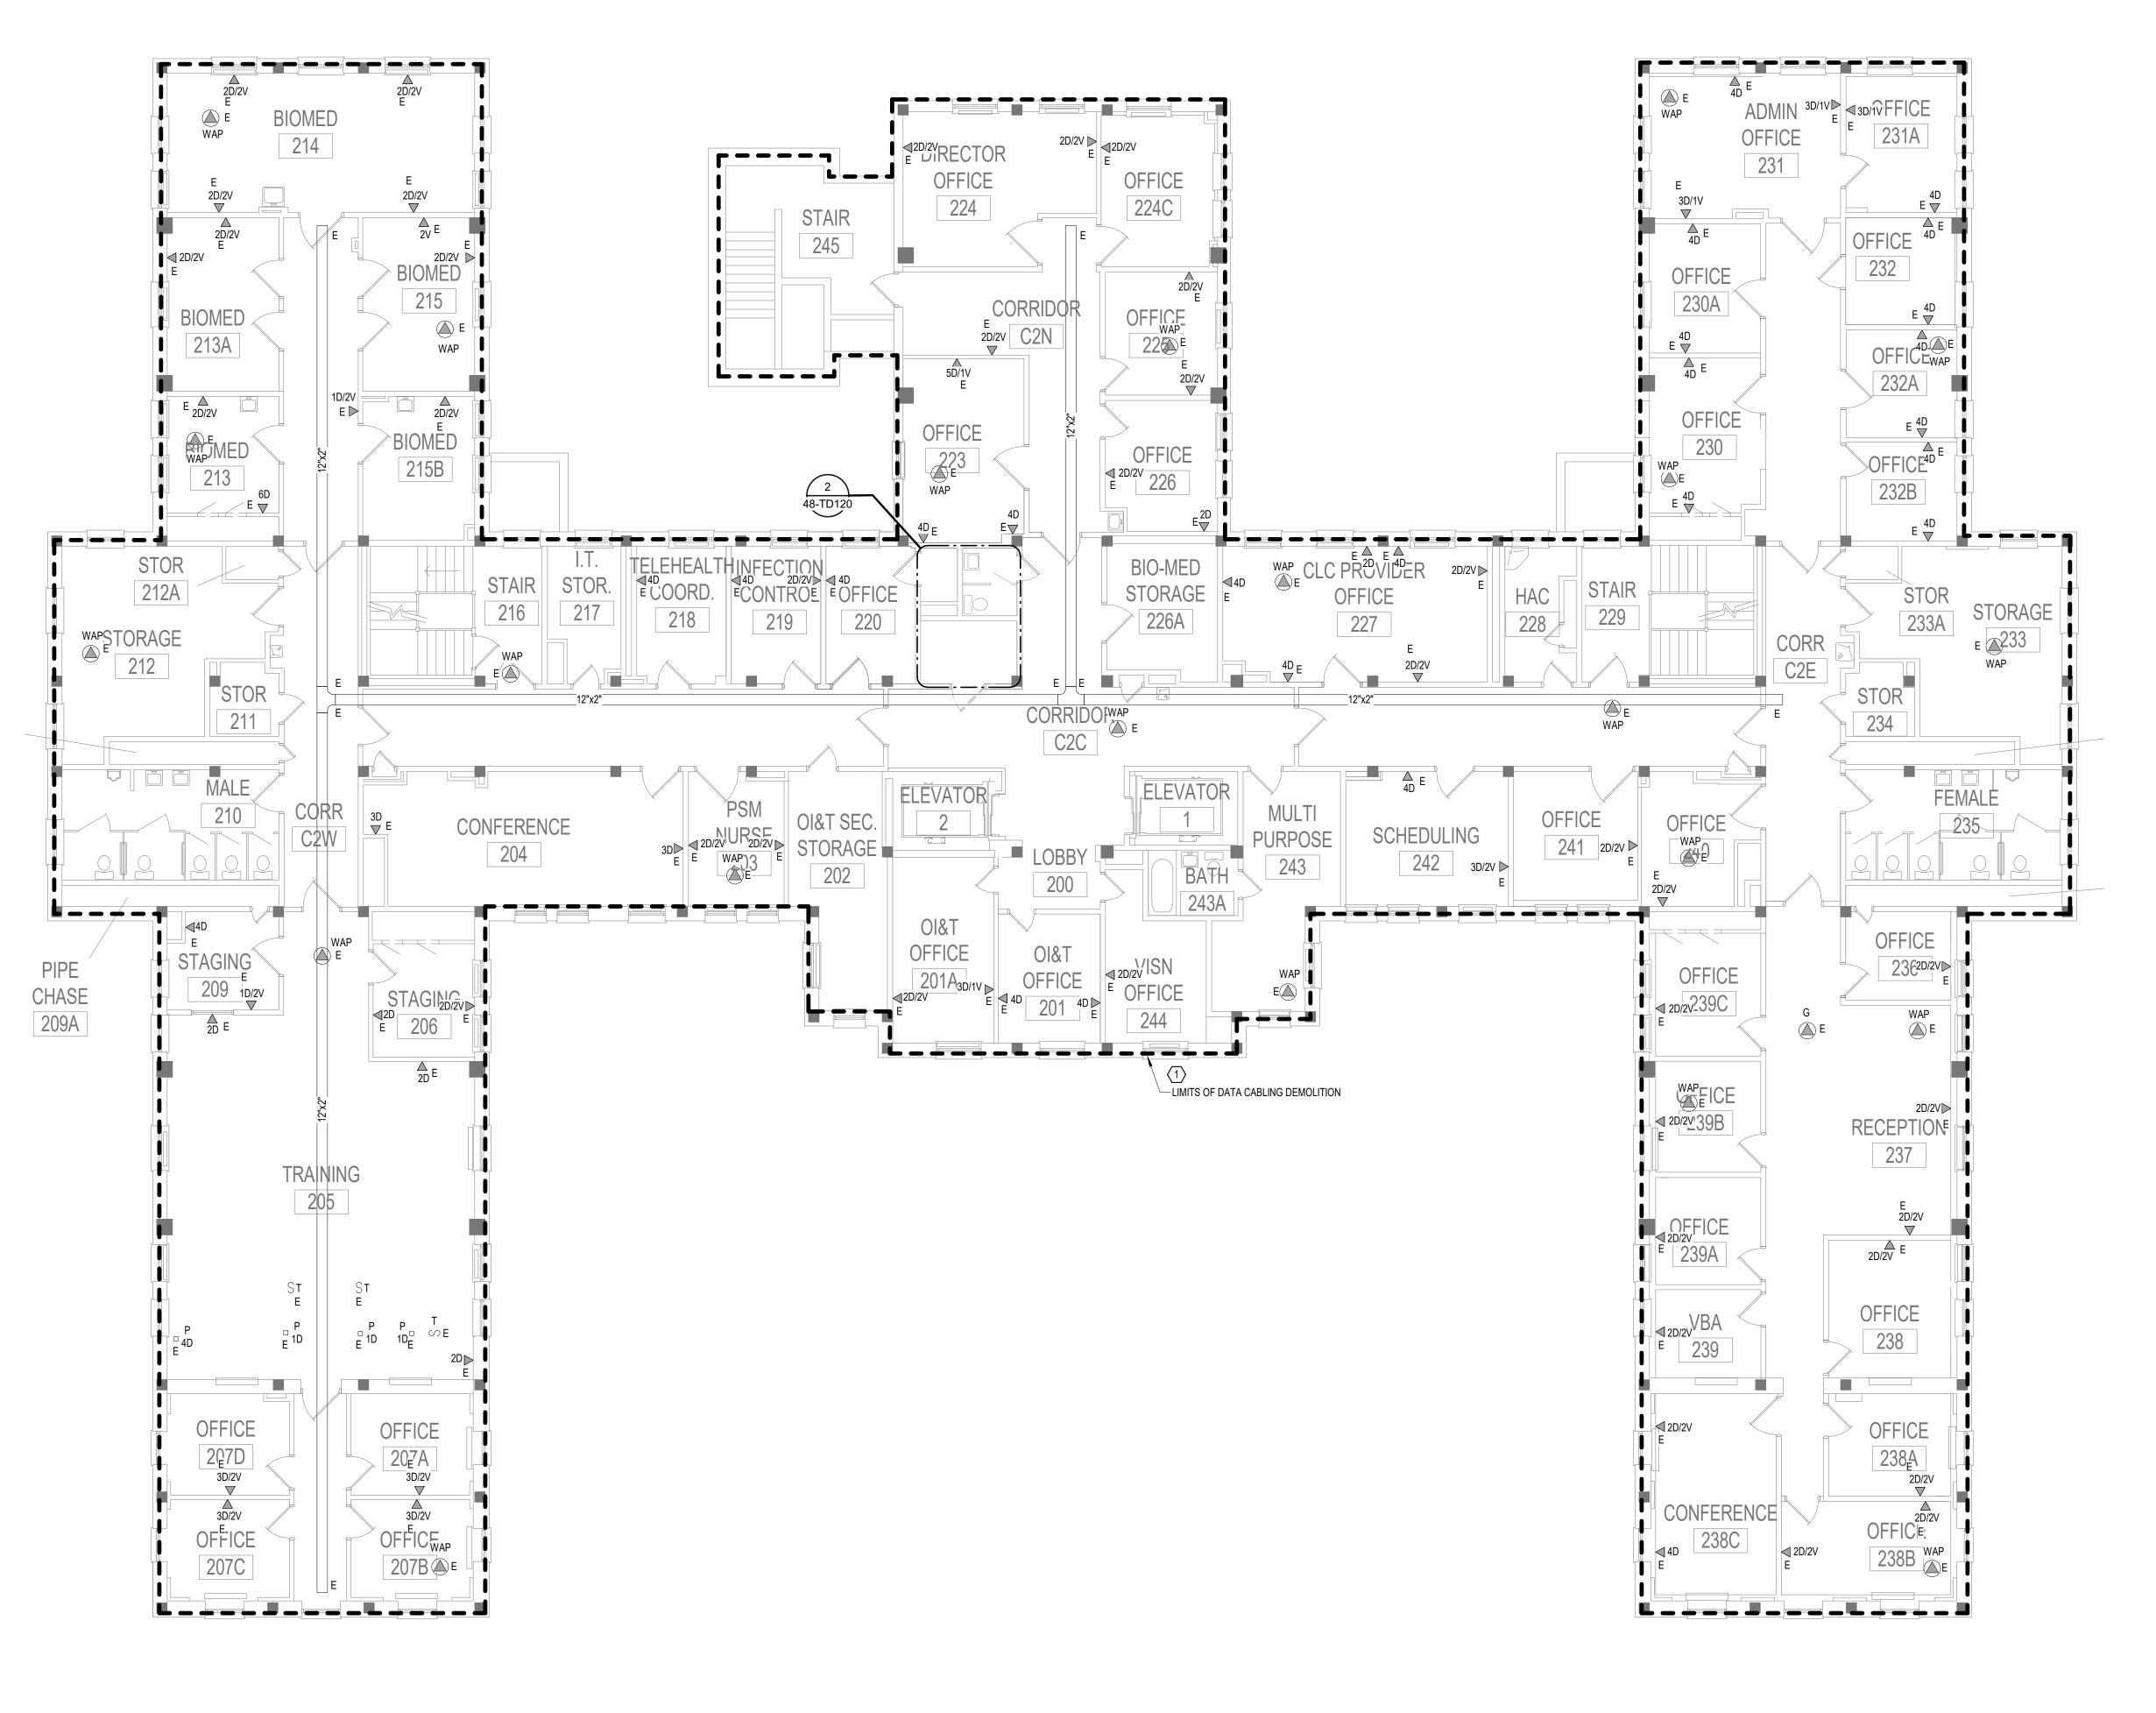2. EXISTING TELECOMMUNICATIONS CAGE AND RACK SHALL BE INCLUDED WITHIN THE SCOPE OF DEMOLITION. EXISTING CABLING AND ASSOCIATED OUTLETS SHALL BE REMOVED AND REPLACED 1 FOR 1 AND REFED FROM DISTRIBUTION EQUIPMENT LOCATED WITHIN THE NEW TELECOMMUNICATIONS ROOM. REFER TO GENERAL CABLING NOTES FOR APPROXIMATE QUANTITIES. REFER TO NEW WORK PLANS FOR SERVING

COMMUNICATIONS ROOM LOCATION AND NEW CABLING ROUTES.

CABLING NOTE:

CABLING NOTES: A. THE EXISTING CABLE COUNT ARE THE CABLES CURRENTLY PRESENT IN THE SPACE. THE CABLE RELOCATION COUNT ARE THE NEW OR RELOCATED CABLES TO BE FED FROM THE SPACE. THE FINAL CABLE COUNT ARE THE CABLES THAT WILL BE PRESENT IN THE SPACE AT THE COMPLETION OF THE

ROOM 221 EXISTING CABLE COUNT

DATA (CAT6): 0 DATA (CAT5e): 295

DATA (CAT5): 0 DATA (CAT3): 0

CABLE RELOCATION COUNT DATA (CAT6): 0 DATA (CAT5e): 0


DATA (CAT5): 0 DATA (CAT3): 0 EXISTING CABLE TO REMAIN

DATA (CAT6): 0 DATA (CAT5e): 0 DATA (CAT5): 0

DATA (CAT3): 0 FINAL CABLE COUNT

DATA (CAT6): 0 DATA (CAT5e): 0

DATA (CAT5): 0 DATA (CAT3): 0

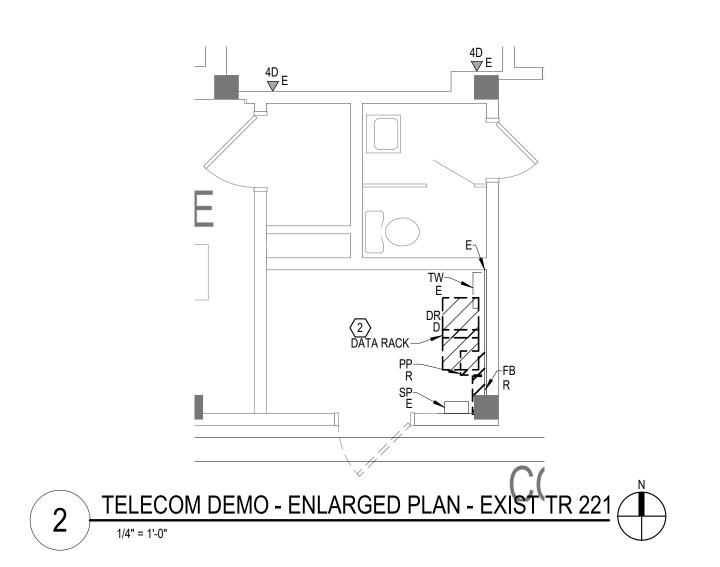

SECOND FLOOR PLAN - TELECOM - DEMOLITION

1/8" = 1'-0"





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EHRM INFRASTRUCTURE

KSB

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VA MEDICAL CENTER ST.CLOUD, MN 56303

03/30/2022 SSK 48-TD120



1 2 9 10 **GENERAL NOTES:** A. REFER TO GENERAL DEMOLITION NOTES ON SHEET T000 FOR ADDITIONAL DEMOLITION SCOPE. SHEET NOTES: 1. REMOVE AND REPLACE EXISTING DATA CABLE: REMOVE ALL EXISTING DATA CABLES AND JACKS THROUGHOUT THIS AREA. REPLACE CABLES AND JACKS 1 FOR 1, AS REQUIRED BY THE NEW WORK PLANS. REFER TO NEW WORK PLANS FOR SERVING COMMUNICATIONS ROOM LOCATION AND NEW CABLING LIMITS OF DATA CABLING DEMOLITION **BUILDING 48 - ATTIC** ATTIC FLOOR PLAN - ELECTRICAL - DEMOLITION CONSULTANT ARCHITECT/ENGINEER OF RECORD 03/30/2022 EHRM INFRASTRUCTURE U.S. Department ATTIC FLOOR PLAN -TELECOM - DEMOLITION ANDERSON of Veterans Affairs Veterans Health Administration 5 BICSI ID # 346555 KSB SSK 48-TD130

St. Cloud VA

Health Care System

LOCATION

VA MEDICAL CENTER

ST.CLOUD, MN 56303

FULLY SPRINKLERED

EXPIRES 12-31-23

Mathan M. Timm

13605 1st Ave. N. #100 Plymouth, MN 55441

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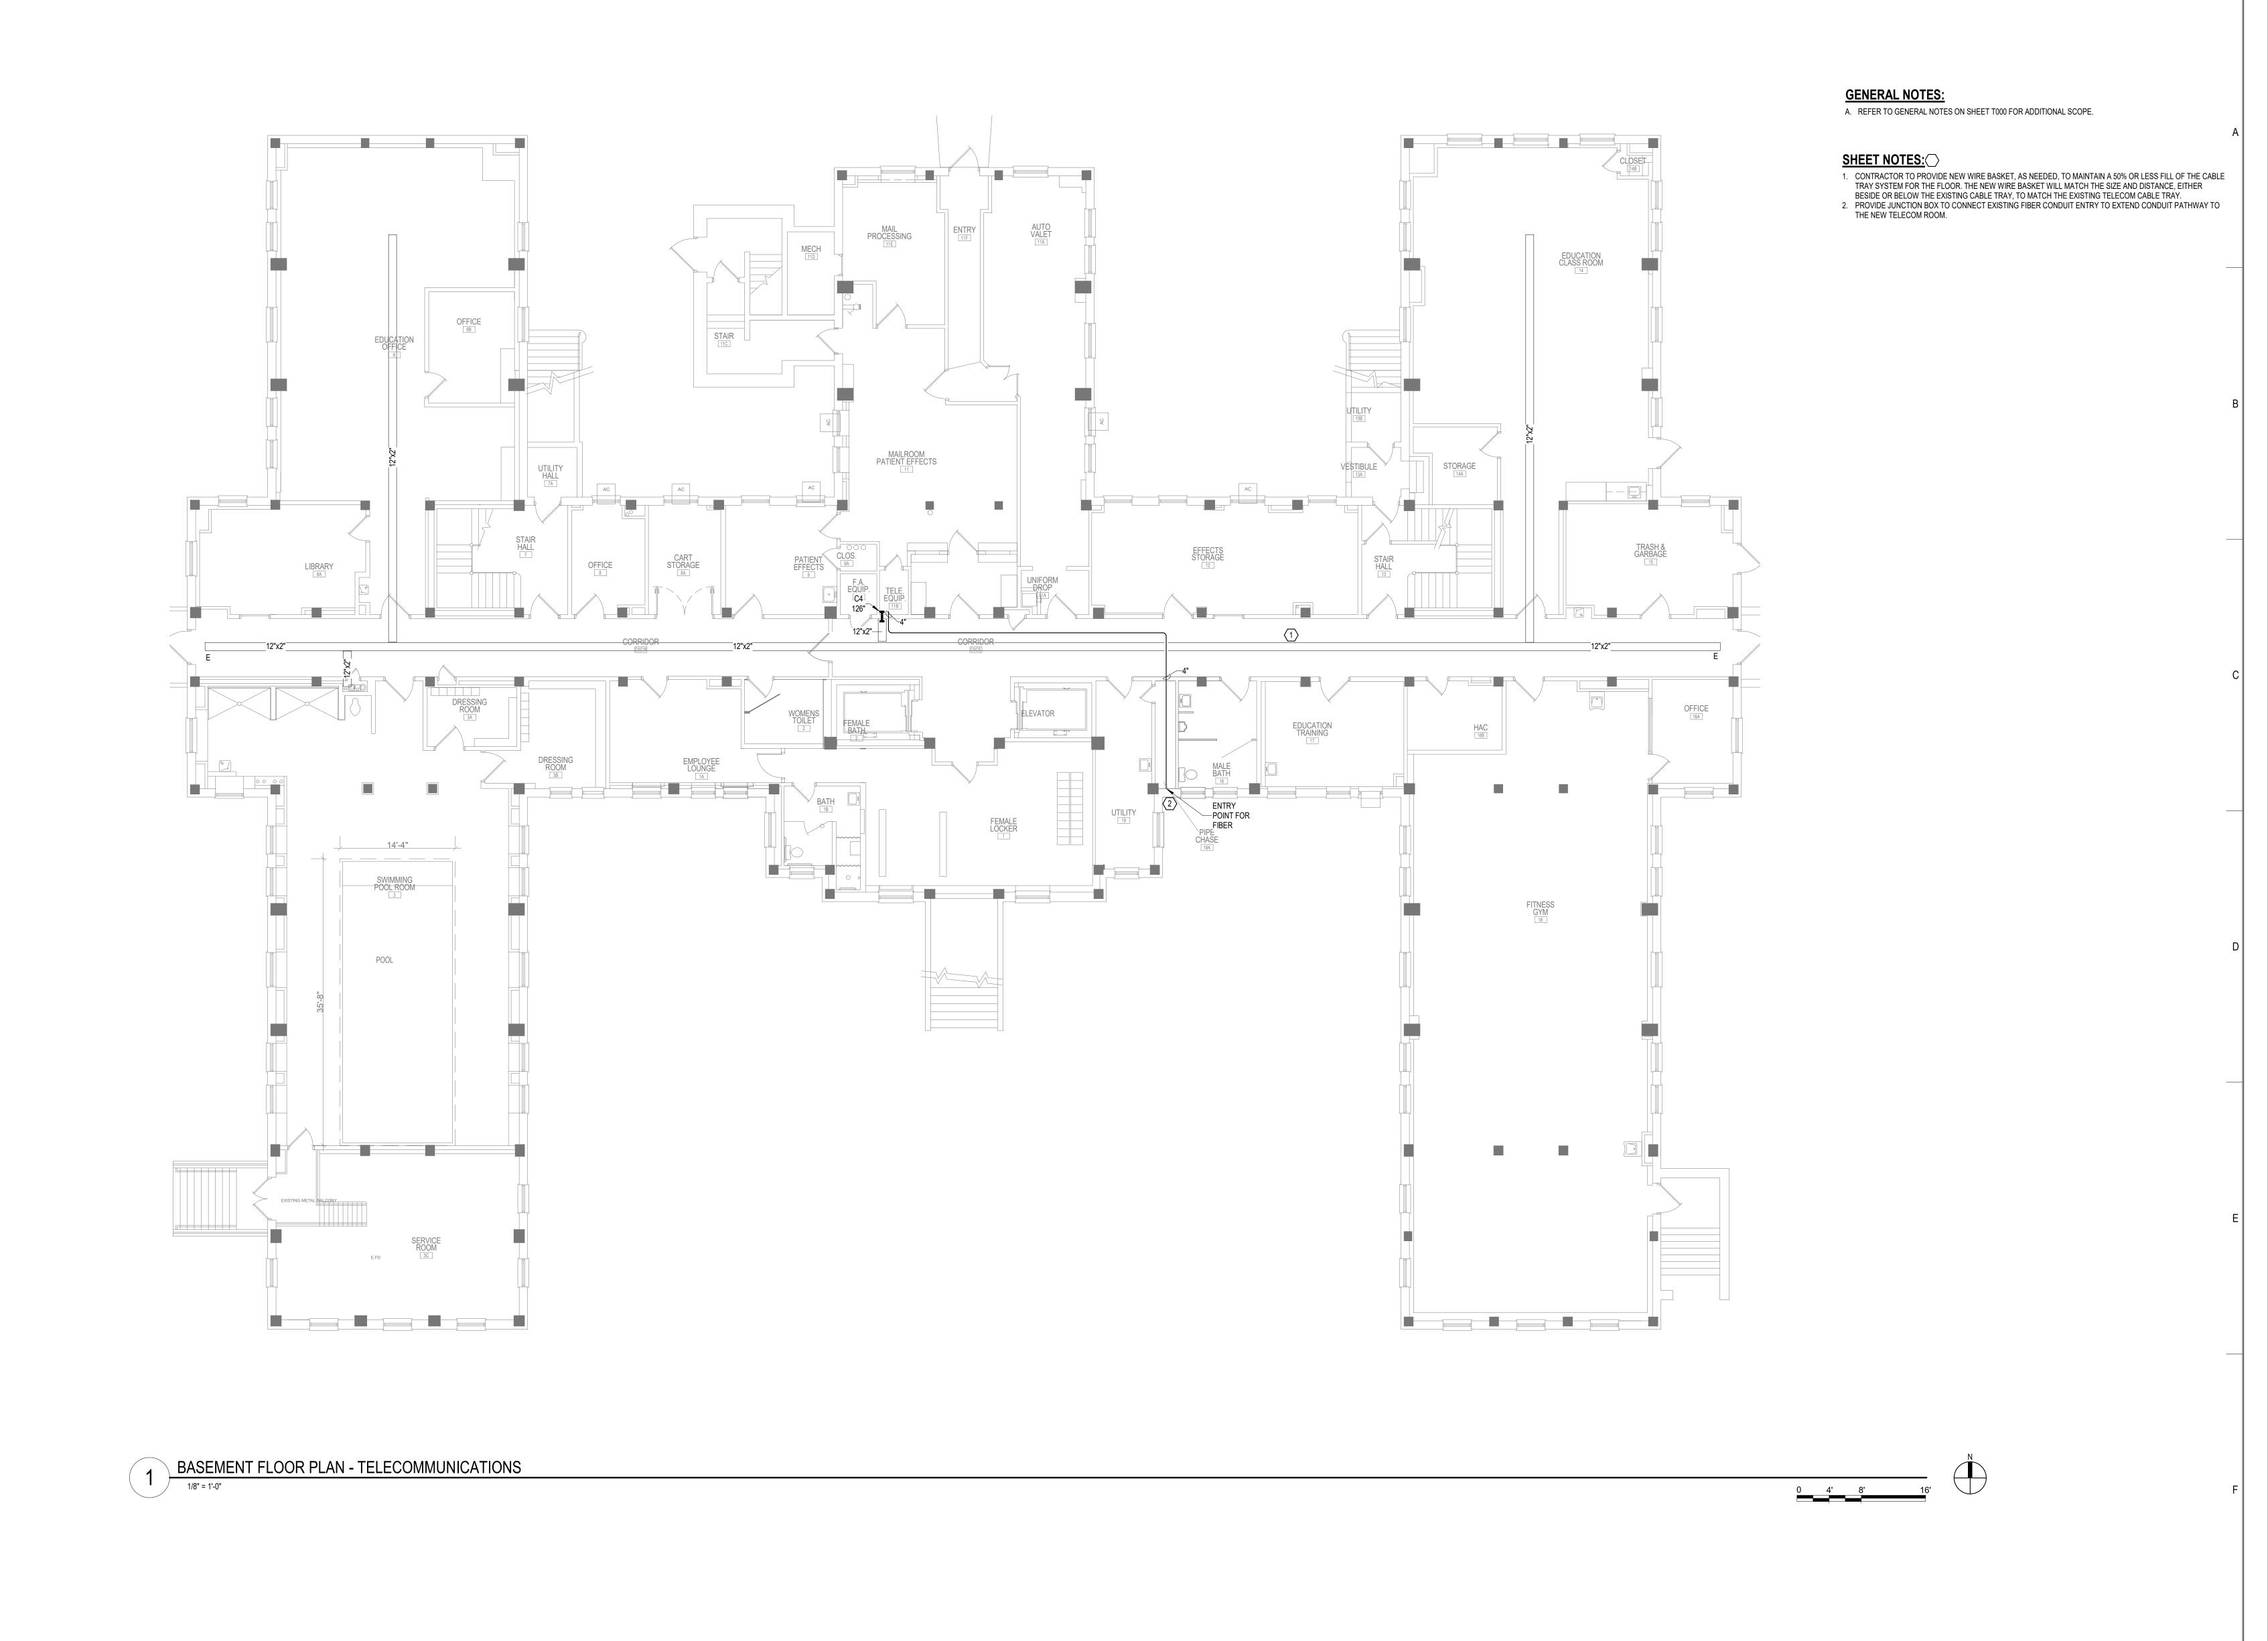
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BASEMENT FLOOR PLAN -TELECOMMUNICATIONS

EHRM INFRASTRUCTURE

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KSB SSK 48-TN100



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PROJECT TITLE

EHRM INFRASTRUCTURE

UPGRADES

PRO

ENUMBRIAN INFRASTRUCTURE

PRO

65

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KSB

VA MEDICAL CENTER ST.CLOUD, MN 56303





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GENERAL NOTES:

A. REFER TO GENERAL NOTES ON SHEET T000 FOR ADDITIONAL SCOPE.

SHEET NOTES:

1. CONTRACTOR TO PROVIDE NEW WIRE BASKET, AS NEEDED, TO MAINTAIN A 50% OR LESS FILL OF THE CABLE TRAY SYSTEM FOR THE FLOOR. THE NEW WIRE BASKET WILL MATCH THE SIZE AND DISTANCE, EITHER BESIDE OR BELOW THE EXISTING CABLE TRAY, TO MATCH THE EXISTING TELECOM CABLE TRAY.



REVISION


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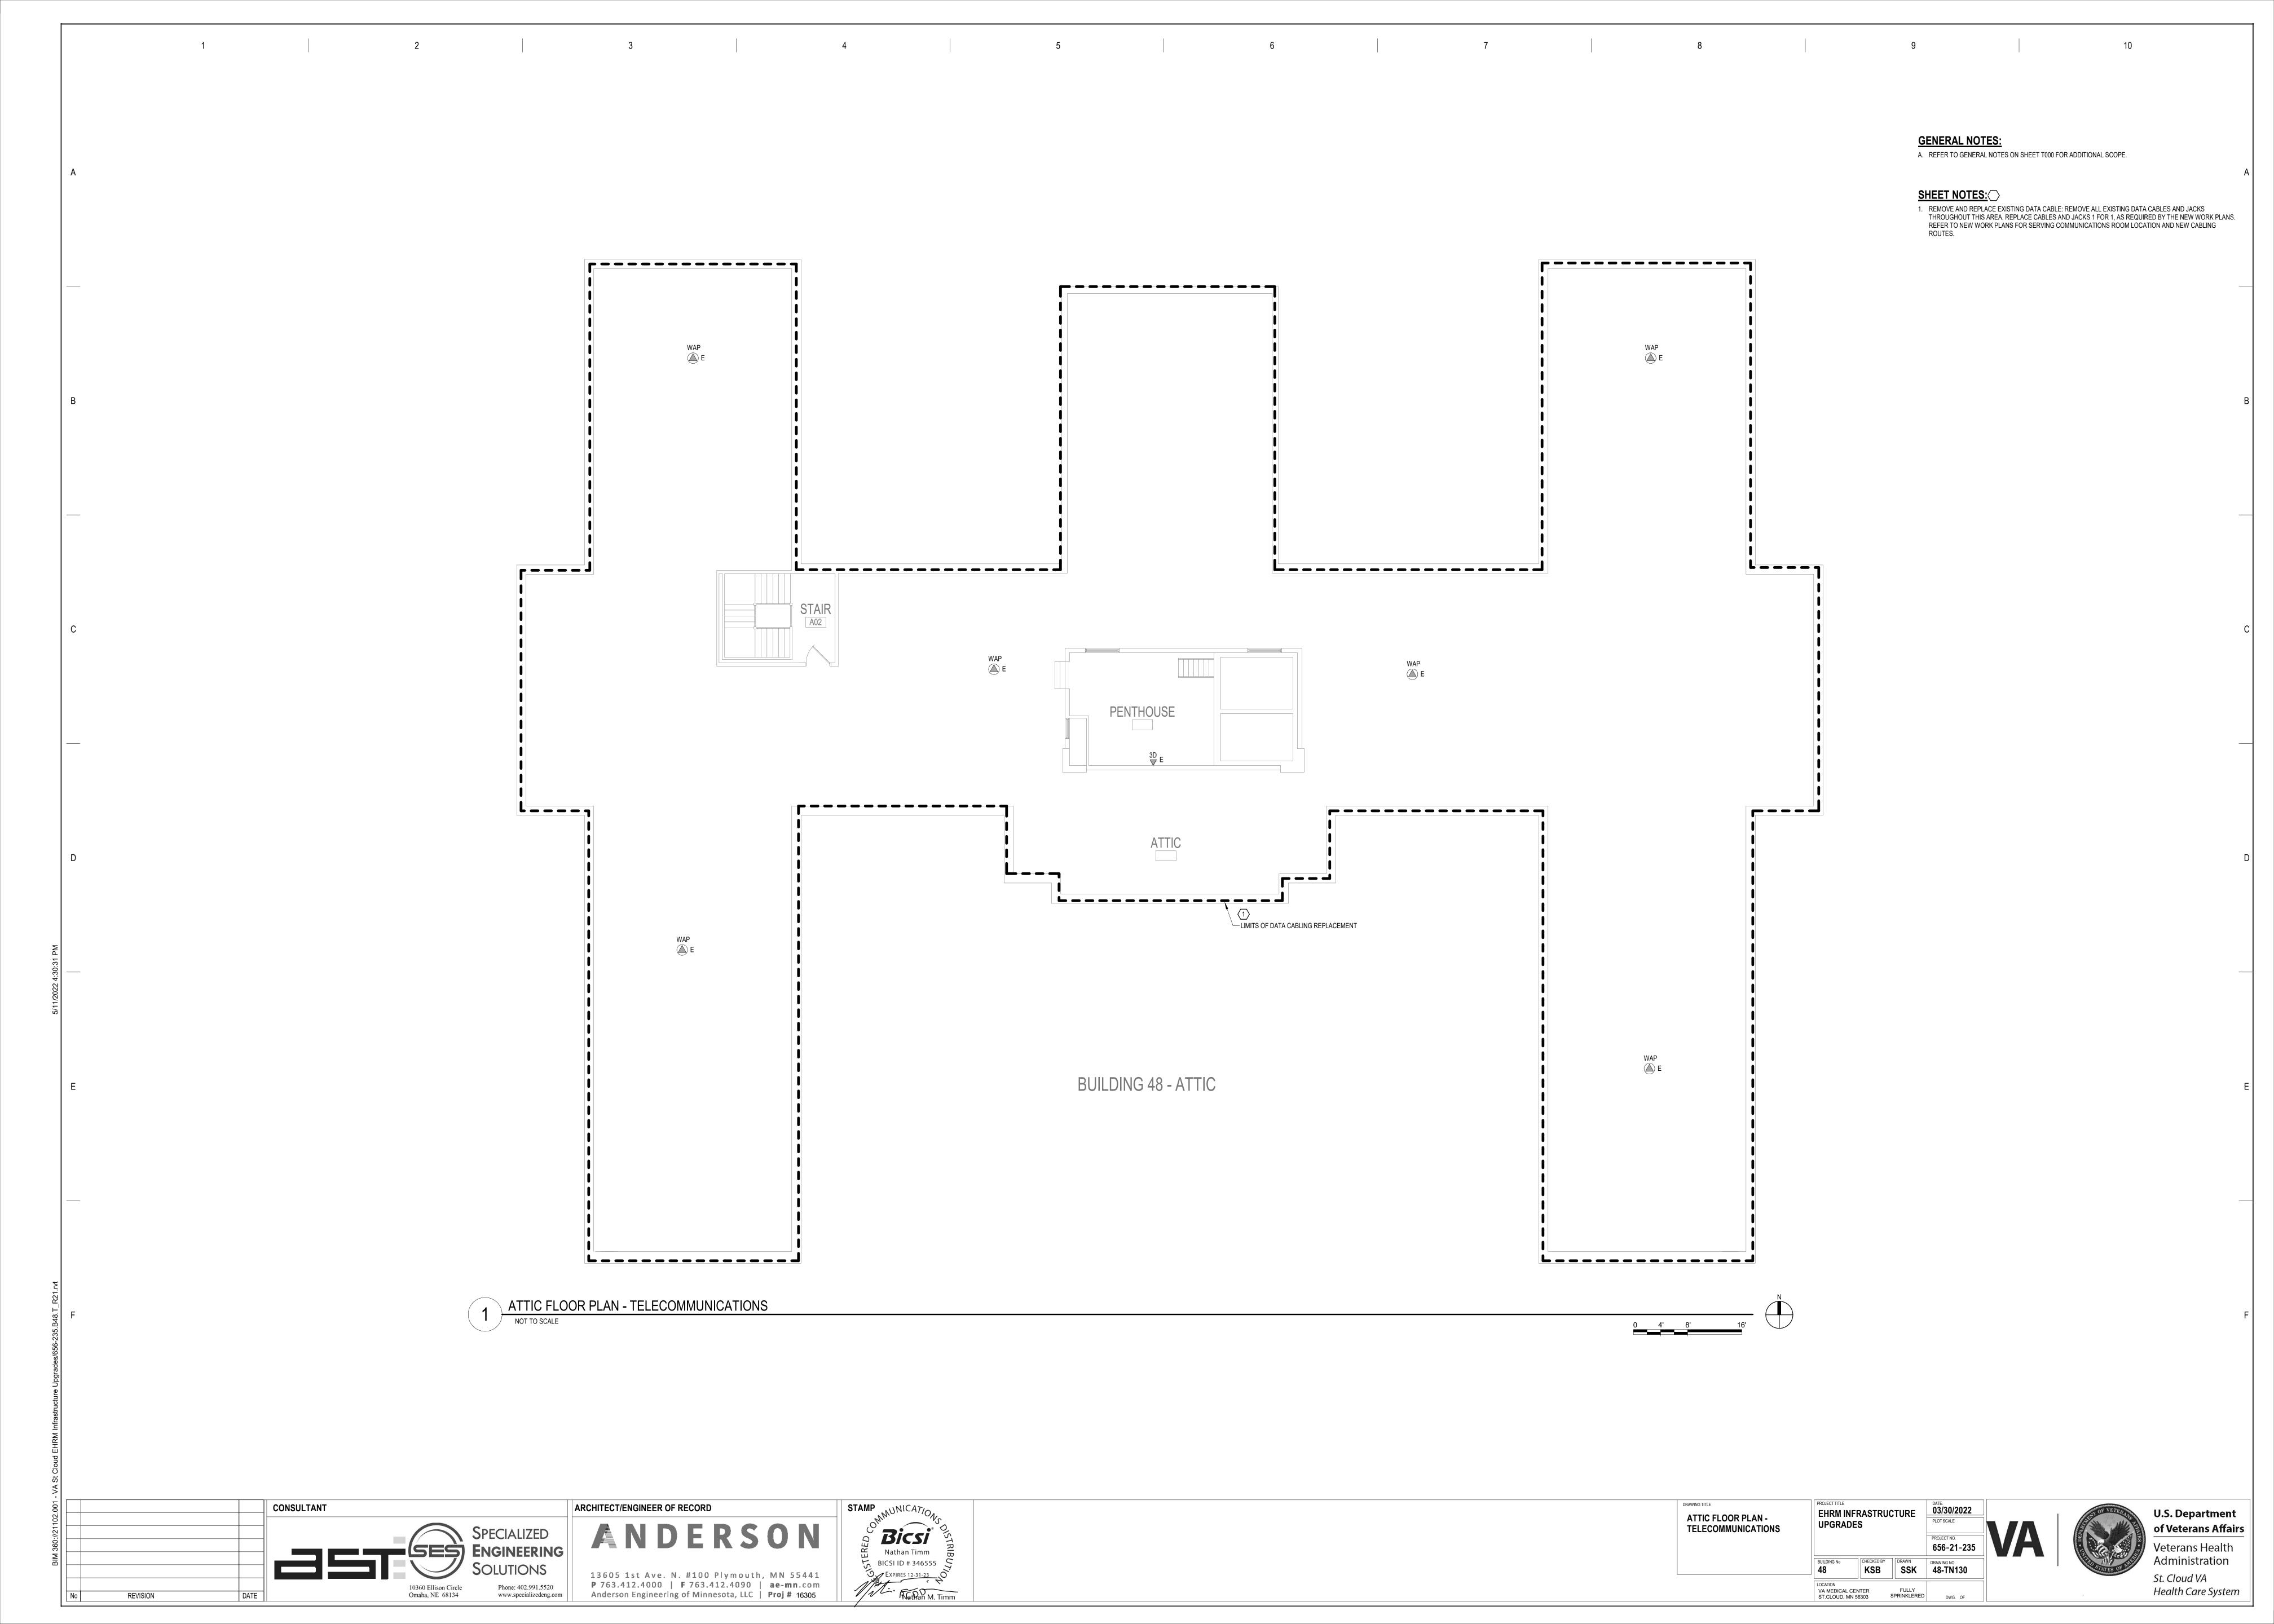





VA MEDICAL CENTER ST.CLOUD, MN 56303





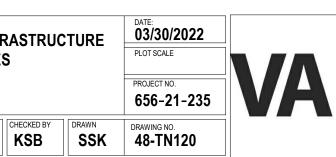

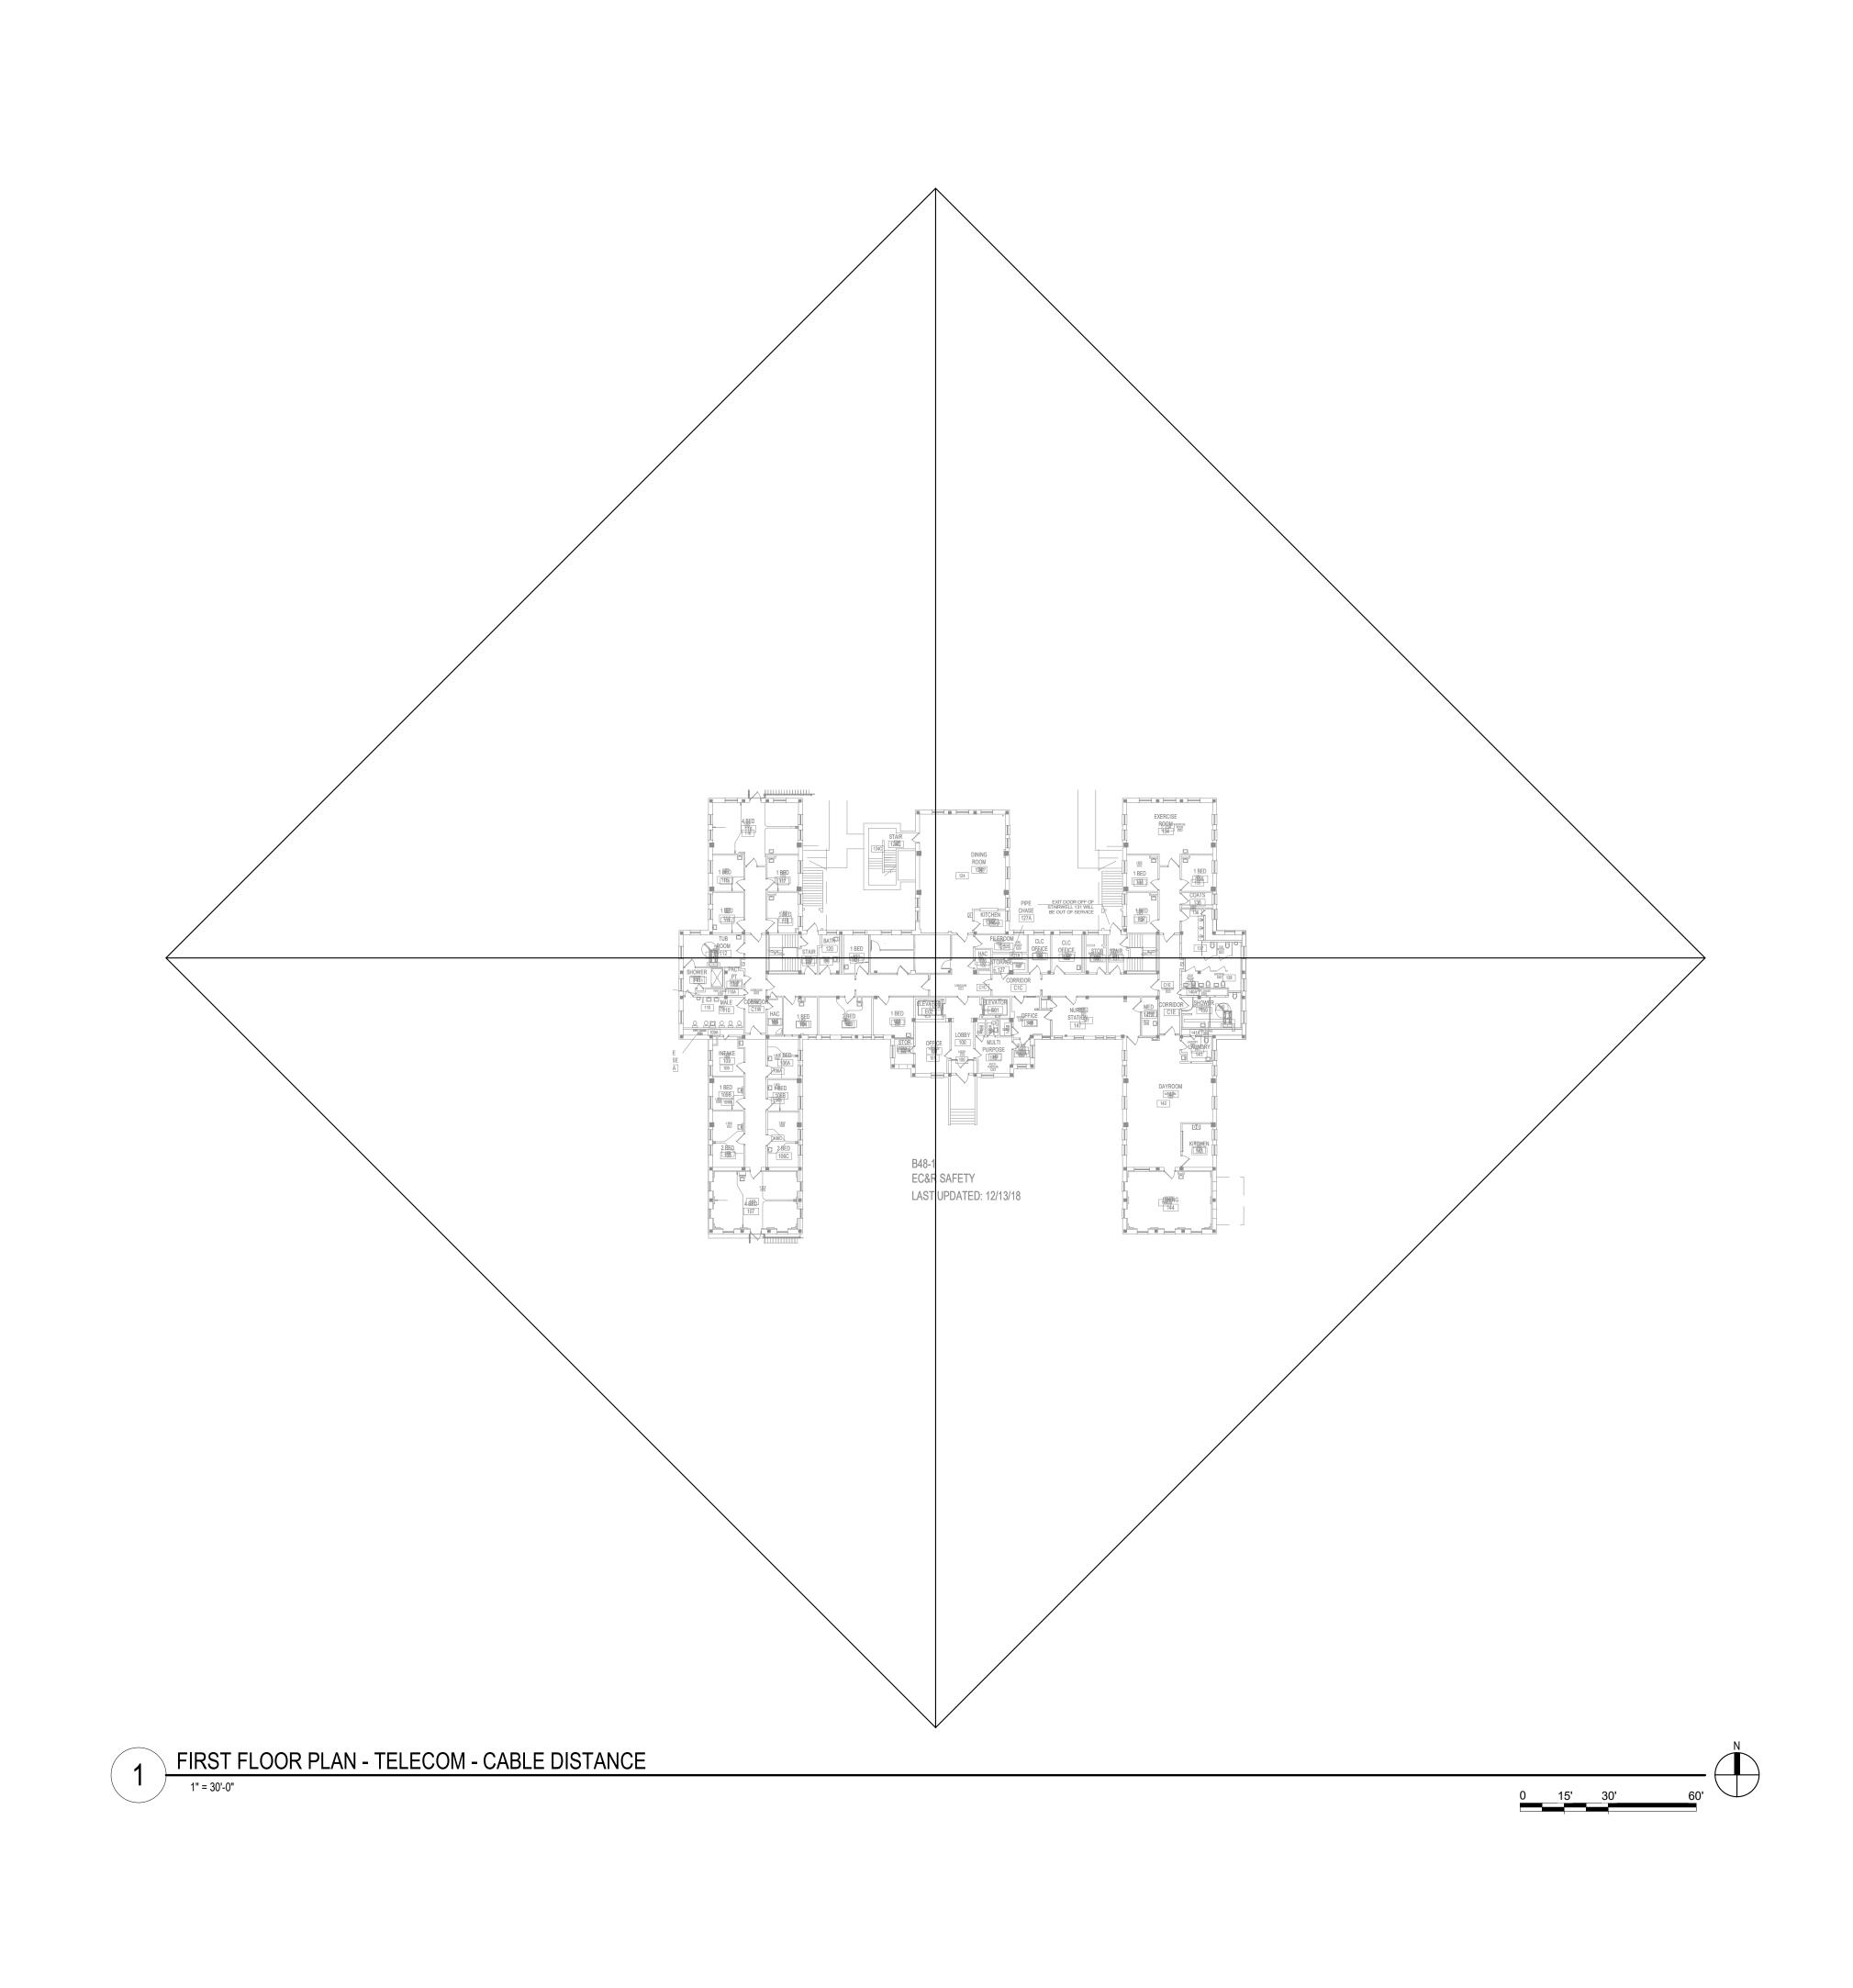

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FIRST FLOOR PLAN -TELECOM - CABLE DISTANCE

PROJECT TITLE


EHRM INFRASTRUCTURE

FULLY SPRINKLERED DWG. OF

LOCATION
VA MEDICAL CENTER
ST.CLOUD, MN 56303

CHECKED BY DRAWN DRAWING NO. 48-TN210



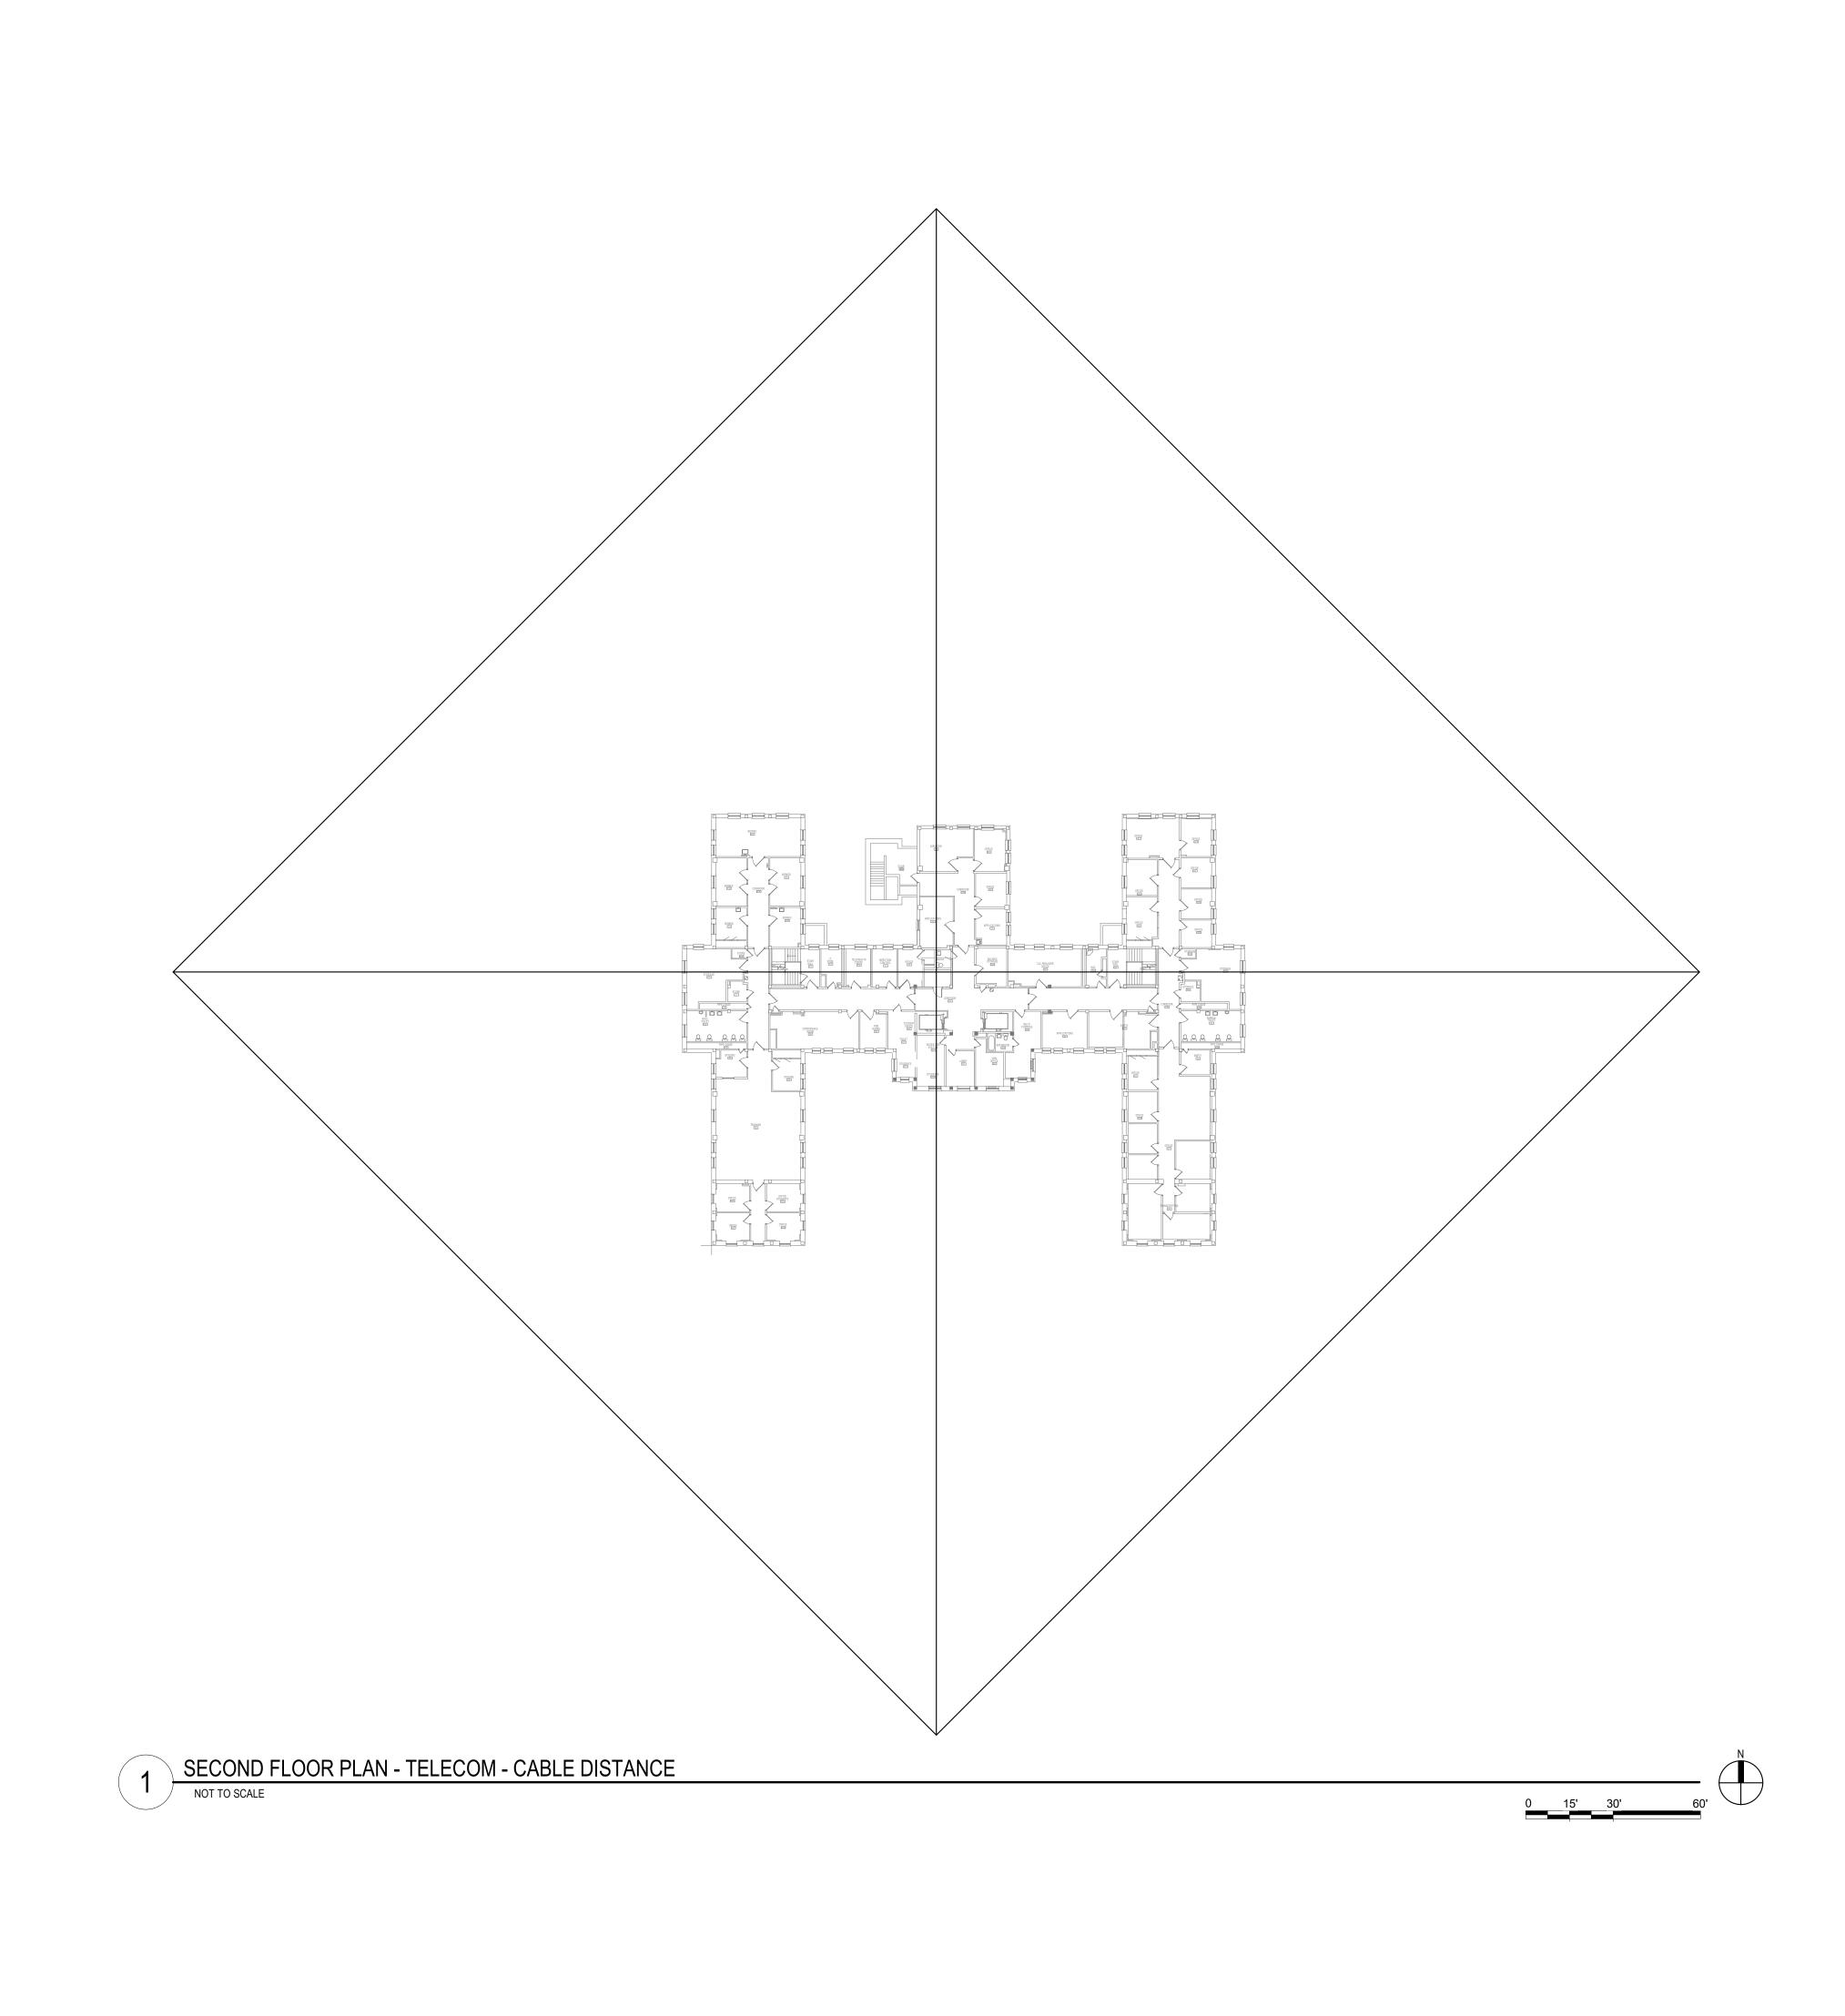

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SECOND FLOOR PLAN -TELECOM - CABLE DISTANCE

PROJECT TITLE


EHRM INFRASTRUCTURE


FULLY SPRINKLERED DWG. OF

LOCATION
VA MEDICAL CENTER
ST.CLOUD, MN 56303


CHECKED BY DRAWN DRAWING NO. 48-TN220



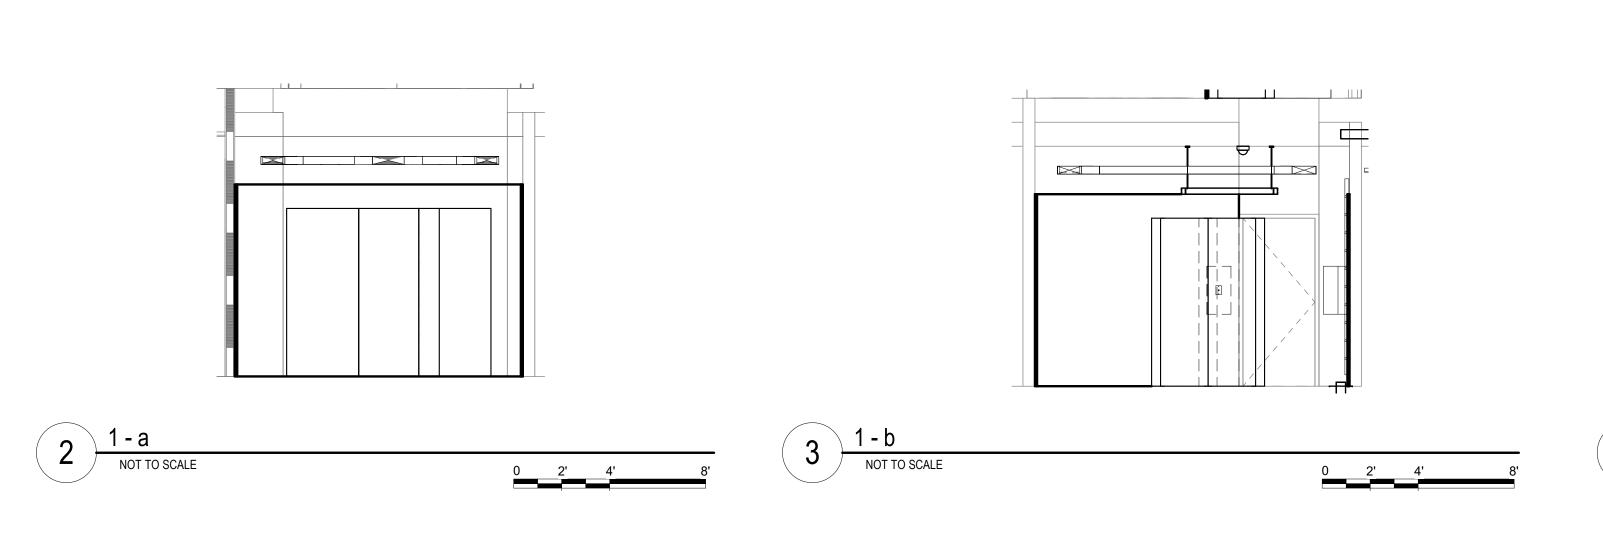

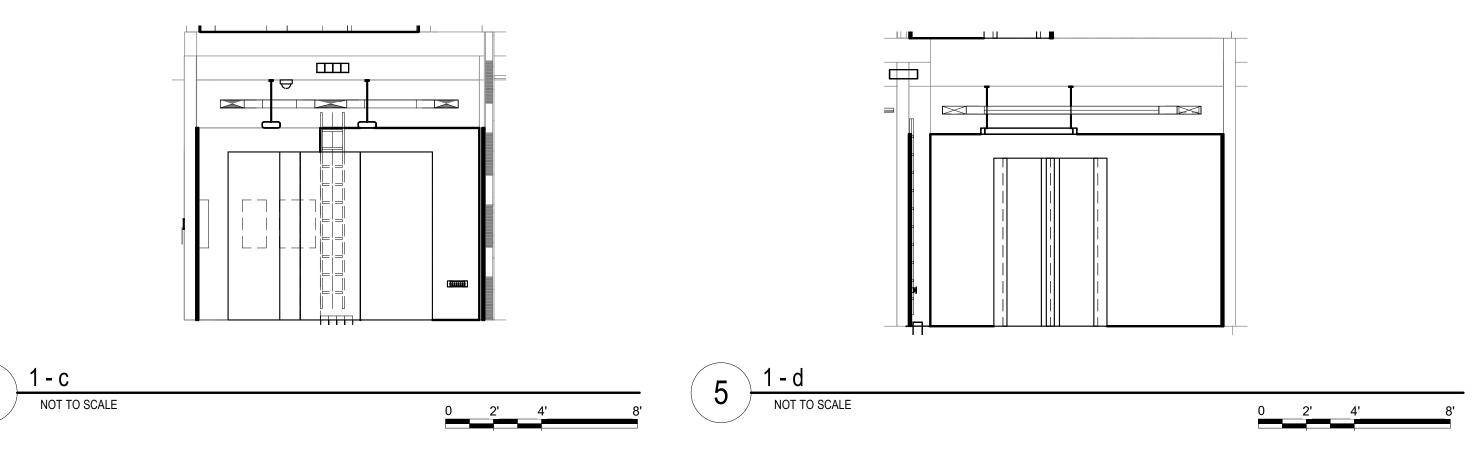

2 8 9

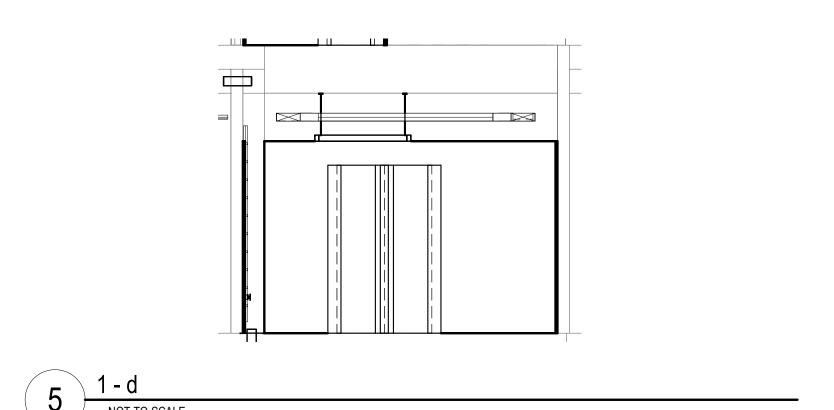

GENERAL NOTES:

A. REFER TO GENERAL NOTES ON SHEET T000 FOR ADDITIONAL SCOPE.

CABLING NOTE:

CABLING NOTES: A. THE EXISTING CABLE COUNT ARE THE CABLES CURRENTLY PRESENT IN THE SPACE. THE CABLE RELOCATION COUNT ARE THE NEW OR RELOCATED CABLES TO BE FED FROM THE SPACE. THE FINAL CABLE COUNT ARE THE CABLES THAT WILL BE PRESENT IN THE SPACE AT THE COMPLETION OF THE PROJECT.

DATA (CAT6): 0

DATA (CAT5e): 240 DATA (CAT5): 0 DATA (CAT3): 0


CABLE RELOCATION COUNT DATA (CAT6): 0 DATA (CAT5e): 0

DATA (CAT5): 0 DATA (CAT3): 0

EXISTING CABLE TO REMAIN DATA (CAT6): 0

DATA (CAT5e): 0 DATA (CAT5): 0 DATA (CAT3): 0


> FINAL CABLE COUNT DATA (CAT6A): 240 DATA (CAT6): 0

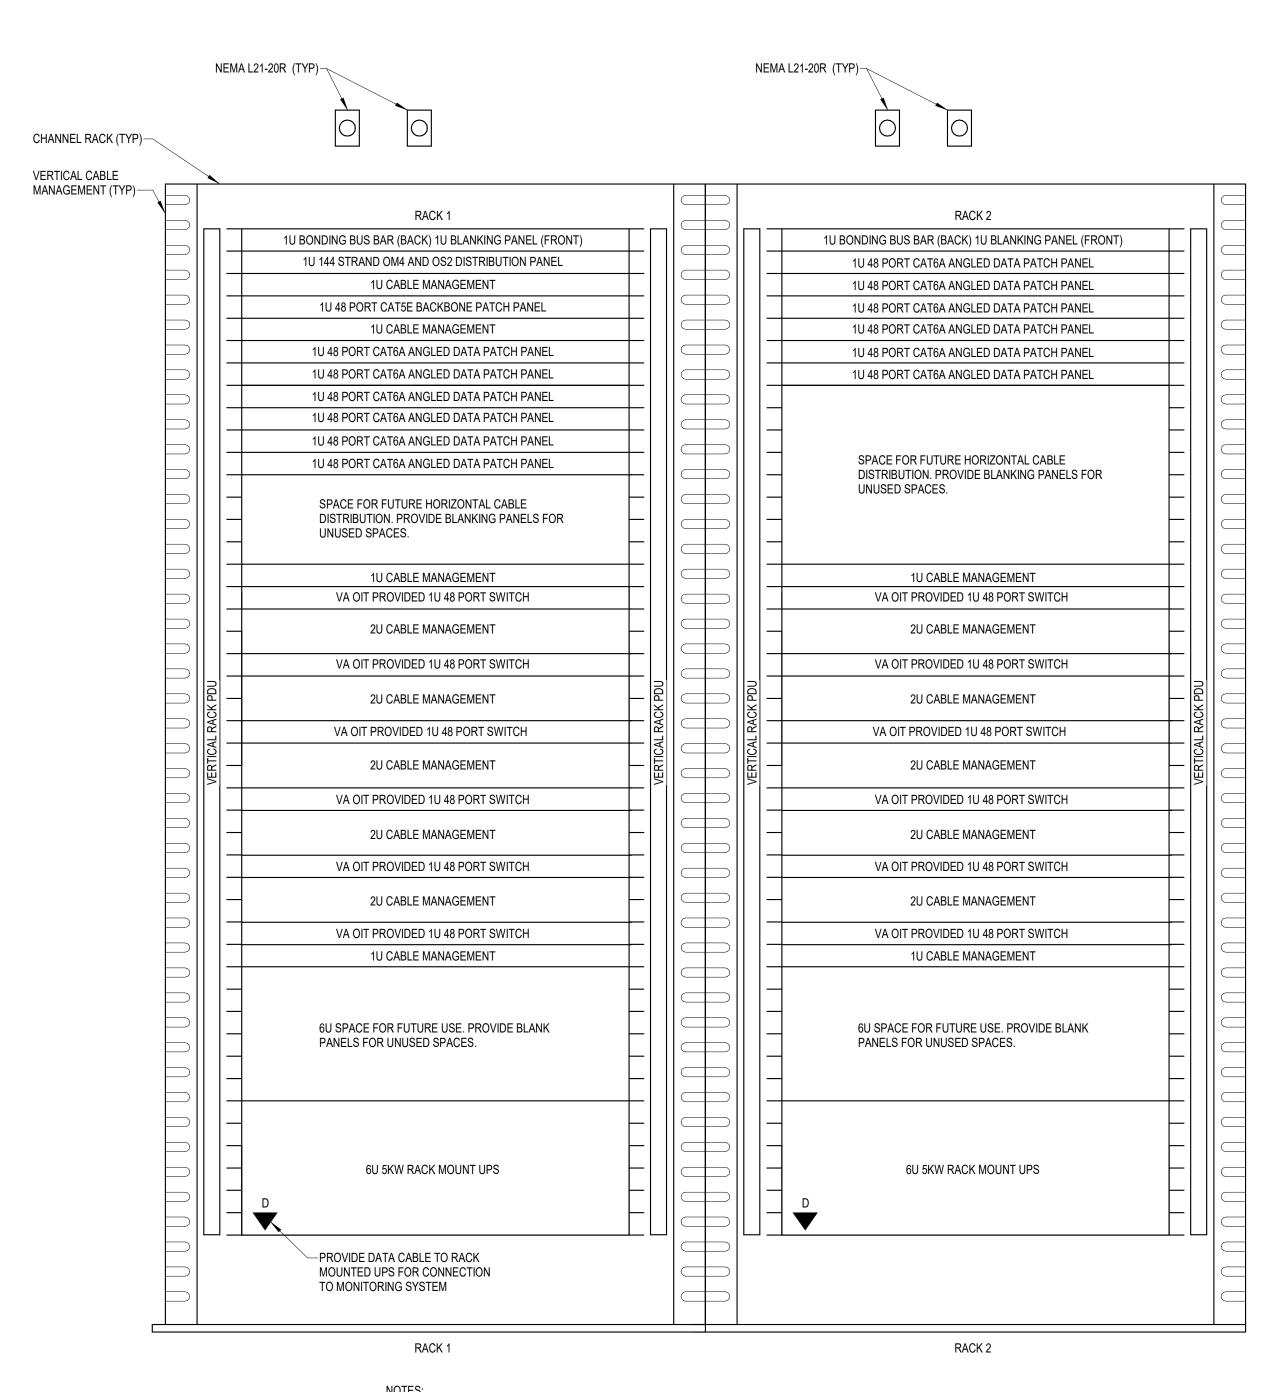

- NOTES:

 1. REFER TO NEW WORK PLAN FOR RACK LOCATIONS. 2. COORDINATE EXACT RACK COUNT AND LOCATION WITH OWNER PRIOR TO PERMANENT INSTALLATION. 3. SEE PROJECT SPECIFICATIONS FOR ADDITIONAL RACK COMPONENTS.
- 4. RACK ELEVATION SHOWS A FULLY CONFIGURED SAMPLE RACK. CONTRACTOR TO PROVIDE REQUIRED EQUIPMENT TO SUPPORT THE FINAL DATA COUNT FROM THE ENLARGED NEW SHEET. (NOT TO EXCEED 288 PORTS PER RACK). 5. COORDINATE FINAL RACK COMPONENT LAYOUT WITH OWNER'S IS/IT REPRESENTATIVE.
- 6. CONTRACTOR IS RESPONSIBLE FOR FINAL CABLE COUNT, QUANTITY OF PATCH PANELS, SWITCHES, FIBER ENCLOSURES, BLANKING PANELS, CABLE MANAGEMENT, AND MOUNTING HARDWARE NOT MARKED AS "OIT PROVIDED". 7. PUNCHDOWN COPPER BACKBONES ON RACK MOUNT PATCH PANELS. TERMINATE ONE (1) PAIR PER PATCH PANEL PORT.

COMMUNICATIONS - TYPICAL TWO RACK ELEVATION WITH RACK MOUNT UPS - EXIST TR 123

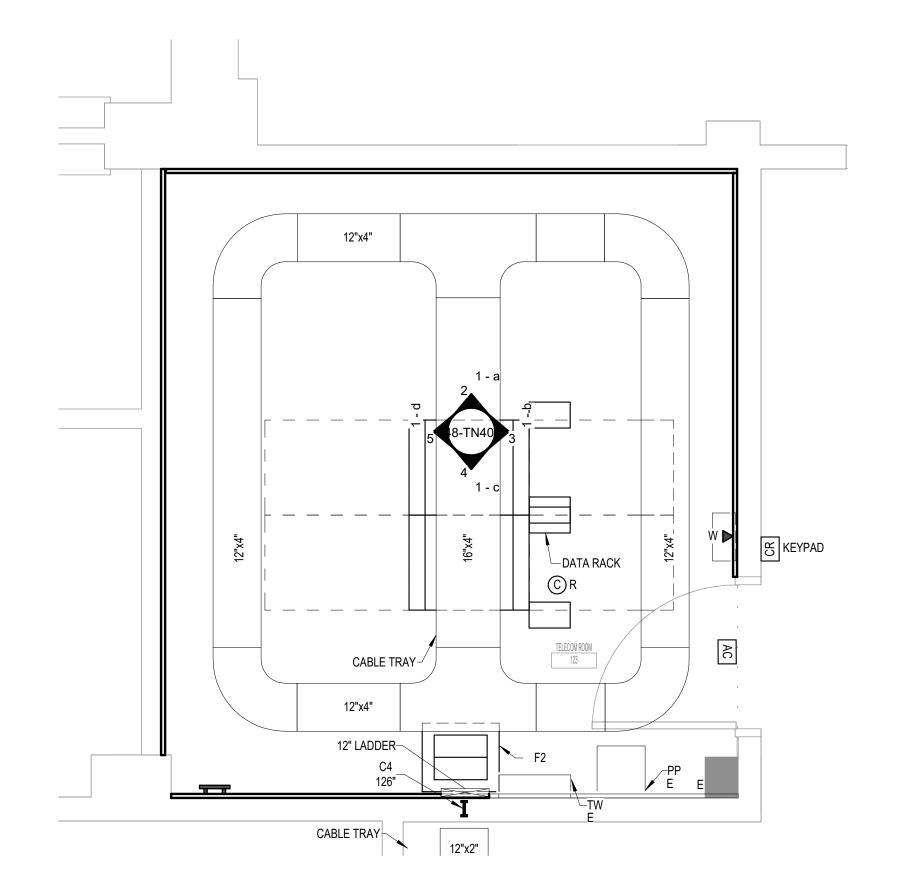






BUILDING No

VA MEDICAL CENTER ST.CLOUD, MN 56303

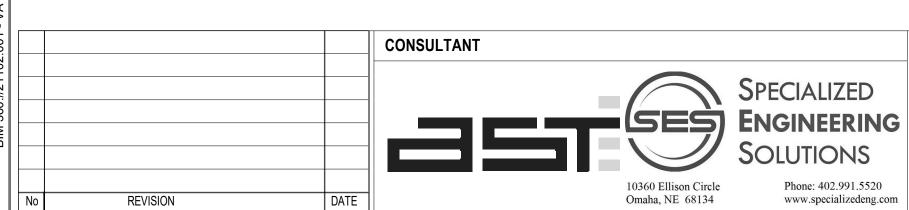




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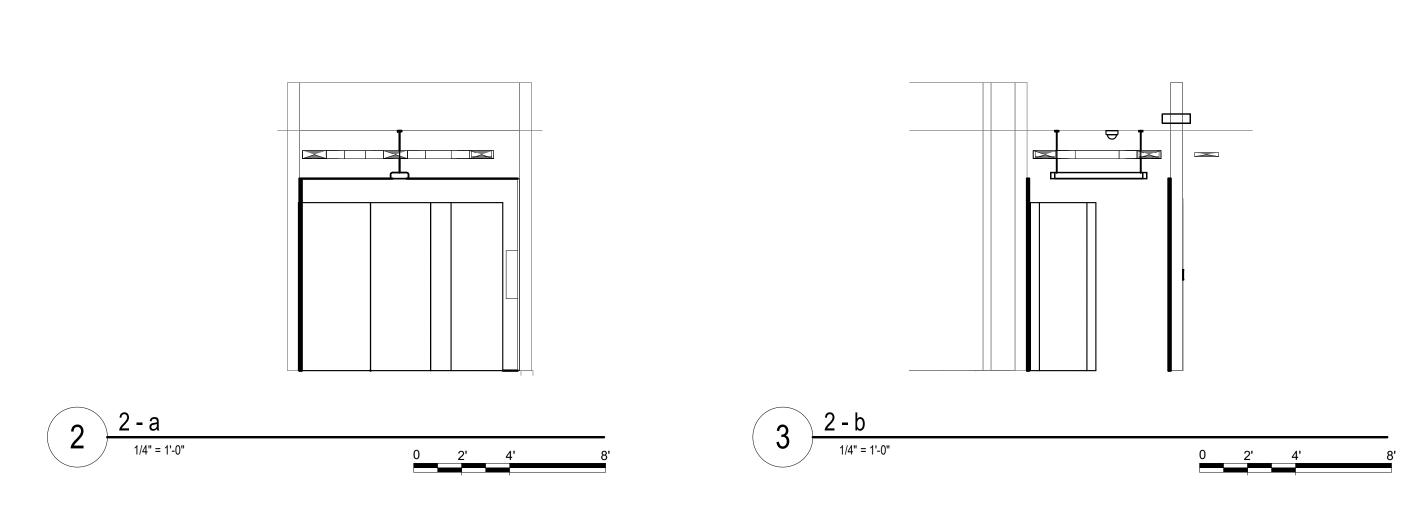





KSB




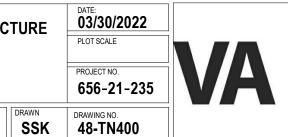



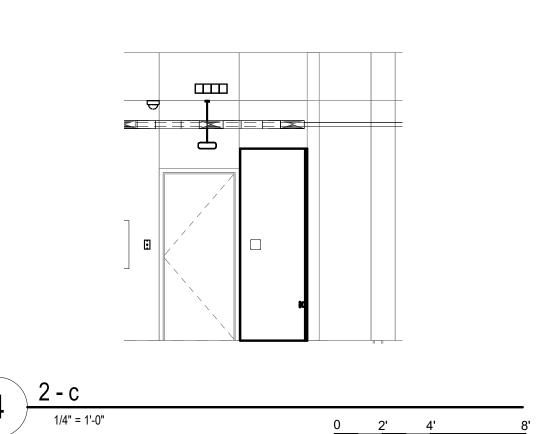

1 2 8

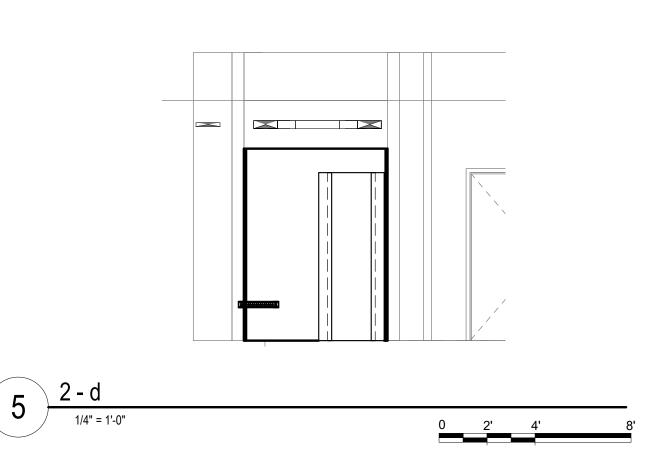

GENERAL NOTES:

A. REFER TO GENERAL NOTES ON SHEET T000 FOR ADDITIONAL SCOPE.

CABLING NOTE:

CABLING NOTES: A. THE EXISTING CABLE COUNT ARE THE CABLES CURRENTLY PRESENT IN THE SPACE. THE CABLE RELOCATION COUNT ARE THE NEW OR RELOCATED CABLES TO BE FED FROM THE SPACE. THE FINAL CABLE COUNT ARE THE CABLES THAT WILL BE PRESENT IN THE SPACE AT THE COMPLETION OF THE PROJECT.

1. ROOM 221 EXISTING CABLE COUNT

DATA (CAT6): 0 DATA (CAT5e): 295 DATA (CAT5): 0 DATA (CAT3): 0

CABLE RELOCATION COUNT


DATA (CAT6): 0 DATA (CAT5e): 0 DATA (CAT5): 0

DATA (CAT3): 0 EXISTING CABLE TO REMAIN

DATA (CAT6): 0 DATA (CAT5e): 0

DATA (CAT5): 0 DATA (CAT3): 0

> FINAL CABLE COUNT DATA (CAT6A): 295 DATA (CAT6): 0

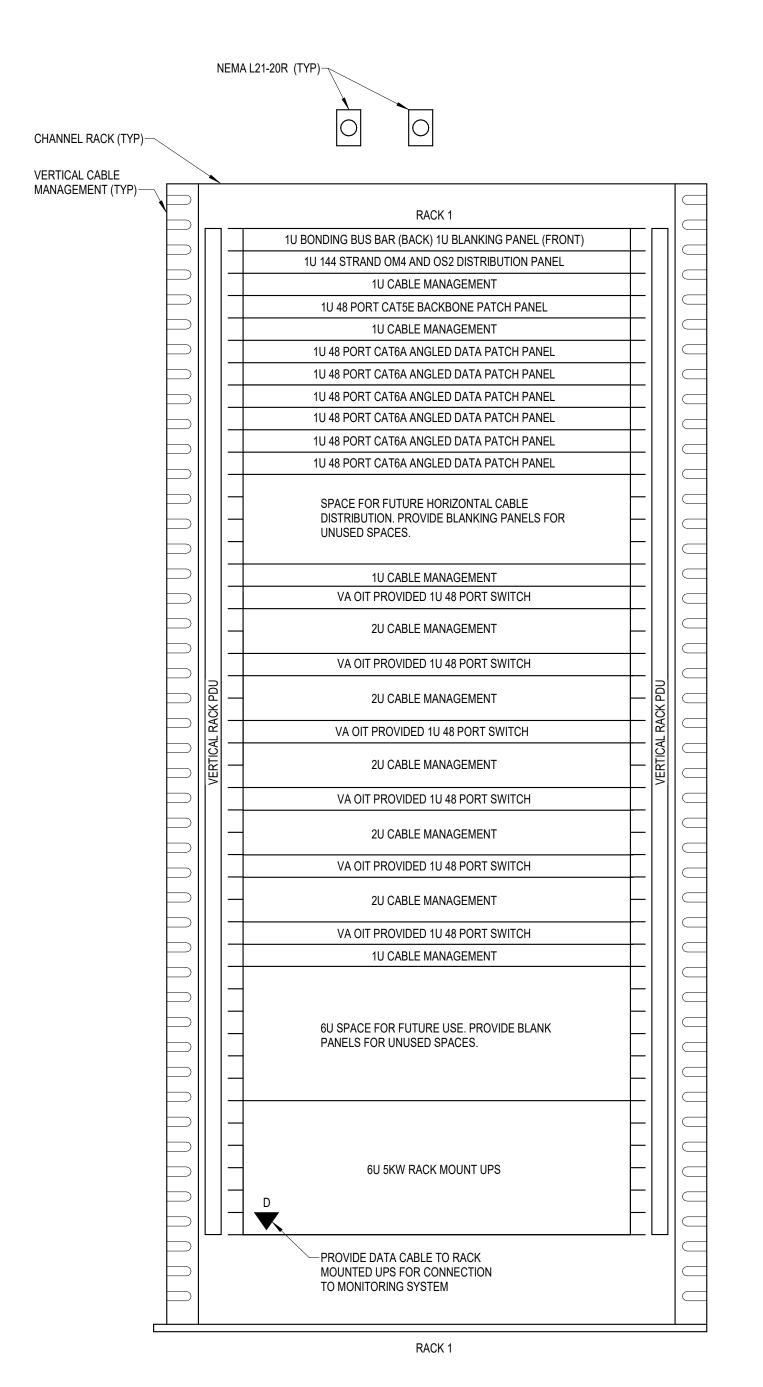


NOTES:

1. REFER TO NEW WORK PLAN FOR RACK LOCATIONS.


REVISION

- 2. COORDINATE EXACT RACK COUNT AND LOCATION WITH OWNER PRIOR TO PERMANENT INSTALLATION.
- 3. SEE PROJECT SPECIFICATIONS FOR ADDITIONAL RACK COMPONENTS. 4. RACK ELEVATION SHOWS A FULLY CONFIGURED SAMPLE RACK. CONTRACTOR TO PROVIDE REQUIRED EQUIPMENT TO SUPPORT THE FINAL DATA COUNT FROM THE ENLARGED NEW SHEET. (NOT TO EXCEED 288 PORTS PER RACK).
- 5. COORDINATE FINAL RACK COMPONENT LAYOUT WITH OWNER'S IS/IT REPRESENTATIVE. 6. CONTRACTOR IS RESPONSIBLE FOR FINAL CABLE COUNT, QUANTITY OF PATCH PANELS, SWITCHES, FIBER
- ENCLOSURES, BLANKING PANELS, CABLE MANAGEMENT, AND MOUNTING HARDWARE NOT MARKED AS "OIT PROVIDED". 7. PUNCHDOWN COPPER BACKBONES ON RACK MOUNT PATCH PANELS. TERMINATE ONE (1) PAIR PER PATCH PANEL PORT.

COMMUNICATIONS - TYPICAL ONE RACK ELEVATION WITH RACK MOUNT UPS - EXIST TR 221

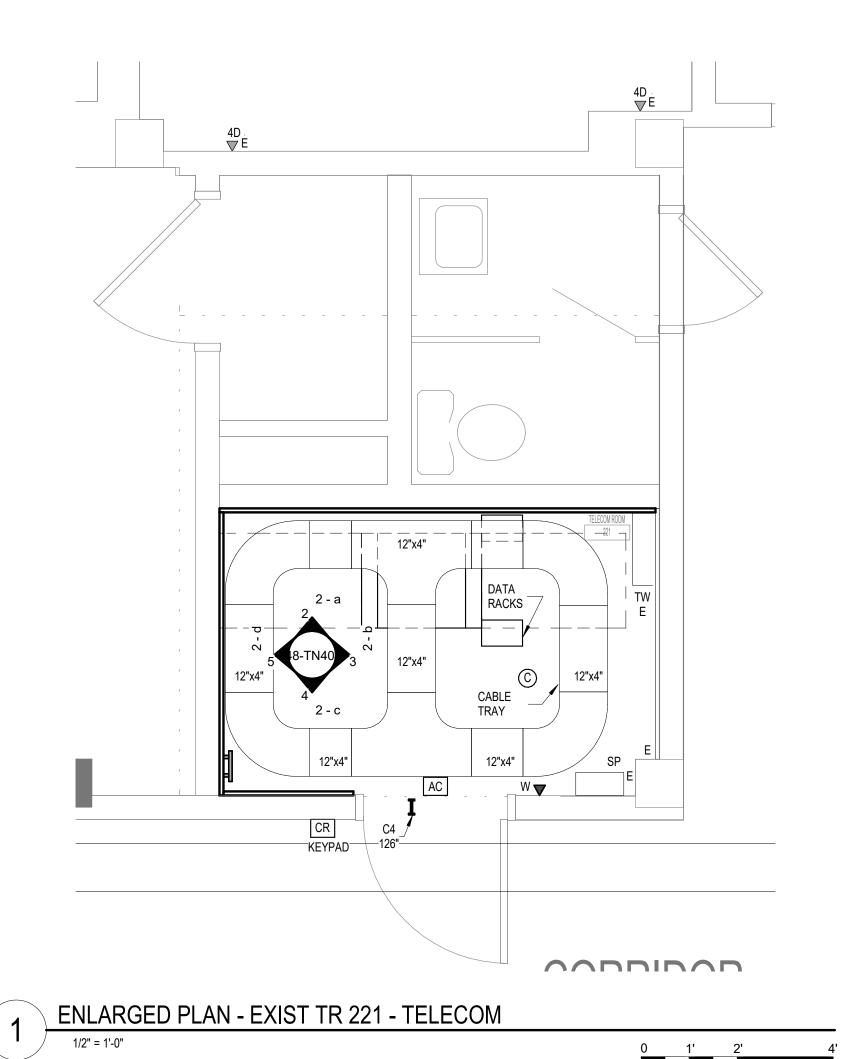



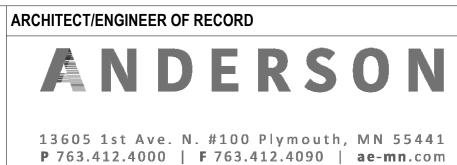

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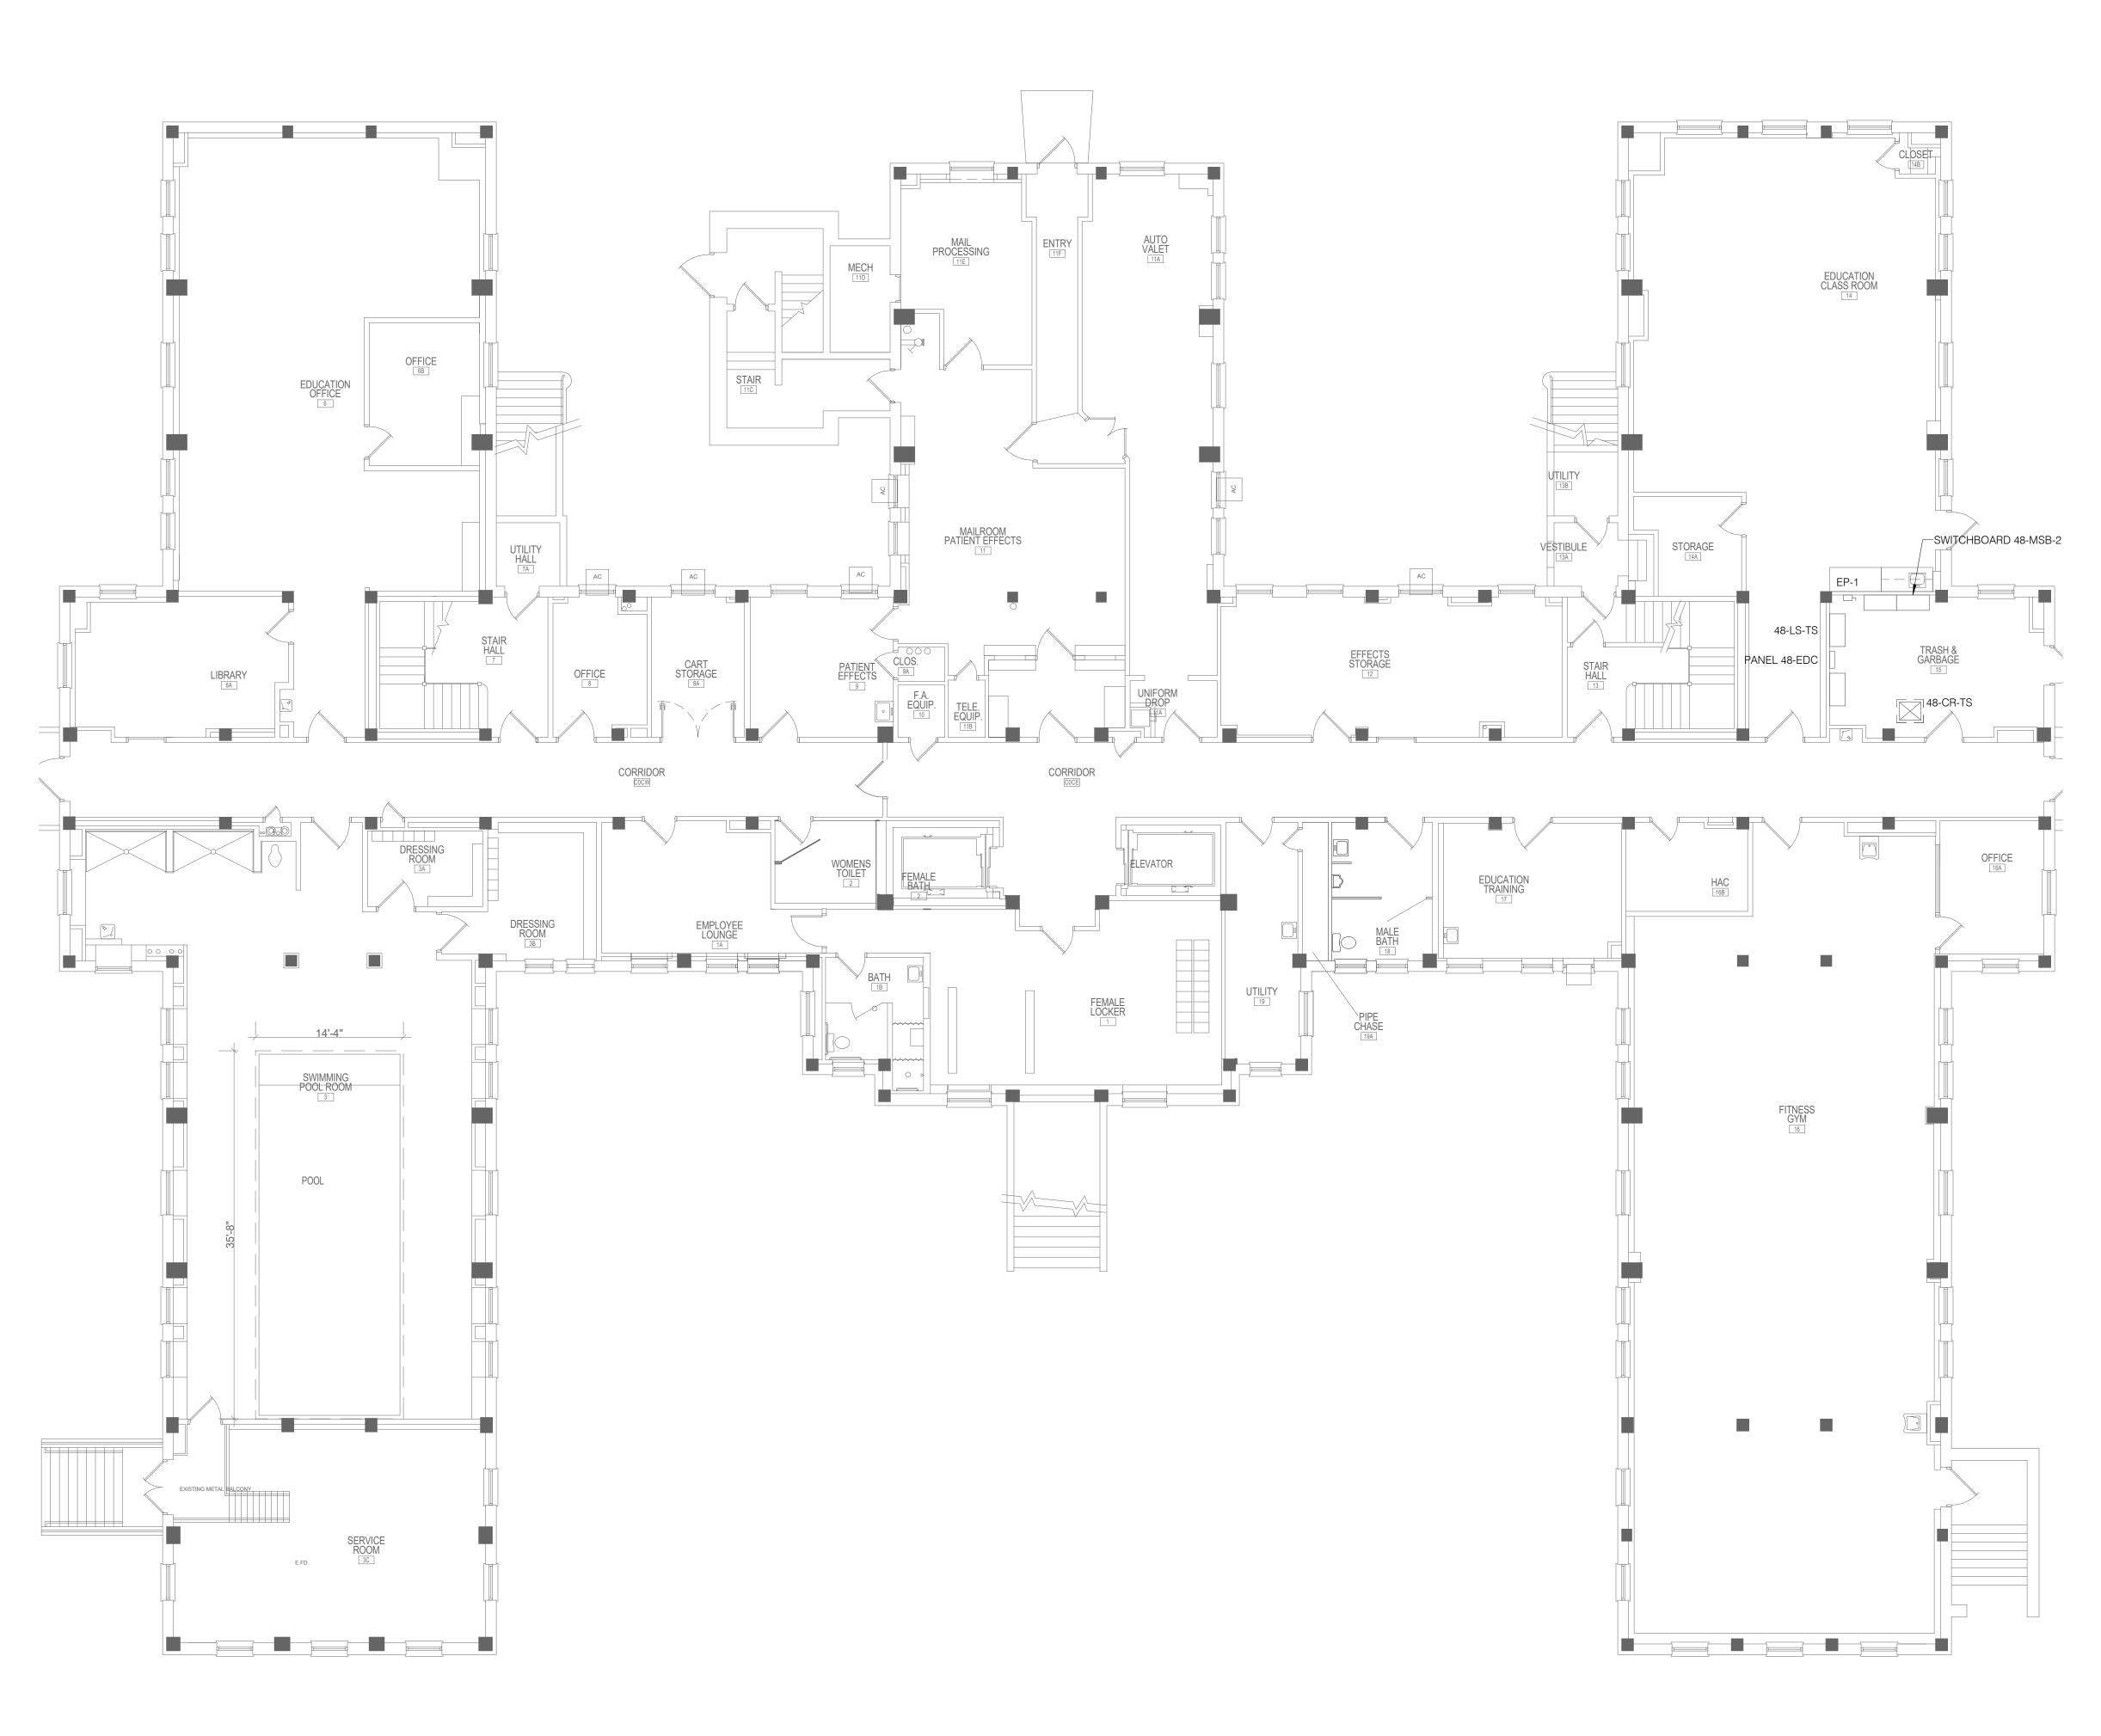




VA MEDICAL CENTER ST.CLOUD, MN 56303

CHECKED BY KSB DRAWN DRAWING NO. 48-TN401





 1

 5

 6

 5

1 BASEMENT FLOOR PLAN - ELECTRICAL

1/8" = 1'-0"

BASEMENT FLOOR PLAN ELECTRICAL

EHRM INFRASTRUCTURE UPGRADES

TBD GJL

VA MEDICAL CENTER ST.CLOUD, MN 56303 FULLY SPRINKLERED 235

U.S. Department
of Veterans Affairs

Veterans Health
Administration

St. Cloud VA
Health Care System

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Omaha, NE 68134

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ARCHITECT/ENGINEER OF RECORD

AND ERSON

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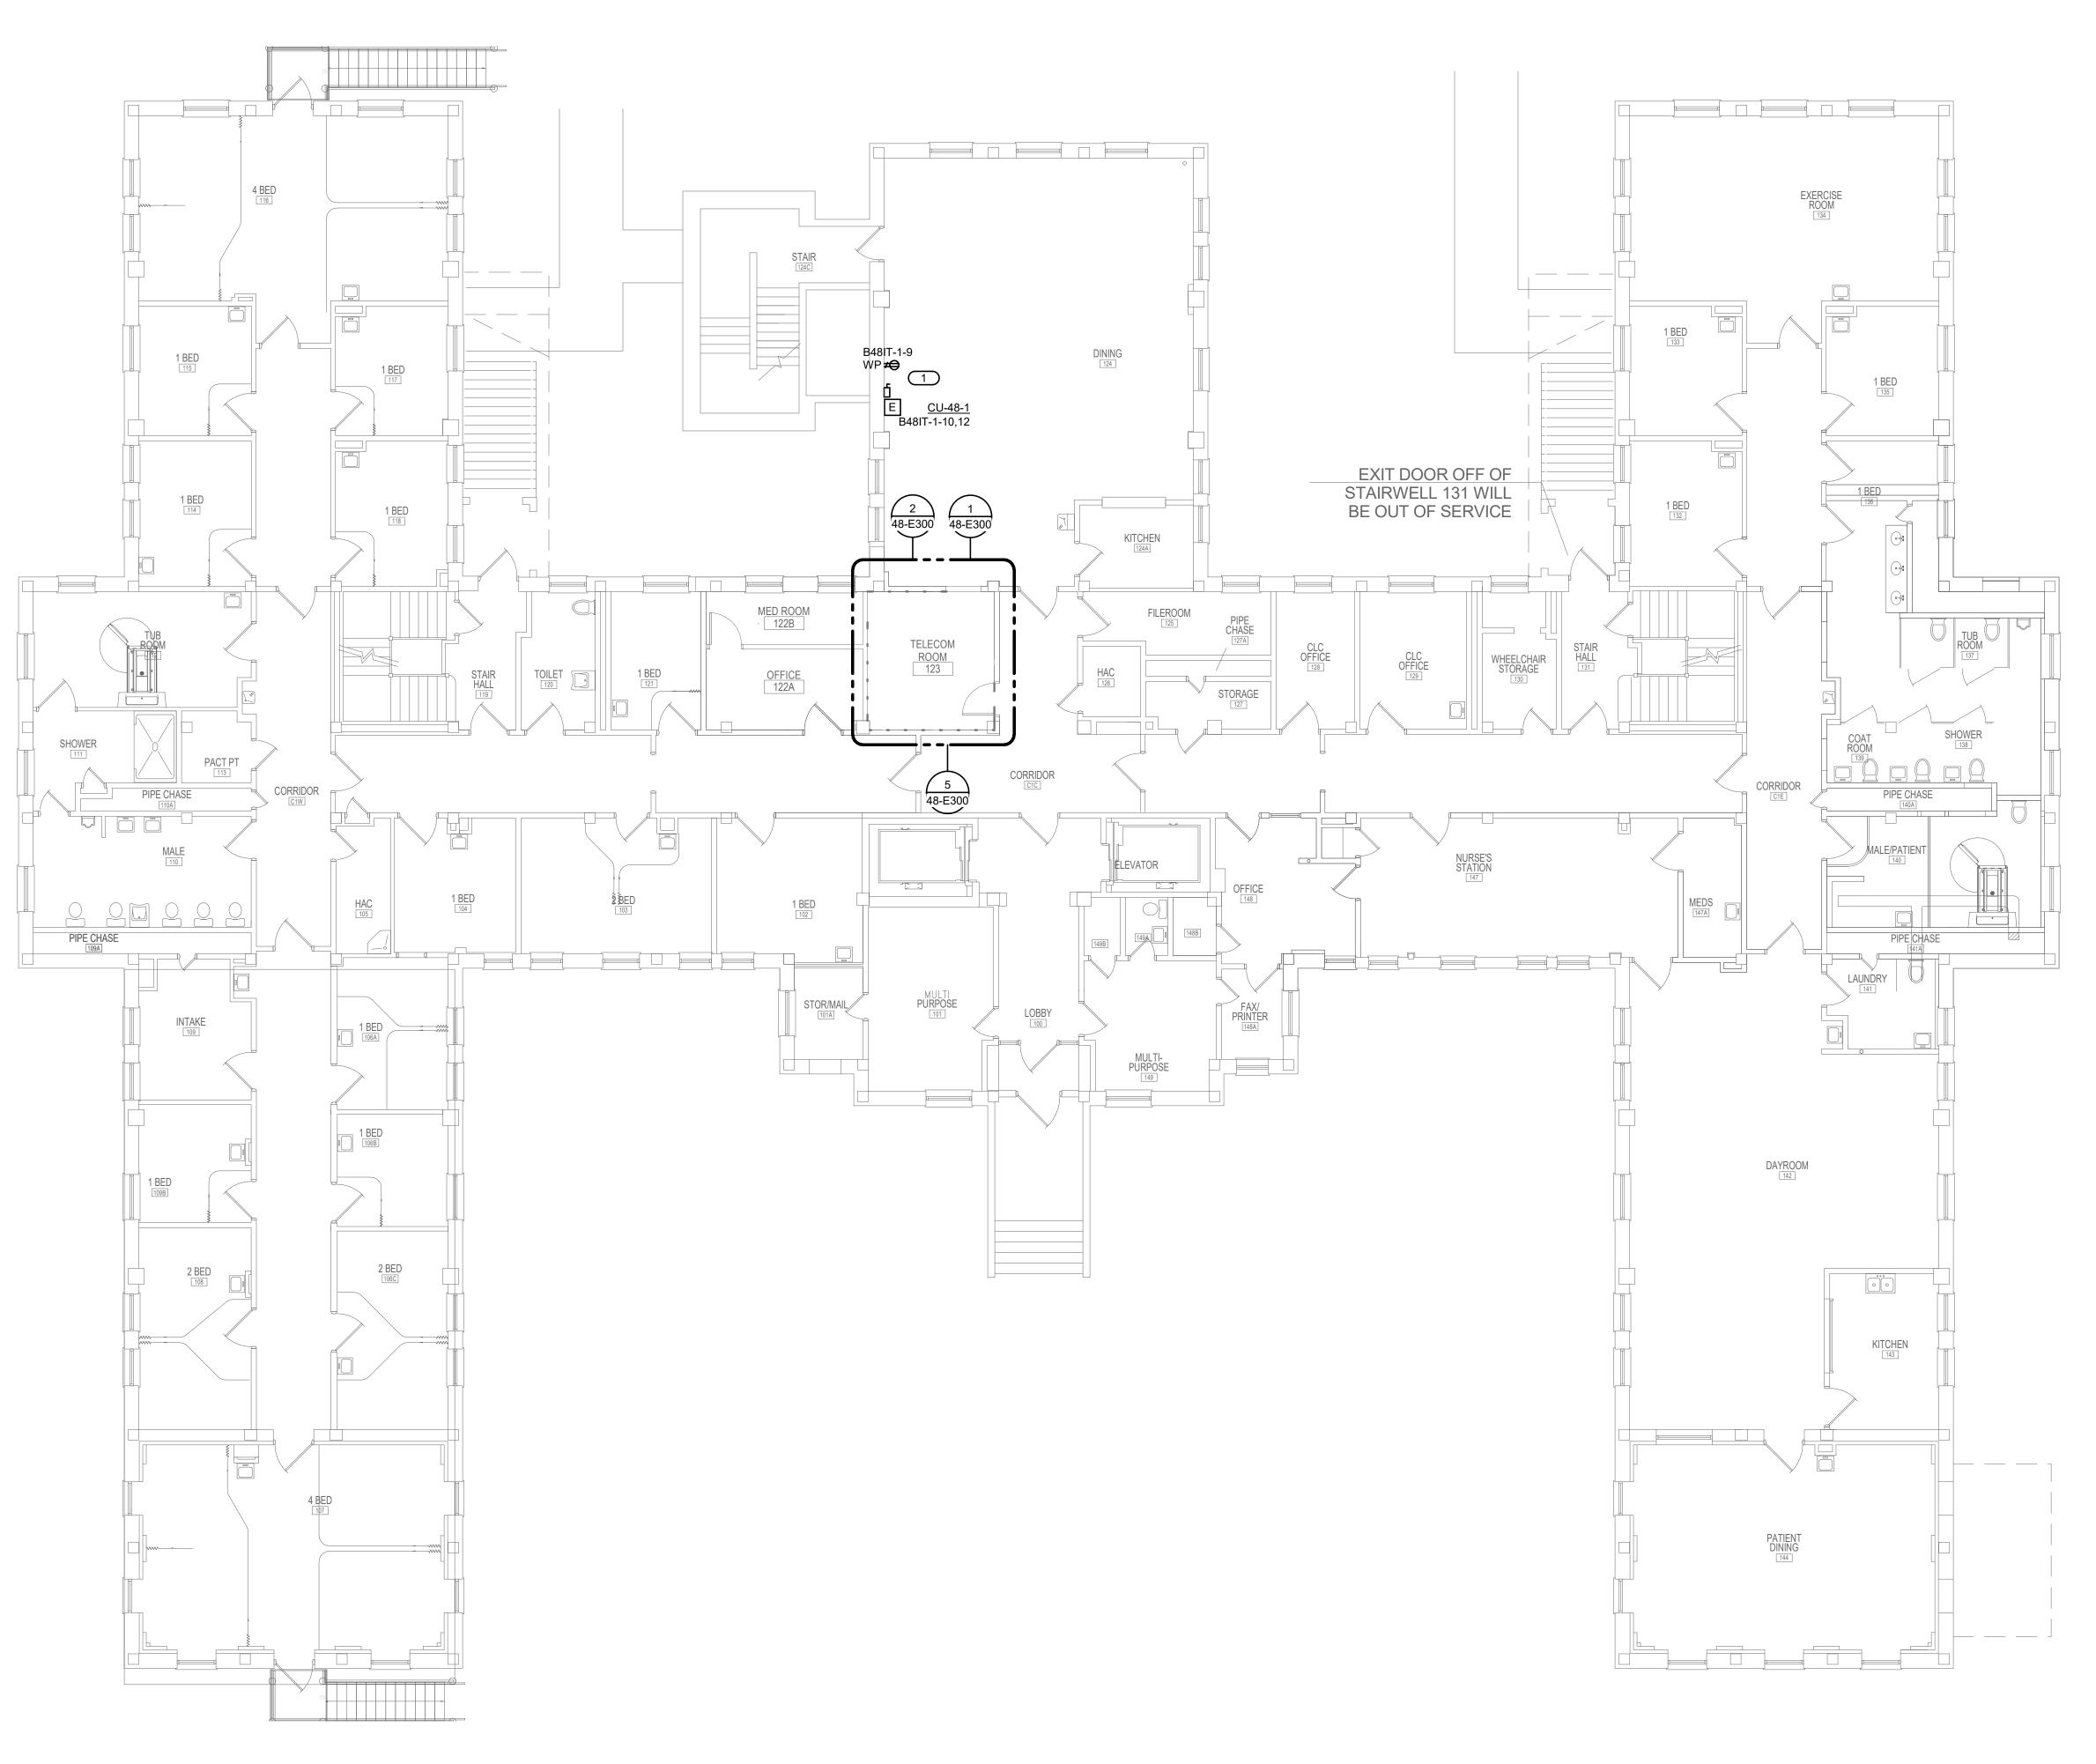
Name:

Date: 03/30/2022

License Number: MN#

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KEYNOTES: # PROVIDE ELECTRICAL CONNECTION TO CONDENSING UNIT, AS REQUIRED. COORDINATE FINAL LOCATION AND CONNECTION REQUIREMENTS WITH MECHANICAL.



1 9 9

1 FIRST FLOOR PLAN - ELECTRICAL

CONSULTANT SPECIALIZED 03/30 Phone: 402.991.5520 DATE Anderson Engineering of Minnesota, LLC | Proj # 16305 Omaha, NE 68134 www.specializedeng.com

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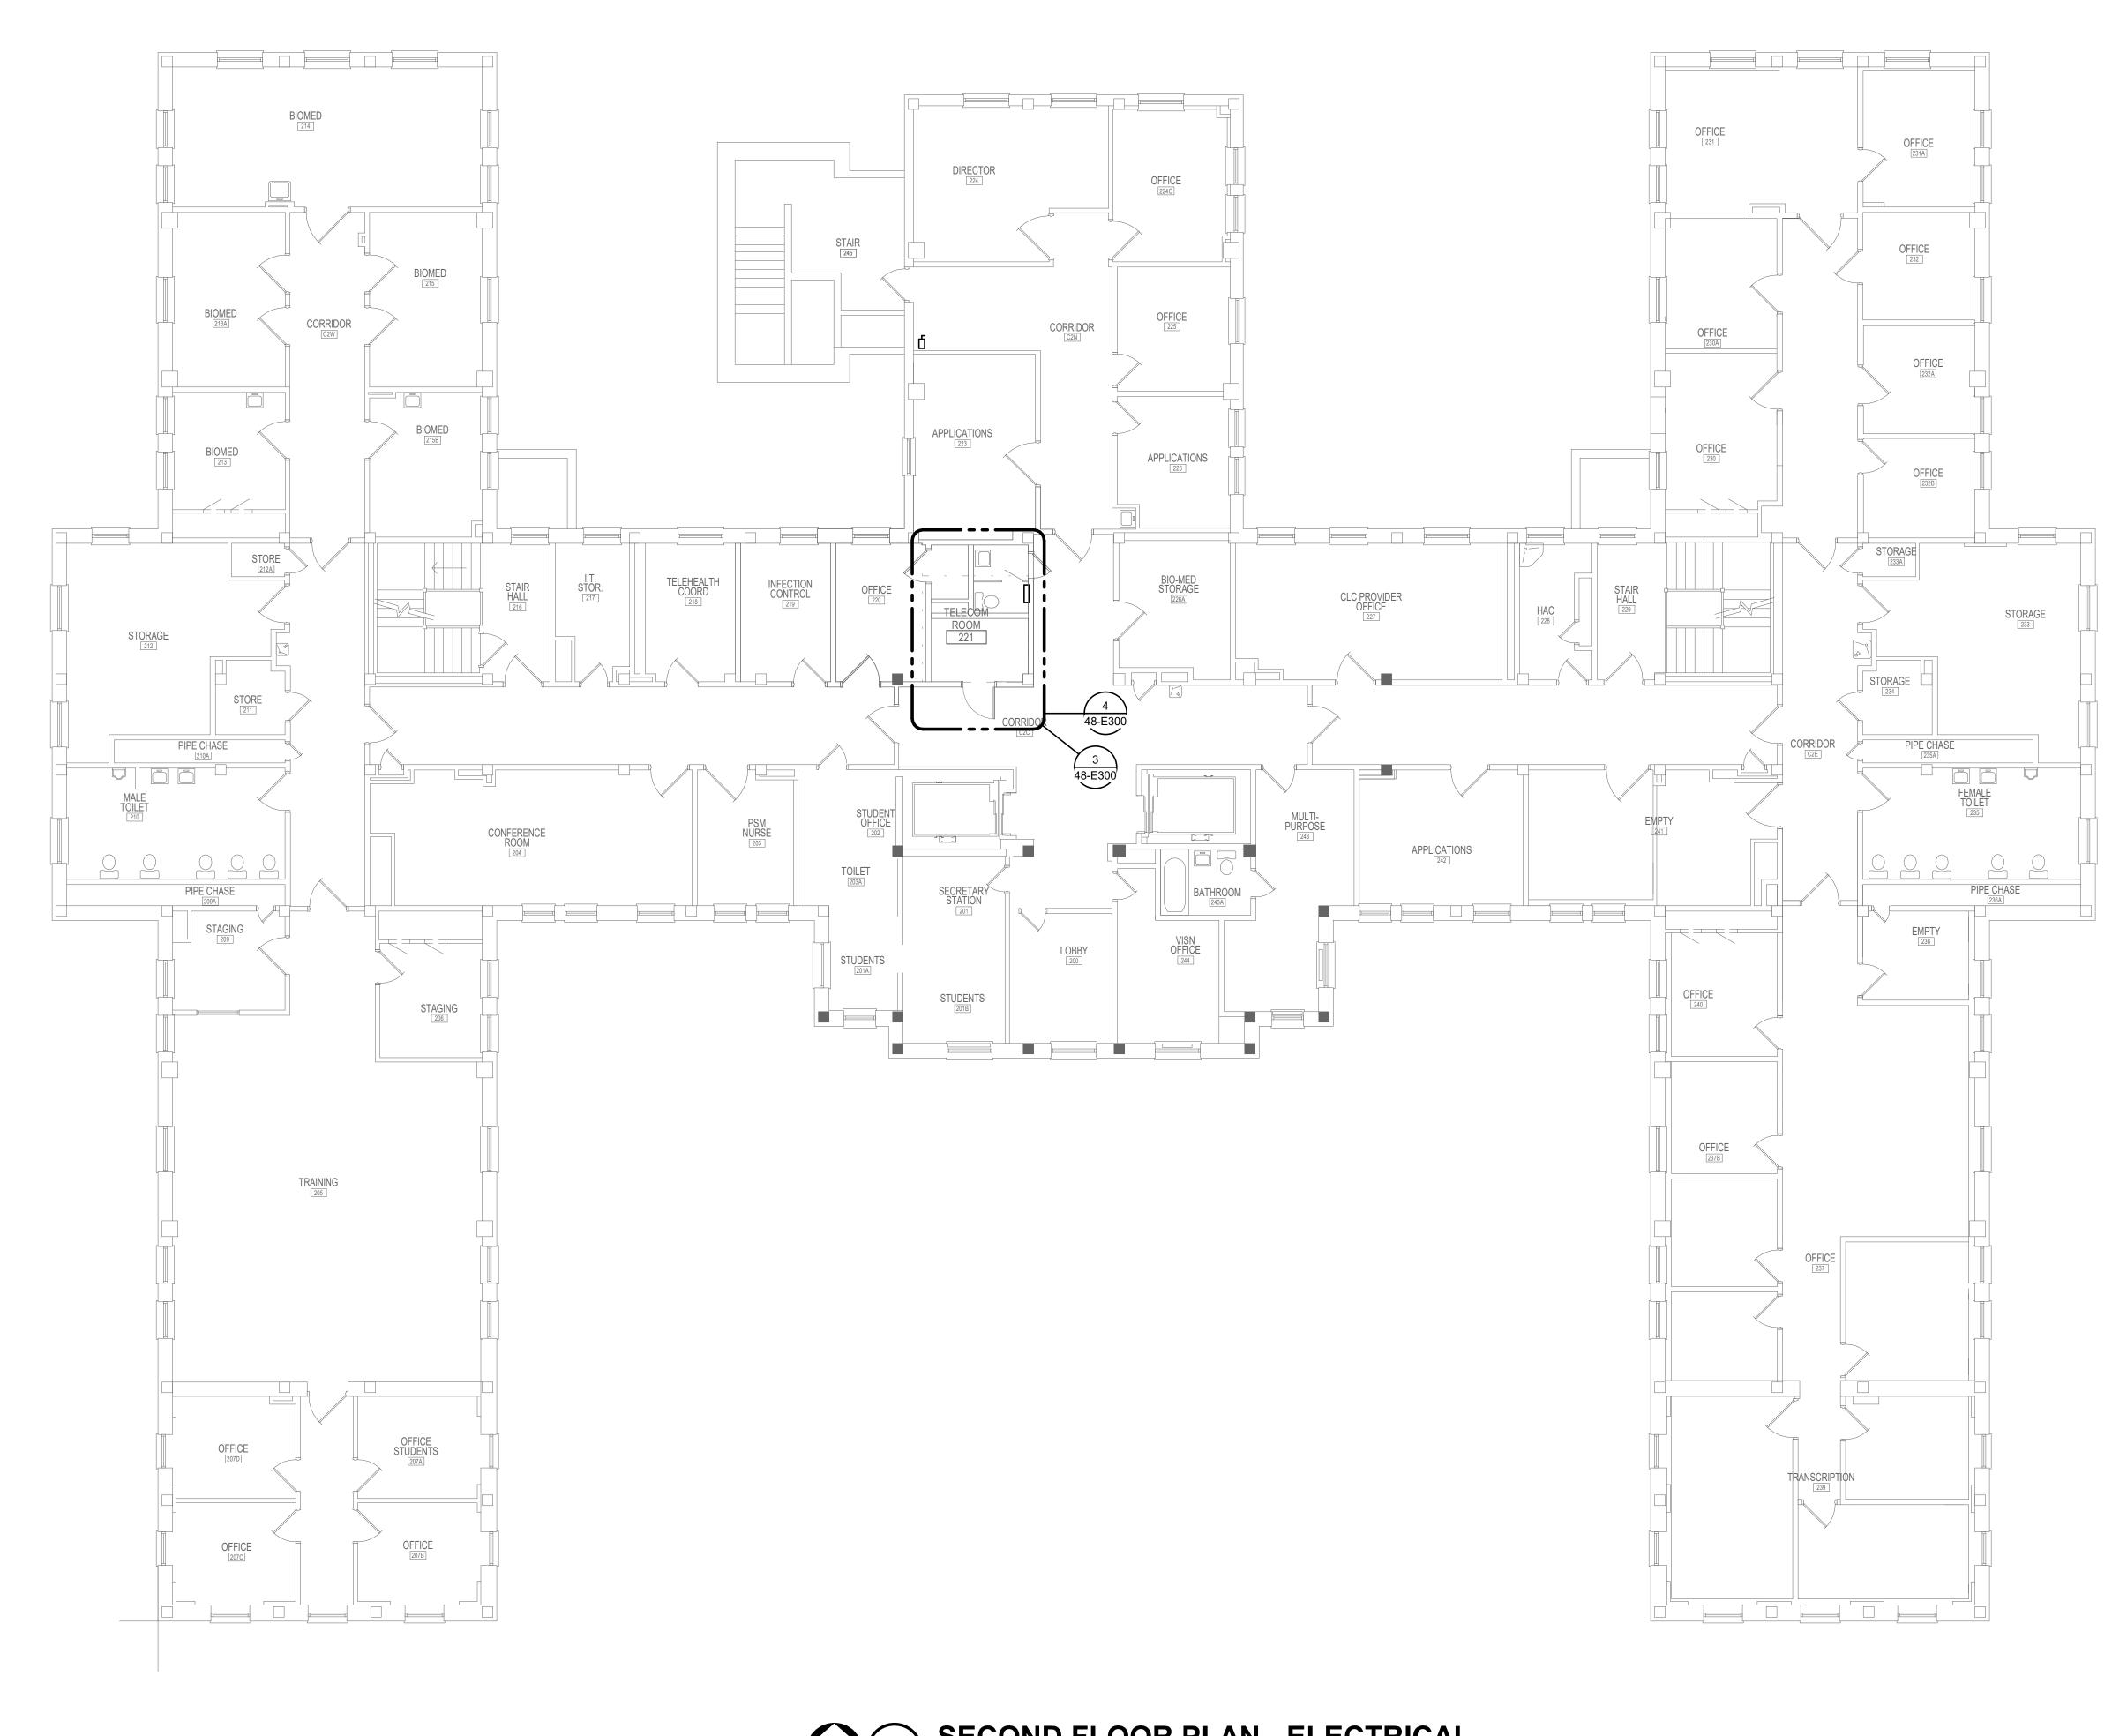
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FIRST FLOOR PLAN -ELECTRICAL

EHRM INFRASTRUCTURE TBD GJL

VA MEDICAL CENTER ST.CLOUD, MN 56303





1 2 8





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License Number: MN#



EHRM INFRASTRUCTURE

FULLY SPRINKLERED


LOCATION

VA MEDICAL CENTER

ST.CLOUD, MN 56303

Checker Author 48-E202




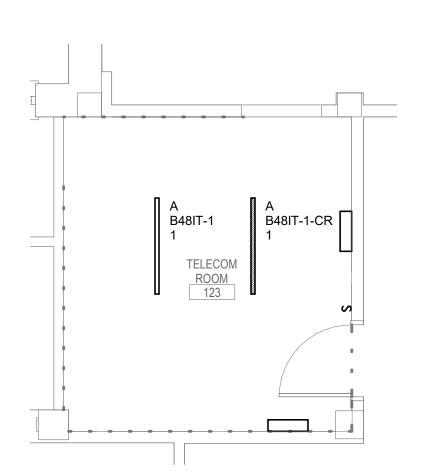


FIRST FLOOR - ENLARGED - TR123 - LIGHTING

1/4" = 1'-0"

0 2' 4' 8'

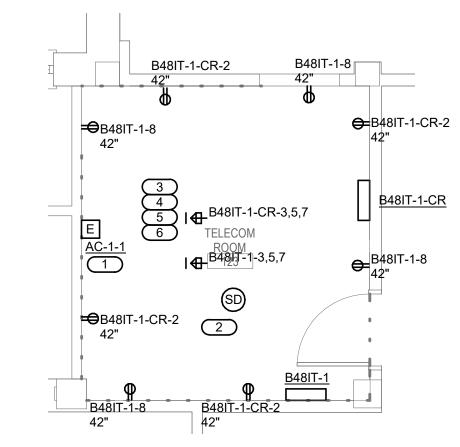


FIRST FLOOR - ENLARGED - TR123 - POWER & SYSTEM

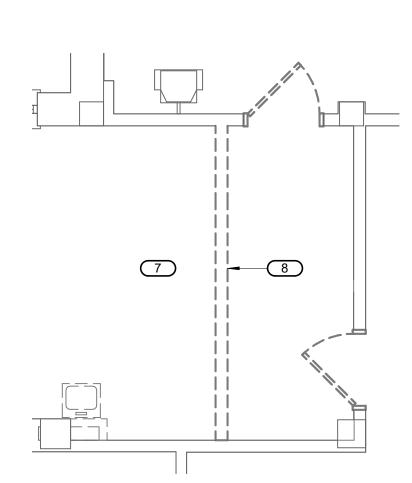

FIRST FLOOR PLAN - ELECTRICAL DEMOLITION


1/4" = 1'-0"

0 2' 4' 8'

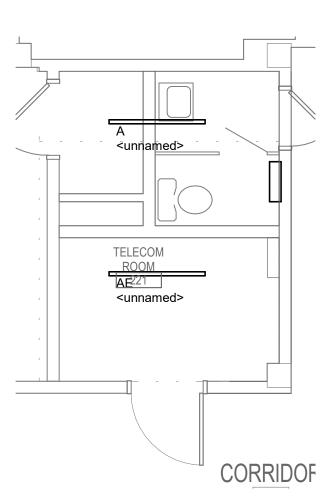

5 9

SECOND FLOOR PLAN - ELECTRICAL - Callout 1

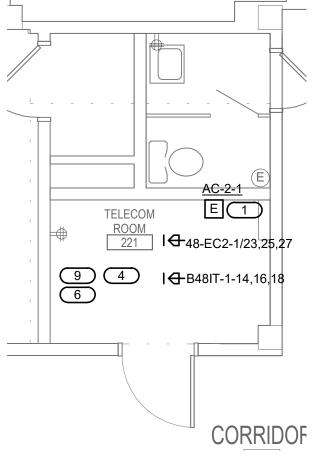

3 SECOND FLOOR - ENLARGED - TR 221 - POWER & SYSTEM

1/4" = 1'-0"

8

SHEET NOTES:

 REFER TO TECHNOLOGY PLANS FOR IT ROOM LAYOUT AND RACK LAYOUT/DETAILS.
 REFER TO SHEET 0-GE400 DETAIL LAYOUT & ONE-LINE OF RACK. KEYNOTES: #

1. INDOOR UNIT TO

 INDOOR UNIT TO BE POWERED BY OUTDOOR UNIT. COORDINATE EXACT LOCATION WITH M.C.
 CONNECT SMOKE DETECTOR TO NEAREST EXISTING SLC.

 COORDINATE FINAL LOCATION OF RECEPTACLE L21-30R WITH TELECOM CONTRACTOR. PROVIDE 3/4"C-4#10, 1#10 GND TO PANEL FOR EACH RECEPTACLE.
 PROVIDE EATON BLADEUPS, 5KW, 120/208V, 3-

PHASE,4-WIRE RACK MOUNTED UPS FOR EACH RACK TOWER. PROVIDE ONE RACK MOUNTED ZONE PDU UNIT. 30 AMP 3 PHASE, 120/208V, 5-WIRE WITH (4) L21-30R, (6) 5-20R AND TWO 10' POWER

CORDS. ZONIT#ZPDS-208V-30A-L21-4L21-20R-CR.

5. PROVIDE APC#AP8861 RPDU RACK PDU 2G WITH L21-20P CORD. (120/208V, 3-PHASE, 20A, ZERO U, 5.7 KW, 208V, (36) C13 (6) C19 (2) 5-20R OUTLETS. PROVIDE TWO PER RACK, MOUNTED PER MANUFACTURER'S REQUIREMENTS.

7. DISCONNECT AND REMOVE LIGHTS AND

RECEPTACLES IN AREA OF NEW IT ROOM.

MAINTAIN CIRCUIT CONTINUITY TO ADJOINING SPACES.

8. DEMO ALL ELECTRICAL ON WALL, DEMO ALL LTG IN ROOM.

9. COORDINATE FINAL LOCATION OF

9. COORDINATE FINAL LOCATION OF RECEPTACLE L21-20R WITH TELECOM CONTRACTOR. PROVIDE 3/4"C-4#12, 1#12 GND TO PANEL FOR EACH RECEPTACLE.

CONSULTANT

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103/30
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Name:

Date: 03/30/2022

License Number: MN#

ELECTRICAL ENLARGED PLANS

PROJECT TITLE

EHRM INFRASTRUCTURE
UPGRADES

PLOT SCALE

PROJECT NO.
656-21-2

BUILDING NO
48

CHECKED BY
TBD

DATE:
03/30/2022

PLOT SCALE

PROJECT NO.
656-21-2

VA MEDICAL CENTER ST.CLOUD, MN 56303





KEYNOTES: #

. PROVIDE NEW 100A/3P CIRCUIT BREAKER IN EXISTING PANEL TO MATCH EXISTING TYPE AND AIC RATING.

PANEL B48IT-1

ENCLOSURE: NEMA PB 1
FED FROM: B-MDP
LOCATION: TELECOM ROOM 123

MOUNTING: SURFACE

SOLID NEUTRAL GROUND BUS MAIN: 100 A MCB
VOLTS: 120/208 Wye
PHASE: 3
WIRE: 4
SCCR: 10 kA

1 2 8 9

NOTES:

K						NIRI	=								WIRI						K
E	СКТ		ОСР	D		SIZE		,	A		3	(2		SIZE			CPD		СКТ	
Υ	NO.	LOAD DESCRIPTION	AMPS	Ρ	Н	N	G							G	Ν	Н	Р	AMPS	LOAD DESCRIPTION	NO.	Y
	1	LIGHTING	20 A	1				0.44	0								1	20 A	SPARE	2	
	3	L21-30R RACK	20 A	3						1.67	0						1	20 A	SPARE	4	
	5											1.67	0				1	20 A	SPARE	6	
	7							1.67	0.72								1	20 A	EP GFI REC.	8	
	9	WP GFI REC.	20 A	1						0.18	1						2	20 A	CU48-1	10	
	11	SPARE	20 A	1								0	1					-		12	
	13	SPARE	20 A	1				0	1.67								3	30 A	L21-30R 2ND FLOOR	14	
	15	SPARE	20 A	1						0	1.67							-		16	
	17	SPARE	20 A	1								0	1.67							18	
	19	SPARE	20 A	1				0	0								1	20 A	SPARE	20	
	21	SPARE	20 A	1						0	0						1	20 A	SPARE	22	
	23	SPARE	20 A	1								0	0				1	20 A	SPARE	24	
	25	SPARE	20 A	1				0	0								1	20 A	SPARE	26	
	27	SPARE	20 A	1						0	0						1	20 A	SPARE	28	
	29	SPARE	20 A	1								0	0				1	20 A	SPARE	30	
					Tota	al Lo	ad:	4.50	kVA	4.51	kVA	4.33	kVA								
				-	Tota	l An	ıps:	37	.69	37	.82	36	.11								
										DAD SI	_	RY									
LO	AD CL	ASSIFICATION	COI	NNE	CTE	D L	OAD	DEN	IAND F	ACTO	R ES	TIMAT	ED DE	MAN	ND				TOTALS*		
Ligh	iting			0.4	144	κVA			100.0	0%		0.4	44 kVA						IOIALO		

Power 12 kVA 100.00% 12 kVA TOTAL CONNECTED LOAD: 13.34 kVA
Receptacles 0.9 kVA 100.00% 0.9 kVA TOTAL ESTIMATED DEMAND LOAD: 13.344 kVA
TOTAL CONNECTED AMPS: 37.04 A

*TOTAL DEMAND CALCS SUBTRACT ANY REDUNDANT LOAD AND THE SMALLER OF ANY NONCOINCIDENT HVAC LOADS. THIS CALC IS DONE AT EACH PANEL.

CIRCUIT KEY NOTES:

MOUNTING: SURFACE
ENCLOSURE: NEMA PB 1
FED FROM: 48-EDC
LOCATION: TELECOM ROOM 123

SOLID NEUTRAL GROUND BUS

PANEL B48IT-1-CR

MAIN: 100 A MCB
VOLTS: 120/208 Wye
PHASE: 3
WIRE: 4
SCCR: 10 kA

TOTAL CONNECTED LOAD:

TOTAL CONNECTED AMPS:

TOTAL ESTIMATED DEMAND LOAD: 6.164 kVA

TOTAL ESTIMATED DEMAND AMPS: 17.1 A

1 LIGHTING TR123 20 A 1 0.44 0.72 0 1 20 A RECEPTACLE TR123 3 L21-30R TR123 20 A 3 1.67 0	20 A 1 0.44 0.72 0.44 0.72 0.44 0.72 0.44 0.72 0.44 0.72 0.44 0.72 0.44 0.72 0.44 0.72 0.44 0.72 0.44 0.72 0.44 0.72 0.44 0.44 0.72 0.44 0.	K E Y	CKT NO.	LOAD DESCRIPTION	OCP AMPS	D P		WIR SIZI N			A	E	В	(;	NIRE SIZE N	•	P	CPD AMPS	LOAD DESCRIPTION	CKT NO.	K E Y
5 1 20 A SPARE 7 1 20 A SPARE 9 SPARE 20 A 1 1 0 0 0 1 20 A SPARE 11 SPARE 20 A 1 0 0 0 0 1 20 A SPARE 13 SPARE 20 A 1 0 0 0 0 1 20 A SPARE 15 SPARE 20 A 1 0 0 0 0 1 20 A SPARE 17 SPARE 20 A 1 0 0 0 0 1 20 A SPARE 18 SPARE 20 A 1 0 0 0 0 1 20 A SPARE 19 SPARE 20 A 1 0 0 0 0 1 20 A SPARE 19 SPARE 20 A 1 0 0 0 0 1 20 A SPARE 21 SPARE 20 A 1 0 0 0 0 1 20 A SPARE 23 SPARE 20 A 1 0 0 0 0 1 20 A SPARE 25 SPARE 20 A 1 0 0 0 0 1 20 A SPARE 27 SPARE 20 A 1 0 0 0 0 1 20 A SPARE 29 SPARE 20 A 1 0 0 0 0 1 20 A SPARE 29 SPARE 20 A 1 0 0 0 0 1 20 A SPARE 29 SPARE 20 A 1 0 0 0 0 1 20 A SPARE						1				0.44	0.72							1				H
7 1.67 0			3	L21-30R TR123	20 A	3						1.67	0			 		1	20 A	SPARE	4	
9 SPARE	20 A 1 0 0 0 0 1 20 A SPARE 10 20 A 1 0 0 0 0 1 20 A SPARE 112 20 A 1 0 0 0 0 1 20 A SPARE 112 20 A 1 0 0 0 0 1 20 A SPARE 114 20 A 1 0 0 0 0 0 1 20 A SPARE 114 20 A 1 0 0 0 0 1 20 A SPARE 118 20 A 1 0 0 0 0 1 20 A SPARE 120 A 1 0 0 0 0 1 20 A SPARE 20 20 A 1 0 0 0 0 1 20 A SPARE 20 A SPARE 20 20 A 1 0 0 0 0 1 20 A SPARE 20		5											1.67	0	 		1	20 A	SPARE	6	
11 SPARE 20 A 1 0 0 0 1 20 A SPARE 13 SPARE 20 A 1 0 0 0 1 20 A SPARE 15 SPARE 20 A 1 0 0 0 1 20 A SPARE 17 SPARE 20 A 1 0 0 0 1 20 A SPARE 19 SPARE 20 A 1 0 0 0 1 20 A SPARE 19 SPARE 20 A 1 0 0 0 1 20 A SPARE 21 SPARE 20 A 1 0 0 0 1 20 A SPARE 23 SPARE 20 A 1 0 0 0 1 20 A SPARE 25 SPARE 20 A 1 0 0 0 1 20 A SPARE 27 SPARE 20 A 1 0 0 0 1 20 A SPARE 29 SPARE 20 A 1 1 20 A SPARE	20 A 1 0 0 0 0 1 20 A SPARE 12 20 A 1 0 0 0 0 0 0 0 0 0 0 0 0 0 0 0 0		7							1.67	0					 		1	20 A	SPARE	8	
13 SPARE	20 A 1 0 0 0 0 1 20 A SPARE 14 20 A 1 0 0 0 0 0 0 0 0 0 0 0 0 0 0 0 0		9	SPARE	20 A	1						0	0			 		1	20 A	SPARE	10	
15 SPARE	20 A 1 0 0 0 0 1 20 A SPARE 16 20 A 1 0 0 0 0 1 20 A SPARE 18 20 A 1 0 0 0 0 1 20 A SPARE 20 A 1 0 0 0 0 1 20 A SPARE 20 A 1 0 0 0 0 0 1 20 A SPARE 20 A 1 1 20 A SPARE 22 20 A 1 0 0 0 0 1 20 A SPARE 24 20 A 1 0 0 0 0 1 20 A SPARE 24 20 A 1 0 0 0 0 1 20 A SPARE 26 20 A 1 0 0 0 0 1 20 A SPARE 26 20 A 1 0 0 0 0 1 20 A SPARE 28 20 A 1 1 20 A SPARE 30 20 A SPARE 30 20 A SPARE 30 A SPARE 3		11	SPARE	20 A	1								0	0	 		1	20 A	SPARE	12	
17 SPARE 20 A 1 0 0 0 1 20 A SPARE 19 SPARE 20 A 1 0 0 0	20 A 1 0 0 0 1 20 A SPARE 18 20 A 1 0 0 0 0 1 20 A SPARE 20 20 A 1 0 0 0 0 1 20 A SPARE 22 20 A 1 0 0 0 0 1 20 A SPARE 22 20 A 1 0 0 0 0 1 20 A SPARE 24 20 A 1 0 0 0 0 1 20 A SPARE 26 20 A 1 0 0 0 0 1 20 A SPARE 26 20 A 1 0 0 0 0 1 20 A SPARE 28 20 A 1 1 20 A SPARE 28 20 A 1 1 20 A SPARE 28 20 A 1 1 20 A SPARE 30 20 A 1 20 A SPARE 30 20 A 1 20 A SPARE 30 A		13	SPARE	20 A	1				0	0					 		1	20 A	SPARE	14	
19 SPARE 20 A 1 0 0 0	20 A 1 0 0 0		15	SPARE	20 A	1						0	0			 		1	20 A	SPARE	16	
21 SPARE 20 A 1 0 0 0 1 20 A SPARE 23 SPARE 20 A 1 0 0 0 1 20 A SPARE 25 SPARE 20 A 1 0 0 0 1 20 A SPARE 27 SPARE 20 A 1 0 0 0 1 20 A SPARE 29 SPARE 20 A 1 1 20 A SPARE 29 SPARE 20 A 1 1 20 A SPARE	20 A 1 0 0 0 0 1 20 A SPARE 22 20 A 1 0 0 0 0 1 20 A SPARE 24 20 A 1 0 0 0 0 1 20 A SPARE 24 20 A 1 0 0 0 0 1 20 A SPARE 26 20 A 1 0 0 0 0 1 20 A SPARE 28 20 A 1 1 20 A SPARE 28 20 A 1 1 20 A SPARE 30 28 20 A 1 1 20 A SPARE 30 28 20 A 1 1 20 A SPARE 30 28 20 A 1 1 20 A SPARE 30 20 A SPARE 30 20 A SPARE 30 20 A SPARE 30 A SPARE		17	SPARE	20 A	1								0	0	 		1	20 A	SPARE	18	
23 SPARE 20 A 1 0 0 0 1 20 A SPARE 25 SPARE 20 A 1 0 0 0 1 20 A SPARE 27 SPARE 20 A 1 0 0 0 1 20 A SPARE 29 SPARE 20 A 1 0 0 0 1 20 A SPARE 29 SPARE 20 A 1 1 20 A SPARE	20 A 1 0 0 0 1 20 A SPARE 24 20 A 1 0 0 0 1 20 A SPARE 26 20 A 1 0 0 0 0 1 20 A SPARE 26 20 A 1 1 20 A SPARE 28 20 A 1 1 20 A SPARE 28 20 A 1 1 20 A SPARE 30 20 A 1 1 20 A SPARE 30 20 A 1 1 20 A SPARE 30 20 A SPARE 30 20 A SPARE 30 A SPARE		19	SPARE	20 A	1				0	0					 		1	20 A	SPARE	20	
25 SPARE 20 A 1 0 0 1 20 A SPARE 27 SPARE 20 A 1 0 0 1 20 A SPARE 29 SPARE 20 A 1 0 0 1 20 A SPARE	20 A 1 0 0 0		21	SPARE	20 A	1						0	0			 		1	20 A	SPARE	22	
27 SPARE 20 A 1 0 0 0 1 20 A SPARE 29 SPARE 20 A 1 1 20 A SPARE	20 A 1 0 0 0 1 20 A SPARE 28 20 A 1 Total Load: 2.83 kVA 1.67 kVA 1.67 kVA		23	SPARE	20 A	1								0	0	 		1	20 A	SPARE	24	
29 SPARE 20 A 1 0 0 0 1 20 A SPARE	20 A 1 0 0 0 1 20 A SPARE 30 Total Load: 2.83 kVA 1.67 kVA 1.67 kVA		25	SPARE	20 A	1				0	0					 		1	20 A	SPARE	26	
	Total Load: 2.83 kVA 1.67 kVA 1.67 kVA		27	SPARE	20 A	1						0	0			 		1	20 A	SPARE	28	
Total Load: 2.83 kVA 1.67 kVA 1.67 kVA			29	SPARE	20 A	1								0	0	 		1	20 A	SPARE	30	
100 KV/ 1.07 KV/	Total Amps: 23.59 13.89 13.89					•	Tot	al L	oad:	2.83	kVA	1.67	kVA	1.67	kVA		•					
Total Amps: 23.59 13.89 13.89							Tota	ıl An	nps:	23	.59	13	.89	13.	89							
LOAD SUMMARY OAD CLASSIFICATION CONNECTED LOAD DEMAND FACTOR ESTIMATED DEMAND			iting				444				100.0				 14 kVA	_				TOTALS*		

100.00%

100.00%

*TOTAL DEMAND CALCS SUBTRACT ANY REDUNDANT LOAD AND THE SMALLER OF ANY NONCOINCIDENT HVAC LOADS. THIS CALC IS DONE AT EACH PANEL.

0.72 kVA

0.72 kVA

100Y

100Y

48-EDC B-MDP

B-MDP

B-MDP

PARTIAL POWER RISER

12" = 1'-0"

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Omaha, NE 68134

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Receptacles

CIRCUIT KEY NOTES:

ARCHITECT/ENGINEER OF RECORD

AND ERSON

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Name:

Date: 03/30/2022

License Number: MN#

ELECTRICAL ONE-LINE
DIAGRAMS & SCHEDULES

> FULLY SPRINKLERED

LOCATION

VA MEDICAL CENTER

ST.CLOUD, MN 56303



FIRST FLOOR



FED FROM: B-MDP **LOCATION:** TELECOM ROOM 123

1 2 8

PANEL B48IT-1

MOUNTING: SURFACE

ENCLOSURE: NEMA PB 1

SOLID NEUTRAL **GROUND BUS**

MAIN: 100 A MCB VOLTS: 120/208 Wye PHASE: 3 WIRE: 4 SCCR: 10 kA

K E	СКТ		ОСРІ	D		NIRI Size			A	E	3		C		VIRE SIZE		(OCPD		СКТ	K E
Υ	NO.	LOAD DESCRIPTION	AMPS	Р	Н	N	G							G	N	Н	Р	AMPS	LOAD DESCRIPTION	NO.	Υ
	1	LIGHTING	20 A	1				0.89	1.67								3	20 A	L21-30R RACK	2	
	3	L21-30R RACK	20 A	3						1.67	1.67				-			-		4	
	5											1.67	1.67		-			-		6	
	7							1.67	0.72								1	20 A	EP GFI REC.	8	
	9	WP GFI REC.	20 A	1						0.72	1						2	20 A	CU48-1	10	
	11	WP GFI REC.	20 A	1								0.18	1		-			-		12	
	13	SPARE	20 A	1				0	0						-		1	20 A	SPARE	14	
	15	SPARE	20 A	1						0	0				-		1	20 A	SPARE	16	
	17	SPARE	20 A	1								0	0		-		1	20 A	SPARE	18	
	19	SPARE	20 A	1				0	0						-		1	20 A	SPARE	20	
	21	SPARE	20 A	1						0	0				-		1	20 A	SPARE	22	
	23	SPARE	20 A	1								0	0		-		1	20 A	SPARE	24	
	25	SPARE	20 A	1				0	0						-		1	20 A	SPARE	26	
	27	SPARE	20 A	1						0	0				-		1	20 A	SPARE	28	
	29	SPARE	20 A	1								0	0		-		1	20 A	SPARE	30	
					Tota	al Lo	oad:	4.94	kVA	5.05	kVA	4.51	kVA								
				•	Tota	I An	nps:	41	.74	42	.66	37	.61								

LOAD SUMMARY											
LOAD CLASSIFICATION CONNECTED LOAD DEMAND FACTOR ESTIMATED DEMAND											
Lighting	0.889 kVA	100.00%	0.889 kVA	- TOTALS*							
Power	12 kVA	100.00%	12 kVA	TOTAL CONNECTED LOAD:	14.51 kVA						
Receptacles	1.62 kVA	100.00%	1.62 kVA	TOTAL ESTIMATED DEMAND LOAD:	14.509 kVA						
				TOTAL CONNECTED AMPS:	40.27 A						
				TOTAL ESTIMATED DEMAND AMPS:	40.3 A						

*TOTAL DEMAND CALCS SUBTRACT ANY REDUNDANT LOAD AND THE SMALLER OF ANY NONCOINCIDENT HVAC LOADS. THIS CALC IS DONE AT EACH PANEL. **CIRCUIT KEY NOTES:**

03/30 DATE 100% CD REVISION

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Name:

Date: 03/30/2027 License Number: MN# 53095


ELECTRICAL SCHEDULES

DATE: 03/30/2022 EHRM INFRASTRUCTURE TBD DRAWN

FULLY SPRINKLERED

LOCATION

VA MEDICAL CENTER
ST.CLOUD, MN 56303

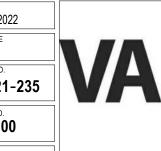




- 1. THE HVAC CONTRACTOR SHALL VISIT THE SITE **PRIOR TO BID** TO FIELD VERIFY ALL EXISTING CONDITIONS WHICH MAY AFFECT THEIR BID. THE FOLLOWING ITEMS SHALL BE VERIFIED:
- A. EXACT PLACEMENT, SIZE, CAPACITY, MANUFACTURER, AND CONDITION OF ALL EXISTING HVAC EQUIPMENT WITHIN SCOPE
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 B. SIZE AND LOCATION OF ALL EXISTING DUCTWORK.
- C. SIZE AND LOCATION OF ALL EXISTING GRILLES, REGISTERS AND DIFFUSERS.
- D. SIZE AND LOCATION OF ALL EXISTING THERMOSTATIC CONTROL DEVICES.
- E. SIZE AND LOCATION OF ALL EXISTING PLUMBING AND HYDRONIC PIPING
- 2. ALL REFERENCES ON THESE DRAWINGS TO EXISTING EQUIPMENT, DUCTWORK, DIFFUSERS, THERMOSTATS AND PIPING ARE FOR REFERENCE ONLY. IT IS THE RESPONSIBILITY OF THE CONTRACTOR TO VERIFY ALL THESE ITEMS PRIOR TO BID AND INCLUDE IN THEIR BID ANY AND ALL AMOUNTS REQUIRED TO ACCOMMODATE EXISTING CONDITIONS.
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- 4. ANY DISCREPANCIES WHICH MAY AFFECT THE CONTRACTORS BID SHALL BE BROUGHT TO THE ATTENTION OF THE ENGINEER AND ARCHITECT FOR DIRECTION.

KEYNOTES 1/48-M101:

- DEMOLISH EXISTING FIRE SPRINKLER HEADS AND BRANCH LINE AS SHOWN.
 PREPARE FOR RECONNECTION.
- 2. DEMOLISH EXISTING FIRE SPRINKLER HEAD AND BRANCH LINE AS SHOWN. PREPARE FOR RECONNECTION.
- 3. 3/4" COPPER WATER PIPE TO REMAIN.

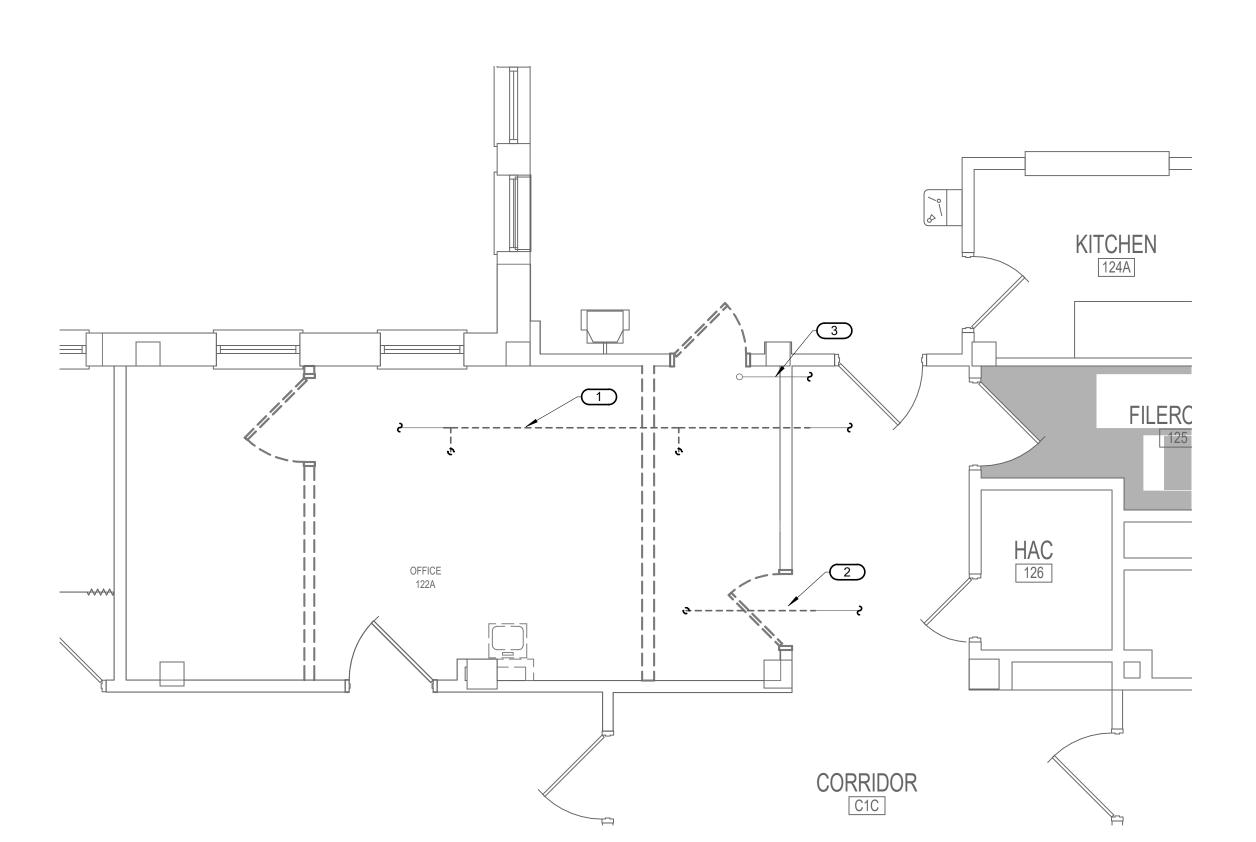


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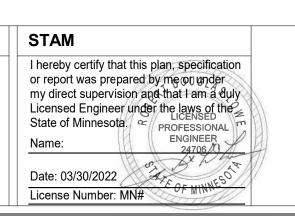
FIRST FLOOR DEMOLITION PLAN - MECHANICAL - TELECOM 123



100% CD 03/3 0 No REVISION DATE





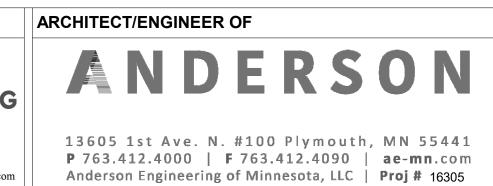



EHRM
INFRASTRUCTURE
UPGRADES

VA MEDICAL CENTER ST.CLOUD, MN 56303






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KEYNOTES 1/48-M102:

AND CONTROLS.


- 1. REMOVE AND DISPOSE OF EXISTING SUPPLY AIR DUCT AS SHOWN. PREPARE FOR RECONNECTION. FIELD VERIFY EXACT REQUIREMENTS.
- 2. EVACUATE AND CAPTURE EXISTING REFRIGERANT, AND DISPOSE OF IN ACCORDANCE WITH SPECIFICATIONS AND ALL REGULATORY REQUIREMENTS. REMOVE AND DISPOSE OF EXISTING DUCTLESS SPLIT AC UNIT ALONG WITH ALL ASSOCIATED REFRIGERANT PIPING, CONDENSING UNIT, CONDENSING PIPING
- 3. REMOVE AND DISPOSE OF EXISTING THERMOSTAT AND ASSOCIATED WIRING. 4. REMOVE AND DISPOSE OF EXISTING FIRE SPRINKLER HEADS AND BRANCH LINES BACK TO LOCATION SHOWN PREPARE FOR RECONNECTION.
- 5. REMOVEAND DISPOSE OF EXISTING EXHAUST REGISTER AND ASSOCIATED DUCTWORK. CAP DUCT IN ATTIC.
- 6. REMOVE AND DISPOSE OF EXISTING PLUMBING PIPING IN WALL AND CAP BACK AT MAINS.
- 7. REMOVE AND DISPOSE OF EXISTING 3" SANITARY, 2" VENT, 1" CW AND 3/4" HW PIPING IN CHASE FROM CEILING OF FIRST FLOOR TO ATTIC. PREP VENT PIPE FOR REROUTING.
- 8. REMOVE AND DISPOSE OF EXISTING PLUMBING FIXTURES.

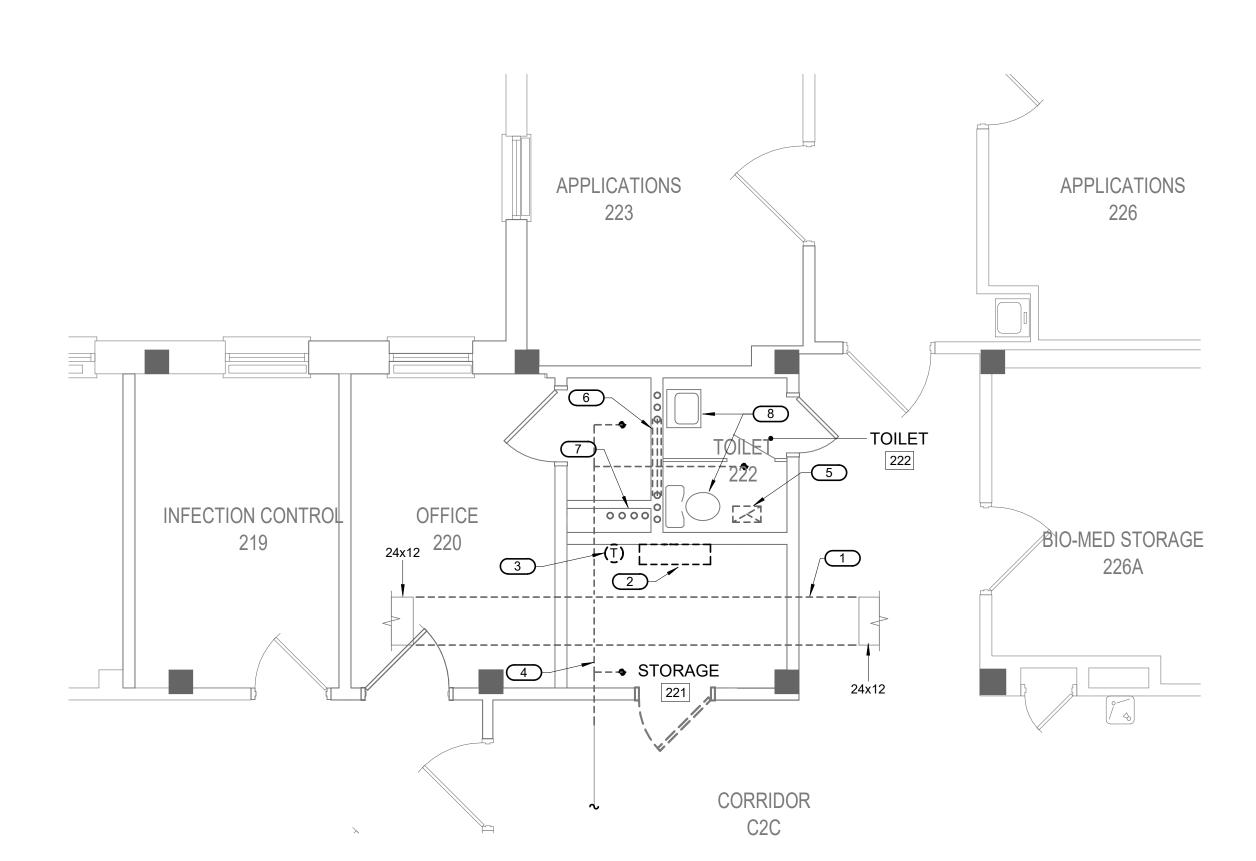


SECOND FLOOR DEMOLITION PLAN - MECHANICAL - STORAGE 221






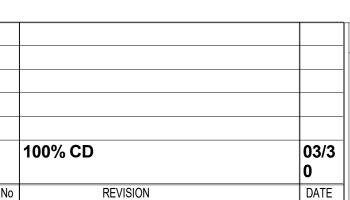



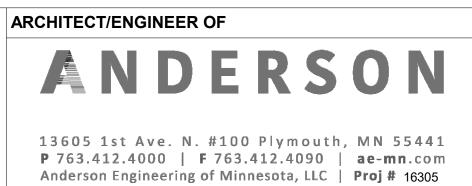

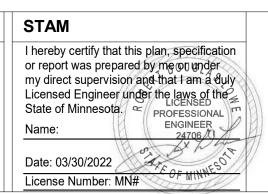





VA MEDICAL CENTER ST.CLOUD, MN 56303

FULLY SPRINKLERED




U.S. Department of Veterans Affairs Veterans Health Administration St. Cloud VA Health Care System


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KEYNOTES 1/48-M201:

- 1. PROVIDE NEW WALL-MOUNTED DUCTLESS COOLING UNIT AC-48-1.
- 2. PROVIDE CONDENSATE PUMP.
- 3. ROUTE NEW REFRIGERANT PIPING TO NEW AIR-COOLED CONDENSING UNIT ON
- 4. PROVIDE NEW AIR-COOLED CONDENSING UNIT CU-48-1. PROVIDE CONCRETE PAD. REFER TO REFRIGERANT PIPING DETAIL 1/0-GM400 AND PAD MOUNTING DETAIL 3/0-GM401
- 5. ROUTE 1" PUMPED CONDENSATE PIPE TO MOP SINK IN HAC 126, APPROXIMATELY 25 FEET EAST. COORDINATE FINAL ROUTING IN FIELD,
- 6. REROUTE EXISTING FIRE SPRINKLER LINE AND PROVIDE NEW SPRINKLER HEADS AS REQUIRED.
- 7. EXTEND EXISTING FIRE SPRINKLER LINE AND PROVIDE NEW SPRINKLER HEAD.
- 8. PROVIDE NEW THERMOSTAT.
- 9. PROVIDE DRIP PAN FOR CONDENSATE PIPE IN TR ROOM. SEE DETAIL FOR REQUIREMENTS.
- 10. 3/4" COPPER WATER PIPE TO REMAIN, PROVIDE DRIP PAN AND PIPE WRAP. SEE 6/0-GM400 FOR REQUIREMENTS.
- 11. REFERE TO 4/0-GM401 FOR WALL PENETRATION SEALING DETAIL.

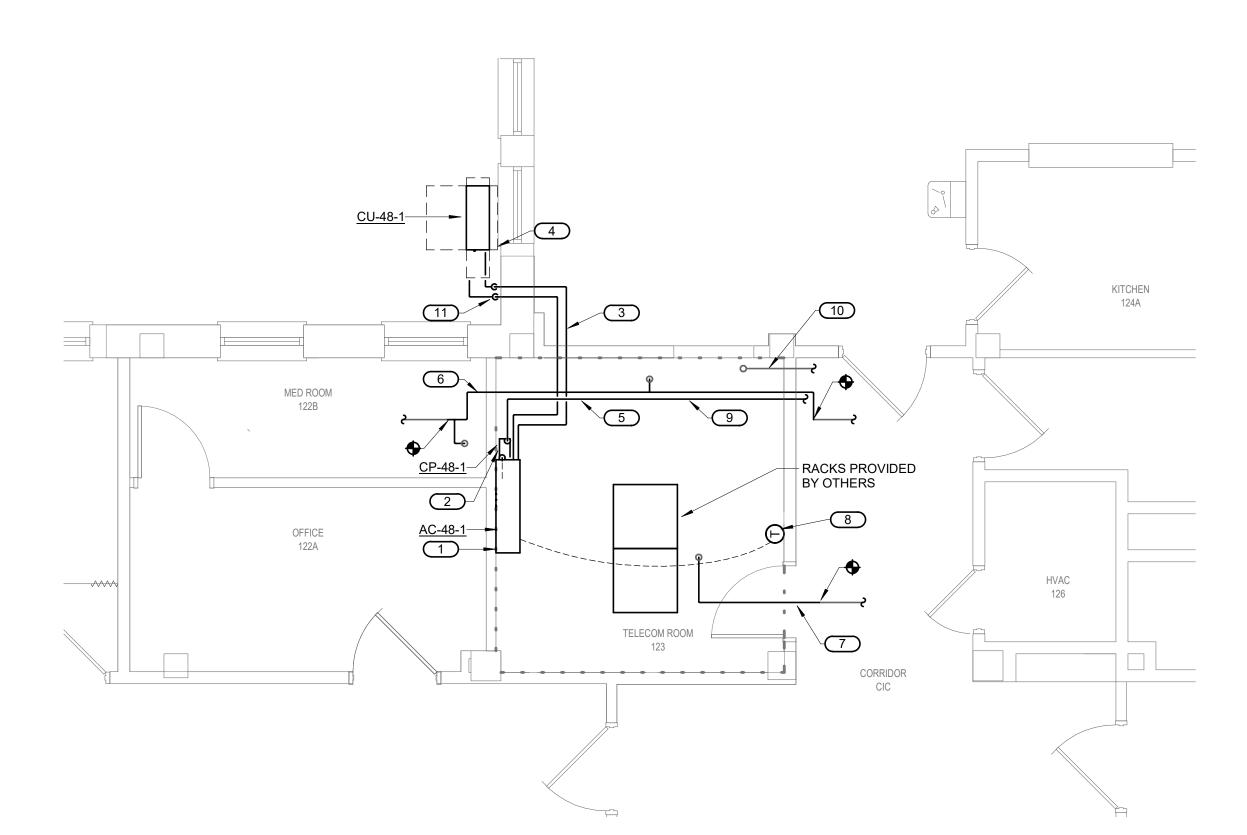


FIRST FLOOR PLAN - MECHANICAL - TELECOM 123

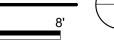

100% CD REVISION





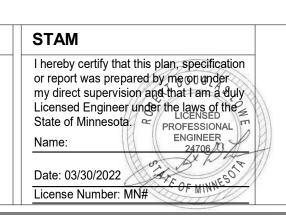



EHRM INFRASTRUCTURE **UPGRADES**

FULLY SPRINKLERED



RDL DJC

VA MEDICAL CENTER ST.CLOUD, MN 56303

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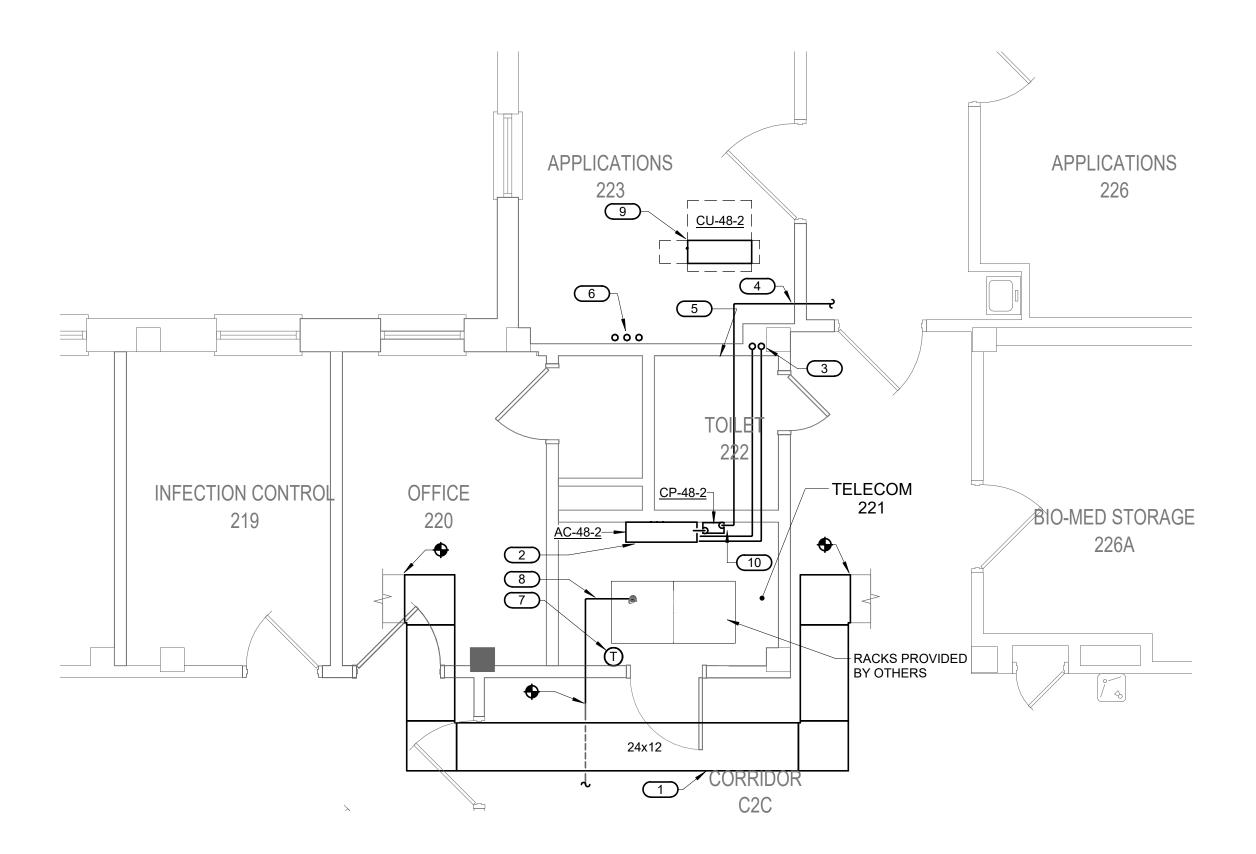
E. SIZE AND LOCATION OF ALL EXISTING PLUMBING AND HYDRONIC PIPING

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KEYNOTES 1/48-M202:


- 1. REROUTE EXISTING SUPPLY AIR DUCT.
- 2. PROVIDE NEW WALL-MOUNTED SPLIT SYSTEM AC UNIT.
- 3. ROUTE NEW REFRIGERANT PIPING UP TO ATTIC. LOCATE NEW AIR-COOLED CONDENSING UNIT IN ATTIC.
- 4. ROUTE 1" PUMPED CONDENSATE PIPE TO MOP SINK IN HAC 28, APPROXIMATELY
- 50 FEET EAST.5. PROVIDE CONDENSATE PUMP.
- REROUTE AND RECONNECT EXISTING PLUMBING PIPING TO ROUTE IN NEW CHASE. FIELD VERIFY EXACT REQUIREMENTS.
- 7. PROVIDE NEW THERMOSTAT.
- 8. PROVIDE NEW FIRE SPRINKLER HEAD AND BRANCH LINE. CONNECT TO
- 9. PROVIDE NEW AIR COOLED CONDENSING UNIT CU-48-2 IN ATTIC ABOVE. FIELD VERIFY LOCATION AND REQUIREMENTS.
- 10. PAN CONDENSATE PUMP AND PIPING ASEMBLY WITHIN TELECOM ROOM 221.




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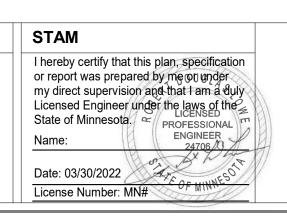
SECOND FLOOR PLAN - MECHANICAL - TELECOM 221





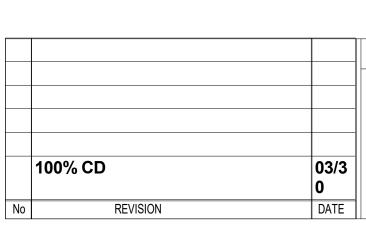



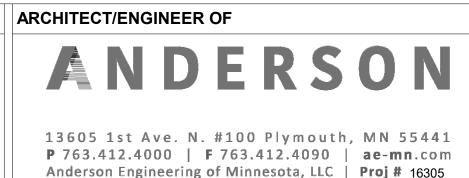



PROJECT TITLE

EHRM
INFRASTRUCTURE
UPGRADES

DATE:
03/30
PLOT SCALE

PROJECT NO.
656-2

RDL DJC

VA MEDICAL CENTER ST.CLOUD, MN 56303 FULLY SPRINKLERED 0/2022 E 21-235 0. 1202

