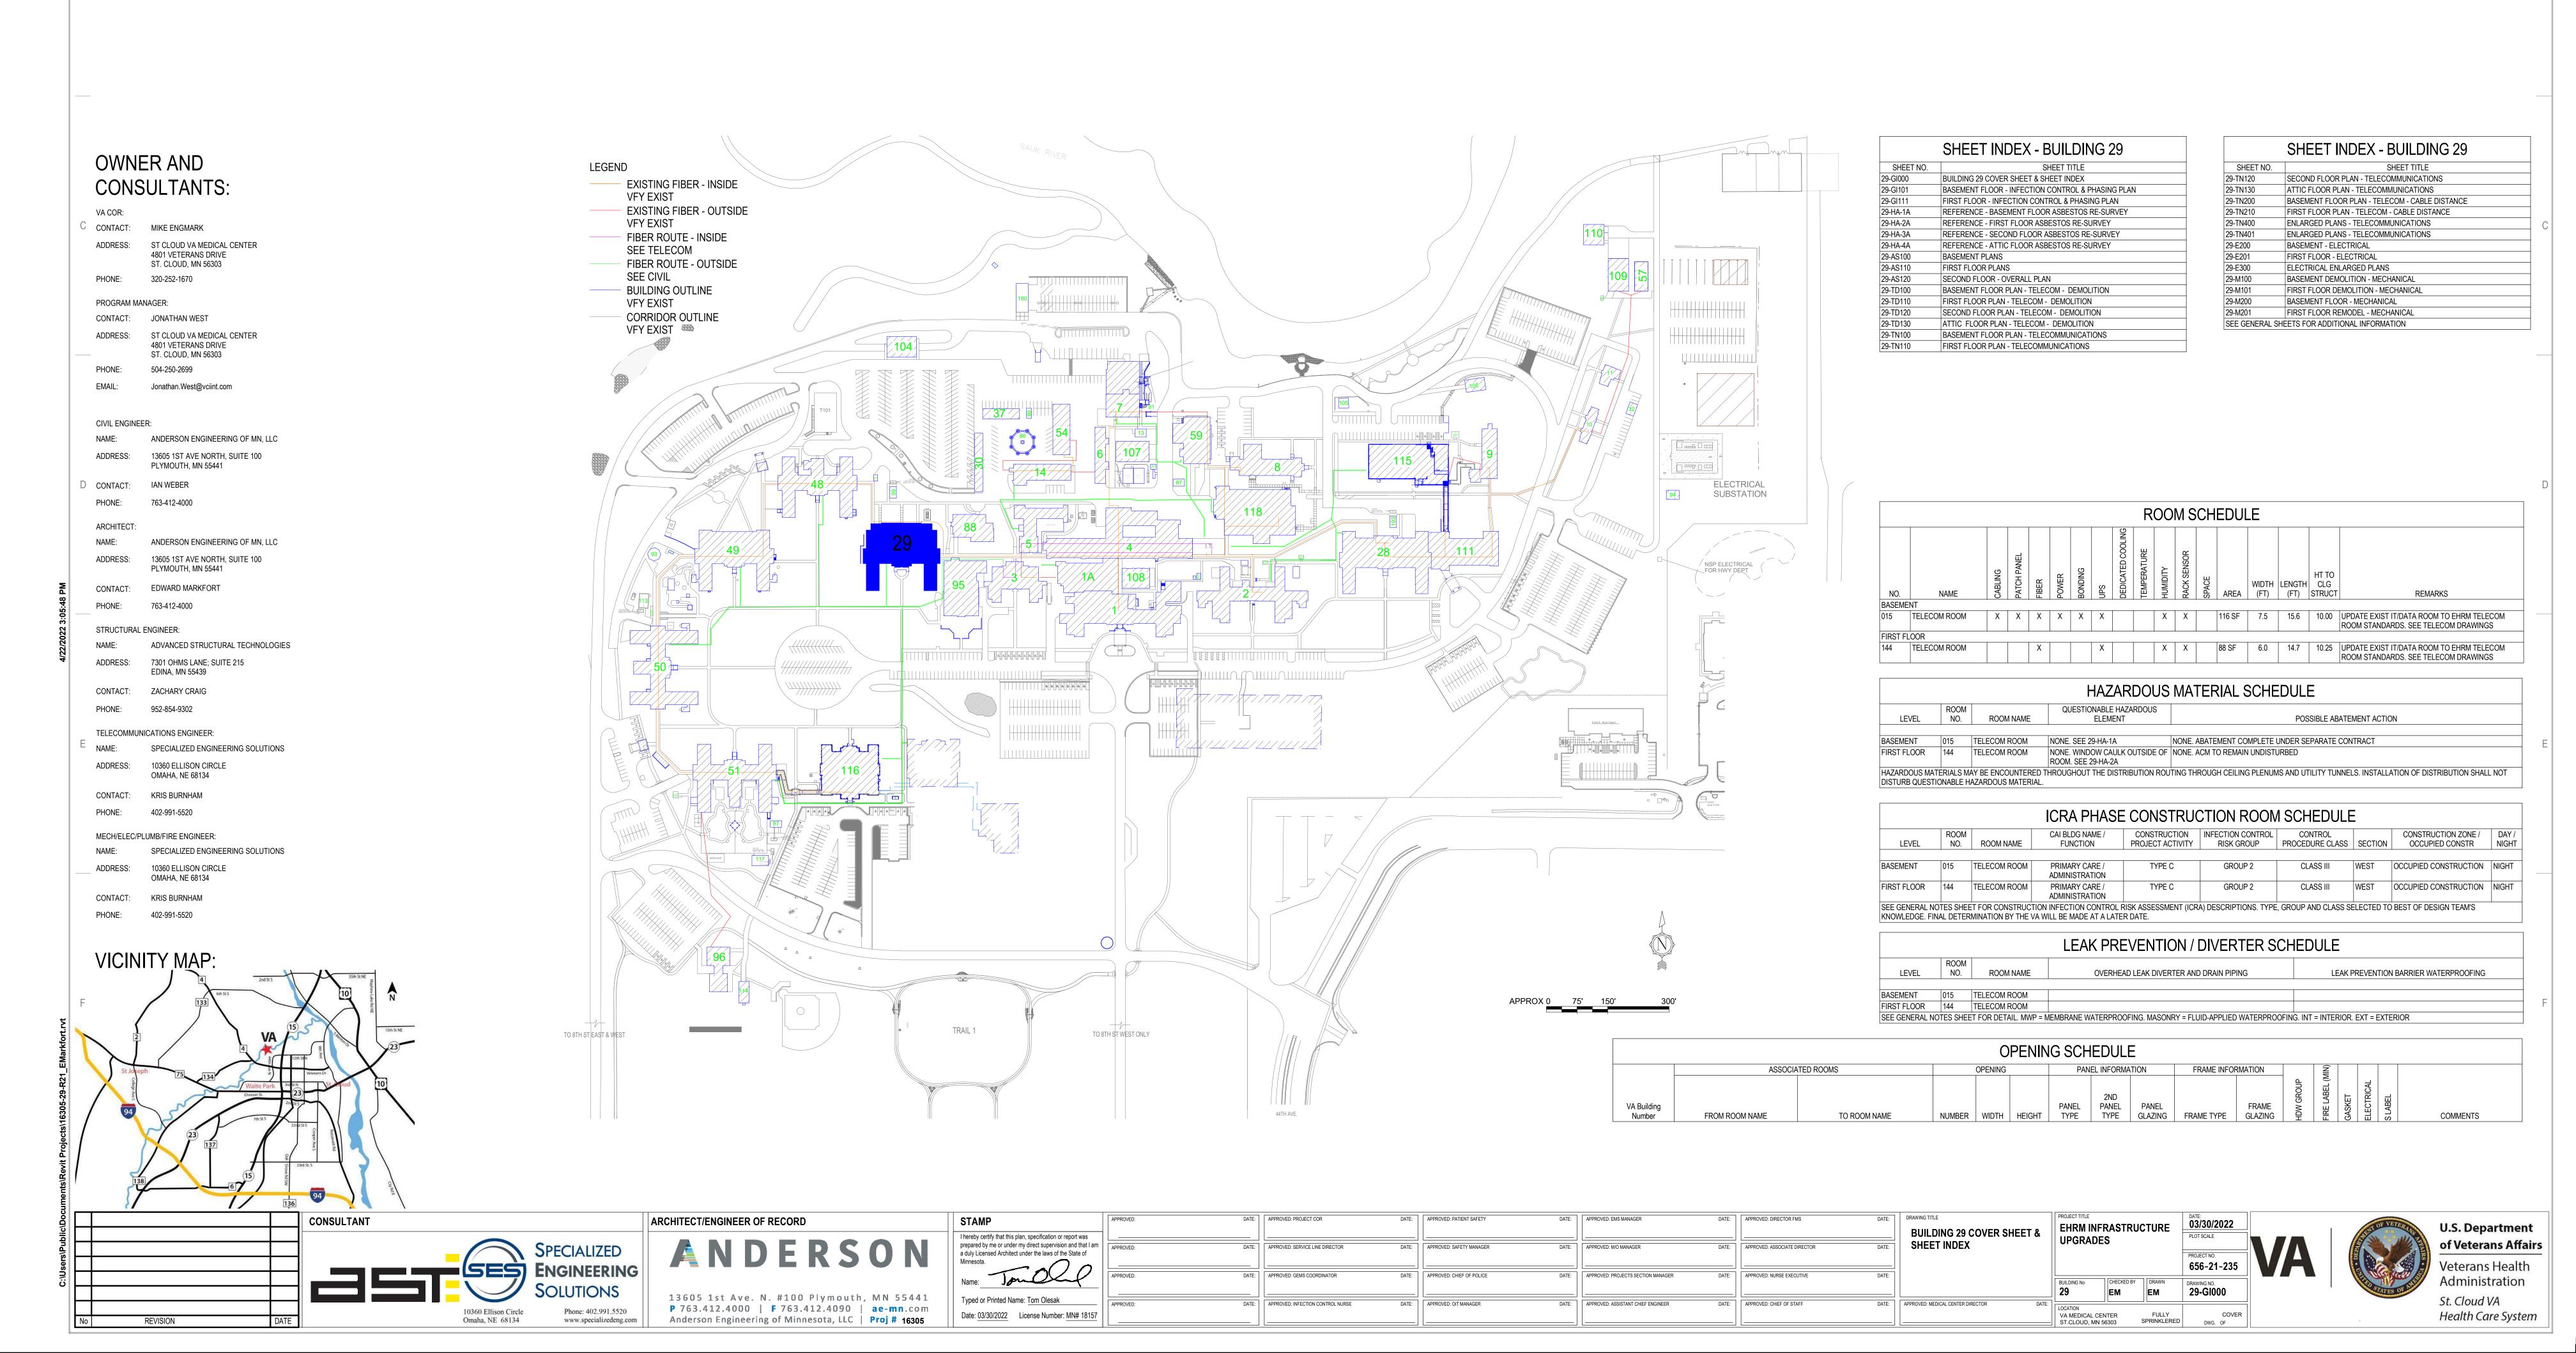
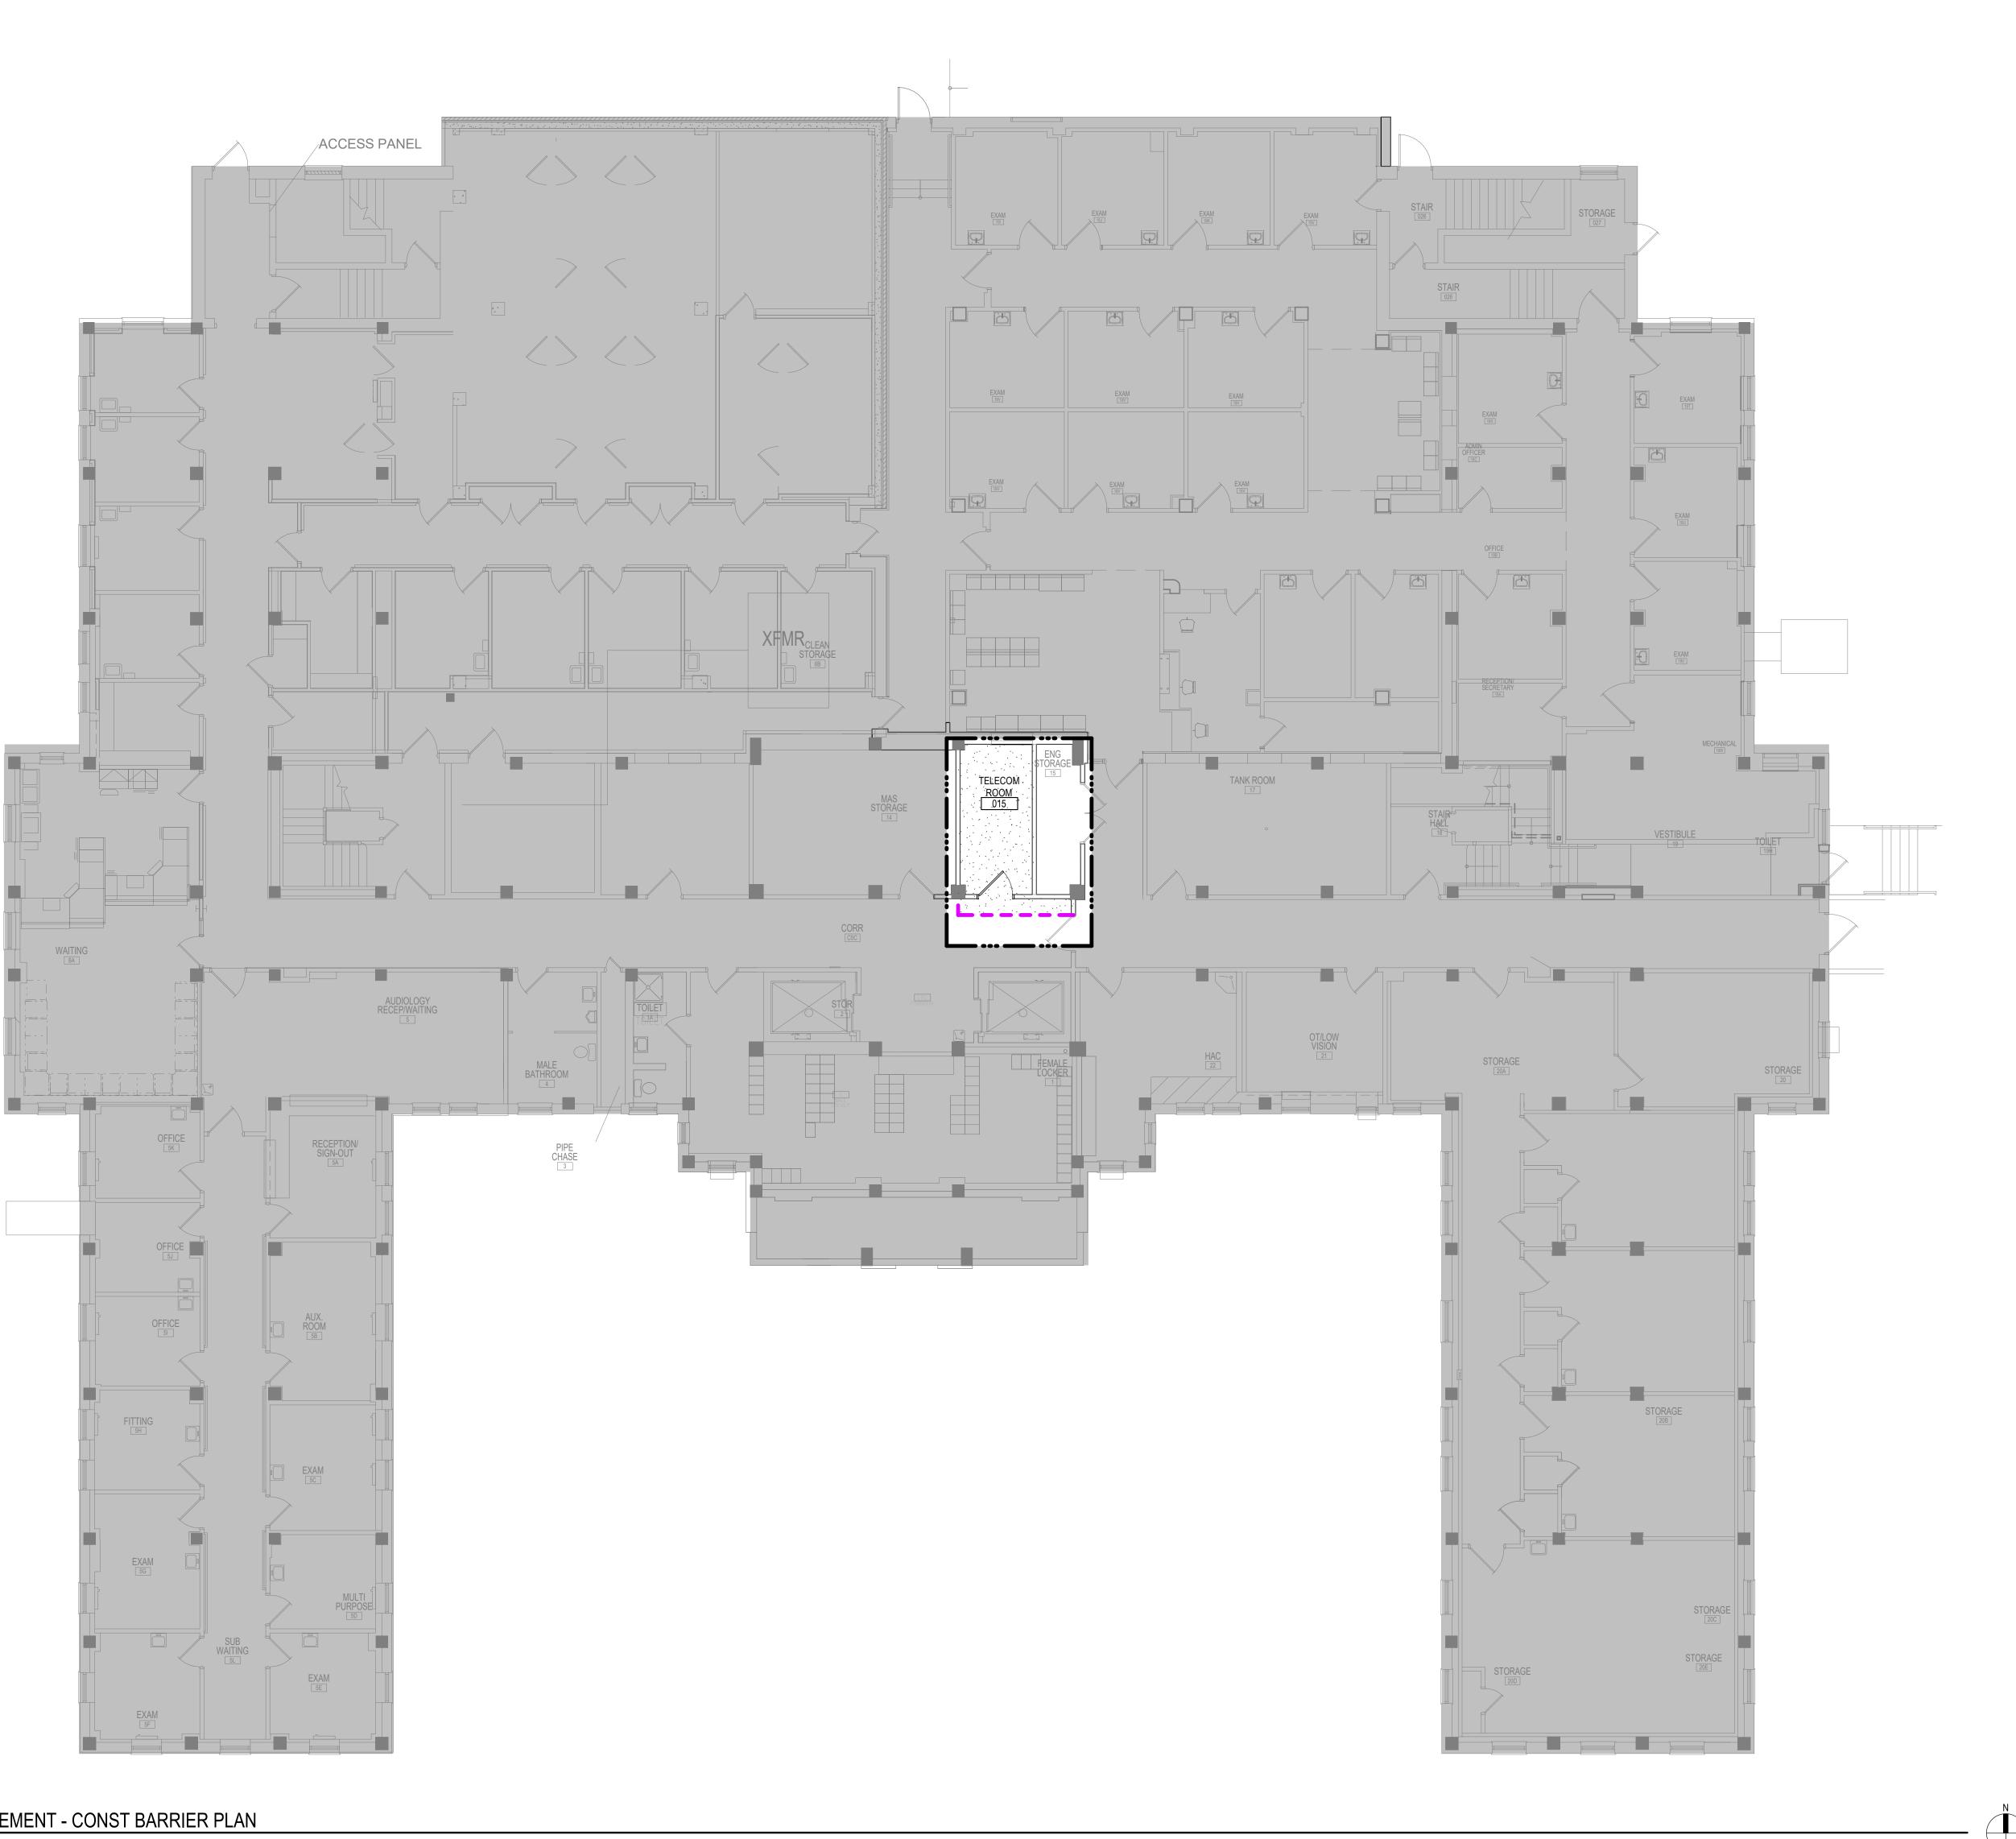
BUILDING 29 - EHRM INFRASTRUCTURE UPGRADES

St. Cloud VA Health Care System Main Campus, St. Cloud, Minnesota





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ROOM ICRA SCHEDULE CAI BLDG NAME / FUNCTION CONSTRUCTION PROJECT ACTIVITY INFECTION CONTROL RISK GROUP CONTROL PROCEDURE CLASS BASEMENT 015 TELECOM ROOM PRIMARY CARE / ADMINISTRATION FIRST FLOOR 144 TELECOM ROOM PRIMARY CARE / ADMINISTRATION CLASS III CLASS III SEE GENERAL NOTES SHEET FOR CONSTRUCTION INFECTION CONTROL RISK ASSESSMENT (ICRA) DESCRIPTIONS. TYPE, GROUP AND CLASS SELECTED TO BEST OF DESIGN TEAM'S KNOWLEDGE. FINAL DETERMINATION BY THE VA WILL BE MADE AT A LATER DATE.

INFECTION CONTROL RISK ASSESSMENT (ICRA) LEGEND LIMITS OF CONSTRUCTION 1 HOUR FIRE RATED ICRA / CONSTRUCTION BARRIER LOCATION, AND DOOR, WHERE SHOWN TEMPORARY NON-RATED (PLASTIC SHEETING) CONSTRUCTION BARRIER LOCATION, WHERE APPROVED BY THE VA FOR USE IN RISK TYPE B. UPGRADE TO 1 HOUR RATED PARTITION WHEN DIRECTED BY THE VA

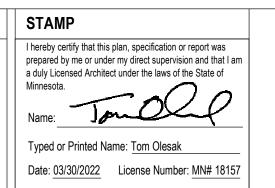
↑ BASEMENT - CONST BARRIER PLAN

REVISION



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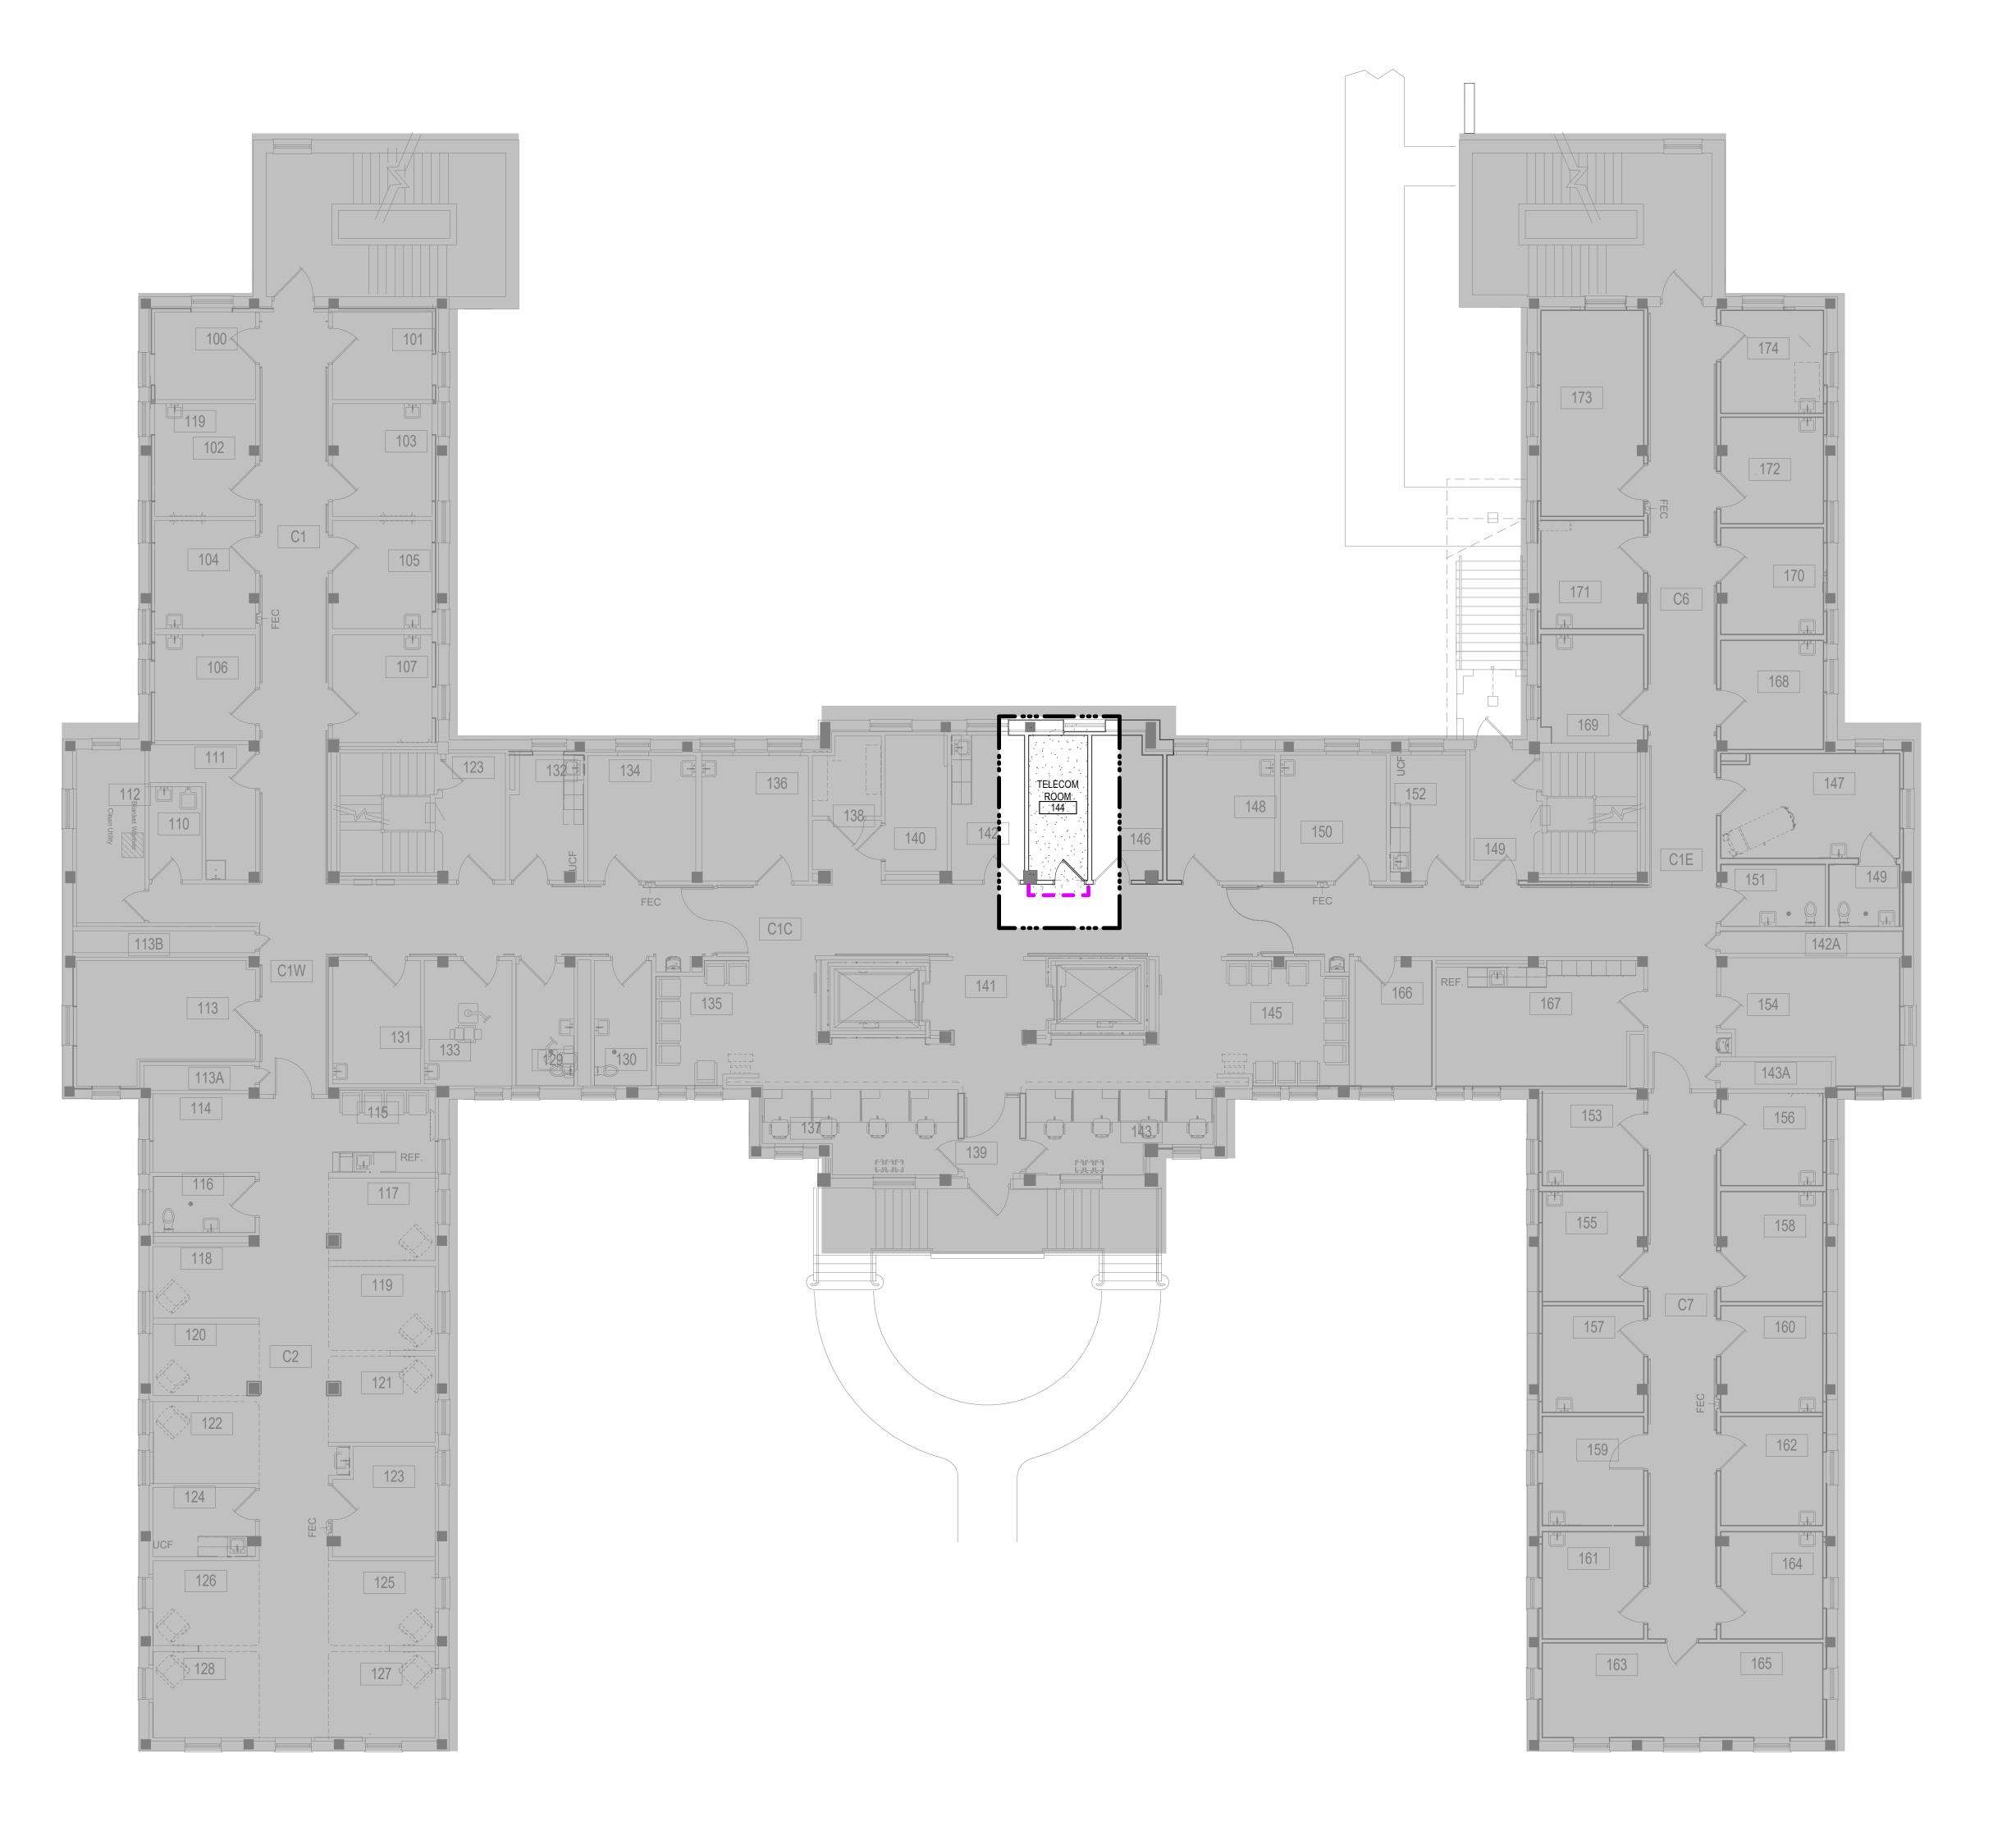


BASEMENT FLOOR -INFECTION CONTROL & PHASING PLAN

EHRM INFRASTRUCTURE

VA MEDICAL CENTER ST.CLOUD, MN 56303





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ROOM ICRA SCHEDULE CAI BLDG NAME / FUNCTION CONSTRUCTION PROJECT ACTIVITY INFECTION CONTROL RISK GROUP CONTROL PROCEDURE CLASS BASEMENT 015 TELECOM ROOM PRIMARY CARE / ADMINISTRATION TYPE C GROUP 2 CLASS III
FIRST FLOOR 144 TELECOM ROOM PRIMARY CARE / ADMINISTRATION TYPE C GROUP 2 CLASS III
SEE GENERAL NOTES SHEET FOR CONSTRUCTION INFECTION CONTROL RISK ASSESSMENT (ICRA) DESCRIPTIONS. TYPE, GROUP AND CLASS SELECTED TO BEST OF DESIGN TEAM'S KNOWLEDGE. FINAL DETERMINATION BY THE VA WILL BE MADE AT A LATER DATE. CLASS III CLASS III

INFECTION CONTROL RISK ASSESSMENT (ICRA) LEGEND

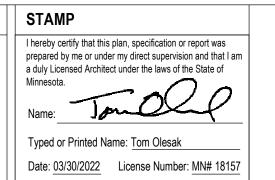
	LIMITS OF CONSTRUCTION
	1 HOUR FIRE RATED ICRA / CONSTRUCTION BARRIER LOCATION, AND DOOR, WHERE SHOWN
	TEMPORARY NON-RATED (PLASTIC SHEETING) CONSTRUCTION BARRIER LOCATION, WHERE APPROVED BY THE VA FOR USE IN RISK TYPE B. UPGRADE TO 1 HOUR RATED PARTITION WHEN DIRECTED BY THE VA

Y FIRST FLOOR - CONST BARRIER PLAN

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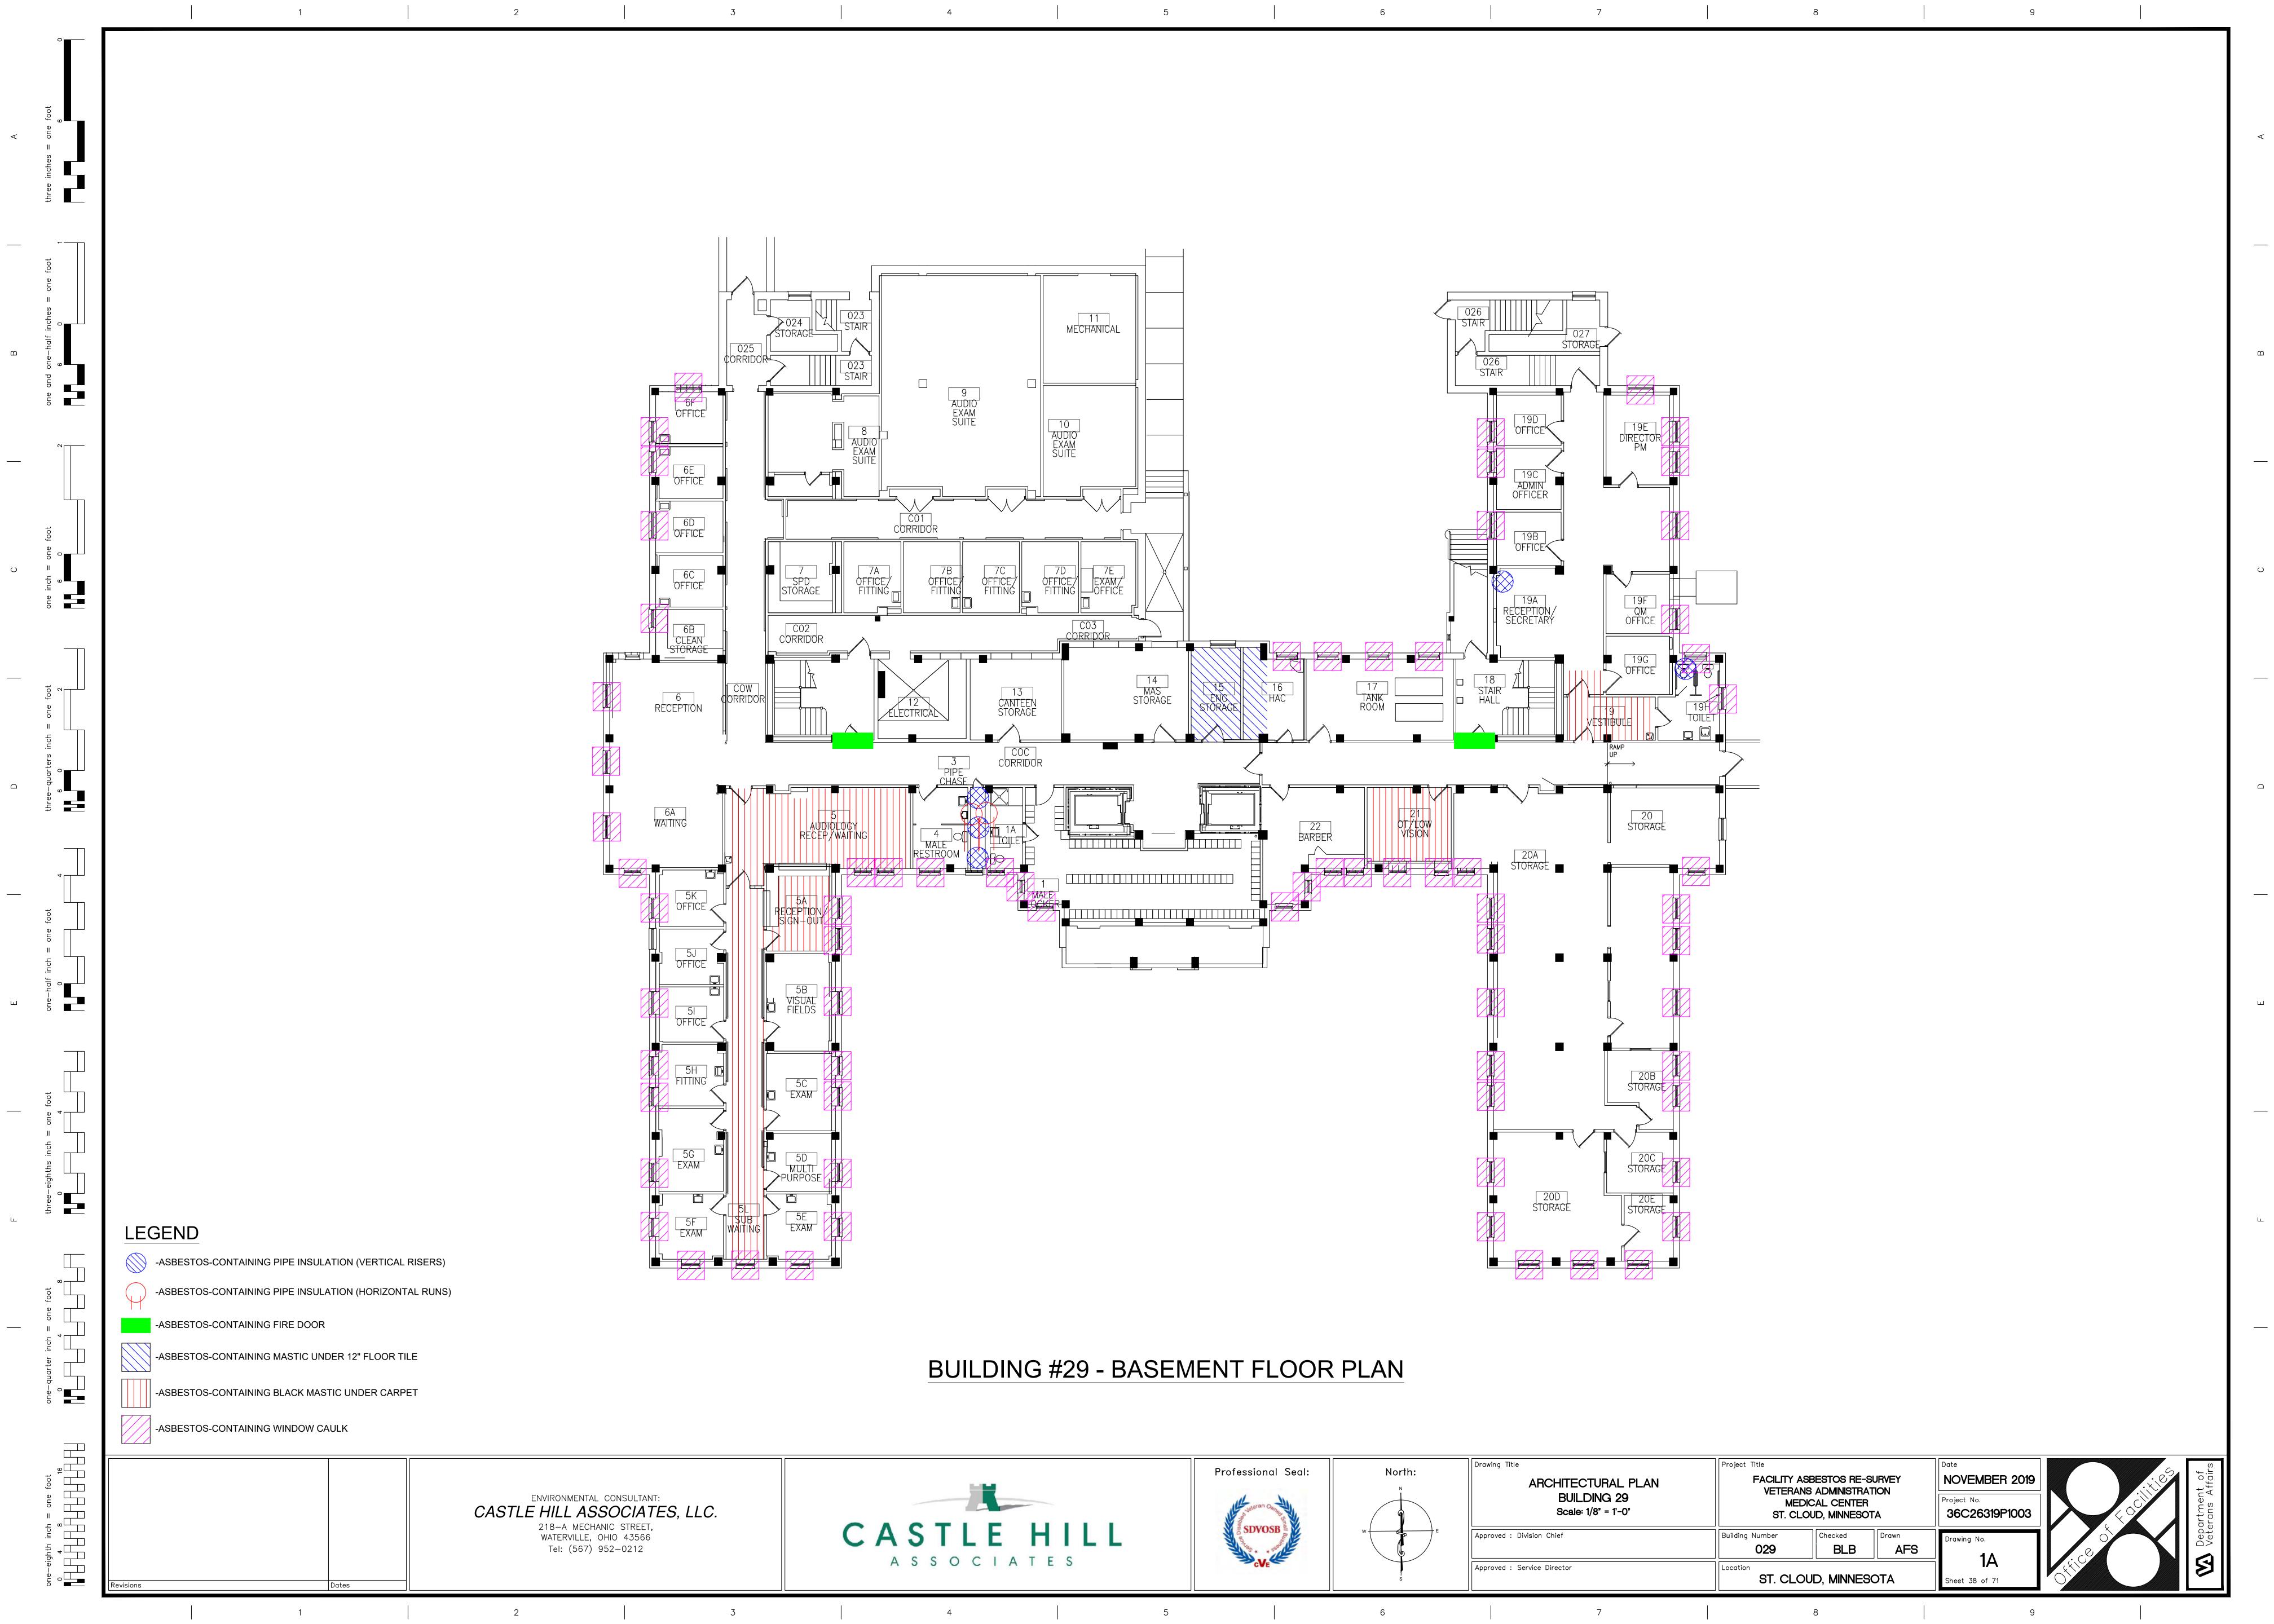


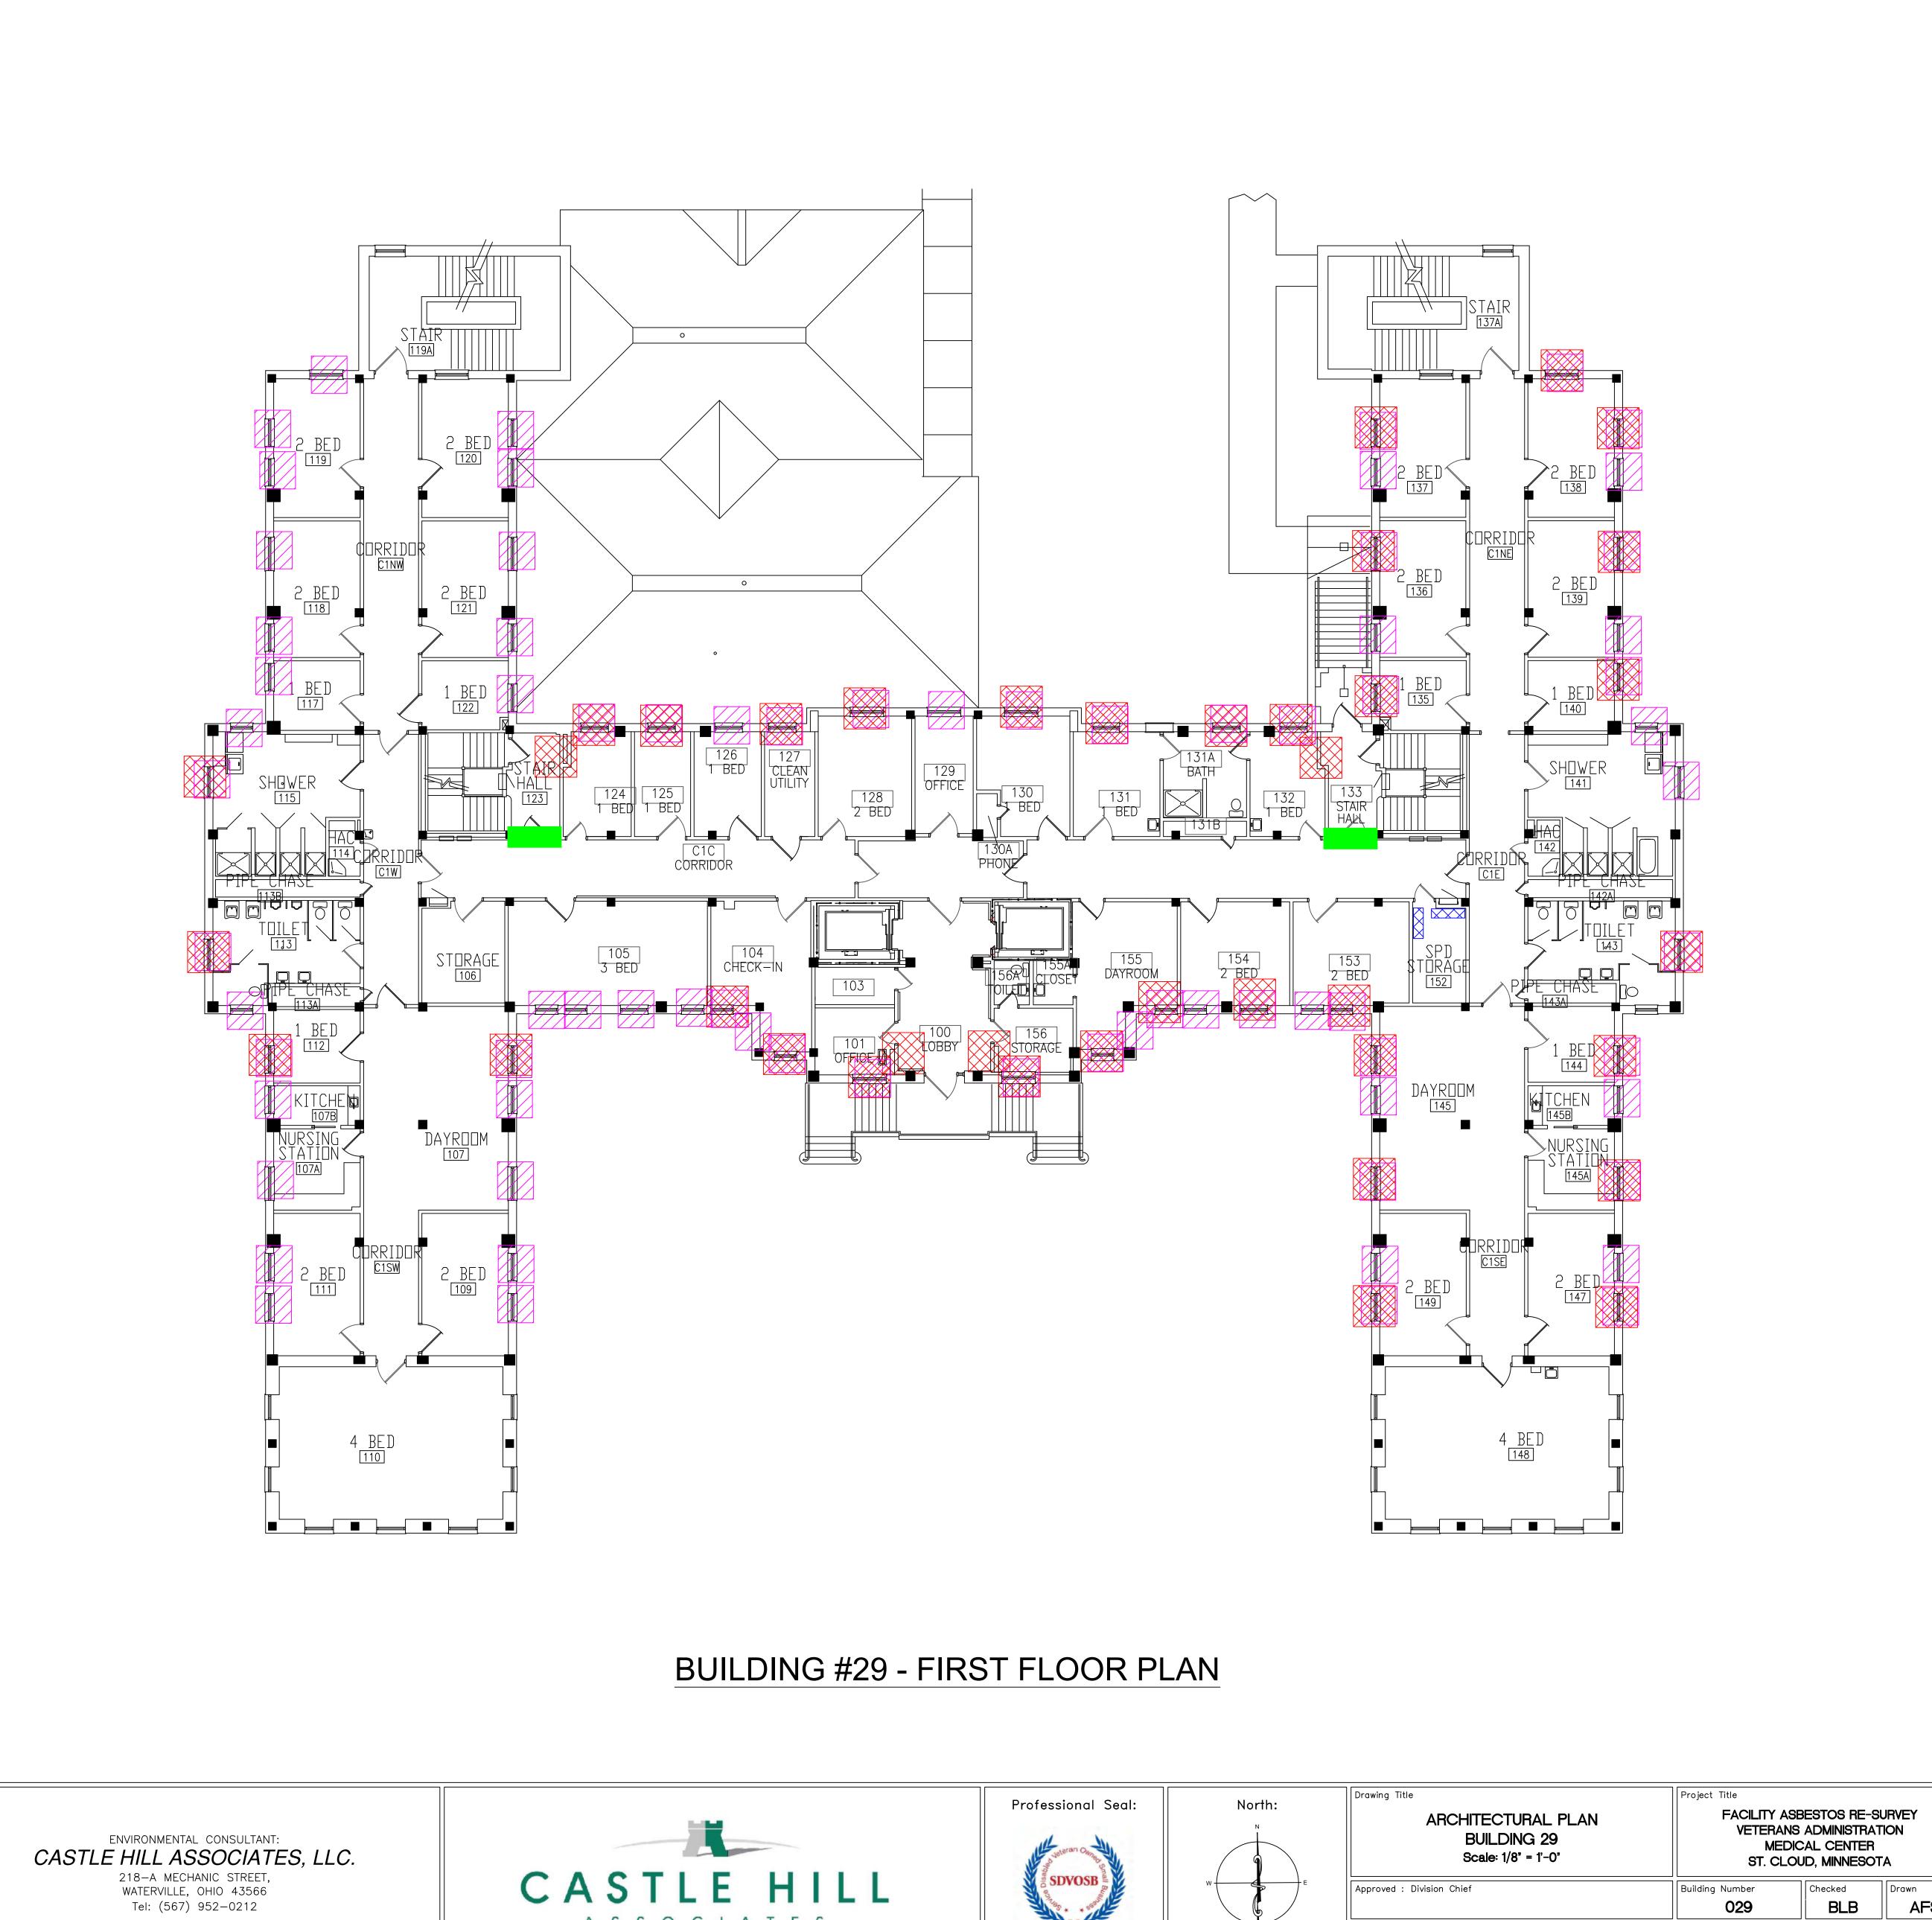


EHRM INFRASTRUCTURE

VA MEDICAL CENTER ST.CLOUD, MN 56303







ASSOCIATES

NOVEMBER 2019

36C26319P1003

Project No.

BLB

ST. CLOUD, MINNESOTA

AFS

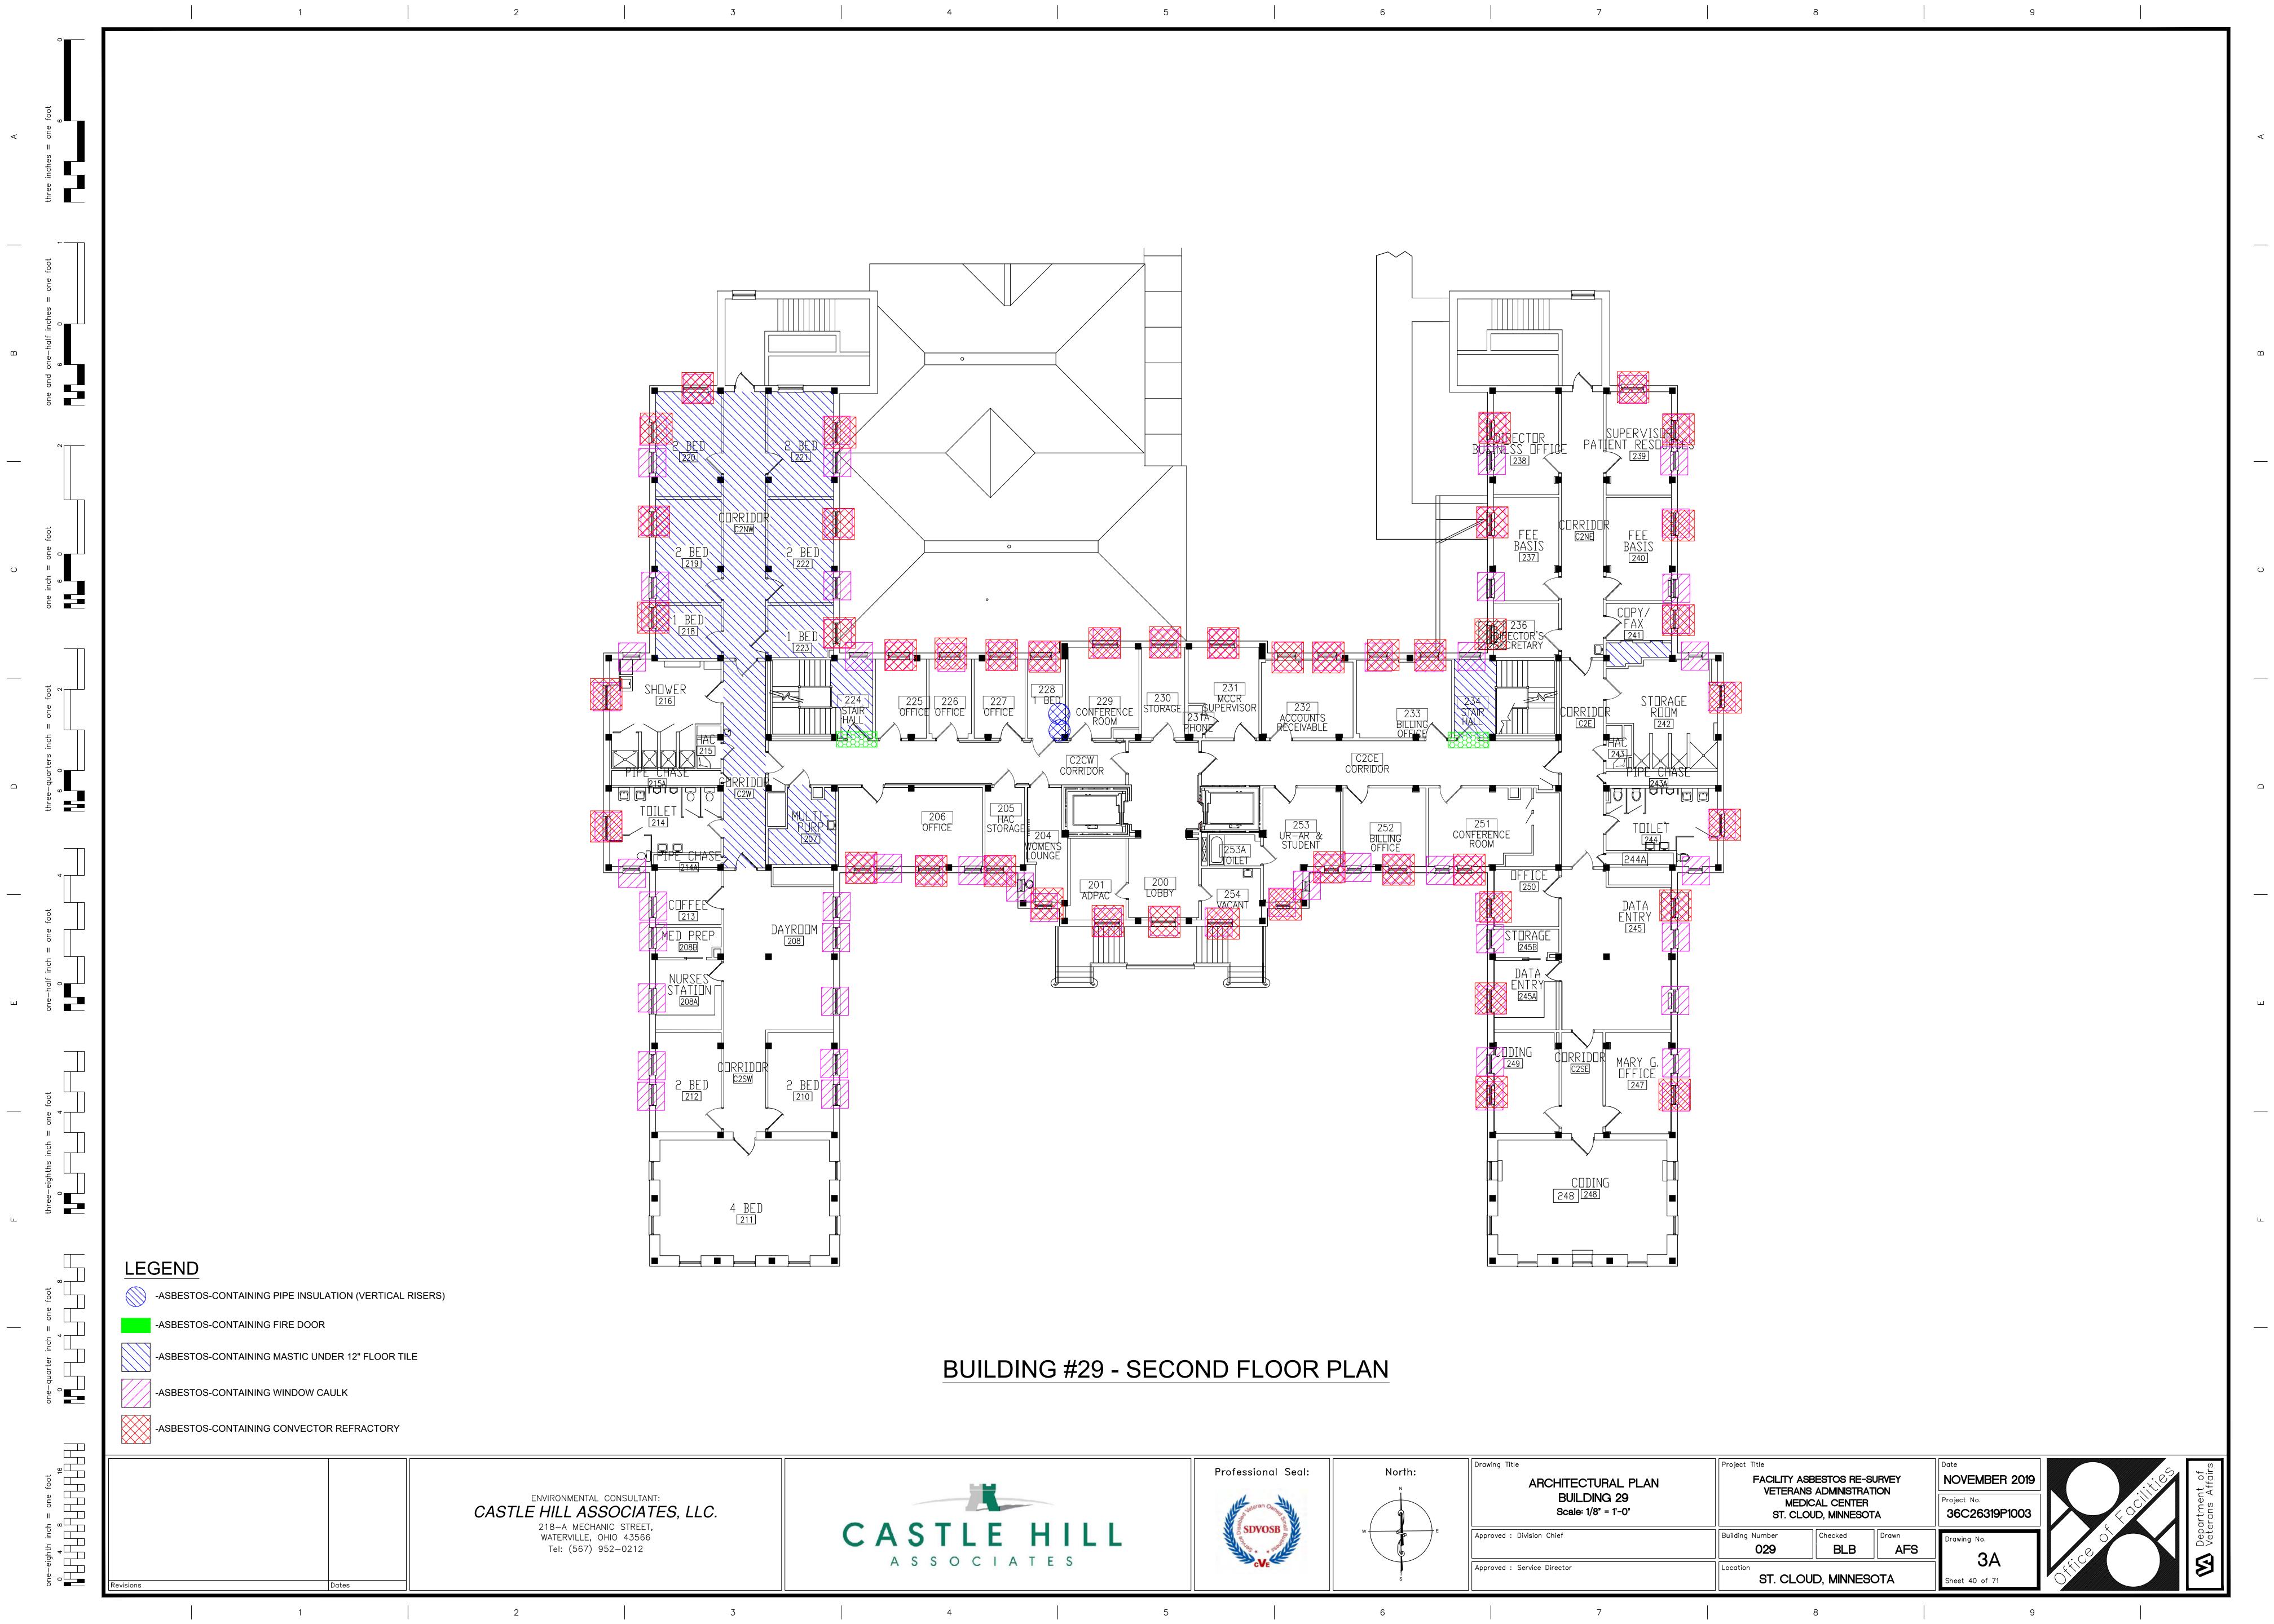
Approved : Division Chief

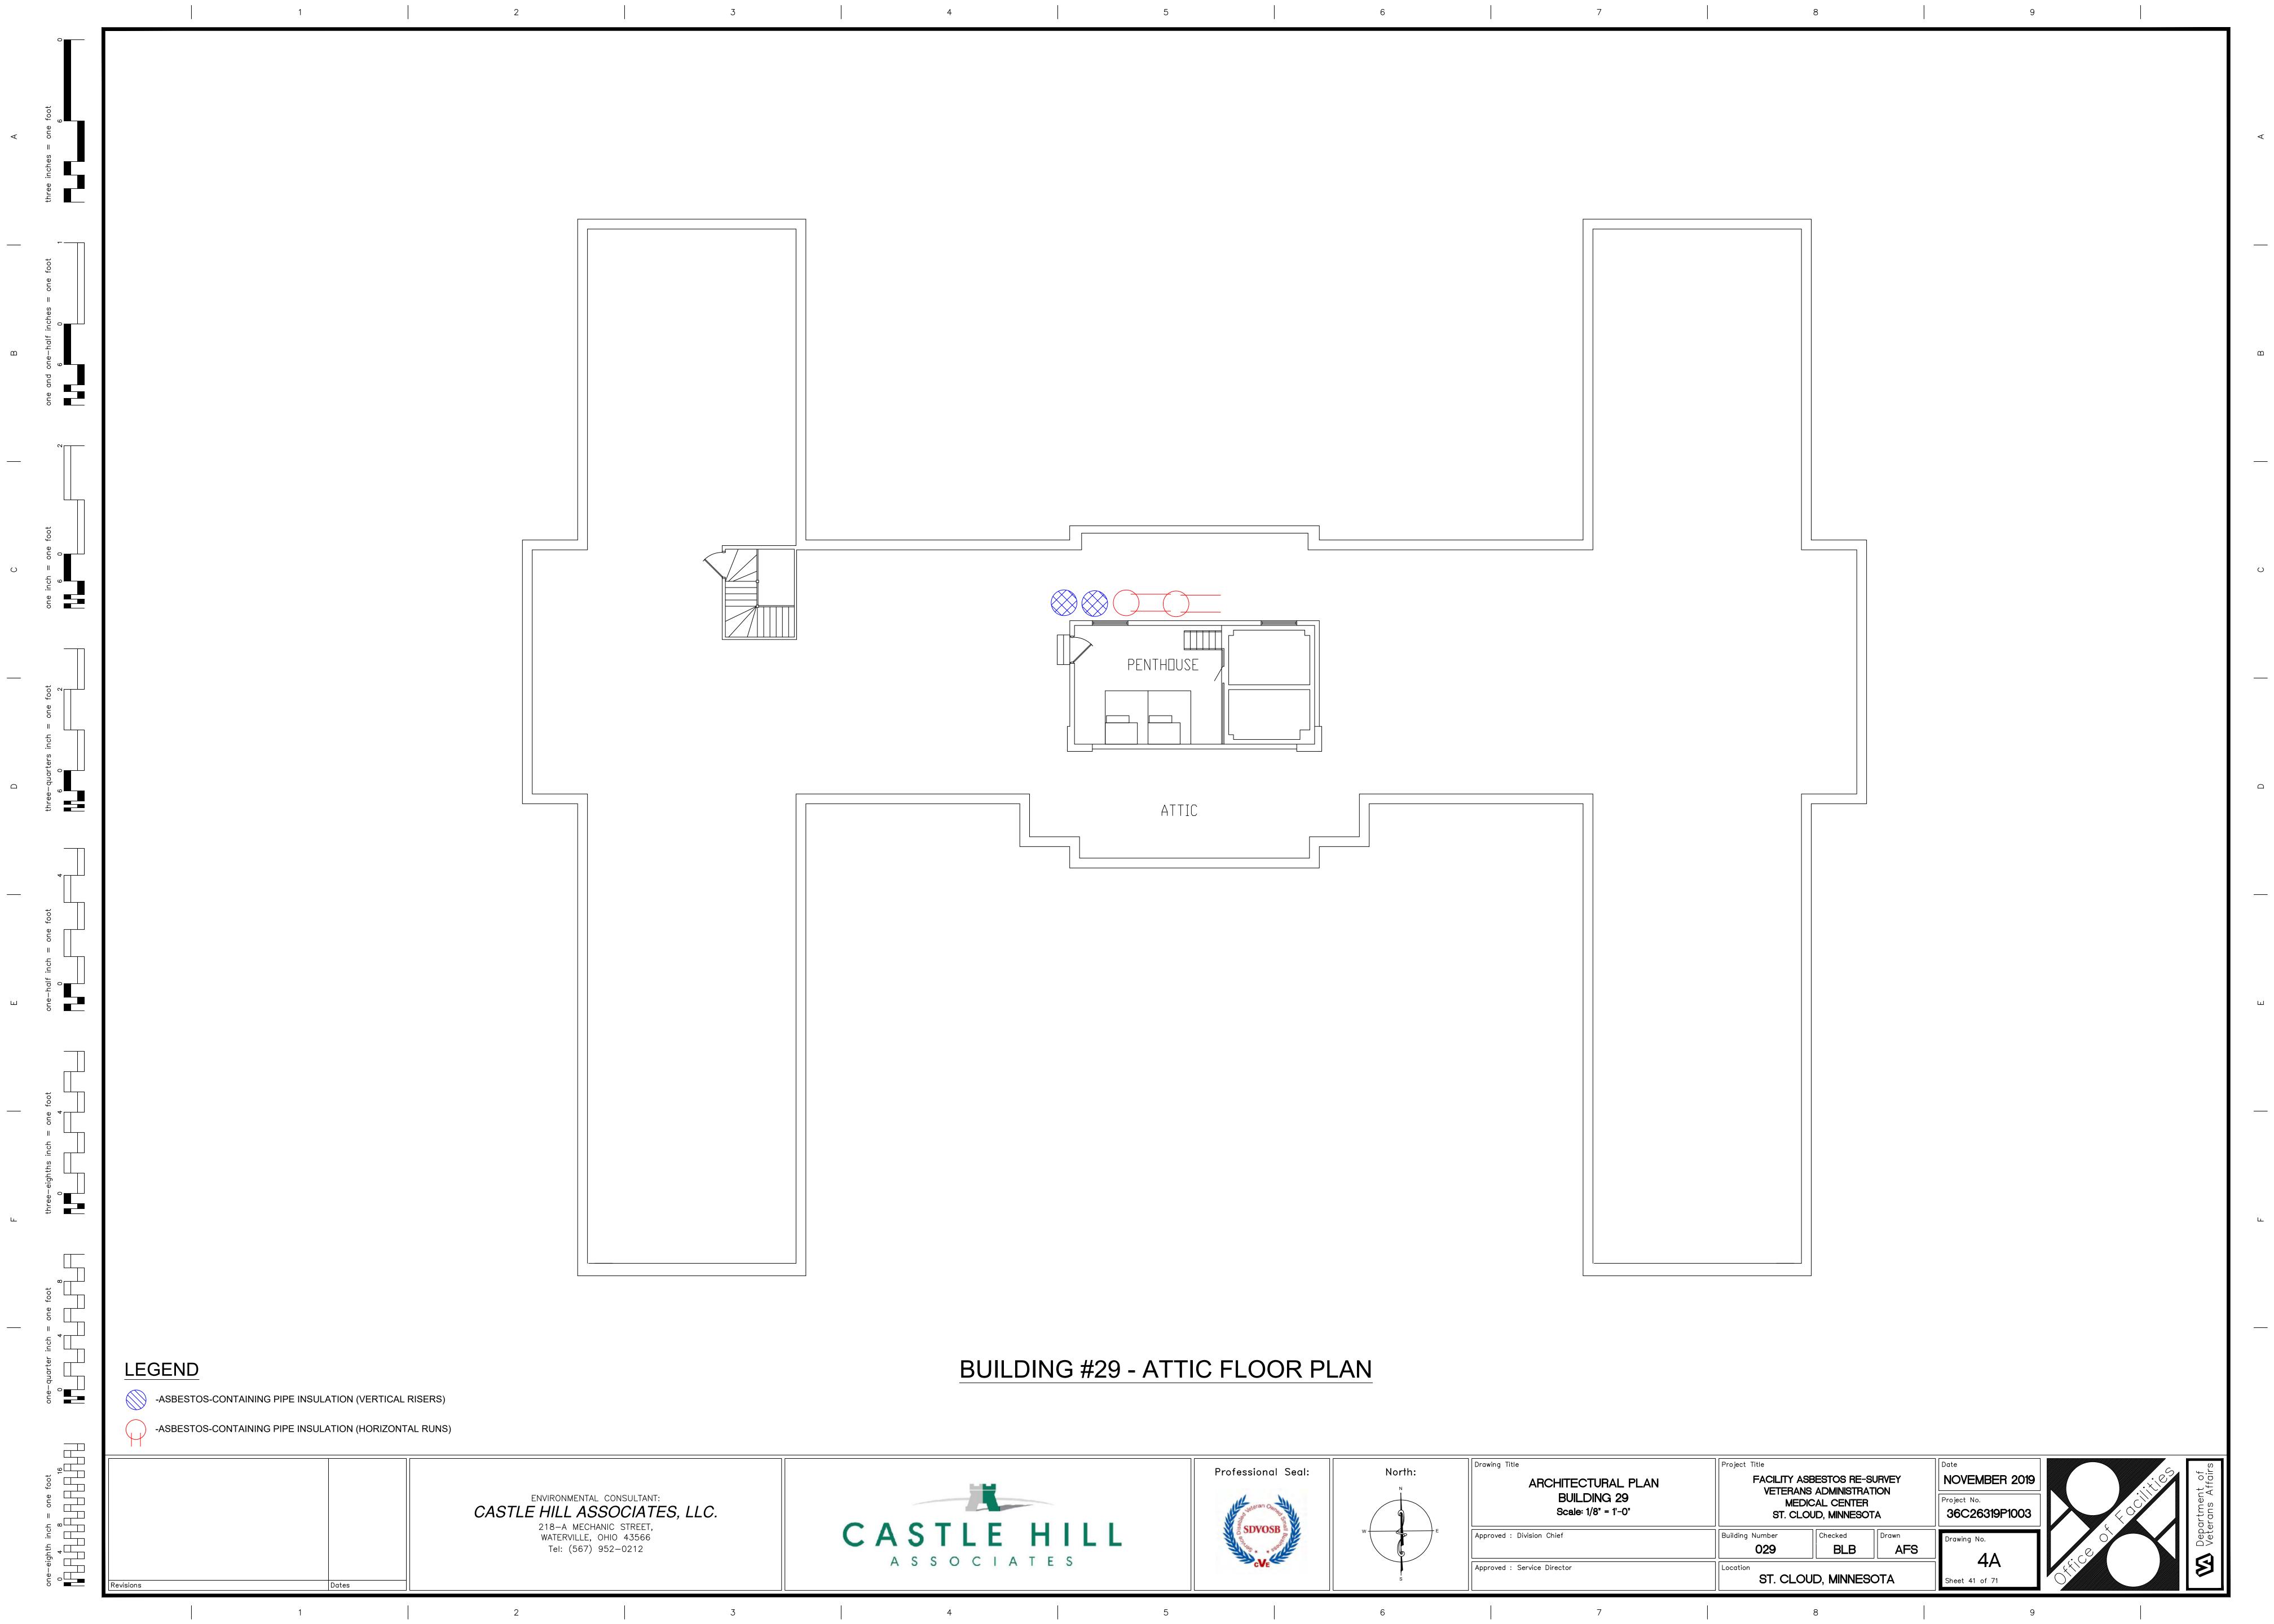
Approved : Service Director

-ASBESTOS-CONTAINING BASE COVE ADHESIVE

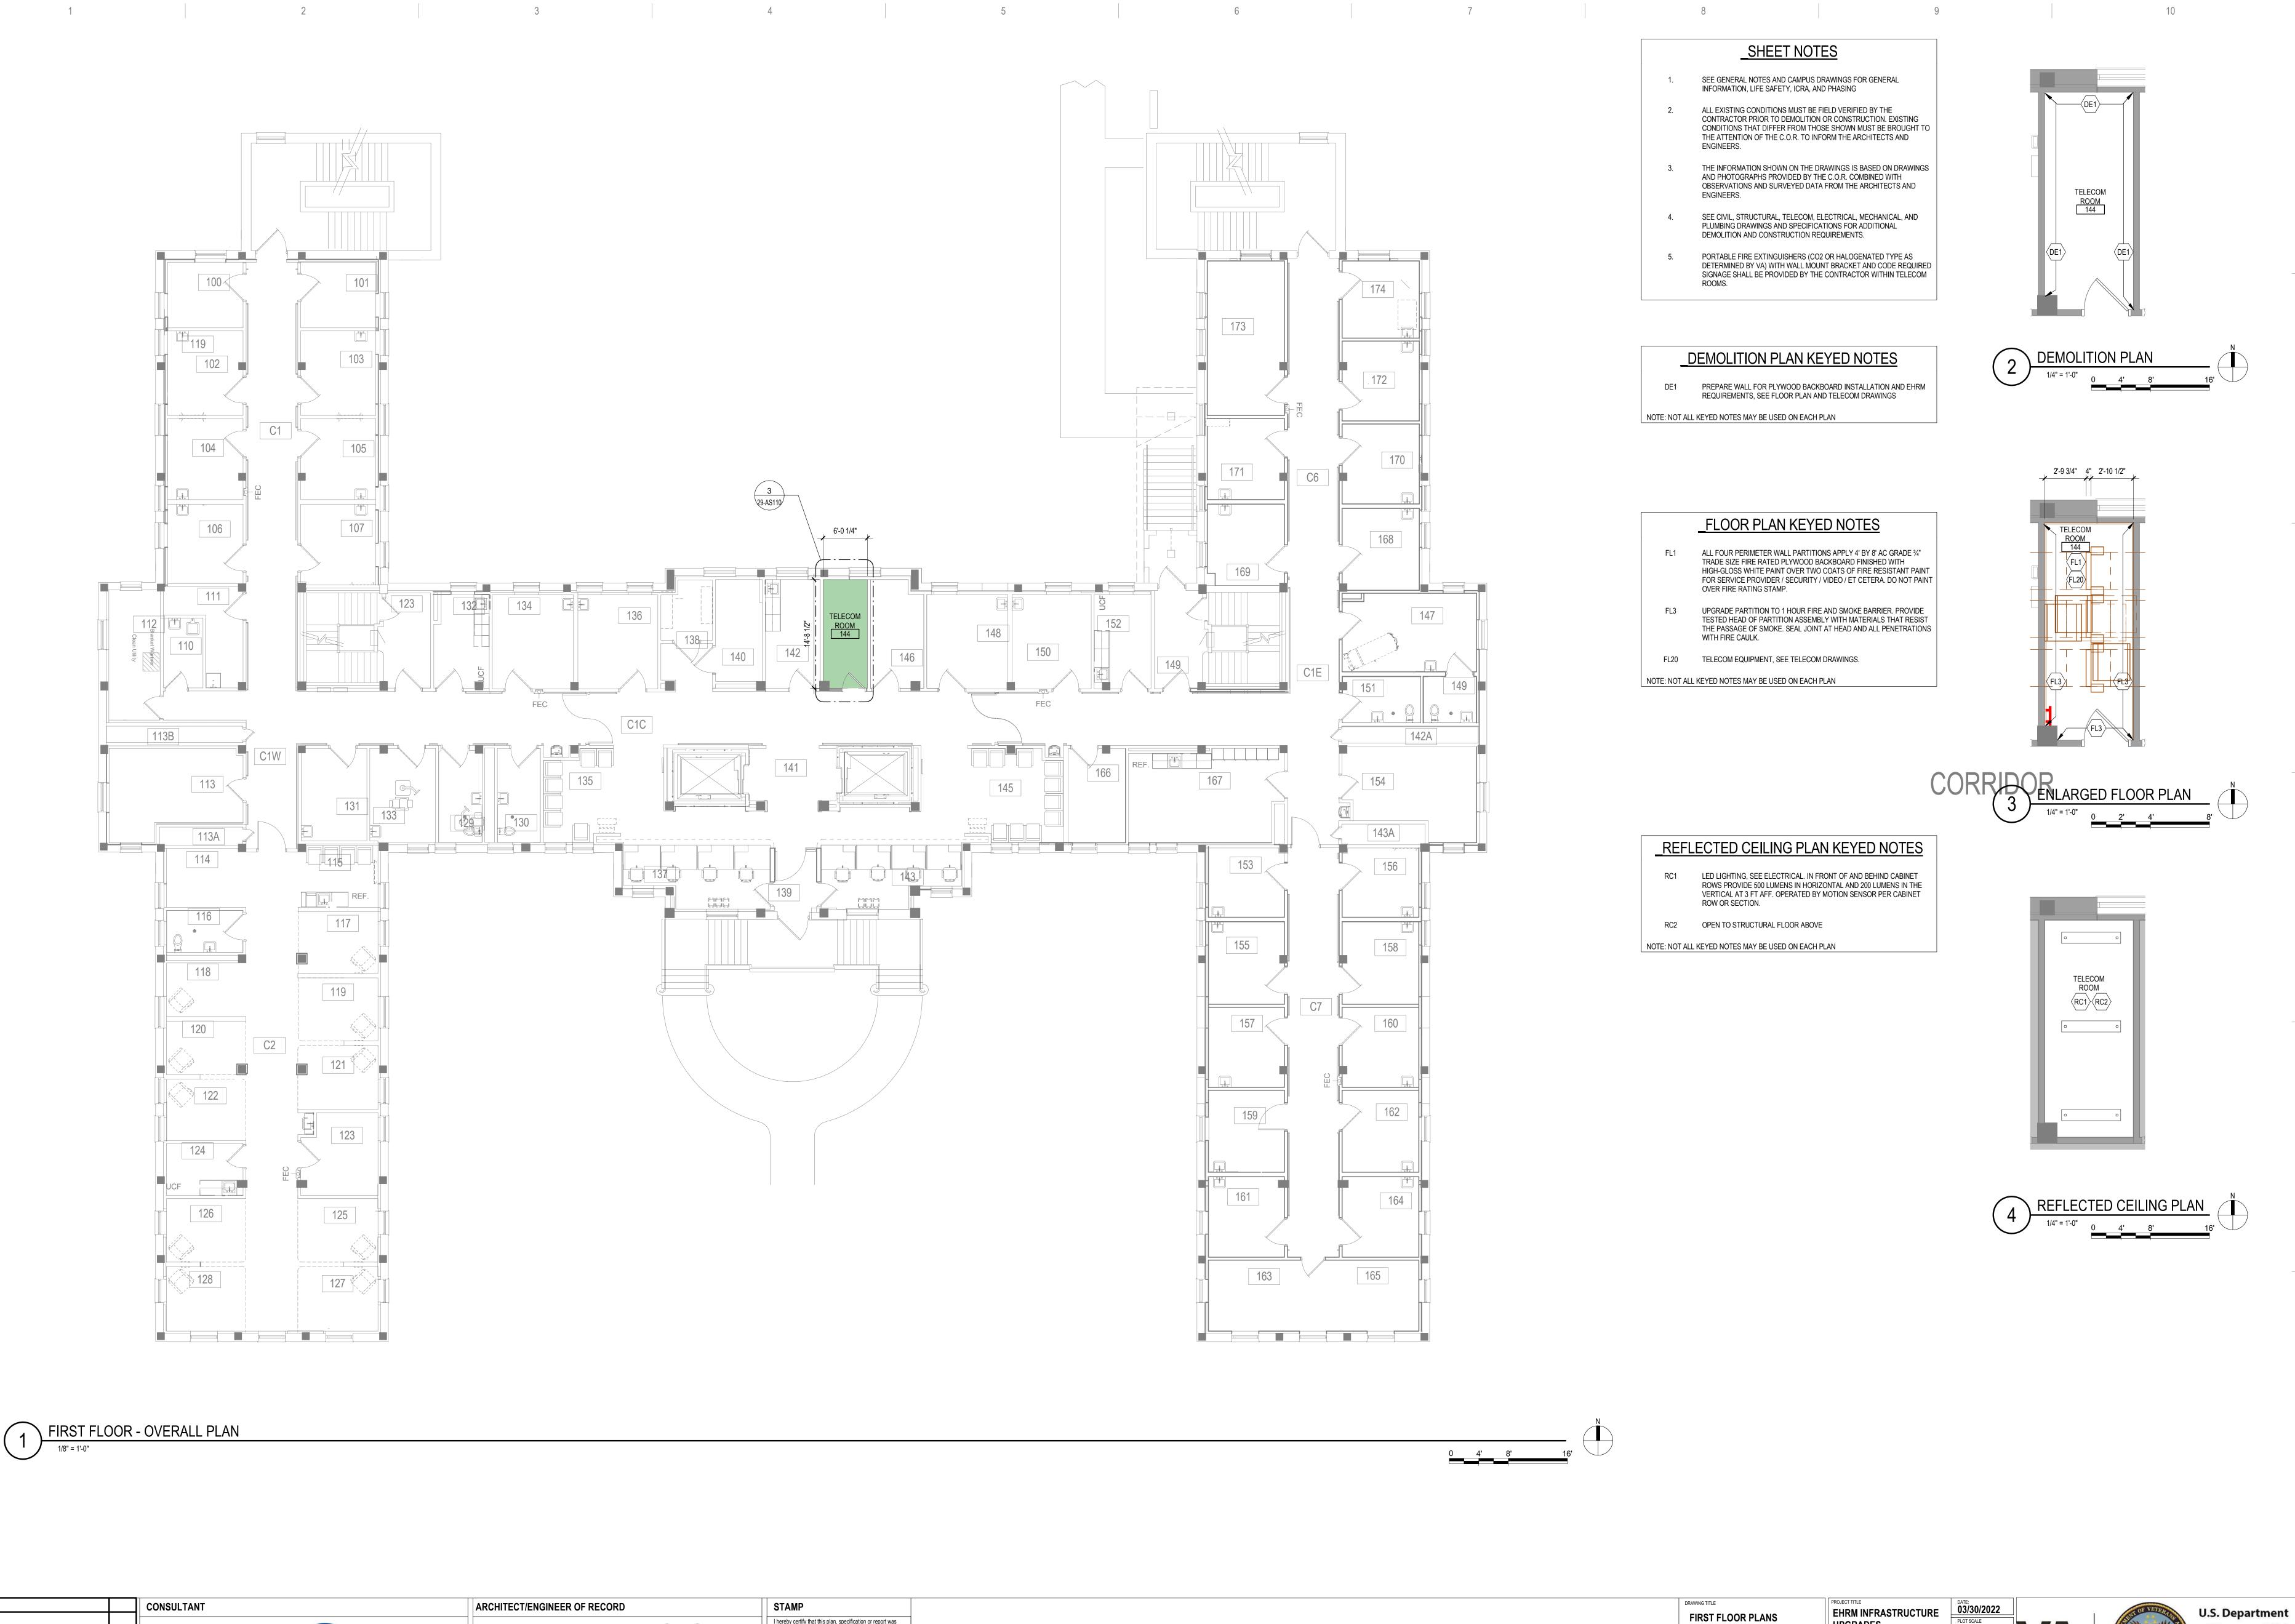
-ASBESTOS-CONTAINING CONVECTOR REFRACTORY

-ASBESTOS-CONTAINING WINDOW CAULK









I hereby certify that this plan, specification or report was

Typed or Printed Name: Tom Olesak

prepared by me or under my direct supervision and that I am a duly Licensed Architect under the laws of the State of

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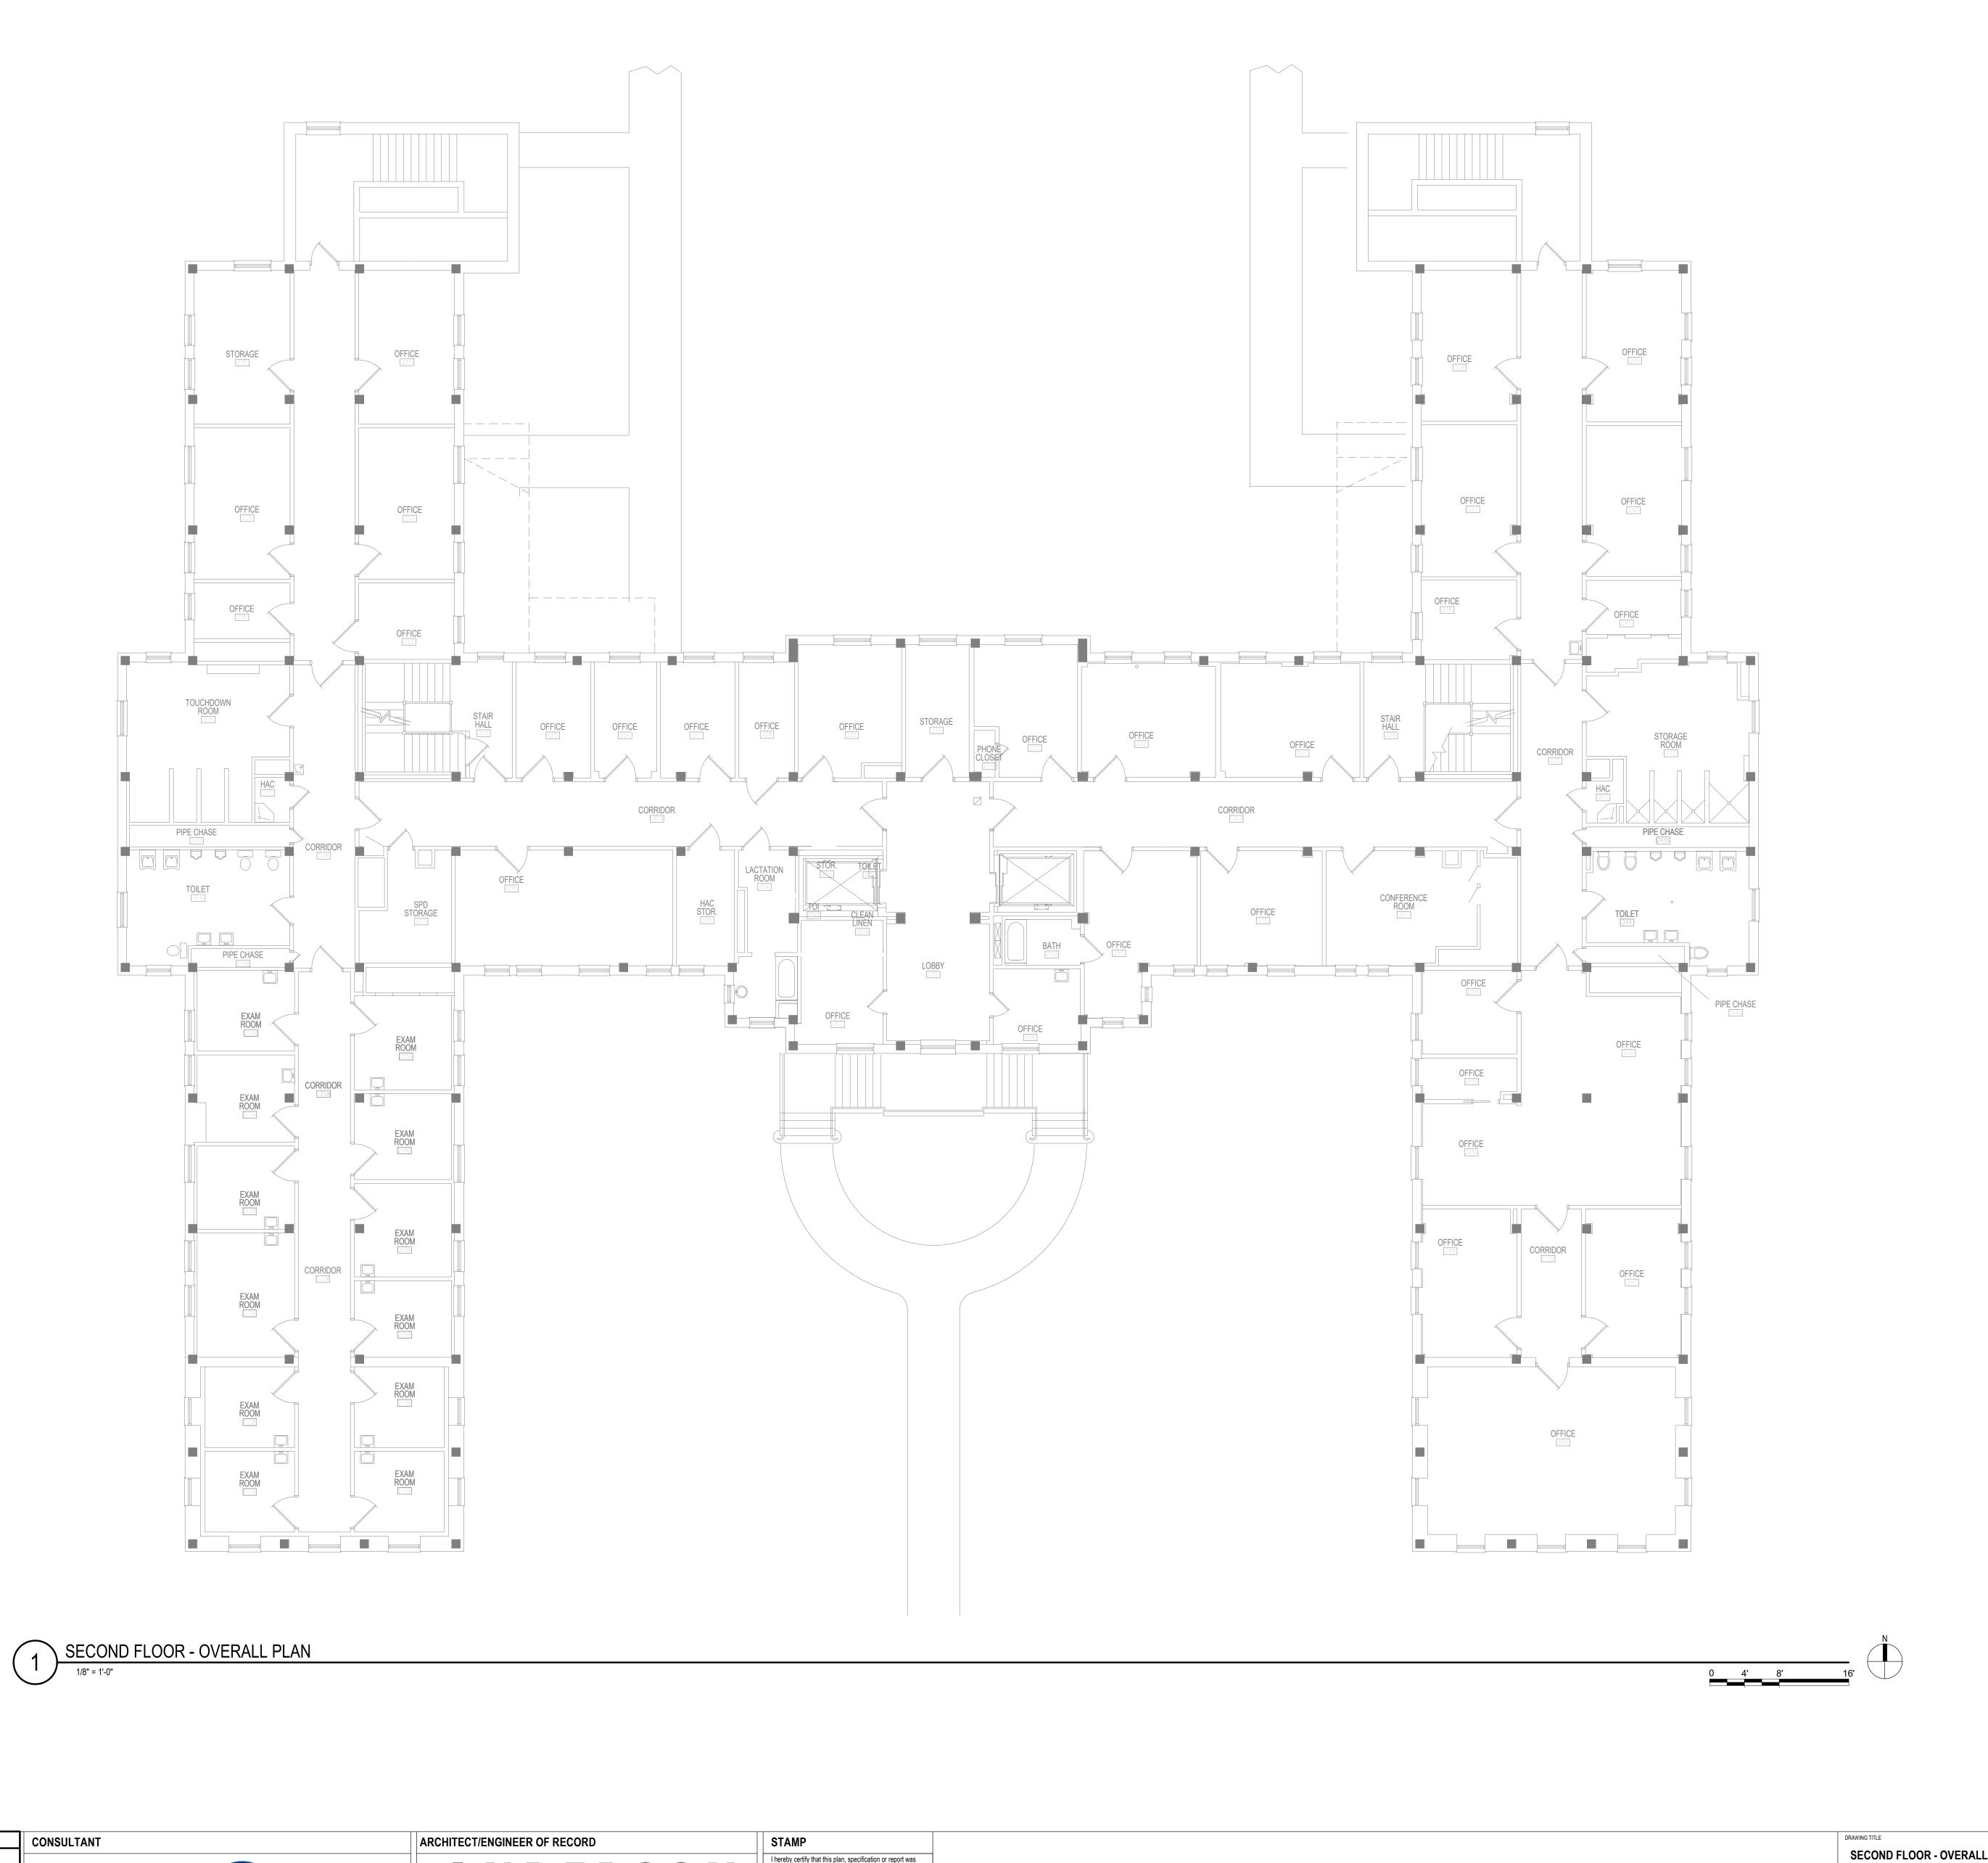
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REVISION

DATE

of Veterans Affairs St. Cloud VA Health Care System

VA MEDICAL CENTER ST.CLOUD, MN 56303



I hereby certify that this plan, specification or report was

prepared by me or under my direct supervision and that I am a duly Licensed Architect under the laws of the State of

Date: <u>03/30/2022</u> License Number: <u>MN# 18157</u>

Typed or Printed Name: Tom Olesak

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REVISION

DATE

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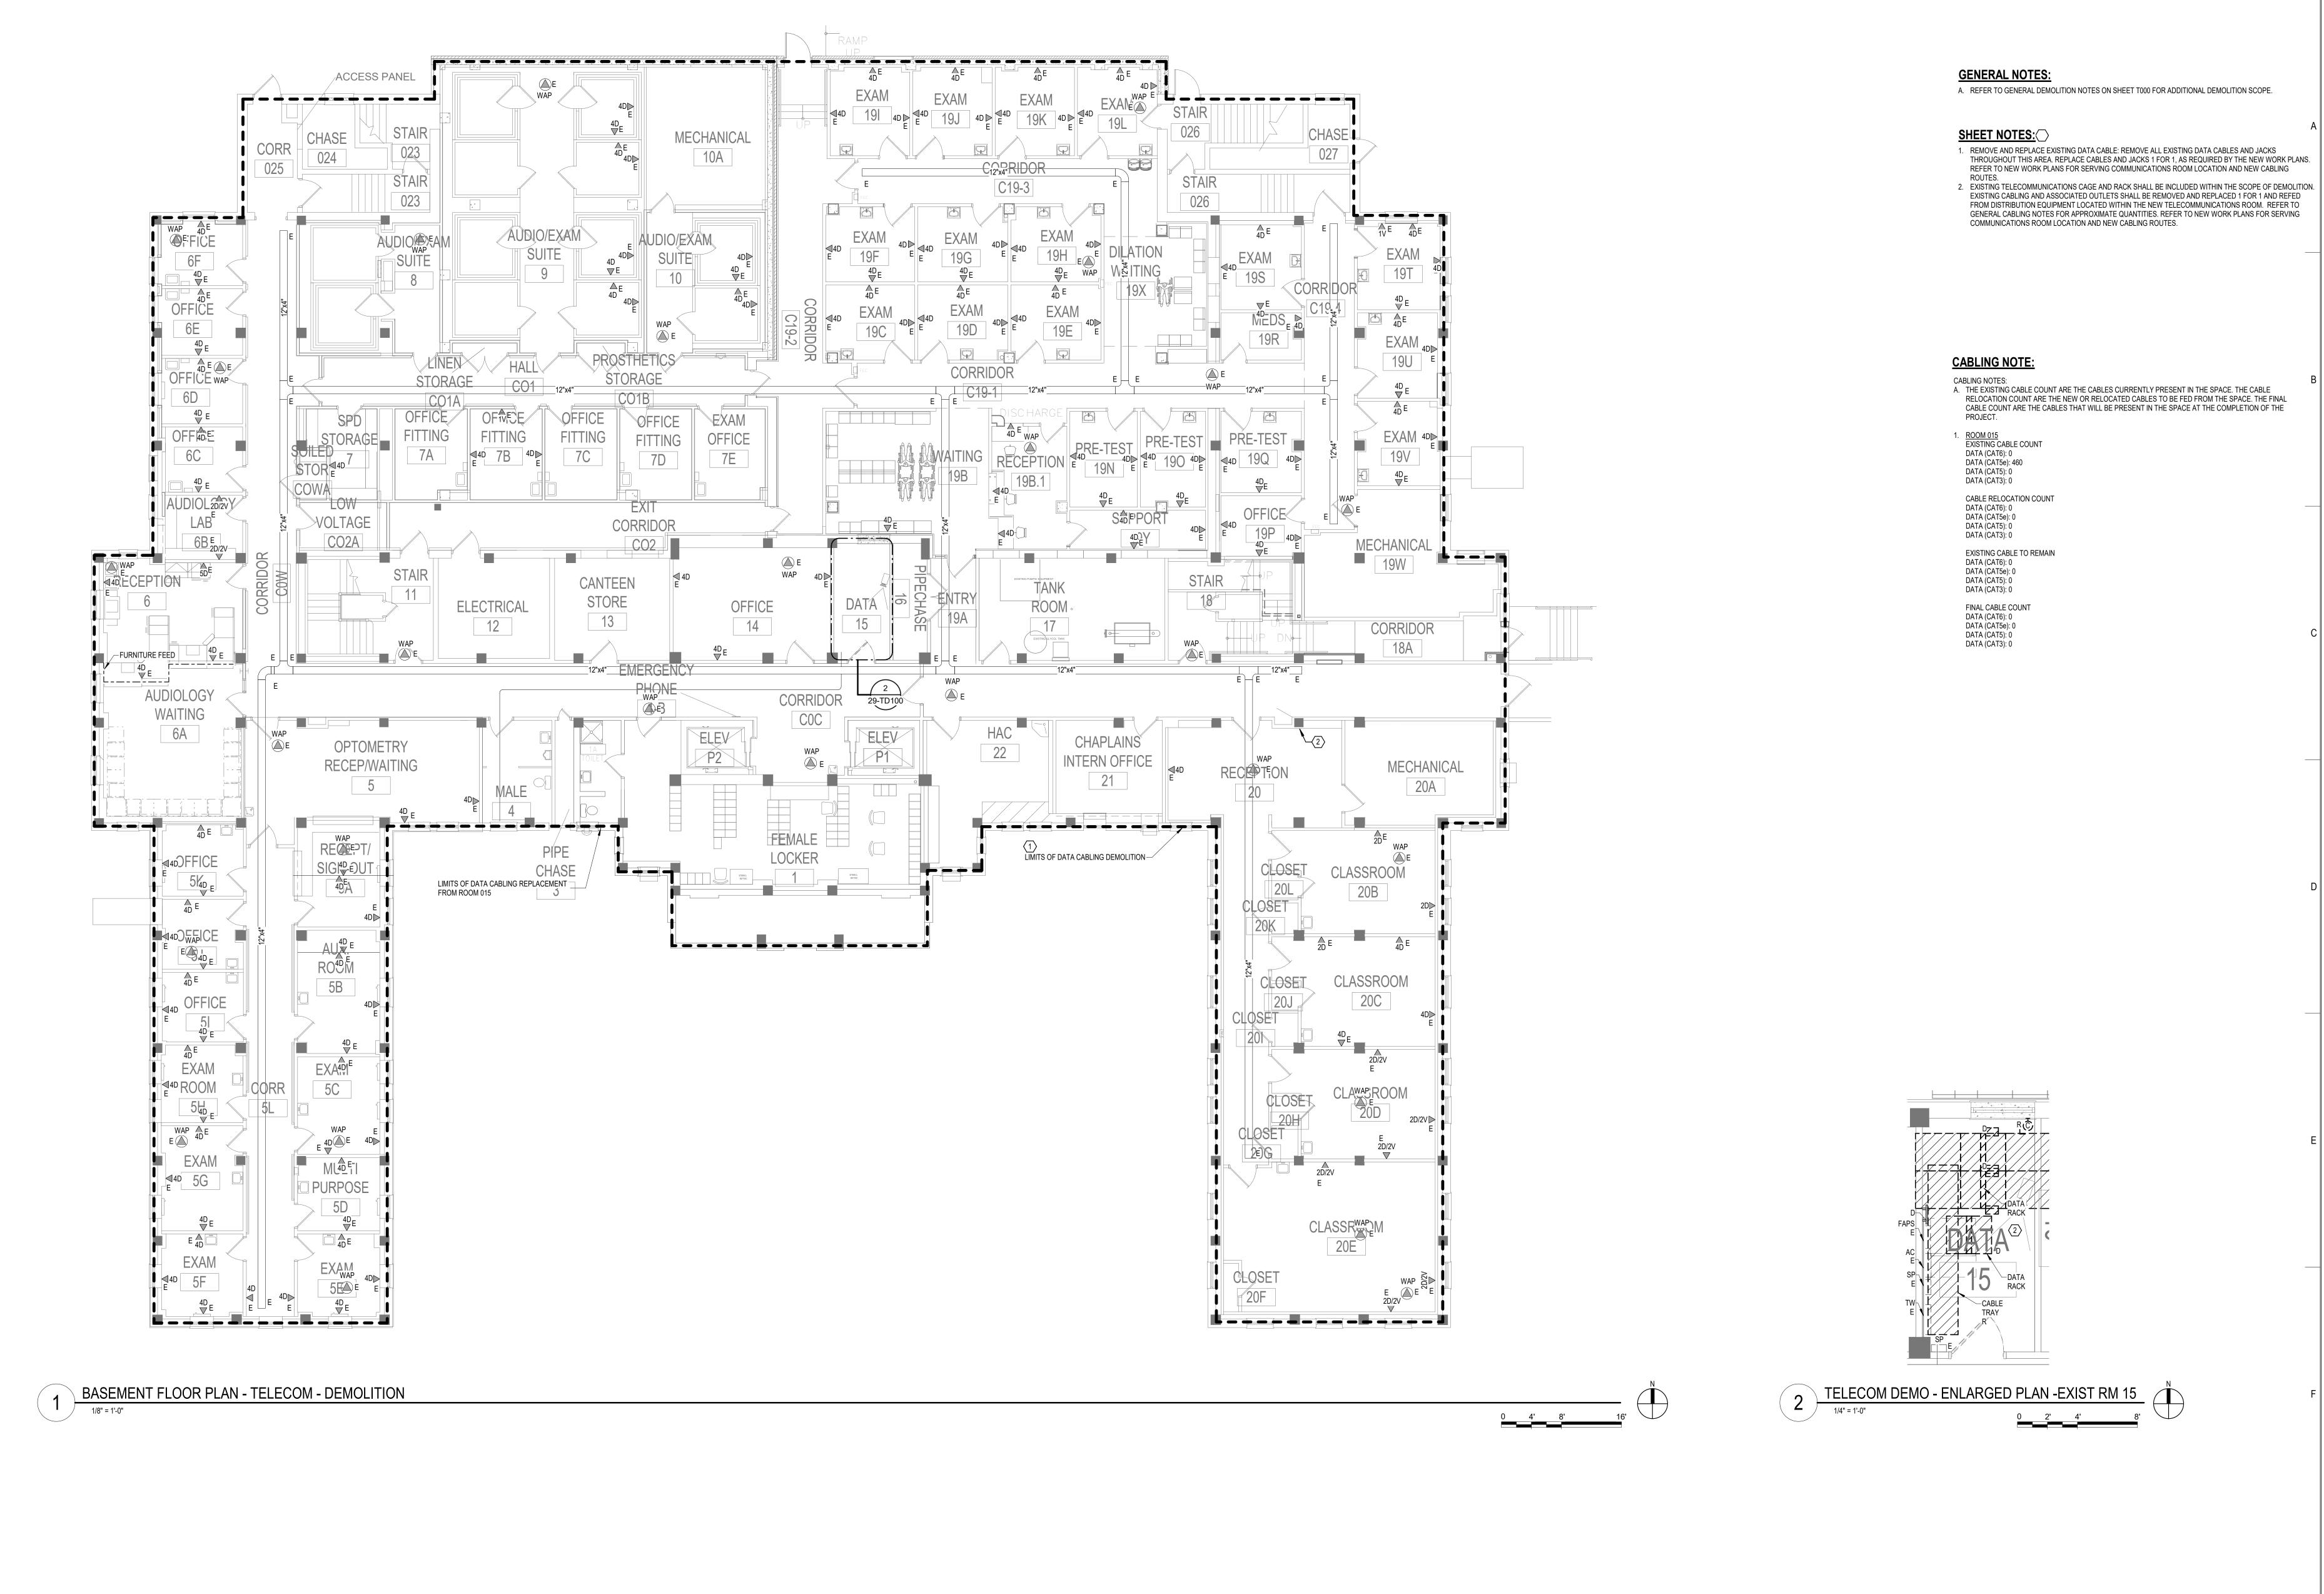
SHEET NOTES

- SEE GENERAL NOTES AND CAMPUS DRAWINGS FOR GENERAL INFORMATION, LIFE SAFETY, ICRA, AND PHASING
- ALL EXISTING CONDITIONS MUST BE FIELD VERIFIED BY THE CONTRACTOR PRIOR TO DEMOLITION OR CONSTRUCTION. EXISTING CONDITIONS THAT DIFFER FROM THOSE SHOWN MUST BE BROUGHT TO THE ATTENTION OF THE C.O.R. TO INFORM THE ARCHITECTS AND
- THE INFORMATION SHOWN ON THE DRAWINGS IS BASED ON DRAWINGS AND PHOTOGRAPHS PROVIDED BY THE C.O.R. COMBINED WITH OBSERVATIONS AND SURVEYED DATA FROM THE ARCHITECTS AND
- SEE CIVIL, STRUCTURAL, TELECOM, ELECTRICAL, MECHANICAL, AND PLUMBING DRAWINGS AND SPECIFICATIONS FOR ADDITIONAL DEMOLITION AND CONSTRUCTION REQUIREMENTS.
- PORTABLE FIRE EXTINGUISHERS (CO2 OR HALOGENATED TYPE AS DETERMINED BY VA) WITH WALL MOUNT BRACKET AND CODE REQUIRED SIGNAGE SHALL BE PROVIDED BY THE CONTRACTOR WITHIN TELECOM

EHRM INFRASTRUCTURE

VA MEDICAL CENTER ST.CLOUD, MN 56303





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BASEMENT FLOOR PLAN -TELECOM - DEMOLITION EHRM INFRASTRUCTURE
UPGRADES

VA MEDICAL CENTER ST.CLOUD, MN 56303

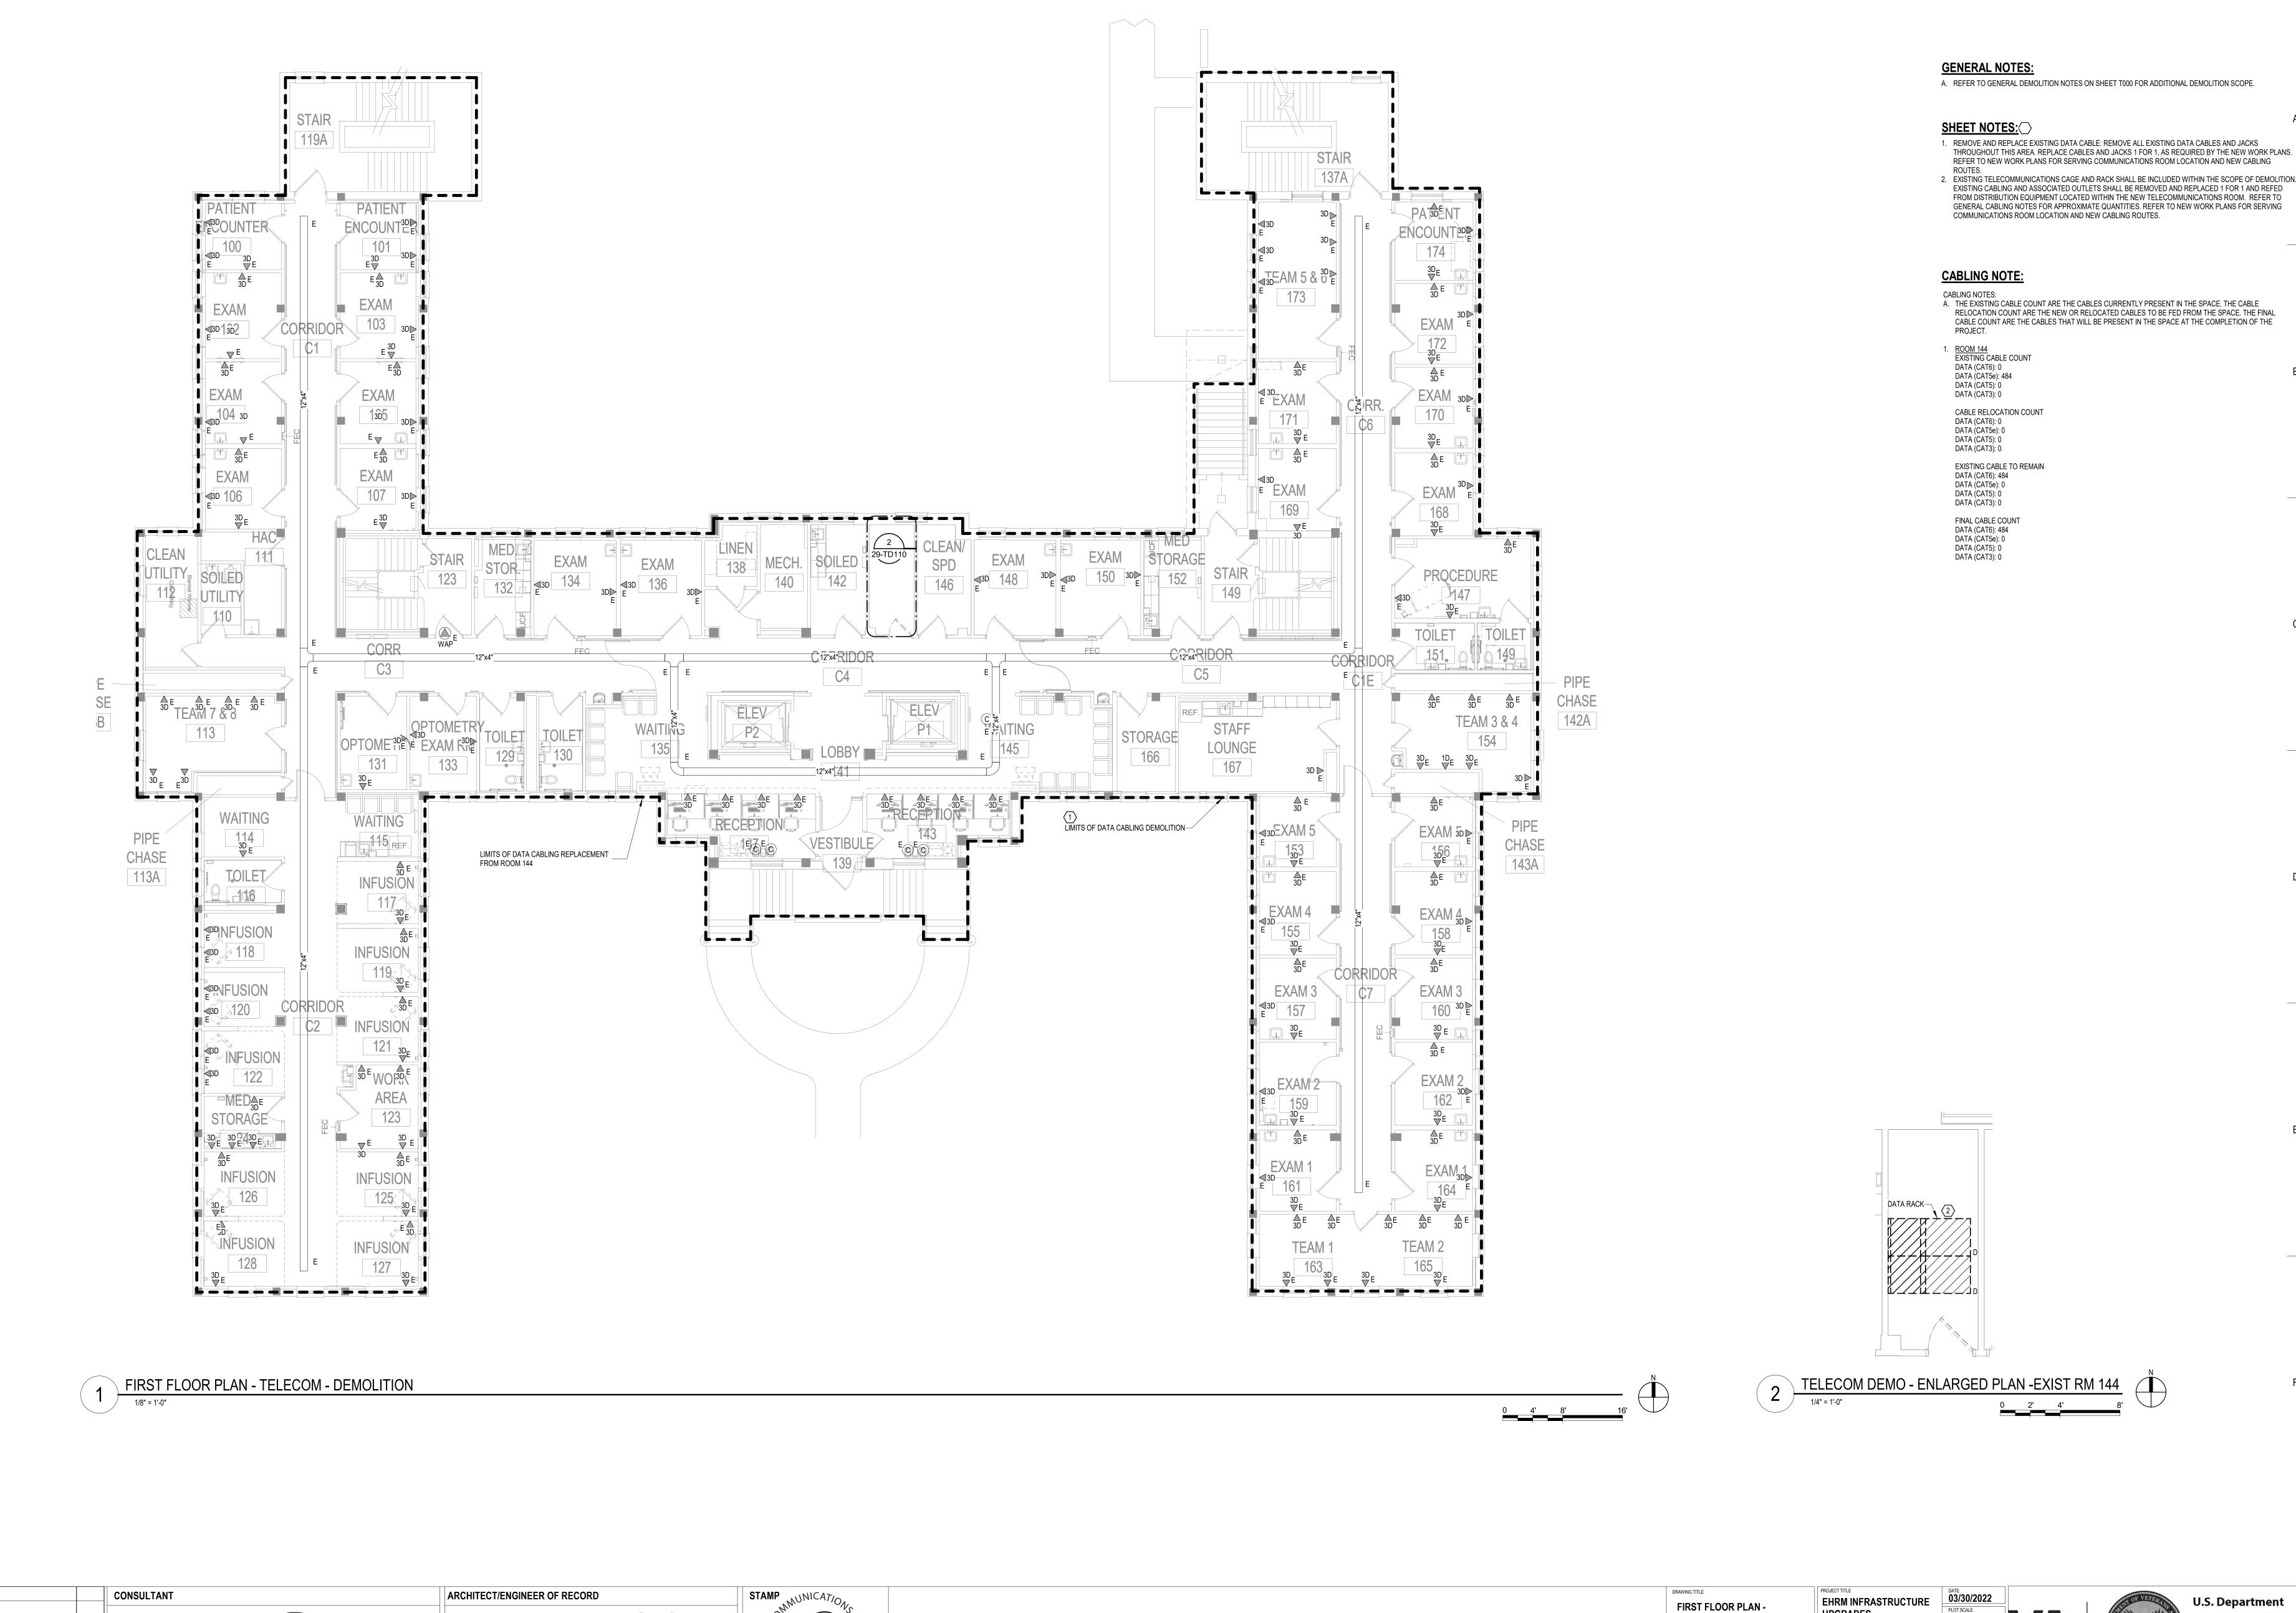
KSB

FULLY SPRINKLERED

PROJECT NO.
656-21-235

DRAWING NO.





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REVISION

BICSI ID # 346555

Wathan M. Timm

EXPIRES 12-31-23

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of Veterans Affairs

Veterans Health
Administration

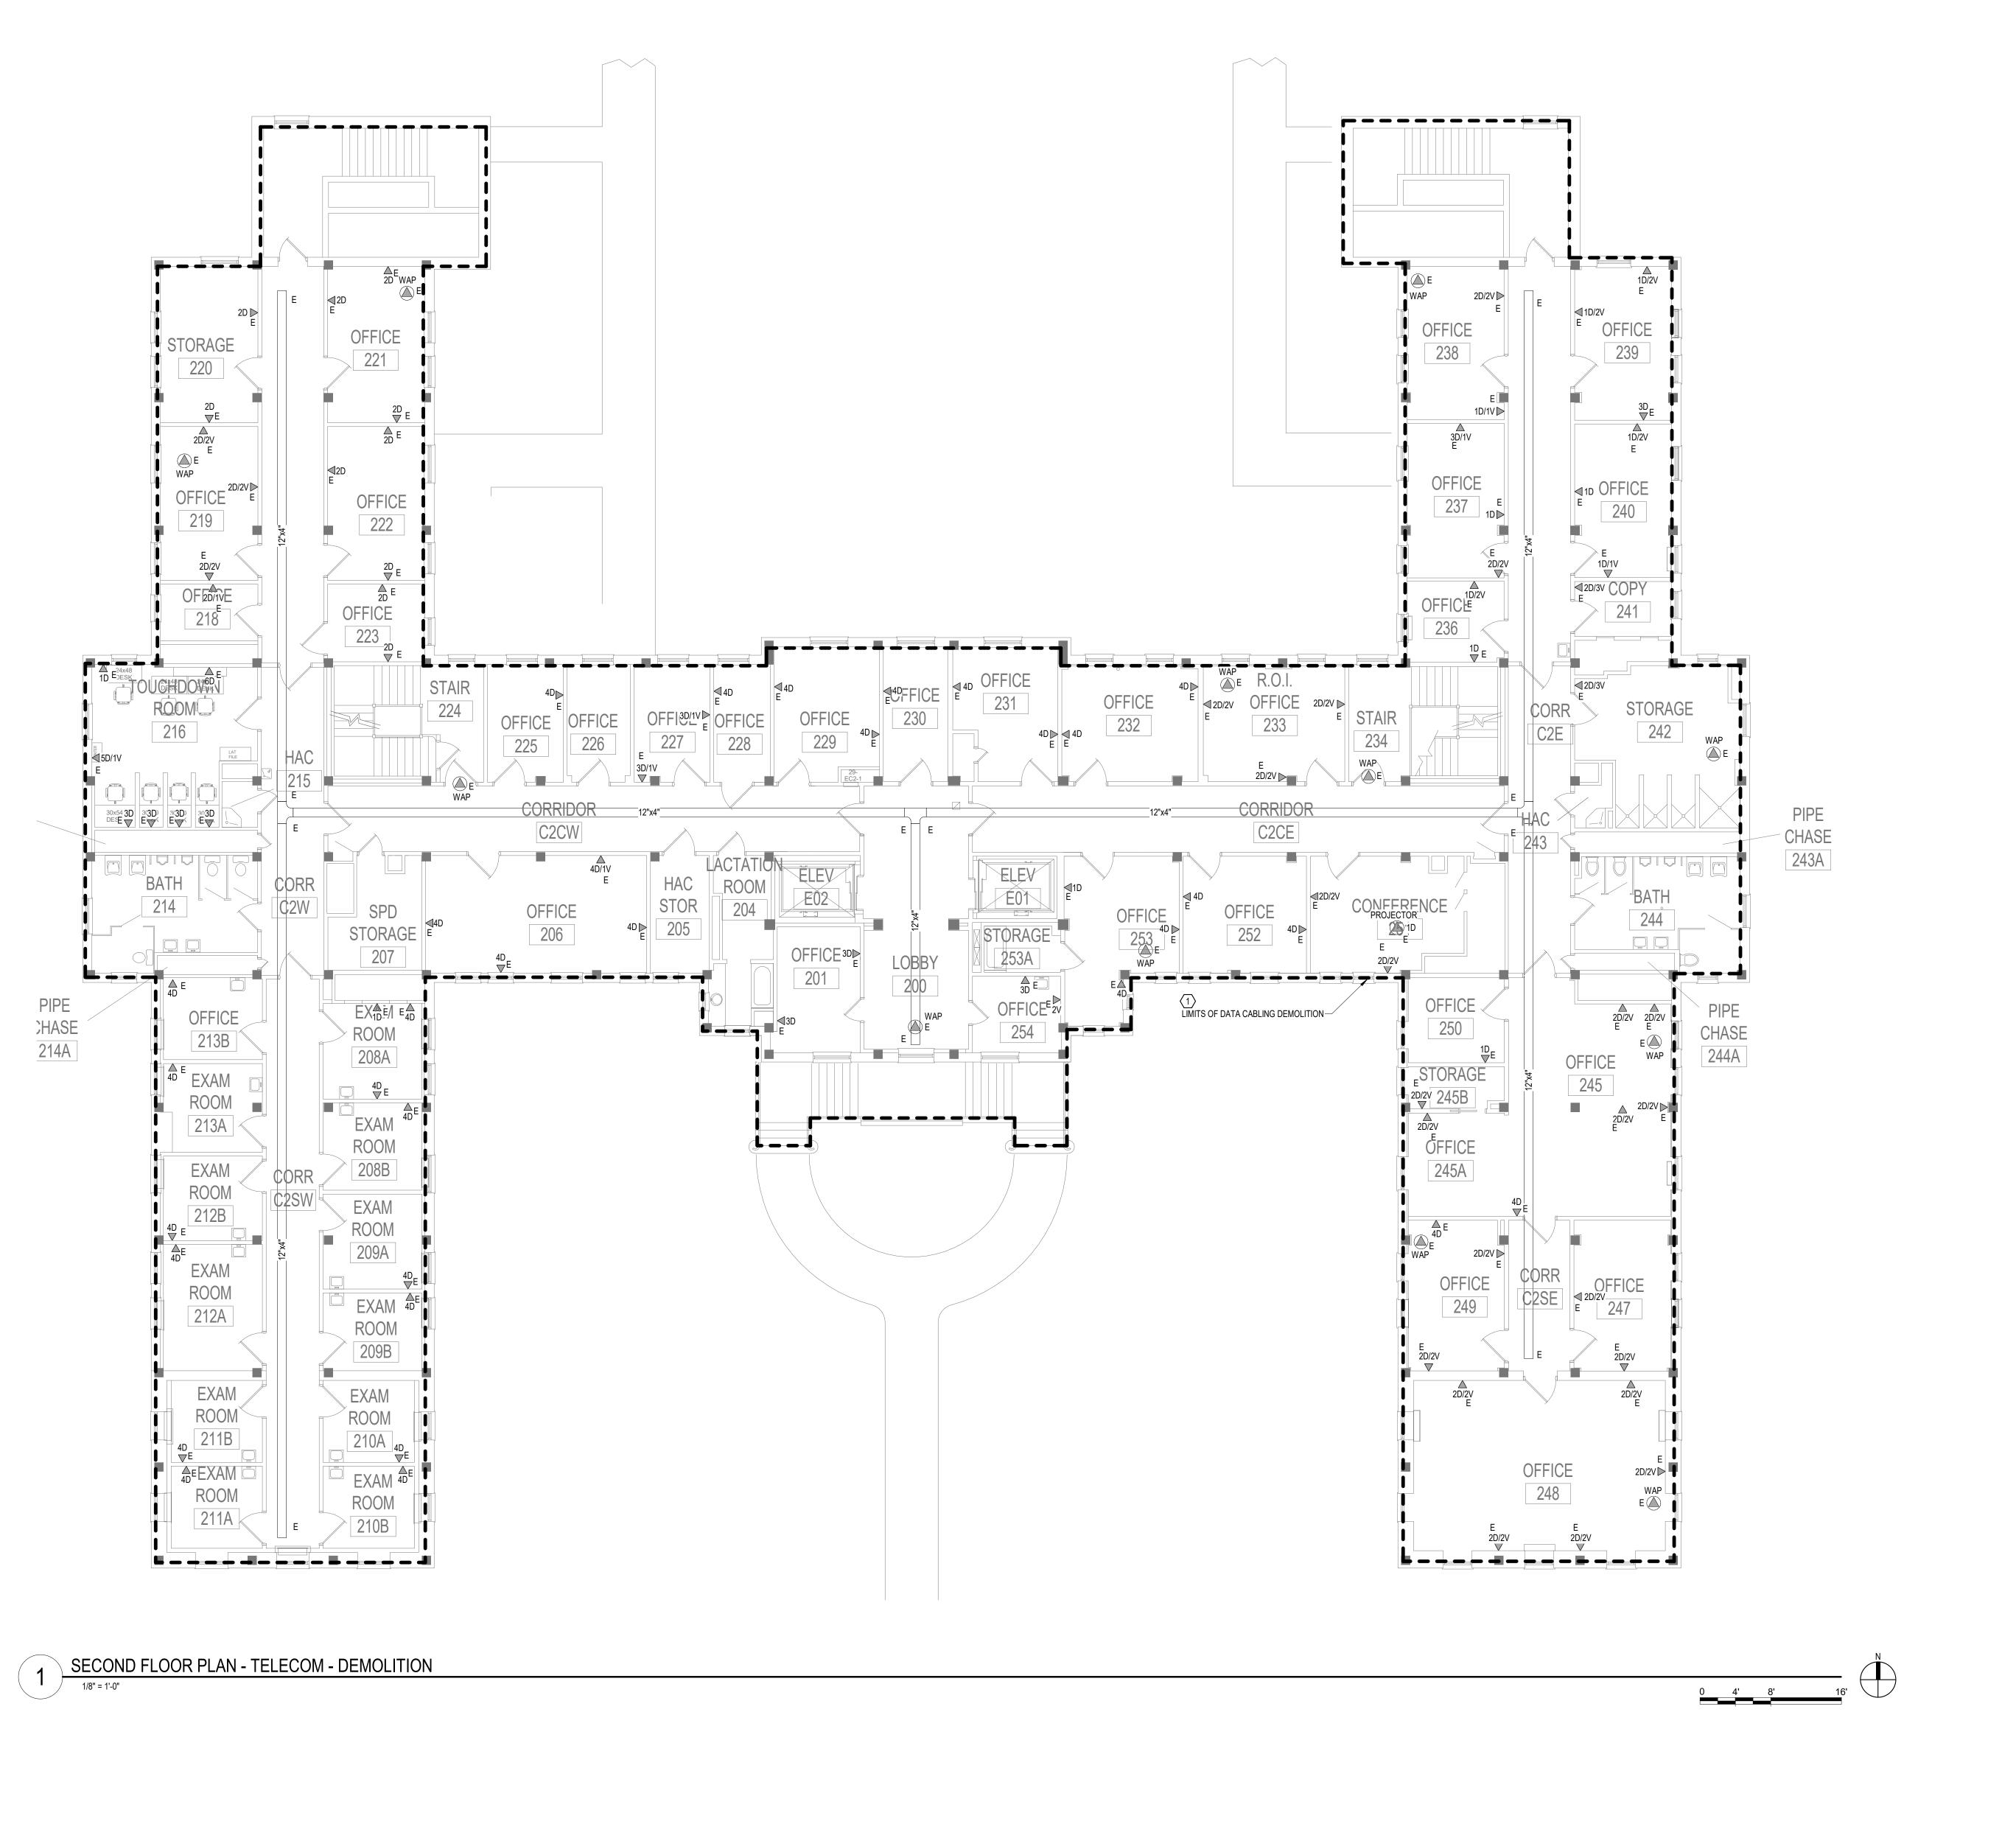
St. Cloud VA
Health Care System

TELECOM - DEMOLITION

KSB

FULLY SPRINKLERED

VA MEDICAL CENTER ST.CLOUD, MN 56303



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GENERAL NOTES:

A. REFER TO GENERAL DEMOLITION NOTES ON SHEET T000 FOR ADDITIONAL DEMOLITION SCOPE.

SHEET NOTES:

1. REMOVE AND REPLACE EXISTING DATA CABLE: REMOVE ALL EXISTING DATA CABLES AND JACKS THROUGHOUT THIS AREA. REPLACE CABLES AND JACKS 1 FOR 1, AS REQUIRED BY THE NEW WORK PLANS. REFER TO NEW WORK PLANS FOR SERVING COMMUNICATIONS ROOM LOCATION AND NEW CABLING

DRAWING TITLE

SECOND FLOOR PLAN TELECOM - DEMOLITION

PROJECT TITLE
EHRM INFRASTRUCTURE
UPGRADES

VA MEDICAL CENTER ST.CLOUD, MN 56303

NFRASTRUCTURE
DES

PROJECT NO 656-2

FULLY SPRINKLERED

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Nathan Timm
BICSI ID # 346555

Expires 12-31-23

Nathan M. Timm

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Health Care System

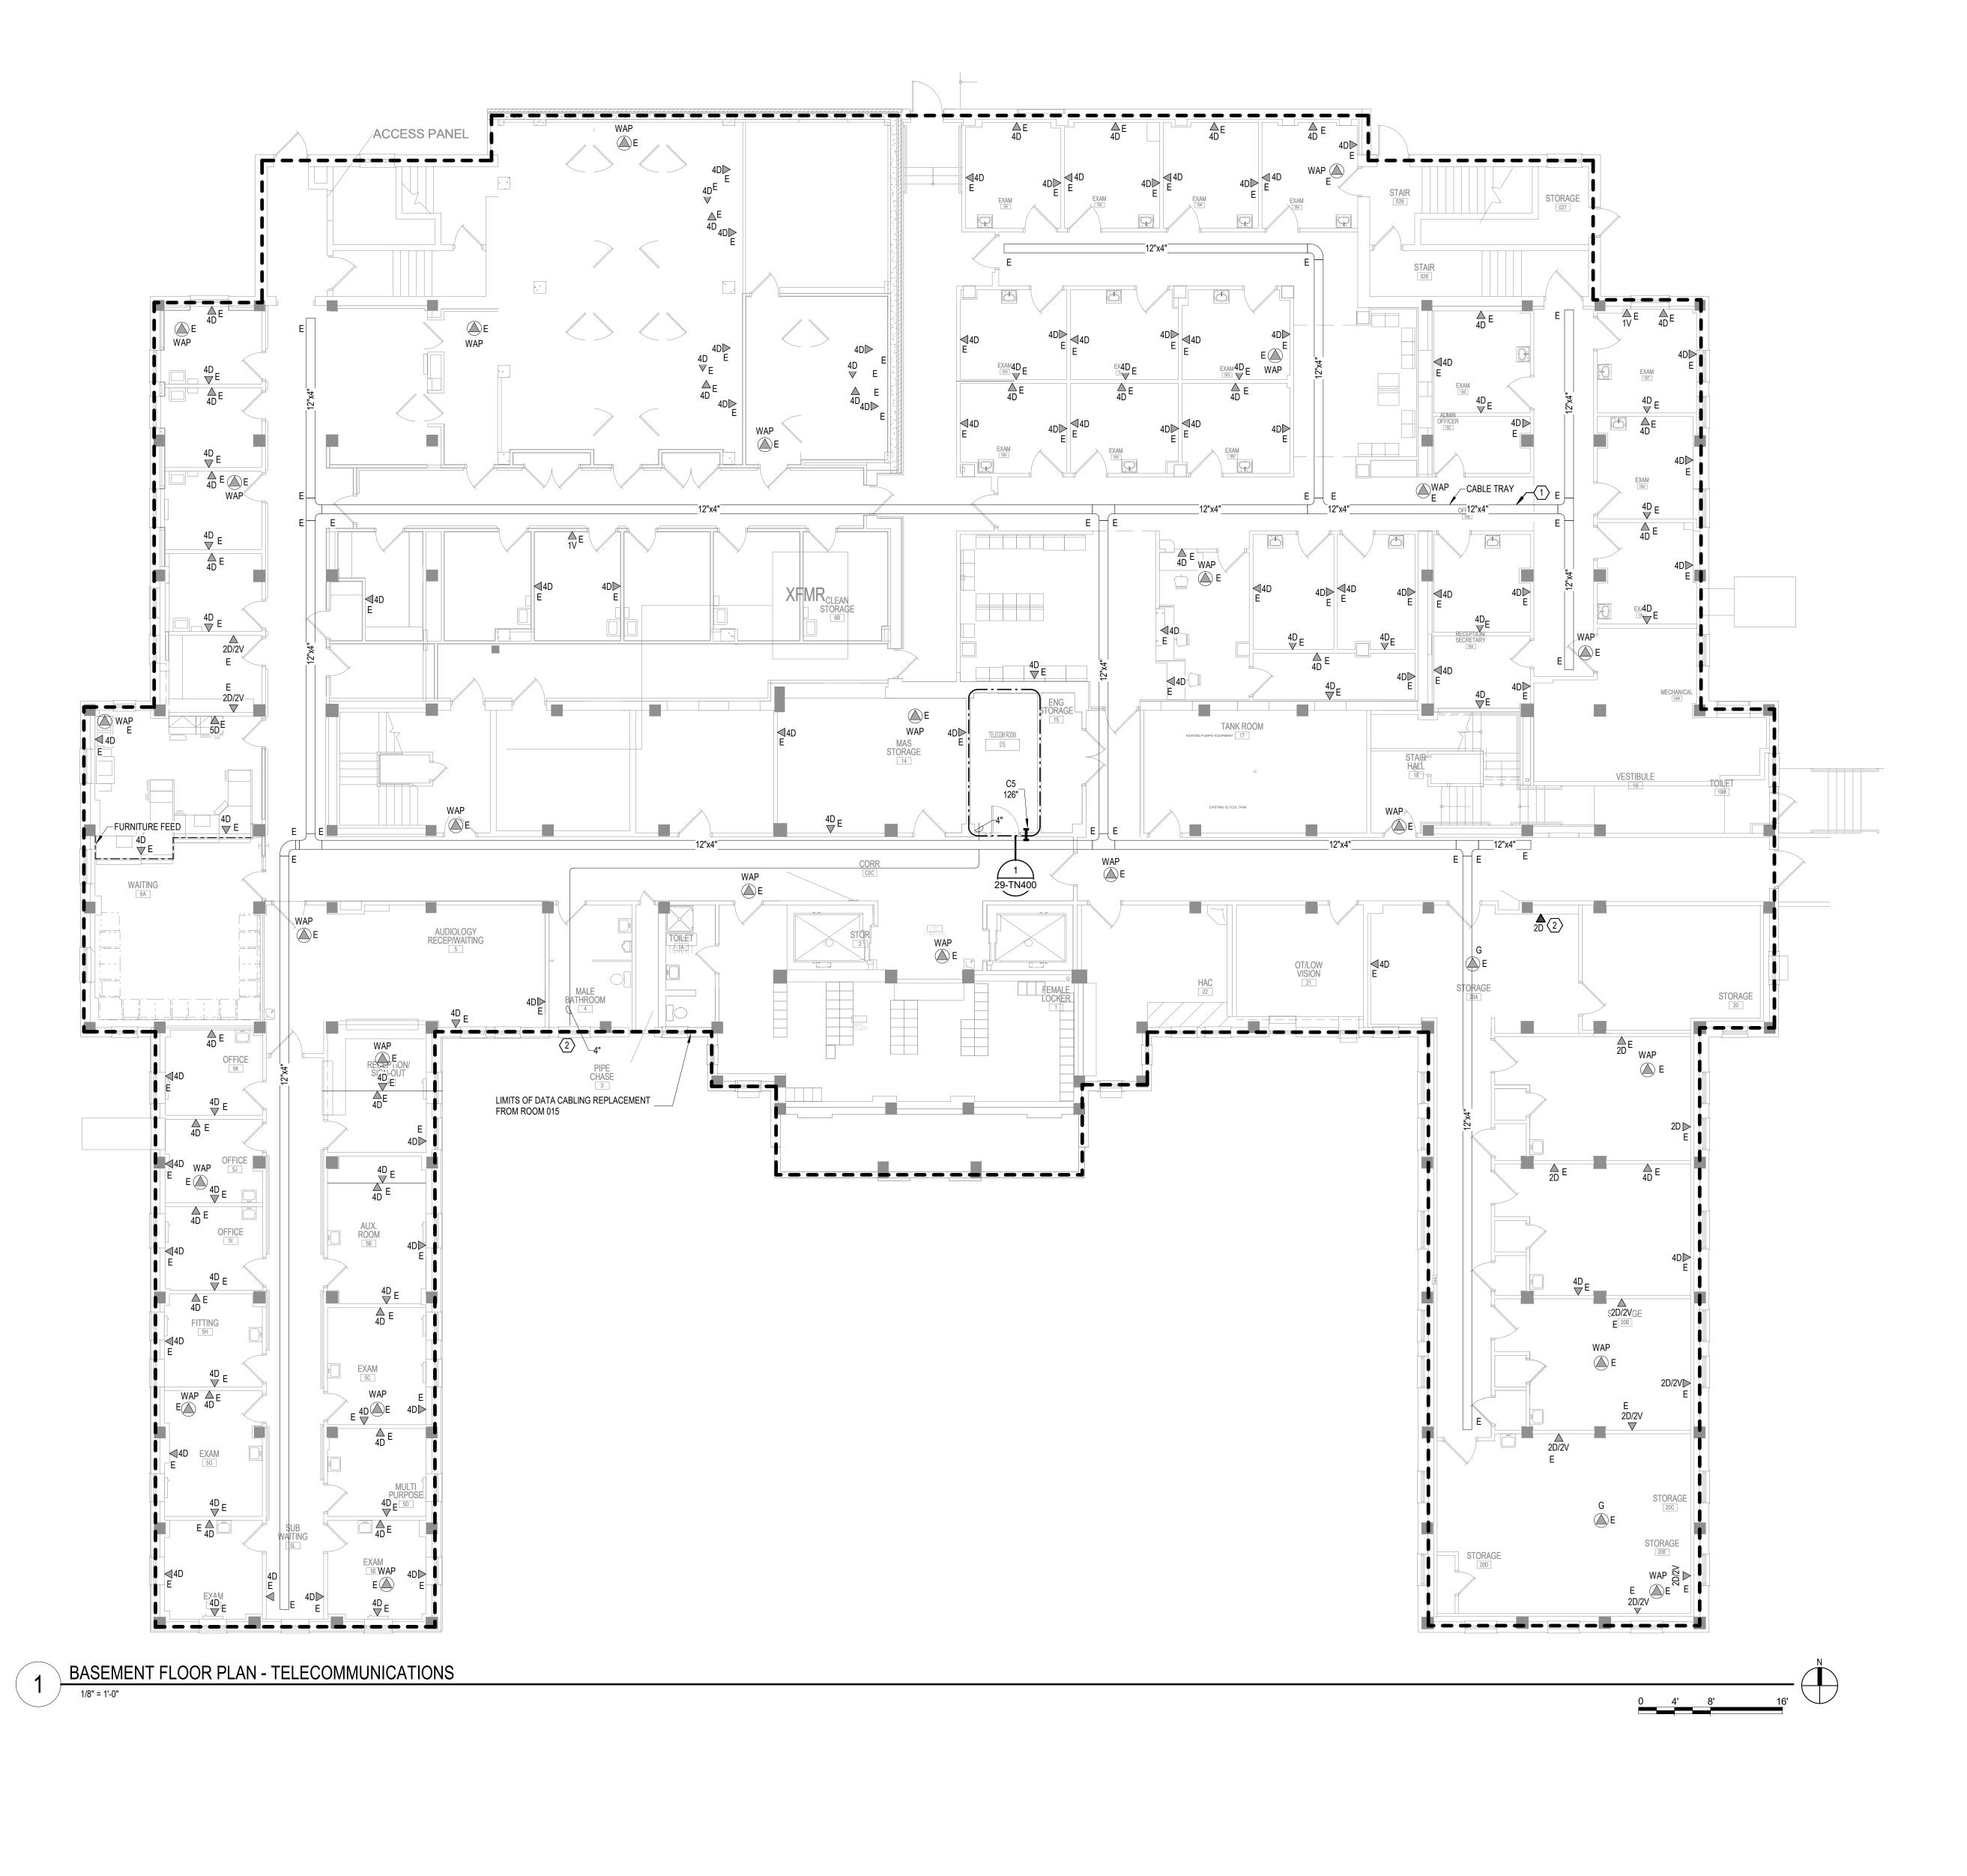
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GENERAL NOTES:

A. REFER TO GENERAL NOTES ON SHEET T000 FOR ADDITIONAL SCOPE.

SHEET NOTES:

- 1. CONTRACTOR TO PROVIDE NEW WIRE BASKET, AS NEEDED, TO MAINTAIN A 50% OR LESS FILL OF THE CABLE TRAY SYSTEM FOR THE FLOOR. THE NEW WIRE BASKET WILL MATCH THE SIZE AND DISTANCE, EITHER
- BESIDE OR BELOW THE EXISTING CABLE TRAY, TO MATCH THE EXISTING TELECOM CABLE TRAY.

 2. PROVIDE JUNCTION BOX TO CONNECT FIBER CONDUIT ENTRY TO EXTEND CONDUIT PATHWAY TO THE NEW

BASEMENT FLOOR PLAN -TELECOMMUNICATIONS

EHRM INFRASTRUCTURE

FULLY SPRINKLERED

LOCATION

VA MEDICAL CENTER

ST.CLOUD, MN 56303

KSB SSK 29-TN100

U.S. Department of Veterans Affairs Veterans Health Administration St. Cloud VA Health Care System

CONSULTANT Phone: 402.991.5520

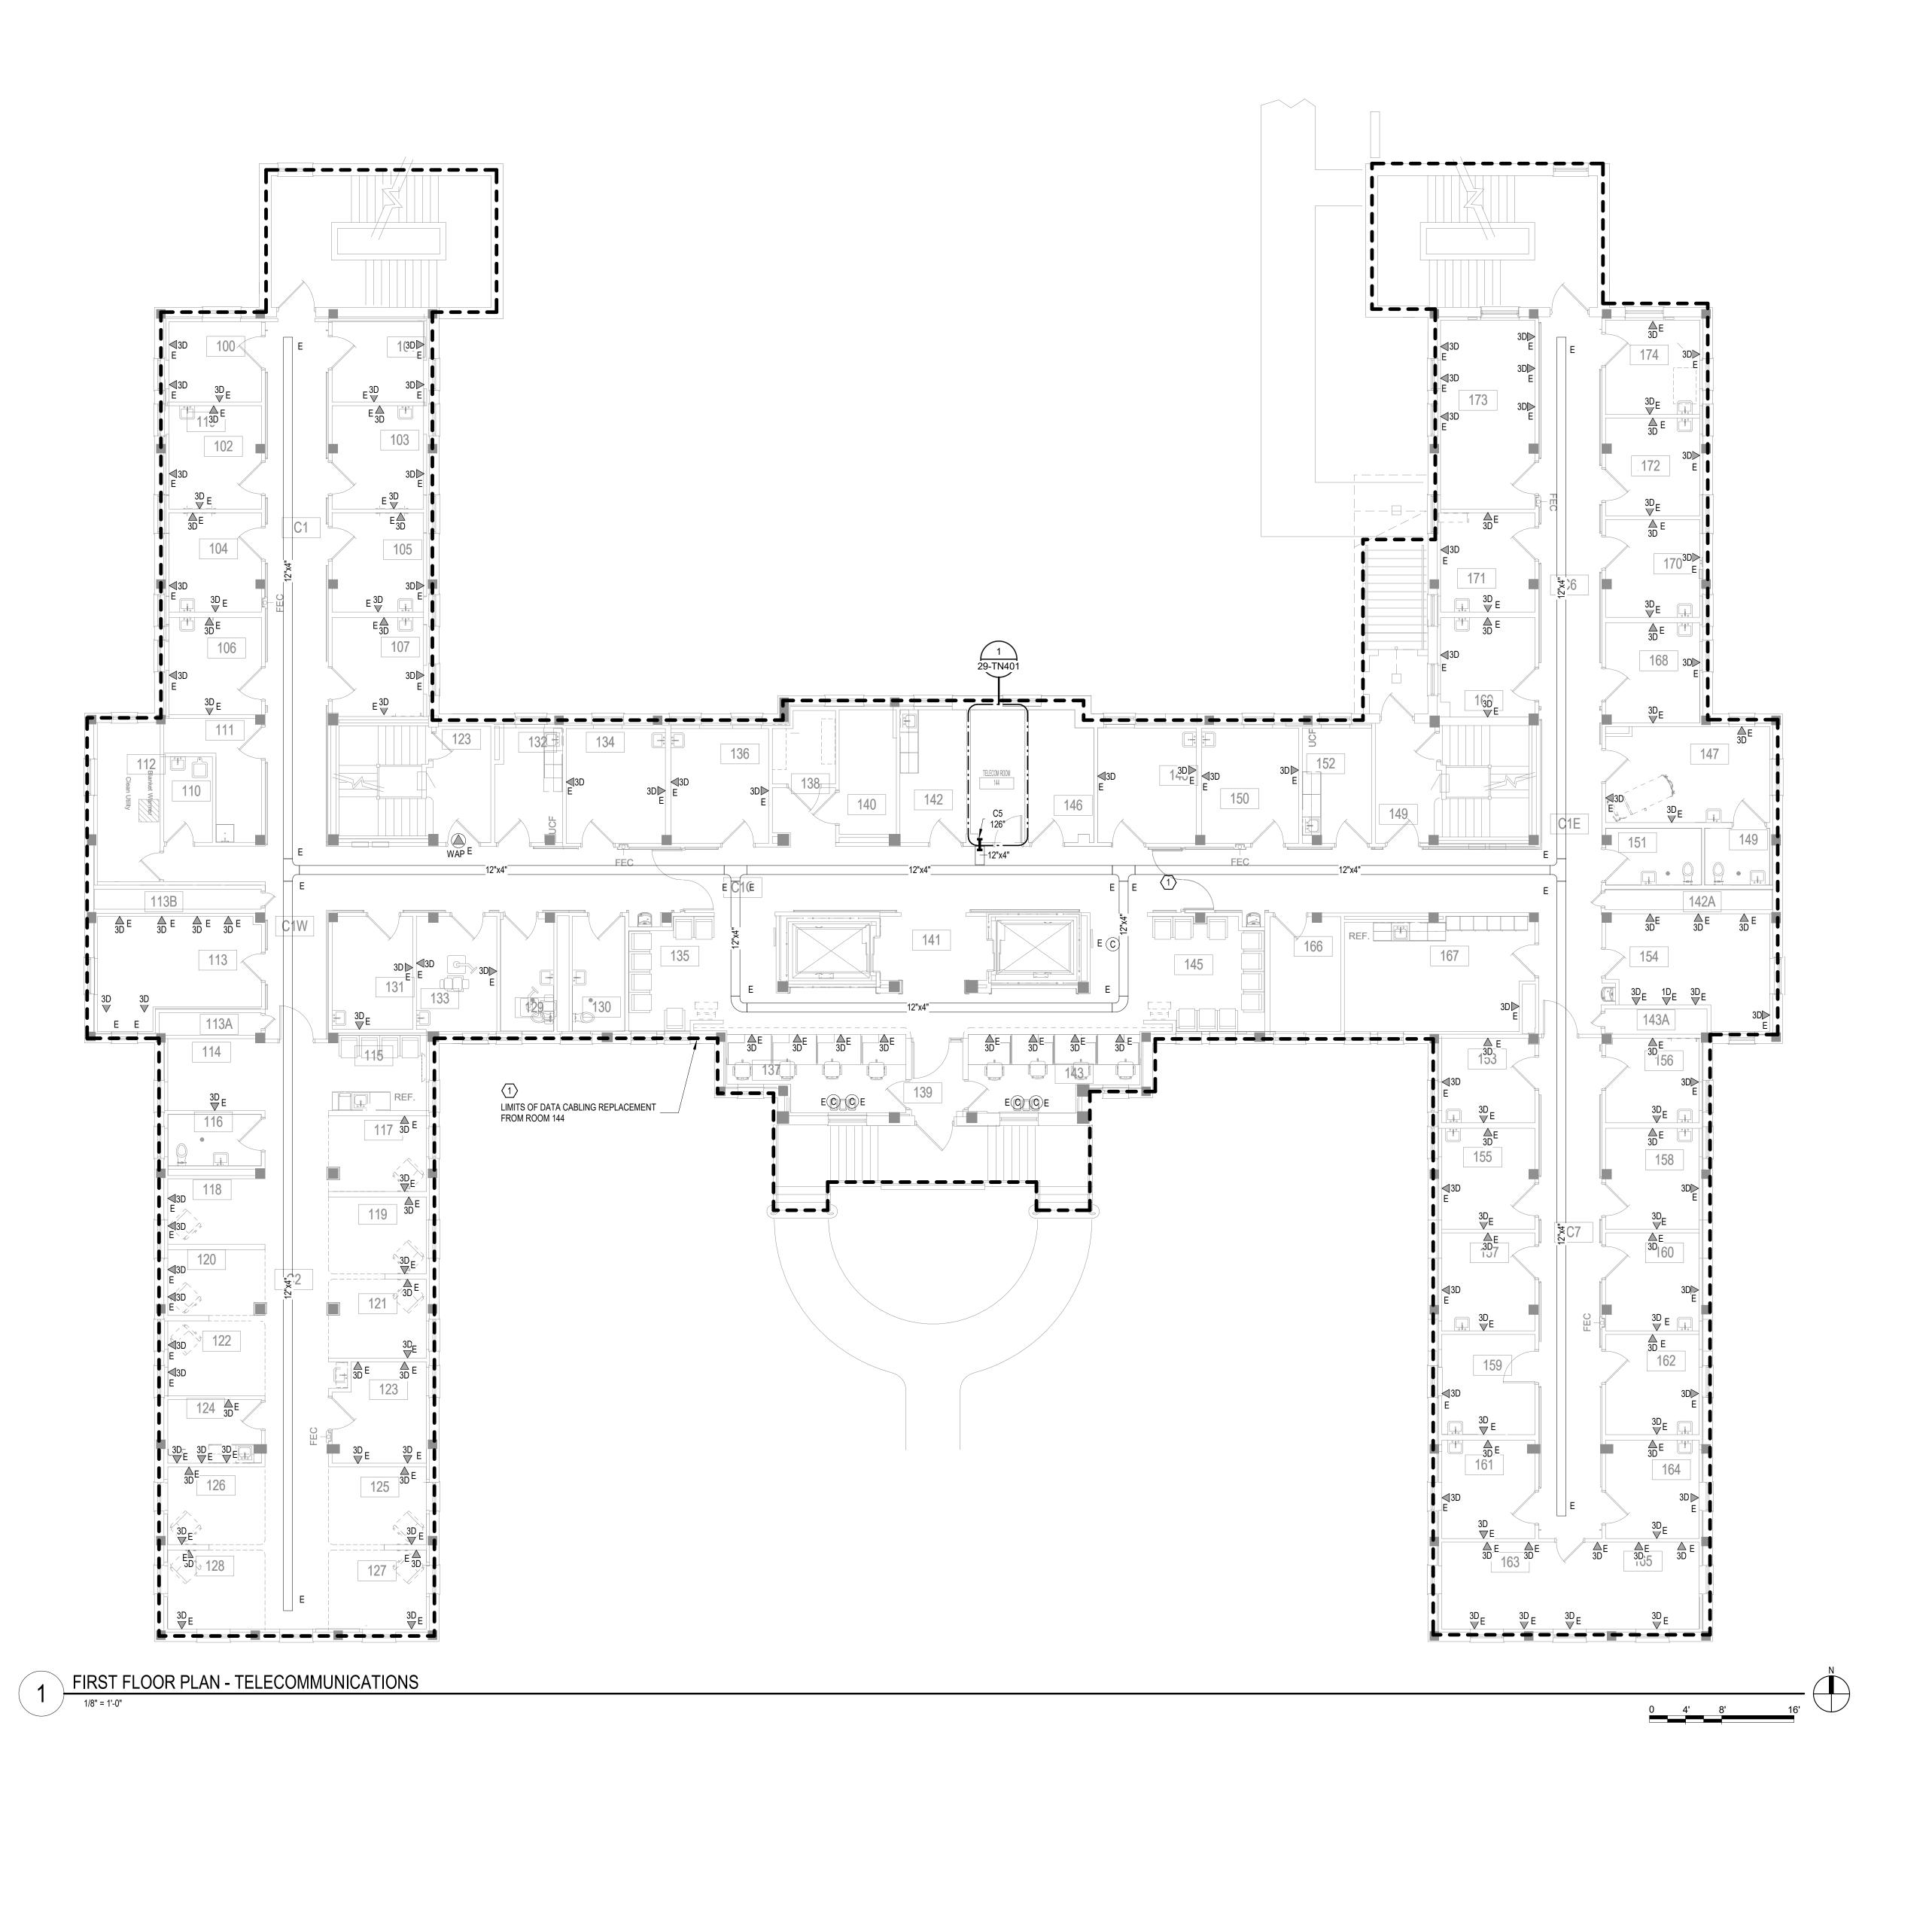
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GENERAL NOTES:

A. REFER TO GENERAL NOTES ON SHEET T000 FOR ADDITIONAL SCOPE.

SHEET NOTES:

1. CONTRACTOR TO PROVIDE NEW WIRE BASKET, AS NEEDED, TO MAINTAIN A 50% OR LESS FILL OF THE CABLE TRAY SYSTEM FOR THE FLOOR. THE NEW WIRE BASKET WILL MATCH THE SIZE AND DISTANCE, EITHER BESIDE OR BELOW THE EXISTING CABLE TRAY, TO MATCH THE EXISTING TELECOM CABLE TRAY.

FIRST FLOOR PLAN -TELECOMMUNICATIONS

03/30/2022 EHRM INFRASTRUCTURE

VA MEDICAL CENTER ST.CLOUD, MN 56303

FULLY SPRINKLERED

KSB SSK 29-TN110



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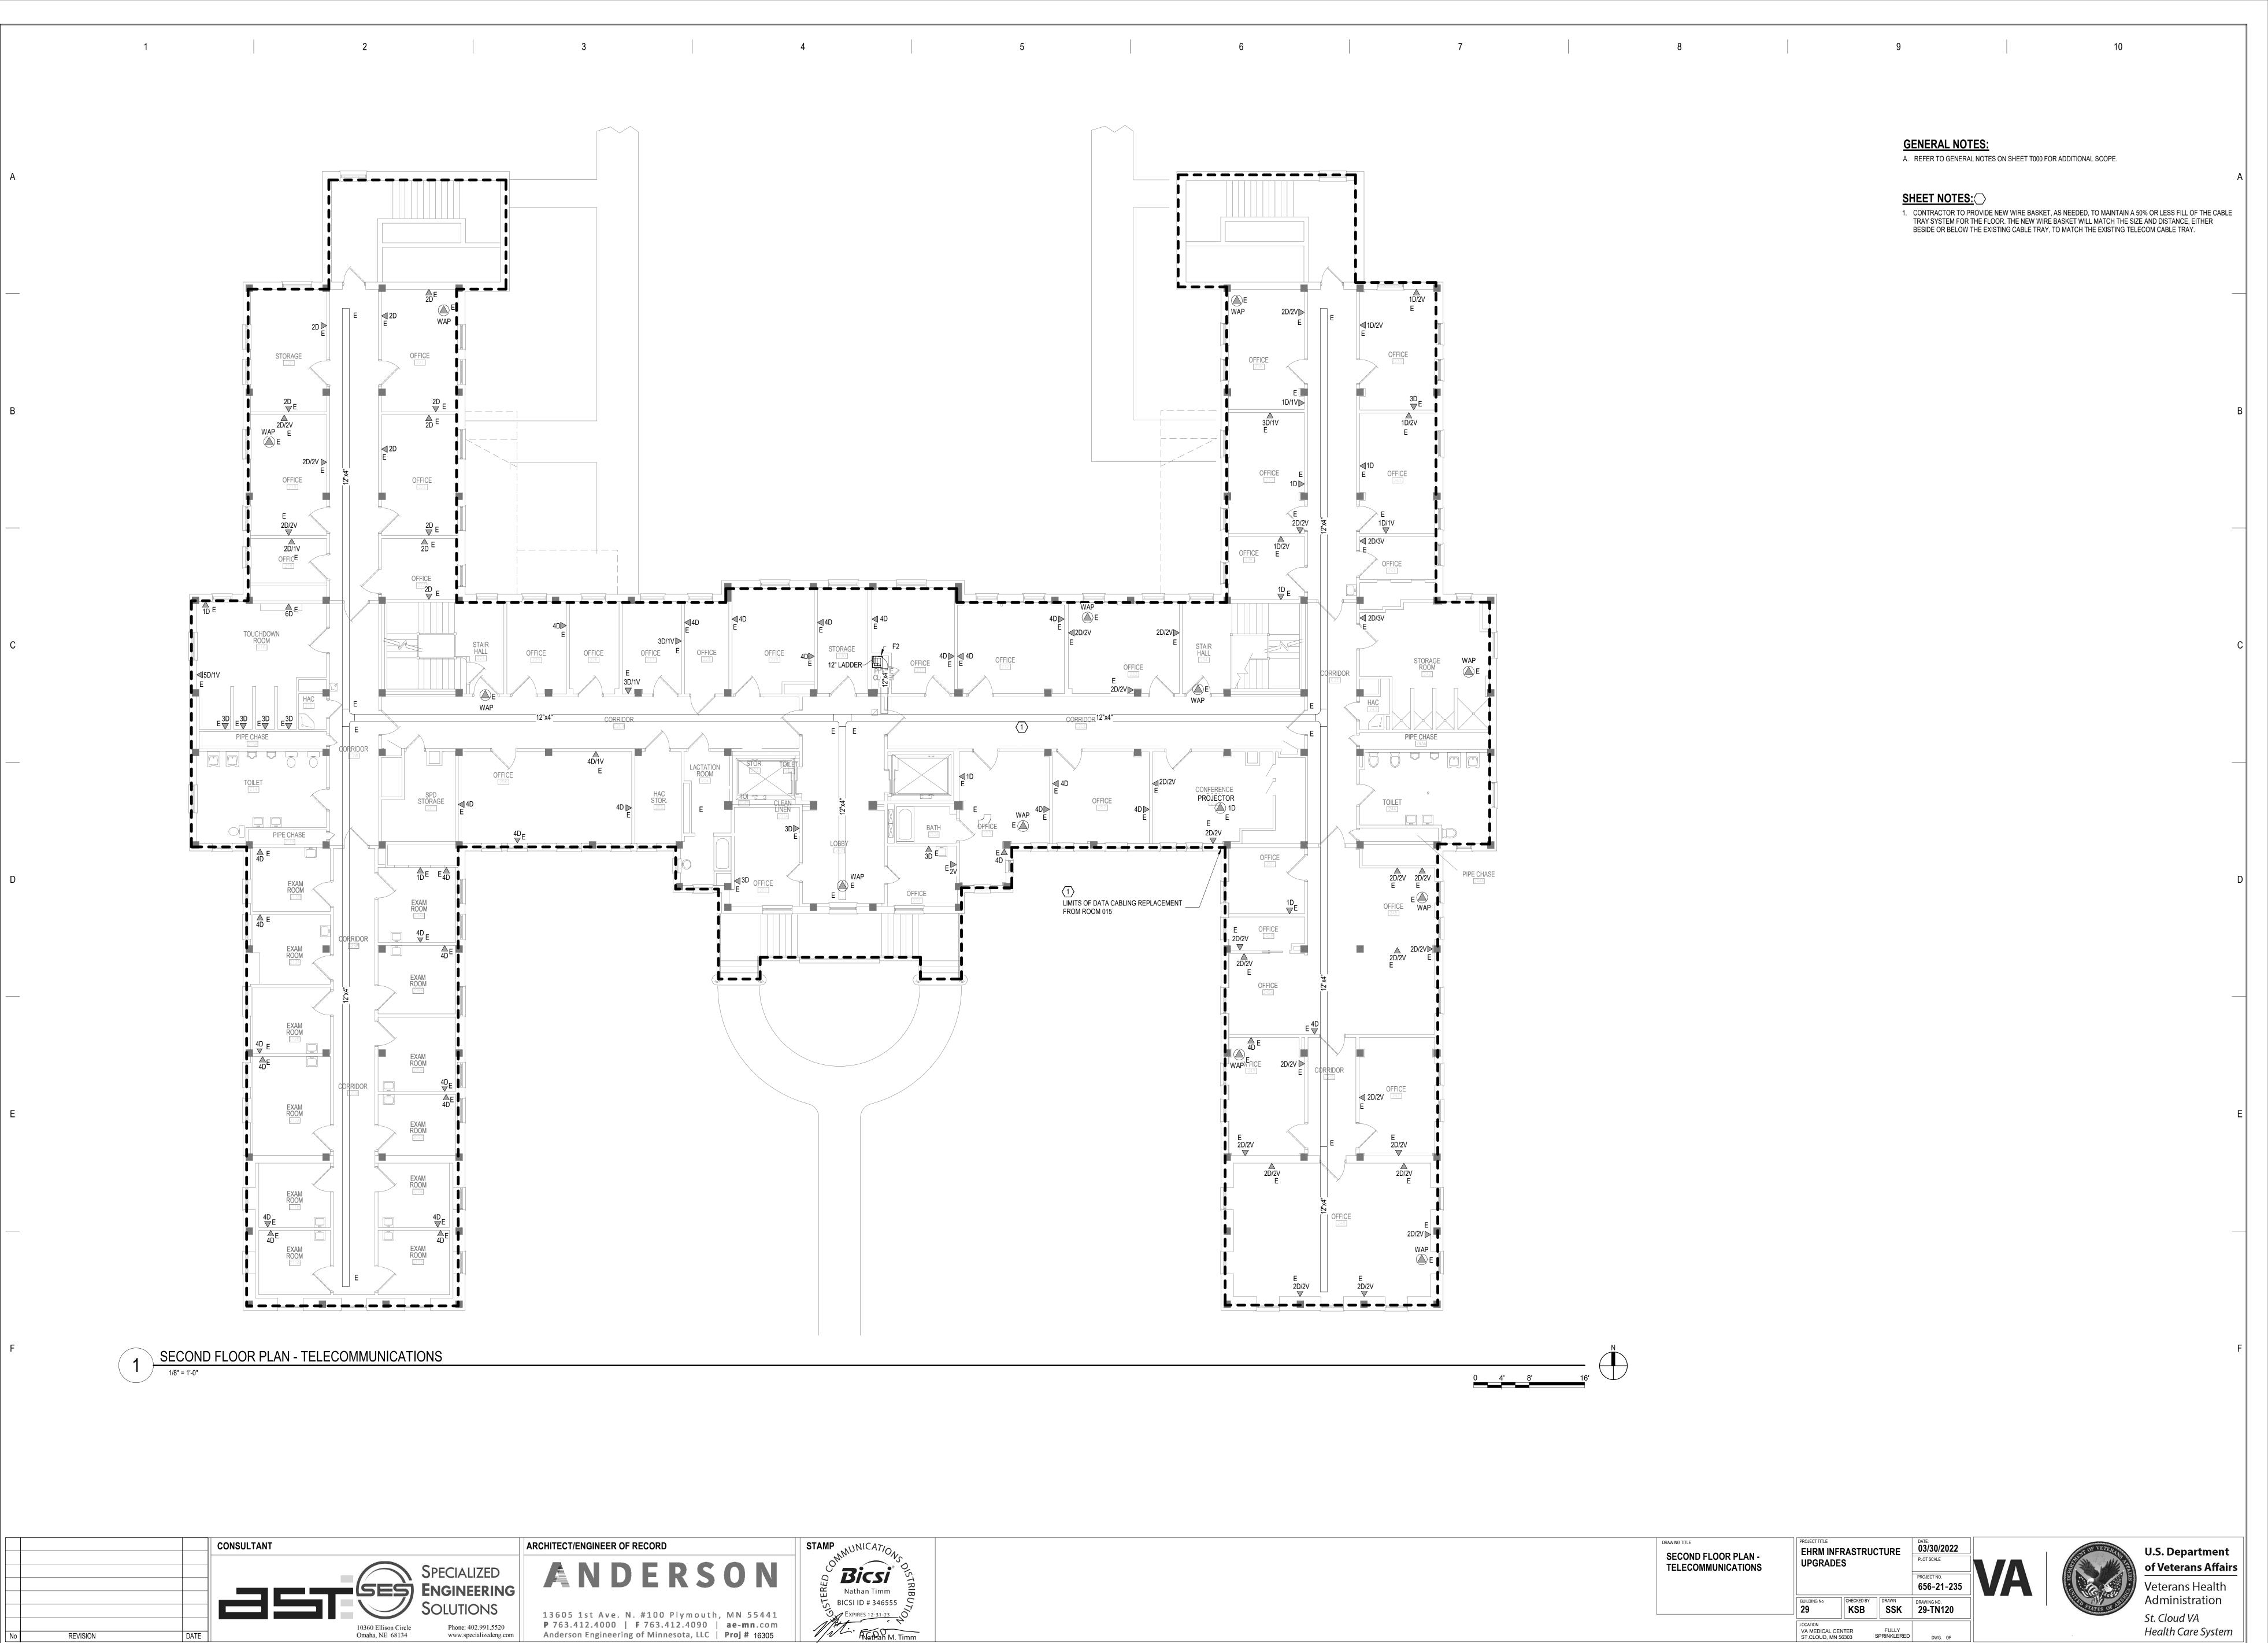
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St. Cloud VA Health Care System

LOCATION
VA MEDICAL CENTER
ST.CLOUD, MN 56303

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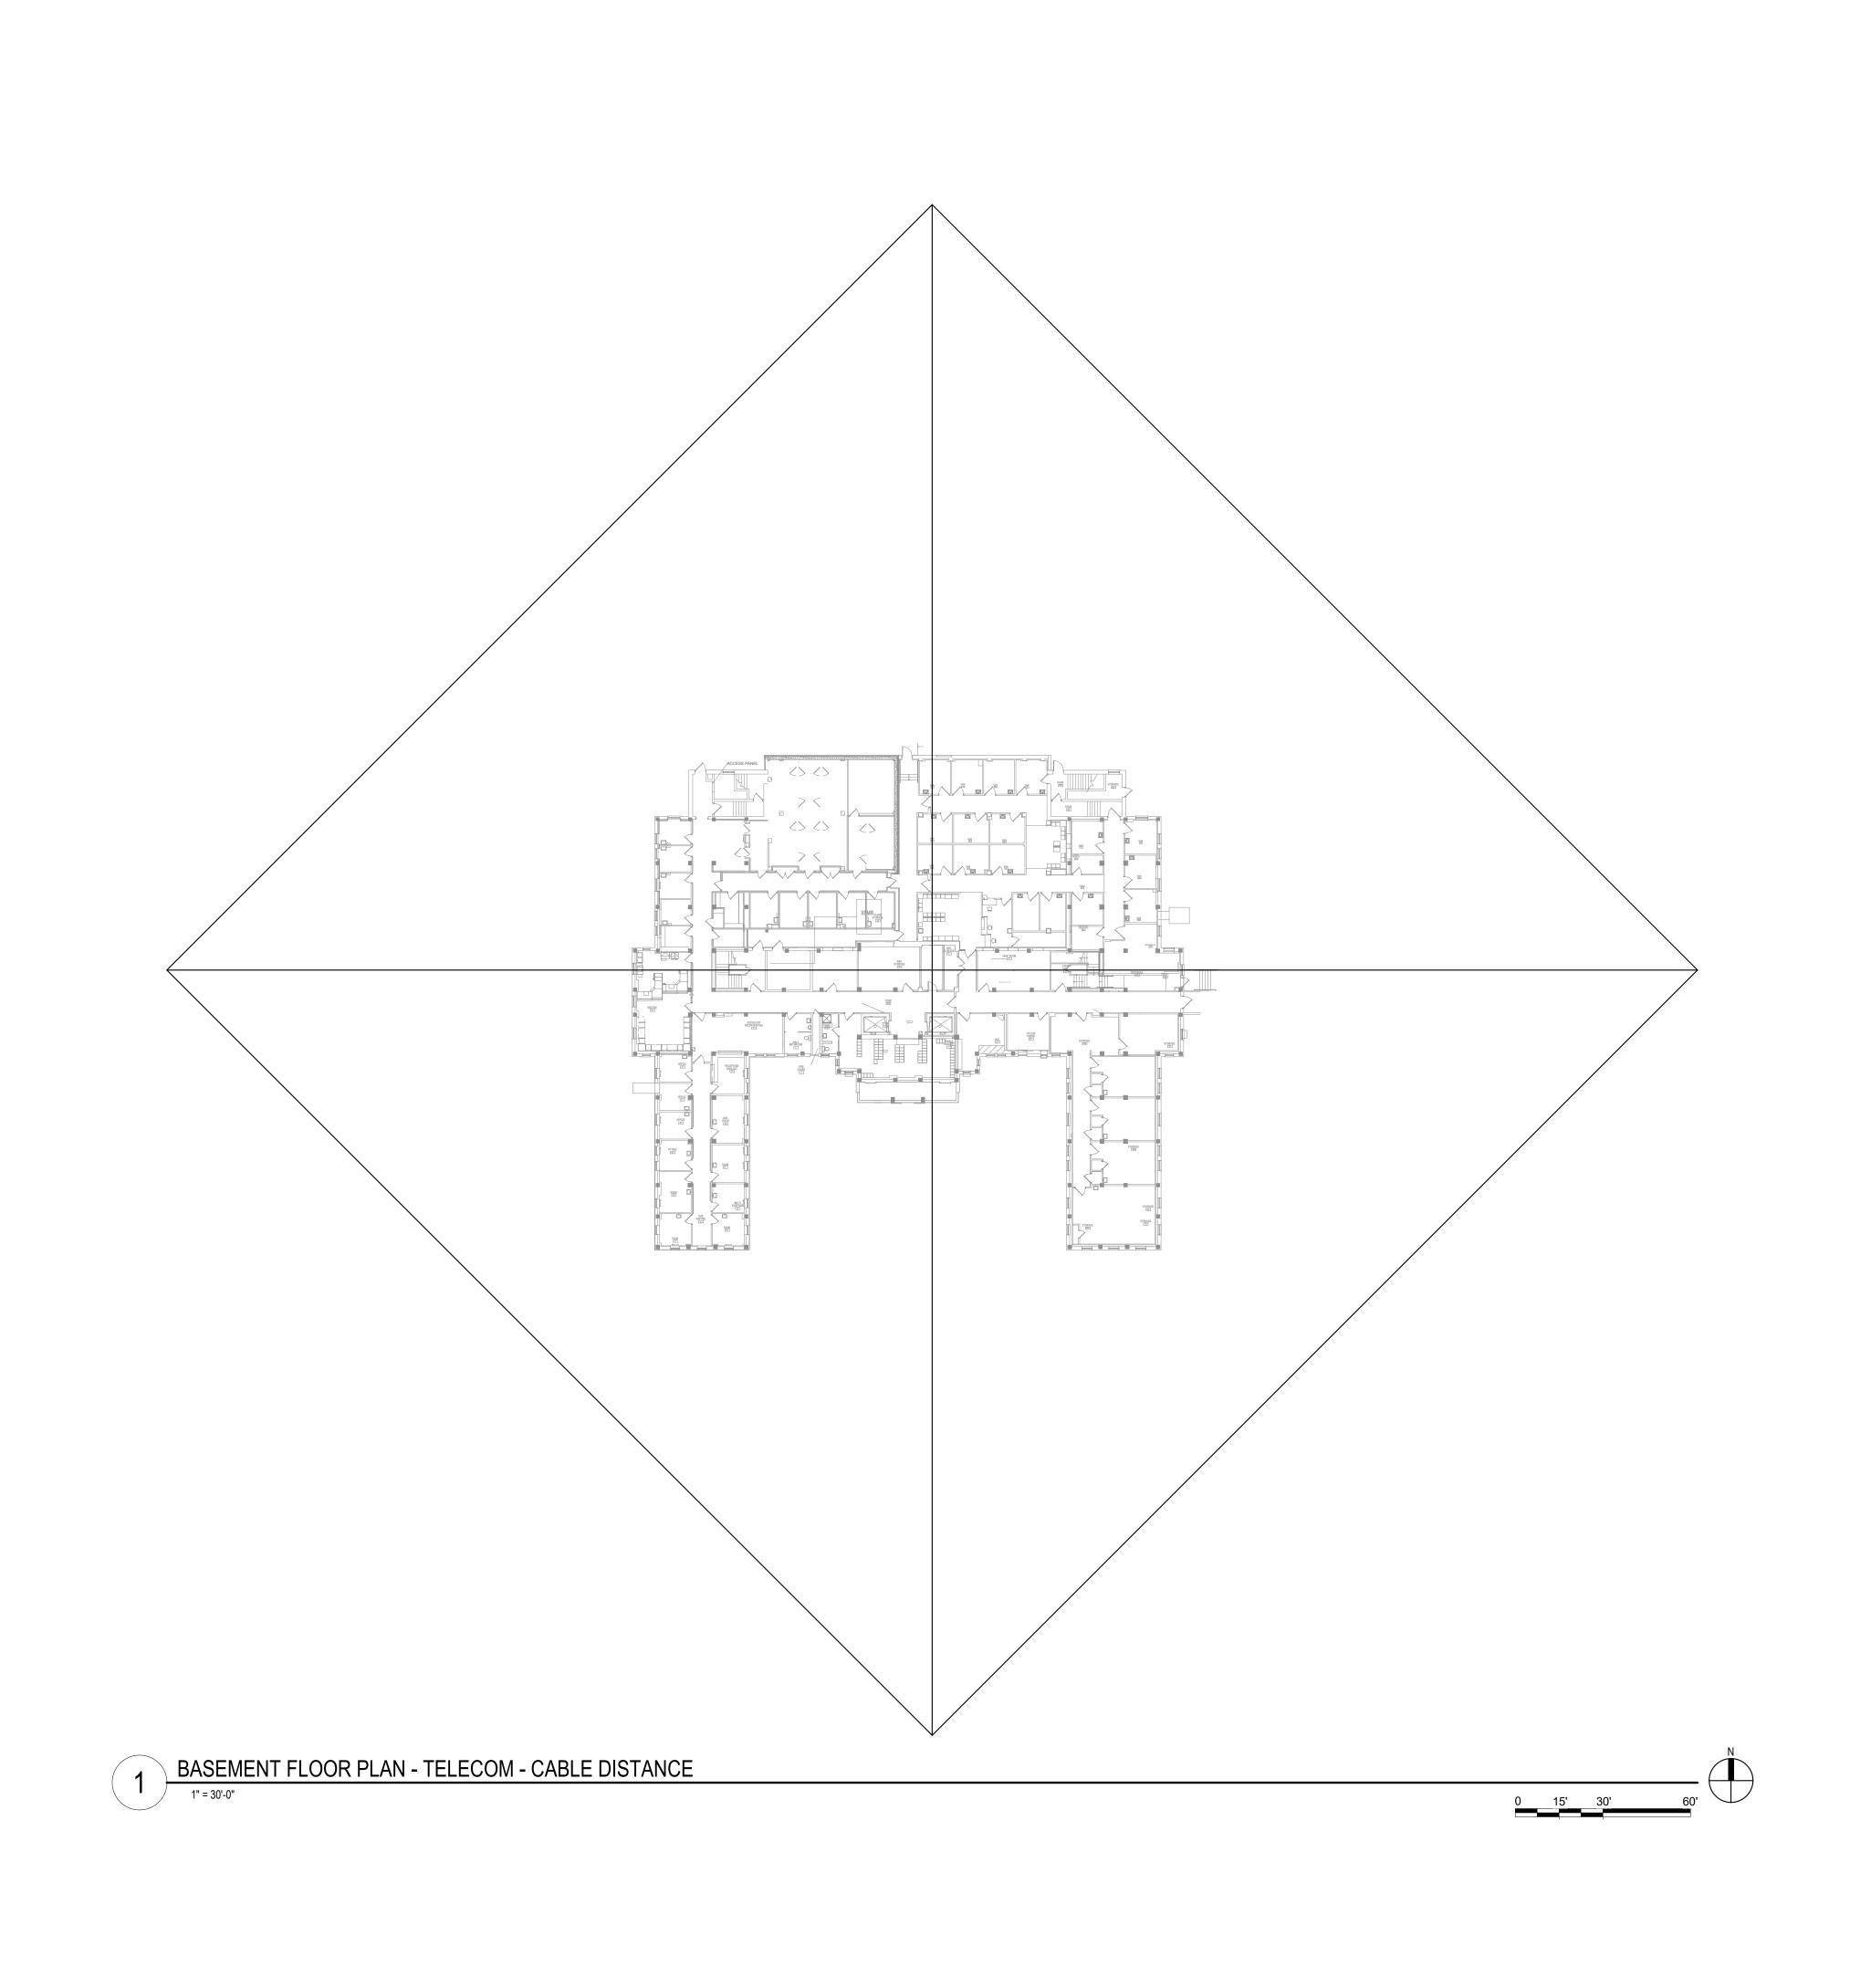
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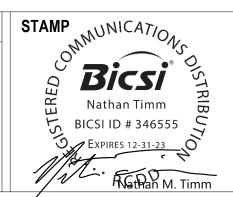
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BASEMENT FLOOR PLAN -TELECOM - CABLE DISTANCE

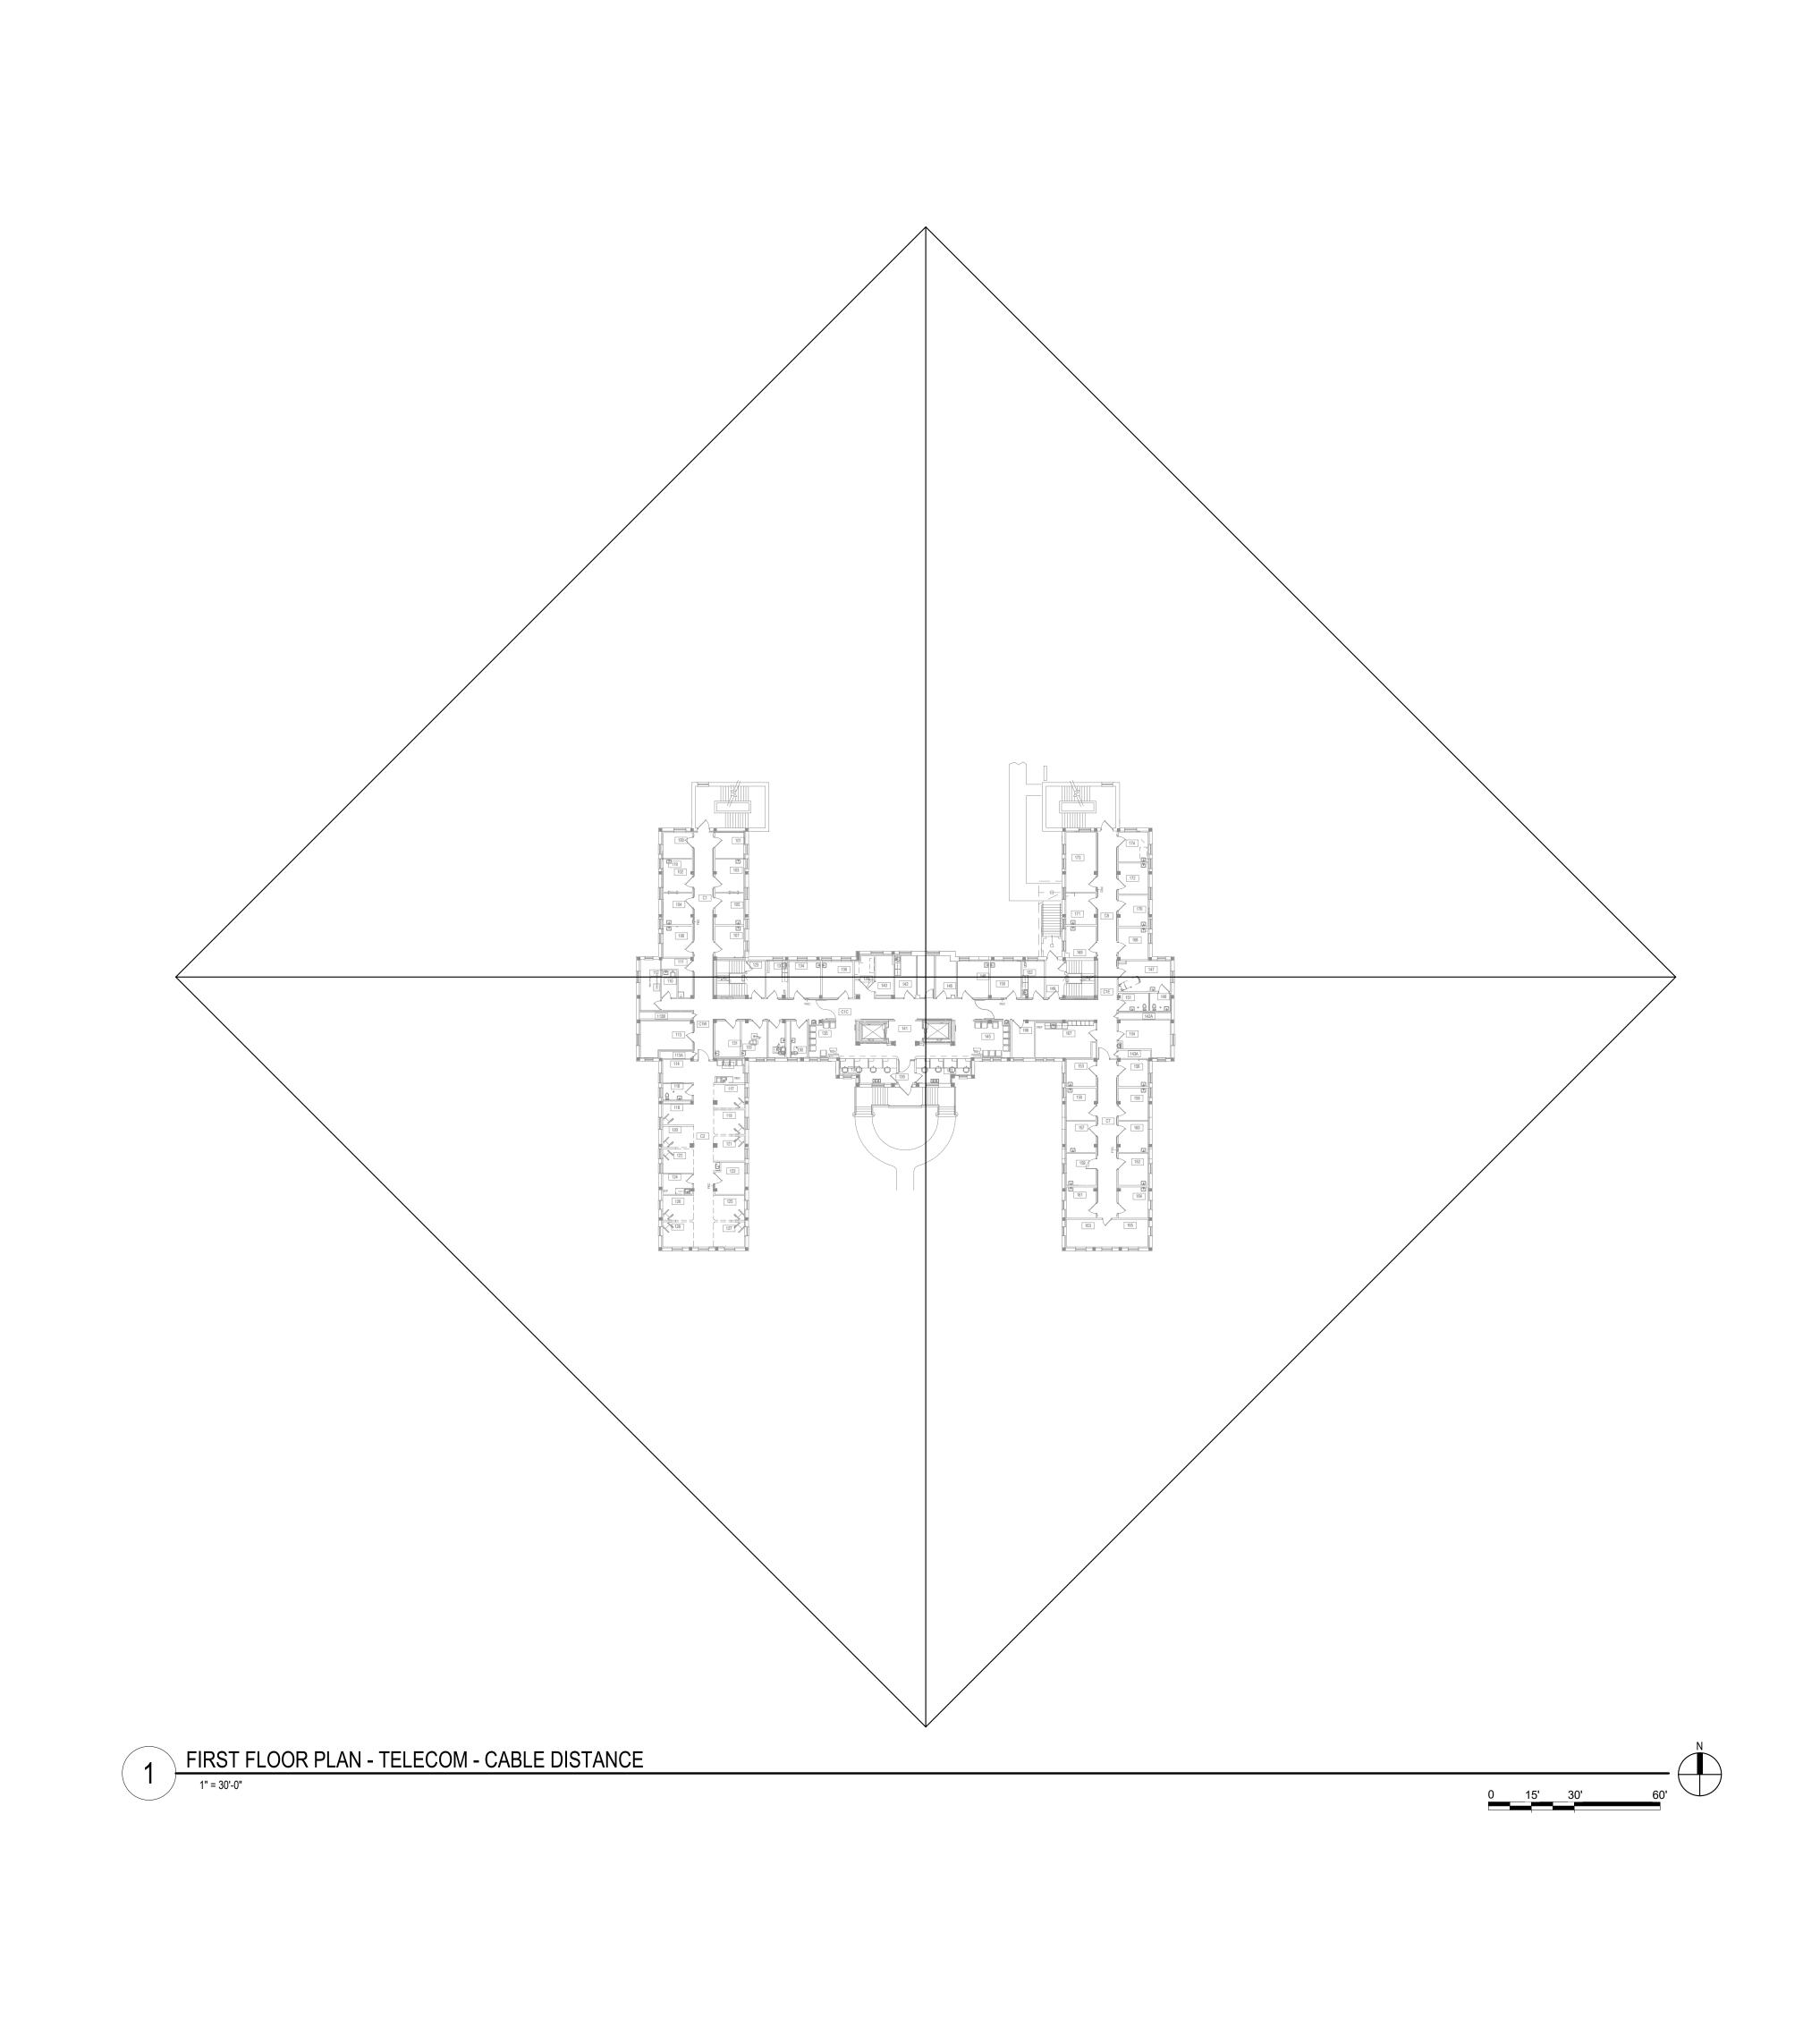
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LOCATION
VA MEDICAL CENTER
ST.CLOUD, MN 56303

03/30/2022 CHECKED BY DRAWN DRAWING NO. 29-TN200





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FIRST FLOOR PLAN TELECOM - CABLE DISTANCE

EHRM INFRASTRUCTURE UPGRADES

DATE:
03/30/2022
PLOT SCALE

PROJECT NO.
656-21-235

DRAWING NO.
29-TN210



BUILDING No

29

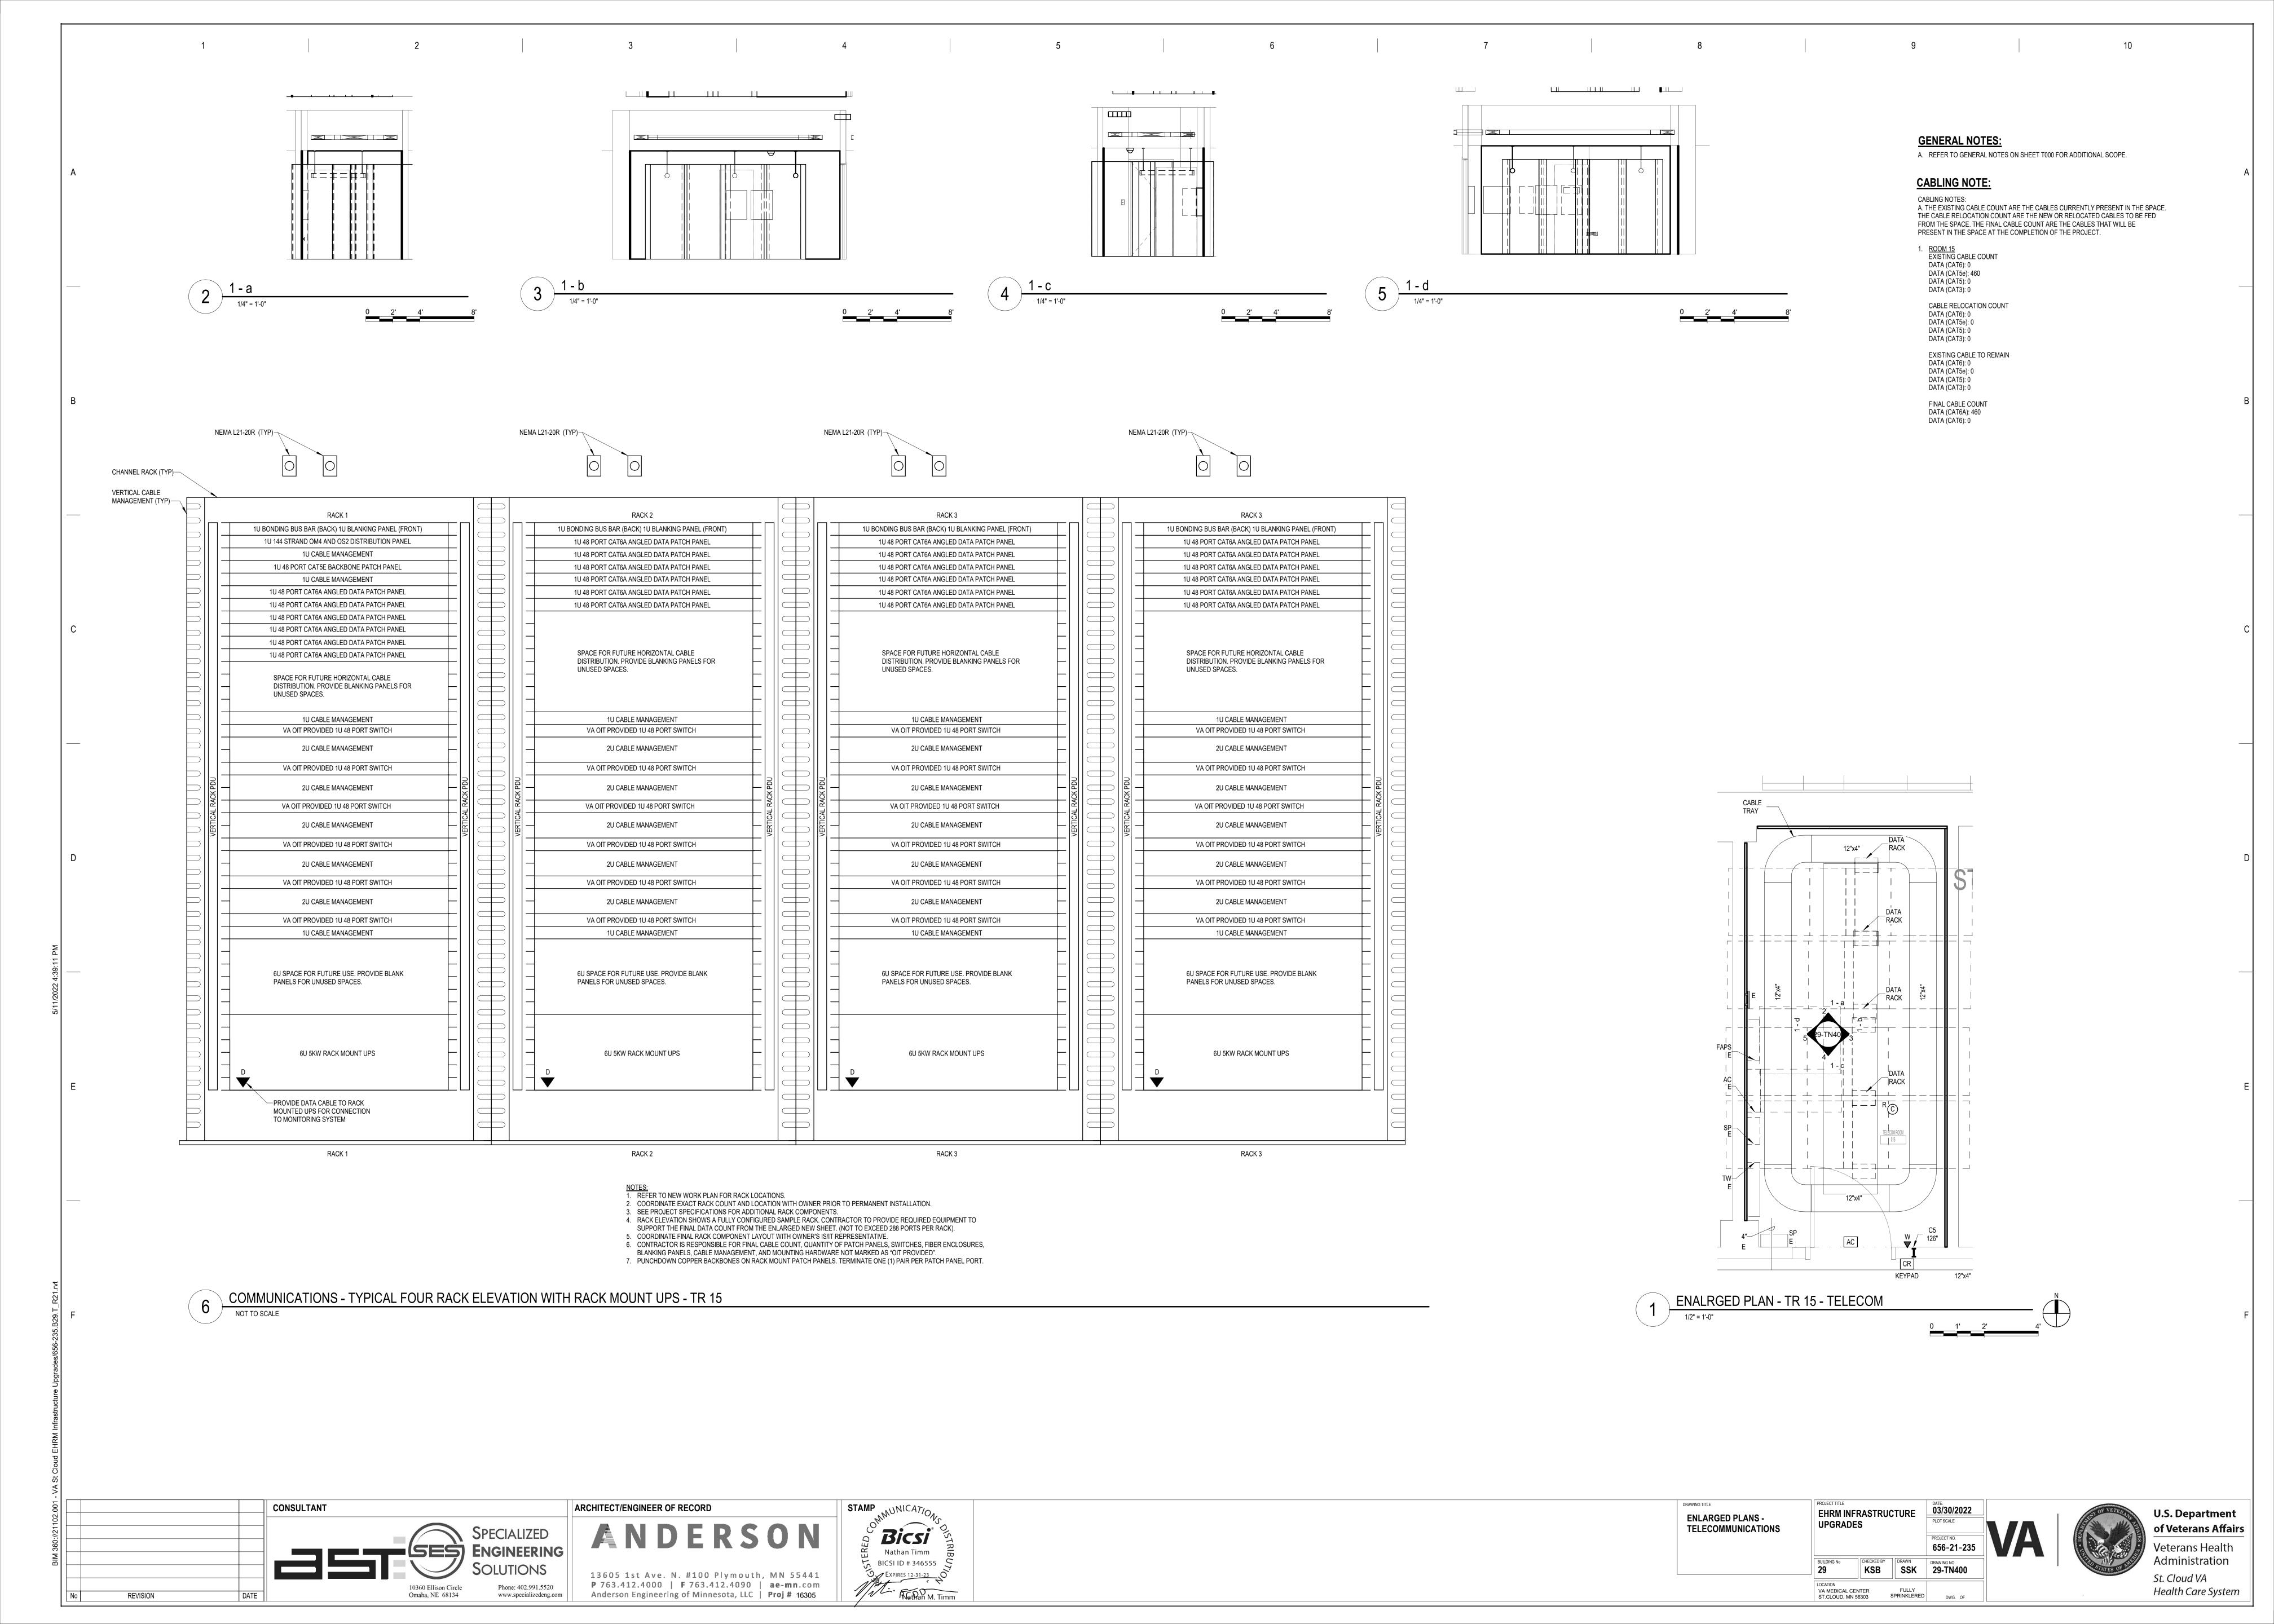
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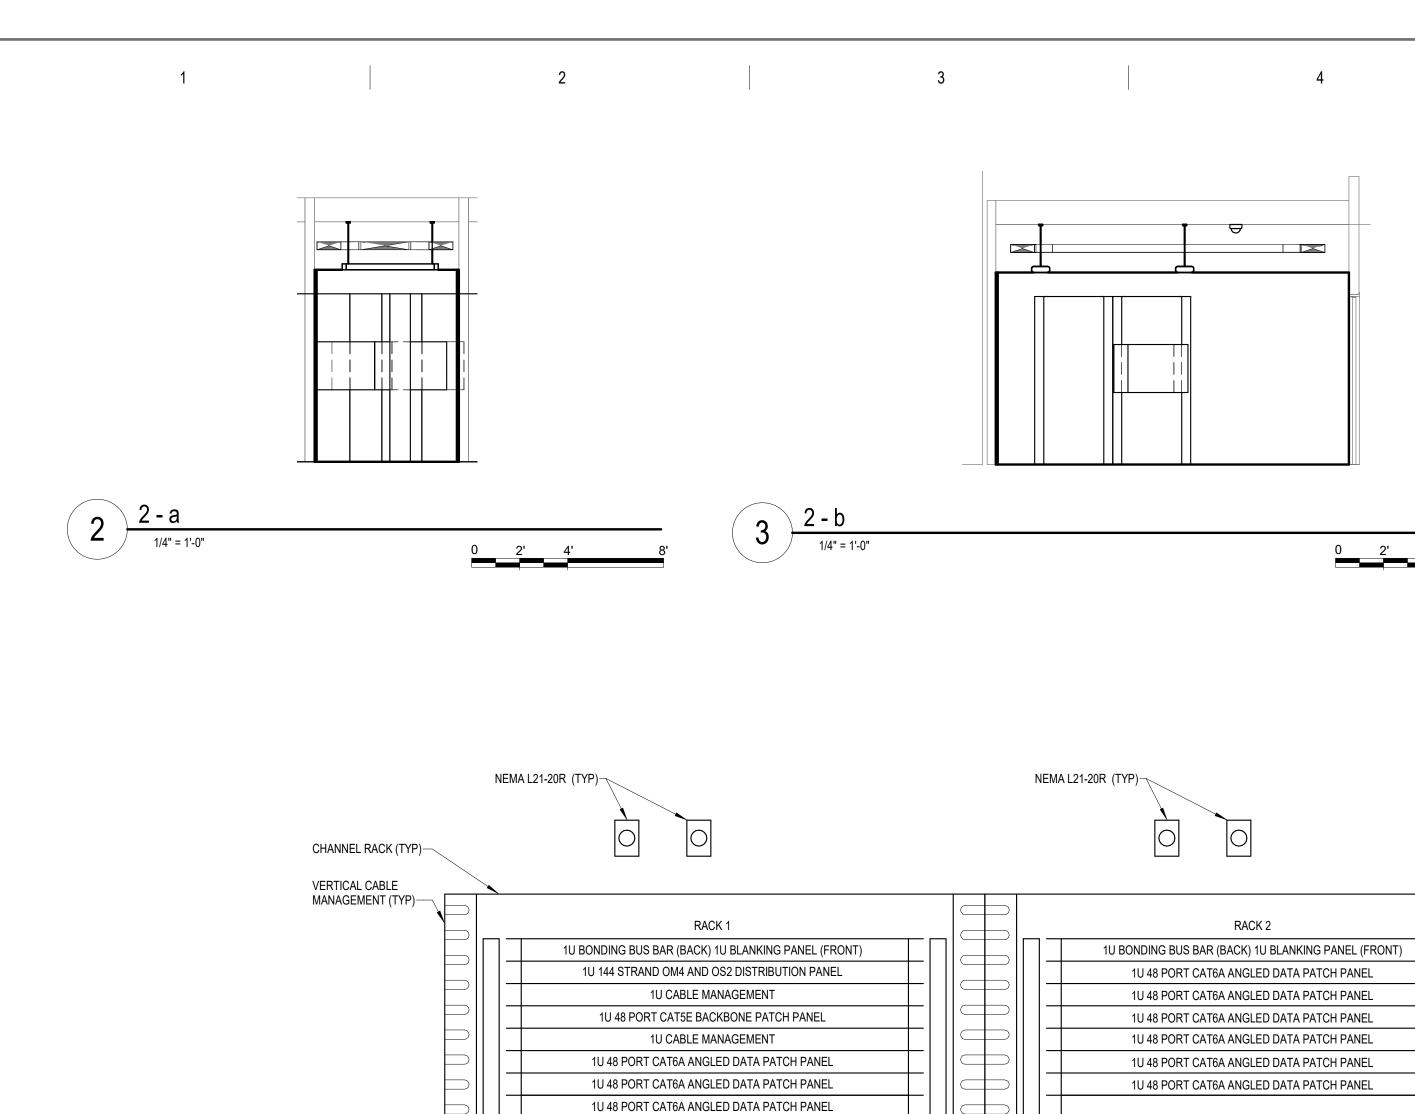
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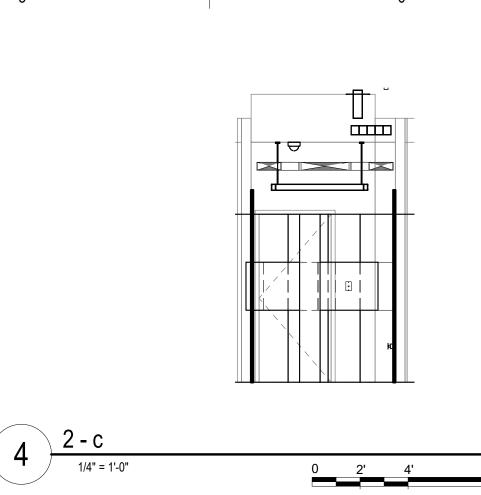
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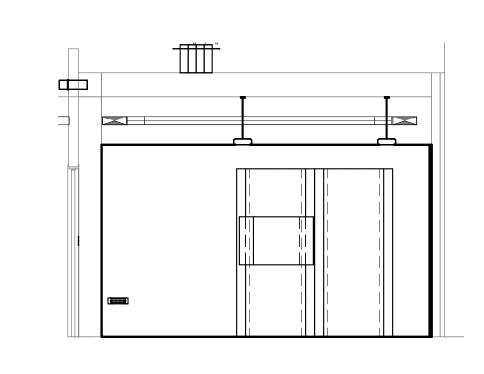
LOCATION
VA MEDICAL CENTER
ST. CLOUD, MN 56303

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1/4" = 1'-0"

0 2' 4'

GENERAL NOTES:

A. REFER TO GENERAL NOTES ON SHEET T000 FOR ADDITIONAL SCOPE.

CABLING NOTE:

CABLING NOTES:
A. THE EXISTING CABLE COUNT ARE THE CABLES CURRENTLY PRESENT IN THE SPACE.
THE CABLE RELOCATION COUNT ARE THE NEW OR RELOCATED CABLES TO BE FED
FROM THE SPACE. THE FINAL CABLE COUNT ARE THE CABLES THAT WILL BE
PRESENT IN THE SPACE AT THE COMPLETION OF THE PROJECT.

1. ROOM 144
EXISTING CABLE COUNT
DATA (CAT6): 0
DATA (CAT5e): 484
DATA (CAT5): 0
DATA (CAT3): 0

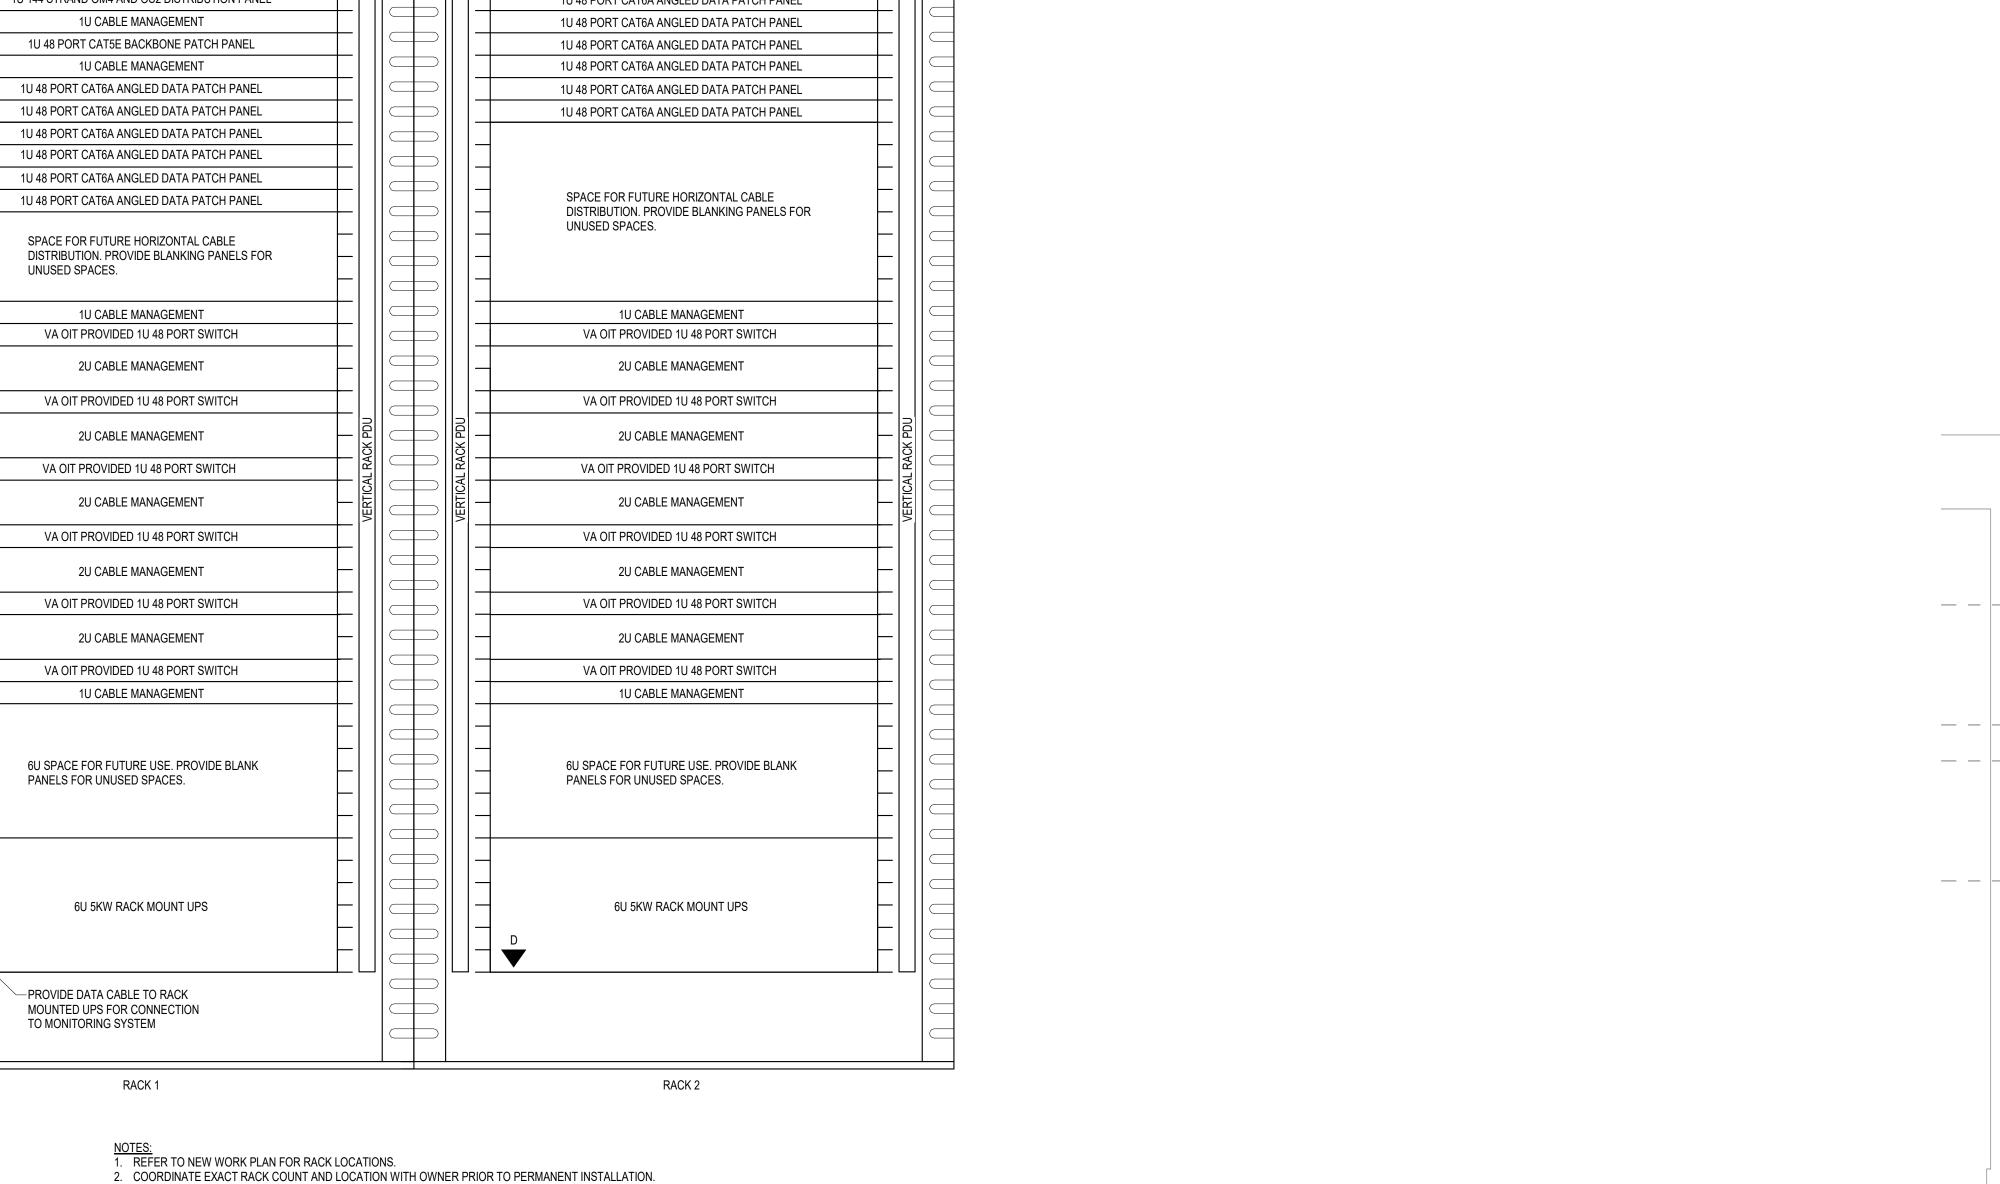
CABLE RELOCATION COUNT DATA (CAT6): 0 DATA (CAT5e): 0 DATA (CAT5): 0

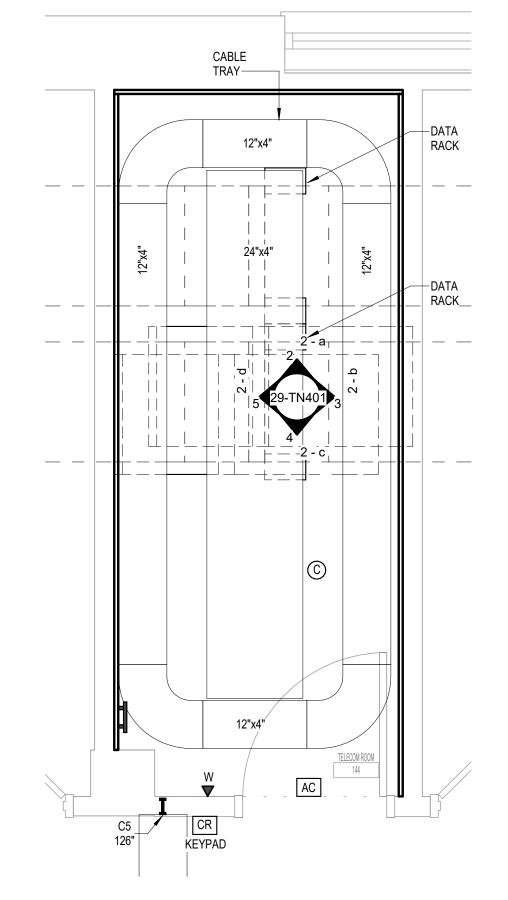
DATA (CAT3): 0

EXISTING CABLE TO REMAIN DATA (CAT6): 0
DATA (CAT5e): 0

DATA (CAT5): 0 DATA (CAT3): 0 FINAL CABLE COUNT DATA (CAT6A): 484

DATA (CAT6): 0





1 ENALRGED PLAN - TR 144 - TELECOM

0 1' 2' 4'

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DATE

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COMMUNICATIONS - TYPICAL TWO RACK ELEVATION WITH RACK MOUNT UPS - TR 144

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3. SEE PROJECT SPECIFICATIONS FOR ADDITIONAL RACK COMPONENTS.

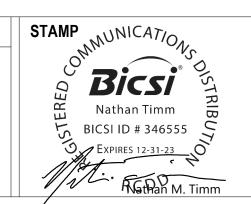
5. COORDINATE FINAL RACK COMPONENT LAYOUT WITH OWNER'S IS/IT REPRESENTATIVE.

4. RACK ELEVATION SHOWS A FULLY CONFIGURED SAMPLE RACK. CONTRACTOR TO PROVIDE REQUIRED EQUIPMENT TO SUPPORT THE FINAL DATA COUNT FROM THE ENLARGED NEW SHEET. (NOT TO EXCEED 288 PORTS PER RACK).

6. CONTRACTOR IS RESPONSIBLE FOR FINAL CABLE COUNT, QUANTITY OF PATCH PANELS, SWITCHES, FIBER ENCLOSURES,

7. PUNCHDOWN COPPER BACKBONES ON RACK MOUNT PATCH PANELS. TERMINATE ONE (1) PAIR PER PATCH PANEL PORT.

BLANKING PANELS, CABLE MANAGEMENT, AND MOUNTING HARDWARE NOT MARKED AS "OIT PROVIDED".





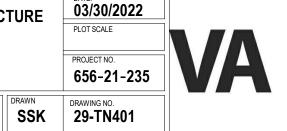


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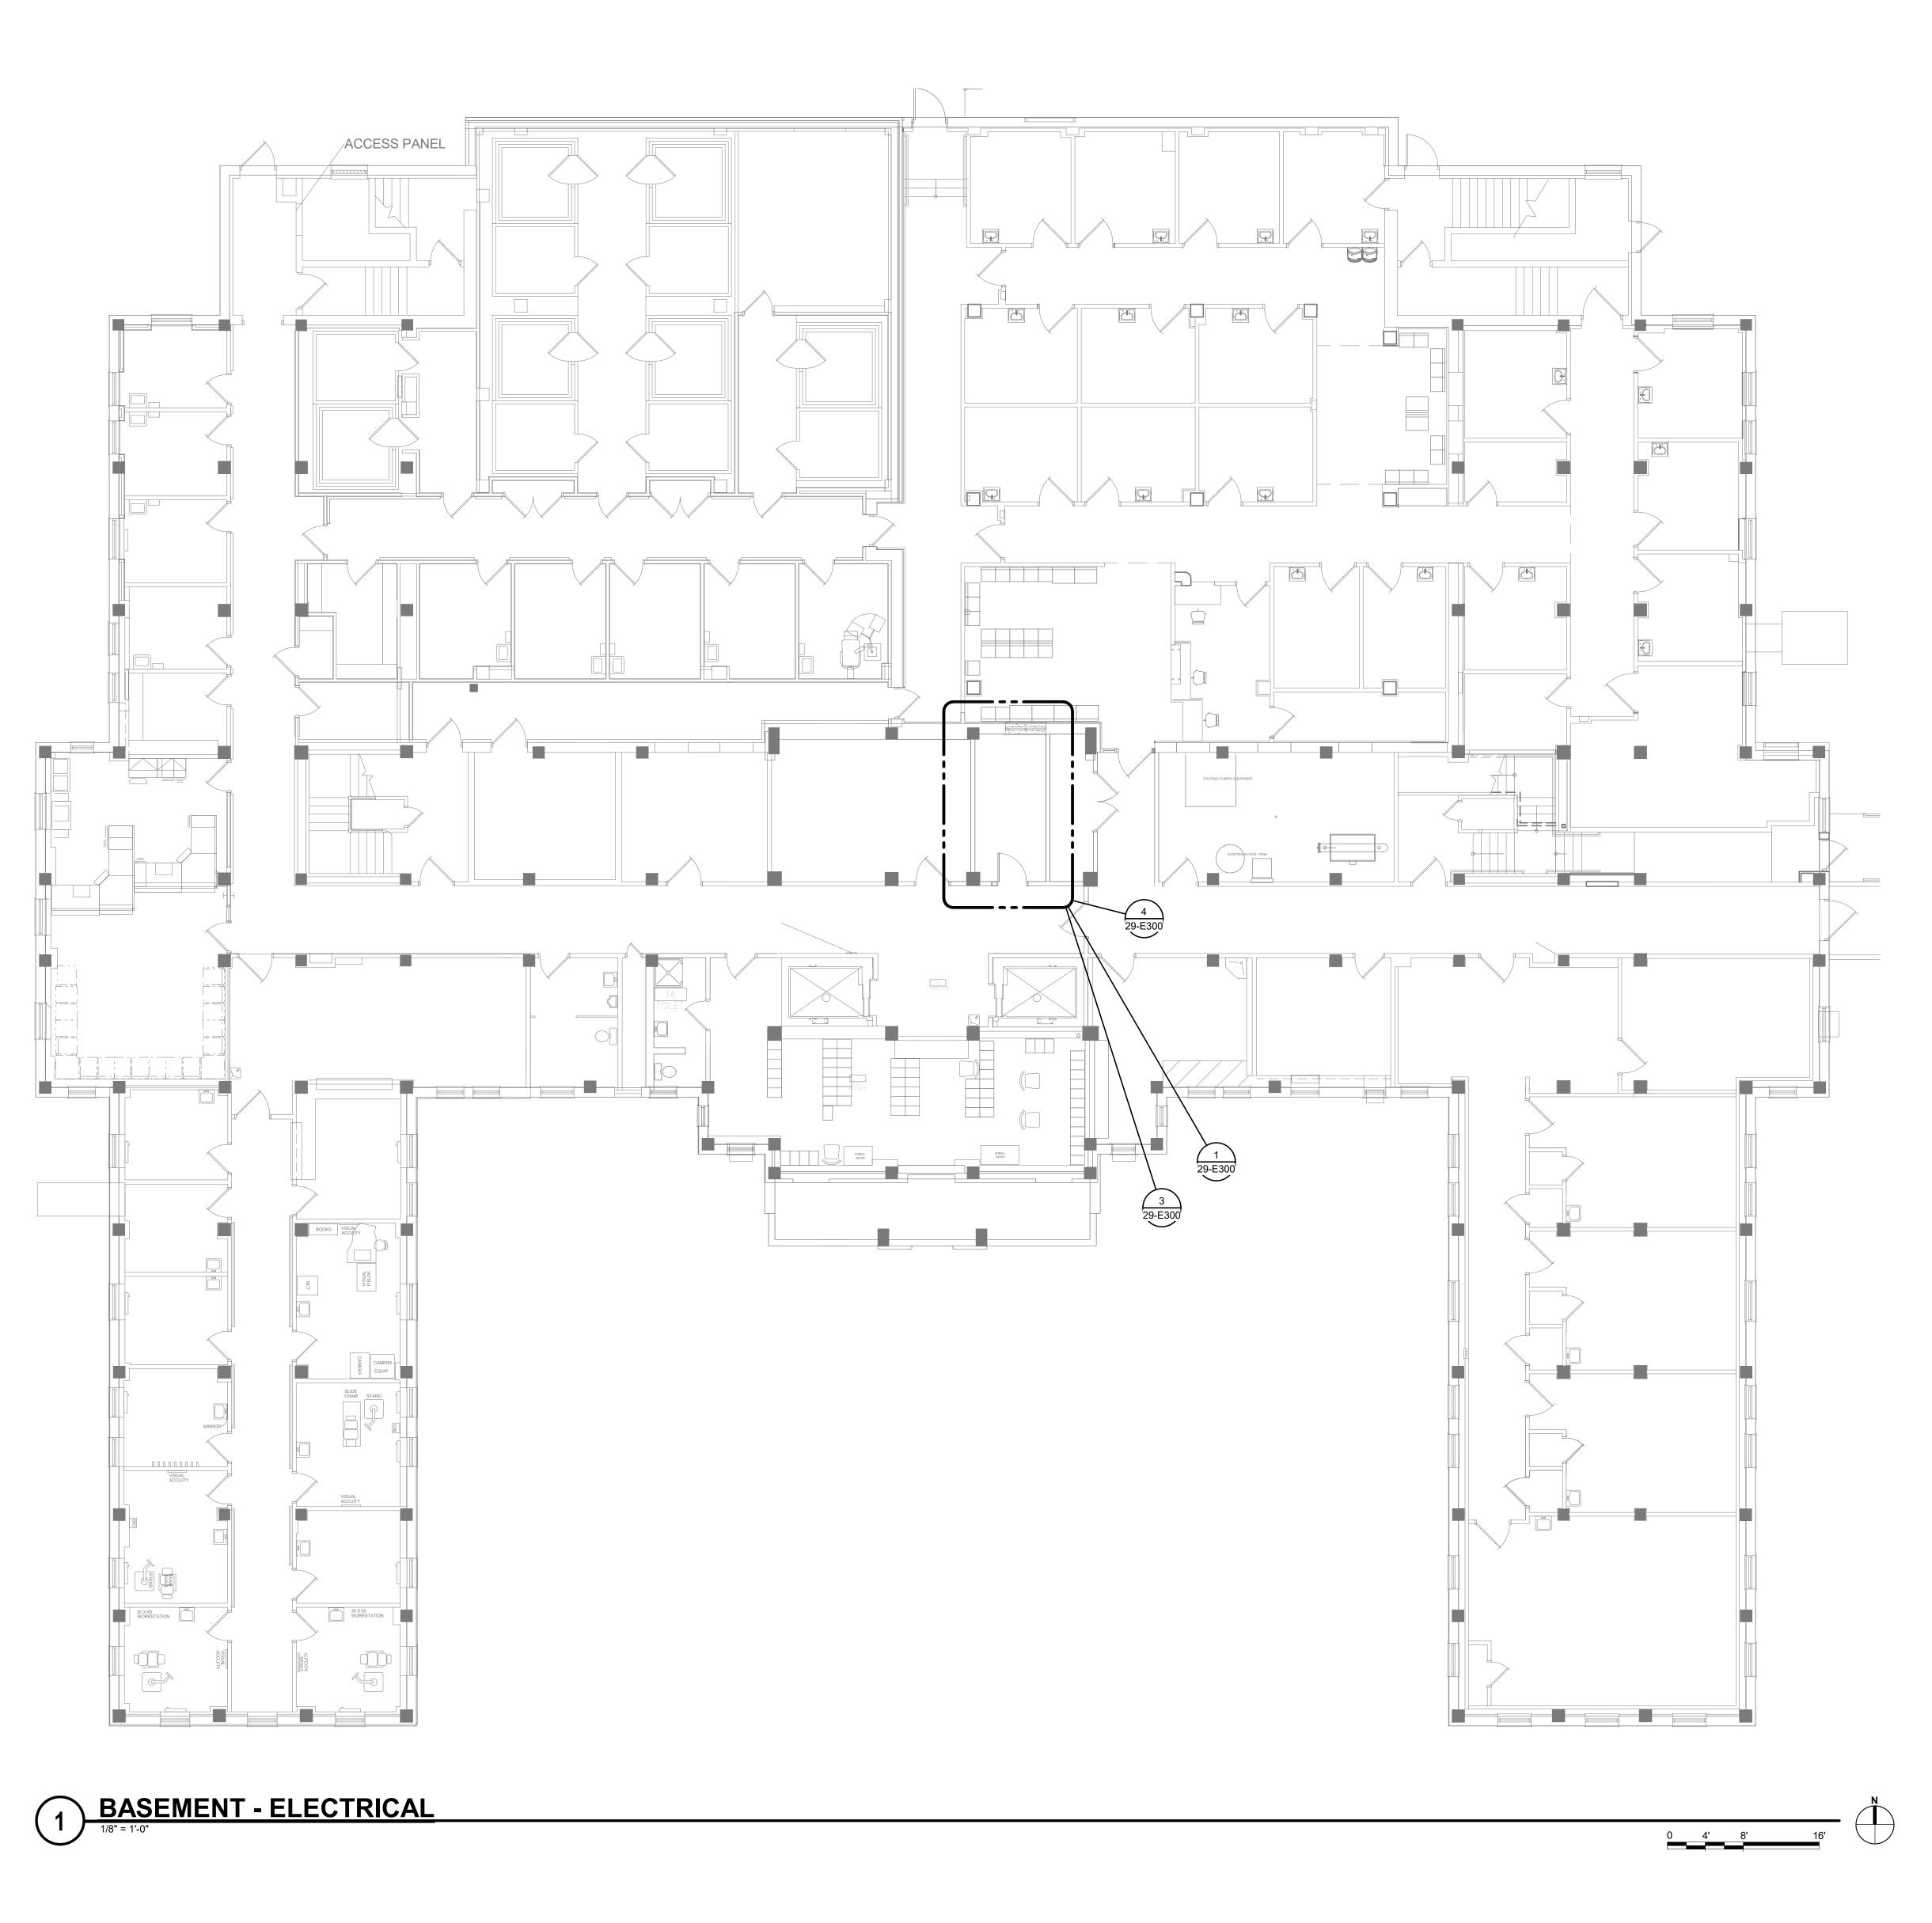
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BUILDING No

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BASEMENT - ELECTRICAL

| PROJECT TILE | EHRM INFRASTRUCTURE | UPGRADES | PROJECT TILE | PROJECT

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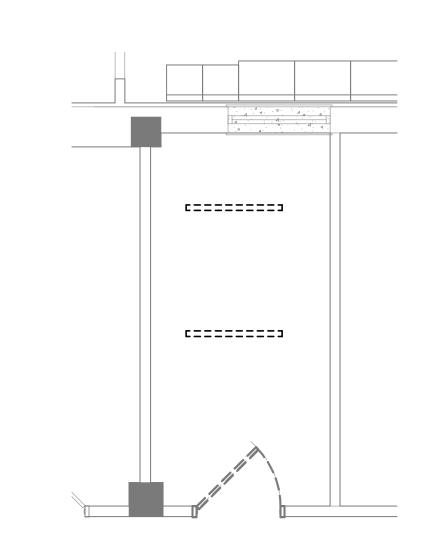
Veterans Health Administration

Health Care System

St. Cloud VA

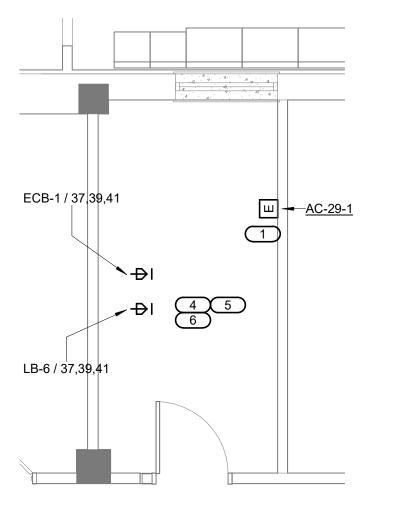
TBD GJL

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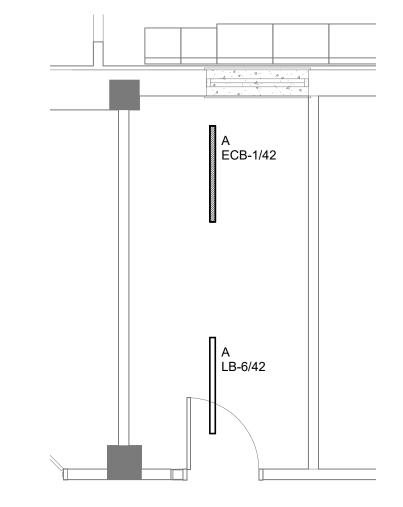
BASEMENT DEMOLITION - TR 015 -3 ELECTRICAL

1/4" = 1'-0"



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BASEMENT - TR 015 - POWER & SYSTEMS



BASEMENT - TR 015 - LIGHTING



SHEET NOTES:

REFER TO TECHNOLOGY PLANS FOR IT ROOM LAYOUT AND RACK LAYOUT/DETAILS. REFER TO SHEET 0-GE400 DETAIL FOR LAYOUT & ONE-LINE OF RACK.

KEYNOTES:

INDOOR UNIT TO BE POWERED BY OUTDOOR UNIT. COORDINATE EXACT LOCATION WITH . CONNECT SMOKE DETECTOR TO NEAREST EXISTING SLC. DISCONNECT AND REMOVE EXISTING LIGHTS AND RECEPTACLES IN ROOM. MAINTAIN CIRCUIT CONTINUITY TO ADJOINING ROOMS. COORDINATE FINAL LOCATION OF RECEPTACLE L21-20R WITH TELECOM CONTRACTOR. PROVIDE 3/4"C-4#12, 1#12 GND TO PANEL FOR EACH RECEPTACLE. PROVIDE EATON BLADEUPS, 5KW, 120/208V, 3 PHASE,4-WIRE RACK MOUNTED UPS FOR EACH RACK TOWER. PROVIDE APC#AP8861 RPDU RACK PDU 2G WITH L21-20P CORD. (120/208V, 3-PHASE, 20A, ZERO U, 5.7 KW, 208V, (36) C13 (6) C19 (2) 5-20R OUTLETS. PROVIDE TWO PER RACK, MOUNTED PER MANUFACTURER'S REQUIREMENTS. PROVIDE ONE RACK MOUNTED ZONE PDU UNIT. 30 AMP 3 PHASE, 120/208V, 5-WIRE WITH (4) L21-30R, (6) 5-20R AND TWO 10' POWER CORDS. ZONIT#ZPDS-208V-30A-L21-4L21-20R-PROVIDE TWO J-BOXES IN CEILING OVER THE CENTER RACK, IN LIEU OF RECEPTACLES . PROVIDE 1"C – 4#8, & 1#8 GND BACK TO A 60A/3P BREAKER IN THE PANEL FOR EACH PROVIDE ONE RACK MOUNTED ZONE PDU UNIT. 60 AMP, 3 PHASE, 120/208V, 5 WIRE WITH (6) L21-20R AND TWO 10' POWER CORDS. ZONIT

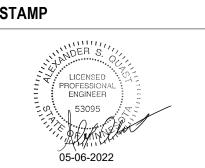
ZPDS-208V60A-HW-6L21-20R.

10. PROVIDE 60A/3P BREAKER AT THE PANEL

CIRCUITED.

L1-2 / 37,39,41

FIRST FLOOR - TR 144 - POWER & 2 SYSTEMS
1/4" = 1'-0"



ELECTRICAL ENLARGED

EHRM INFRASTRUCTURE

LOCATION

VA MEDICAL CENTER

ST.CLOUD, MN 56303

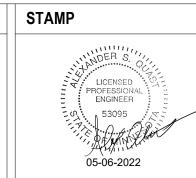
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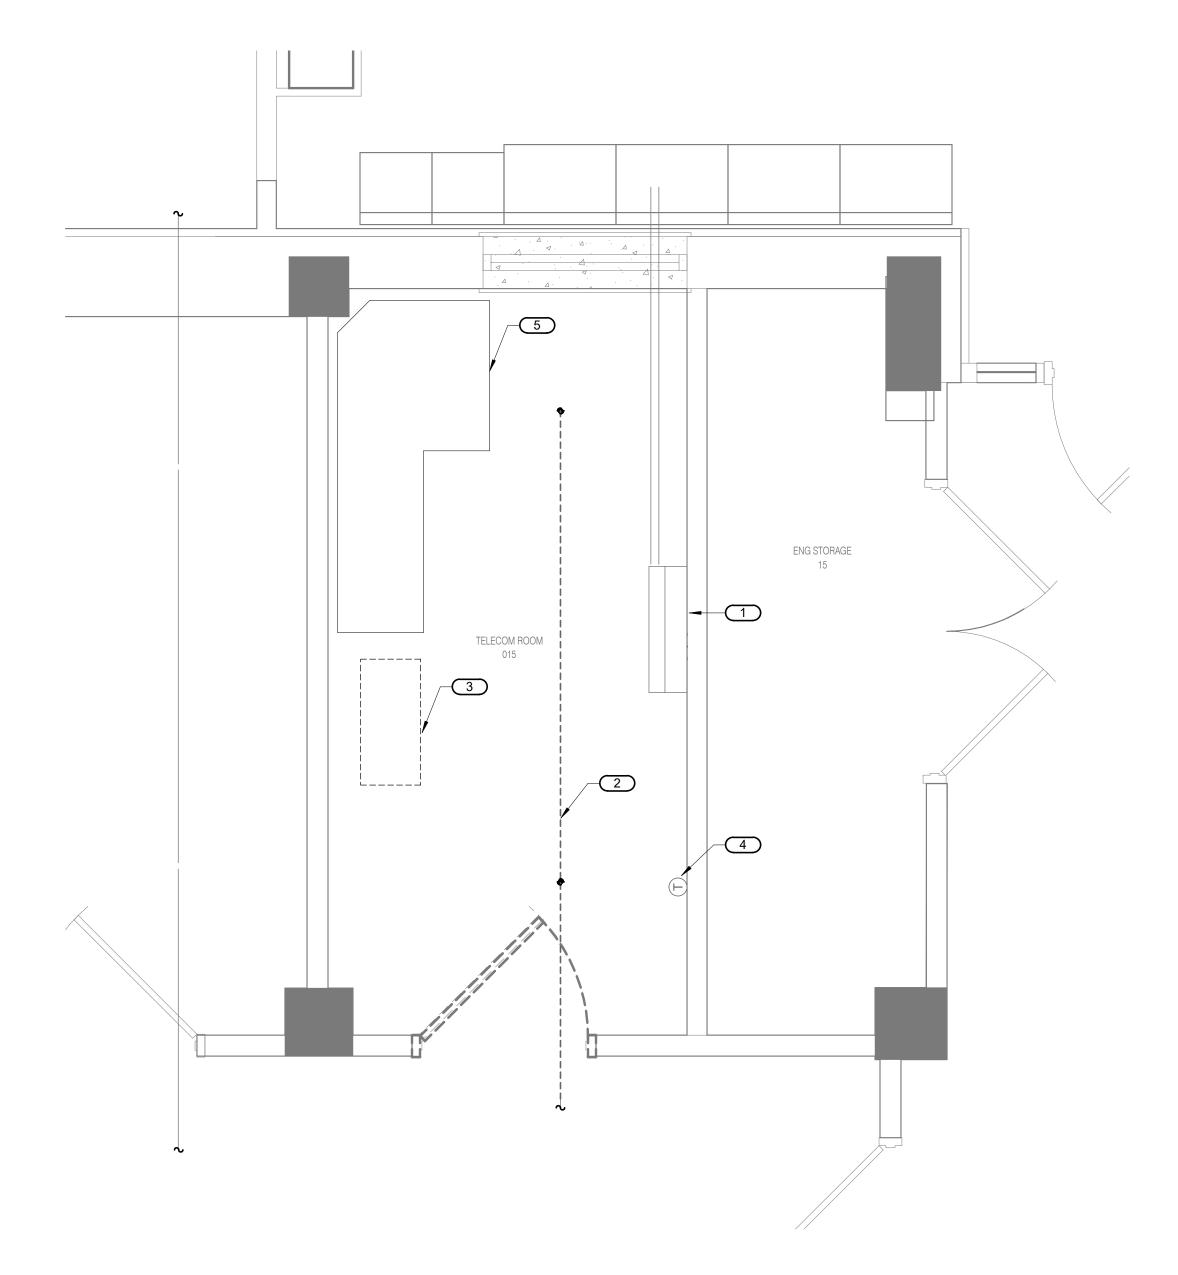
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ARCHITECT/ENGINEER OF RECORD ANDERSON 13605 1st Ave. N. #100 Plymouth, MN 55441 P 763.412.4000 | F 763.412.4090 | ae-mn.com Anderson Engineering of Minnesota, LLC | Proj # 16305



FIELD VERIFICATION NOTES

- 1. THE HVAC CONTRACTOR SHOULD VISIT THE SITE PRIOR TO BID TO FIELD VERIFY ALL EXISTING CONDITIONS WHICH MAY AFFECT THEIR BID. THE FOLLOWING ITEMS SHALL BE VERIFIED:
- A. EXACT PLACEMENT, SIZE, CAPACITY, MANUFACTURER, AND CONDITION OF ALL EXISTING HVAC EQUIPMENT WITHIN SCOPE OF WORK, WHETHER EXPLICITLY SHOWN OR NOT.
- B. SIZE AND LOCATION OF ALL EXISTING DUCTWORK.
- C. SIZE AND LOCATION OF ALL EXISTING GRILLES. REGISTERS AND DIFFUSERS.
- D. SIZE AND LOCATION OF ALL EXISTING THERMOSTATIC CONTROL DEVICES.
- E. SIZE AND LOCATION OF ALL EXISTING PLUMBING AND HYDRONIC PIPING.
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- 3. NO ADDITIONAL COMPENSATION WILL BE MADE AFTER THE PROJECT HAS BEEN AWARDED FOR FAILURE TO VERIFY EXISTING
- 4. ANY DISCREPANCIES WHICH MAY AFFECT THE CONTRACTORS BID SHALL BE BROUGHT TO THE ATTENTION OF THE ENGINEER AND



2 8 9

BASEMENT DEMOLITION - MECHANICAL

BASEMENT DEMOLITION -**MECHANICAL**

KEYNOTES 1/29-M100: #

1/29-M200FOR NEW.

EXISTING DUCTLESS SPLIT SYSTEM TO REMAIN.

EXISTING RACK TO BE DEMOLISHED BY OTHERS.

EXTENSION. FIELD VERIFY REQUIREMENTS.

EXISTING THERMOSTAT TO REMAIN.

EXISTING FIRE SPRINKLER LINE. DEMOLISH BACK AND CAP. SEE

AREA OF EXISTING PIPE DRIP FOR EXTENSION. SEE 1/29-M200 FOR DRIP PAN

EHRM INFRASTRUCTURE

VA MEDICAL CENTER ST.CLOUD, MN 56303

RDL DRAWN

FULLY SPRINKLERED



U.S. Department of Veterans Affairs Veterans Health Administration St. Cloud VA Health Care System

CONSULTANT 100% CD 03/30 DATE

REVISION



ARCHITECT/ENGINEER OF RECORD 13605 1st Ave. N. #100 Plymouth, MN 55441 P 763.412.4000 | F 763.412.4090 | ae-mn.com

I hereby certify that this plan, specification or report was prepared by me log under my direct supervision and that I am a duly Licensed Engineer under the laws of the State of Minnesota. Date: 03/30/2022 Anderson Engineering of Minnesota, LLC | Proj # 16305

STAMP

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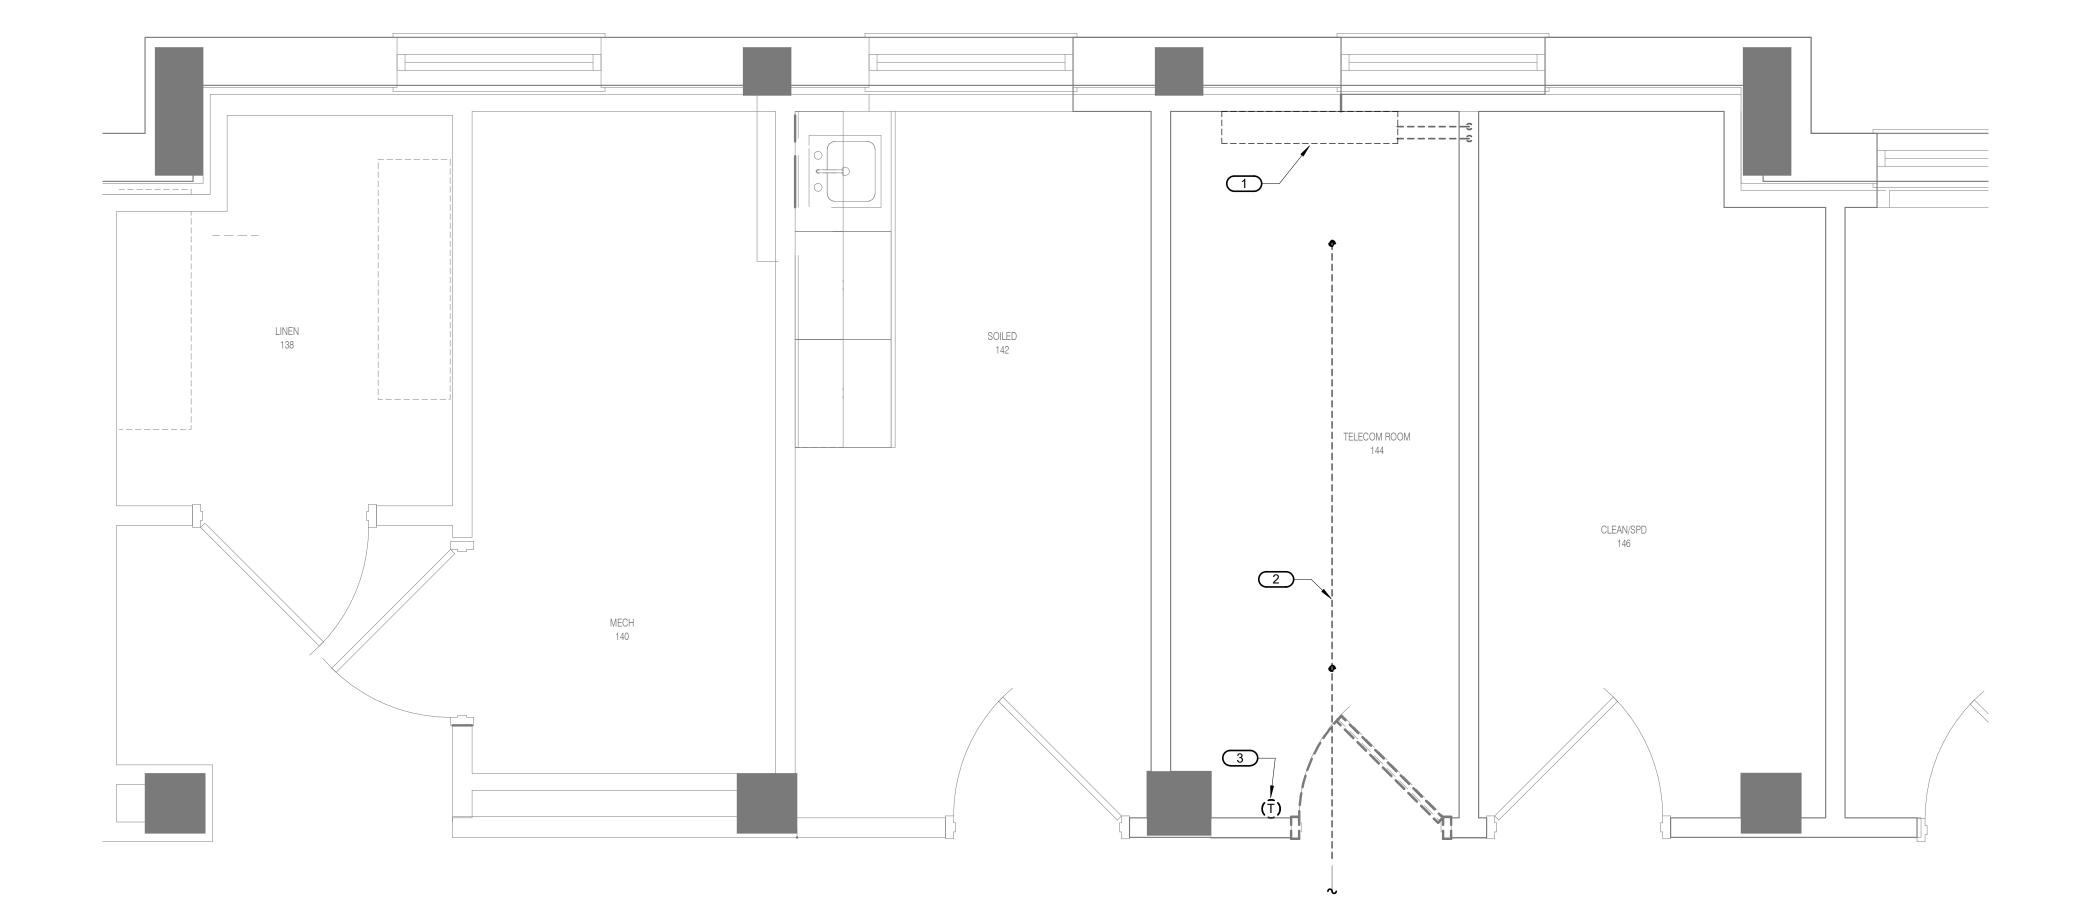
KEYNOTES 1/29-M101: #

DEMO EXISTING UNIT CONVECTOR AND CONTROLS. CAP PIPES IN PREPARATION FOR NEW CUH. FIELD VERIFY REQUIREMENTS.

REMOVE AND DIPOSE OF EXISTING FIRE SPRINKLER HEADS AND PIPING BACK

TO LOCATION SHOWN AND PREPARE FOR RECONNECTION AND REROUTING.

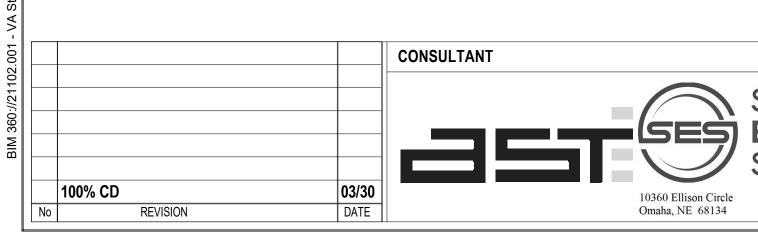
REMOVE AND DIPOSE OF EXISTING THERMOSTAT AND ASSOCIATED WIRING.

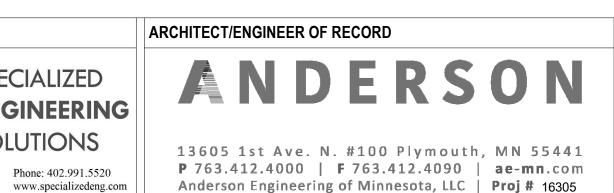


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FIRST FLOOR DEMOLITION

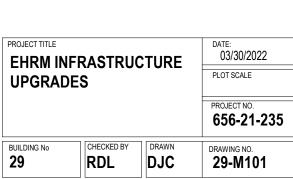












FULLY SPRINKLERED

VA MEDICAL CENTER ST.CLOUD, MN 56303





EXTEND EXISTING PIPE DRIP PAN TO SERVE ADDITIONAL PIPING IN AREAS SHOWN. FIELD VERIFY REQUIREMENTS. EXISTING THERMOSTAT TO REMAIN. EXTEND EXISTING FIRE SPRINKLER BRANCH LINES AND PROVIDE NEW SPRINKLER HEADS. FIELD VERIFY. ROUTE NEW REFRIGERANT PIPING EAST AND RISE INTO MECHANICAL ROOM 140. LOCATE AIR COOLED CONDENSING UNIT OUTSIDE NORTH EXTERIOR WALL OF ROOM 140. SEE 29-M201 FOR LOCATION. — RACK PROVIDED BY OTHERS — EXISTING WALL MOUNTED DUCTLESS COOLING UNIT 2 TELECOM ROOM 3 + ENG STORAGE BASEMENT FLOOR - MECHANICAL

CONSULTANT

03/30

DATE

100% CD

REVISION

ARCHITECT/ENGINEER OF RECORD

Phone: 402.991.5520

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Omaha, NE 68134

13605 1st Ave. N. #100 Plymouth, MN 55441

P 763.412.4000 | F 763.412.4090 | ae-mn.com

Anderson Engineering of Minnesota, LLC | Proj # 16305

STAMP

I hereby certify that this plan, specification or report was prepared by the log under my direct supervision and that I am a duly Licensed Engineer under the laws of the State of Minnesota.

Name:

| PROFESSIONAL ENGINEER 24706 / 1

Date: 03/30/2022

1 2 8

KEYNOTES 1/29-M200: #

EXISTING WALL MOUNTED SPLIT SYSTEM AC UNIT TO REMAIN.

EXISTING PIPE DRAIN PAN IN THIS AREA.

EHRM INFRASTRUCTURE UPGRADES

RDL DRAWN

FULLY SPRINKLERED

BUILDING No 29

LOCATION

VA MEDICAL CENTER

ST.CLOUD, MN 56303

BASEMENT FLOOR -

MECHANICAL

03/30/2022
PLOT SCALE

PROJECT NO.
656-21-235

DRAWING NO.
29-M200

U.S. Department
of Veterans Affairs

Veterans Health
Administration
St. Cloud VA
Health Care System

FIELD VERIFICATION NOTES

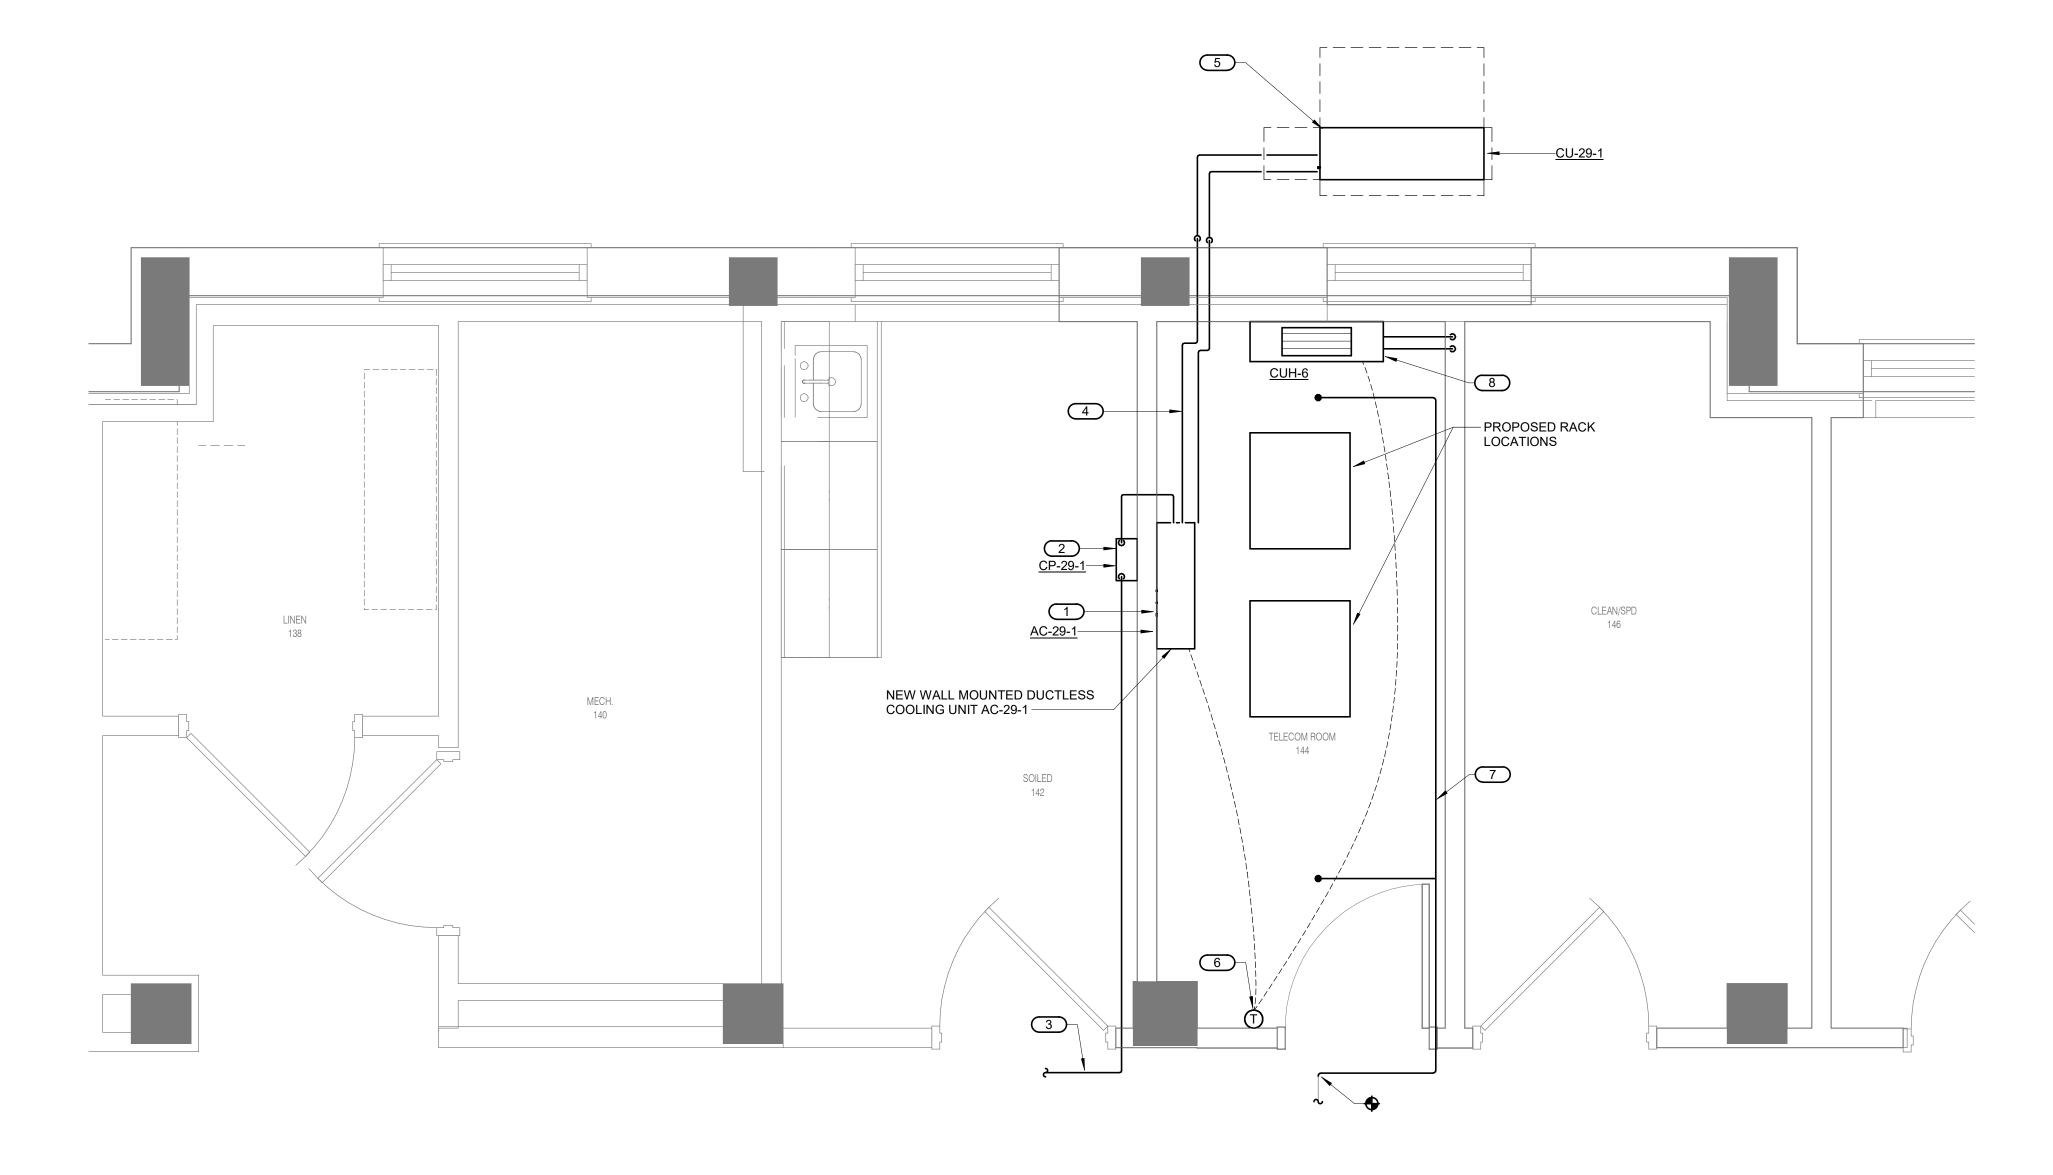
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- KEYNOTES 1/29-M201: #
- 1. PROVIDE NEW WALL MOUNTED SPLIT SYSTEM AC UNIT.
- 2. PROVIDE NEW CONDENSATE PUMP.
- ROUTE NEW 1" PUMPED CONDENSATE PIPE TO MOP SINK IN HAC 111, APPROXIMATELY 90 FEET WEST.
- ROUTE NEW REFRIGERANT PIPING TO NEW CONDENSING UNIT.
 PROVIDE NEW AIR COOLED CONDENSING UNIT ON GRADE. PROVIDE CONCRETE PAD. PROVIDE CONCRETE PAD. REFER TO REFRIGERANT PIPING

DETAIL 1/0-GM400 AND PAD MOUNTING DETAIL 3/0-GM400.

- PROVIDE NEW THERMOSTAT. WIRE COMMON TO AC UNIT AND CUH.
- 8. PROVIDE NEW CABINET UNIT HEATER. CONNECT TO EXISTING PIPING. FIELD VERIFY REQUIREMENTS.

EXTEND FIRE SPRINKLER LINE AND PROVIDE NEW SPRINKLER HEADS.

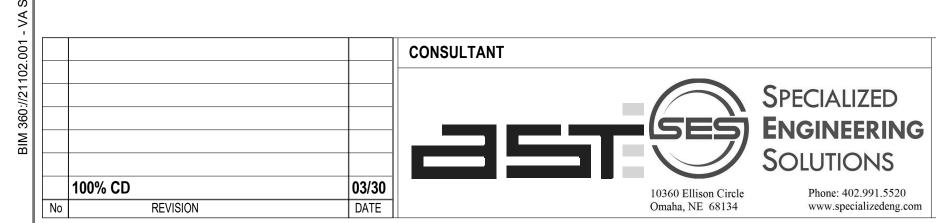


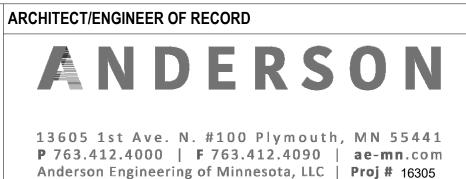
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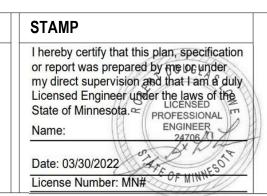
FIRST FLOOR - MECHANICAL - TELECOM 100B

1/2" = 1'-0"

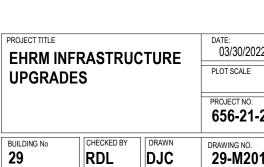
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