



# BUILDING 28 - EHRM INFRASTRUCTURE UPGRADES

St. Cloud VA Health Care System Main Campus, St. Cloud, Minnesota

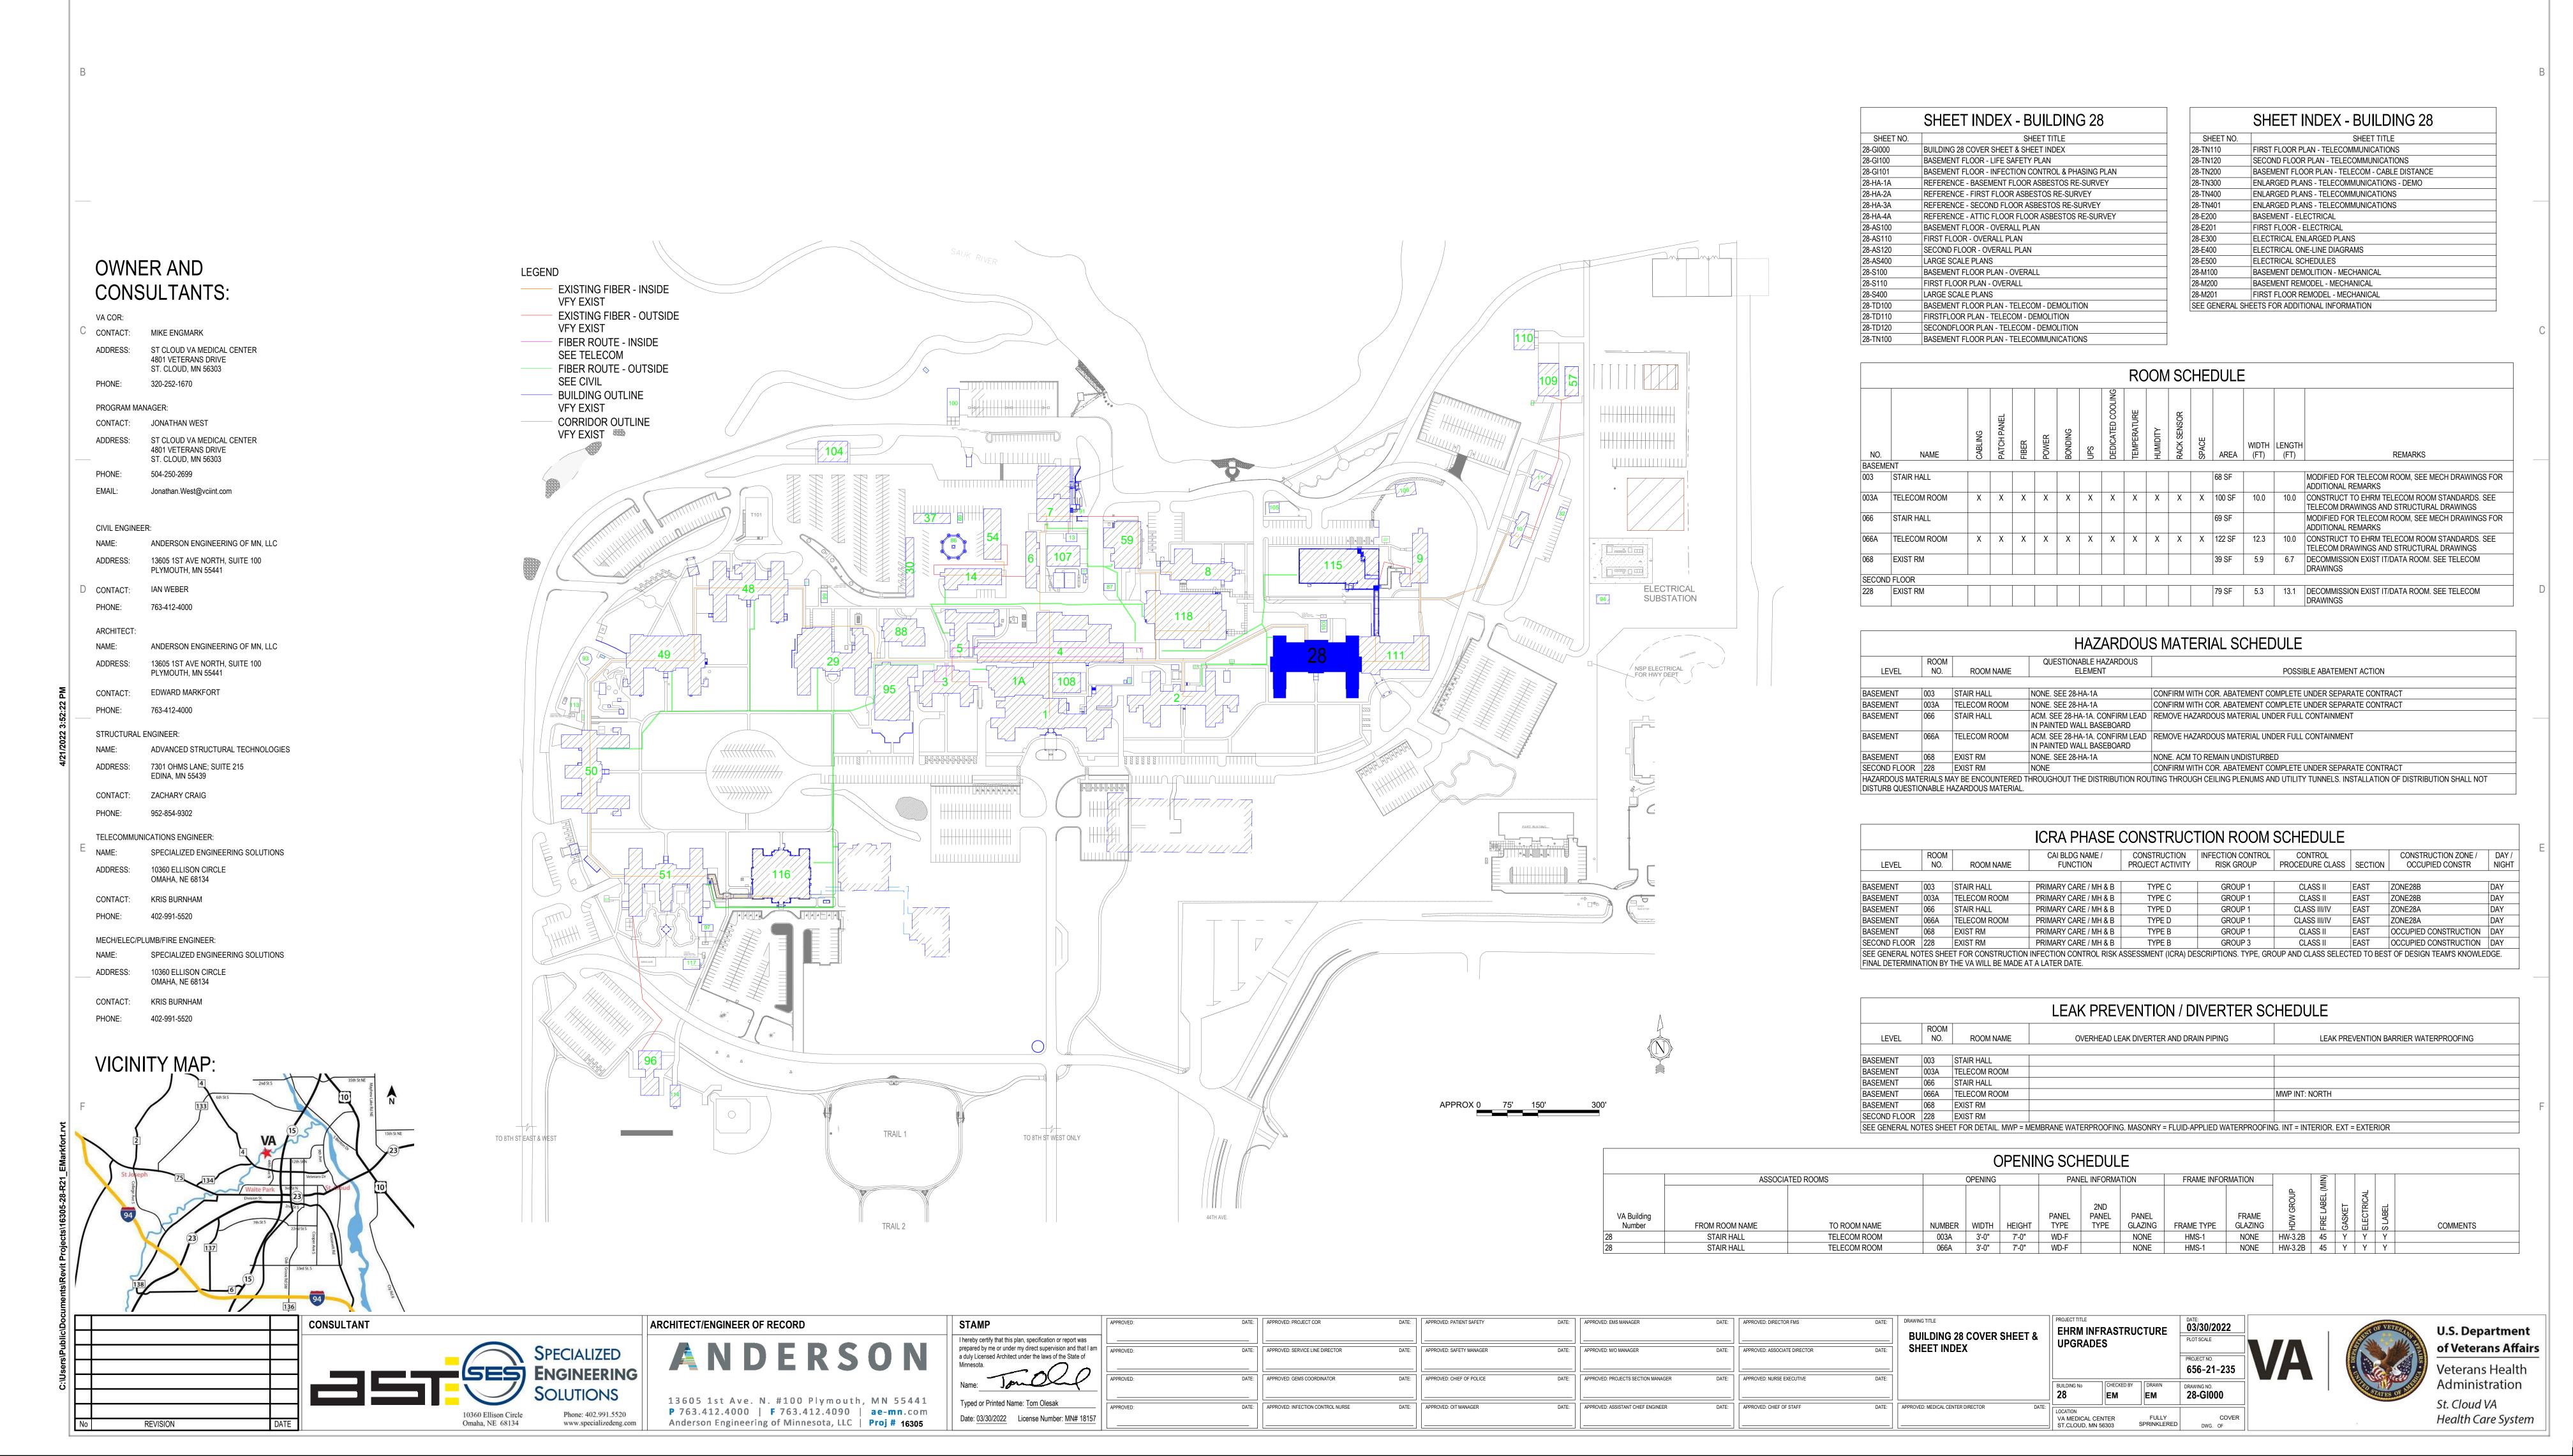

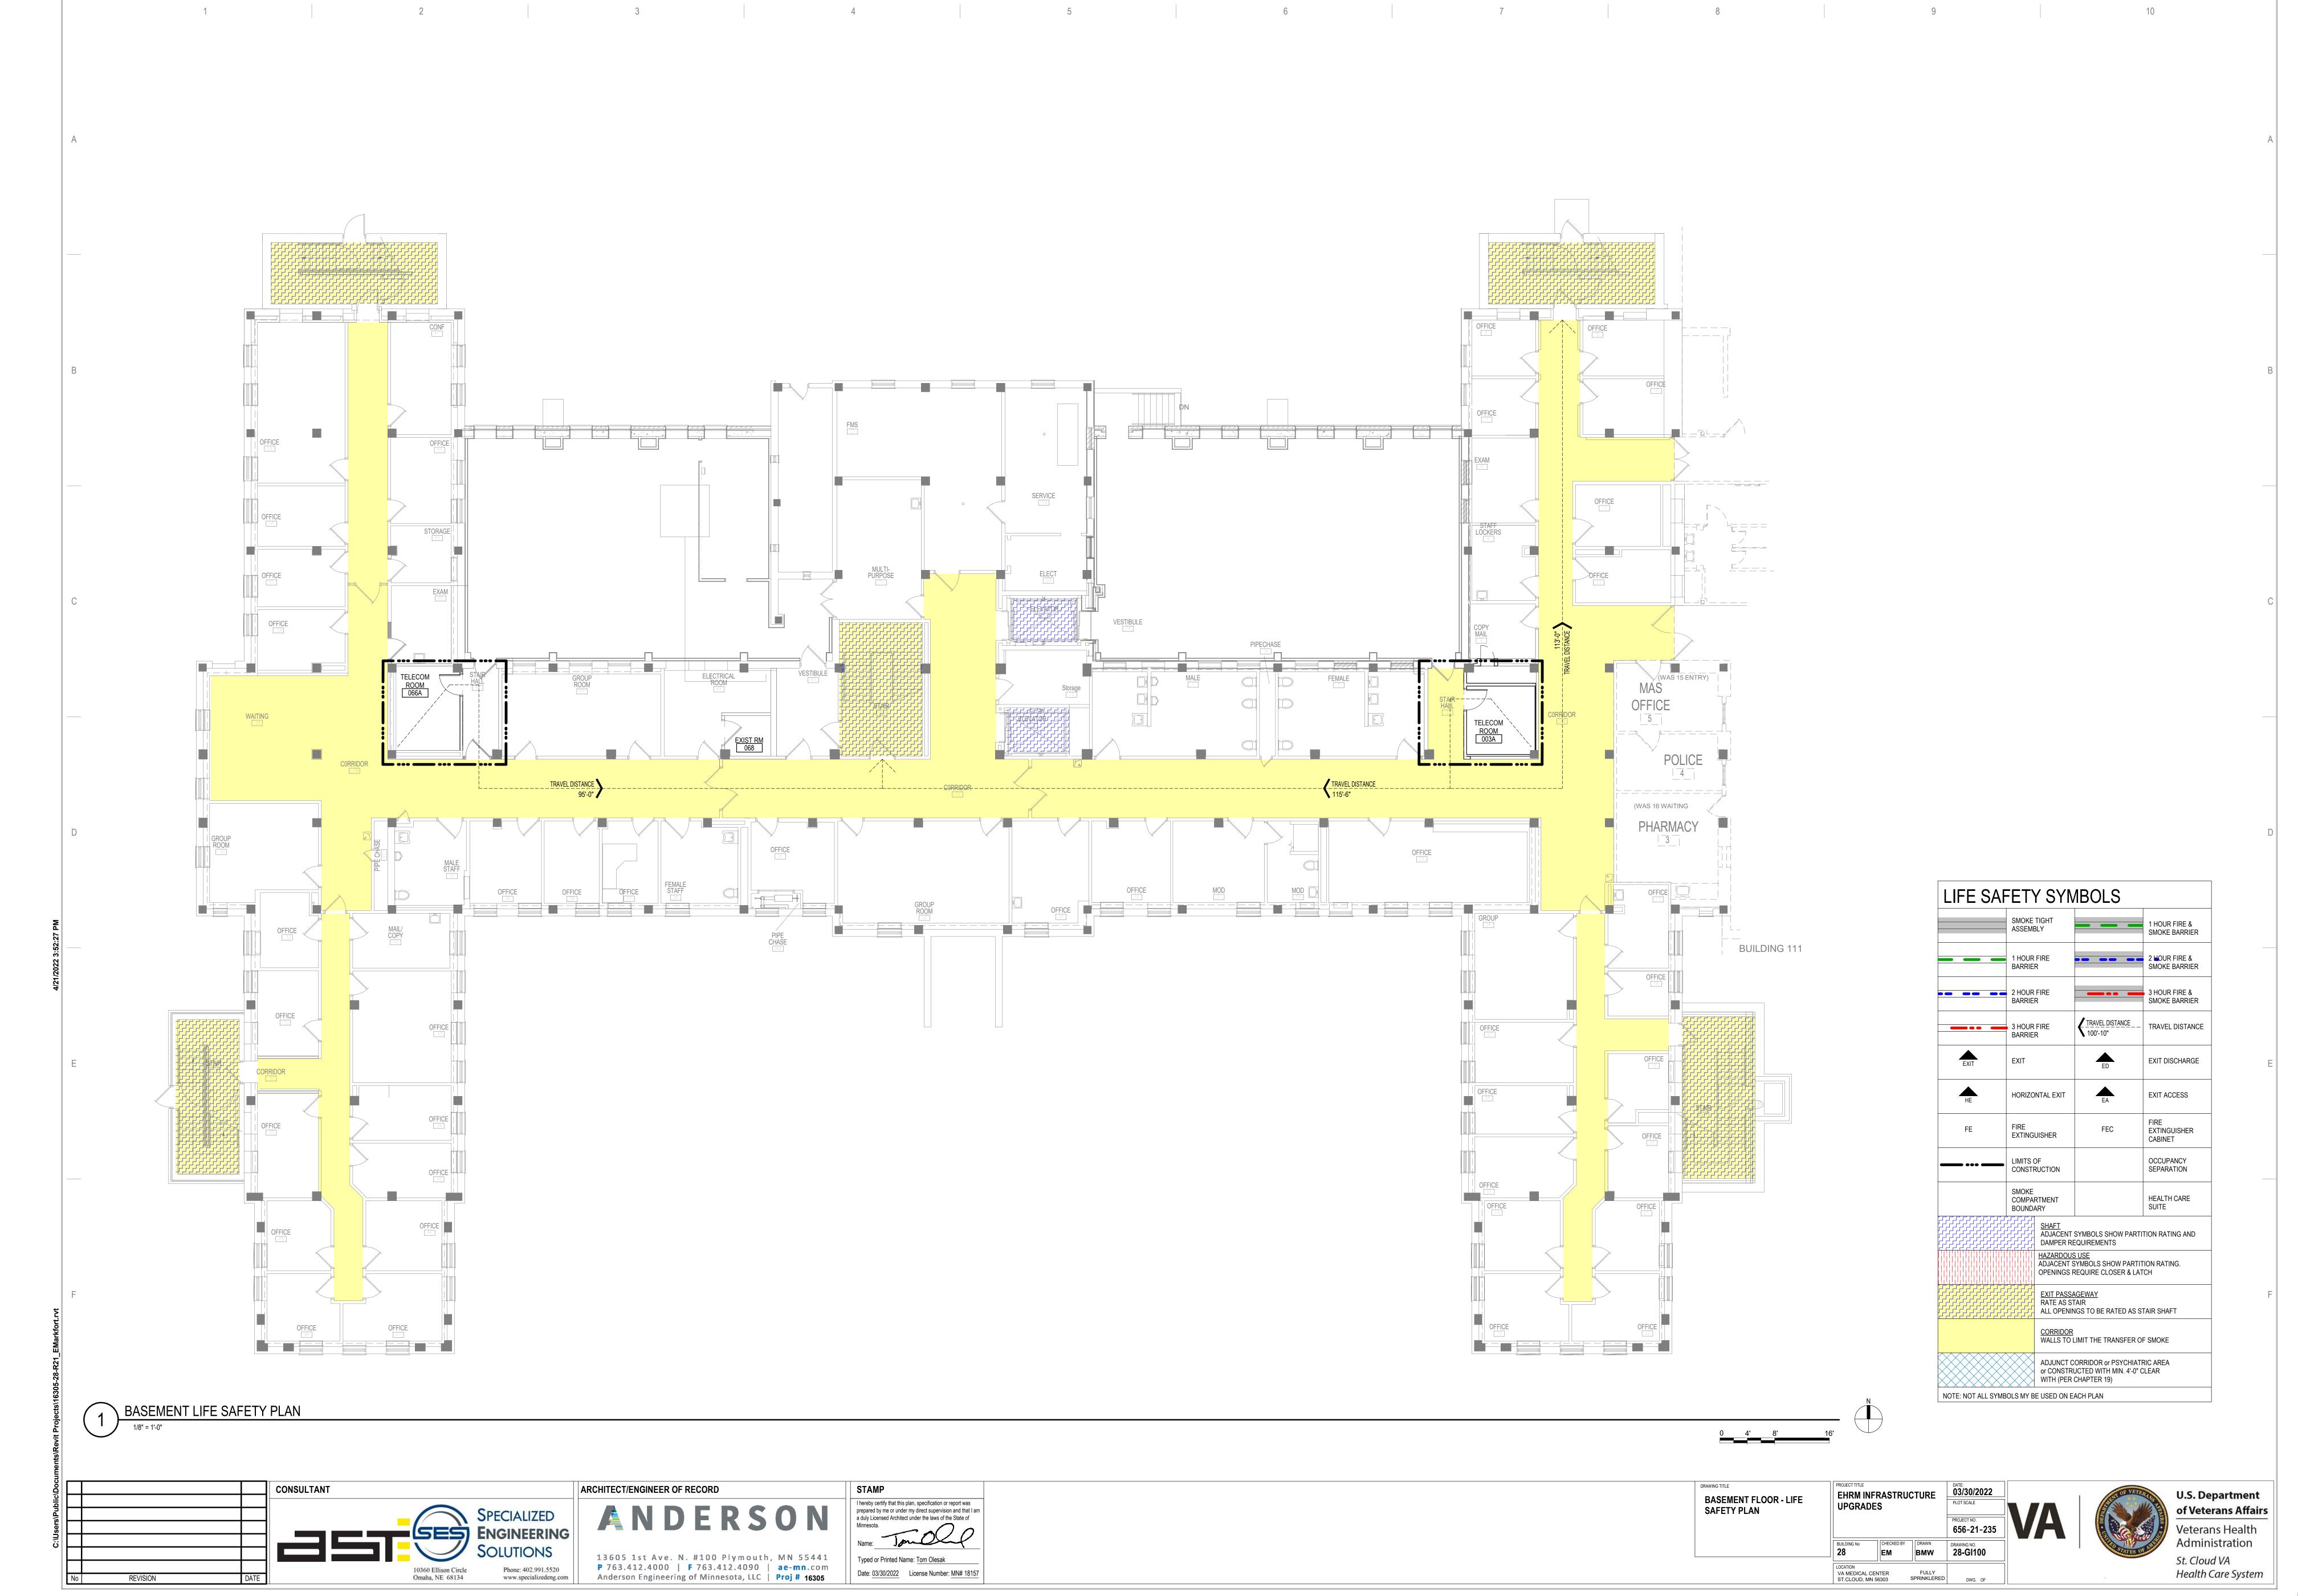

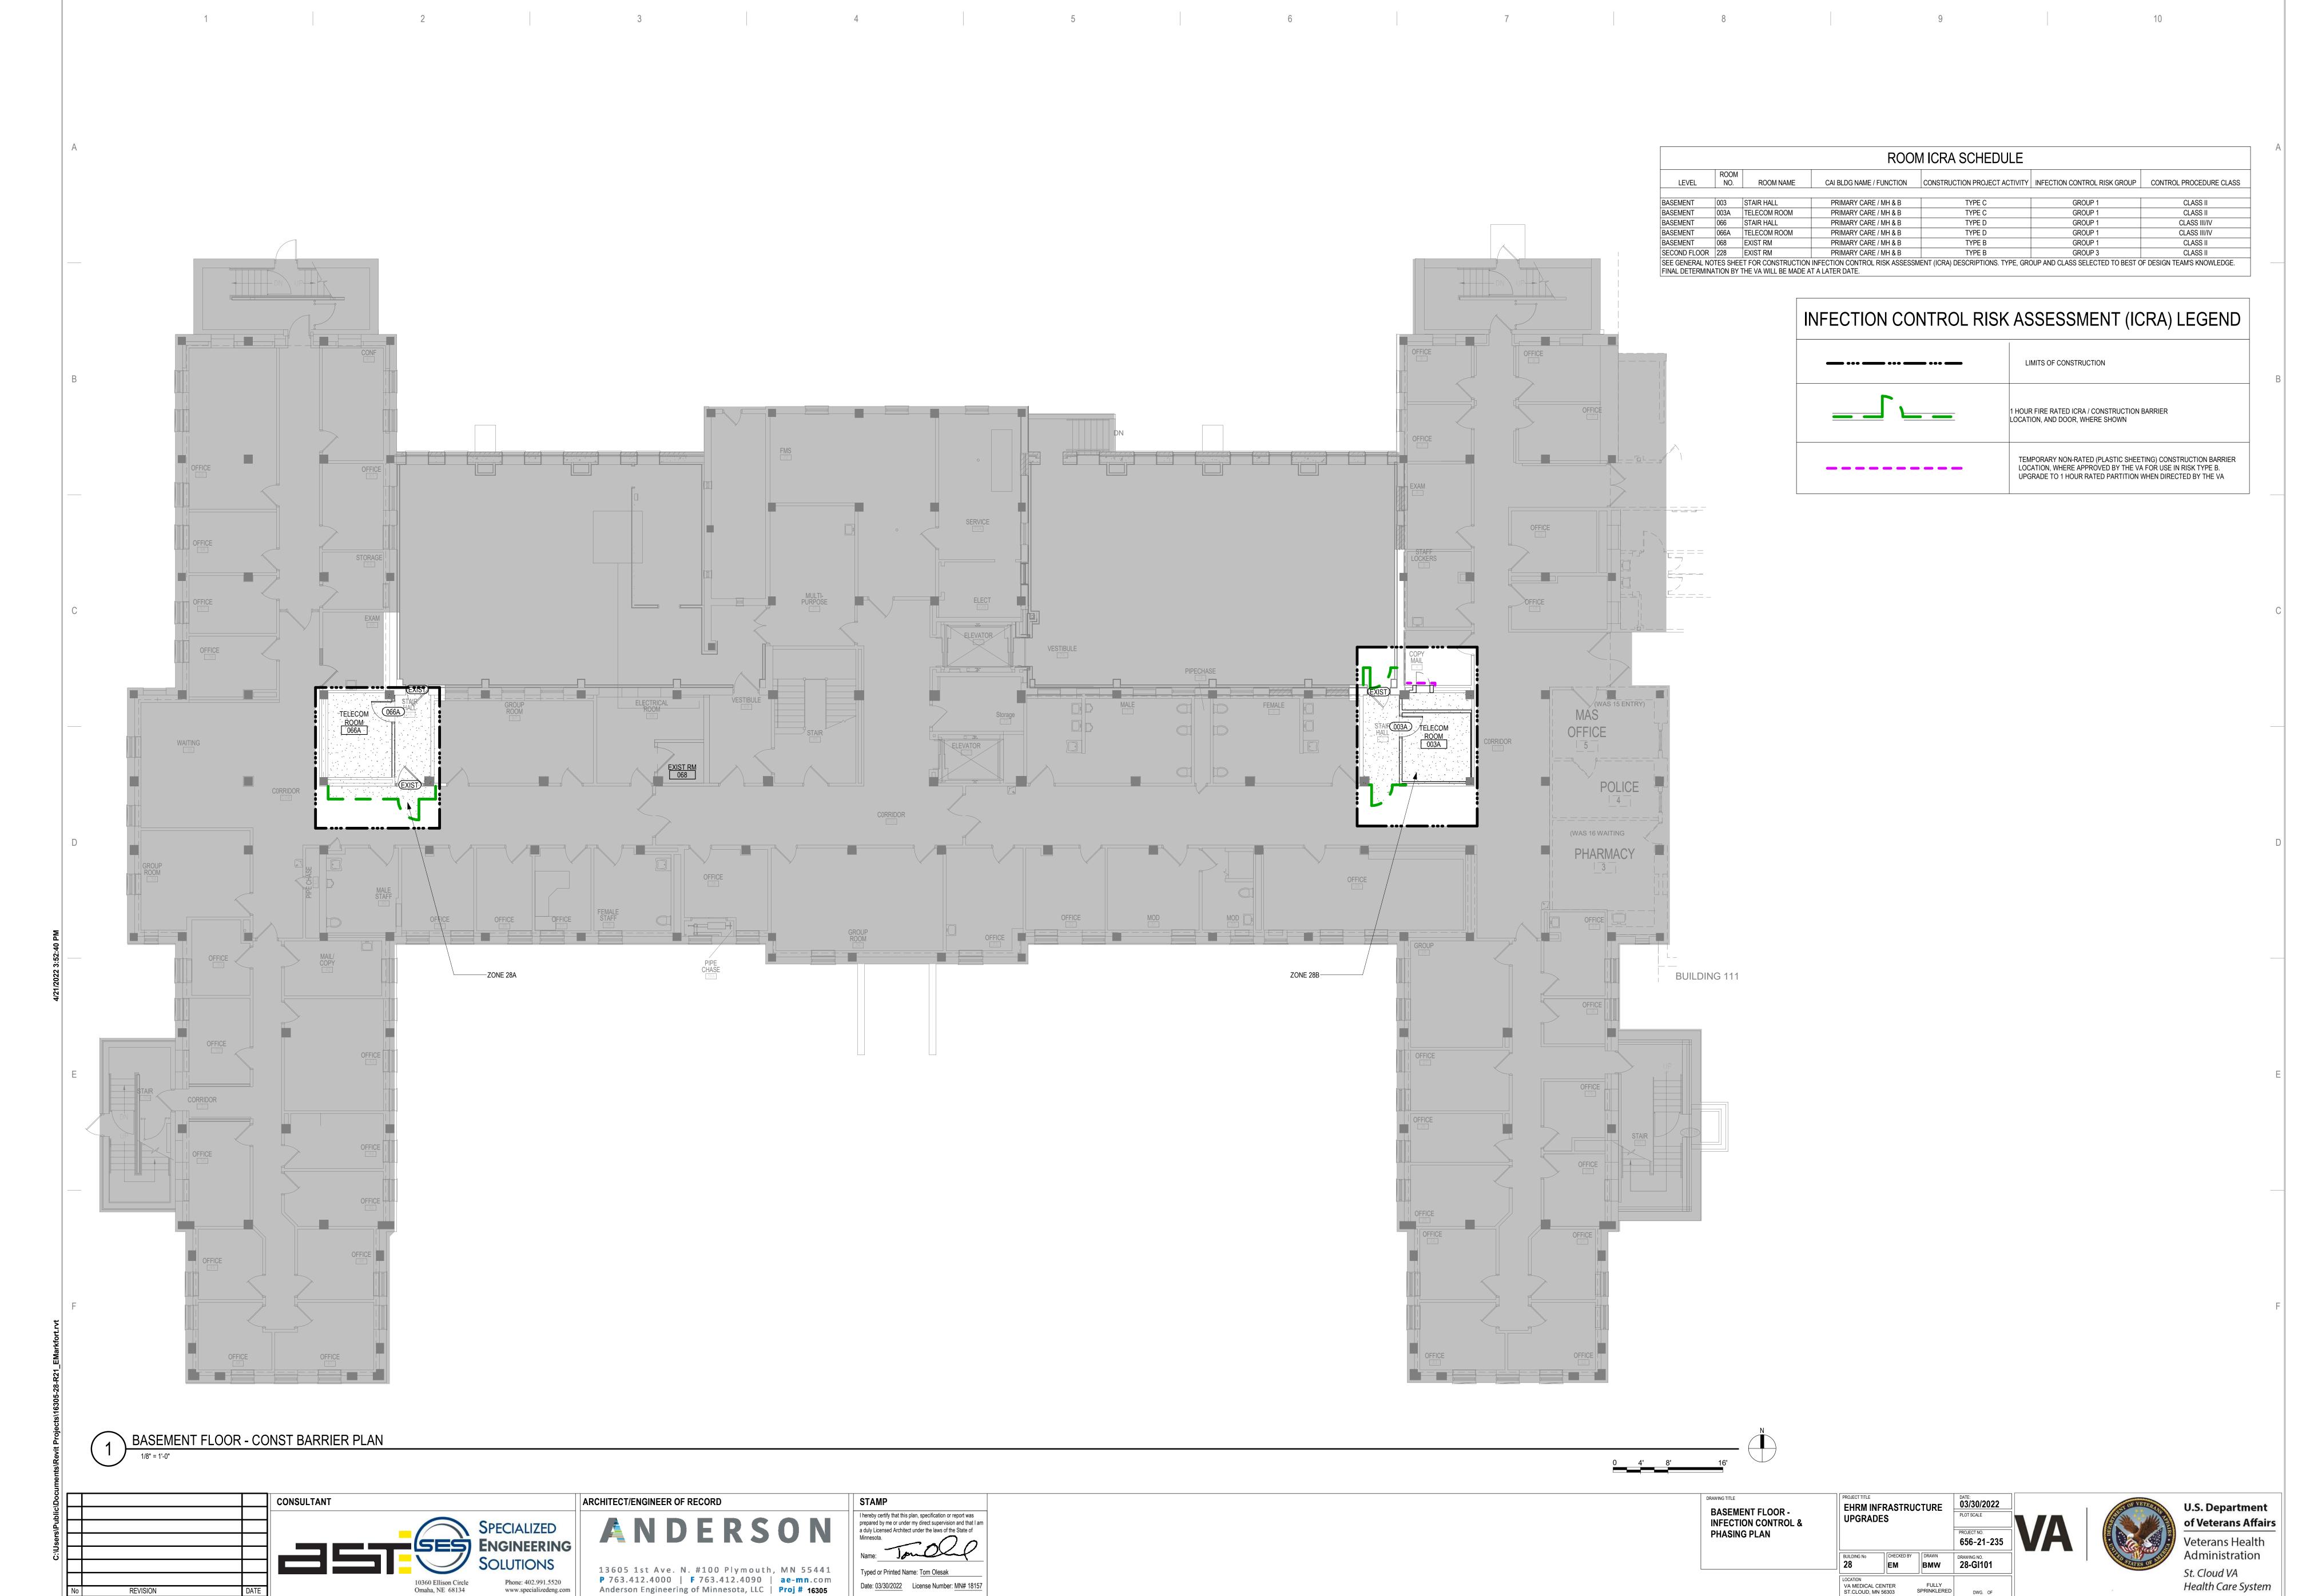

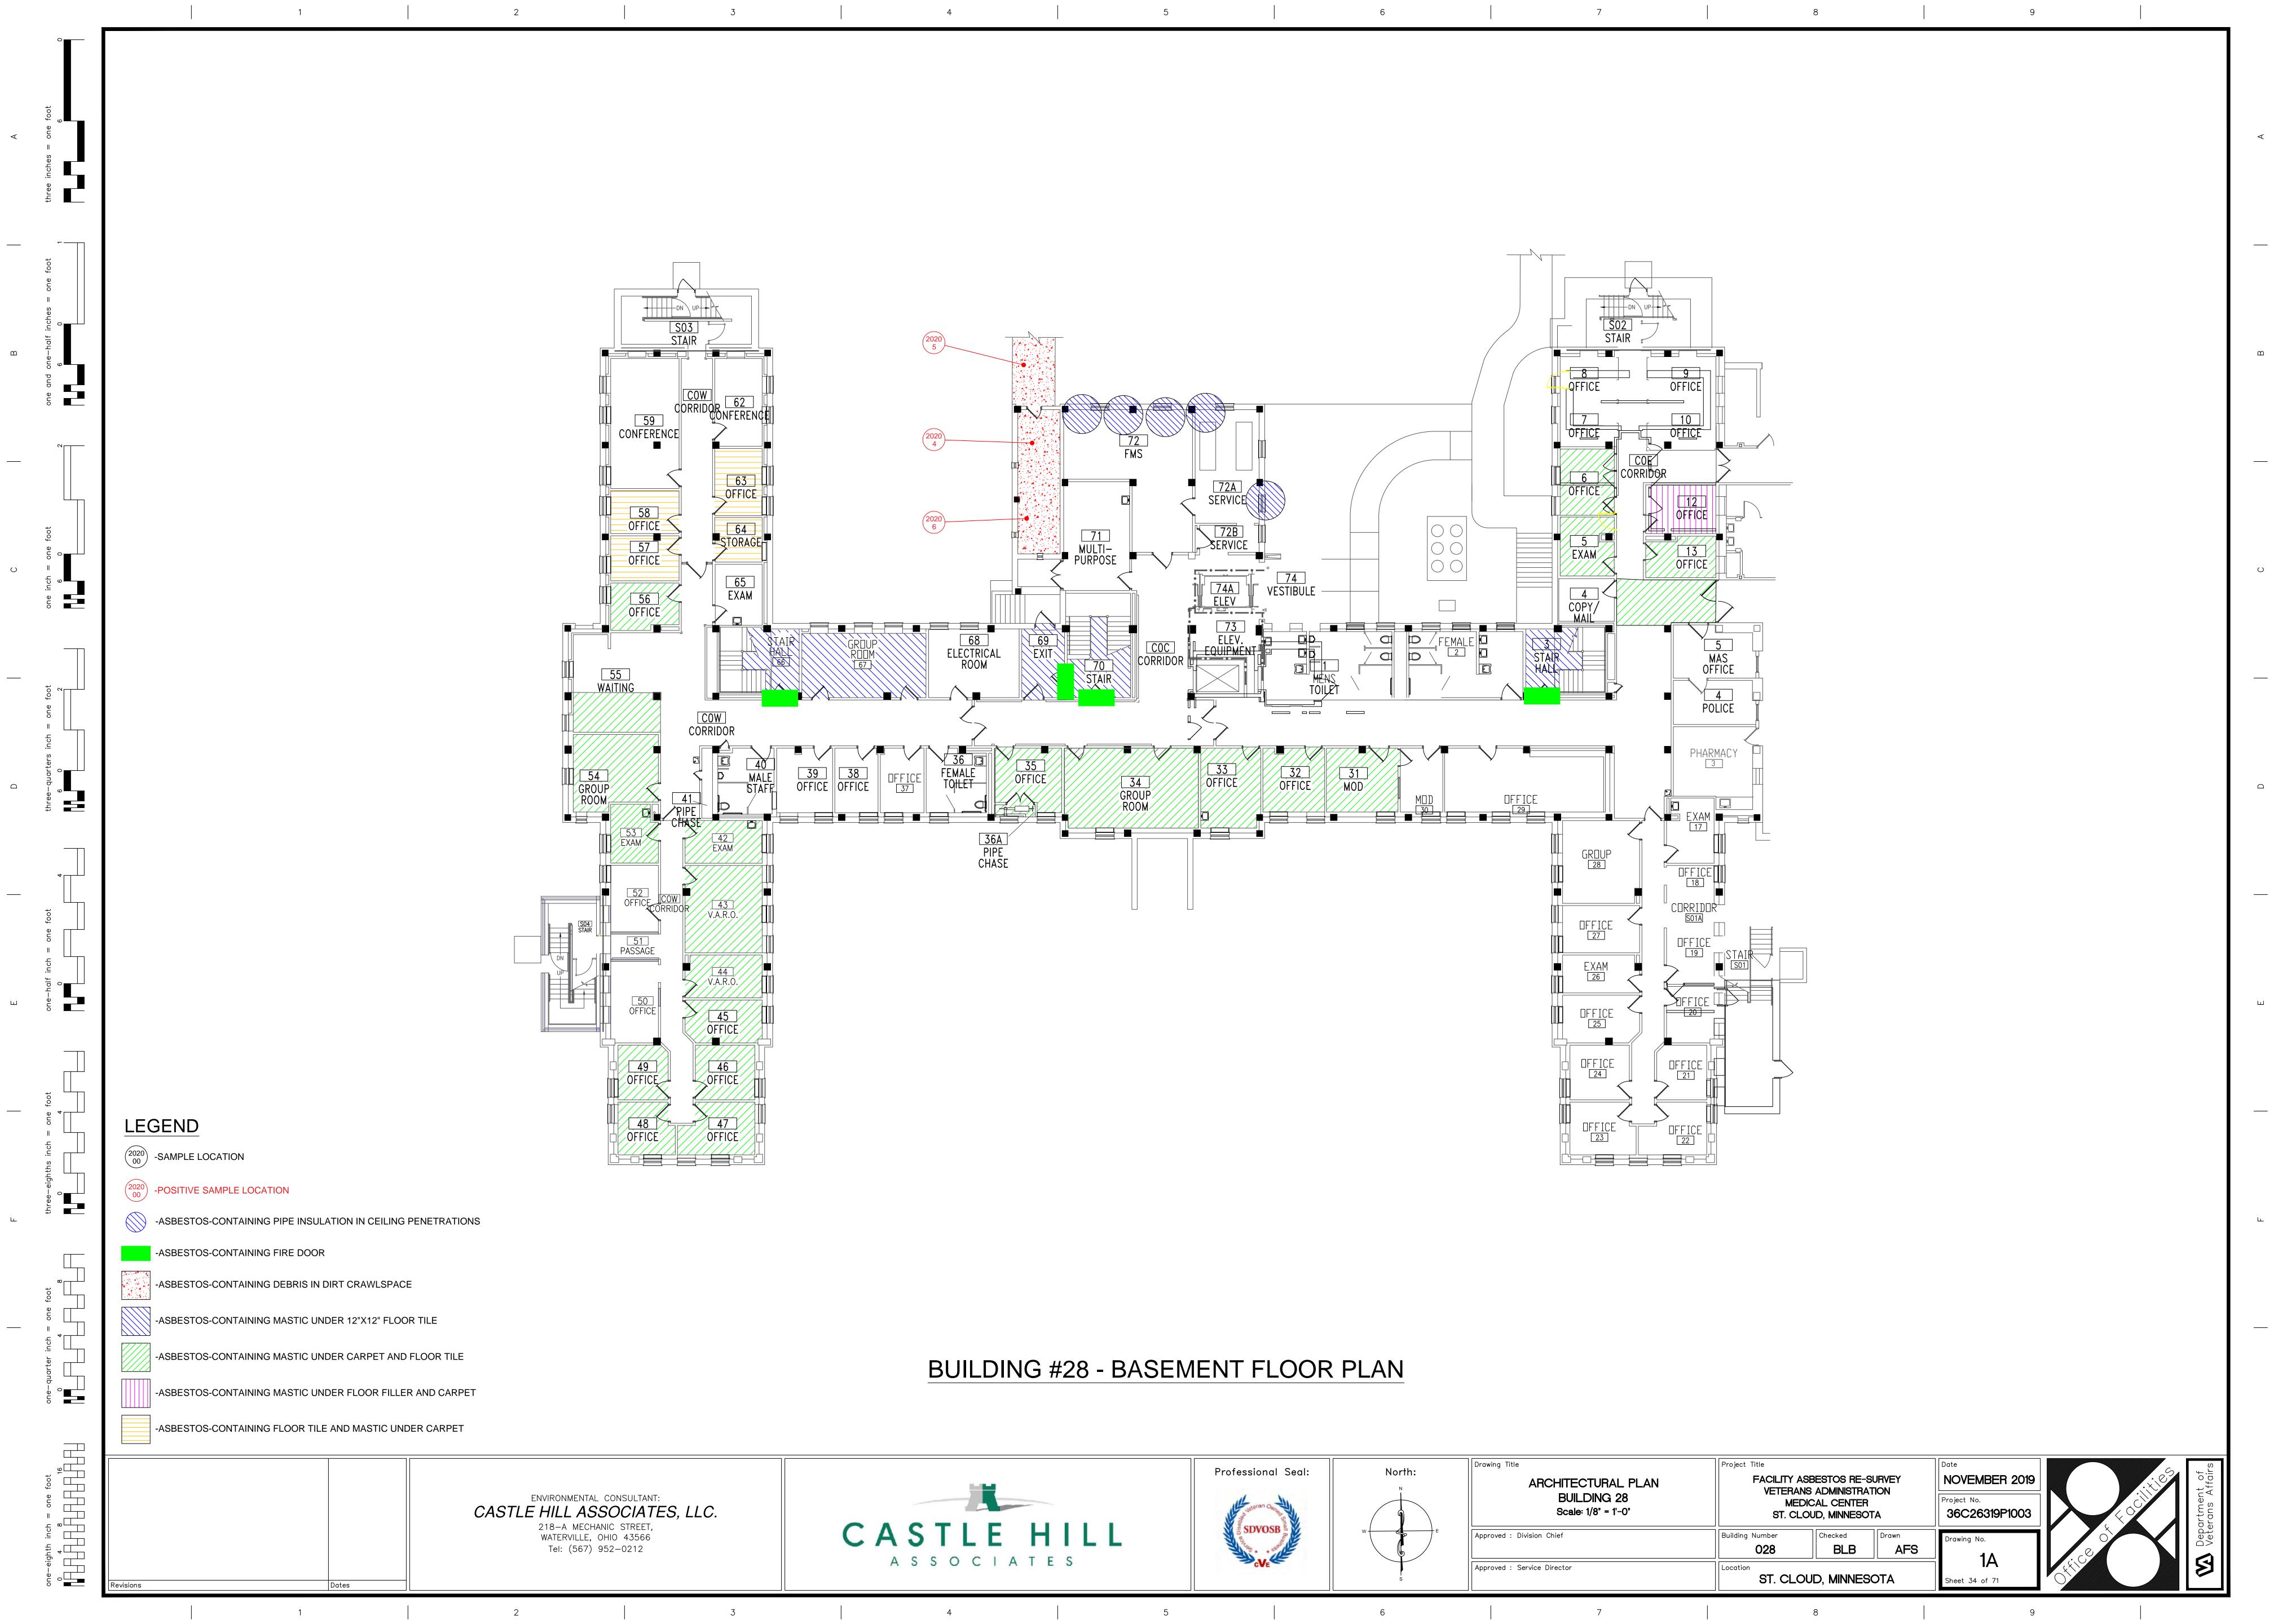



### LEGEND

one-eighth inch = one foot  $\begin{bmatrix}
0 & 4 & 8 \\
16
\end{bmatrix}$ 

-ASBESTOS-CONTAINING PIPE INSULATION (VERTICAL RISERS)

-ASBESTOS-CONTAINING FIRE DOO

-ASBESTOS-CONTAINING CONVECTOR INSULATION

-ASBESTOS-CONTAINING MASTIC UNDER 12"X12" FLOOR TILE

-ASBESTOS-CONTAINING MASTIC UNDER CARPET AND FLOOR TILE

# BUILDING #28 - FIRST FLOOR PLAN

ENVIRONMENTAL CONSULTANT:

CASTLE HILL ASSOCIATES, LLC.


218-A MECHANIC STREET,

WATERVILLE, OHIO 43566

Tel: (567) 952-0212





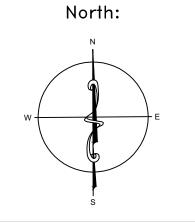

Approved : Service Director

Drawing Title	Project Title
ARCHITECTURAL PLAN BUILDING 28 Scale: 1/8" = 1'-0"	FACILIT VETE ST.
Approved : Division Chief	Building Number

EILITY ASBESTOS RE-SURVEY
ETERANS ADMINISTRATION
MEDICAL CENTER
ST. CLOUD, MINNESOTA


Project No.
36C26319P1003

Prawing No.

Drawing No.
2A

ST. CLOUD, MINNESOTA

M Department of Veterons Affairs

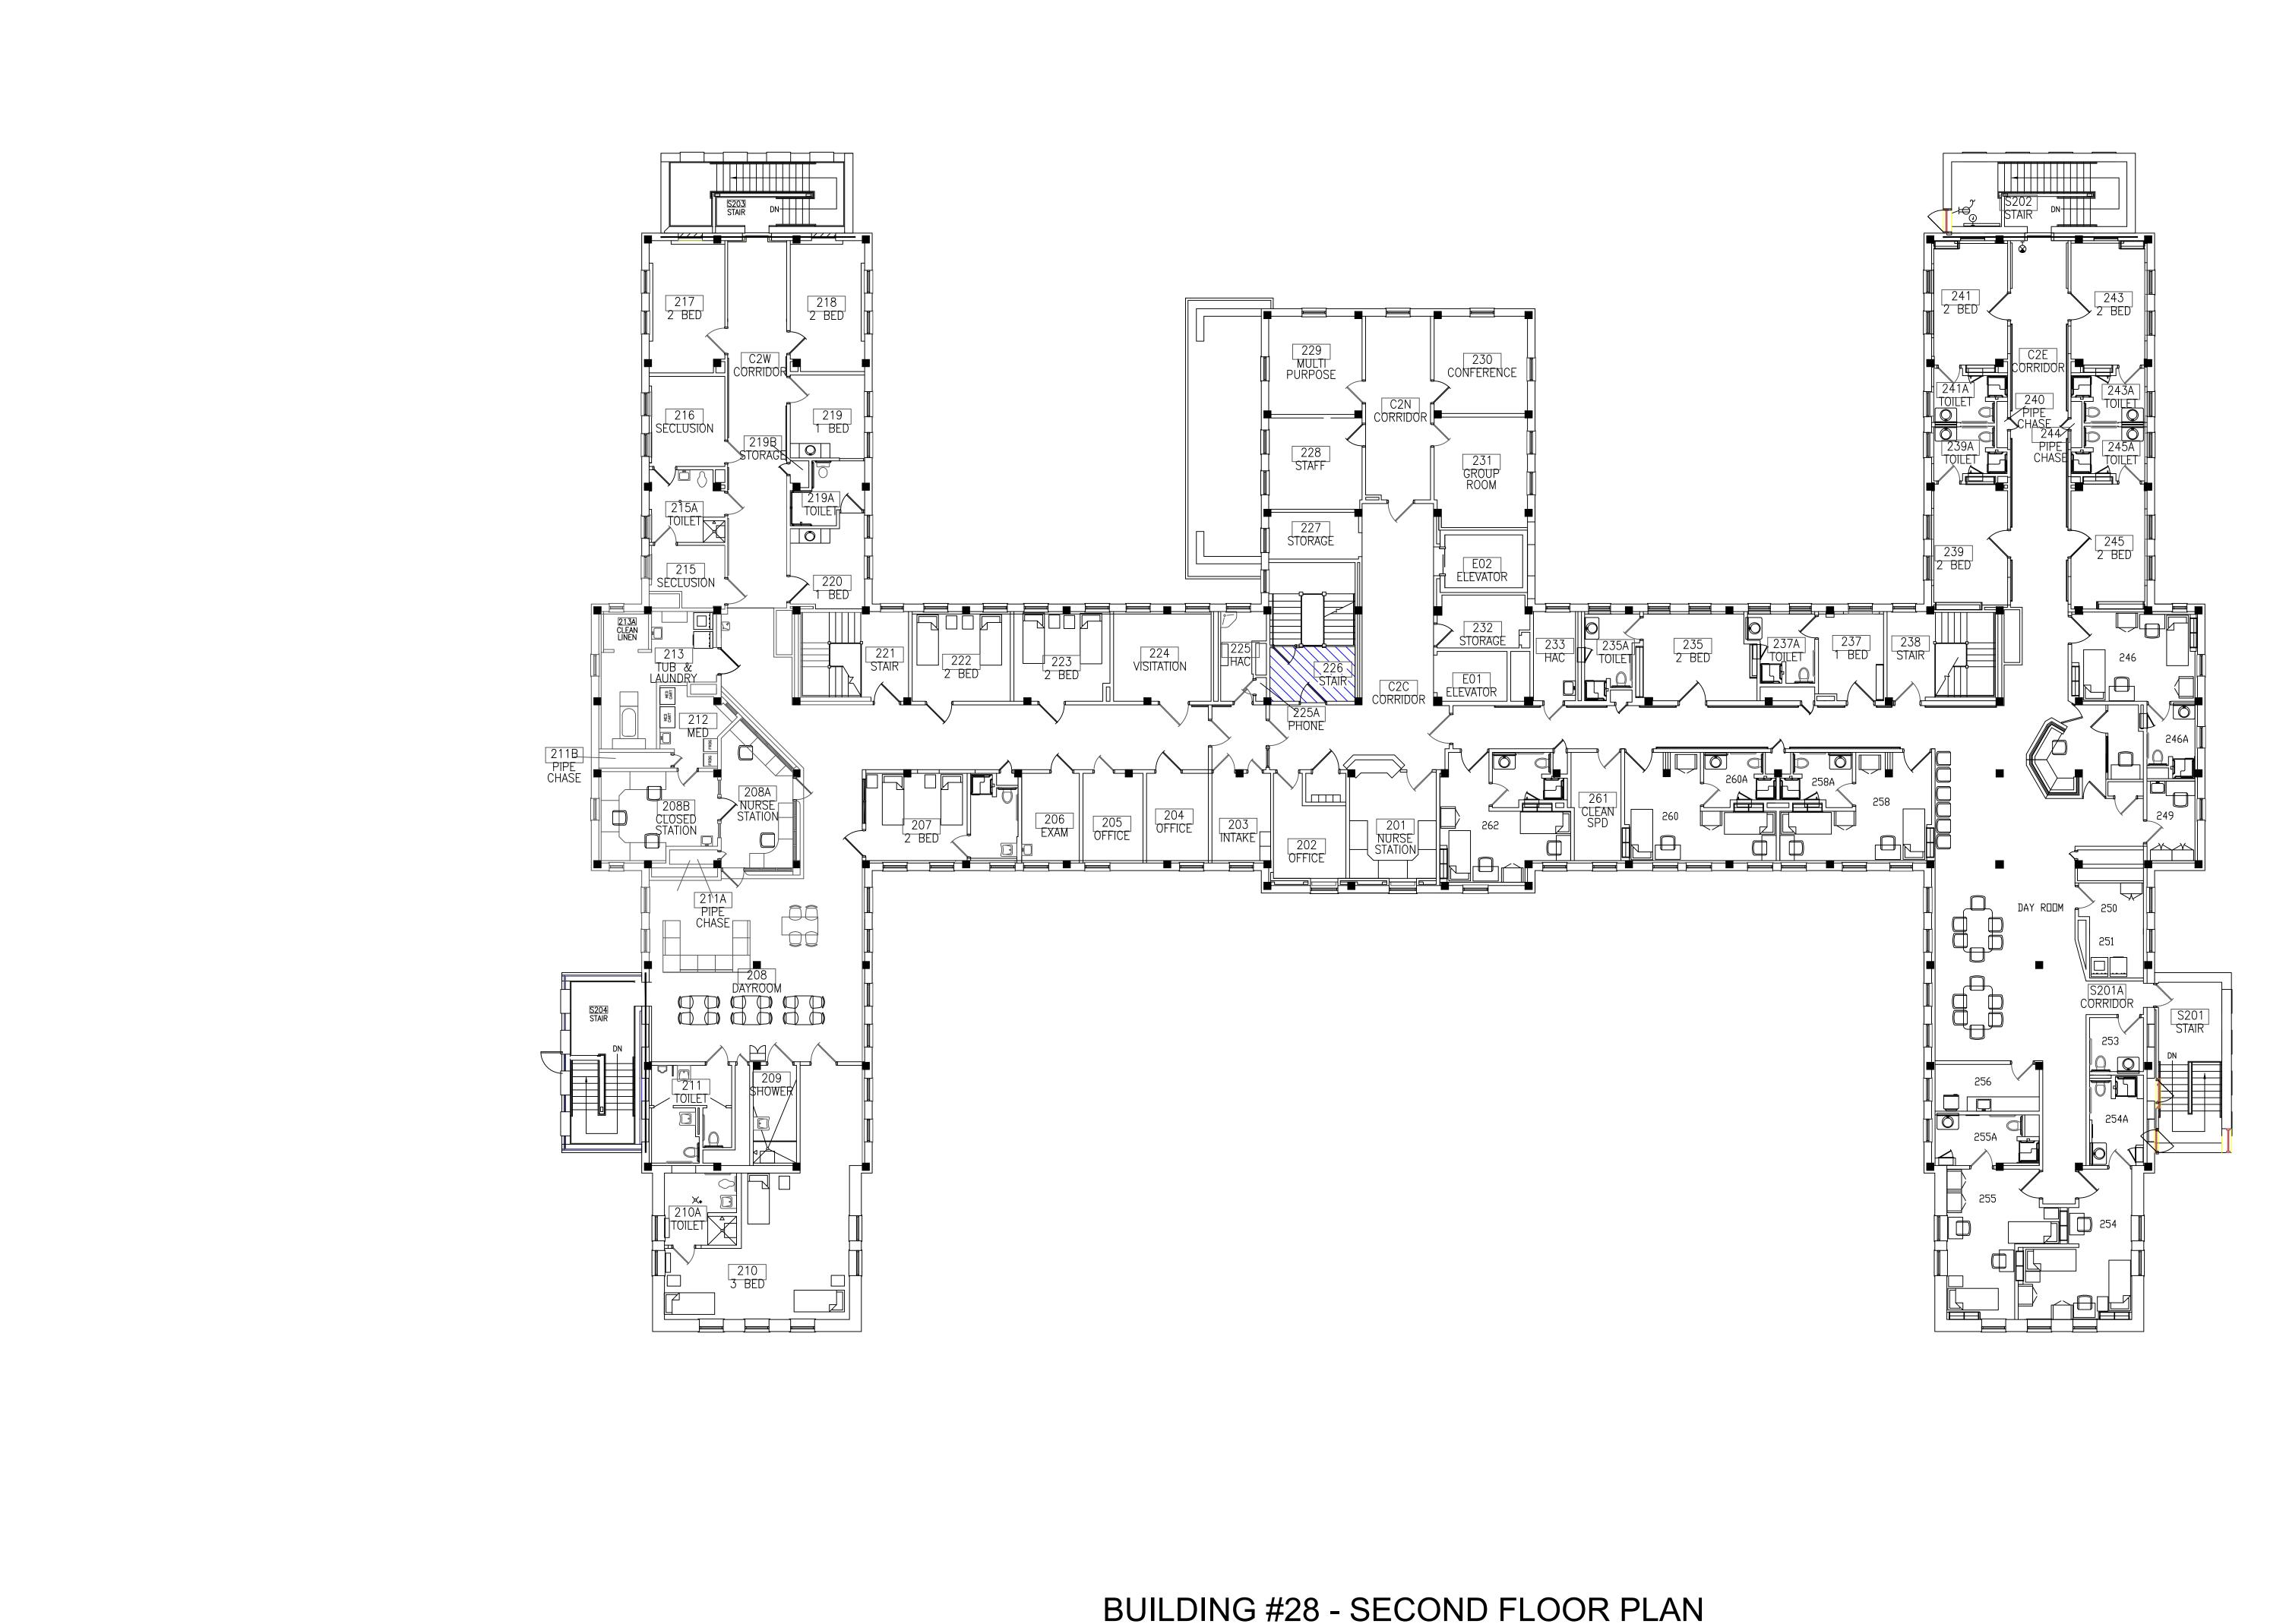

# BUILDING #28 - SECOND FLOOR PLAN

LEGEND

-ASBESTOS-CONTAINING MASTIC UNDER 12"X12" FLOOR TILE

ENVIRONMENTAL CONSULTANT:

CASTLE HILL ASSOCIATES, LLC.


218-A MECHANIC STREET,

WATERVILLE, OHIO 43566

Tel: (567) 952-0212





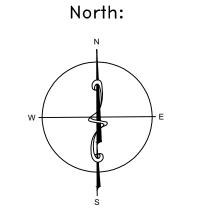

Drawing Title

Approved : Service Director


ARCHITECTURAL PLAN BUILDING 28 Scale: 1/8" = 1'-0"							
ed : Division Chief	Building						


Project Title FACILITY ASBESTOS RE-SURVEY
VETERANS ADMINISTRATION
MEDICAL CENTER
ST. CLOUD, MINNESOTA 028 BLB AFS

ST. CLOUD, MINNESOTA

NOVEMBER 2019 Project No. 36C26319P1003



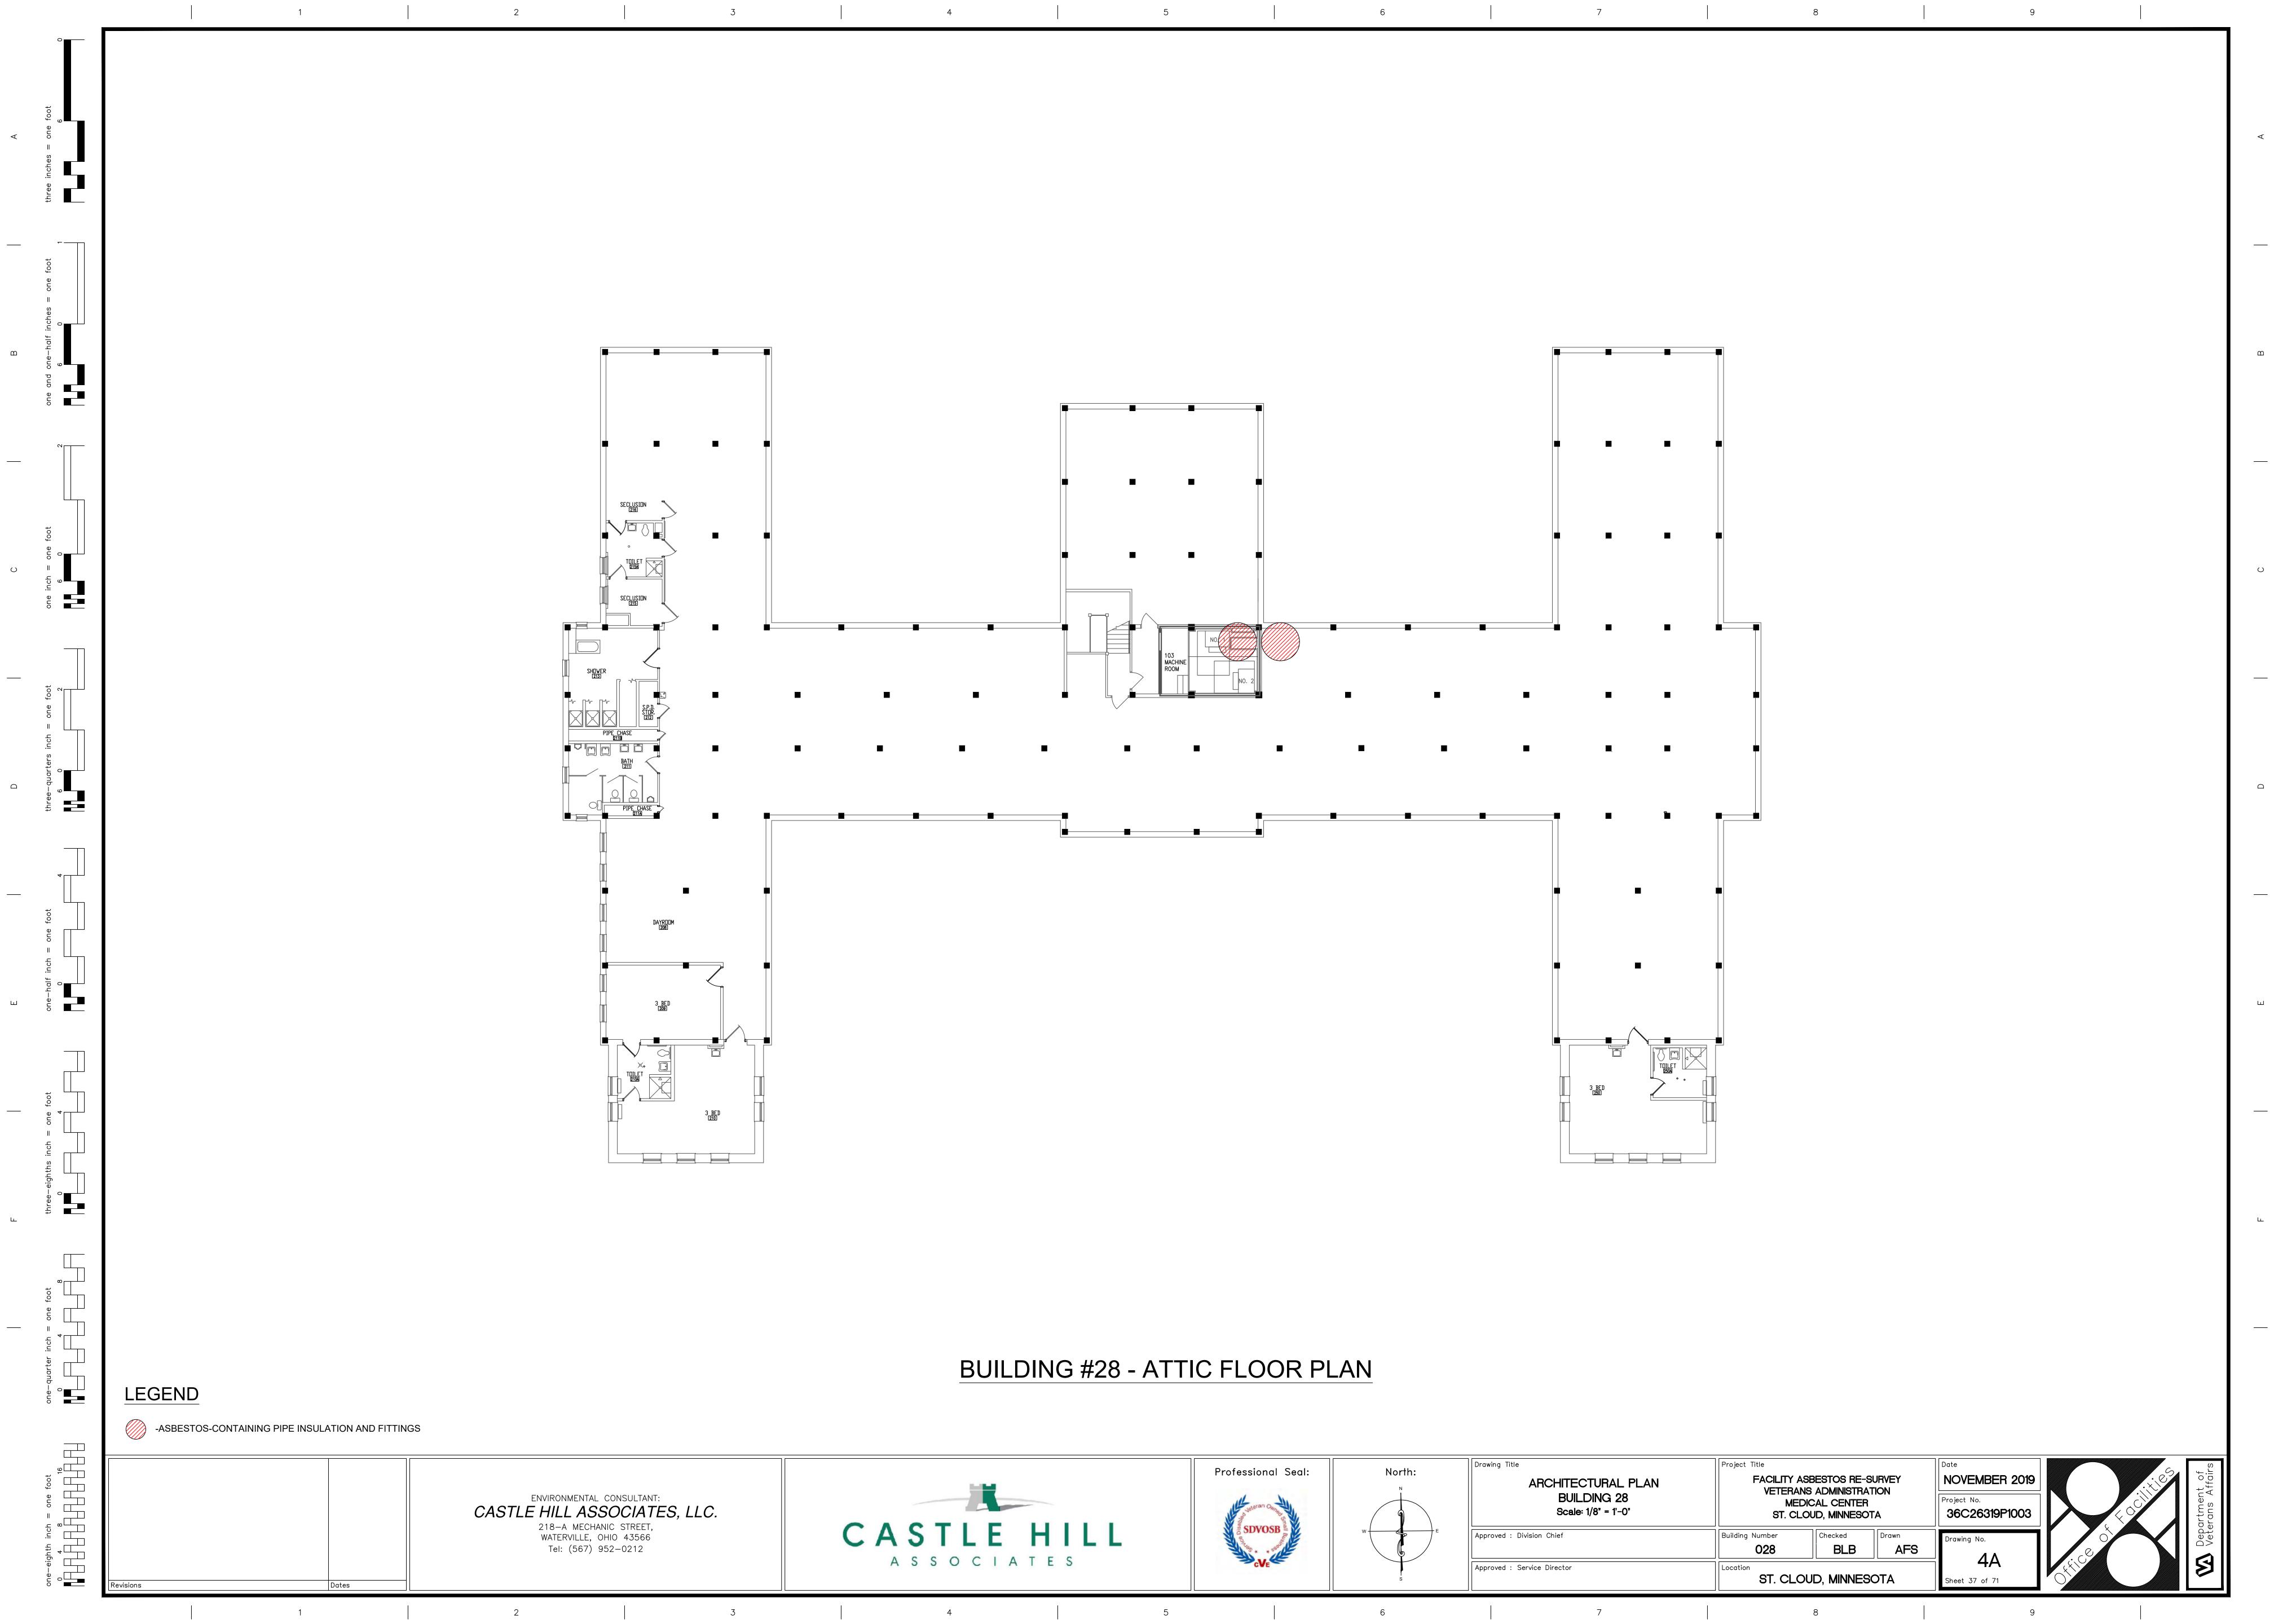

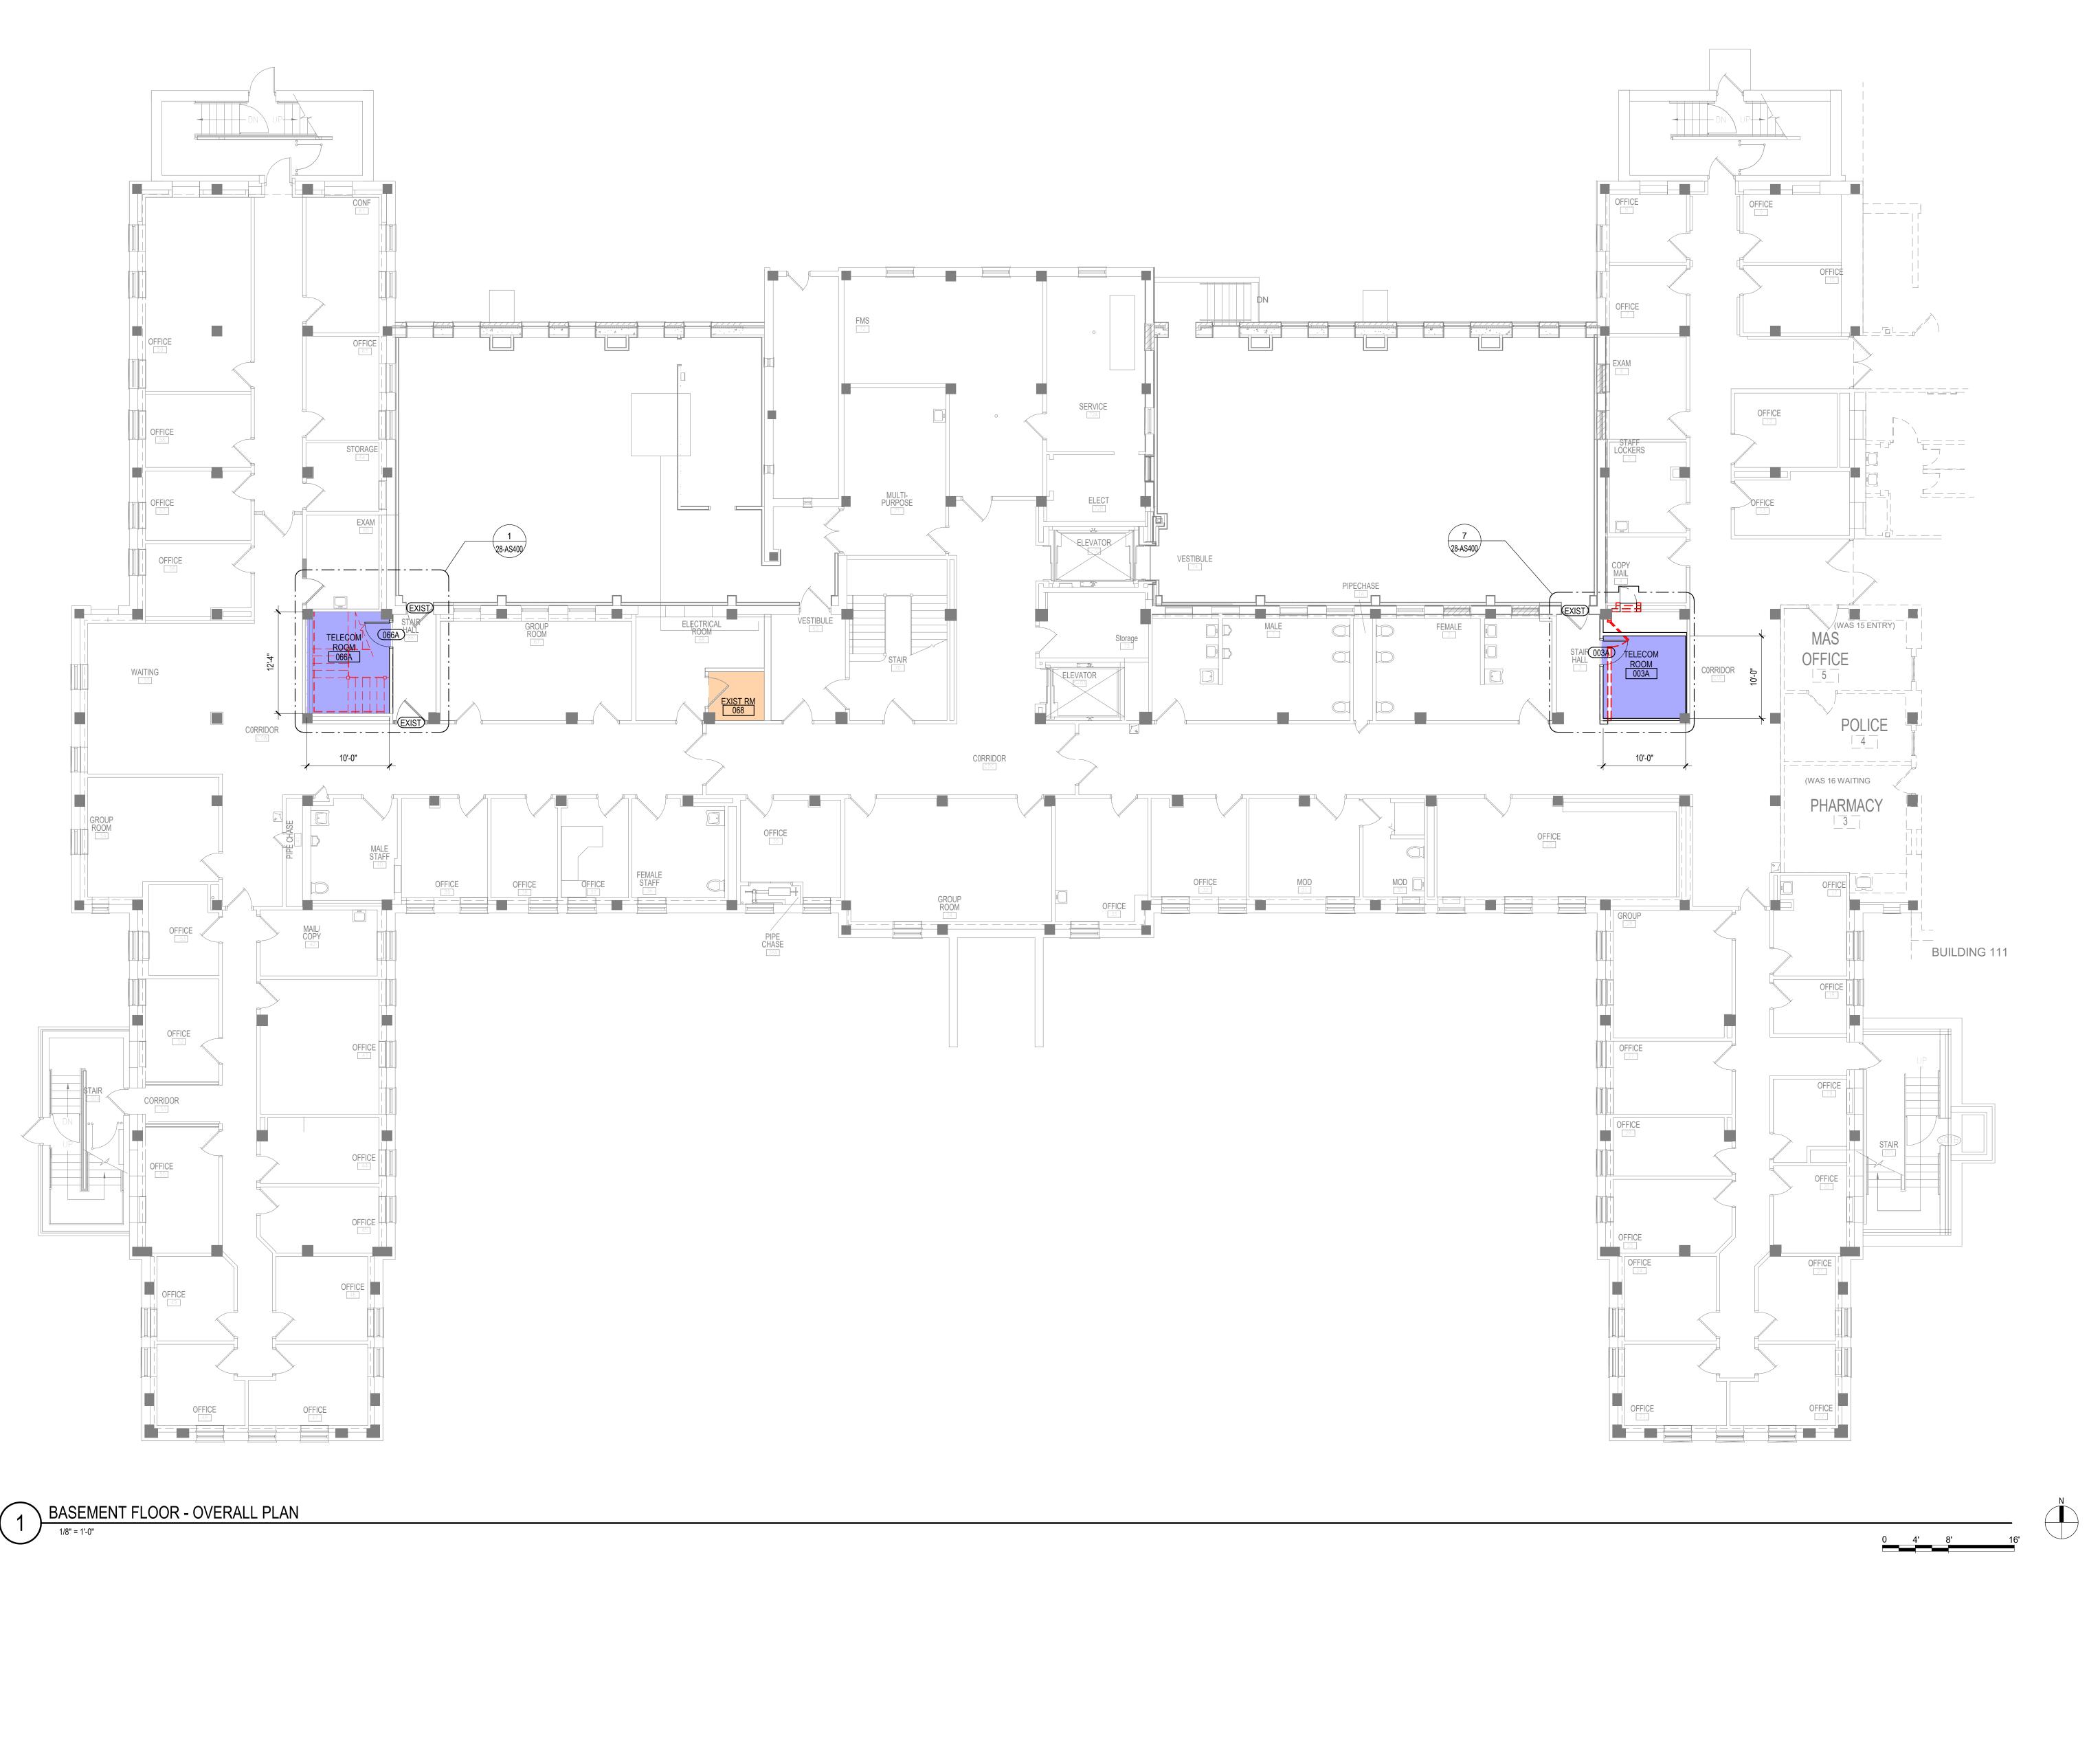

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SHEET NOTES

ENGINEERS.

1. SEE GENERAL NOTES AND CAMPUS DRAWINGS FOR GENERAL INFORMATION, LIFE SAFETY, ICRA, AND PHASING

2. ALL EXISTING CONDITIONS MUST BE FIELD VERIFIED BY THE CONTRACTOR PRIOR TO DEMOLITION OR CONSTRUCTION. EXISTING CONDITIONS THAT DIFFER FROM THOSE SHOWN MUST BE BROUGHT TO THE ATTENTION OF THE C.O.R. TO INFORM THE ARCHITECTS AND

THE INFORMATION SHOWN ON THE DRAWINGS IS BASED ON DRAWINGS AND PHOTOGRAPHS PROVIDED BY THE C.O.R. COMBINED WITH OBSERVATIONS AND SURVEYED DATA FROM THE ARCHITECTS AND ENGINEERS.

4. SEE CIVIL, STRUCTURAL, TELECOM, ELECTRICAL, MECHANICAL, AND PLUMBING DRAWINGS AND SPECIFICATIONS FOR ADDITIONAL DEMOLITION AND CONSTRUCTION REQUIREMENTS.

PORTABLE FIRE EXTINGUISHERS (CO2 OR HALOGENATED TYPE AS DETERMINED BY VA) WITH WALL MOUNT BRACKET AND CODE REQUIRED SIGNAGE SHALL BE PROVIDED BY THE CONTRACTOR WITHIN TELECOM

DRAWING TITLE

BASEMENT FLOOR - OVERALL

PROJECT TITLE

EHRM INFRASTRUCTURE

LIDERADES

VA MEDICAL CENTER ST.CLOUD, MN 56303

TITLE

IM INFRASTRUCTURE

RADES

DATE:
03/30

PLOT SCA

PROJECT

FULLY SPRINKLERED

DATE: 03/30/2022
PLOT SCALE

PROJECT NO. 656-21-235

DRAWING NO. 28-A\$100



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Phone: 402.991.5520

Omaha, NE 68134

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DATE

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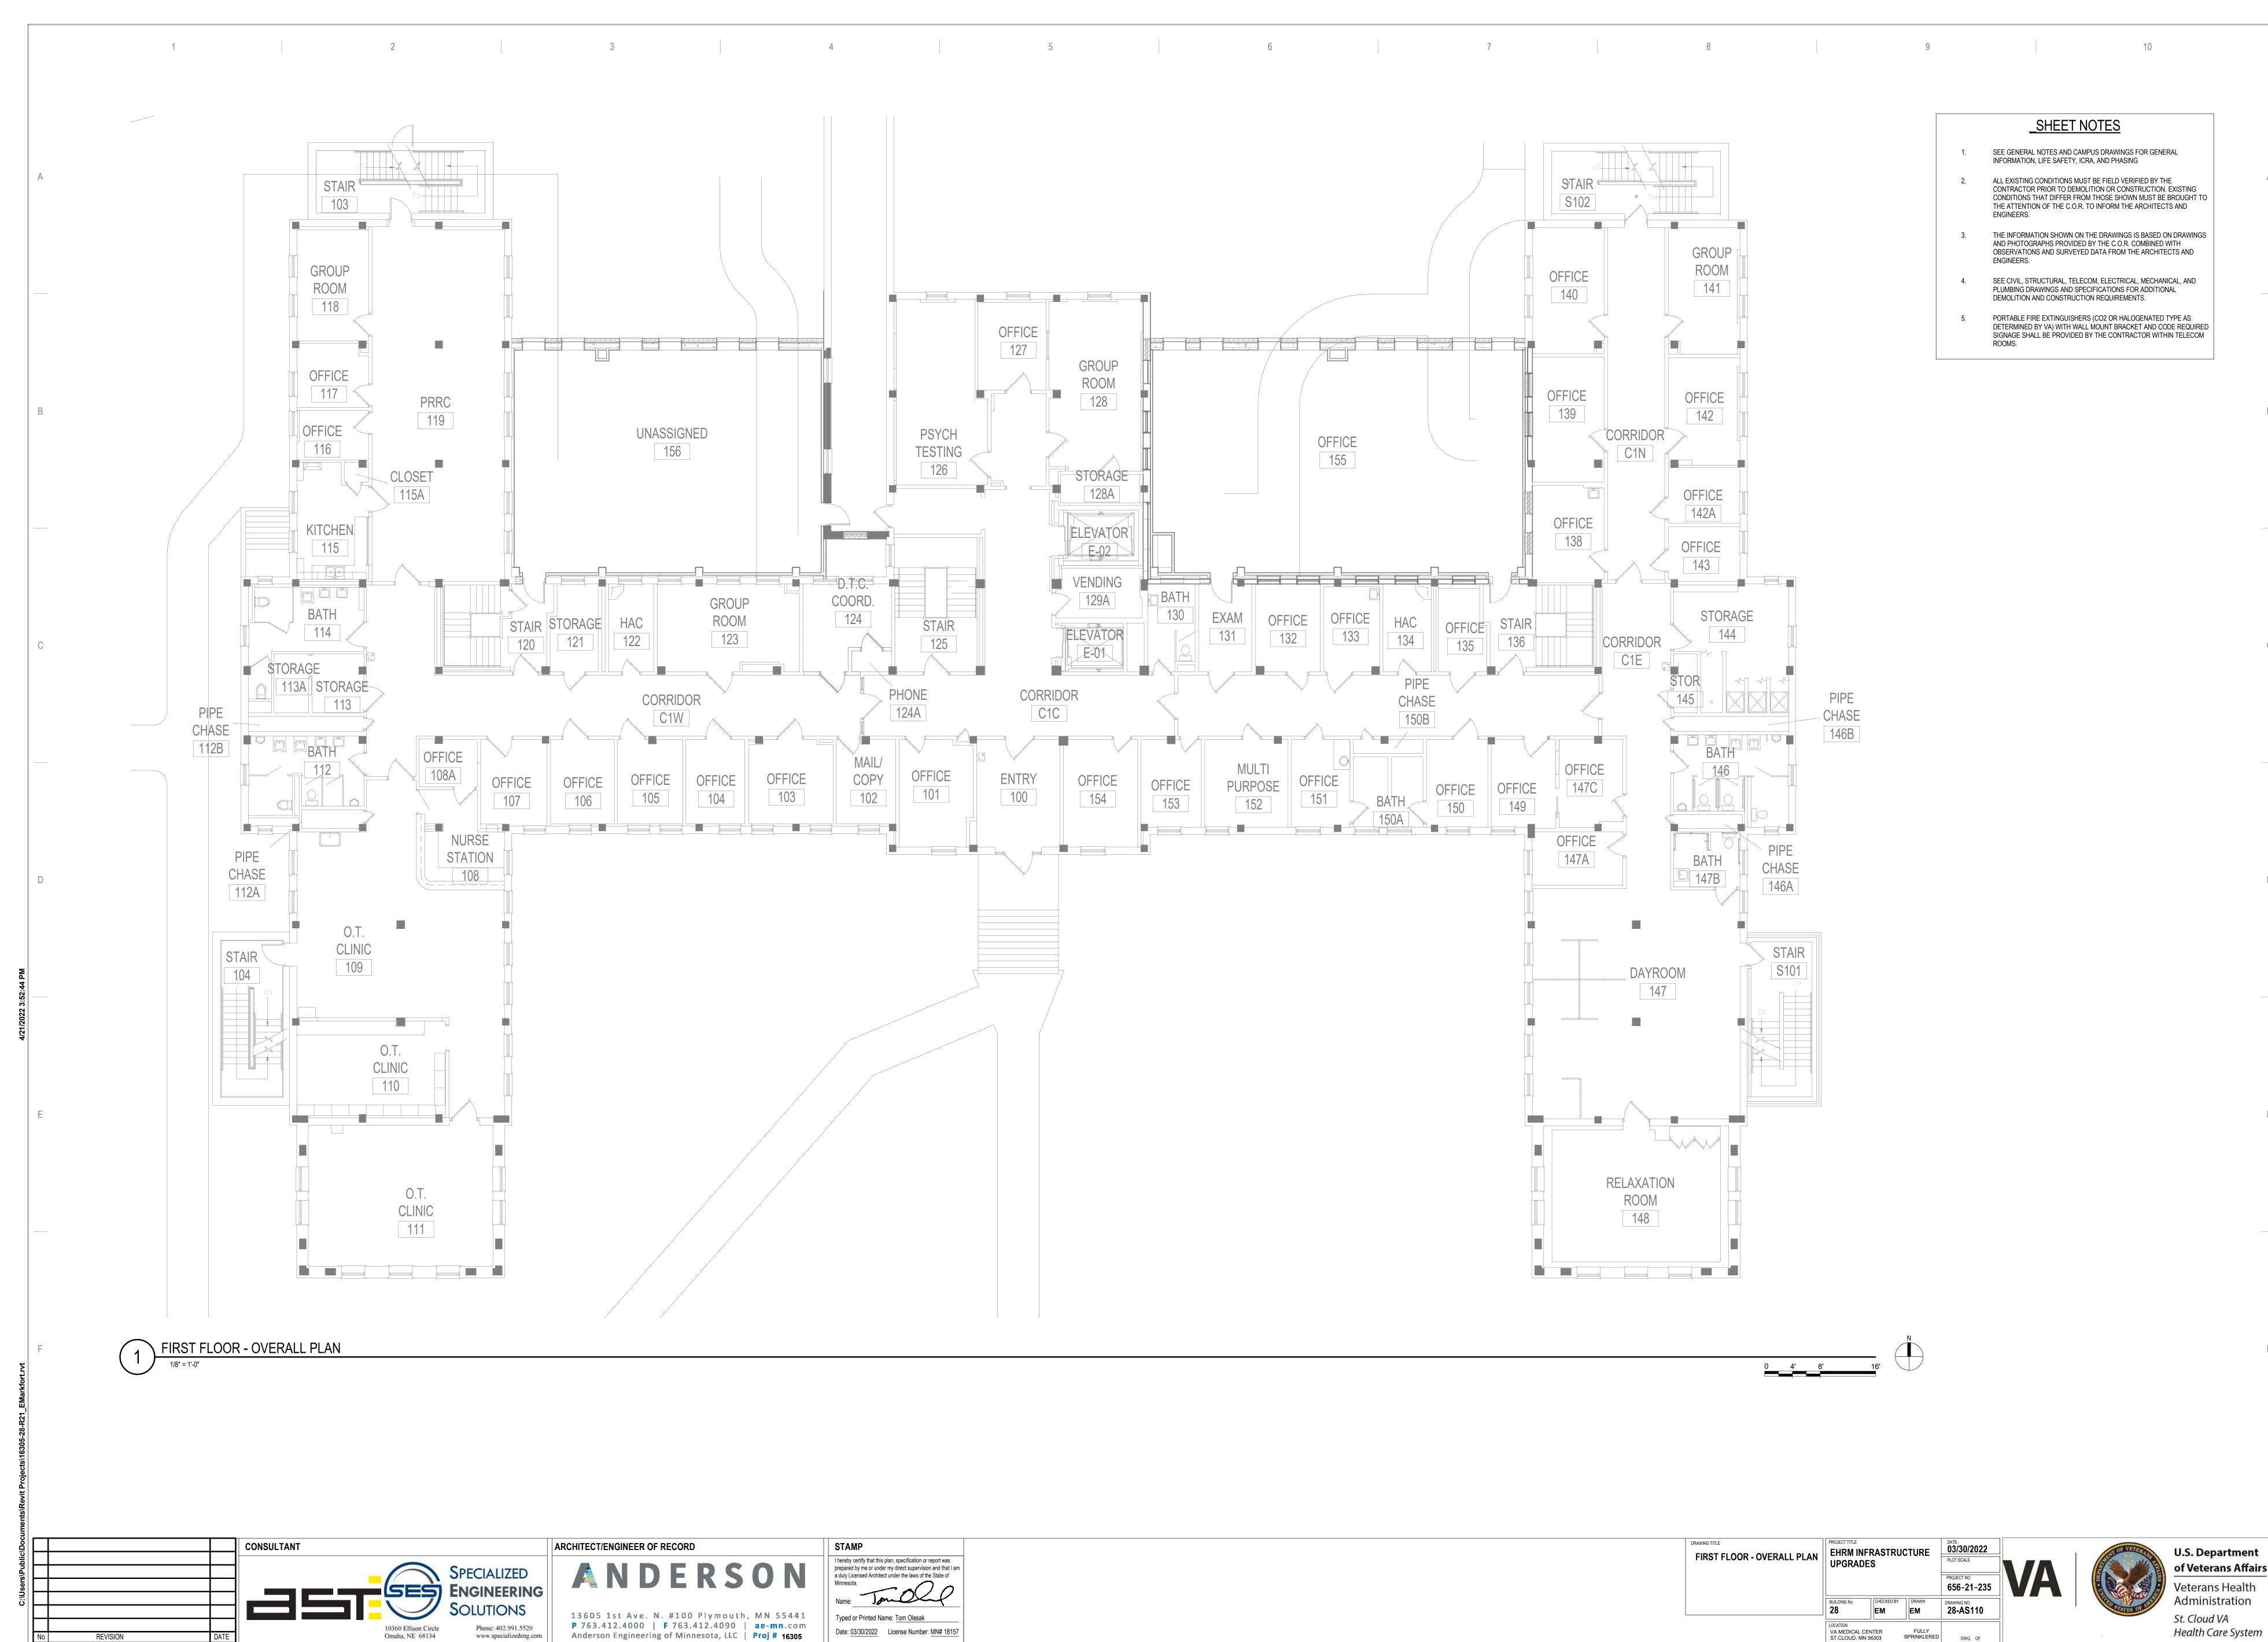
Anderson Engineering of Minnesota, LLC | Proj # 16305

I hereby certify that this plan, specification or report was prepared by me or under my direct supervision and that I am a duly Licensed Architect under the laws of the State of Minnesota.

Name:

Typed or Printed Name: Tom Olesak

Date: 03/30/2022 License Number: MN# 18157




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DATE

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SHEET NOTES

ENGINEERS.

ROOMS.

SEE GENERAL NOTES AND CAMPUS DRAWINGS FOR GENERAL INFORMATION, LIFE SAFETY, ICRA, AND PHASING

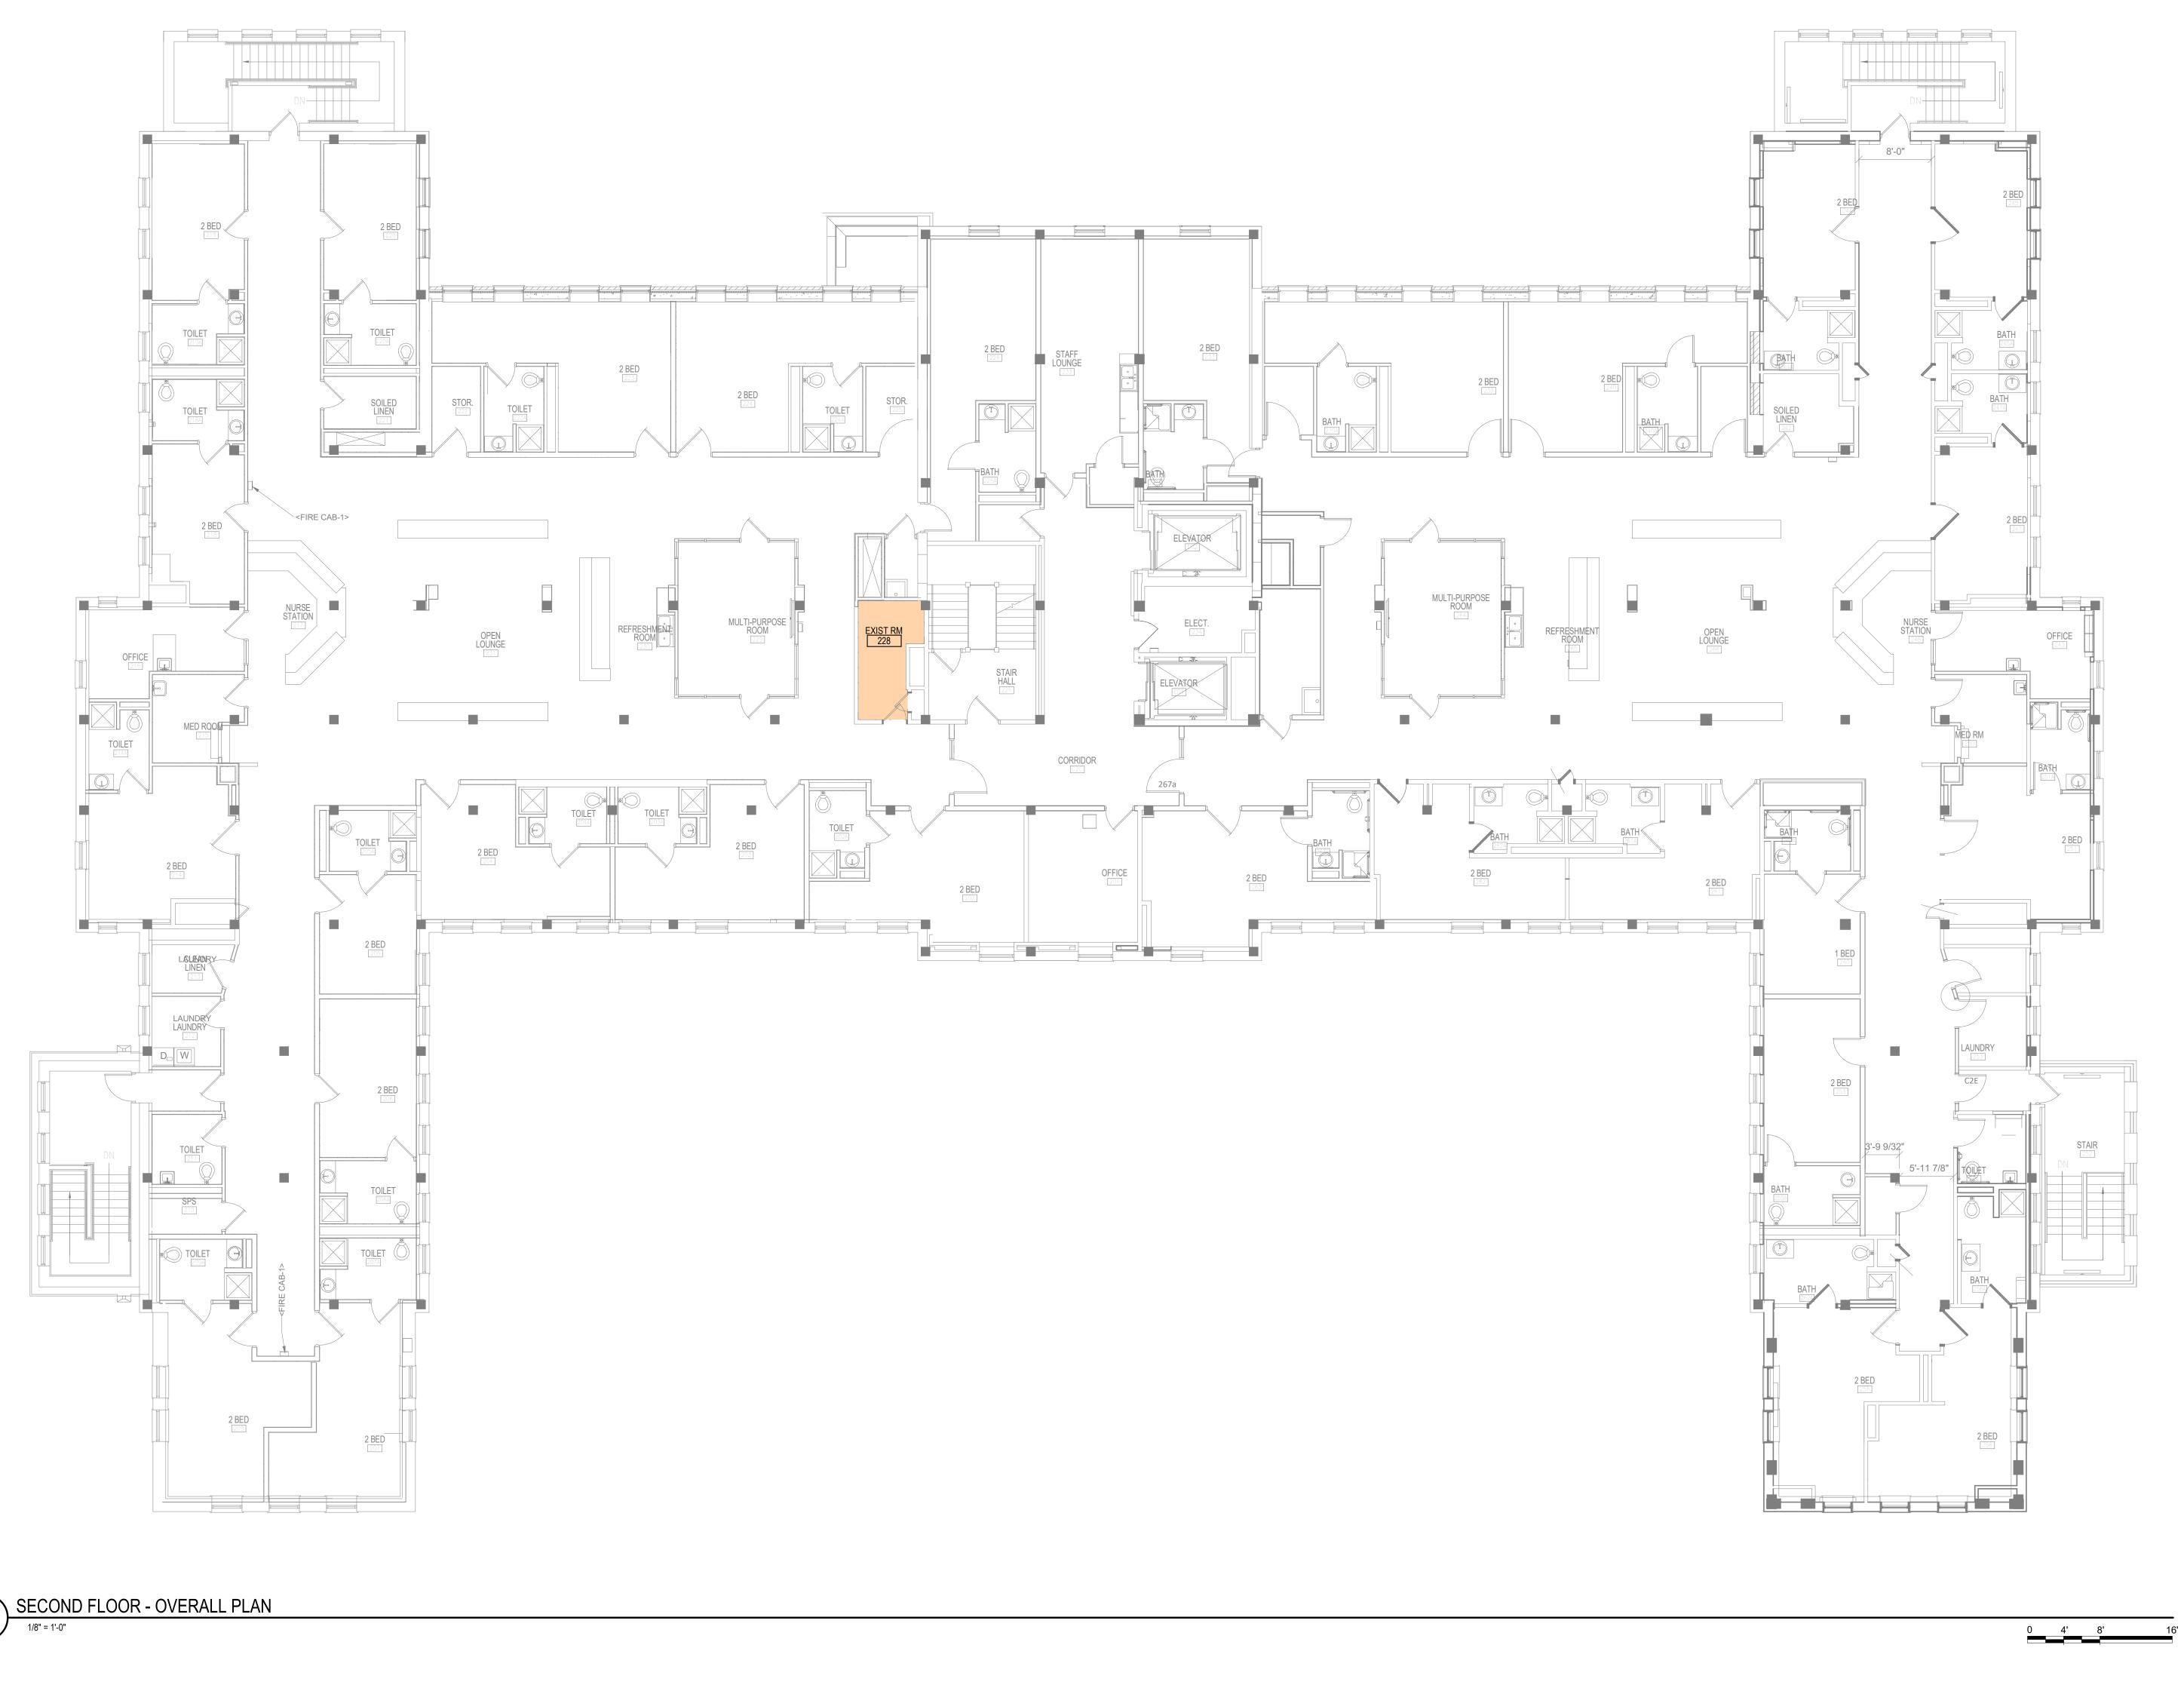
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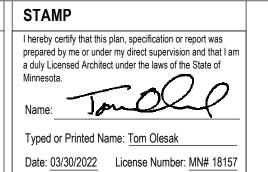
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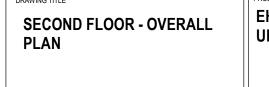
4. SEE CIVIL, STRUCTURAL, TELECOM, ELECTRICAL, MECHANICAL, AND PLUMBING DRAWINGS AND SPECIFICATIONS FOR ADDITIONAL DEMOLITION AND CONSTRUCTION REQUIREMENTS.


PORTABLE FIRE EXTINGUISHERS (CO2 OR HALOGENATED TYPE AS DETERMINED BY VA) WITH WALL MOUNT BRACKET AND CODE REQUIRED SIGNAGE SHALL BE PROVIDED BY THE CONTRACTOR WITHIN TELECOM







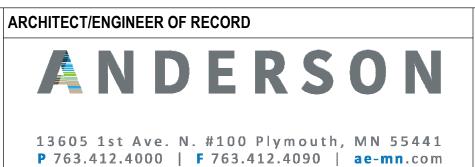

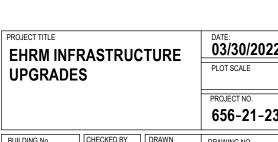


FULLY SPRINKLERED


VA MEDICAL CENTER ST.CLOUD, MN 56303






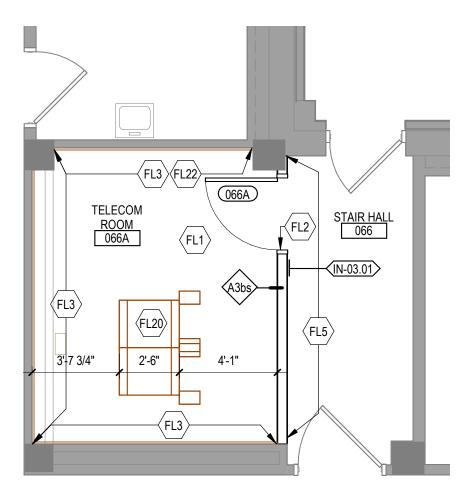




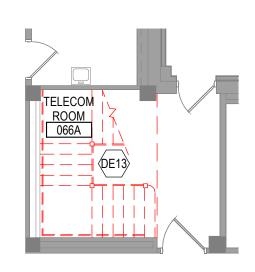



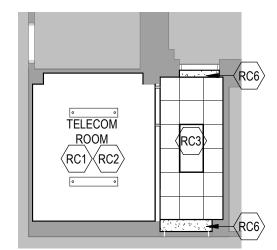





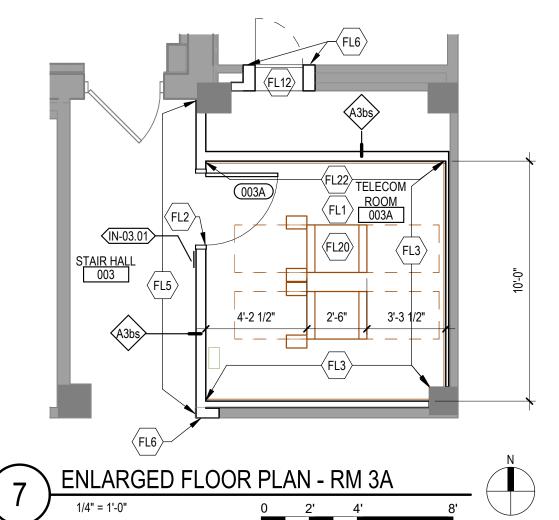


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#### DEMOLITION PLAN KEYED NOTES

- PREPARE WALL FOR PLYWOOD BACKBOARD INSTALLATION AND EHRM REQUIREMENTS, SEE FLOOR PLAN AND TELECOM DRAWINGS
- REMOVE AND SALVAGE DOOR AND PREPARE OPENING TO ACCOMMODATE PLAN. SEE FLOOR PLAN AND DOOR SCHEDULE
- REMOVE WALL PARTITION IN ITS ENTIRETY.
- PARTIALLY REMOVE WALL TO ACCOMMODATE PLAN AS REQUIRED. COORDINATE TEMP SHORING WITH STRUCTURAL. SEE FLOOR PLAN
- DEMO, REMOVE AND DISPOSE CONCRETE STAIRS INCLUDING WALL RAILINGS, ETC. AS REQUIRED FOR THE CONSTRUCTION OF FIRST FLOOR CONCRETE INFILL. SEE STRUCTURAL

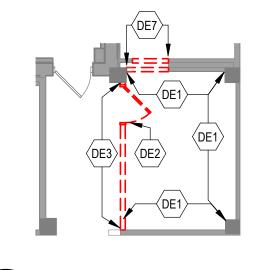NOTE: NOT ALL KEYED NOTES MAY BE USED ON EACH PLAN
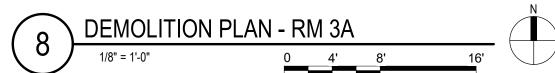
# \_FLOOR PLAN KEYED NOTES

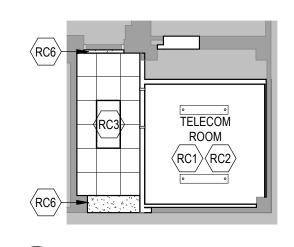- ALL FOUR PERIMETER WALL PARTITIONS APPLY 4' BY 8' AC GRADE 3/4" TRADE SIZE FIRE RATED PLYWOOD BACKBOARD FINISHED WITH HIGH-GLOSS WHITE PAINT OVER TWO COATS OF FIRE RESISTANT PAINT FOR SERVICE PROVIDER / SECURITY / VIDEO / ET CETERA. DO NOT PAINT OVER FIRE RATING STAMP.
- FL2 DOOR, SIZE AS SCHEDULED, FIRE RESISTANT AS SCHEDULED
- FL3 UPGRADE PARTITION TO 1 HOUR FIRE AND SMOKE BARRIER. PROVIDE TESTED HEAD OF PARTITION ASSEMBLY WITH MATERIALS THAT RESIST THE PASSAGE OF SMOKE. SEAL JOINT AT HEAD AND ALL PENETRATIONS
- FL5 FINISH EXTERNAL SIDE OF NEW PARTITIONS WITH P-2 & RB-1
- FL6 FINISH NEW PARTITIONS TO MATCH EXISTING PARTITIONS THIS AREA
- BUILDING MECHANICAL ACCESS DOOR PANEL. COORDINATE LOCATION AND CONSTRUCTION DETAILS WITH ADJACENT ROOM FUNCTION. VERIFY EXISTING CONDITION IN FIELD. FOLLOW MANUFACTURER DETAILS FOR

HEAD, DOOR, JAMB, AND SUPPORT REQUIREMENTS

- FL20 TELECOM EQUIPMENT, SEE TELECOM DRAWINGS.
- FL22 LEAK PREVENTION BARRIER WATERPROOFING DETAIL AT EXISTING PARTITION. SEE AS601.

#### REFLECTED CEILING PLAN KEYED NOTES

- RC1 LED LIGHTING, SEE ELECTRICAL. IN FRONT OF AND BEHIND CABINET ROWS PROVIDE 500 LUMENS IN HORIZONTAL AND 200 LUMENS IN THE VERTICAL AT 3 FT AFF. OPERATED BY MOTION SENSOR PER CABINET ROW OR SECTION.
- RC2 OPEN TO STRUCTURAL FLOOR ABOVE
- RC3 ACT SYSTEM AND 2X4 LIGHT FIXTURE, MATCH EXIST ADJACENT CEILING. SEE ELECTRICAL
- GYP SOFFIT. 1/2" GYP BD ON MTL STUD AFFIXED TO OPENING LIMITS,

NOTE: NOT ALL KEYED NOTES MAY BE USED ON EACH PLAN

#### SHEET NOTES

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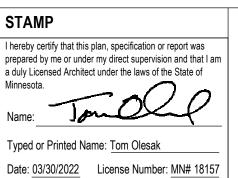
ARCHITECT/ENGINEER OF RECORD

NOTE: NOT ALL KEYED NOTES MAY BE USED ON EACH PLAN

WITH FIRE CAULK.

# ANDERSON

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LARGE SCALE PLANS

EHRM INFRASTRUCTURE

03/30/2022




Phone: 402.991.5520

www.specializedeng.com

Omaha, NE 68134

28-AS400 EM VA MEDICAL CENTER SPRINKLERED

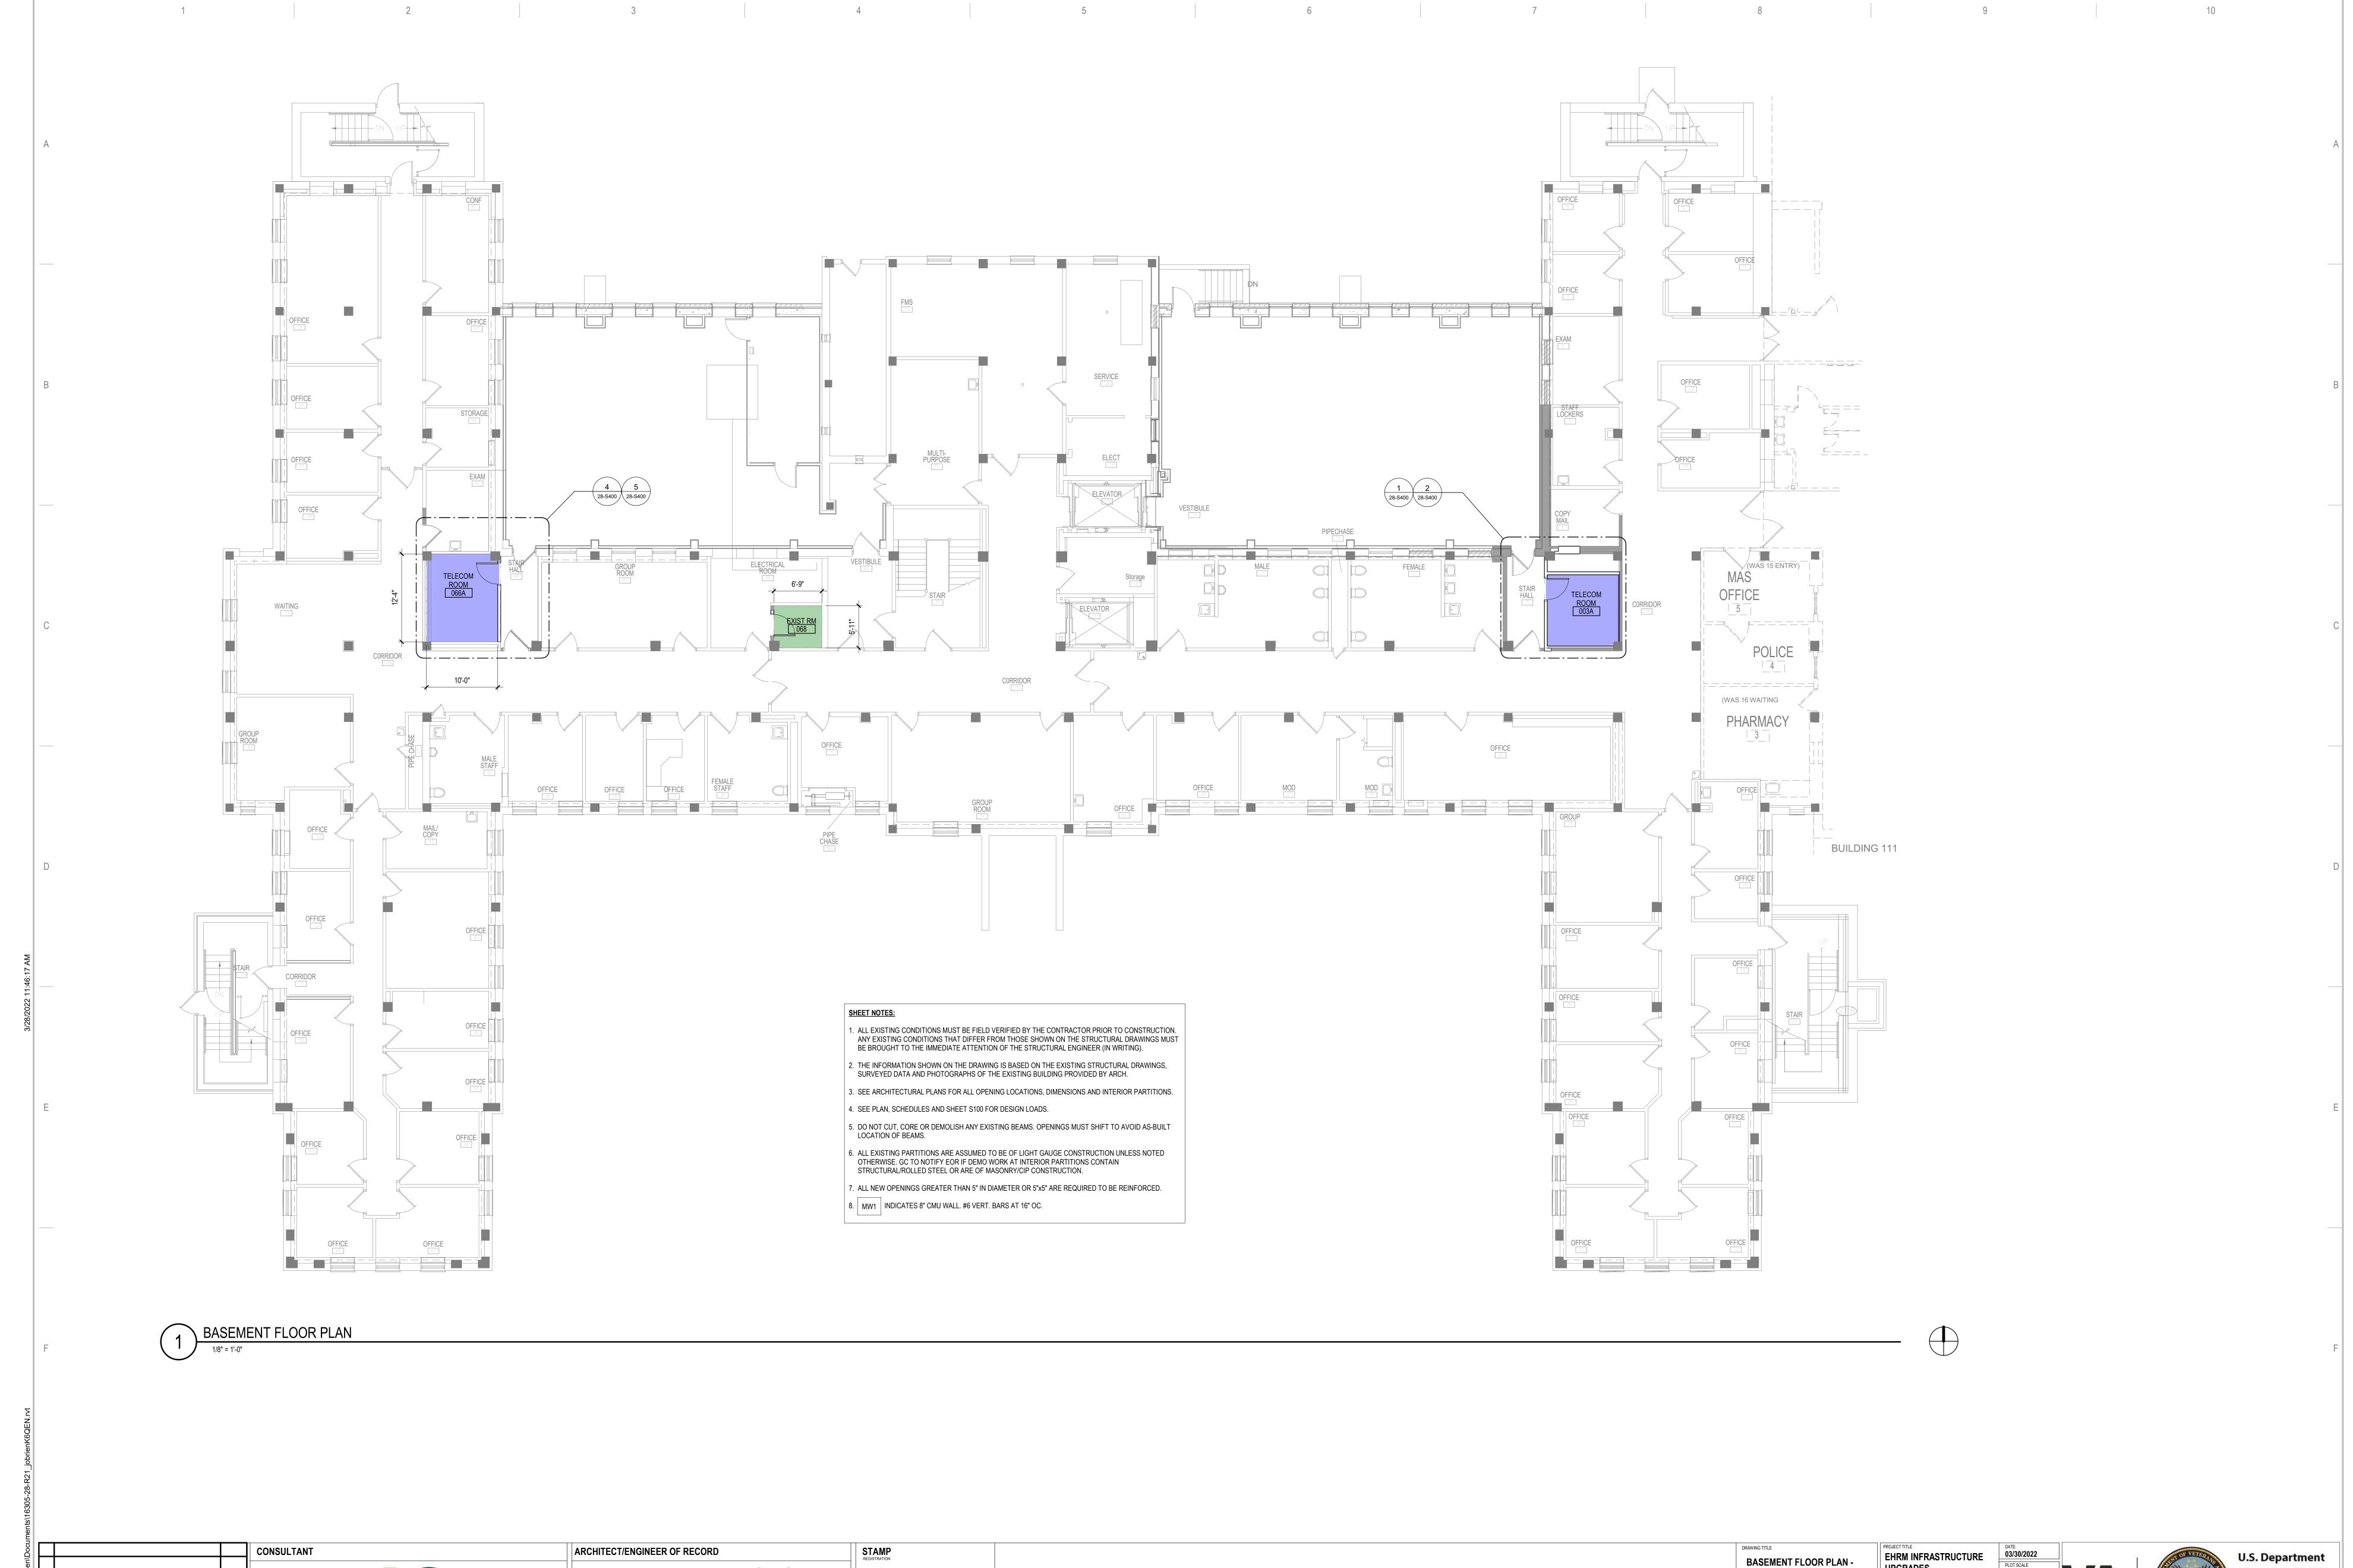

I HEREBY CERTIFY THAT THIS PLAN, SPECIFICATION, OR REPORT WAS PREPARED BY ME OR UNDER MY DIRECT SUPERVISION AND THAT I AM A DULY LICENSED PROFESSIONAL ENGINEER UNDER THE LAWS OF THE STATE OF MINNESOTA.

PRINT NAME: Zachary D. Craig

SIGNATURE:

DATE: 7/30/2022 LICENSE #:57219

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Anderson Engineering of Minnesota, LLC | Proj # 16305

Phone: 402.991.5520

www.specializedeng.com

Omaha, NE 68134

SUITE #215 (952) 854-9302 TEL.

DATE AST PROJECT NUMBER: MN 1964

REVISION

RASTRUCTURE
S

PLOT SCALE

PROJECT NO.
656-21-235

CHECKED BY ZDC

PRAWN JRO
28-S100


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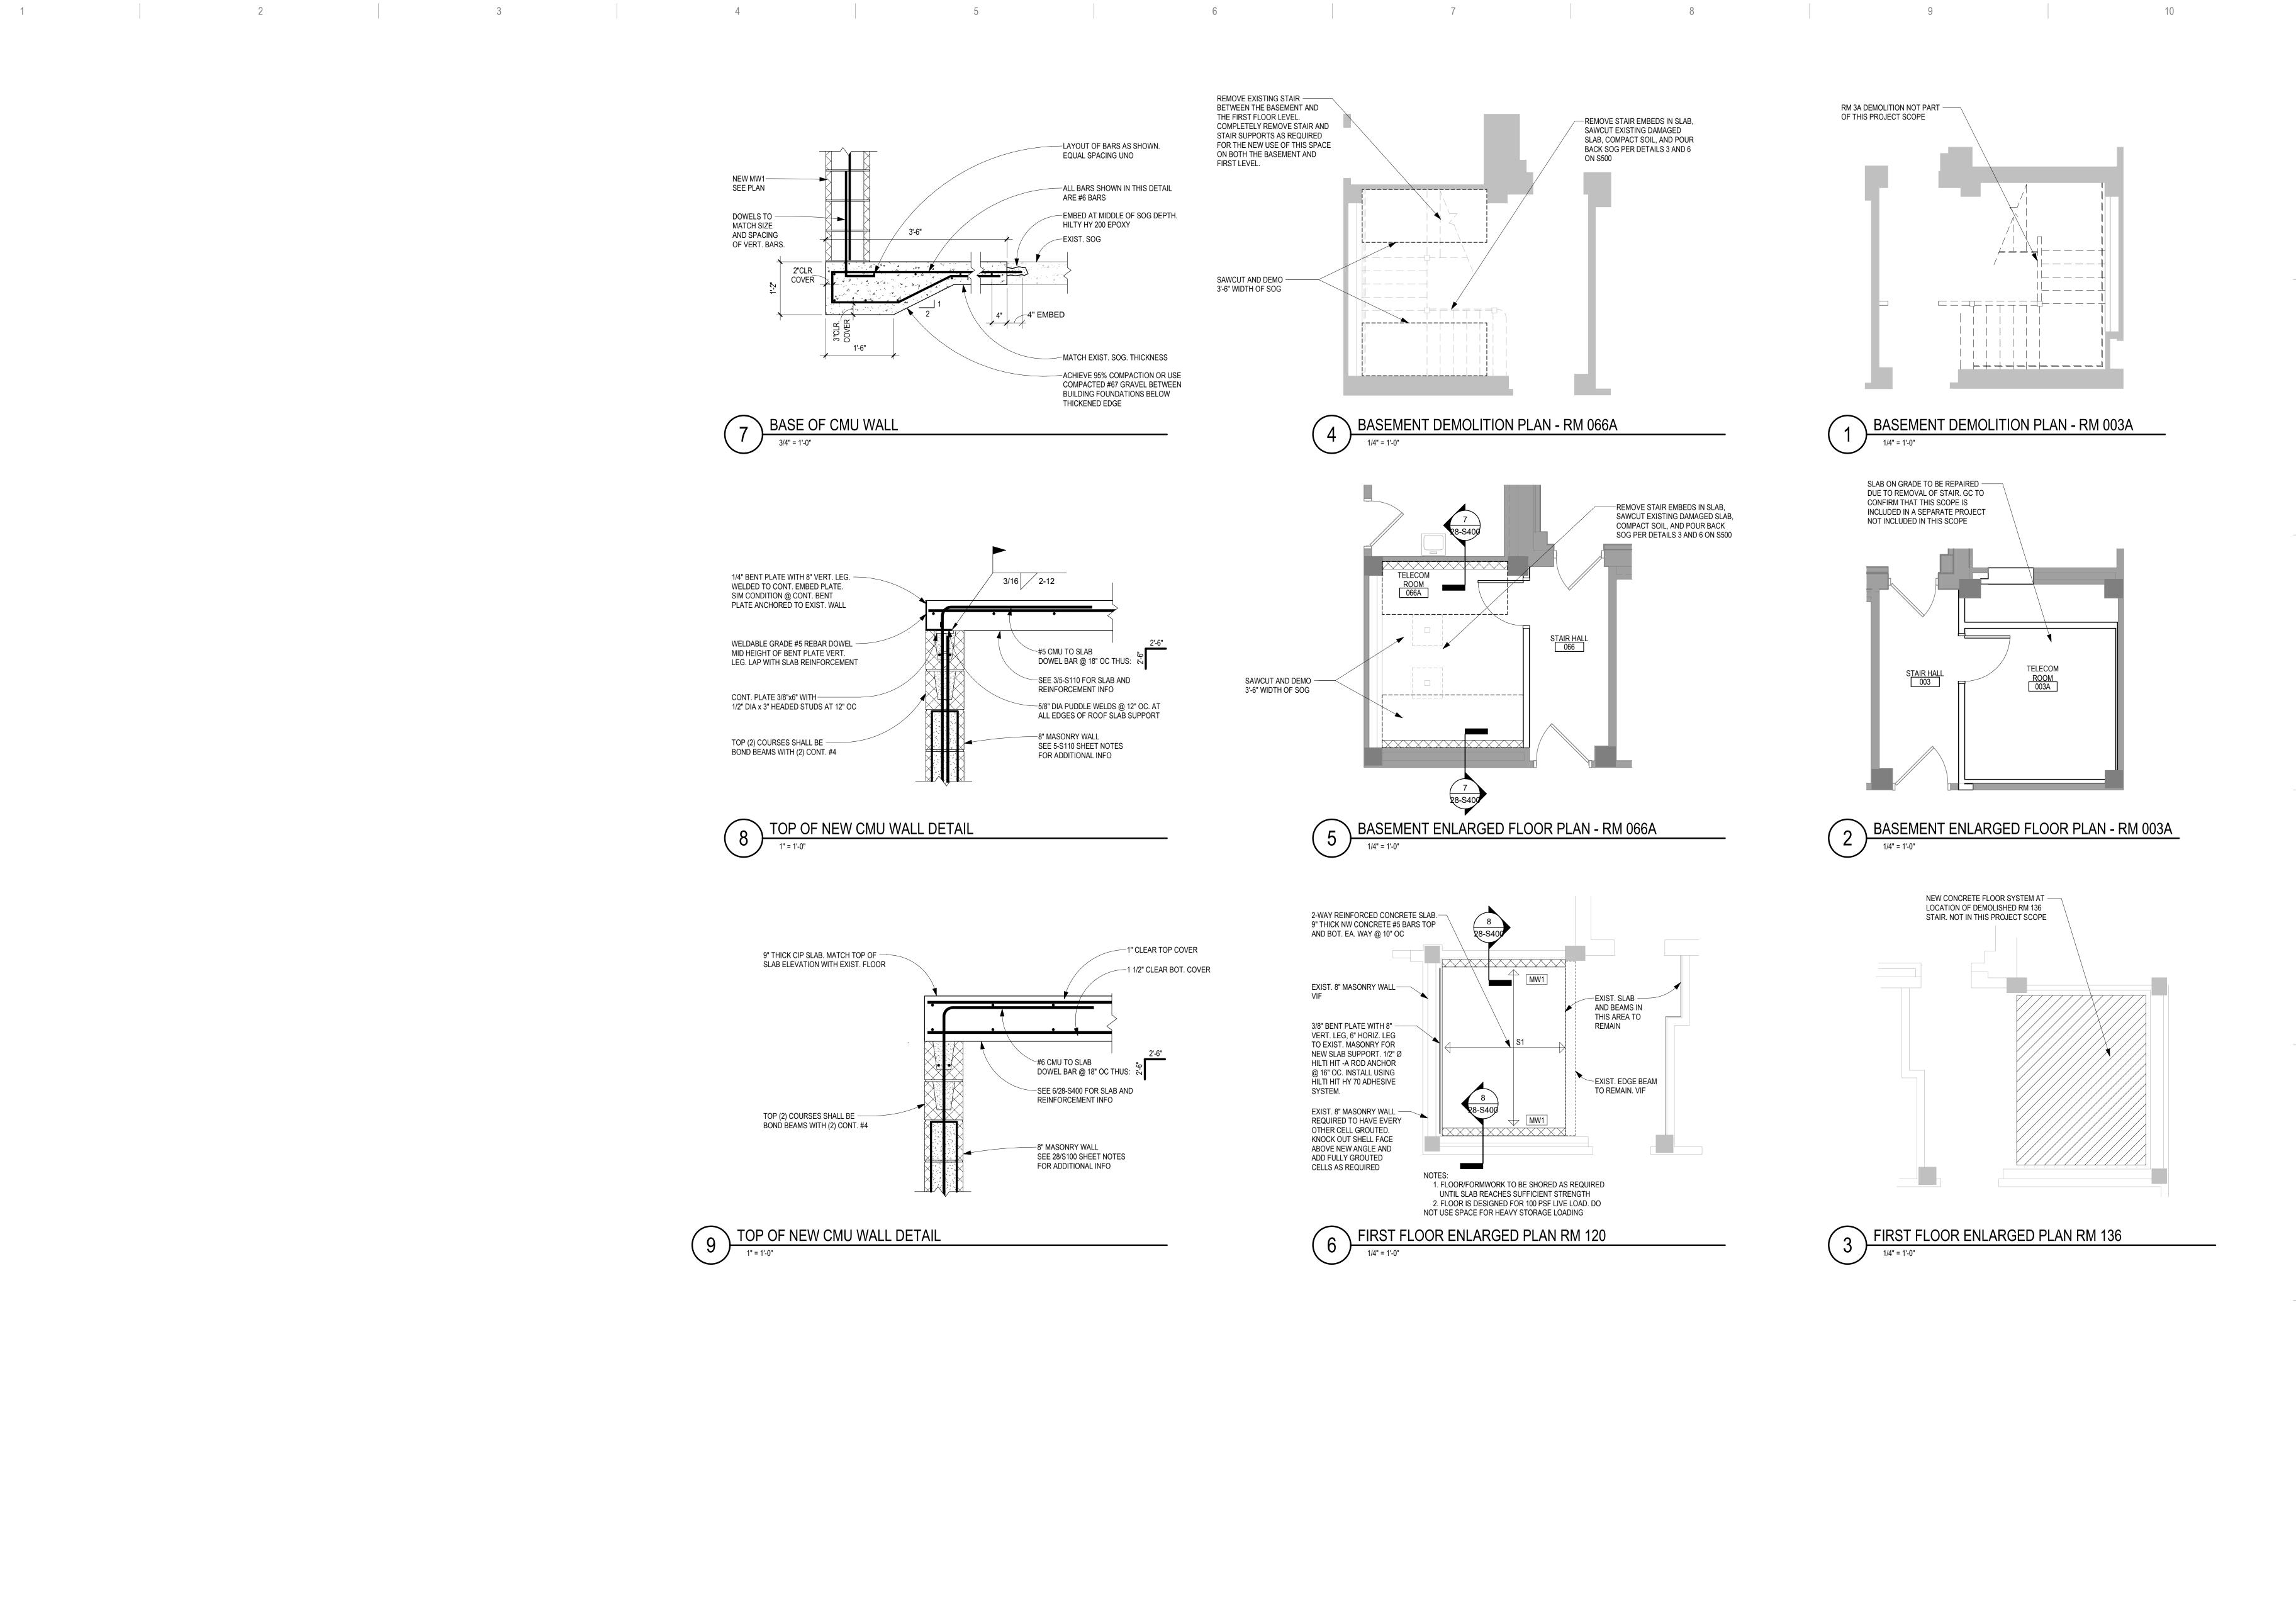
St. Cloud VA
Health Care System

**UPGRADES** 

VA MEDICAL CENTER ST.CLOUD, MN 56303

**OVERALL** 



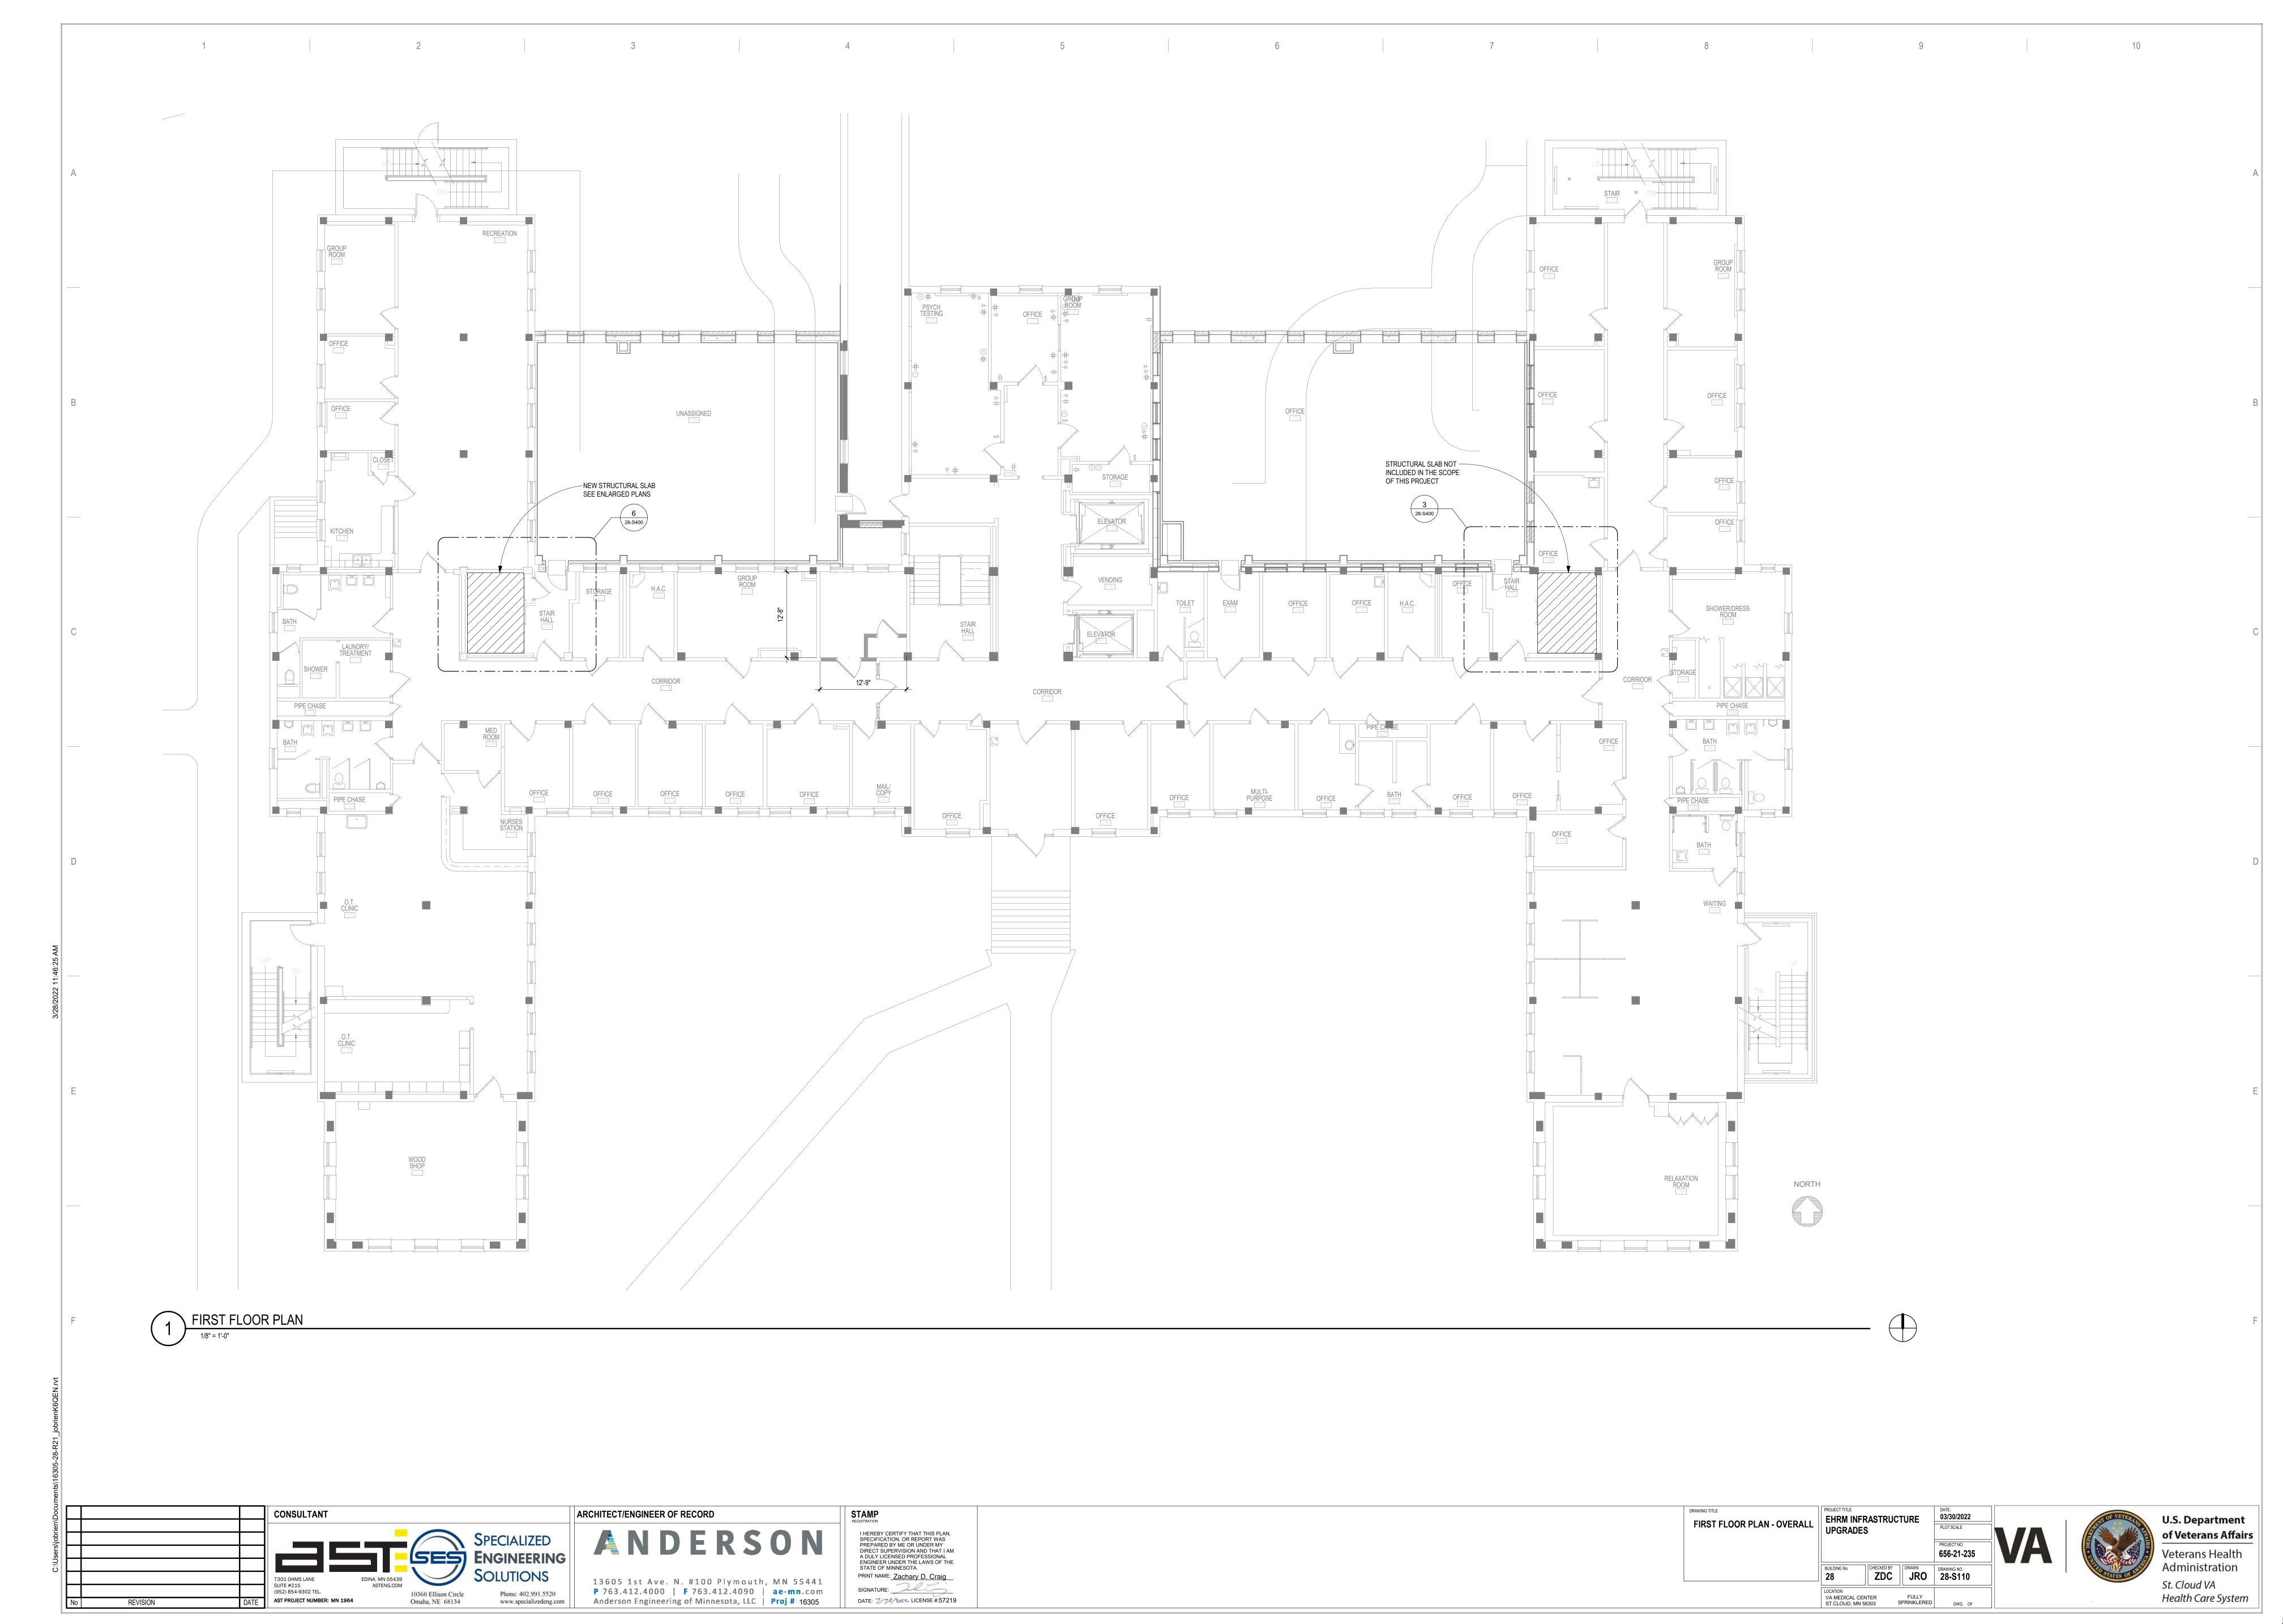

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SOLUTIONS

10360 Ellison Circle
Omaha, NE 68134


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EHRM INFRASTRUCTURE UPGRADES

VA MEDICAL CENTER ST.CLOUD, MN 56303 FULLY SPRINKLERED

RASTRUCTURE

03/30/2022

PLOT SCALE

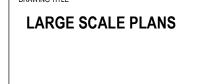PROJECT NO.
656-21-235

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DRAWN DRAWING NO.
28-S400



03/30/2022

KSB SSK 28-TD100

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EHRM INFRASTRUCTURE

VA MEDICAL CENTER ST.CLOUD, MN 56303

BASEMENT FLOOR PLAN -TELECOM - DEMOLITION **U.S. Department** 

of Veterans Affairs

Veterans Health Administration

Health Care System

St. Cloud VA

CONSULTANT

REVISION

ARCHITECT/ENGINEER OF RECORD

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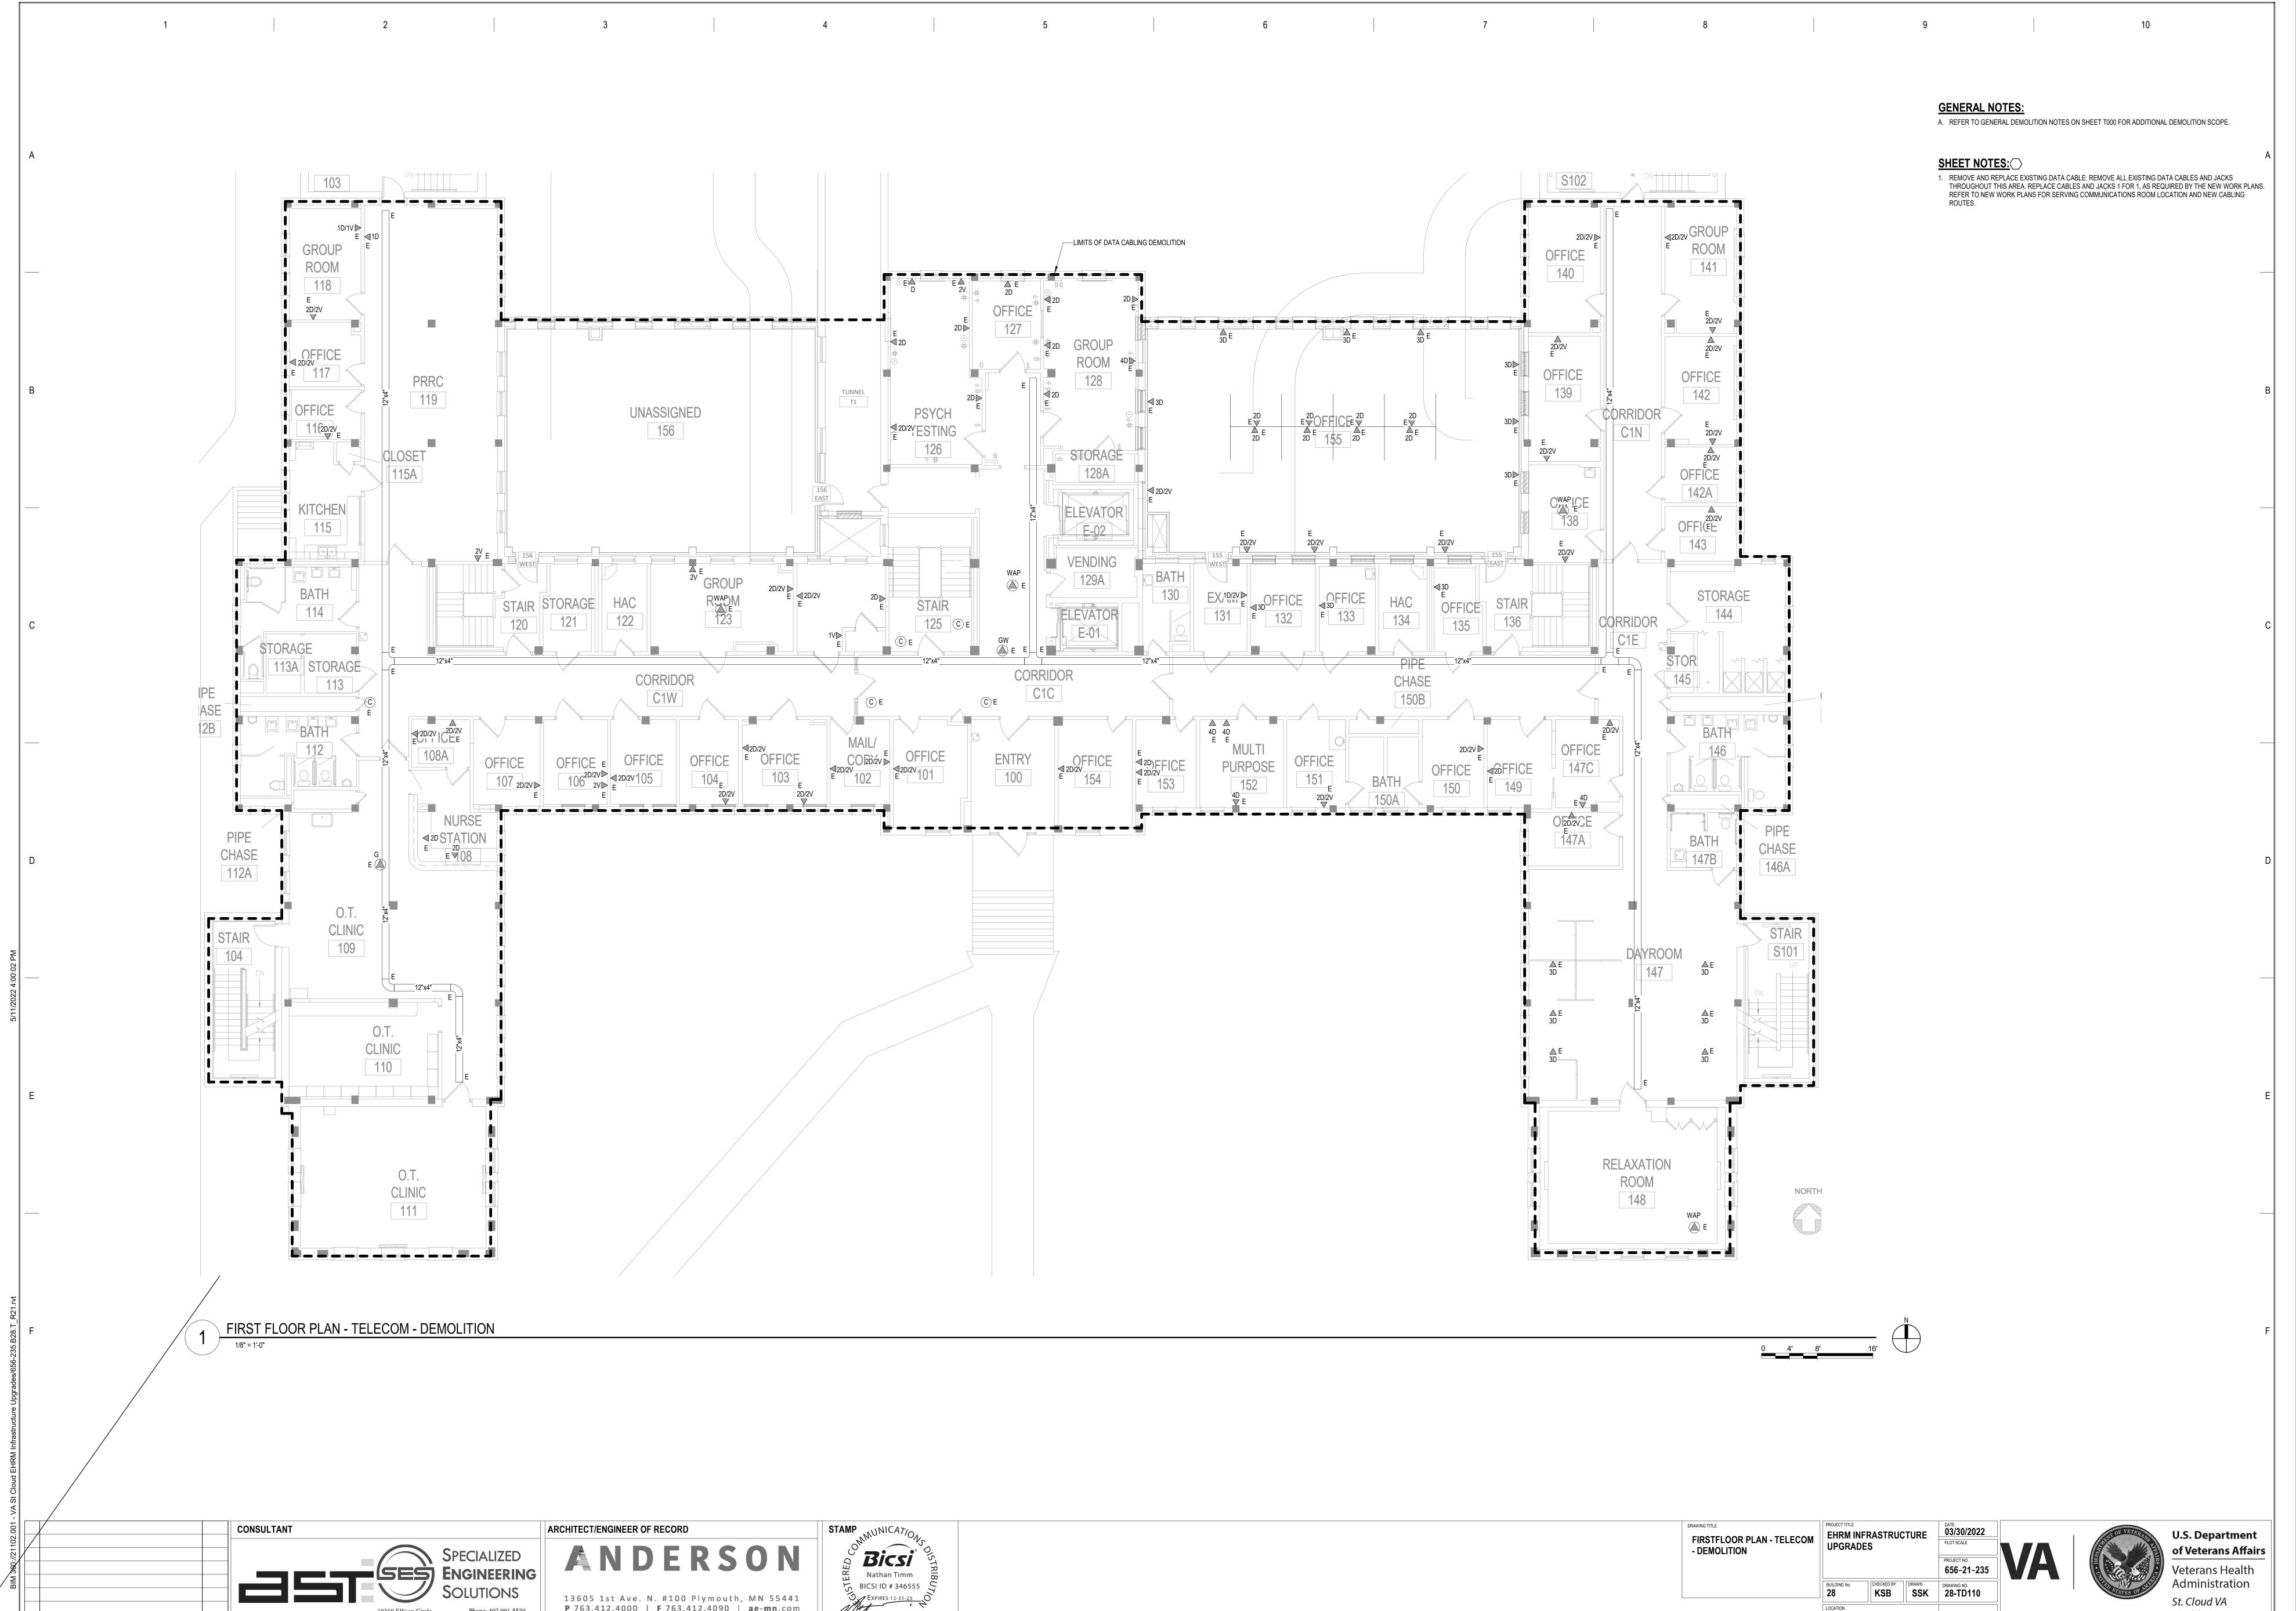
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BICSI ID # 346555

MGtRan M. Timm

EXPIRES 12-31-23

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Materian M. Timm

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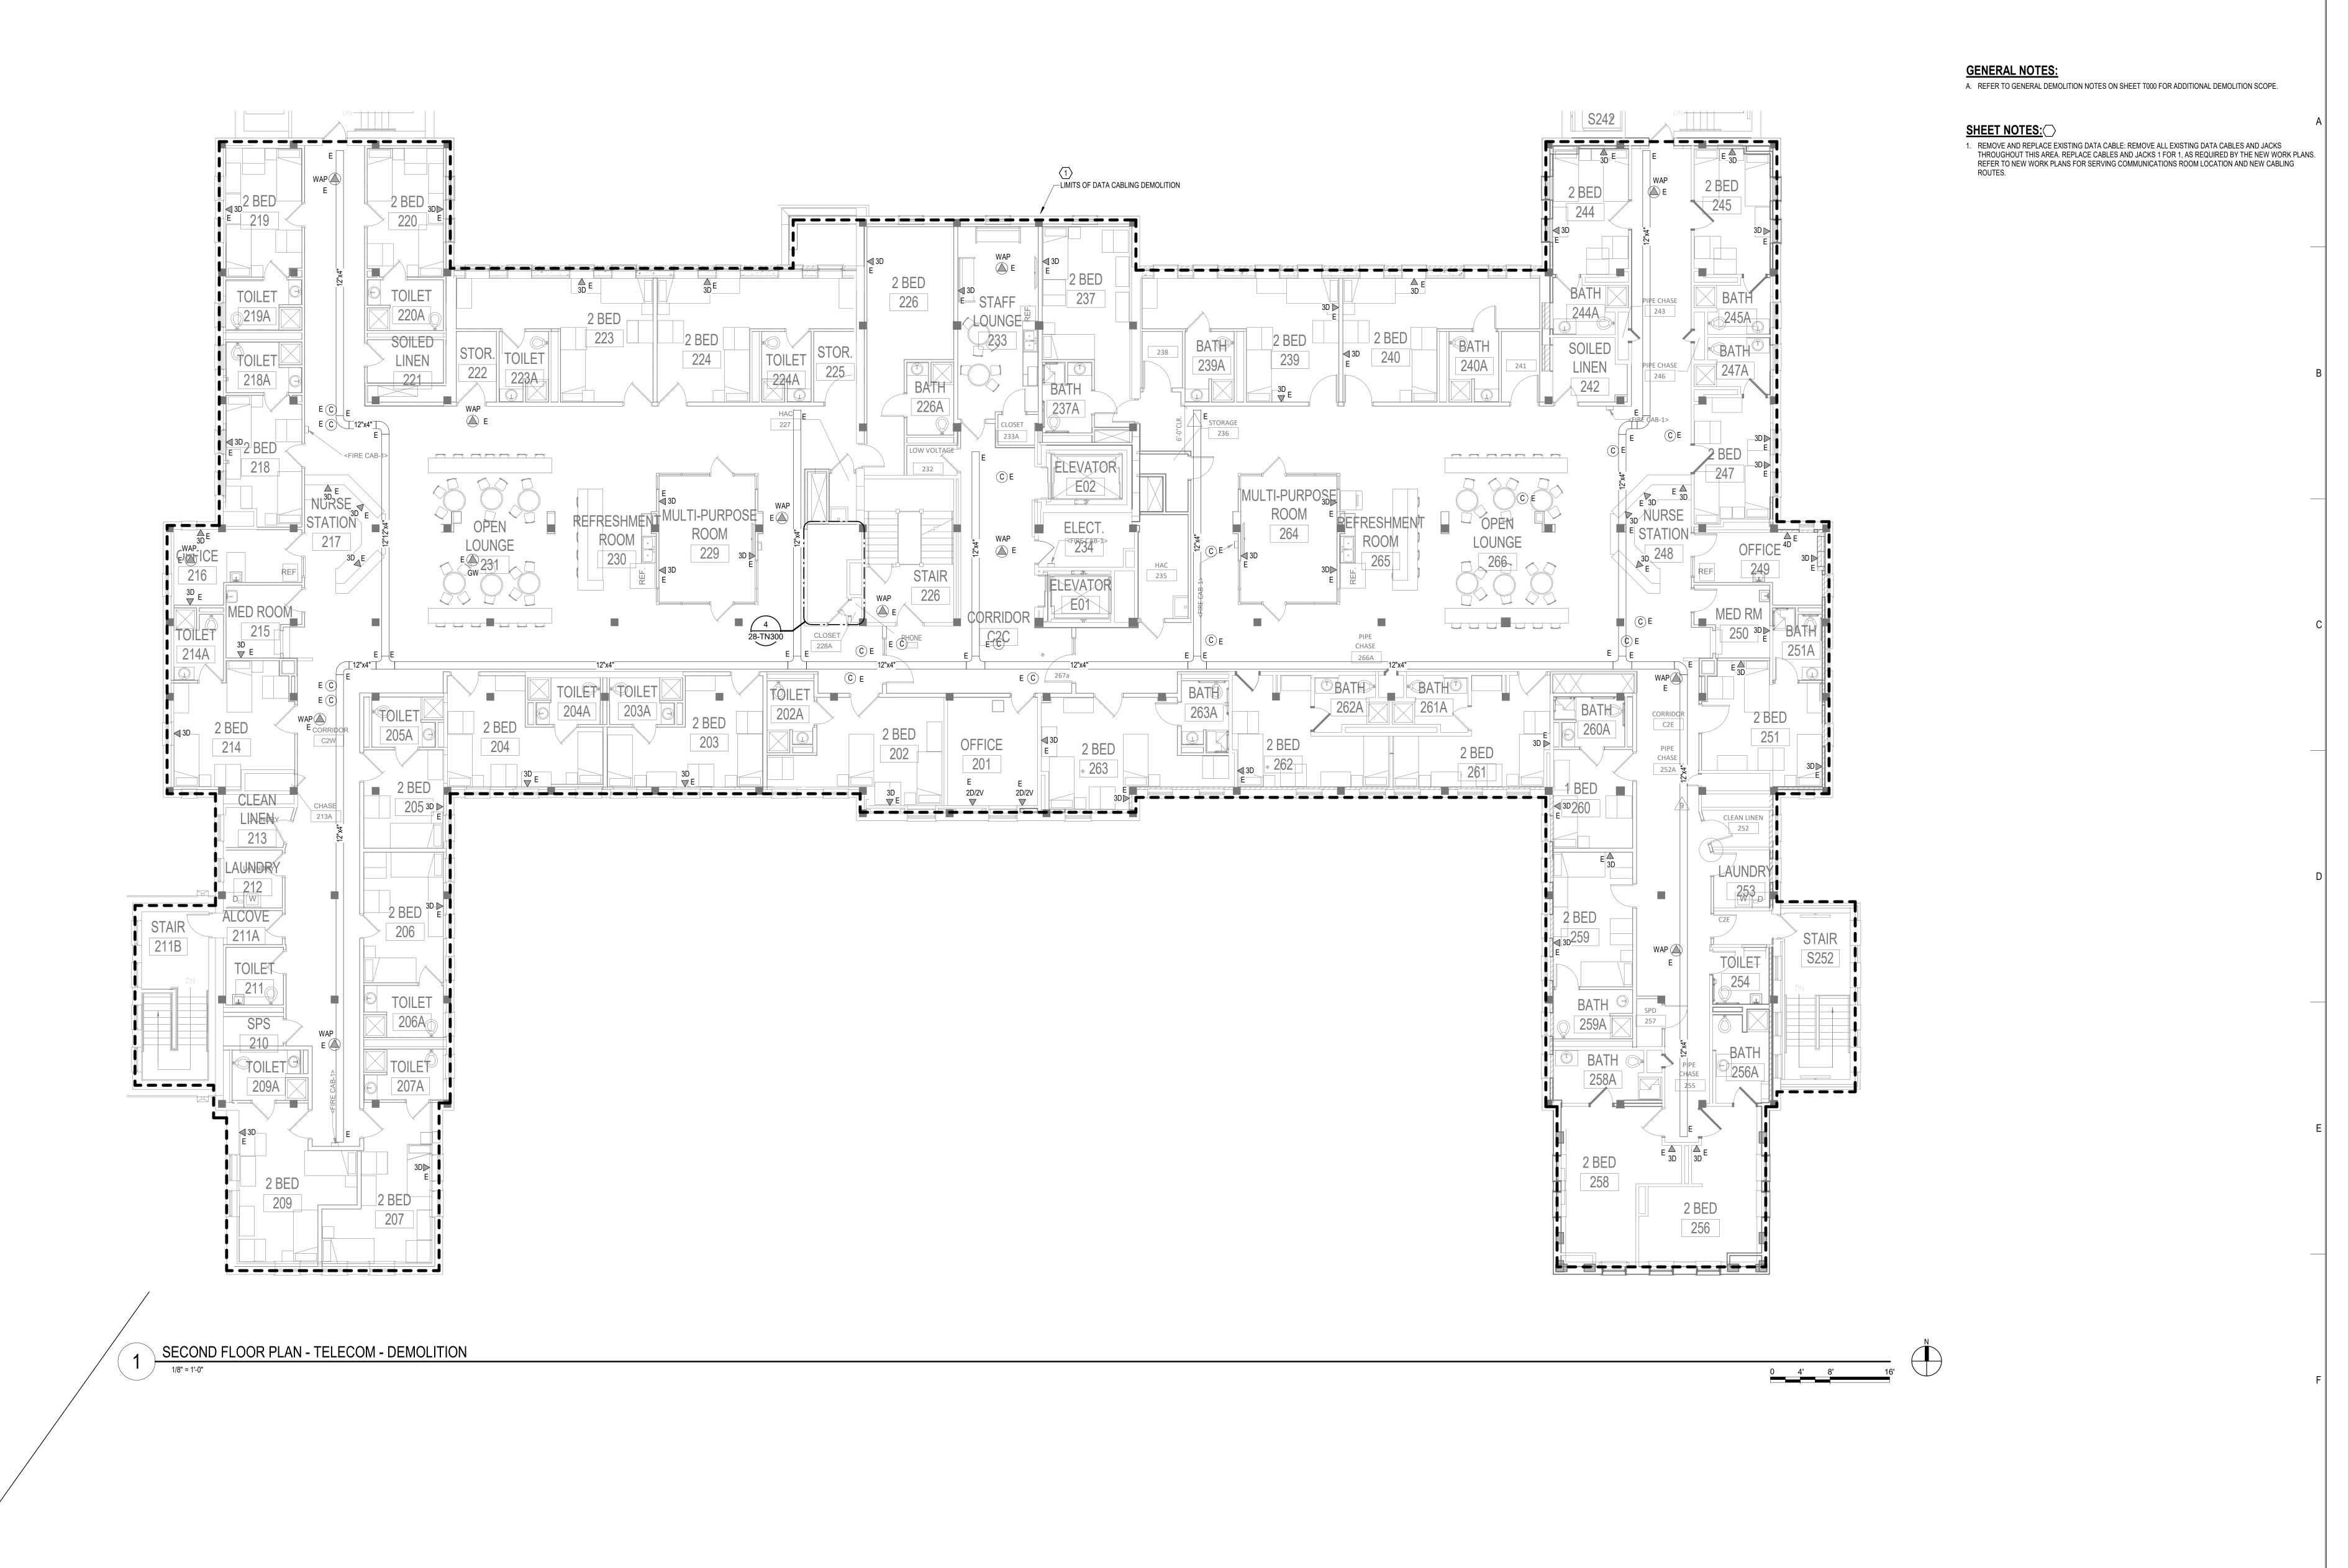
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Mathan M. Timm

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U.S. Department
of Veterans Affairs

Veterans Health
Administration

St. Cloud VA
Health Care System

BUILDING No CHECKED BY KSB DRAWN DRAWING NO 28-TD

LOCATION VA MEDICAL CENTER ST.CLOUD, MN 56303 SPRINKLERED DWG


SECONDFLOOR PLAN -

**TELECOM - DEMOLITION** 

EHRM INFRASTRUCTURE

03/30/2022

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ARCHITECT/ENGINEER OF RECORD
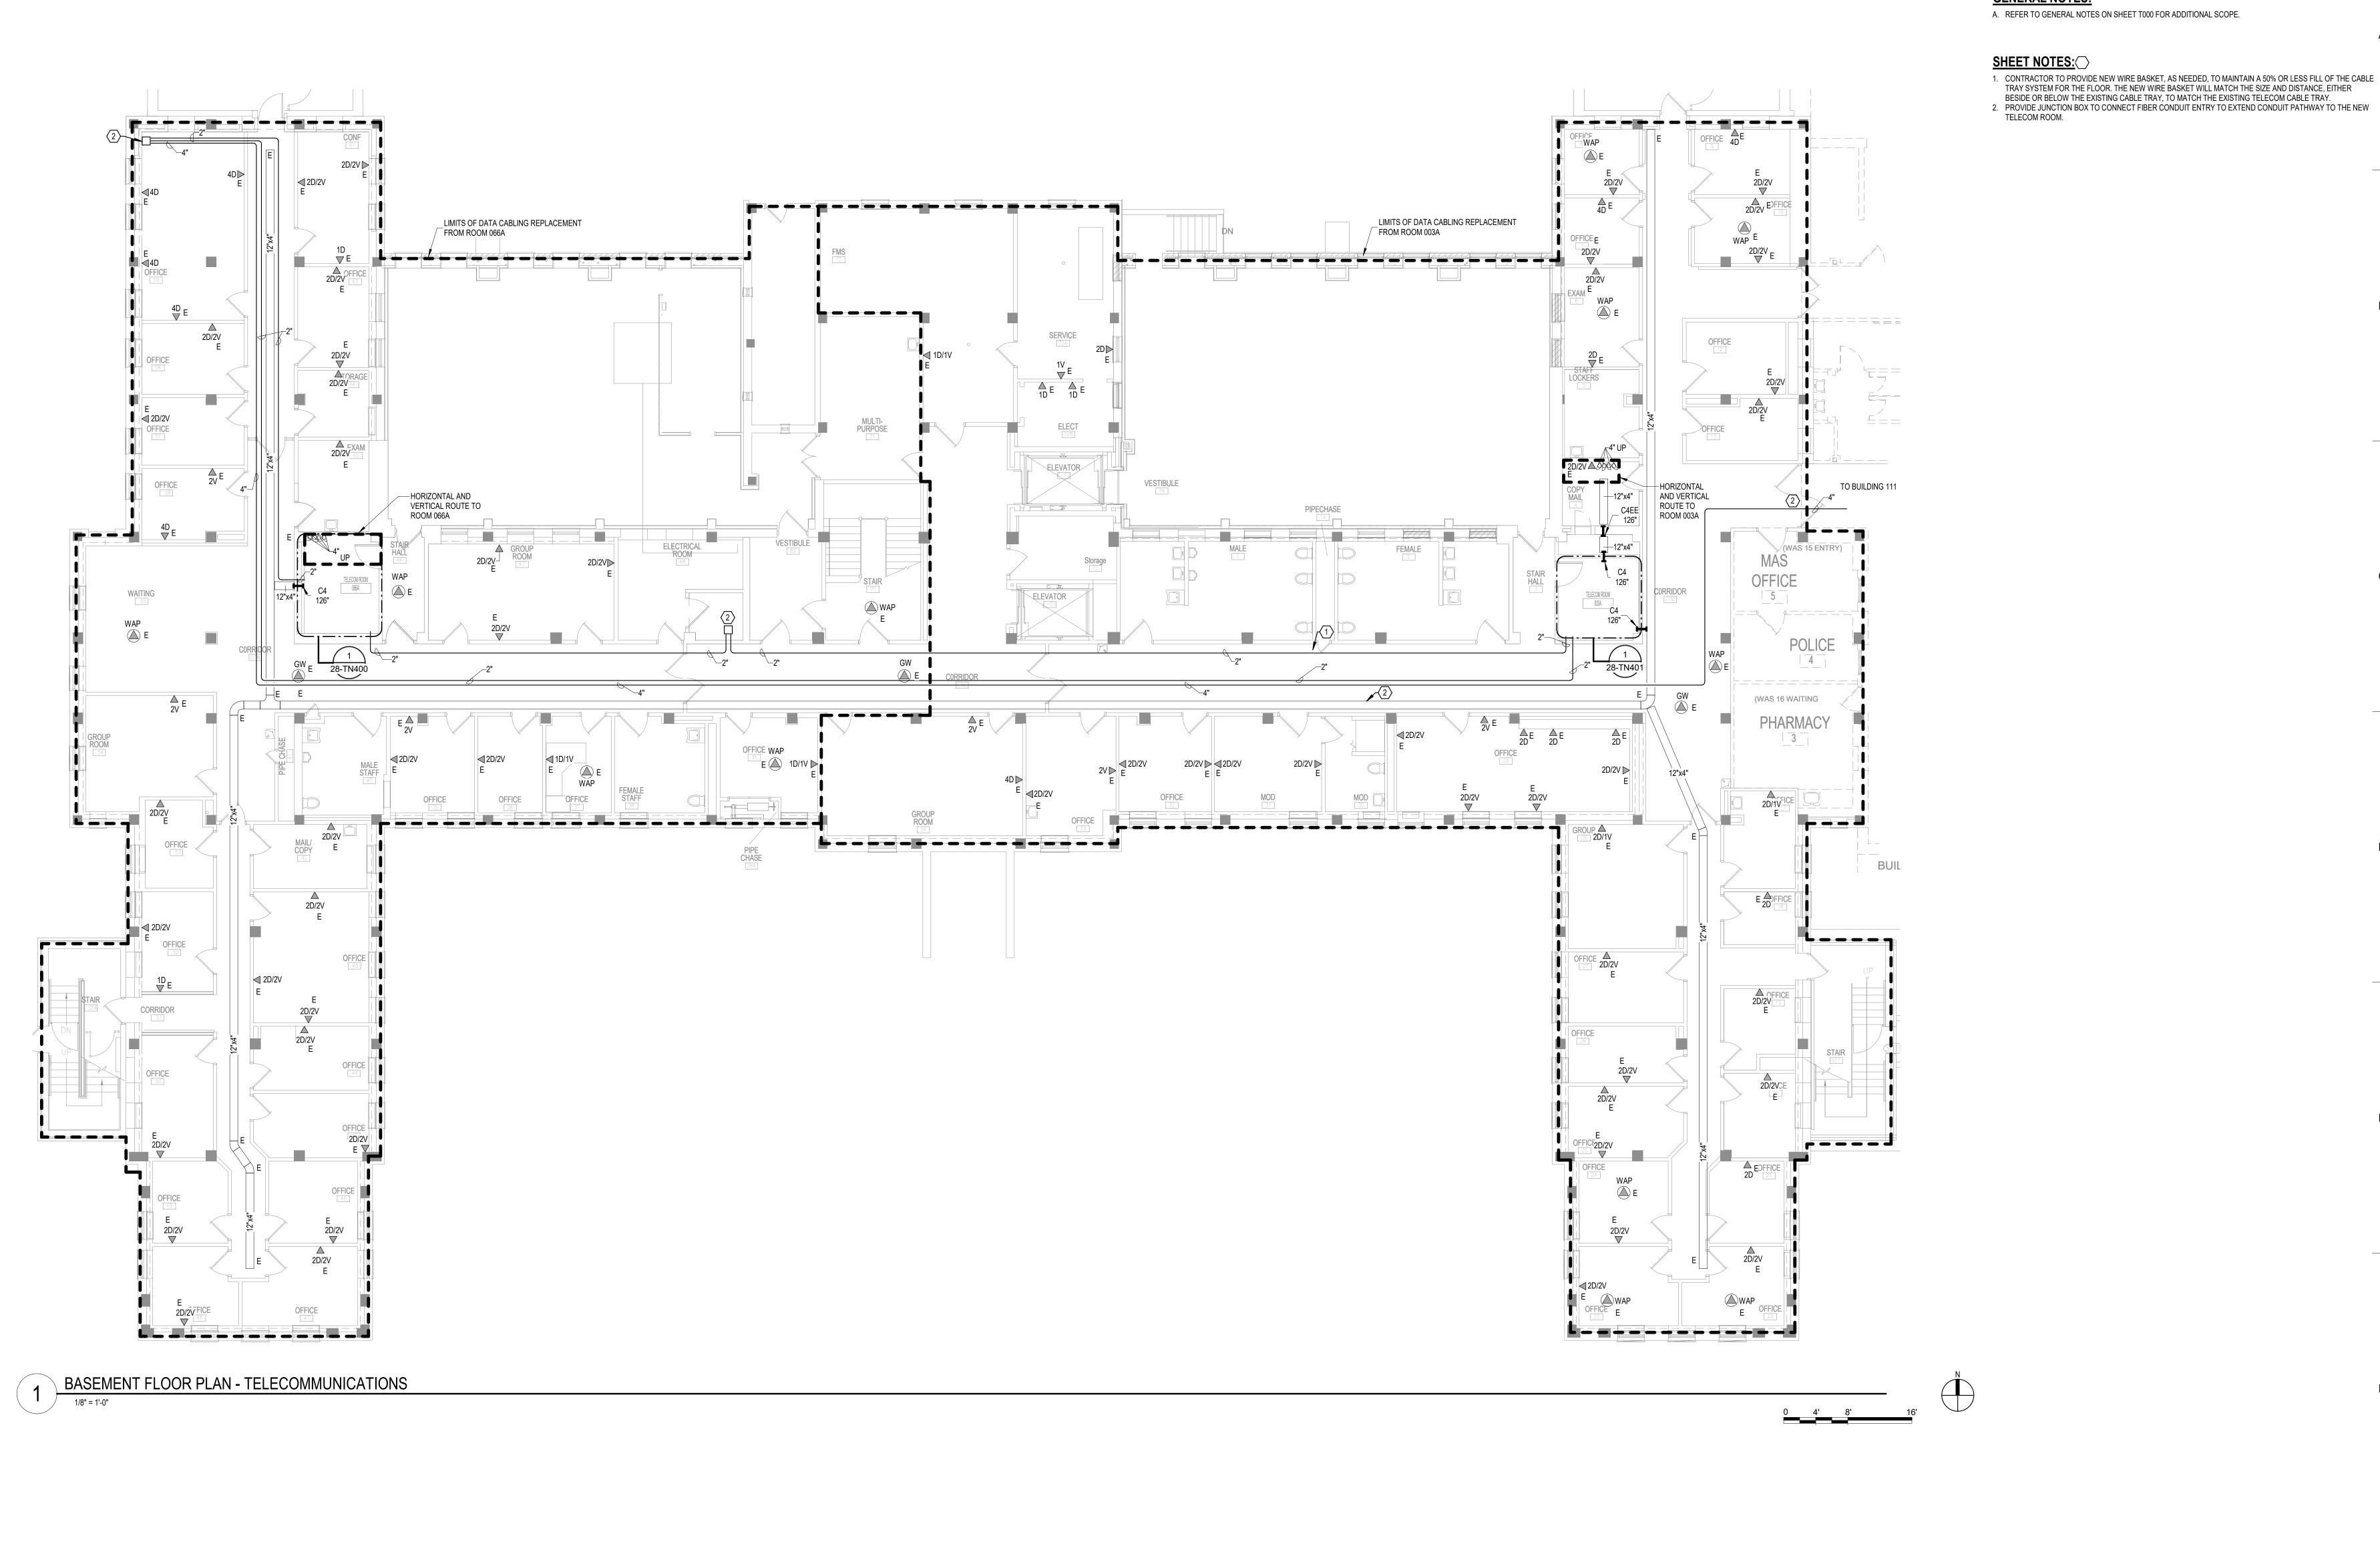
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BICSI ID # 346555

MGtRan M. Timm

EXPIRES 12-31-23

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**GENERAL NOTES:** 

03/30/2022 KSB SSK 28-TN100


EHRM INFRASTRUCTURE

VA MEDICAL CENTER ST.CLOUD, MN 56303

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BASEMENT FLOOR PLAN -TELECOMMUNICATIONS



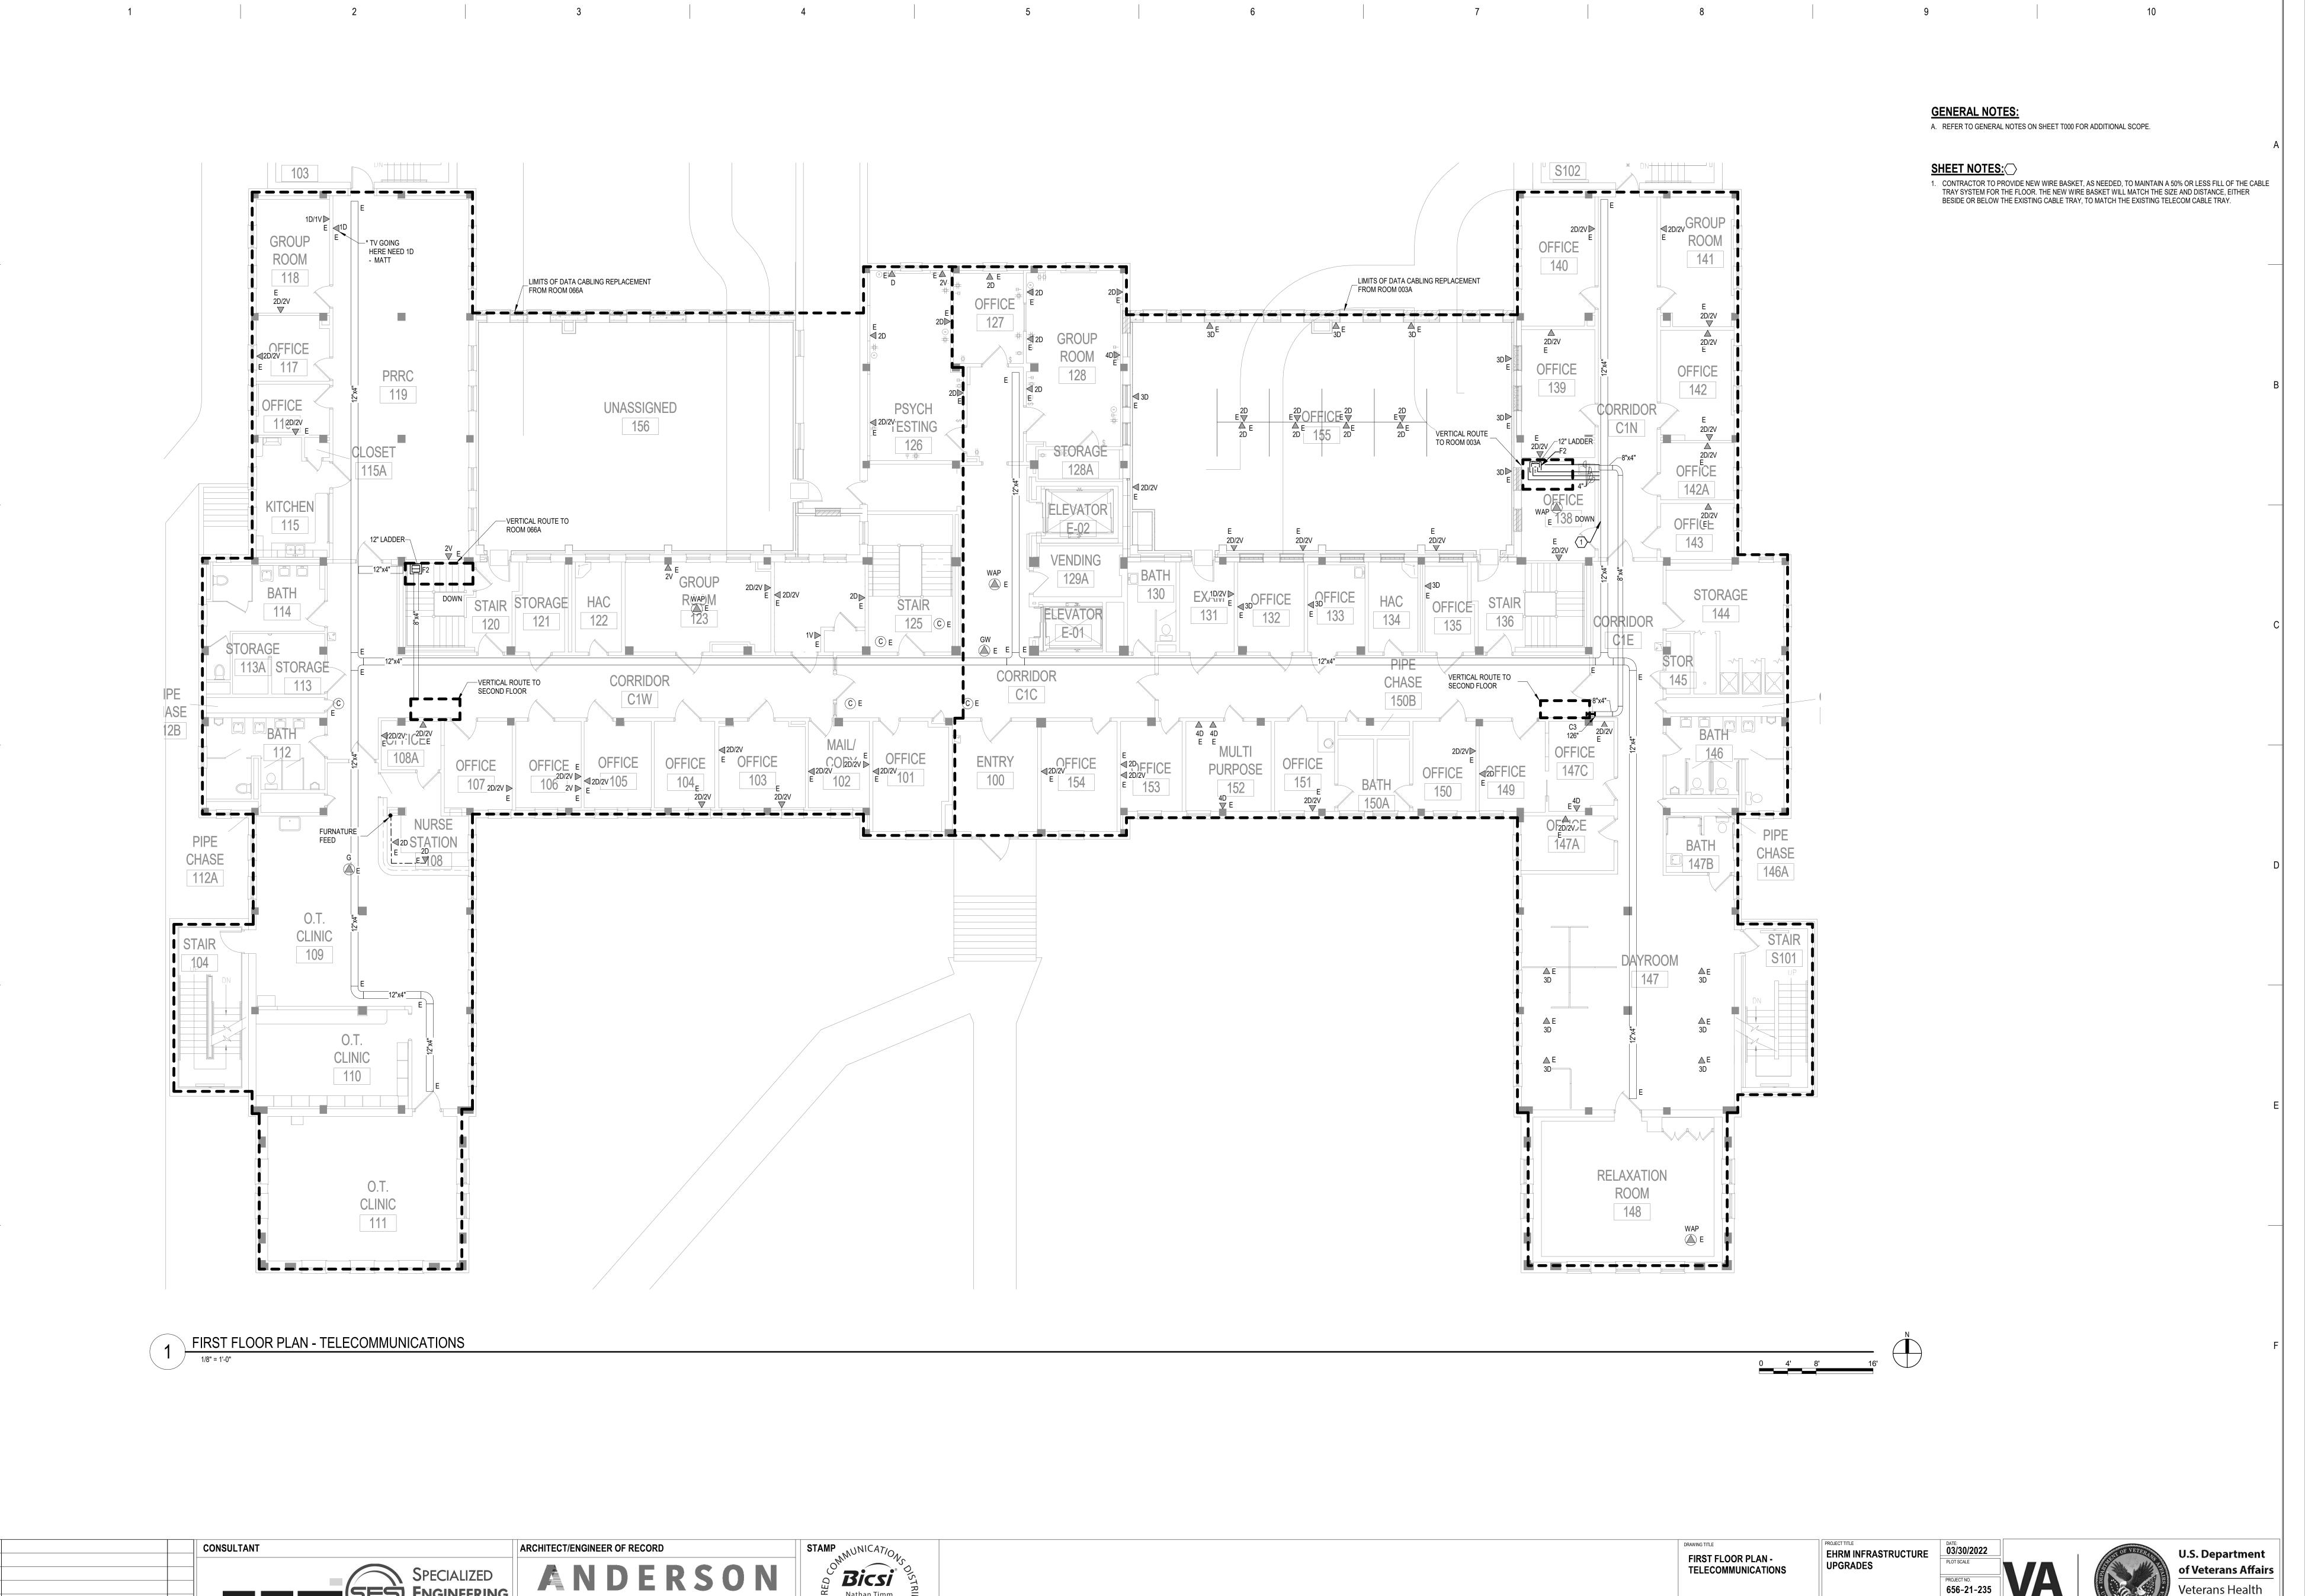

BICSI ID # 346555

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Administration

Health Care System


St. Cloud VA

BUILDING No

VA MEDICAL CENTER ST.CLOUD, MN 56303

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SSK 28-TN110

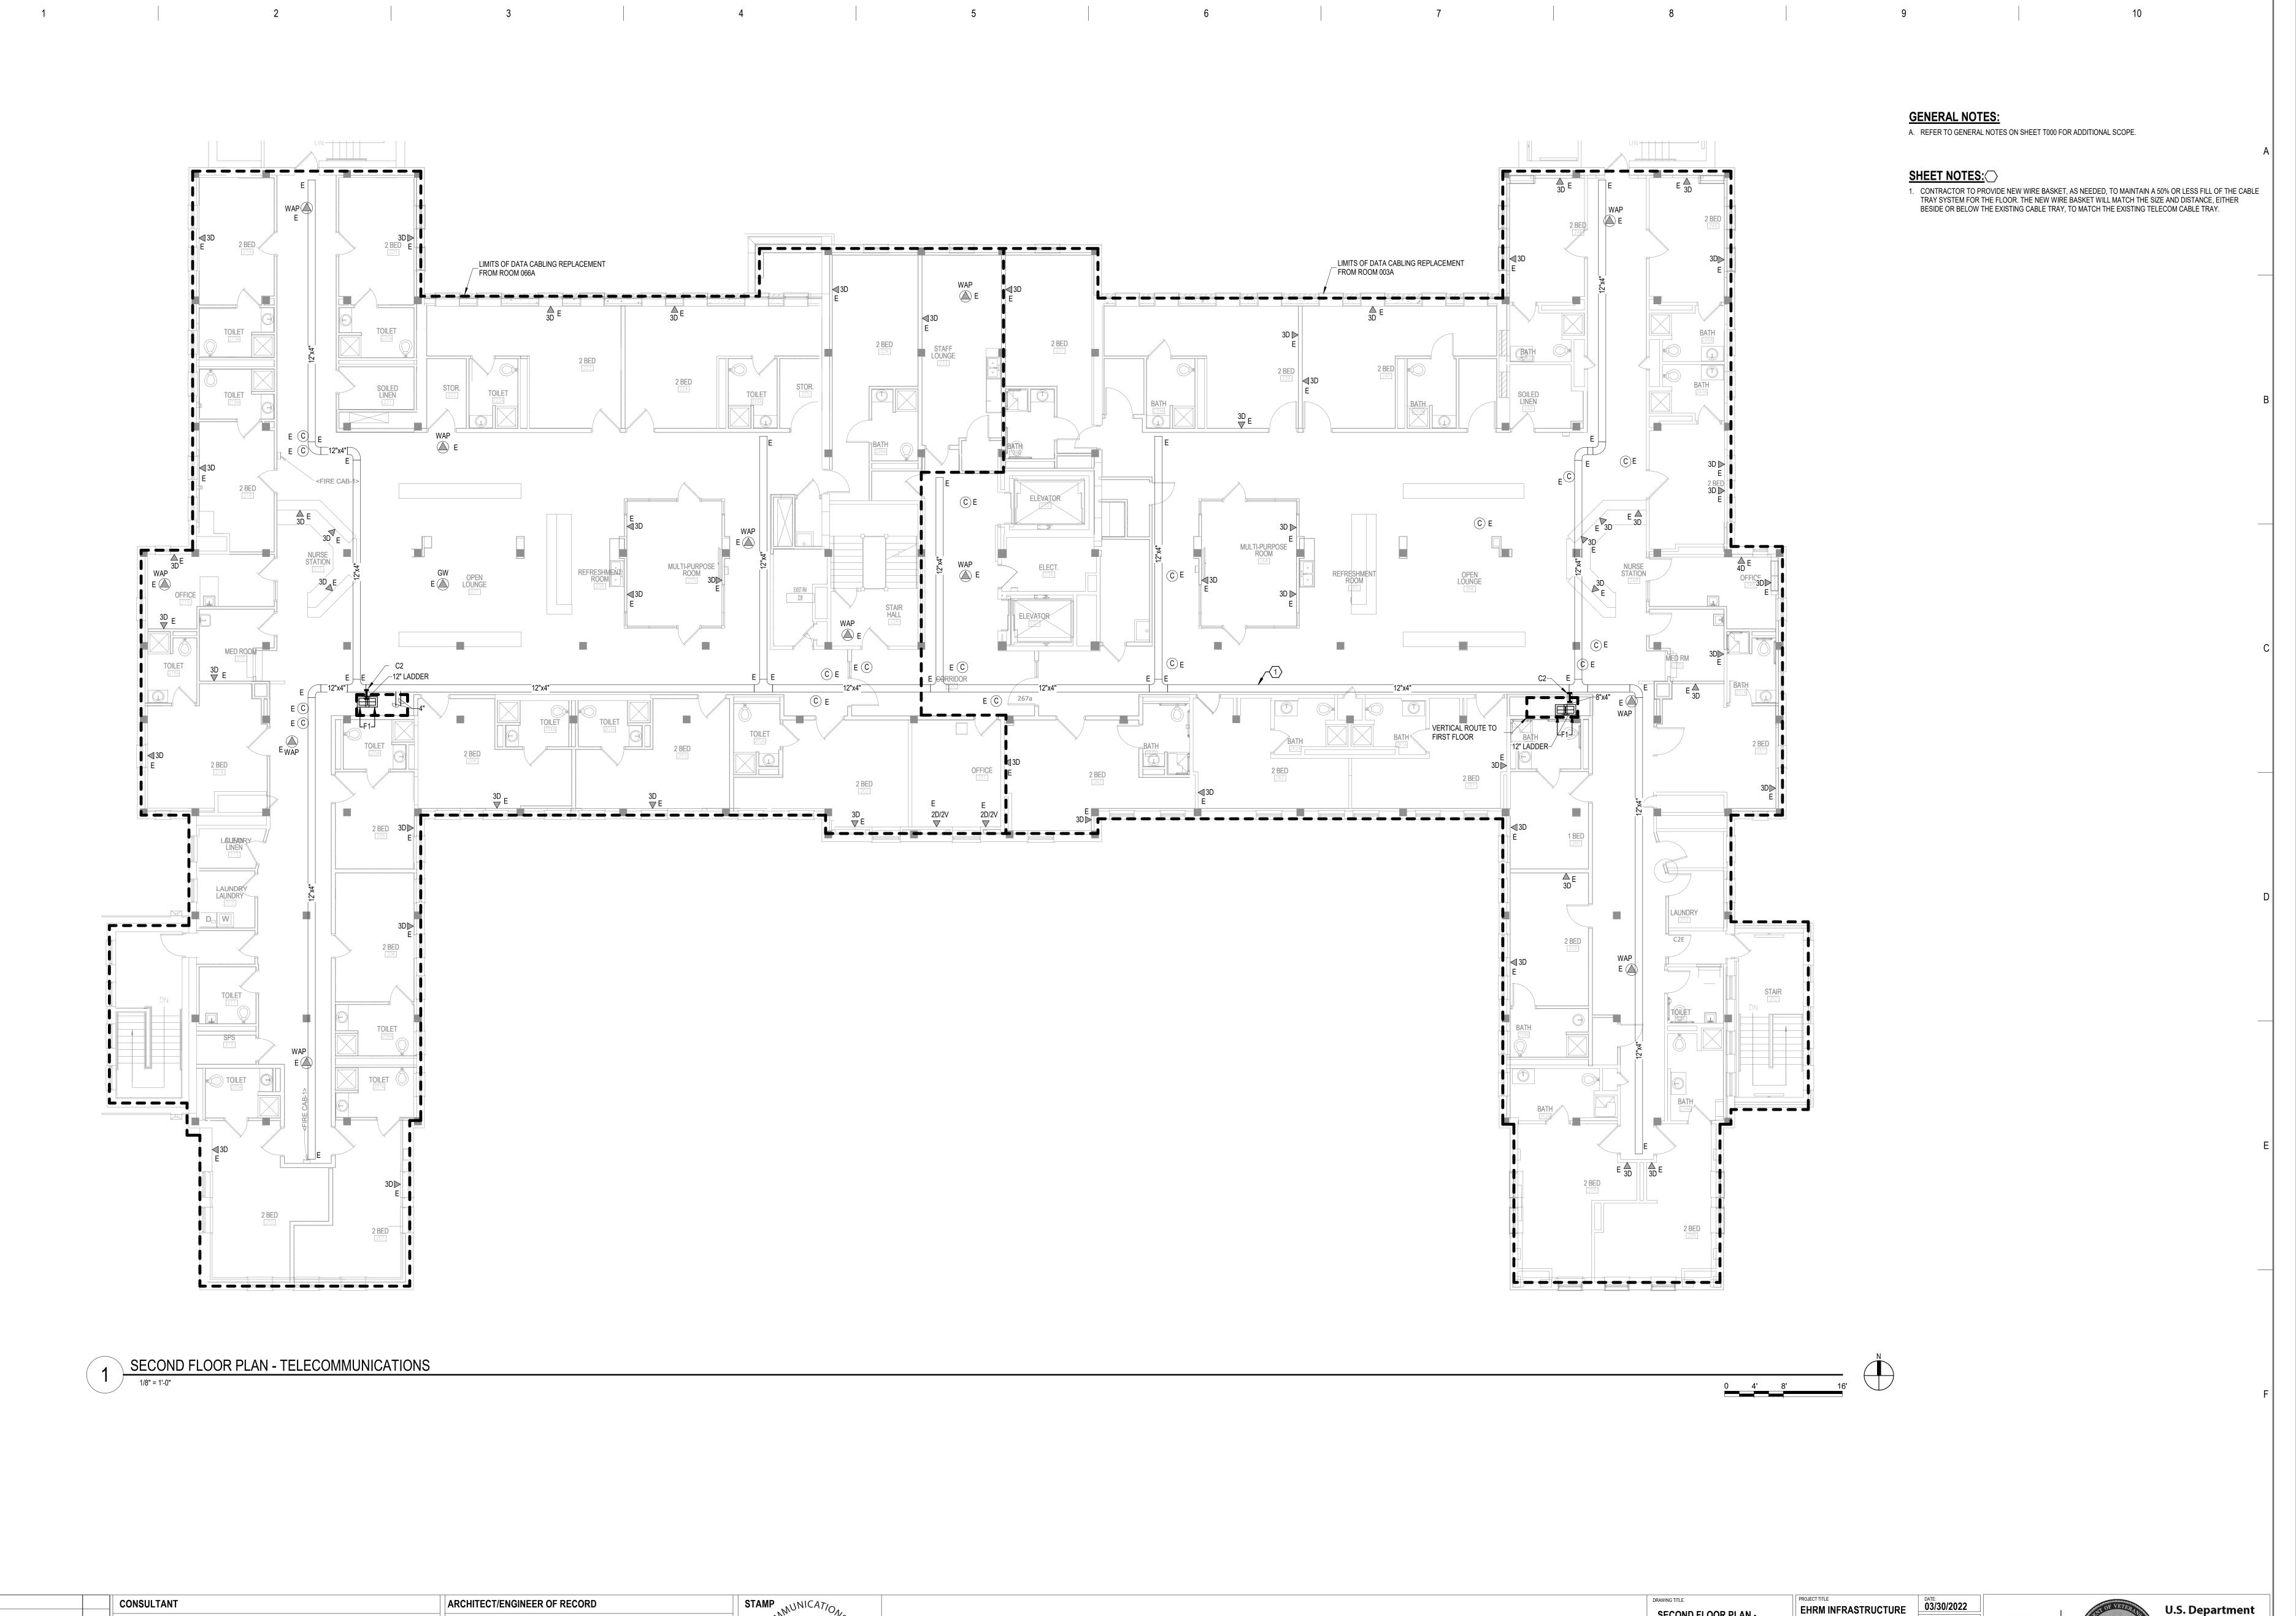

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BICSI ID # 346555

Mathan M. Timm

EXPIRES 12-31-23

U.S. Department of Veterans Affairs Veterans Health Administration St. Cloud VA Health Care System

SECOND FLOOR PLAN -

**TELECOMMUNICATIONS** 


BUILDING No 28

LOCATION

VA MEDICAL CENTER

ST.CLOUD, MN 56303

KSB SSK 28-TN120

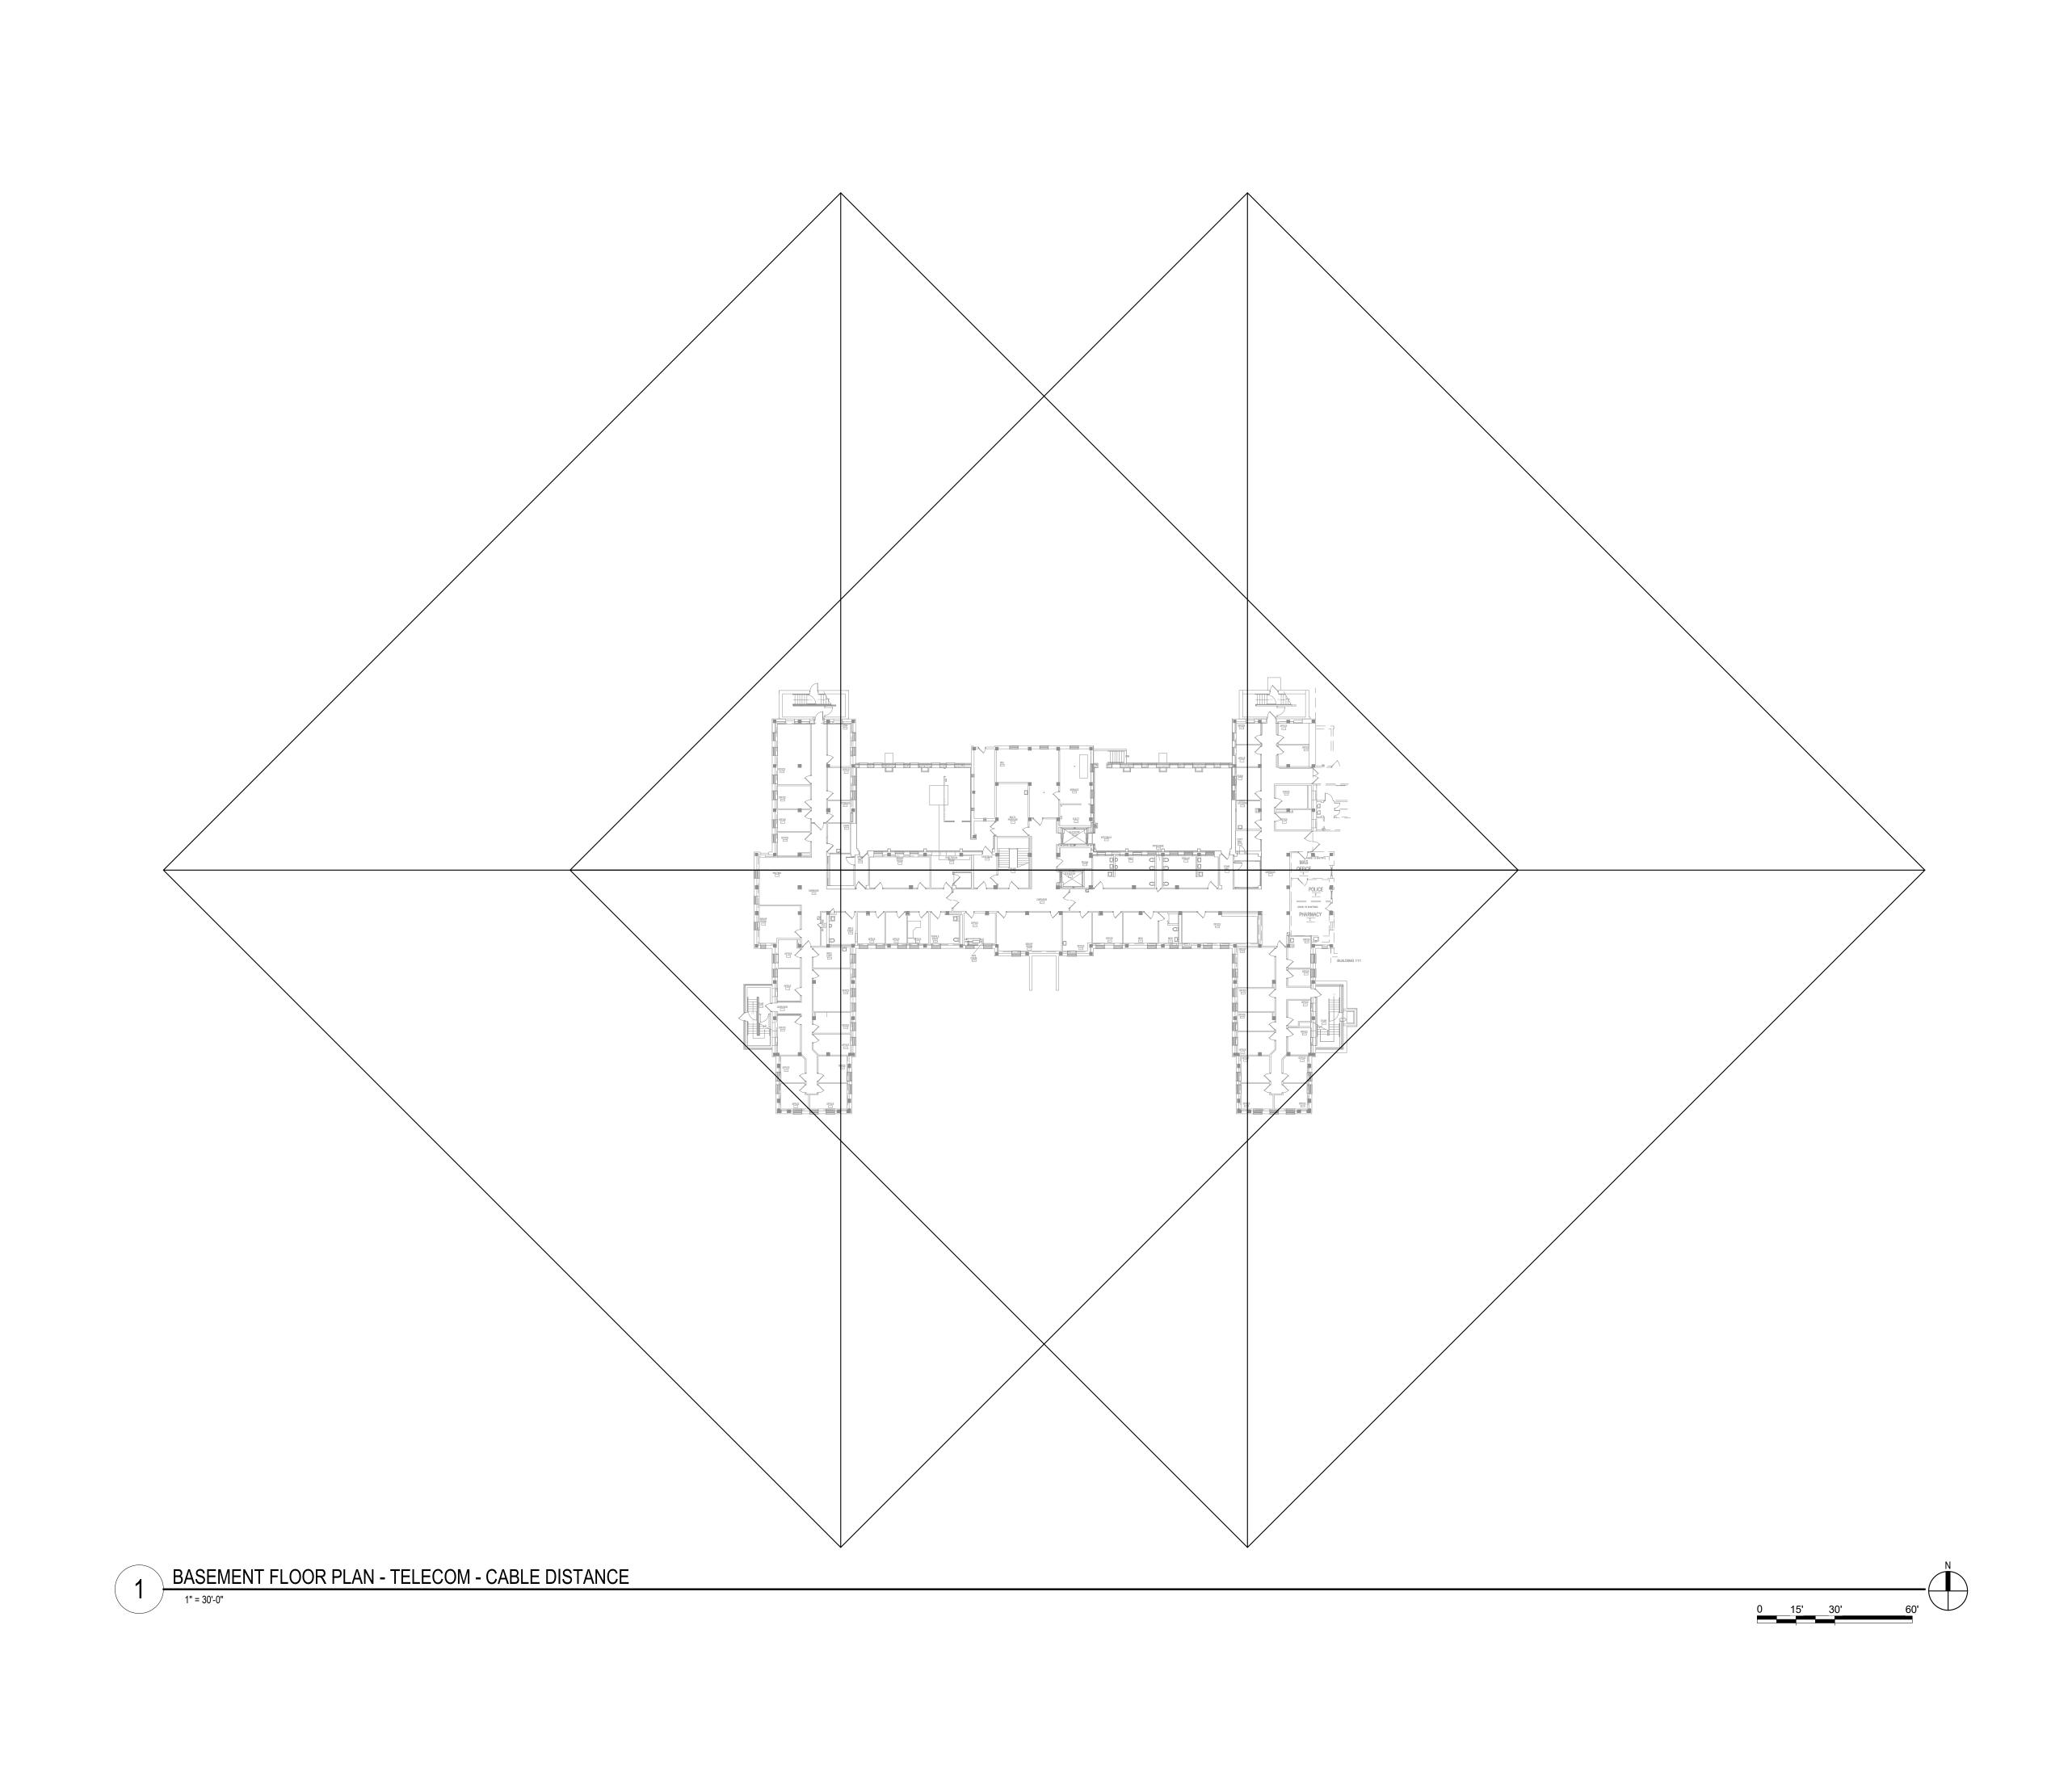


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CONSULTANT Phone: 402.991.5520 Omaha, NE 68134 www.specializedeng.com

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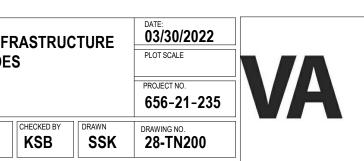


BASEMENT FLOOR PLAN -TELECOM - CABLE DISTANCE


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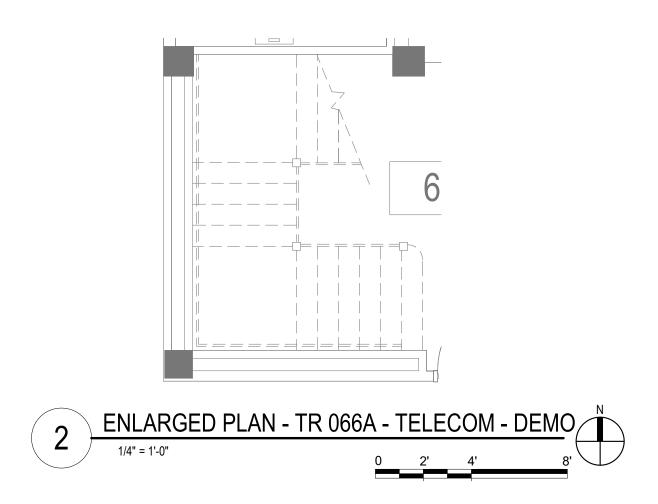
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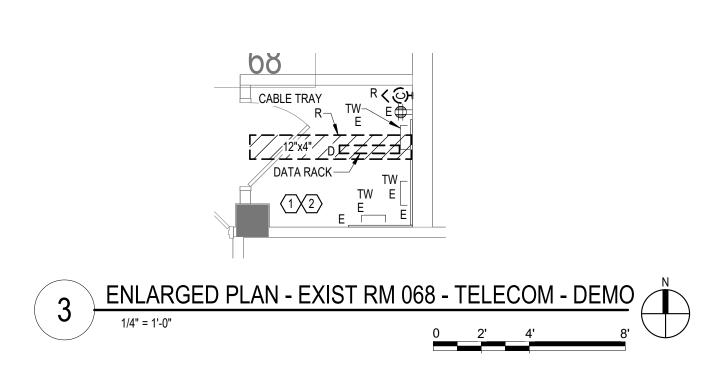
LOCATION
VA MEDICAL CENTER
ST.CLOUD, MN 56303




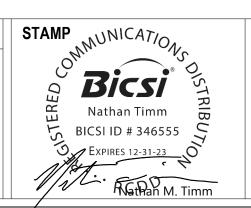






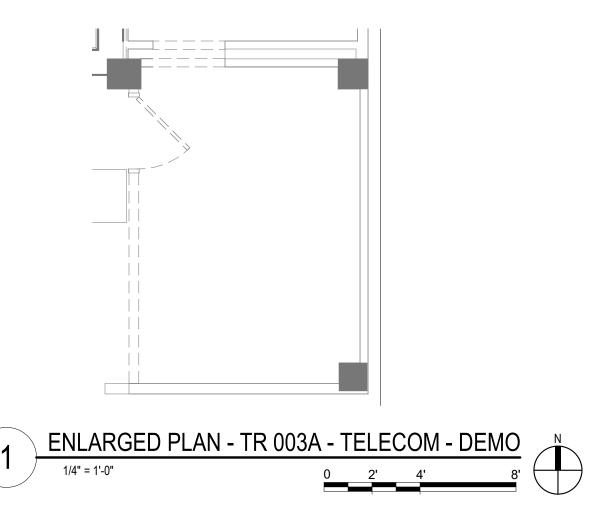

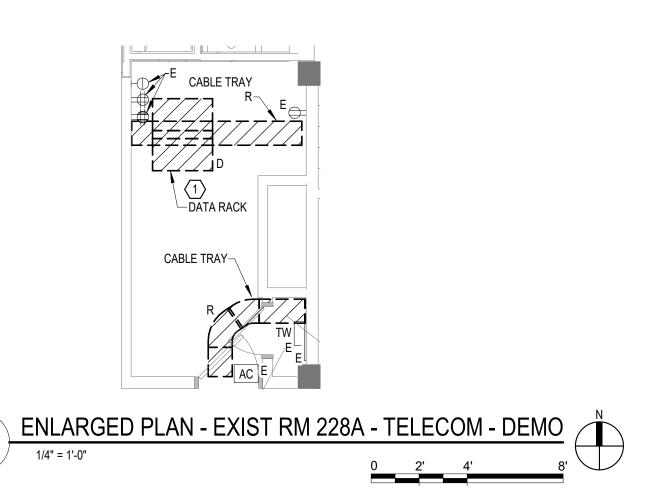



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**GENERAL NOTES:** 

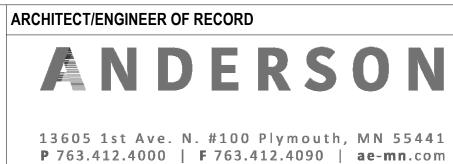A. REFER TO GENERAL DEMOLITION NOTES ON SHEET T000 FOR ADDITIONAL DEMOLITION SCOPE.

SHEET NOTES:

1. EXISTING TELECOMMUNICATIONS CAGE AND RACK SHALL BE INCLUDED WITHIN THE SCOPE OF DEMOLITION. EXISTING CABLING AND ASSOCIATED OUTLETS SHALL BE REMOVED AND REPLACED 1 FOR 1 AND REFED FROM DISTRIBUTION EQUIPMENT LOCATED WITHIN THE NEW TELECOMMUNICATIONS ROOM. REFER TO GENERAL CABLING NOTES FOR APPROXIMATE QUANTITIES. REFER TO NEW WORK PLANS FOR SERVING COMMUNICATIONS ROOM LOCATION AND NEW CABLING ROUTES. 2. EXISTING CABLE TRAY, SECURITY CAMERAS, GROUND BUS BARS, AND RACKS FROM DECOMMISSIONED ROOMS ARE TO BE REUSED, WHEN POSSBILE, IN NEW CONSTRUCTION TRS.

#### **CABLING NOTE:**

A. THE EXISTING CABLE COUNT ARE THE CABLES CURRENTLY PRESENT IN THE SPACE. THE CABLE RELOCATION COUNT ARE THE NEW OR RELOCATED CABLES TO BE FED FROM THE SPACE. THE FINAL CABLE COUNT ARE THE CABLES THAT WILL BE PRESENT IN THE SPACE AT THE COMPLETION OF THE

EXISTING CABLE TO REMAIN

DATA (CAT3): 0

EXISTING CABLE COUNT DATA (CAT6): 0 DATA (CAT6): 0 DATA (CAT5e): 288 DATA (CAT5e): 430 DATA (CAT5): 0 DATA (CAT5): 0 DATA (CAT3): 0 DATA (CAT3): 0 CABLE RELOCATION COUNT CABLE RELOCATION COUNT DATA (CAT6): 0 DATA (CAT5e): 0 DATA (CAT6): 0 DATA (CAT5e): 0 DATA (CAT5): 0 DATA (CAT5): 0 DATA (CAT3): 0 DATA (CAT3): 0

DATA (CAT6): 0 DATA (CAT6): 0 DATA (CAT5e): 0 DATA (CAT5e): 0 DATA (CAT5): 0 DATA (CAT5): 0 DATA (CAT3): 0 DATA (CAT3): 0 FINAL CABLE COUNT FINAL CABLE COUNT DATA (CAT6): 0 DATA (CAT6): 0 DATA (CAT5e): 0 DATA (CAT5e): 0 DATA (CAT5): 0 DATA (CAT5): 0

EXISTING CABLE TO REMAIN

DATA (CAT3): 0

ENLARGED PLANS -TELECOMMUNICATIONS -

FULLY SPRINKLERED





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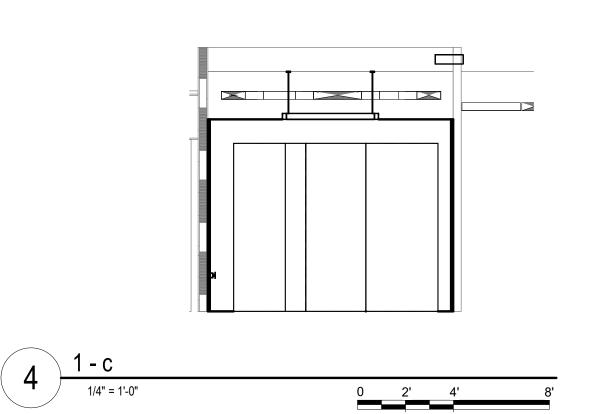
EHRM INFRASTRUCTURE CHECKED BY DRAWN DRAWING NO. 28-TN300 LOCATION


VA MEDICAL CENTER

ST.CLOUD, MN 56303



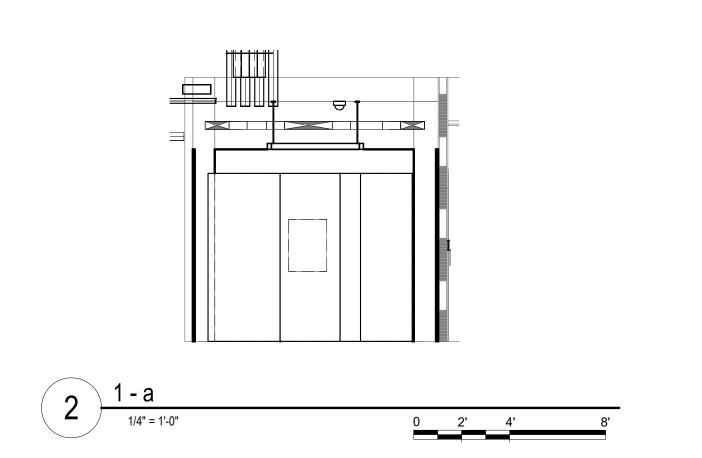

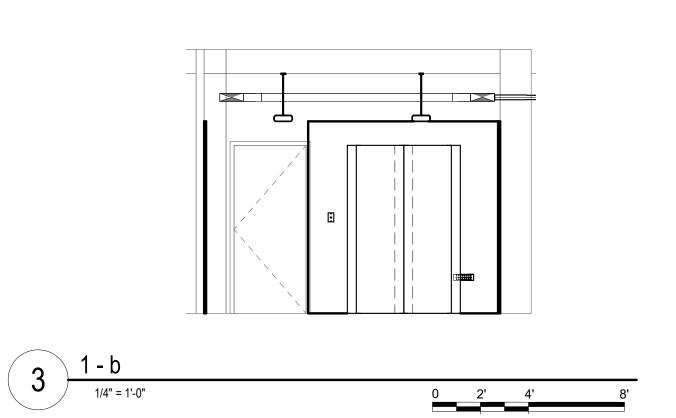

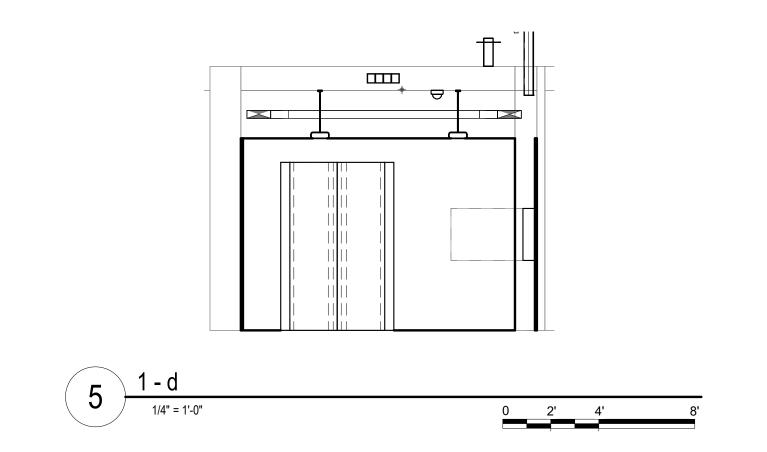

**GENERAL NOTES:** 

A. REFER TO GENERAL NOTES ON SHEET T000 FOR ADDITIONAL SCOPE.

#### SHEET NOTES:

1. PROVIDE A NEW ACCESS CONTROL PANEL TO BE INSTALLED IN THE TELECOM ROOM. THE CARD READER AND KEYPAD FOR THIS ROOM TO BE WIRED TO THE NEW ACCESS CONTROL PANEL. EXISTING CARD READERS AND KEYPADS WILL BE MOVED TO THE NEW CONTROL PANEL UNDER A DIFFERENT PROJECT.

## **CABLING NOTE:**

CABLING NOTES: A. THE EXISTING CABLE COUNT ARE THE CABLES CURRENTLY PRESENT IN THE SPACE. THE CABLE RELOCATION COUNT ARE THE NEW OR RELOCATED CABLES TO BE FED FROM THE SPACE. THE FINAL CABLE COUNT ARE THE CABLES THAT WILL BE PRESENT IN THE SPACE AT THE COMPLETION OF THE PROJECT.

1. ROOM 066A EXISTING CABLE COUNT DATA (CAT6): 0

DATA (CAT5e): 0 DATA (CAT5): 0

DATA (CAT3): 0 CABLE RELOCATION COUNT


DATA (CAT5e): 361 FROM ROOM 068A DATA (CAT5): 0

DATA (CAT3): 0

EXISTING CABLE TO REMAIN DATA (CAT6): 0 DATA (CAT5e): 0

DATA (CAT5): 0 DATA (CAT3): 0

FINAL CABLE COUNT DATA (CAT6A): 361 DATA (CAT6): 0

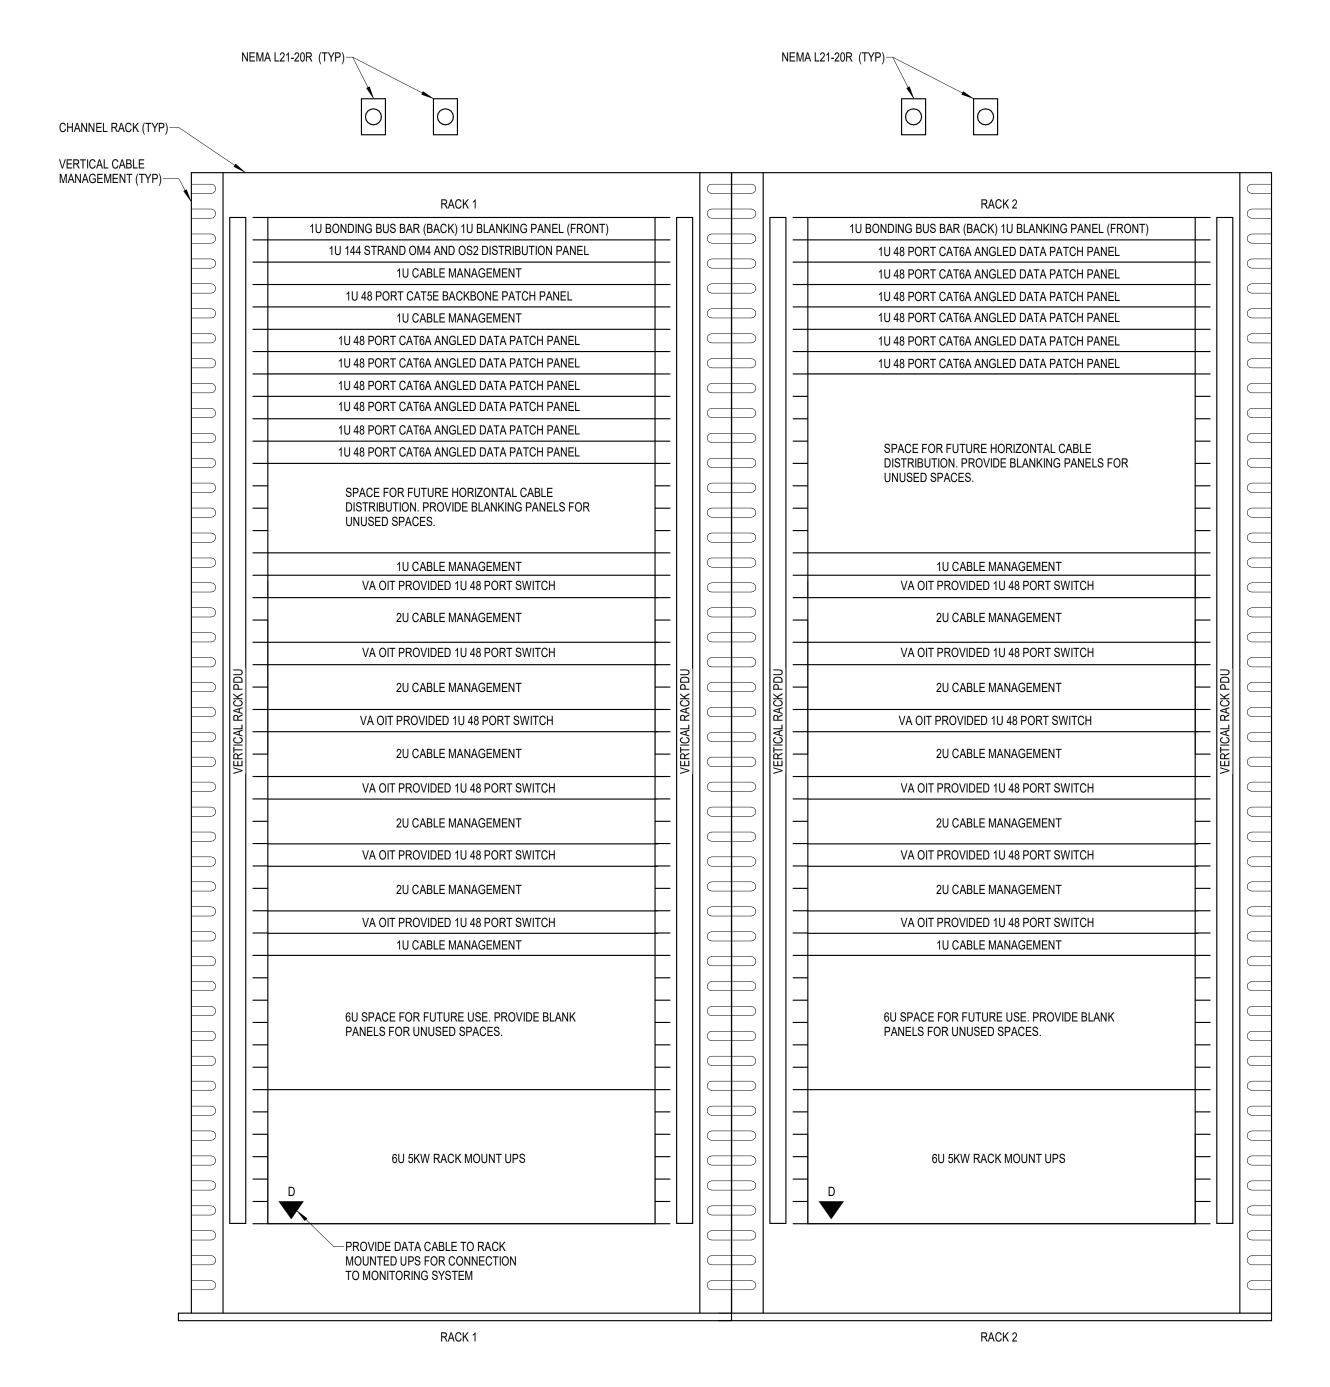

1. REFER TO NEW WORK PLAN FOR RACK LOCATIONS. 2. COORDINATE EXACT RACK COUNT AND LOCATION WITH OWNER PRIOR TO PERMANENT INSTALLATION. 3. SEE PROJECT SPECIFICATIONS FOR ADDITIONAL RACK COMPONENTS.


Phone: 402.991.5520

www.specializedeng.com

4. RACK ELEVATION SHOWS A FULLY CONFIGURED SAMPLE RACK. CONTRACTOR TO PROVIDE REQUIRED EQUIPMENT TO SUPPORT THE FINAL DATA COUNT FROM THE ENLARGED NEW SHEET. (NOT TO EXCEED 288 PORTS PER RACK). 5. COORDINATE FINAL RACK COMPONENT LAYOUT WITH OWNER'S IS/IT REPRESENTATIVE. 6. CONTRACTOR IS RESPONSIBLE FOR FINAL CABLE COUNT, QUANTITY OF PATCH PANELS, SWITCHES, FIBER ENCLOSURES,

BLANKING PANELS, CABLE MANAGEMENT, AND MOUNTING HARDWARE NOT MARKED AS "OIT PROVIDED". 7. PUNCHDOWN COPPER BACKBONES ON RACK MOUNT PATCH PANELS. TERMINATE ONE (1) PAIR PER PATCH PANEL PORT.

COMMUNICATIONS - TYPICAL TWO RACK ELEVATION WITH RACK MOUNT UPS - TR 066A

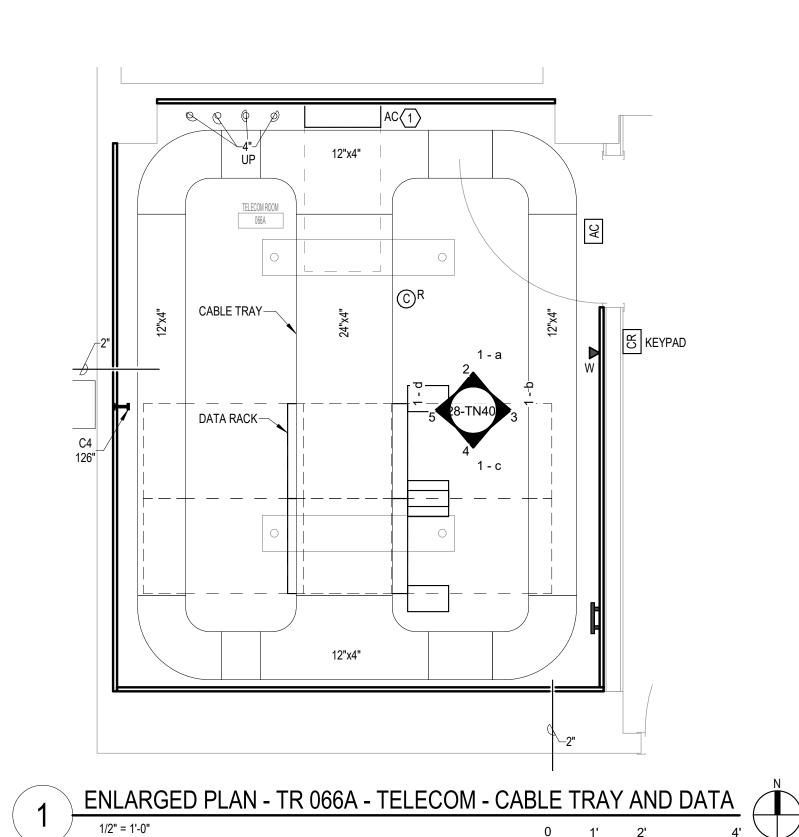

**ENLARGED PLANS -TELECOMMUNICATIONS**  PROJECT TITLE

EHRM INFRASTRUCTURE

BUILDING No

VA MEDICAL CENTER ST.CLOUD, MN 56303

CHECKED BY DRAWN SSK

FULLY SPRINKLERED


03/30/2022 SSK DRAWING NO. 28-TN400






Omaha, NE 68134


REVISION

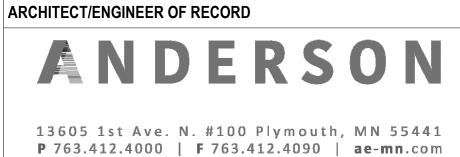



Anderson Engineering of Minnesota, LLC | Proj # 16305



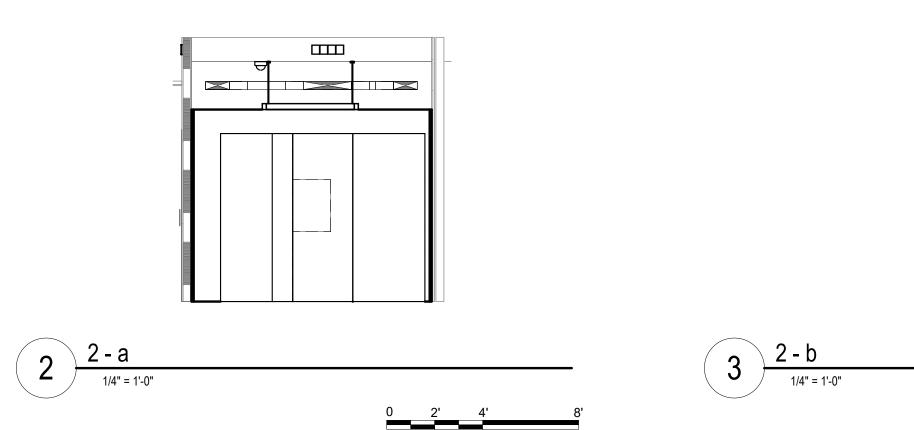

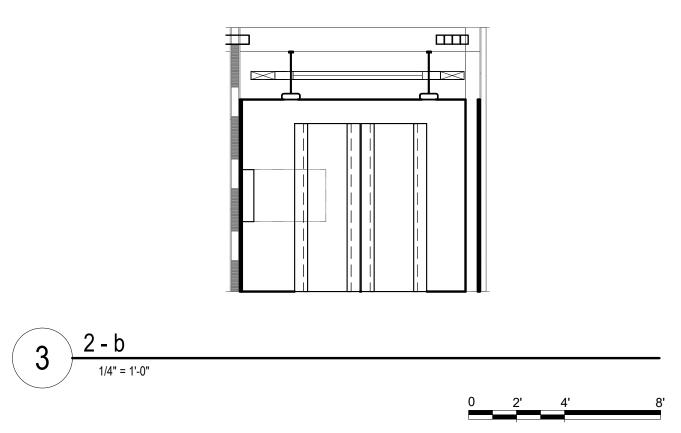

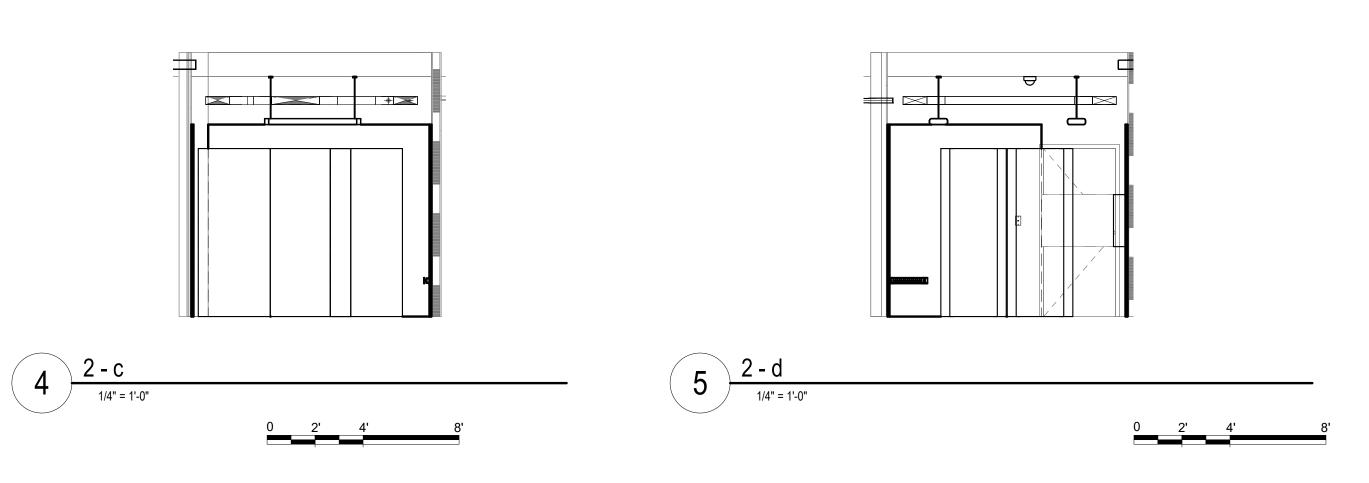

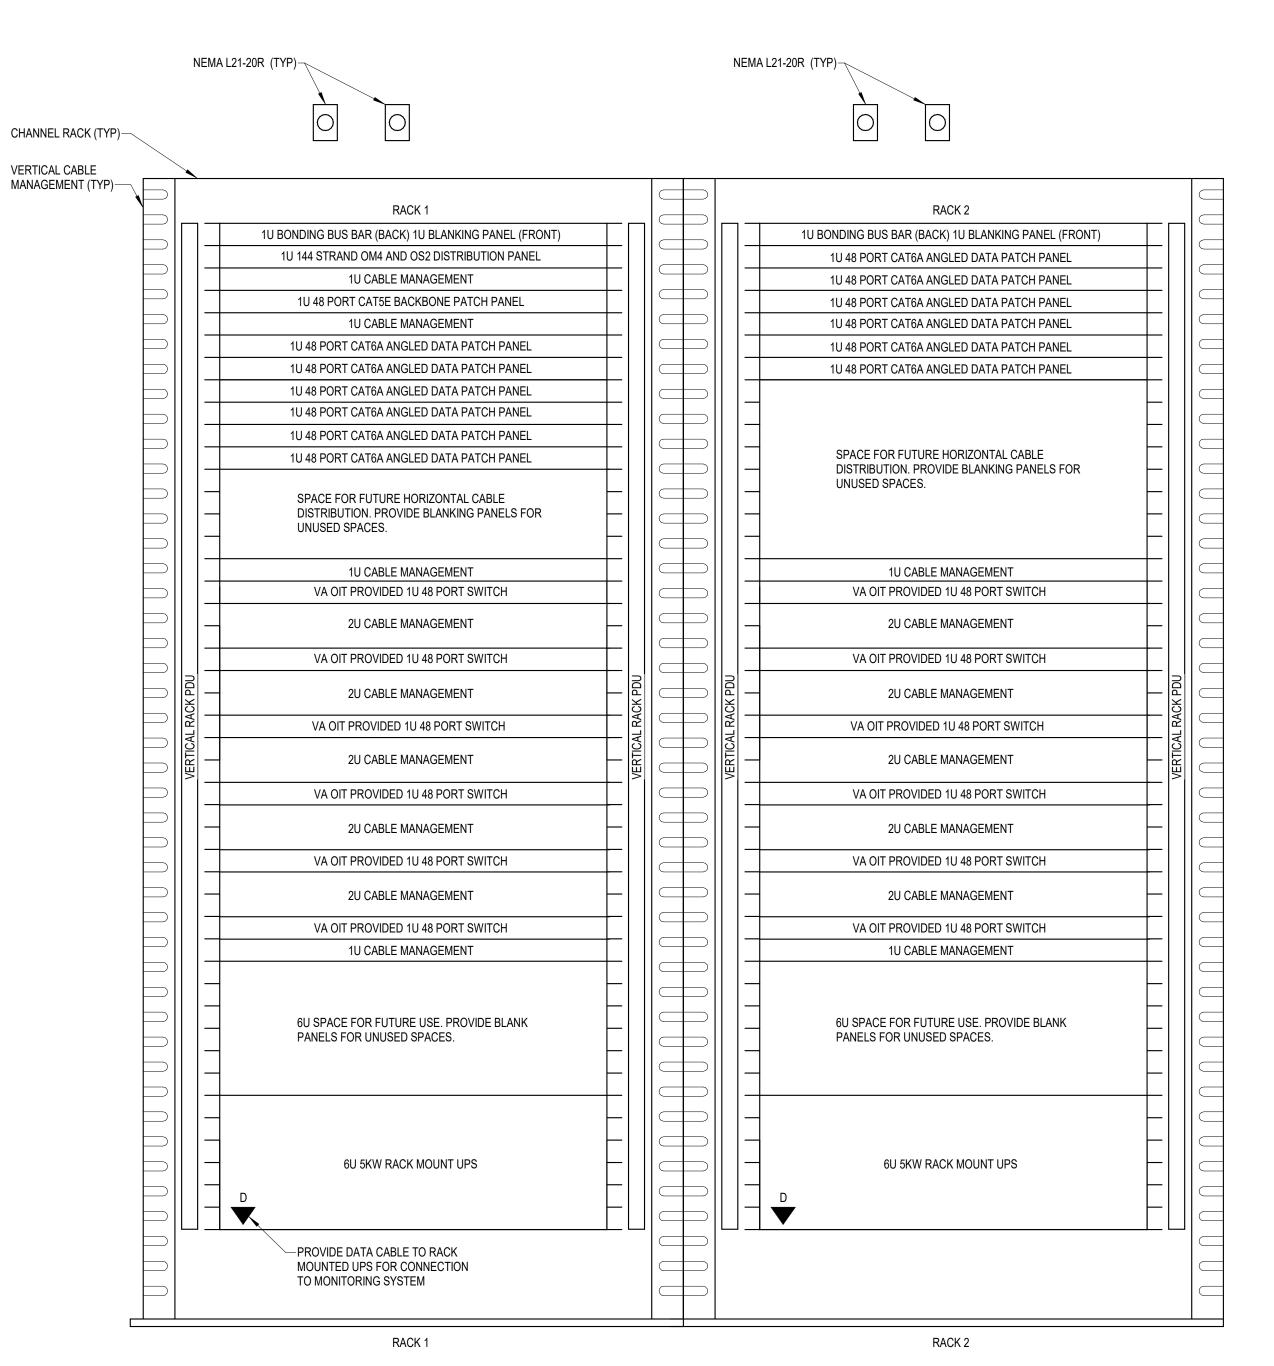


NOTES:

1. REFER TO NEW WORK PLAN FOR RACK LOCATIONS. 2. COORDINATE EXACT RACK COUNT AND LOCATION WITH OWNER PRIOR TO PERMANENT INSTALLATION.

www.specializedeng.com

- 3. SEE PROJECT SPECIFICATIONS FOR ADDITIONAL RACK COMPONENTS. 4. RACK ELEVATION SHOWS A FULLY CONFIGURED SAMPLE RACK. CONTRACTOR TO PROVIDE REQUIRED EQUIPMENT TO SUPPORT THE FINAL DATA COUNT FROM THE ENLARGED NEW SHEET. (NOT TO EXCEED 288 PORTS PER RACK).
- 5. COORDINATE FINAL RACK COMPONENT LAYOUT WITH OWNER'S IS/IT REPRESENTATIVE. 6. CONTRACTOR IS RESPONSIBLE FOR FINAL CABLE COUNT, QUANTITY OF PATCH PANELS, SWITCHES, FIBER ENCLOSURES,
- BLANKING PANELS, CABLE MANAGEMENT, AND MOUNTING HARDWARE NOT MARKED AS "OIT PROVIDED".
- 7. PUNCHDOWN COPPER BACKBONES ON RACK MOUNT PATCH PANELS. TERMINATE ONE (1) PAIR PER PATCH PANEL PORT.



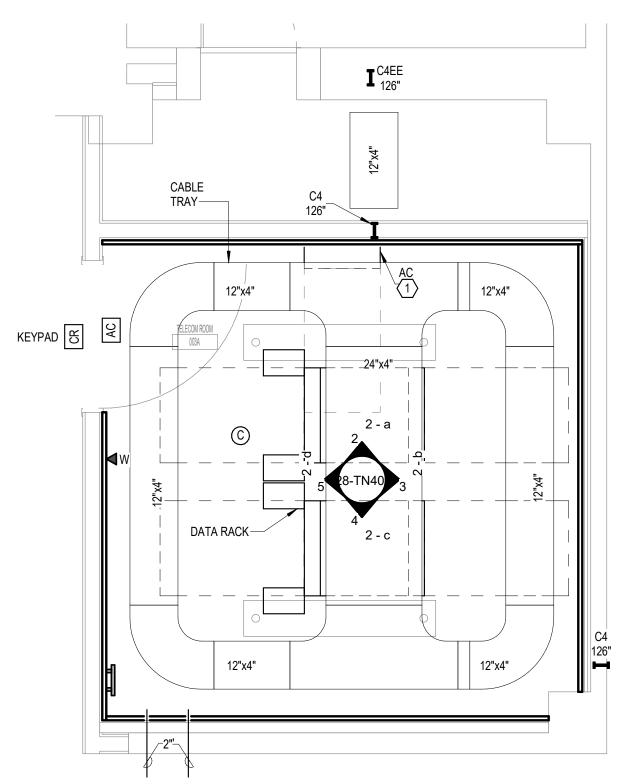

1 ENLARGED PLAN - TR 003A - TELECOM - CABLE TRAY AND DATA

1/2" = 1'-0"

CONSULTANT Phone: 402.991.5520

Omaha, NE 68134

ARCHITECT/ENGINEER OF RECORD ANDERSON 13605 1st Ave. N. #100 Plymouth, MN 55441





EHRM INFRASTRUCTURE

VA MEDICAL CENTER ST.CLOUD, MN 56303

FULLY SPRINKLERED

03/30/2022 KSB SSK 28-TN401



**GENERAL NOTES:** 

A. REFER TO GENERAL NOTES ON SHEET T000 FOR ADDITIONAL SCOPE.

SHEET NOTES:

1. PROVIDE A NEW ACCESS CONTROL PANEL TO BE INSTALLED IN THE TELECOM ROOM. THE CARD READER AND KEYPAD FOR THIS ROOM TO BE WIRED TO THE NEW ACCESS CONTROL PANEL. EXISTING CARD READERS AND KEYPADS WILL BE MOVED TO THE NEW CONTROL PANEL UNDER A DIFFERENT PROJECT.

**CABLING NOTE:** 

A. THE EXISTING CABLE COUNT ARE THE CABLES CURRENTLY PRESENT IN THE SPACE. THE CABLE RELOCATION COUNT ARE THE NEW OR RELOCATED CABLES TO BE FED FROM THE SPACE. THE FINAL CABLE COUNT ARE THE CABLES THAT WILL BE PRESENT IN THE SPACE AT THE COMPLETION OF THE PROJECT.

EXISTING CABLE COUNT DATA (CAT6): 0

DATA (CAT5e): 0 DATA (CAT5): 0 DATA (CAT3): 0

CABLE RELOCATION COUNT DATA (CAT6): 0

DATA (CAT5e): 73 FROM ROOM 068A, 288 FROM ROOM 228 DATA (CAT5): 0

DATA (CAT3): 0 EXISTING CABLE TO REMAIN

DATA (CAT6): 0 DATA (CAT5e): 0

DATA (CAT5): 0 DATA (CAT3): 0


FINAL CABLE COUNT DATA (CAT6A): 361 DATA (CAT6): 0


REVISION


P 763.412.4000 | F 763.412.4090 | ae-mn.com

Anderson Engineering of Minnesota, LLC | Proj # 16305




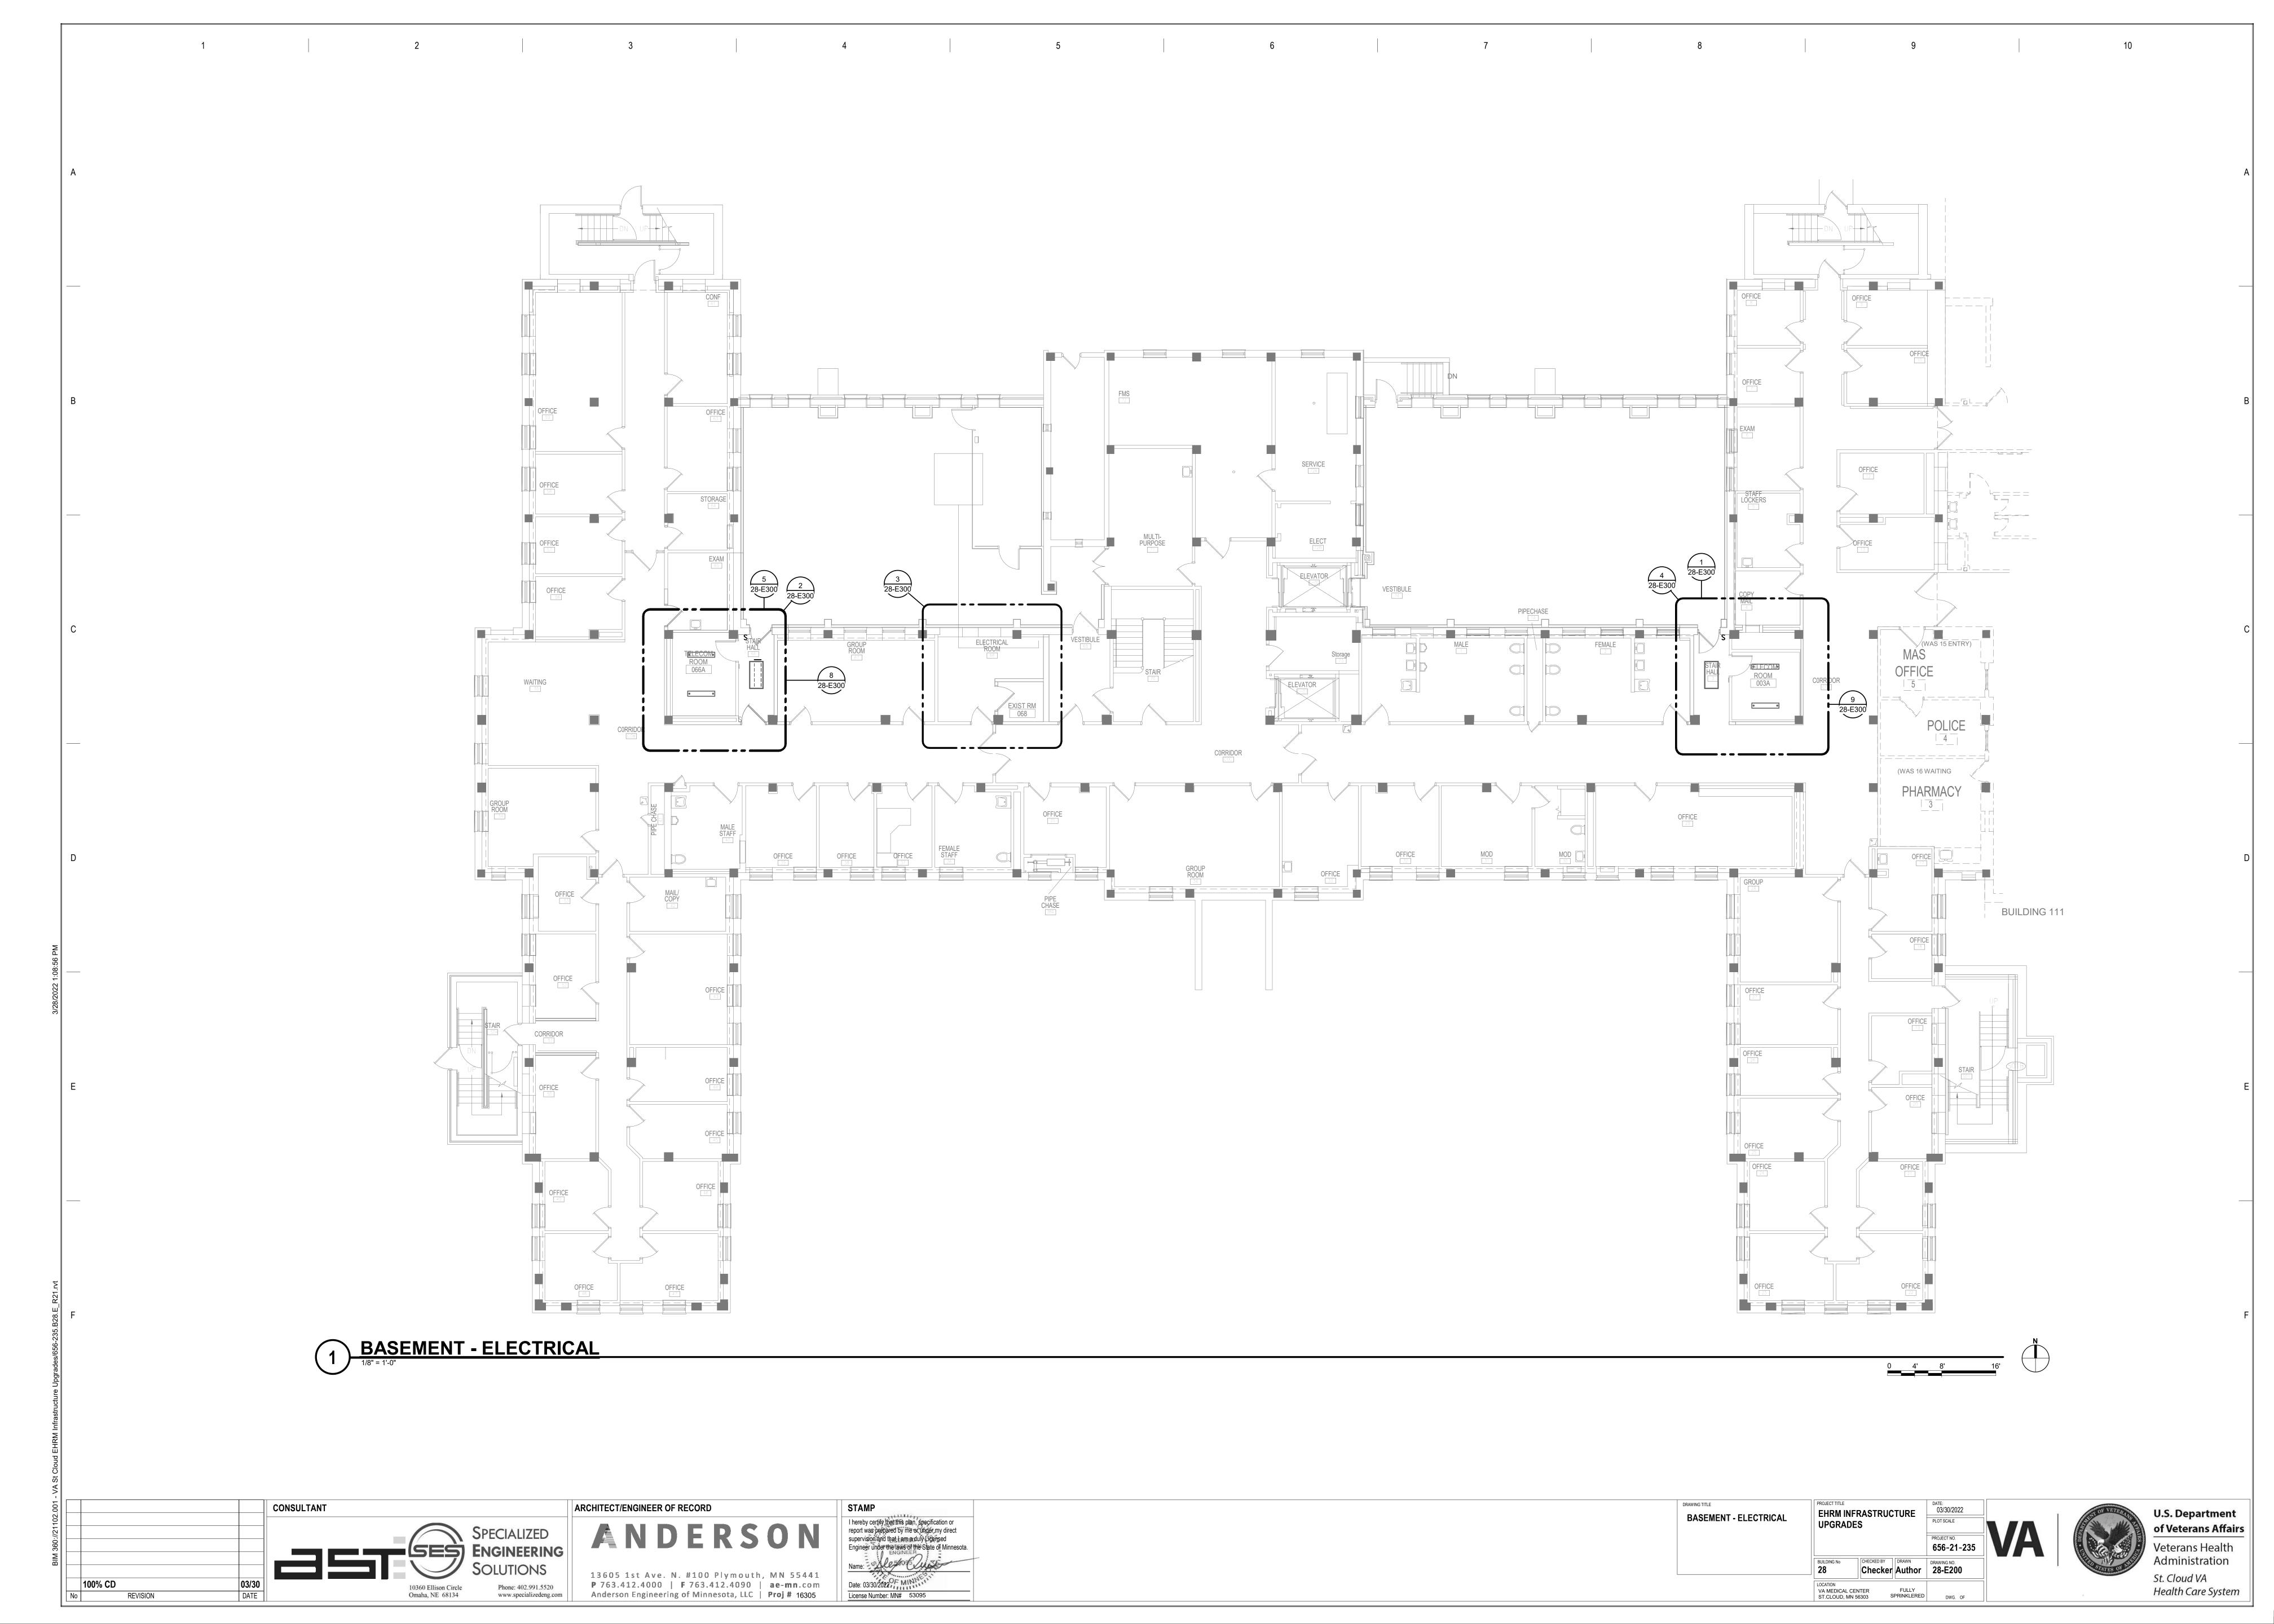

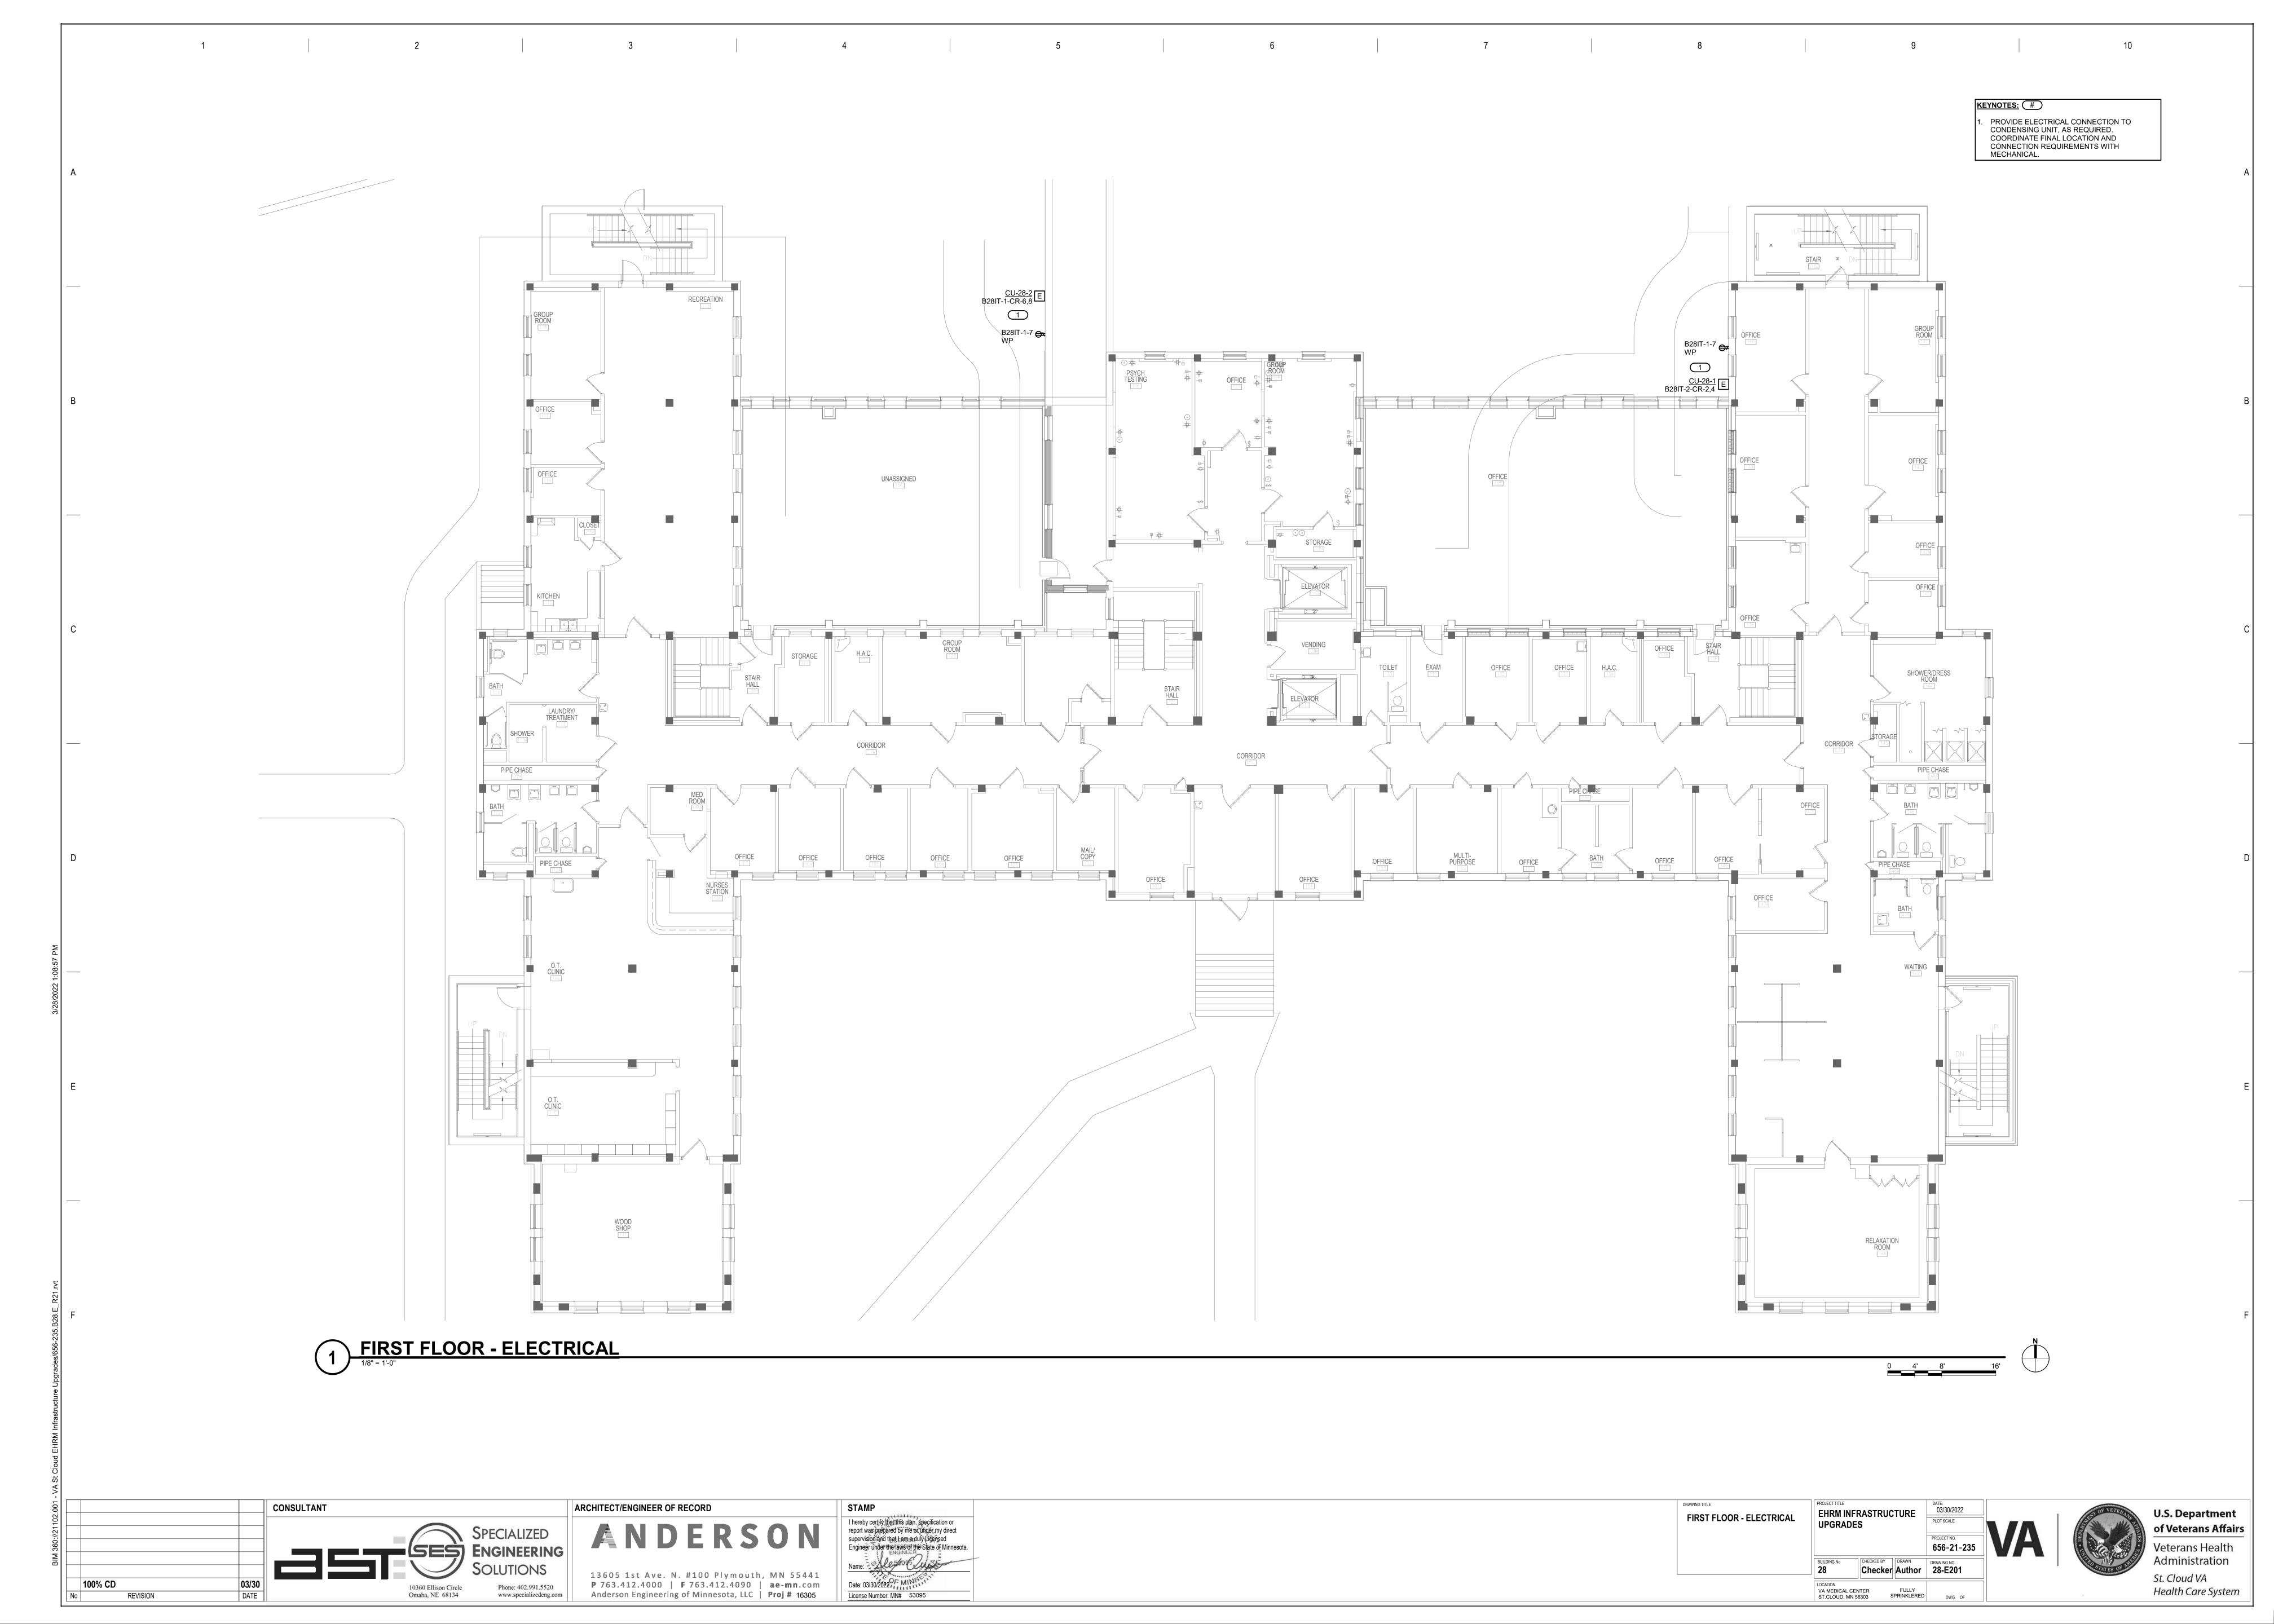


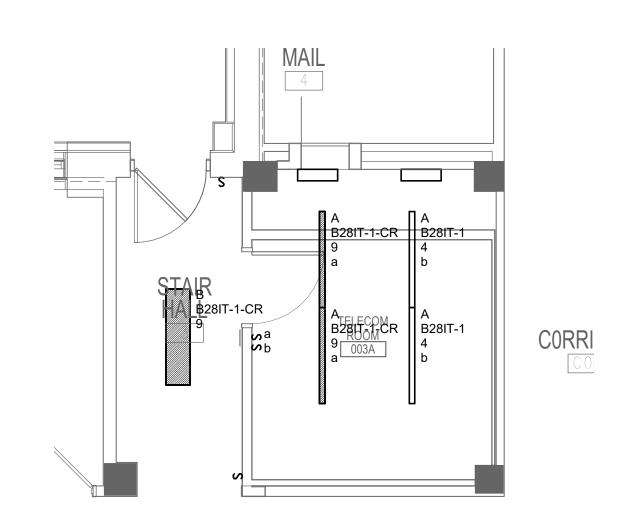




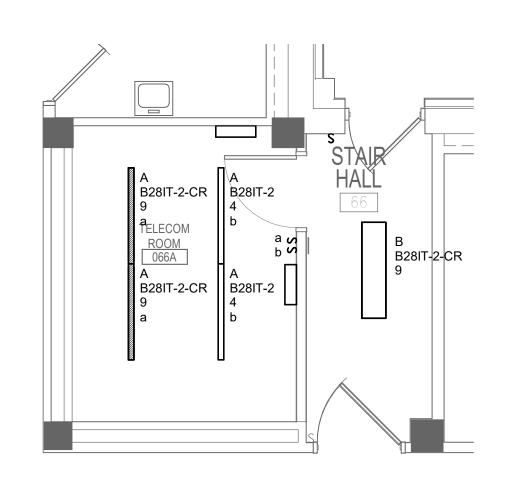




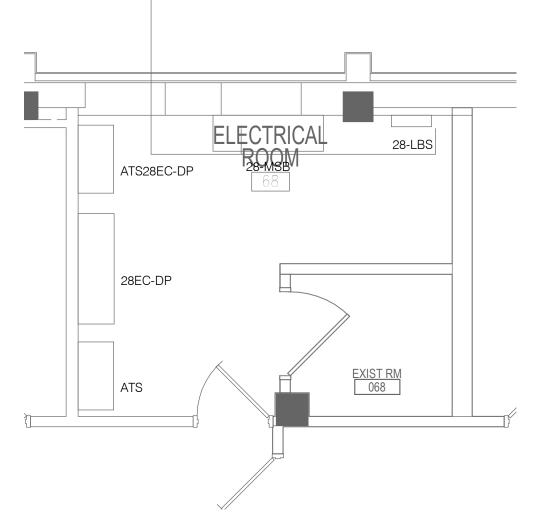

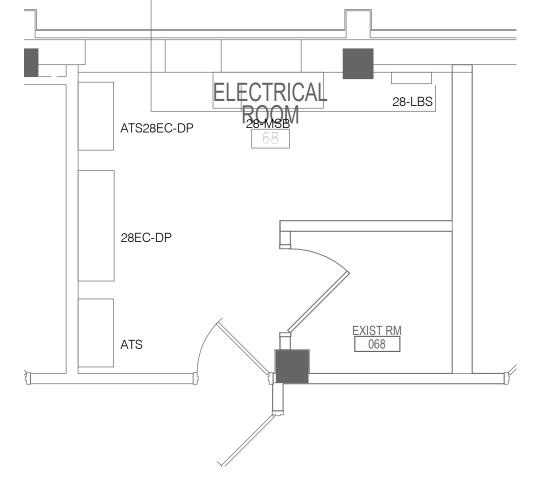



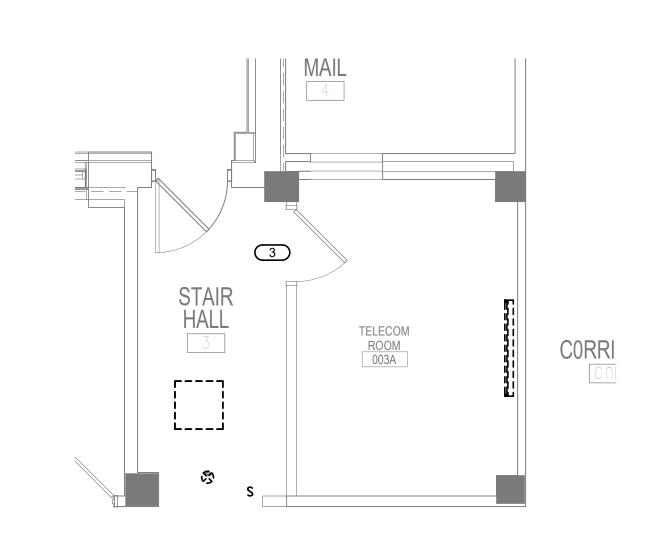

SHEET NOTES:

KEYNOTES: #

EXISTING SLC.

RACK TOWER.

& ONE-LINE OF RACK.

REFER TO TECHNOLOGY PLANS FOR IT ROOM LAYOUT AND RACK LAYOUT/DETAILS. REFER TO SHEET 0-GE400 DETAIL FOR LAYOUT

NDOOR UNIT TO BE POWERED BY OUTDOOR UNIT. COORDINATE EXACT LOCATION WITH

CONNECT SMOKE DETECTOR TO NEAREST

COORDINATE FINAL LOCATION OF RECEPTACLE L21-30R WITH TELECOM

TO PANEL FOR EACH RECEPTACLE.

DISCONNECT AND REMOVE EXISTING LIGHTS AND RECEPTACLES IN ROOM. MAINTAIN CIRCUIT CONTINUITY TO ADJOINING ROOMS.

CONTRACTOR. PROVIDE 3/4"C-4#10, 1#12 GND


PROVIDE EATON BLADEUPS, 5KW, 120/208V, 3-PHASE,4-WIRE RACK MOUNTED UPS FOR EACH

ZERO U, 5.7 KW, 208V, (36) C13 (6) C19 (2) 5-20R OUTLETS. PROVIDE TWO PER RACK, MOUNTED

PROVIDE APC#AP8861 RPDU RACK PDU 2G WITH L21-20P CORD. (120/208V, 3-PHASE, 20A,


PER MANUFACTURER'S REQUIREMENTS.

PROVIDE ONE RACK MOUNTED ZONE PDU UNIT. 30 AMP 3 PHASE, 120/208V, 5-WIRE WITH (4) L21-30R, (6) 5-20R AND TWO 10' POWER CORDS. ZONIT#ZPDS-208V-30A-L21-4L21-20R-

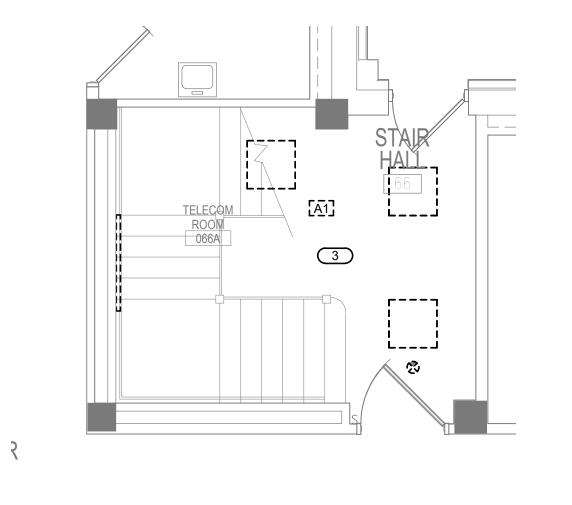







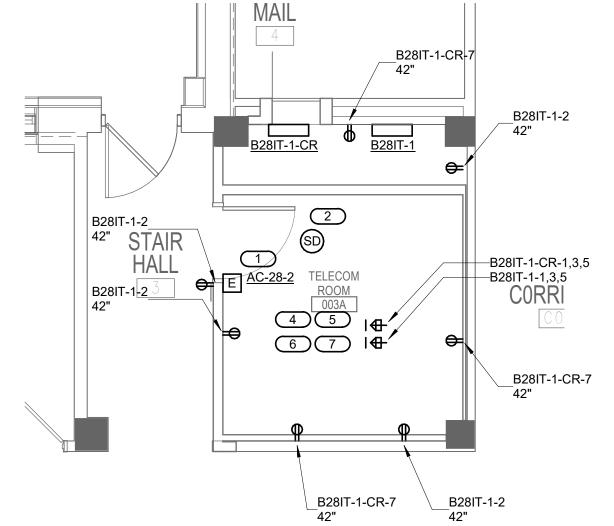





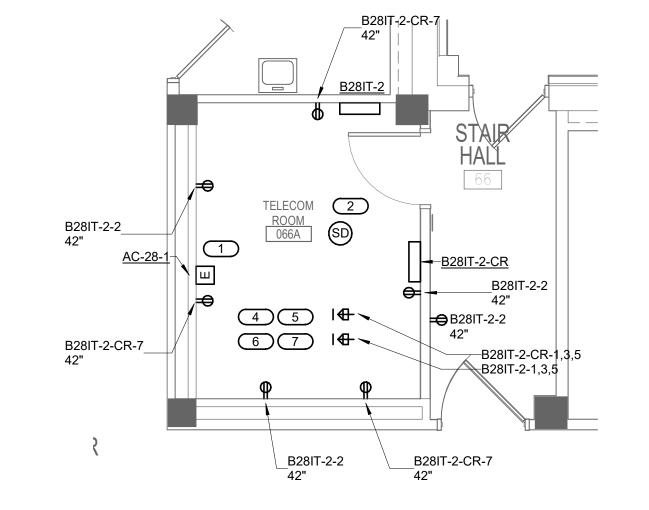



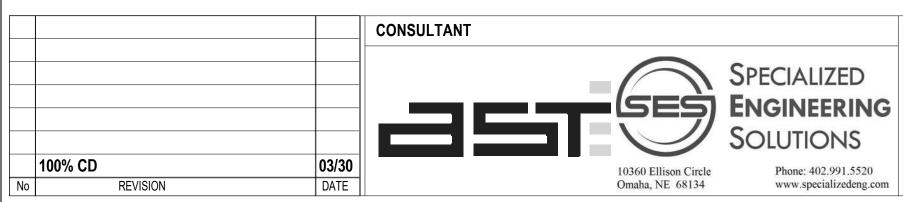


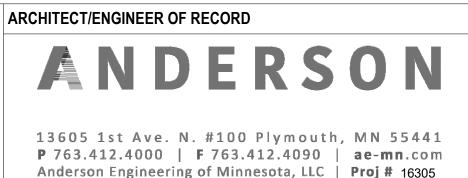

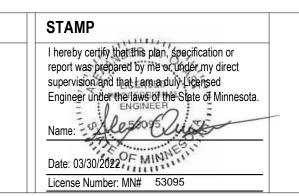




VA MEDICAL CENTER ST.CLOUD, MN 56303

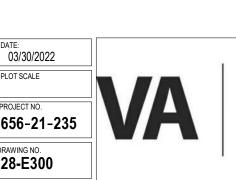





KEYNOTES: # PROVIDE NEW 100A/3P CIRCUIT BREAKERS IN EXISTING PANEL TO MATCH EXISTING TYPE AND AIC RATING.

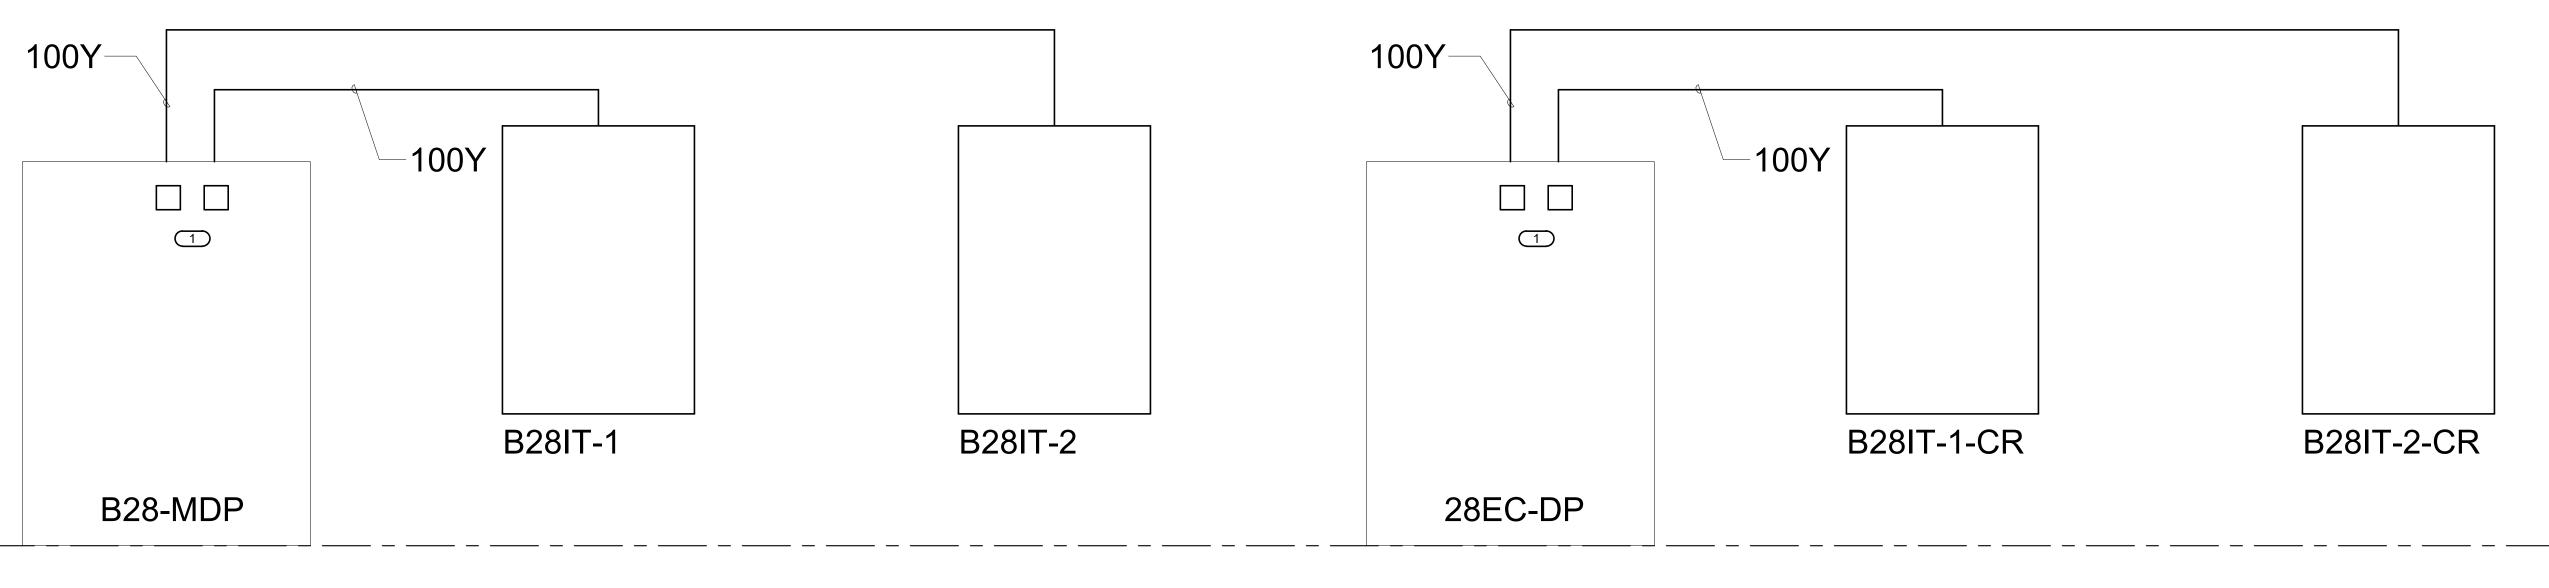


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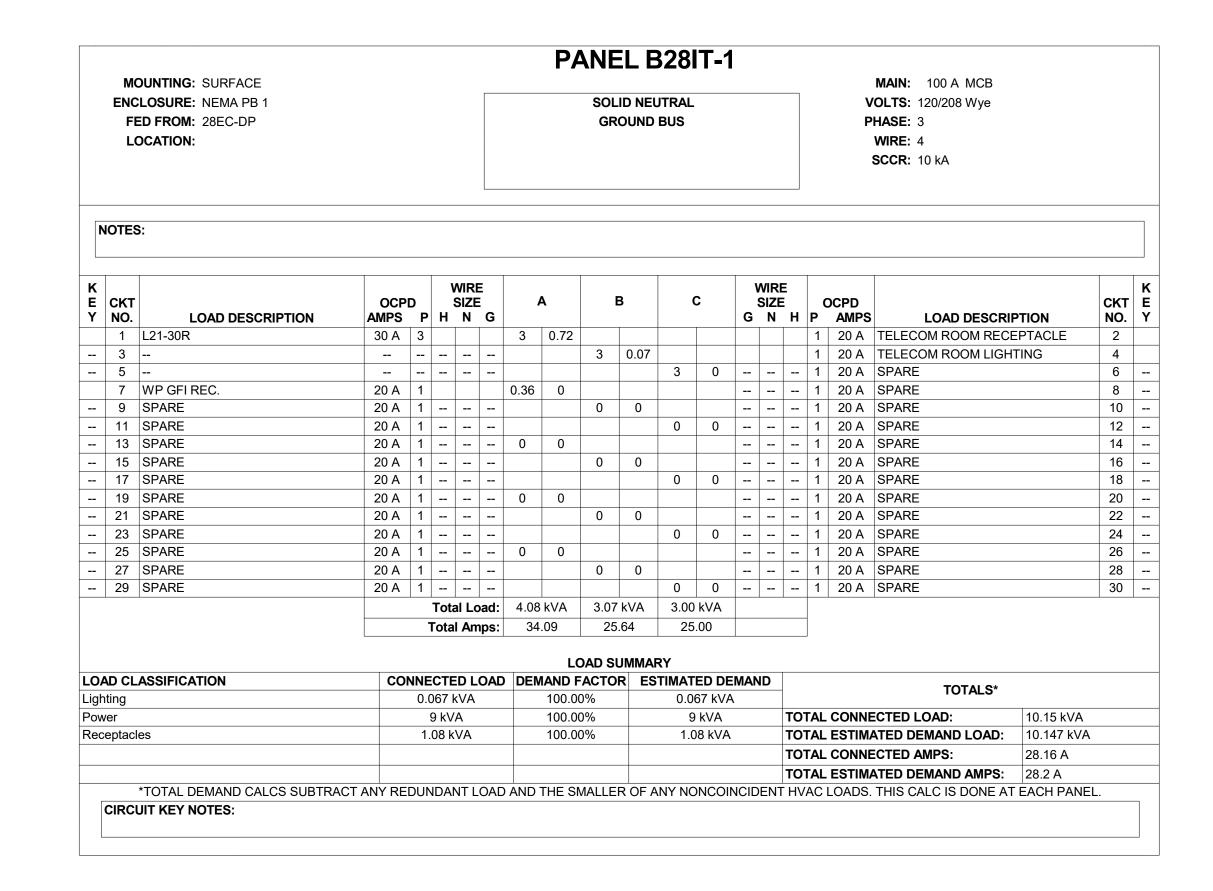


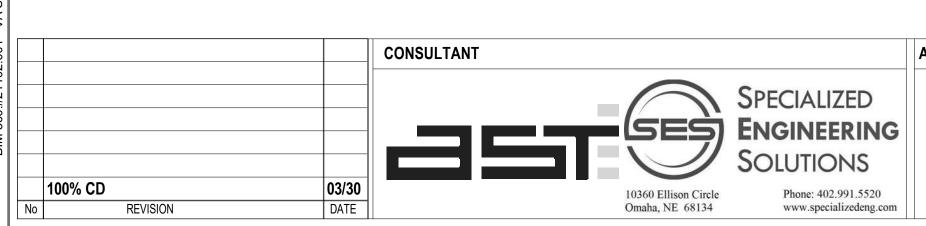



PANEL B28IT-2-CR MOUNTING: SURFACE MAIN: 100 A MCB **ENCLOSURE**: NEMA PB 1 **SOLID NEUTRAL VOLTS**: 120/208 Wye FED FROM: 28EC-DP **GROUND BUS** PHASE: 3 **LOCATION: TELECOM ROOM 066A** WIRE: 4 SCCR: 10 kA OCPD WIRE C SIZE OCPD E CKT CKT E LOAD DESCRIPTION Y NO. AMPS P H N G G N H P AMPS NO. Y 7 TELECOM ROOM RECEPTACLE 9 TELECOM ROOM LIGHTING -- 11 SPARE -- 13 SPARE -- 15 SPARE -- 17 SPARE -- 19 SPARE -- 21 SPARE -- 23 SPARE -- 25 SPARE -- 27 SPARE -- 29 SPARE **Total Load:** 4.54 kVA 4.07 kVA 3.00 kVA **Total Amps:** 39.20 35.26 25.00 LOAD SUMMARY LOAD CLASSIFICATION CONNECTED LOAD DEMAND FACTOR ESTIMATED DEMAND TOTALS\* 0.067 kVA 100.00% 0.067 kVA TOTAL CONNECTED LOAD: 11 kVA 100.00% 11 kVA 0.54 kVA 100.00% TOTAL ESTIMATED DEMAND LOAD: 11.607 kVA Receptacles 0.54 kVA TOTAL CONNECTED AMPS: TOTAL ESTIMATED DEMAND AMPS: 32.2 A \*TOTAL DEMAND CALCS SUBTRACT ANY REDUNDANT LOAD AND THE SMALLER OF ANY NONCOINCIDENT HVAC LOADS. THIS CALC IS DONE AT EACH PANEL **CIRCUIT KEY NOTES:** 

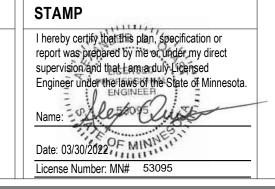5 9

	M	OUNTING: SURFACE		PANEL B28IT-1-CR  MAIN: 100 A MCB																
	ENC FE	CLOSURE: NEMA PB 1 ED FROM: 28EC-DP OCATION:									NEUTRAL UND BUS						/OLTS: 120/208 Wye PHASE: 3 WIRE: 4 SCCR: 10 kA			
N	IOTES	S:																		
K E Y	CKT NO.	LOAD DESCRIPTION	OCP AMPS		WIR SIZ	E		Δ	В	<u> </u>	(	;		WIRE SIZE N I		OCPD AMPS	LOAD DESCRI	PTION	CKT NO.	ŀ
•		L21-30R	20 A	3	1 14		3						-	14 1	ır	AIVIFS	LUAD DESCRI	FIION	2	
	3								3										4	_
	5	 		-					3		3	1			2	20 A	CU-28-2		6	
		TELECOM ROOM RECEPTACLE	20 A	1			0.54	1				•			-   -				8	_
		TELECOM ROOM LIGHTING	20 A	1			0.0.	-	0.07	0					- 1	20 A	SPARE		10	_
		SPARE	20 A	1 -					10101		0	0			- 1		SPARE		12	_
		SPARE	20 A	1 -			0	0							- 1		SPARE		14	_
		SPARE	20 A	1 -					0	0					- 1		SPARE		16	_
		SPARE	20 A	1 -							0	0			- 1		SPARE		18	_
	19	SPARE	20 A	1 -	-		0	0							- 1	20 A	SPARE		20	_
	21	SPARE	20 A	1 -					0	0					- 1	20 A	SPARE		22	
	23	SPARE	20 A	1 -							0	0			- 1	20 A	SPARE		24	
	25	SPARE	20 A	1 -			0	0							- 1	20 A	SPARE		26	
	27	SPARE	20 A	1 -					0	0					- 1	20 A	SPARE		28	
	29	SPARE	20 A	1 -							0	0			- 1	20 A	SPARE		30	
	l			To	tal L	oad:	4.54	kVA	3.07	kVA	4.00	kVA							- 1	
				Total Amp			<b>s</b> : 39.03		25.56		34.53									
								L	OAD SU	ММД	RY									
_OA	AD CL	ASSIFICATION	СО	CONNECTED LO				DAD DEMAND FACT			STIMAT	ED DE	EMAN	ID	TOTAL OF					_
Lighting				0.067 kVA				100.0	0%		0.06	37 kVA	4		TOTALS*					
Power Receptacles			11 kVA				100.0	0%		11	kVA		Т	OTAI	CONN	ECTED LOAD:	11.61 kVA			
			0.54 kVA			100.0		0%		0.54 kVA			TC		ESTIM	ATED DEMAND LOAD:	11.607 kVA			
														TC		CONN	ECTED AMPS:	32.22 A		
																	ATED DEMAND AMPS:	32.2 A		

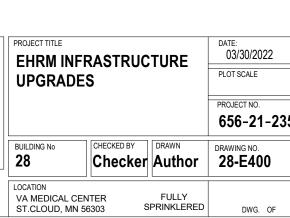

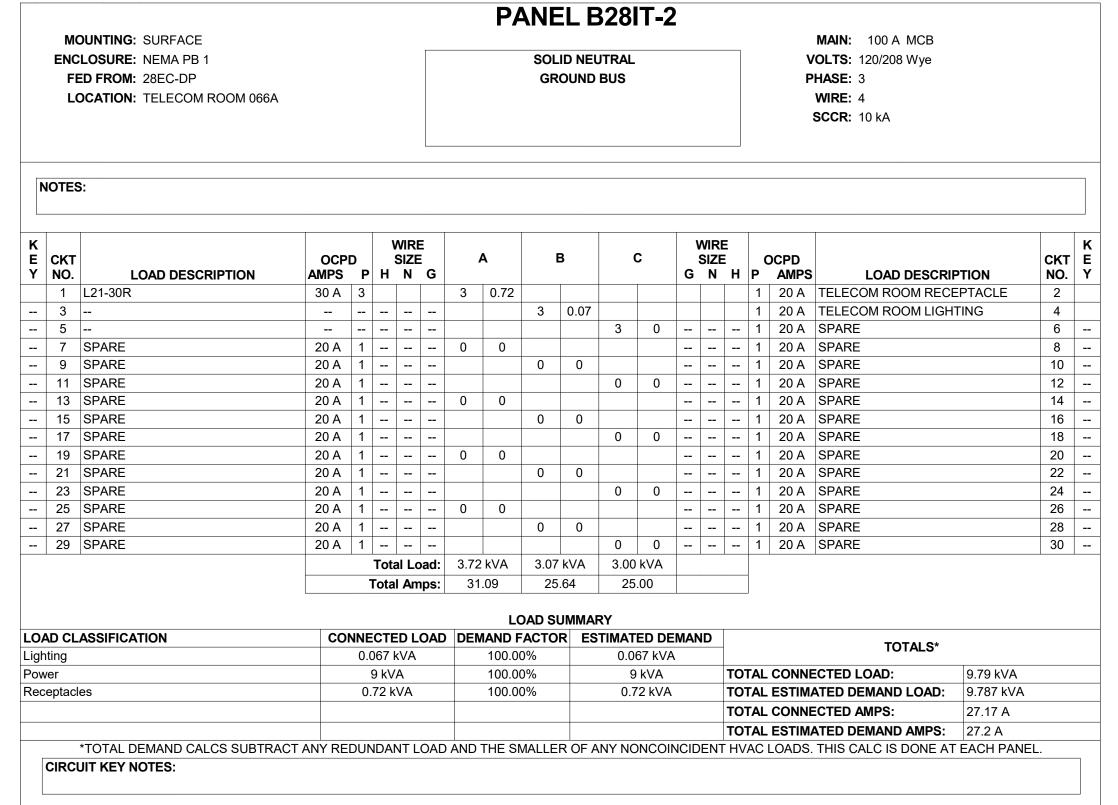

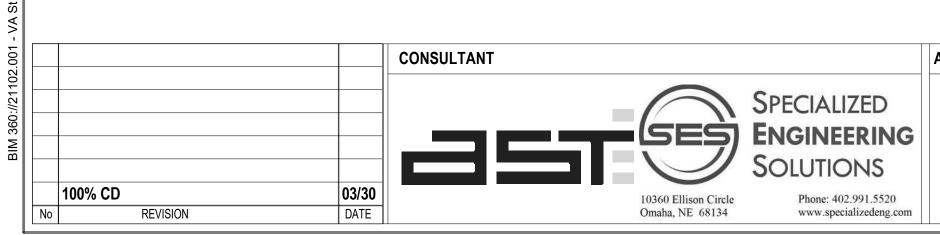


ARCHITECT/ENGINEER OF RECORD


ANDERSON

13605 1st Ave. N. #100 Plymouth, MN 55441
P 763.412.4000 | F 763.412.4090 | ae-mn.com

Anderson Engineering of Minnesota, LLC | Proj # 16305

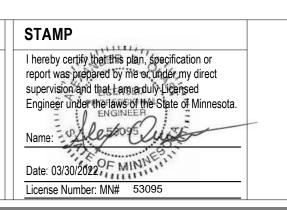



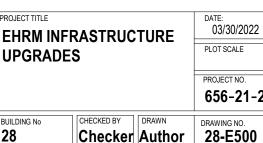

SPRINKLERED

VA MEDICAL CENTER





#### FIELD VERIFICATION NOTES

- 1. THE HVAC CONTRACTOR SHOULD VISIT **PRIOR TO BID** TO FIELD VERIFY ALL EXISTING CONDITIONS WHICH MAY AFFECT THIER BID. THE FOLLOWING ITEMS SHALL BE VERIFIED:
- A. EXACT PLACEMENT, SIZE, CAPACITY, MANUFACTURER AND CONDITION OF ALL EXISTING HVAC EQUIPMENT WITHIN SCOPE OF WORK, WHETHER EXPLICITLY SHOWN OR NOT.
- B. SIZE AND LOCATION OF ALL EXISTING DUCTWORK.
- C. SIZE AND LOCATION FO ALL EXISTING GRILLES, REGISTERS AND DIFFUSERS.
- D. SIZE AND LOCATION OF ALL EXISTING THERMOSTATIC CONTROL DEVICES.
- E. SIZE AND LOCATION OF ALL EXISTING PLUMBING AND HYDRONIC PIPING.
- 2. ALL REFERENCES ON THESE DRAWINGS TO EXISTING EQUIPMENT, DUCTWORK, DIFFUSERS, THERMOSTATS AND PIPING ARE FOR REFERENCE ONLY. IT IS THE RESPONSIBILITY OF THE CONTRACTOR TO VERIFY ALL THESE ITEMS PRIOR TO BID AND INCLUDE IN THEIR BID ANY AND ALL AMOUNTS REQUIRED TO ACCOMODATE EXISTING CONDITIONS.
- 3. NO ALLOWANCES WILL BE MADE AFTER THE PROJECT HAS BEEN AWARDED FOR FAILURE TO VERIFY EXISTING CONDITIONS.
- 4. ANY DISCREPANCIES WHICH MAY AFFECT THE CONTRACTORS BID SHALL BE BROUGHT TO THE ATTENTION OF THE ENGINEER AND ARCHITECT FOR

#### **KEYNOTES 1/28-M100:**

- 1. REMOVE SECTION OF EXISTING 3" STEAM PIPE AND PREP FOR REROUTING.
- 2. REMOVE SECTION OF EXISTING 1" CONDENSATE RETURN PIPING AND PREP FOR REROUTING.
- 3. REMOVE AND DISPOSE OF EXISTING FIRE PROTECTION SPRINKLER LINES BACK TO OUT OF STAIRWELL FOR REROUTING. PREPARE PIPE ENDS FOR RECONNECTION. FIELD VERIFY REQUIREMENTS.


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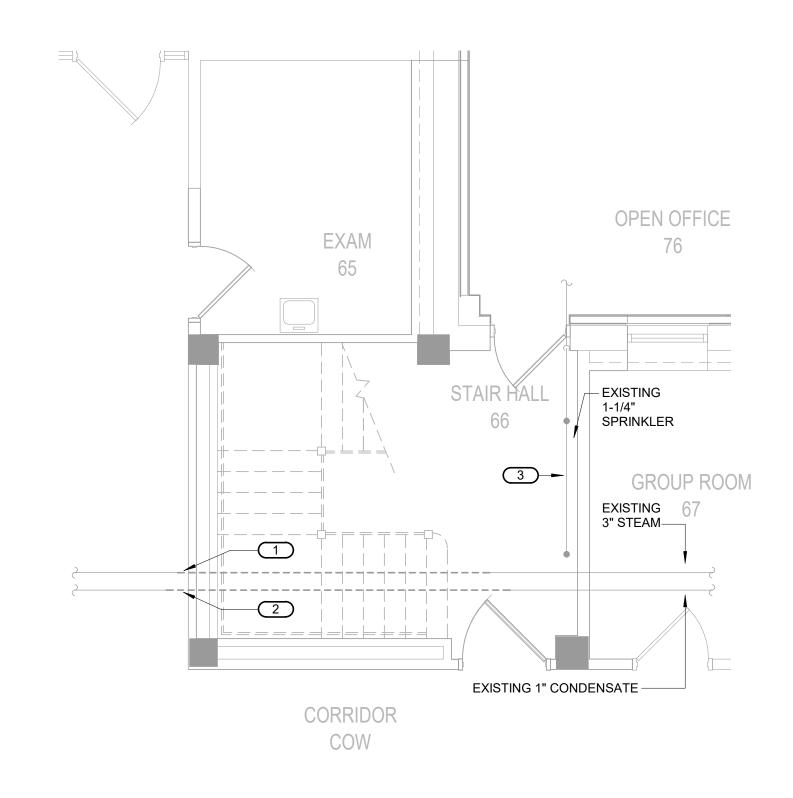
 5
 9

- 4. EXISTING 2" STEEL AND NO HUB CAST IRON VENT AND SANITARY PIPING.
- 5. EXISTING 2" SAFE WASTE WITH FUNNEL TO BE REPIPED TO FIT WITHIN NEW CHASE SPACE.

#### **KEYNOTES 2/28-M100:**

- 1. REMOVE SECTION OF EXISTING 3" STEAM PIPE AND PREP FOR REROUTING.
- 2. REMOVE SECTION OF EXISTING 1" CONDENSATE RETURN PIPING AND PREP FOR
- 3. EXISTING FIRE PROTECTION LINE AND SPRINKLER HEADS TO REMAIN.



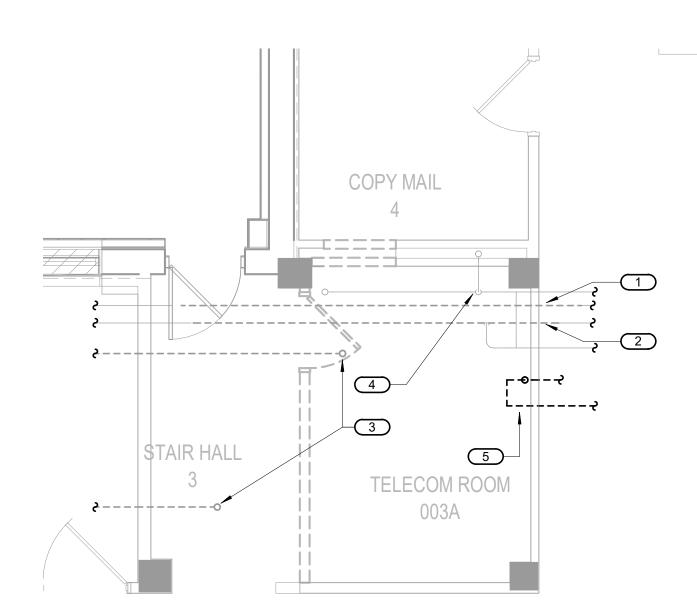


BASEMENT DEMOLITION - MECHANICAL - TELECOM 003A

1/4" = 1'-0"

BASEMENT DEMOLITION - MECHANICAL - TELECOM 066A


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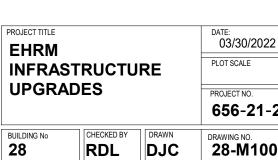




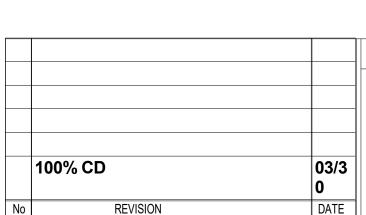






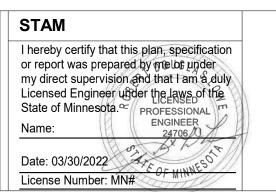

VA MEDICAL CENTER ST.CLOUD, MN 56303

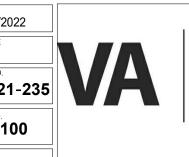



#### **FIELD VERIFICATION NOTES**


- 1. THE HVAC CONTRACTOR SHOULD VISIT <u>PRIOR TO BID</u> TO FIELD VERIFY ALL EXISTING CONDITIONS WHICH MAY AFFECT THIER BID. THE FOLLOWING ITEMS SHALL BE VERIFIED:
- A. EXACT PLACEMENT, SIZE, CAPACITY, MANUFACTURER AND CONDITION OF ALL EXISTING HVAC EQUIPMENT WITHIN SCOPE OF WORK, WHETHER EXPLICITLY SHOWN OR NOT.
- B. SIZE AND LOCATION OF ALL EXISTING DUCTWORK.
- C. SIZE AND LOCATION FO ALL EXISTING GRILLES, REGISTERS AND DIFFUSERS.
- D. SIZE AND LOCATION OF ALL EXISTING THERMOSTATIC CONTROL DEVICES.
- E. SIZE AND LOCATION OF ALL EXISTING PLUMBING AND HYDRONIC PIPING.

  2. ALL REFERENCES ON THESE DRAWINGS TO EXISTING FOLIPMENT, DUCTWORK, DIFFUSERS, THERMOSTATS AND PIPING.
- 2. ALL REFERENCES ON THESE DRAWINGS TO EXISTING EQUIPMENT, DUCTWORK, DIFFUSERS, THERMOSTATS AND PIPING ARE FOR REFERENCE ONLY. IT IS THE RESPONSIBILITY OF THE CONTRACTOR TO VERIFY ALL THESE ITEMS PRIOR TO BID AND INCLUDE IN THEIR BID ANY AND ALL AMOUNTS REQUIRED TO ACCOMODATE EXISTING CONDITIONS.
- 3. NO ALLOWANCES WILL BE MADE AFTER THE PROJECT HAS BEEN AWARDED FOR FAILURE TO VERIFY EXISTING CONDITIONS.
- 4. ANY DISCREPANCIES WHICH MAY AFFECT THE CONTRACTORS BID SHALL BE BROUGHT TO THE ATTENTION OF THE ENGINEER AND ARCHITECT FOR DIRECTION.





PHOTOS
NO SCALE

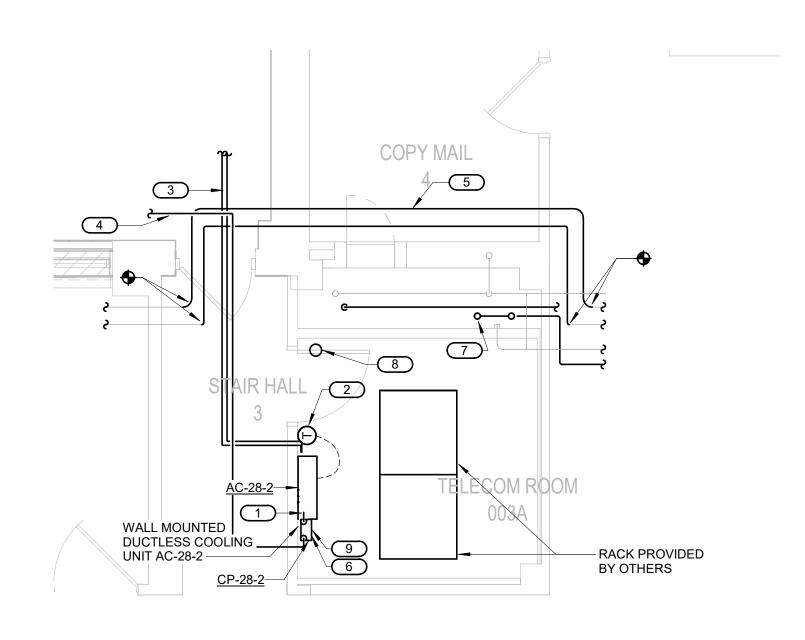




#### KEYOTES 1/28-M200:

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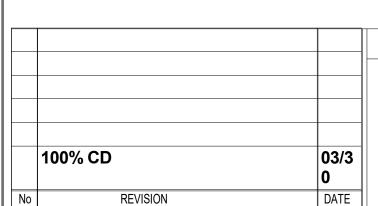
- 1. PROVIDE NEW WALL-MOUNTED SPLIT SYSTEM AC UNIT.
- 2. PROVIDE NEW THERMOSTAT.
- 3. ROUTE NEW REFRIGERANT PIPING NORTH TO NEW AIR-COOLED CONDENSING UNIT LOCATED ON EXTERIOR PATIO. SEE 1/28-M201.
- 4. ROUTE 1" PUMPED CONDENSATE PIPING TO FLOOR DRAIN IN FMS LOCATED APPROXIMATELY 80 FEET WEST AND 50 FEET NORTH. FIELD VERIFY ROUTING.
- 5. REROUTE AND RECONNECT EXISTING 3" STEAM AND 1" CONDENSATE RETURN PIPING. FIELD VERIFY REQUIREMENTS.
- 6. PROVIDE NEW CONDENSATE PUMP.
- REPLICATE EXISTING SAFE WASTE AND EXTEND DRAIN LINES AS NEEDED. FIELD VERIFY REQUIREMENTS.
- 8. RE-PIPE EXISTING FLOOR CLEANOUT FOR FINISHED FLOOR APPLICATION WITH FLOOR PLATE.
- 9. PAN CONDENSATE PUMP AND PIPING ASEMBLY WITHIN TELECOM ROOM 003A. FIELD VERIFY REQUIRMENTS.

#### **KEYNOTES 2/28-M200:**


- 1. PROVIDE NEW WALL-MOUNTED SPLIT SYSTEM AC UNIT.
- 2. PROVIDE NEW THERMOSTAT.
- 3. RE-ROUTE AND RECONNECT EXISTING STEAM AND CONDENSATE PIPING. FIELD VERIFY REQUIREMENTS.
- 4. ROUTE NEW REFRIGERANT PIPING NORTH TO NEW AIR-COOLED CONDENSING UNIT LOCATED ON EXTERIOR PATIO. SEE 1/28-M201.
- ROUTE 1" PUMPED CONDENSATE PIPING TO FLOOR DRAIN IN FMS LOCATED APPROXIMATELY 85 FEET EAST AND 50 FEET NORTH. FIELD VERIFY ROUTING.
- 6. PROVIDE NEW CONDENSATE PUMP.
- 7. PAN CONDENSATE PUMP AND PIPING ASEMBLY WITHIN TELECOM ROOM 066A. FIELD VERIFY REQUIRMENTS.



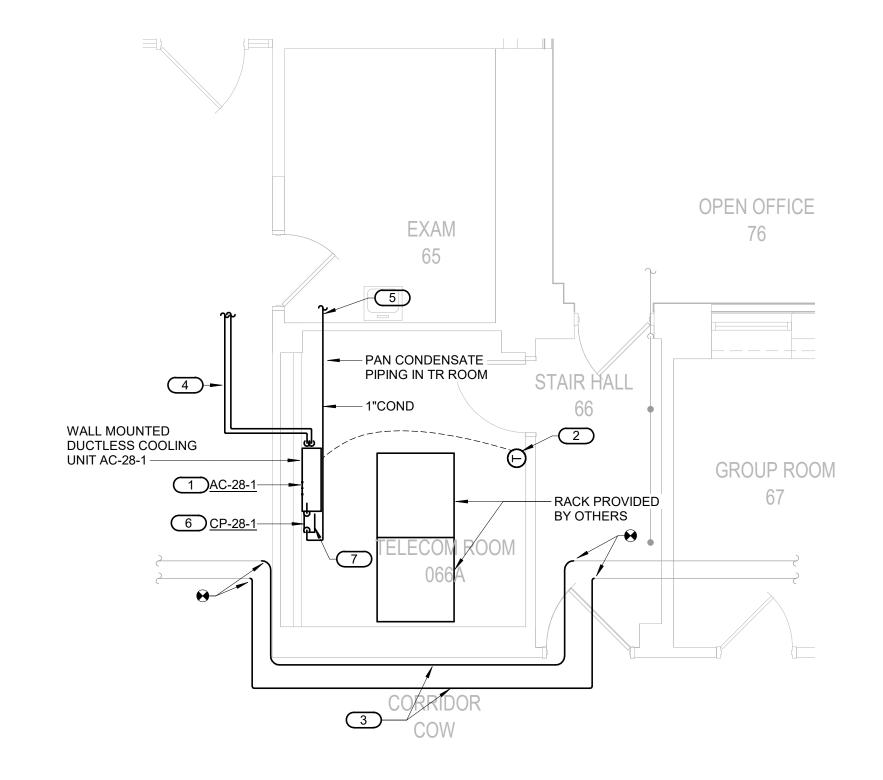






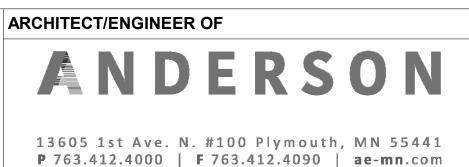

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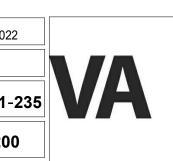
EHRM
INFRASTRUCTURE
UPGRADES

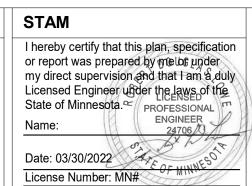BUILDING No
28

CHECKED BY
RDL

SPRINKLERED

VA MEDICAL CENTER ST.CLOUD, MN 56303





#### FIELD VERIFICATION NOTES


- 1. THE HVAC CONTRACTOR SHOULD VISIT <u>PRIOR TO BID</u> TO FIELD VERIFY ALL EXISTING CONDITIONS WHICH MAY AFFECT THIER BID. THE FOLLOWING ITEMS SHALL BE VERIFIED:
- A. EXACT PLACEMENT, SIZE, CAPACITY, MANUFACTURER AND CONDITION OF ALL EXISTING HVAC EQUIPMENT WITHIN SCOPE OF
- WORK, WHETHER EXPLICITLY SHOWN OR NOT.
- B. SIZE AND LOCATION OF ALL EXISTING DUCTWORK.
- C. SIZE AND LOCATION FO ALL EXISTING GRILLES, REGISTERS AND DIFFUSERS.
- D. SIZE AND LOCATION OF ALL EXISTING THERMOSTATIC CONTROL DEVICES.

E. SIZE AND LOCATION OF ALL EXISTING PLUMBING AND HYDRONIC PIPING.


- 2. ALL REFERENCES ON THESE DRAWINGS TO EXISTING EQUIPMENT, DUCTWORK, DIFFUSERS, THERMOSTATS AND PIPING ARE FOR REFERENCE ONLY. IT IS THE RESPONSIBILITY OF THE CONTRACTOR TO VERIFY ALL THESE ITEMS PRIOR TO BID AND INCLUDE IN THEIR BID ANY AND ALL AMOUNTS REQUIRED TO ACCOMODATE EXISTING CONDITIONS.
- 3. NO ALLOWANCES WILL BE MADE AFTER THE PROJECT HAS BEEN AWARDED FOR FAILURE TO VERIFY EXISTING CONDITIONS.
- 4. ANY DISCREPANCIES WHICH MAY AFFECT THE CONTRACTORS BID SHALL BE BROUGHT TO THE ATTENTION OF THE ENGINEER AND ARCHITECT FOR DIRECTION.

- **KEYNOTES 1/28-M201:**
- 1. PROVIDE NEW AIR-COOLED CONDENSING UNIT. PROVIDE CONCRETE PAD. REFER TO REFRIGERANT PIPING DETAIL. 1/0-GM400 AND PAD MOUNTING DETAIL 3/0-GM401
- 2. ROUTE NEW REFRIGERANT PIPING DOWN TO BASEMENT LEVEL AND TO TELECOM 066A FOR AC-28-1.
- 3. ROUTE NEW REFRIGERANT PIPING DOWN TO BASEMENT LEVEL
- AND TO TELECOM 003A FOR AC-28-2.

4. SEAL PIPE PENETRATIONS WATER TIGHT. FIELD VERIFY REQUIREMENTS. REFERE TO 5/0-GM401 FOR ROOF/PATIO PENETRATION SEALING DETAIL.

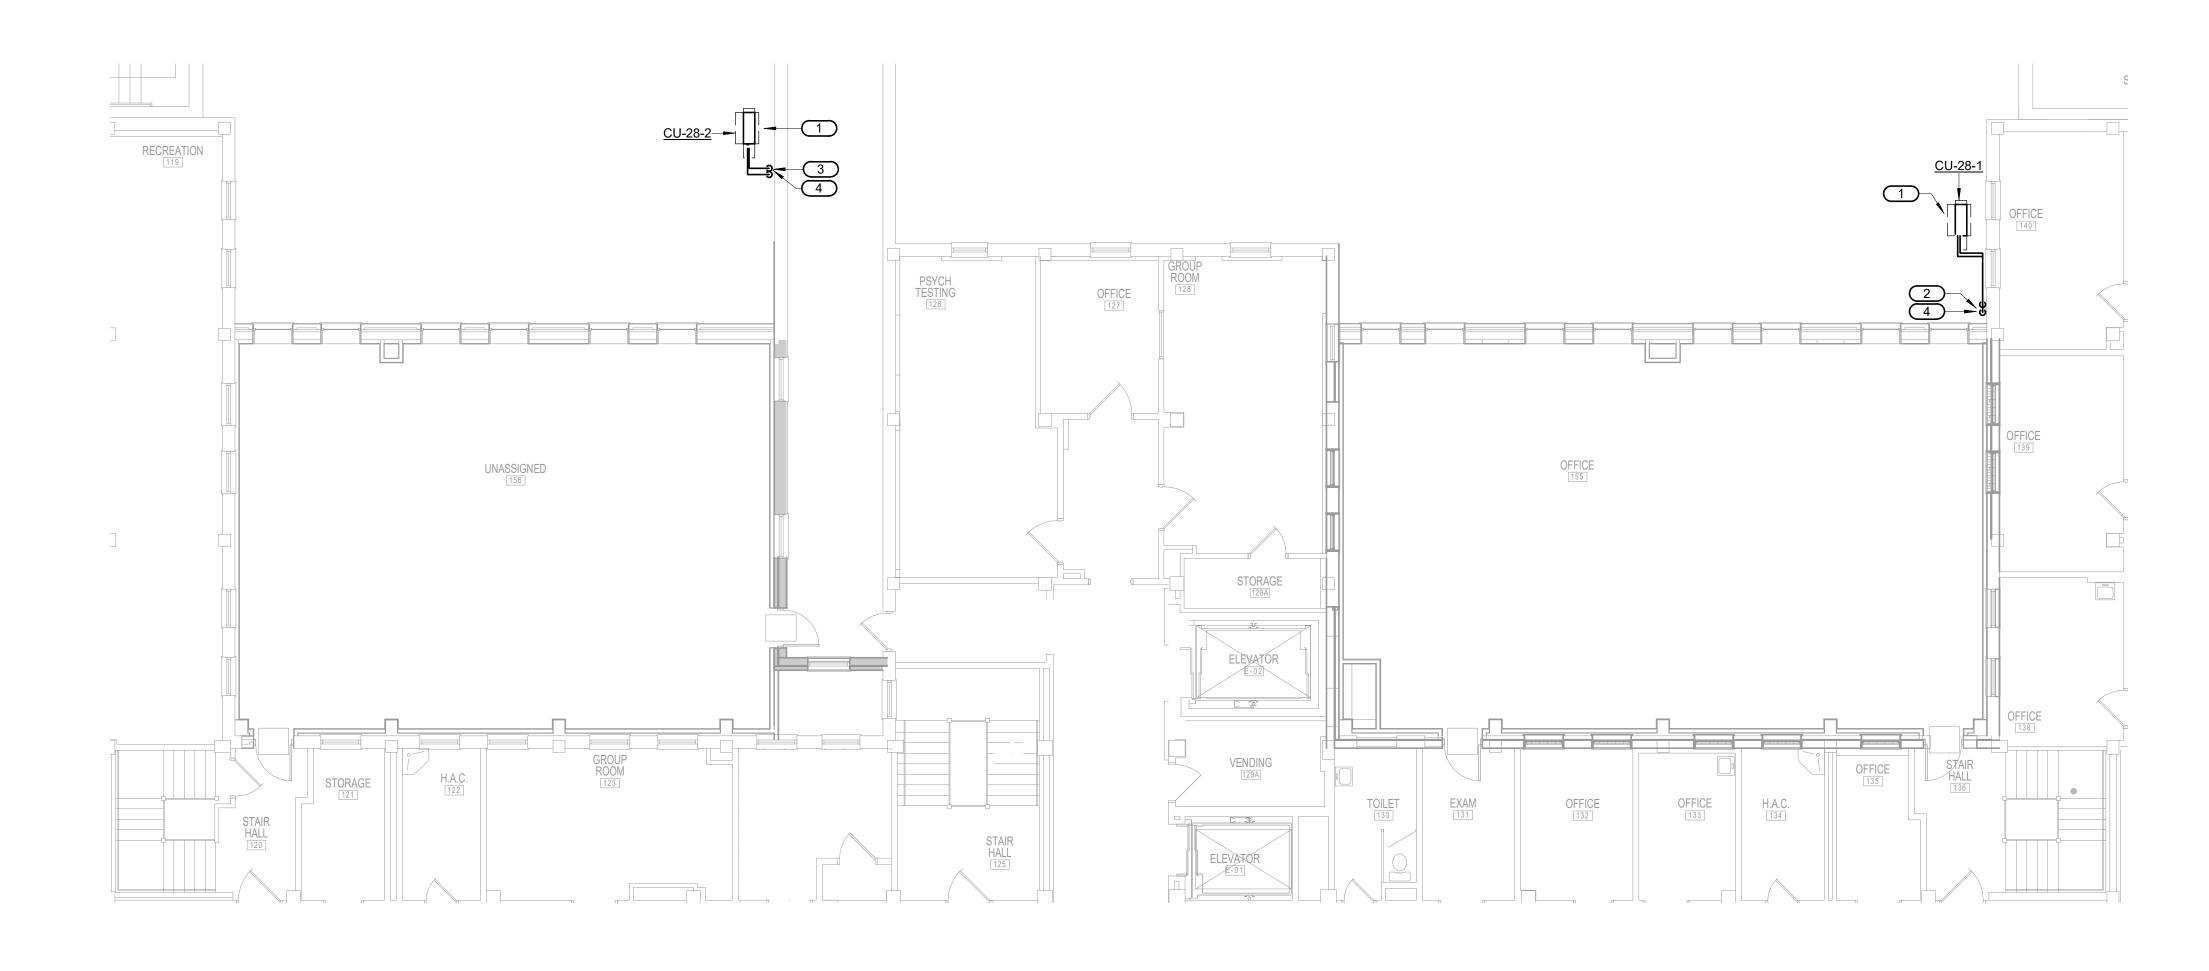


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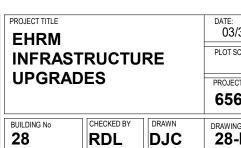


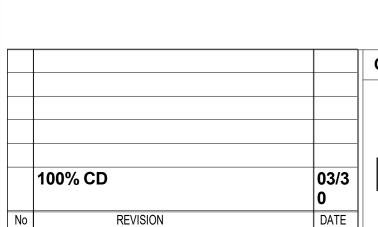

FIRST FLOOR - MECHANICAL- CONDENSING UNITS

1/8" = 1'-0"

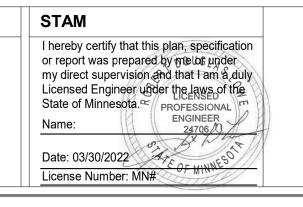



VA MEDICAL CENTER ST.CLOUD, MN 56303

