
# BUILDING 11 - EHRM INFRASTRUCTURE UPGRADES

St. Cloud VA Health Care System Main Campus, St. Cloud, Minnesota

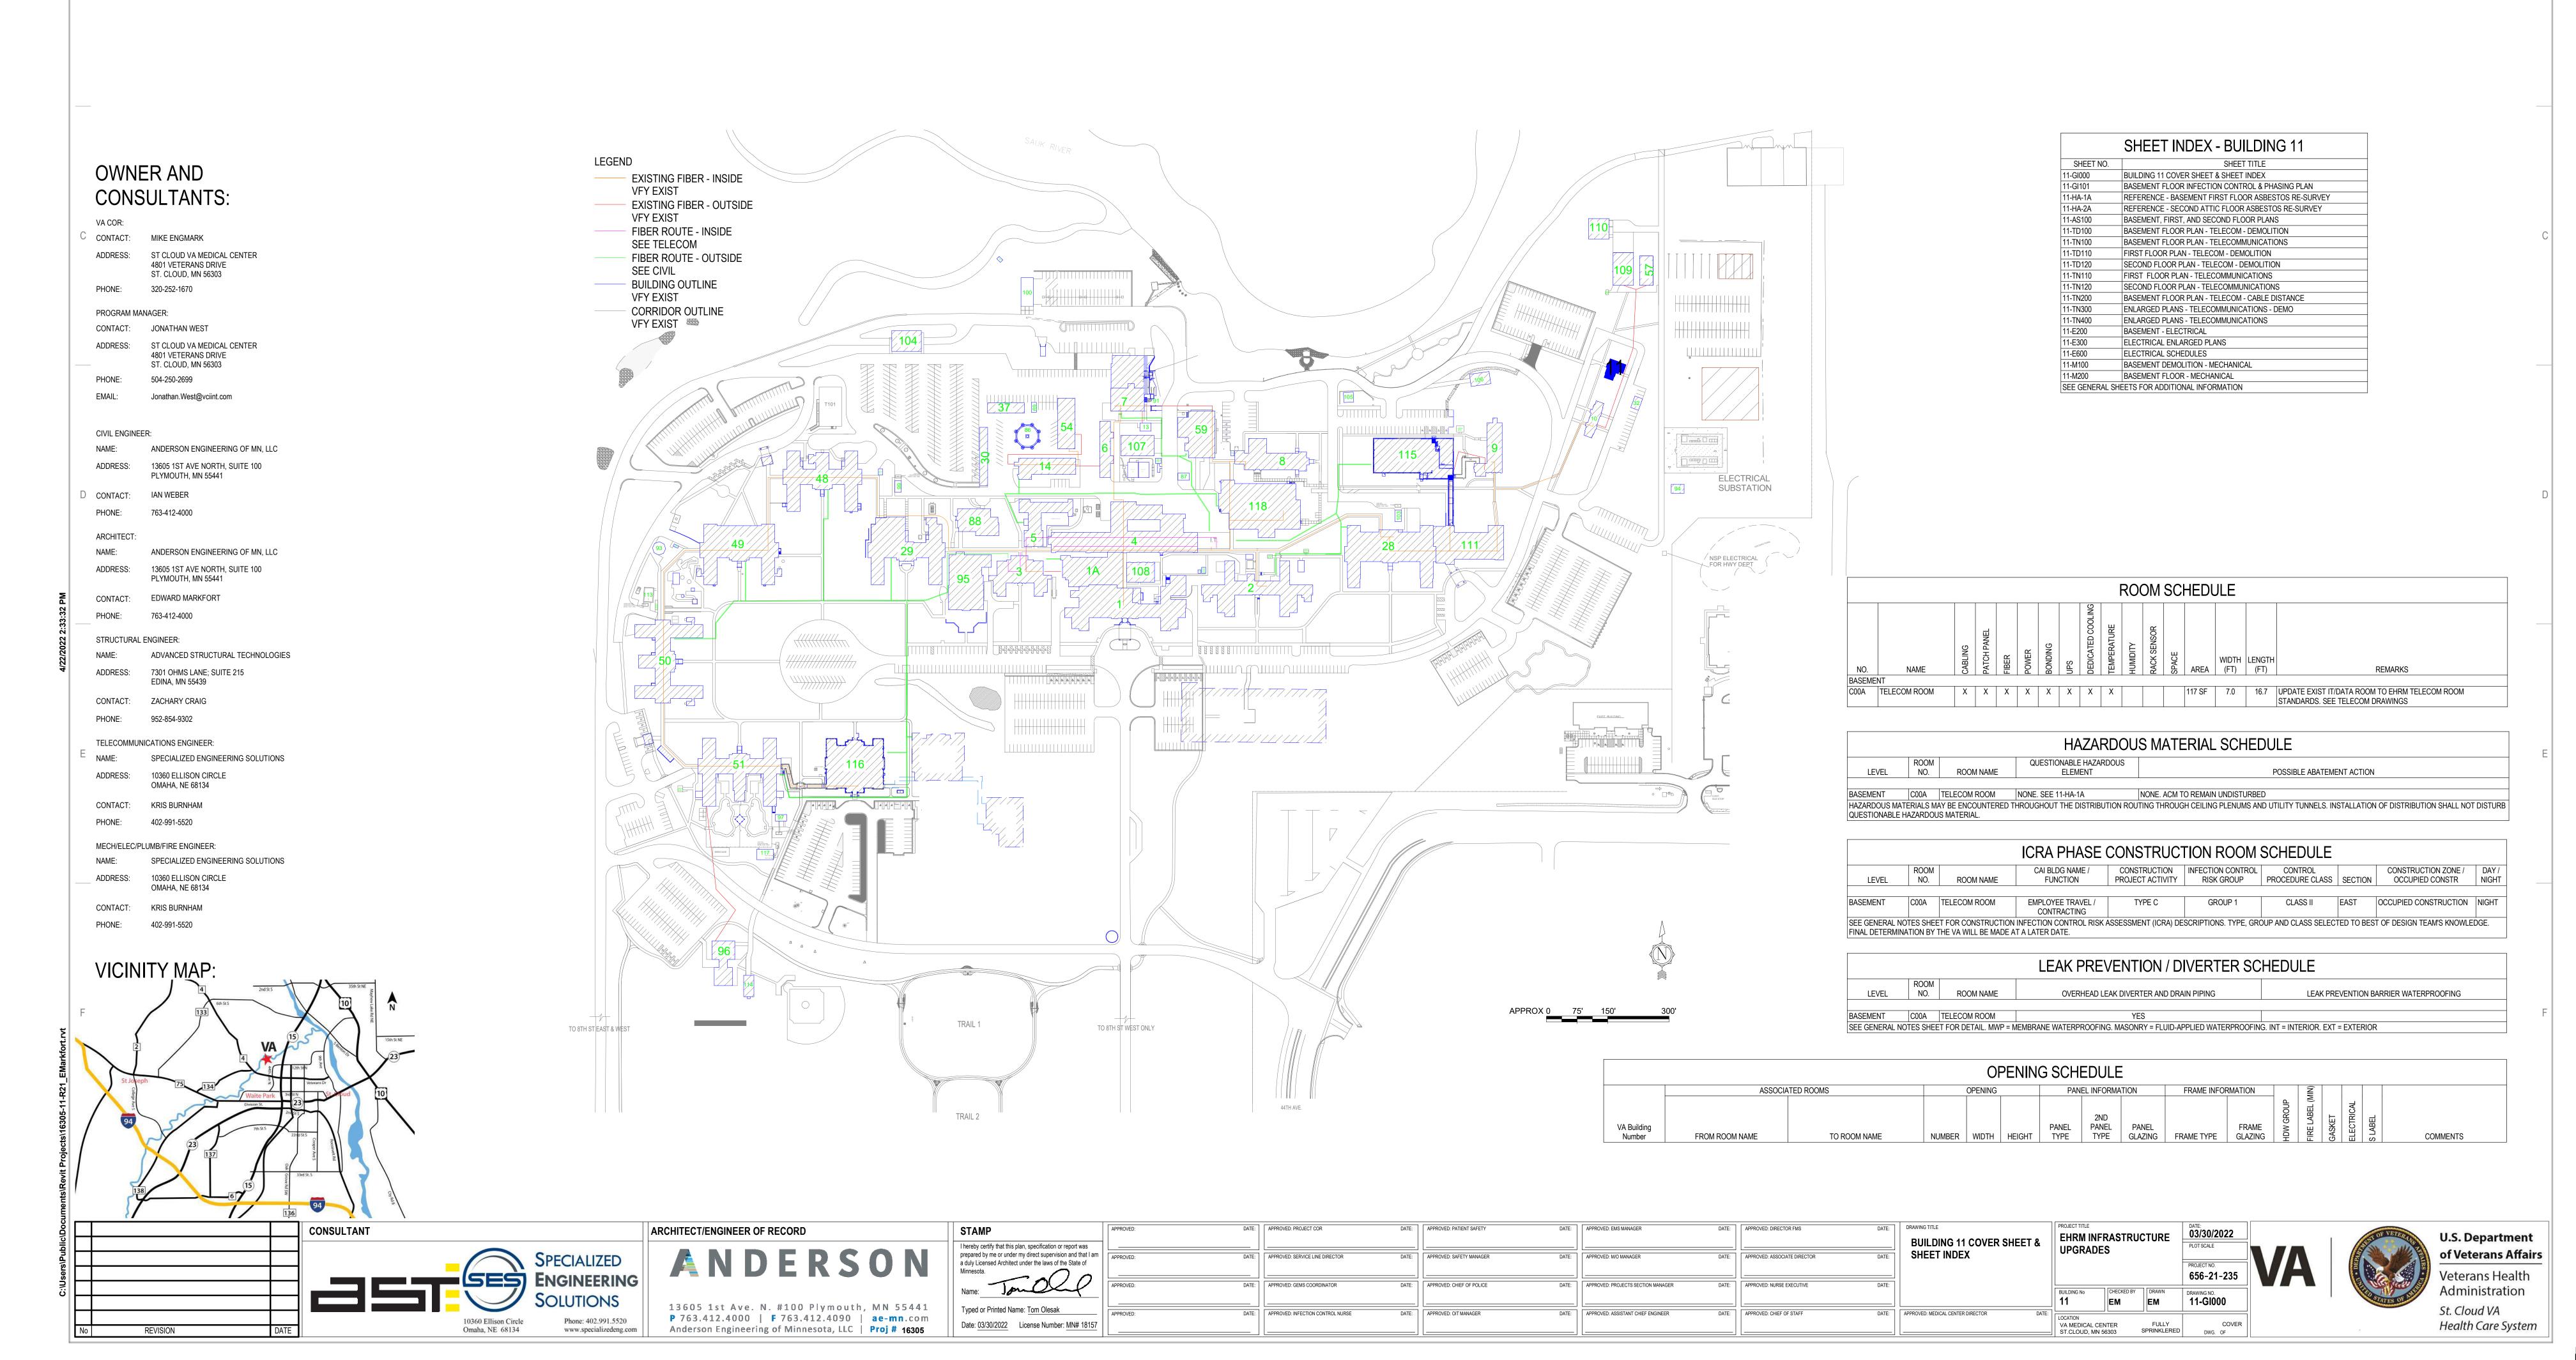

TELECOM : UNEXCAVATED VACANT VACANT UNEXCAVATED BASEMENT - CONST BARRIER PLAN

BASEMENT

1/4" = 1'-0"

ROOM ICRA SCHEDULE ROOM LEVEL NO. ROOM NAME CAI BLDG NAME / FUNCTION CONSTRUCTION PROJECT ACTIVITY INFECTION CONTROL RISK GROUP CONTROL PROCEDURE CLASS BASEMENT C00A TELECOM ROOM EMPLOYEE TRAVEL / CONTRACTING TYPE C GROUP 1 CLASS II
SEE GENERAL NOTES SHEET FOR CONSTRUCTION INFECTION CONTROL RISK ASSESSMENT (ICRA) DESCRIPTIONS. TYPE, GROUP AND CLASS SELECTED TO BEST OF DESIGN TEAM'S KNOWLEDGE.
FINAL DETERMINATION BY THE VA WILL BE MADE AT A LATER DATE.

INFECTION CONTROL RISK ASSESSMENT (ICRA) LEGEND	
	LIMITS OF CONSTRUCTION
	1 HOUR FIRE RATED ICRA / CONSTRUCTION BARRIER LOCATION, AND DOOR, WHERE SHOWN
	TEMPORARY NON-RATED (PLASTIC SHEETING) CONSTRUCTION BARRIER LOCATION, WHERE APPROVED BY THE VA FOR USE IN RISK TYPE B. UPGRADE TO 1 HOUR RATED PARTITION WHEN DIRECTED BY THE VA

BASEMENT FLOOR INFECTION CONTROL & PHASING PLAN

EHRM INFRASTRUCTURE

FULLY SPRINKLERED

BUILDING No

VA MEDICAL CENTER ST.CLOUD, MN 56303

03/30/2022



STAMP I hereby certify that this plan, specification or report was prepared by me or under my direct supervision and that I am a duly Licensed Architect under the laws of the State of

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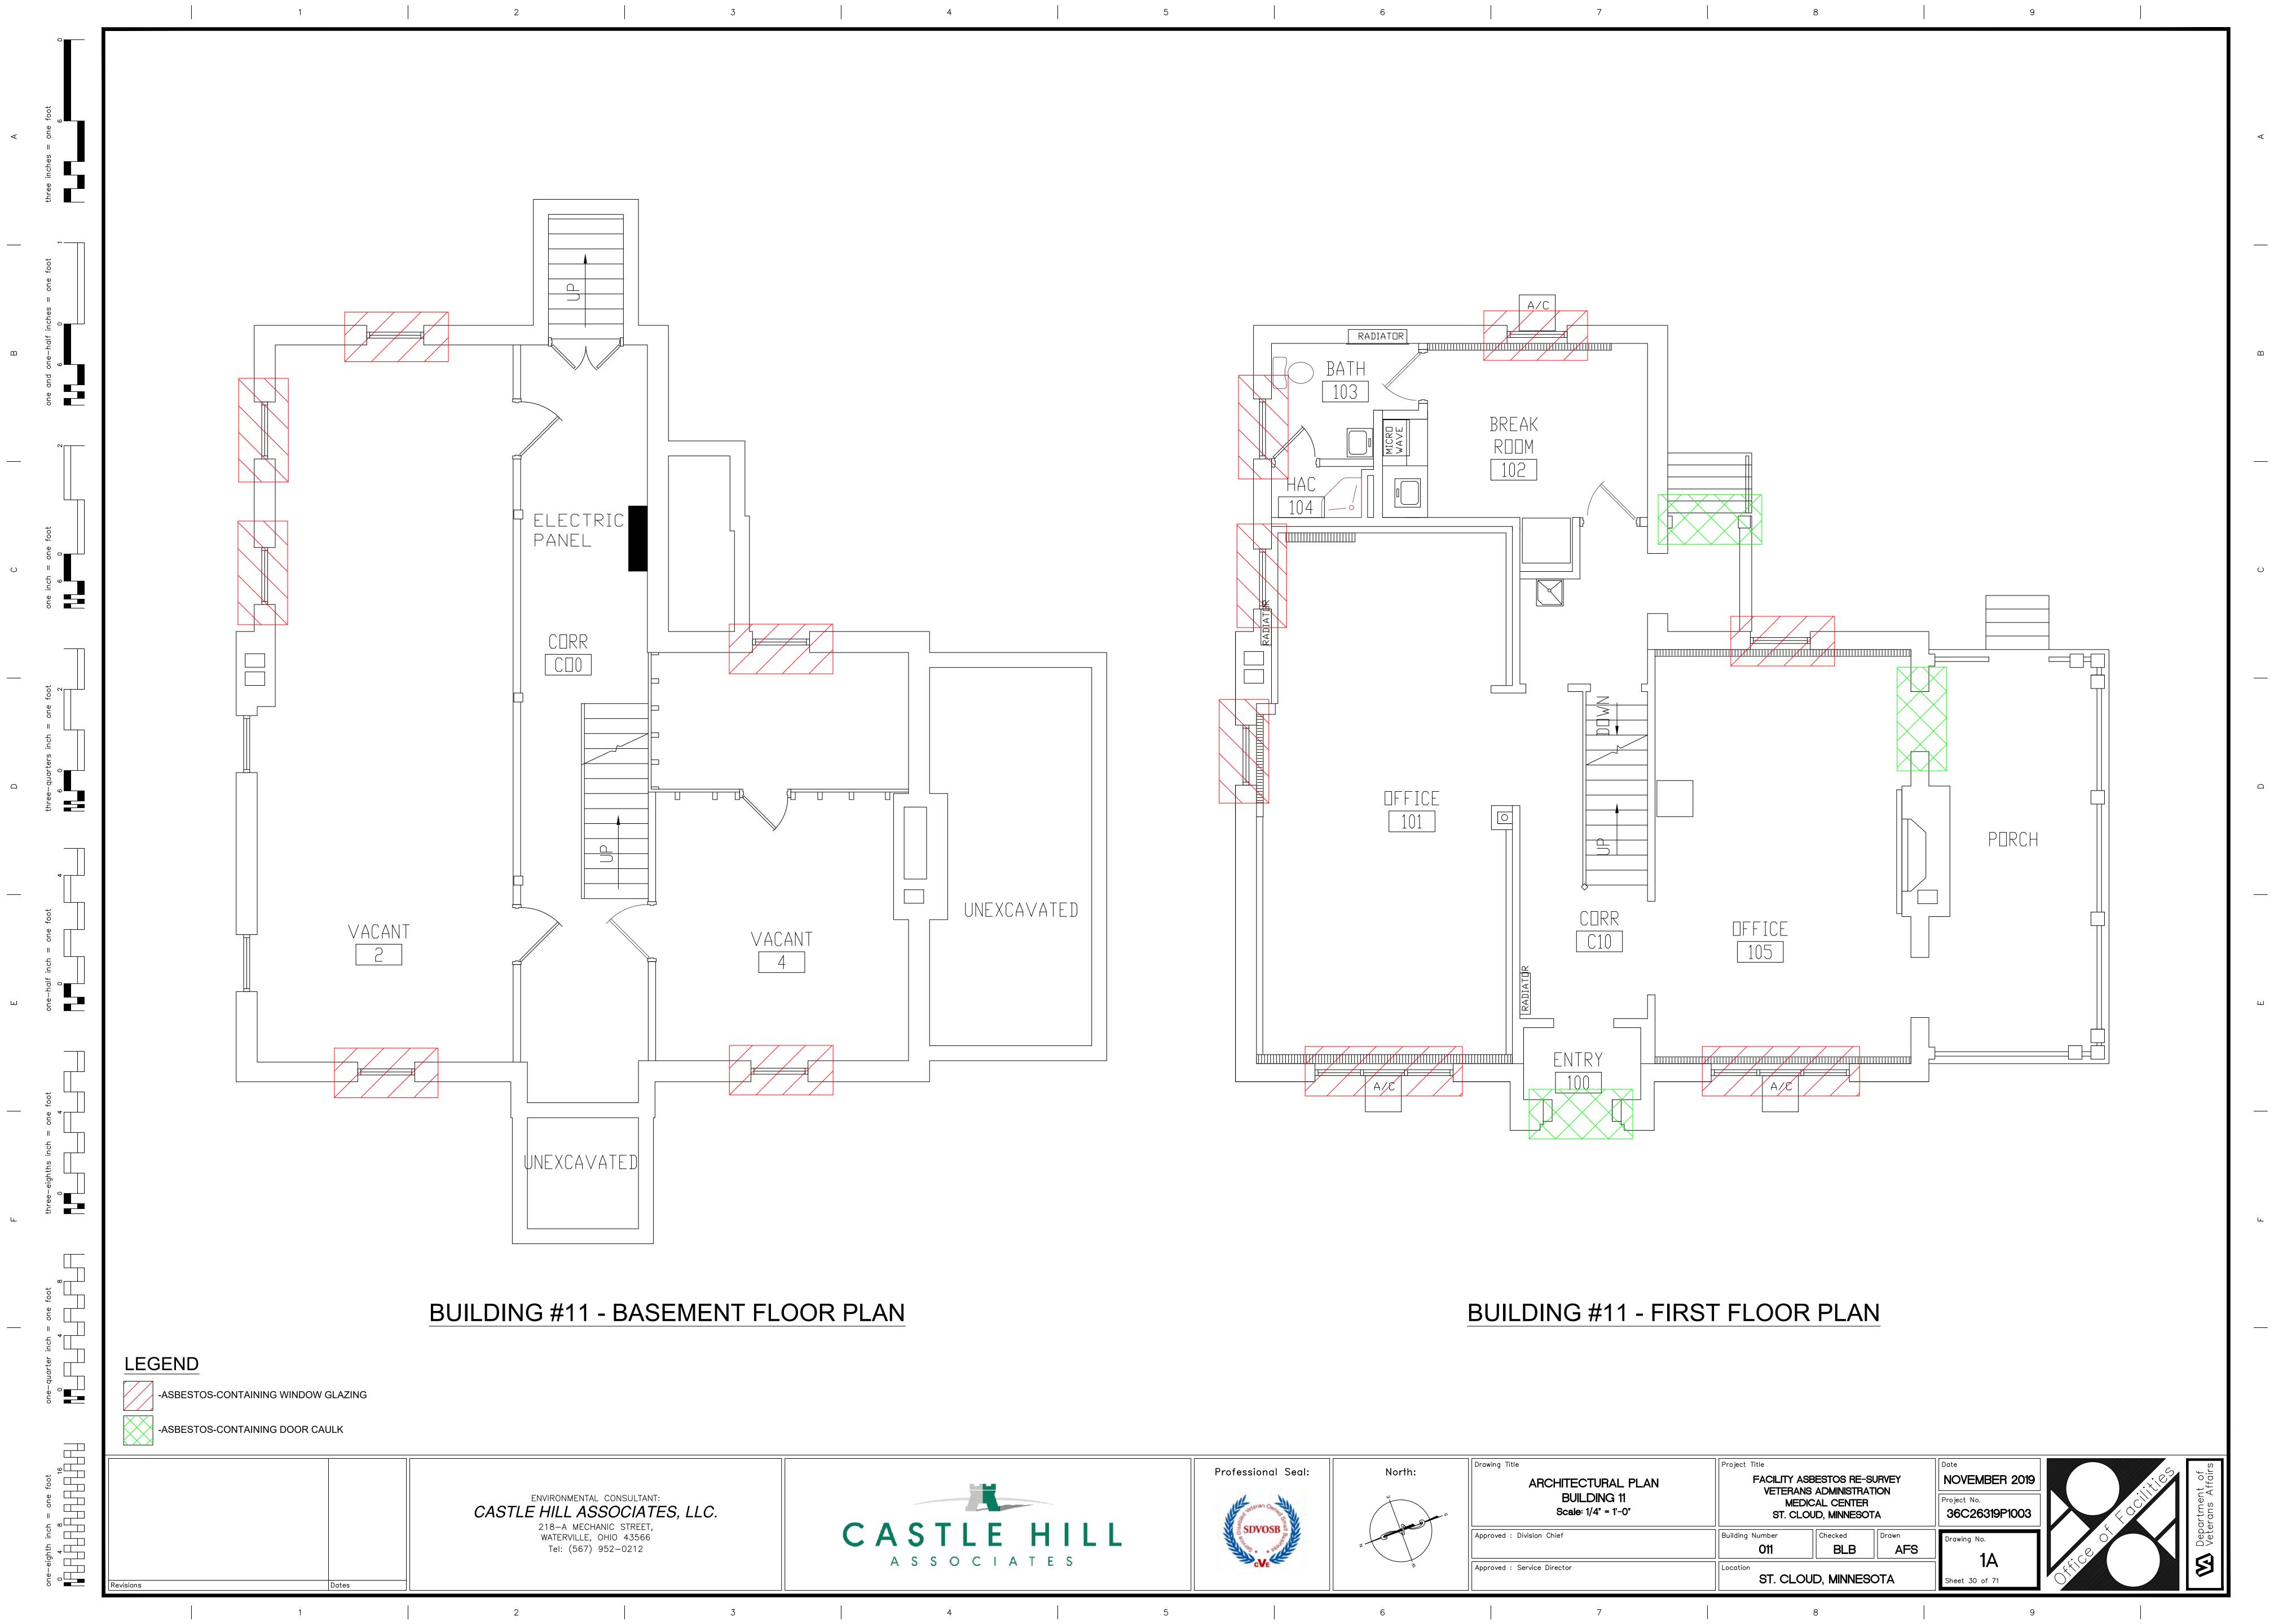
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 7





REVISION








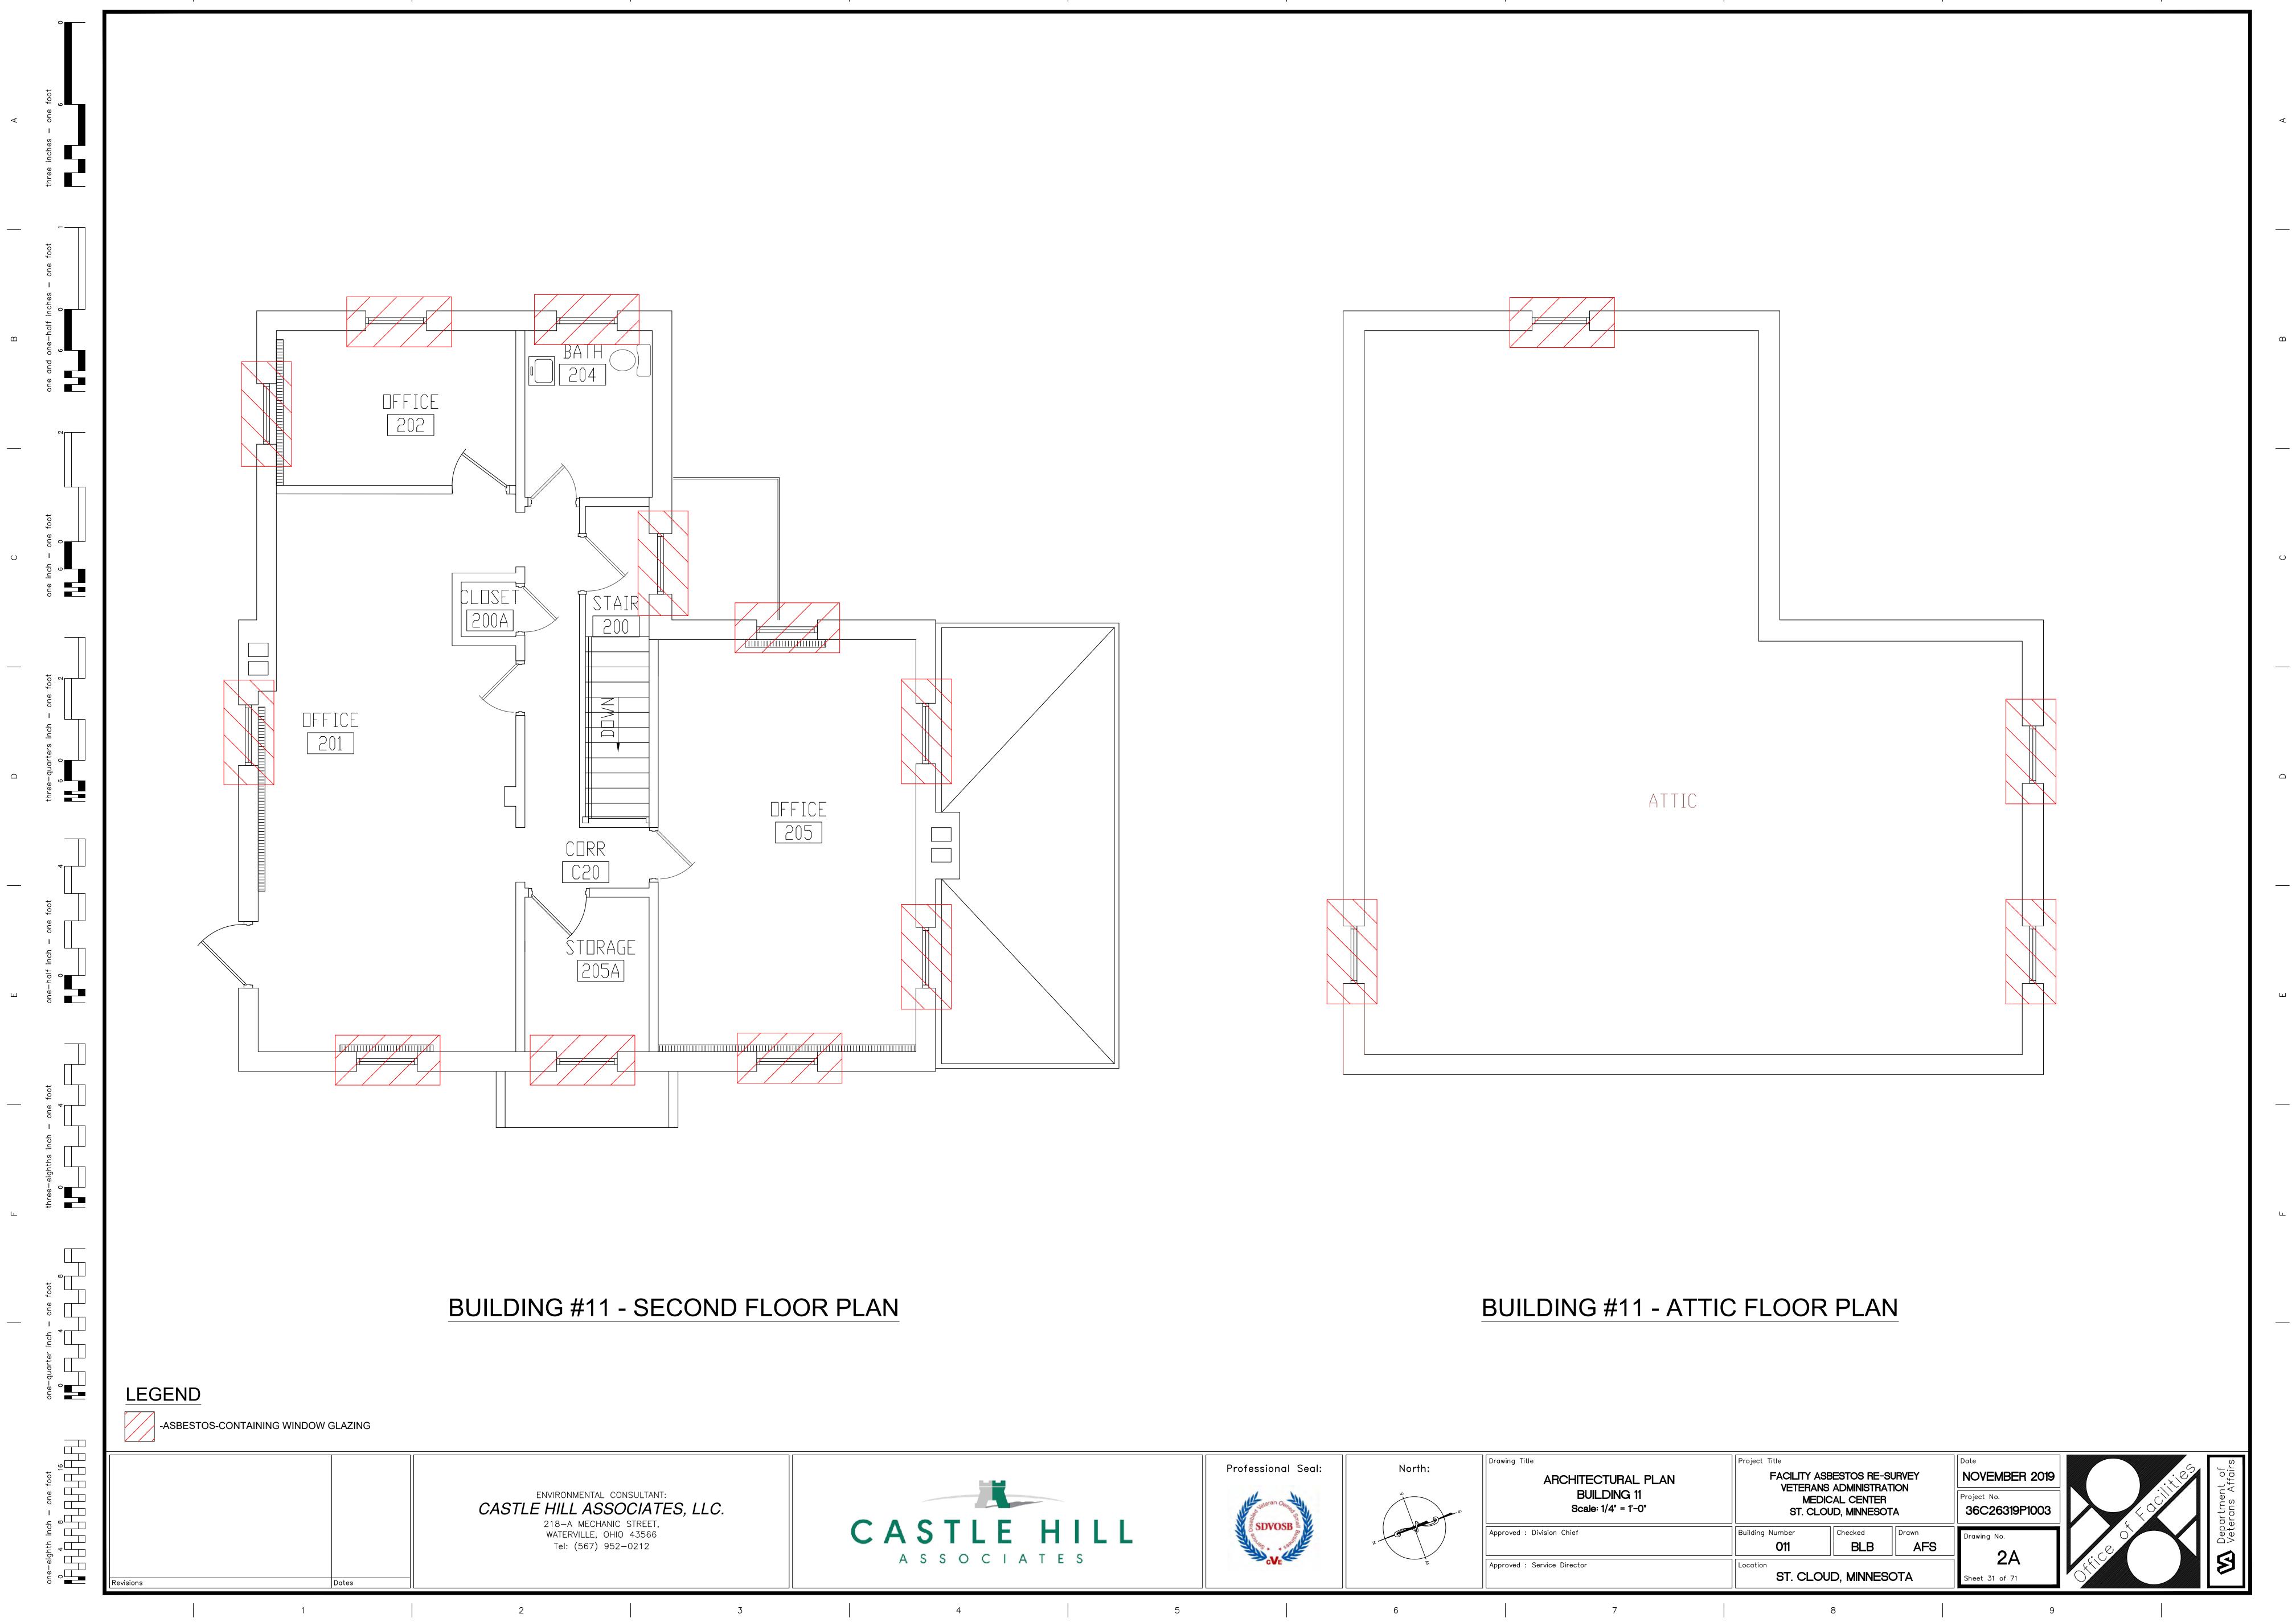


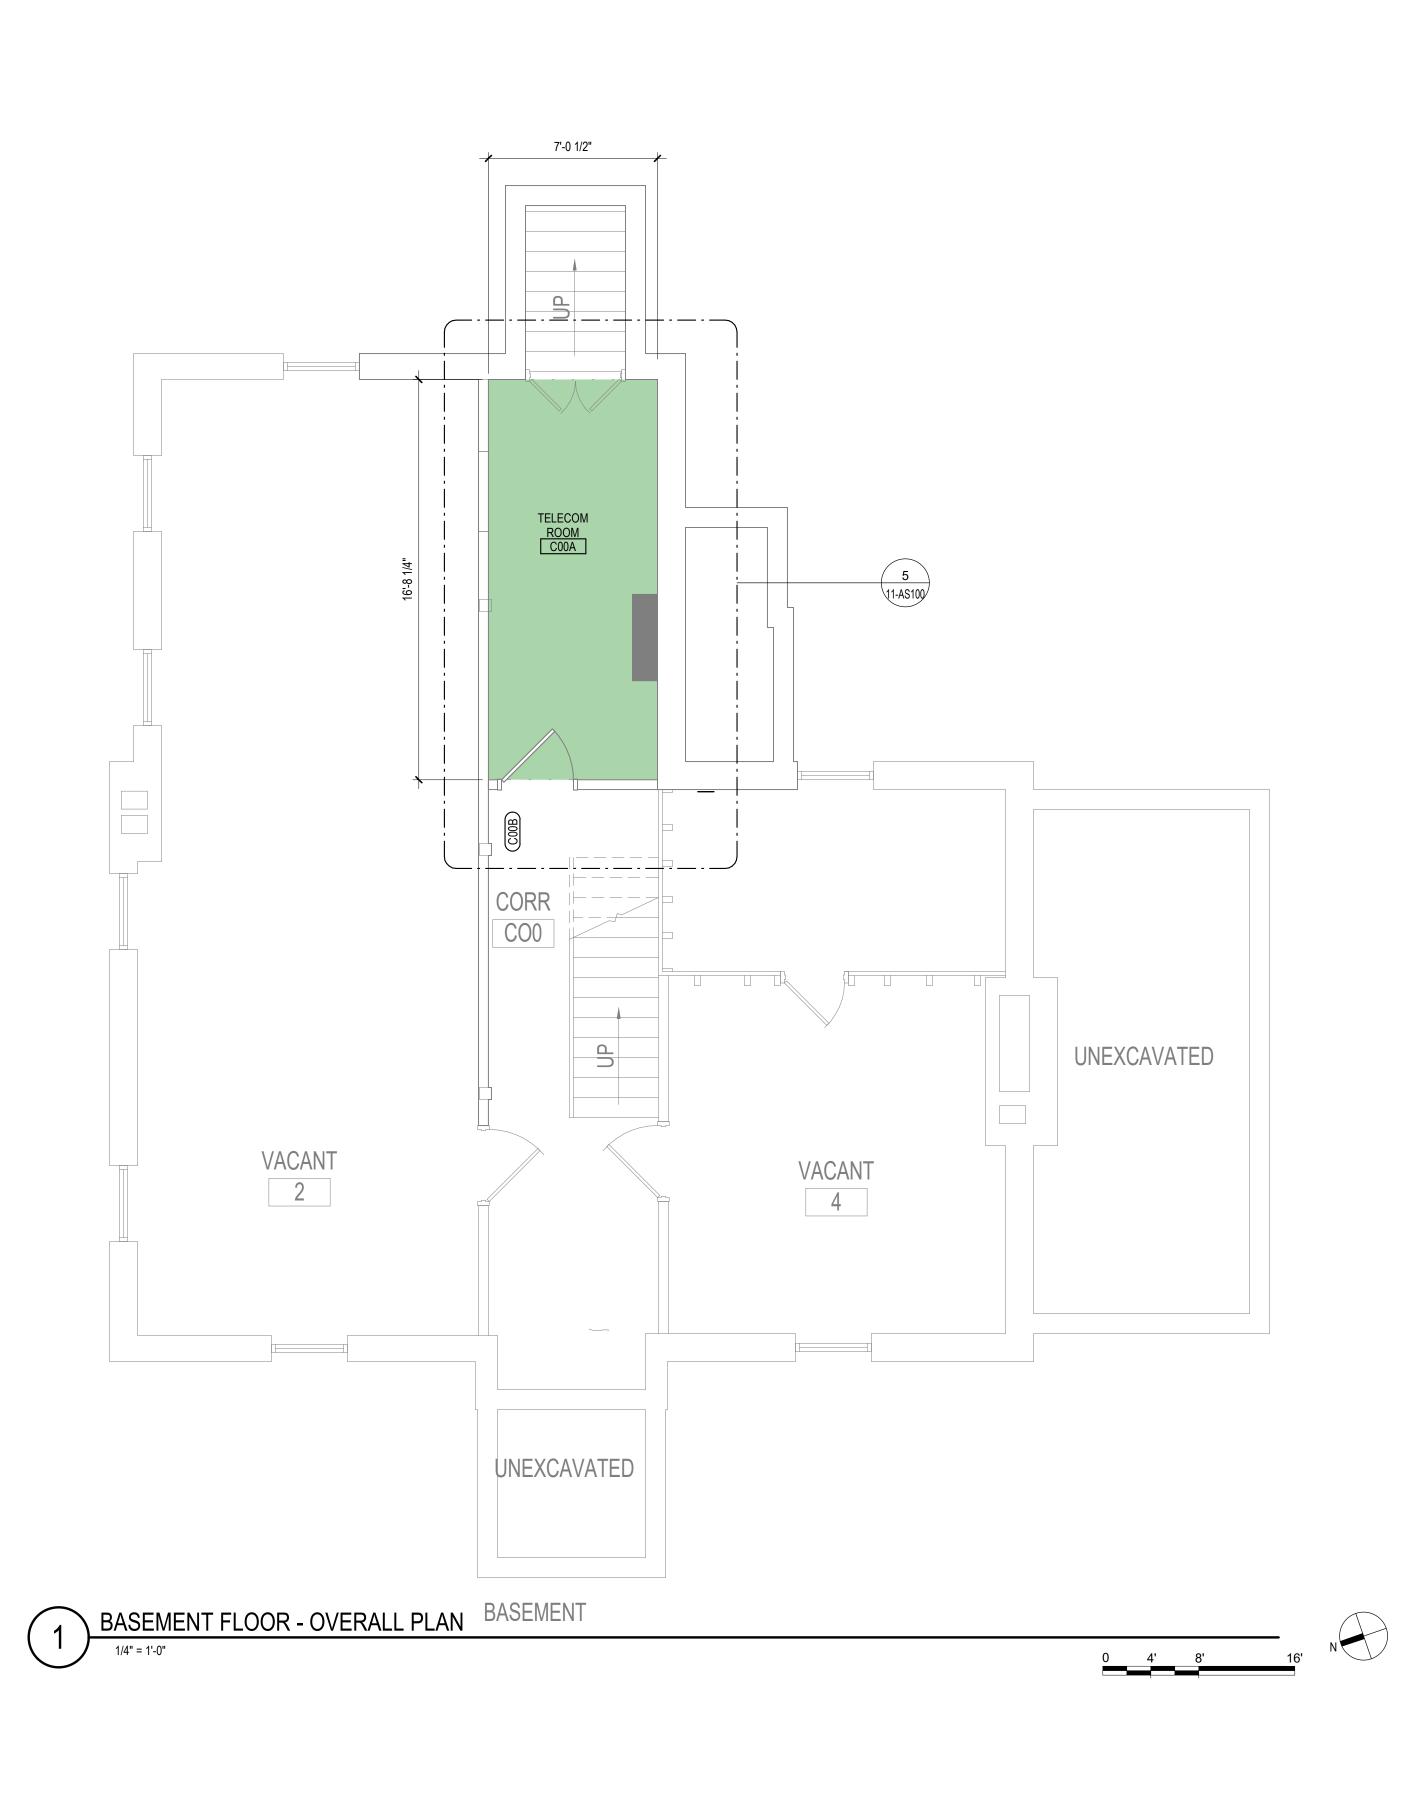

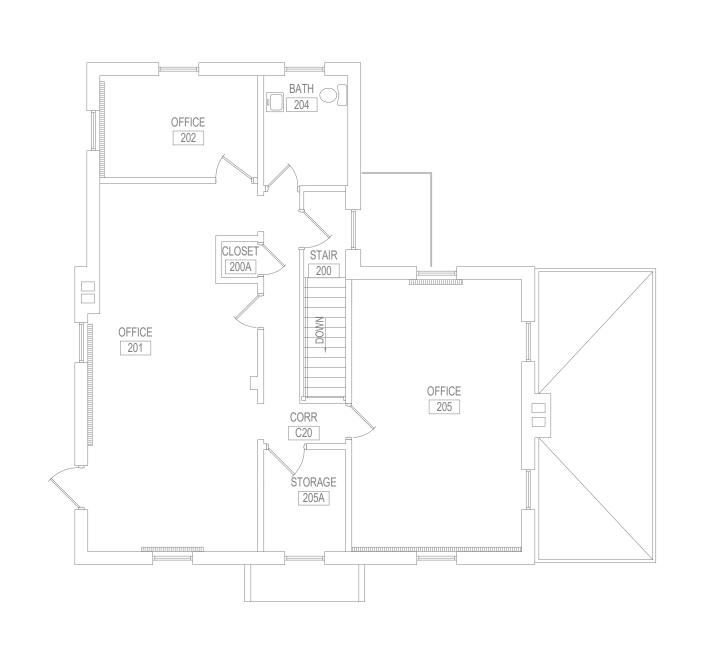

1 2 8



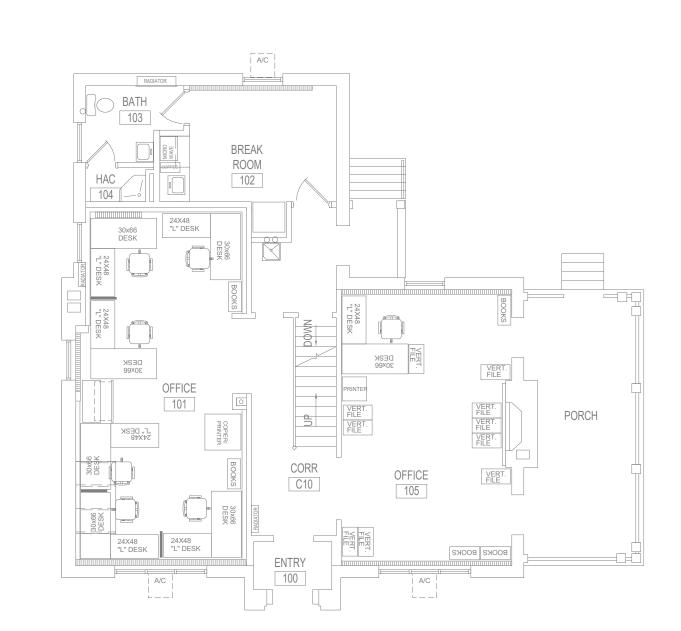

FIRST FLOOR - OVERALL PLAN

1/8" = 1'-0"

## \_DEMOLITION PLAN KEYED NOTES

DE1 PREPARE WALL FOR PLYWOOD BACKBOARD INSTALLATION AND EHRM REQUIREMENTS, SEE FLOOR PLAN AND TELECOM DRAWINGS

NOTE: NOT ALL KEYED NOTES MAY BE USED ON EACH PLAN

### \_FLOOR PLAN KEYED NOTES

- FL1 ALL FOUR PERIMETER WALL PARTITIONS APPLY 4' BY 8' AC GRADE 3/4"
  TRADE SIZE FIRE RATED PLYWOOD BACKBOARD FINISHED WITH
  HIGH-GLOSS WHITE PAINT OVER TWO COATS OF FIRE RESISTANT PAINT
  FOR SERVICE PROVIDER / SECURITY / VIDEO / ET CETERA. DO NOT PAINT
  OVER FIRE RATING STAMP.
- FL3

  UPGRADE PARTITION TO 1 HOUR FIRE AND SMOKE BARRIER. PROVIDE
  TESTED HEAD OF PARTITION ASSEMBLY WITH MATERIALS THAT RESIST
  THE PASSAGE OF SMOKE. SEAL JOINT AT HEAD AND ALL PENETRATIONS
  WITH FIRE CAULK.
- FL14 PROVIDE UL RATED 1 HOUR HORIZONTAL SHAFT WALL ASSEMBLY AT CEILING TIGHT TO UNDERSIDE OF EXISTING STRUCTURE ABOVE. WHERE EXISTING FINISHES ARE DISTURBED ON PAINTED SURFACES, PAINT TO MATCH ADJACENT FINISH. PAINT ENTIRE PARTITION ON INTERIOR SPACES WHERE PATCHING OCCURS. PAINT CEILING TO MATCH
- FL20 TELECOM EQUIPMENT, SEE TELECOM DRAWINGS.
- FL21 OVERHEAD LEAK DIVERTER, SEE PLUMBING.

NOTE: NOT ALL KEYED NOTES MAY BE USED ON EACH PLAN

ADJACENT FINISH


## REFLECTED CEILING PLAN KEYED NOTES


- RC1 LED LIGHTING, SEE ELECTRICAL. IN FRONT OF AND BEHIND CABINET ROWS PROVIDE 500 LUMENS IN HORIZONTAL AND 200 LUMENS IN THE VERTICAL AT 3 FT AFF. OPERATED BY MOTION SENSOR PER CABINET ROW OR SECTION.
- RC7 RATED CEILING SEE FLOOR PLAN KEYED NOTE 14


NOTE: NOT ALL KEYED NOTES MAY BE USED ON EACH PLAN

# \_SHEET NOTES


- 1. SEE GENERAL NOTES AND CAMPUS DRAWINGS FOR GENERAL INFORMATION, LIFE SAFETY, ICRA, AND PHASING
- 2. ALL EXISTING CONDITIONS MUST BE FIELD VERIFIED BY THE CONTRACTOR PRIOR TO DEMOLITION OR CONSTRUCTION. EXISTING CONDITIONS THAT DIFFER FROM THOSE SHOWN MUST BE BROUGHT TO THE ATTENTION OF THE C.O.R. TO INFORM THE ARCHITECTS AND
- 3. THE INFORMATION SHOWN ON THE DRAWINGS IS BASED ON DRAWINGS AND PHOTOGRAPHS PROVIDED BY THE C.O.R. COMBINED WITH OBSERVATIONS AND SURVEYED DATA FROM THE ARCHITECTS AND ENGINEERS.
- 4. SEE CIVIL, STRUCTURAL, TELECOM, ELECTRICAL, MECHANICAL, AND PLUMBING DRAWINGS AND SPECIFICATIONS FOR ADDITIONAL DEMOLITION AND CONSTRUCTION REQUIREMENTS.
- PORTABLE FIRE EXTINGUISHERS (CO2 OR HALOGENATED TYPE AS DETERMINED BY VA) WITH WALL MOUNT BRACKET AND CODE REQUIRED SIGNAGE SHALL BE PROVIDED BY THE CONTRACTOR WITHIN TELECOM ROOMS.

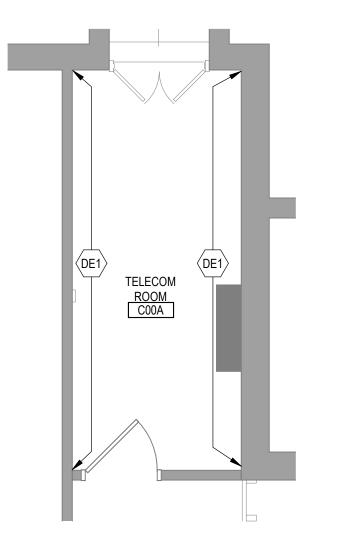


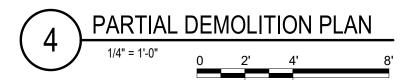


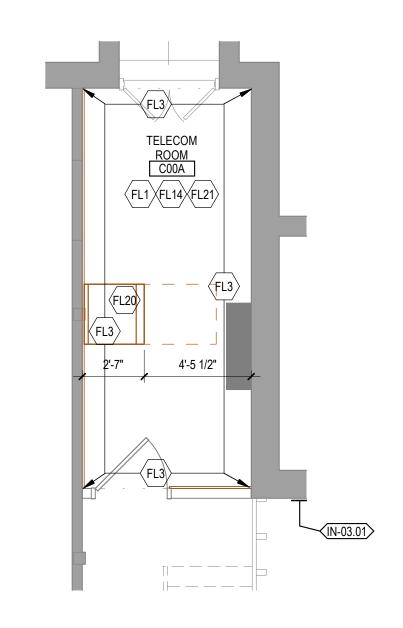





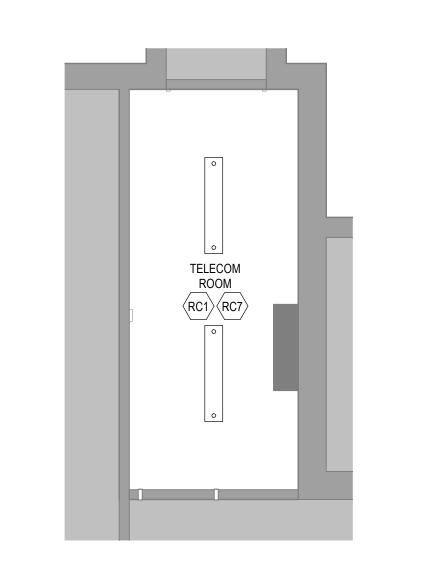

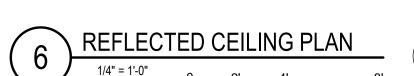


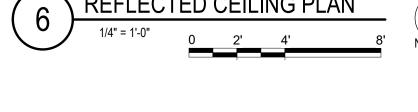

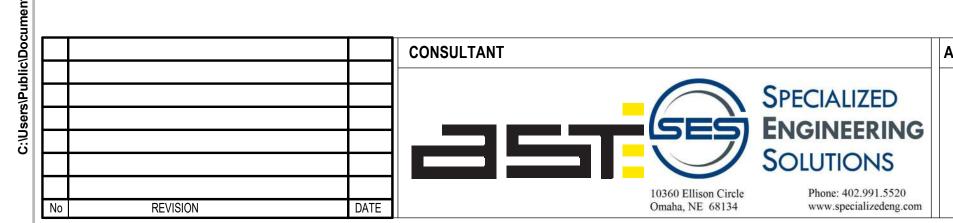


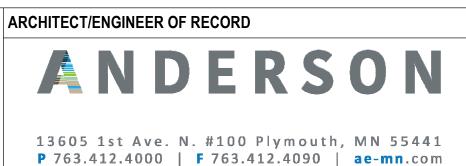

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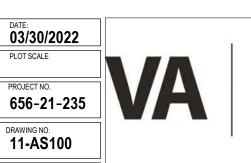


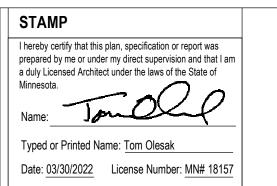

FULLY SPRINKLERED

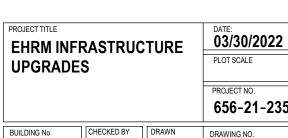EM

VA MEDICAL CENTER ST.CLOUD, MN 56303






A. REFER TO GENERAL DEMOLITION NOTES ON SHEET T000 FOR ADDITIONAL DEMOLITION SCOPE.


SHEET NOTES:

1. REMOVE AND REPLACE EXISTING DATA CABLE: REMOVE ALL EXISTING DATA CABLES AND JACKS THROUGHOUT THIS AREA. REPLACE CABLES AND JACKS 1 FOR 1, AS REQUIRED BY THE NEW WORK PLANS. REFER TO NEW WORK PLANS FOR SERVING COMMUNICATIONS ROOM LOCATION AND NEW CABLING

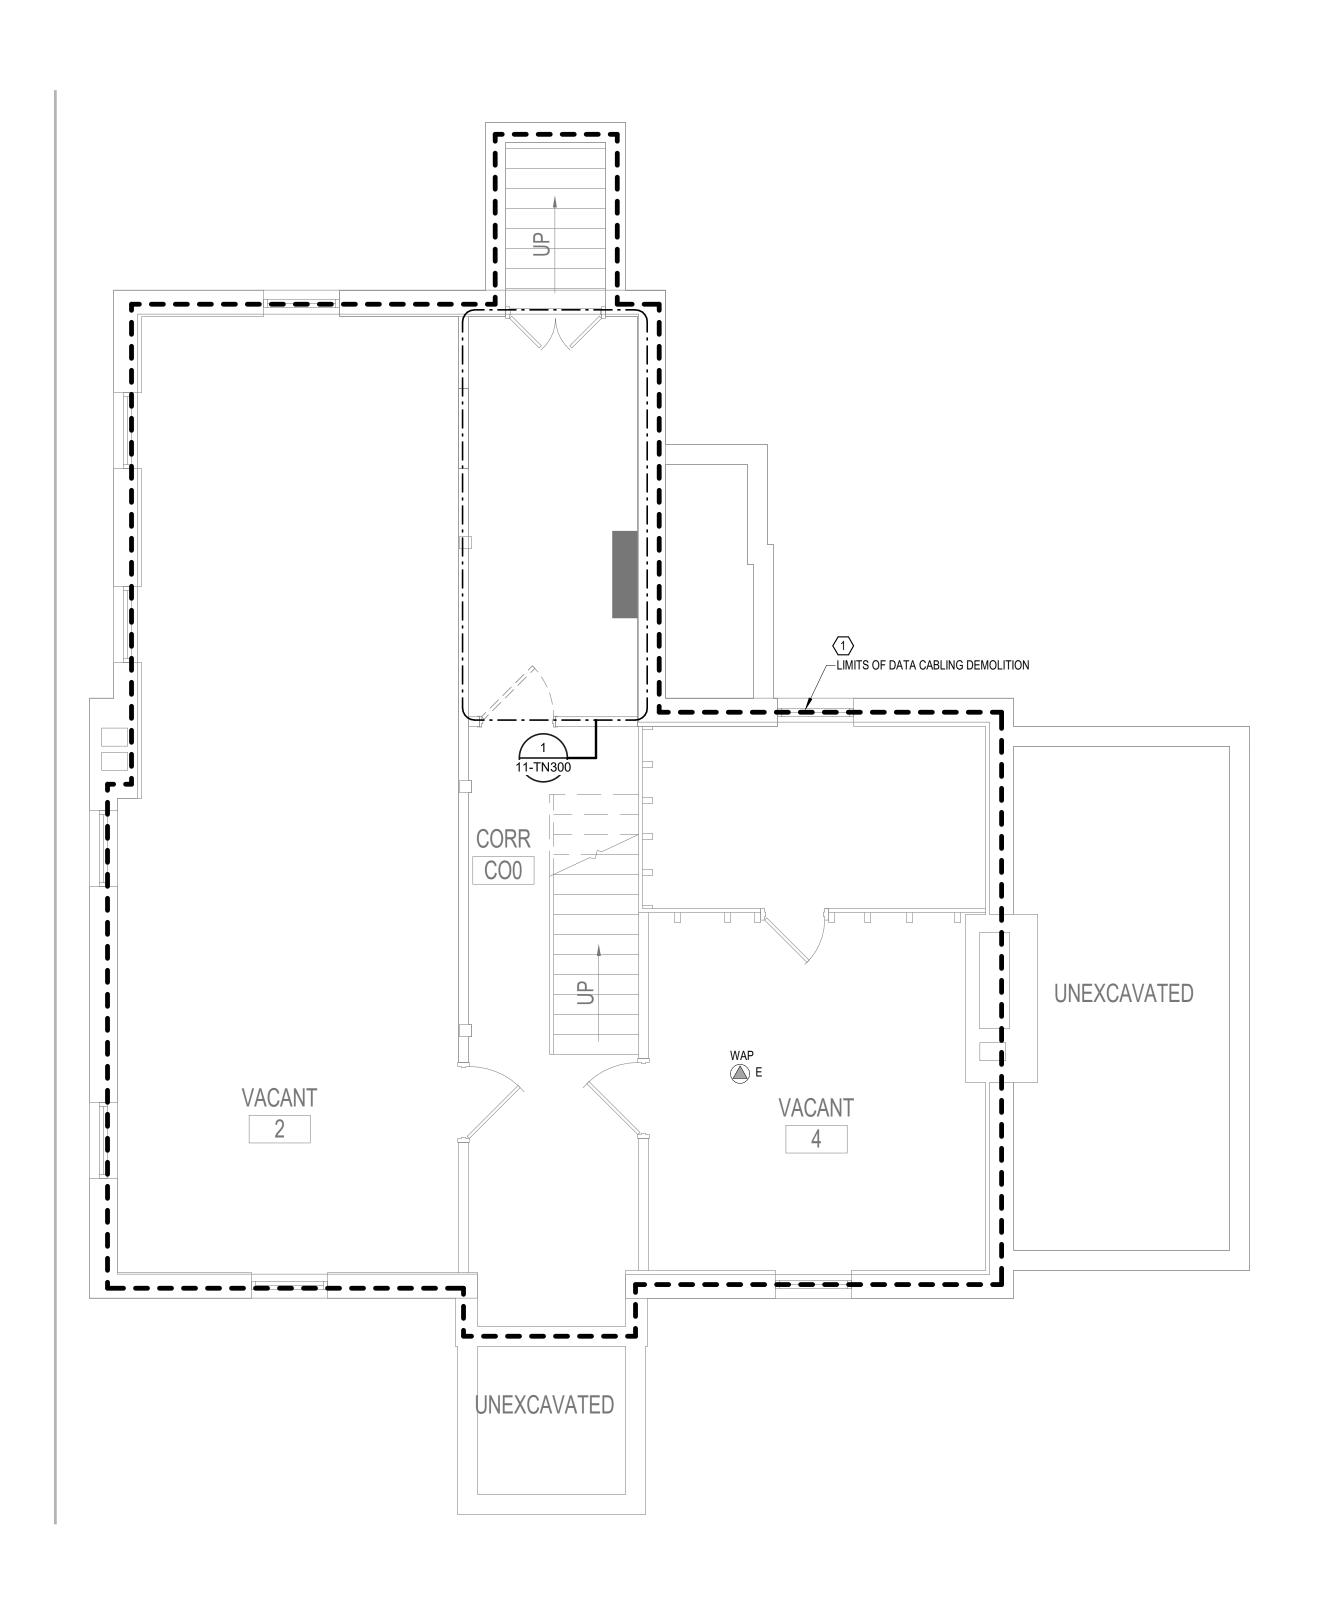

1 2 9

BASEMENT FLOOR PLAN - ELECTRICAL - DEMOLITION

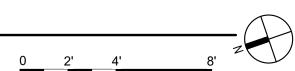



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BASEMENT FLOOR PLAN -TELECOM - DEMOLITION

EHRM INFRASTRUCTURE

03/30/2022



U.S. Department

Veterans Health Administration

Health Care System

St. Cloud VA


of Veterans Affairs

BUILDING No CHECKED BY DRAWN DRAWING NO. 11-TD100 LOCATION
VA MEDICAL CENTER
ST.CLOUD, MN 56303 FULLY SPRINKLERED

A. REFER TO GENERAL DEMOLITION NOTES ON SHEET T000 FOR ADDITIONAL DEMOLITION SCOPE.

SHEET NOTES:

REMOVE AND REPLACE EXISTING DATA CABLE: REMOVE ALL EXISTING DATA CABLES AND JACKS
THROUGHOUT THIS AREA. REPLACE CABLES AND JACKS 1 FOR 1, AS REQUIRED BY THE NEW WORK PLANS.
REFER TO NEW WORK PLANS FOR SERVING COMMUNICATIONS ROOM LOCATION AND NEW CABLING
ROUTES.

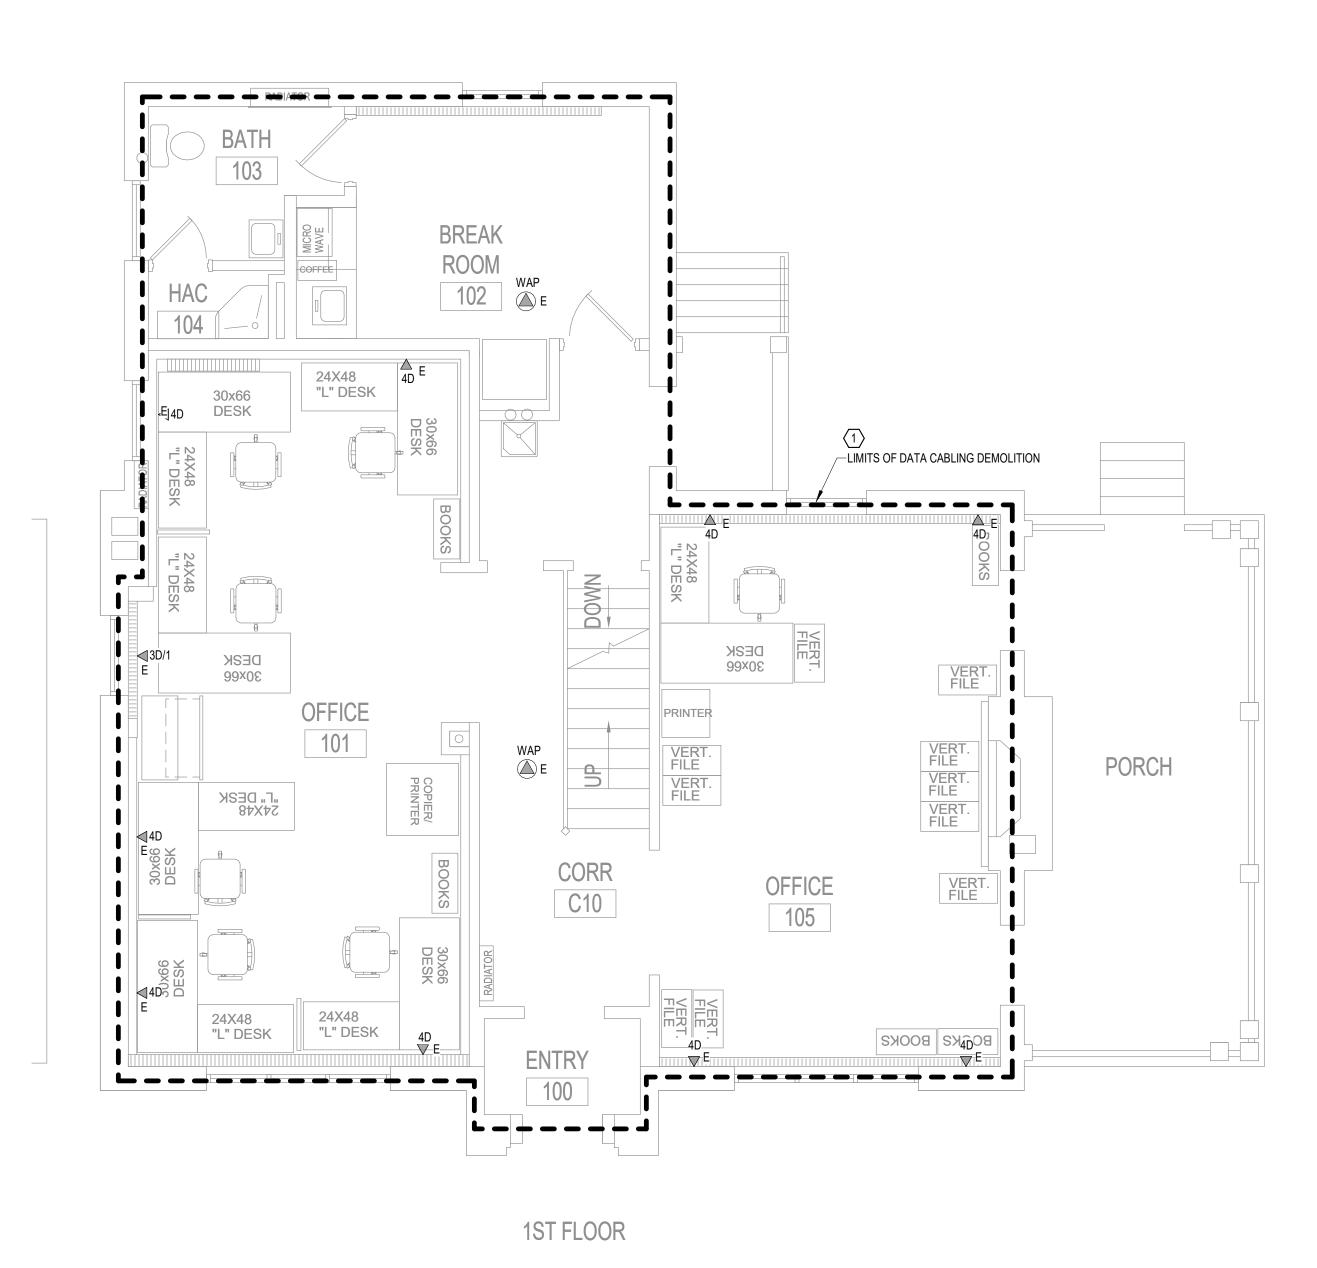

1 2 8

1 FIRST FLOOR PLAN - TELECOM - DEMOLITION

2' 4' 8'

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Omaha, NE 68134

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BUILDING No


LOCATION
VA MEDICAL CENTER
ST.CLOUD, MN 56303



A. REFER TO GENERAL DEMOLITION NOTES ON SHEET T000 FOR ADDITIONAL DEMOLITION SCOPE.

SHEET NOTES:

1. REMOVE AND REPLACE EXISTING DATA CABLE: REMOVE ALL EXISTING DATA CABLES AND JACKS THROUGHOUT THIS AREA. REPLACE CABLES AND JACKS 1 FOR 1, AS REQUIRED BY THE NEW WORK PLANS. REFER TO NEW WORK PLANS FOR SERVING COMMUNICATIONS ROOM LOCATION AND NEW CABLING

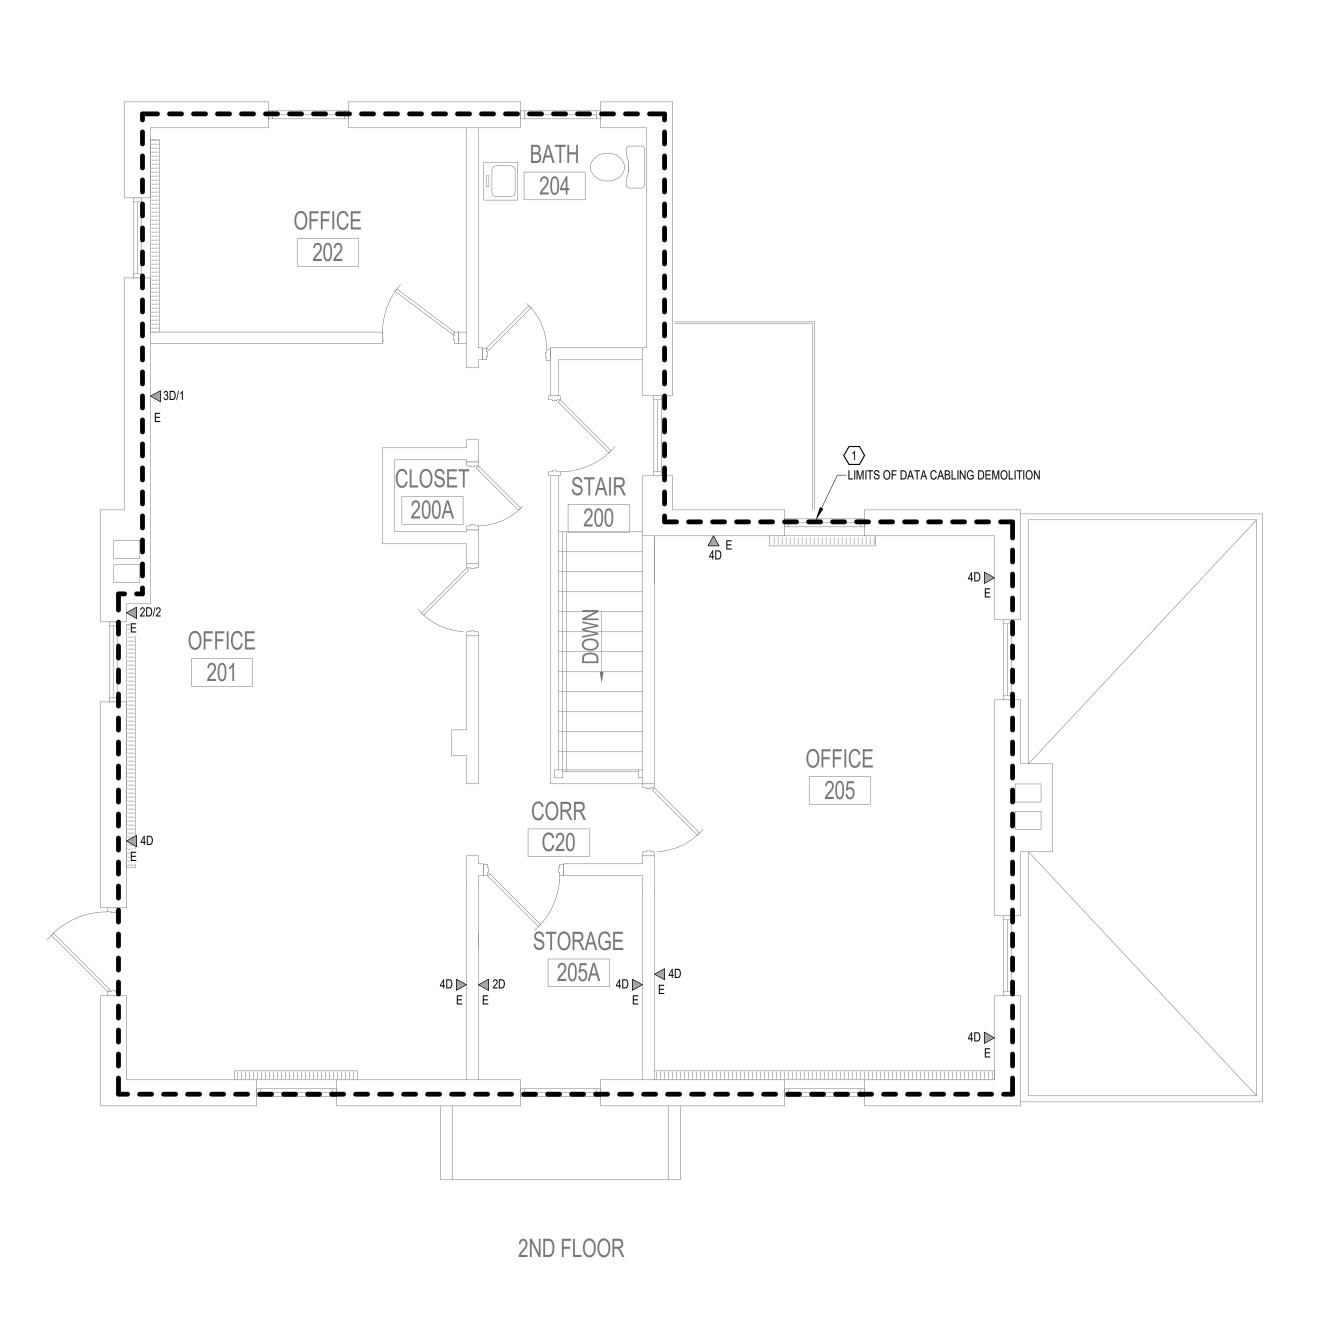


1 2 8

SECOND FLOOR PLAN - TELECOM - DEMOLITION





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EHRM INFRASTRUCTURE

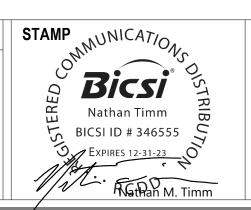
FULLY SPRINKLERED

BUILDING No

LOCATION
VA MEDICAL CENTER
ST.CLOUD, MN 56303

03/30/2022 CHECKED BY DRAWN DRAWING NO. 11-TD120



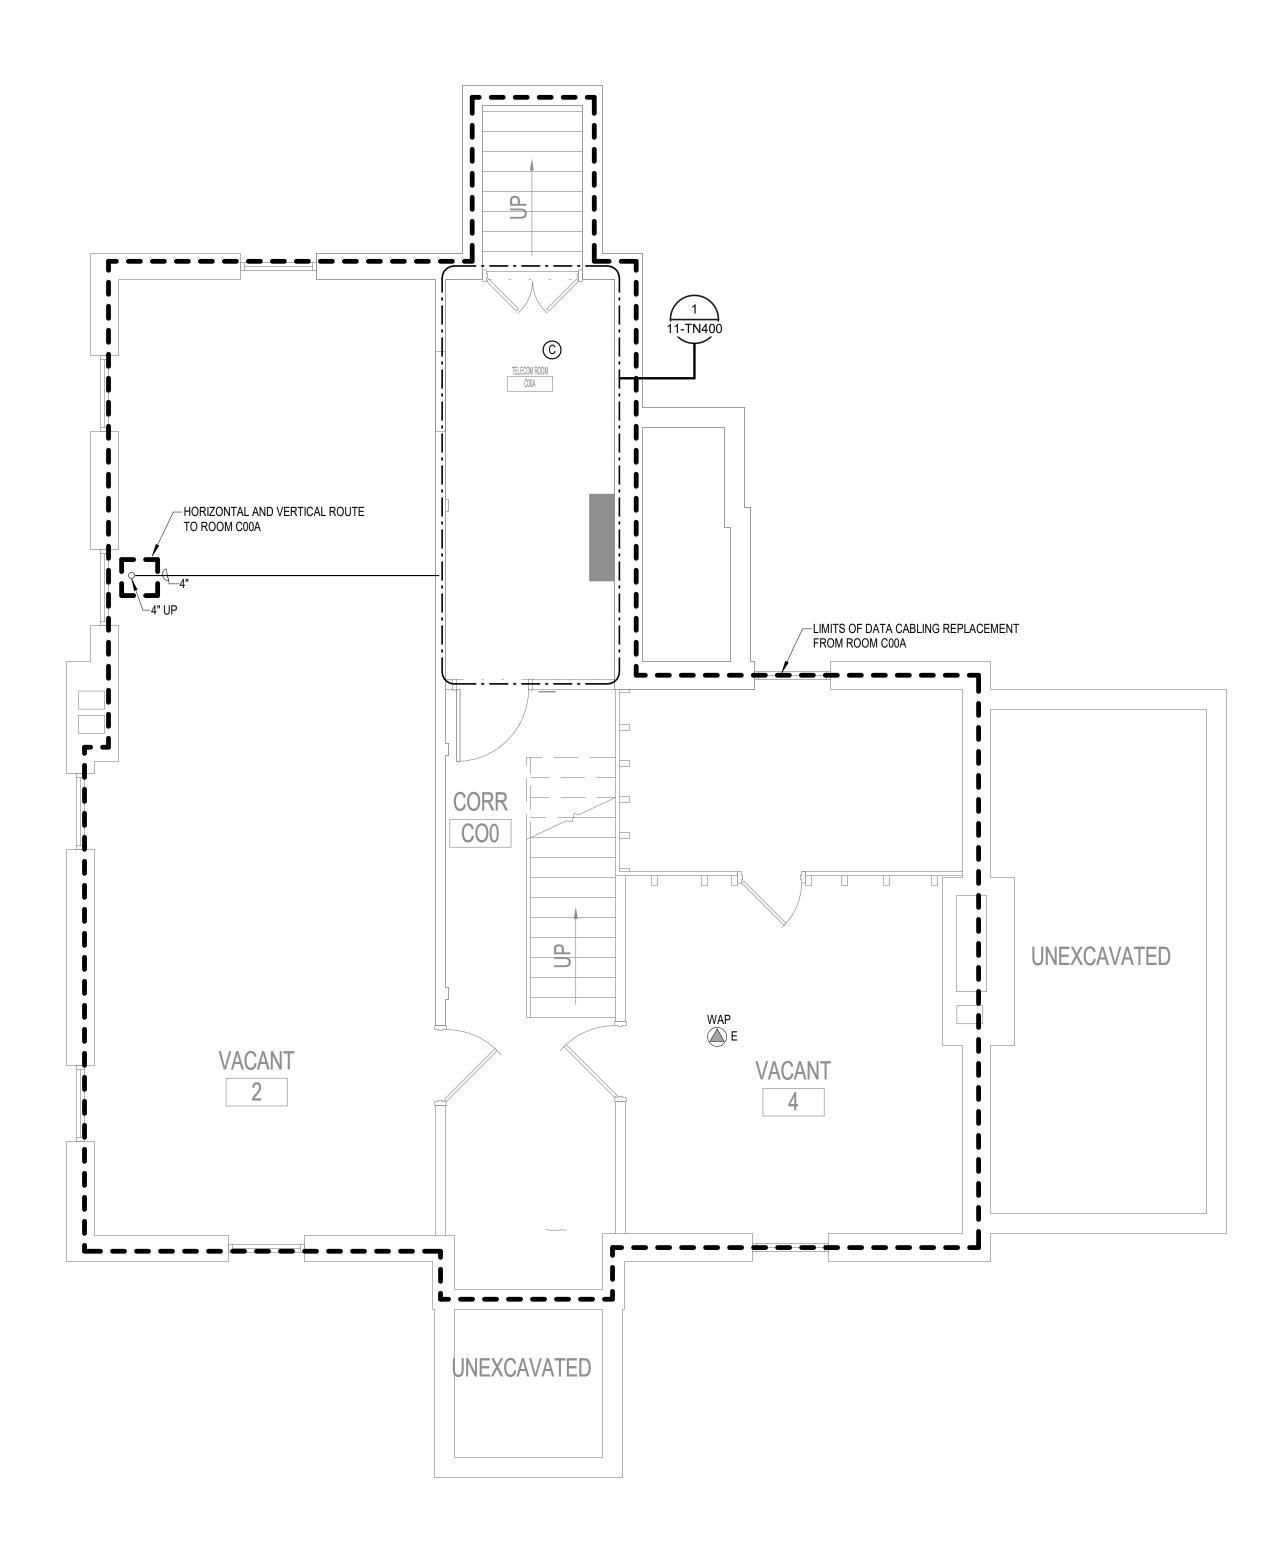

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BASEMENT FLOOR PLAN - TELECOMMUNICATIONS

1/4" = 1'-0"



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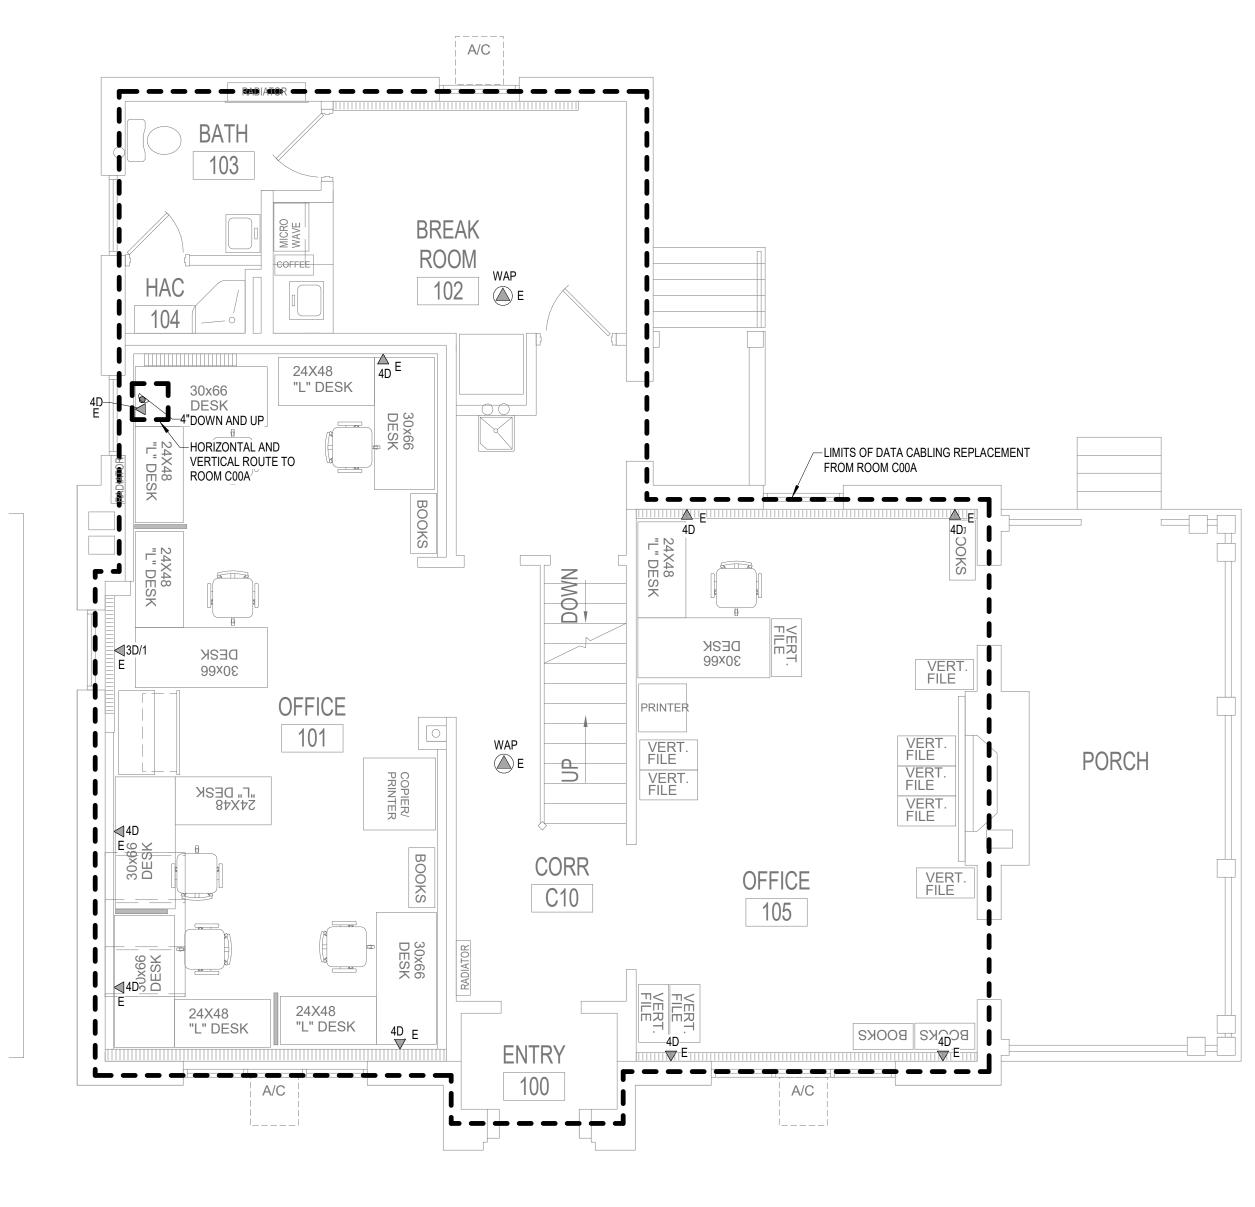


> FULLY SPRINKLERED DWG. OF

LOCATION
VA MEDICAL CENTER
ST.CLOUD, MN 56303

2022 21-235 2100





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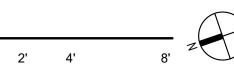
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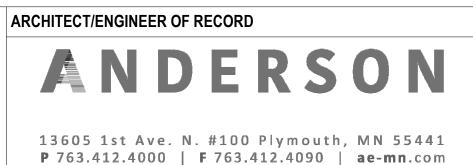
1ST FLOOR

FIRST FLOOR PLAN - TELECOMMUNICATIONS

1/4" = 1'-0"











EHRM INFRASTRUCTURE

FULLY SPRINKLERED

BUILDING No


LOCATION

VA MEDICAL CENTER

ST.CLOUD, MN 56303

03/30/2022 CHECKED BY DRAWN DRAWING NO. 11-TN110



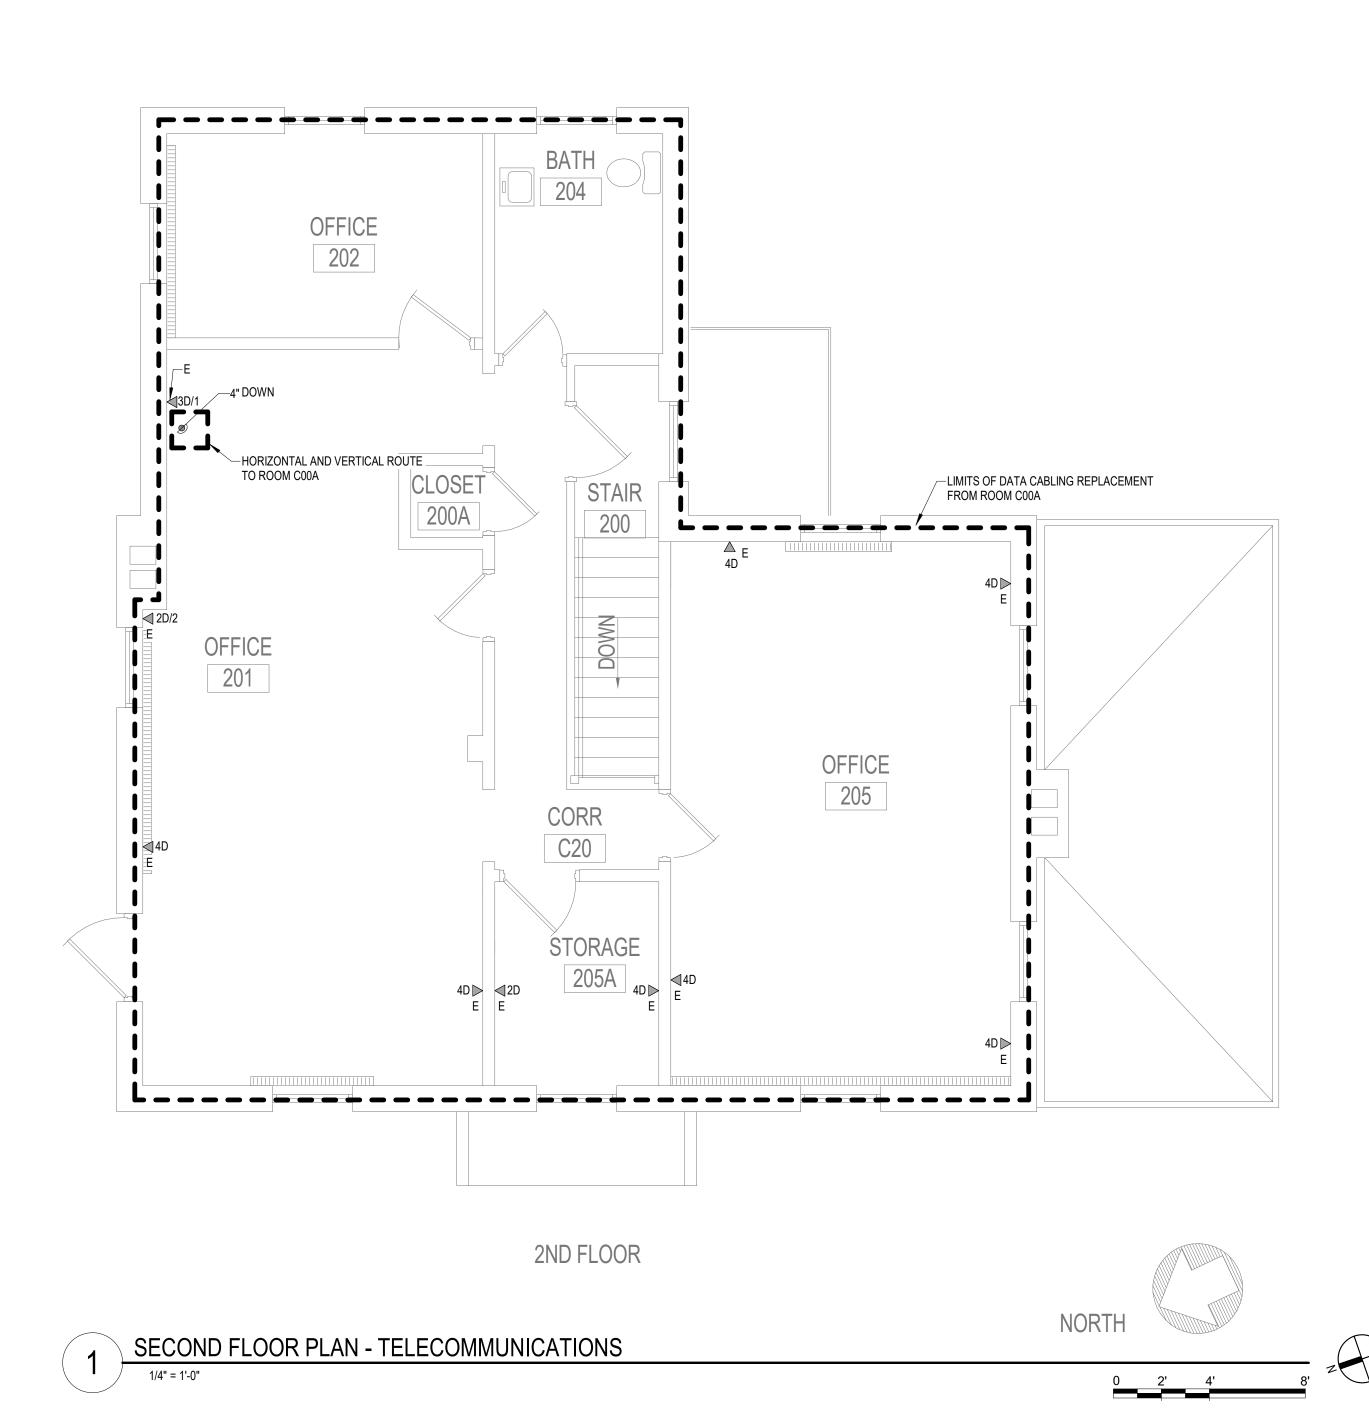

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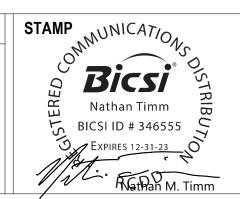
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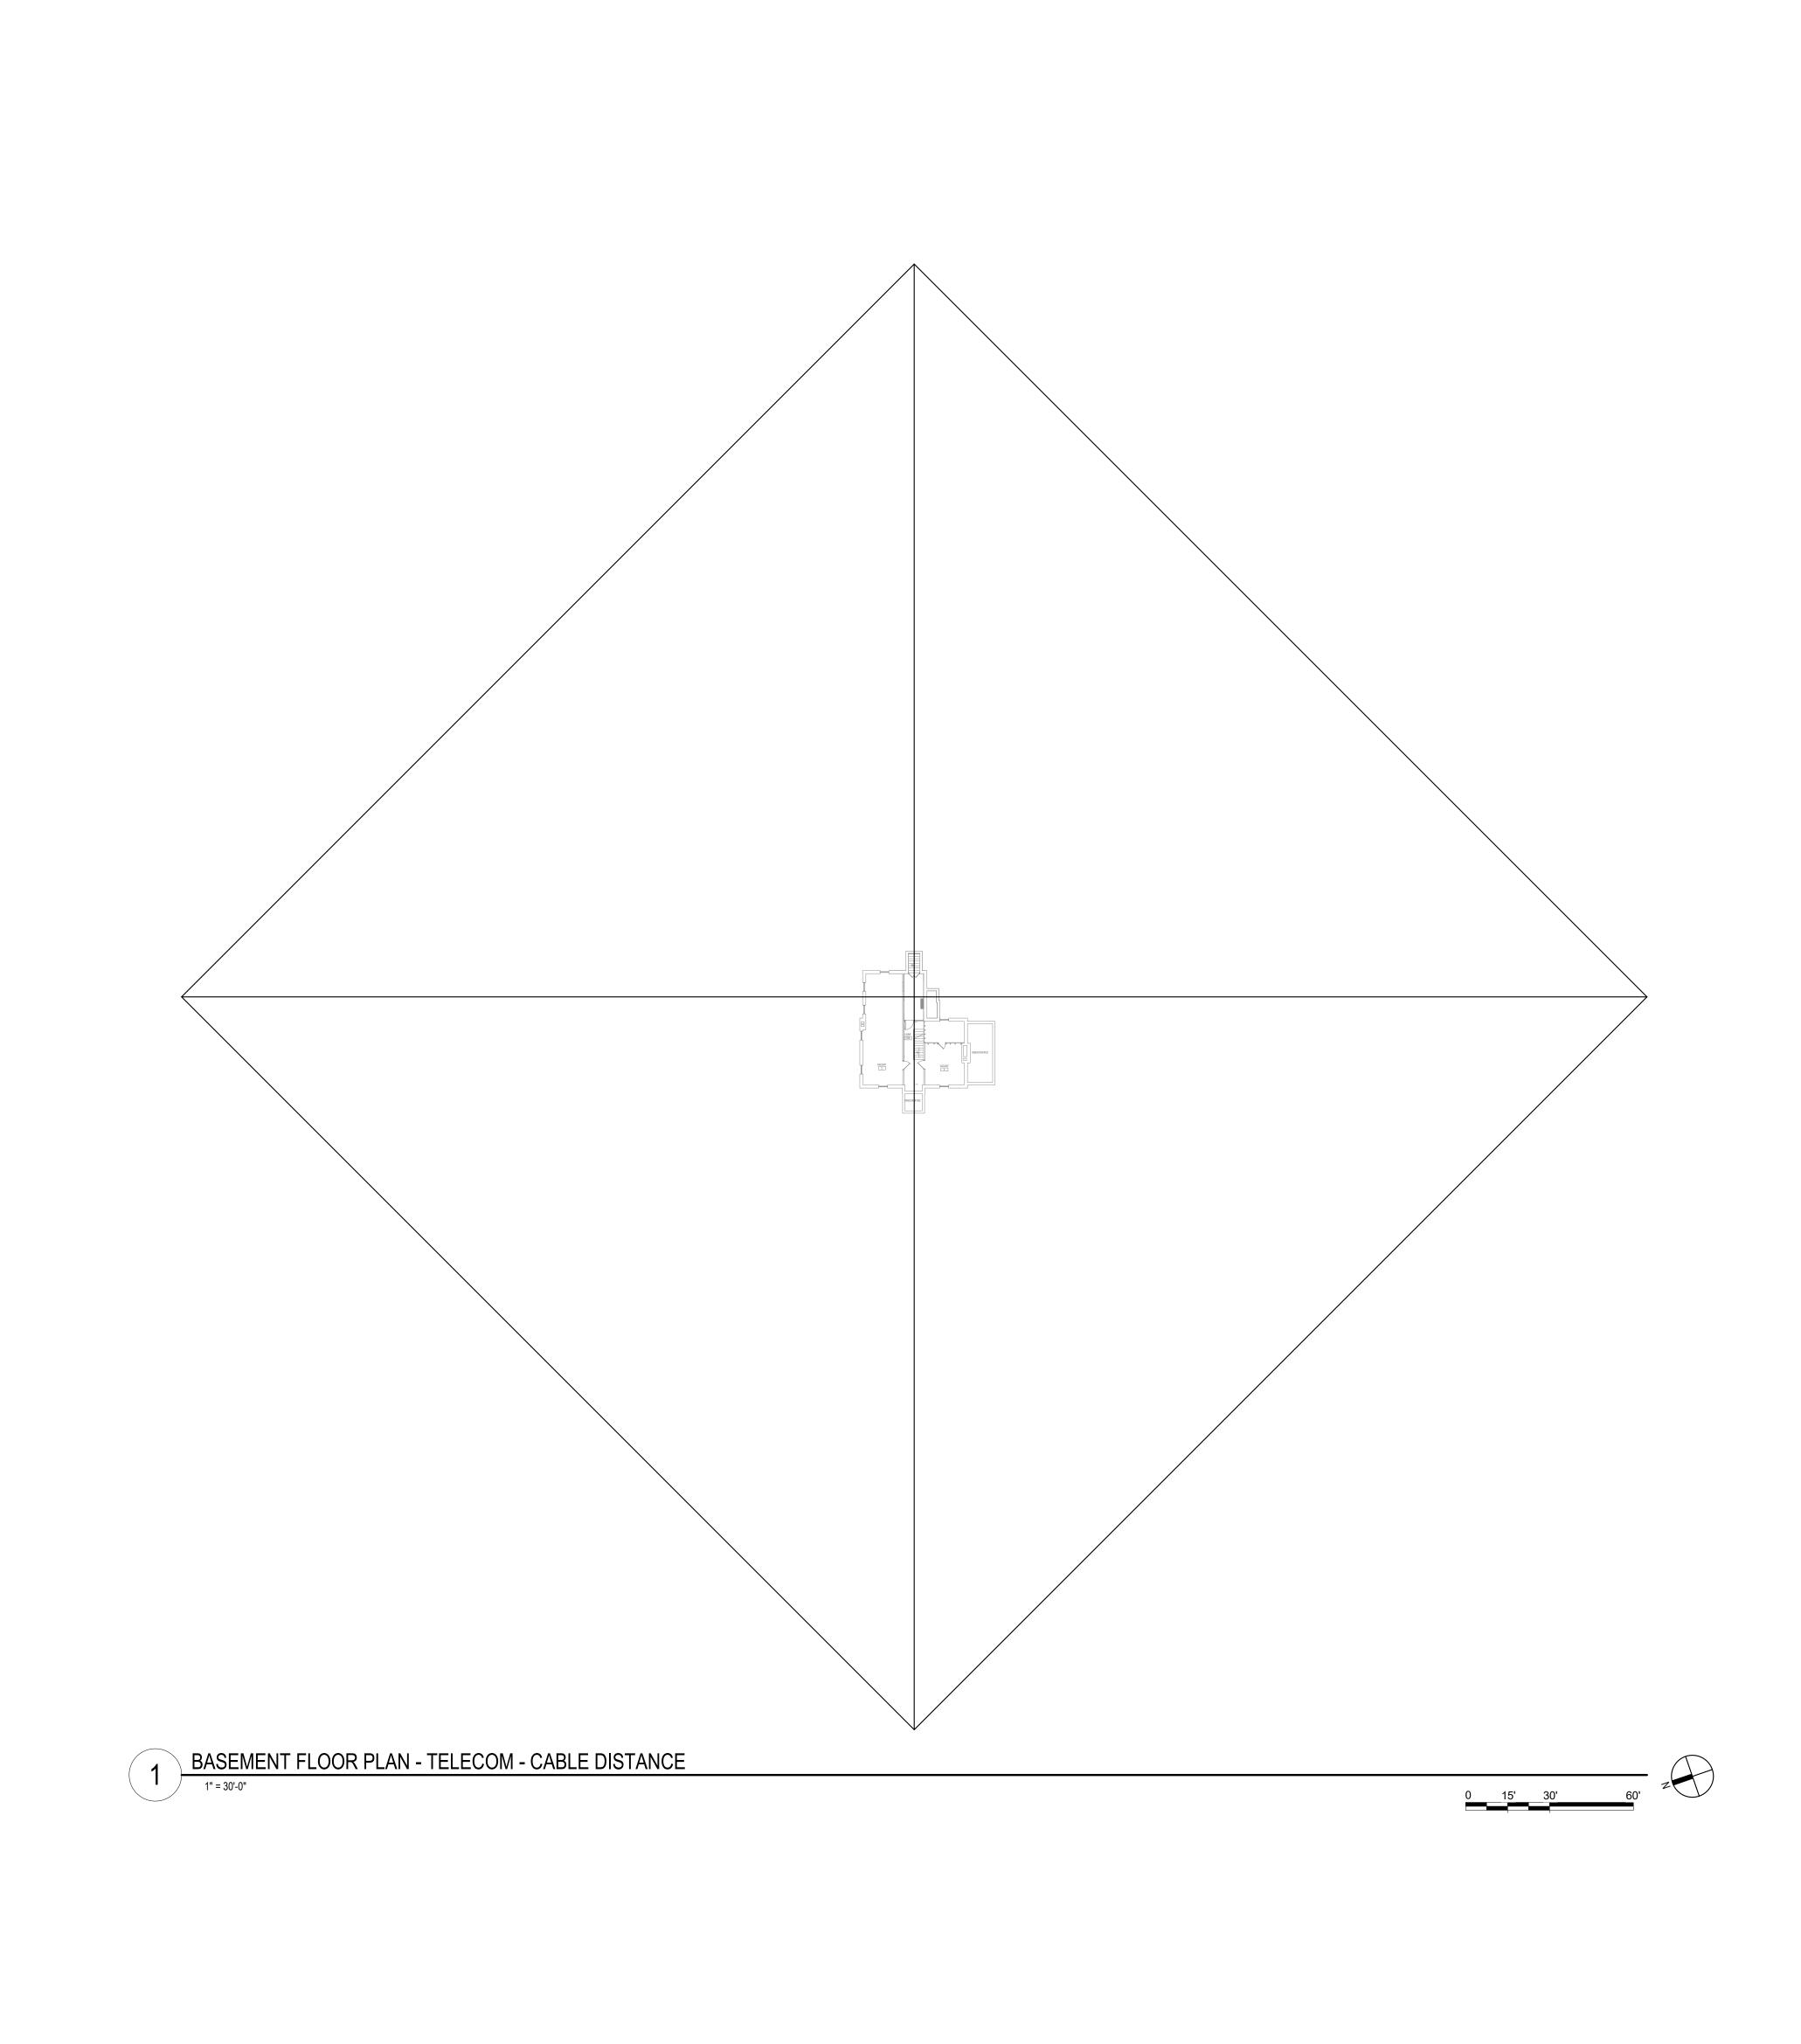
EHRM INFRASTRUCTURE BUILDING No

FULLY SPRINKLERED

LOCATION
VA MEDICAL CENTER
ST.CLOUD, MN 56303

03/30/2022 CHECKED BY DRAWN DRAWING NO. 11-TN120





1 2 9 10

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BASEMENT FLOOR PLAN - TELECOM - CABLE DISTANCE

PROJECT TITLE

EHRM INFRASTRUCTURE


UPGRADES

LOCATION
VA MEDICAL CENTER
ST.CLOUD, MN 56303

| CHECKED BY | CHECKED BY | KSB | SSK | DRAWING NO. | SSK | 11-TN200 | STATE |

FULLY SPRINKLERED DWG. OF



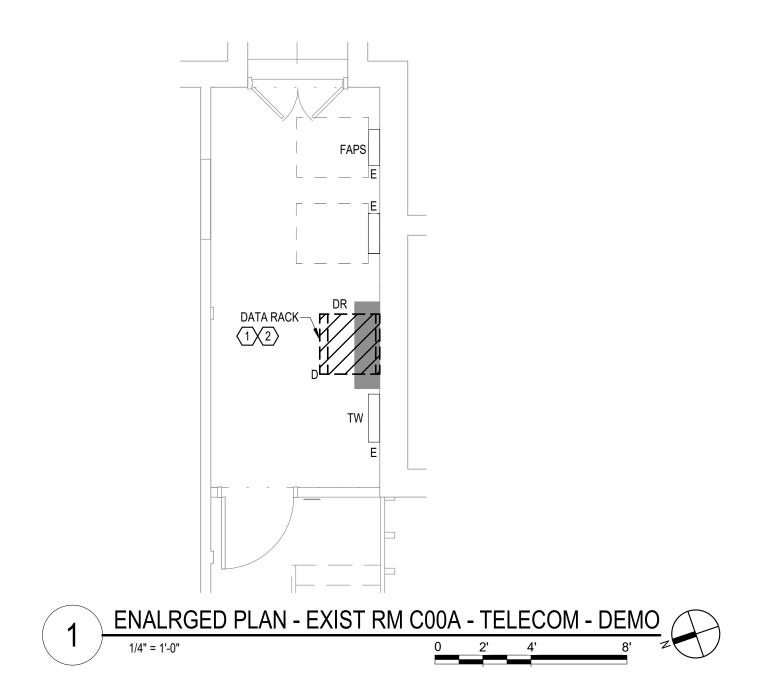

A. REFER TO GENERAL DEMOLITION NOTES ON SHEET T000 FOR ADDITIONAL DEMOLITION SCOPE.

SHEET NOTES:

1. EXISTING TELECOMMUNICATIONS CAGE AND RACK SHALL BE INCLUDED WITHIN THE SCOPE OF DEMOLITION. EXISTING CABLING AND ASSOCIATED OUTLETS SHALL BE REMOVED AND REPLACED 1 FOR 1 AND REFED FROM DISTRIBUTION EQUIPMENT LOCATED WITHIN THE NEW TELECOMMUNICATIONS ROOM. REFER TO GENERAL CABLING NOTES FOR APPROXIMATE QUANTITIES. REFER TO NEW WORK PLANS FOR SERVING COMMUNICATIONS ROOM LOCATION AND NEW CABLING ROUTES. 2. EXISTING DATA CABINET TO BE REPLACED WITH NEW EHRM TE.

**CABLING NOTE:** 

A. THE EXISTING CABLE COUNT ARE THE CABLES CURRENTLY PRESENT IN THE SPACE. THE CABLE RELOCATION COUNT ARE THE NEW OR RELOCATED CABLES TO BE FED FROM THE SPACE. THE FINAL CABLE COUNT ARE THE CABLES THAT WILL BE PRESENT IN THE SPACE AT THE COMPLETION OF THE

1. ROOM COOA EXISTING CABLE COUNT DATA (CAT6): 0 DATA (CAT5e): 57

DATA (CAT5): 0 DATA (CAT3): 0

CABLE RELOCATION COUNT

DATA (CAT6): 0 DATA (CAT5e): 0 DATA (CAT5): 0

DATA (CAT3): 0 EXISTING CABLE TO REMAIN

DATA (CAT6): 0 DATA (CAT5e): 0 DATA (CAT5): 0

DATA (CAT3): 0 FINAL CABLE COUNT

DATA (CAT6): 0 DATA (CAT5e): 0

DATA (CAT5): 0 DATA (CAT3): 0

ENLARGED PLANS -TELECOMMUNICATIONS -DEMO

PROJECT TITLE

EHRM INFRASTRUCTURE

BUILDING No

LOCATION

VA MEDICAL CENTER
ST.CLOUD, MN 56303

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03/30/2022 CHECKED BY DRAWN DRAWING NO. 11-TN300



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Omaha, NE 68134


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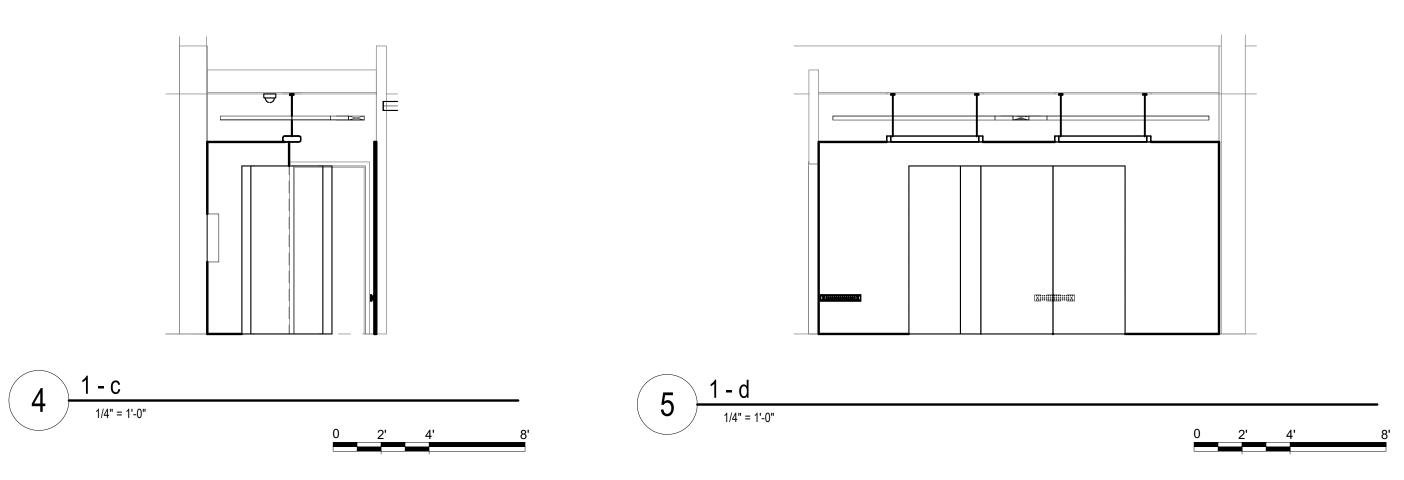
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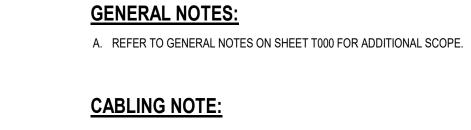


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CABLING NOTES: A. THE EXISTING CABLE COUNT ARE THE CABLES CURRENTLY PRESENT IN THE SPACE. THE CABLE RELOCATION COUNT ARE THE NEW OR RELOCATED CABLES TO BE FED FROM THE SPACE. THE FINAL CABLE COUNT ARE THE CABLES THAT WILL BE PRESENT IN THE SPACE AT THE COMPLETION OF THE PROJECT.

1. ROOM COOA EXISTING CABLE COUNT DATA (CAT6): 0 DATA (CAT5e): 57


DATA (CAT5): 0

DATA (CAT3): 0 CABLE RELOCATION COUNT DATA (CAT6): 0 DATA (CAT5e): 0 DATA (CAT5): 0

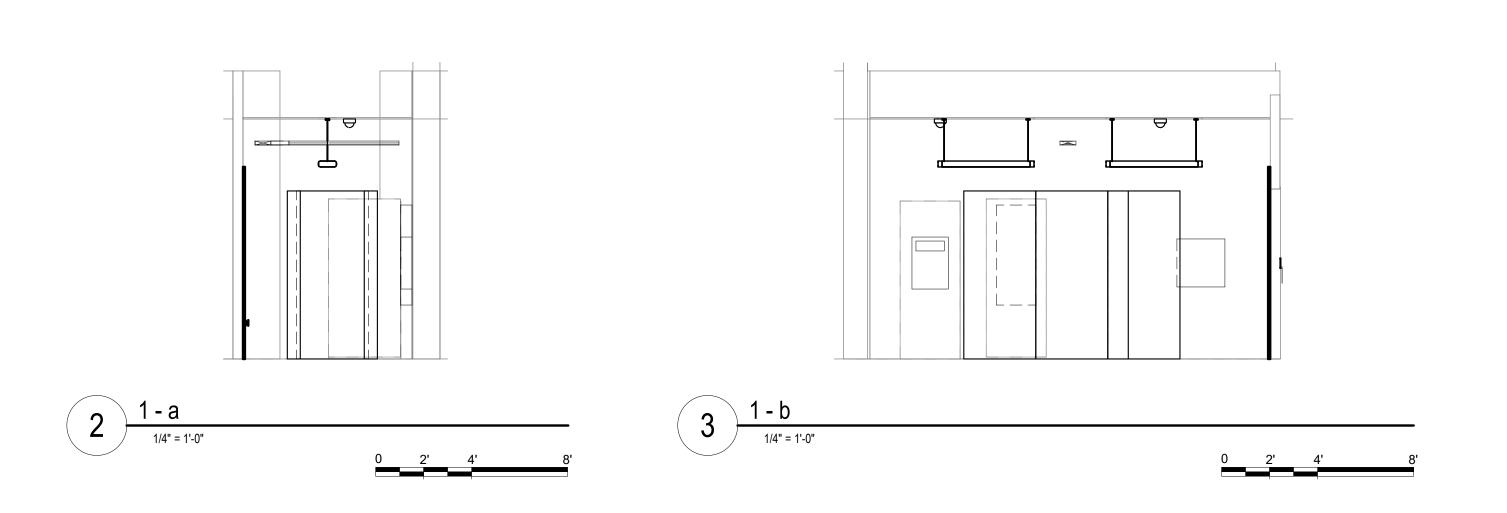DATA (CAT3): 0 EXISTING CABLE TO REMAIN DATA (CAT6): 0

DATA (CAT5e): 0 DATA (CAT5): 0 DATA (CAT3): 0

FINAL CABLE COUNT DATA (CAT6A): 57 DATA (CAT6): 0

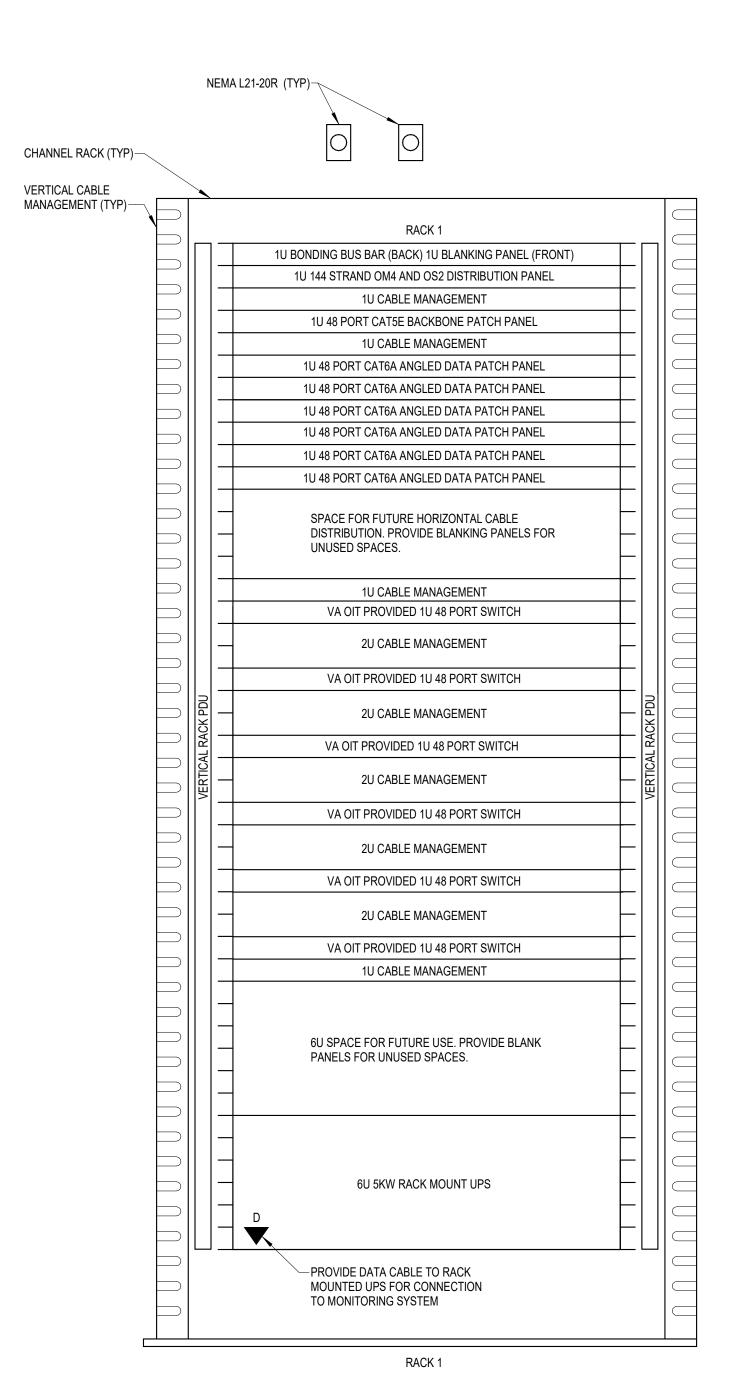


NOTES:

1. REFER TO NEW WORK PLAN FOR RACK LOCATIONS. 2. COORDINATE EXACT RACK COUNT AND LOCATION WITH OWNER PRIOR TO PERMANENT INSTALLATION.

- 3. SEE PROJECT SPECIFICATIONS FOR ADDITIONAL RACK COMPONENTS. 4. RACK ELEVATION SHOWS A FULLY CONFIGURED SAMPLE RACK. CONTRACTOR TO PROVIDE REQUIRED EQUIPMENT TO SUPPORT THE FINAL DATA COUNT FROM THE ENLARGED NEW SHEET. (NOT TO EXCEED 288 PORTS PER RACK).
- 5. COORDINATE FINAL RACK COMPONENT LAYOUT WITH OWNER'S IS/IT REPRESENTATIVE.
- 6. CONTRACTOR IS RESPONSIBLE FOR FINAL CABLE COUNT, QUANTITY OF PATCH PANELS, SWITCHES, FIBER ENCLOSURES, BLANKING PANELS, CABLE MANAGEMENT, AND MOUNTING HARDWARE NOT MARKED AS "OIT PROVIDED". 7. PUNCHDOWN COPPER BACKBONES ON RACK MOUNT PATCH PANELS. TERMINATE ONE (1) PAIR PER PATCH PANEL PORT.

COMMUNICATIONS - TYPICAL ONE RACK ELEVATION WITH RACK MOUNT UPS - TR C00A

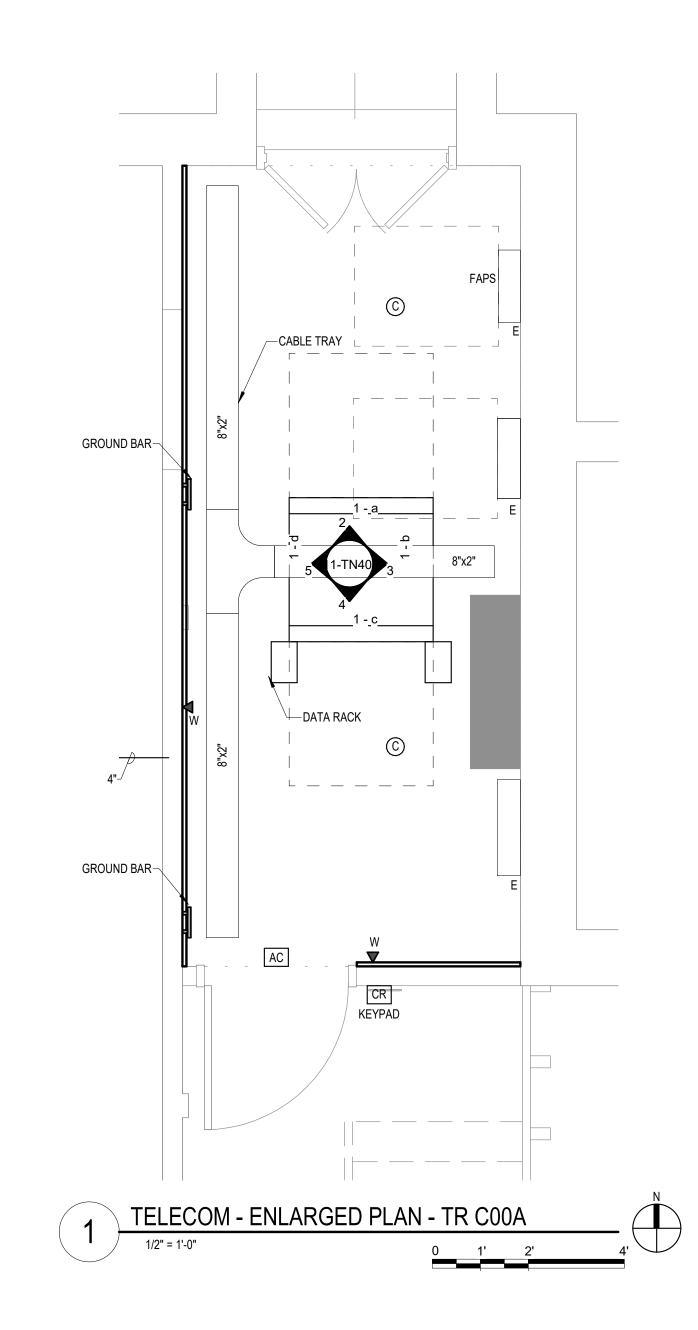



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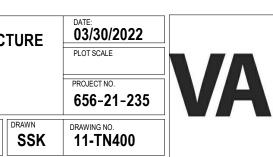


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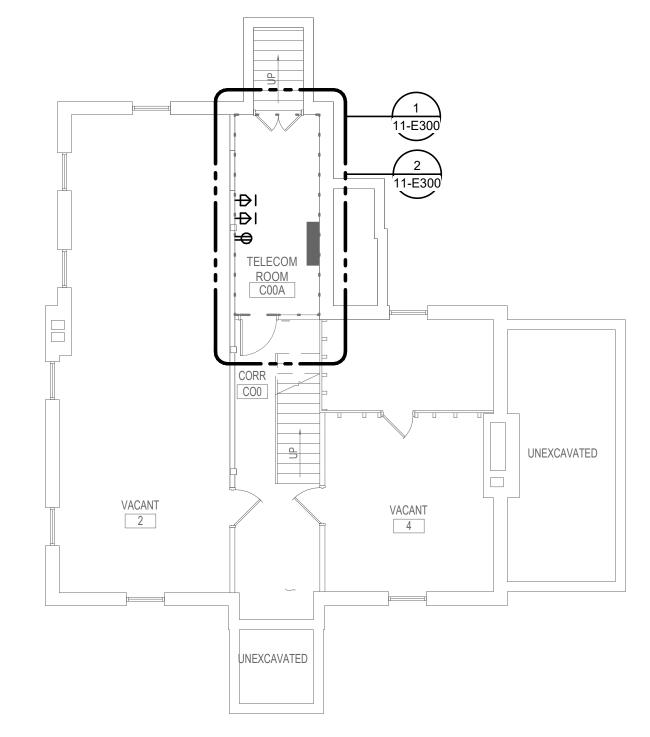
FULLY SPRINKLERED

BUILDING No

VA MEDICAL CENTER ST.CLOUD, MN 56303







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1 BASEMENT - ELECTRICAL

1/8" = 1'-0"

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No REVISION

DATE

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BASEMENT - ELECTRICAL

EHRM INFRASTRUCTURE
UPGRADES

PROJECT TITLE

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PROJECT TITLE

PROJECT TITLE

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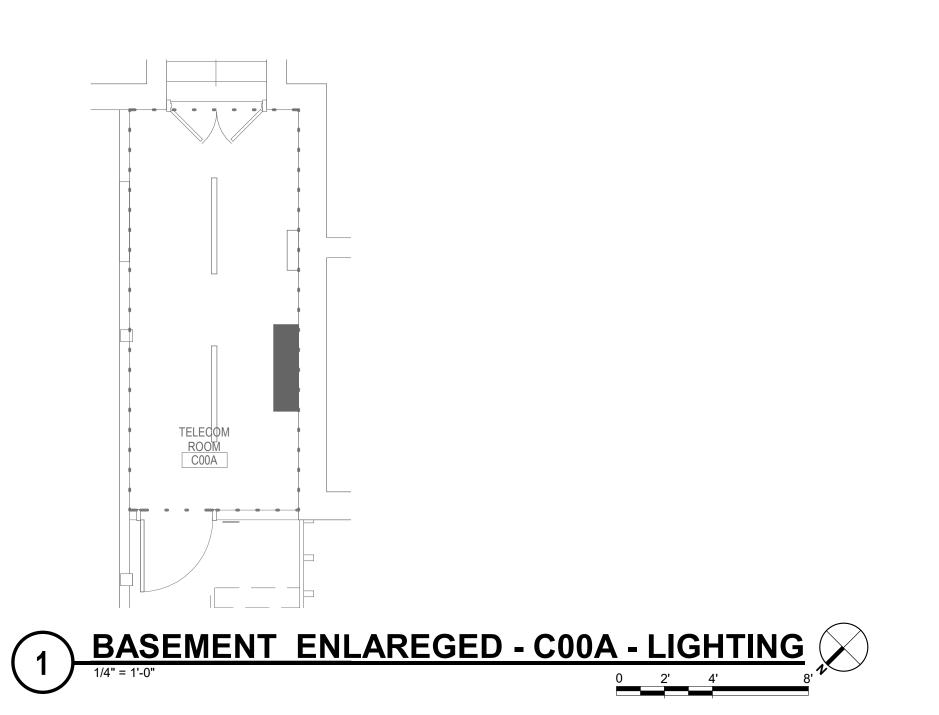
LOCATION
VA MEDICAL CENTER
ST.CLOUD, MN 56303


TBD DRAWN

FULLY SPRINKLERED DWG. OF

30/2022 SALE T NO. -21-235





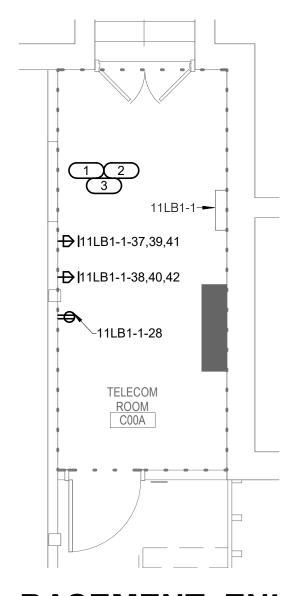

BASEMENT ENLAREGED - C00A - POWER & SYSTEM

1/4" = 1'-0"

8

1 2 8

SHEET NOTES:

 REFER TO TECHNOLOGY PLANS FOR IT ROOM LAYOUT AND RACK LAYOUT/DETAILS.
 REFER TO SHEET 0-GE400 DETAIL LAYOUT & ONE-LINE OF RACK.

KEYNOTES: #

COORDINATE FINAL LOCATION OF RECEPTACLE L21-20R WITH TELECOM CONTRACTOR. PROVIDE 3/4"C-4#12, 1#12 GND TO PANEL FOR EACH RECEPTACLE.
PROVIDE EATON BLADEUPS, 5KW, 120/208V, 3-PHASE,4-WIRE RACK MOUNTED UPS FOR EACH RACK TOWER.
PROVIDE APC#AP8861 RPDU RACK PDU 2G WITH L21-20P CORD. (120/208V, 3-PHASE, 20A, ZERO U, 5.7 KW, 208V, (36) C13 (6) C19 (2) 5-20R

OUTLETS. PROVIDE TWO PER RACK, MOUNTED PER MANUFACTURER'S REQUIREMENTS.

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0 REVISION
DATE

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ELECTRICAL ENLARGED PLANS

EHRM INFRASTRUCTURE UPGRADES

LOCATION

VA MEDICAL CENTER

ST.CLOUD, MN 56303

TBD DRAWN

FULLY SPRINKLERED

03/30/2022

LOT SCALE

ROJECT NO.
656-21-235



U.S. Department
of Veterans Affairs
Veterans Health
Administration
St. Cloud VA
Health Care System

**EXISTING PANEL 11LB1-1** MOUNTING: SURFACE MAIN: 100 A MCB **ENCLOSURE**: NEMA PB 1 **SOLID NEUTRAL** VOLTS: 120/208 Wye FED FROM: 0 A/0P @ **GROUND BUS** PHASE: 3 LOCATION: TELECOM ROOM C00A WIRE: 4 SCCR: 65 kA WIRE
OCPD SIZE A B C SIZE OCPD
AMPS P H N G G N H P AMPS LOAD DESCRIPTION CKT E NO. Y E CKT Y NO. AMPS P H N G -- 1 SPACE -- 3 EXISTING LOAD 2 --6 --8 --10 ---- 5 EXISTING LOAD
-- 7 EXISTING LOAD -- 9 EXISTING LOAD -- 11 EXISTING LOAD -- 13 EXISTING LOAD -- 15 EXISTING LOAD -- 17 EXISTING LOAD -- 19 EXISTING LOAD -- 21 EXISTING LOAD -- 23 EXISTING LOAD -- 25 EXISTING LOAD -- 27 EXISTING LOAD -- 29 EXISTING LOAD -- 31 EXISTING LOAD -- 33 SPARE -- 35 SPARE 37 L21-20R 40 --**Total Load:** 3.33 kVA 3.69 kVA 3.33 kVA **Total Amps:** 27.78 30.78 27.78 LOAD SUMMARY LOAD CLASSIFICATION CONNECTED LOAD | DEMAND FACTOR | ESTIMATED DEMAND TOTALS\* 10 kVA 100.00% 0.36 kVA 100.00% 0.36 kVA TOTAL CONNECTED LOAD: TOTAL ESTIMATED DEMAND LOAD: 10.36 kVA

\*TOTAL DEMAND CALCS SUBTRACT ANY REDUNDANT LOAD AND THE SMALLER OF ANY NONCOINCIDENT HVAC LOADS. THIS CALC IS DONE AT EACH PANEL.

CIRCUIT KEY NOTES: REARRANGE THIS CIRCUIT BREAKERS IN PANEL TO ALLOW FOR 3 CONSECUTIVE SPACES.

CONSULTANT 100% CD DATE


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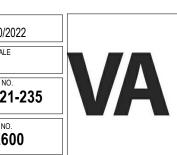
5 9

ELECTRICAL SCHEDULES

EHRM INFRASTRUCTURE TBD GJL

VA MEDICAL CENTER ST.CLOUD, MN 56303

FULLY SPRINKLERED

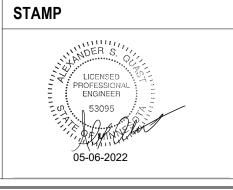

TOTAL CONNECTED AMPS: 28.76 A TOTAL ESTIMATED DEMAND AMPS: 28.8 A



# FIELD VERIFICATION NOTES


- 1. THE HVAC CONTRACTOR SHALL VISIT THE SITE **PRIOR TO BID** TO FIELD VERIFY ALL EXISTING CONDITIONS WHICH MAY AFFECT THEIR BID. THE FOLLOWING ITEMS SHALL BE VERIFIED:
- A. EXACT PLACEMENT, SIZE, CAPACITY, MANUFACTURER, AND CONDITION OF ALL EXISTING HVAC EQUIPMENT WITHIN SCOPE OF WORK, WHETHER EXPLICITLY SHOWN OR NOT.
- B. SIZE AND LOCATION OF ALL EXISTING DUCTWORK.
- C. SIZE AND LOCATION OF ALL EXISTING GRILLES, REGISTERS AND DIFFUSERS.
- D. SIZE AND LOCATION OF ALL EXISTING THERMOSTATIC CONTROL DEVICES.
- E. SIZE AND LOCATION OF ALL EXISTING PLUMBING AND HYDRONIC PIPING
- 2. ALL REFERENCES ON THESE DRAWINGS TO EXISTING EQUIPMENT, DUCTWORK, DIFFUSERS, THERMOSTATS AND PIPING ARE FOR REFERENCE ONLY. IT IS THE RESPONSIBILITY OF THE CONTRACTOR TO VERIFY ALL THESE ITEMS PRIOR TO BID AND INCLUDE IN THEIR BID ANY AND ALL AMOUNTS REQUIRED TO ACCOMMODATE EXISTING CONDITIONS.
- 3. NO ALLOWANCES WILL BE MADE AFTER THE PROJECT HAS BEEN AWARDED FOR FAILURE TO VERIFY EXISTING CONDITIONS.
- 4. ANY DISCREPANCIES WHICH MAY AFFECT THE CONTRACTORS BID SHALL BE BROUGHT TO THE ATTENTION OF THE ENGINEER AND ARCHITECT FOR DIRECTION.

#### KEYNOTES 1/11-M100: #


- REMOVE EXISTING 2" HEATING WATER SUPPLY AND RETURN PIPING WHERE SHOWN FOR REROUTING. PREPARE PIPE ENDS FOR NEW CONNECTION FIELD
- VERIFY REQUIREMENTS.

  2. REMOVE EXISTING FIRE SPRINKLER HEADS AND BRANCH LINE BACK AS SHOWN
- 3. EXISTING 4" SANITARY DRAIN TO REMAIN.

FOR REROUTING. FIELD VERIFY REQUIREMENTS.

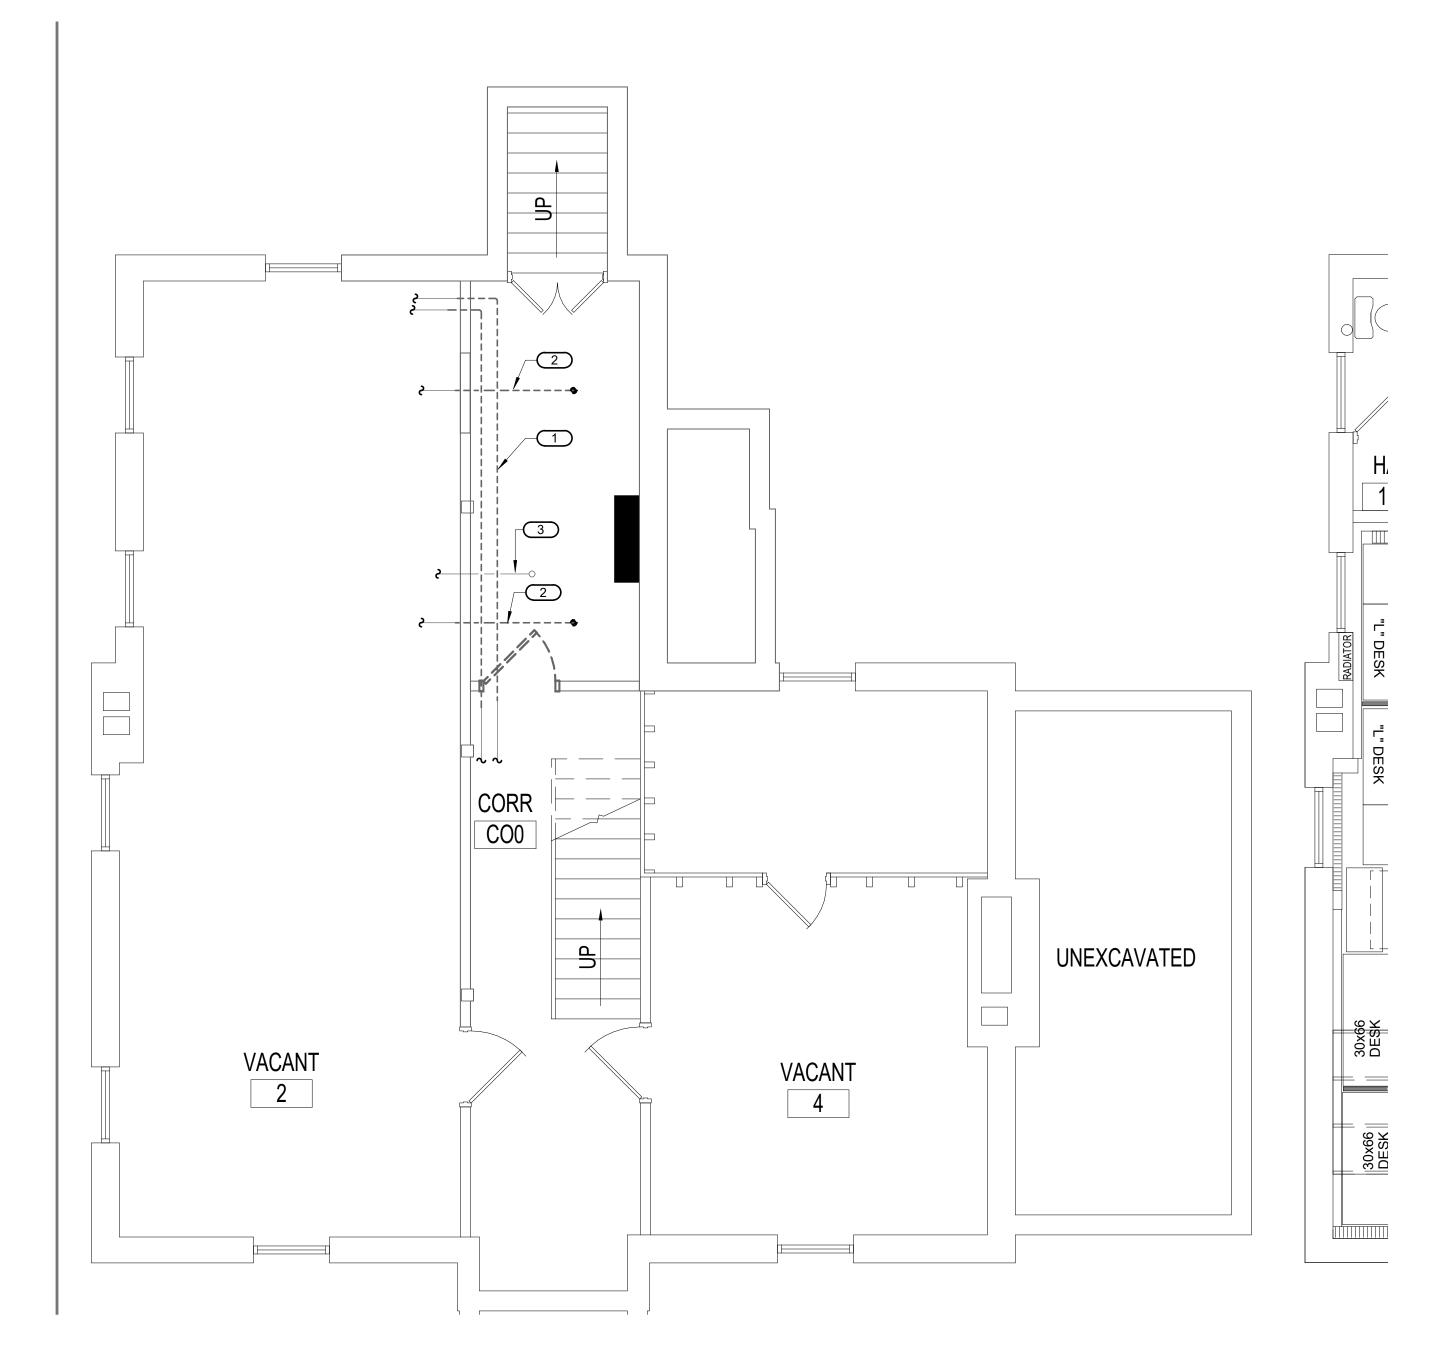

5 9

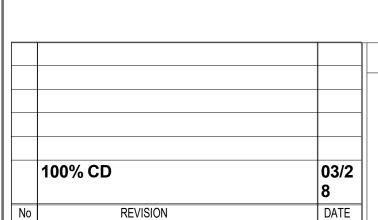







BASEMENT DEMOLITION - MECHANICAL



VA MEDICAL CENTER ST.CLOUD, MN 56303 FULLY SPRINKLERED





- 1. THE HVAC CONTRACTOR SHALL VISIT THE SITE PRIOR TO BID TO FIELD VERIFY ALL EXISTING CONDITIONS WHICH MAY AFFECT THEIR
  - A. EXACT PLACEMENT, SIZE, CAPACITY, MANUFACTURER, AND CONDITION OF ALL EXISTING HVAC EQUIPMENT WITHIN SCOPE OF WORK, WHETHER EXPLICITLY SHOWN OR NOT.
  - B. SIZE AND LOCATION OF ALL EXISTING DUCTWORK.

BID. THE FOLLOWING ITEMS SHALL BE VERIFIED:


- C. SIZE AND LOCATION OF ALL EXISTING GRILLES, REGISTERS AND DIFFUSERS.
- D. SIZE AND LOCATION OF ALL EXISTING THERMOSTATIC CONTROL DEVICES.

E. SIZE AND LOCATION OF ALL EXISTING PLUMBING AND HYDRONIC PIPING

- ALL REFERENCES ON THESE DRAWINGS TO EXISTING EQUIPMENT, DUCTWORK, DIFFUSERS, THERMOSTATS AND PIPING ARE FOR
  REFERENCE ONLY. IT IS THE RESPONSIBILITY OF THE CONTRACTOR TO VERIFY ALL THESE ITEMS PRIOR TO BID AND INCLUDE IN THEIR
  BID ANY AND ALL AMOUNTS REQUIRED TO ACCOMMODATE EXISTING CONDITIONS.
- 3. NO ALLOWANCES WILL BE MADE AFTER THE PROJECT HAS BEEN AWARDED FOR FAILURE TO VERIFY EXISTING CONDITIONS.
- 4. ANY DISCREPANCIES WHICH MAY AFFECT THE CONTRACTORS BID SHALL BE BROUGHT TO THE ATTENTION OF THE ENGINEER AND ARCHITECT FOR DIRECTION.

#### KEYNOTES 1/11-M200: #

- 1. PROVIDE NEW WALL-MOUNTED DUCTLESS COOLING UNIT.
- 2. PROVIDE NEW THERMOSTAT.
- 3. PROVIDE CONDENSATE PUMP.
- ROUTE 1" PUMPED CONDENSATE PIPE NORTH TO EXTERIOR WALL THEN RISE INTO HAC 104 AND DISCHARGE TO MOP SINK, APPROXIMATELY 120 FEET. COORDINATE FINAL ROUTING IN FIELD.
- 5. ROUTE REFRIGERANT PIPING TO NEW AIR-COOLED CONDENSING UNIT ON GRADE. PROVIDE CONCRETE PAD.
- 6. REROUTE 2" HEATING WATER SUPPLY AND RETURN PIPING AND RECONNECT AS SHOWN
- 7. REROUTE EXISTING FIRE SPRINKLER BRANCH LINE AND PROVIDE NEW SPRINKLER HEAD.
- 8. PROVIDE NEW AIR COOLED CONDENSING UNIT CU-11-1 ON GRADE ABOVE. REFER TO REFRIGERANT PIPING DETAIL 1/0-GM400 AND PAD MOUNTING DETAIL 3/0-GM401
- 9. EXISTING 4" SANITARY DRAIN. PROVIDE DRIP PAN. SEE DETAIL 6/0-GM400 FOR REQUIREMENTS. DRIP PAN TO DISCHARGE TO NEAREST FLOOR DRAIN OR AREA
- 10. REFERE TO 4/0-GM401 FOR WALL PENETRATION SEALING DETAIL.
- 11. PROVIDE NEW CONDENSATE DRIP PAN FOR ALL CONDENSATE PIPING. SEE DETAIL 6/0-GM400 FOR REQUIREMENTS

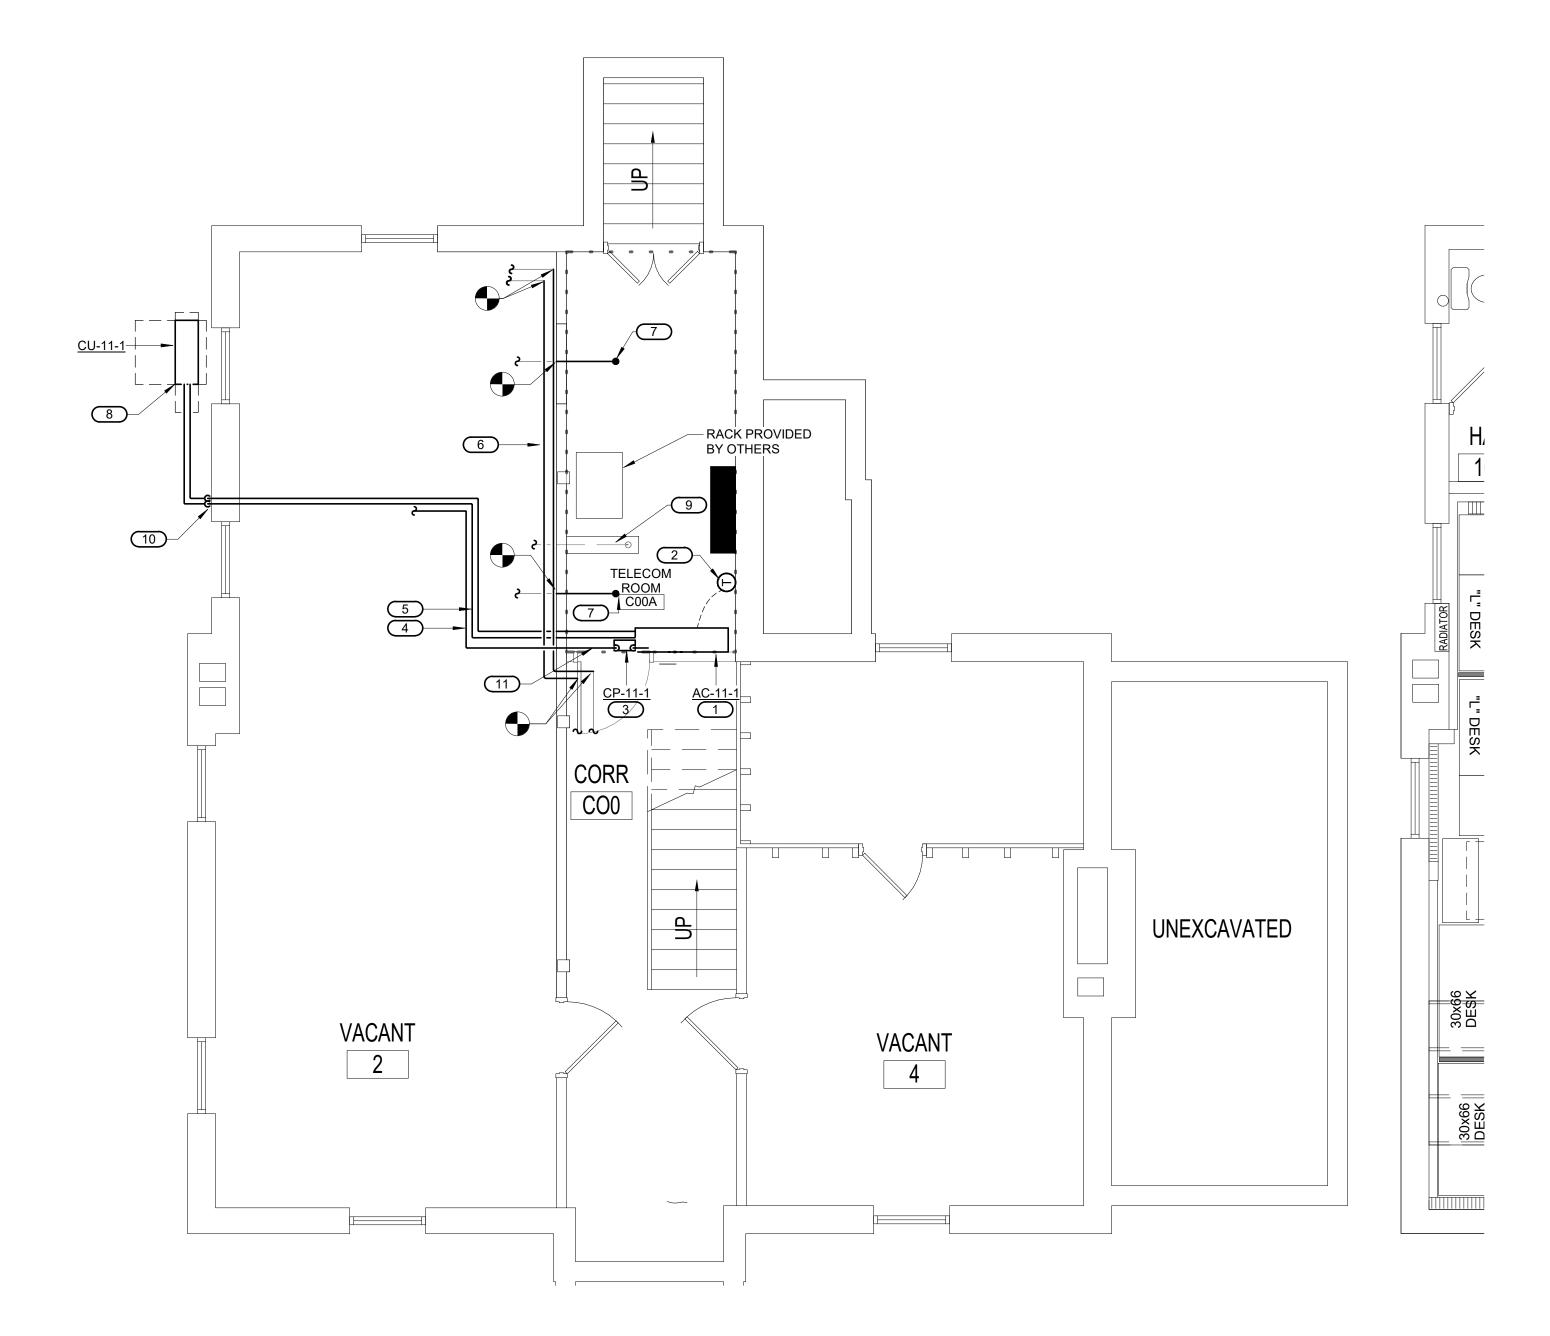


1 BASEMENT FLOOR - MECHANICAL







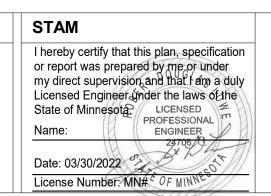



EHRM
INFRASTRUCTURE
UPGRADES

DATE: 03/30/2022
PLOT SCALE
PROJECT NO. 656-21-235

N DRAWING NO. 11-M200

