
1 BL	JILDING 9 - EHRM INFRASTRU
А	St. Cloud VA Health Care S Main Campus, St. Cloud, Mir
BUDGEN VA COR C CONTACT: MARY PROMARK ADDRESS: ST CO LOUX WANDROU CONTART Ref 19 ELEMAN BORNE BT COULDN WANDROU PROCEED BUDGEN PROCESS: ST CO LOUX WANDROU CONTART REF 1000: ST 2020 TO PROCESS: ST CO LOUX WANDROU CONTART REF 1000: ST 2020 TO PROCESS: ST CO LOUX WANDROU CONTART REF 1000: ST 2020 TO PROCESS: ST 2	
CONSULTANT	ARCHITECT/ENGINEER OF RECORD APPROVED RALLET OR APPROVED VECTOR CONTROL NURSE APPROVED VECTOR CONTROL NURSE APPROVED VECT

UCTURE UPGRADES

System Ainnesota

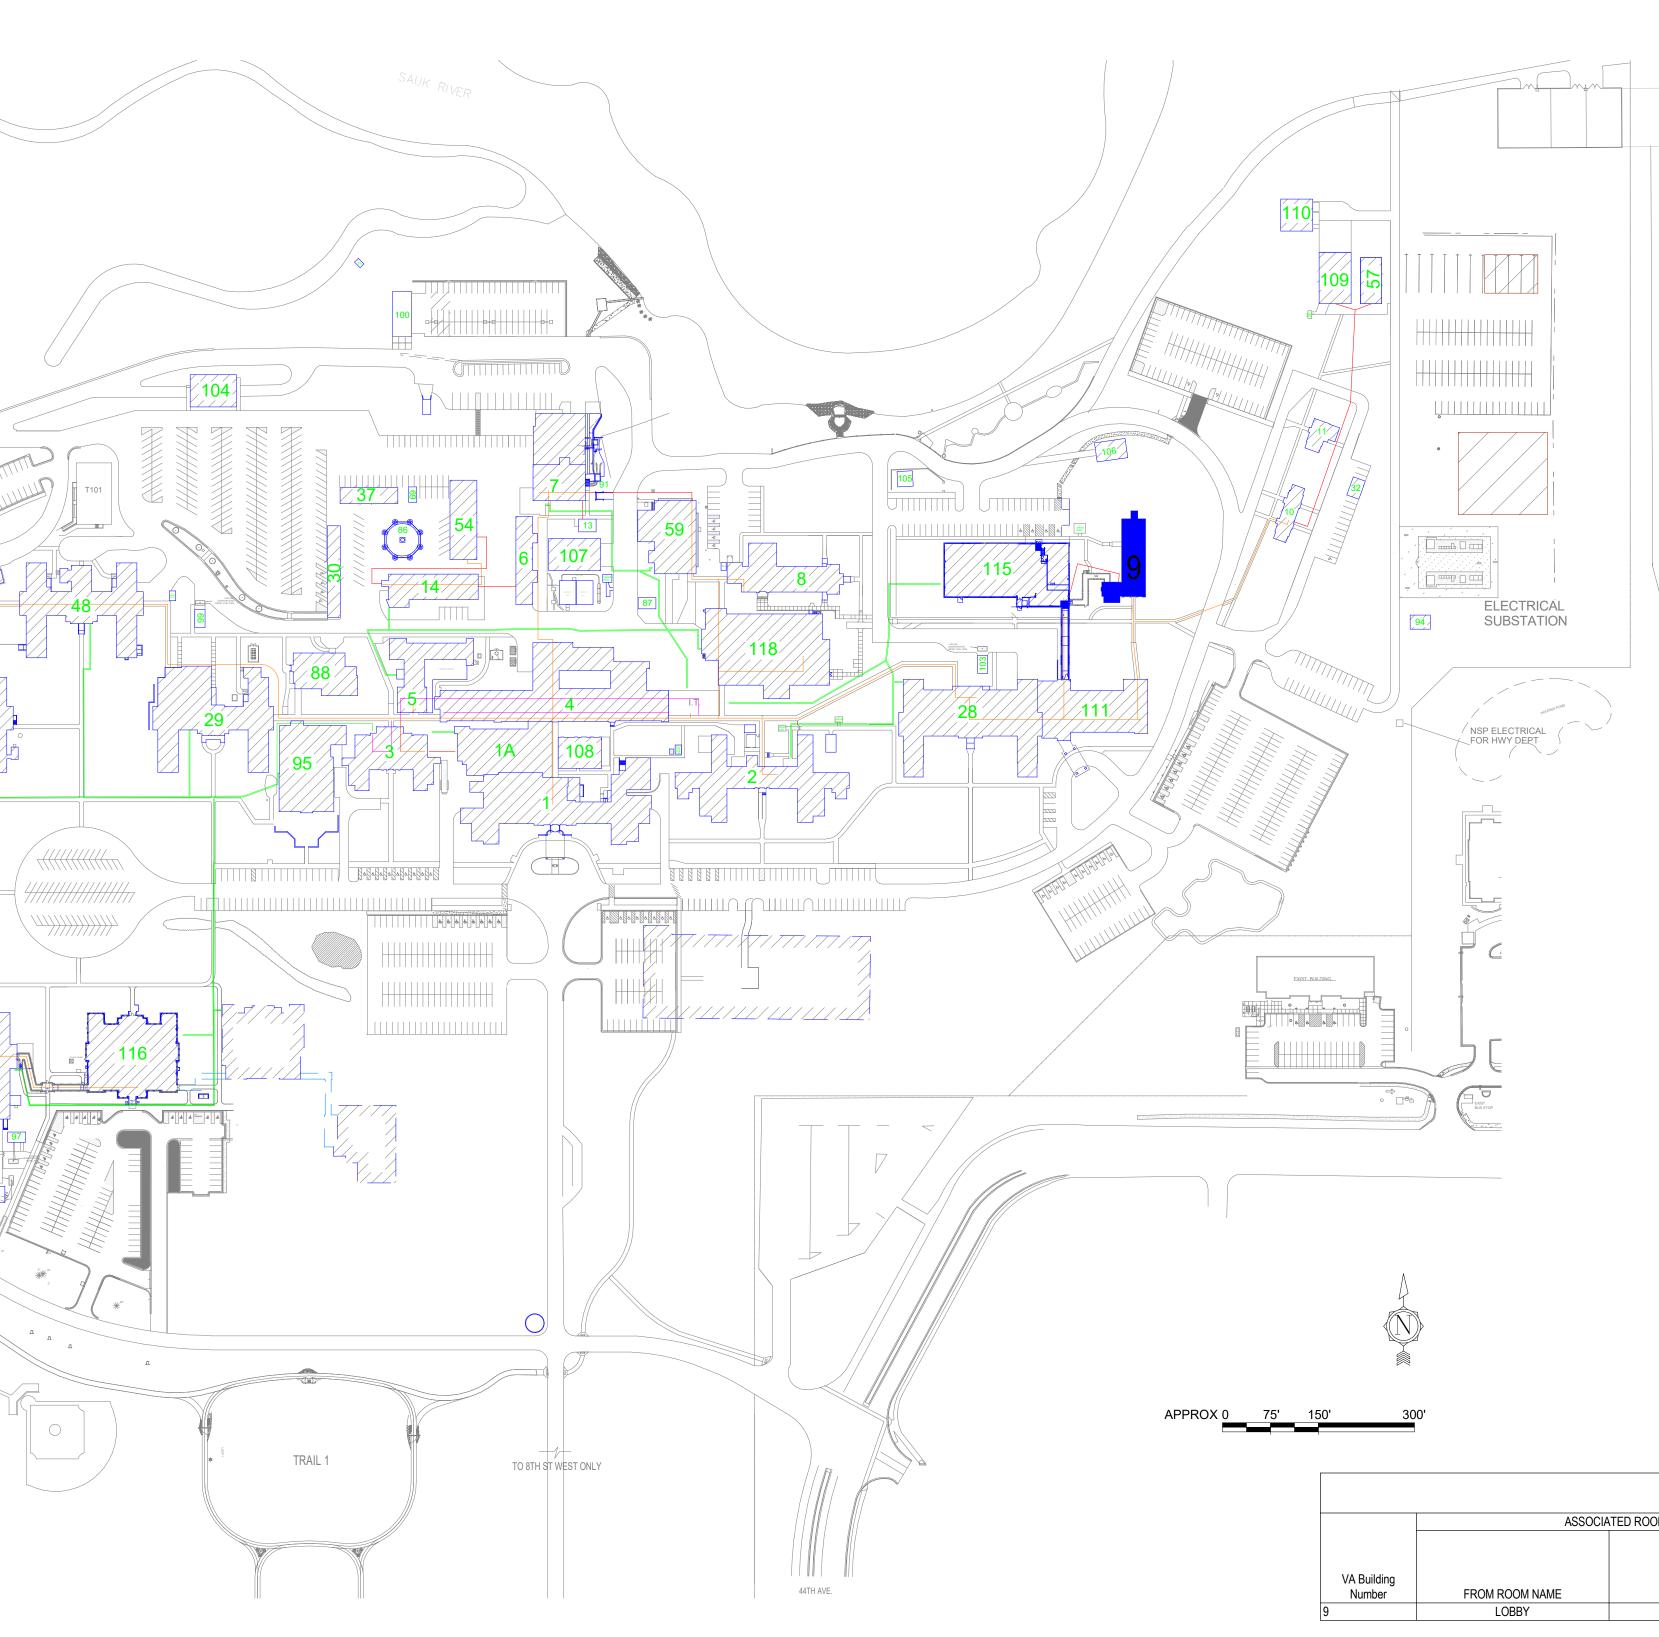


	SHEET INDEX - BUILDING 9
SHEET NO.	SHEET TITLE
9-GI000	BUILDING 9 COVER SHEET & SHEET INDEX
9-GI110	FIRST FLOOR LIFE SAFETY PLAN
9-GI111	FIRST FLOOR INFECTION CONTROL & PHASING PLAN
9-HA-1A	REFERENCE - BASEMENT FLOOR ASBESTOS RE-SURVEY
9-HA-2A	REFERENCE - FIRST FLOOR ASBESTOS RE-SURVEY
9-HA-3A	REFERENCE - SECOND FLOOR ASBESTOS RE-SURVEY
9-HA-4A	REFERENCE - ATTIC FLOOR ASBESTOS RE-SURVEY
9-AS100	BASEMENT, FIRST, AND SECOND FLOOR PLANS
9-TD100	FLOOR PLANS - TELECOM - DEMOLITION
9-TN100	FLOOR PLANS - TELECOMMUNICATIONS
9-TN210	FIRST FLOOR PLAN - TELECOM - CABLE DISTANCE
9-TN300	ENLARGED PLANS - TELECOMMUNICATIONS - DEMO
9-TN400	ENLARGED PLANS - TELECOMMUNICATIONS
09-E100	FIRST FLOOR DEMOLITION - ELECTRICAL
09-E200	BASEMENT - ELECTRICAL
09-E201	FIRST FLOOR - ELECTRICAL
09-E300	ELECTRICAL ENLARGED PLANS
09-E500	ELECTRICAL ONE-LINE DIAGRAMS
09-E600	ELECTRICAL SCHEDULES
09-M101	FIRST FLOOR DEMOLITION - MECHANICAL
09-M201	FIRST FLOOR REMODEL - MECHANICAL
SEE GENERAL S	HEETS FOR ADDITIONAL INFORMATION

									RC	OM	SC	ΗE	DULE		
NO.	NAME	CABLING	PATCH PANEL	FIBER	POWER	BONDING	UPS	DEDICATED COOLING	TEMPERATURE	HUMIDITY	RACK SENSOR	SPACE	AREA	WIDTH (FT)	LENG (FT
BASEM	ENT														
016	EXIST RM												35 SF	5.7	6.1
FIRST F	LOOR														
100	LOBBY												249 SF		
100B	TELECOM ROOM	X	X	X	X	X	X	X	X	X	X	X	120 SF	14.1	8.5


			HAZAR	DOU	S MATE	RIAL SCHEE	DULE
LEVEL	ROOM NO.	ROOM NAME	QUESTIONABLE HAZARD	OUS			POSSIBL
LEVEL	110.						FUSSIBL
BASEMENT	016	EXIST RM	NONE. SEE 9-HA-1A		NONE. ACM TO	O REMAIN UNDISTURBE	D
FIRST FLOOR	100	LOBBY	UNDER FLOOR TILE SEE 9-HA-2A		TO LIMITS OF	LAN, REMO	
FIRST FLOOR	100B	TELECOM ROOM	ACM. SEE 9-HA-2A		REMOVE HAZ	ARDOUS MATERIAL UND	ER FULL CO
QUESTIONABLE			ICRA PHASE	CON	STRUC		SCHE
LEVEL	ROOM NO.	ROOM NAME	CAI BLDG NAME / FUNCTION		ONSTRUCTION INFECTION CONTR DJECT ACTIVITY RISK GROUP		CON PROCEDU
						1	
BASEMENT	016	EXIST RM	DOMICILIARY / POLICE		TYPE B	GROUP 1	CLA
FIRST FLOOR	100	LOBBY	DOMICILIARY / POLICE		TYPE B	GROUP 2	CLA
FIRST FLOOR	100B	TELECOM ROOM	DOMICILIARY / POLICE		TYPE C	GROUP 2	CLAS
		ET FOR CONSTRUCTION THE VA WILL BE MADE /	N INFECTION CONTROL RISK A	ASSESSN	IENT (ICRA) DE	SCRIPTIONS. TYPE, GRO	OUP AND CL
			LEAK PRE	/EN]	FION / D	IVERTER SC	HEDU
LEVEL	ROOM NO.	ROOM NAME	OVERHEAD LE	eak dive	RTER AND DRA	IN PIPING	
							1
BASEMENT	016	EXIST RM					
FIRST FLOOR	100	LOBBY					
FIRST FLOOR	100B	TELECOM ROOM					L

	OPENING SCHEDULE										
	ASSOCI	ATED ROOMS		OPENING		PAN	IEL INFORMA	TION	FRAME INFO	RMATION	
VA Building Number	FROM ROOM NAME	TO ROOM NAME	NUMBER	WIDTH	HEIGHT	PANEL TYPE	2ND PANEL TYPE	PANEL GLAZING	FRAME TYPE	FRAME GLAZING	HDW GROUP
9	LOBBY	TELECOM ROOM	100B	3'-0"	7'-0"	WD-F		NONE	HMS-1	NONE	HW-3

DATE:	APPROVED: EMS MANAGER DATE:	APPROVED: DIRECTOR FMS DATE:	DRAWING TITLE BUILDING 9 COVER SHEET & SHEET INDEX	PROJECT TITLE EHRM INFF UPGRADE		TURE	DATE: 03/30/2022 PLOT SCALE	
DATE:	APPROVED: M/O MANAGER DATE:	APPROVED: ASSOCIATE DIRECTOR DATE:	SHEETINDEA				PROJECT NO. 656-21-235	VA
DATE:	APPROVED: PROJECTS SECTION MANAGER DATE:	APPROVED: NURSE EXECUTIVE DATE:		BUILDING No 9	CHECKED BY	DRAWN EM	DRAWING NO. 9-GI000	
DATE:	APPROVED: ASSISTANT CHIEF ENGINEER DATE:	APPROVED: CHIEF OF STAFF DATE:	APPROVED: MEDICAL CENTER DIRECTOR DATE:	LOCATION VA MEDICAL CEN ST.CLOUD, MN 50		FULLY	COVER DWG. OF	

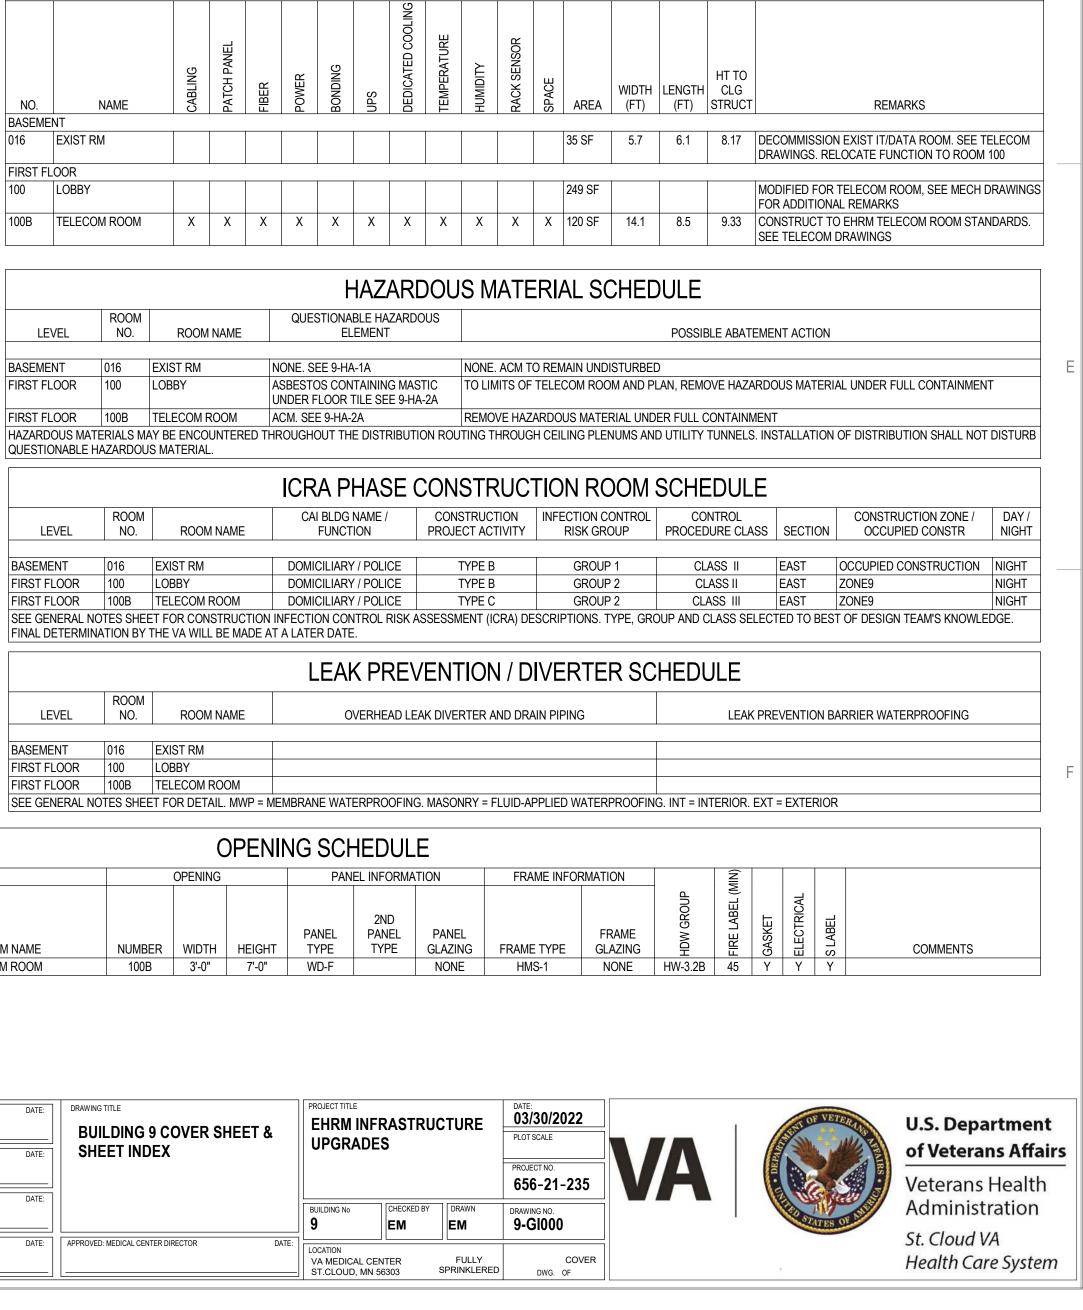


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LIFE SAF	SMOKE TIGHT
	1 HOUR FIRE BARRIER
	2 HOUR FIRE BARRIER
	3 HOUR FIRE BARRIER
EXIT	EXIT
HE	HORIZONTAL E
FE	FIRE EXTINGUISHEF
	LIMITS OF CONSTRUCTIO
	SMOKE COMPARTMEN BOUNDARY SHAF ADJA DAMI HAZA ADJA OPEN EXIT RATE ALL C CORI WALL
	or CC WITH
NOTE: NOT ALL SYMB	OLS MY BE USEL

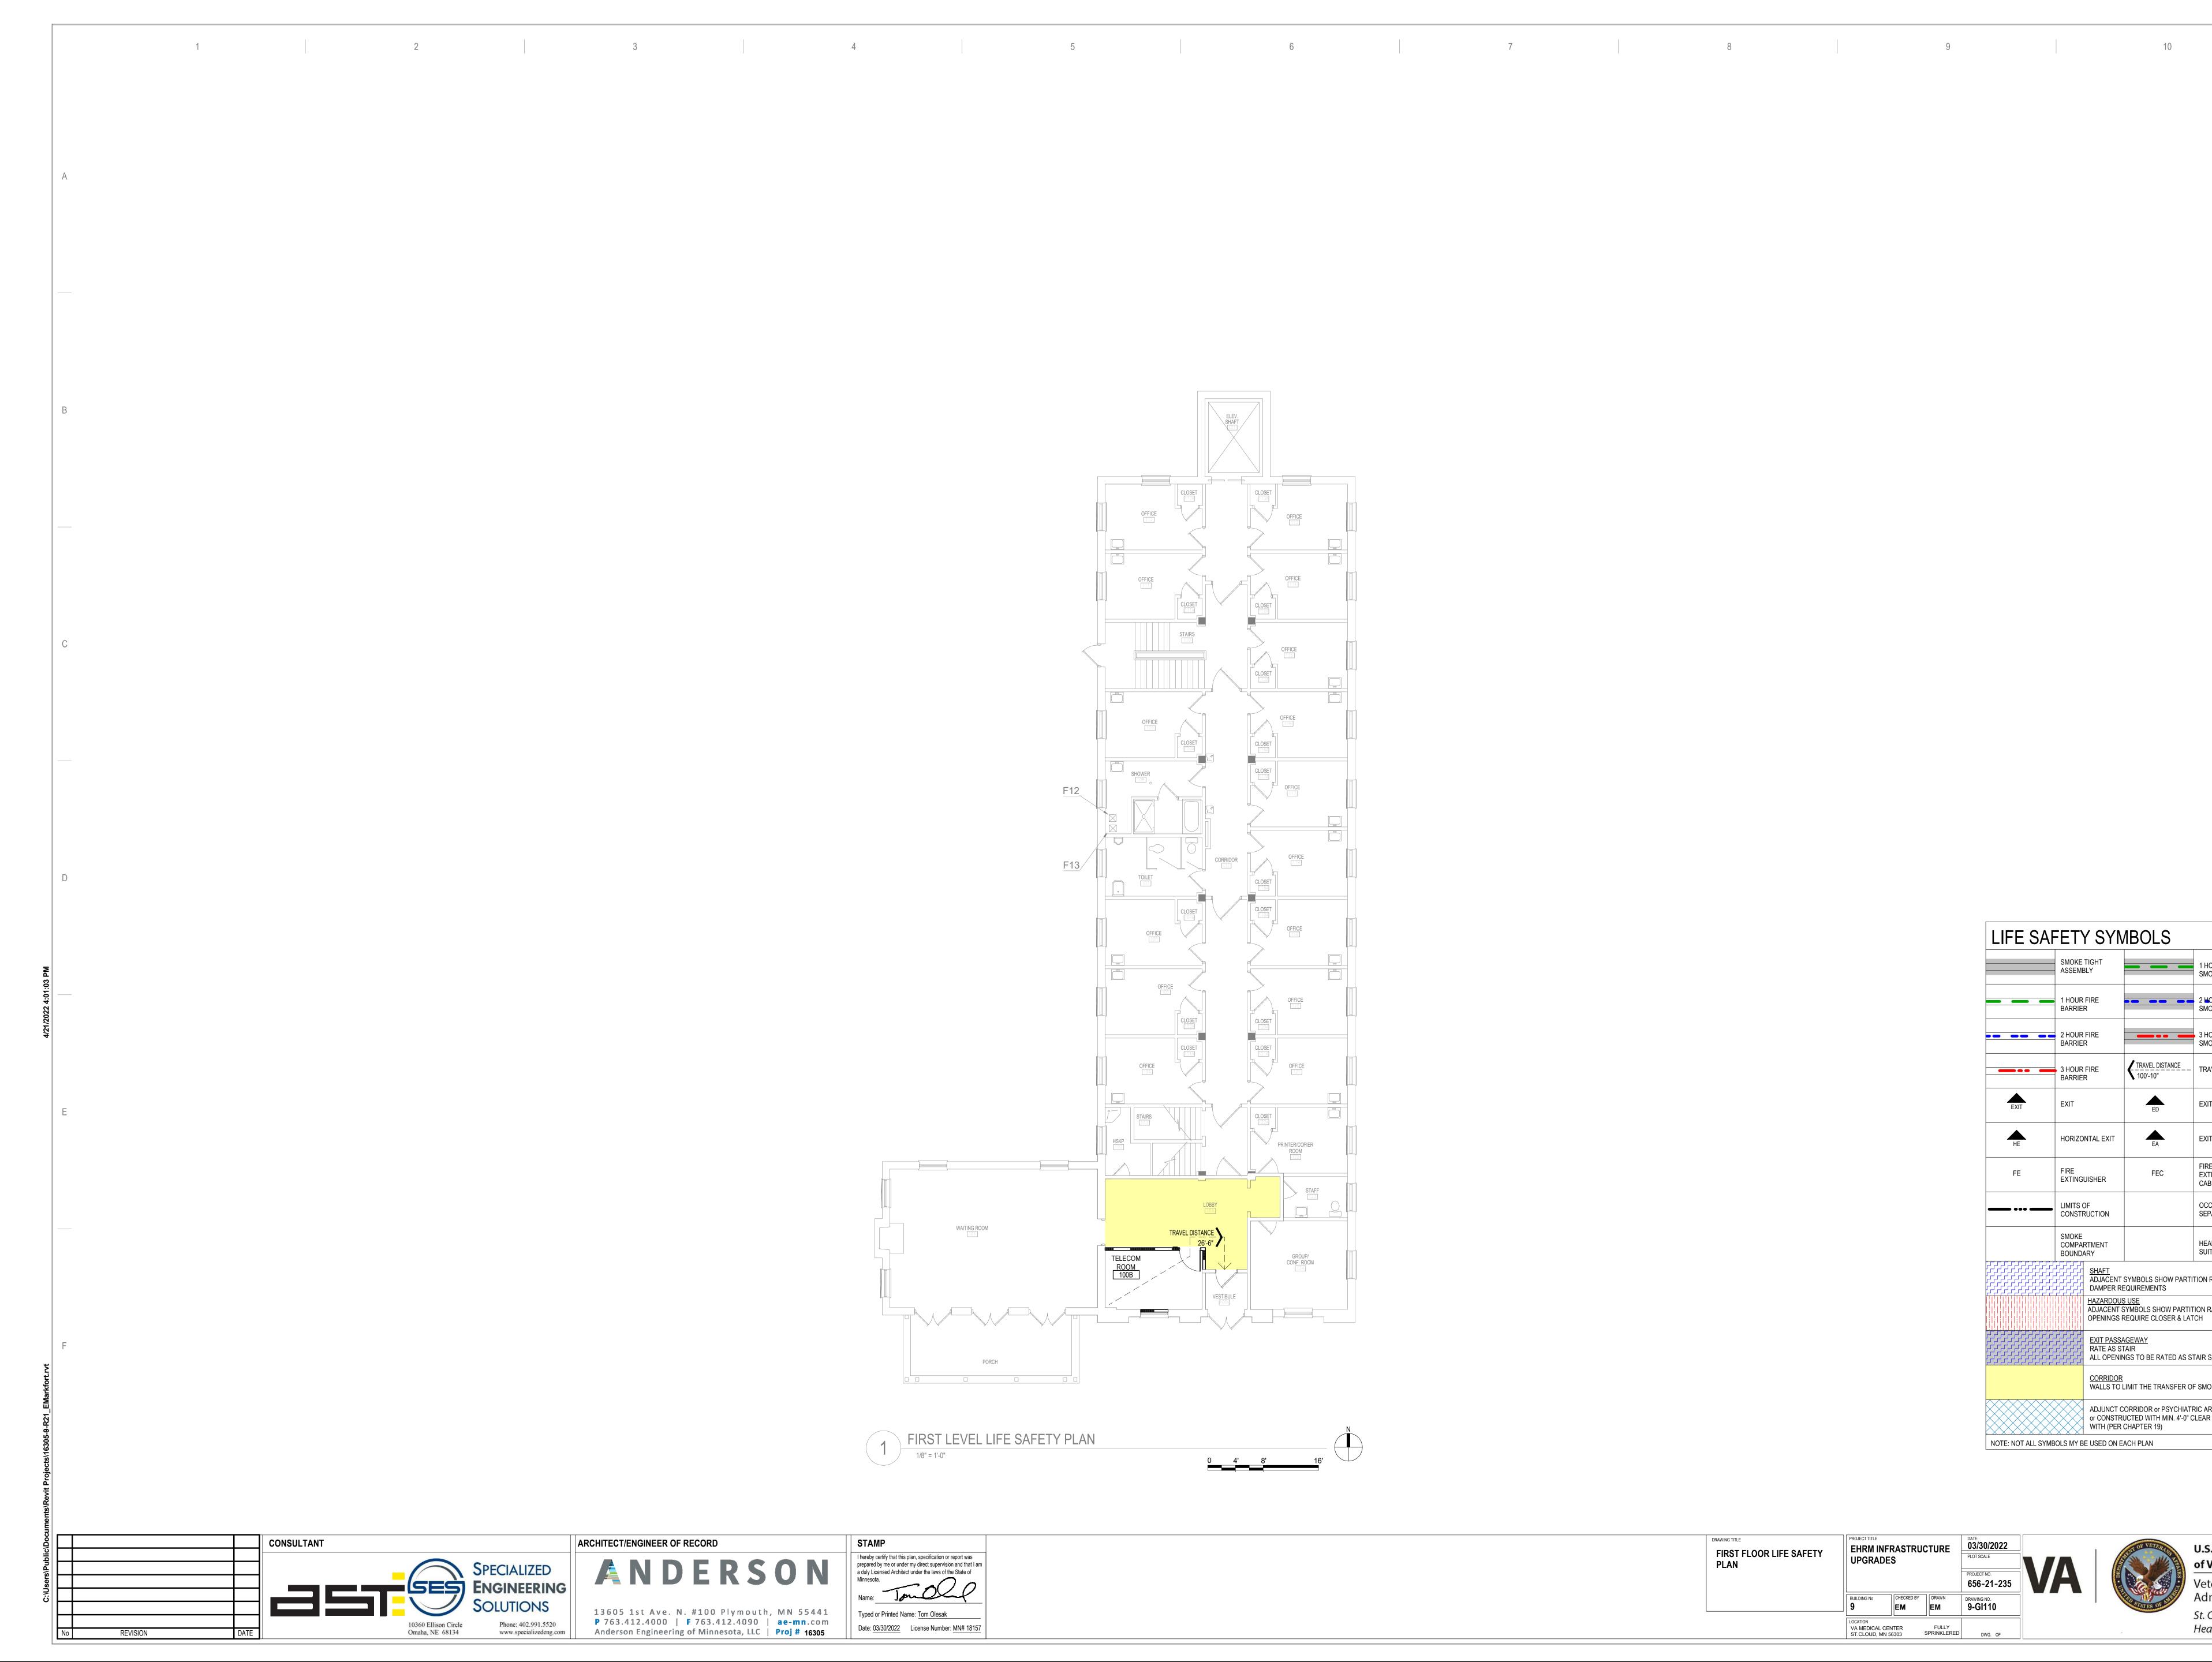
DRAWING TITLE FIRST FLOOR LIFE SAFETY PLAN	PROJECT TITLE EHRM INFRASTRUCTURE UPGRADES			DATE: 03/30/2022 PLOT SCALE PROJECT NO. 656-21-235	VA
	BUILDING No 9	CHECKED BY	DRAWN EM	DRAWING NO. 9-GI110	
	LOCATION VA MEDICAL CEN ST.CLOUD, MN 5		FULLY SPRINKLERED	DWG. OF	



1 HOUR FIRE &

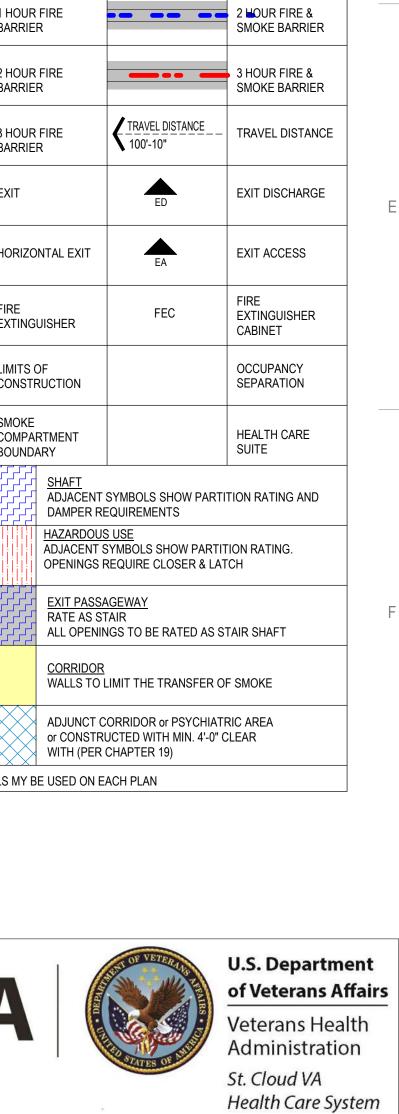SMOKE BARRIER

ETY SYMBOLS

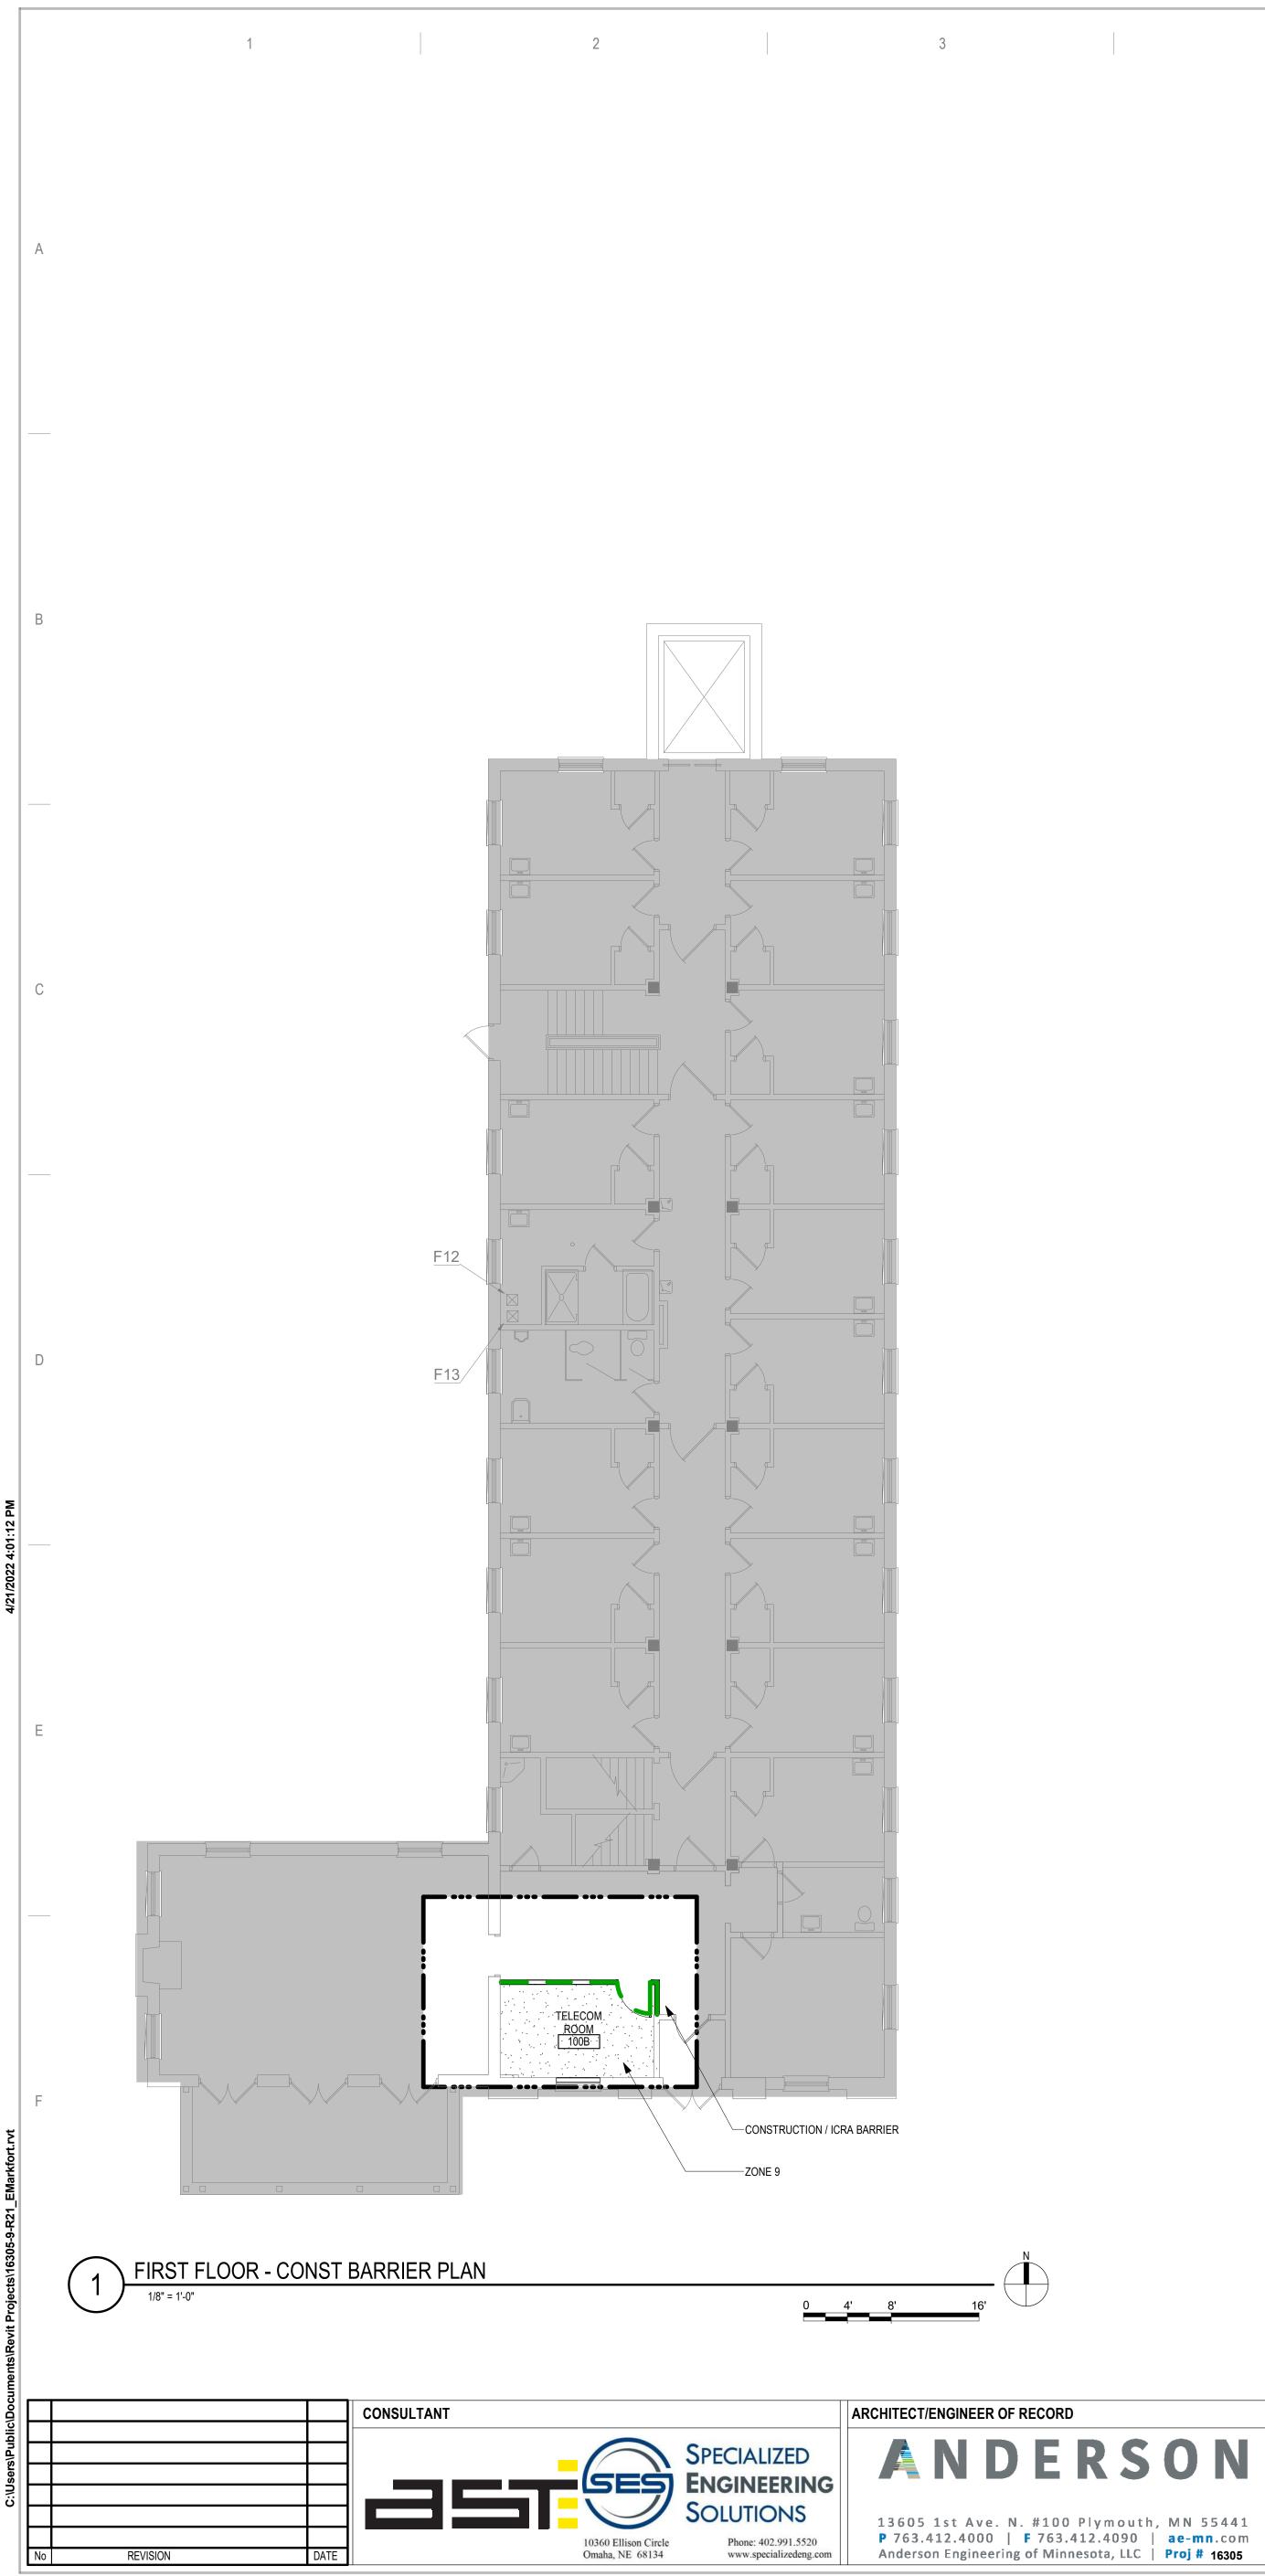


4	5	6	7	8	9	10

SEQUENCE OF EVENTS - Z SELECTIVE UPGRADE TO EXISTING INFORMATION TECH BUILDING TOTAL UPGRADE PROCESS INITIAL ICRA AND ILSM

 CONSTRUCTION OF BARRIER IN ONE NIGHT SHIFT. BAR AND PARTITION TO BECOME PERMANENT CONSTRUCT HAZARDOUS MATERIAL ABATEMENT AS INDICATED
 CONSTRUCT ROOMS AS DIRECTED, SEE ASSOCIATED D STRUCTURAL, ELECTRICAL, MECHANICAL, TELECOM, A • INSTALL TEMPORARY PROTECTION AND CONDUCT SEL ENABLE UPGRADES INSTALL COMMON CABLE INFRASTRUCTURE
 CONSTRUCT COMMUNICATION BACKBONE INSTALL CAT 6A DECOMMISSION EXISTING NON-EHRM INFORMATION T

SUGGESTED SEQUENCE. FINAL INSTALLATION SEQUENCE TO E



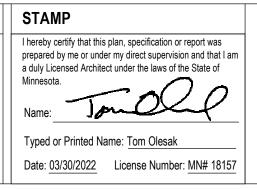


ZONE 9								
					ROO	M ICRA SCHEDULE		
HNOLOGY TO ENABLE	LEVEL	ROOM NO.	ROOM NAME	CAI BLDG NAME	FUNCTION	CONSTRUCTION PROJECT ACTIVITY	INFECTION CONTROL RISK GROUP	CONTROL PROCEDURE CLASS
ARRIER INCLUDES DOOR	BASEMENT	016	EXIST RM	DOMICILIARY	/ POLICE	TYPE B	GROUP 1	CLASS II
TION OF ROOM	FIRST FLOOR		LOBBY	DOMICILIARY		TYPE B	GROUP 2	CLASS II
DRAWINGS FROM	FIRST FLOOR	100B	TELECOM ROOM	DOMICILIARY	/ POLICE	TYPE C	GROUP 2	CLASS III
ECHNOLOGY ROOMS						ESSMENT (ICRA		
	_	••••		—	LIMITS C	OF CONSTRUCTION		
E MADE AT A LATER DATE.	DE AT A LATER DATE.				1 HOUR FIRE RATED ICRA / CONSTRUCTION BARRIER LOCATION, AND DOOR, WHERE SHOWN			
	_					RY NON-RATED (PLASTIC SHEETING) CC , WHERE APPROVED BY THE VA FOR US		

UPGRADE TO 1 HOUR RATED PARTITION WHEN DIRECTED BY THE VA

DRAWING TITLE	PROJECT TITLE				
FIRST FLOOR INFECTION CONTROL & PHASING PLAN	UPGRADES			PLOT SCALE	
				PROJECT NO. 656-21-235	V
	BUILDING No	CHECKED BY	DRAWN BW	DRAWING NO. 9-GI111	
	LOCATION VA MEDICAL C ST.CLOUD, MN		FULLY	DWG. OF	





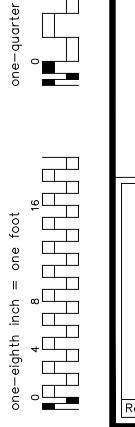

Revisions

-ASBESTOS-CONTAINING WINDOW CAULK

-ASBESTOS-CONTAINING BASEBOARD ADHESIVE

-ASBESTOS-CONTAINING MASTIC UNDER DOUBLE LAYER FLOOR TILE UNDER CARPET

-ASBESTOS-CONTAINING MASTIC UNDER FLOOR TILE AND CARPET

Dates

1


-ASBESTOS-CONTAINING MASTIC UNDER DOUBLE LAYER FLOOR TILE


-ASBESTOS-CONTAINING MASTIC UNDER 12"X12" FLOOR TILE

-ASBESTOS-CONTAINING FIRE DOOR

-ASBESTOS-CONTAINING MUDDED PIPE FITTINGS



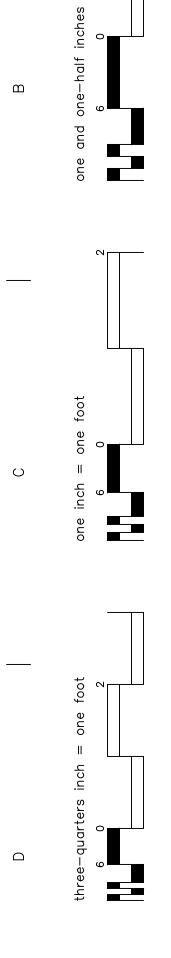

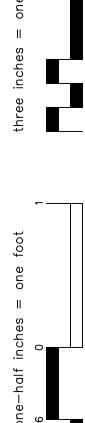

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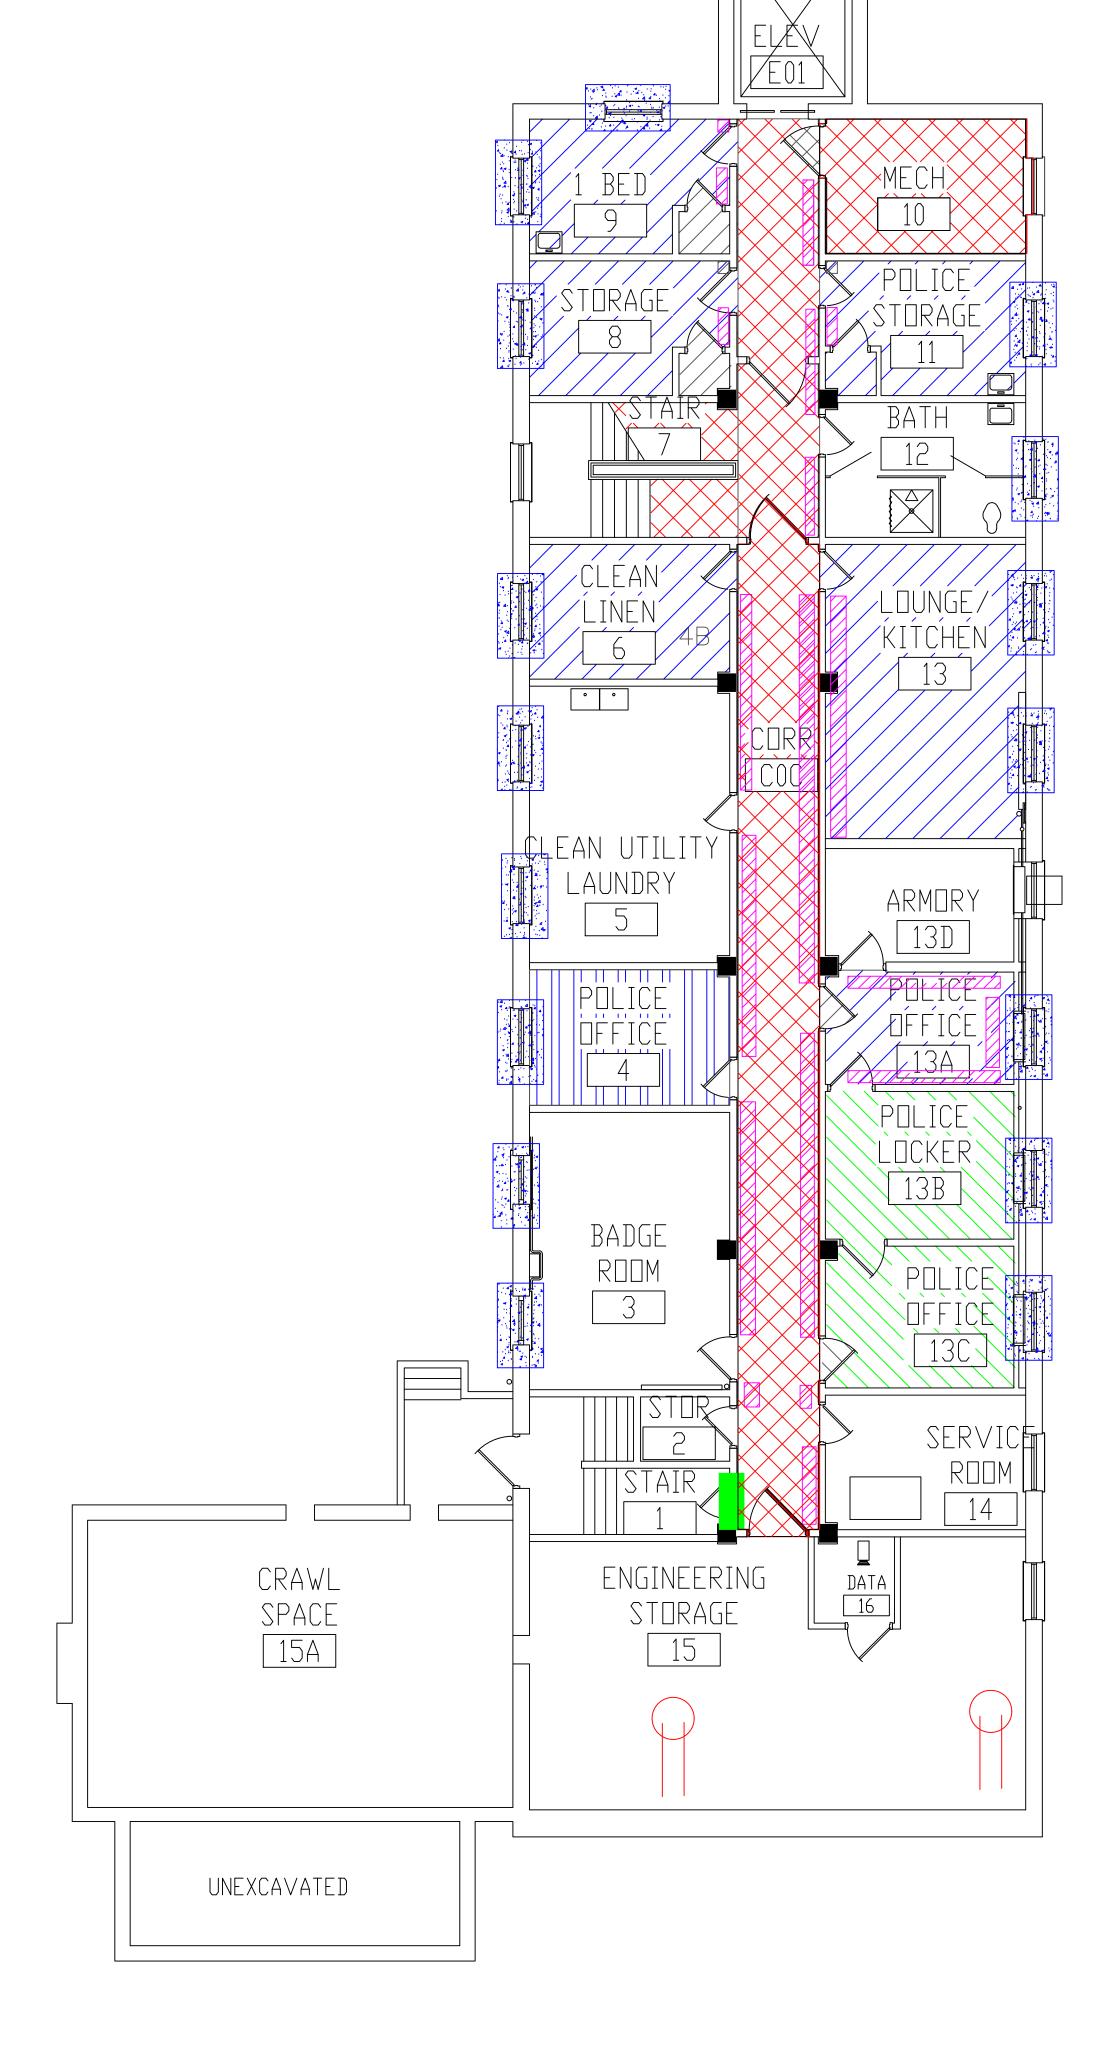
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BUILDING #9 - BASEMENT FLOOR PLAN



North:	Drawing Title	Project Title			Date		
NOTITI: N	ARCHITECTURAL PLAN		ASBESTOS RE-3		NOVEMBER 201		
W E	BUILDING 9 Scale: 1/8" = 1'-0"	ME	MEDICAL CENTER ST. CLOUD, MINNESOTA				
	Approved : Division Chief	Building Number	Checked BLB	Drawn AFS	Drawing No.		
	Approved : Service Director	Location ST. CLO	1 A Sheet 23 of 71				
			_	1			






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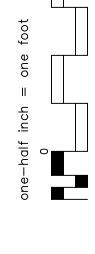
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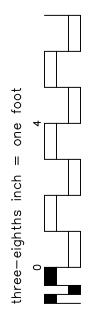
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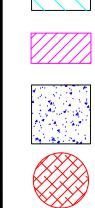
foot

LEGEND

-ASBESTOS-CONTAINING MUDDED PIPE FITTINGS

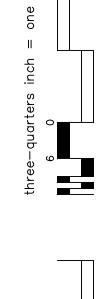

-ASBESTOS-CONTAINING MASTIC UNDER 12"X12" FLOOR TILE



Revisions

-ASBESTOS-CONTAINING BASEBOARD ADHESIVE

-ASBESTOS-CONTAINING MASTIC UNDER CARPET


-ASBESTOS-CONTAINING WINDOW CAULK


-ASBESTOS-CONTAINING DOWNSPOUT RAIN LEADER TAR

Dates

1



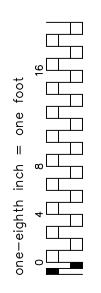


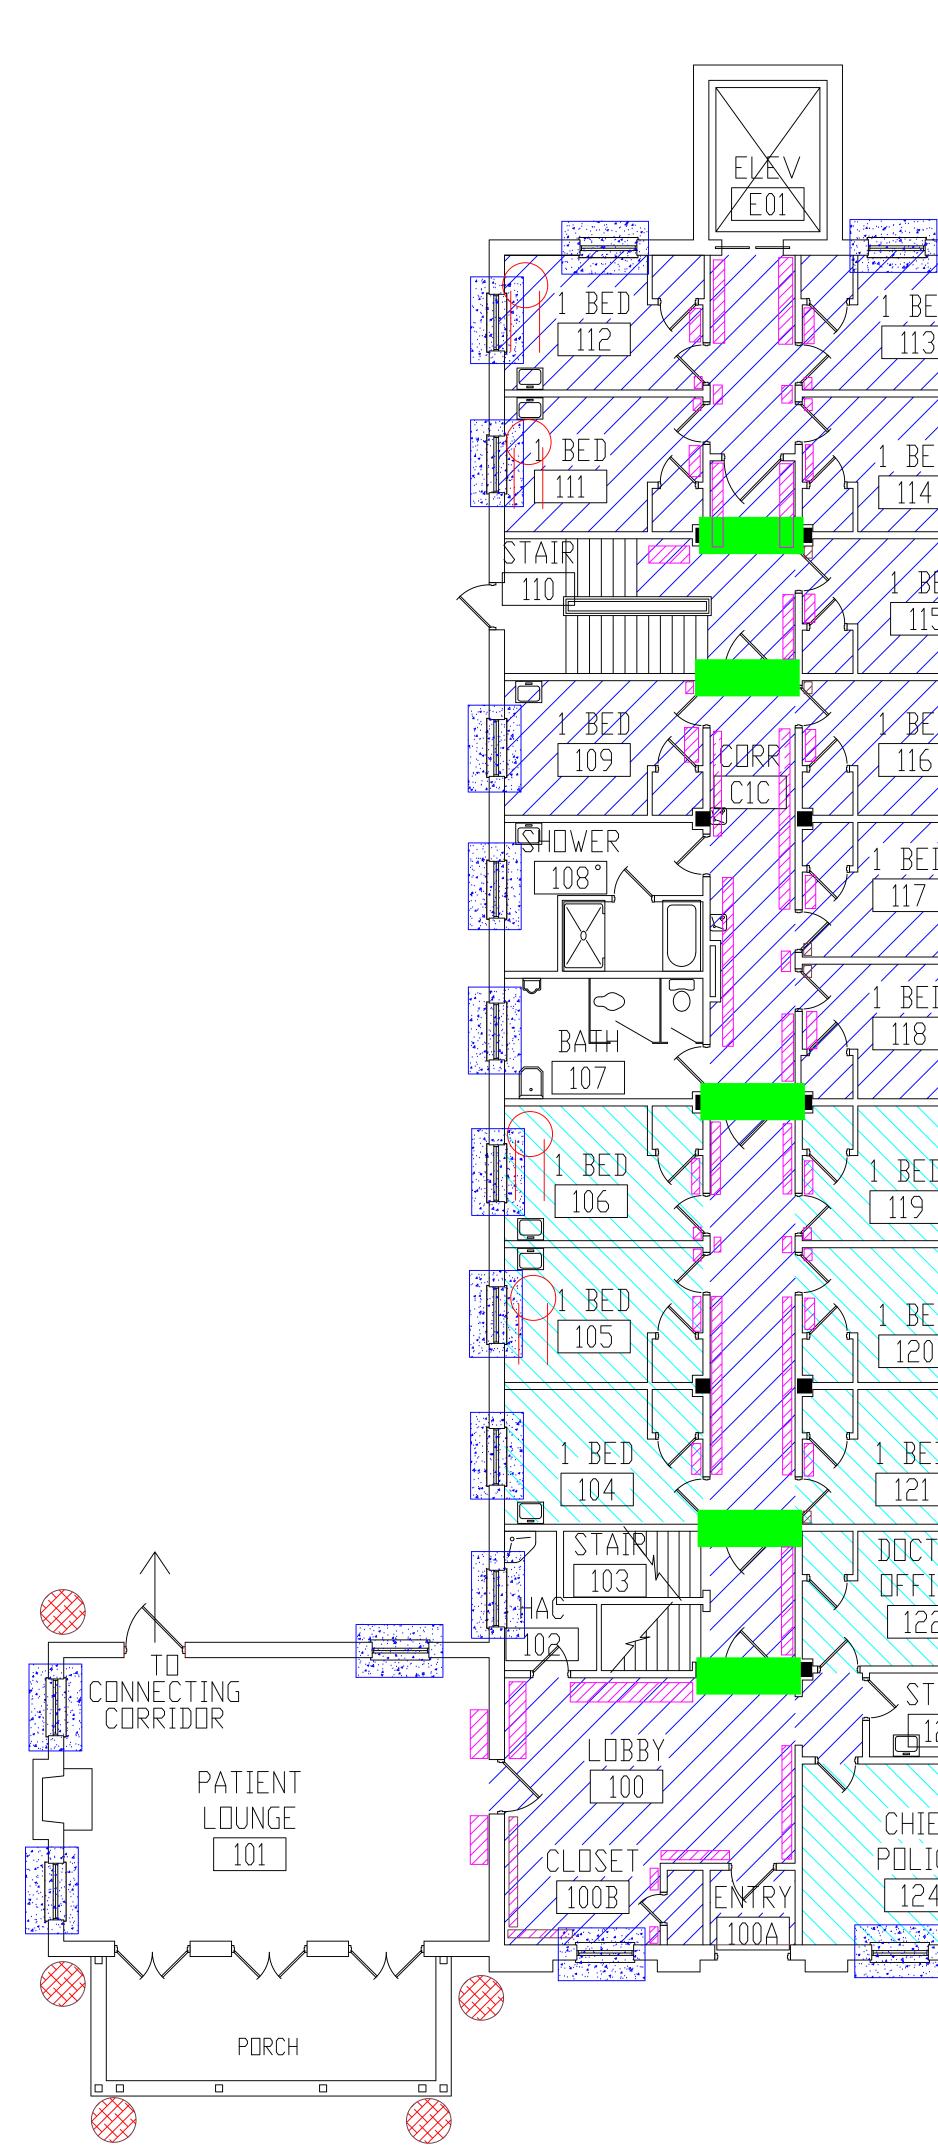

BUILDING #9 - FIRST FLOOR PLAN



4

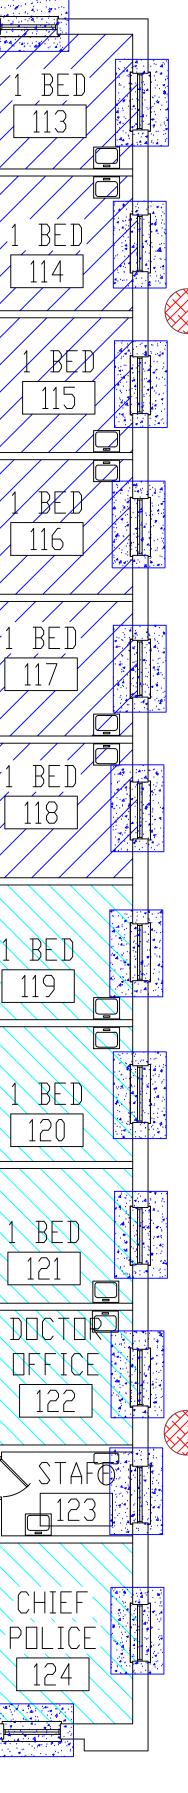

Project Title Drawing Title Date North: FACILITY ASBESTOS RE-SURVEY VETERANS ADMINISTRATION MEDICAL CENTER ST. CLOUD, MINNESOTA NOVEMBER 2019 ARCHITECTURAL PLAN BUILDING 9 Scale: 1/8" = 1'-0" Project No. 36C26319P1003 Approved : Division Chief Building Number Checked Drawn rawing No. 009 BLB AFS 2A Approved : Service Director Location ST. CLOUD, MINNESOTA Sheet 24 of 71


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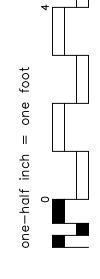



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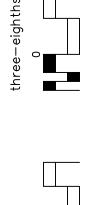


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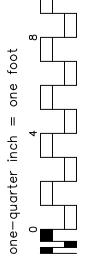
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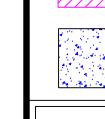


-ASBESTOS-CONTAINING MASTIC UNDER 12"X12" FLOOR TILE

-ASBESTOS-CONTAINING MASTIC UNDER CARPET AND FLOOR TILE

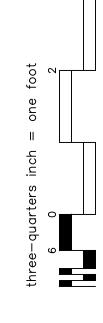Dates

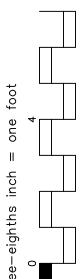
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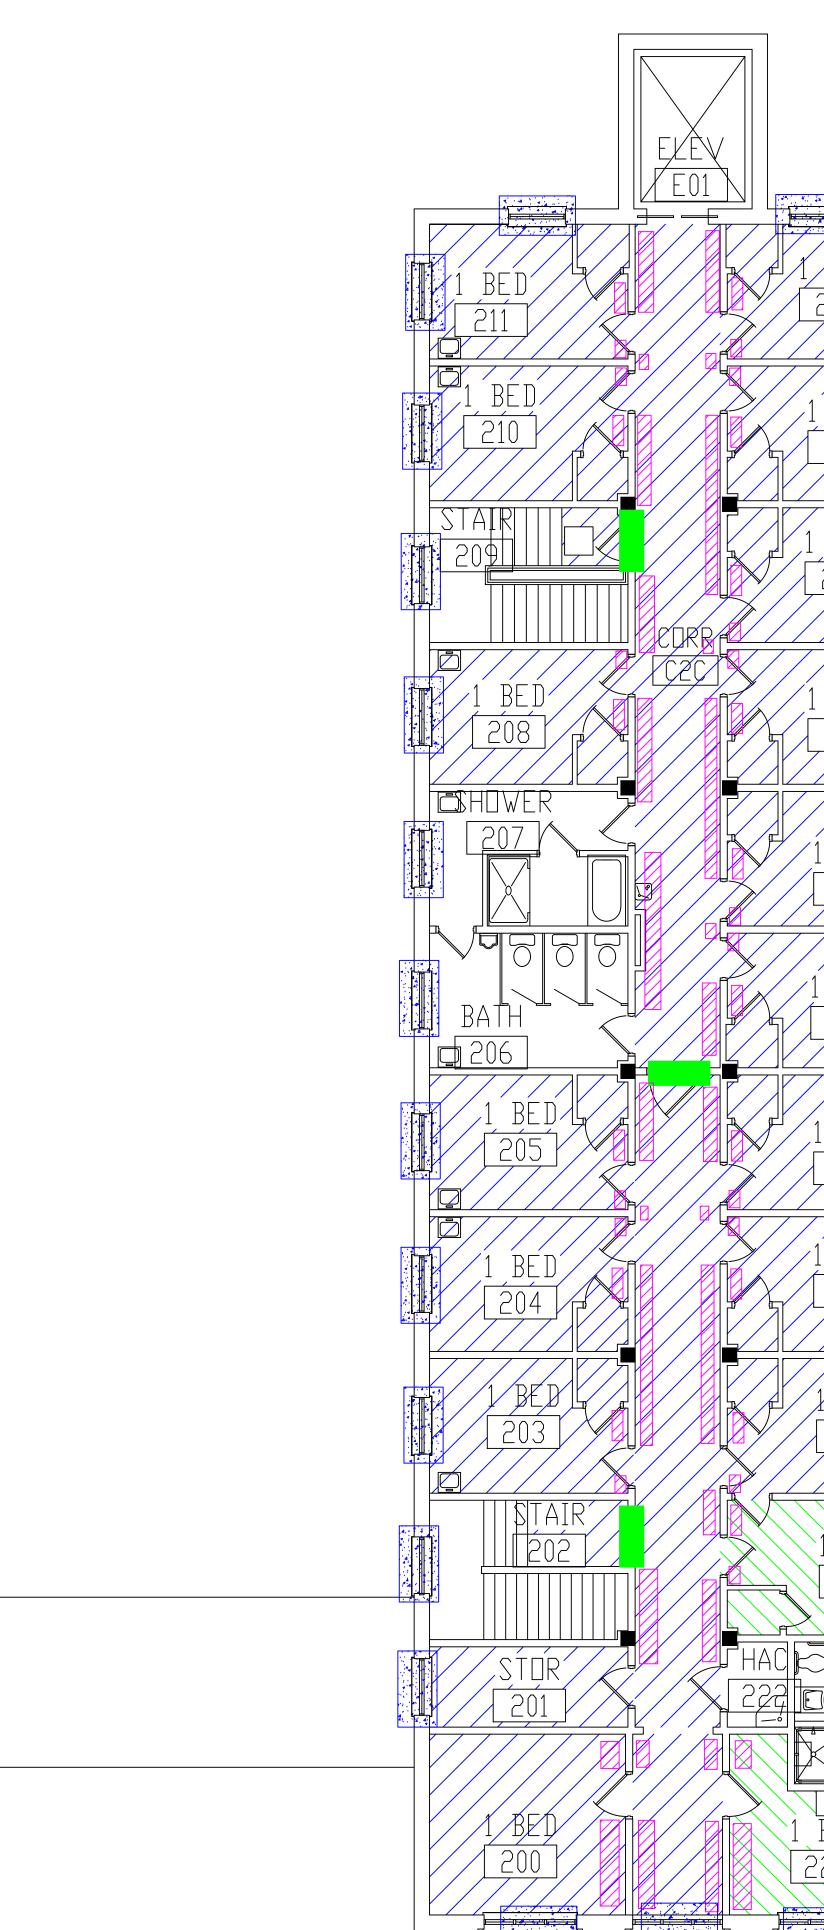


Revisions

-ASBESTOS-CONTAINING BASEBOARD ADHESIVE -ASBESTOS-CONTAINING WINDOW CAULK





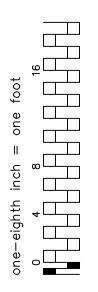


BUILDING #9 - SECOND FLOOR PLAN



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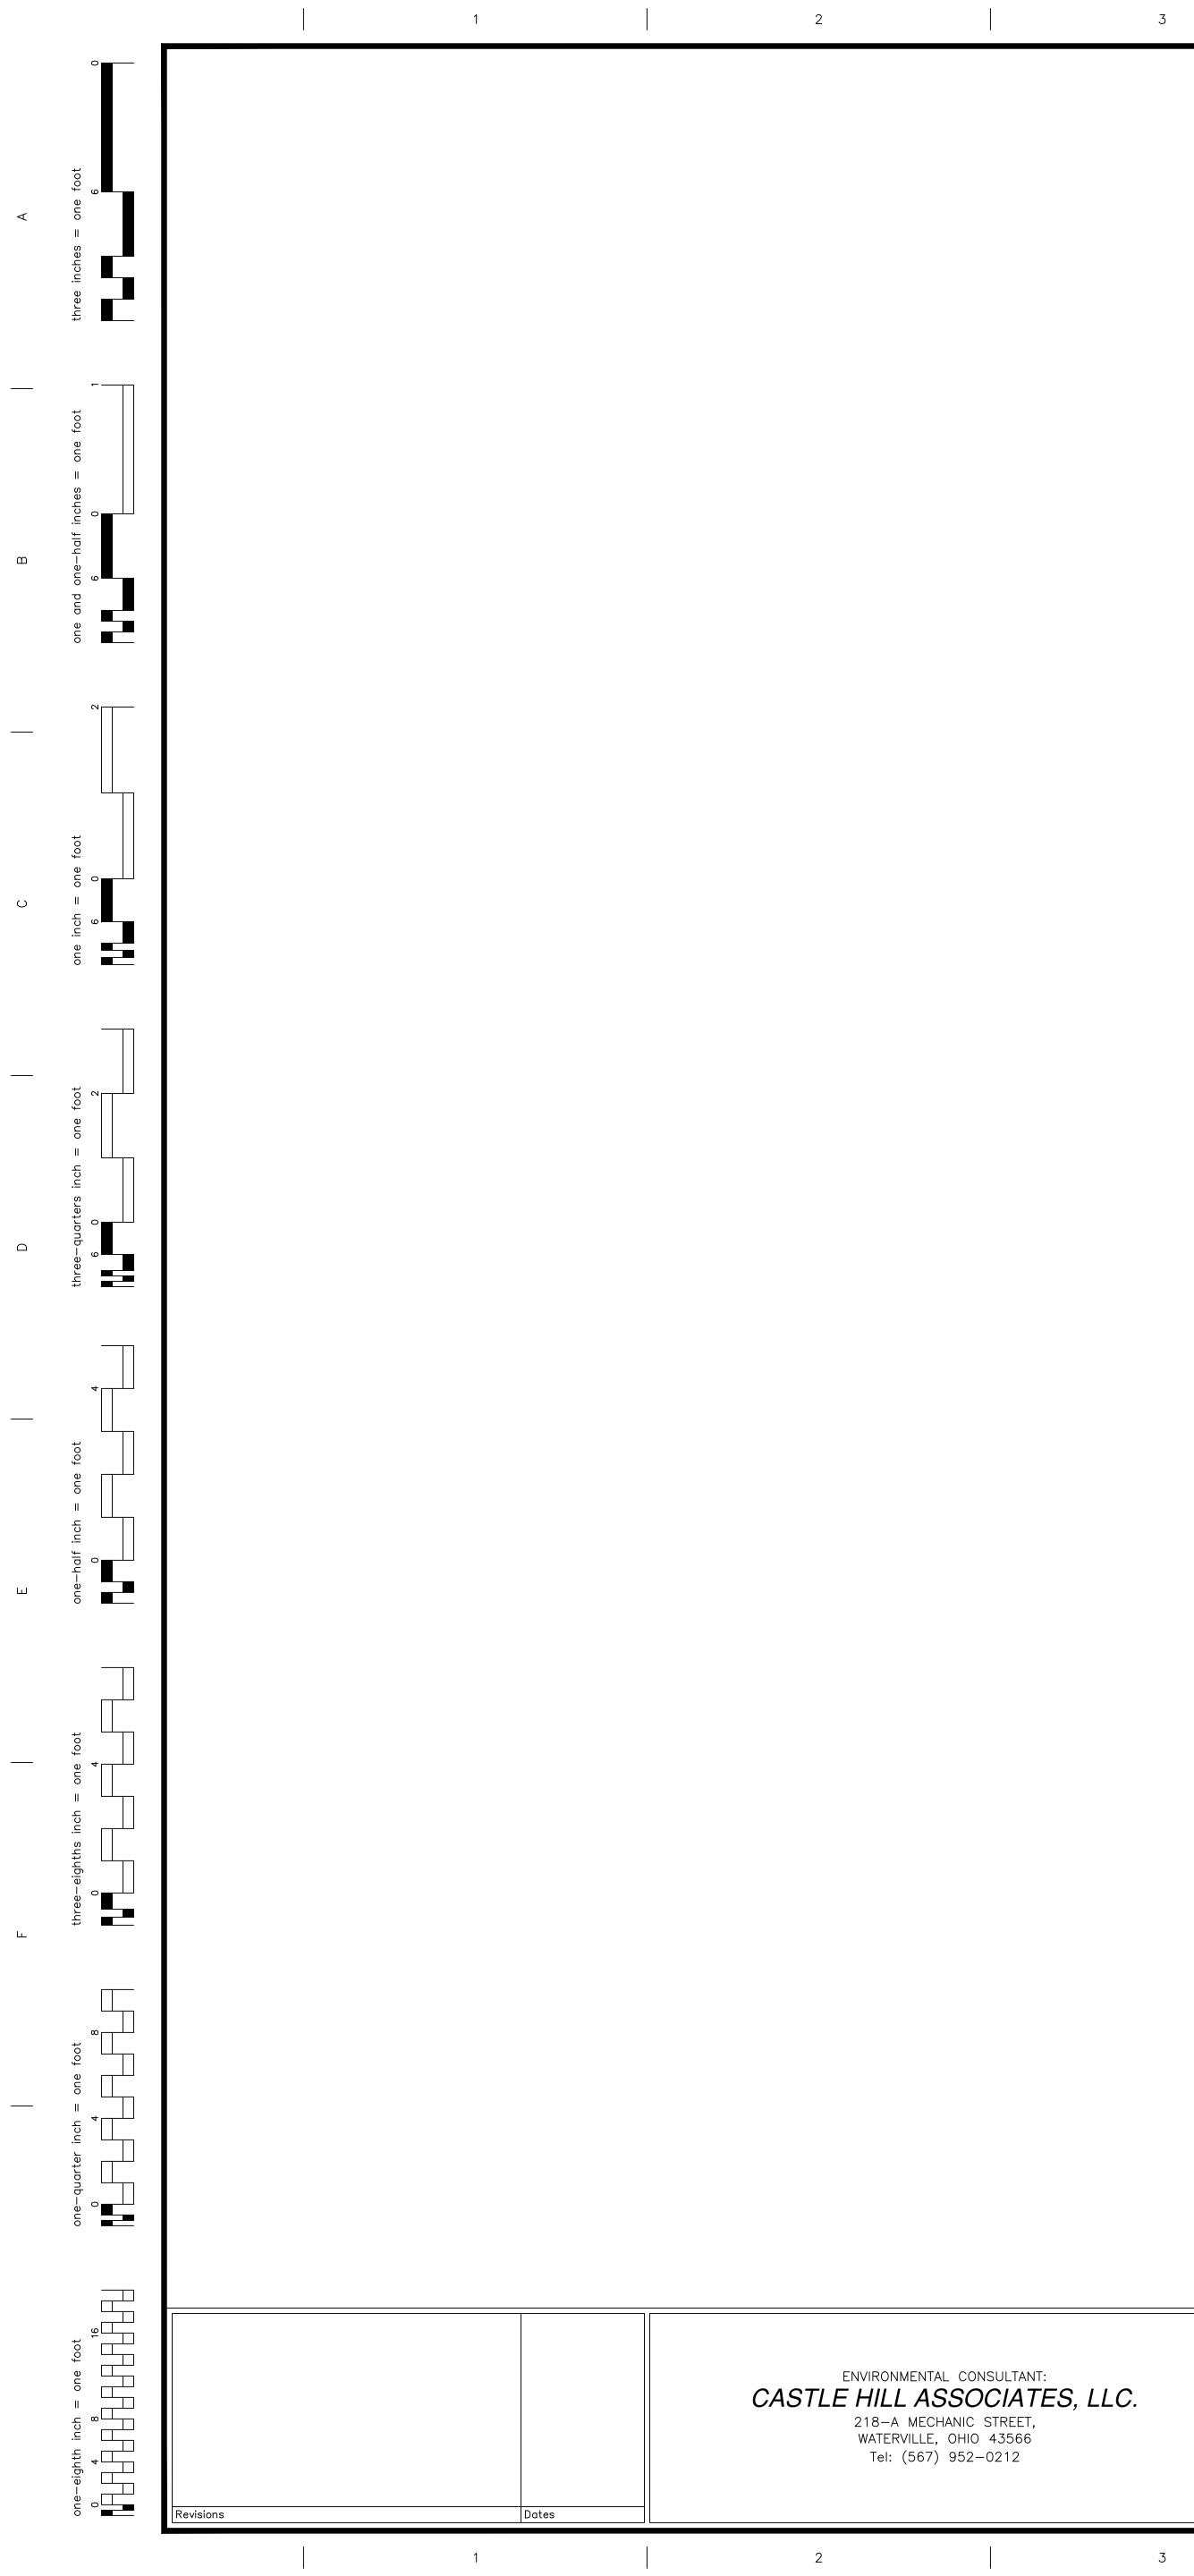
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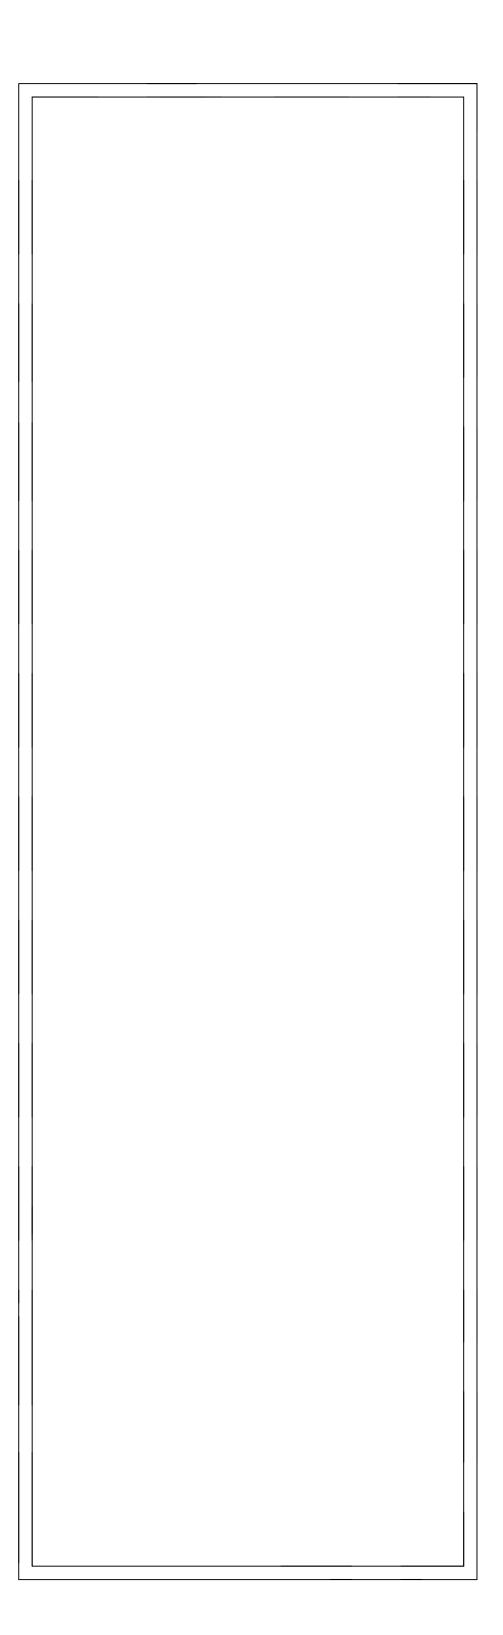


North:	Drawing Title ARCHITECTURAL PLAN		SBESTOS RE-		Date NOVEMBER 2019
	BUILDING 9 Scale: 1/8" = 1'-0"	MEC	OICAL CENTER OUD, MINNESC	ł	Project No. 36C26319P1003
	Approved : Division Chief	Building Number	Checked BLB	Drawn AFS	Drawing No.
s	Approved : Service Director	Location ST. CLC	DUD, MINNES	BOTA	Sheet 25 of 71
6	7		8		9



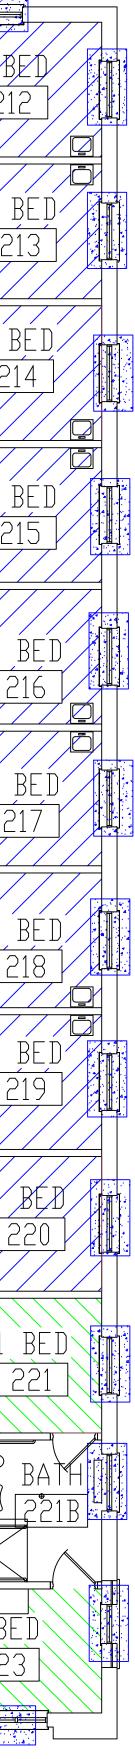





BUILDING #9 - ATTIC FLOOR PLAN






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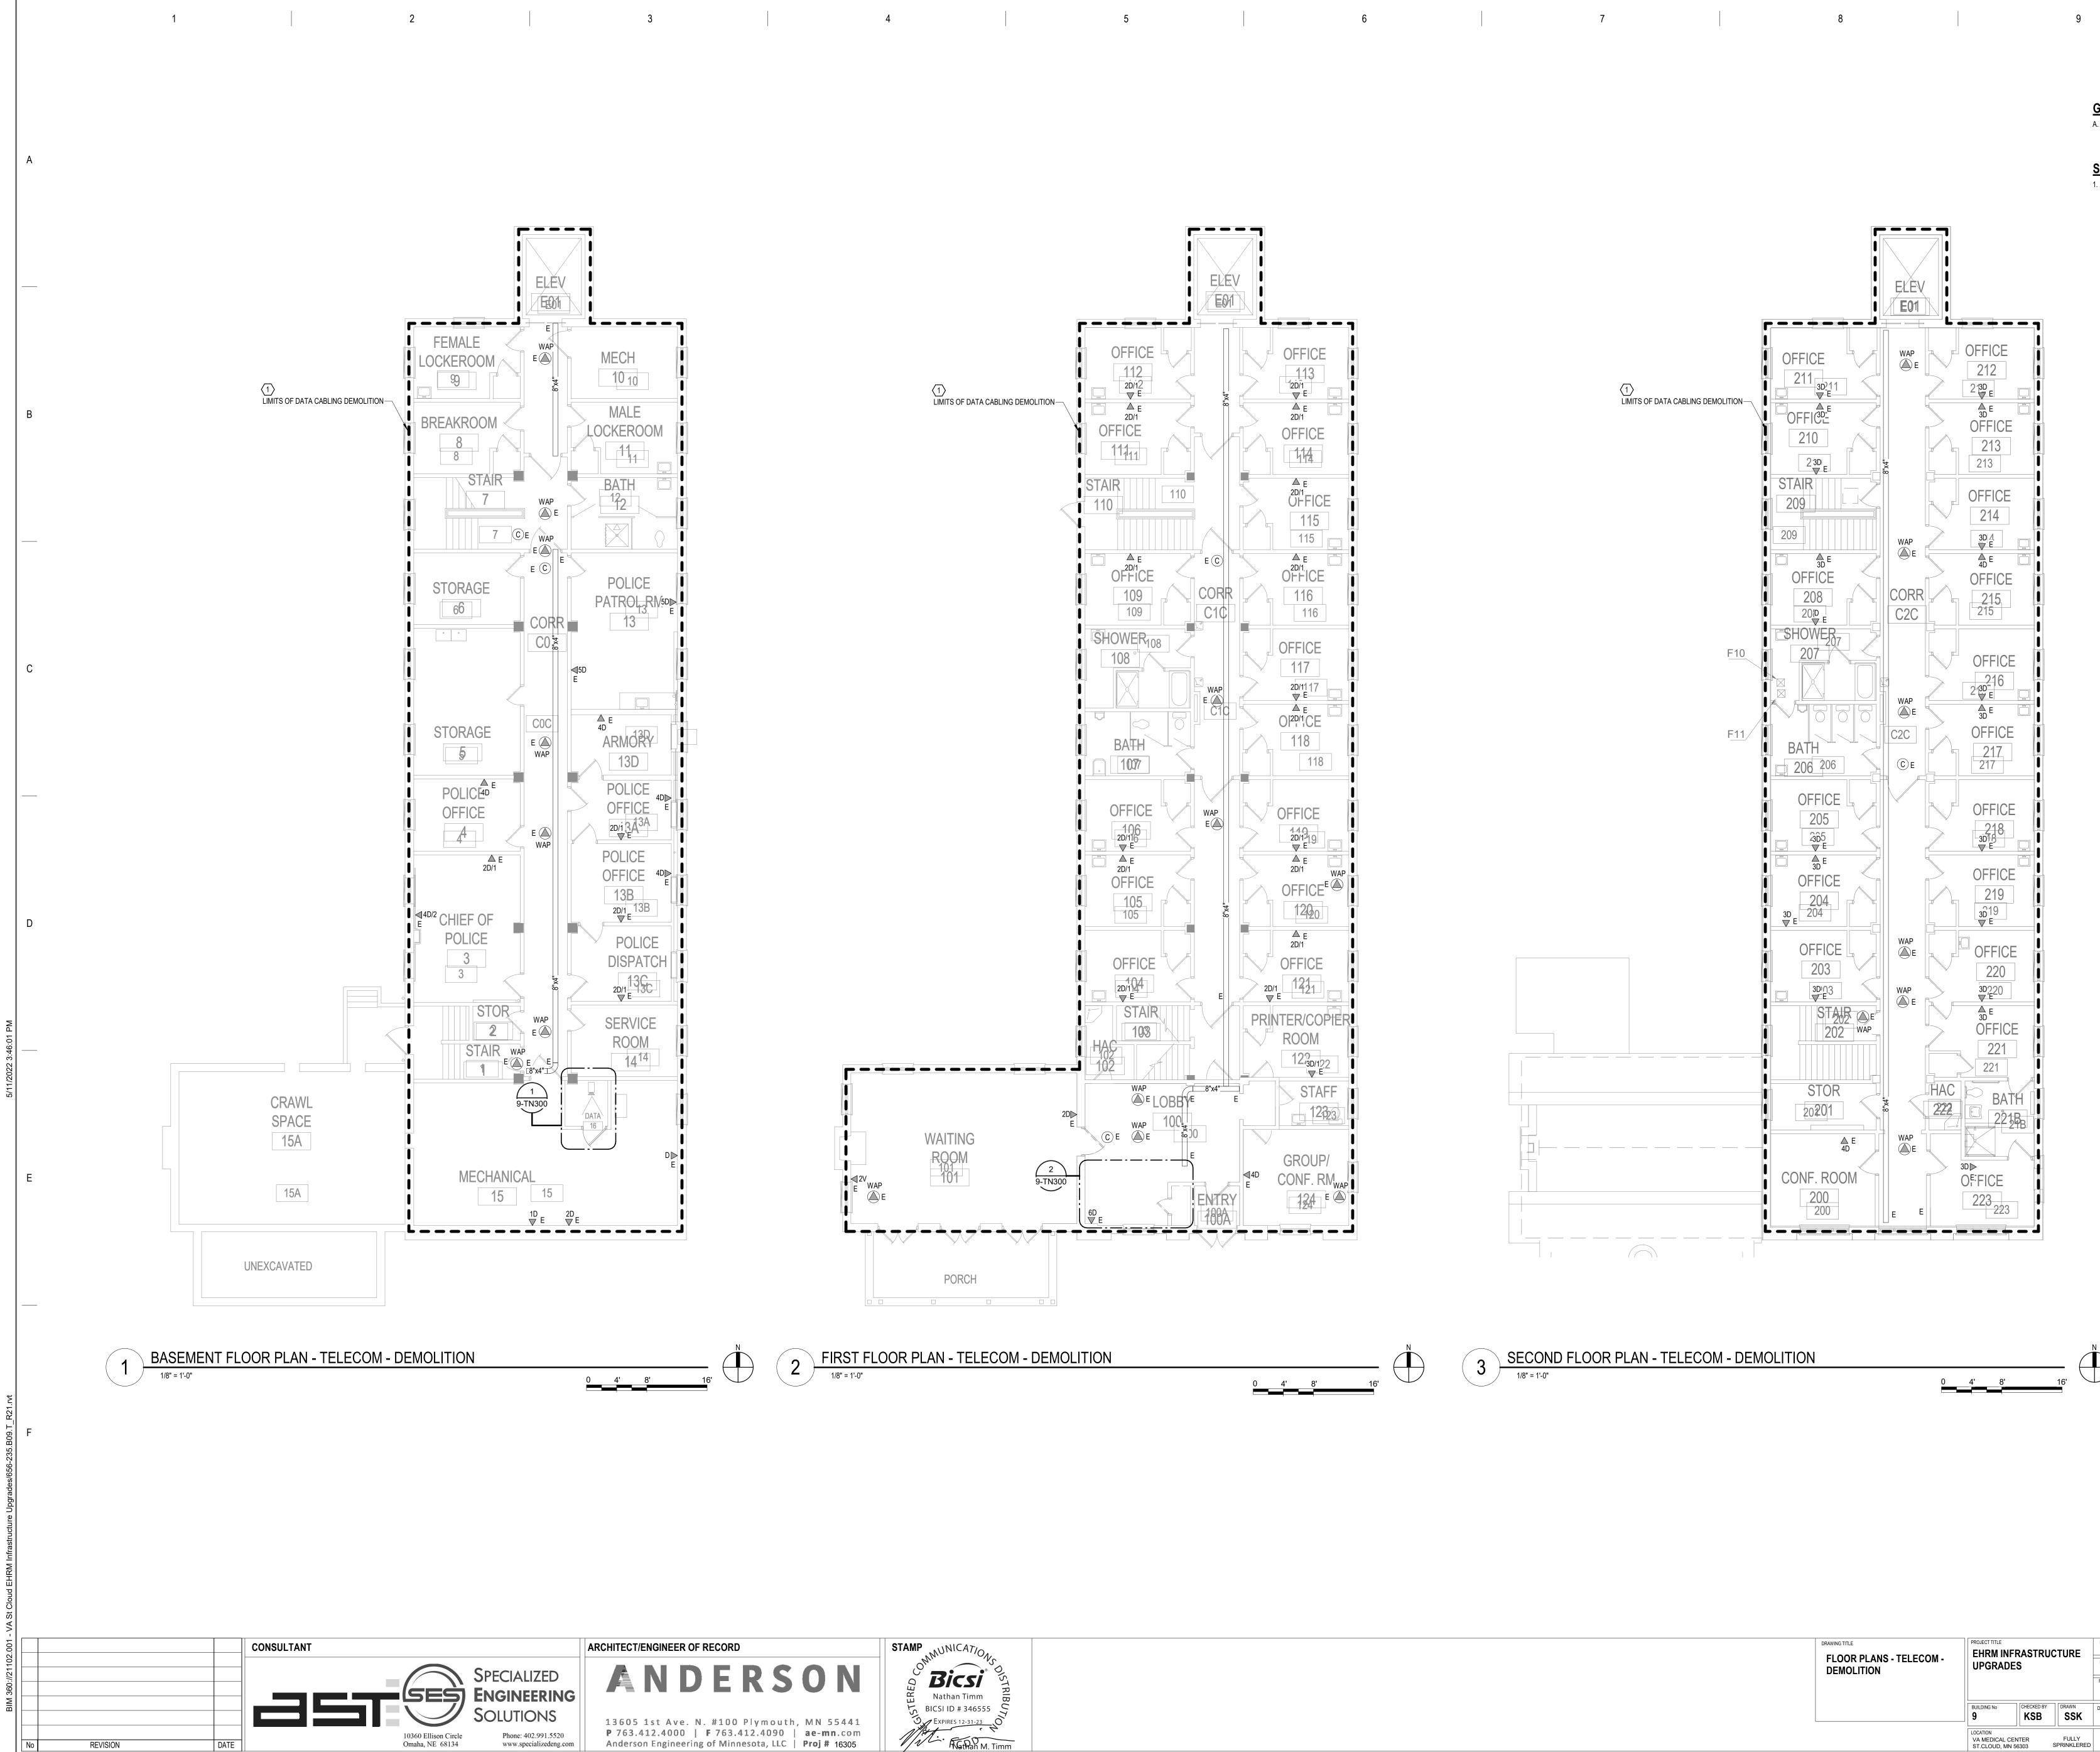



North:	Drawing Title ARCHITECTURAL PLAN BUILDING 9 Scale: 1/8" = 1'-0"	VETERANS	BESTOS RE- S ADMINISTRA ICAL CENTER DUD, MINNESC	ATION R	Date NOVEMBER 2019 Project No. 36C26319P1003
W E	Approved : Division Chief	Building Number	Checked BLB	Drawn AFS	Drawing No.
s	Approved : Service Director	Location ST. CLO	UD, MINNES	BOTA	4A Sheet 26 of 71



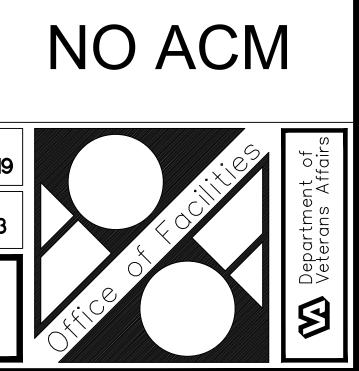

DRAWING TITLE BASEMENT, FIRST, AND SECOND FLOOR PLANS	PROJECT TITLE EHRM IN UPGRAD	FRASTRU	CTURE	DATE: 03/30/2022 PLOT SCALE PROJECT NO. 656-21-235	VA
	BUILDING No 9	CHECKED BY	DRAWN EM	DRAWING NO. 9-AS100	
	LOCATION VA MEDICAL C ST.CLOUD, MM		FULLY SPRINKLERED	DWG. OF	




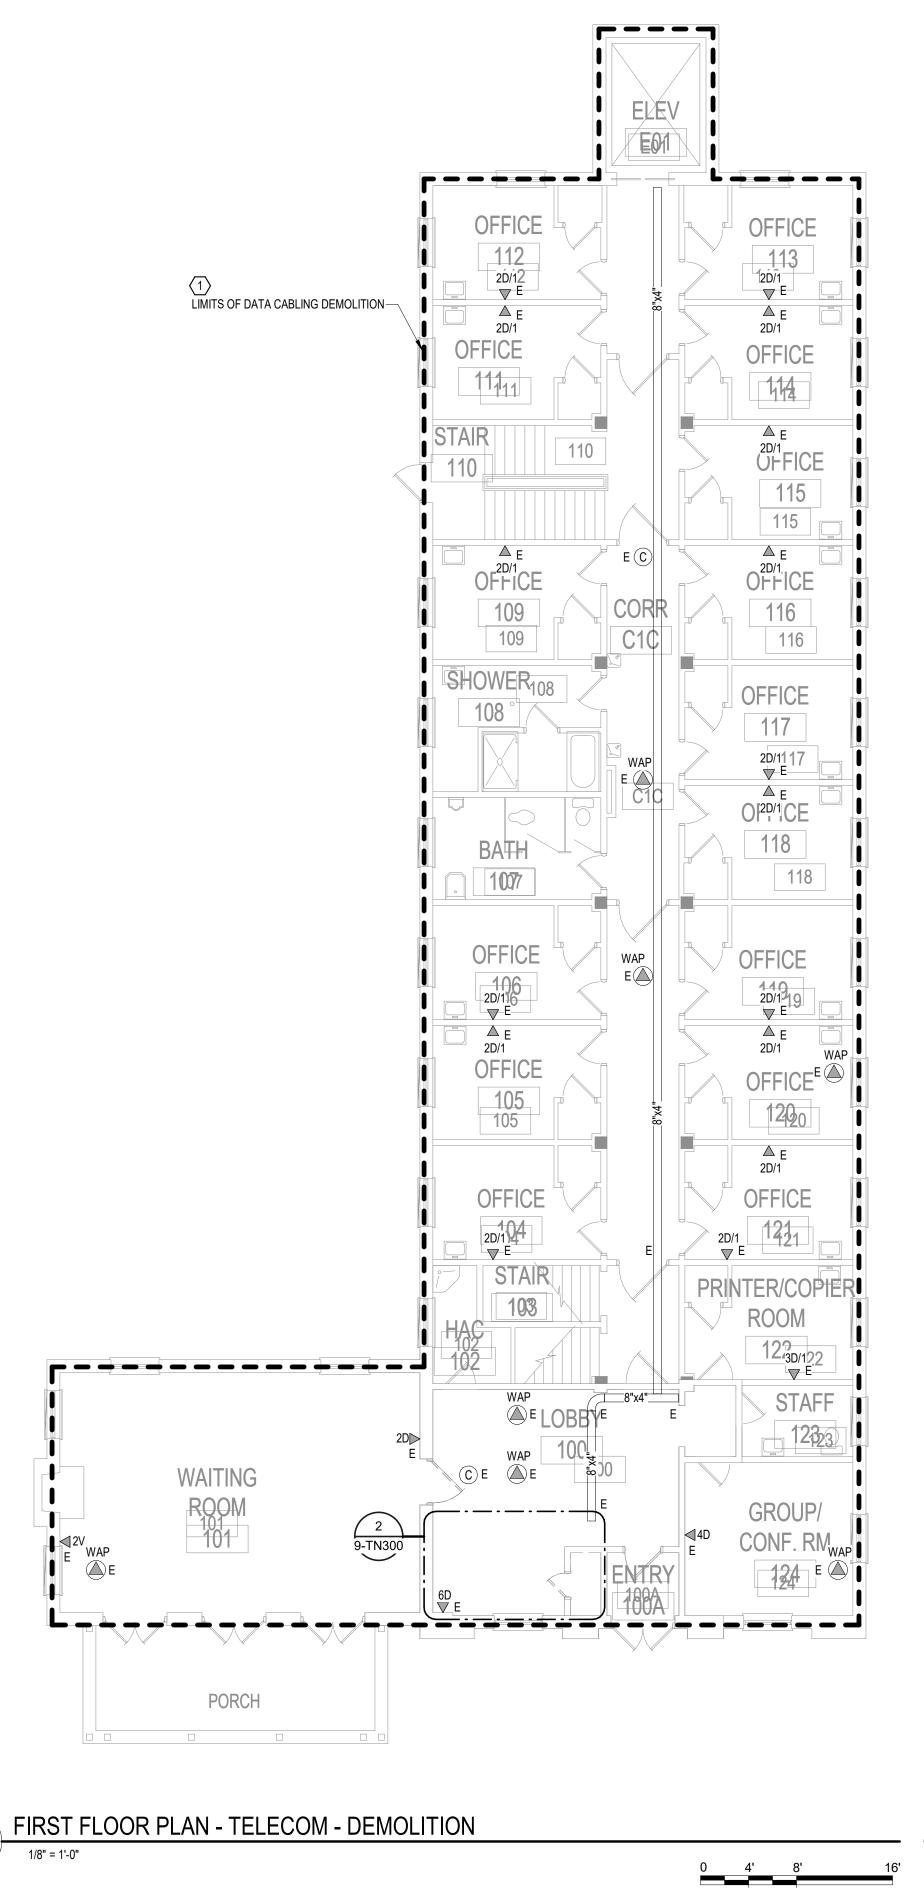

GENERAL NOTES: A. REFER TO GENERAL DEMOLITION

<u>SHEET NOTES:</u> 1. REMOVE AND REPLACE EXISTING I THROUGHOUT THIS AREA. REPLAC REFER TO NEW WORK PLANS FOR

ROUTES.

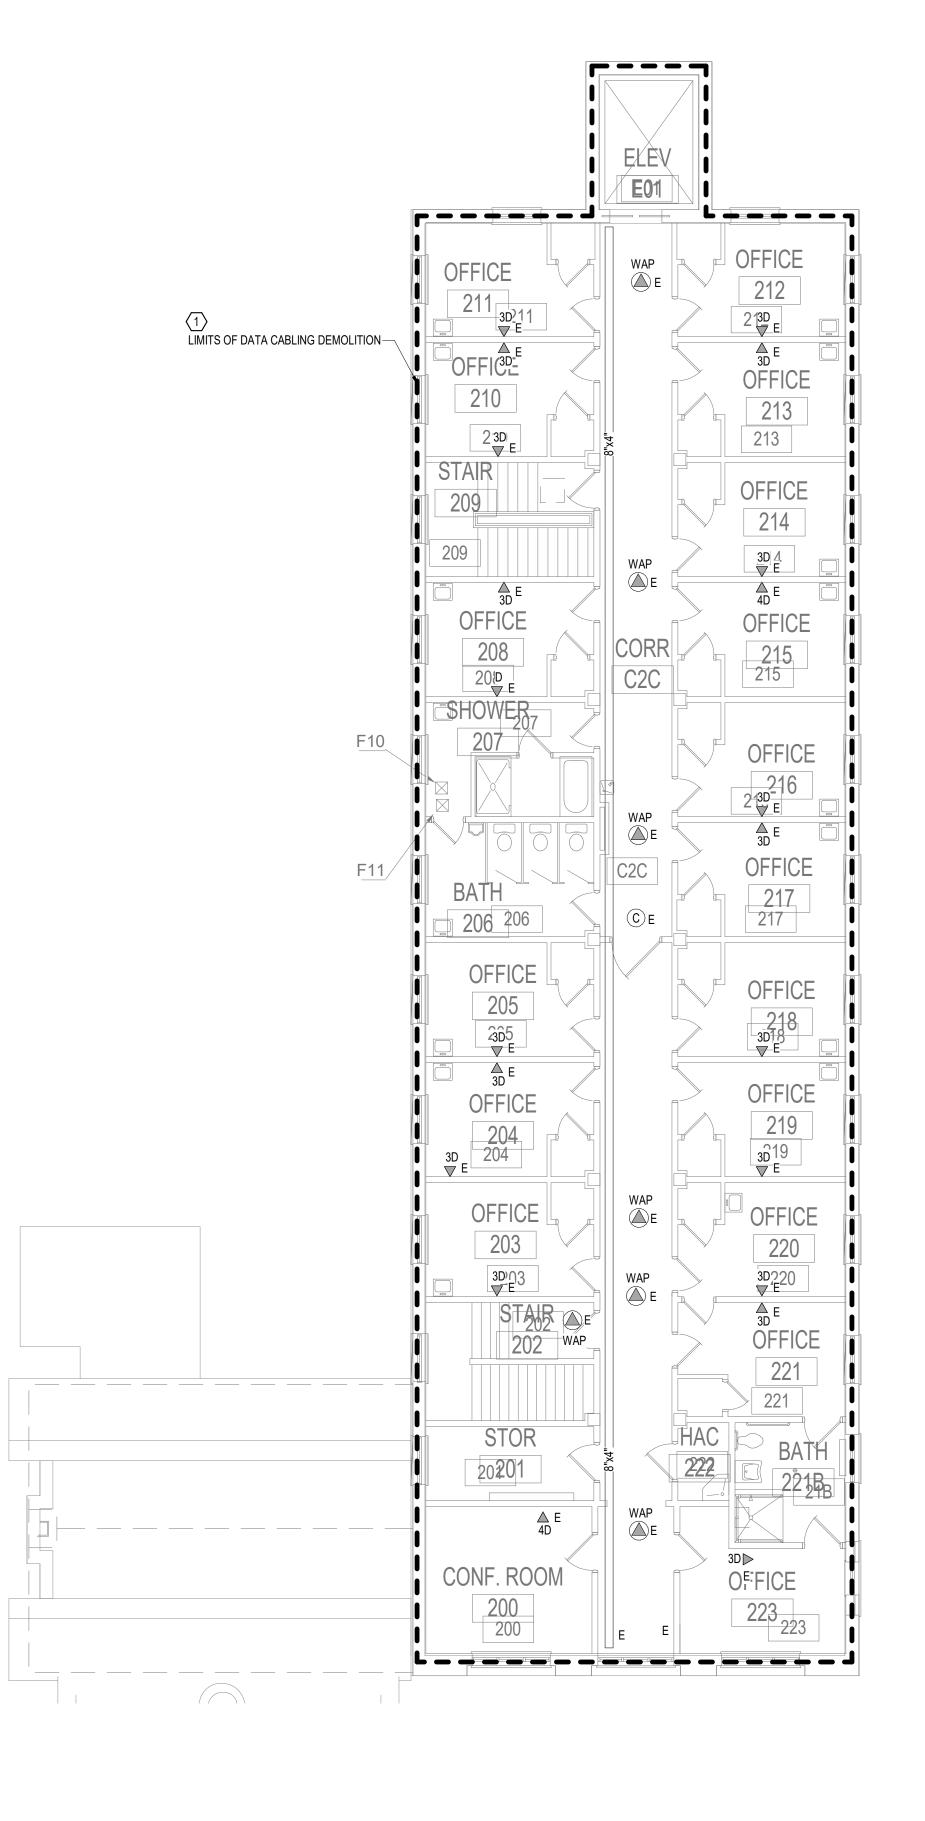



3 SECOND FLOOR PLAN - TELECOM - DEMOLITION 1/8" = 1'-0"


DRAWING TITLE FLOOR PLANS - TELECOM - DEMOLITION	PROJECT TITLE EHRM INFI UPGRADE		ICTURE	DATE: 03/30/2022 PLOT SCALE PROJECT NO. 656-21-235	VA
	BUILDING No 9	CHECKED BY	DRAWN	DRAWING NO. 9-TD100	
	LOCATION VA MEDICAL CEN ST.CLOUD, MN 5		FULLY SPRINKLERED	DWG. OF	

10	
ON NOTES ON SHEET T000 FOR ADDITIONAL DEMOLITION SCOPE. IG DATA CABLE: REMOVE ALL EXISTING DATA CABLES AND JACKS LACE CABLES AND JACKS 1 FOR 1, AS REQUIRED BY THE NEW WORK PLANS. OR SERVING COMMUNICATIONS ROOM LOCATION AND NEW CABLING	A
	В
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3 SECOND FLOOR PLAN - TELECOMMUNICATIONS


DRAWING TITLE FLOOR PLANS - TELECOMMUNICATIONS	PROJECT TITLE EHRM INFI UPGRADE		ICTURE	DATE: 03/30/2022 PLOT SCALE PROJECT NO. 656-21-235	VA
	BUILDING № 9	CHECKED BY	drawn SSK	drawing no. 9-TN100	
	LOCATION VA MEDICAL CEN ST.CLOUD, MN 5		FULLY SPRINKLERED	DWG. OF	

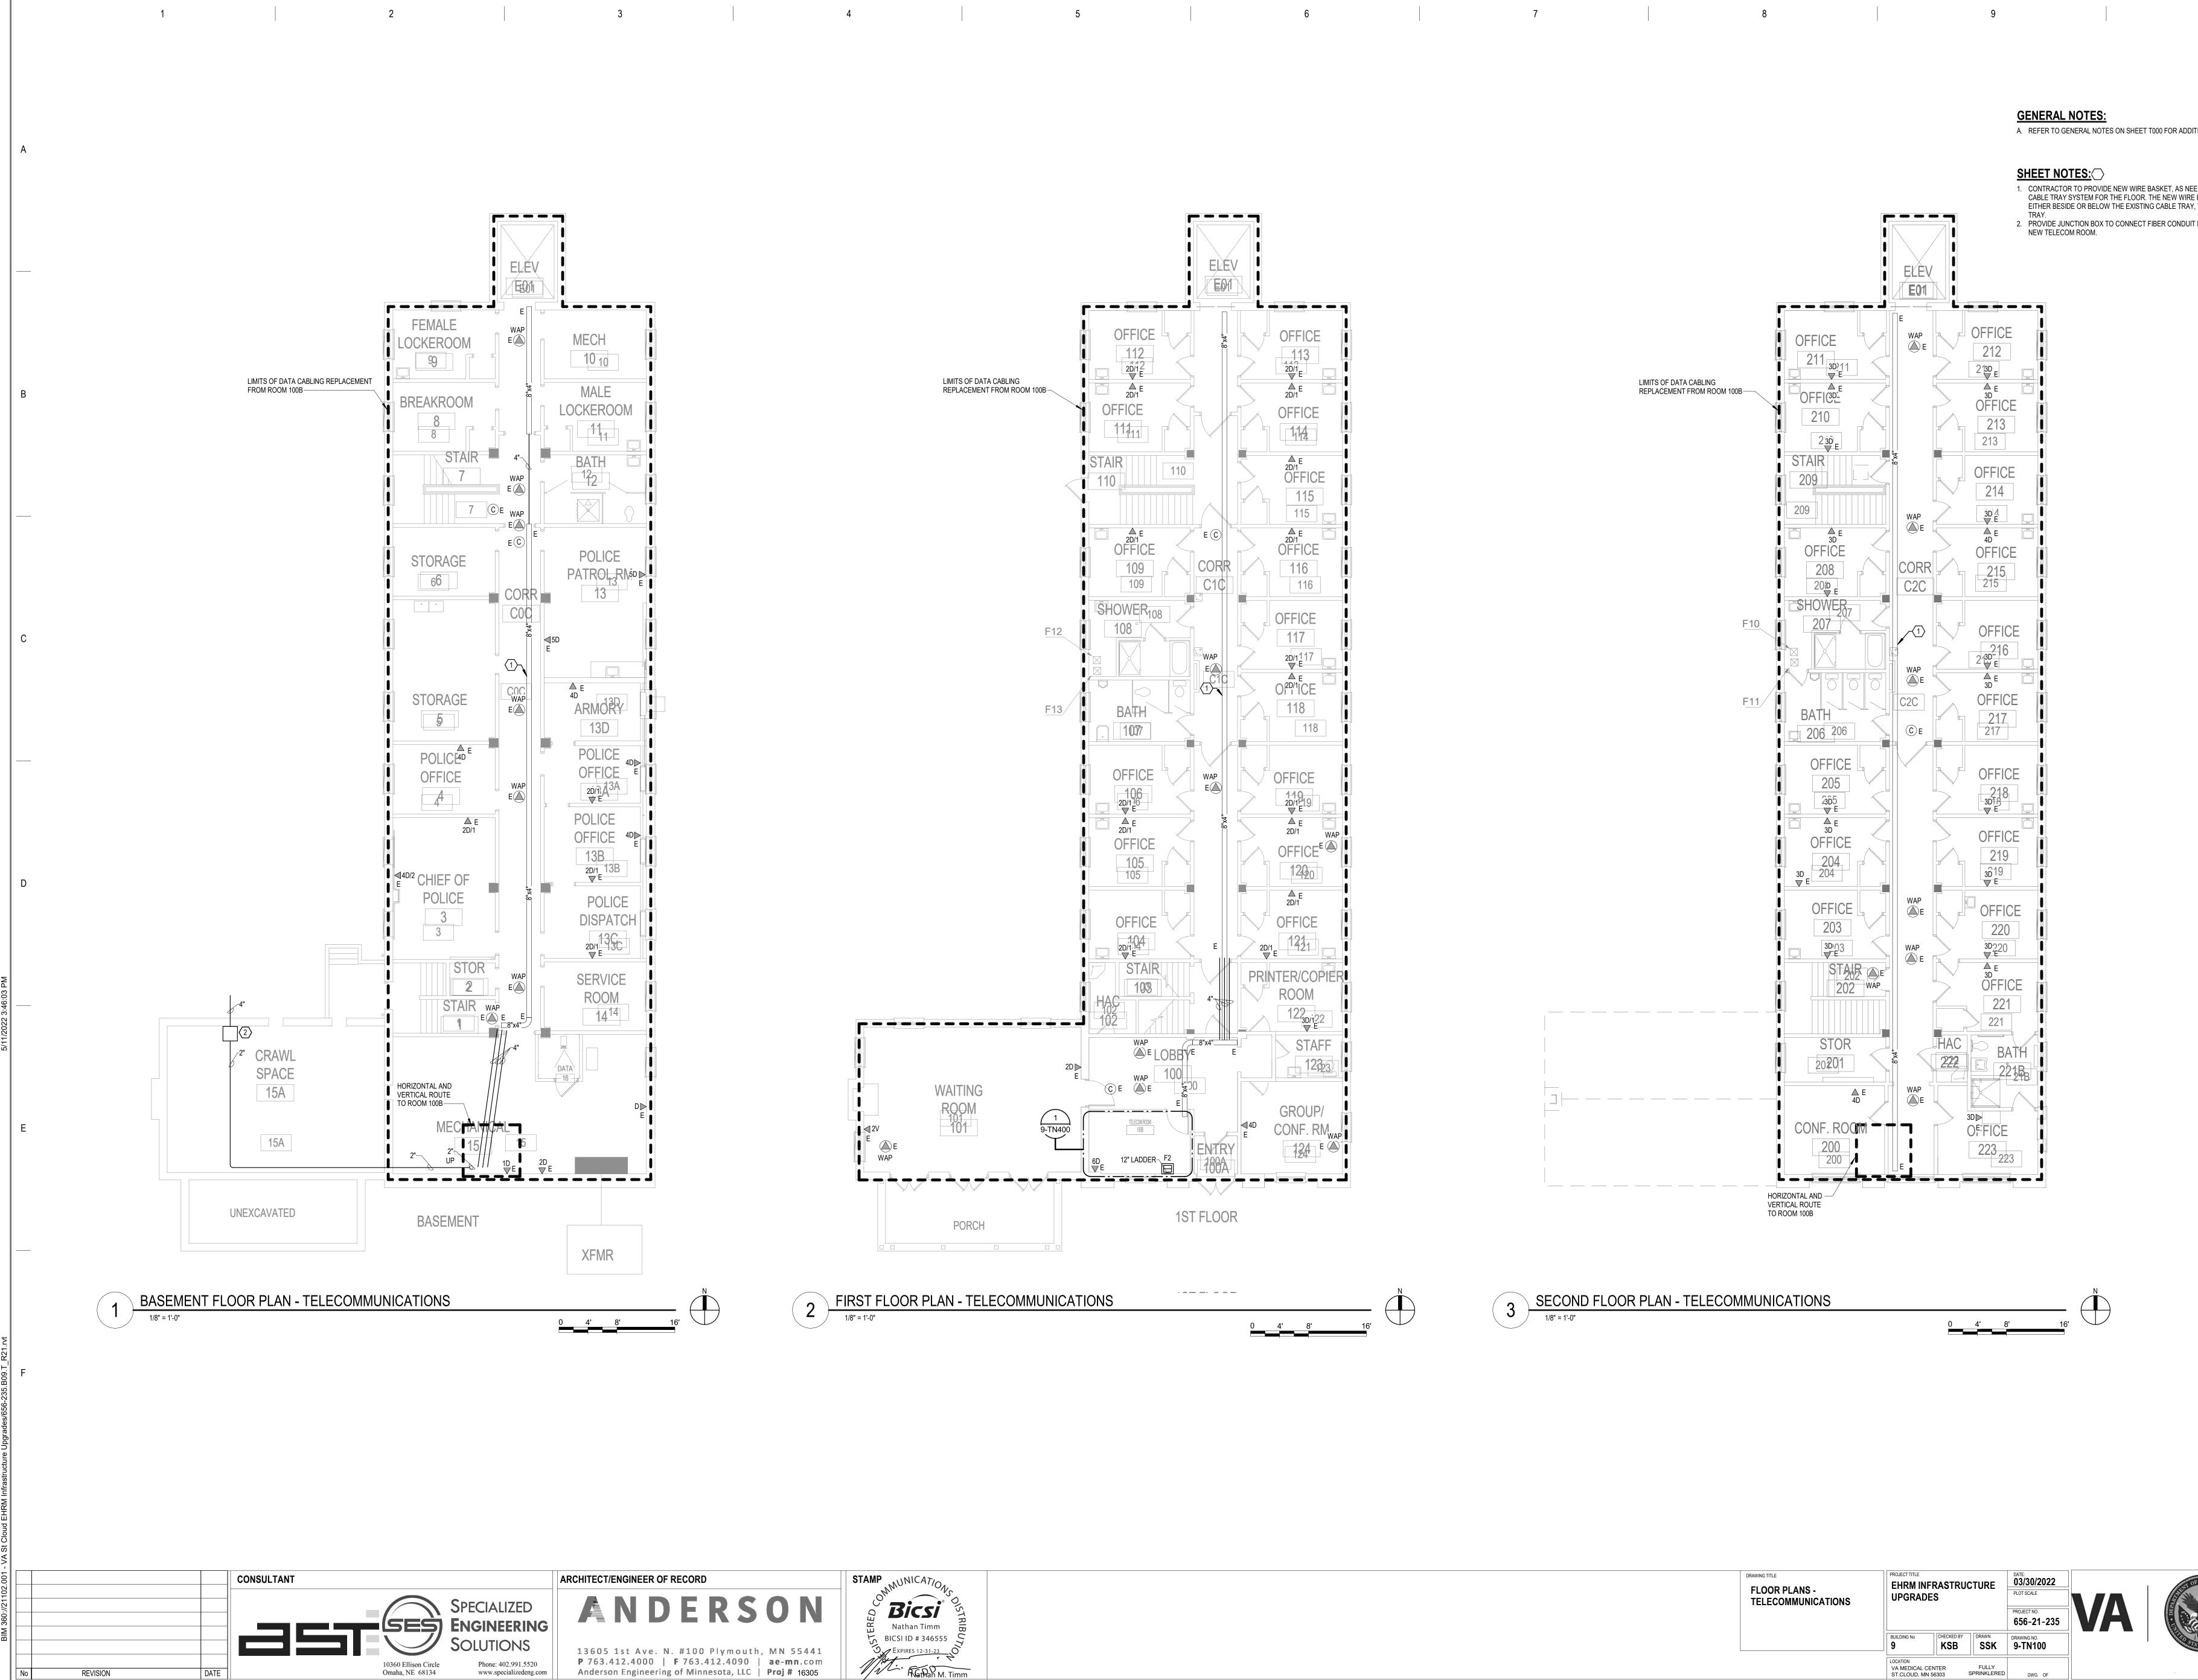A. REFER TO GENERAL NOTES ON SHEET T000 FOR ADDITIONAL SCOPE.

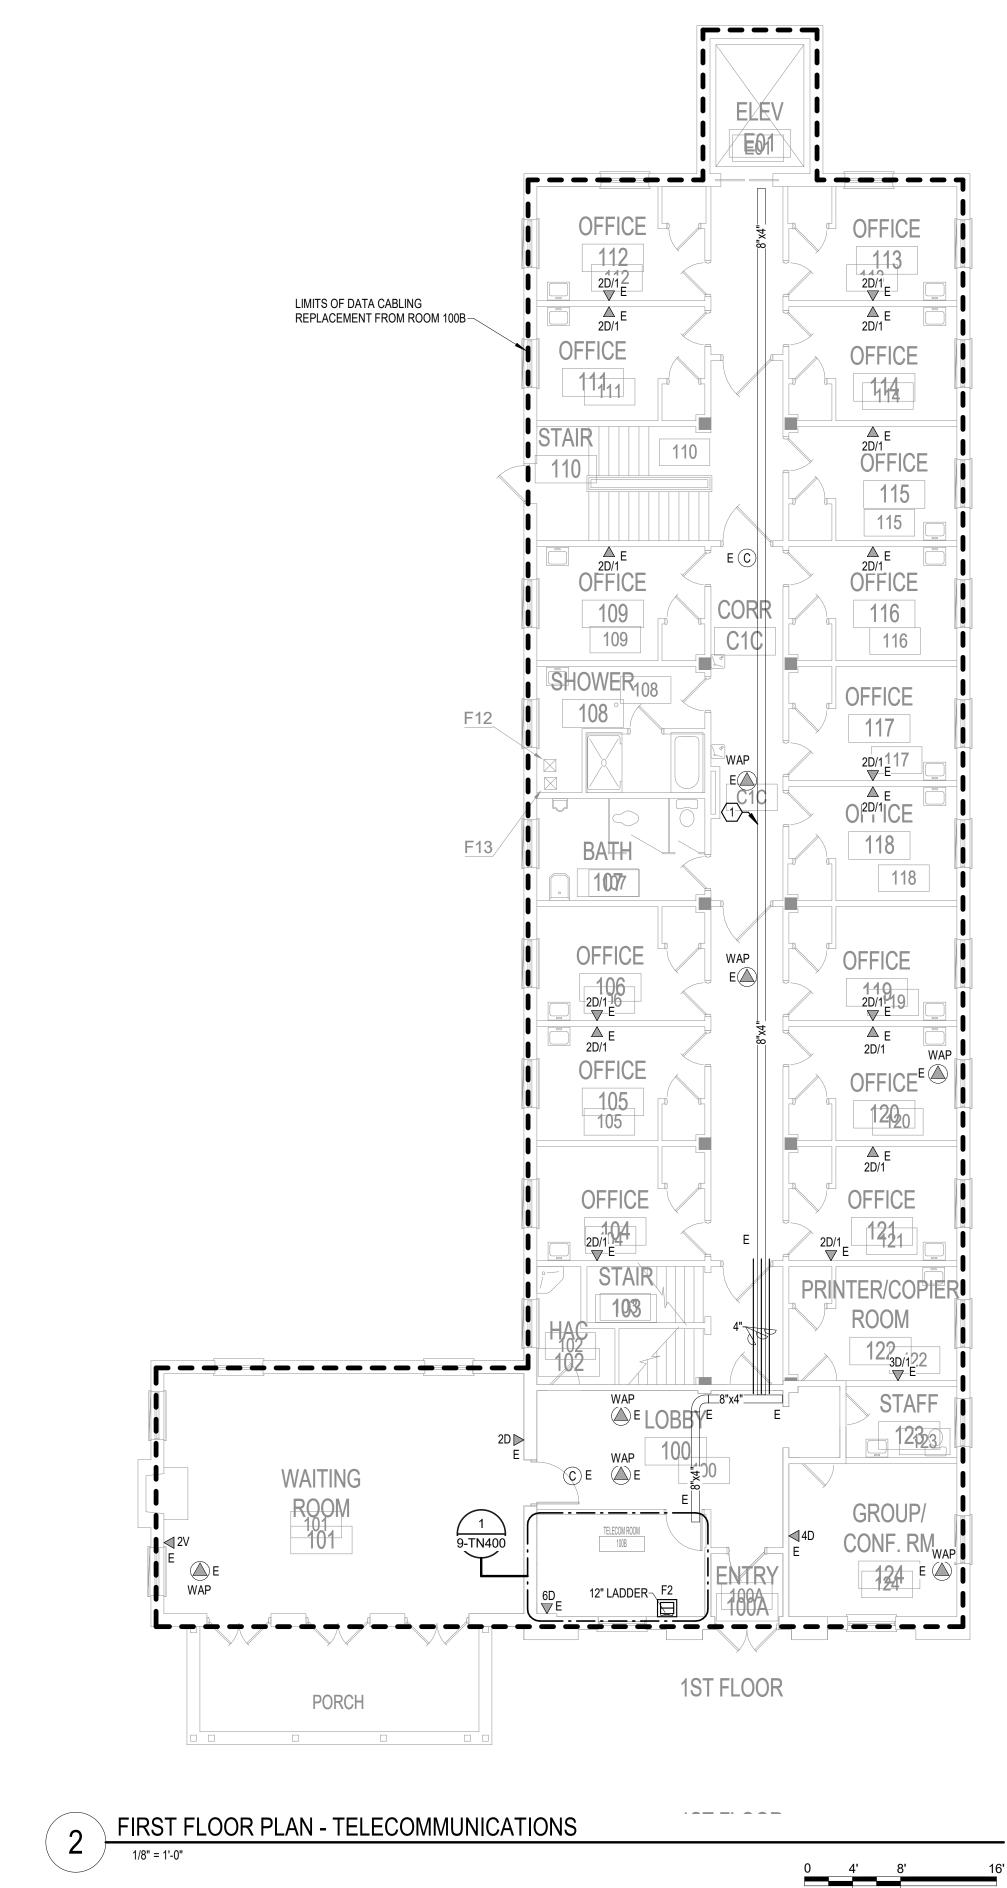1. CONTRACTOR TO PROVIDE NEW WIRE BASKET, AS NEEDED, TO MAINTAIN A 50% OR LESS FILL OF THE CABLE TRAY SYSTEM FOR THE FLOOR. THE NEW WIRE BASKET WILL MATCH THE SIZE AND DISTANCE, EITHER BESIDE OR BELOW THE EXISTING CABLE TRAY, TO MATCH THE EXISTING TELECOM CABLE 2. PROVIDE JUNCTION BOX TO CONNECT FIBER CONDUIT ENTRY TO EXTEND CONDUIT PATHWAY TO THE

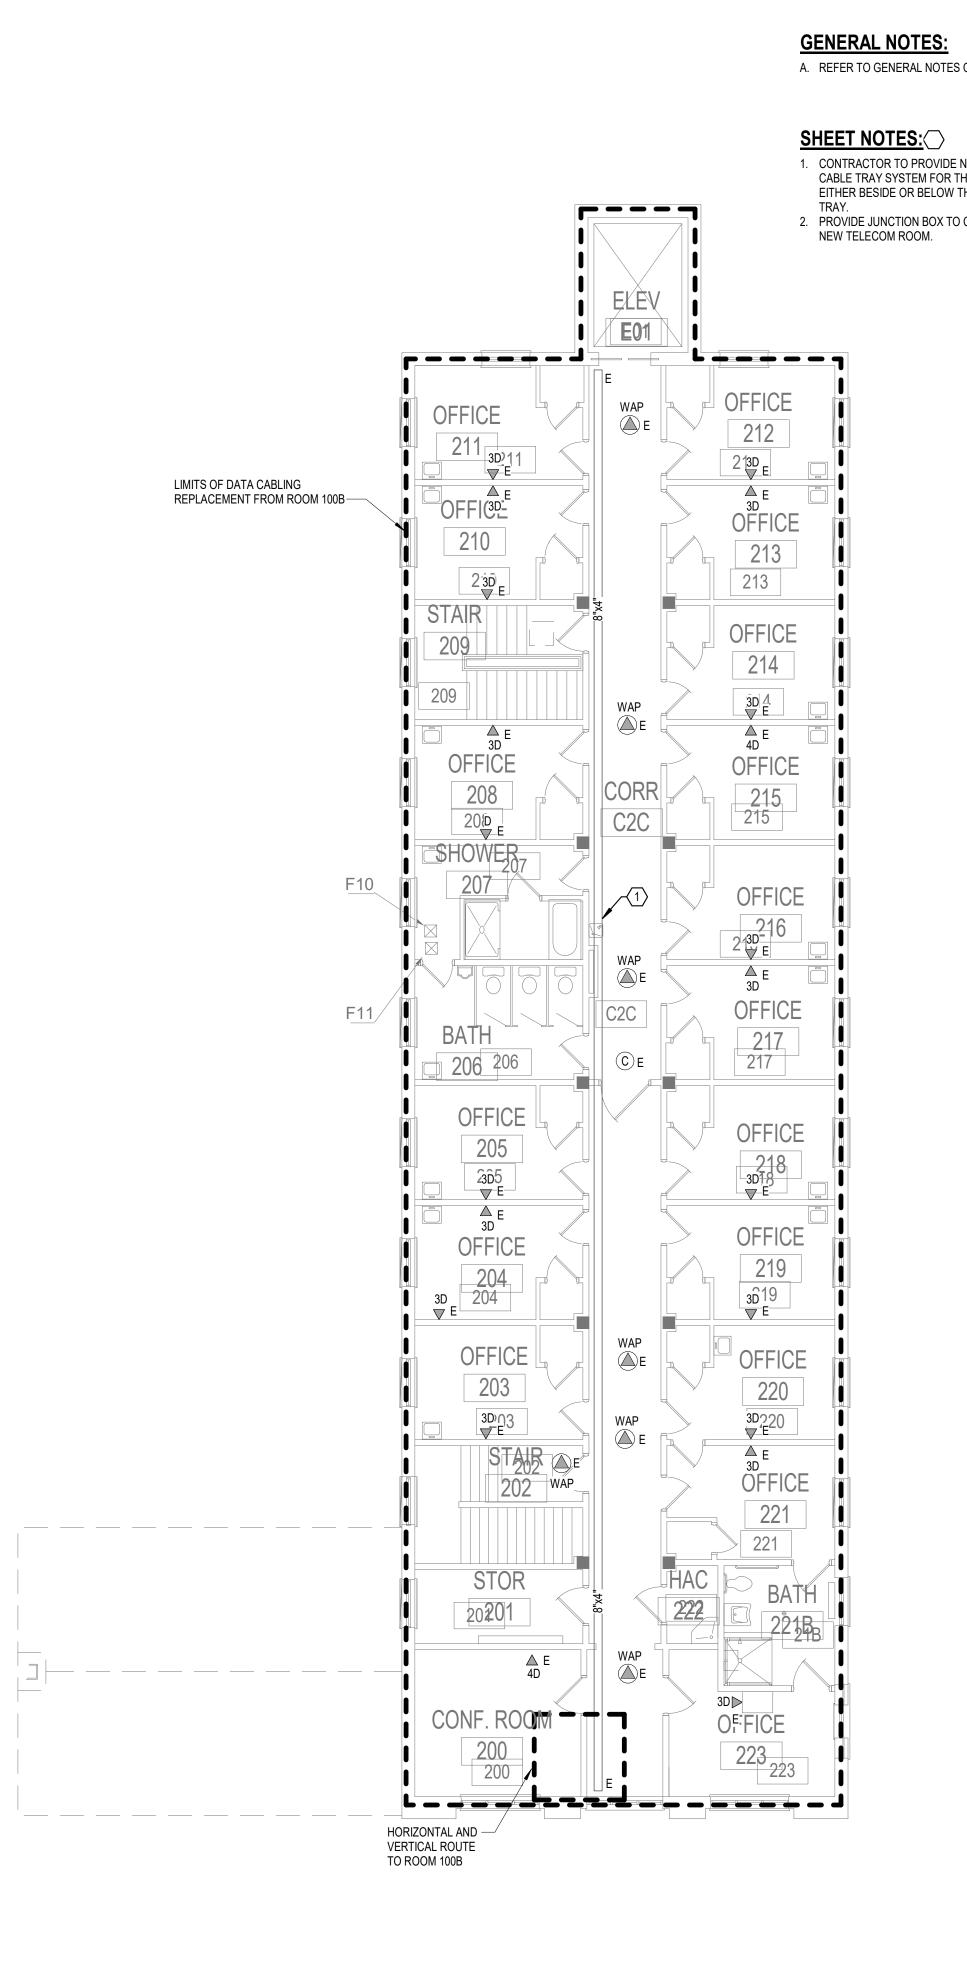
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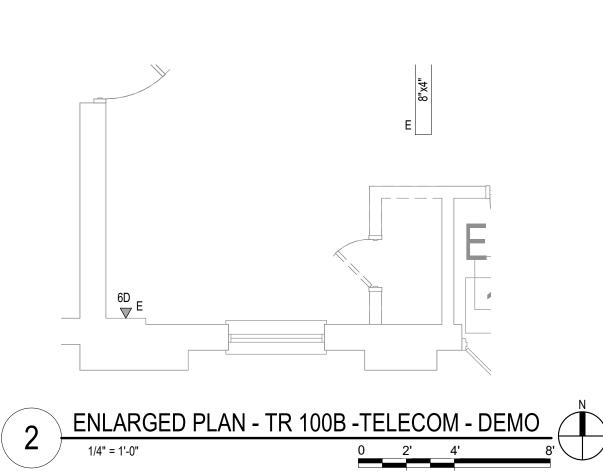


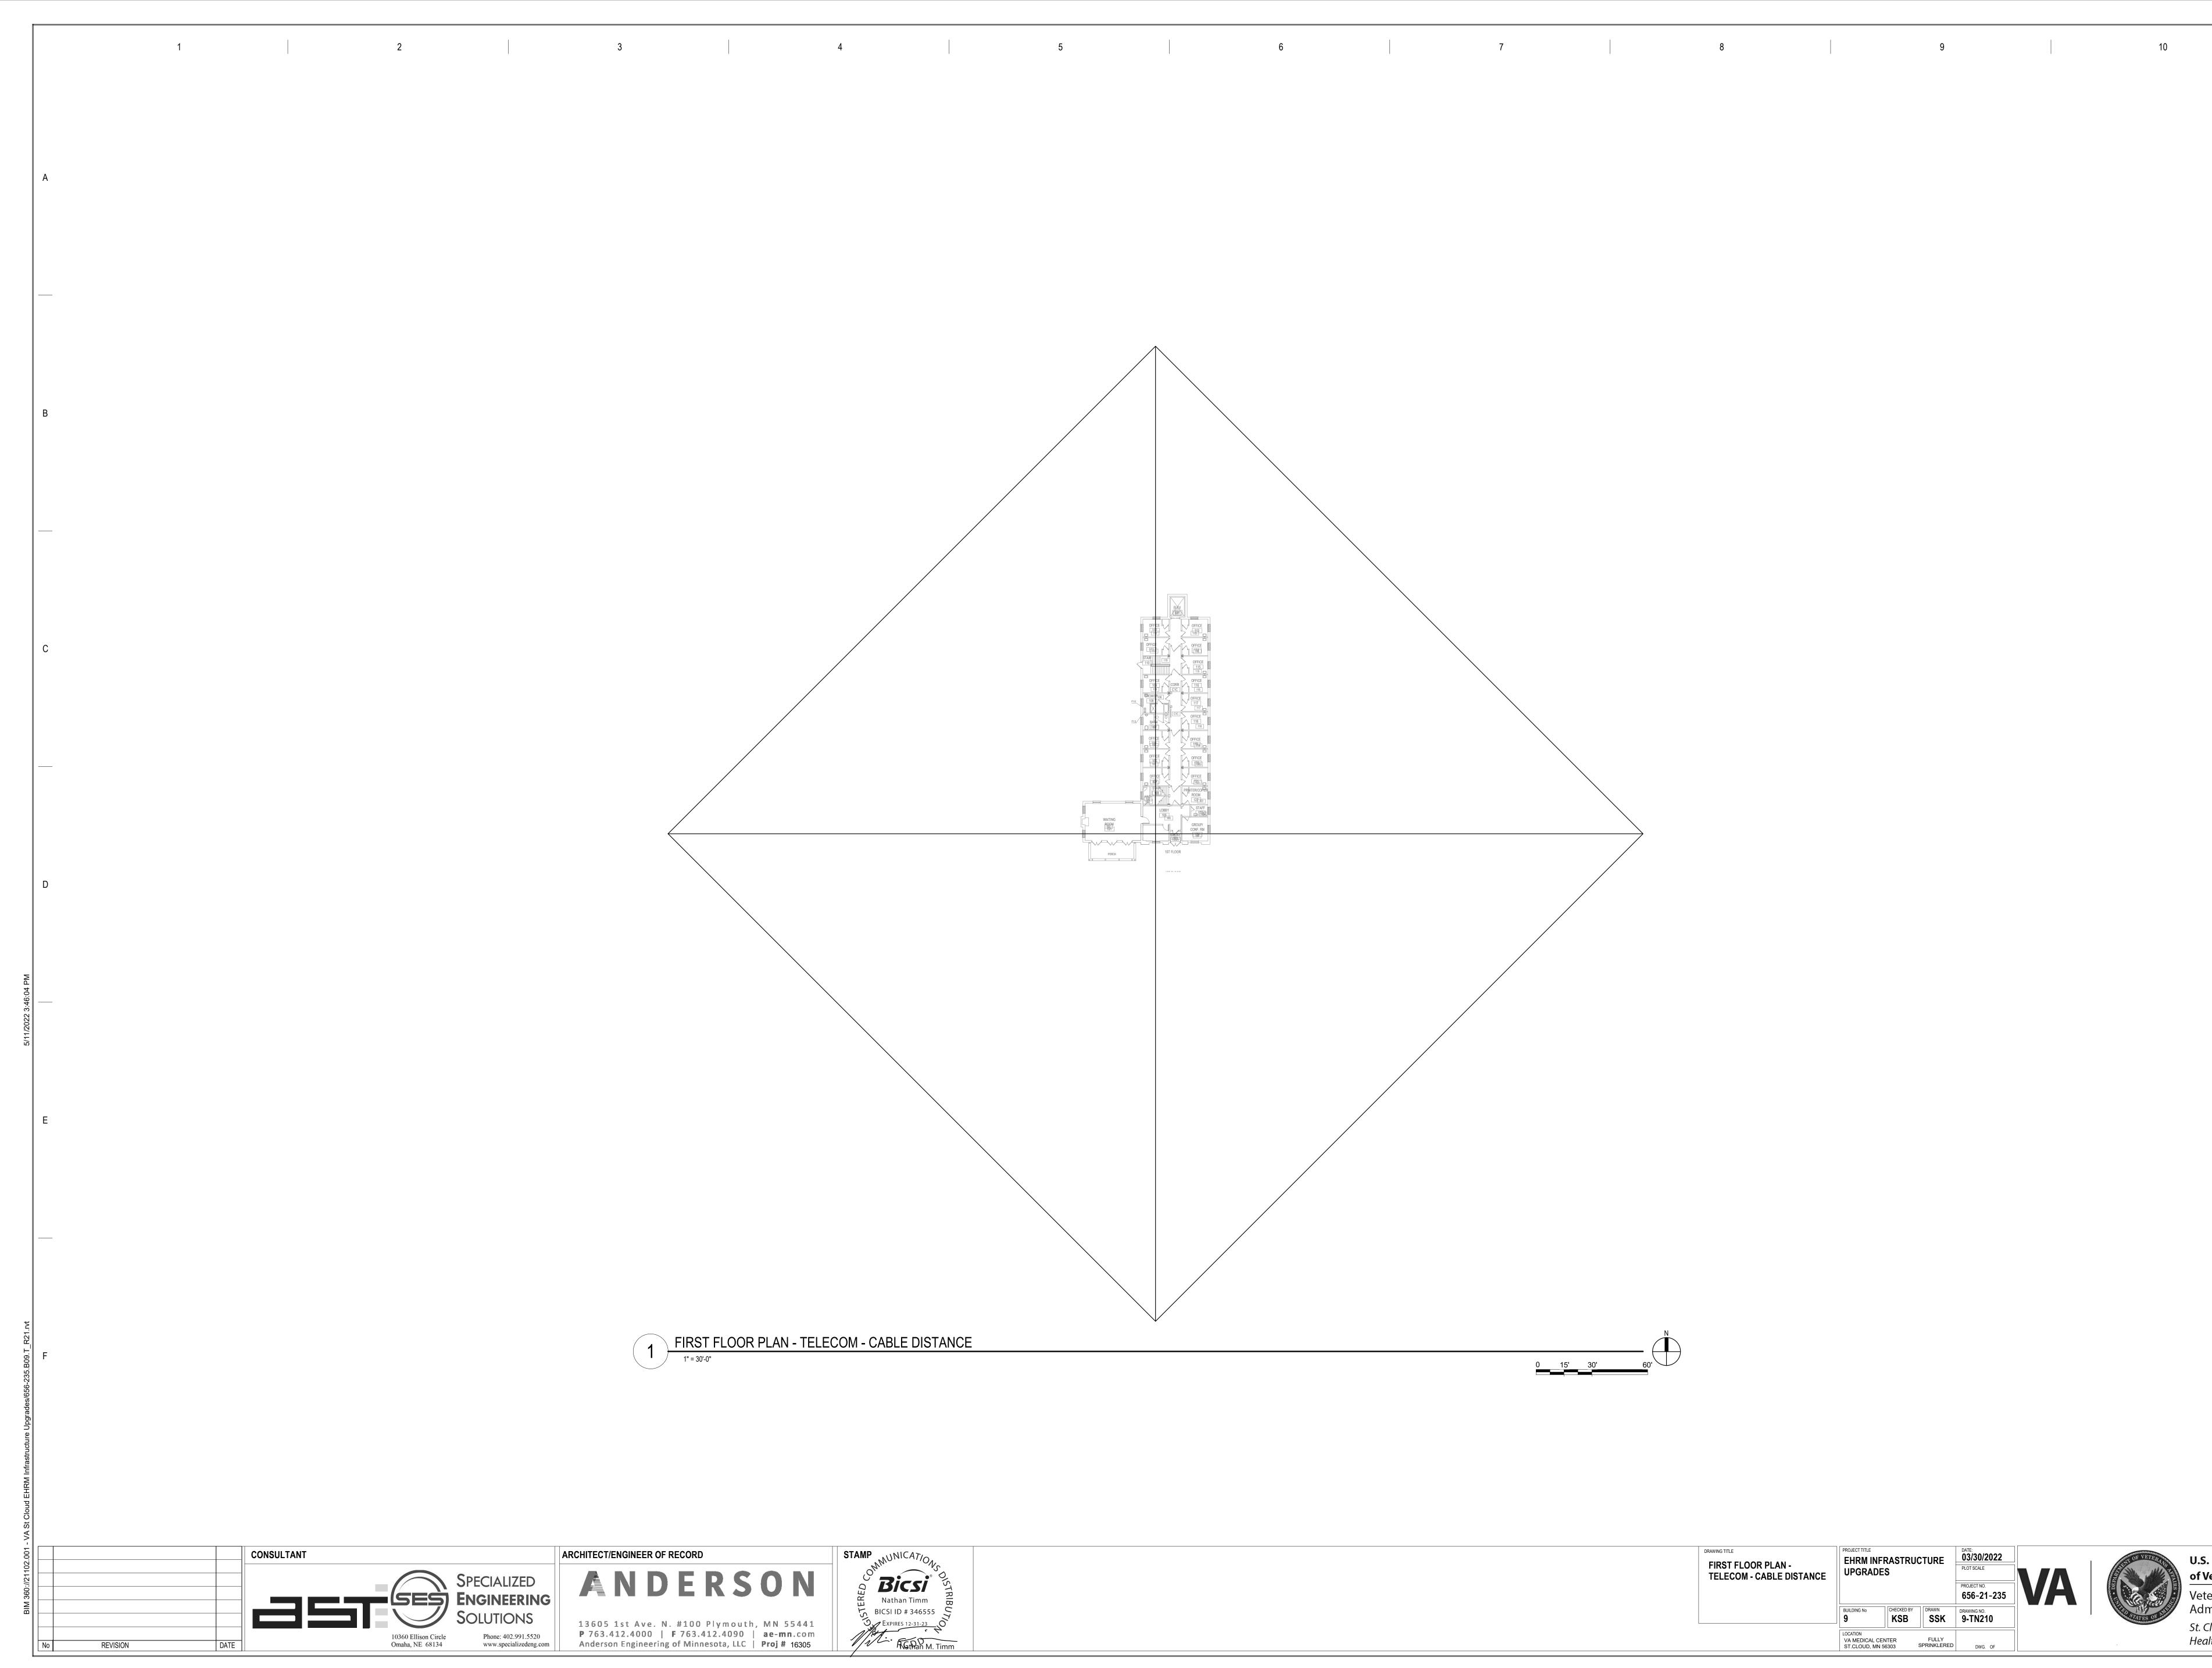

DRAWING TITLE FIRST FLOOR PLAN - TELECOM - CABLE DISTANCE	EHRM INFRASTRUCTURE UPGRADES			DATE: 03/30/2022 PLOT SCALE	
				PROJECT NO. 656-21-235	
	BUILDING No	CHECKED BY	DRAWN SSK	DRAWING NO. 9-TN210	
	LOCATION VA MEDICAL CI ST.CLOUD, MN		FULLY SPRINKLERED	DWG. OF	





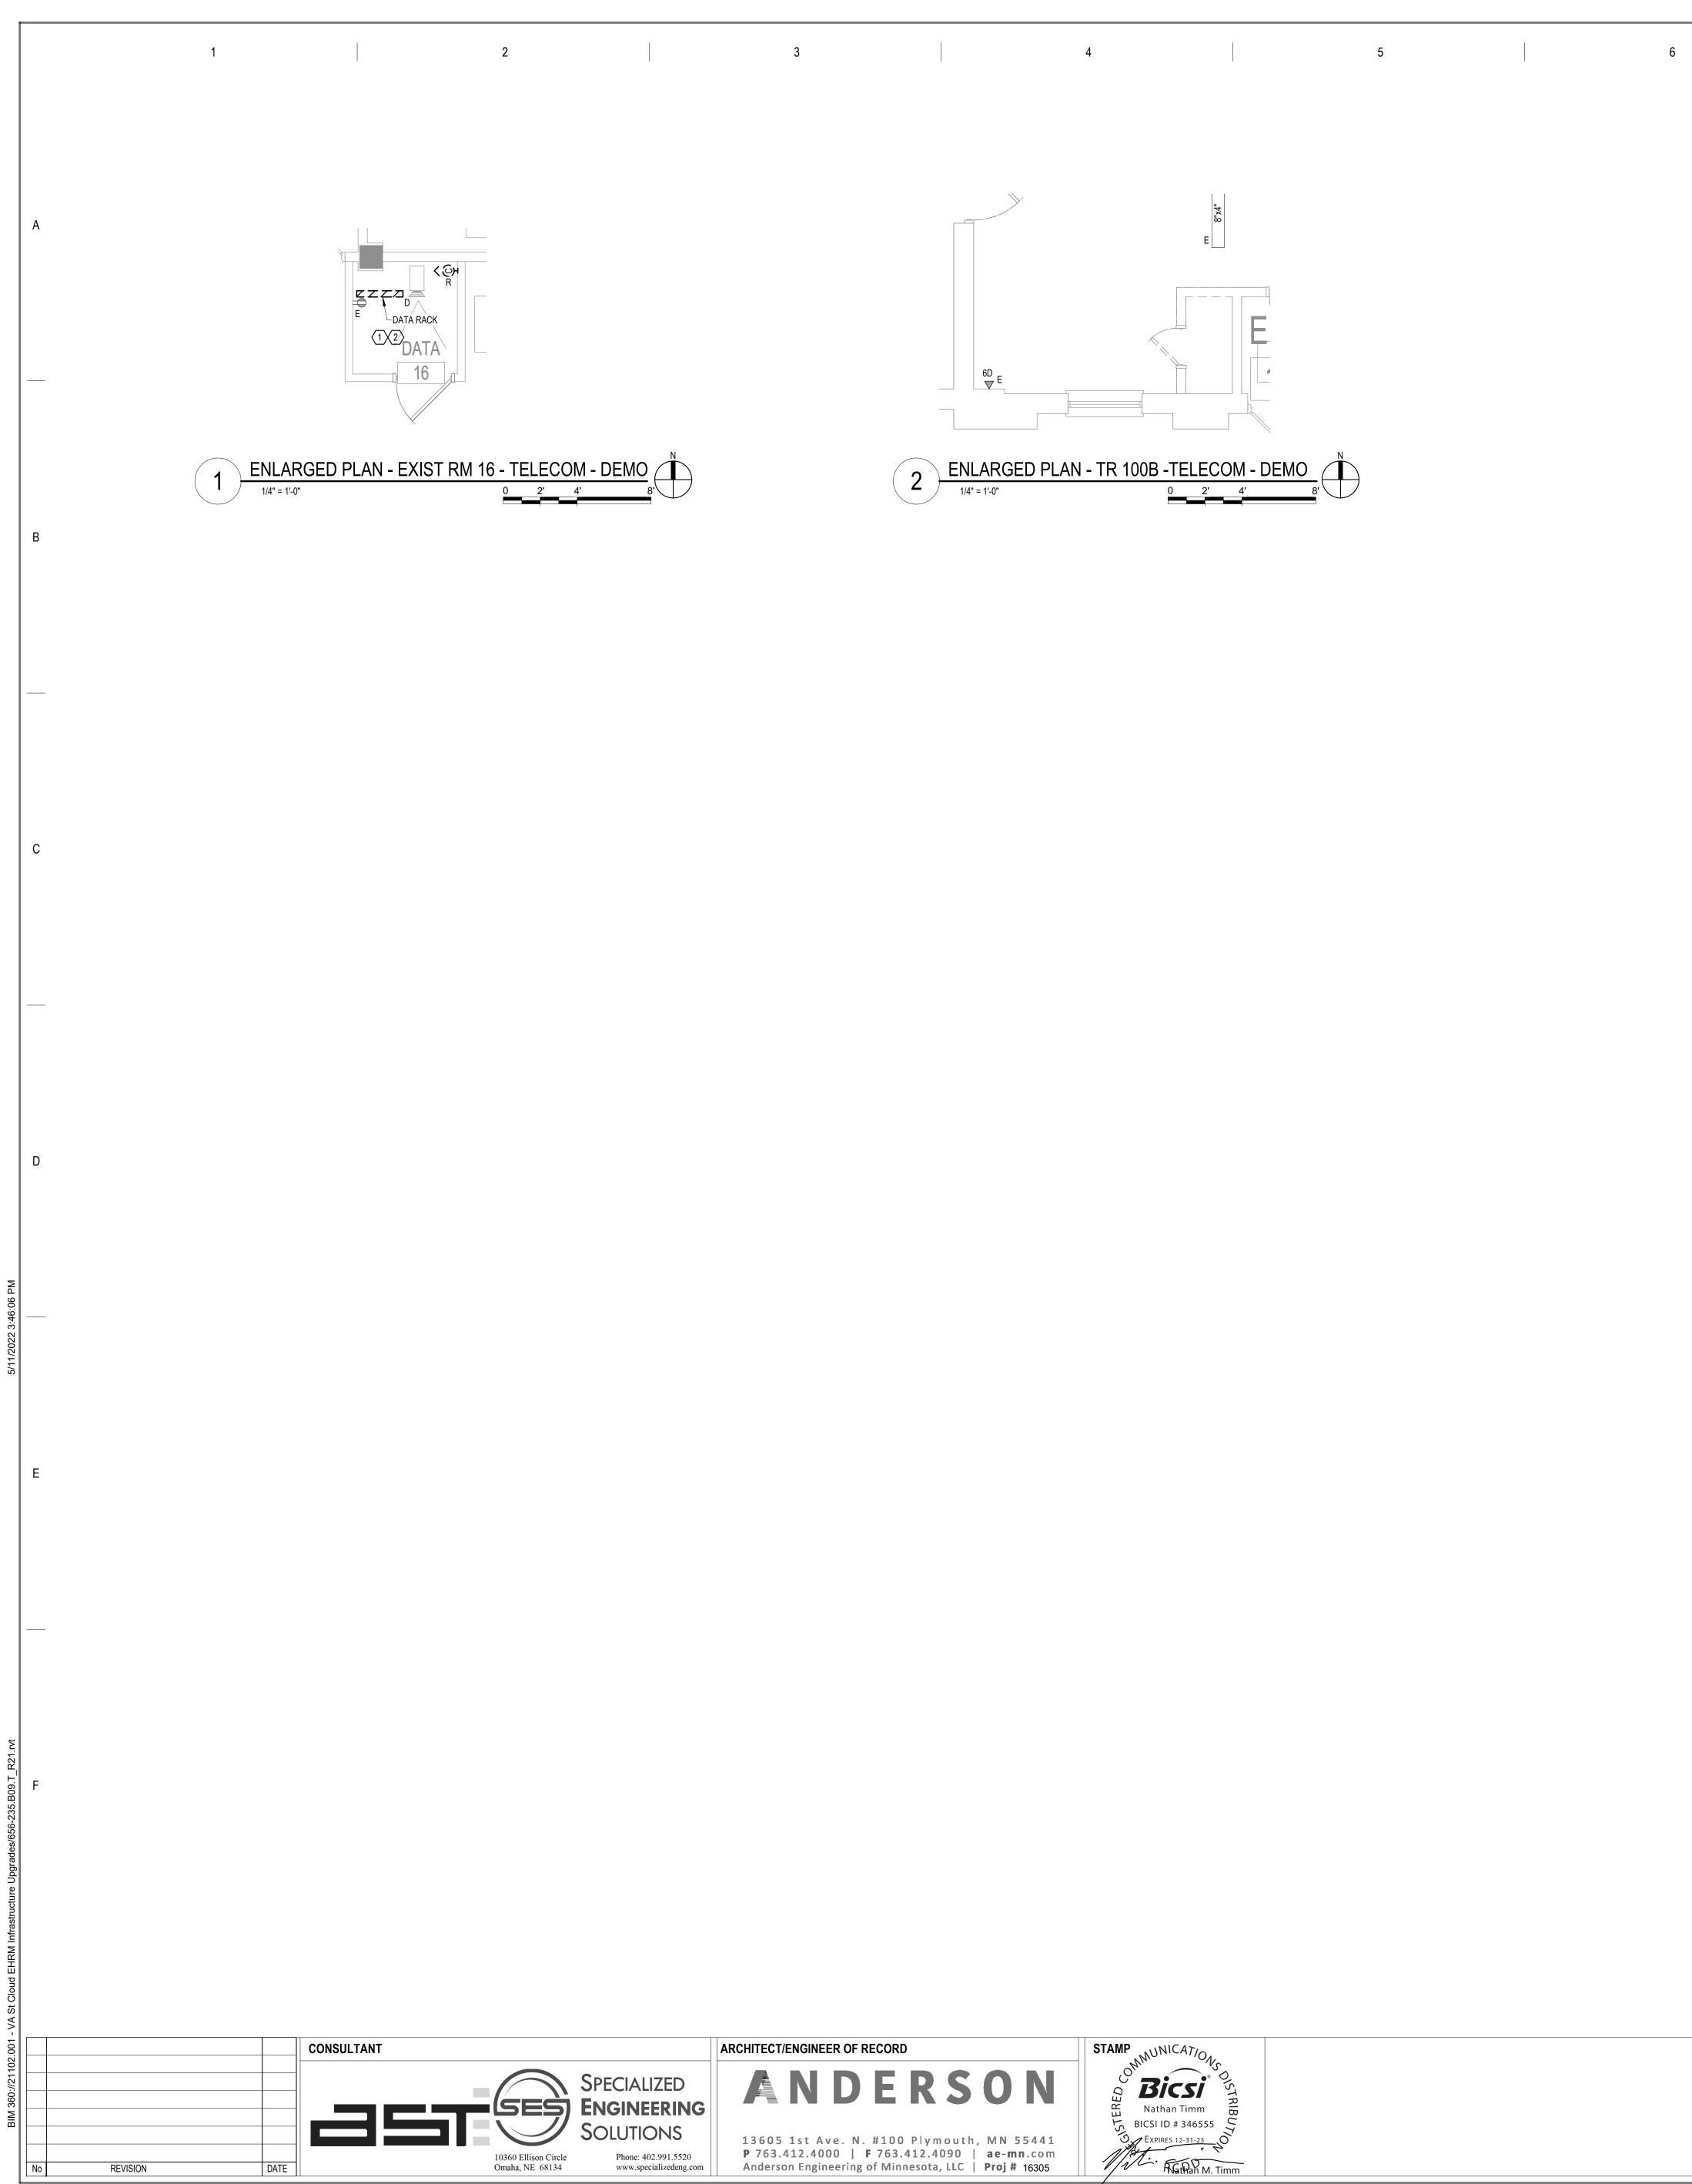



7	8	9	
			L NOTES: GENERAL DEMOLITION NO
		EXISTING C/ FROM DISTF GENERAL C. COMMUNIC/ 2. EXISTING C/	DTES: ELECOMMUNICATIONS CAG ABLING AND ASSOCIATED C ABLING NOTES FOR APPRC ABLING NOTES FOR APPRC ATIONS ROOM LOCATION A ABLE TRAY, SECURITY CAM TO BE REUSED, WHEN PO
		RELOCATIO	

DRAWING TITLE ENLARGED PLANS - TELECOMMUNICATIONS - DEMO	PROJECT TITLE EHRM INF UPGRADE		CTURE	DATE: 03/30/2022 PLOT SCALE PROJECT NO. 656-21-235	
	BUILDING No	CHECKED BY	DRAWN SSK	DRAWING NO. 9-TN300	
	LOCATION VA MEDICAL CE ST.CLOUD, MN		FULLY SPRINKLERED	DWG. OF	

N NOTES ON SHEET T000 FOR ADDITIONAL DEMOLITION SCOPE.

10

CAGE AND RACK SHALL BE INCLUDED WITHIN THE SCOPE OF DEMOLITION. ATED OUTLETS SHALL BE REMOVED AND REPLACED 1 FOR 1 AND REFED T LOCATED WITHIN THE NEW TELECOMMUNICATIONS ROOM. REFER TO APPROXIMATE QUANTITIES. REFER TO NEW WORK PLANS FOR SERVING FION AND NEW CABLING ROUTES. Y CAMERAS, GROUND BUS BARS, AND RACKS FROM DECOMMISSIONED EN POSSBILE, IN NEW CONSTRUCTION TRS.

E THE CABLES CURRENTLY PRESENT IN THE SPACE. THE CABLE EW OR RELOCATED CABLES TO BE FED FROM THE SPACE. THE FINAL THAT WILL BE PRESENT IN THE SPACE AT THE COMPLETION OF THE

PROJECT.

1. <u>ROOM 16</u> EXISTING CABLE COUNT DATA (CAT6): 0 DATA (CAT5e): 101 DATA (CAT5): 0 DATA (CAT3): 0

DATA (CAT6): 0 DATA (CAT5e): 0 DATA (CAT5): 0 DATA (CAT3): 0


DATA (CAT6): 0 DATA (CAT5e): 0 DATA (CAT5): 0 DATA (CAT3): 0


FINAL CABLE COUNT DATA (CAT6): 0 DATA (CAT5e): 0

DATA (CAT5): 0 DATA (CAT3): 0

CABLE RELOCATION COUNT

EXISTING CABLE TO REMAIN

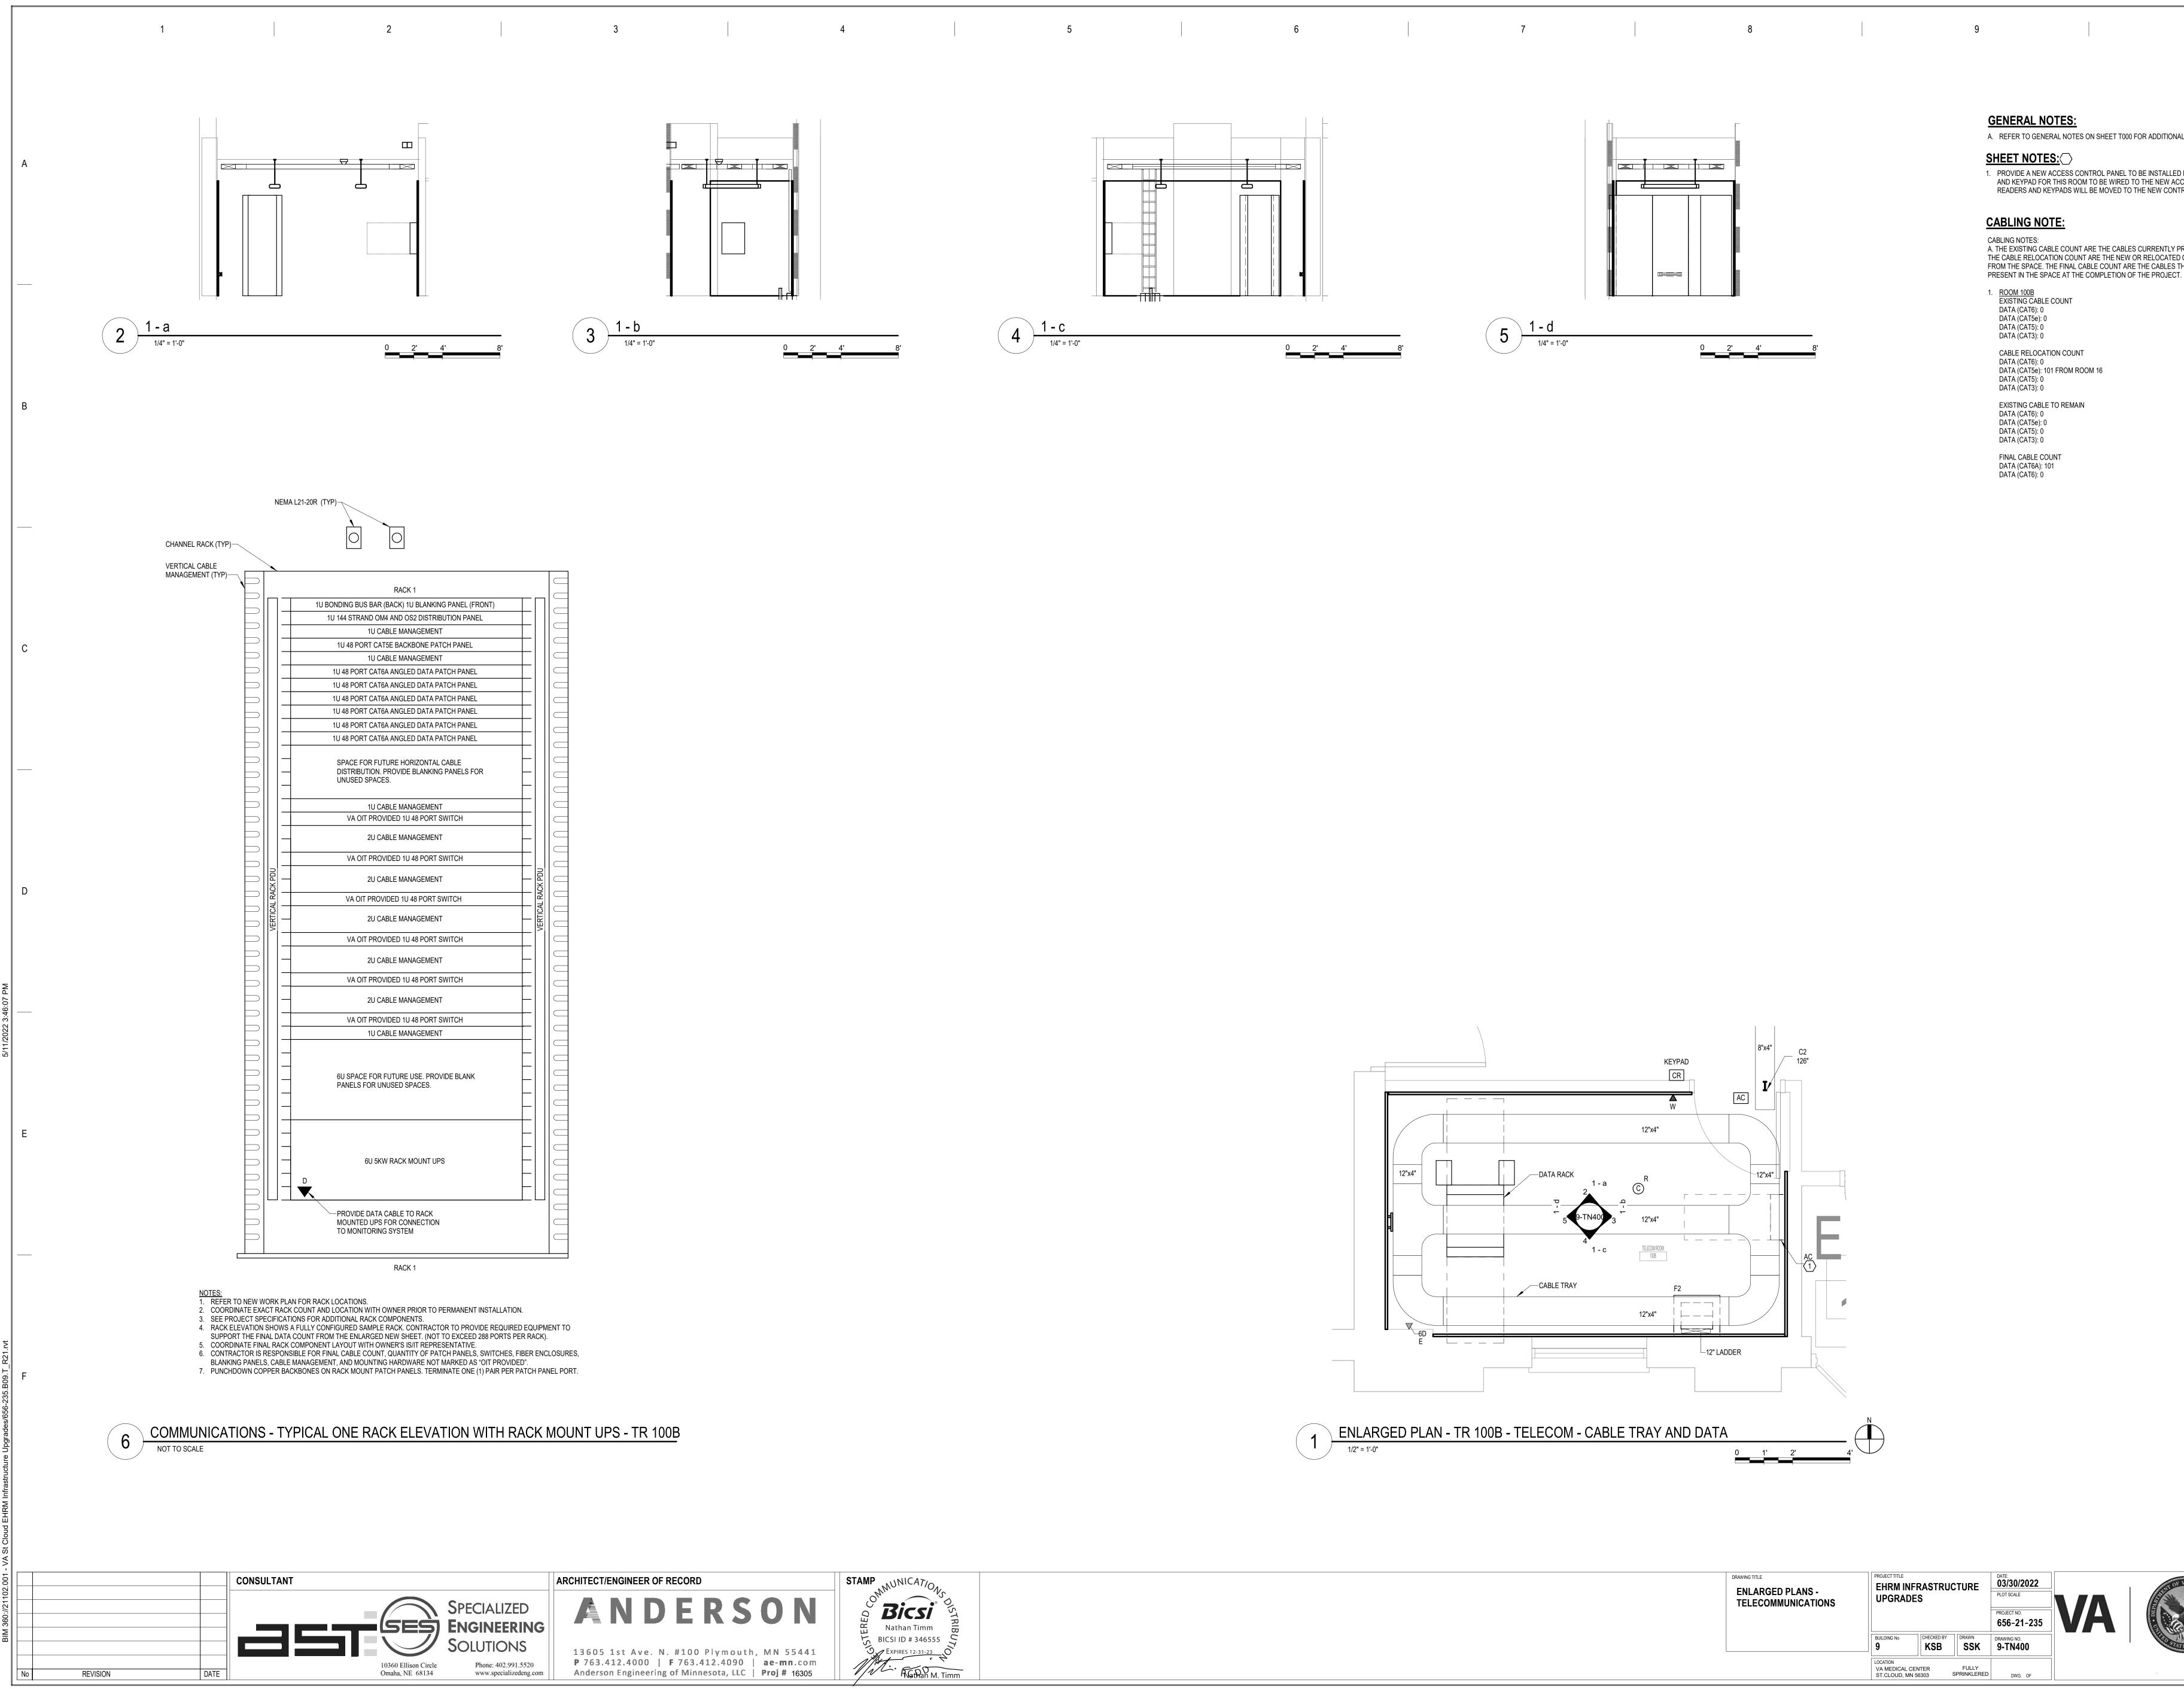

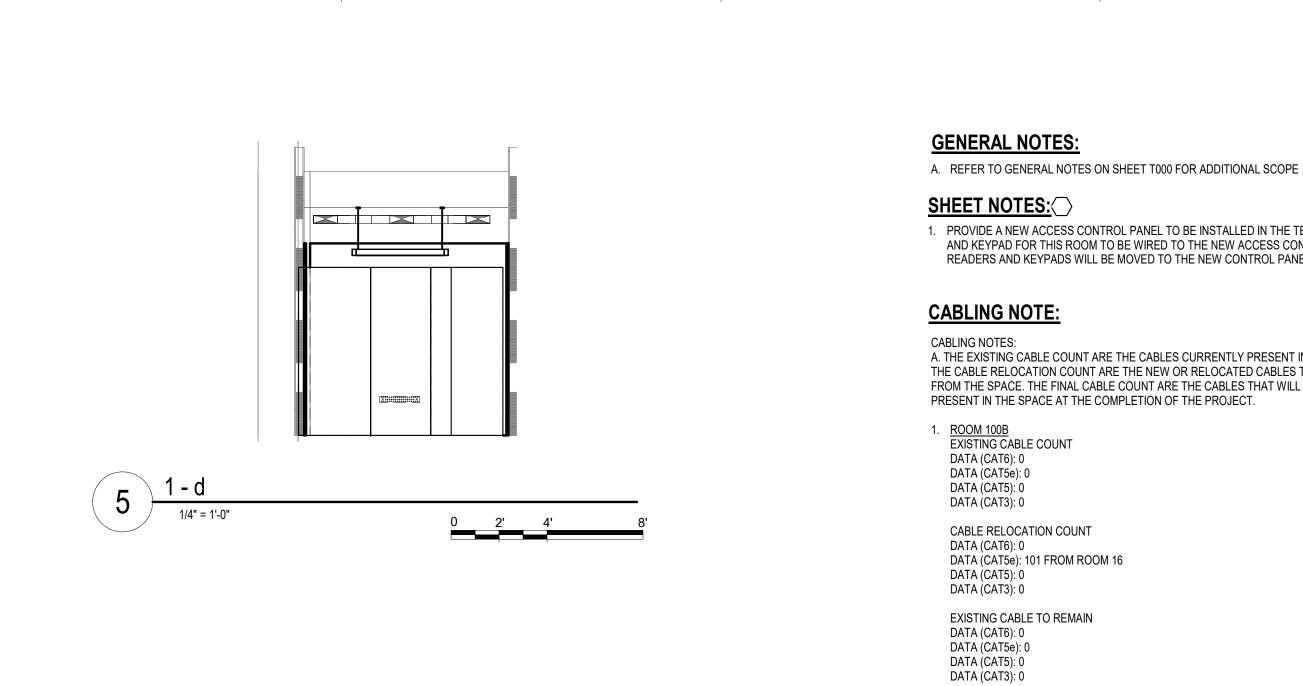

FINAL CABLE COUNT DATA (CAT6A): 101 DATA (CAT6): 0


DRAWING TITLE ENLARGED PLANS - TELECOMMUNICATIONS	EHRM INF		CTURE	DATE: 03/30/2022 PLOT SCALE PROJECT NO. 656-21-235	VA
	BUILDING No	CHECKED BY	DRAWN SSK	DRAWING NO. 9-TN400	
	LOCATION VA MEDICAL C ST.CLOUD, MN		FULLY SPRINKLERED	DWG. OF	


1. PROVIDE A NEW ACCESS CONTROL PANEL TO BE INSTALLED IN THE TELECOM ROOM. THE CARD READER AND KEYPAD FOR THIS ROOM TO BE WIRED TO THE NEW ACCESS CONTROL PANEL. EXISTING CARD READERS AND KEYPADS WILL BE MOVED TO THE NEW CONTROL PANEL UNDER A DIFFERENT PROJECT.

10

A. THE EXISTING CABLE COUNT ARE THE CABLES CURRENTLY PRESENT IN THE SPACE. THE CABLE RELOCATION COUNT ARE THE NEW OR RELOCATED CABLES TO BE FED FROM THE SPACE. THE FINAL CABLE COUNT ARE THE CABLES THAT WILL BE PRESENT IN THE SPACE AT THE COMPLETION OF THE PROJECT.



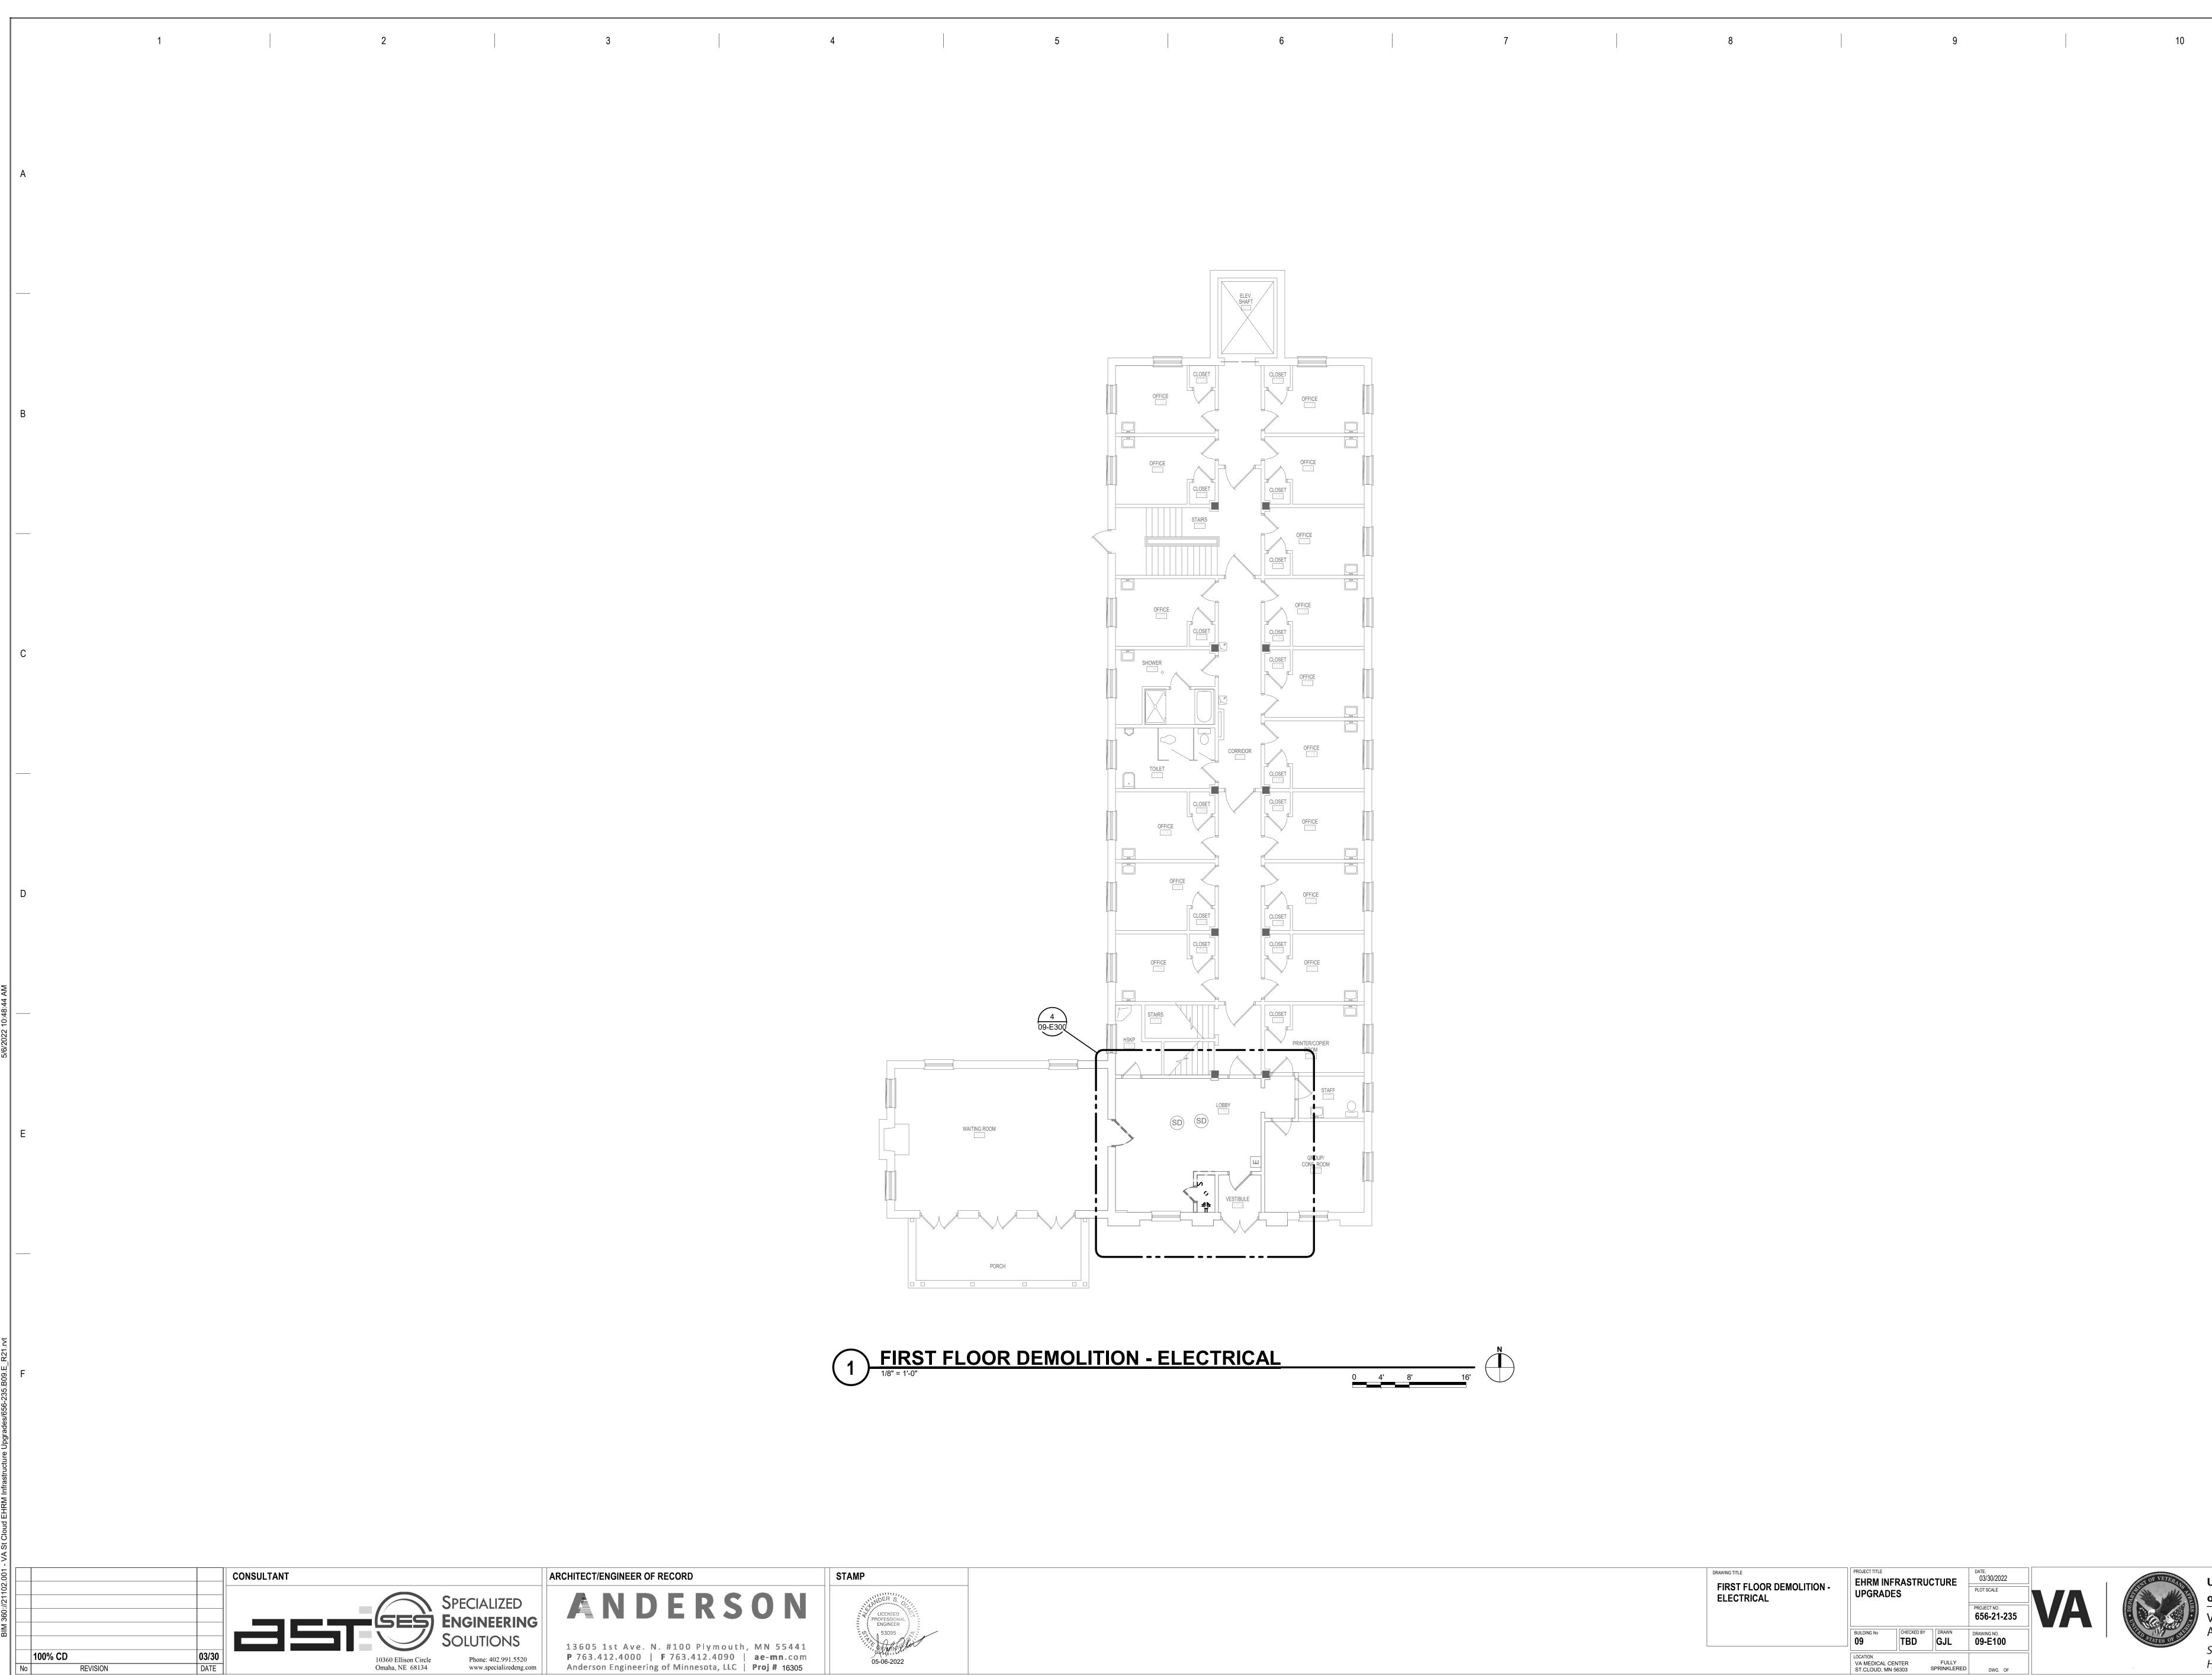

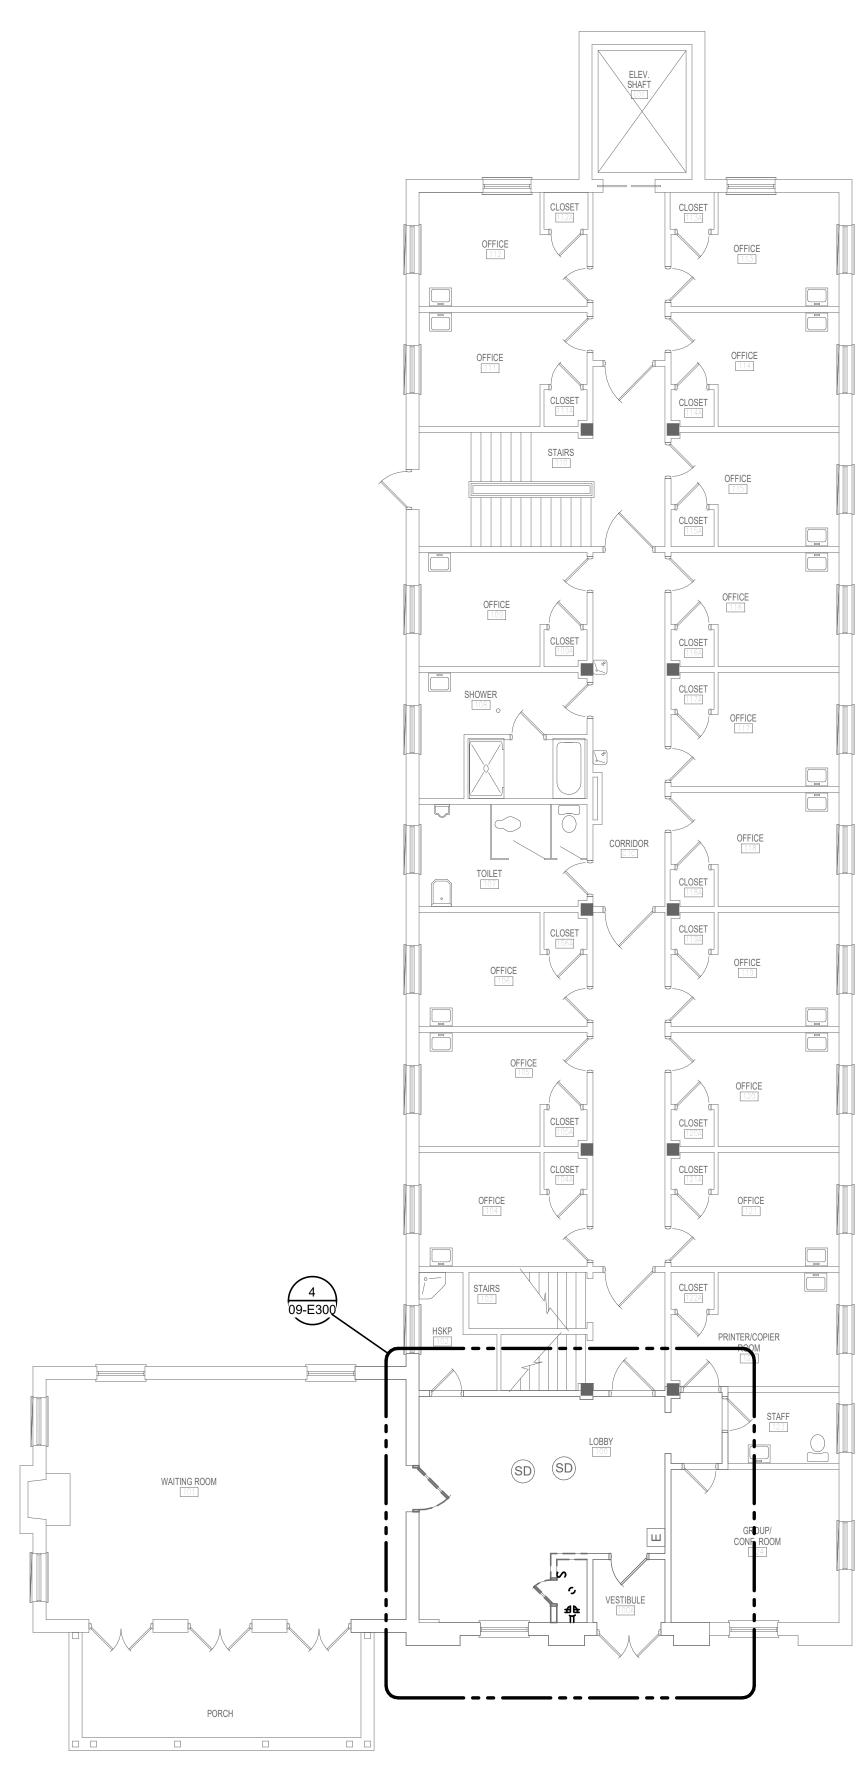


1) FIRST FLOOR DEMOLITION - ELECTRICAL

0 4' 8'

DRAWING TITLE FIRST FLOOR DEMOLITION - ELECTRICAL	PROJECT TITLE EHRM IN UPGRAD	FRASTRU()ES	CTURE	DATE: 03/30/2022 PLOT SCALE PROJECT NO. 656-21-235	
	BUILDING No	CHECKED BY	drawn GJL	DRAWING NO. 09-E100	
	LOCATION VA MEDICAL (ST.CLOUD, MI		FULLY	DWG. OF	




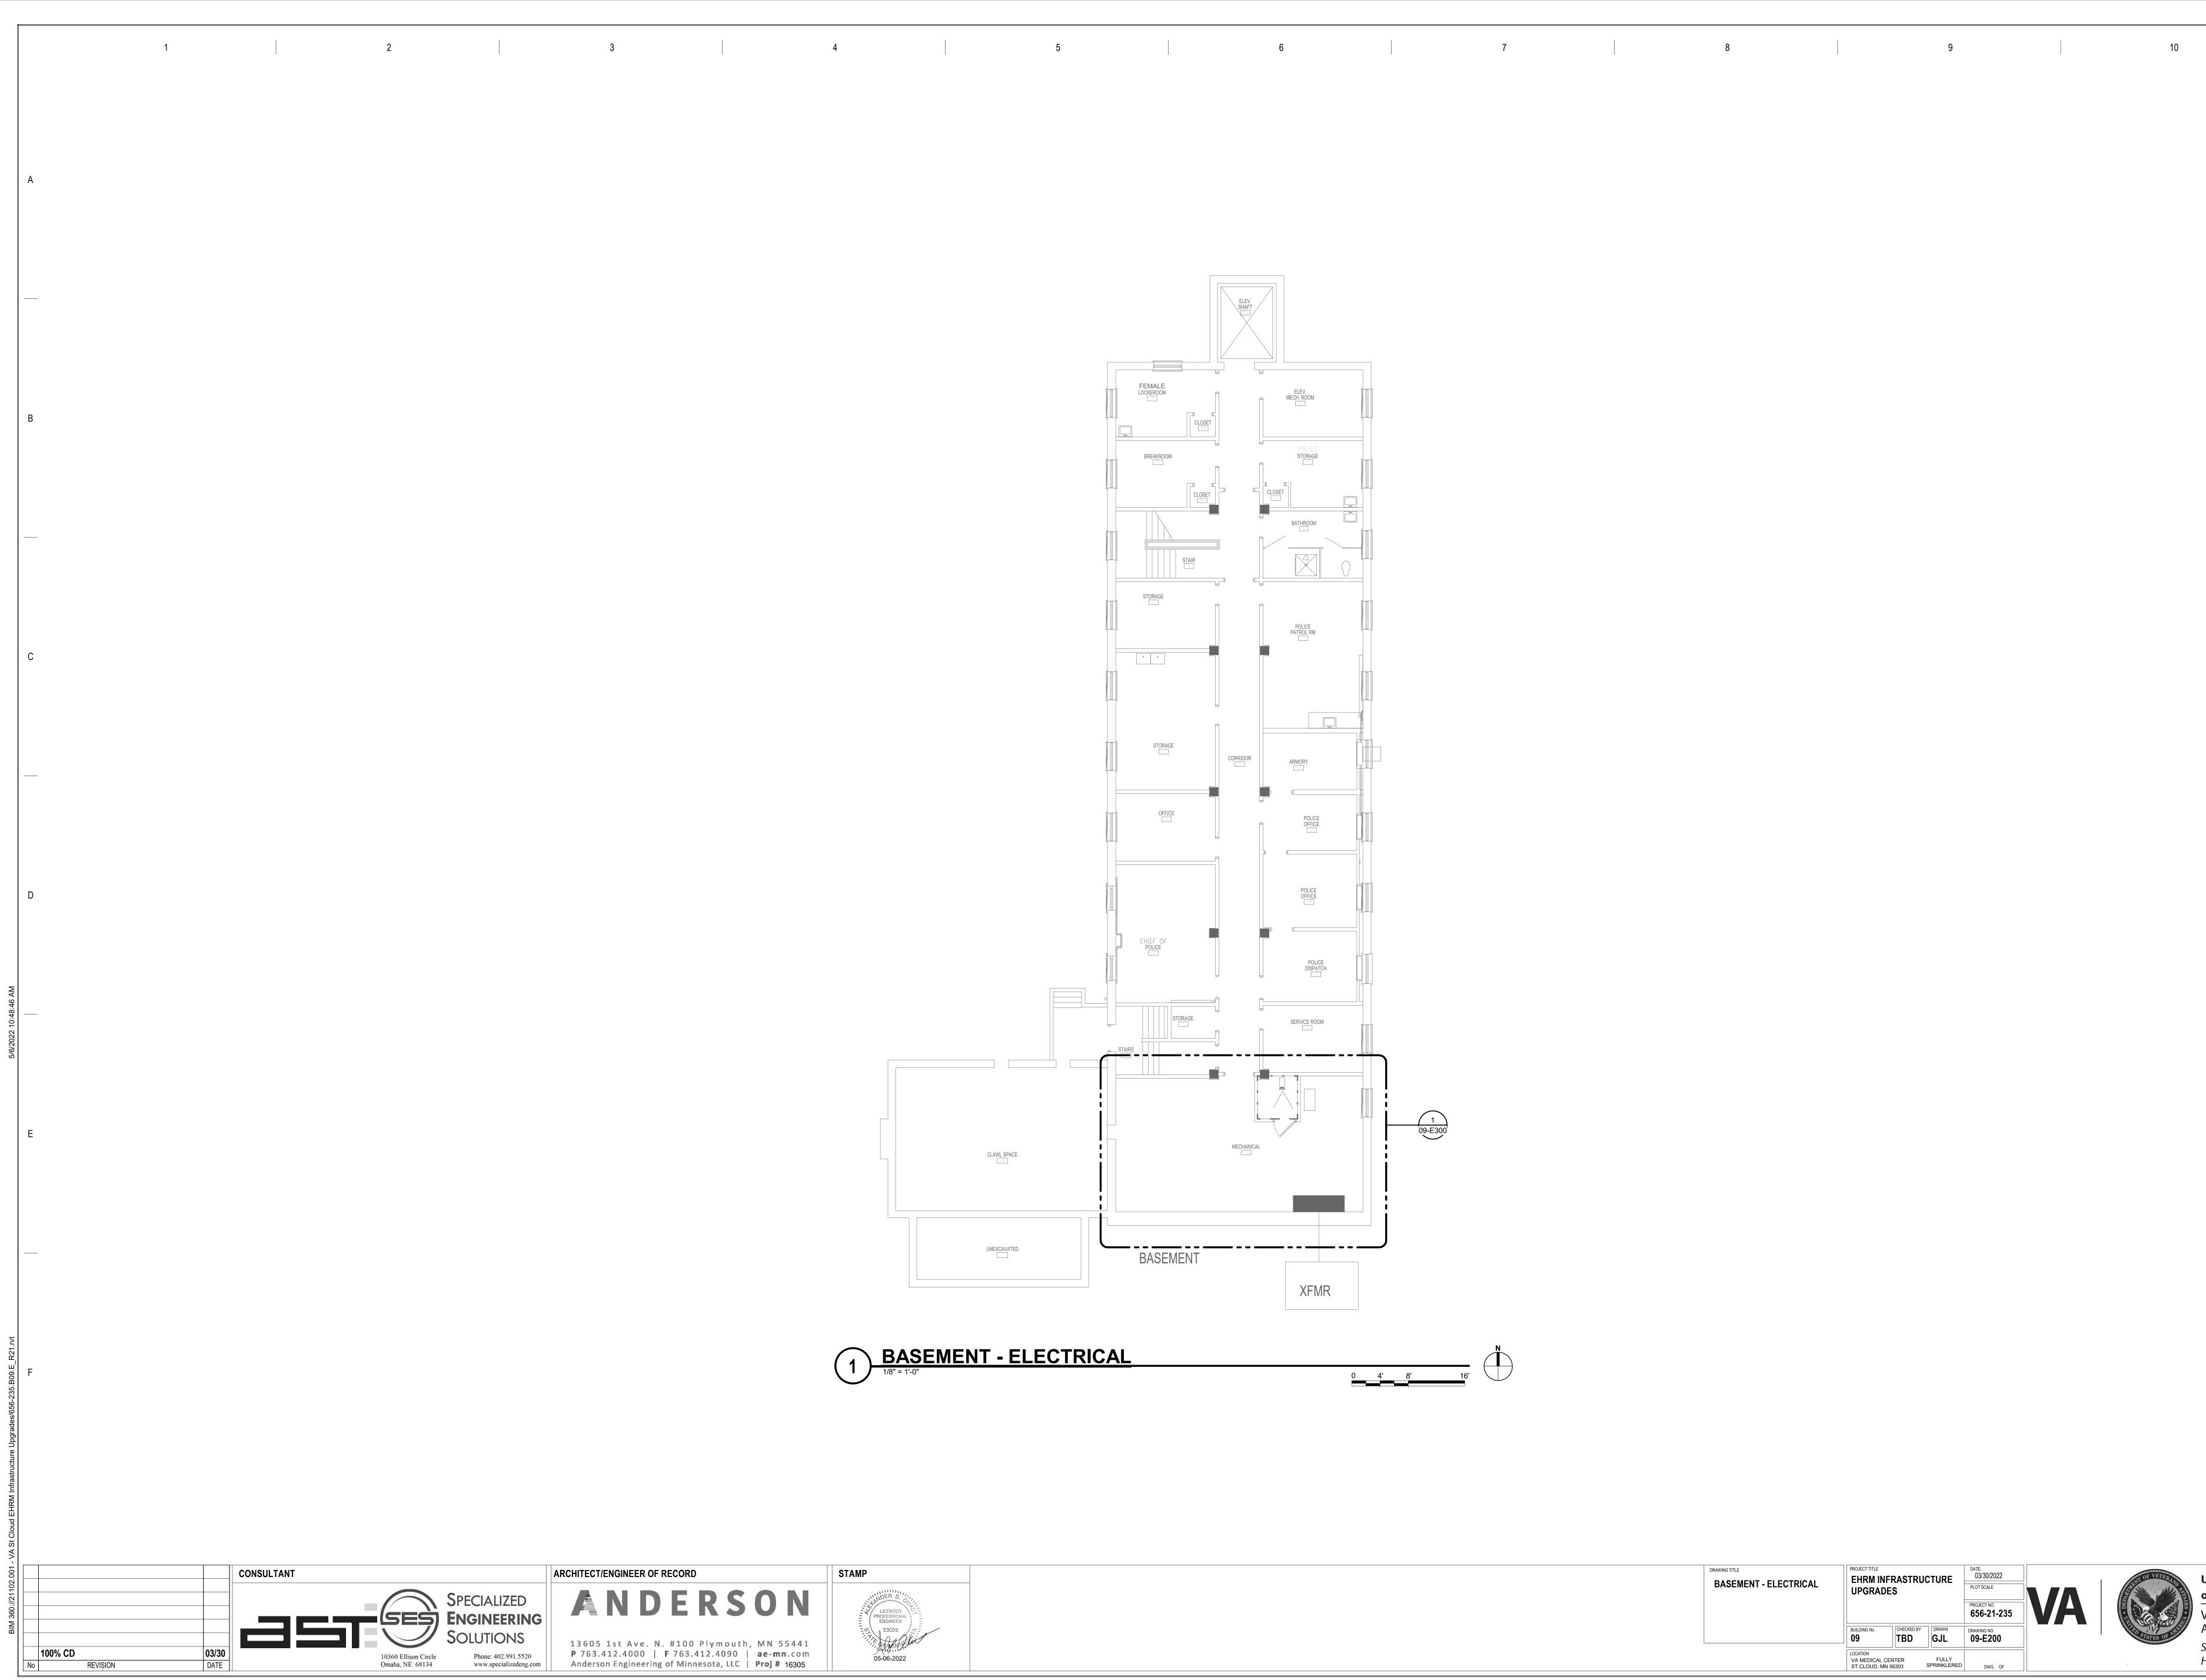


DRAWING TITLE BASEMENT - ELECTRICAL	PROJECT TITLE EHRM INFRASTRUCT UPGRADES	URE	DATE: 03/30/2022 PLOT SCALE	
	11 11	DRAWN	PROJECT NO. 656-21-235 DRAWING NO.	
		FULLY	09-E200	

_____1 _____09-E300



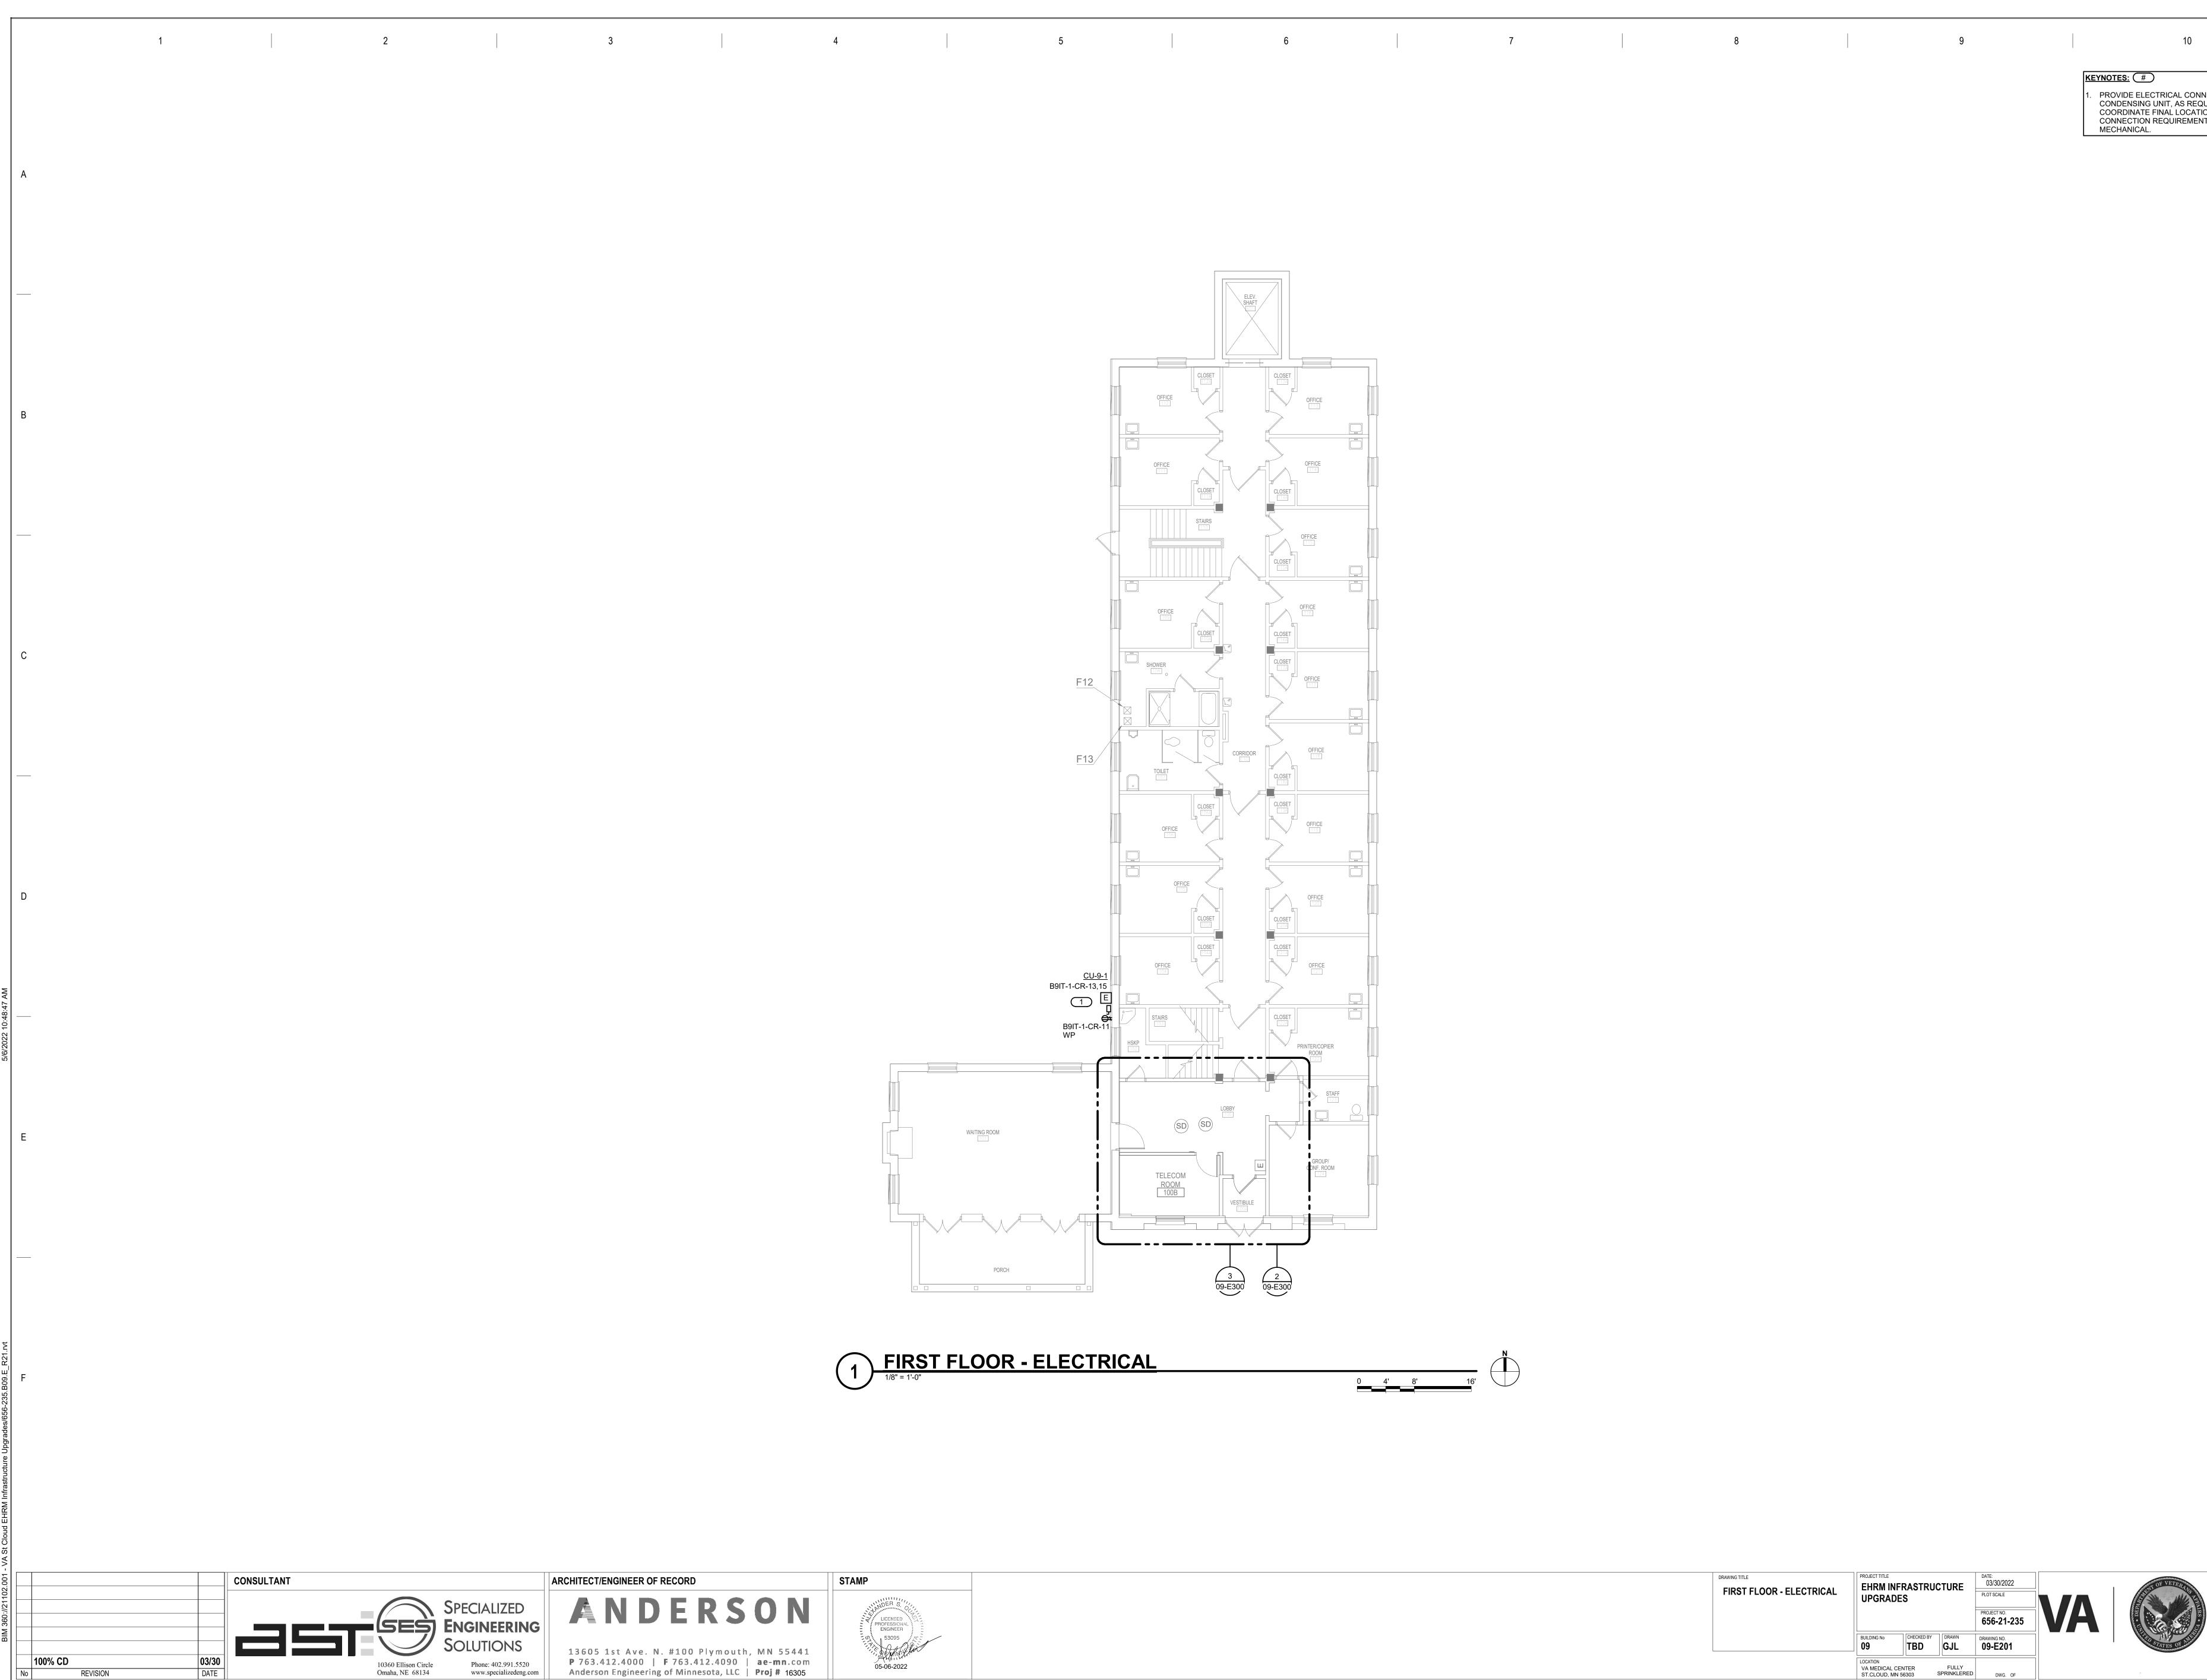

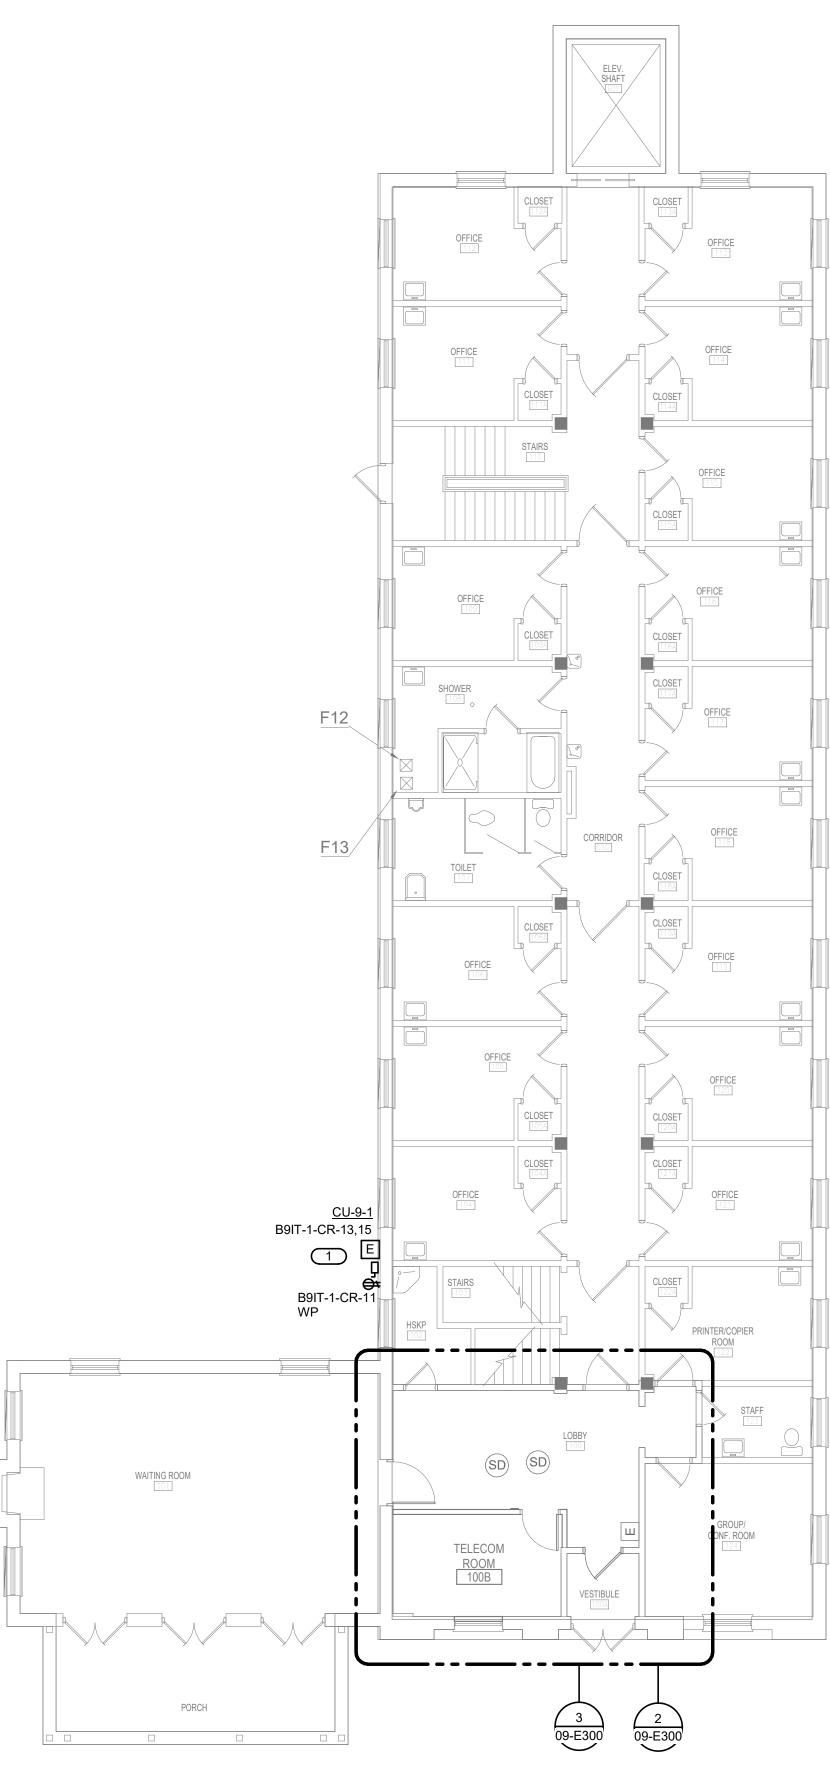

0 4' 8'


1) FIRST FLOOR - ELECTRICAL


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DRAWING TITLE FIRST FLOOR - ELECTRICAL	PROJECT TITLE EHRM INF UPGRADE		CTURE	DATE: 03/30/2022 PLOT SCALE	
				PROJECT NO. 656-21-235	VA
	BUILDING No 09	CHECKED BY	drawn GJL	DRAWING NO. 09-E201	
	LOCATION VA MEDICAL CE ST.CLOUD, MN 5		FULLY SPRINKLERED	DWG. OF	

KEYNOTES: # 1. PROVIDE ELECTRICAL CONNECTION TO CONDENSING UNIT, AS REQUIRED. COORDINATE FINAL LOCATION AND CONNECTION REQUIREMENTS WITH MECHANICAL.





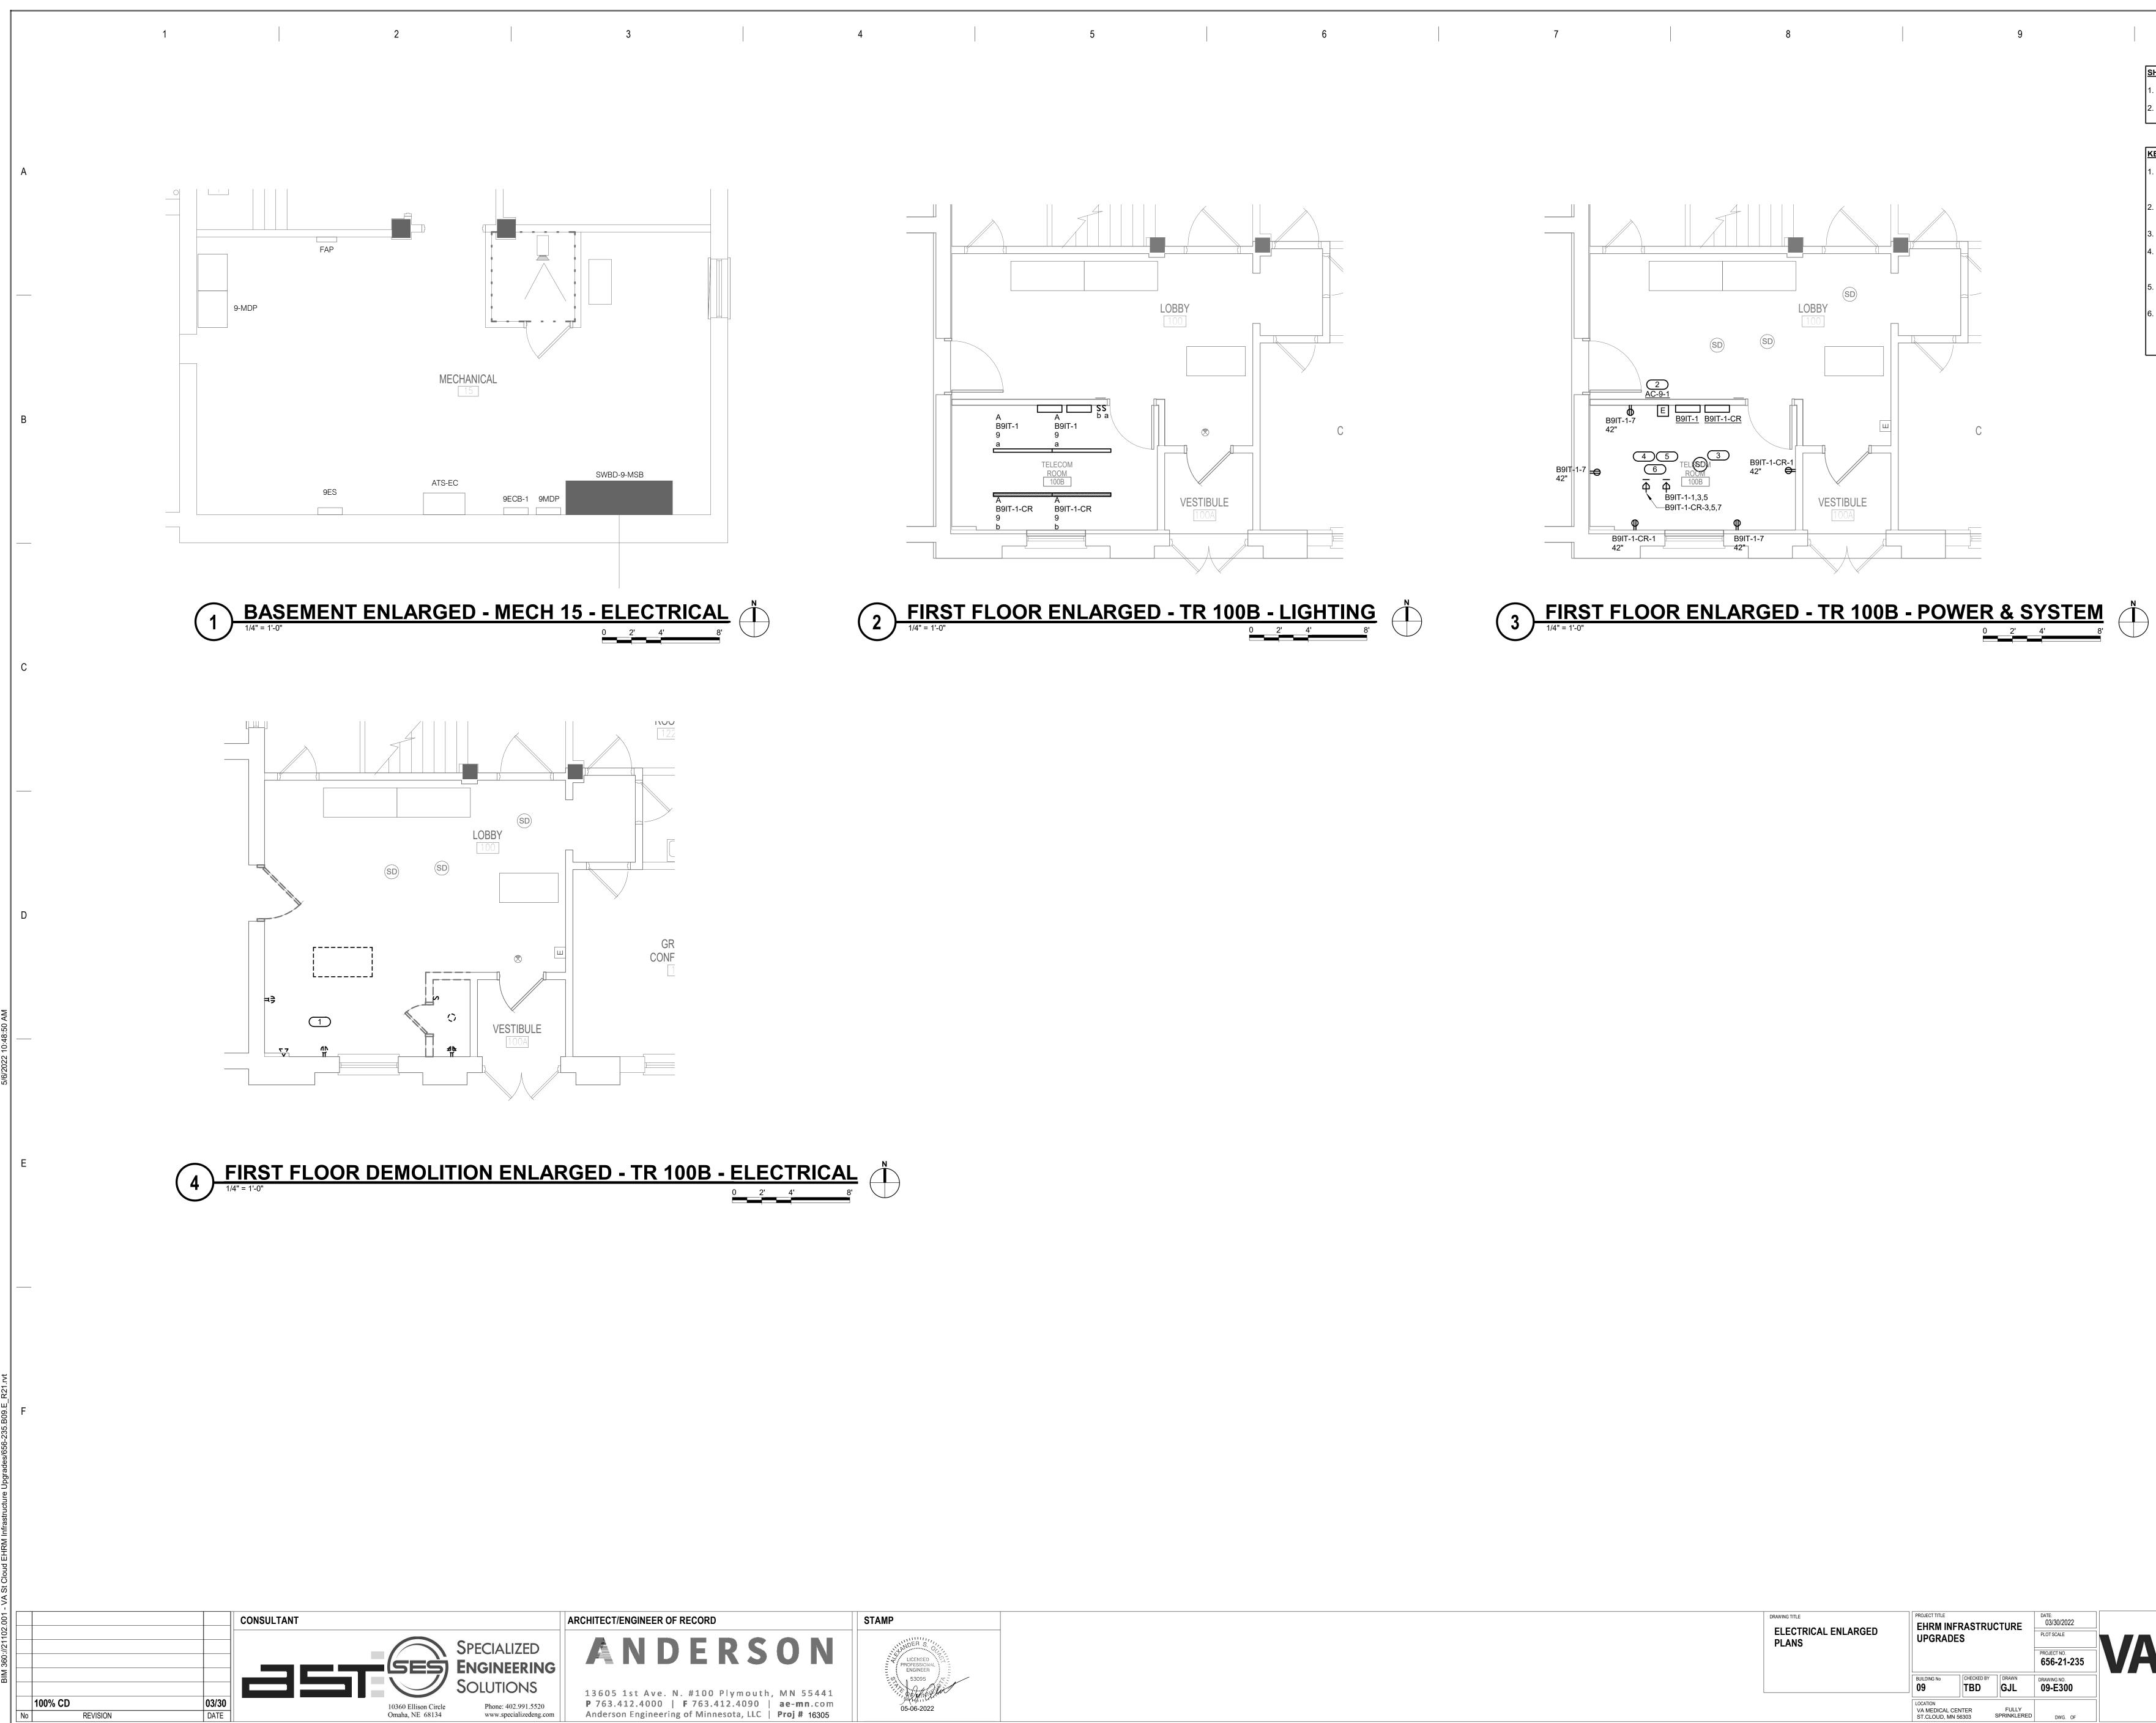

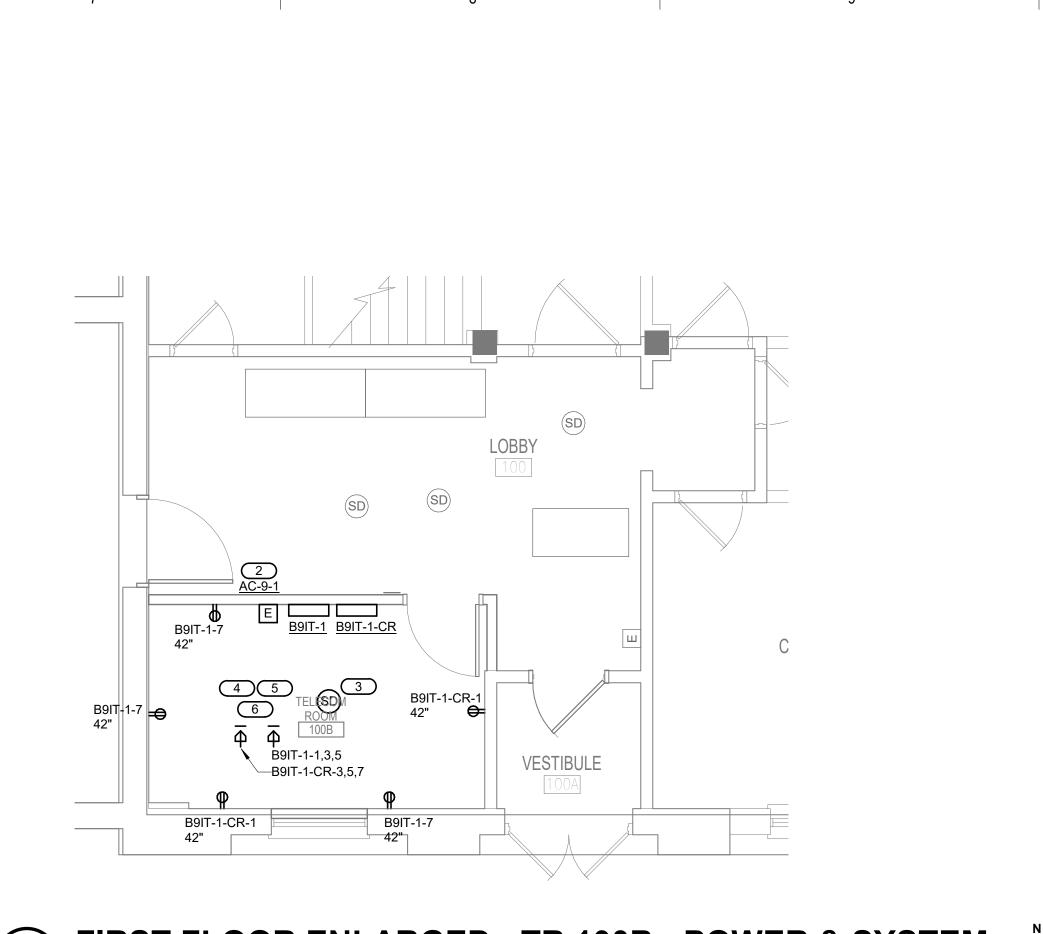

DRAWING TITLE ELECTRICAL ENLARGED PLANS	PROJECT TITLE EHRM INF UPGRADE		CTURE	DATE: 03/30/2022 PLOT SCALE	
				PROJECT NO. 656-21-235	VA
	BUILDING No 09	CHECKED BY	drawn GJL	DRAWING NO. 09-E300	
	LOCATION VA MEDICAL CE ST.CLOUD, MN 5		FULLY SPRINKLERED	DWG. OF	

SHEET NOTES:
 REFER TO TECHNOLOGY PLANS FOR IT ROOM LAYOUT AND RACK LAYOUT/DETAILS. REFER TO SHEET 0-GE400 DETAIL LAYOUT &
ONE-LINE OF RACK.
KEYNOTES: #

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1.	DISCONNECT AND REMOVE LIGHTS AND RECEPTACLES IN AREA OF NEW IT ROOM. MAINTAIN CIRCUIT CONTINUITY TO ADJOINING SPACES.
2.	INDOOR UNIT TO BE POWERED BY OUTDOOR UNIT. COORDINATE EXACT LOCATION WITH M.C.
3.	CONNECT SMOKE DETECTOR TO NEAREST EXISTING SLC.
4.	COORDINATE FINAL LOCATION OF RECEPTACLE L21-20R WITH TELECOM CONTRACTOR. PROVIDE 3/4"C-4#12, 1#12 GND TO PANEL FOR EACH RECEPTACLE.
5.	PROVIDE EATON BLADEUPS, 5KW, 120/208V, 3- PHASE, 4-WIRE RACK MOUNTED UPS FOR EACH RACK TOWER.
6.	PROVIDE APC#AP8861 RPDU RACK PDU 2G WITH L21-20P CORD. (120/208V, 3-PHASE, 20A, ZERO U, 5.7 KW, 208V, (36) C13 (6) C19 (2) 5-20R OUTLETS. PROVIDE TWO PER RACK, MOUNTED PER MANUFACTURER'S REQUIREMENTS.



Α PANEL B9IT-1 MOUNTING: SURFACE MAIN: 100 A MCB _____ ENCLOSURE: NEMA PB 1 SOLID NEUTRAL VOLTS: 120/208 Wye FED FROM: SWBD-9-MSB GROUND BUS PHASE: 3 LOCATION: TELECOM ROOM 100B **WIRE:** 4 SCCR: 10 kA NOTES: WIRE
OCPDWIRE
SIZEWIRE
AWIRE
BWIRE
COCPD K R E CKT Y NO.

 AMPS
 P
 H
 N
 G
 I.67
 O
 I. LOAD DESCRIPTION LOAD DESCRIPTION AMPS P H N G G N H P AMPS
 1
 L21-20R RACK

 - 3

 - 5
 7 TELECOM ROOM REC. 9 LIGHTING
 - 11
 SPARE

 - 13
 SPARE
 -- 15 SPARE
 - 17
 SPARE

 - 19
 SPARE

 - 21
 SPARE
 -- 23 SPARE -- 25 SPARE -- 27 SPARE -- 29 SPARE
 Total Load:
 2.21 kVA
 1.71 kVA
 1.67 kVA

 Total Amps:
 18.45
 14.32
 13.89
 LOAD SUMMARY LOAD CLASSIFICATION CONNECTED LOAD DEMAND FACTOR ESTIMATED DEMAND TOTALS* 0.044 kVA 0.044 kVA 100.00% С Lighting 5 kVA 100.00% 5 kVA TOTAL CONNECTED LOAD: TOTAL ESTIMATED DEMAND LOAD: 5.584 kVA 0.54 kVA 100.00% 0.54 kVA Receptacles TOTAL CONNECTED AMPS: TOTAL ESTIMATED DEMAND AMPS: 15.5 A *TOTAL DEMAND CALCS SUBTRACT ANY REDUNDANT LOAD AND THE SMALLER OF ANY NONCOINCIDENT HVAC LOADS. THIS CALC IS DONE AT EACH PANEL. **CIRCUIT KEY NOTES:** PANEL B9IT-1-CR MAIN: 100 A MCB MOUNTING: SURFACE ENCLOSURE: NEMA PB 1 SOLID NEUTRAL **VOLTS:** 120/208 Wye FED FROM: 9-ECB-1 GROUND BUS **PHASE:** 3 LOCATION: TELECOM ROOM 100B **WIRE:** 4 SCCR: 10 kA NOTES: D WIRE OCPD SIZE A WIRE C SIZE OCPD K В E CKT

 AMPS
 P
 H
 N
 G
 G
 N
 H
 P
 AMPS
 LC

 20 A
 1
 0.36
 0
 - - 1
 20 A
 SPARE

 20 A
 3
 - 0.36
 0
 1.67
 0
 - - 1
 20 A
 SPARE

 -- - - - - 1.67
 0
 - - 1
 20 A
 SPARE

 -- - - - 1.67
 0
 - - 1
 20 A
 SPARE

 -- - - 1.67
 0
 - - - 1
 20 A
 SPARE

 20 A
 1
 - 1.67
 0
 - - - 1
 20 A
 SPARE

 20 A
 1
 - 1.67
 0
 - - 1
 20 A
 SPARE

 20 A
 1
 1.00
 - - - 1
 LOAD DESCRIPTION LOAD DESCRIPTION Y NO. AMPS P H N G G N H P AMPS 1 TELECOM ROOM REC. 3 L21-20R RACK --- 5 ----- 7 --9 LIGHTING 11 WP GFI REC 13 CU-9-1 -- 15 ---- 17 SPARE -- 19 SPARE -- 21 SPARE -- 23 SPARE -- 25 SPARE -- 27 SPARE -- 29 SPARE
 Total Load:
 3.03 kVA
 2.71 kVA
 1.85 kVA

 Total Amps:
 26.33
 23.70
 15.39
 Е LOAD SUMMARY LOAD CLASSIFICATION CONNECTED LOAD DEMAND FACTOR ESTIMATED DEMAND TOTALS* 0.044 kVA 100.00% 0.044 kVA Lighting 7 kVA 100.00% TOTAL CONNECTED LOAD: 7 kVA Power TOTAL ESTIMATED DEMAND LOAD: 7.584 kVA 0.54 kVA 100.00% 0.54 kVA Receptacles TOTAL CONNECTED AMPS: TOTAL ESTIMATED DEMAND AMPS: 21.1 A *TOTAL DEMAND CALCS SUBTRACT ANY REDUNDANT LOAD AND THE SMALLER OF ANY NONCOINCIDENT HVAC LOADS. THIS CALC IS DONE AT EACH PANEL. **CIRCUIT KEY NOTES:** CONSULTANT ARCHITECT/ENGINEER OF RECORD

100% CD


REVISION

03/30

DATE

10360 Ellison Circle Omaha, NE 68134

SPECIALIZED **ENGINEERING** JTIONS Phone: 402.991.5520 www.specializedeng.com

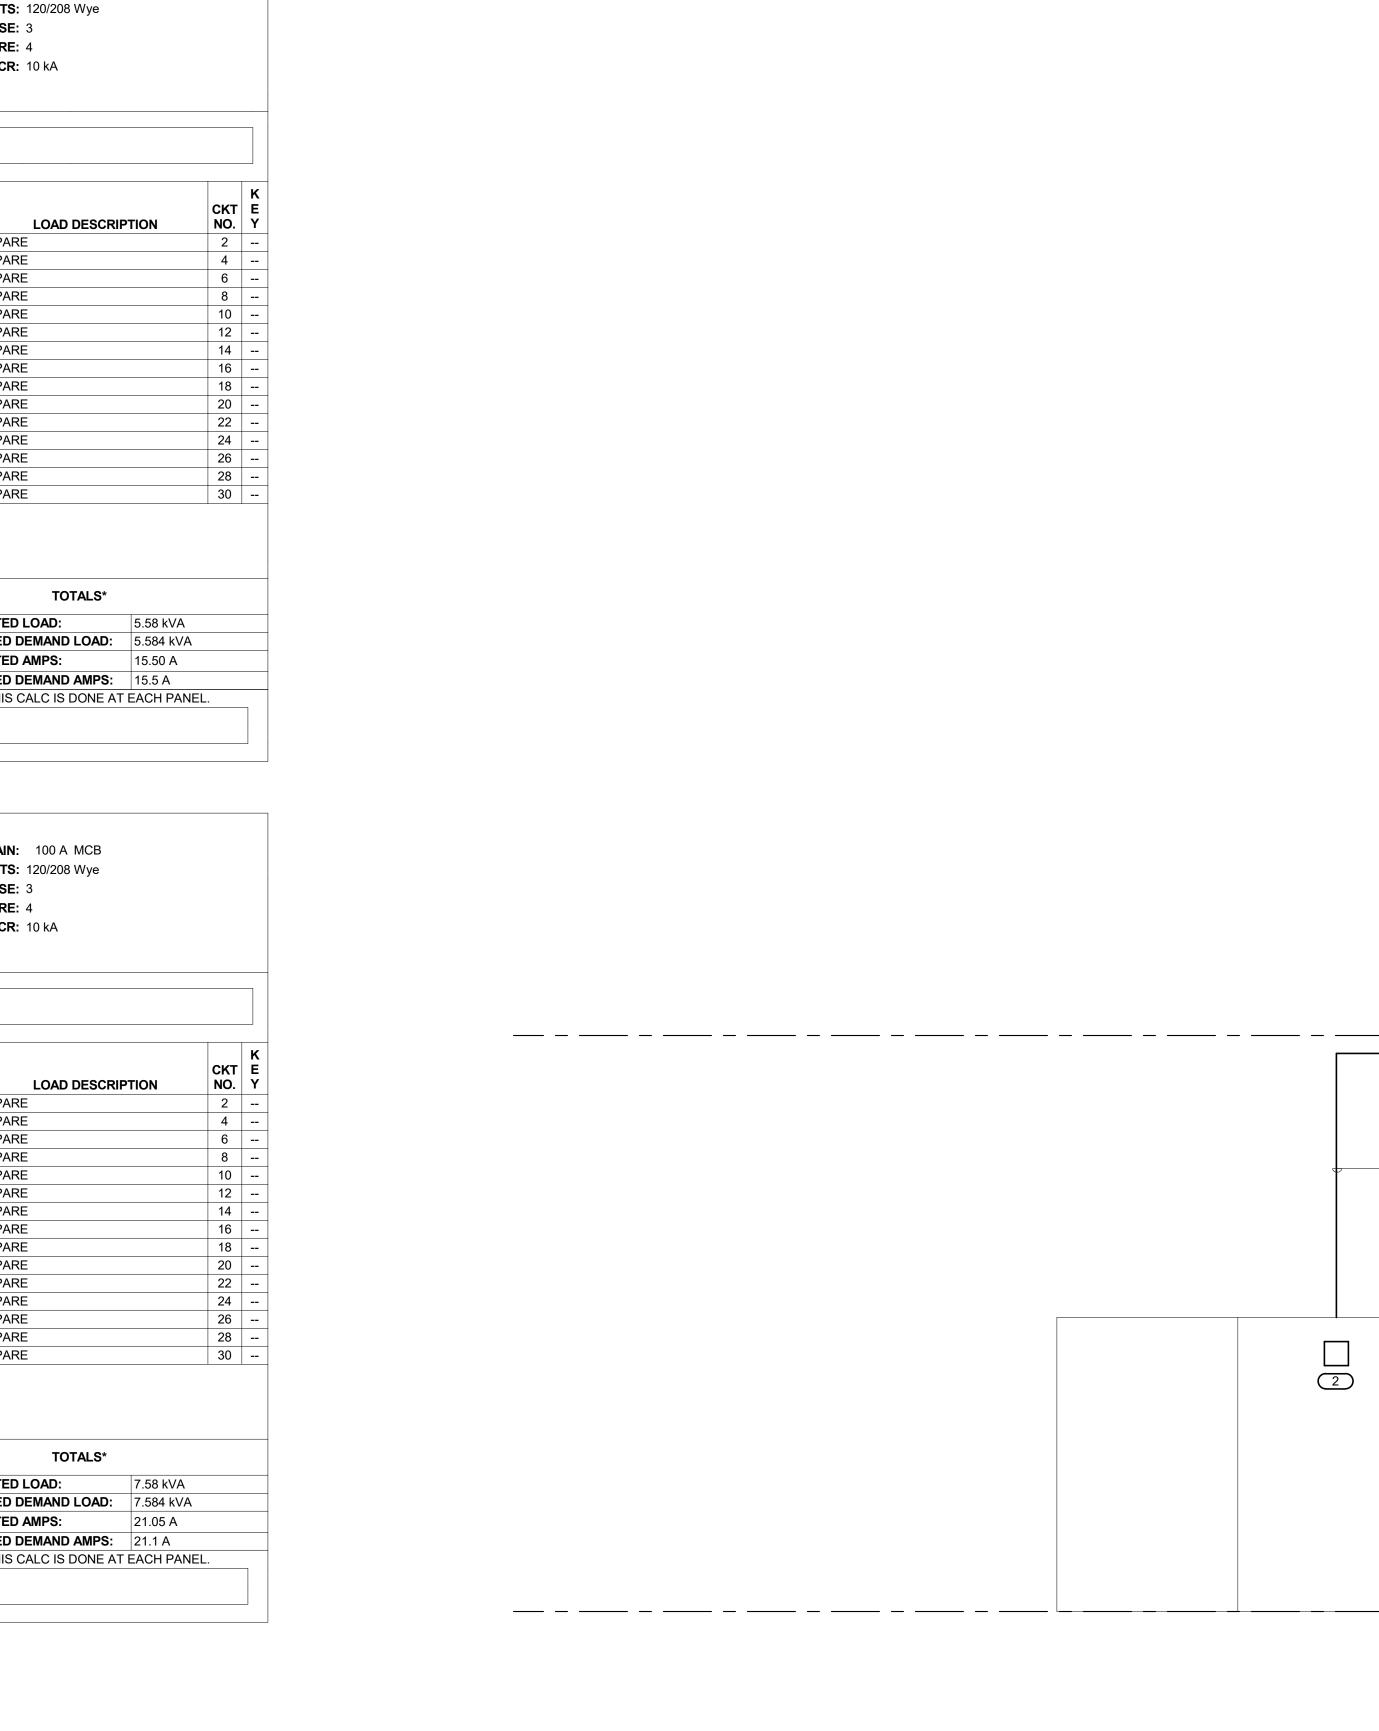




2

1 2 3 9 3 9 1 **3** 9



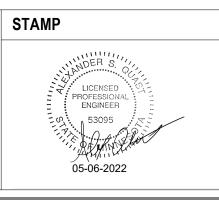


-1-CR	B-9IT-1-CF	B-9IT-1	
			00Y
		9-ECB-1	
		9-ECB-1	WB-9-MSB

DRAWING TITLE ELECTRICAL ONE-LINE DIAGRAMS	PROJECT TITLE EHRM INFR UPGRADES		TURE	DATE: 03/30/2022 PLOT SCALE PROJECT NO. 656-21-235	VA
		CHECKED BY	drawn GJL	DRAWING NO. 09-E500	
	LOCATION VA MEDICAL CEN ST.CLOUD, MN 56		FULLY SPRINKLERED	DWG. OF	

1	0

<u> KE</u>	<u>YNOTES:</u> (#)
1.	PROVIDE NEW 100A/3P CIRCUIT BREAKER IN
	EXISTING PANEL TO MATCH EXISTING TYPE
	AND AIC RATING.
2.	PROVIDE NEW 100A/3P SWITCH FUSED AT
	100AMPS

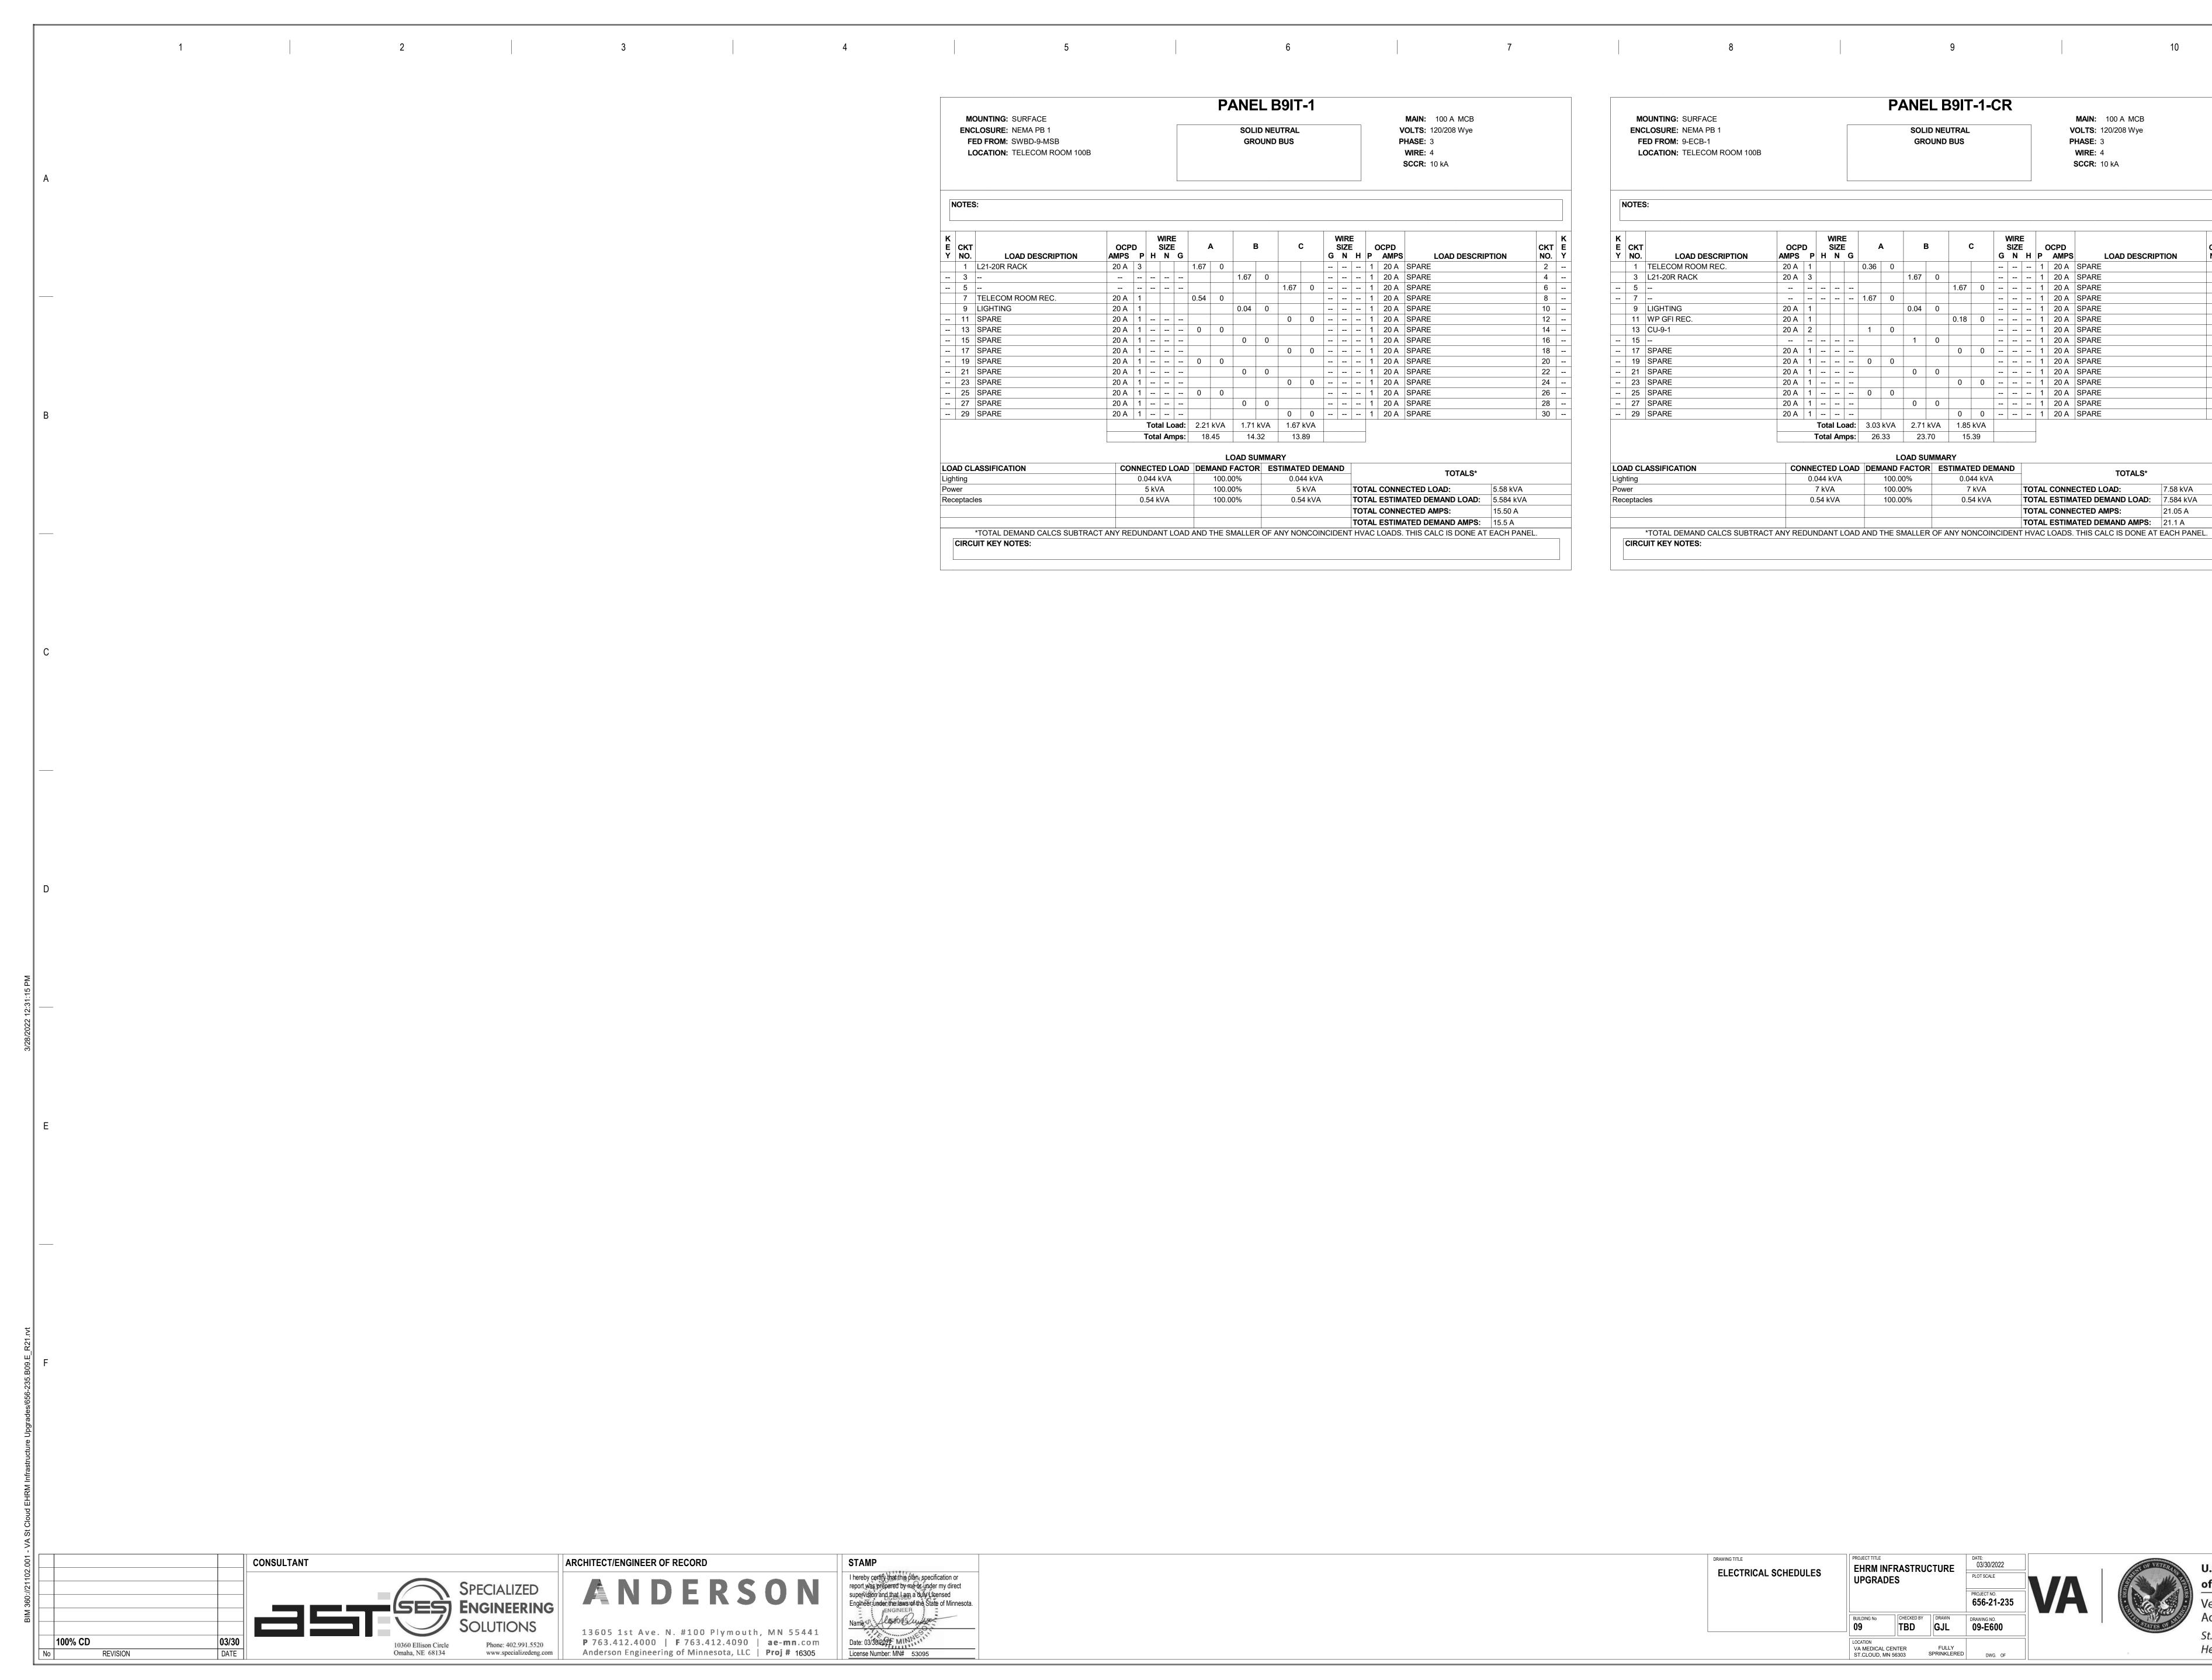

							P	ANE	LE	39IT	-1									
MOUNTING: SURFACE ENCLOSURE: NEMA PB 1 FED FROM: SWBD-9-MSB LOCATION: TELECOM ROOM 100B						SOLID NEUTRAL GROUND BUS										MAIN: 100 A MCB VOLTS: 120/208 Wye PHASE: 3 WIRE: 4 SCCR: 10 kA				
	IOTES				WIRE								WIRE							
K E Y	CKT NO.	LOAD DESCRIPTION	OCPD AMPS		SIZE N G		A	B		C			SIZE	H P	OCPD AMPS	S LOAD DESCRI	ΡΤΙΟΝ	CKT NO.		
-		L21-20R RACK	20 A 3			1.67	0							1		SPARE		2		
	3			-				1.67	0					1	20 A			4		
	5									1.67	0			1		SPARE		6		
	7	TELECOM ROOM REC.	20 A 1	_		0.54	0							1	20 A			8		
		LIGHTING	20 A 1					0.04	0					1	20 A			10		
		SPARE								0	0			1	20 A			12		
		SPARE	20 A 1			0	0							1		SPARE		14		
		SPARE	20 A 1					0	0		1			1	20 A			16		
	17	SPARE	20 A 1							0	0			1	20 A	SPARE		18		
	19	SPARE	20 A 1			0	0							1	20 A	SPARE		20		
	21	SPARE	20 A 1					0	0					1	20 A	SPARE		22		
	23	SPARE	20 A 1							0	0			1	20 A	SPARE		24		
	25	SPARE	20 A 1			0	0							1	20 A	SPARE		26		
	27	SPARE	20 A 1					0	0					1	20 A	SPARE		28		
	29	SPARE	20 A 1							0	0			1	20 A	SPARE		30		
				Tot	al Load	2.21	kVA	1.71	kVA	1.67	kVA									
				Tota	al Amps	18	.45	14.	32	13.	.89									
							L	OAD SU	MMAF	۲Y										
LOA		ASSIFICATION	CONN	ECT	ED LOA	D DEN				TIMAT	ED DE	MAN	ID			TOTALS*				
Ligh	nting		C	.044	kVA		100.0	0%		0.04	14 kVA					IUIALS^				
Pow	/er			5 k\	/A		100.0	0%		5	kVA		٦ 🗌	ΓΟΤΑ	L CONN	ECTED LOAD:	5.58 kVA			
Rec	eptacl	es).54 I	кVА		100.0	0%		0.5	4 kVA		1	ΓΟΤΑ		IATED DEMAND LOAD:	5.584 kVA			
											1	ΓΟΤΑ	L CONN	ECTED AMPS:	15.50 A					
															-		10.00 / (


I hereby certify that this plan, specification or report was prepared by me or under my direct supervision and that Lam a duly Licensed Engineer under the laws of the State of Minnesota.


	M								P/	ANE	ELE	39IT	-1-	CF	R							
		DUNTING: SURFACE														MAIN: 100 A MCB						
		LOSURE: NEMA PB 1																	OLTS: 120/208 Wye			
		ED FROM: 9-ECB-1								GR	OUNL) BUS							HASE: 3			
	LC	DCATION: TELECOM ROOM 100B																	WIRE: 4 SCCR: 10 kA			
N	OTES	3:																				_
K E Y	CKT NO.		OCPI AMPS	DP		WIR SIZI N	Ε		A	E	3	(C		NIRE SIZE N)CPD AMPS	LOAD DESCR		CKT NO.	
-		TELECOM ROOM REC.	20 A	1				0.36	0								1		SPARE		2	+
		L21-20R RACK	20 A	3						1.67	0						1		SPARE		4	-
-	5											1.67	0				1		SPARE		6	
-	7							1.67	0								1		SPARE		8	-
	9	LIGHTING	20 A	1					-	0.04	0						1		SPARE		10	
	11	WP GFI REC.	20 A	1								0.18	0				1		SPARE		12	-
	13	CU-9-1	20 A	2				1	0								1	20 A	SPARE		14	-
	15									1	0						1	20 A	SPARE		16	-
	17	SPARE	20 A	1								0	0				1	20 A	SPARE		18	•
	19	SPARE	20 A	1				0	0								1	20 A	SPARE		20	
	21	SPARE	20 A	1						0	0						1	20 A	SPARE		22	
	23	SPARE	20 A	1								0	0 0	0			- 1 20 A		SPARE		24	
	25	SPARE	20 A	1				0	0								1	20 A	SPARE		26	
	27	SPARE	20 A	1						0	0						1	20 A	SPARE		28	
	29	SPARE	20 A	1								0	0				1	20 A	SPARE		30	
					Tot	al L	oad:	3.03	3 kVA	2.71	kVA	1.85	kVA									
					Tota	l An	nps:	26	6.33	23	.70	15	.39									
									L	OAD SI	JMMA	RY										
OA	D CL	ASSIFICATION	CO	NNE	СТІ	ED L	.OA	D DEI	AND I	FACTO	R ES	STIMAT	ED DE	MAN	١D				TOTALS*			
igh	ting			0.	044	kVA			100.0	0%		0.0	44 kVA	۱								
ow					7 k\				100.0				kVA			-		-	ECTED LOAD:	7.58 kVA		
ec	eptacl	es		0	.54 k	κVA			100.0	0%		0.5	64 kVA			тот	AL	ESTIM	ATED DEMAND LOAD:	7.584 kVA		
																TOT	AL	CONNE	ECTED AMPS:	21.05 A		

CIRCUIT KEY NOTES:

DRAWING TITLE ELECTRICAL SCHEDULES	PROJECT TITLE EHRM INFRASTRUCTURE UPGRADES		DATE: 03/30/2022 PLOT SCALE PROJECT NO. 656-21-235		OF VETERAL OF	
	BUILDING No	CHECKED BY	drawn GJL	DRAWING NO. 09-E600		STATES OF SUS
	LOCATION VA MEDICAL C ST.CLOUD, MI		FULLY	DWG. OF]	



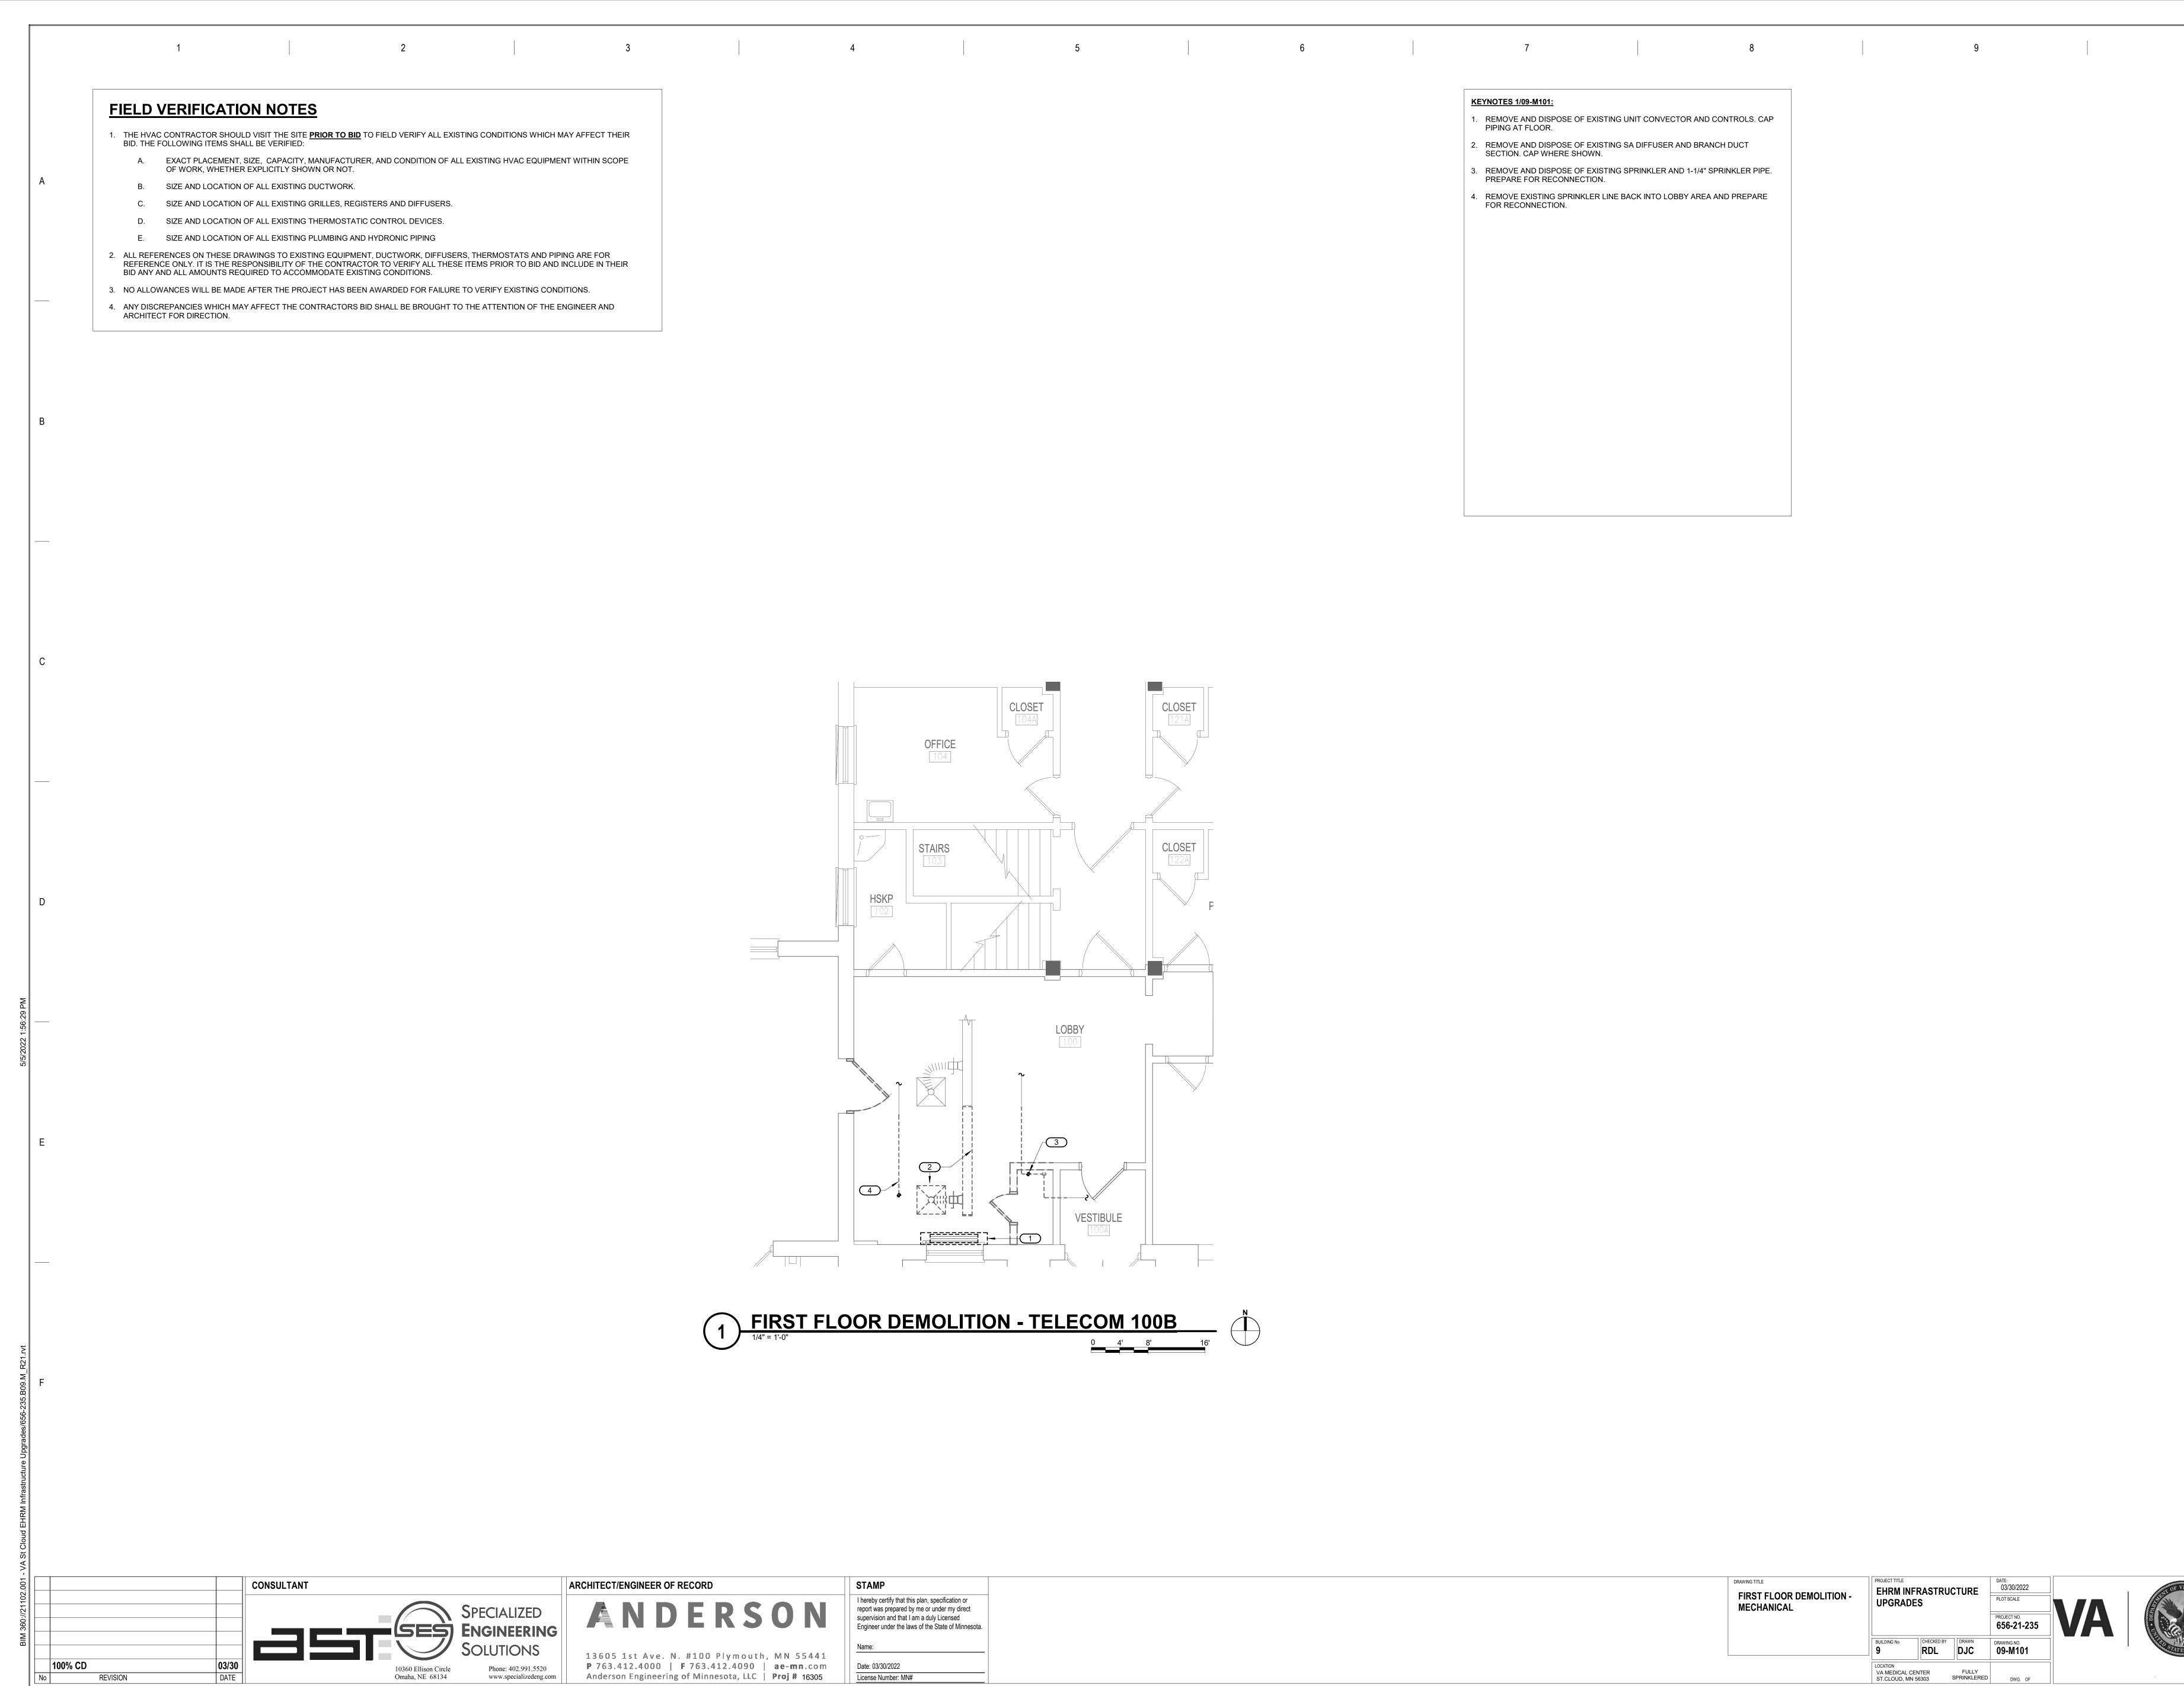

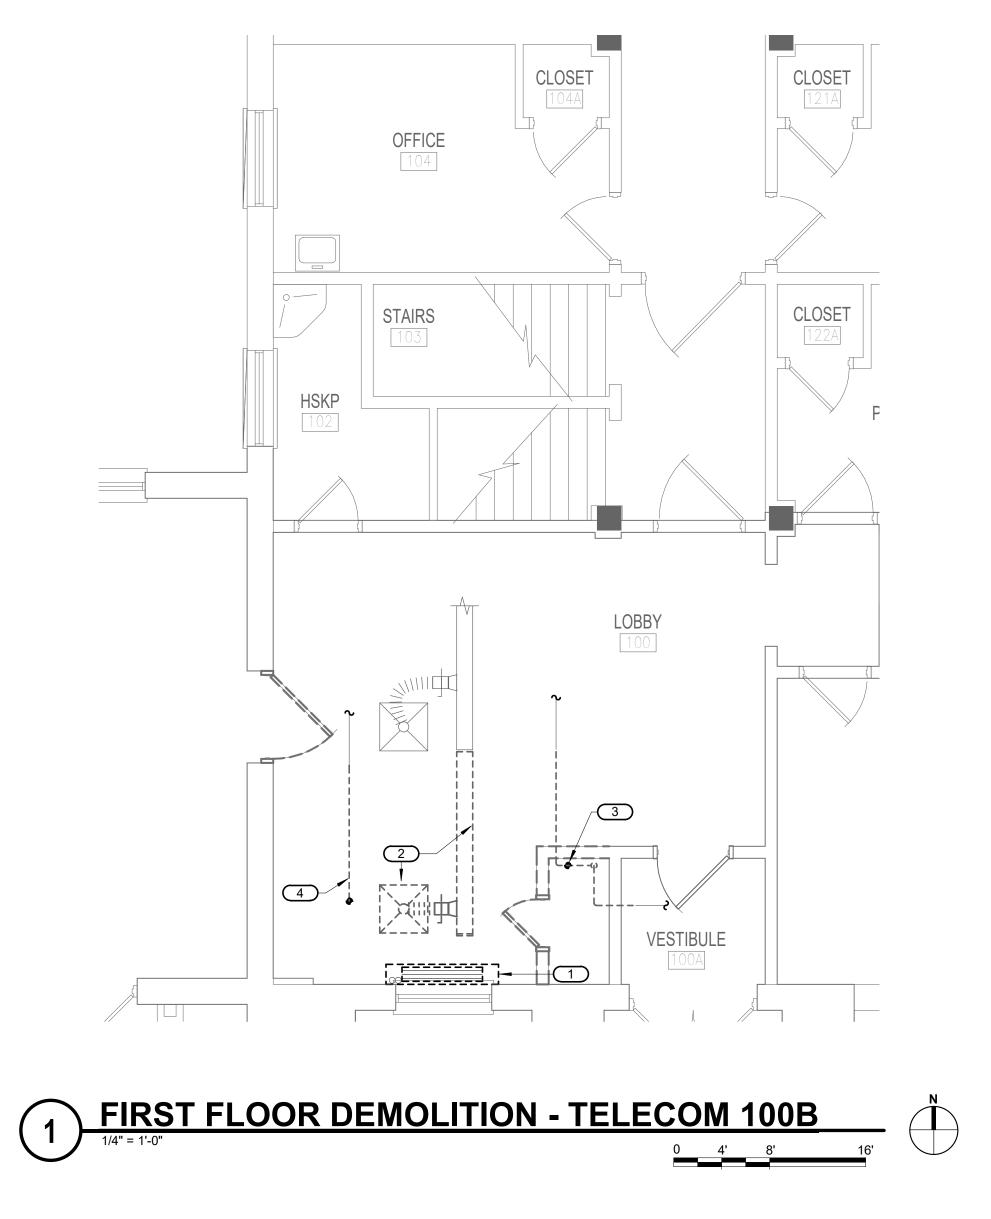



STAMP I hereby certify that this plan, specification or report was prepared by me or under my direct supervision and that I am a duly Licensed Engineer under the laws of the State of Minnesota. Name:

Date: 03/30/2022

License Number: MN#

KEYNOTES	1/09-M101:


FOR RECONNECTION.


- 1. REMOVE AND DISPOSE OF EXISTING UNIT CONVECTOR AND CONTROLS. CAP PIPING AT FLOOR.
- 2. REMOVE AND DISPOSE OF EXISTING SA DIFFUSER AND BRANCH DUCT SECTION. CAP WHERE SHOWN.
- 3. REMOVE AND DISPOSE OF EXISTING SPRINKLER AND 1-1/4" SPRINKLER PIPE.
- PREPARE FOR RECONNECTION. 4. REMOVE EXISTING SPRINKLER LINE BACK INTO LOBBY AREA AND PREPARE

DRAWING TITLE FIRST FLOOR DEMOLITION - MECHANICAL	PROJECT TITLE EHRM INFRASTRUCTURE UPGRADES			DATE: 03/30/2022 PLOT SCALE PROJECT NO. 656-21-235	VA
	BUILDING No 9	CHECKED BY	DRAWN	DRAWING NO. 09-M101	
	LOCATION VA MEDICAL CEI ST.CLOUD, MN 5		FULLY SPRINKLERED	DWG. OF	



10

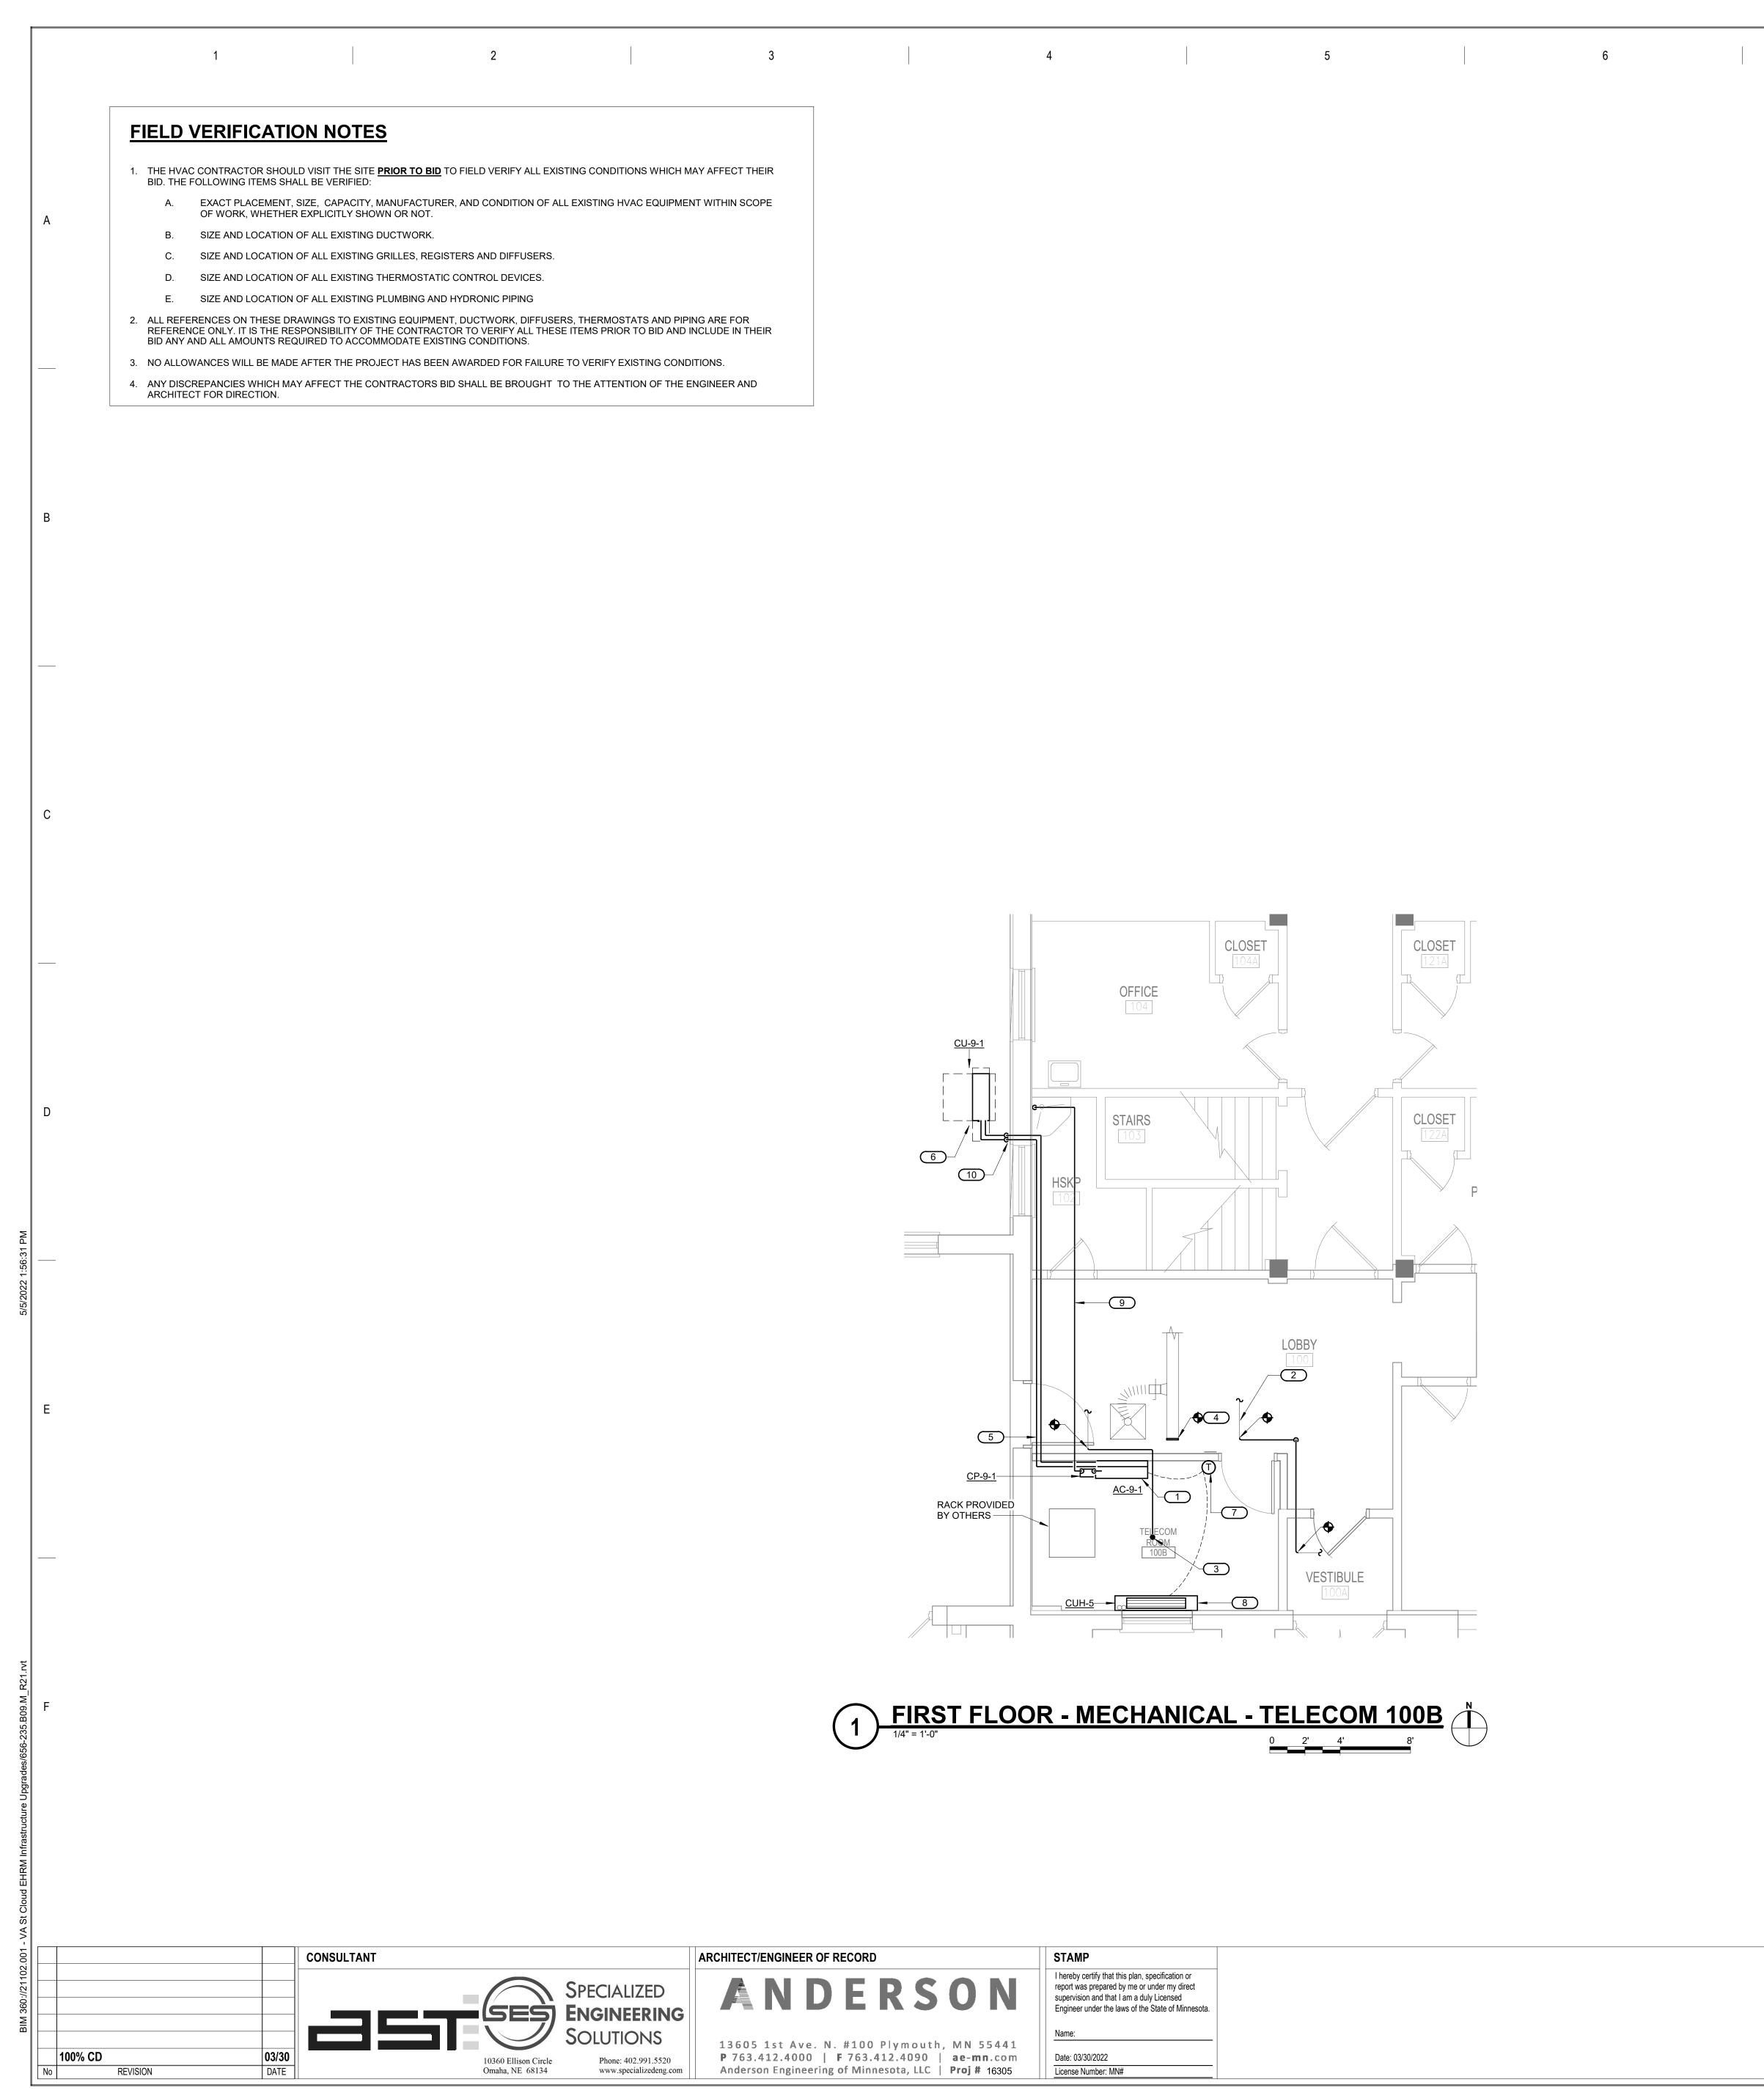


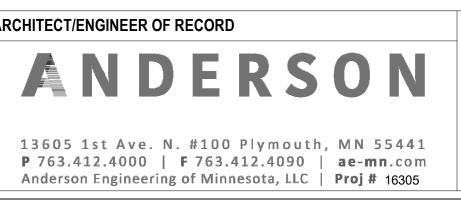

STAMP I hereby certify that this plan, specification or report was prepared by me or under my direct supervision and that I am a duly Licensed Engineer under the laws of the State of Minnesota. Name:

Date: 03/30/2022

License Number: MN#

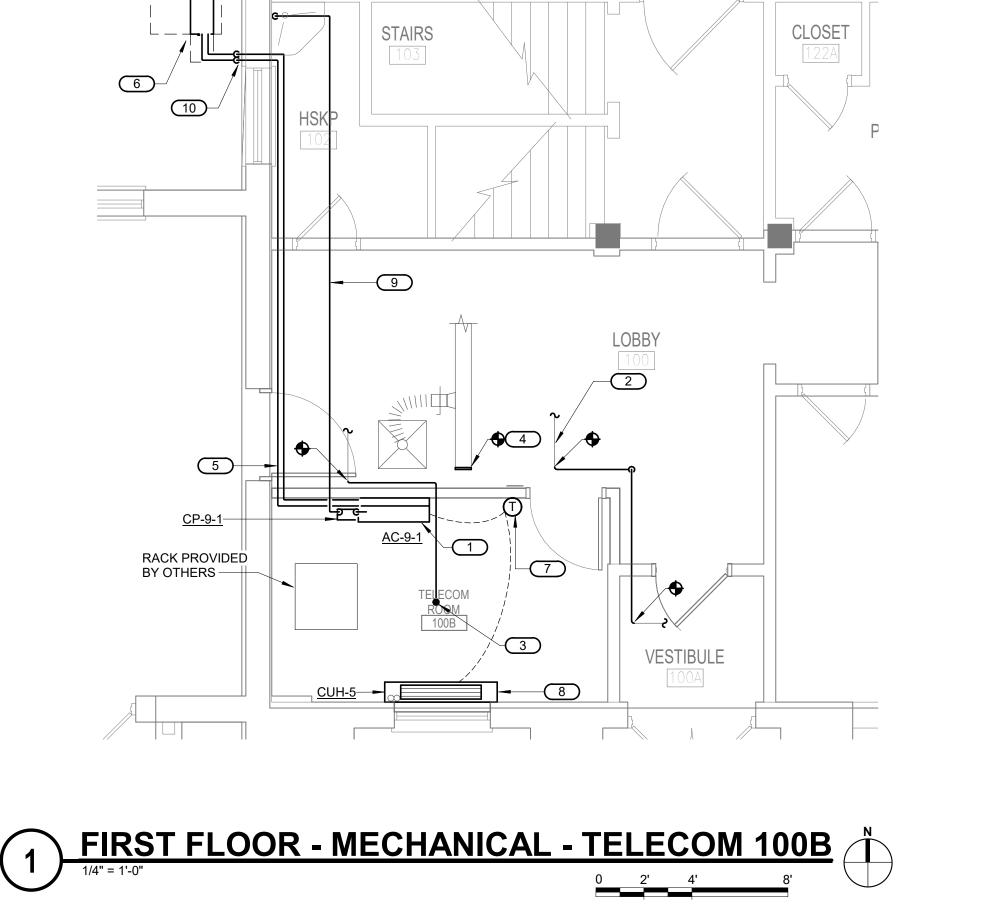

CLOSE

OFFICE 104

<u>CU-9-1</u>

CLOSE

	7		8		9
KE	EYNOTES 1/09-M201:				
1.	PROVIDE NEW WALL-MOU	JNTED DUCTLESS COOLING U	UNIT AC-9-1.		
2.	RE-ROUTE EXISTING 1-1/4 REQUIRMENTS.	I" SPRINKLER PIPE. FIELD VEF	RIFY EXACT		
3.	PROVIDE NEW DEDICATE HEAD.	D FIRE SPRINKLER BRANCH I	LINE AND SPRINKLER		
4.	CAP DUCT IN THIS LOCAT	ION.			
5.		NT PIPING TO NEW CU-9-1 UN GERANT PIPING DETAIL 1/0-G			
6.	PROVIDE NEW AIR COOLE MOUNTING DETAIL 3/0-GM	ED CONDENSING UNIT. PROV /401	IDE CONCRETE PAD. PAD		
7.	PROVIDE NEW THERMOS	TAT - WIRE COMMON TO NEV	V AC UNIT AND CUH.		
8.	PROVIDE NEW CABINET L MAKE CONNECTION.	JNIT HEATER CUH-5. MODIFY	EXISTING PIPING AND		
9.		ENSATE PIPING TO MOP SINK PIPING ASEMBLY WITHIN TEI			
10.). REFERE TO 4/0-GM401 FO	OR WALL PENETRATION SEAL	ING DETAIL.		

DRAWING TITLE FIRST FLOOR REMODEL - MECHANICAL	PROJECT TITLE EHRM INFI UPGRADE		CTURE	DATE: 03/30/2022 PLOT SCALE PROJECT NO. 656-21-235	VA
	BUILDING No	CHECKED BY	DRAWN DJC	DRAWING NO. 09-M201	
	LOCATION VA MEDICAL CEI ST.CLOUD, MN 5		FULLY SPRINKLERED	DWG. OF	



10