


1 BUIL	DING 8 – EF	A INFRA	ASTRUCT	TURE UP(BRADES
A		St. Cloud VA Hea ain Campus, St.			
<page-header> Image: State State</page-header>					DUNTERED THROUGHOUT THE DISTRIBUTION ROUTING THROUGH CEILING PLENUMS AND UTILITY TUNNELS. INSTALLATION I CRA PHASE CONSTRUCTION ROOM SCHEDULE AN NAME CAI BLOG NAME / CONSTRUCTION INFECTION CONTROL CONTROL PROCEDURE CLASS SECTION I RECREATION TYPE B GROUP 1 CLASS II EAST I ROOM RECREATION TYPE B GROUP 1 CLASS II EAST NSTRUCTION INFECTION CONTROL RISK ASSESSMENT (ICRA) DESCRIPTIONS. TYPE, GROUP AND CLASS SELECTED TO BE LL BE MADE AT A LATER DATE. I LEAK PREVENTION / DIVERTER SCHEDULE M NAME OVERHEAD LEAK DIVERTER AND DRAIN PIPING LEAK PREVENTION I MAME OVERHEAD LEAK DIVERTER AND DRAIN PIPING LEAK PREVENTION I ROOM MUMP INT: EAST ALL MWP = MEMBRANE WATERPROOFING. MASONRY = FLUID-APPLIED WATERPROOFING. INT = INTERIOR. EXT = EXTERIOR DENING PANEL INFORMATION FRAME INFORMATION OF TAME INFORMATION I PANEL INFORMATION FRAME INFORMATION OF TAME INFORMATION OF TAME INFORMATION OF TAME INFORMATION OF TAXES OF TAXE
CONSULTANT CONSULTANT	ARCHITECT/ENGINEER OF RECORD SPECIALIZED ENGINEERING SOLUTIONS the the the the the the the the	I hereby certify that this plan, specification or report was prepared by me or under my direct supervision and that I am a duly Licensed Architect under the laws of the State of Minnesota. Image: Date: Date	VICE LINE DIRECTOR DATE: APPROVED: SAFETY MANAGER DATE: APPROVED: M/O MANAGER	ER DATE: APPROVED: ASSOCIATE DIRECTOR DATE: ECTION MANAGER DATE: APPROVED: NURSE EXECUTIVE DATE:	DPGRADES PROJECT NO. 656-21-235 VAA BUILDING No CHECKED BY EM DRAWING NO. 8 EM B EM

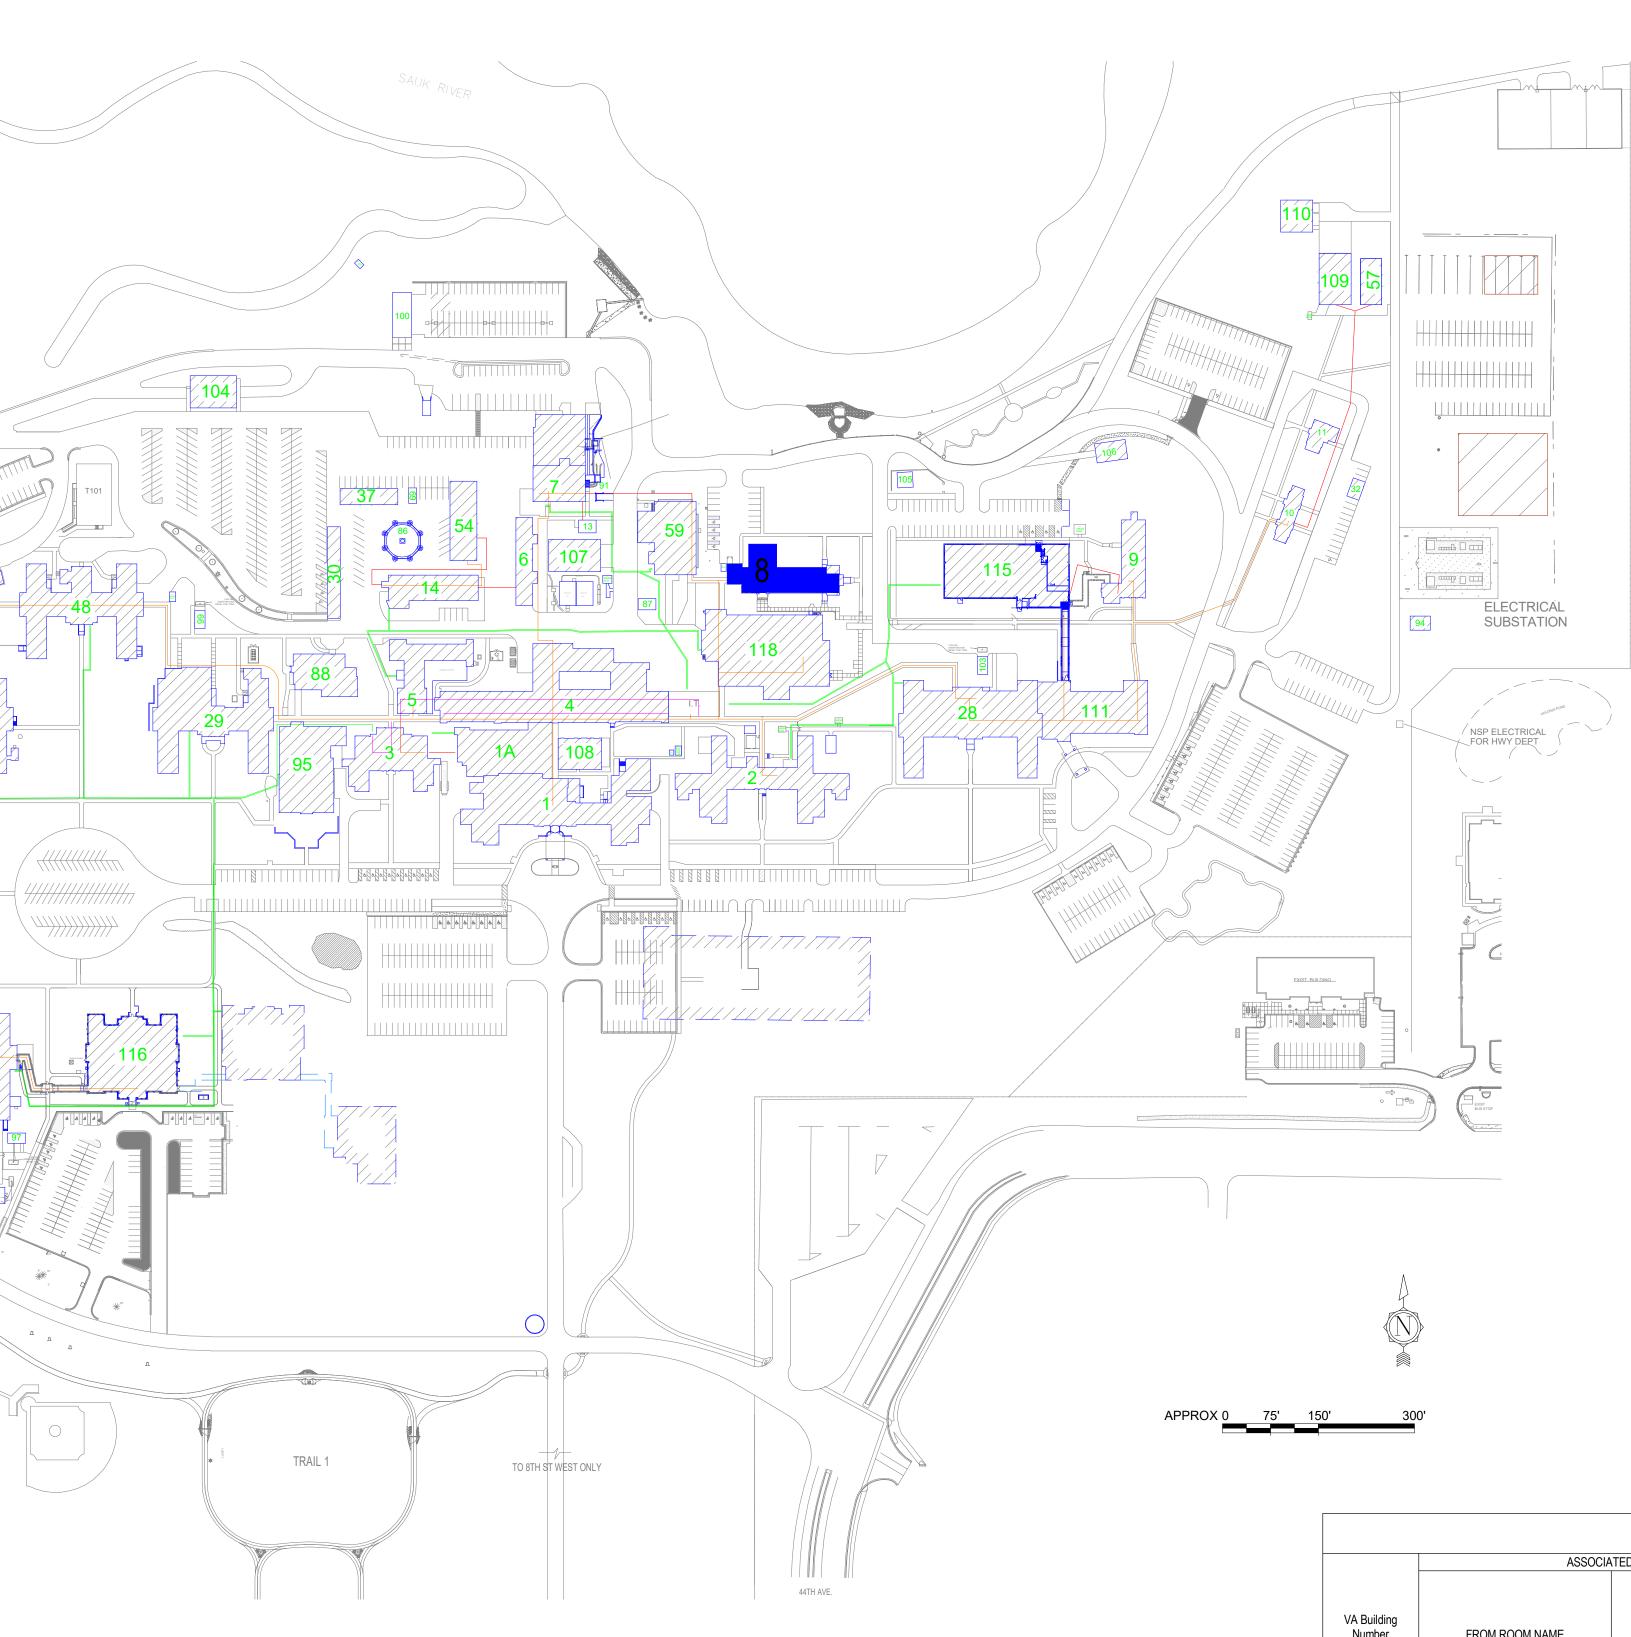


										RC	DOM	SC	HE	DULE	Ē	
NO.		NAME	CABLING	PATCH PANEL	FIBER	POWER	BONDING	UPS	DEDICATED COOLING	TEMPERATURE	HUMIDITY	RACK SENSOR	SPACE	AREA	WIDTH (FT)	LENGT (FT)
BASEME 012A	NT EXIST R	M												15 SF	5.2	2.9
															0.2	2.0
FIRST FL 116		MROOM			X	X		X			X	X		110 SF	8.7	12.6
LE	VEL	ROOM NO.	ROOM	NAME		QUES	STIONA	HAZ	ZARDC		IS M	ATE	ERI	AL S(CHED	POS
BASEME	NT	012A	EXIST RM			ASBESTO UNDER F				-	NONE.	ACM T	OREN	ain und	ISTURBED)
	OUS MAT		TELECOM F AY BE ENCO S MATERIAL	UNTER		NONE. SE IROUGHO			RIBUTIC	ON ROU				COMPLE		
						ICR	AP	HAS	SE C	CON	STF	RUC	TIC	N RC	DOM	SCF
LE	EVEL	ROOM NO.	ROOM	/I NAME			I BLDG FUNCT	NAME / TON			STRUC ECT AC		INF	ECTION C RISK GR		PROC
BASEM	ENT	012A	EXIST RM			F	RECREA	TION			TYPE B			GROUF	P1	
	NERAL N		TELECOM ET FOR CON THE VA WIL	ISTRUC		INFECTION		NTROL	RISK AS		TYPE C /IENT (I(ESCRI	grouf Ptions. 1		oup an
						L	EA	k pf	REV	′EN ⁻	ΓΙΟΝ	\ / D	IVE	ERTE	R SC	HED
LE	EVEL	ROOM NO.	ROOM	/I NAME			C	VERHE	AD LEA	AK DIVE	RTER A	ND DR.	AIN PI	PING		


	OPENING SCHEDULE										
	ASSOCI	ATED ROOMS		OPENING		PAN	EL INFORMA	TION	FRAME INFOR	RMATION	
VA Building Number	FROM ROOM NAME	TO ROOM NAME	NUMBER	WIDTH	HEIGHT	PANEL TYPE	2ND PANEL TYPE	PANEL GLAZING	FRAME TYPE	FRAME GLAZING	HDW GROUP

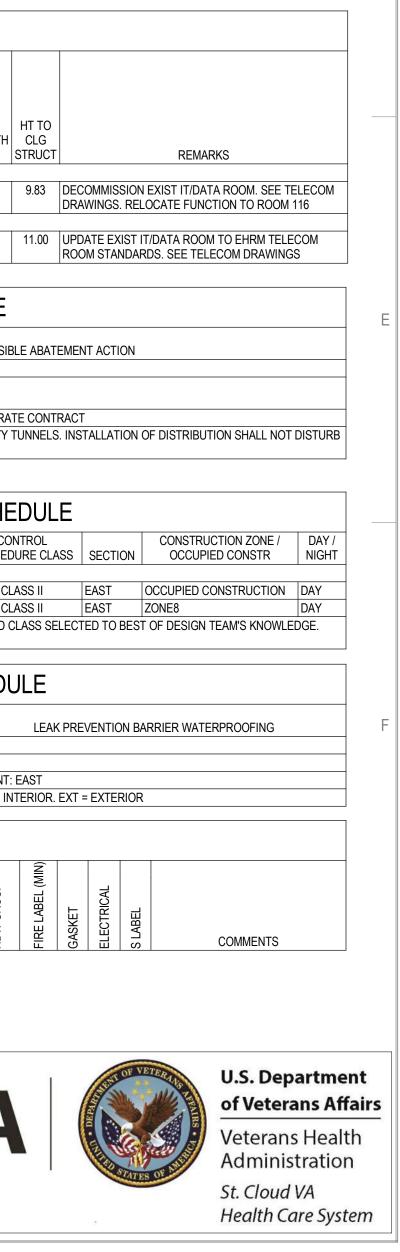

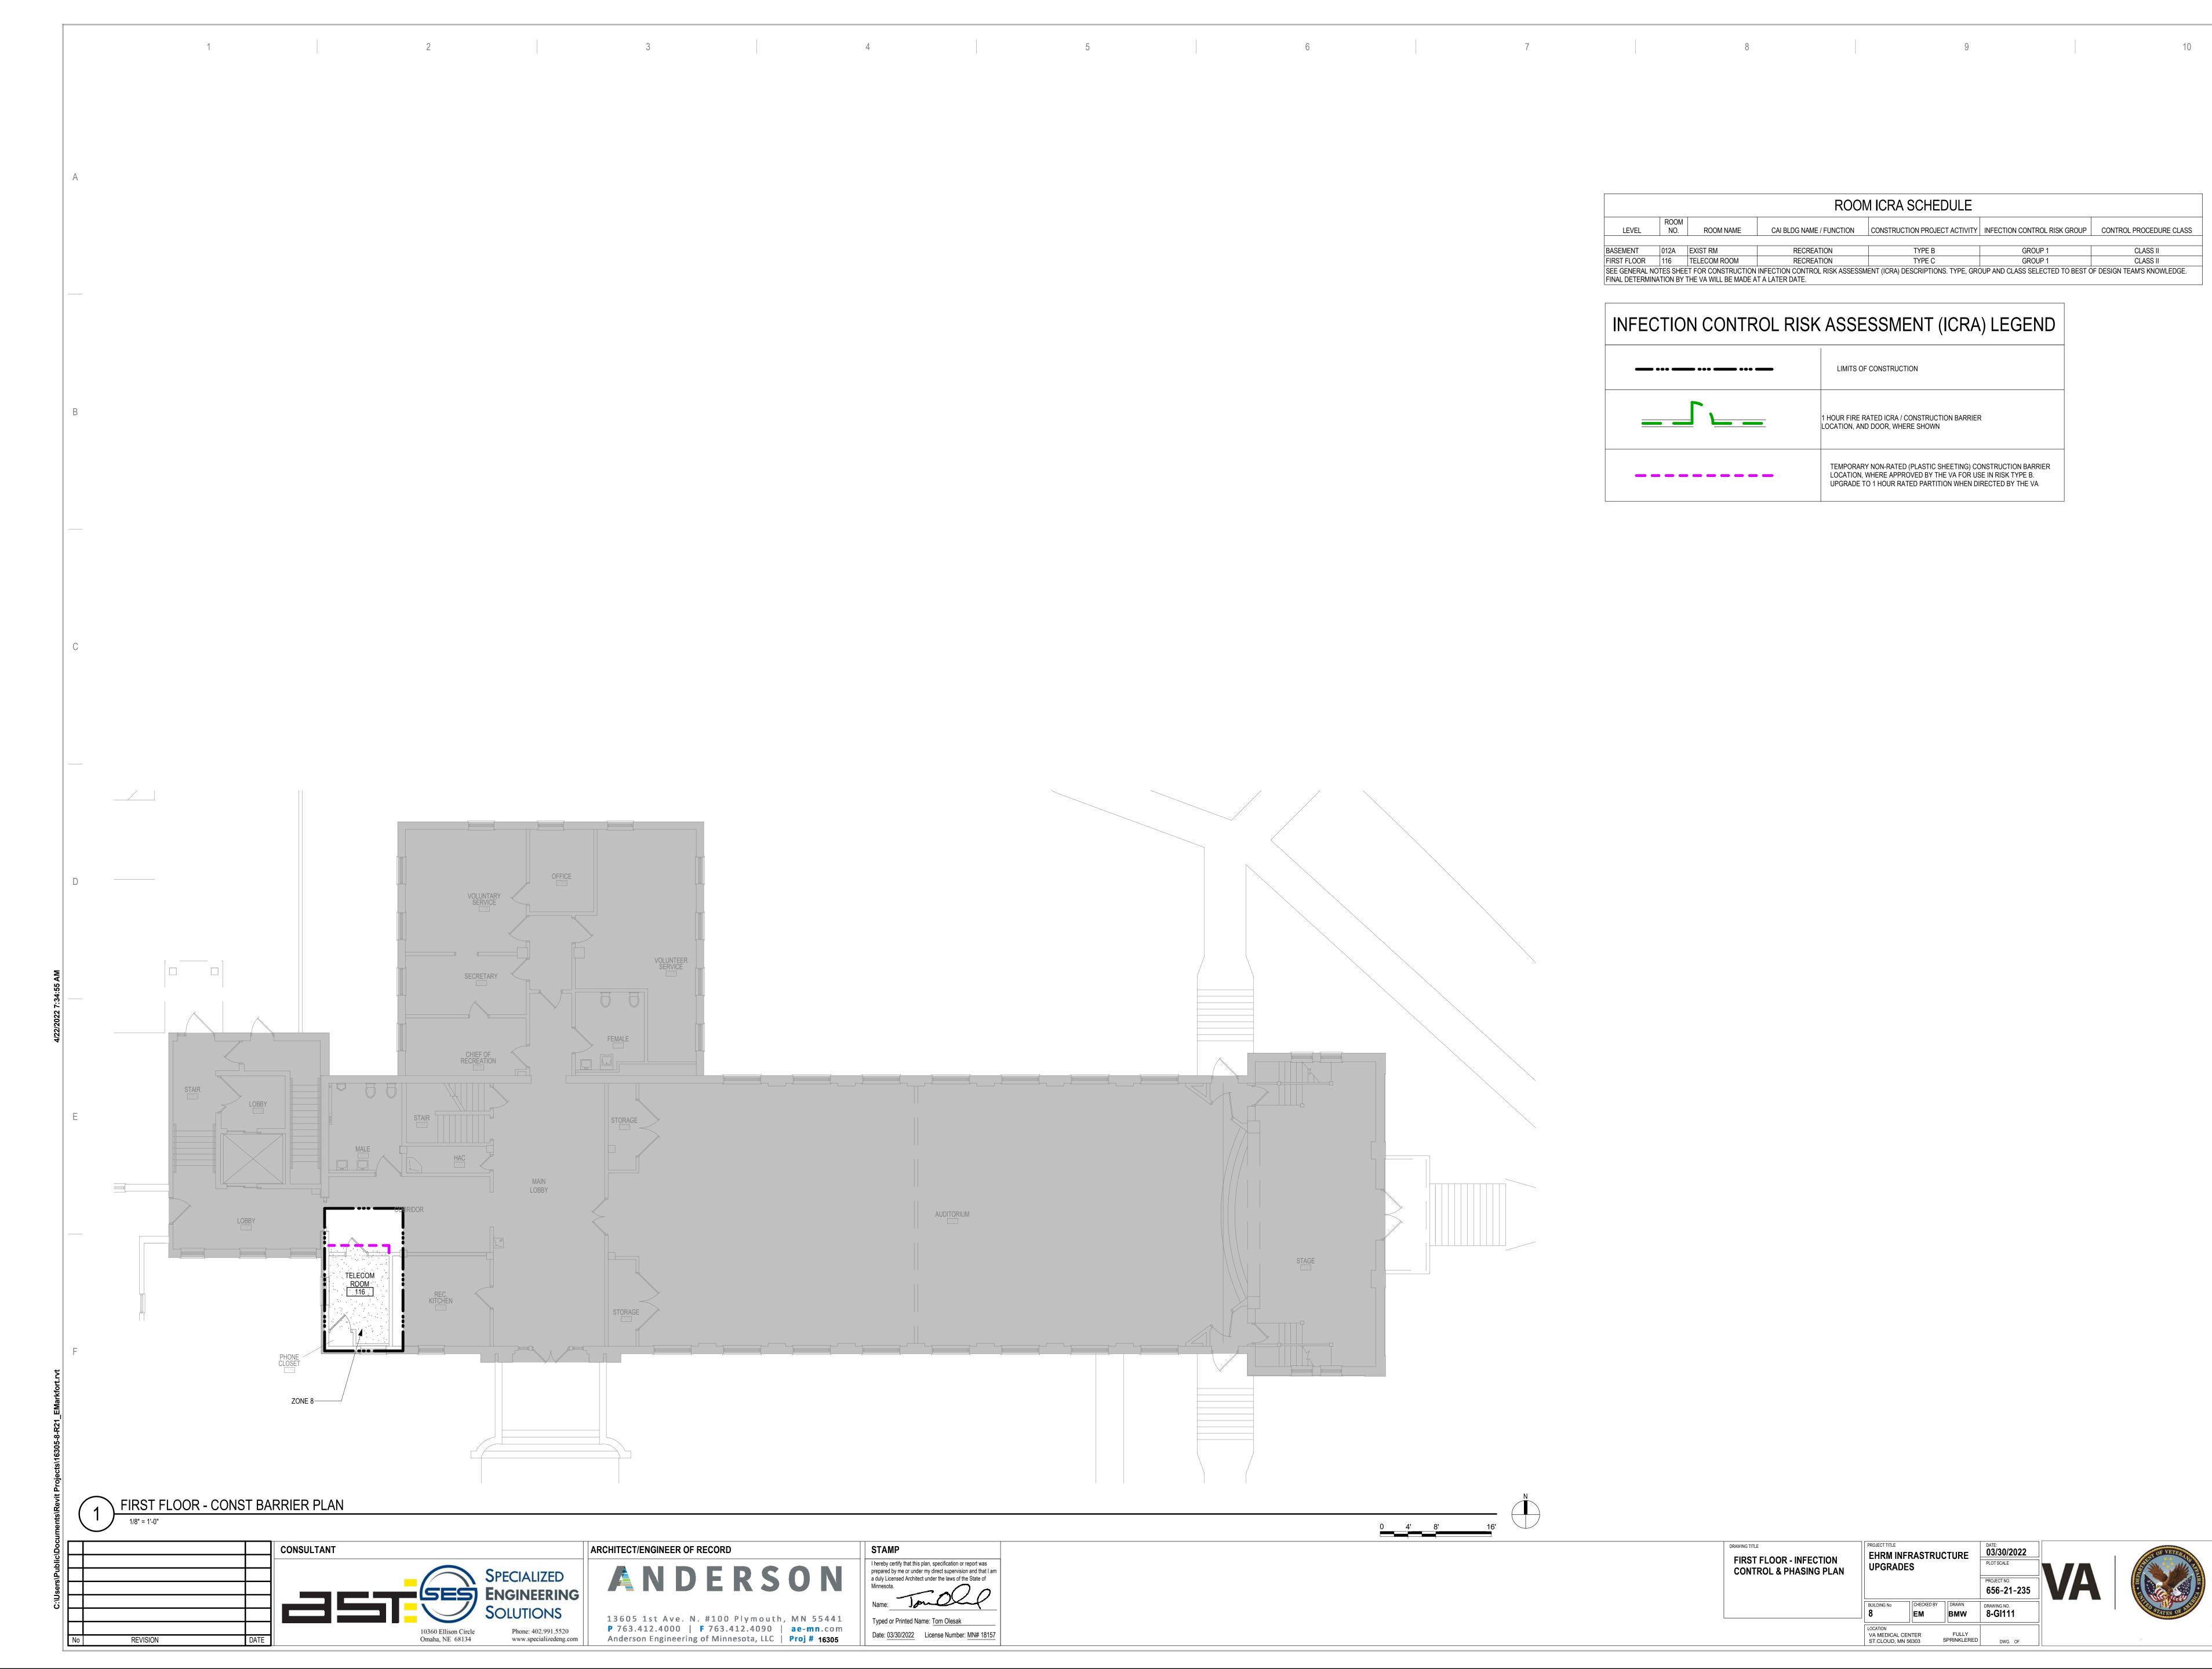


		CAI BLDG NAME / FUNCTION	CONSTRUCTION PROJECT ACTIVITY	INFECTION CONTROL RISK GROUP	CONTROL PROCEDURE CLASS
BASEMENT 012A E	XIST RM	RECREATION	TYPE B	GROUP 1	CLASS II
FIRST FLOOR 116 TE	ELECOM ROOM	RECREATION	TYPE C	GROUP 1	CLASS II

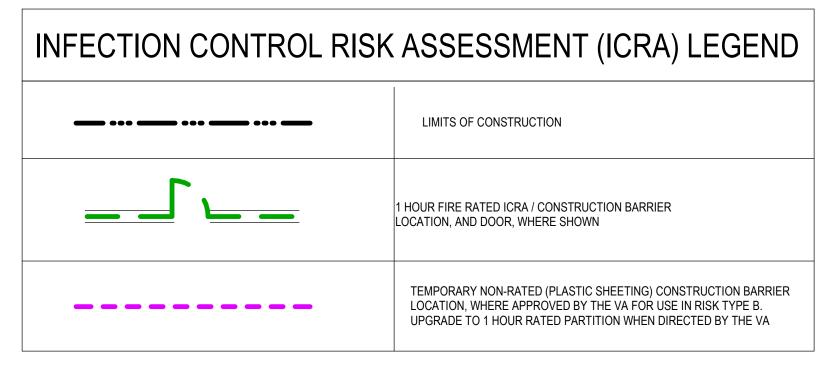


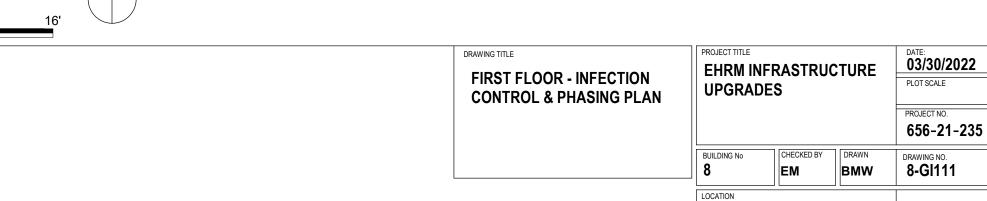

FULLY SPRINKLERED VA MEDICAL CENTER ST.CLOUD, MN 56303 DWG. OF



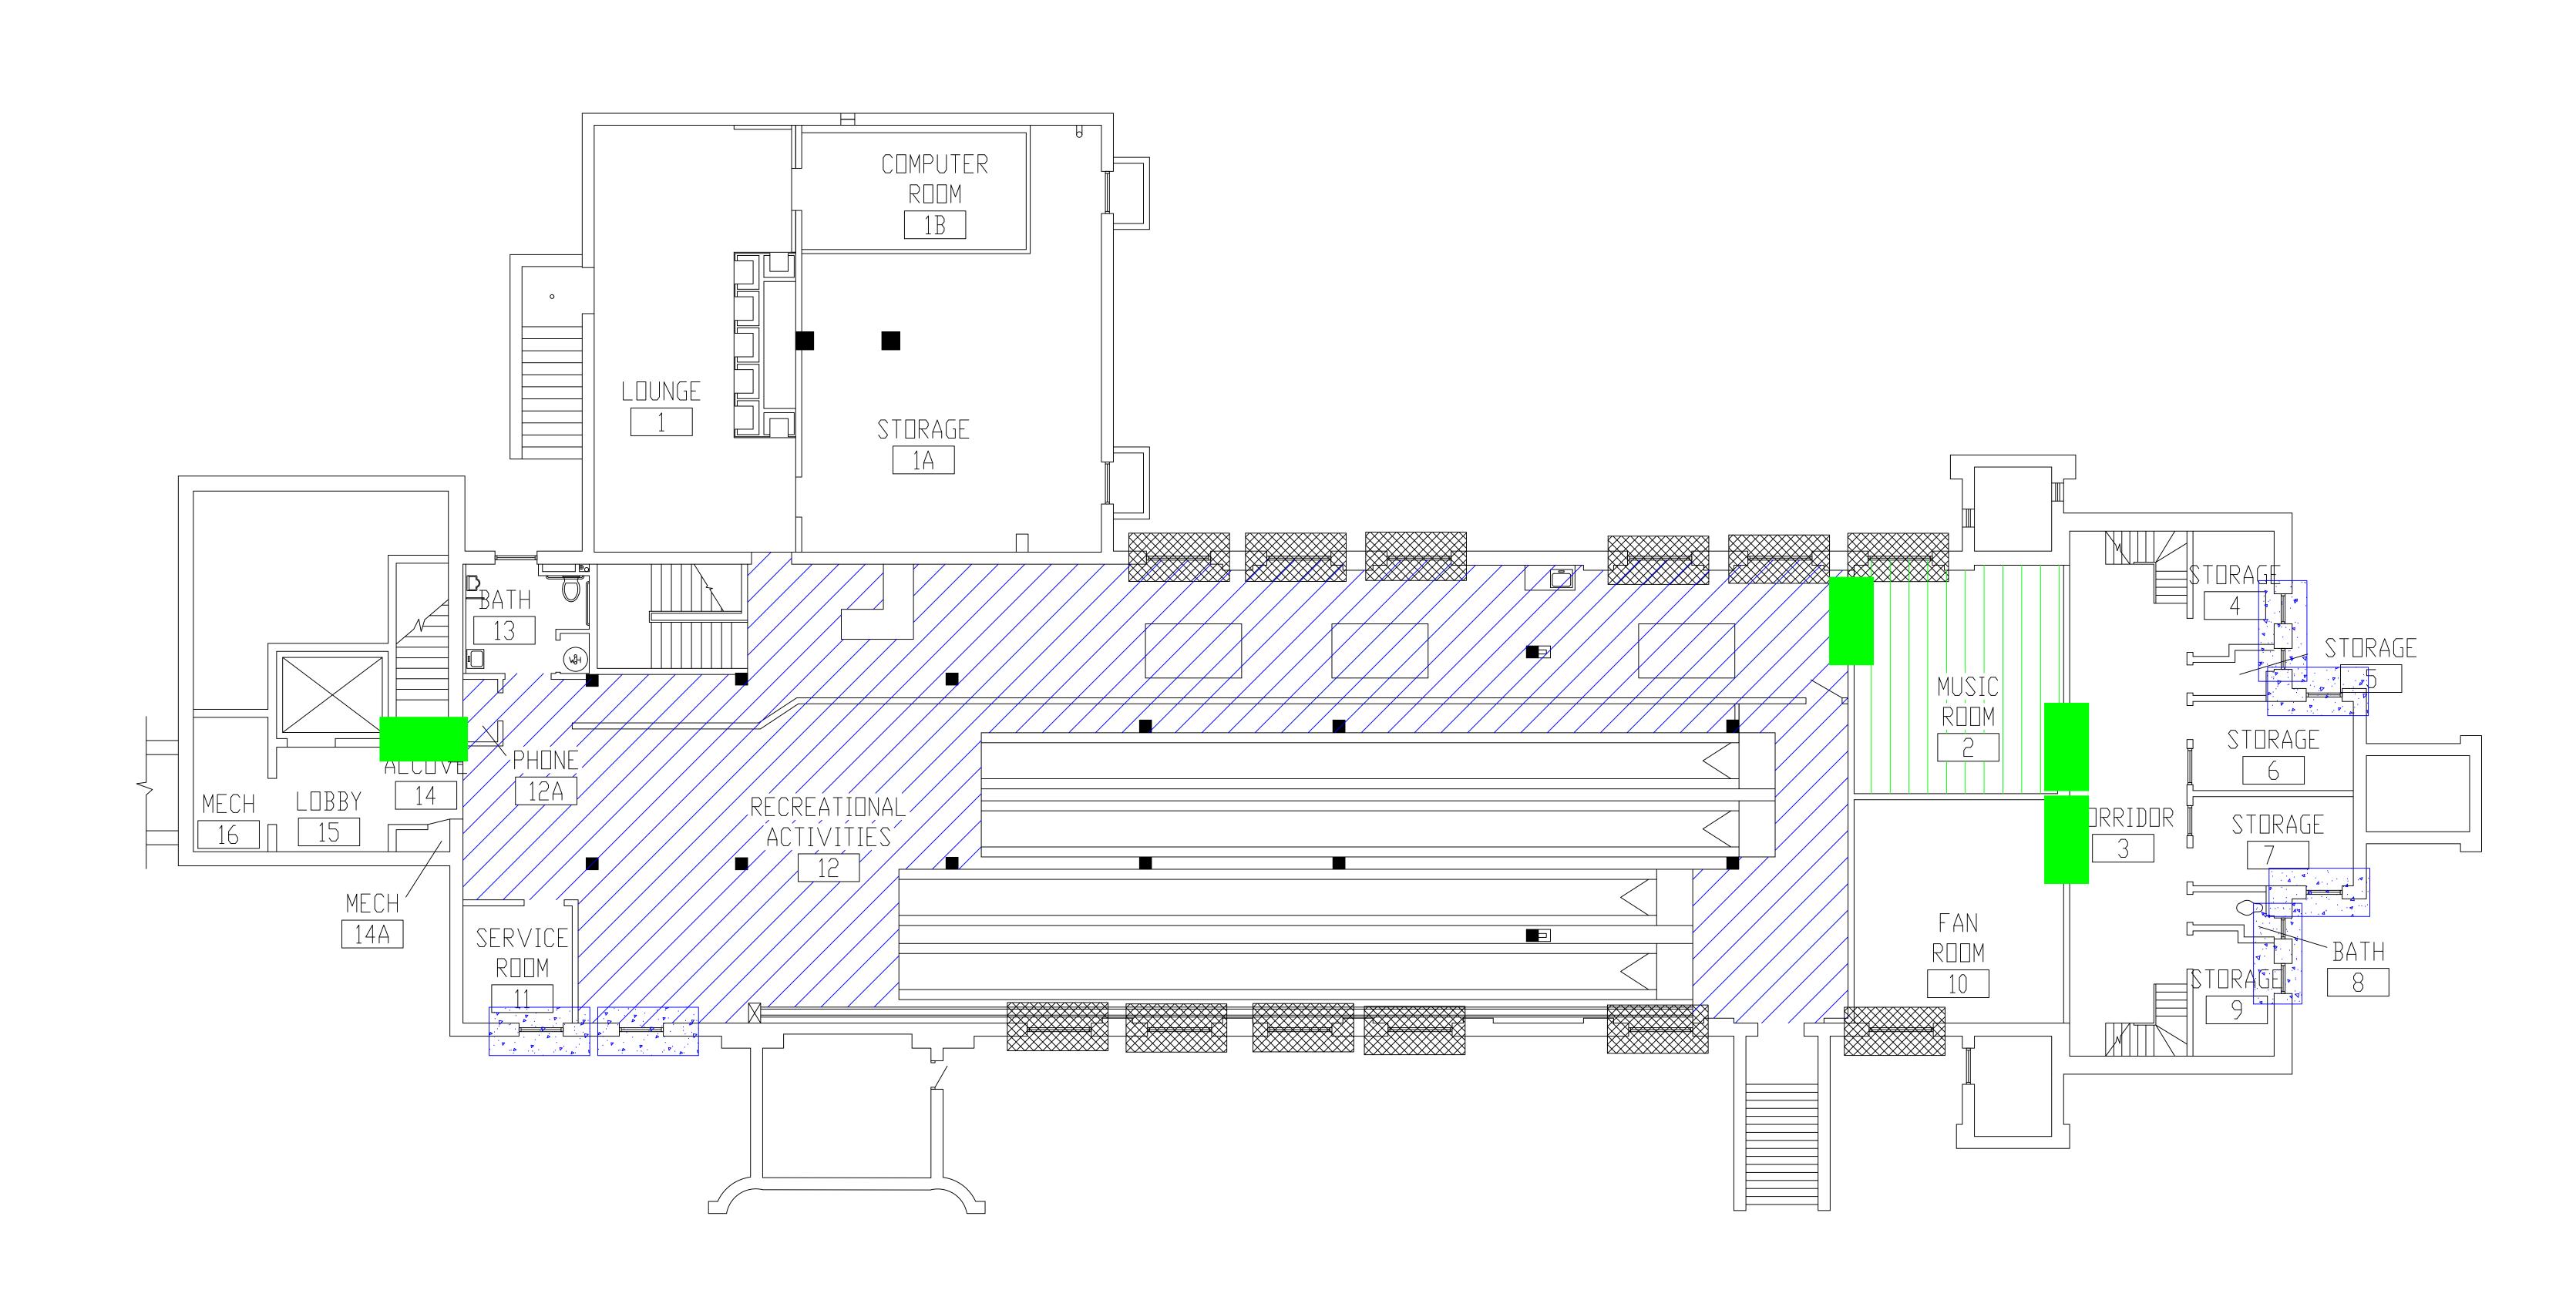

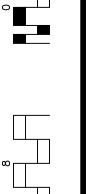

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one-eighth inch = one foot 0 4 8 16 16 16

Revisions

LEGEND

-ASBESTOS-CONTAINING FIRE DOOR

-ASBESTOS-CONTAINING 9"X9" FLOOR TILE AND MASTIC

-ASBESTOS-CONTAINING MASTIC UNDER 12"X12" FLOOR TILE

Dates

1

-ASBESTOS-CONTAINING WINDOW CAULK AND GLAZING

-ASBESTOS-CONTAINING WINDOW CAULK

ENVIRONMENTAL CONSULTANT: CASTLE HILL ASSOCIATES, LLC. 218–A MECHANIC STREET, WATERVILLE, OHIO 43566 Tel: (567) 952–0212


BUILDING #8 - BASEMENT FLOOR PLAN




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N o utilo e	Drawing Title	Project Title			Date	
North: ∾	ARCHITECTURAL PLAN		ASBESTOS RE- NS ADMINISTRA		NOVEMBER 2019	9
W	BUILDING 8 Scale: 1/8" = 1'-0"	ME ST. Cl	Project No. 36C26319P1003	}		
	Approved : Division Chief	Building Number 008	Checked BLB	Drawn AFS	Drawing No.	
	Approved : Service Director	Location ST. CLO	1 A Sheet 19 of 71			





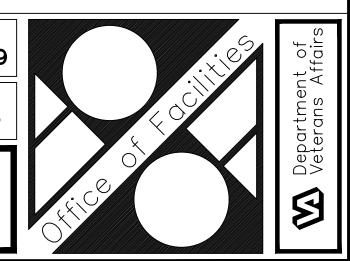
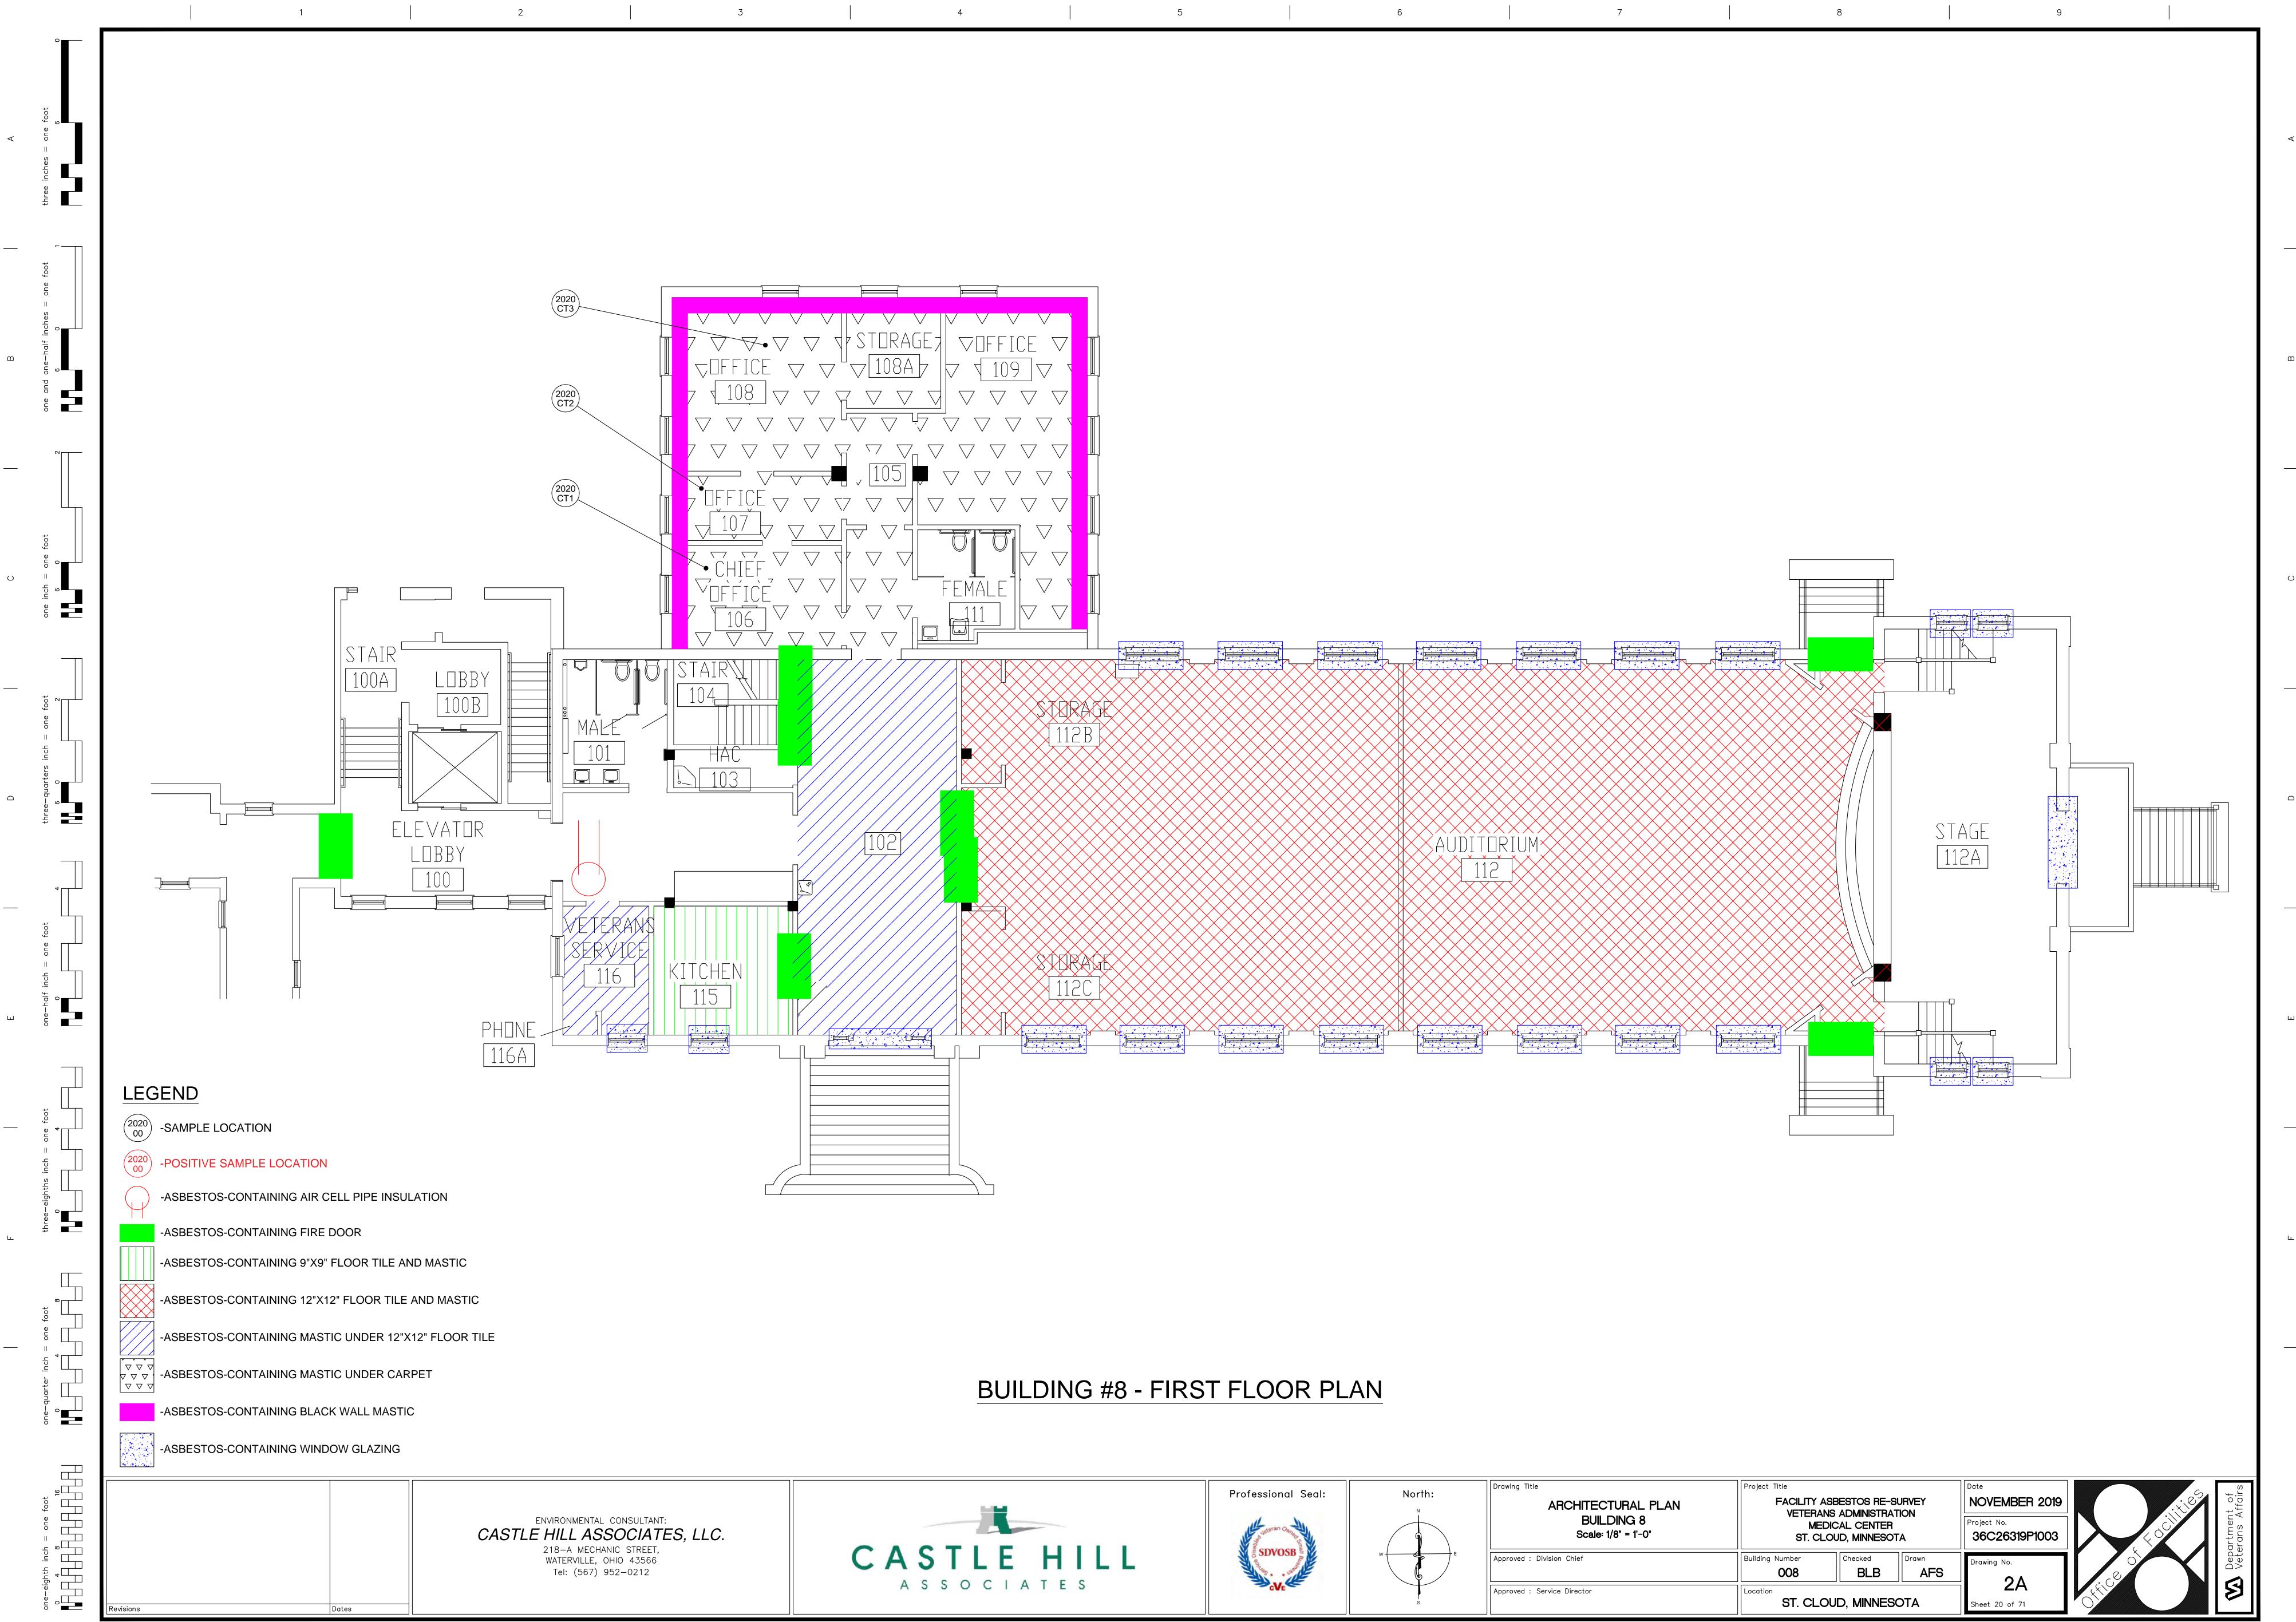
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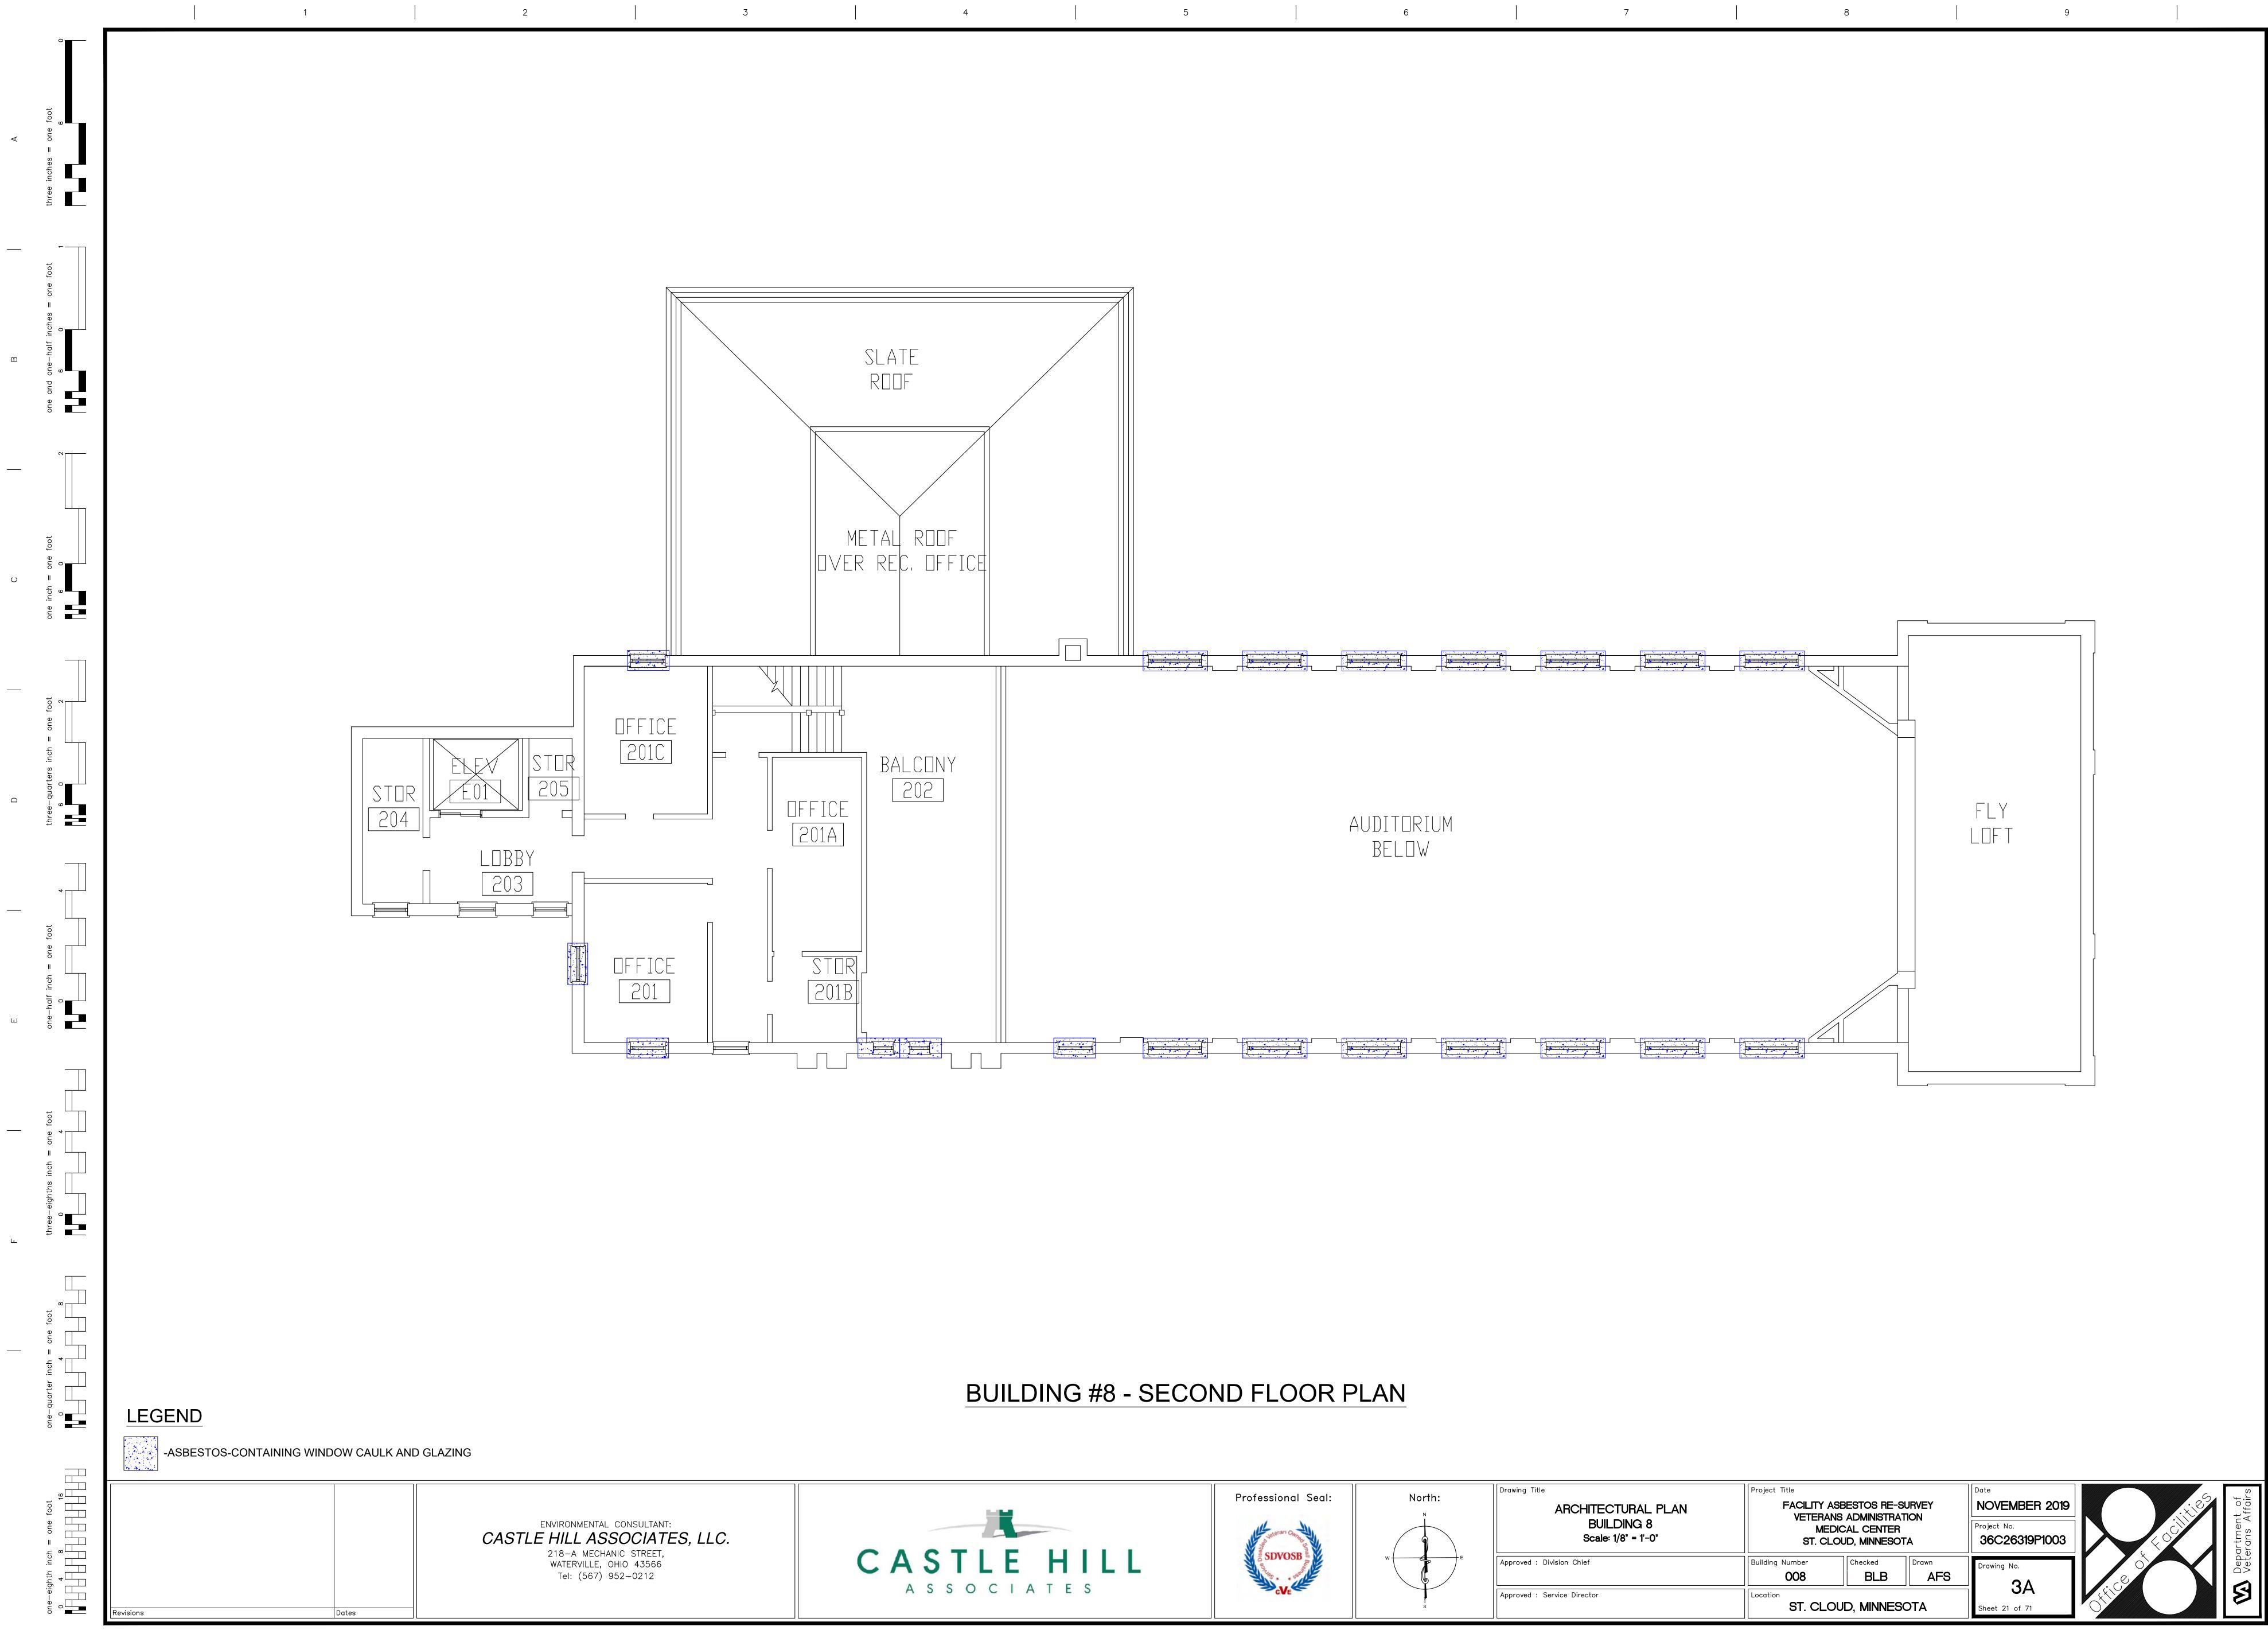
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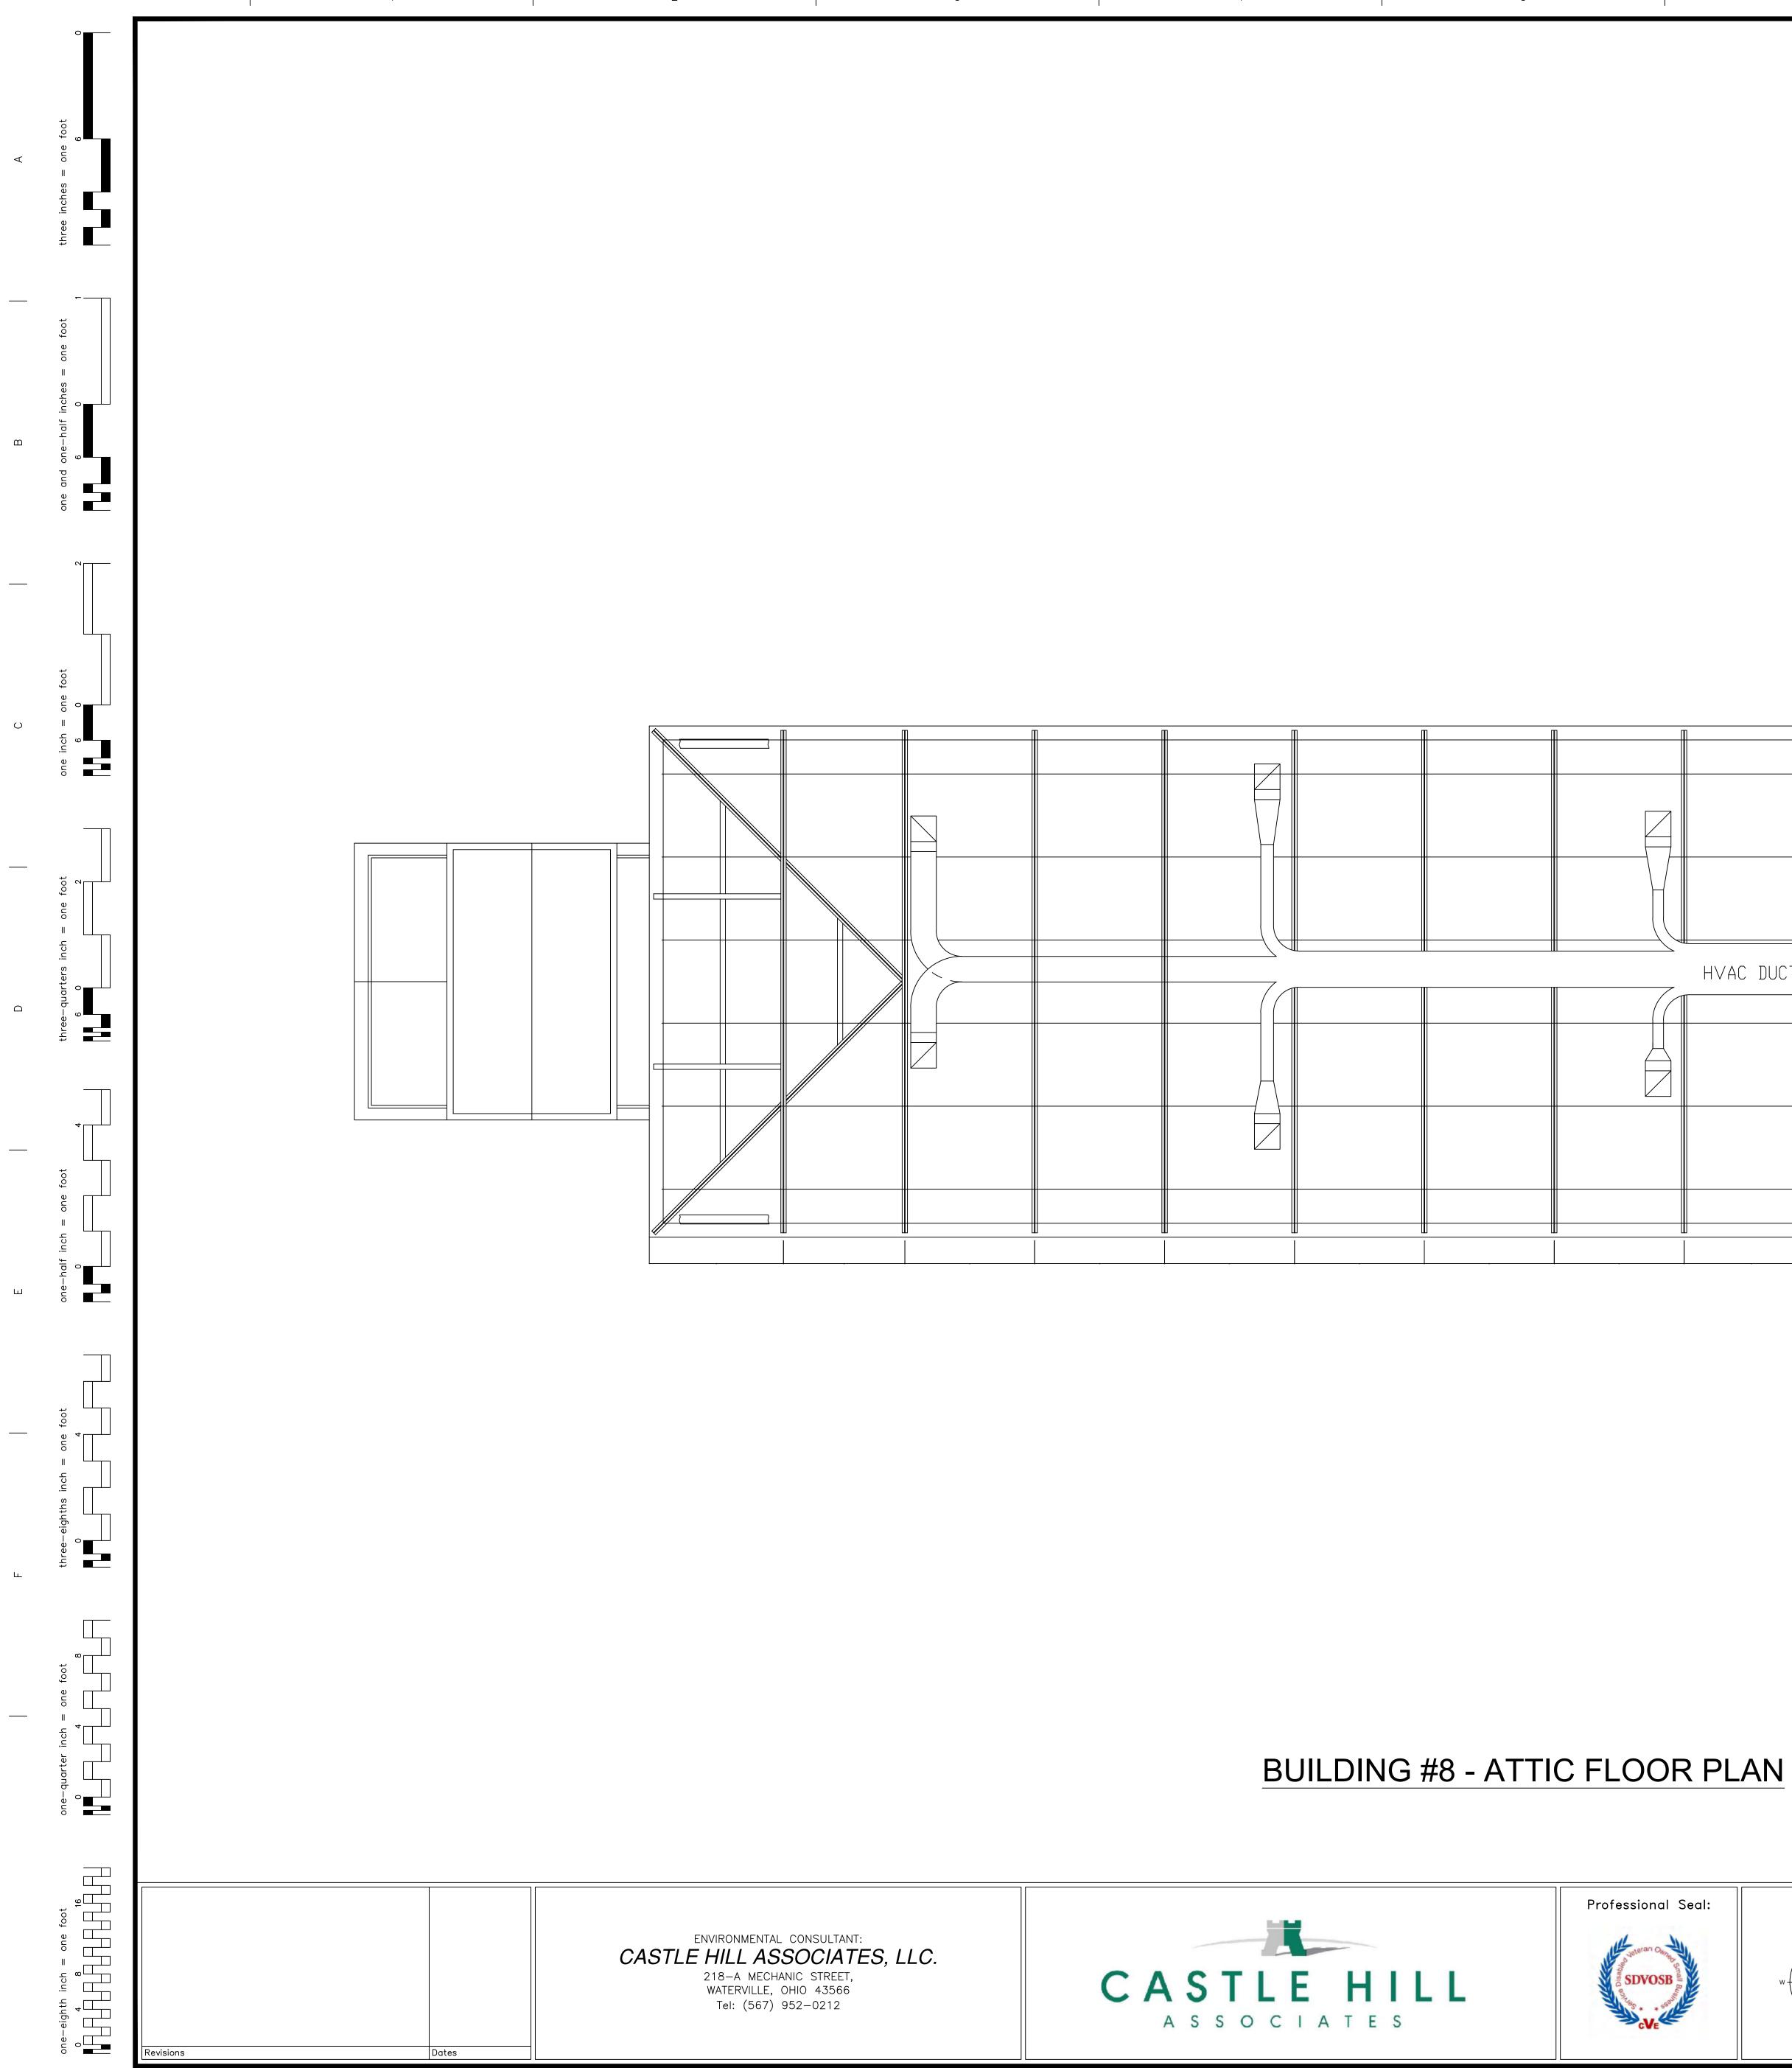


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North:	Drawing Title	Project Title			Date NOVEMBER 2019	
	ARCHITECTURAL PLAN		SBESTOS RE-S			
W	BUILDING 8 Scale: 1/8" = 1'-0"	ME	MEDICAL CENTER ST. CLOUD, MINNESOTA			
	Approved : Division Chief	Building Number	Checked BLB	Drawn AFS	Drawing No.	
	Approved : Service Director	Location ST. CLC	3A Sheet 21 of 71			



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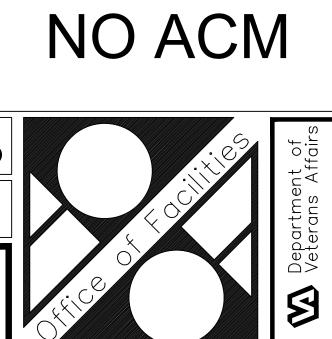


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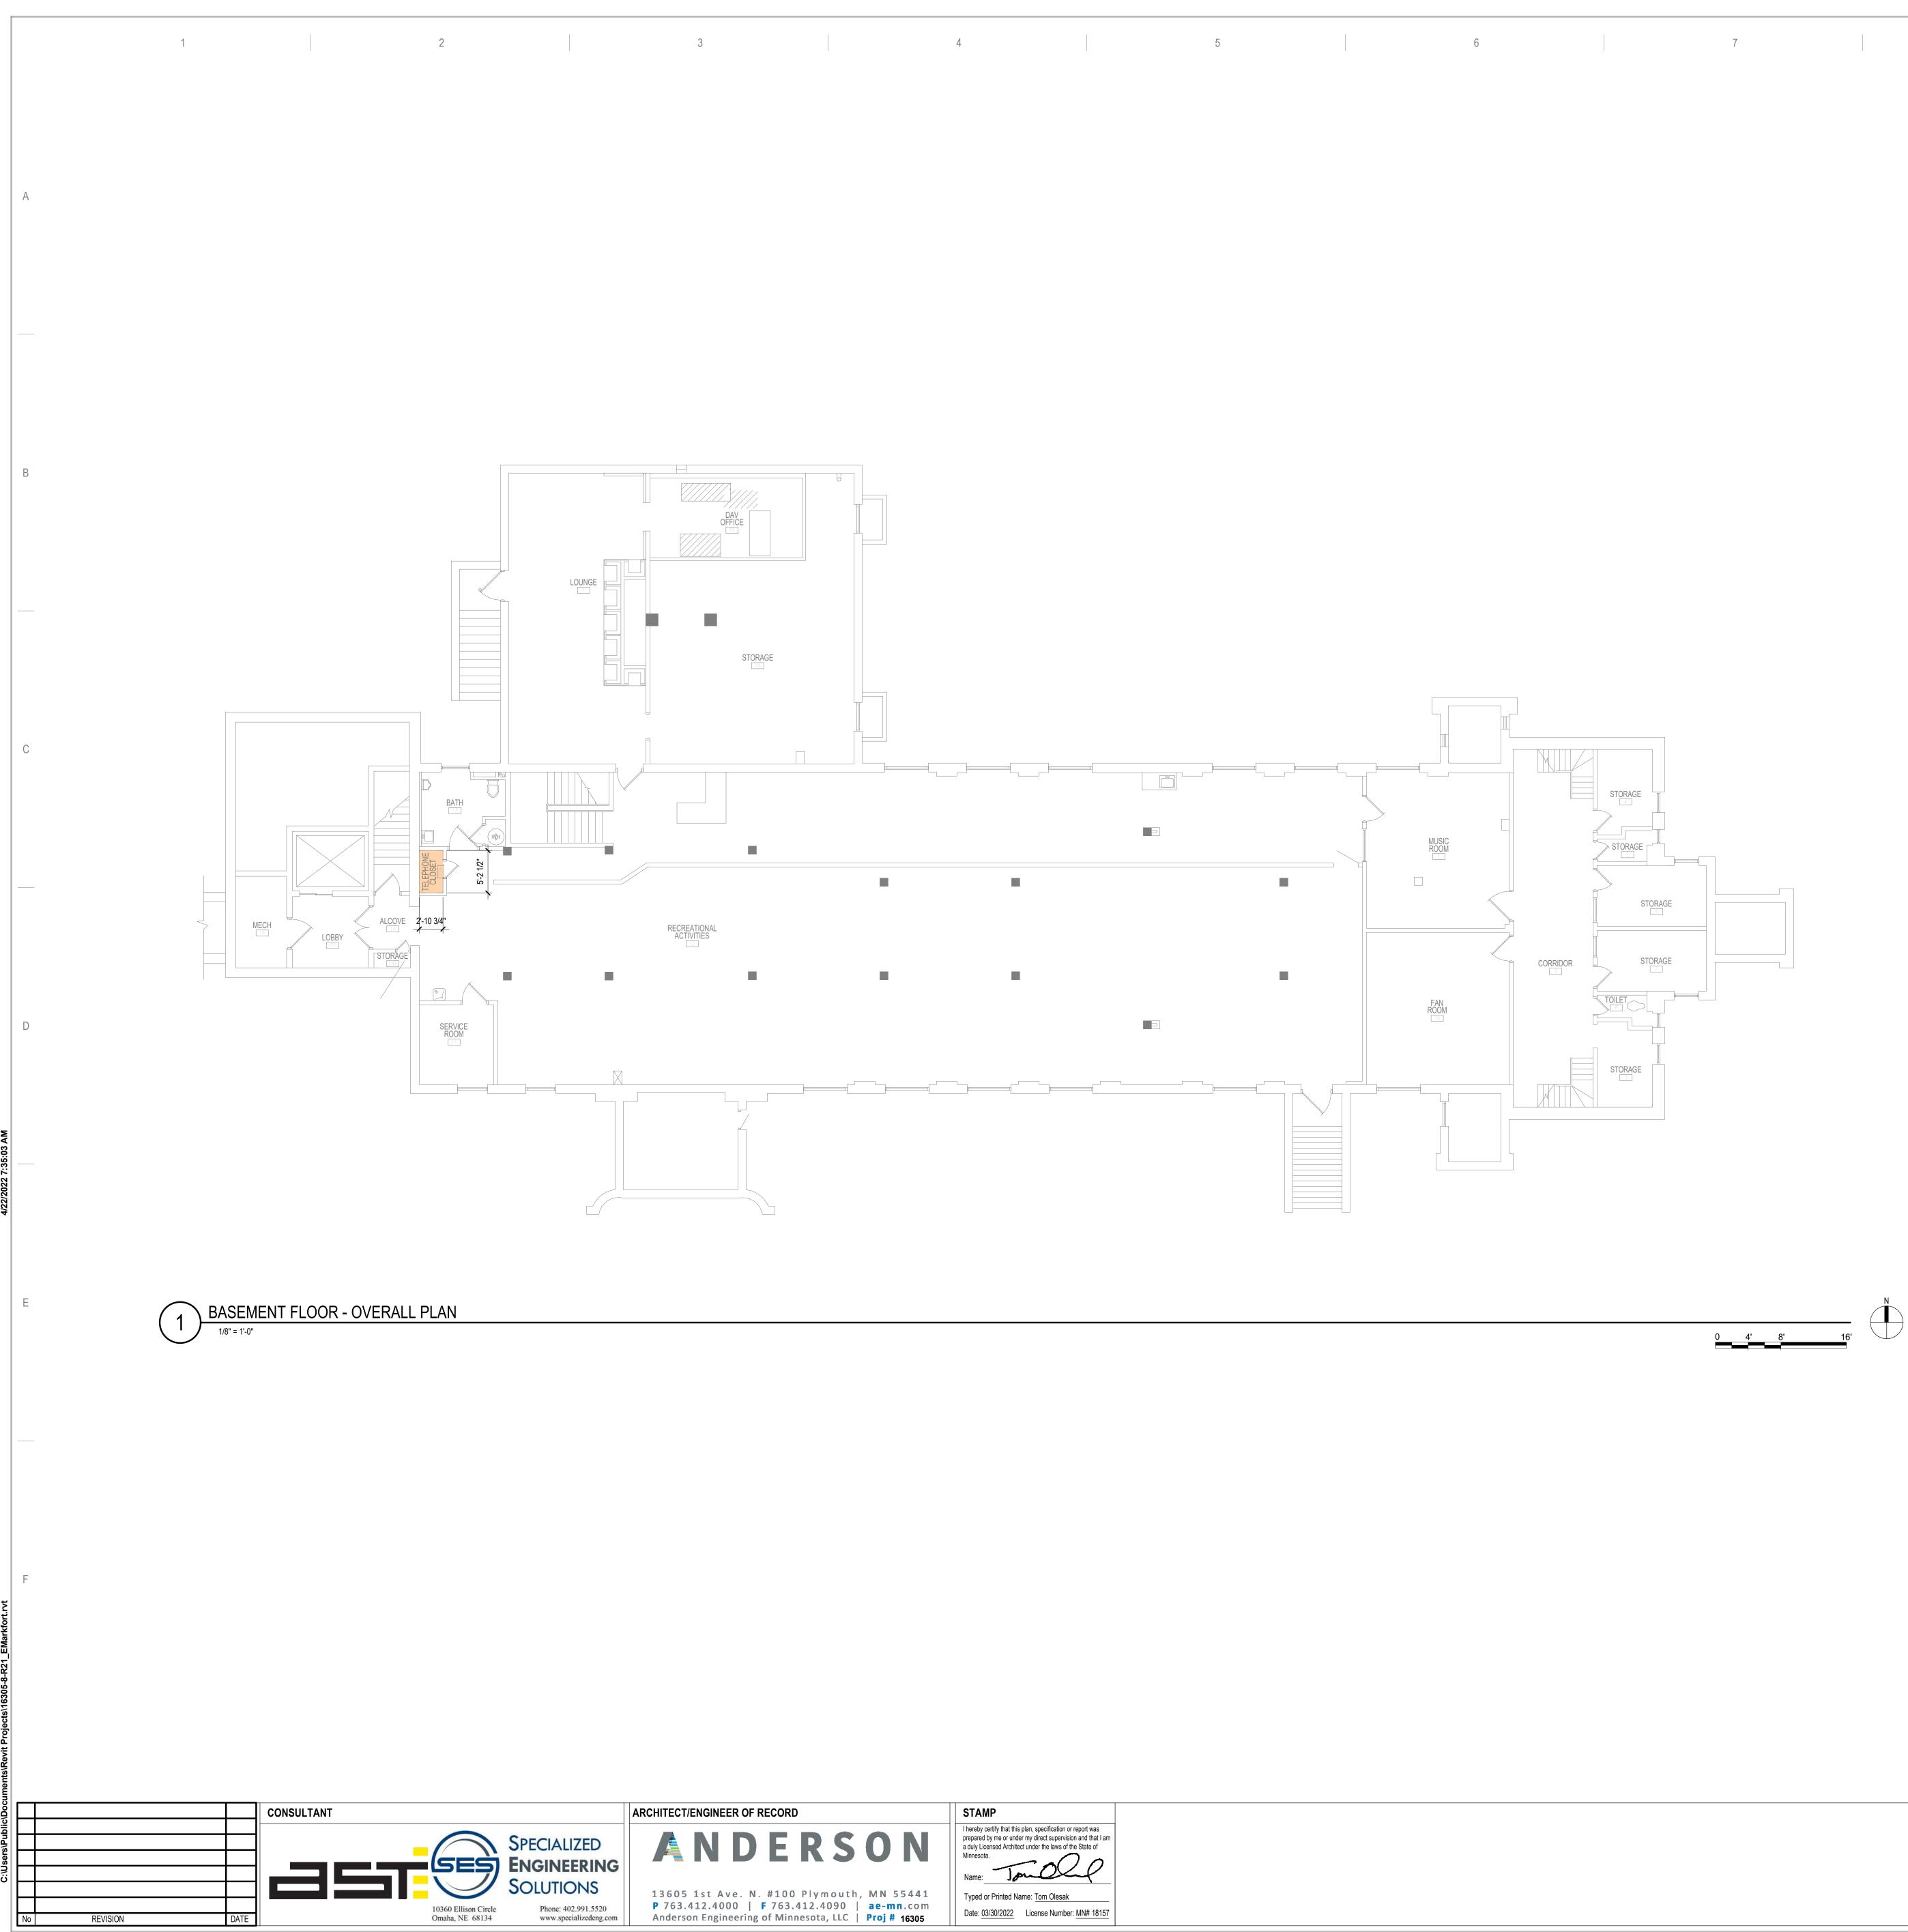
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North:	Drawing Title ARCHITECTURAL PLAN		BESTOS RE-S		Date NOVEMBER 2019	
	BUILDING 8 Scale: 1/8" = 1'-0"	MEDI	VETERANS ADMINISTRATION MEDICAL CENTER ST. CLOUD, MINNESOTA			
W E	Approved : Division Chief	Building Number	Checked BLB	Drawn AFS	Drawing No.	
	Approved : Service Director	Location ST. CLOU	4A Sheet 22 of 71			




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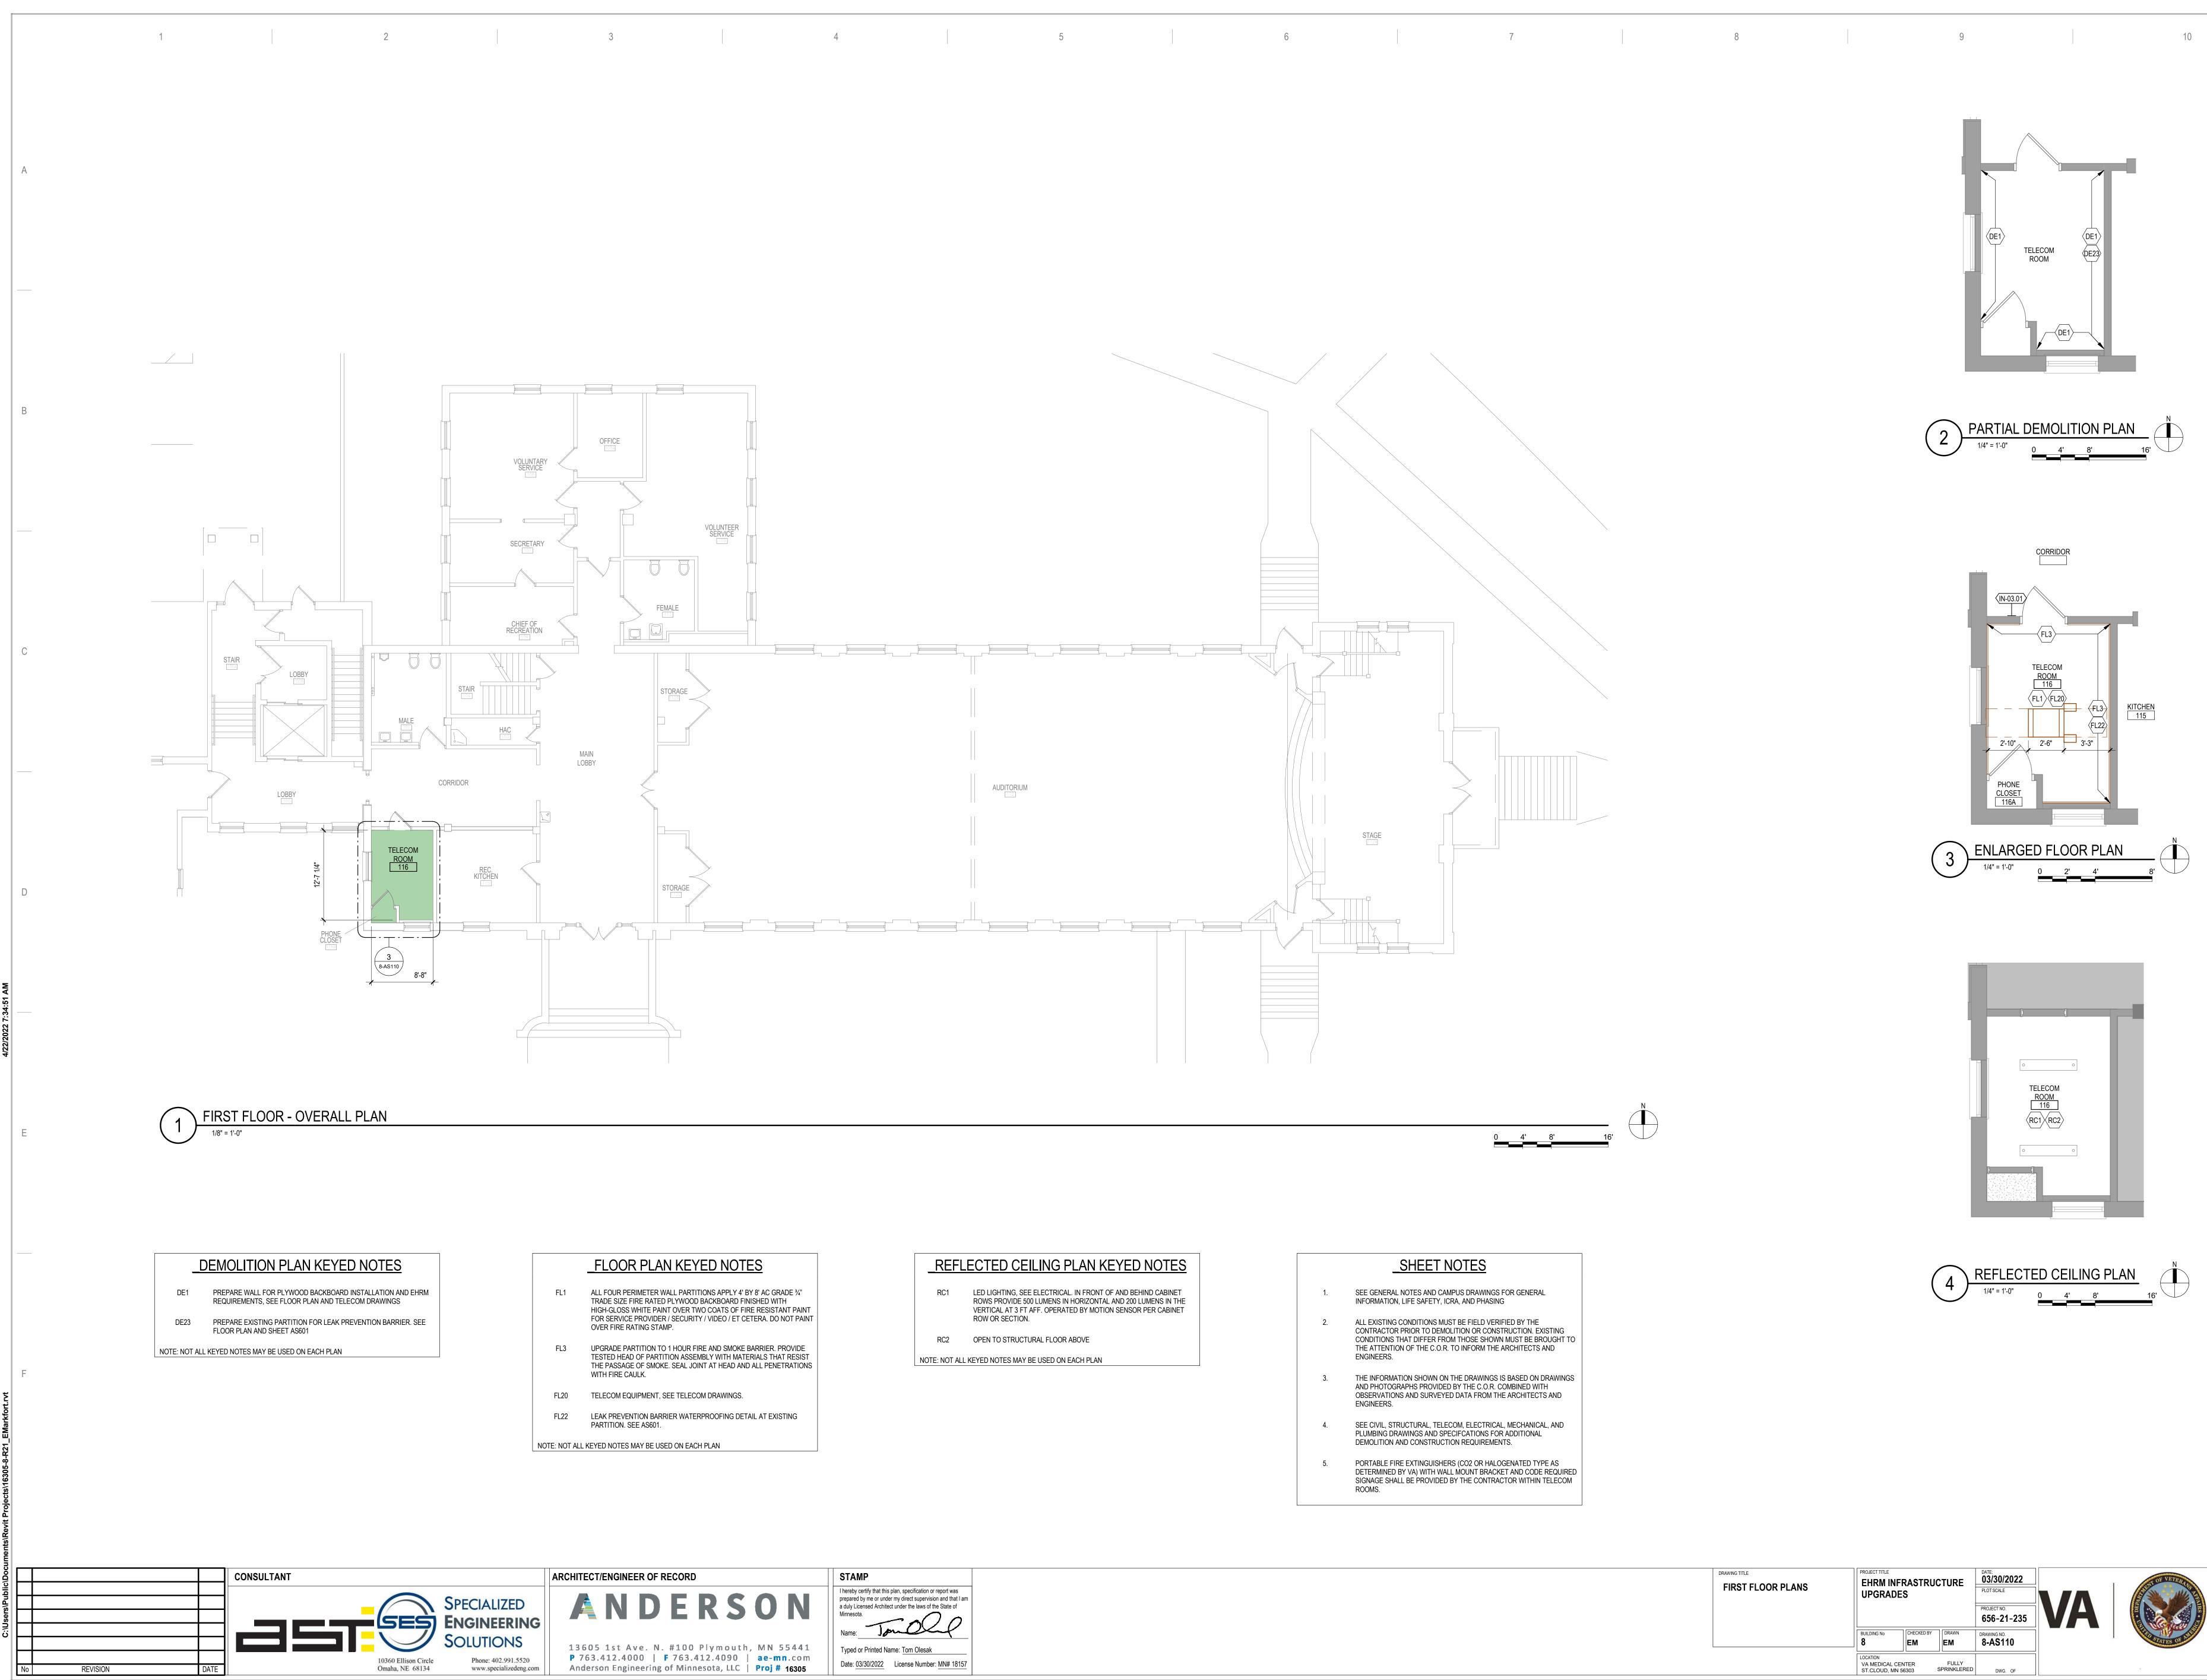
7	8	9	
			SHEE
		1.	SEE GENERAL NOTES AN INFORMATION, LIFE SAFE
		2.	ALL EXISTING CONDITION CONTRACTOR PRIOR TO CONDITIONS THAT DIFFE THE ATTENTION OF THE ENGINEERS.
		3.	THE INFORMATION SHOW AND PHOTOGRAPHS PRO OBSERVATIONS AND SUF ENGINEERS.
		4.	SEE CIVIL, STRUCTURAL, PLUMBING DRAWINGS AN DEMOLITION AND CONST
		5.	Portable fire extingl Determined by VA) wit Signage shall be prov Rooms.

DRAWING TITLE BASEMENT FLOOR - OVERALL PLAN	EHRM INF		CTURE	DATE: 03/30/2022 PLOT SCALE PROJECT NO. 656-21-235	VA	
	BUILDING No	CHECKED BY	DRAWN EM	DRAWING NO. 8-AS100		ļ
	LOCATION VA MEDICAL CE ST.CLOUD, MN §		FULLY SPRINKLERED	DWG. OF		




10



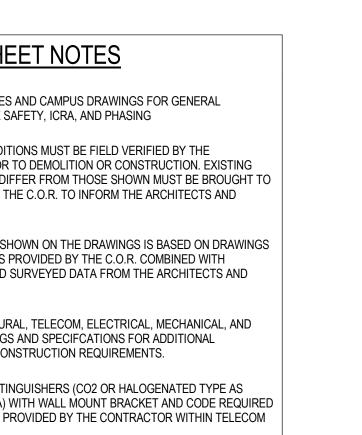

N KEYED NOTES	_REFLECTED CEILING PLAN KEYED NOTES		
VALL PARTITIONS APPLY 4' BY 8' AC GRADE ¾" O PLYWOOD BACKBOARD FINISHED WITH NT OVER TWO COATS OF FIRE RESISTANT PAINT R / SECURITY / VIDEO / ET CETERA. DO NOT PAINT MP.	RC1LED LIGHTING, SEE ELECTRICAL. IN FRONT OF AND BEHIND CABINET ROWS PROVIDE 500 LUMENS IN HORIZONTAL AND 200 LUMENS IN THE VERTICAL AT 3 FT AFF. OPERATED BY MOTION SENSOR PER CABINET ROW OR SECTION.RC2OPEN TO STRUCTURAL FLOOR ABOVE	1. 2.	SEE G INFOR ALL EX CONTI COND
D 1 HOUR FIRE AND SMOKE BARRIER. PROVIDE ITION ASSEMBLY WITH MATERIALS THAT RESIST (E. SEAL JOINT AT HEAD AND ALL PENETRATIONS	NOTE: NOT ALL KEYED NOTES MAY BE USED ON EACH PLAN		THE A ENGIN
SEE TELECOM DRAWINGS.		3.	THE IN AND P OBSEI ENGIN
RIER WATERPROOFING DETAIL AT EXISTING		4.	SEE C PLUMI DEMO
ED UN EACH PLAN		5.	PORT/ DETEF SIGNA ROOM

DRAWING TITLE FIRST FLOOR PLANS	PROJECT TITLE EHRM INI UPGRAD		JCTURE	DATE: 03/30/2022 PLOT SCALE PROJECT NO. 656-21-235	VA
	BUILDING No	CHECKED BY	DRAWN EM	DRAWING NO. 8-AS110	
	LOCATION VA MEDICAL C ST.CLOUD, MN		FULLY SPRINKLERED	DWG. OF	

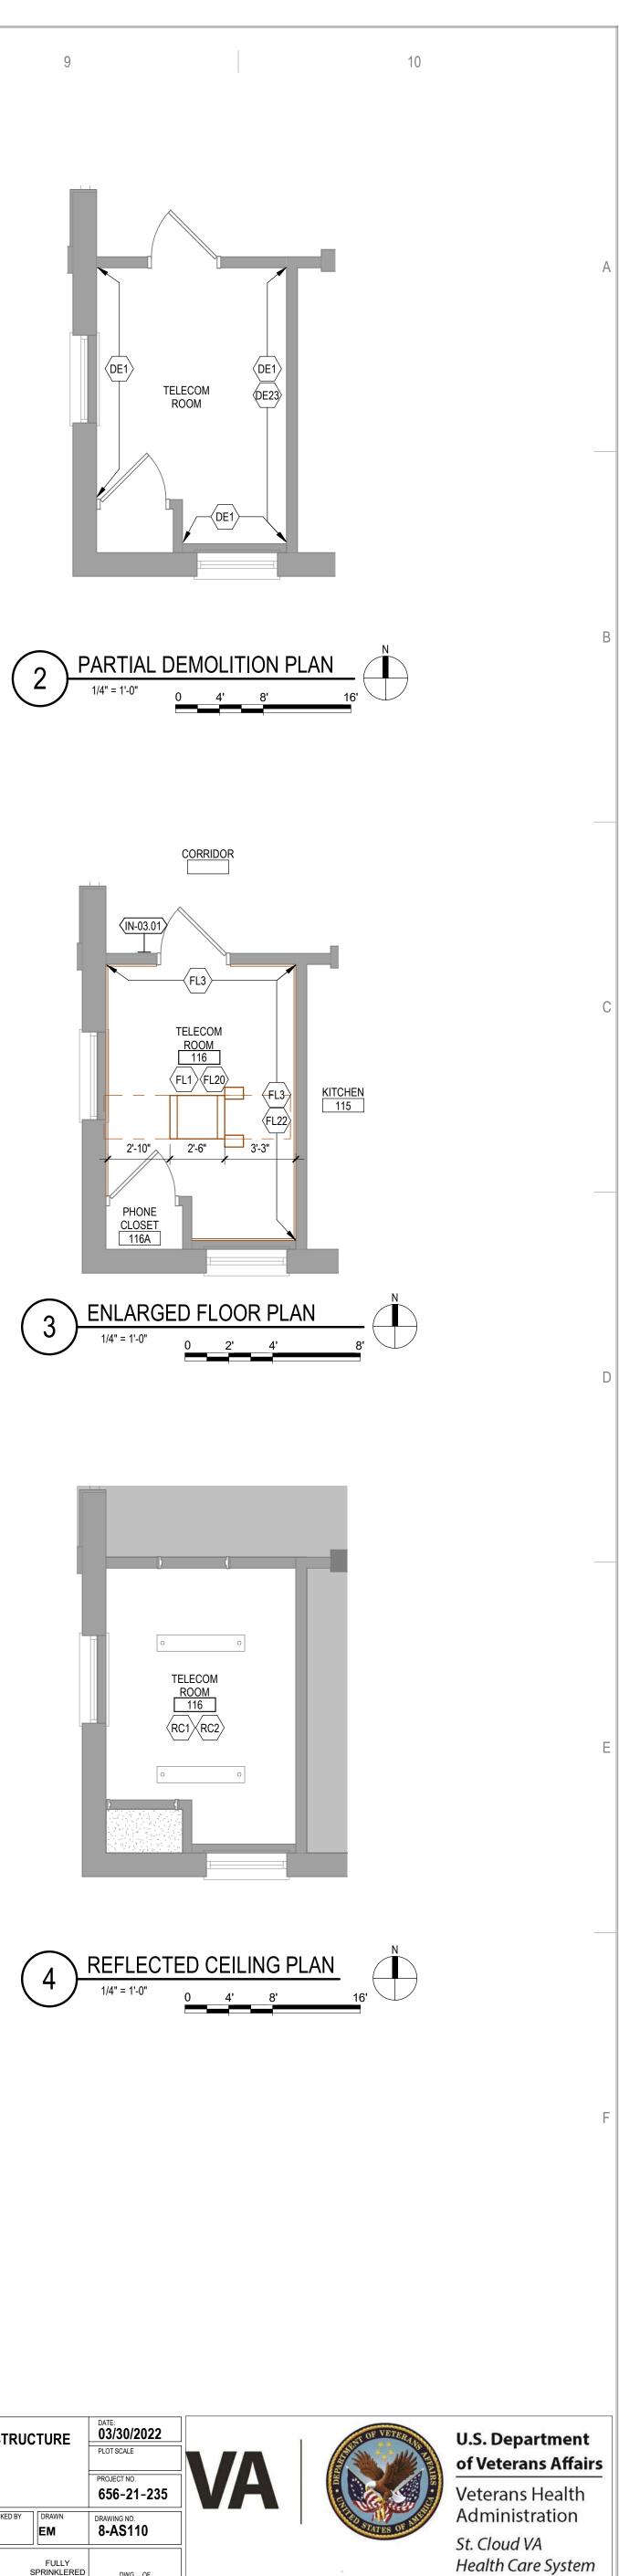


TELECOM ROOM

TELECOM ROOM 116 (FL1)(FL20)

0

TELECOM

ROOM 116 (RC1/RC2)

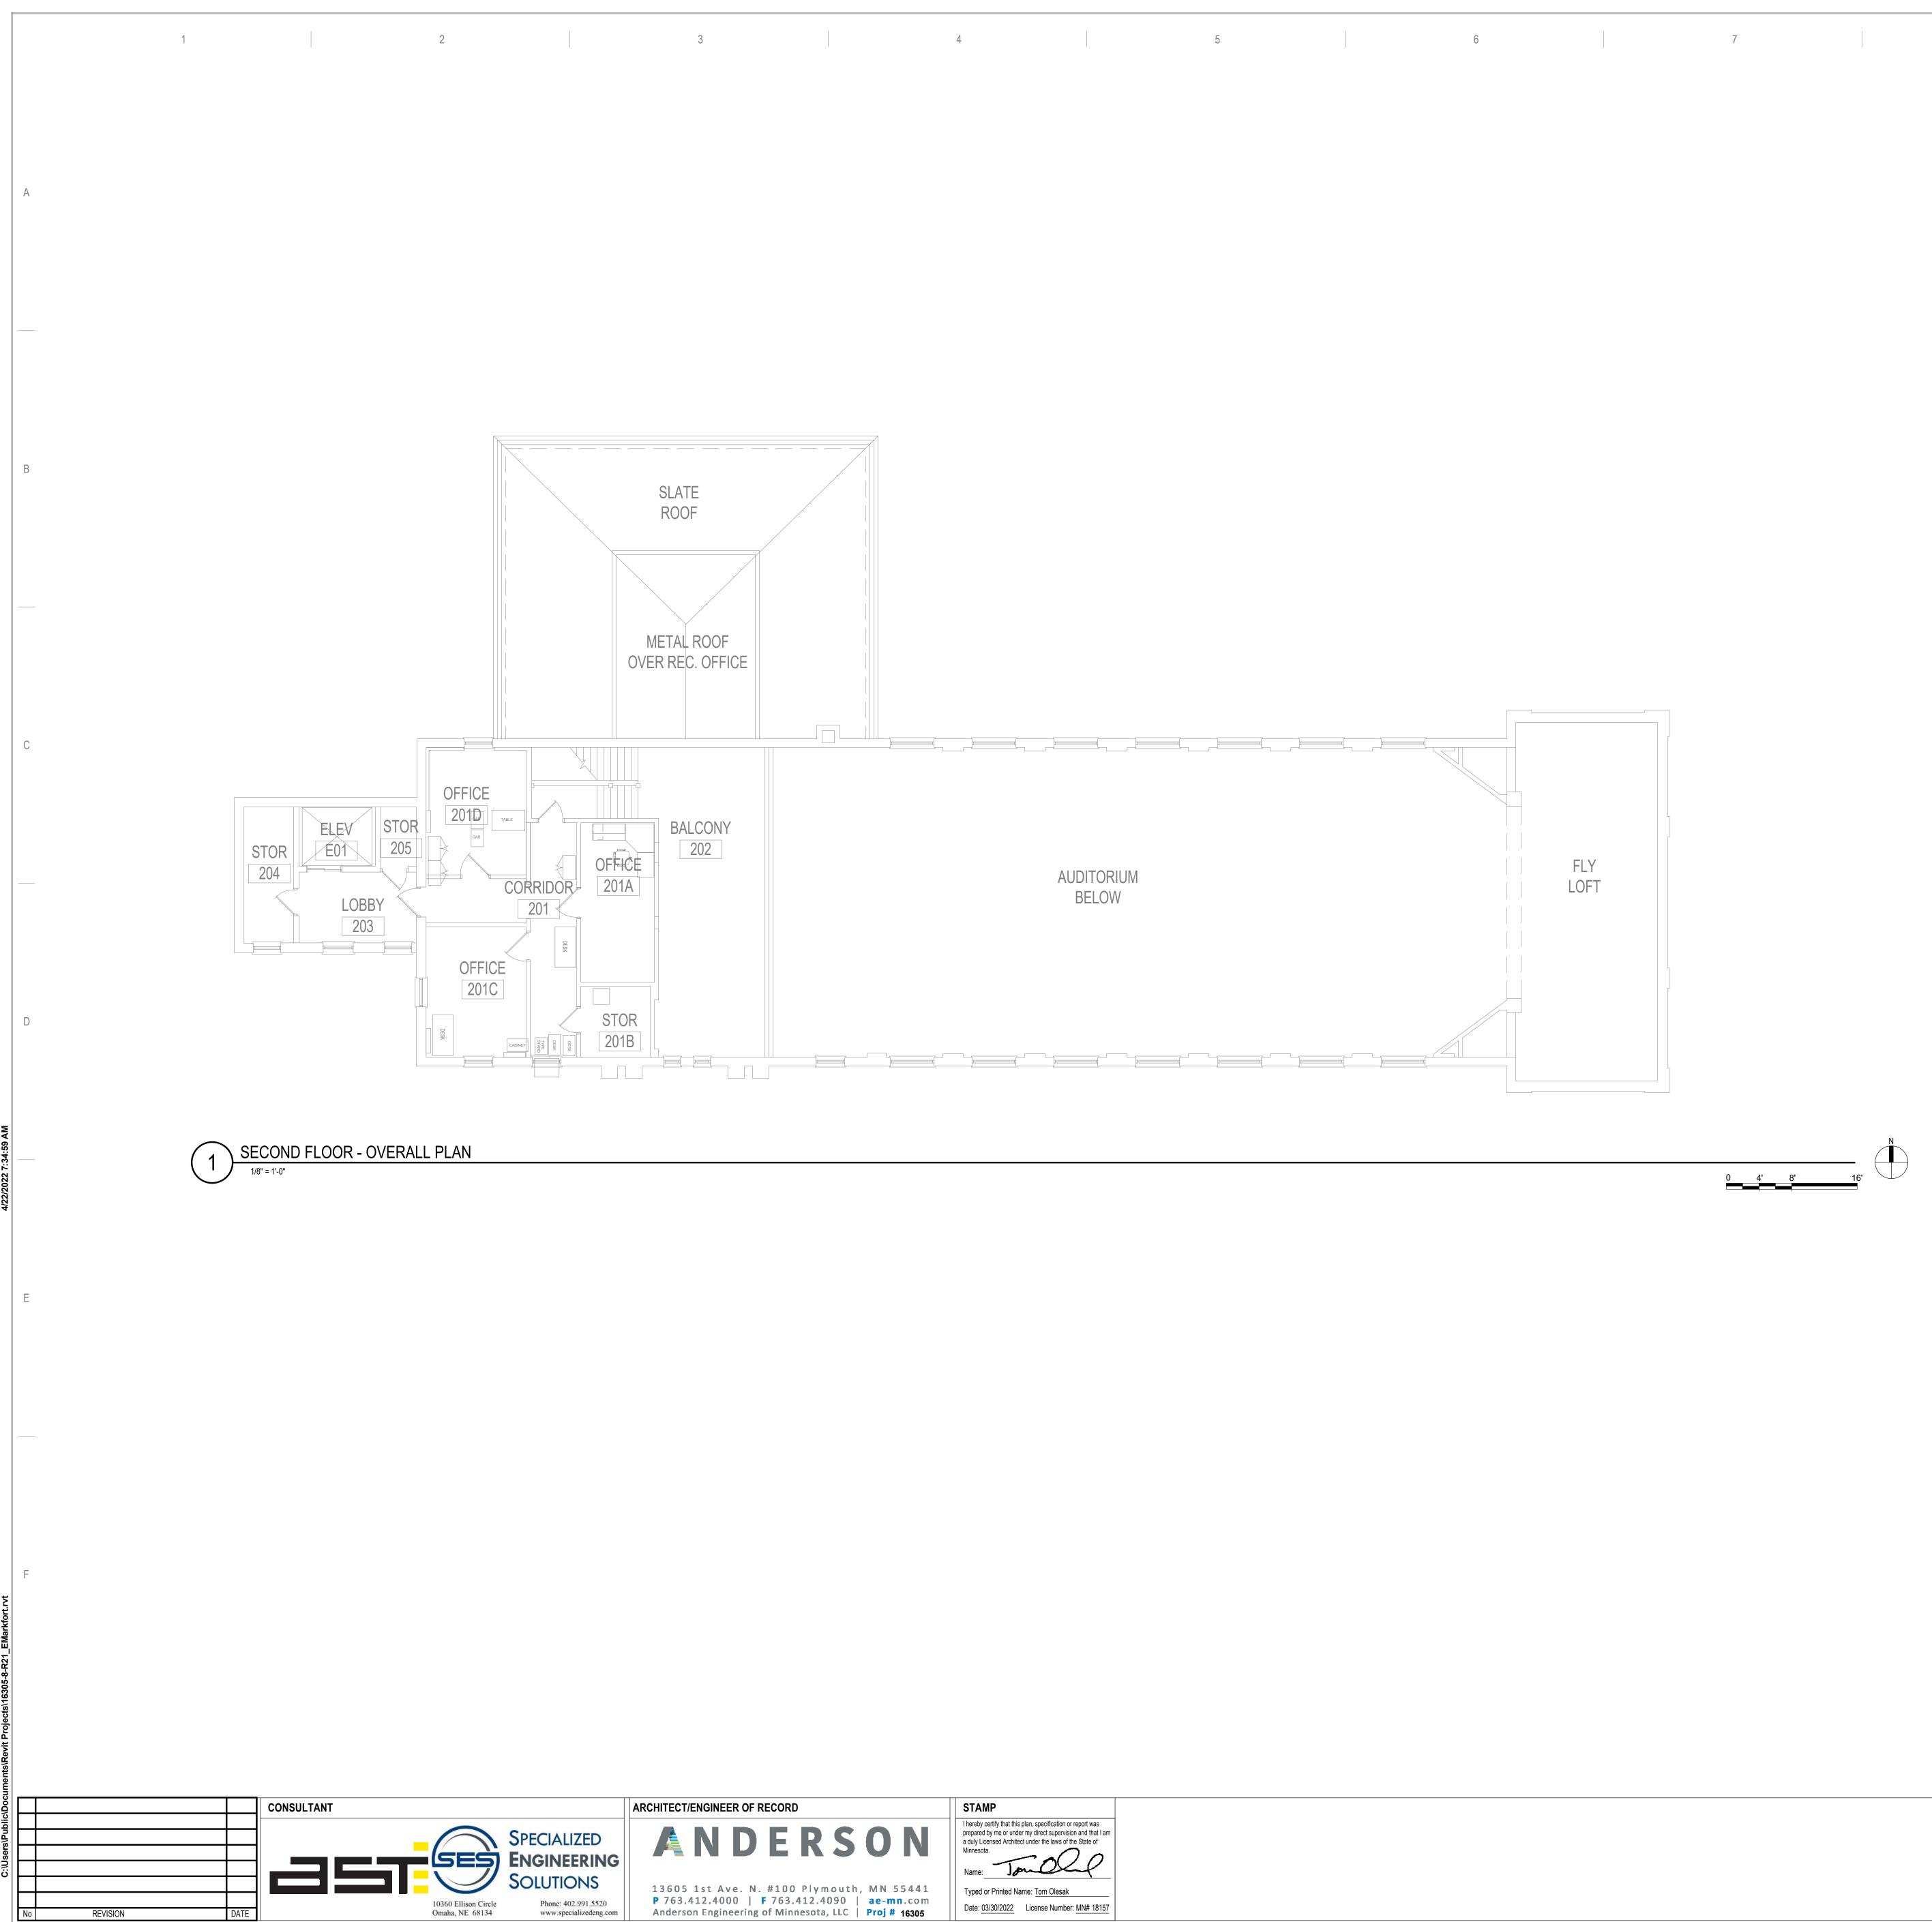

	7	8	9	
				_Sł
			1.	SEE GENERAL NOT INFORMATION, LIF
			2.	ALL EXISTING CON CONTRACTOR PRI CONDITIONS THAT THE ATTENTION O ENGINEERS.
			3.	THE INFORMATION AND PHOTOGRAPH OBSERVATIONS AN ENGINEERS.
			4.	SEE CIVIL, STRUCT PLUMBING DRAWIN DEMOLITION AND (
			5.	Portable fire ex Determined by V Signage shall bi Rooms.

DRAWING TITLE SECOND FLOOR - OVERALL PLAN	PROJECT TITLE EHRM INFRASTRUCTURE UPGRADES			DATE: 03/30/2022 PLOT SCALE PROJECT NO. 656-21-235	VA
	BUILDING No	CHECKED BY	DRAWN EM	DRAWING NO. 8-AS120	
	LOCATION VA MEDICAL CE ST.CLOUD, MN 5		FULLY	DWG. OF	

SHEET NOTES

L NOTES AND CAMPUS DRAWINGS FOR GENERAL N, LIFE SAFETY, ICRA, AND PHASING


CONDITIONS MUST BE FIELD VERIFIED BY THE PRIOR TO DEMOLITION OR CONSTRUCTION. EXISTING HAT DIFFER FROM THOSE SHOWN MUST BE BROUGHT TO IN OF THE C.O.R. TO INFORM THE ARCHITECTS AND

TION SHOWN ON THE DRAWINGS IS BASED ON DRAWINGS RAPHS PROVIDED BY THE C.O.R. COMBINED WITH IS AND SURVEYED DATA FROM THE ARCHITECTS AND

RUCTURAL, TELECOM, ELECTRICAL, MECHANICAL, AND RAWINGS AND SPECIFCATIONS FOR ADDITIONAL AND CONSTRUCTION REQUIREMENTS.

RE EXTINGUISHERS (CO2 OR HALOGENATED TYPE AS BY VA) WITH WALL MOUNT BRACKET AND CODE REQUIRED LL BE PROVIDED BY THE CONTRACTOR WITHIN TELECOM



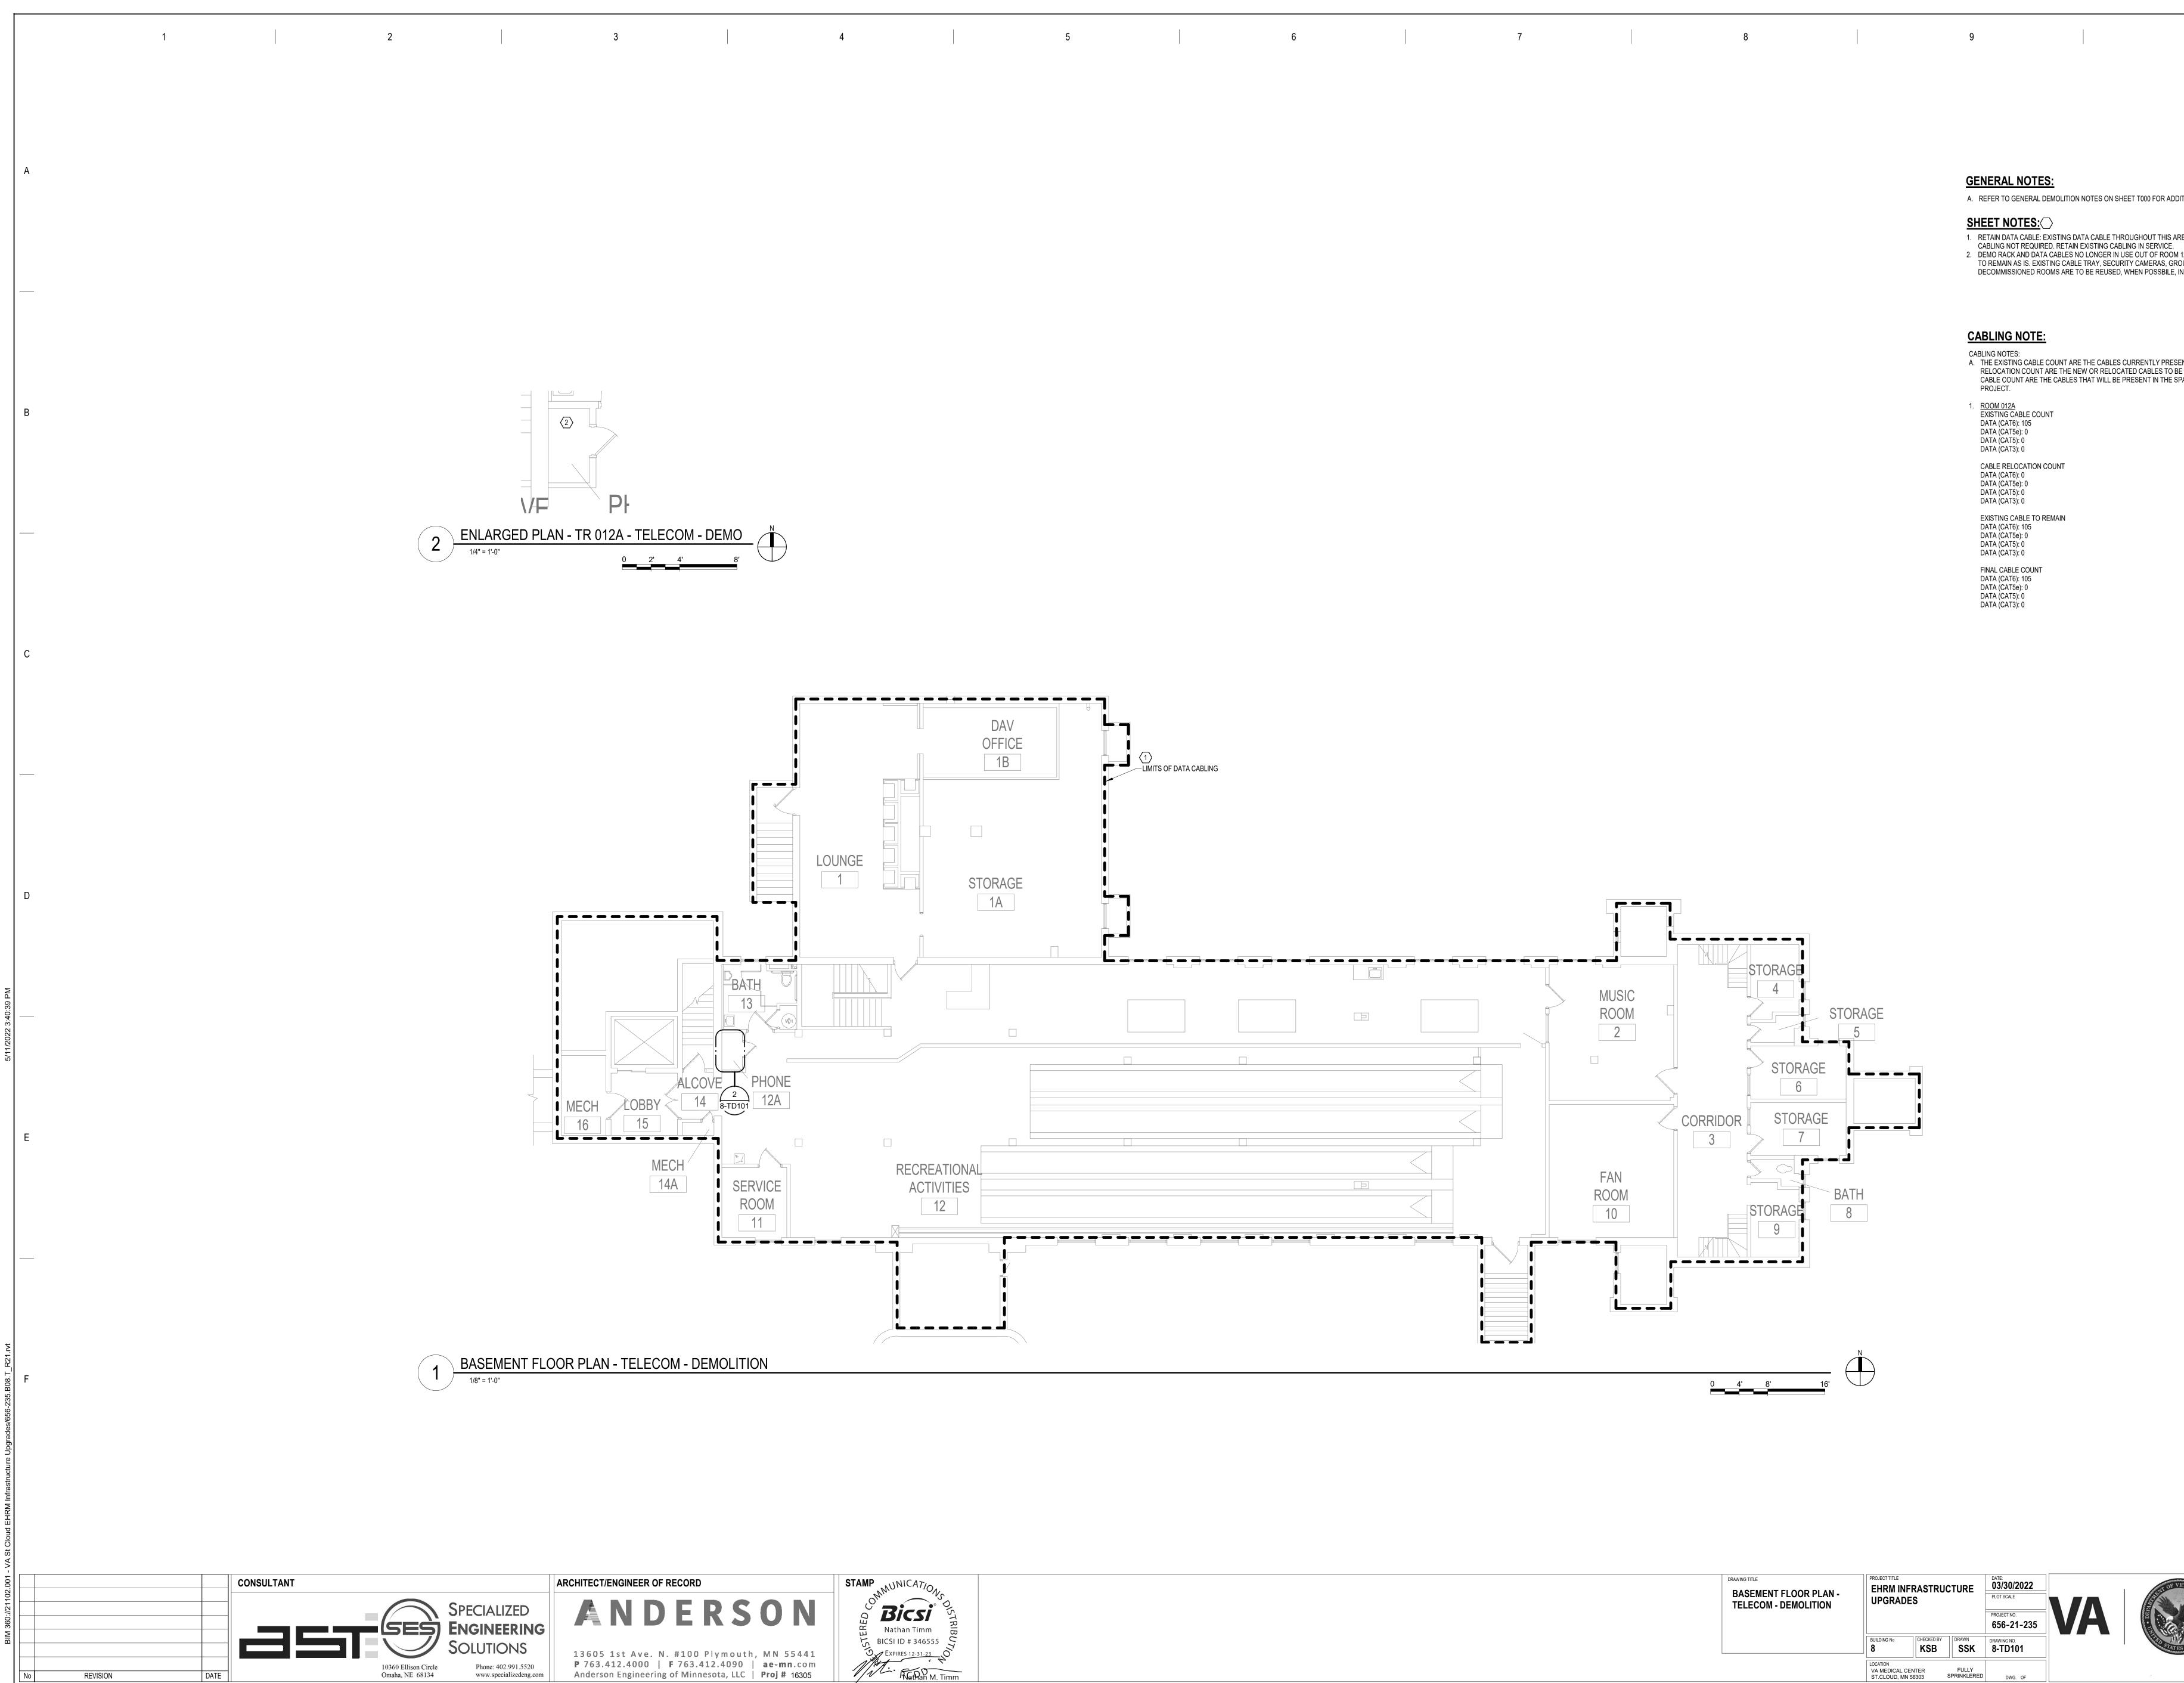

GENERAL NOTES:

SHEET NOTES: CABLING NOT REQUIRED. RETAIN EXISTING CABLING IN SERVICE.

CABLING NOTE:

- CABLING NOTES: PROJECT.
- 1. <u>ROOM 012A</u> EXISTING CABLE COUNT DATA (CAT6): 105 DATA (CAT5e): 0 DATA (CAT5): 0 DATA (CAT3): 0
- CABLE RELOCATION COUNT DATA (CAT6): 0 DATA (CAT5e): 0 DATA (CAT5): 0
- DATA (CAT3): 0 EXISTING CABLE TO REMAIN
- DATA (CAT6): 105 DATA (CAT5e): 0 DATA (CAT5): 0 DATA (CAT3): 0
- FINAL CABLE COUNT DATA (CAT6): 105 DATA (CAT5e): 0 DATA (CAT5): 0

DATA (CAT3): 0


DRAWING TITLE BASEMENT FLOOR PLAN - TELECOM - DEMOLITION	EHRM INF		ICTURE	DATE: 03/30/2022 PLOT SCALE	
				PROJECT NO. 656-21-235	
	BUILDING No	CHECKED BY	DRAWN SSK	DRAWING NO. 8-TD101	
	LOCATION VA MEDICAL CEN ST.CLOUD, MN 50		FULLY SPRINKLERED	DWG. OF	

A. REFER TO GENERAL DEMOLITION NOTES ON SHEET T000 FOR ADDITIONAL DEMOLITION SCOPE. 1. RETAIN DATA CABLE: EXISTING DATA CABLE THROUGHOUT THIS AREA IS SUFFICIENT TO REMAIN. NEW 2. DEMO RACK AND DATA CABLES NO LONGER IN USE OUT OF ROOM 12A. ALL PHONE CABLES AND EQUIPMENT TO REMAIN AS IS. EXISTING CABLE TRAY, SECURITY CAMERAS, GROUND BUS BARS, AND RACKS FROM DECOMMISSIONED ROOMS ARE TO BE REUSED, WHEN POSSBILE, IN NEW CONSTRUCTION TRS.


10

A. THE EXISTING CABLE COUNT ARE THE CABLES CURRENTLY PRESENT IN THE SPACE. THE CABLE RELOCATION COUNT ARE THE NEW OR RELOCATED CABLES TO BE FED FROM THE SPACE. THE FINAL CABLE COUNT ARE THE CABLES THAT WILL BE PRESENT IN THE SPACE AT THE COMPLETION OF THE



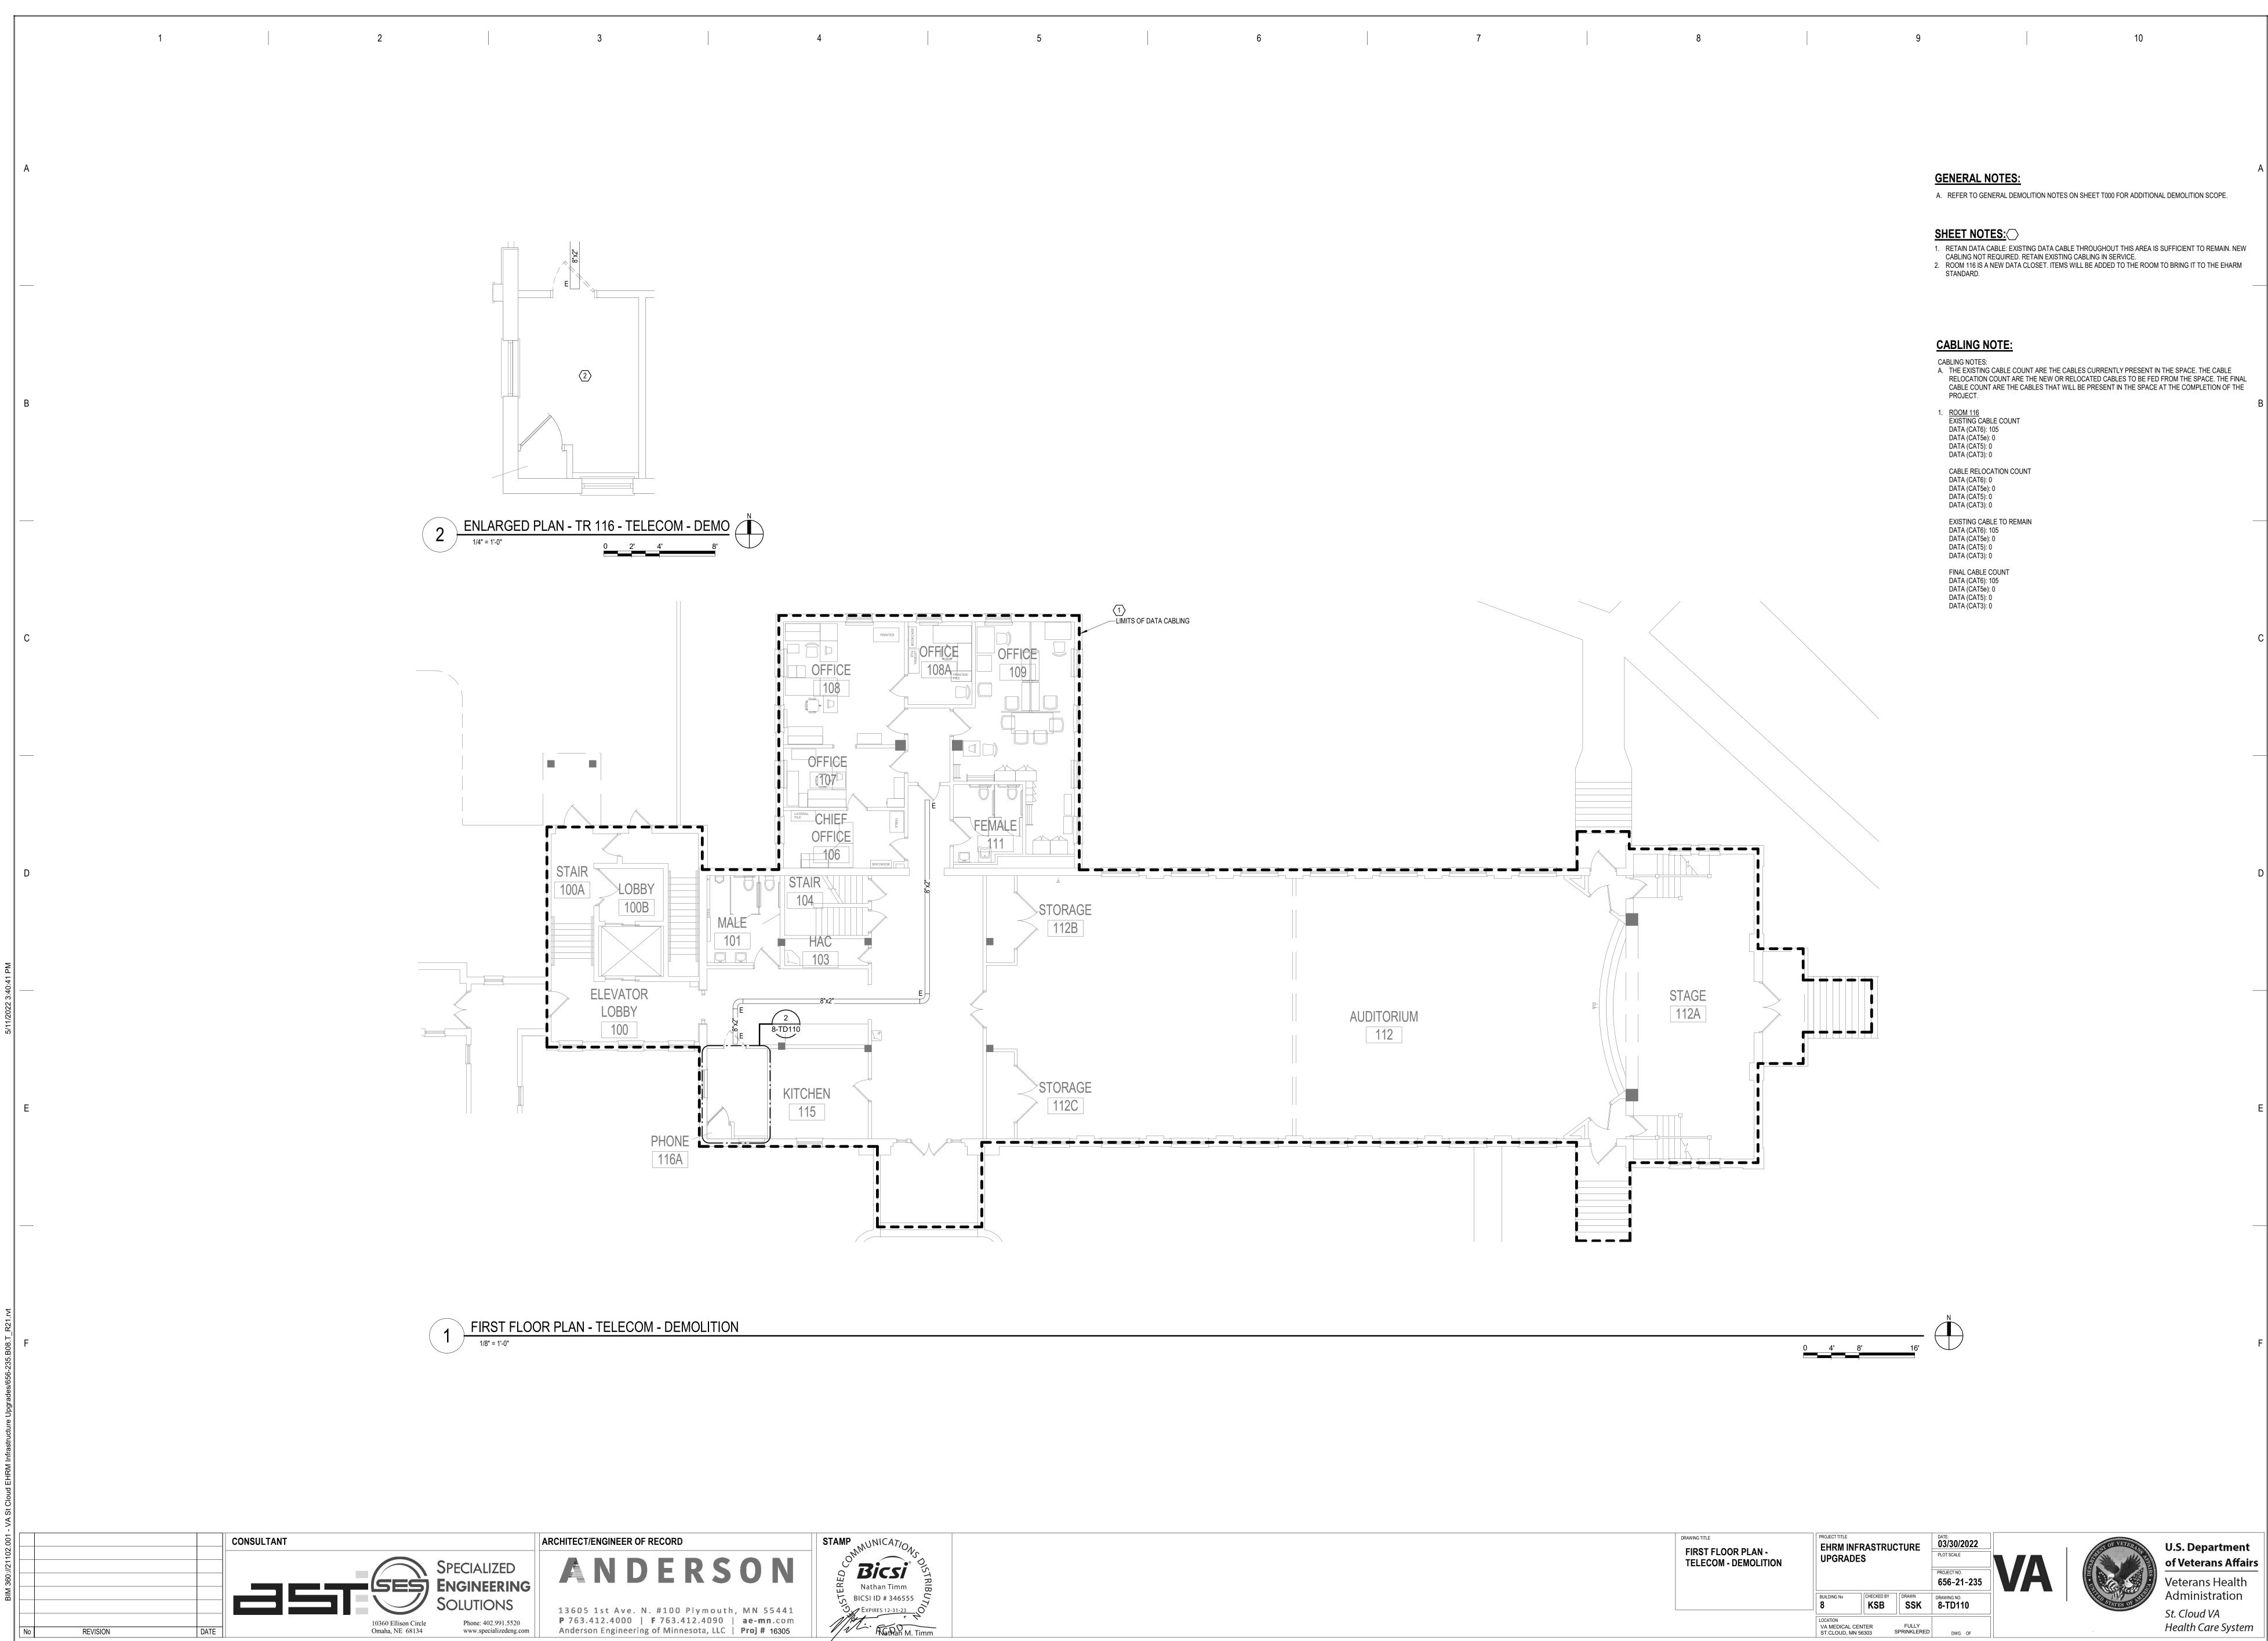

FIRST FLOOR PLAN - TELECOM - DEMOLITION	EHRM INFRASTRUCTURE UPGRADES			Date O3/30/2022 PLOT SCALE PROJECT NO. 656-21-235 656-21-235	VA
	BUILDING No	CHECKED BY	DRAWN SSK	DRAWING NO. 8-TD110	
	LOCATION VA MEDICAL CE ST.CLOUD, MN		FULLY SPRINKLERED	DWG. OF	

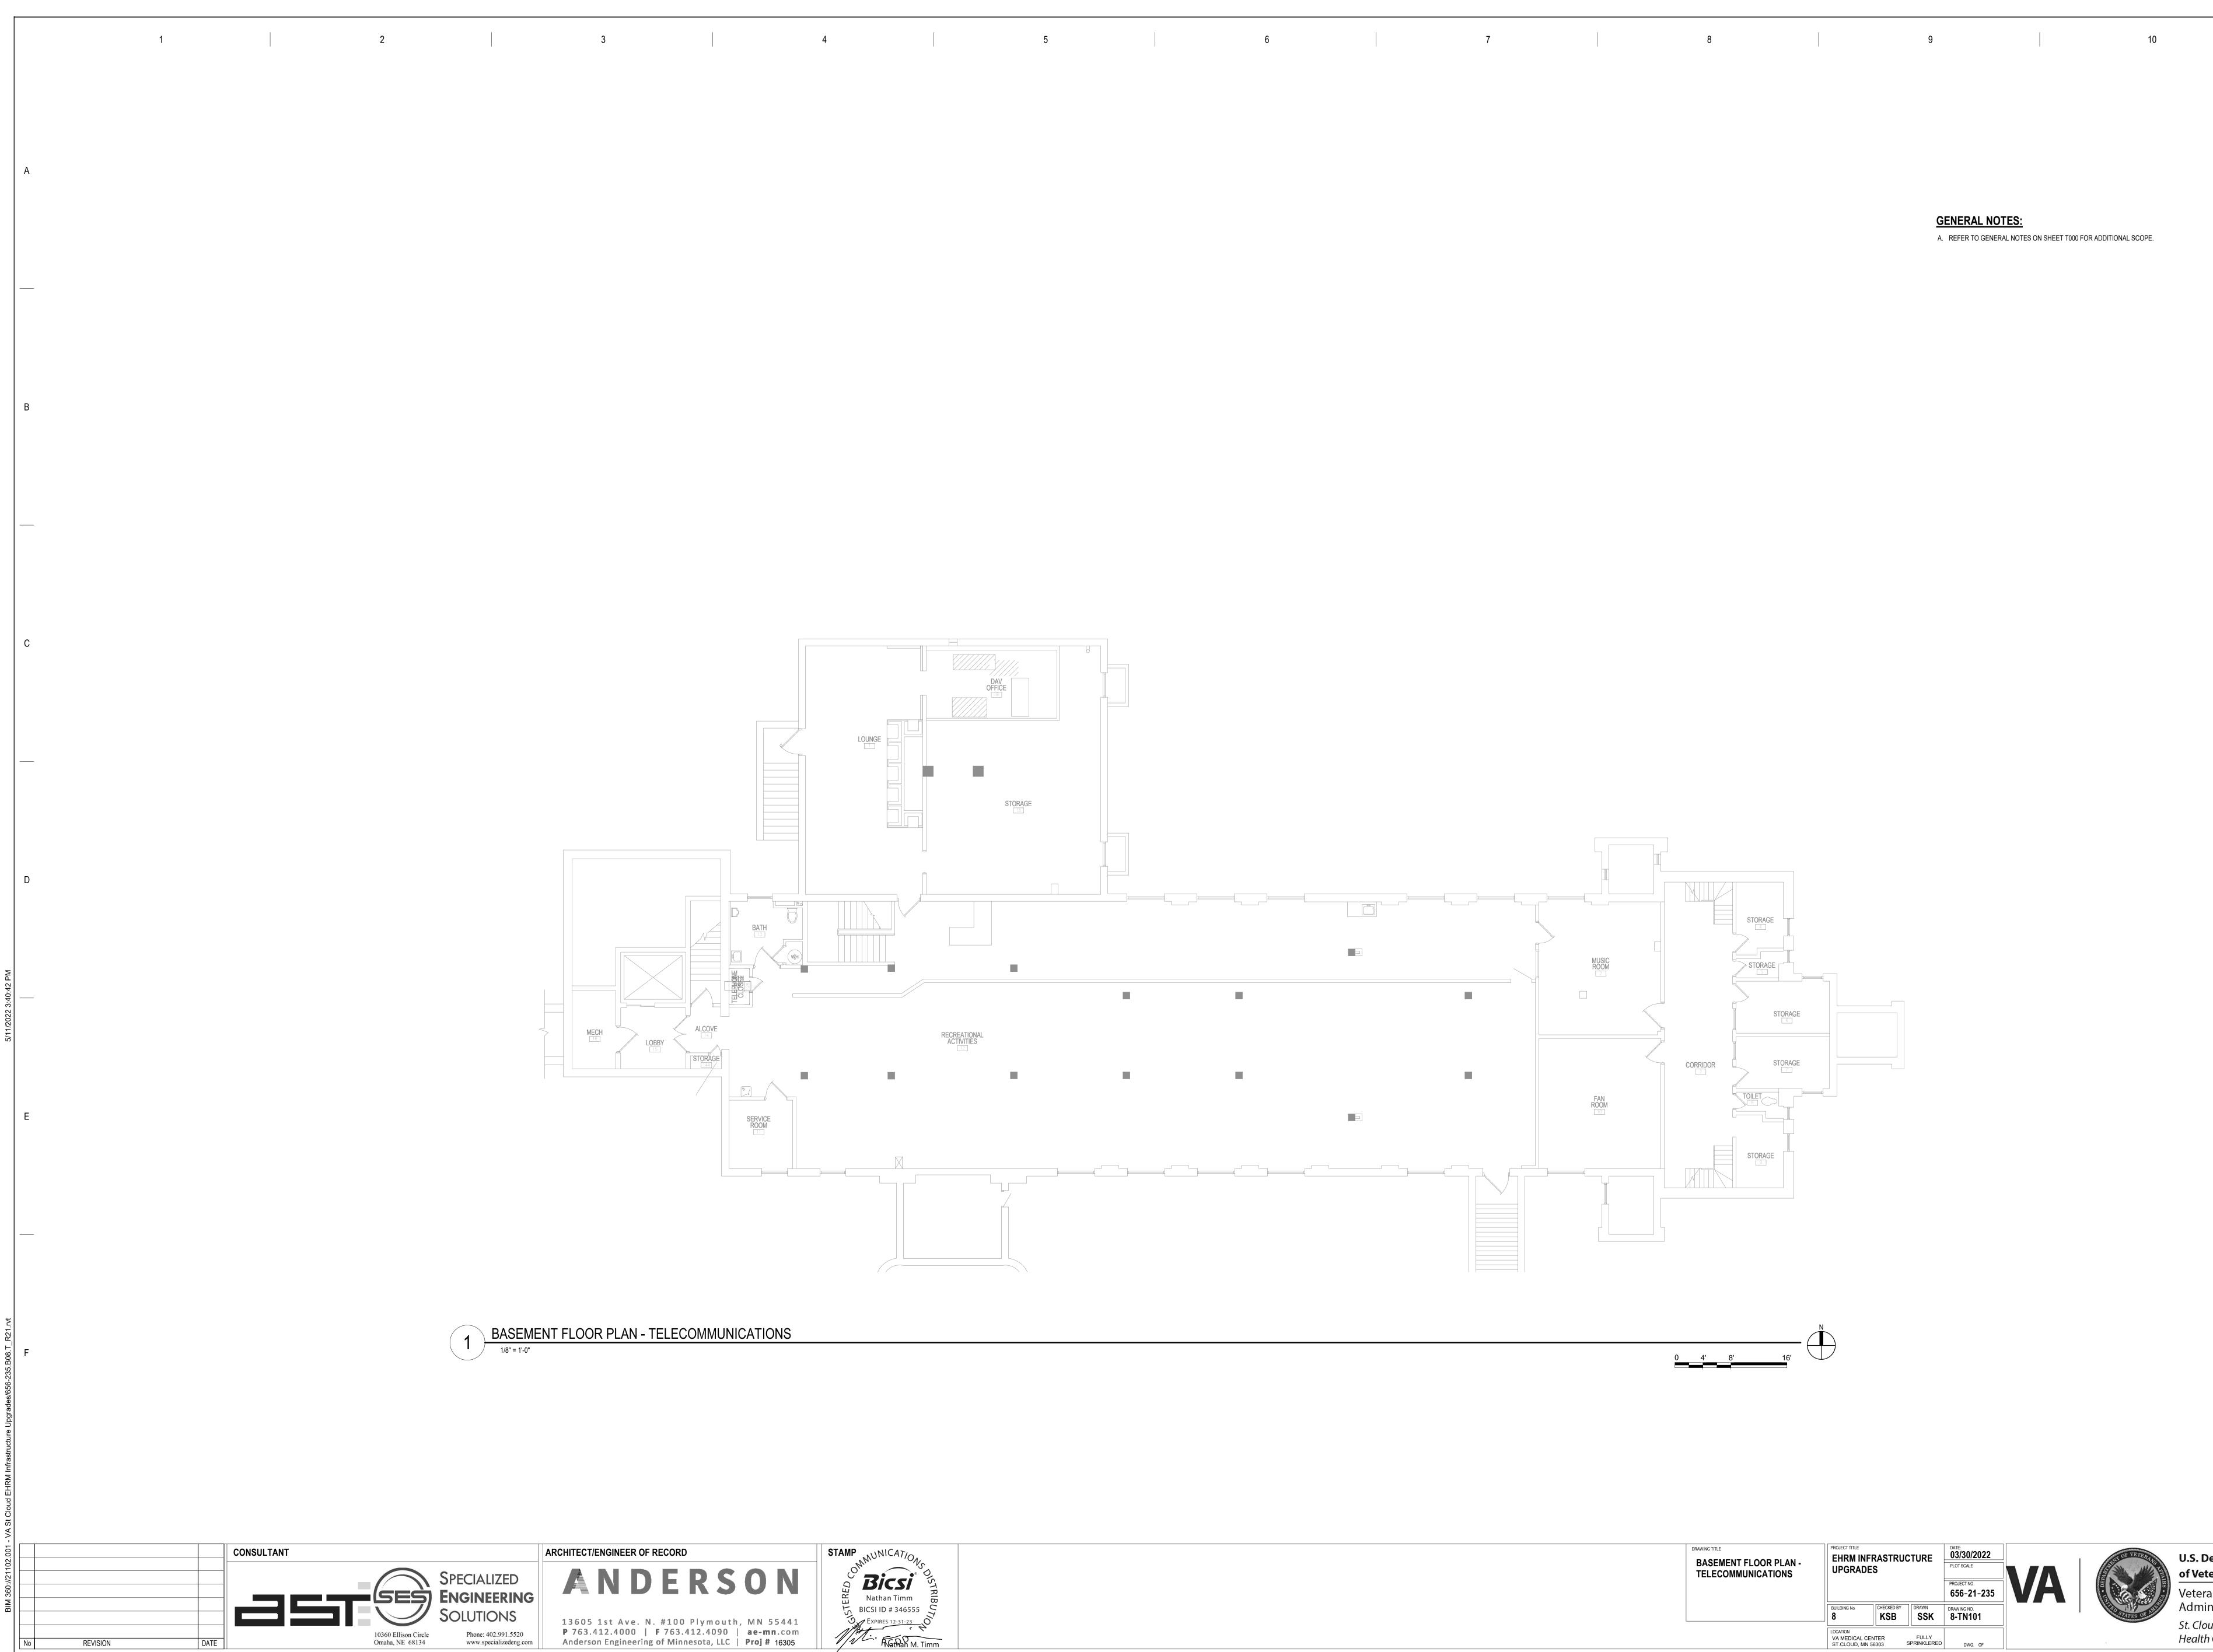


GENERAL NOTES:

A. REFER TO GENERAL NOTES ON SHEET T000 FOR ADDITIONAL SCOPE.

DRAWING TITLE BASEMENT FLOOR PLAN - TELECOMMUNICATIONS	EHRM INFRASTRUCTURE UPGRADES			DATE: 03/30/2022 PLOT SCALE PROJECT NO. 656-21-235	VA
	BUILDING No	CHECKED BY	DRAWN SSK	DRAWING NO. 8-TN101	
	LOCATION VA MEDICAL C ST.CLOUD, MN		FULLY SPRINKLERED	DWG. OF	



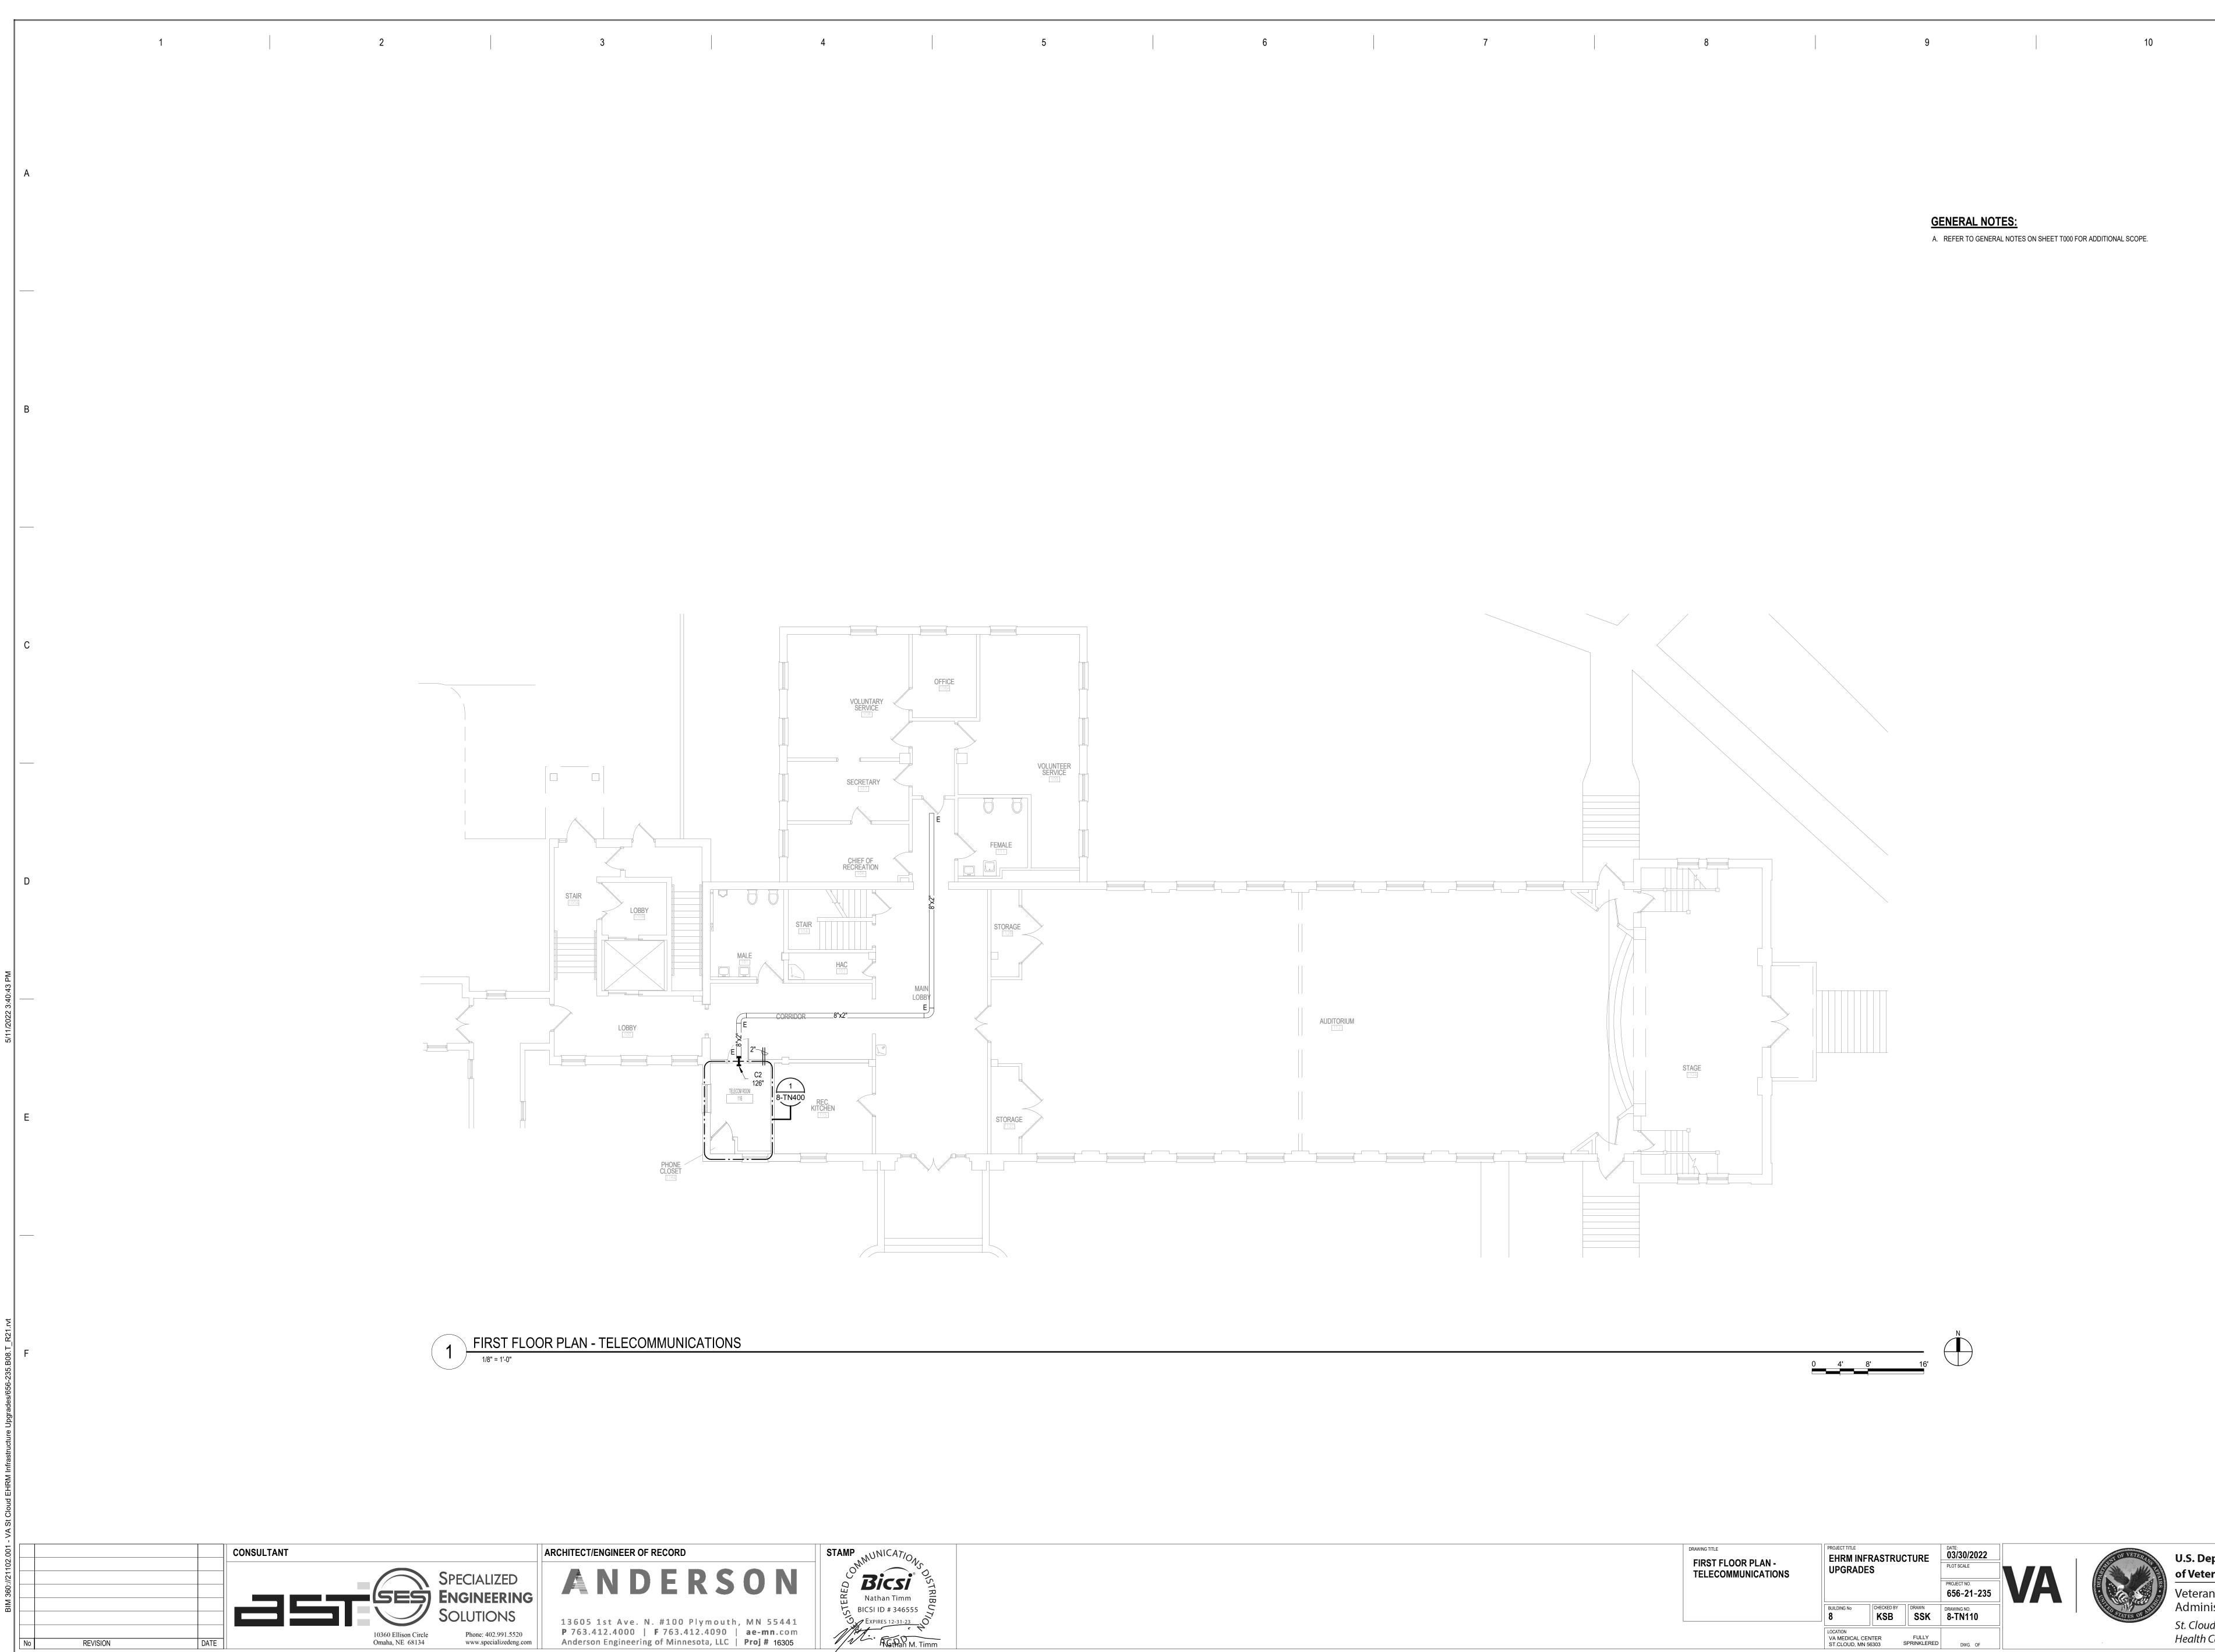


GENERAL NOTES:

A. REFER TO GENERAL NOTES ON SHEET T000 FOR ADDITIONAL SCOPE.


DRAWING TITLE FIRST FLOOR PLAN - TELECOMMUNICATIONS	EHRM INFRASTRUCTURE UPGRADES			DATE: 03/30/2022 PLOT SCALE PROJECT NO. 656-21-235	VA
	BUILDING No	CHECKED BY	DRAWN SSK	drawing no. 8-TN110	
	LOCATION VA MEDICAL CE ST.CLOUD, MN S		FULLY SPRINKLERED	DWG. OF	




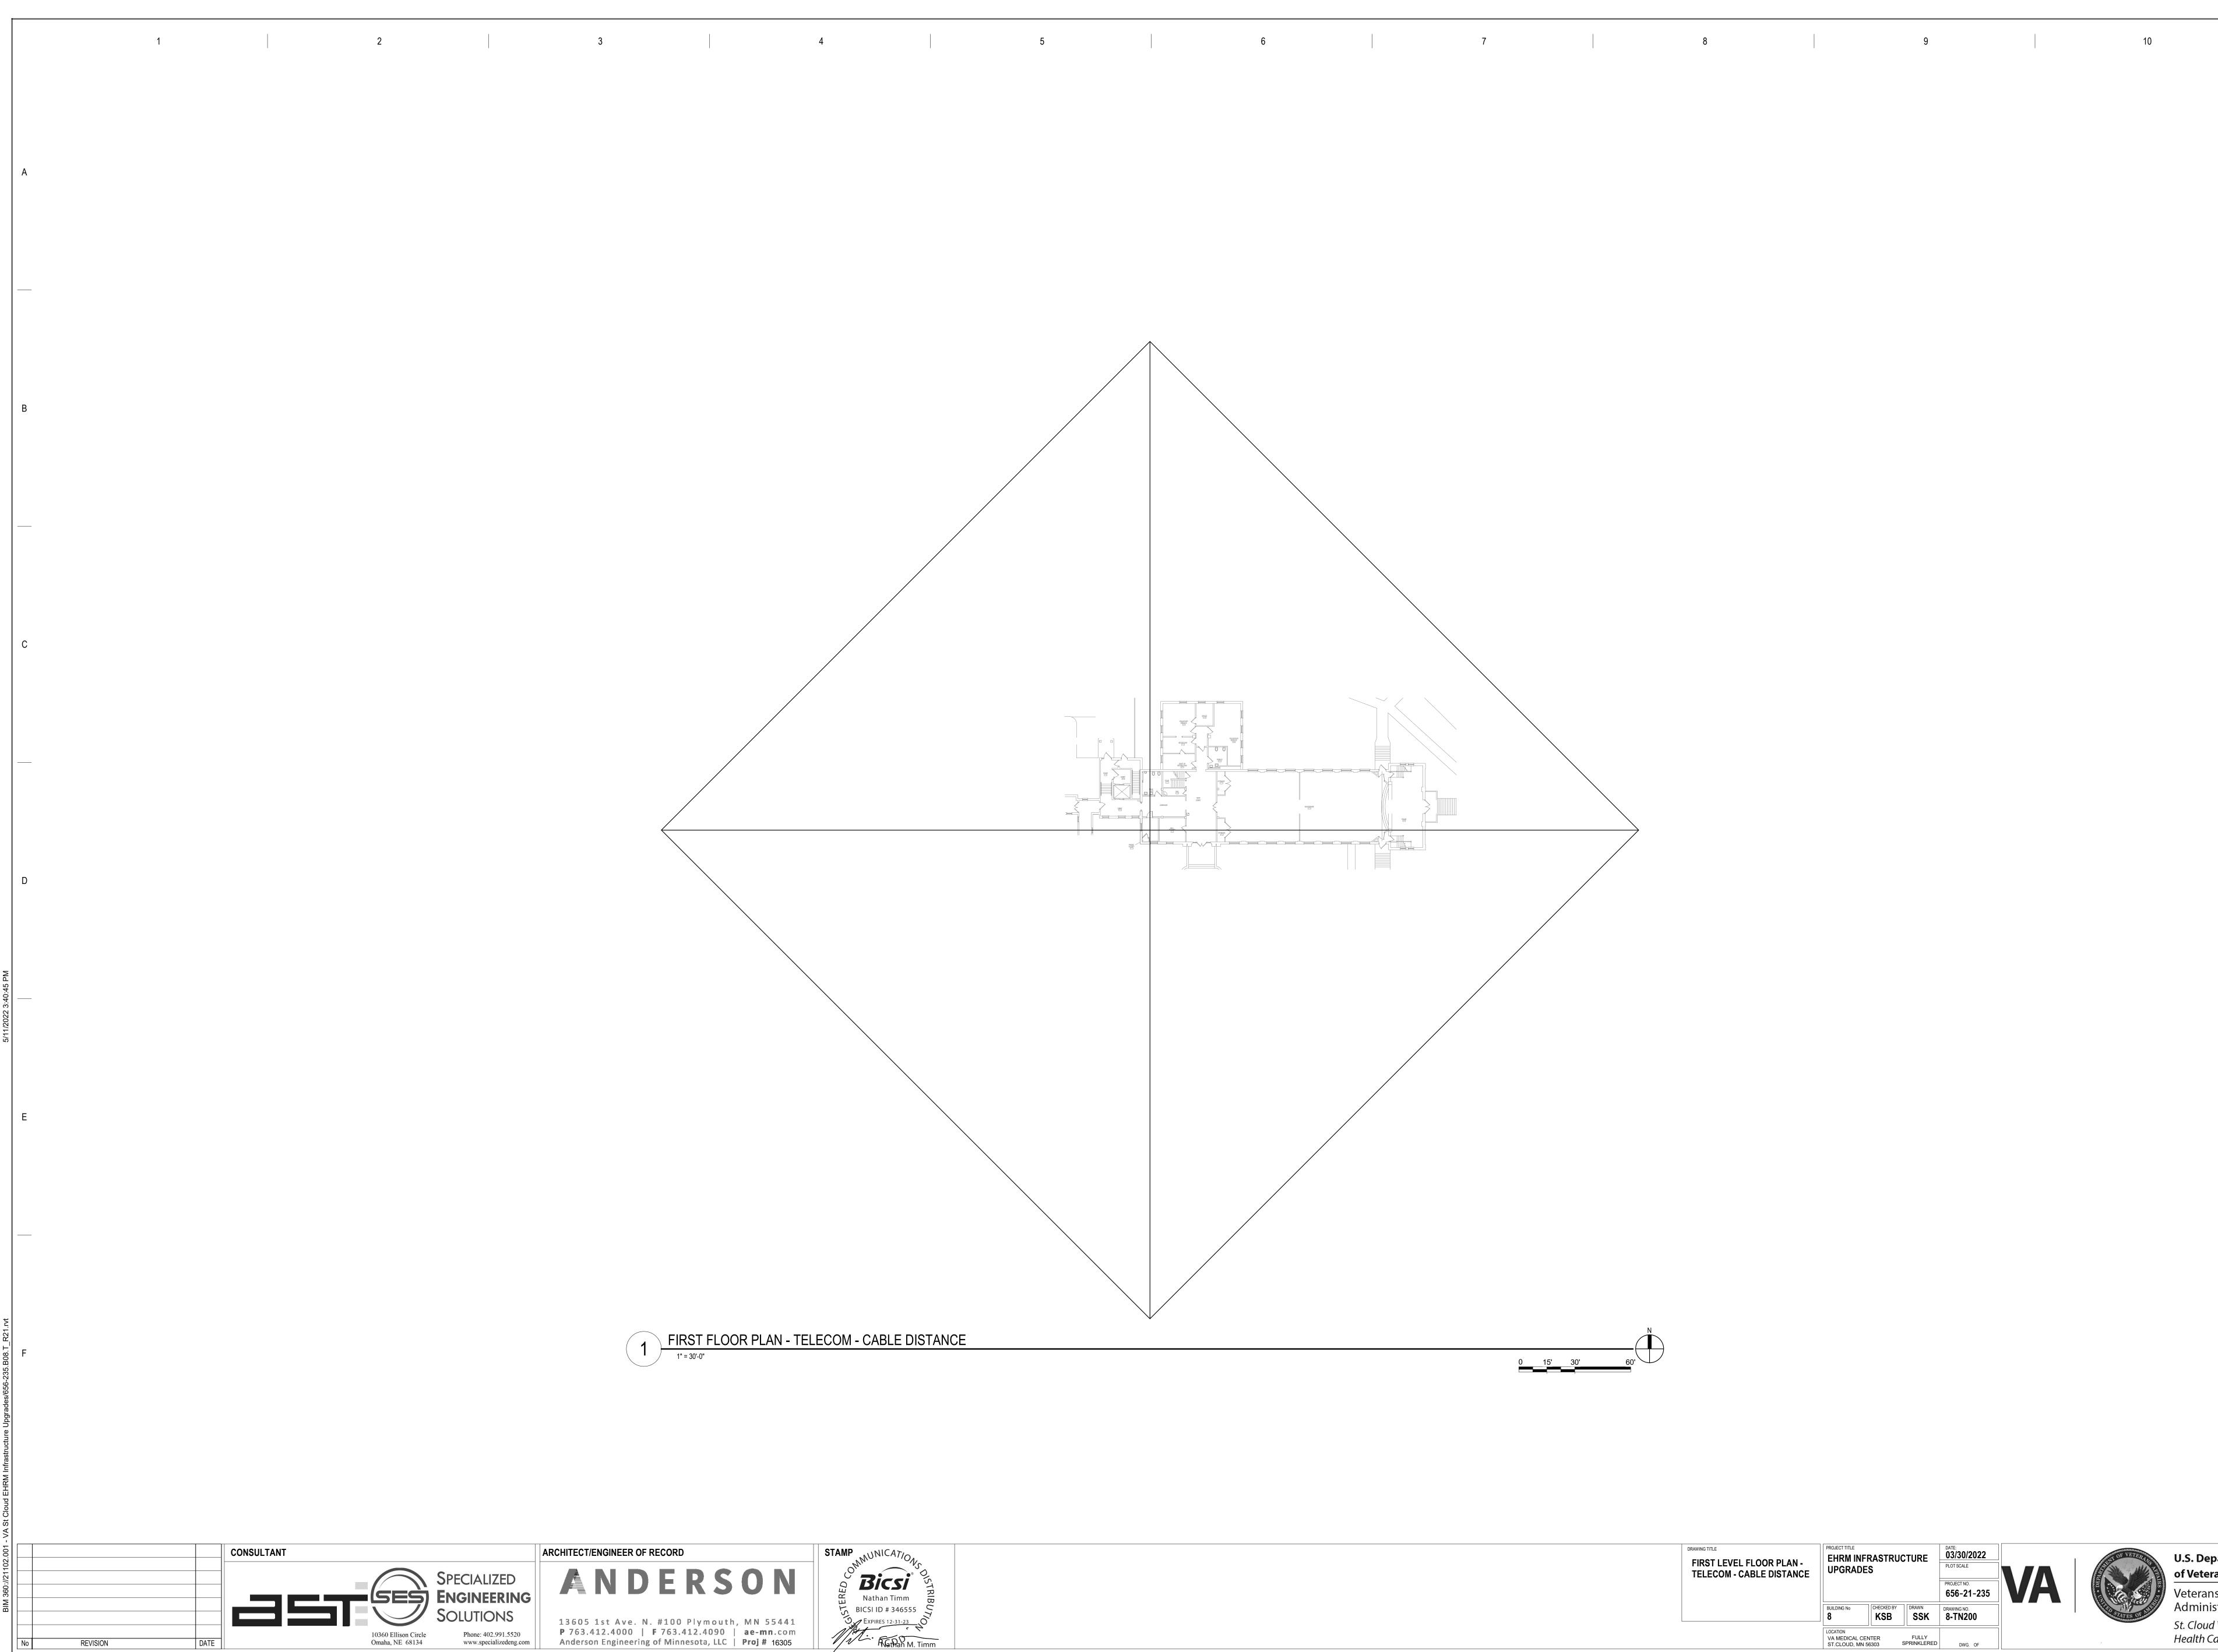

FIRST LEVEL FLOOR PLAN - TELECOM - CABLE DISTANCE		EHRM INFRASTRUCTURE UPGRADES			VA
	BUILDING No	CHECKED BY	DRAWN SSK	DRAWING NO. 8-TN200	
	LOCATION VA MEDICAL CEI ST.CLOUD, MN 5		FULLY SPRINKLERED	DWG. OF	



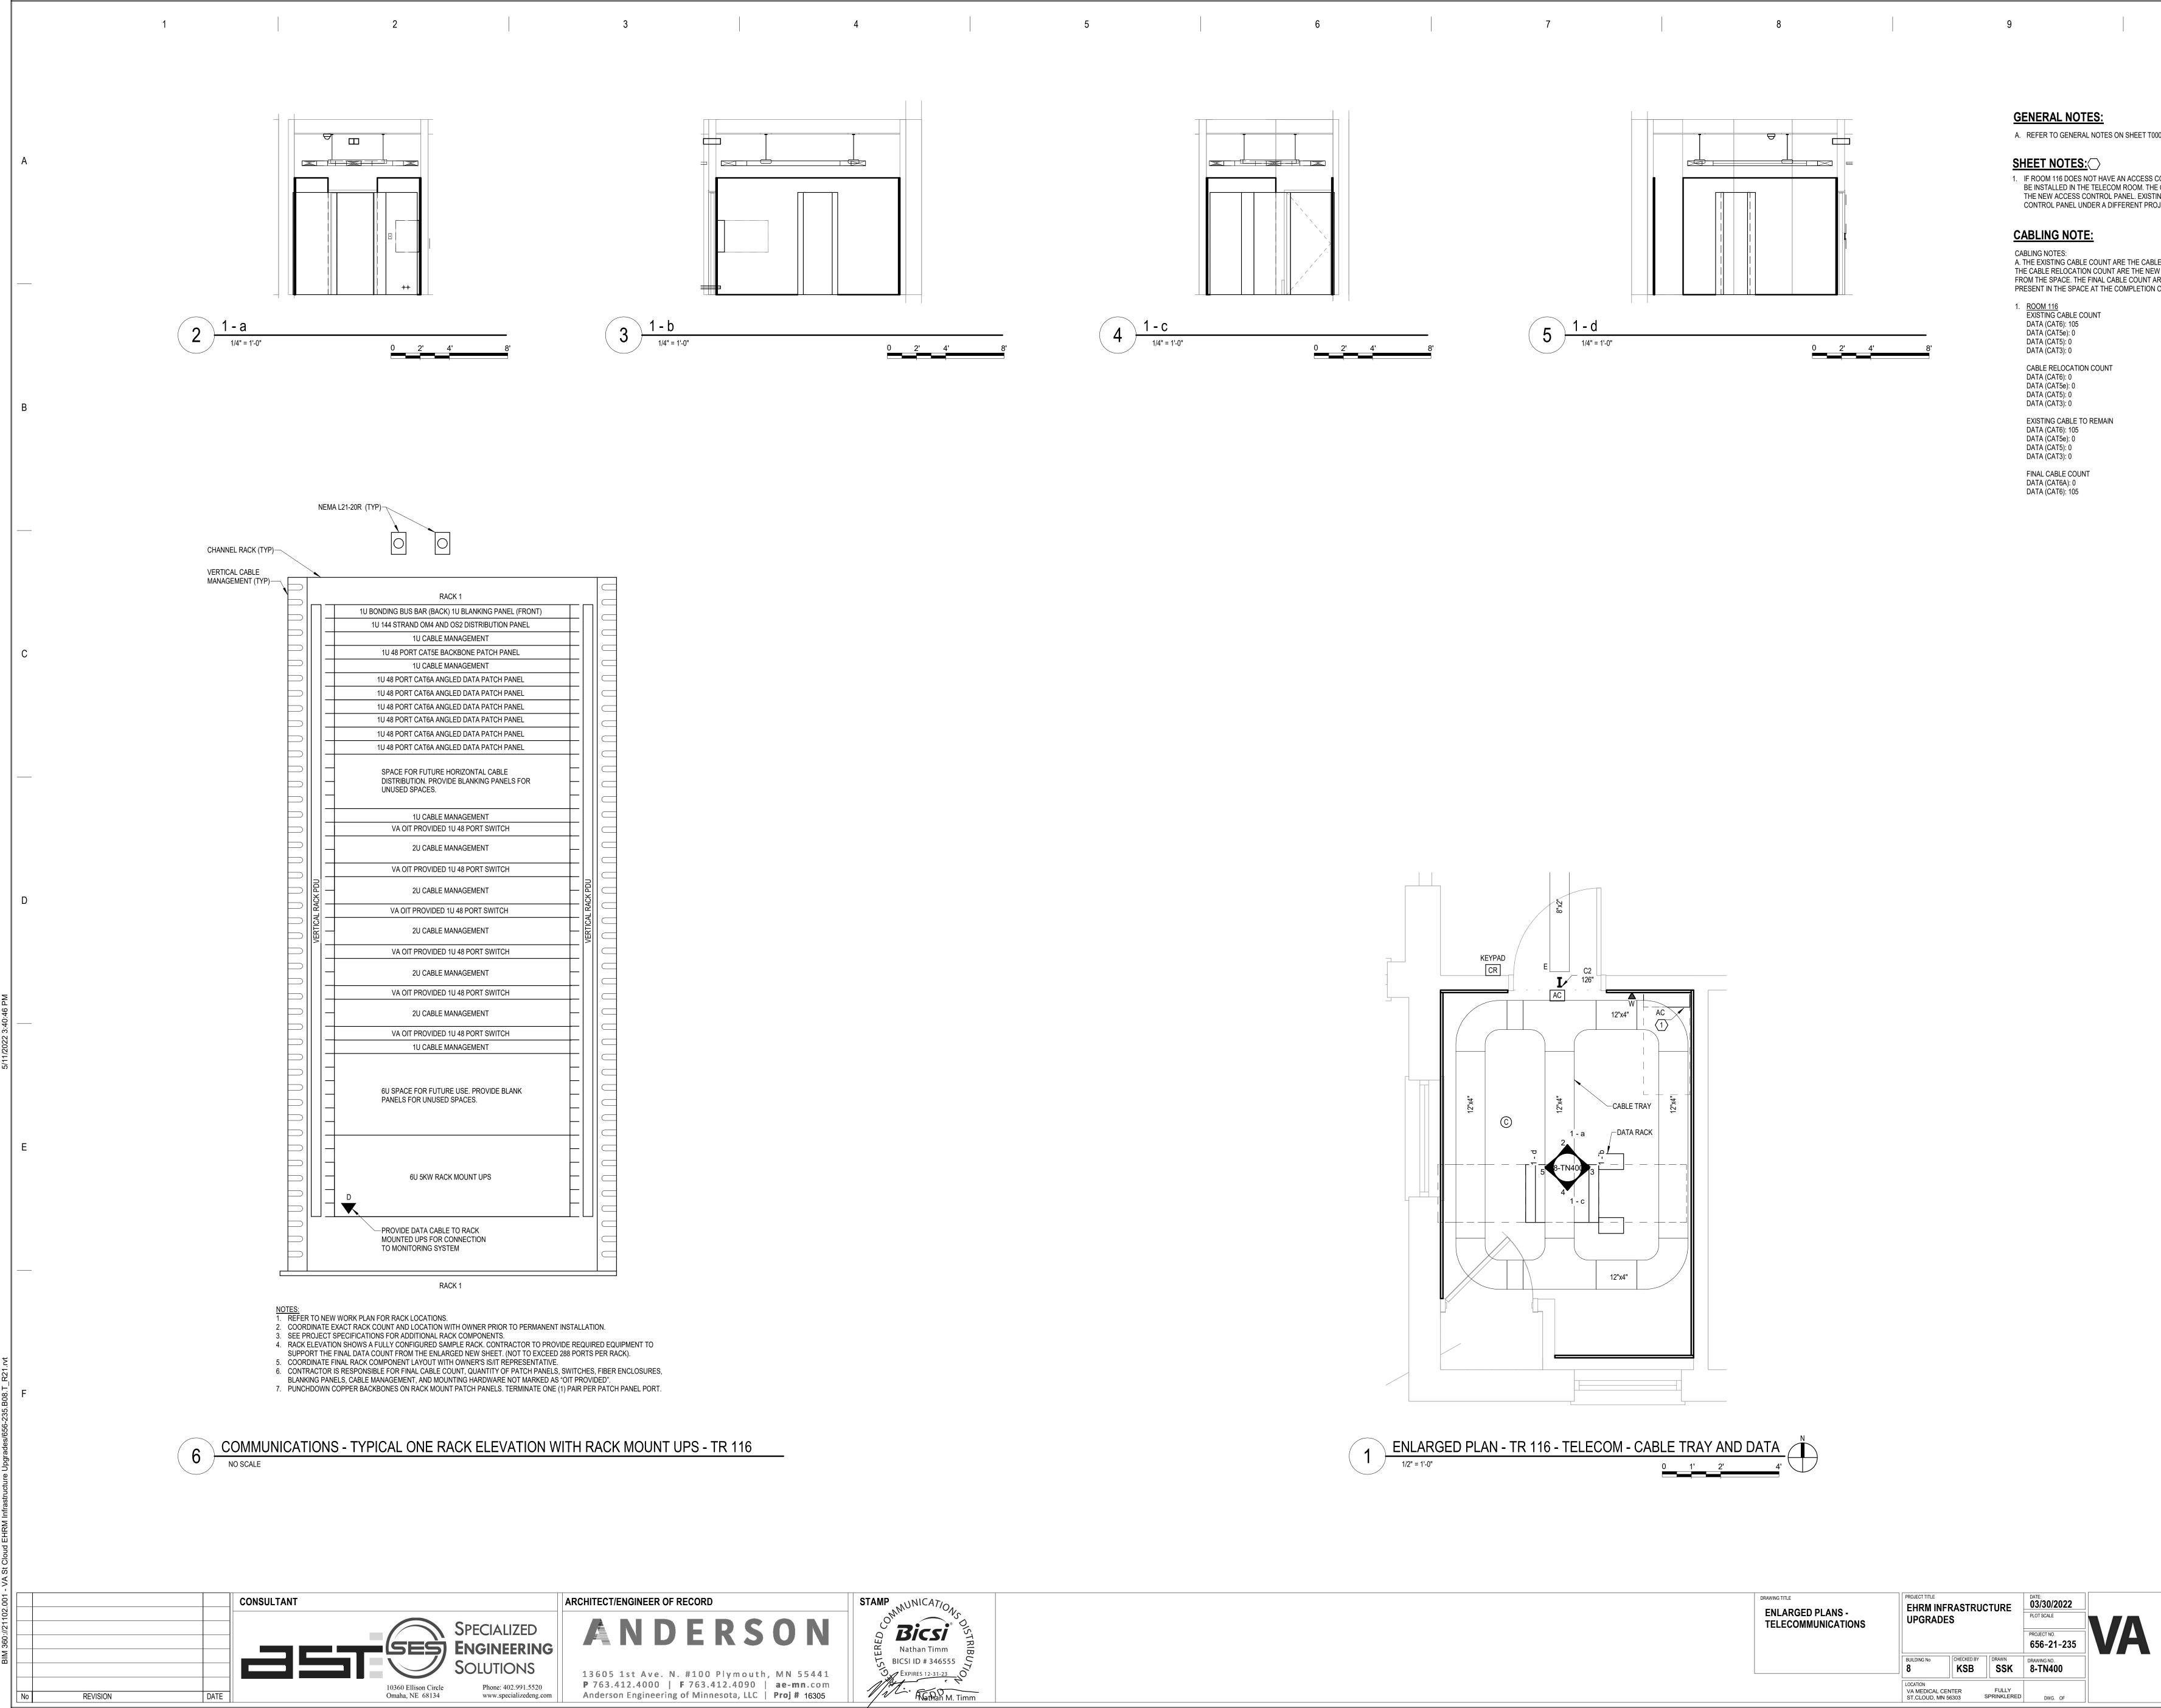

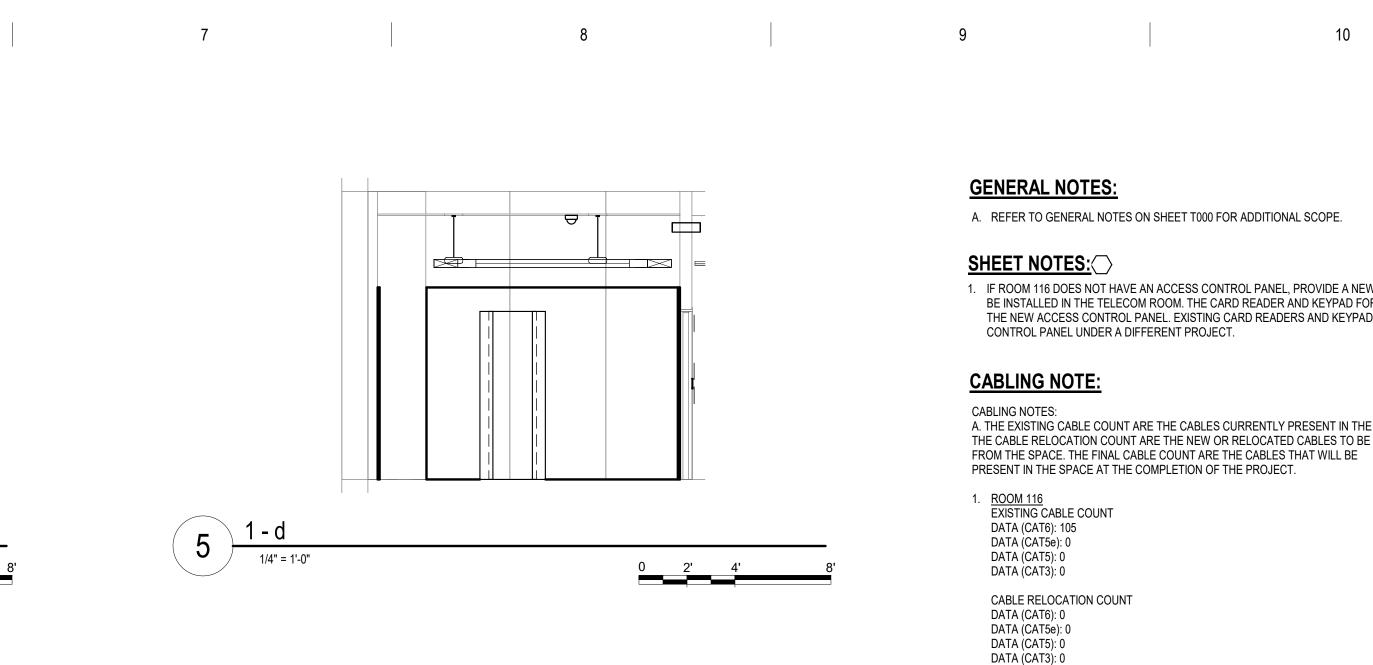


DATA (CAT5e): 0 DATA (CAT5): 0 DATA (CAT3): 0 FINAL CABLE COUNT DATA (CAT6A): 0

DATA (CAT6): 105

DATA (CAT6): 105

EXISTING CABLE TO REMAIN

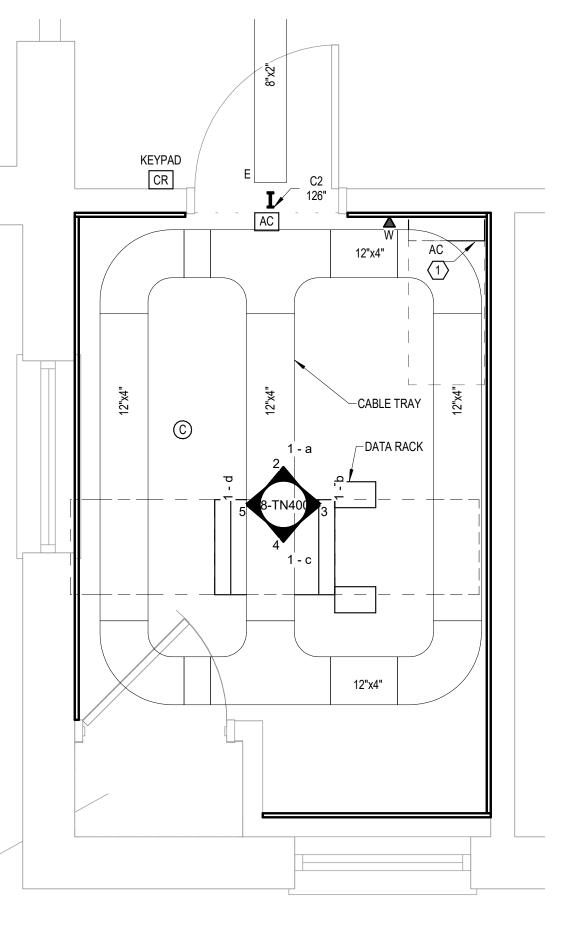

ENLARGED PLAN - TR 116 - TELECOM - CABLE TRAY AND DATA


DRAWING TITLE ENLARGED PLANS - TELECOMMUNICATIONS	PROJECT TITLE EHRM INFRASTRUCTURE UPGRADES			DATE: 03/30/2022 PLOT SCALE PROJECT NO.	
	BUILDING No 8	CHECKED BY	DRAWN	656-21-235 DRAWING NO. 8-TN400	Ľ
	LOCATION VA MEDICAL CI ST.CLOUD, MN		FULLY	DWG. OF	

1. IF ROOM 116 DOES NOT HAVE AN ACCESS CONTROL PANEL, PROVIDE A NEW ACCESS CONTROL PANEL TO BE INSTALLED IN THE TELECOM ROOM. THE CARD READER AND KEYPAD FOR THIS ROOM TO BE WIRED TO THE NEW ACCESS CONTROL PANEL. EXISTING CARD READERS AND KEYPADS WILL BE MOVED TO THE NEW

10


A. THE EXISTING CABLE COUNT ARE THE CABLES CURRENTLY PRESENT IN THE SPACE. THE CABLE RELOCATION COUNT ARE THE NEW OR RELOCATED CABLES TO BE FED



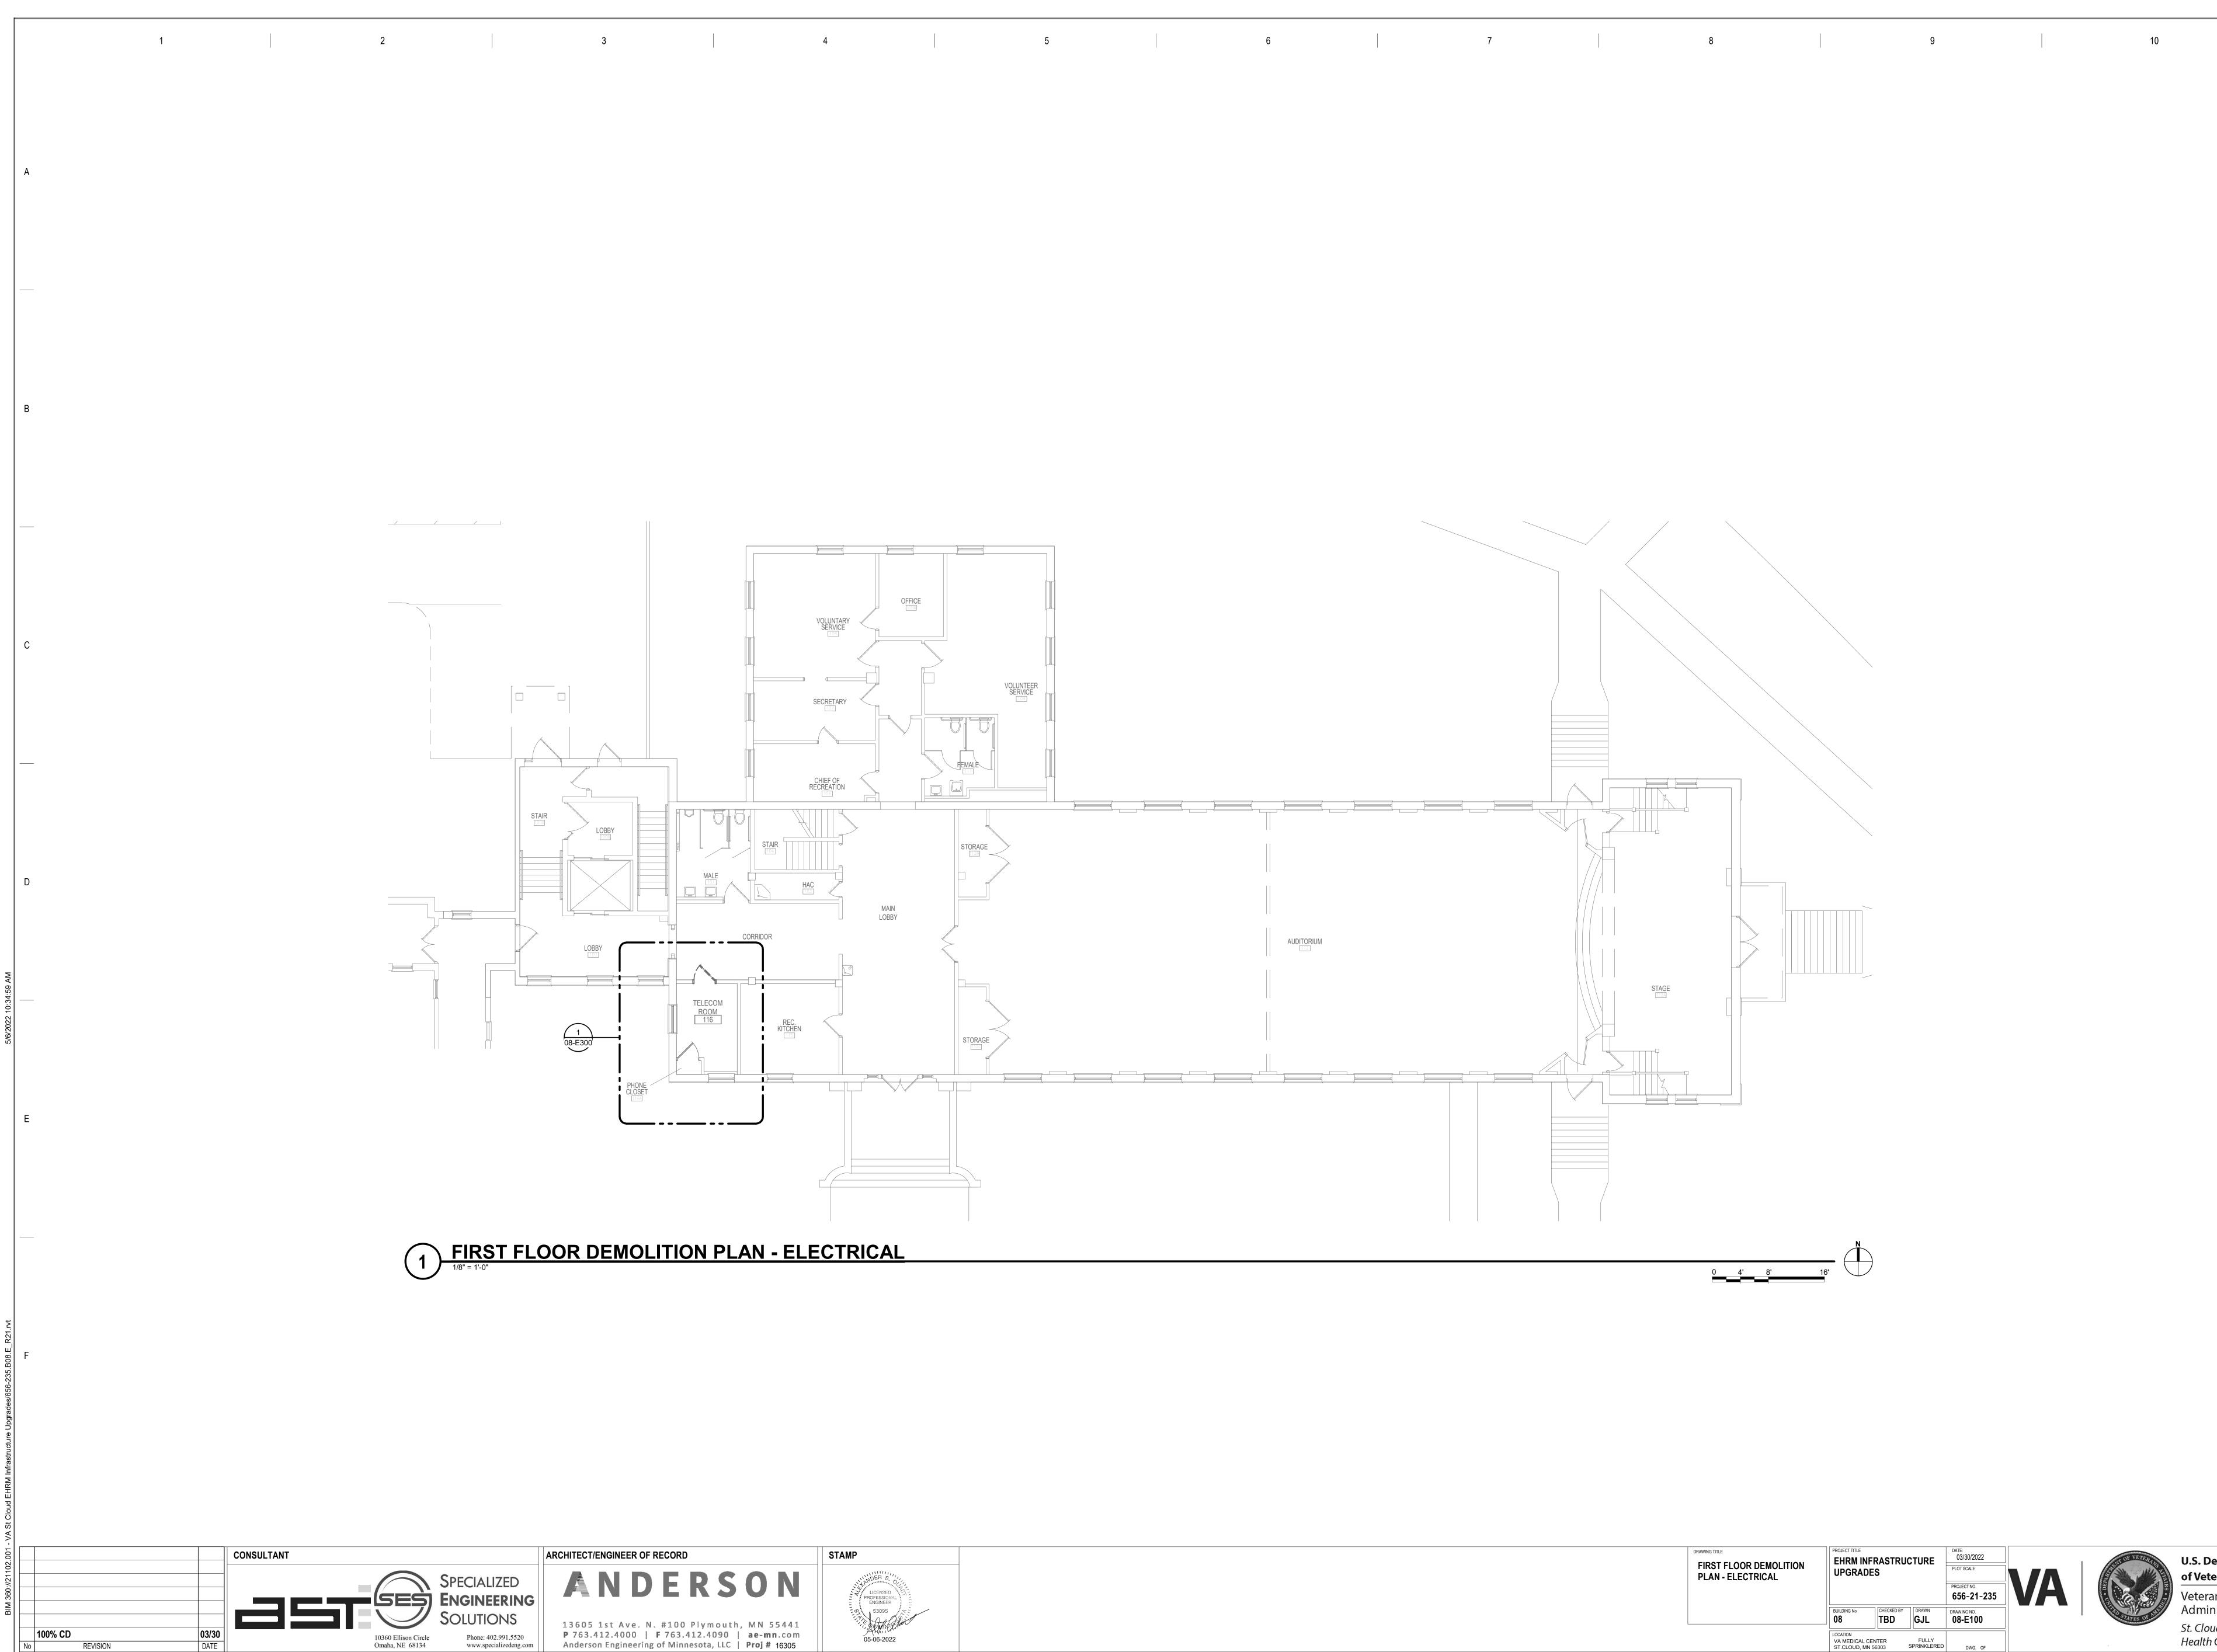



FIRST FLOOR DEMOLITION PLAN - ELECTRICAL		EHRM INFRASTRUCTURE UPGRADES			VA
	BUILDING No	CHECKED BY	drawn GJL	drawing no.	
	LOCATION VA MEDICAL CENTER FULLY ST.CLOUD, MN 56303 SPRINKLERED		DWG. OF		



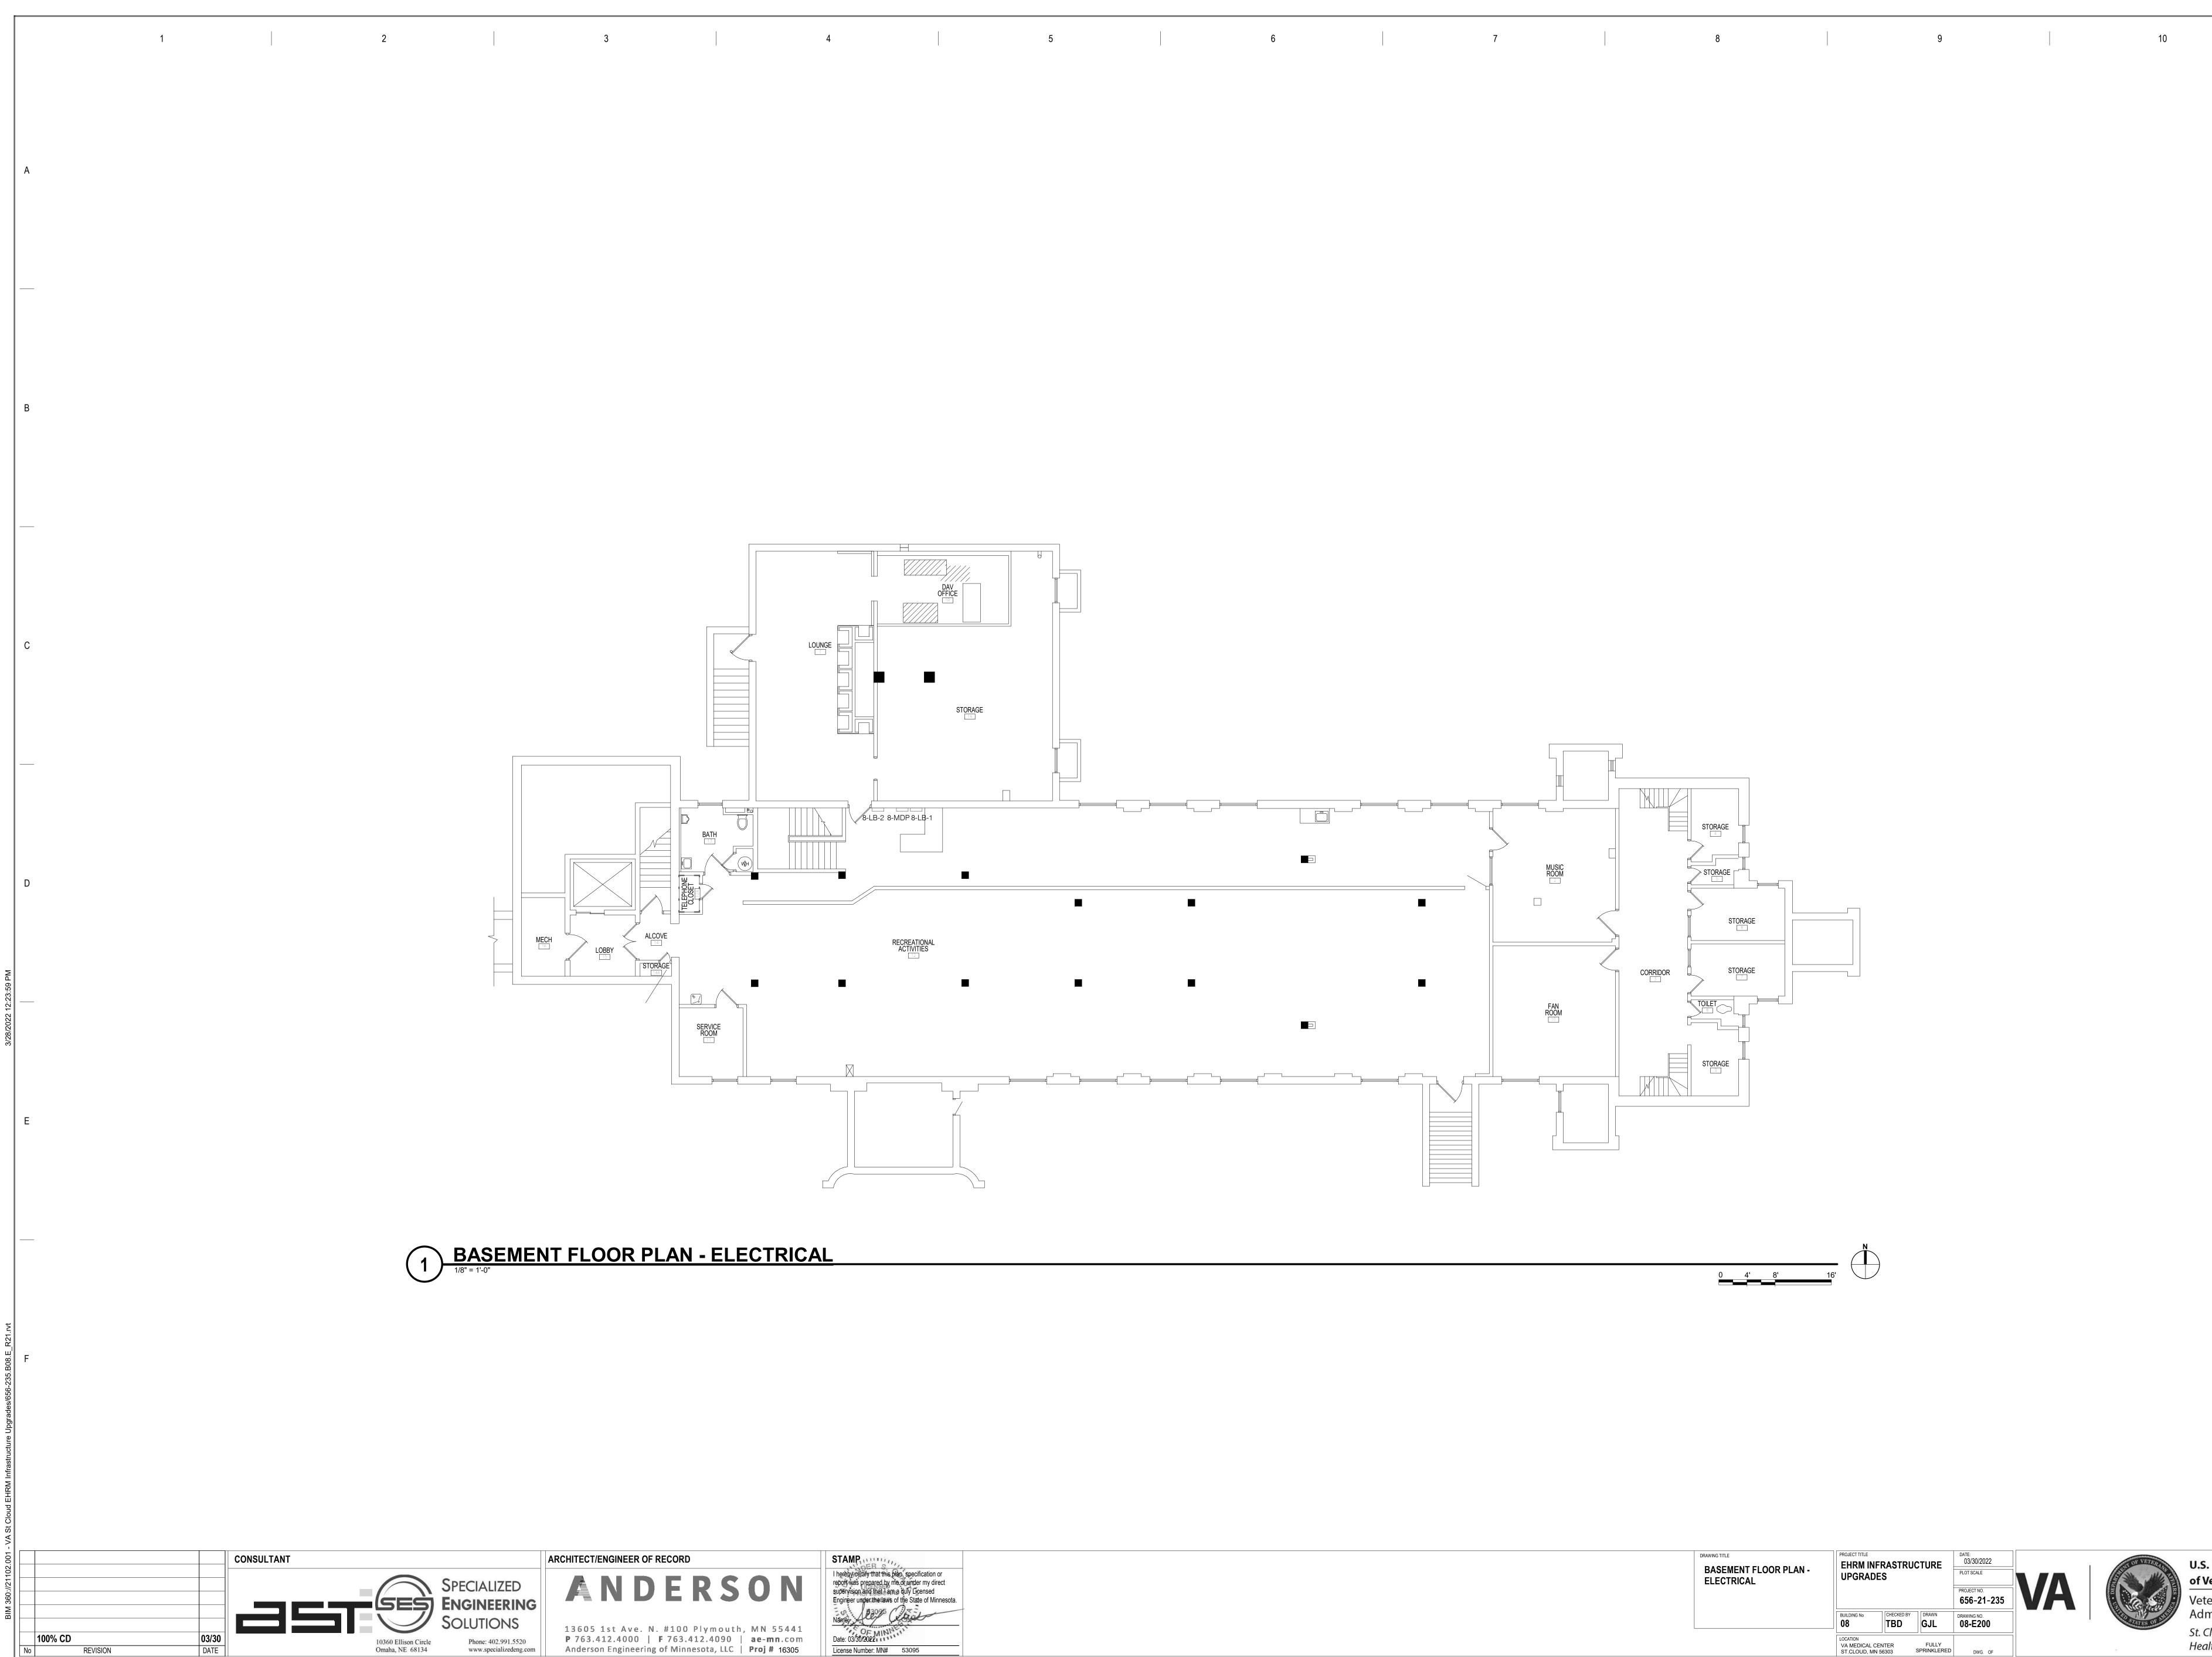


DRAWING TITLE BASEMENT FLOOR PLAN - ELECTRICAL	EHRM INFRASTRUCTURE UPGRADES			DATE: 03/30/2022 PLOT SCALE PROJECT NO. 656-21-235	VA
	BUILDING No	CHECKED BY	drawn GJL	DRAWING NO. 08-E200	
	LOCATION VA MEDICAL CENTER FULLY ST.CLOUD, MN 56303 SPRINKLERED		FULLY SPRINKLERED	DWG. OF	

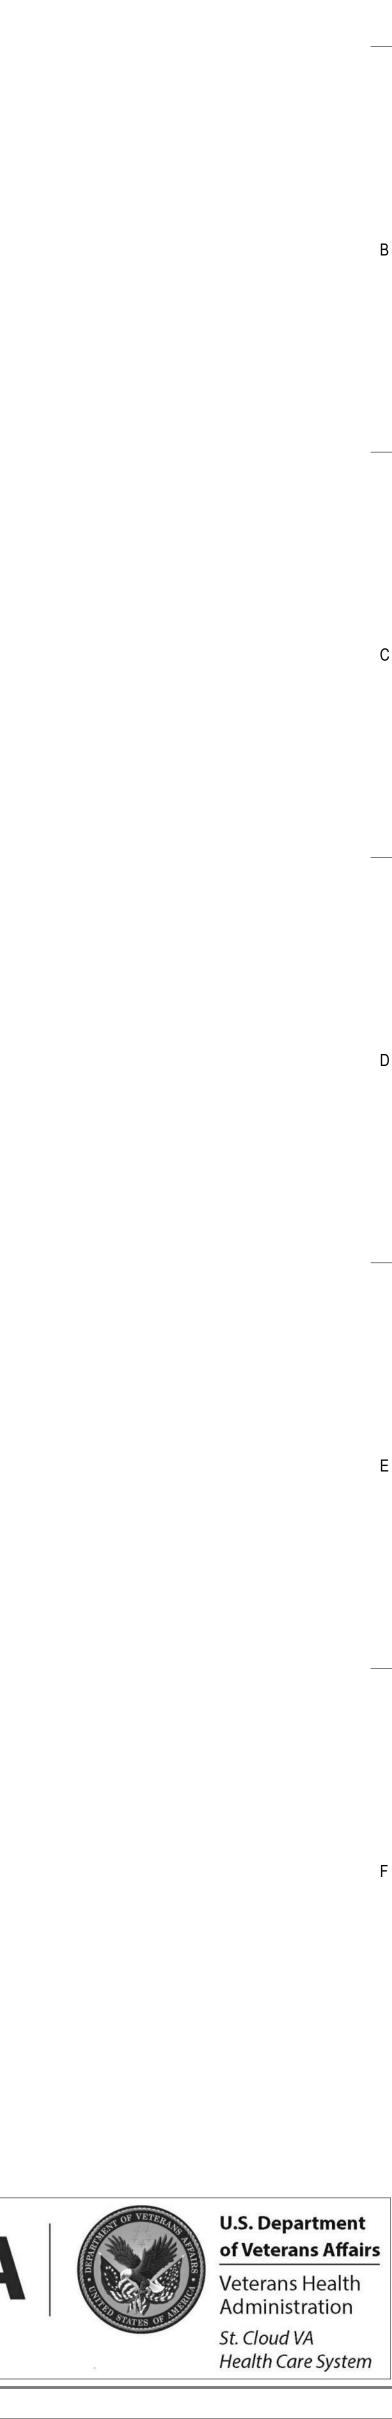

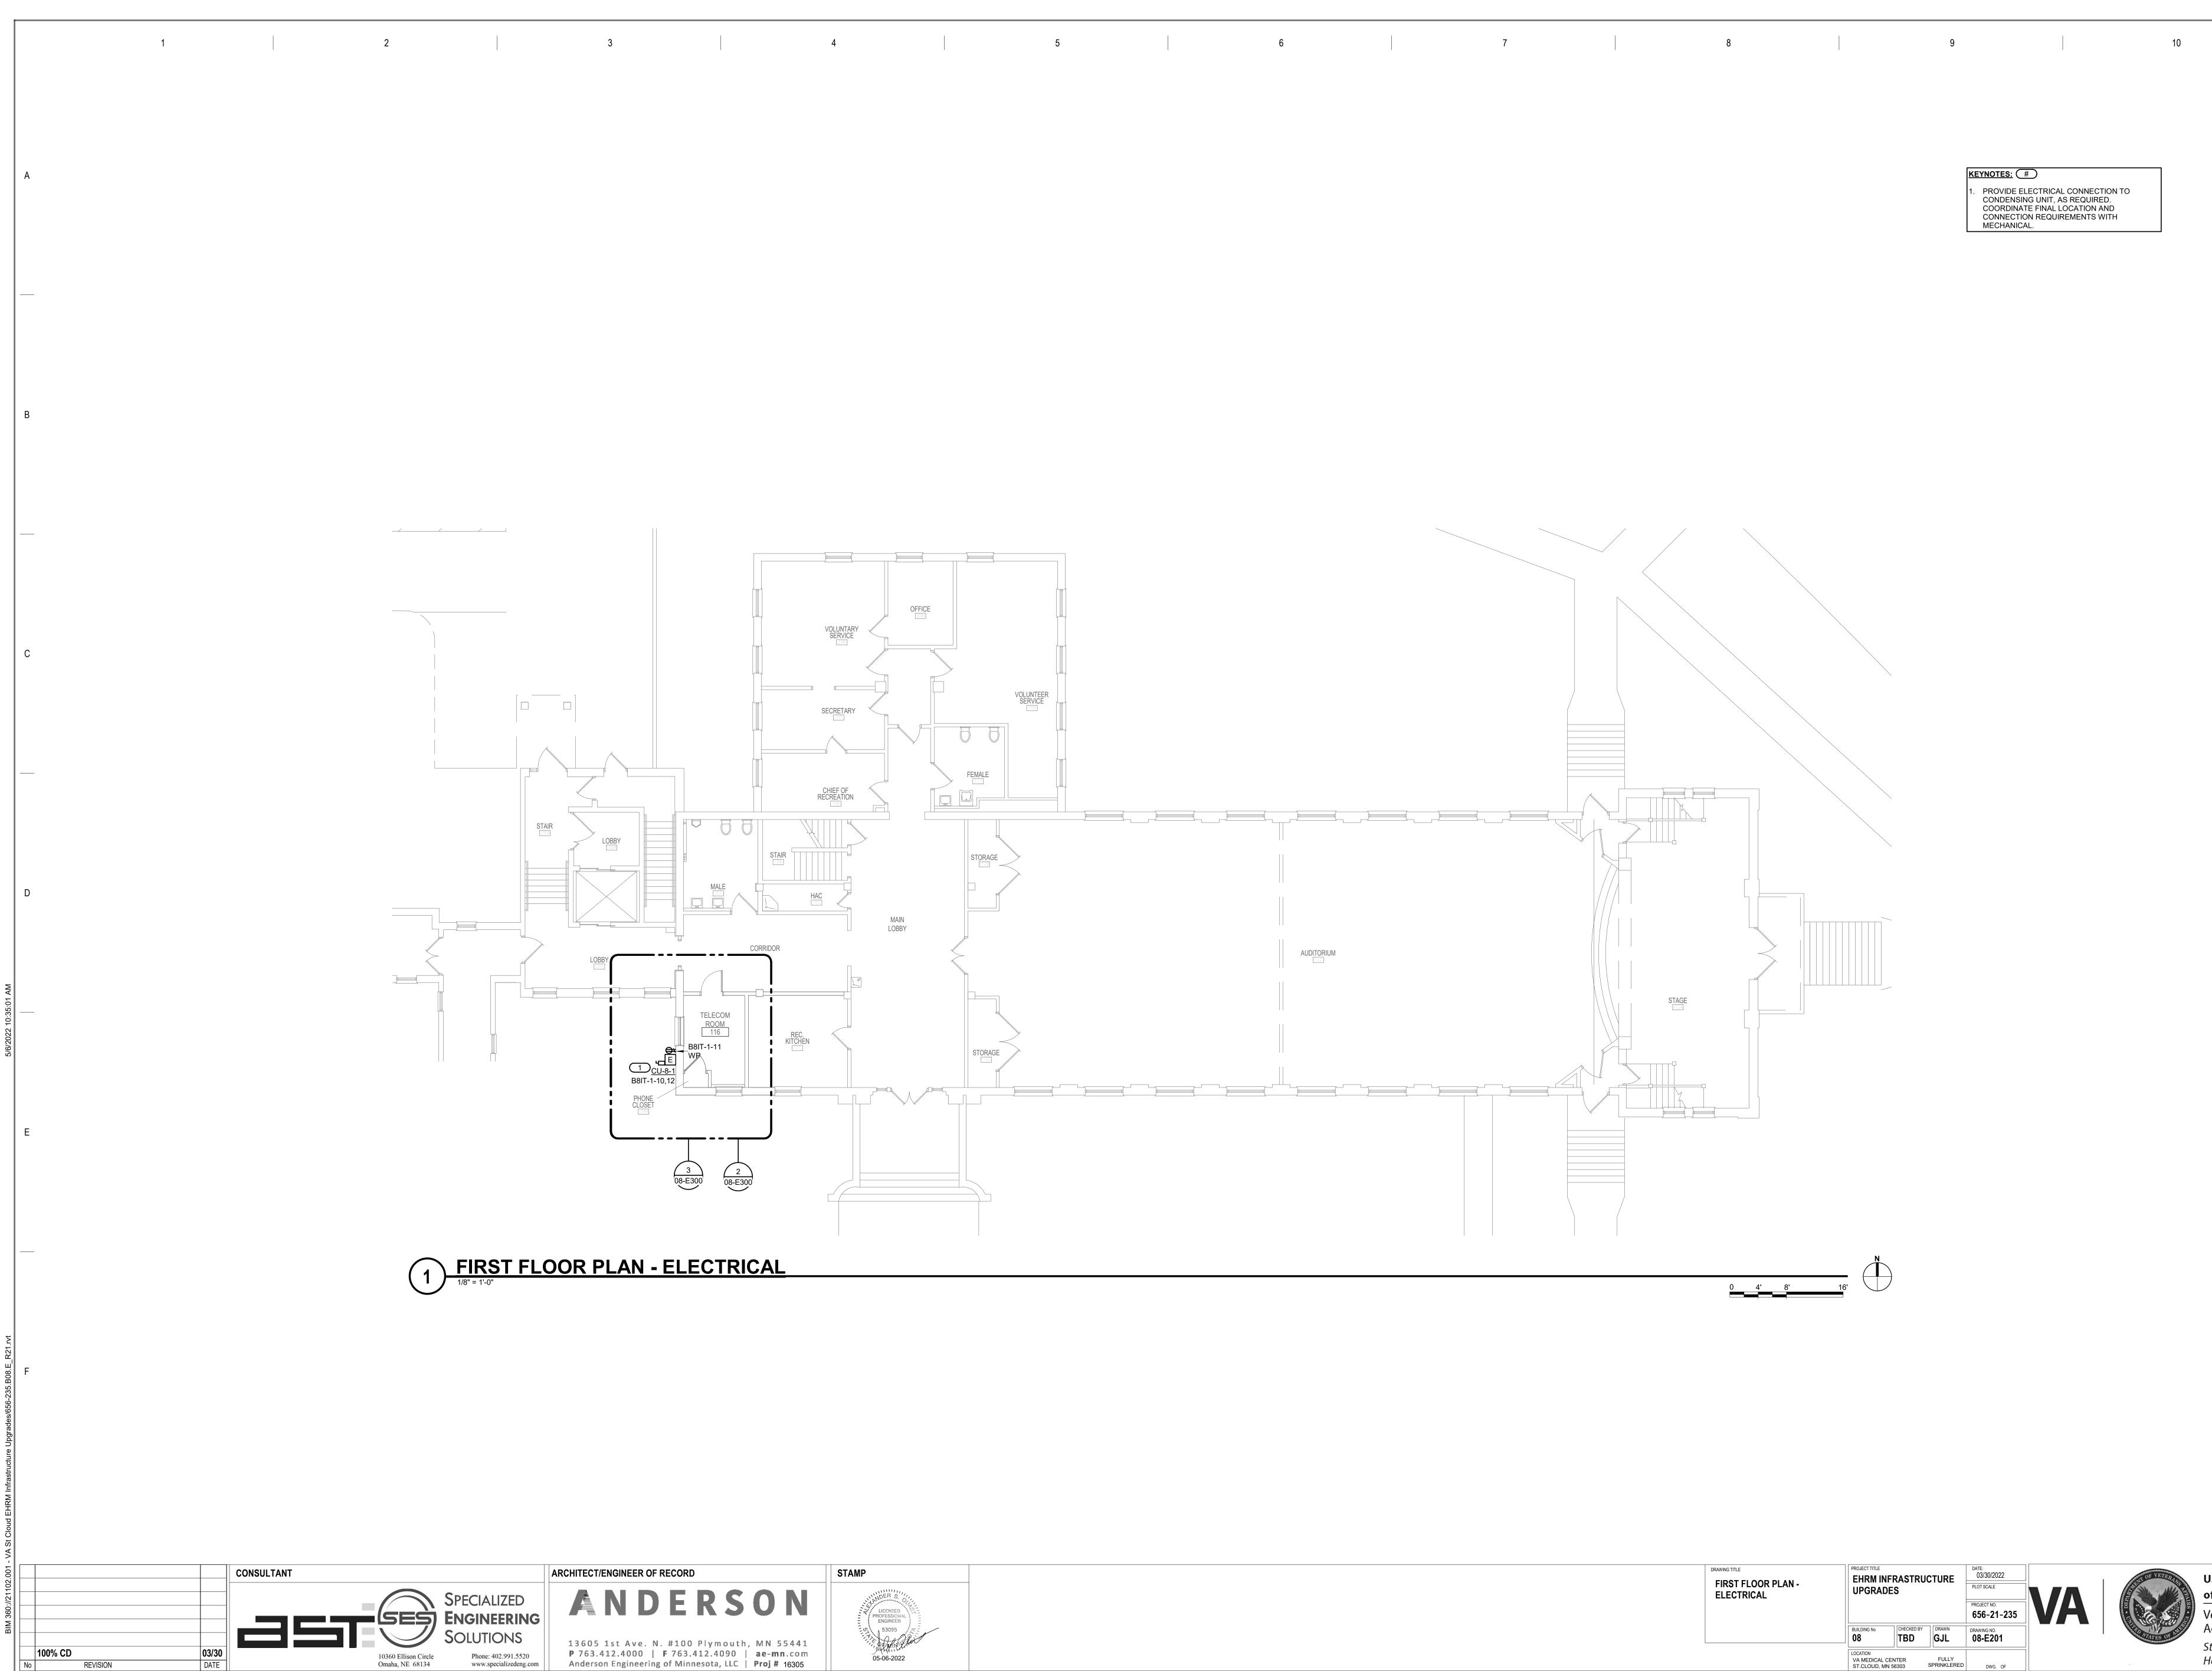


FIRST FLOOR PLAN - ELECTRICAL	EHRM INFRASTRUCTURE UPGRADES			PROJECT NO. 656-21-235		VA
	BUILDING No	CHECKED BY	drawn GJL	DRAWING NO. 08-E20	1	
	LOCATION VA MEDICAL CE ST.CLOUD, MN 5		FULLY SPRINKLERED	DWG.	OF	



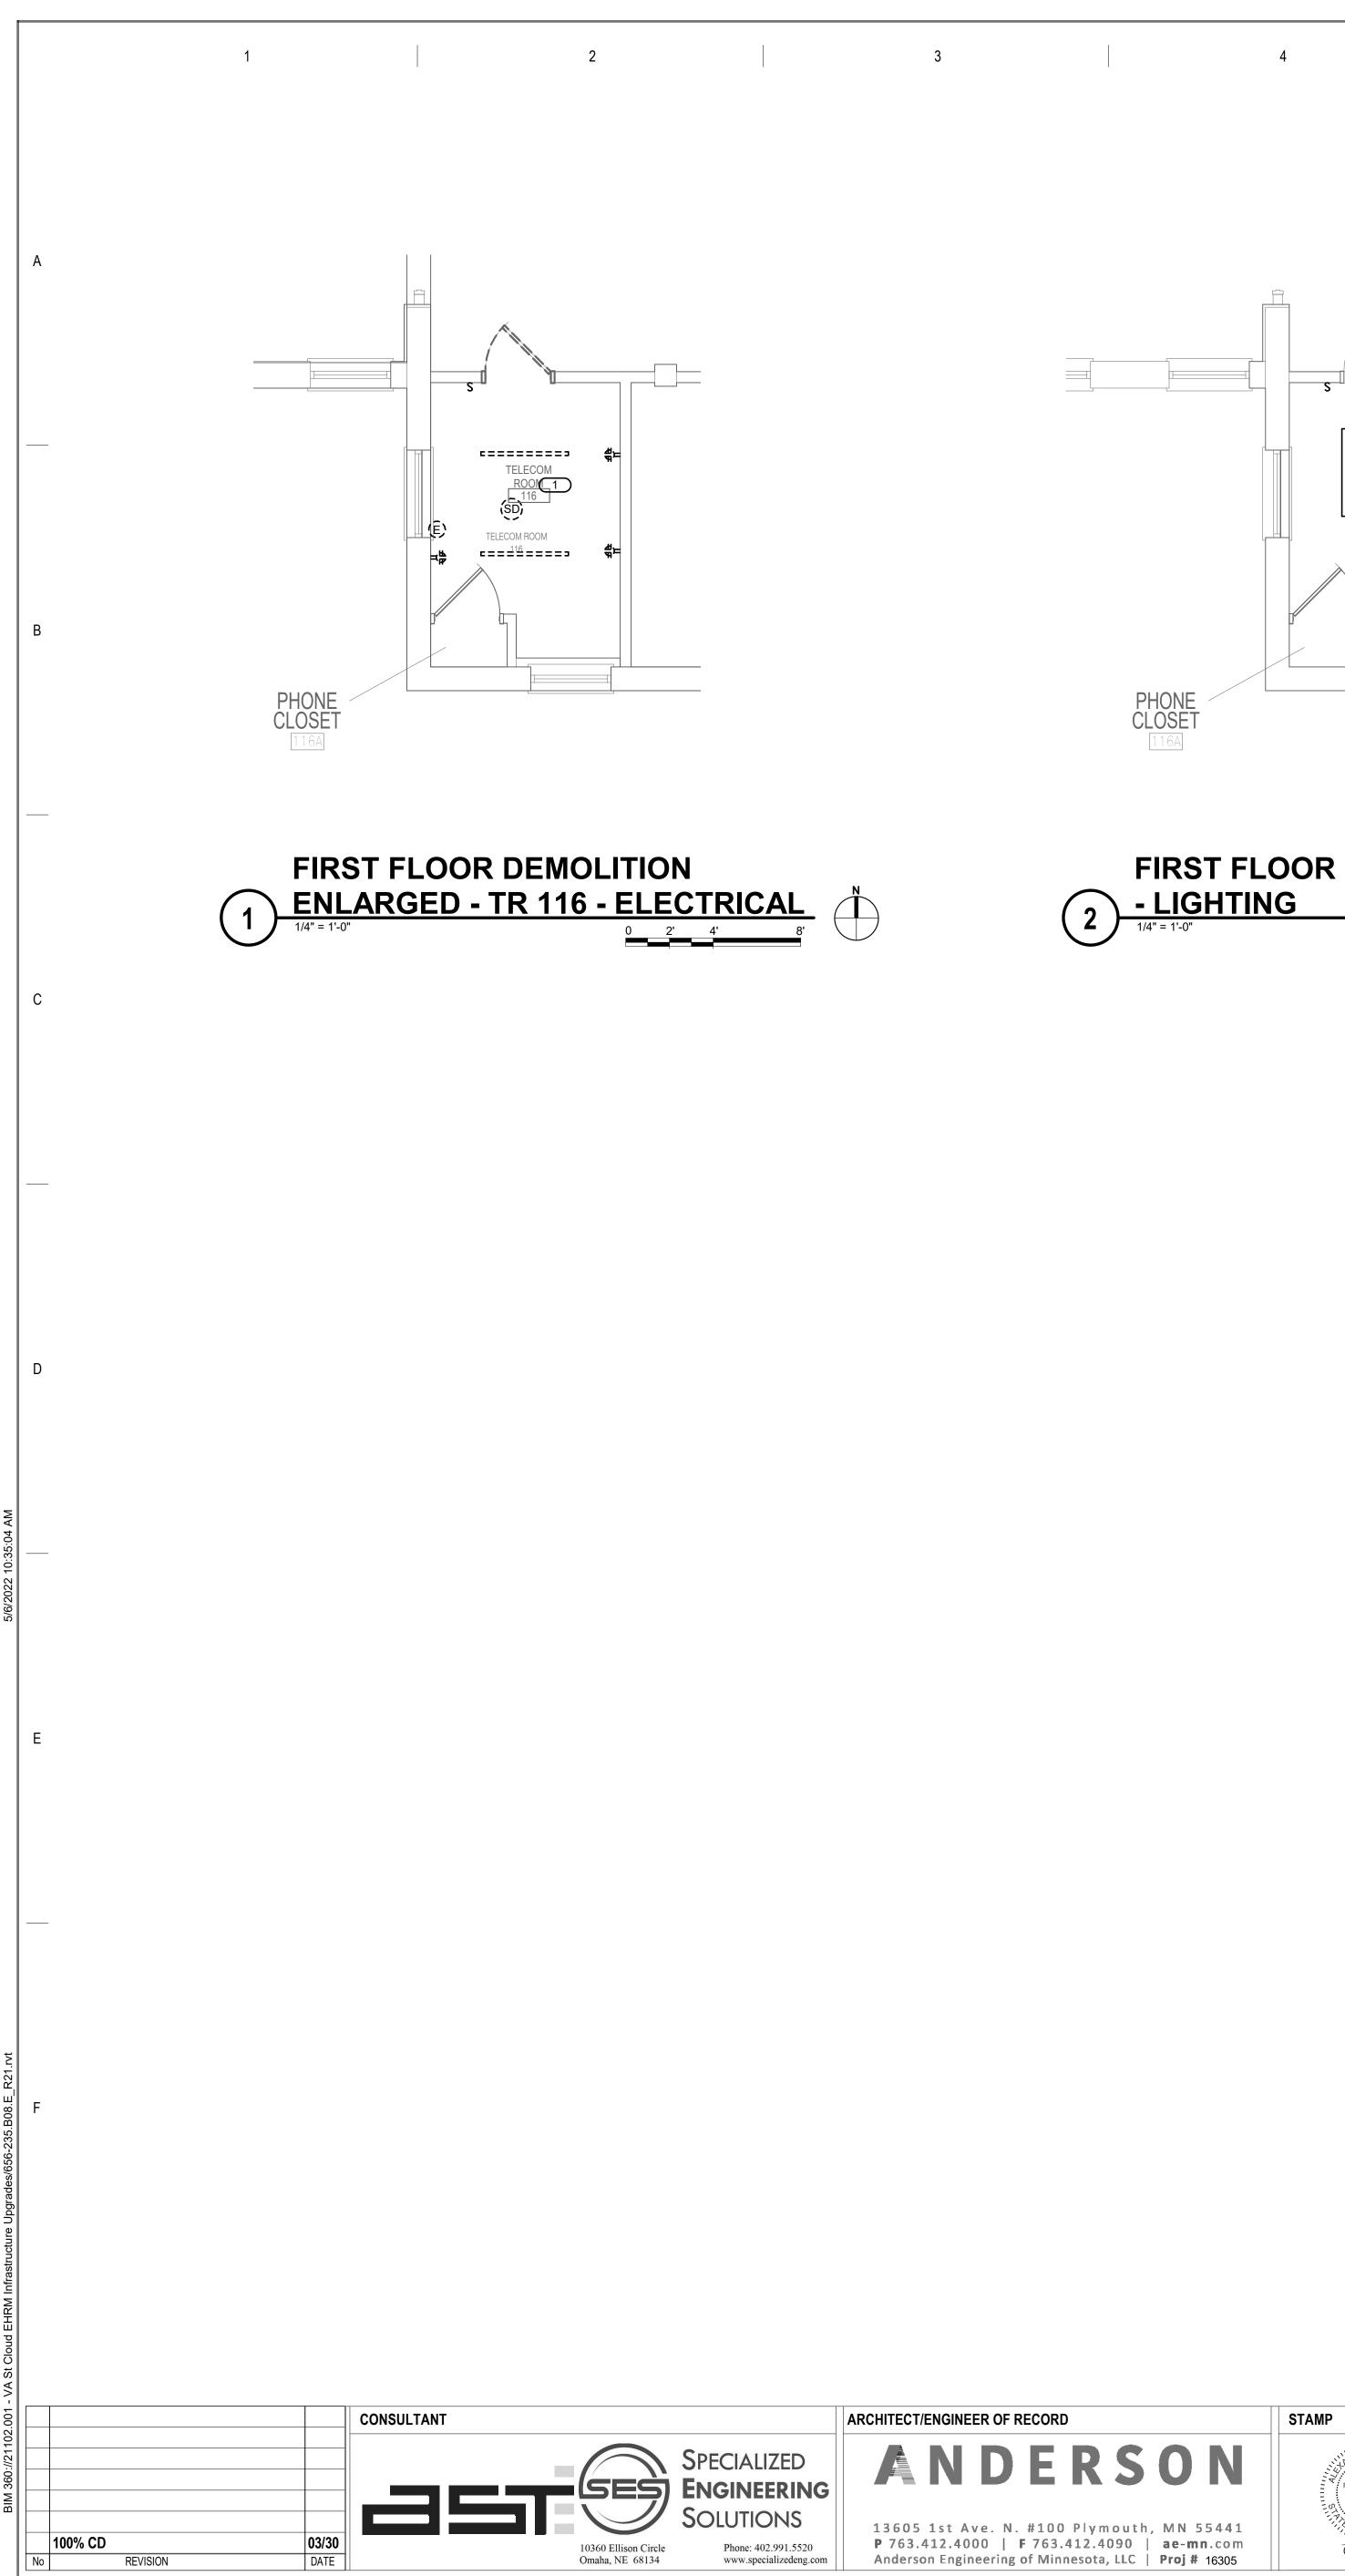

LICENSED PROFESSIONAL ENGINEER 53095

05-06-2022

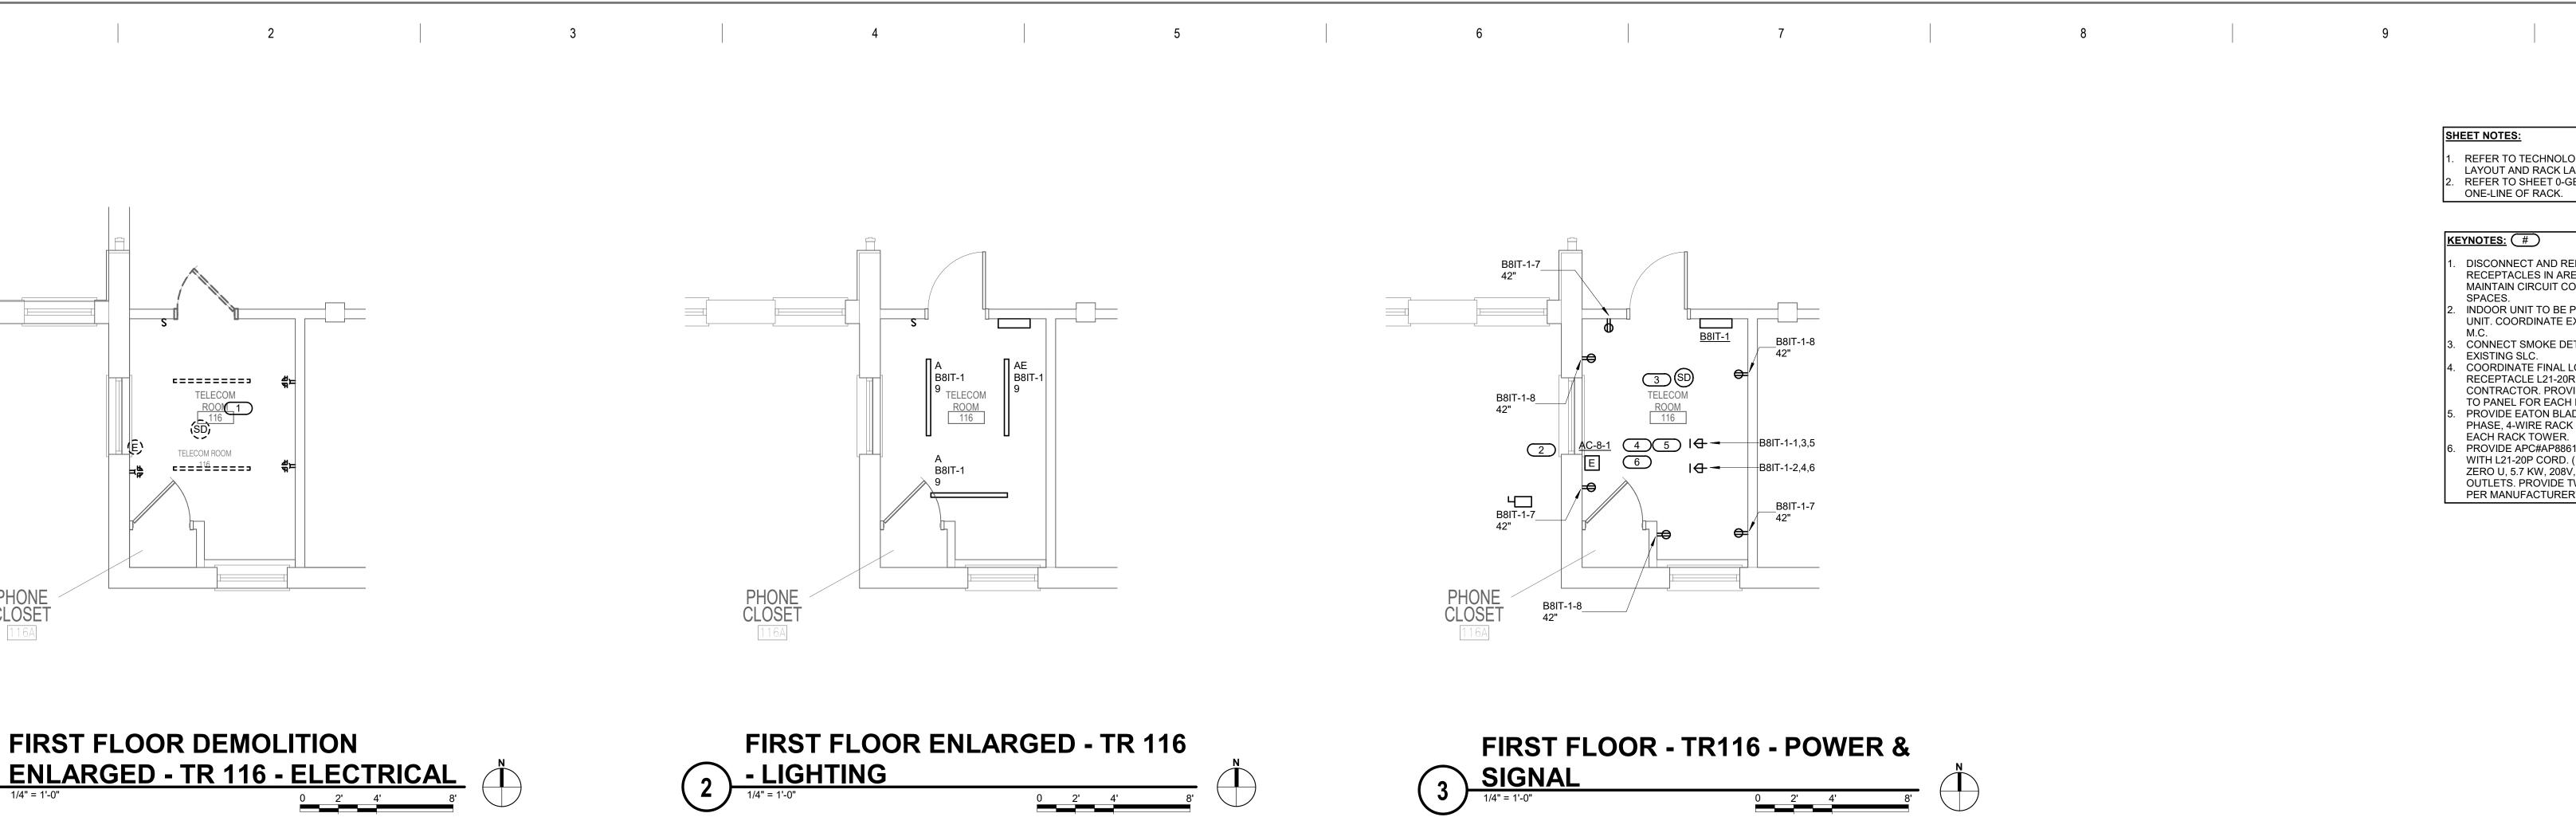

DRAWING TITLE ELECTRICAL ENLARGED PLANS	PROJECT TITLE EHRM INFRASTRUCTURE UPGRADES			DATE: 03/30/2022 PLOT SCALE PROJECT NO. 656-21-235	VA
	BUILDING No 08	CHECKED BY	drawn GJL	DRAWING NO. 08-E300	
	LOCATION VA MEDICAL CEN ST.CLOUD, MN 56		FULLY SPRINKLERED	DWG. OF	


REFER TO TECHNOLOGY PLANS FOR IT ROOM LAYOUT AND RACK LAYOUT/DETAILS. REFER TO SHEET 0-GE400 DETAIL LAYOUT & ONE-LINE OF RACK.

DISCONNECT AND REMOVE LIGHTS AND RECEPTACLES IN AREA OF NEW IT ROOM. MAINTAIN CIRCUIT CONTINUITY TO ADJOINING SPACES. INDOOR UNIT TO BE POWERED BY OUTDOOR UNIT. COORDINATE EXACT LOCATION WITH M.C. CONNECT SMOKE DETECTOR TO NEAREST EXISTING SLC

M.C. CONNECT SMOKE DETECTOR TO NEAREST EXISTING SLC. COORDINATE FINAL LOCATION OF RECEPTACLE L21-20R WITH TELECOM CONTRACTOR. PROVIDE 3/4"C-4#12, 1#12 GND TO PANEL FOR EACH RECEPTACLE. PROVIDE EATON BLADEUPS, 5KW, 120/208V, 3-PHASE, 4-WIRE RACK MOUNTED UPS FOR EACH RACK TOWER. PROVIDE APC#AP8861 PDDU BACK PDU 20

PROVIDE APC#AP8861 RPDU RACK PDU 2G WITH L21-20P CORD. (120/208V, 3-PHASE, 20A, ZERO U, 5.7 KW, 208V, (36) C13 (6) C19 (2) 5-20R OUTLETS. PROVIDE TWO PER RACK, MOUNTED PER MANUFACTURER'S REQUIREMENTS.




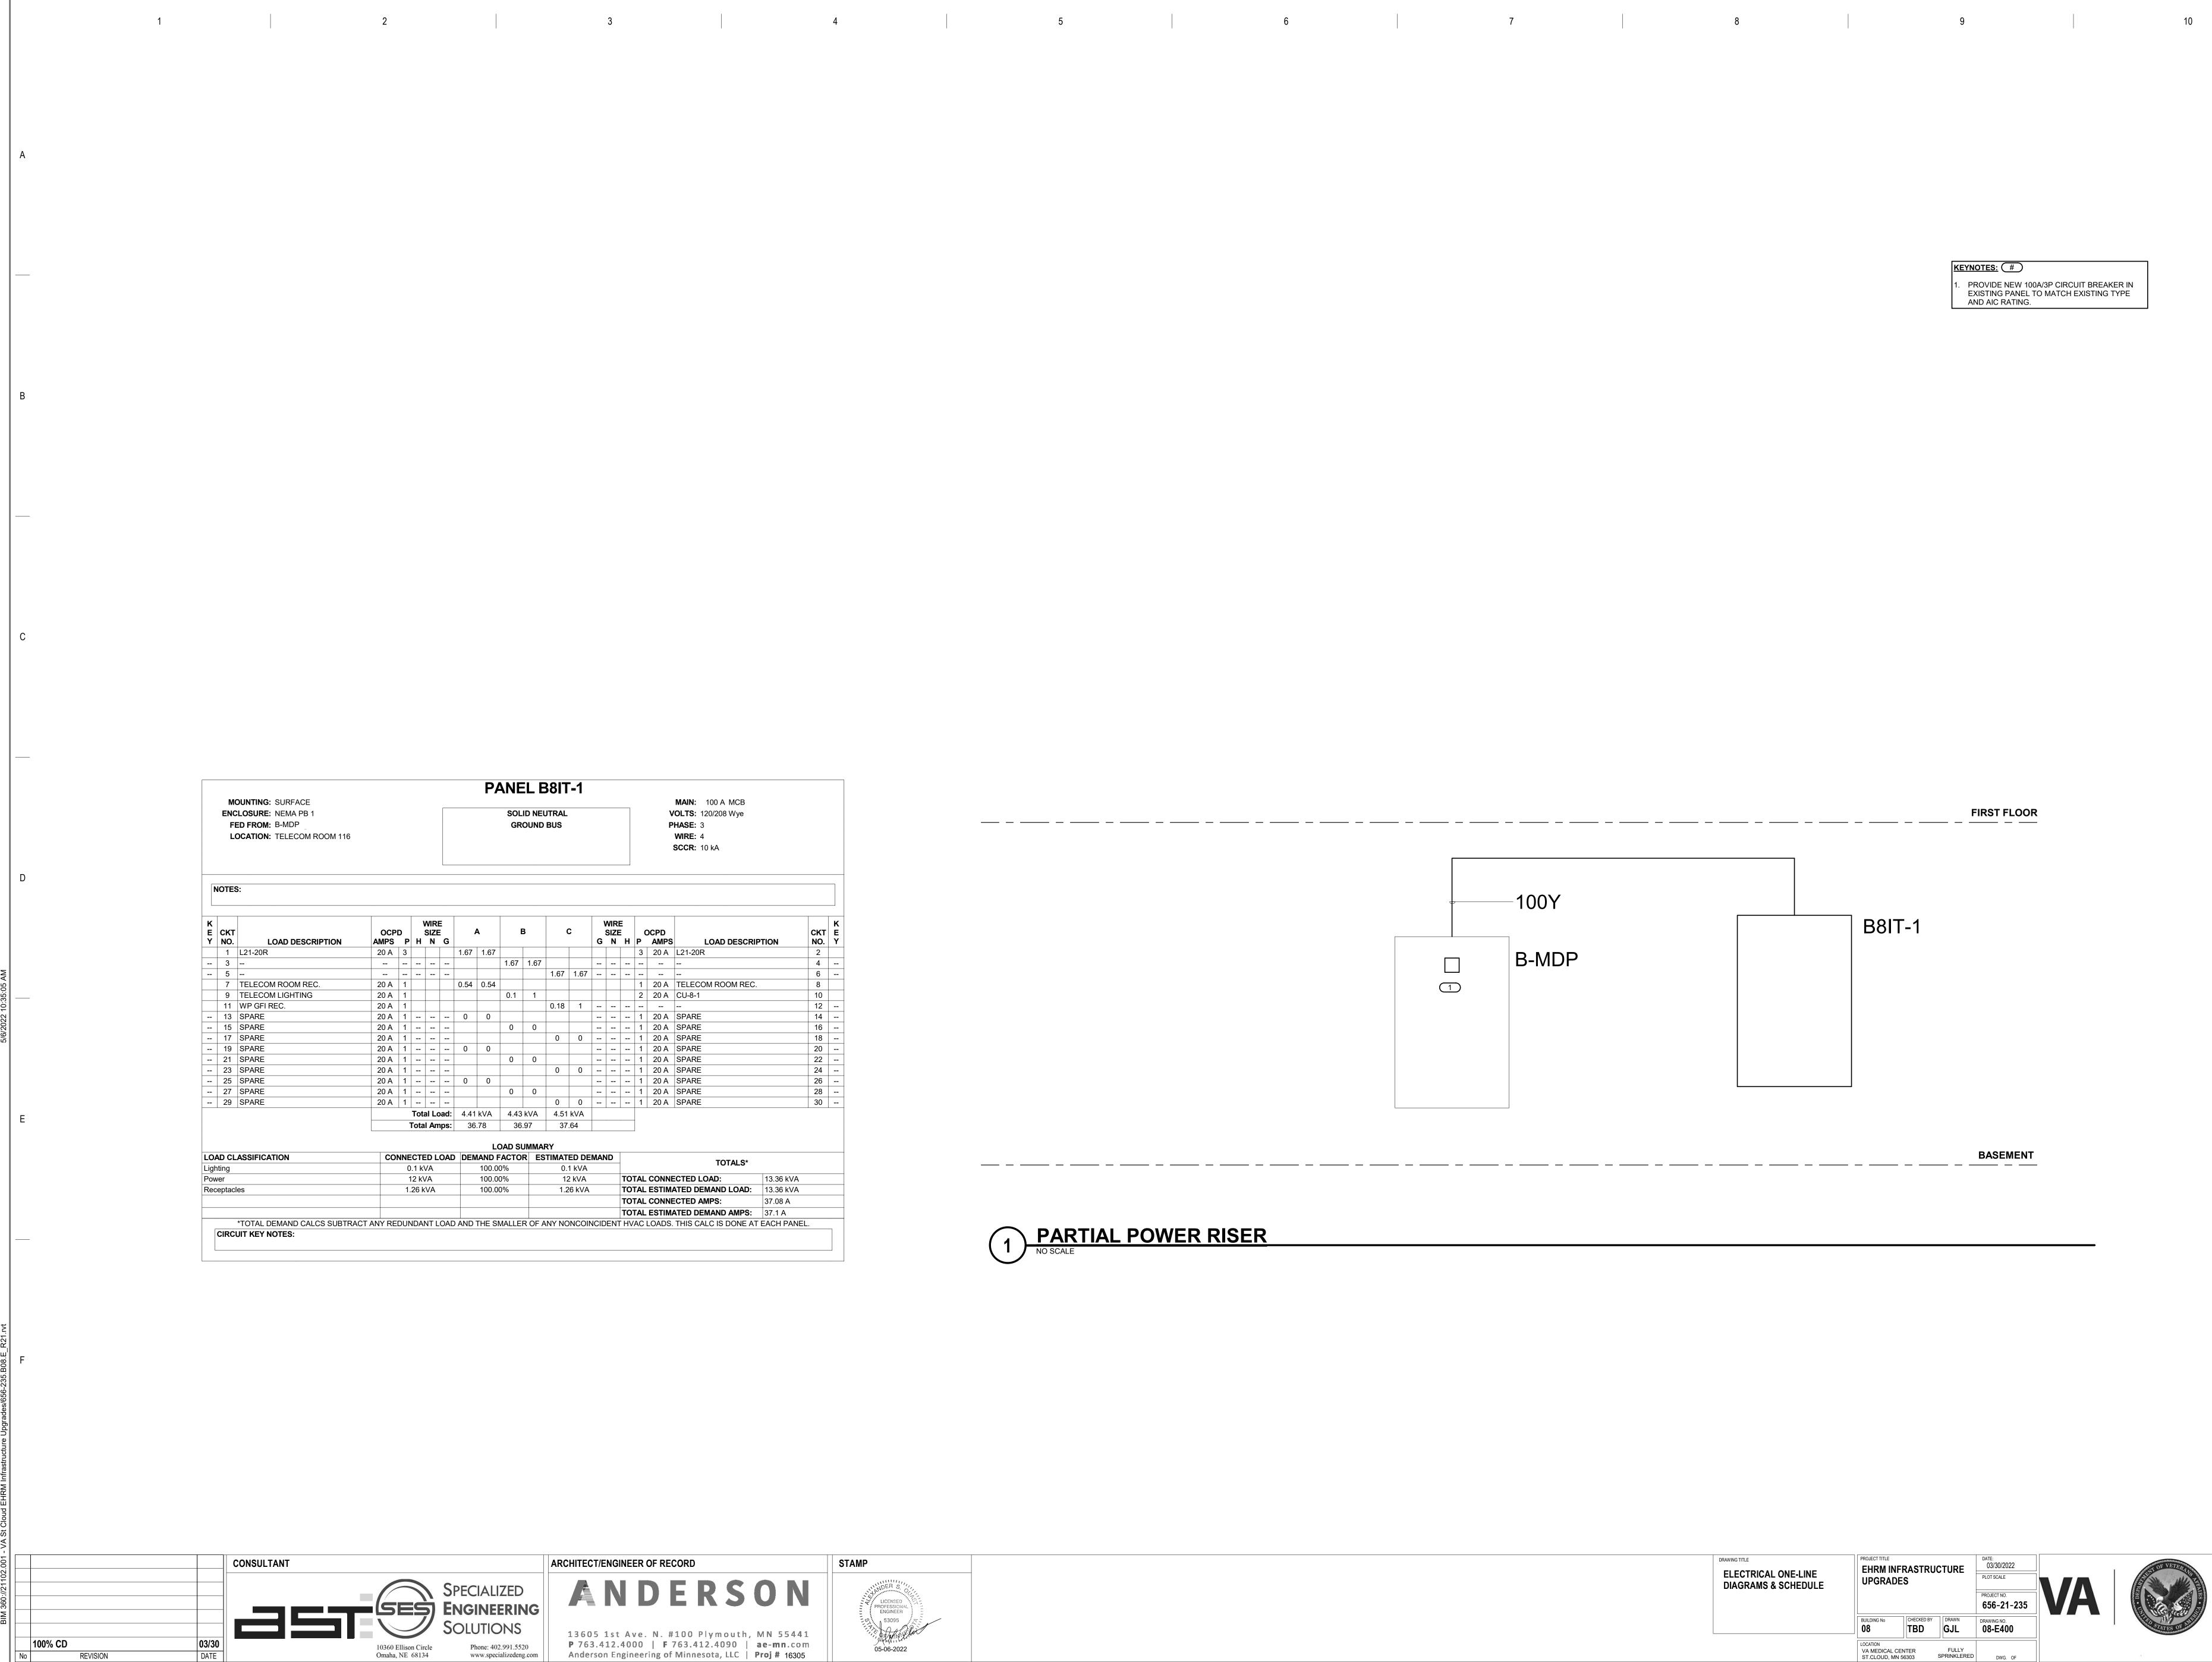

UTIONS	13605 1st
Phone: 402.991.5520 www.specializedeng.com	P 763.412 Anderson E

V Pi	MAIN: 100 A MCB OLTS: 120/208 Wye HASE: 3 WIRE: 4 SCCR: 10 kA			
D MPS	LOAD DESCRIP	TION	CKT NO.	K E Y
) A	L21-20R		2	
			4	
			6	
) A	TELECOM ROOM REC.		8	
) A	CU-8-1		10	
			12	
) A	SPARE		14	
) A	SPARE		16	
) A	SPARE		18	
) A	SPARE		20	
D A	SPARE		22	
) A	SPARE		24	
) A	SPARE		26	
ЛA	SPARE		28	
) A	SPARE		30	
	TOTALS*			
	CTED LOAD:	13.36 kVA		
	ATED DEMAND LOAD:	13.36 kVA		
	CTED AMPS:	37.08 A		
	ATED DEMAND AMPS:	37.1 A		
	THIS CALC IS DONE AT I			



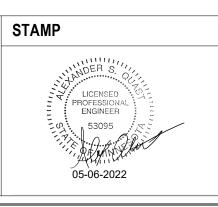



KEYNOTES: # PROVIDE NEW 100A/3P CIRCUIT BREAKER IN EXISTING PANEL TO MATCH EXISTING TYPE AND AIC RATING.

FIRST FLOOR -100Y B8IT-1 B-MDP \bigcirc BASEMENT _____

DRAWING TITLE ELECTRICAL ONE-LI DIAGRAMS & SCHED	EHRM INF		CTURE	DATE: 03/30/2022 PLOT SCALE PROJECT NO.	ΝΔ
	BUILDING No	CHECKED BY	drawn GJL	656-21-235 DRAWING NO. 08-E400	
	LOCATION VA MEDICAL CE ST.CLOUD, MN \$		FULLY SPRINKLERED	DWG. OF	



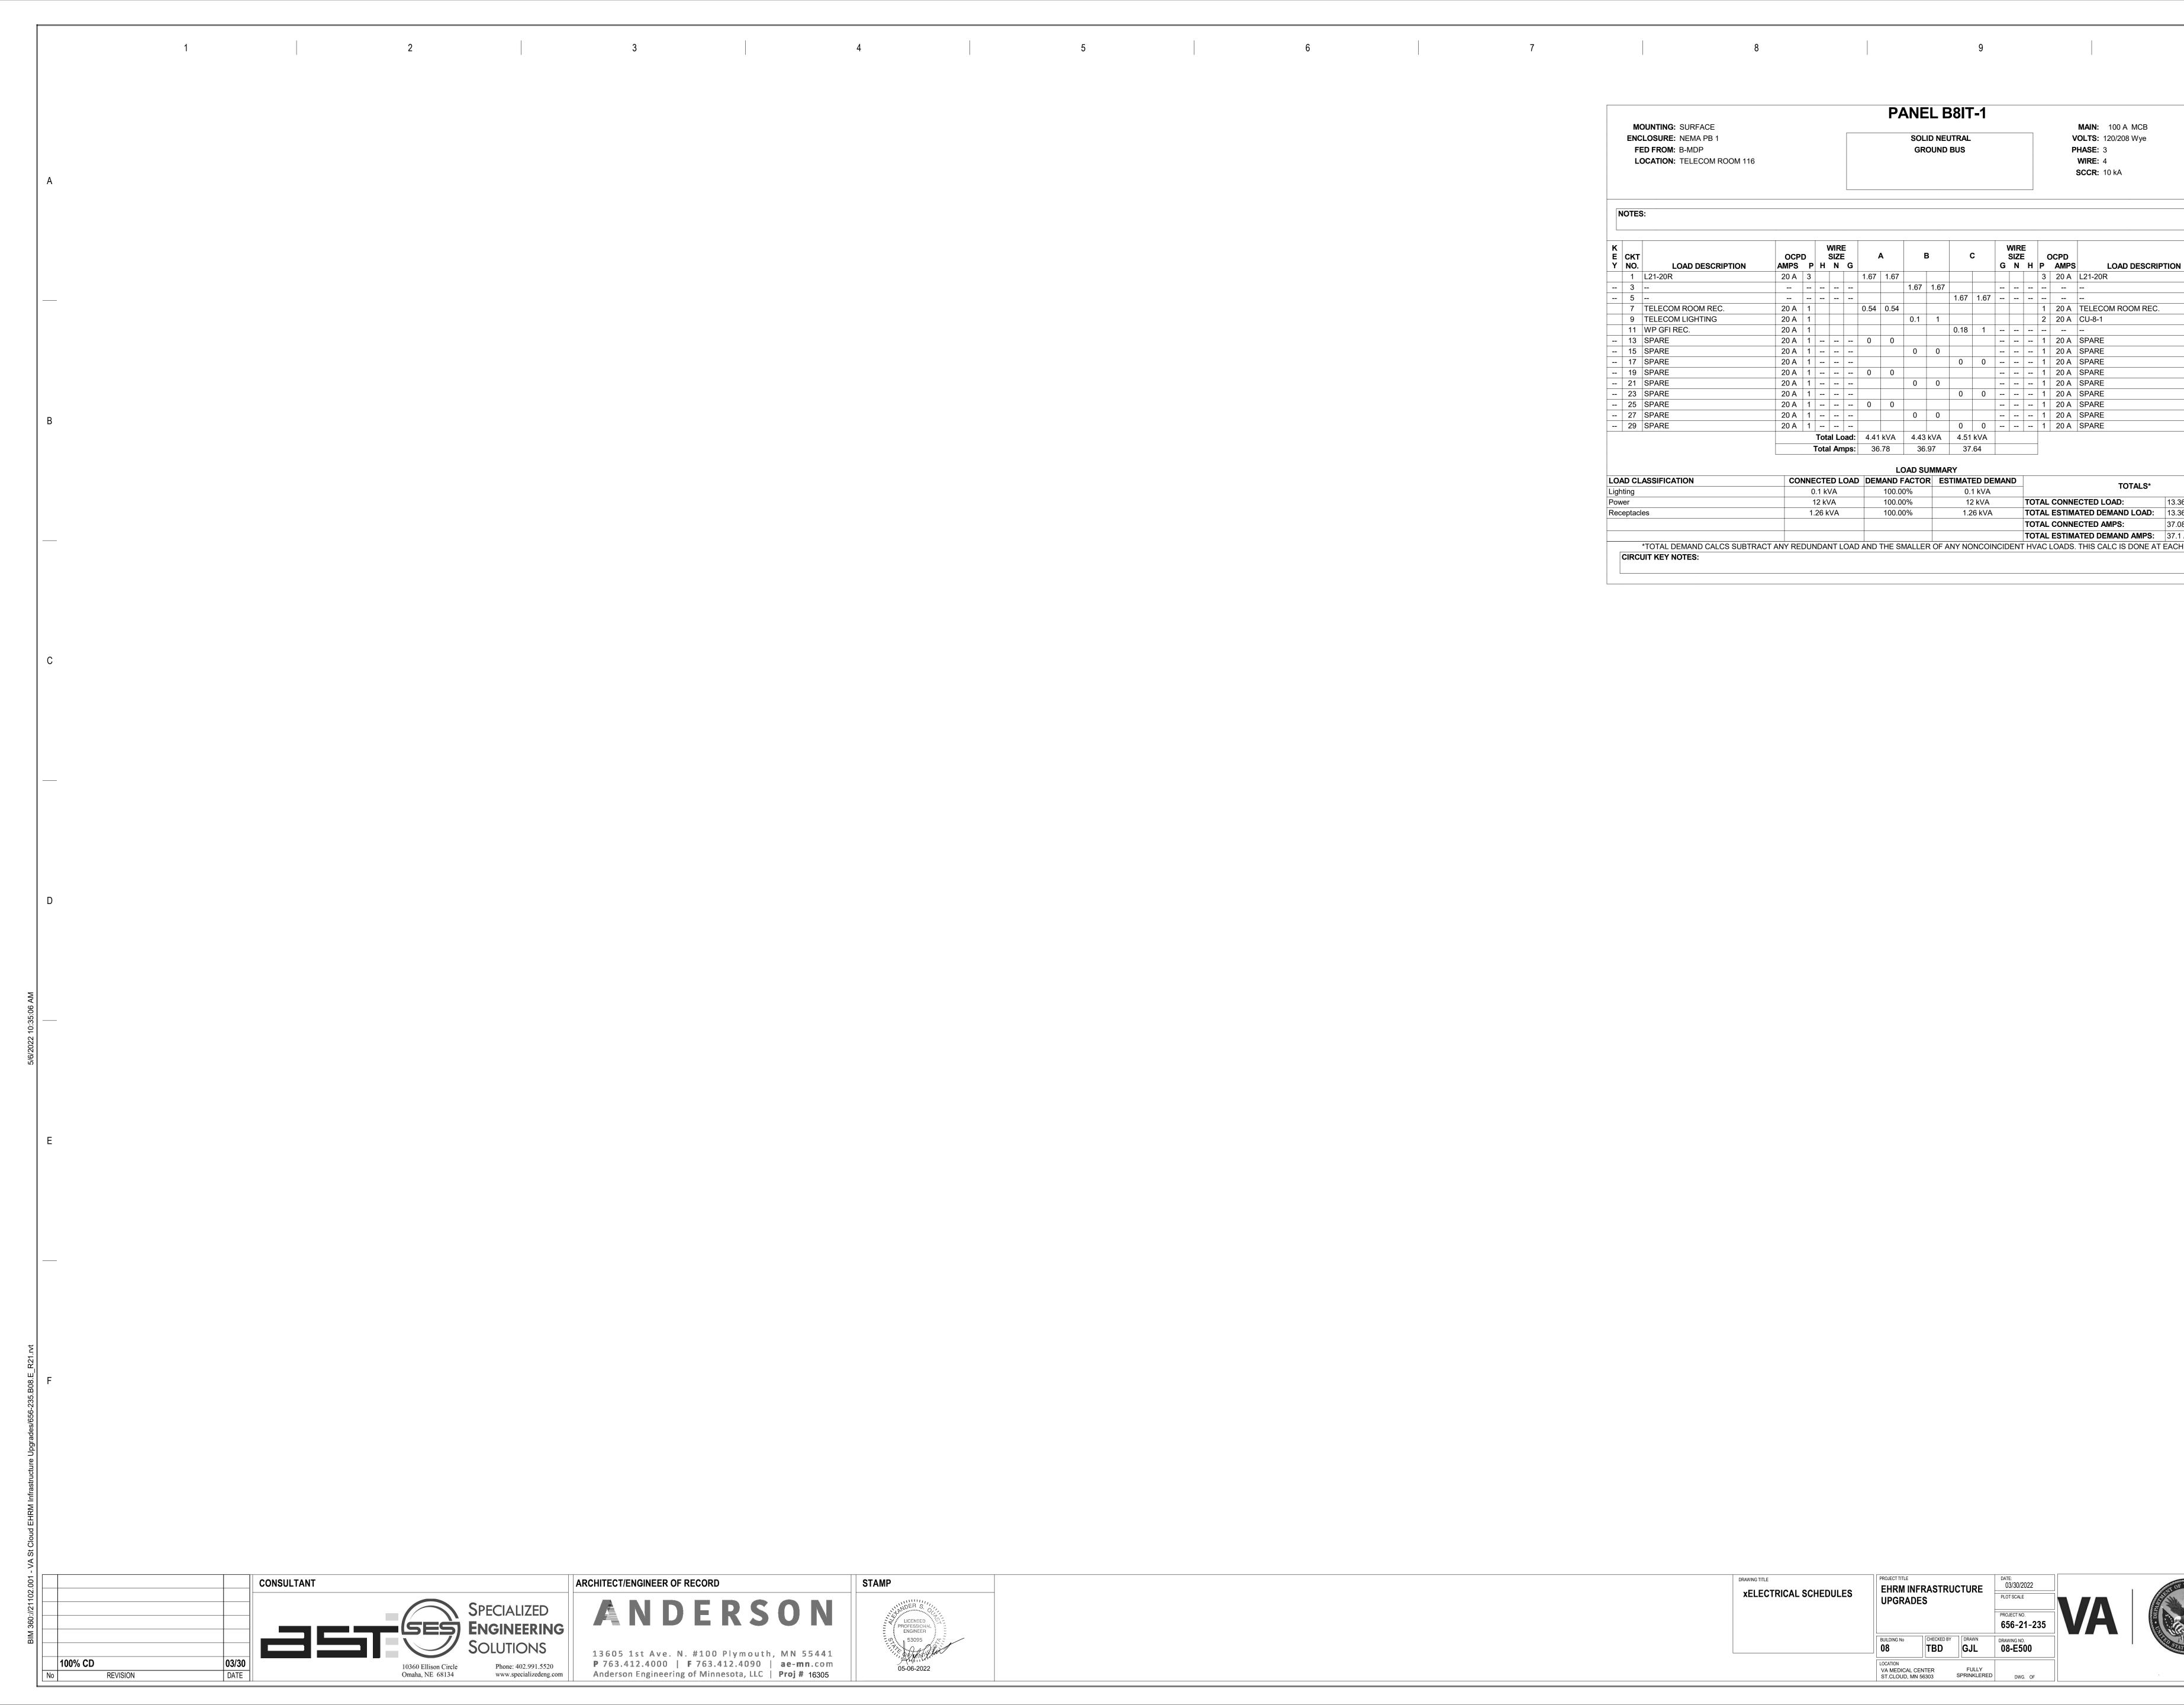


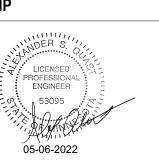

									P	ANE	EL E	B8IT	-1									
MOUNTING: SURFACE ENCLOSURE: NEMA PB 1 FED FROM: B-MDP LOCATION: TELECOM ROOM 116				SOLID NEUTRAL GROUND BUS								MAIN: 100 A MCB VOLTS: 120/208 Wye PHASE: 3 WIRE: 4 SCCR: 10 kA										
N	OTES	6 :																				-
	скт		OCP			WIR SIZI	E		A		В	C	;		VIRE	:		CPD			скт	
Y	NO.	LOAD DESCRIPTION	AMPS		H	N	G	1.07	1.07					G	N	Н		AMPS		PTION	NO	_
_	1	L21-20R	20 A	3				1.67	1.67	1.67	1.67						3	20 A	L21-20R		2	-
	3 5									1.07	1.07	1.67	1.67								6	_
-	7	TELECOM ROOM REC.	20 A	1	+		+	0.54	0.54			1.07	1.07				1	20 A	TELECOM ROOM REC		8	_
\neg	9	TELECOM LIGHTING	20 A	1	-		+		0.07	0.1	1						2	20 A	CU-8-1	•	10	_
	-	WP GFI REC.	20 A	1								0.18	1								12	_
	13	SPARE	20 A	1				0	0								1	20 A	SPARE		14	_
		SPARE	20 A	1						0	0						1		SPARE		16	_
		SPARE	20 A	1								0	0				1		SPARE		18	_
		SPARE	20 A	1				0	0	-							1		SPARE		20	_
		SPARE	20 A	1						0	0						1		SPARE		22	_
	23 25	SPARE SPARE	20 A 20 A	1				0	0			0	0				1		SPARE SPARE		24	_
	25 27	SPARE	20 A	1					0	0	0						1		SPARE		26 28	_
		SPARE	20 A	1								0	0				1		SPARE		30	_
				· ·	Tot	ı al L	oad:	4.41	kVA	4.43	kVA	4.51					-					-
							nps:		.78		.97	37.										
			L									ער]	1					
.OA	D CL	ASSIFICATION	CO	NN	ECTI	ED L	.OAD	DEN		DAD SI FACTO		TIMAT	ED DE	MAN	ID							-
ight	ting).1 k				100.0				l kVA						TOTALS*			
ow					12 k'				100.0				2 kVA						ECTED LOAD:	13.36 kVA		
Rece	eptacl	es		1	.26	ΧA			100.0	0%		1.2	6 kVA						ATED DEMAND LOAD:	13.36 kVA		
																			ECTED AMPS:	37.08 A		_
		*TOTAL DEMAND CALCS SUBTRAC							_	_						TOT	AL	ESTIM/	ATED DEMAND AMPS:	37.1 A		

DRAWING TITLE XELECTRICAL SCHEDULES	PROJECT TITLE EHRM IN UPGRAD	FRASTRU ES	CTURE	DATE: 03/30/2022 PLOT SCALE	
				PROJECT NO. 656-21-235	V
	BUILDING No	CHECKED BY	drawn GJL	DRAWING NO. 08-E500	
	LOCATION VA MEDICAL C ST.CLOUD, MN		FULLY	DWG. OF	



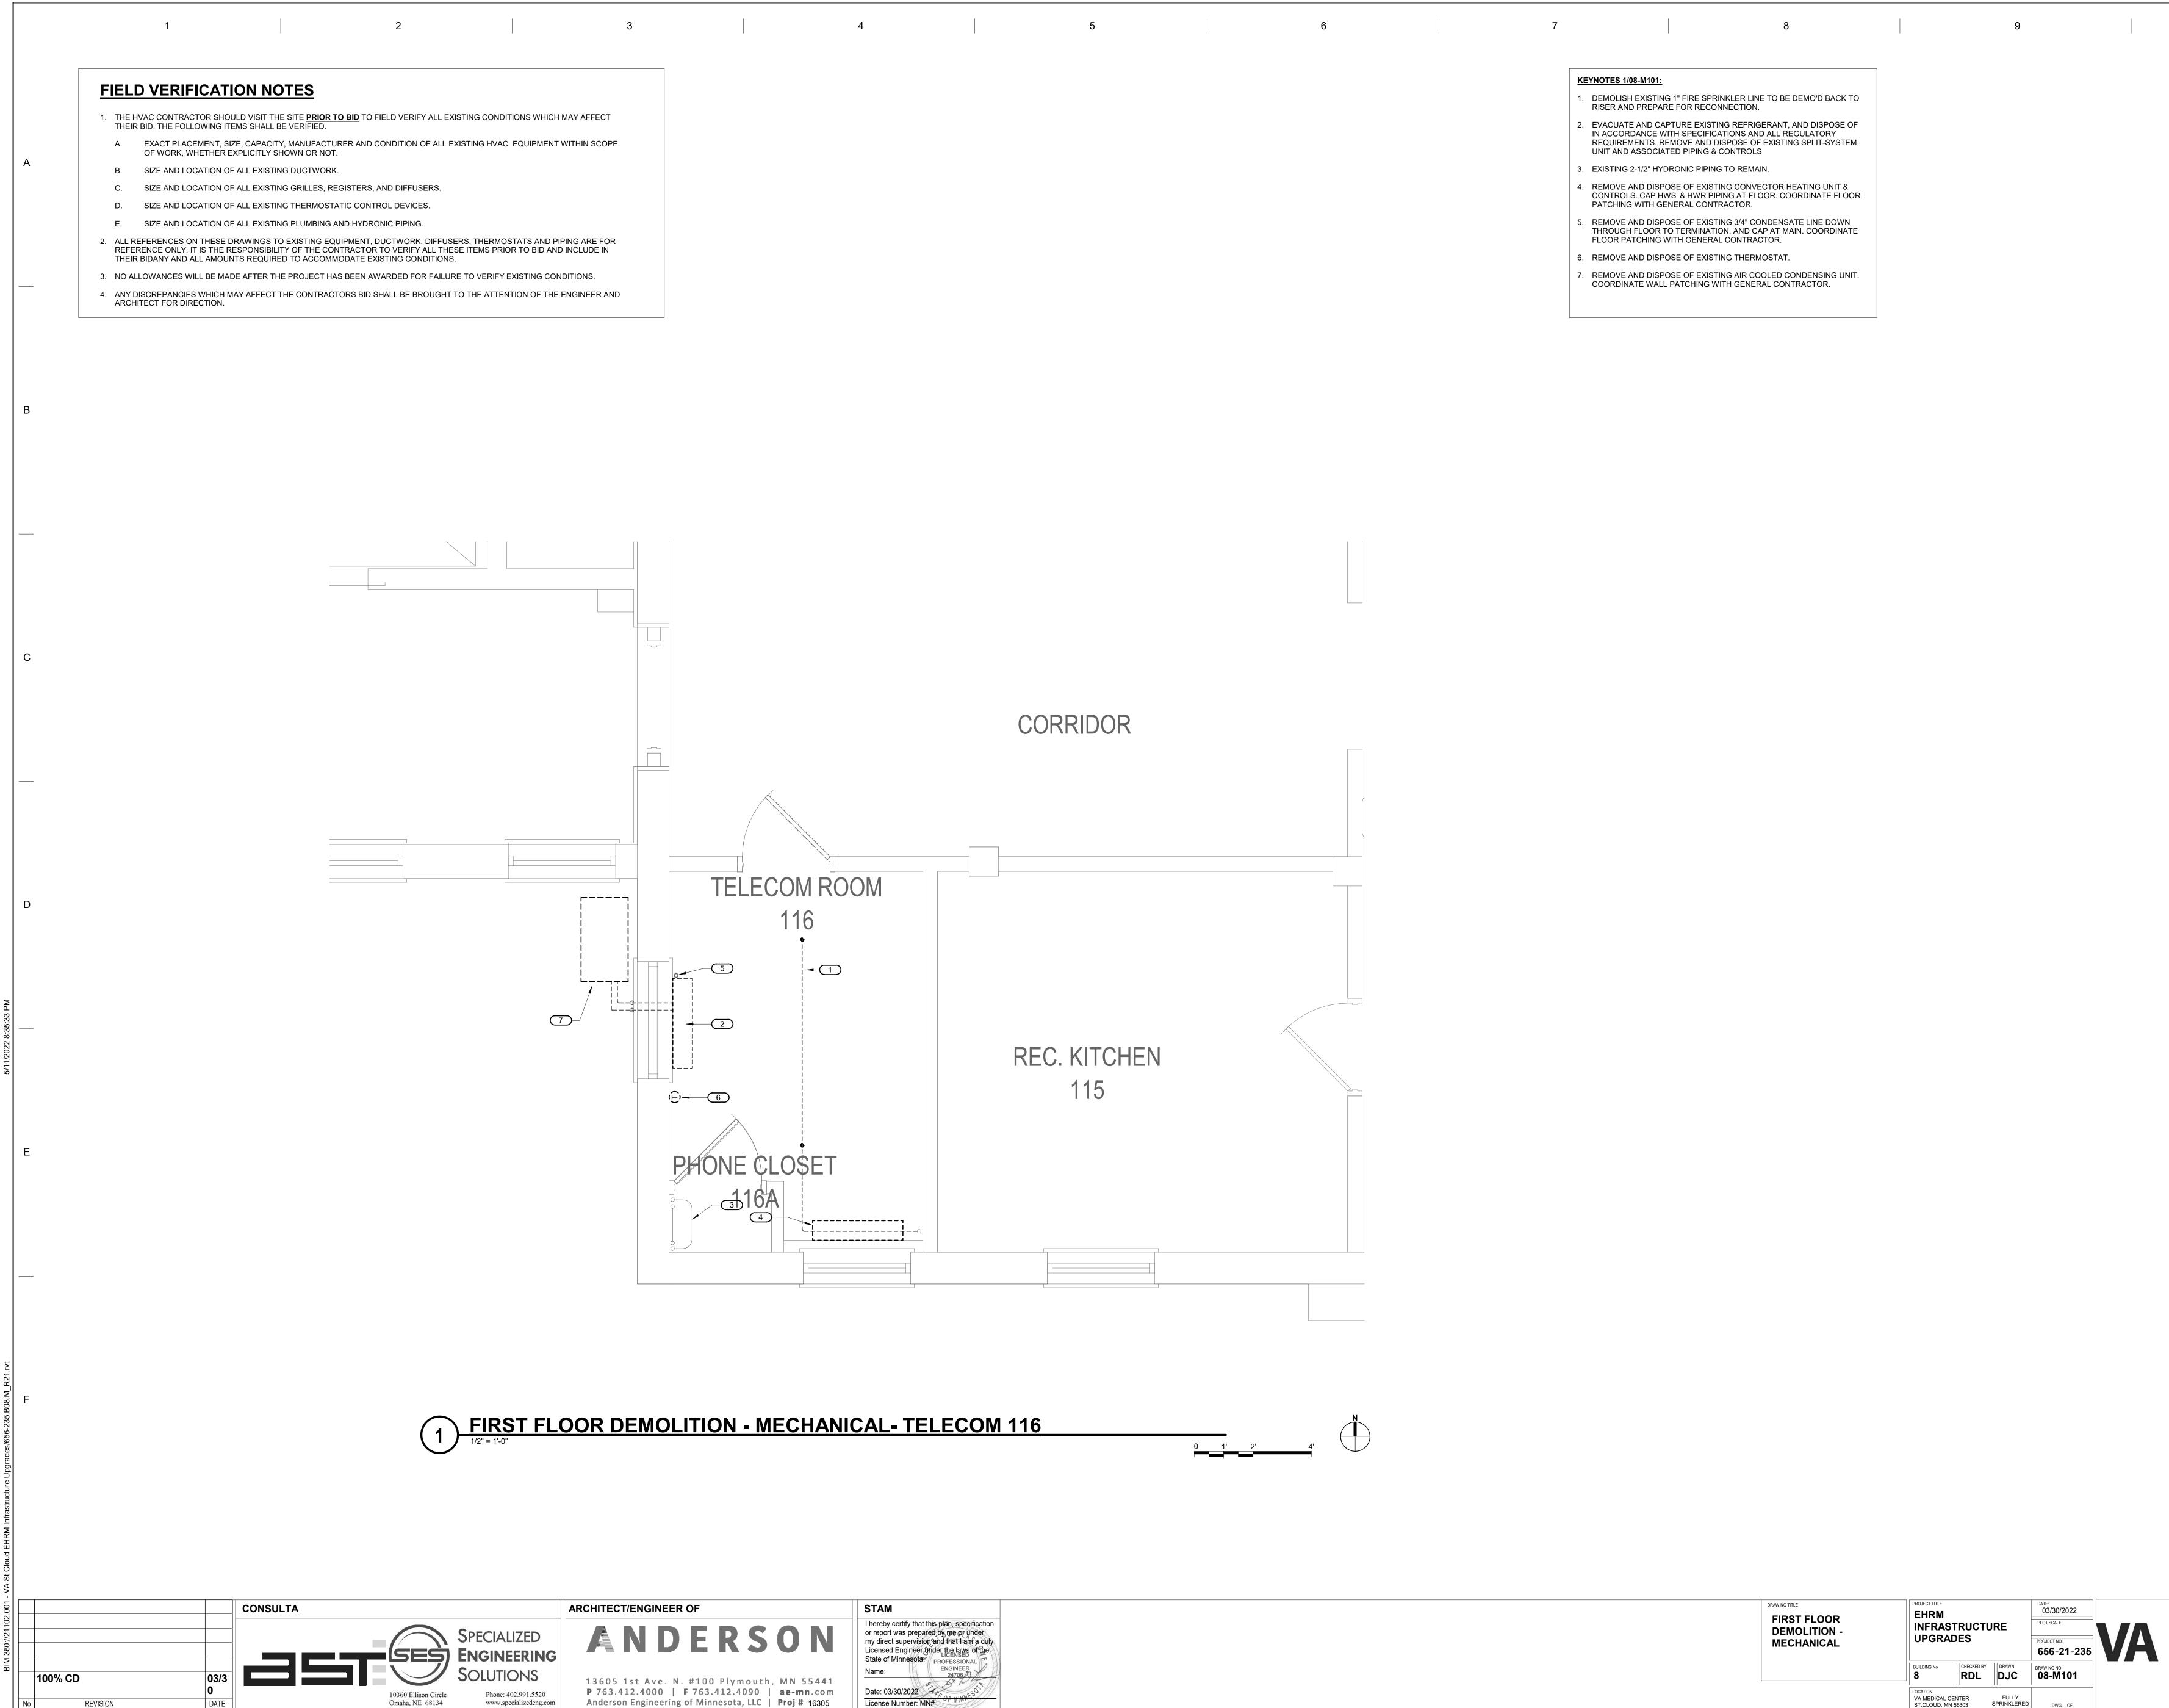


KE	YNOTES 1/08-M101:
1.	DEMOLISH EXISTING 1" FIRE SPRINKLER LINE TO BE DEMO'D BACK TO RISER AND PREPARE FOR RECONNECTION.
2.	EVACUATE AND CAPTURE EXISTING REFRIGERANT, AND DISPOSE OF IN ACCORDANCE WITH SPECIFICATIONS AND ALL REGULATORY REQUIREMENTS. REMOVE AND DISPOSE OF EXISTING SPLIT-SYSTEM UNIT AND ASSOCIATED PIPING & CONTROLS
3.	EXISTING 2-1/2" HYDRONIC PIPING TO REMAIN.
4.	REMOVE AND DISPOSE OF EXISTING CONVECTOR HEATING UNIT & CONTROLS. CAP HWS & HWR PIPING AT FLOOR. COORDINATE FLOOR PATCHING WITH GENERAL CONTRACTOR.
5.	REMOVE AND DISPOSE OF EXISTING 3/4" CONDENSATE LINE DOWN THROUGH FLOOR TO TERMINATION. AND CAP AT MAIN. COORDINATE FLOOR PATCHING WITH GENERAL CONTRACTOR.
6.	REMOVE AND DISPOSE OF EXISTING THERMOSTAT.

7. REMOVE AND DISPOSE OF EXISTING AIR COOLED CONDENSING UNIT. COORDINATE WALL PATCHING WITH GENERAL CONTRACTOR.


DRAWING TITLE FIRST FLOOR DEMOLITION - MECHANICAL	PROJECT TITLE EHRM INFRAS UPGRAI		DATE: 03/30/2022 PLOT SCALE PROJECT NO. 656-21-235	V	
	BUILDING No	CHECKED BY	DRAWN DJC	DRAWING NO. 08-M101	
	LOCATION VA MEDICAL CI ST.CLOUD, MN		FULLY SPRINKLERED	DWG. OF	



	1		2		3
Α	 THE HVAC CONTRACT THEIR BID. THE FOLL A. EXACT PLACE OF WORK, WH B. SIZE AND LOC C. SIZE AND LOC D. SIZE AND LOC E. SIZE AND LOC E. SIZE AND LOC 2. ALL REFERENCES ON REFERENCE ONLY. IT THEIR BIDANY AND A 3. NO ALLOWANCES WI 	OWING ITEMS SHALL BE VERIFIED. EMENT, SIZE, CAPACITY, MANUFACTU HETHER EXPLICITLY SHOWN OR NOT. CATION OF ALL EXISTING DUCTWORK. CATION OF ALL EXISTING GRILLES, RE CATION OF ALL EXISTING GRILLES, RE CATION OF ALL EXISTING THERMOSTA CATION OF ALL EXISTING THERMOSTA CATION OF ALL EXISTING PLUMBING A IN THESE DRAWINGS TO EXISTING EQU IS THE RESPONSIBILITY OF THE CON LL AMOUNTS REQUIRED TO ACCOMM LL BE MADE AFTER THE PROJECT HA	GISTERS, AND DIFFUSERS. ATIC CONTROL DEVICES. ND HYDRONIC PIPING. JIPMENT, DUCTWORK, DIFFUSERS, THI ITRACTOR TO VERIFY ALL THESE ITEM ODATE EXISTING CONDITIONS. S BEEN AWARDED FOR FAILURE TO VE	HVAC EQUIPMENT WITHIN SCOPI ERMOSTATS AND PIPING ARE FOR S PRIOR TO BID AND INCLUDE IN RIFY EXISTING CONDITIONS.	R
D	4. ANY DISCREPANCIES ARCHITECT FOR DIRE		ORS BID SHALL BE BROUGHT TO THE	ATTENTION OF THE ENGINEER AN	ID
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C					
C D					
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				<u>CU-8-1</u> 5	
M_R21.rvt					
// Infrastructure Upgrades/656-235.B08.N				1 FIF 1/2" =	RST FL 1'-0"
BIM 360://21102.001 - VA St Cloud EHRM Infrastructure Upgrades/656-235.B08.M_R21.rvt					CT/ENGINEE
No	CD REVISION	03/3 0 DATE	10360 Ellison Circle	UTIONS Phone: 402,991,5520 1360 P 763	5 1st Ave. N 3.412.4000 son Engineering

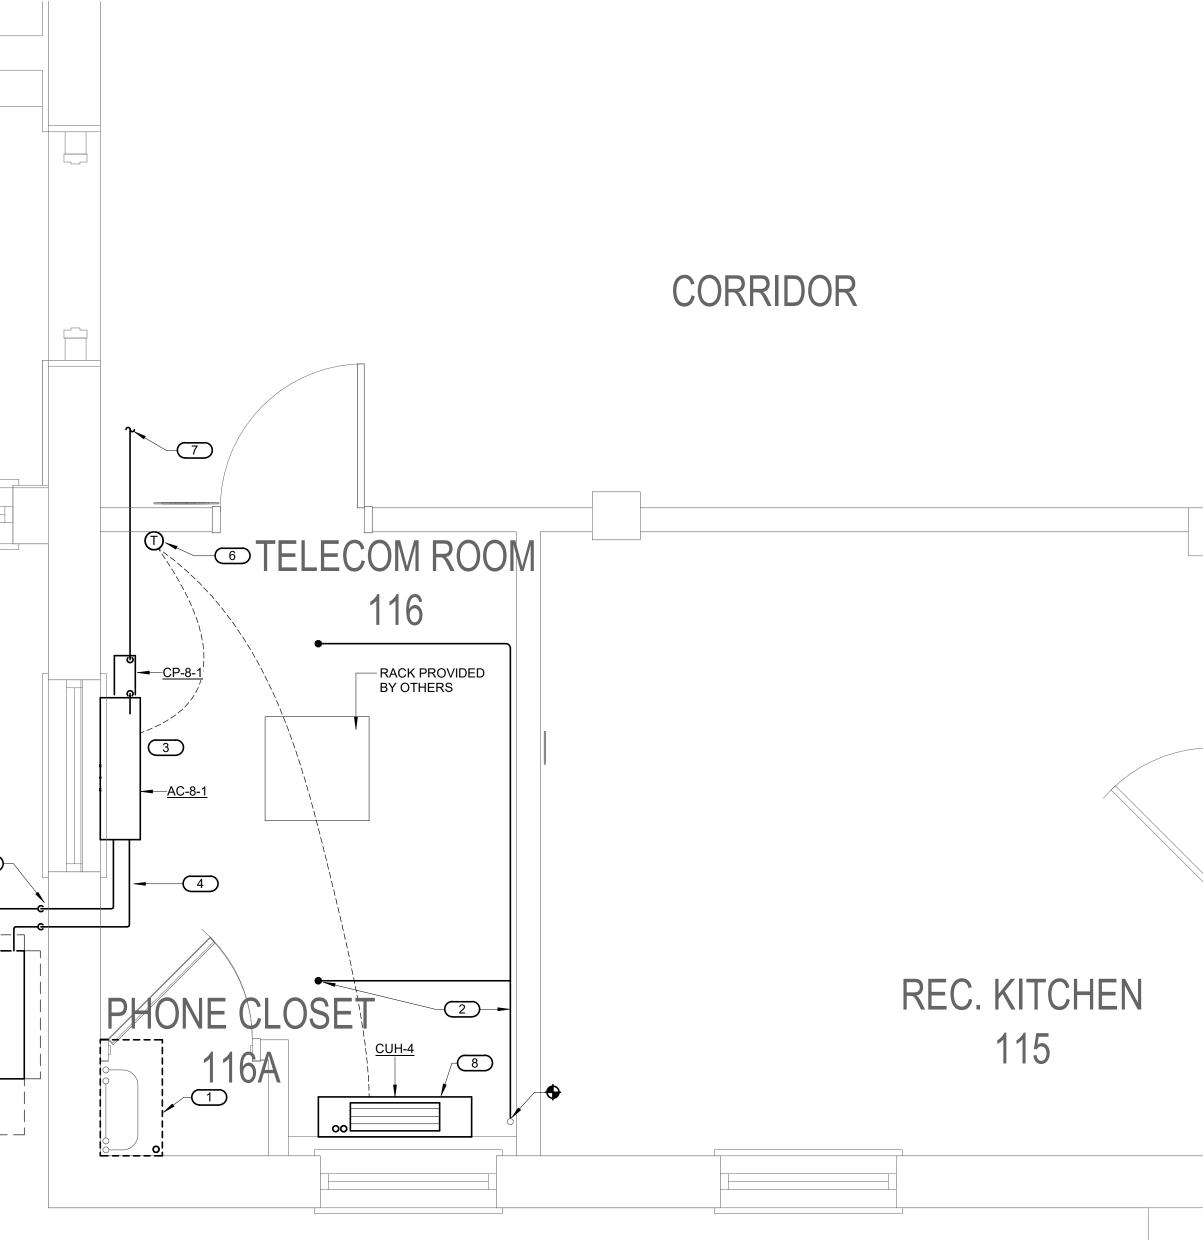


<u>OOR - MECHANICAL - TELECOM 116</u>

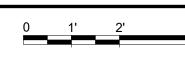



	4	5	6	7 8		9	1 0
				 KEYNOTES 1/08-M201: DRIP PAN EXISTING HYDRONIC PIPING. DROP 1" DRIP PAN DRAIN TO SERVICE ROOM AND ROUTE TO FLOOR DRAIN. FIELD VERIFY REQUIREMENTS PROVIDE 1" FIRE SPRINKLER LINE. PROVIDE NEW SPRINKLER HE/ PROVIDE NEW WALL-MOUNTED DUCTLESS COOLING UNIT AC-8-1 ROUTE NEW REFRIGERANT PIPING TO CU-8-1 UNIT. LOCATE CU-8 GRADE. PROVIDE NEW AIR COOLED CONDENSING UNIT. PROVIDE CONCR REFER TO REFRIGERANT PIPING DETAIL 1/0-GM400 AND PAD MOU DETAIL 3/0-GM401. PROVIDE NEW THERMOSTAT - WIRE COMMON WITH NEW AC UNIT ROUTE 1" PUMPED CONDENSATE DRAIN APPROXIMATELY 35 FEE AND DROP TO MOP SINK IN HAC ROOM 103. FIELD VERIFY REQUIF PROVIDE NEW CABINET UNIT HEATER CUH-4. RECONNECT TO EX HYDRONIC HEATING PIPING. REFERE TO 4/0-GM401 FOR WALL PENETRATION SEALING DETAIL 	ADS. B-1 ON RETE PAD. UNTING T AND CUH. ET NORTH REMENTS. KISTING		
				3. THE LIVE TO 4/0-GWI40T FOR WALL FENETRATION SEALING DETAIL	-		

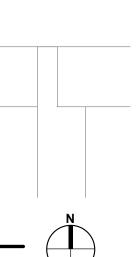

DRAWING TITLE FIRST FLOOR REMODEL - MECHANICAL	PROJECT TITLE EHRM INFRAST UPGRAE	_	JRE	DATE: 03/30/2022 PLOT SCALE PROJECT NO. 656-21-235	VA
	BUILDING No	CHECKED BY	DRAWN DJC	DRAWING NO. 08-M201	
	LOCATION VA MEDICAL CE ST.CLOUD, MN		FULLY SPRINKLERED	DWG. OF	

