BUILDING 5 - EHRM INFRASTRUCTURE UPGRADES


St. Cloud VA Health Care System Main Campus, St. Cloud, Minnesota



St. Cloud VA

Health Care System



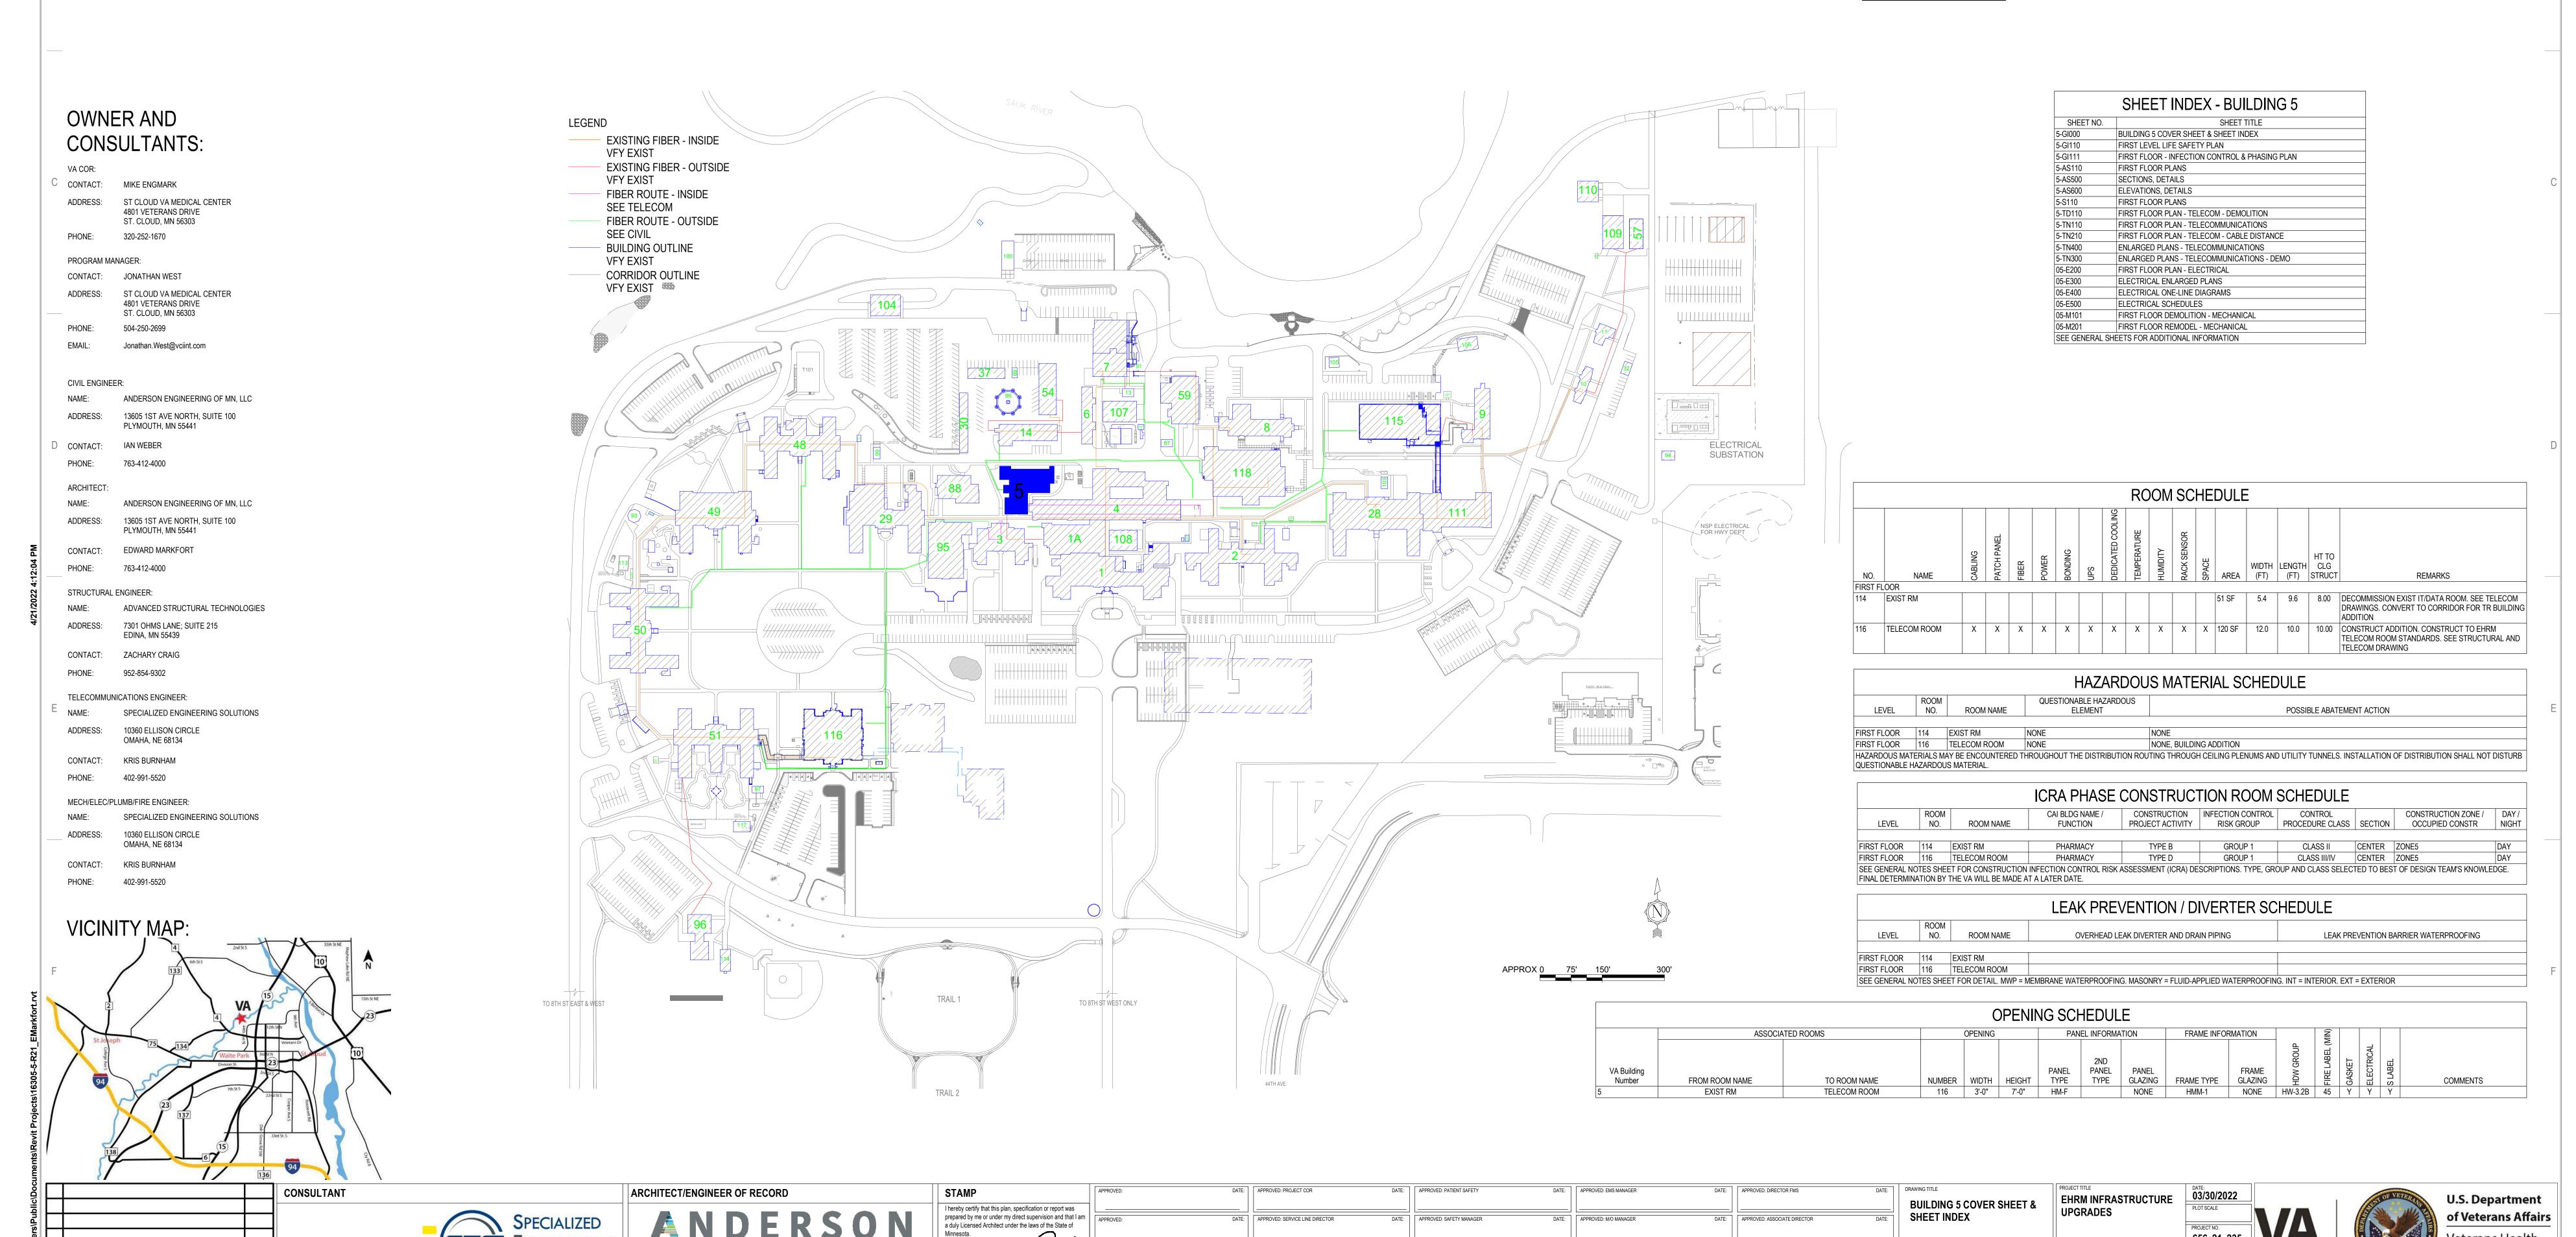

DATE: APPROVED: GEMS COORDINATOR

DATE: APPROVED: INFECTION CONTROL NURSE

13605 1st Ave. N. #100 Plymouth, MN 55441

P 763.412.4000 | F 763.412.4090 | ae-mn.com

Anderson Engineering of Minnesota, LLC | Proj # 16305

www.specializedeng.com

REVISION

DATE: APPROVED: CHIEF OF POLICE

DATE: APPROVED: OIT MANAGER

DATE: APPROVED: PROJECTS SECTION MANAGER


DATE: APPROVED: ASSISTANT CHIEF ENGINEER

DATE: APPROVED: NURSE EXECUTIV

DATE: APPROVED: CHIEF OF STAFF

DATE: APPROVED: MEDICAL CENTER DIRECTOR


VA MEDICAL CENTER

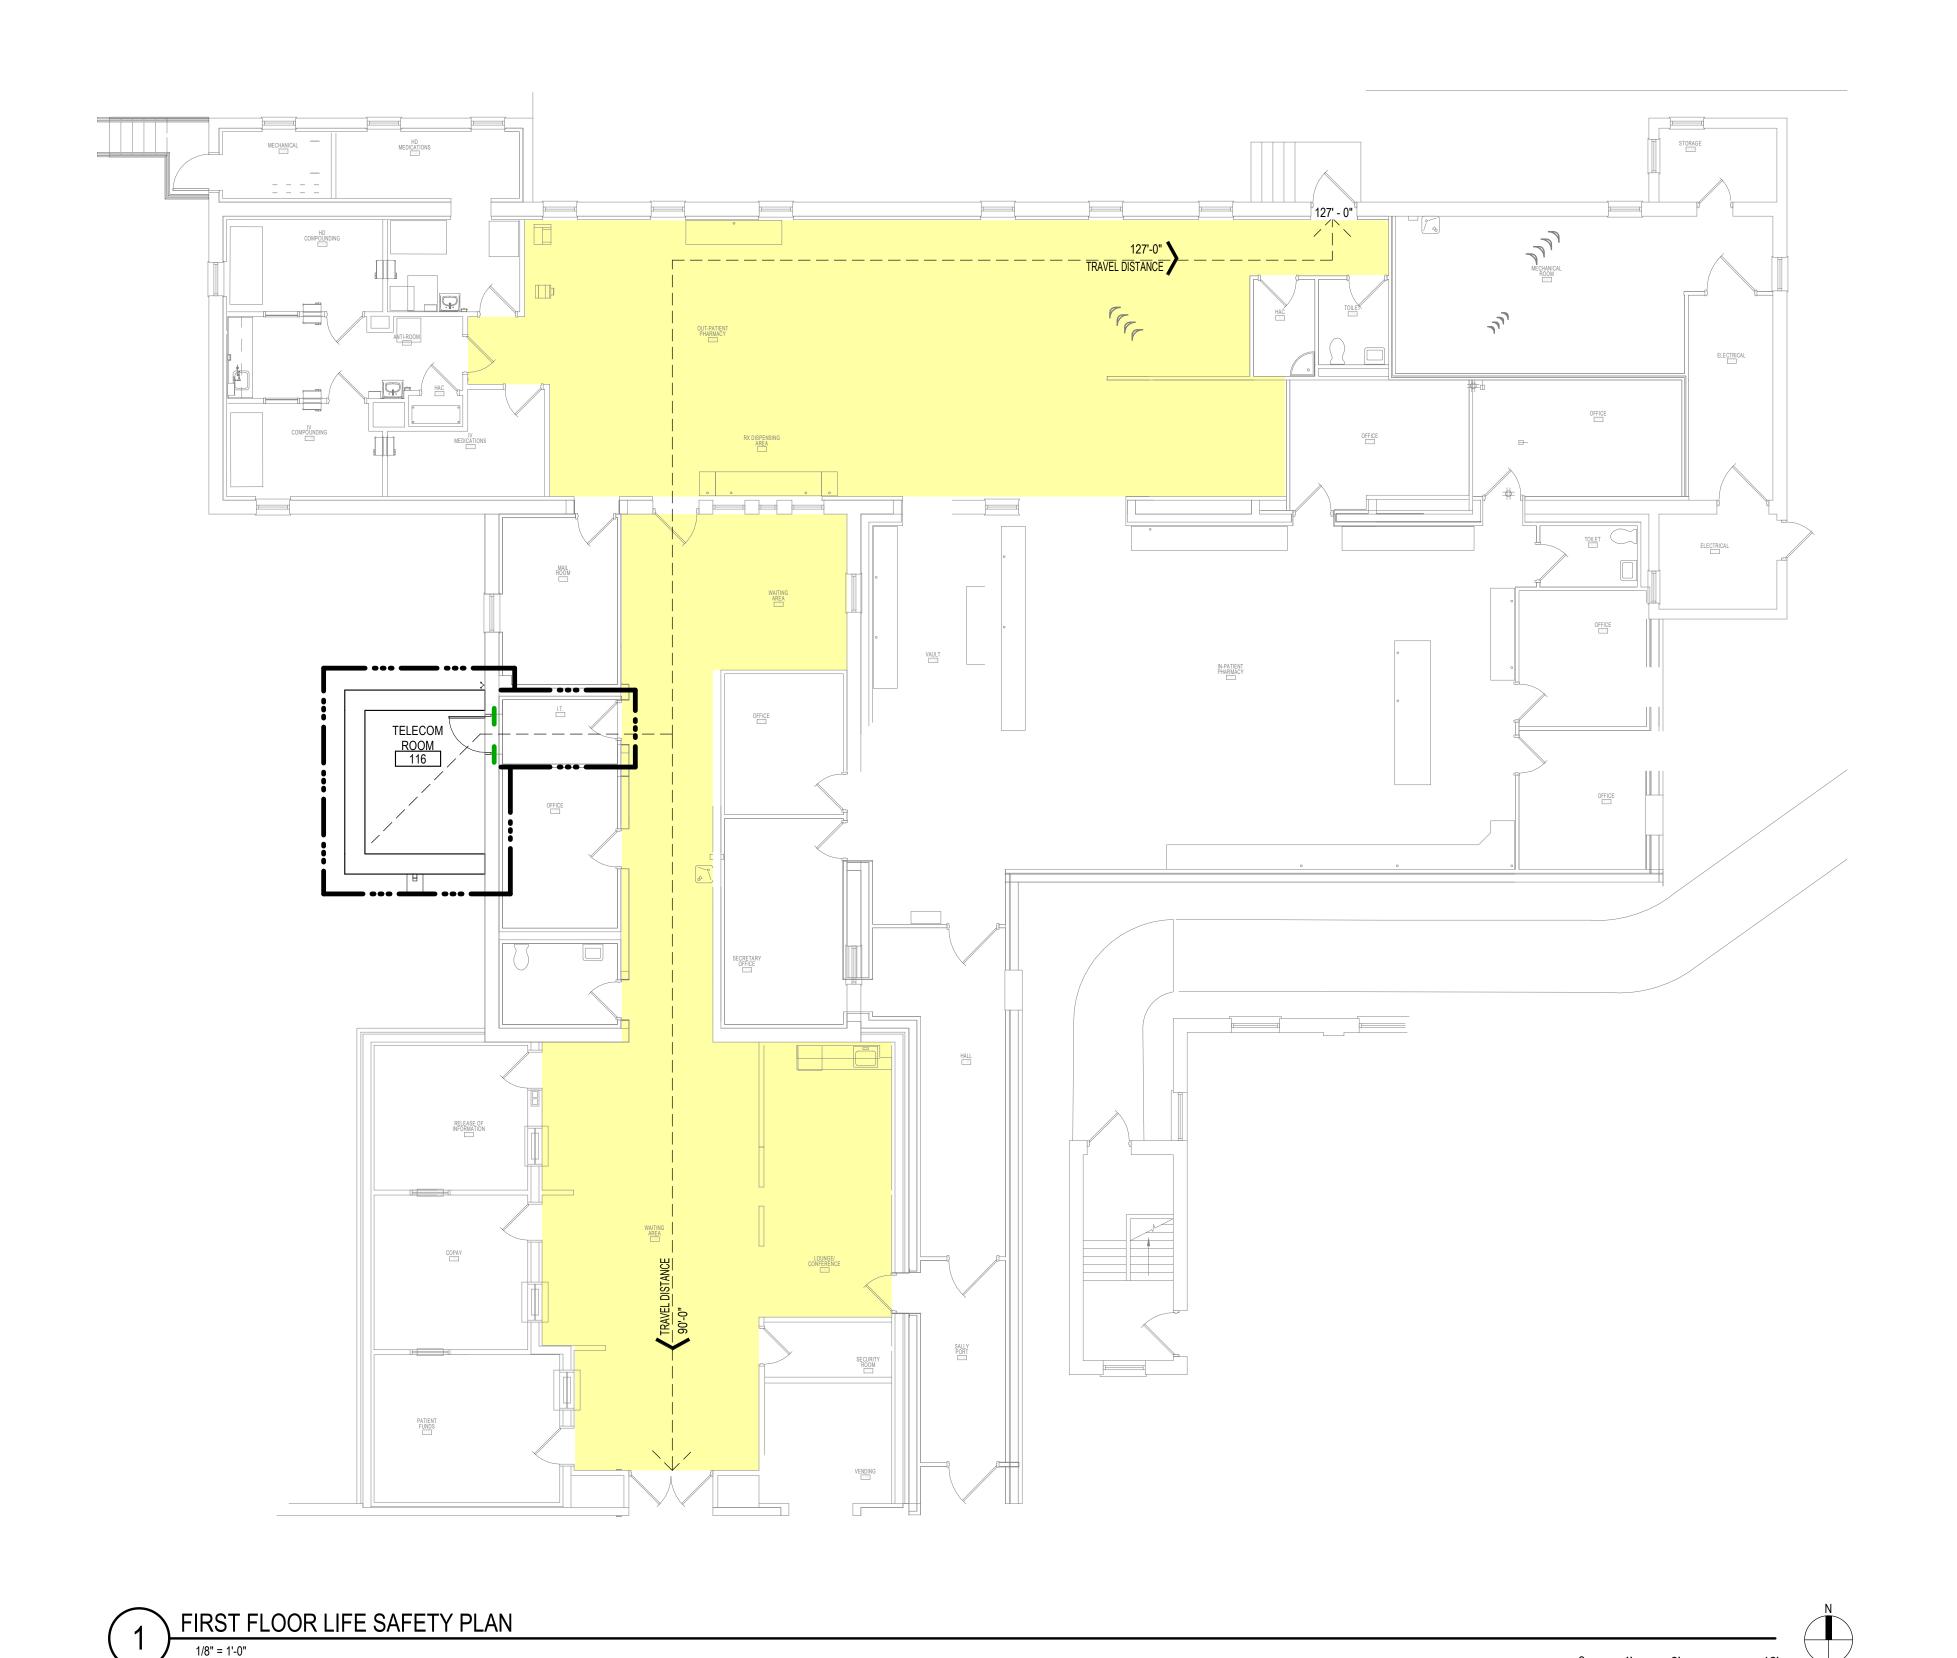

1 9 9

LIFE SAFETY SYMBOLS 1 HOUR FIRE & ASSEMBLY SMOKE BARRIER 1 HOUR FIRE 2 HOUR FIRE & 2 HOUR FIRE 3 HOUR FIRE & SMOKE BARRIER TRAVEL DISTANCE _ _ TRAVEL DISTANCE 3 HOUR FIRE EXIT DISCHARGE HORIZONTAL EXIT EXIT ACCESS FIRE EXTINGUISHER EXTINGUISHER CABINET LIMITS OF OCCUPANCY CONSTRUCTION SEPARATION HEALTH CARE COMPARTMENT BOUNDARY SHAFT
ADJACENT SYMBOLS SHOW PARTITION RATING AND DAMPER REQUIREMENTS HAZARDOUS USE
ADJACENT SYMBOLS SHOW PARTITION RATING. OPENINGS REQUIRE CLOSER & LATCH EXIT PASSAGEWAY RATE AS STAIR ALL OPENINGS TO BE RATED AS STAIR SHAFT CORRIDOR
WALLS TO LIMIT THE TRANSFER OF SMOKE ADJUNCT CORRIDOR or PSYCHIATRIC AREA or CONSTRUCTED WITH MIN. 4'-0" CLEAR WITH (PER CHAPTER 19) NOTE: NOT ALL SYMBOLS MY BE USED ON EACH PLAN


TYPE(S) OF CONSTRUCTION							
CONSTRUCTION TYPE	(IBC CHAPTER 6) IBC II-B						
CONSTRUCTION TYPE (EXISTING)	(IBC CHAPTER 6) IBC II-B						
AREA SEPARATIONS / FIRE WALLS	SEE LIFE SAFETY PLANS						

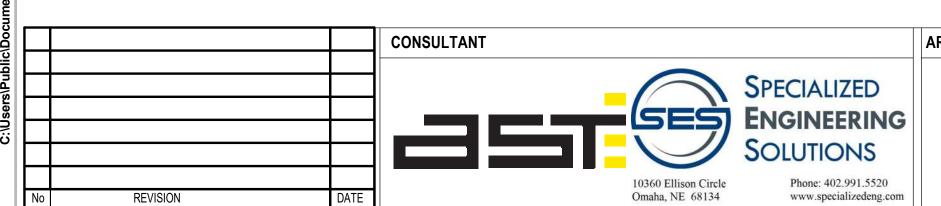

ARCHITECT/ENGINEER OF RECORD

AND ERSON

13605 1st Ave. N. #100 Plymouth, MN 55441
P 763.412.4000 | F 763.412.4090 | ae-mn.com
Anderson Engineering of Minnesota, LLC | Proj # 16305

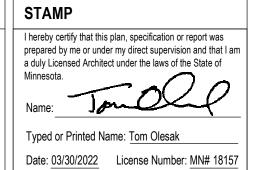



PROJECT TITLE


EHRM INFRASTRUCTURE
UPGRADES

DATE:
03/30/2022

PLOT SCALE

PROJECT NO.
656-21-235

VA MEDICAL CENTER ST.CLOUD, MN 56303

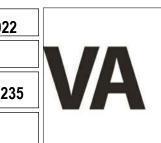



SEQUENCE OF EVENTS - ZONE 5

SELECTIVE UPGRADE TO EXISTING INFORMATION TECHNOLOGY TO ENABLE BUILDING TOTAL UPGRADE PROCESS
 INITIAL ICRA AND ILSM
 WITH THE EXCEPTION OF POOR 146 CONSTRUCT POOMS AS DIRECTED. SEE

 WITH THE EXCEPTION OF DOOR 116, CONSTRUCT ROOMS AS DIRECTED, SEE ASSOCIATED DRAWINGS FROM STRUCTURAL, ELECTRICAL, MECHANICAL, TELECOM, AND FINISHES
 PROVIDE TEMPORARY DOOR AT SOUTH WALL OF ADDITION

SELECTIVE DEMOLITION TO ENABLE UPGRADES
INSTALL COMMON CABLE INFRASTRUCTURE
CONSTRUCT COMMUNICATION BACKBONE

 1
 5

 2
 8

 INSTALL CAT 6A
 INSTALL TEMPORARY PROTECTION AND CONDUCT SELECTIVE DEMOLITION TO CONSTRUCT DOOR OPENING AND DOOR 116 ON EAST WALL OF ROOM.

DEMOLISH TEMPORARY DOOR, TOOTH IN WALL, AND COMPLETE EXTERIOR BUILDING FINISHES
 DECOMMISSION EXISTING NON-EHRM INFORMATION TECHNOLOGY ROOMS

SUGGESTED SEQUENCE. FINAL INSTALLATION SEQUENCE TO BE MADE AT A LATER DATE.


ROOM ICRA SCHEDULE							
LEVEL	ROOM NO.	ROOM NAME	CAI BLDG NAME / FUNCTION	CONSTRUCTION PROJECT ACTIVITY	INFECTION CONTROL RISK GROUP	CONTROL PROCEDURE CLASS	
FIRST FLOOR	114	EXIST RM	PHARMACY	TYPE B	GROUP 1	CLASS II	
FIRST FLOOR	116	TELECOM ROOM	PHARMACY	TYPE D	GROUP 1	CLASS III/IV	
SEE GENERAL NOTES SHEET FOR CONSTRUCTION INFECTION CONTROL RISK ASSESSMENT (ICRA) DESCRIPTIONS. TYPE, GROUP AND CLASS SELECTED TO BEST OF DESIGN TEAM'S KNOWLEDGE. FINAL DETERMINATION BY THE VA WILL BE MADE AT A LATER DATE.							

INFECTION CONTROL RISK ASSESSMENT (ICRA) LEGEND

LIMITS OF CONSTRUCTION

1 HOUR FIRE RATED ICRA / CONSTRUCTION BARRIER LOCATION, AND DOOR, WHERE SHOWN

TEMPORARY NON-RATED (PLASTIC SHEETING) CONSTRUCTION BARRIER LOCATION, WHERE APPROVED BY THE VA FOR USE IN RISK TYPE B. UPGRADE TO 1 HOUR RATED PARTITION WHEN DIRECTED BY THE VA

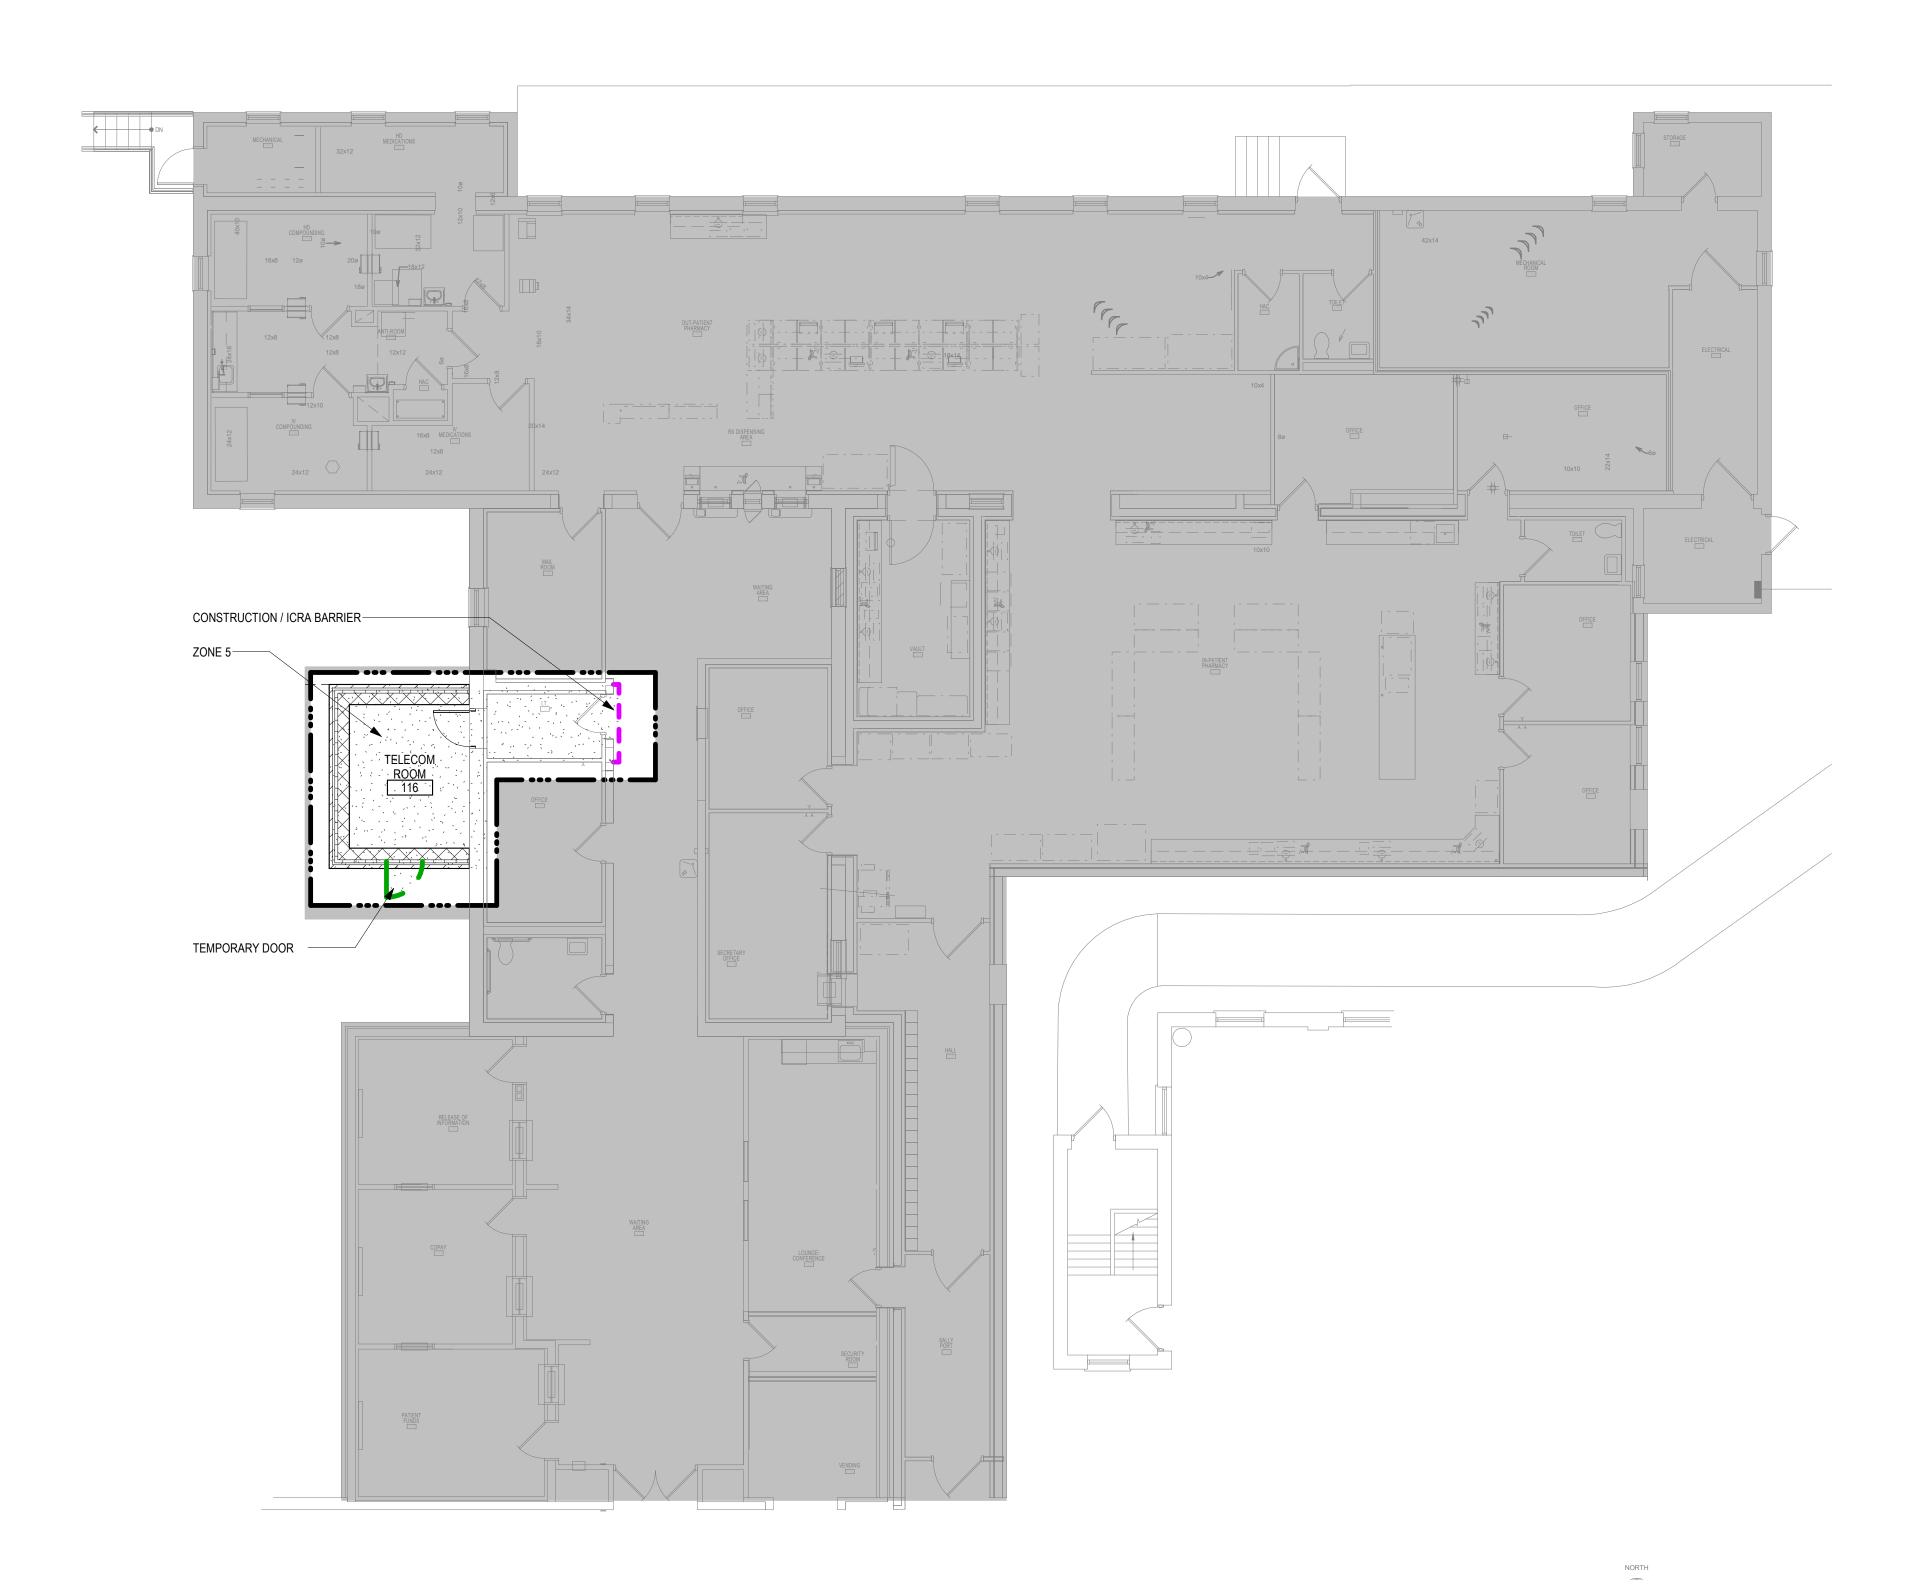

1 FIRST FLOOR - CONST BARRIER PLAN

CONSULTANT

SPECIALIZED
ENGINEERING
SOLUTIONS

10360 Ellison Circle
Omaha, NE 68134


Phone: 402.991.5520
www.specializedeng.com

ARCHITECT/ENGINEER OF RECORD

ARCHITECT/ENGINEER OF RECORD

13605 1st Ave. N. #100 Plymouth, MN 55441
P 763.412.4000 | F 763.412.4090 | ae-mn.com

Anderson Engineering of Minnesota, LLC | Proj # 16305

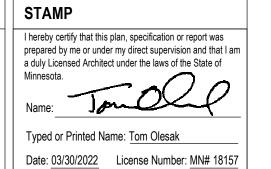


FIRST FLOOR - INFECTION CONTROL & PHASING PLAN

EHRM INFRASTRUCTURE UPGRADES

VA MEDICAL CENTER ST.CLOUD, MN 56303 FULLY SPRINKLERED 2022 1-235



FIRST FI CONTRO

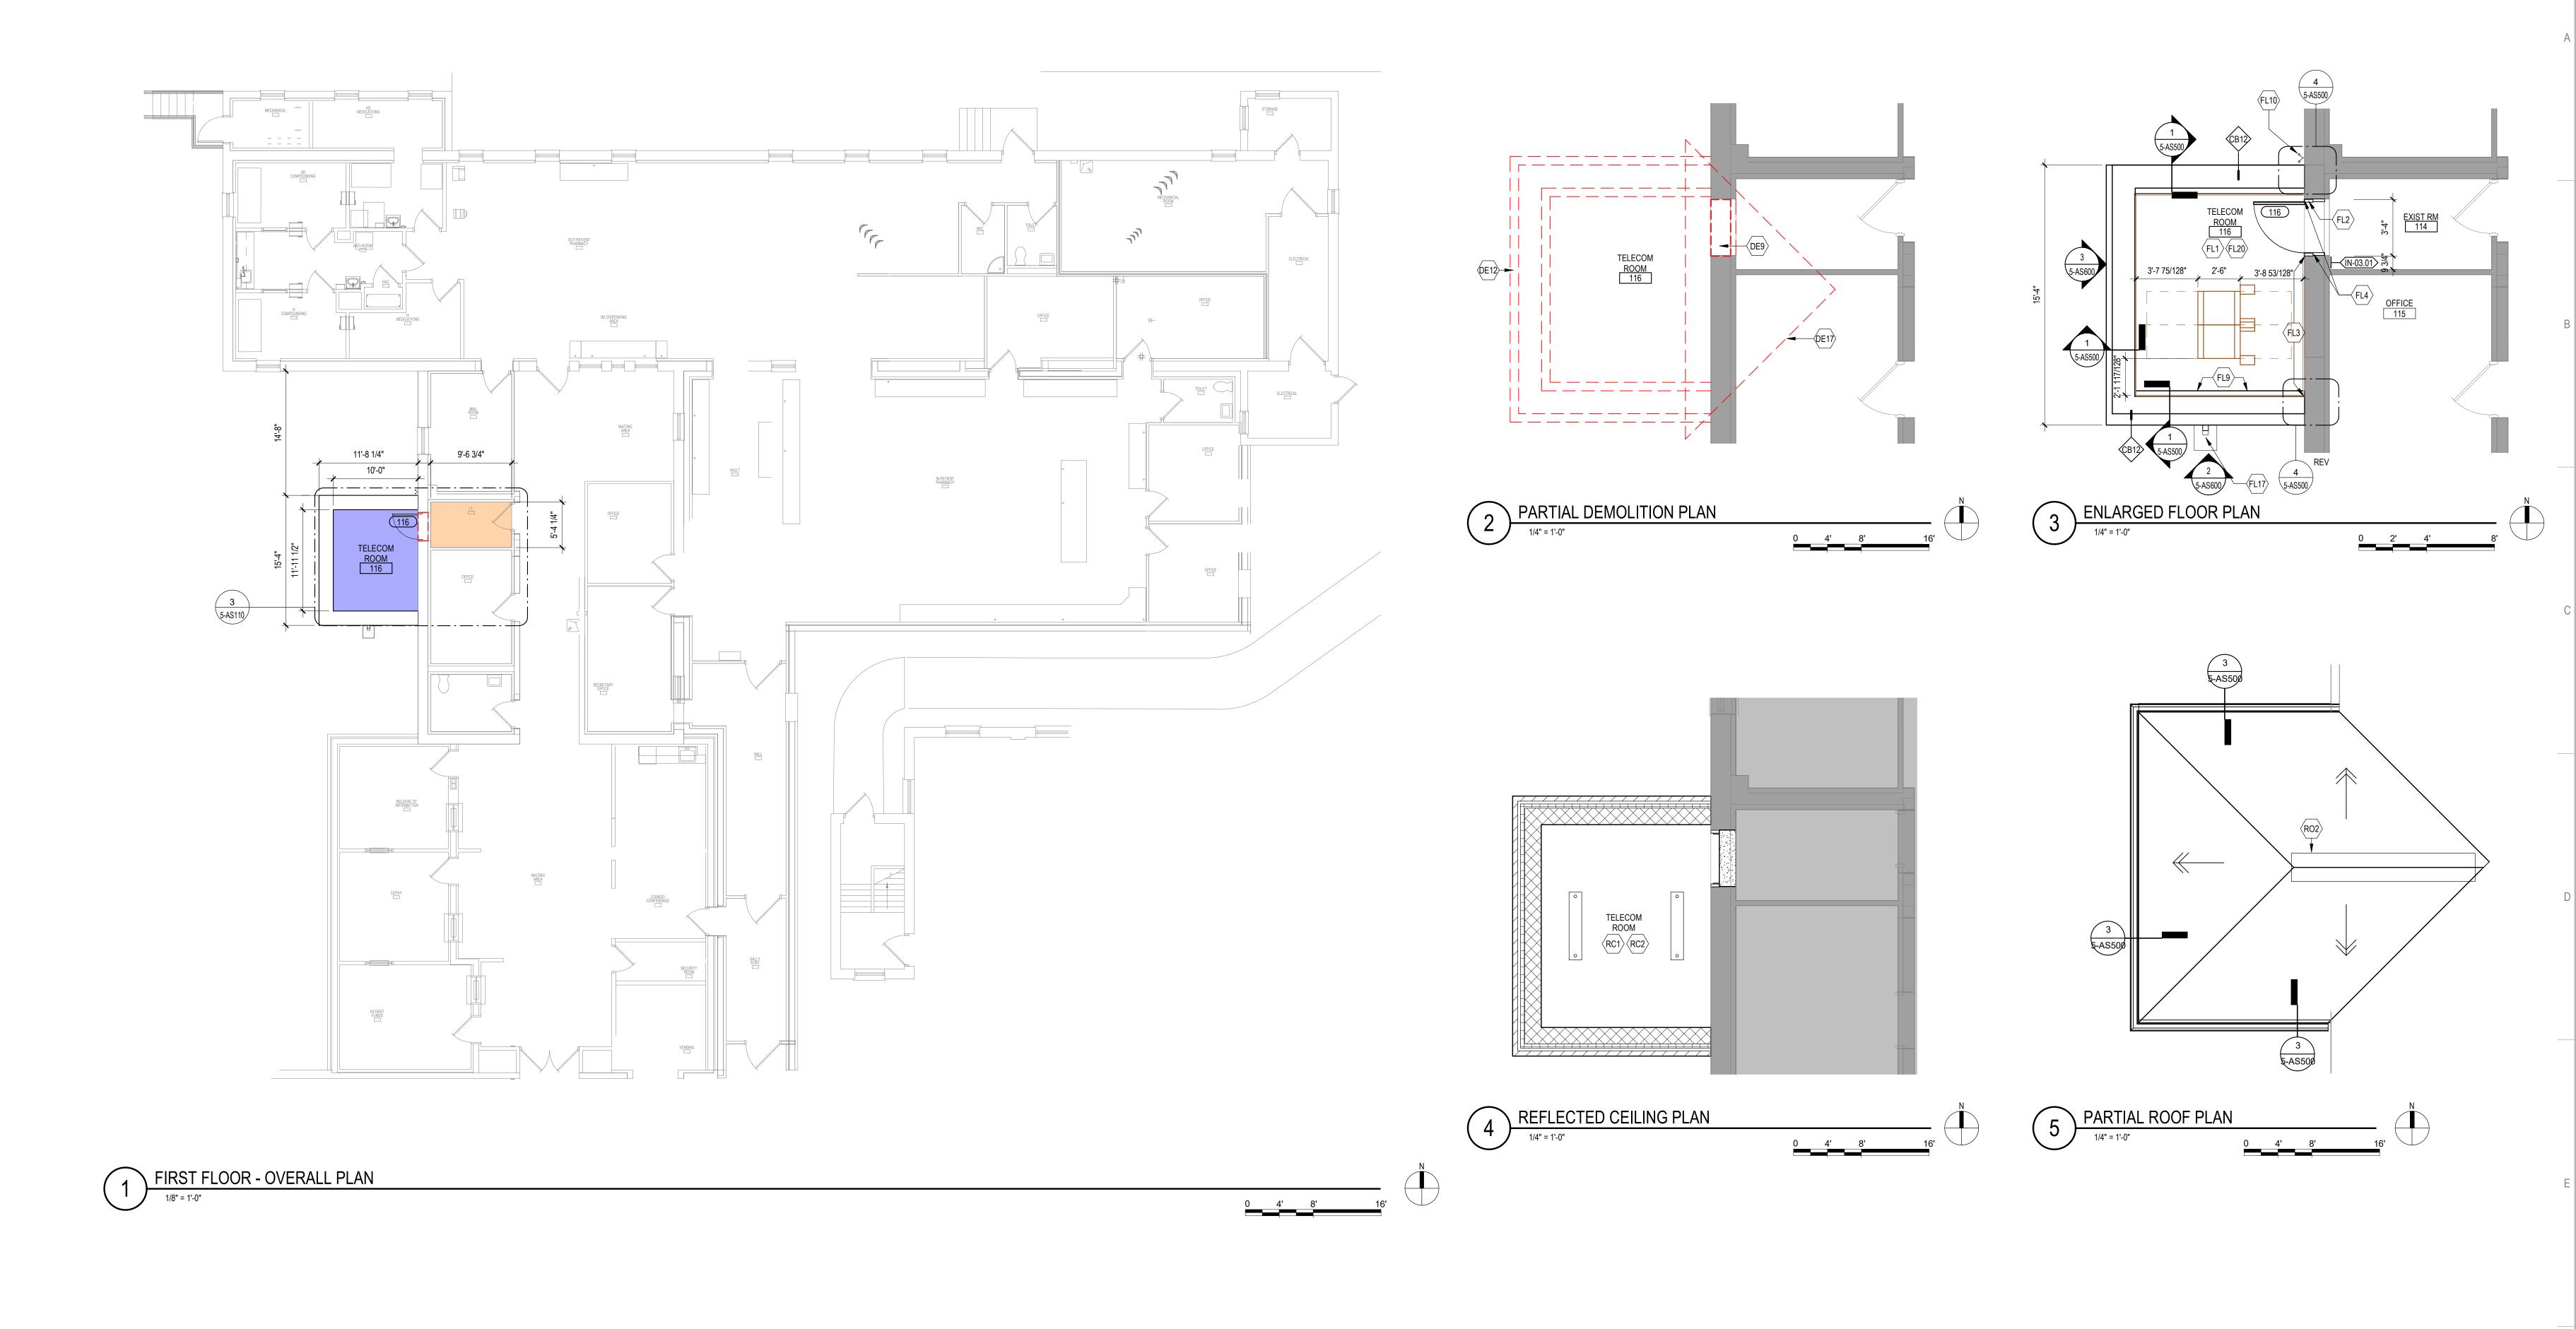

 1
 2

 3
 7

_DEMOLITION PLAN KEYED NOTES

- REMOVE AND SALVAGE EXISTING MASORNY WALL ASSEMBLY AS REQUIRED FOR NEW DOOR INSTALLATION.
- REFER TO STRUCTURE FOR EXCAVATION EXTENTS OF FOOTING AND FOUNDATIONS.
- PARTIALLY REMOVE SHINGLES, GUTTER, ALL ASSOCIATED SHEATHING AND ROOF FRAMING ETC. AS REQUIRED FOR INSTALLATION OF NEW

NOTE: NOT ALL KEYED NOTES MAY BE USED ON EACH PLAN

_FLOOR PLAN KEYED NOTES

- 4' BY 8' AC GRADE 3/4" TRADE SIZE PLYWOOD BACKBOARD PAINTED HIGH-GLOSS WHITE WITH TWO COATS OF FIRE RESISTANT PAINT FOR
- SERVICE PROVIDER / SECURITY / VIDEO / ET CETERA

FL2 DOOR, SIZE AS SCHEDULED, FIRE RESISTANT AS SCHEDULED

- UPGRADE PARTITION TO 1 HOUR FIRE AND SMOKE BARRIER. PROVIDE TESTED HEAD OF PARTITION ASSEMBLY WITH MATERIALS THAT RESIST THE PASSAGE OF SMOKE. SEAL JOINT AT HEAD AND ALL PENETRATIONS WITH FIRE CAULK.
- PATCH TO MATCH FINISHES DISTURBED BY CONSTRUCTION TO MATCH EXISTING; FLOOR AND WALL. CONTRACTOR TO PROVIDE LABOR AND
- MATERIAL. FL9 AT REMOVED TEMPORARY DOOR, TOOTH IN BLOCK.
- FL10 EXIST BUILDING FIRE DEPARTMENT CONNECTION, MODIFY TO MAINTAIN
- FL17 PREFINISHED METAL DOWNSPOUT AND PRECAST CONCRETE SPLASH

FL20 TELECOM EQUIPMENT, SEE TELECOM DRAWINGS.

NOTE: NOT ALL KEYED NOTES MAY BE USED ON EACH PLAN

_REFLECTED CEILING PLAN KEYED NOTES

- LED LIGHTING, SEE ELECTRICAL. IN FRONT OF AND BEHIND CABINET ROWS PROVIDE 500 LUMENS IN HORIZONTAL AND 200 LUMENS IN THE VERTICAL AT 3 FT AFF. OPERATED BY MOTION SENSOR PER CABINET ROW OR SECTION.
- RC2 OPEN TO STRUCTURAL FLOOR ABOVE

NOTE: NOT ALL KEYED NOTES MAY BE USED ON EACH PLAN

_ROOF PLAN KEYED NOTES

RO2 INSTALL RIDGE ROOF VENT TO THE EXTENTS SHOWN NOTE: NOT ALL KEYED NOTES MAY BE USED ON EACH PLAN

_SHEET NOTES

- SEE GENERAL NOTES AND CAMPUS DRAWINGS FOR GENERAL INFORMATION, LIFE SAFETY, ICRA, AND PHASING
- ALL EXISTING CONDITIONS MUST BE FIELD VERIFIED BY THE CONTRACTOR PRIOR TO DEMOLITION OR CONSTRUCTION. EXISTING CONDITIONS THAT DIFFER FROM THOSE SHOWN MUST BE BROUGHT TO THE ATTENTION OF THE C.O.R. TO INFORM THE ARCHITECTS AND ENGINEERS.
- THE INFORMATION SHOWN ON THE DRAWINGS IS BASED ON DRAWINGS AND PHOTOGRAPHS PROVIDED BY THE C.O.R. COMBINED WITH OBSERVATIONS AND SURVEYED DATA FROM THE ARCHITECTS AND ENGINEERS.
- SEE CIVIL, STRUCTURAL, TELECOM, ELECTRICAL, MECHANICAL, AND PLUMBING DRAWINGS AND SPECIFICATIONS FOR ADDITIONAL DEMOLITION AND CONSTRUCTION REQUIREMENTS.
- PORTABLE FIRE EXTINGUISHERS (CO2 OR HALOGENATED TYPE AS DETERMINED BY VA) WITH WALL MOUNT BRACKET AND CODE REQUIRED SIGNAGE SHALL BE PROVIDED BY THE CONTRACTORWITHIN TELECOM

CONSULTANT Phone: 402.991.5520 DATE Omaha, NE 68134 www.specializedeng.com REVISION

ARCHITECT/ENGINEER OF RECORD 13605 1st Ave. N. #100 Plymouth, MN 55441

P 763.412.4000 | F 763.412.4090 | ae-mn.com

Anderson Engineering of Minnesota, LLC | Proj # 16305

STAMP I hereby certify that this plan, specification or report was prepared by me or under my direct supervision and that I am a duly Licensed Architect under the laws of the State of Typed or Printed Name: Tom Olesak Date: <u>03/30/2022</u> License Number: <u>MN# 18157</u>


FIRST FLOOR PLANS


EHRM INFRASTRUCTURE


03/30/2022



BUILDING No VA MEDICAL CENTER SPRINKLERED

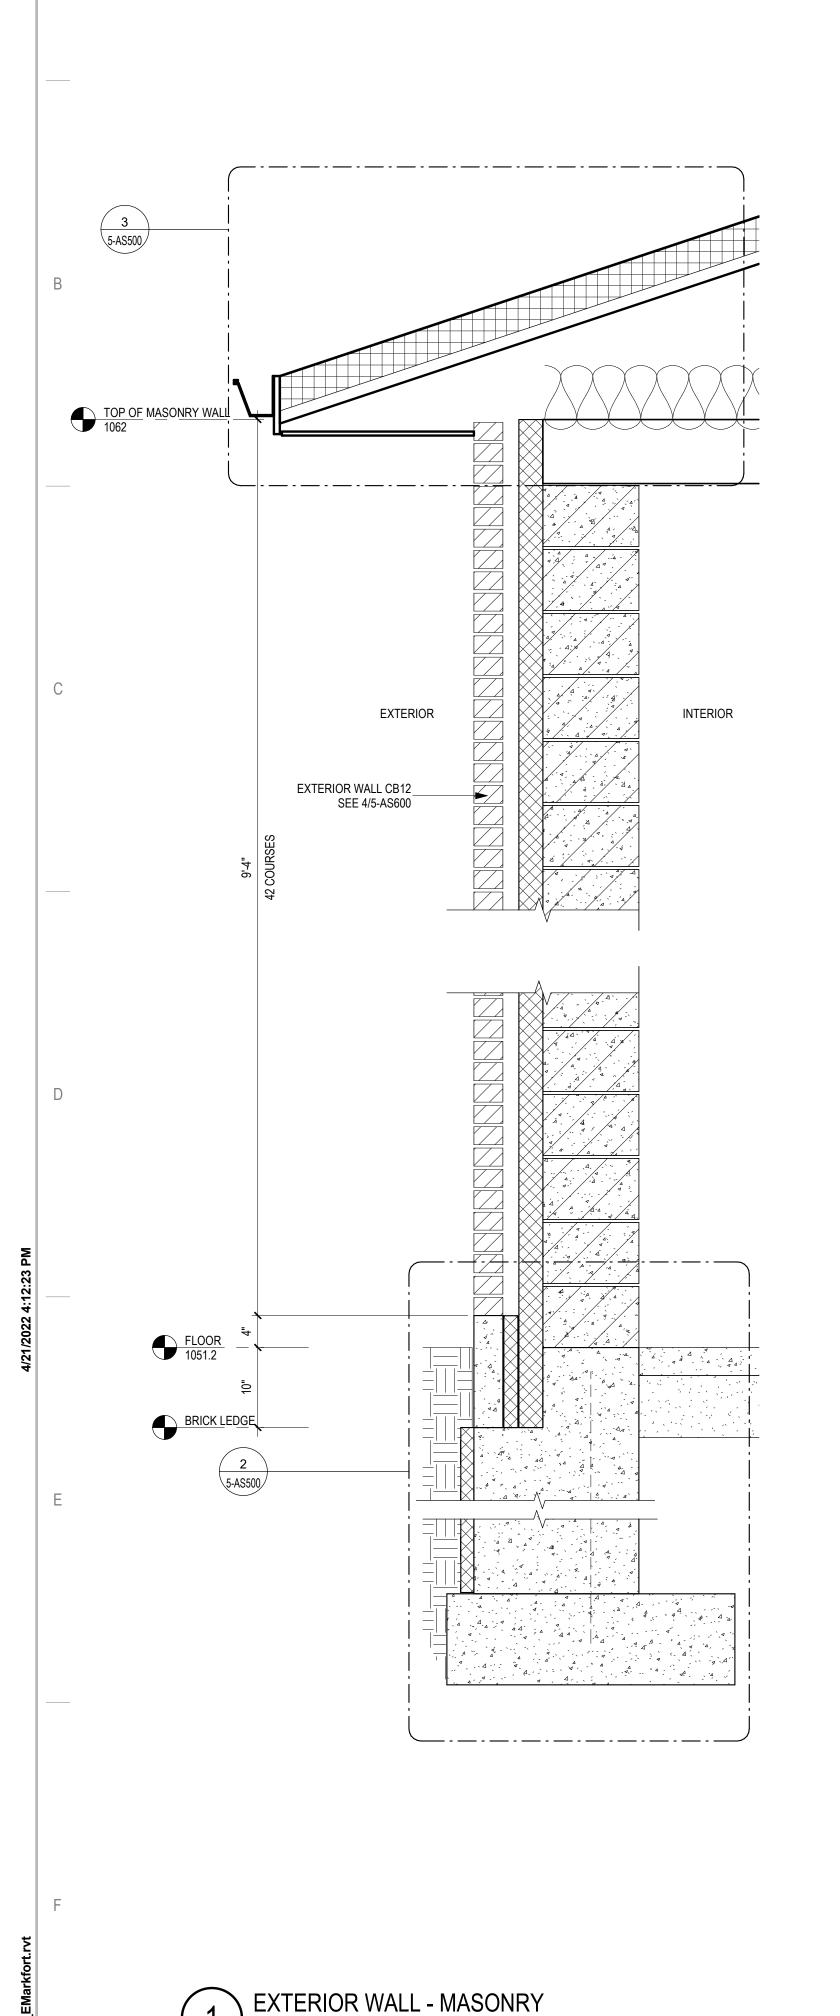

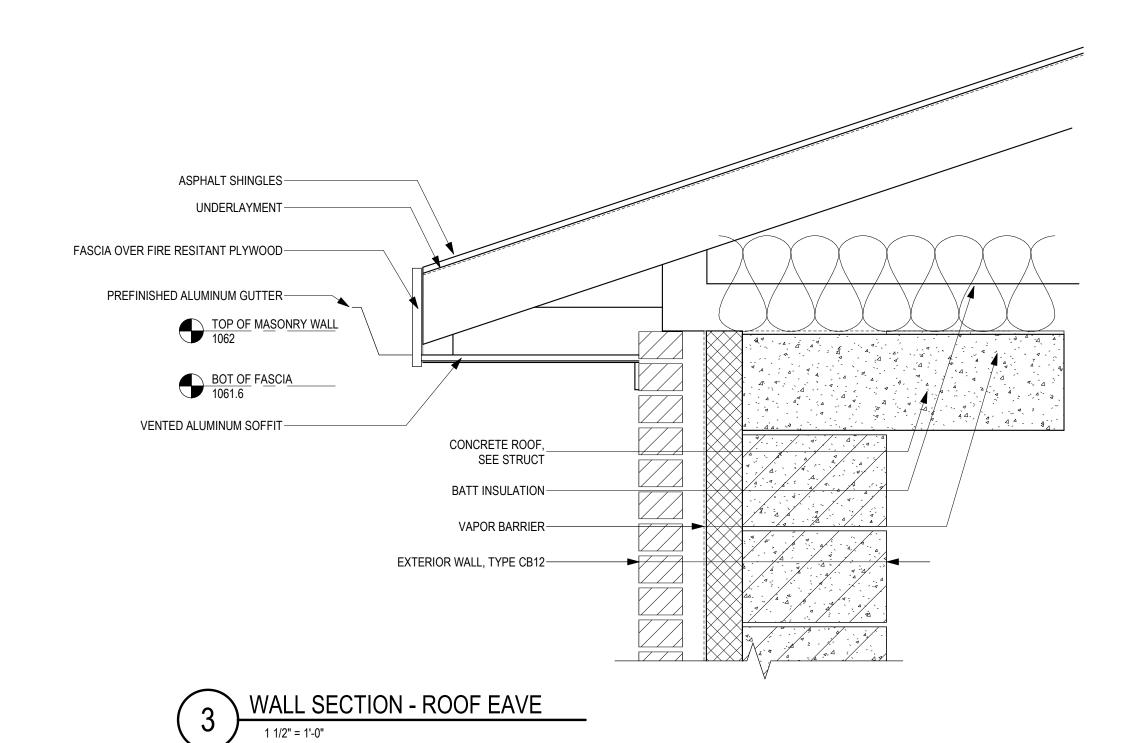


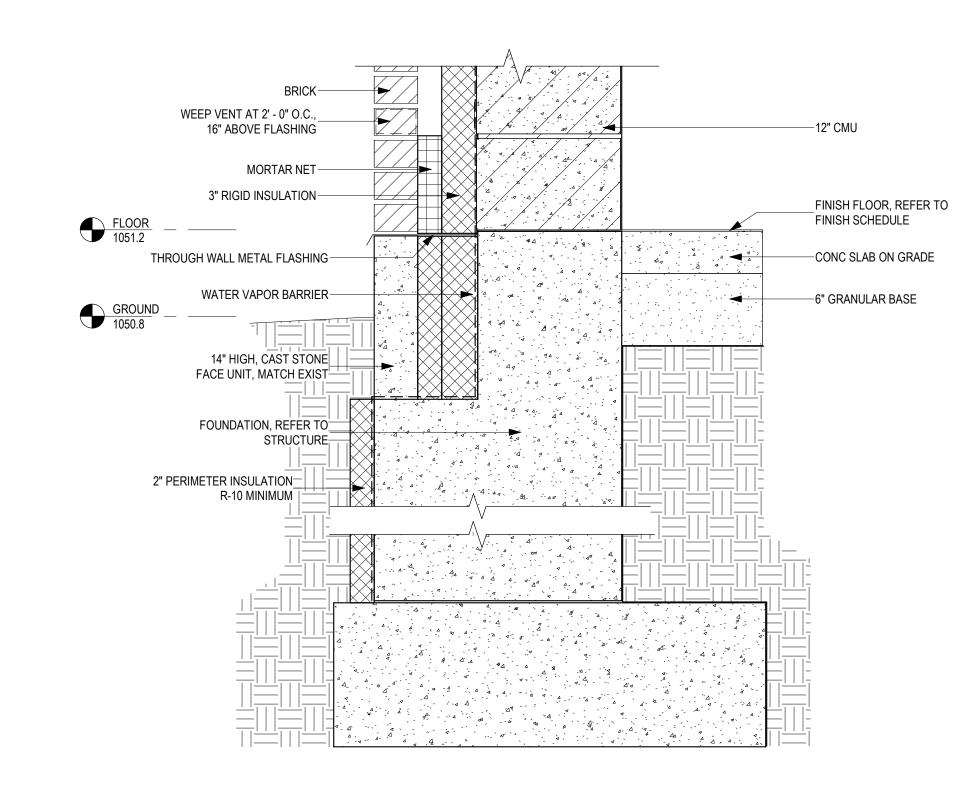


 1
 5

 2
 6




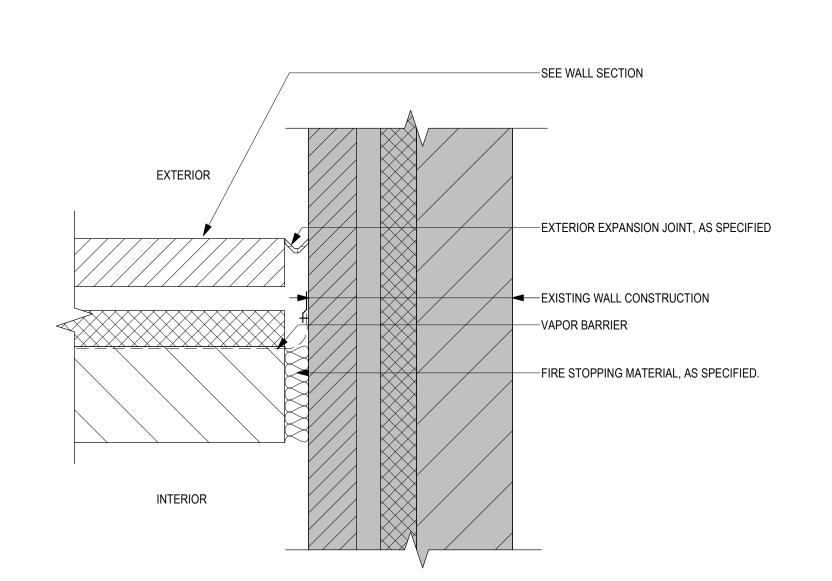

PLAN SECTION - FIRESTOPPING AT NEW WALL

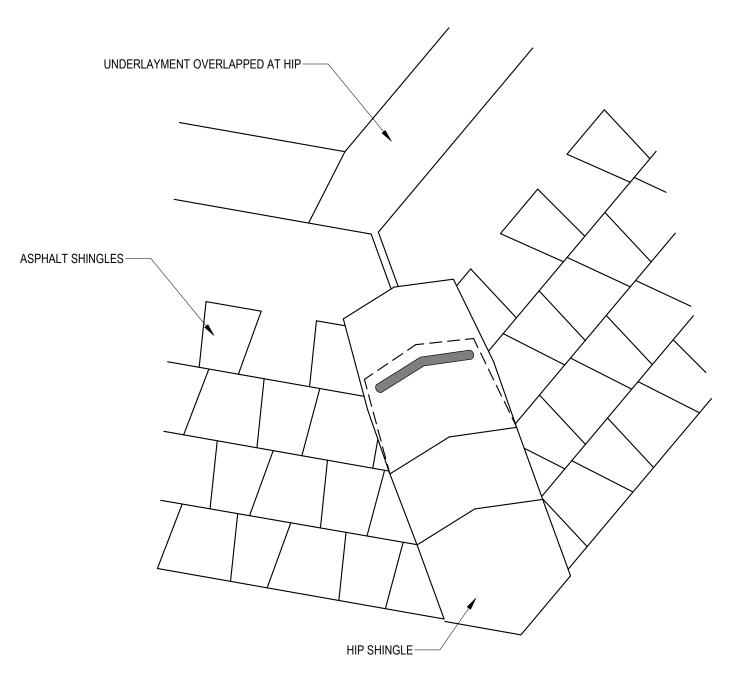


5) ROOF HIP DETAIL

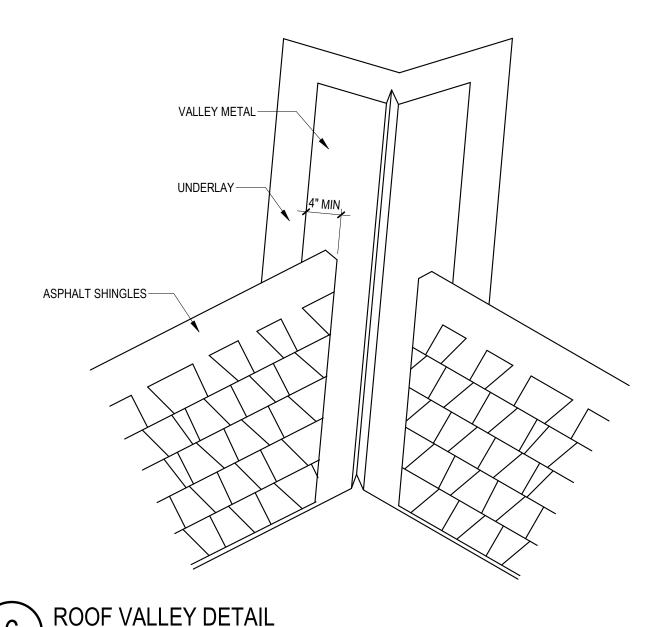



ROOF VALLEY DETAIL

1 1/2" = 1'-0"

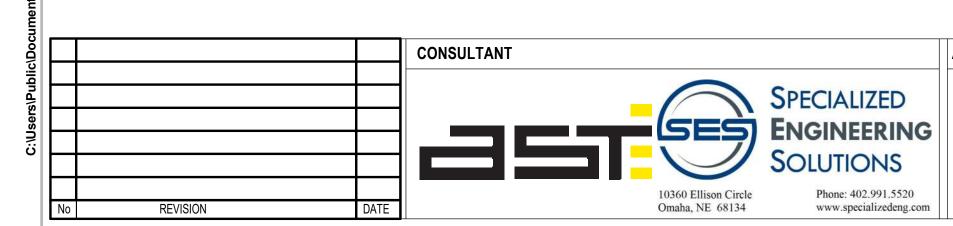



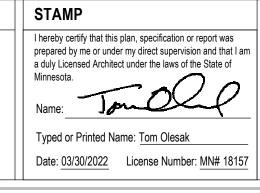

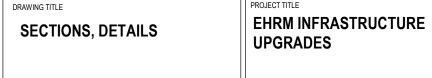

VA MEDICAL CENTER ST.CLOUD, MN 56303

| CHECKED BY | DRAWN | DRAWING NO. | S-AS500 |





ELEVATION KEYED NOTES

EL1 EXISTING BUILDING ELEMENT, TO REMAIN

NOTE: NOT ALL KEYED NOTES MAY BE USED ON EACH PLAN

 1

 2

 3

 4

- EL2 EXISTING WALL/PARTITION, PREPARE FOR MODIFICATION AS PRESCRIBED BY PLAN
- EL3 TELECOM ROOM ENCLOSURE TO MATCH EXISTING CONSTRUCTION



EXISTING CONDITION







SOUTH ELEVATION - ROOM 114B


1/4" = 1'-0"

PERSPECTIVE VIEW FROM NORTHWEST

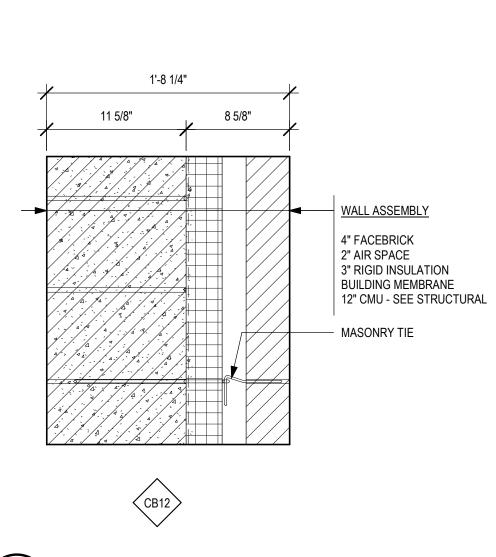


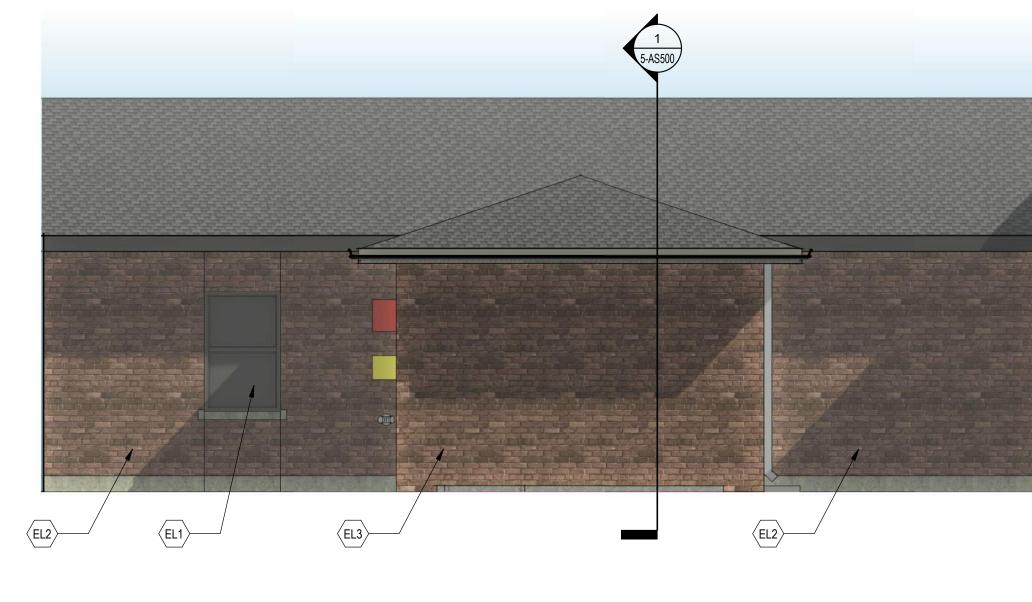

WEST ELEVATION - ROOM 114B

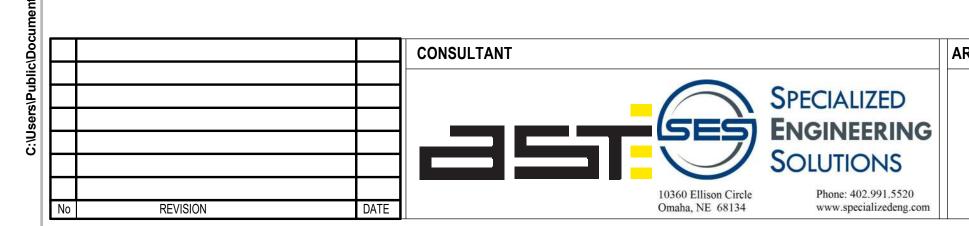




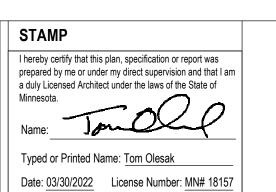




BUILDING No

VA MEDICAL CENTER ST.CLOUD, MN 56303

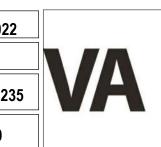



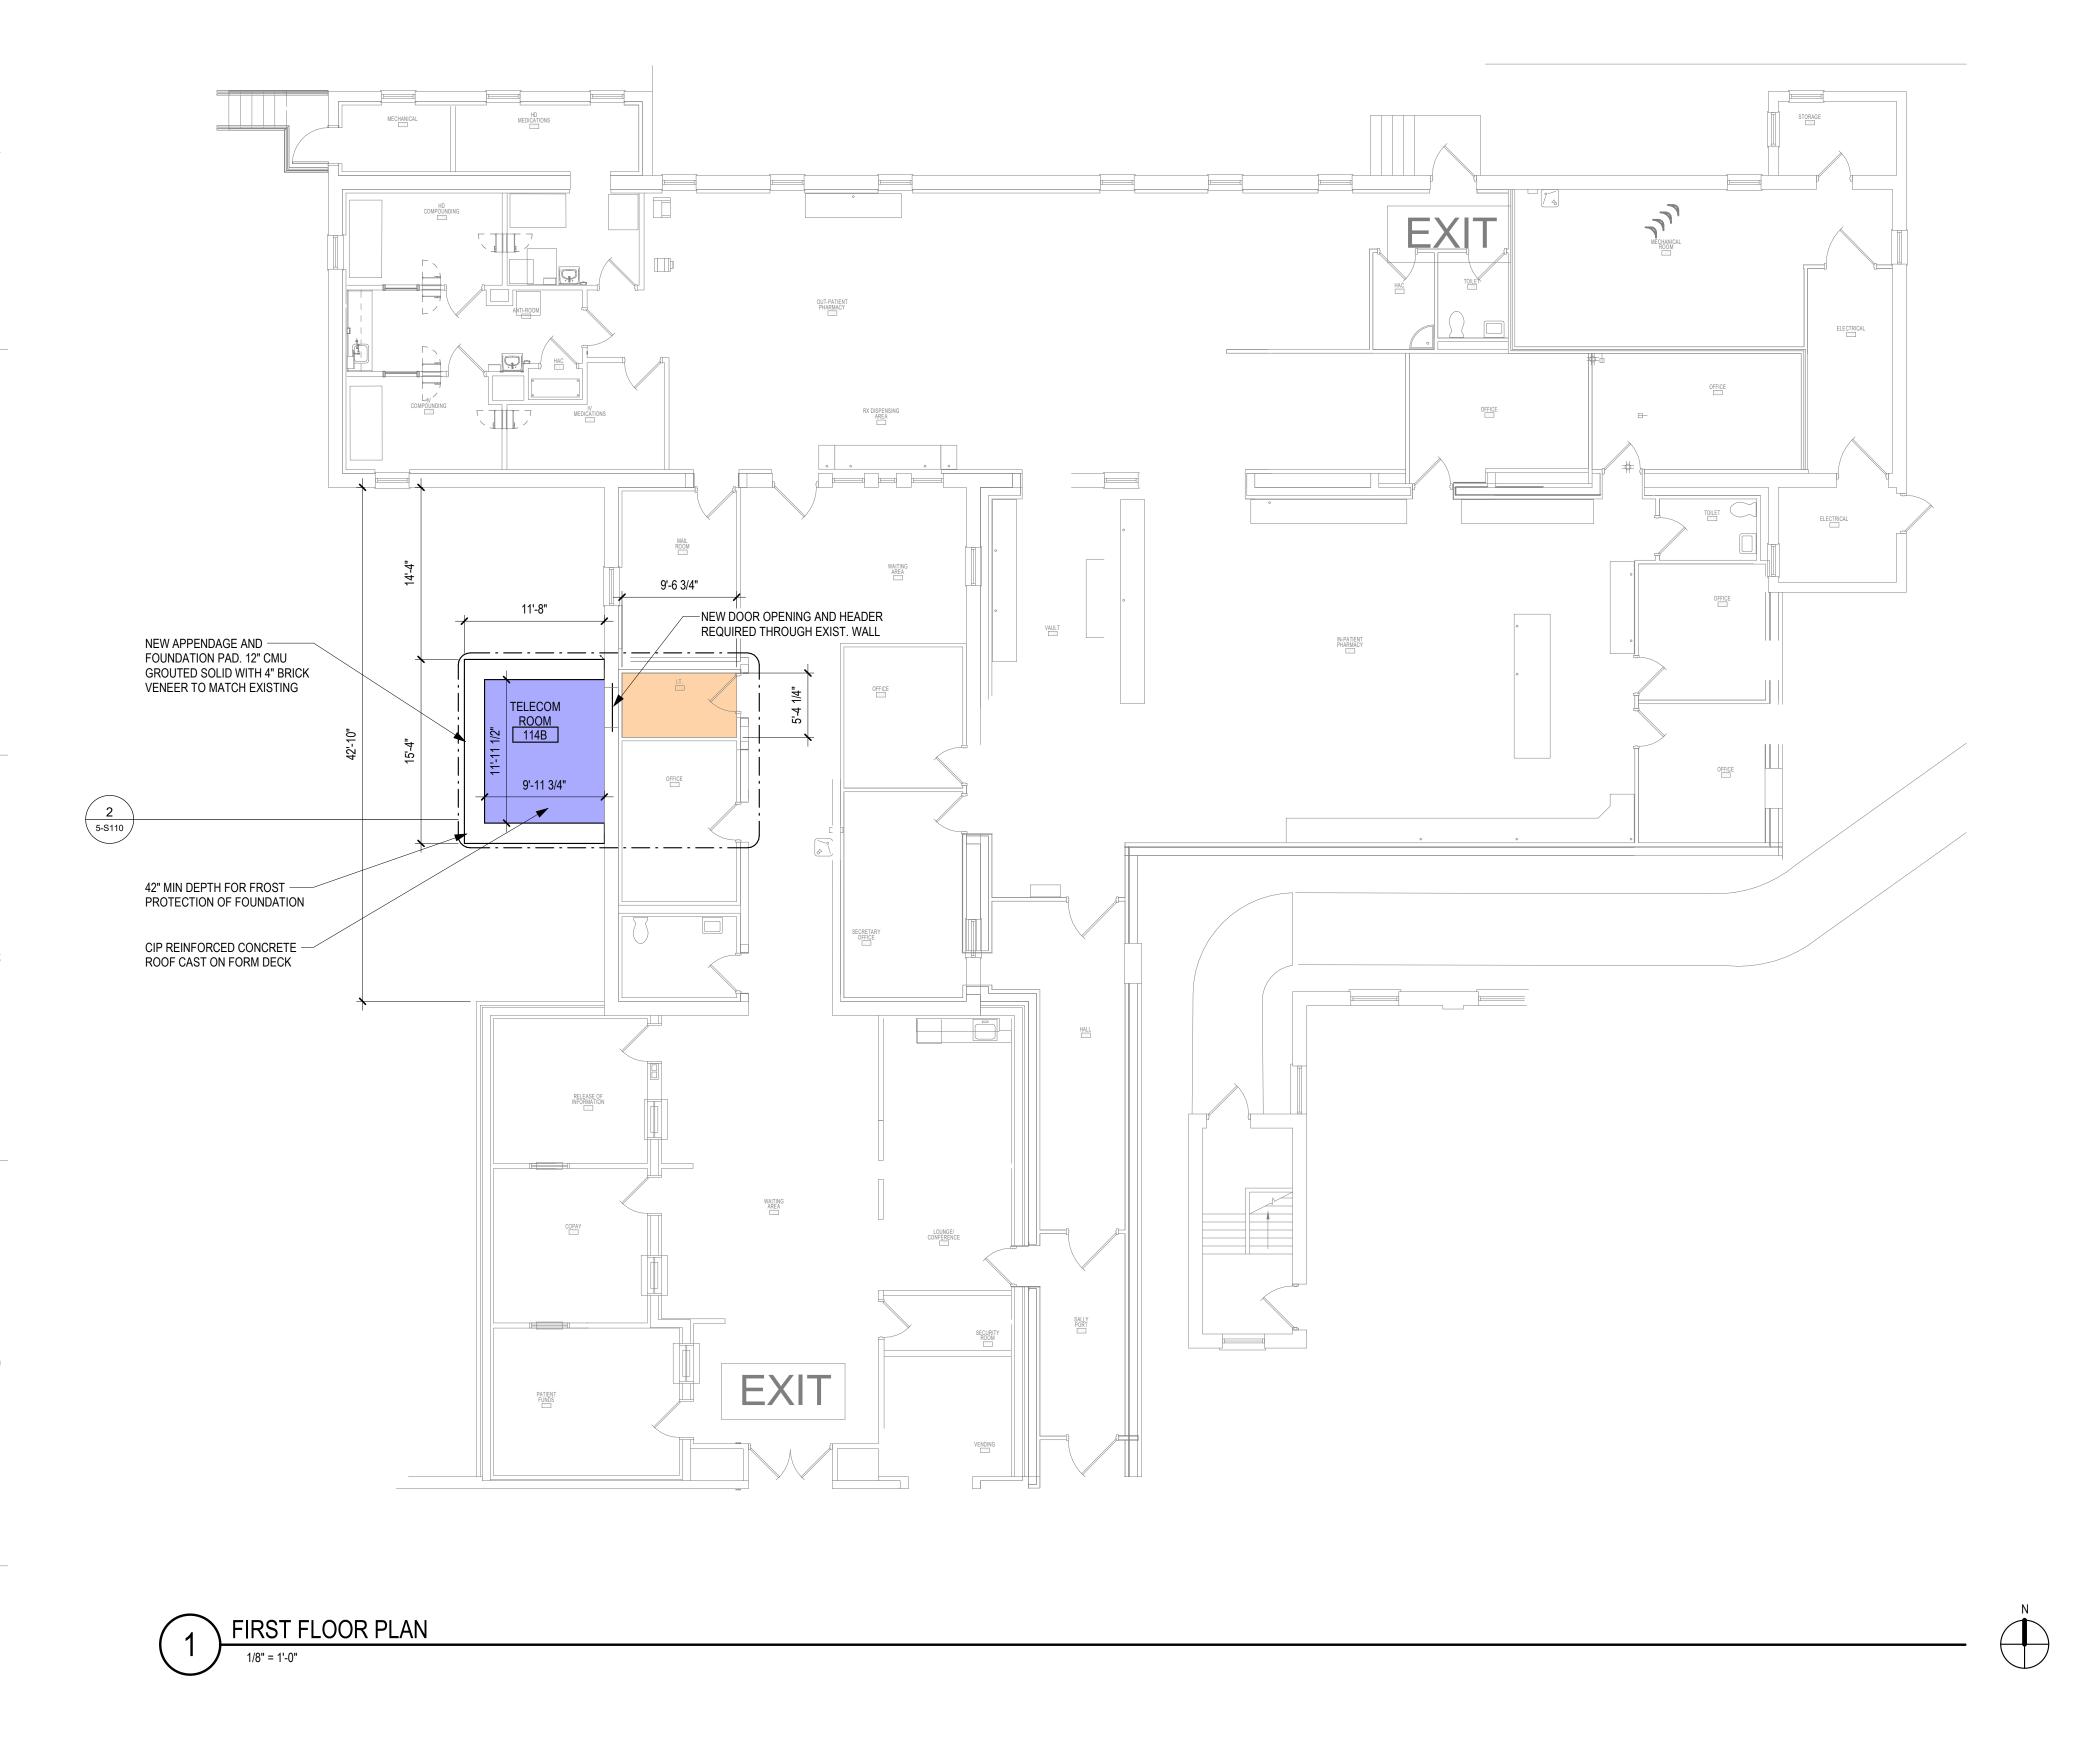

2 ENLARGED FLOOR PLAN
3/8" = 1'-0" -L5X5X3/8 CONT. ANGLE TO EXIST. MASONRY FOR 3C18 DECK SUPPORT. SHORING DESIGN BY OTHERS. 1/2" DIA HILTI HIT -A ROD ANCHOR AT MINIMUM, SHORE DECK @ 16" OC. INSTALL USING HILTI AT 1/3 SPANS HIT HY 70 ADHESIVE SYSTEM. REMOVE BRICK VENEER AND VERIFY 8" MASONRY WALL TYPE -EXIST. 8" MASONRY WALL REQUIRED TO HAVE EVERY OTHER CELL GROUTED. KNOCK OUT SHELL FACE ABOVE NEW ANGLE AND ADD FULLY GROUTED CELLS AS REQUIRED

INDICATES 8" THICK CIP SLAB W/ #5 @ 12" O.C. TOP AND BOT. EACH WAY. 2" TOP AND BOT. COVER. SLAB MUST BE SHORED AS REQUIRED UNTIL

3/4" PLYWOOD SHEATING. SEE ARCH FOR ROOF ASSEMBLY AND PROFILE.

LIGHT GUAGUE TRUSSES BY OTHERS TO FRAME HIPPED ROOF ABOVE S2 ROOF SLAB.

CONCRETE REACHES 7-% OF DESIGN STRENGTH

11'-8"

BOT. OF WALL FOOTING AT ——

42" BELOW TOP OF SOG.


5" THICK SOG W/ #4 — @ 12" O.C. EA WAY. MID. OF SLAB

3. SEE ARCHITECTURAL PLANS FOR ALL OPENING LOCATIONS, DIMENSIONS AND INTERIOR PARTITIONS.

4. SEE PLAN, SCHEDULES AND SHEET S100 FOR DESIGN LOADS.

LOCATION OF BEAMS.

7. ALL NEW OPENINGS GREATER THAN 5" IN DIAMETER OR 5"x5" ARE REQUIRED TO BE REINFORCED. 8. MASONRY WALL SHALL BE 12" BLOCK WITH #5 VERT BARS EACH FACE @ 16" OC UNLESS NOTED OTHERWISE.

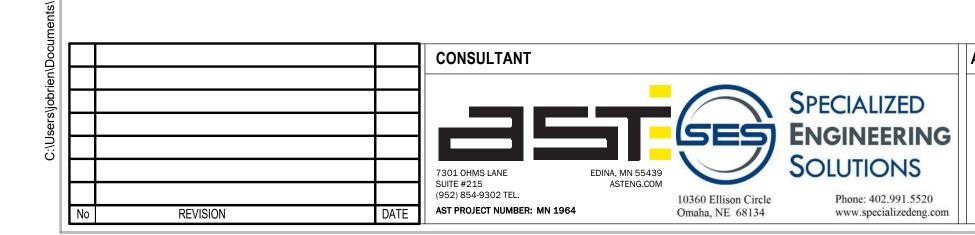




PRINT NAME: Zachary D. Craig


SIGNATURE:

DATE: 7/30/2022 LICENSE #:57219



1 9 9

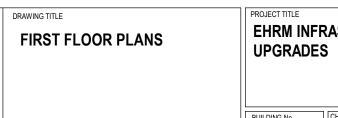

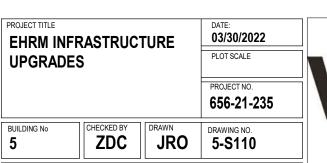

FULLY SPRINKLERED

VA MEDICAL CENTER ST.CLOUD, MN 56303





SHEET NOTES: 1. ALL EXISTING CONDITIONS MUST BE FIELD VERIFIED BY THE CONTRACTOR PRIOR TO CONSTRUCTION. ANY EXISTING CONDITIONS THAT DIFFER FROM THOSE SHOWN ON THE STRUCTURAL DRAWINGS MUST BE BROUGHT TO THE IMMEDIATE ATTENTION OF THE STRUCTURAL ENGINEER (IN WRITING).

2. THE INFORMATION SHOWN ON THE DRAWING IS BASED ON THE EXISTING STRUCTURAL DRAWINGS, SURVEYED DATA AND PHOTOGRAPHS OF THE EXISTING BUILDING PROVIDED BY ARCH.

5. DO NOT CUT, CORE OR DEMOLISH ANY EXISTING BEAMS. OPENINGS MUST SHIFT TO AVOID AS-BUILT


6. ALL EXISTING PARTITIONS ARE ASSUMED TO BE OF LIGHT GAUGE CONSTRUCTION UNLESS NOTED OTHERWISE. GC TO NOTIFY EOR IF DEMO WORK AT INTERIOR PARTITIONS CONTAIN STRUCTURAL/ROLLED STEEL OR ARE OF MASONRY/CIP CONSTRUCTION.

GENERAL NOTES:

A. REFER TO GENERAL DEMOLITION NOTES ON SHEET T000 FOR ADDITIONAL DEMOLITION SCOPE.


SHEET NOTES:

1. REMOVE AND REPLACE EXISTING DATA CABLE: REMOVE ALL EXISTING DATA CABLES AND JACKS THROUGHOUT THIS AREA. REPLACE CABLES AND JACKS 1 FOR 1, AS REQUIRED BY THE NEW WORK PLANS. REFER TO NEW WORK PLANS FOR SERVING COMMUNICATIONS ROOM LOCATION AND NEW

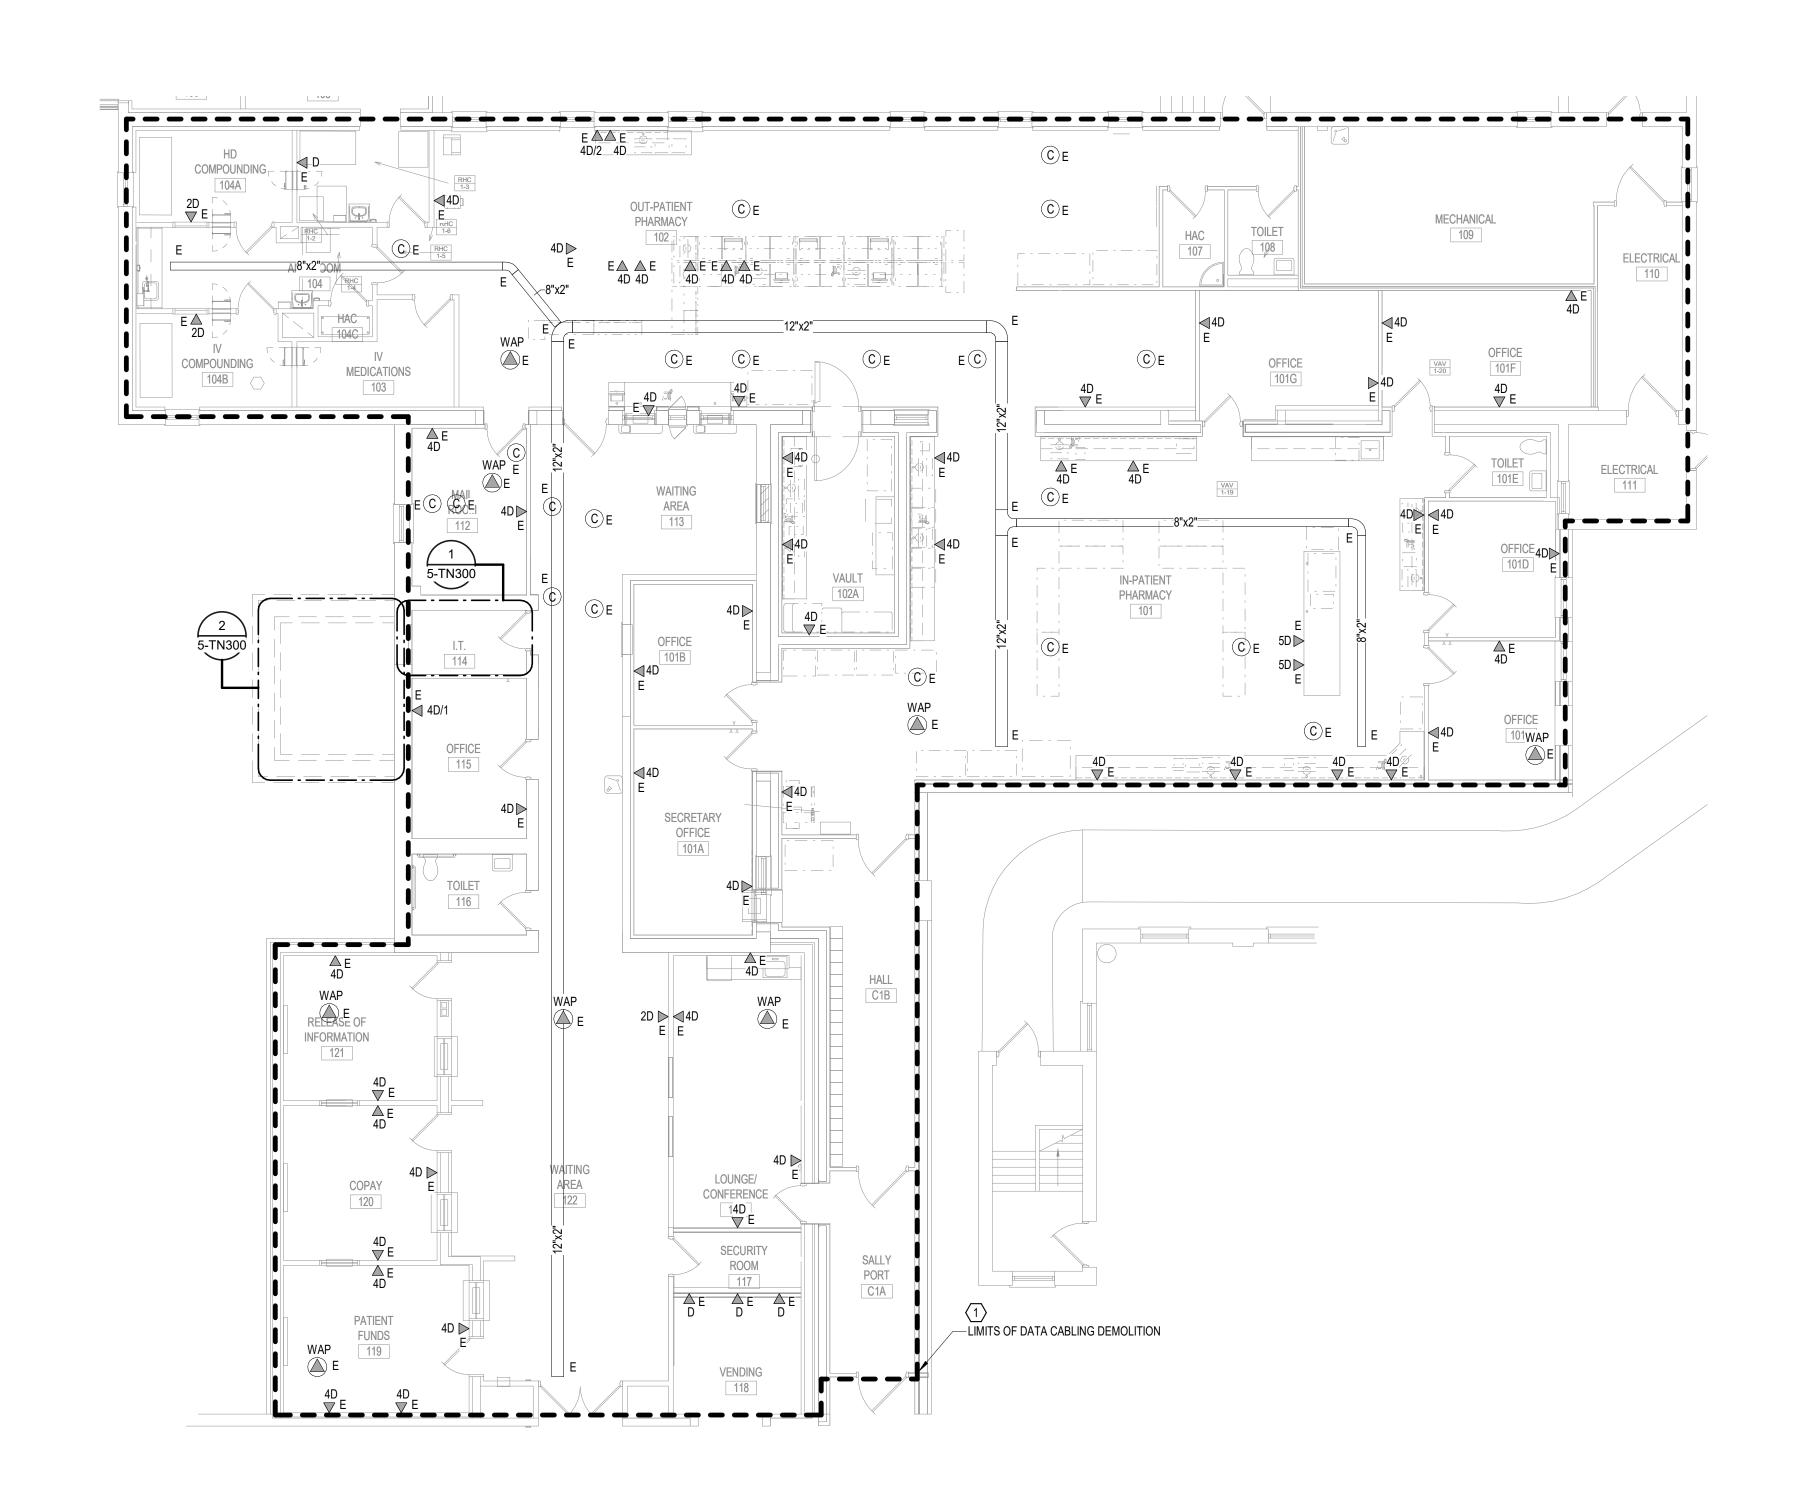

1 2 9

FIRST FLOOR PLAN - TELECOM - DEMOLITION

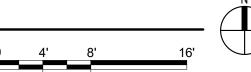



REVISION

ARCHITECT/ENGINEER OF RECORD ANDERSON 13605 1st Ave. N. #100 Plymouth, MN 55441 P 763.412.4000 | F 763.412.4090 | ae-mn.com Anderson Engineering of Minnesota, LLC | Proj # 16305







FULLY SPRINKLERED

BUILDING No

LOCATION

VA MEDICAL CENTER
ST.CLOUD, MN 56303

03/30/2022 KSB DRAWN DRAWING NO. 5-TD110






A. REFER TO GENERAL NOTES ON SHEET T000 FOR ADDITIONAL SCOPE.

SHEET NOTES:

CONTRACTOR TO PROVIDE NEW WIRE BASKET, AS NEEDED, TO MAINTAIN A 50% OR LESS FILL OF THE CABLE TRAY SYSTEM FOR THE FLOOR. THE NEW WIRE BASKET WILL MATCH THE SIZE AND DISTANCE, EITHER BESIDE OR BELOW THE EXISTING CABLE TRAY, TO MATCH THE EXISTING TELECOM CABLE TRAY.

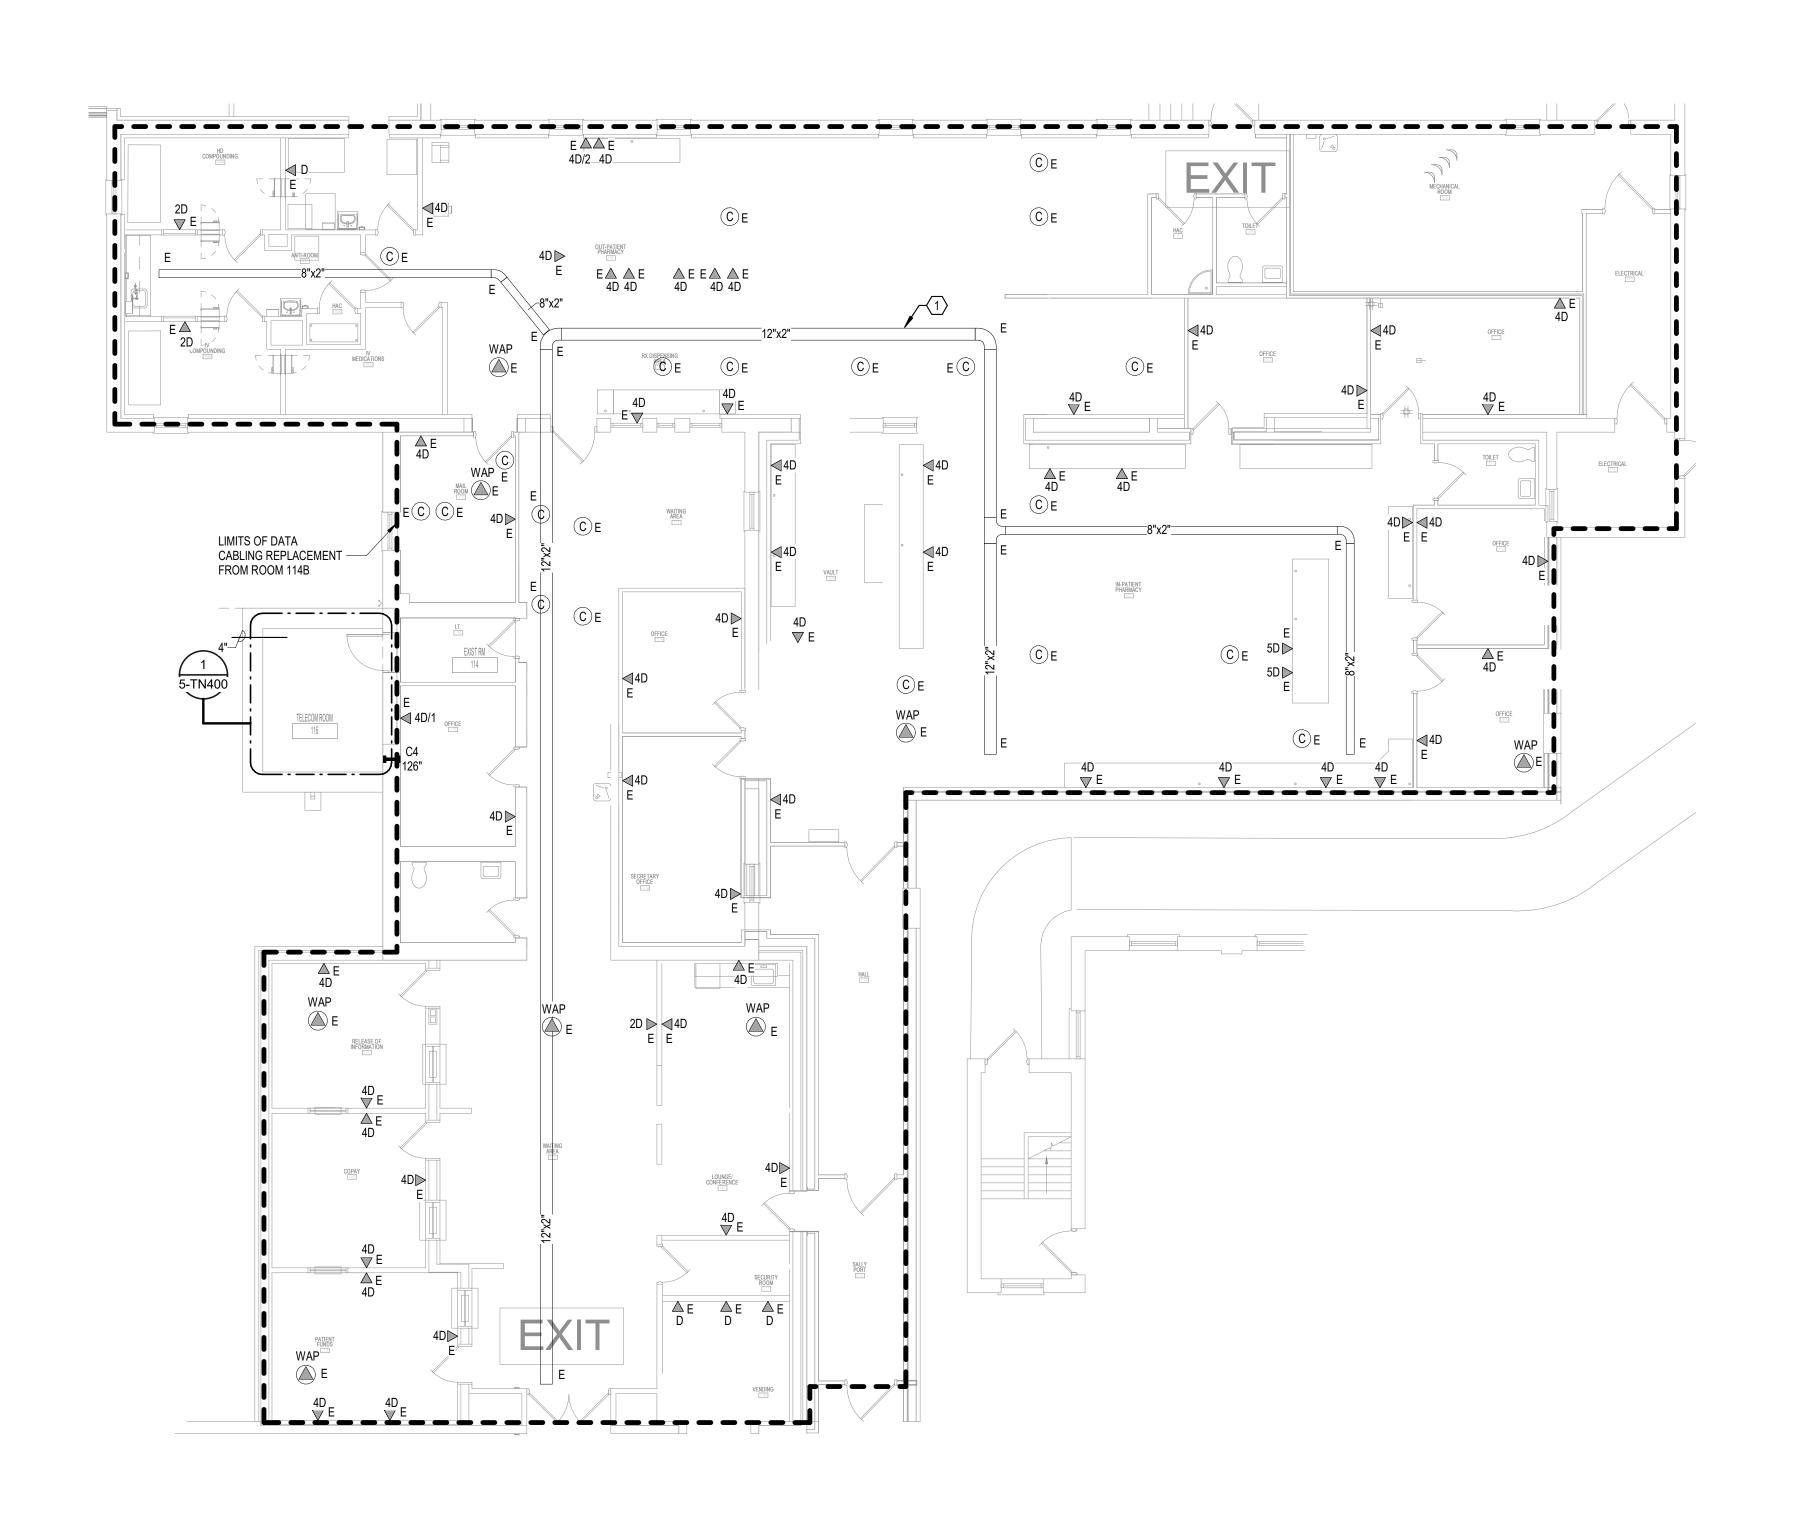

1 2 9 10

FIRST FLOOR PLAN - TELECOMMUNICATIONS

FIRST FLOOR PLAN -TELECOMMUNICATIONS

03/30/2022 EHRM INFRASTRUCTURE

FULLY SPRINKLERED

BUILDING No

LOCATION


VA MEDICAL CENTER
ST.CLOUD, MN 56303

CHECKED BY DRAWN DRAWING NO. SSK 5-TN110






REVISION

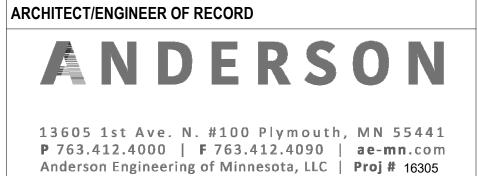



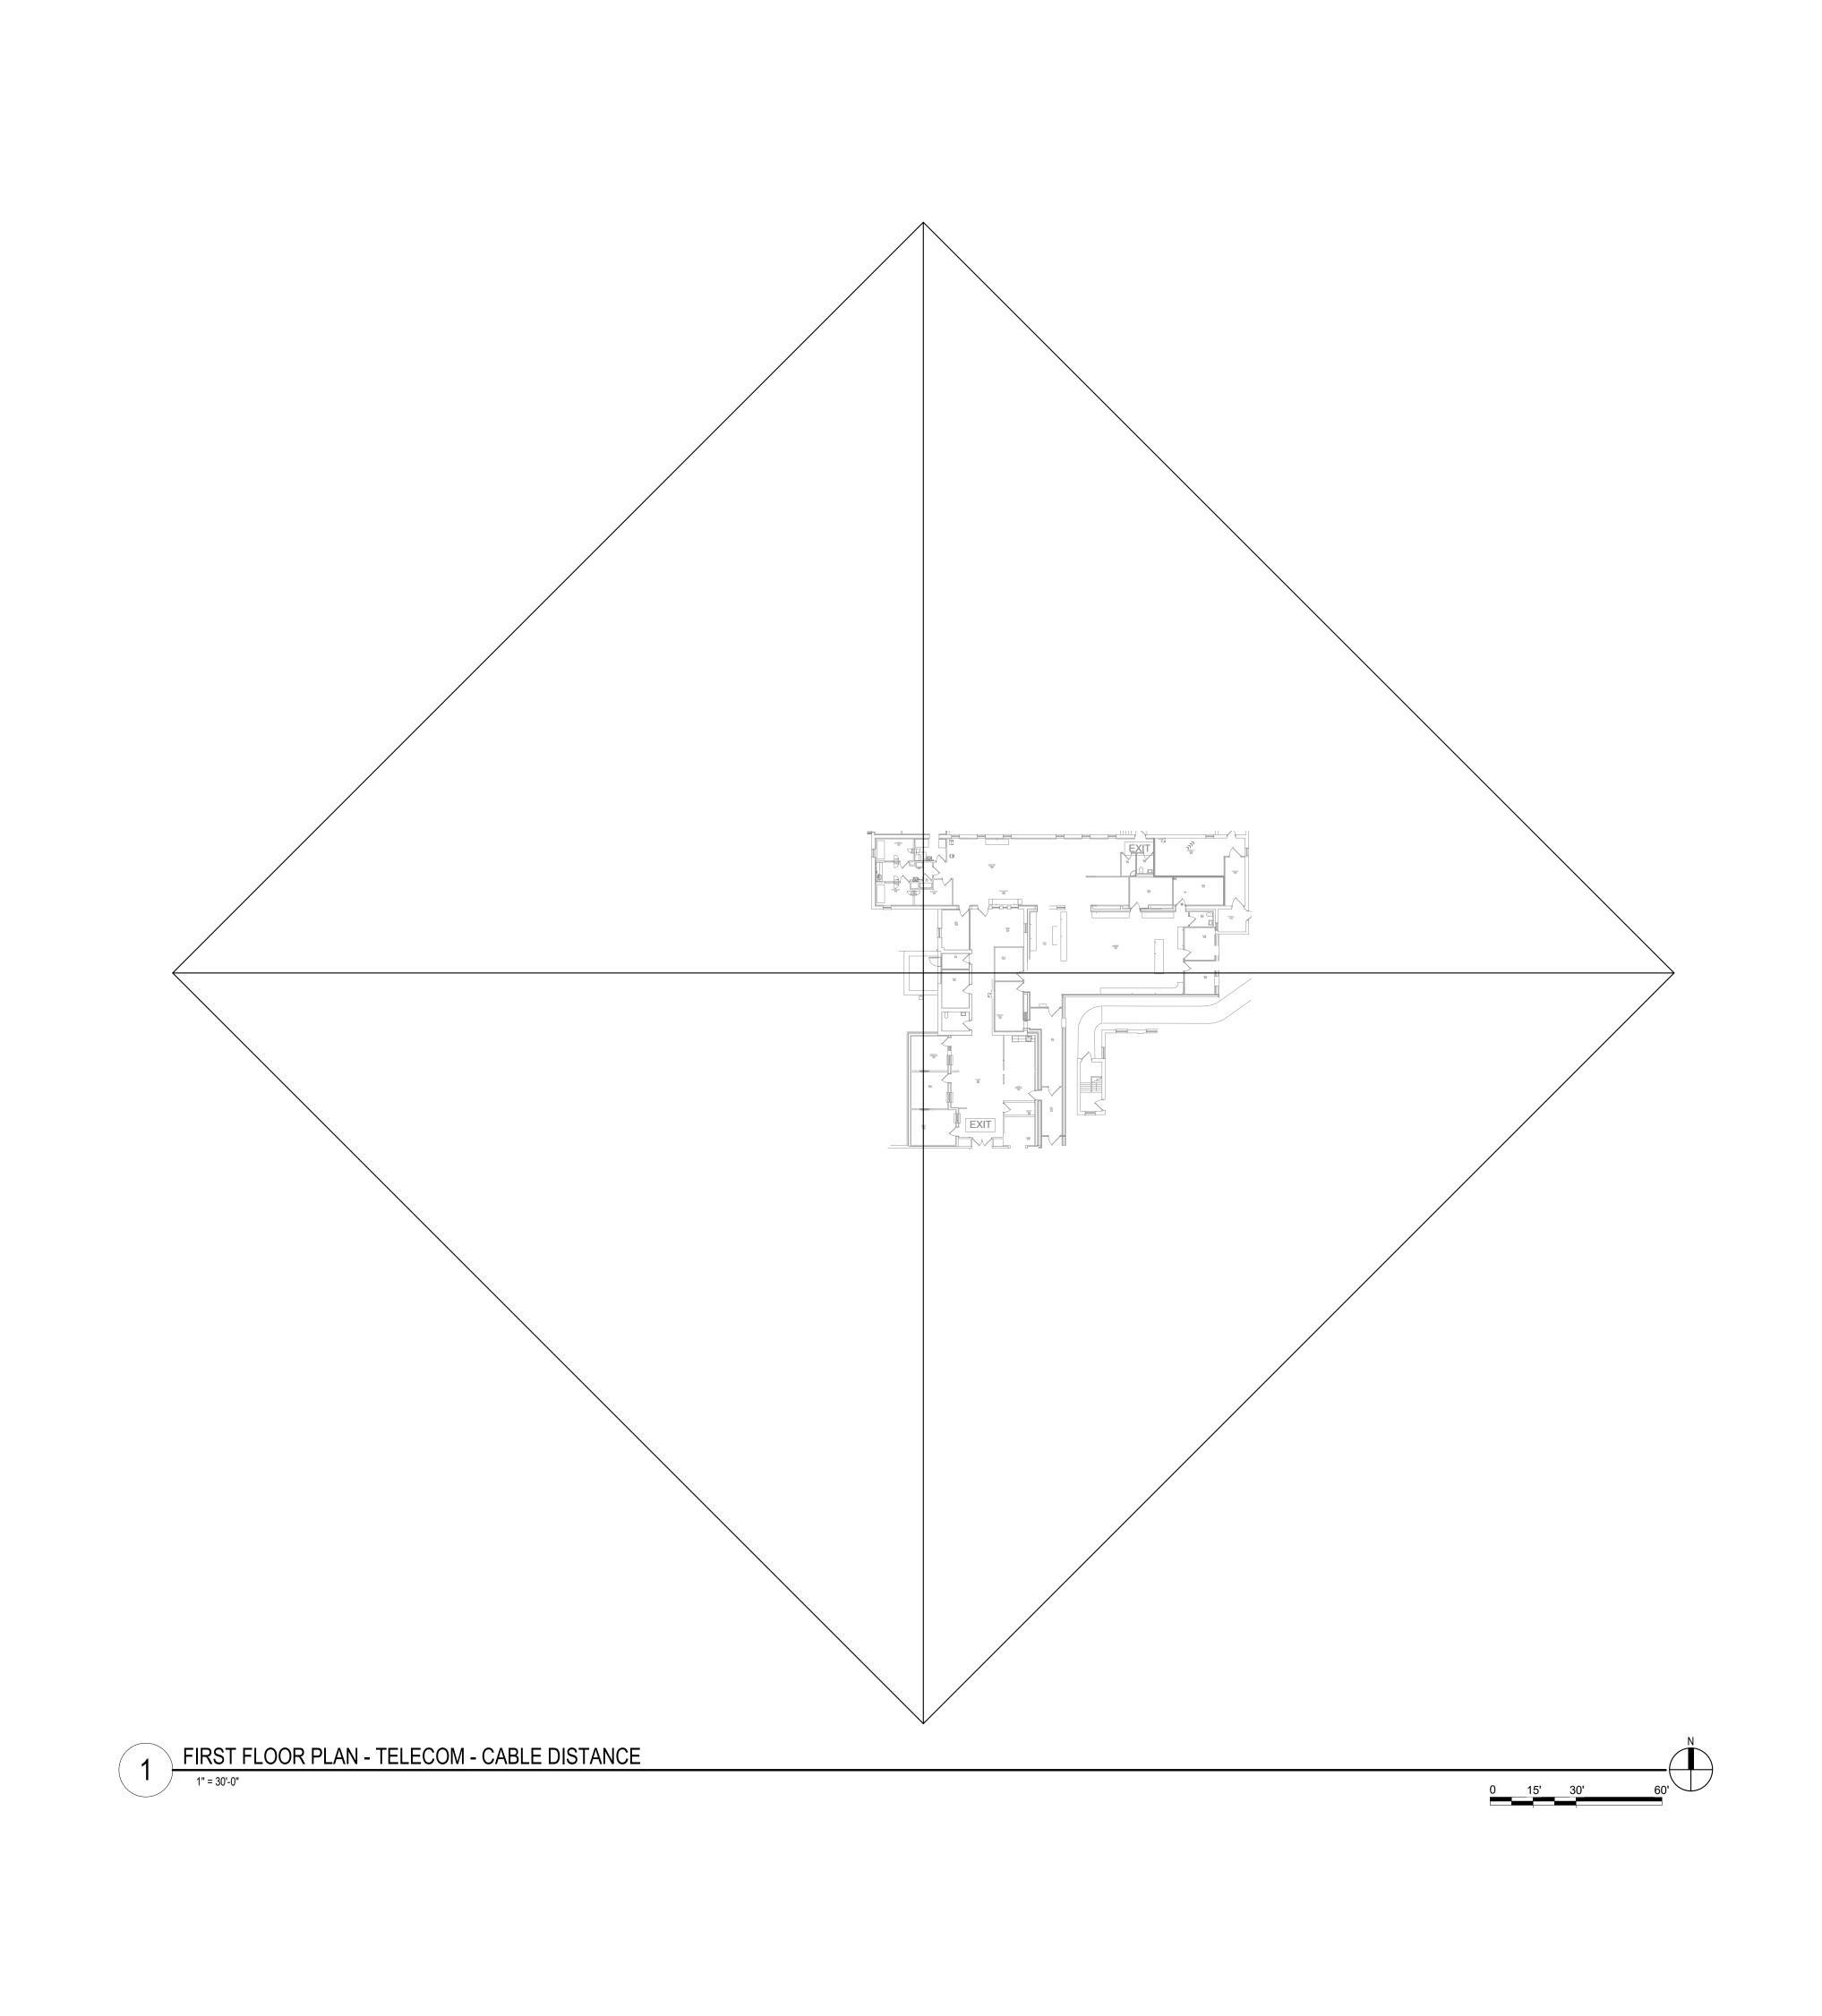

1 2 9 10

No REVISION DATE

SPECIALIZED ENGINEERING SOLUTIONS


10360 Ellison Circle Omaha, NE 68134

Phone: 402.991.5520 www.specializedeng.com

ARCHITECT/ENGINEER OF RECORD

AND ERSON

13605 1st Ave. N. #100 Plymouth, MN 55441
P 763.412.4000 | F 763.412.4090 | ae-mn.com
Anderson Engineering of Minnesota, LLC | Proj # 16305

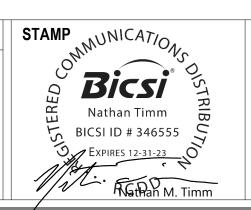

FIRST FLOOR PLAN TELECOM - CABLE DISTANCE

PROJECT TITLE

EHRM INFRASTRUCTURE


UPGRADES


LOCATION

VA MEDICAL CENTER
ST.CLOUD, MN 56303

> FULLY SPRINKLERED DWG. OF



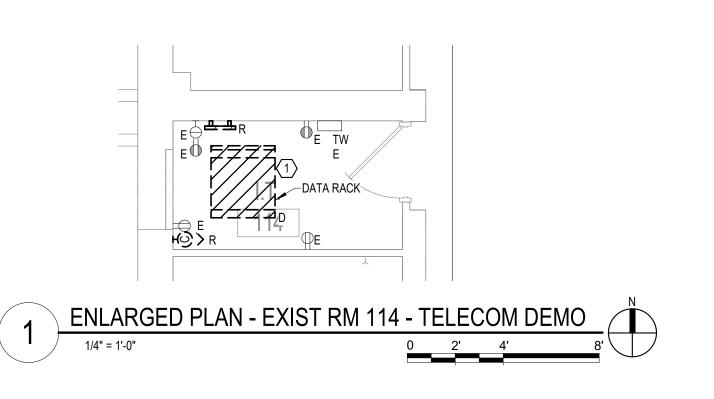

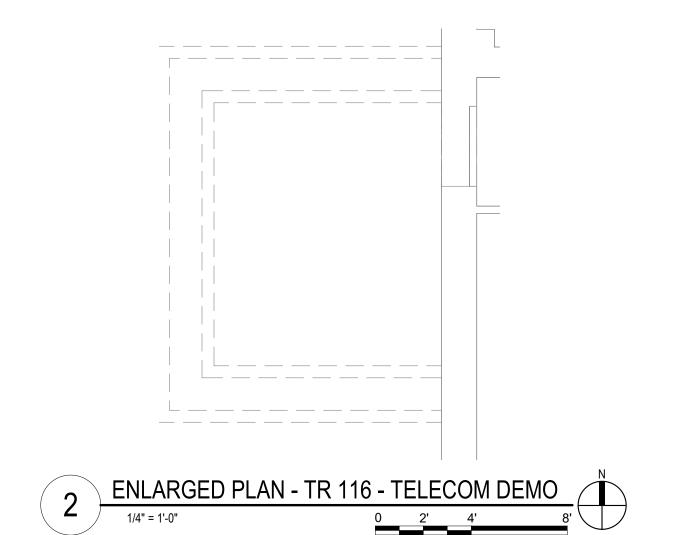



ENLARGED PLANS -TELECOMMUNICATIONS -

EHRM INFRASTRUCTURE

LOCATION

VA MEDICAL CENTER
ST.CLOUD, MN 56303

03/30/2022 CHECKED BY DRAWN DRAWING NO. SSK 5-TN300

FULLY SPRINKLERED

GENERAL NOTES:

SHEET NOTES:

CABLING NOTE:

1. ROOM 114 EXISTING CABLE COUNT

CABLE RELOCATION COUNT

EXISTING CABLE TO REMAIN

DATA (CAT6): 0 DATA (CAT5e): 243 DATA (CAT5): 0 DATA (CAT3): 0

DATA (CAT6): 0 DATA (CAT5e): 0 DATA (CAT5): 0 DATA (CAT3): 0

DATA (CAT6): 0 DATA (CAT5e): 0 DATA (CAT5): 0 DATA (CAT3): 0

FINAL CABLE COUNT DATA (CAT6): 0 DATA (CAT5e): 0

DATA (CAT5): 0 DATA (CAT3): 0

A. REFER TO GENERAL DEMOLITION NOTES ON SHEET T000 FOR ADDITIONAL DEMOLITION SCOPE.

COMMUNICATIONS ROOM LOCATION AND NEW CABLING ROUTES.

ROOMS ARE TO BE REUSED, WHEN POSSBILE, IN NEW CONSTRUCTION TRS.


1. EXISTING TELECOMMUNICATIONS CAGE AND RACK SHALL BE INCLUDED WITHIN THE SCOPE OF DEMOLITION. EXISTING CABLING AND ASSOCIATED OUTLETS SHALL BE REMOVED AND REPLACED 1 FOR 1 AND REFED FROM DISTRIBUTION EQUIPMENT LOCATED WITHIN THE NEW TELECOMMUNICATIONS ROOM. REFER TO GENERAL CABLING NOTES FOR APPROXIMATE QUANTITIES. REFER TO NEW WORK PLANS FOR SERVING

2. EXISTING CABLE TRAY, SECURITY CAMERAS, GROUND BUS BARS, AND RACKS FROM DECOMMISSIONED

A. THE EXISTING CABLE COUNT ARE THE CABLES CURRENTLY PRESENT IN THE SPACE. THE CABLE

RELOCATION COUNT ARE THE NEW OR RELOCATED CABLES TO BE FED FROM THE SPACE. THE FINAL CABLE COUNT ARE THE CABLES THAT WILL BE PRESENT IN THE SPACE AT THE COMPLETION OF THE



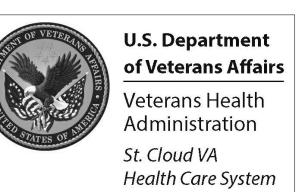



Omaha, NE 68134


www.specializedeng.com


REVISION


ARCHITECT/ENGINEER OF RECORD ANDERSON 13605 1st Ave. N. #100 Plymouth, MN 55441 P 763.412.4000 | F 763.412.4090 | ae-mn.com


G BICSI ID # 346555 EXPIRES 12-31-23 Mathan M. Timm Anderson Engineering of Minnesota, LLC | Proj # 16305

1 2 8

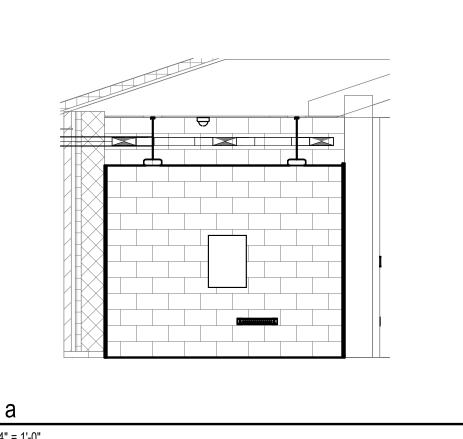

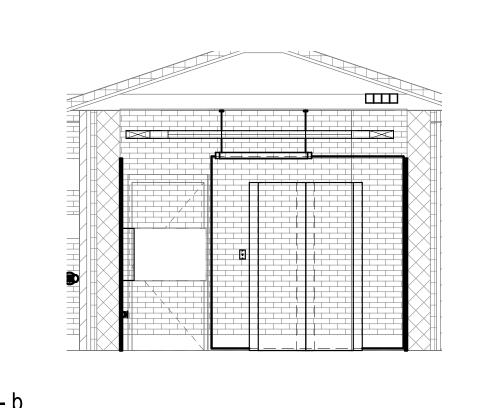

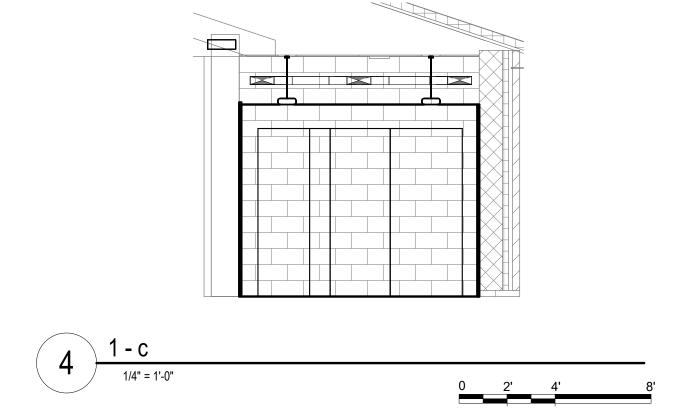

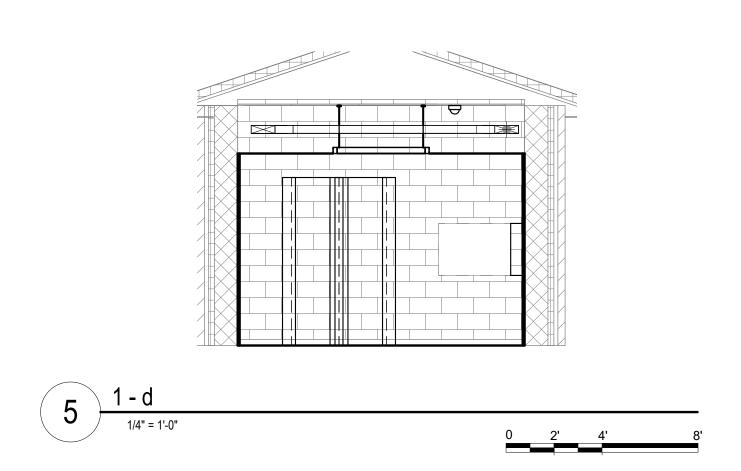

GENERAL NOTES:

A. REFER TO GENERAL DEMOLITION NOTES ON SHEET T000 FOR ADDITIONAL DEMOLITION SCOPE.

SHEET NOTES:

1. PROVIDE A NEW ACCESS CONTROL PANEL TO BE INSTALLED IN THE TELECOM ROOM. THE CARD READER AND KEYPAD FOR THIS ROOM TO BE WIRED TO THE NEW ACCESS CONTROL PANEL. EXISTING CARD READERS AND KEYPADS WILL BE MOVED TO THE NEW CONTROL PANEL UNDER A DIFFERENT PROJECT.

CABLING NOTE:

A. THE EXISTING CABLE COUNT ARE THE CABLES CURRENTLY PRESENT IN THE SPACE. THE CABLE RELOCATION COUNT ARE THE NEW OR RELOCATED CABLES TO BE FED FROM THE SPACE. THE FINAL CABLE COUNT ARE THE CABLES THAT WILL BE PRESENT IN THE SPACE AT THE COMPLETION OF THE PROJECT.

1. ROOM 116 EXISTING CABLE COUNT DATA (CAT6): 0

DATA (CAT5e): 0 DATA (CAT5): 0 DATA (CAT3): 0

CABLE RELOCATION COUNT DATA (CAT6): 0 DATA (CAT5e): 243 FROM 114


DATA (CAT5): 0 DATA (CAT3): 0

EXISTING CABLE TO REMAIN DATA (CAT6): 0 DATA (CAT5e): 0 DATA (CAT5): 0

FINAL CABLE COUNT DATA (CAT6A): 243

DATA (CAT3): 0


DATA (CAT6): 0

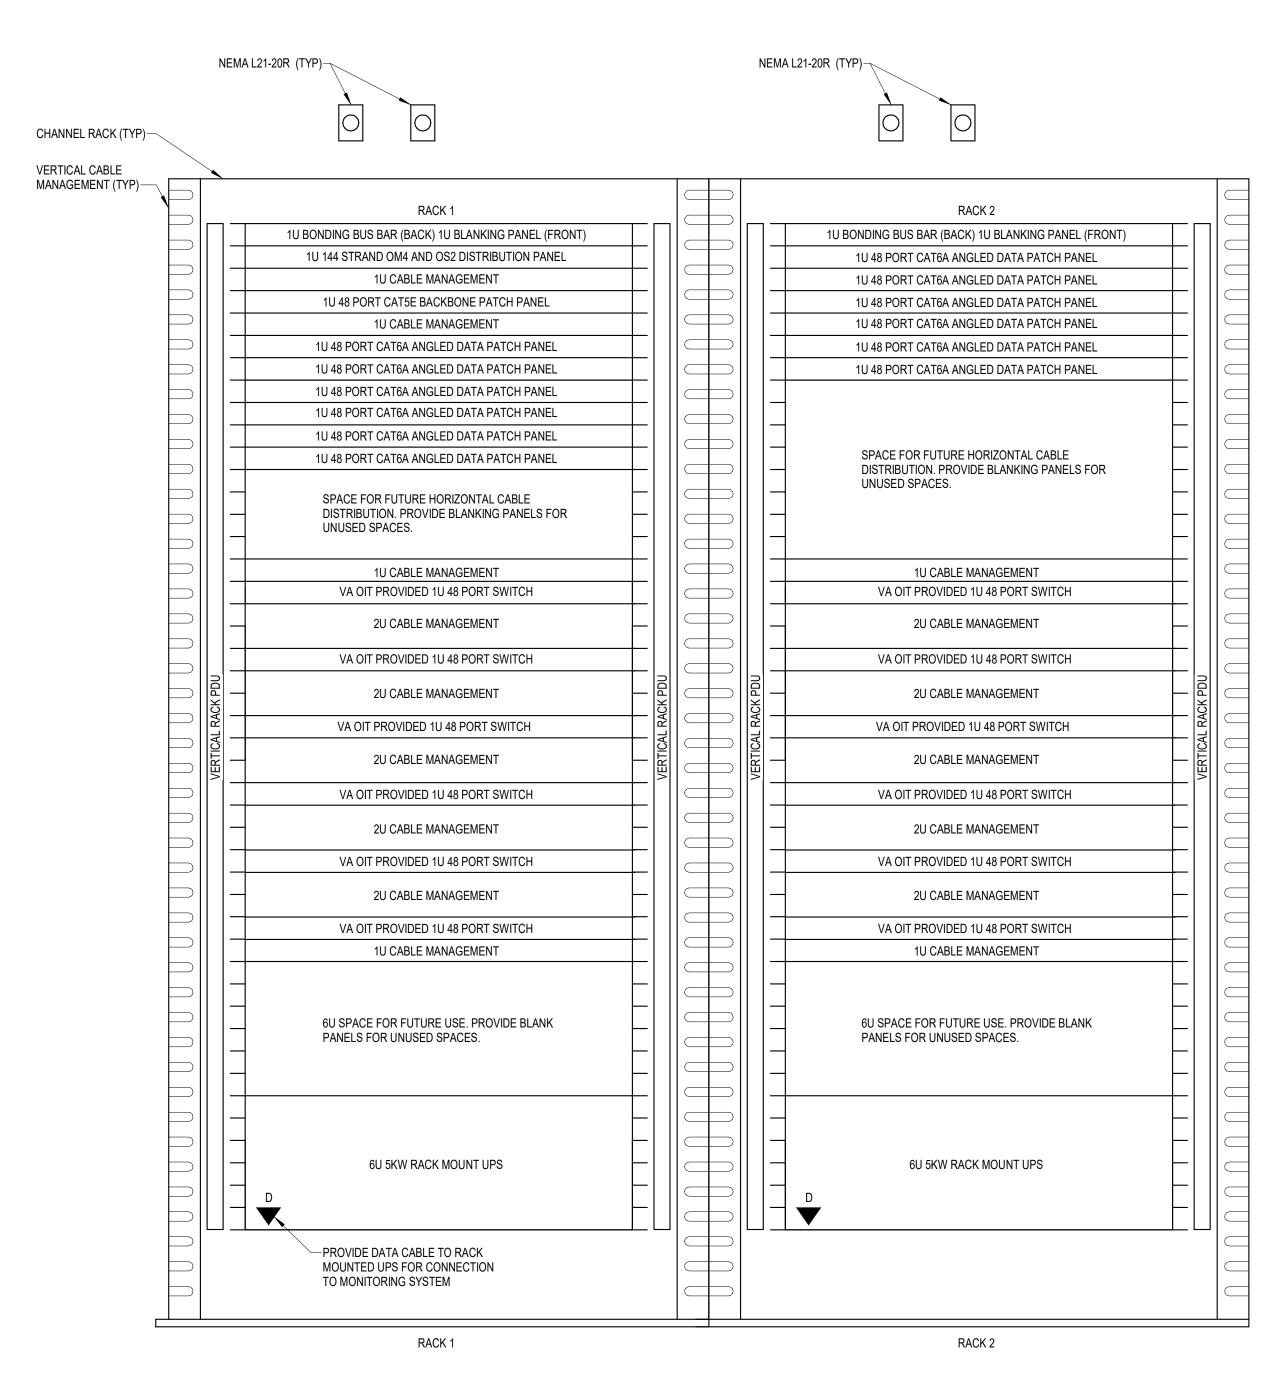

- 1. REFER TO NEW WORK PLAN FOR RACK LOCATIONS. 2. COORDINATE EXACT RACK COUNT AND LOCATION WITH OWNER PRIOR TO PERMANENT INSTALLATION.
- 3. SEE PROJECT SPECIFICATIONS FOR ADDITIONAL RACK COMPONENTS. 4. RACK ELEVATION SHOWS A FULLY CONFIGURED SAMPLE RACK. CONTRACTOR TO PROVIDE REQUIRED EQUIPMENT TO SUPPORT THE FINAL DATA COUNT FROM THE ENLARGED NEW SHEET. (NOT TO EXCEED 288 PORTS PER RACK).
- 5. COORDINATE FINAL RACK COMPONENT LAYOUT WITH OWNER'S IS/IT REPRESENTATIVE. 6. CONTRACTOR IS RESPONSIBLE FOR FINAL CABLE COUNT, QUANTITY OF PATCH PANELS, SWITCHES, FIBER ENCLOSURES,
- BLANKING PANELS, CABLE MANAGEMENT, AND MOUNTING HARDWARE NOT MARKED AS "OIT PROVIDED". 7. PUNCHDOWN COPPER BACKBONES ON RACK MOUNT PATCH PANELS. TERMINATE ONE (1) PAIR PER PATCH PANEL PORT.

6 COMMUNICATIONS - TYPICAL TWO RACK ELEVATION WITH RACK MOUNT UPS - TR 116


NOT TO SCALE

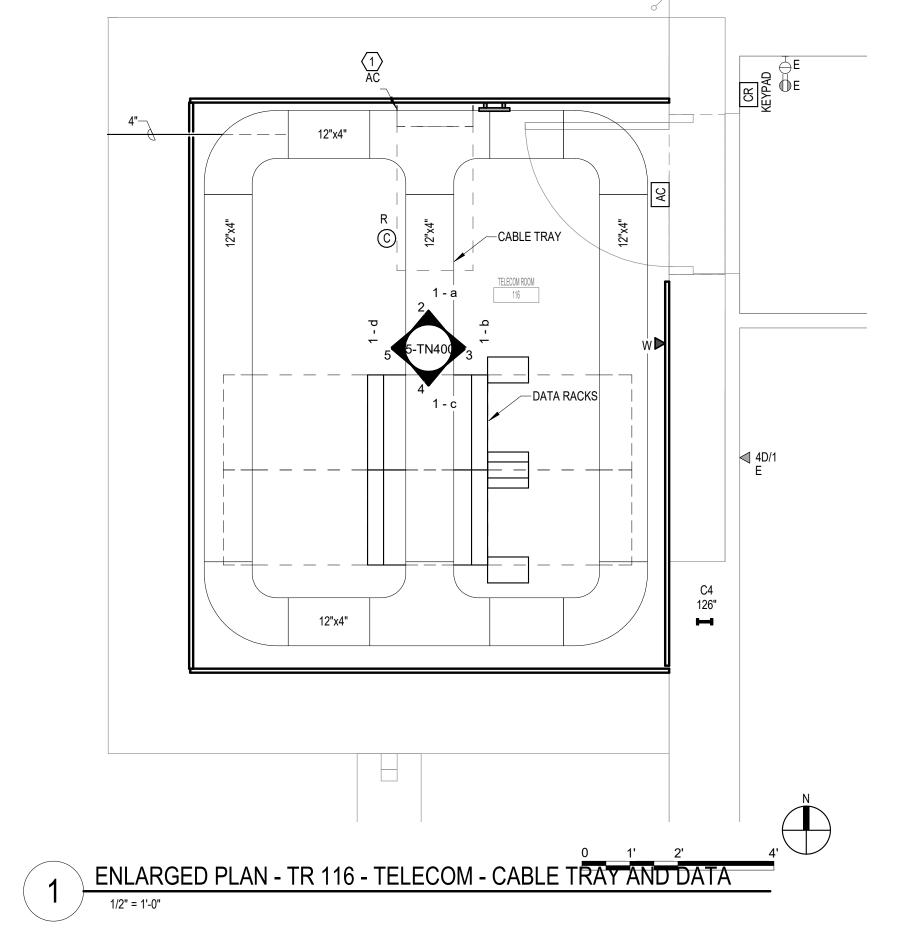



REVISION

ARCHITECT/ENGINEER OF RECORD ANDERSON 13605 1st Ave. N. #100 Plymouth, MN 55441 P 763.412.4000 | F 763.412.4090 | ae-mn.com

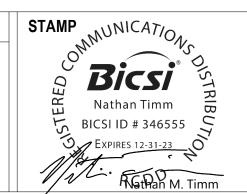



EHRM INFRASTRUCTURE

VA MEDICAL CENTER ST.CLOUD, MN 56303


KSB

FULLY SPRINKLERED

03/30/2022 SSK DRAWING NO. 5-TN400



KEYNOTES: # 1. PROVIDE ELECTRICAL CONNECTION TO CONDENSING UNIT, AS REQUIRED. COORDINATE FINAL LOCATION AND CONNECTION REQUIREMENTS WITH MECHANICAL.

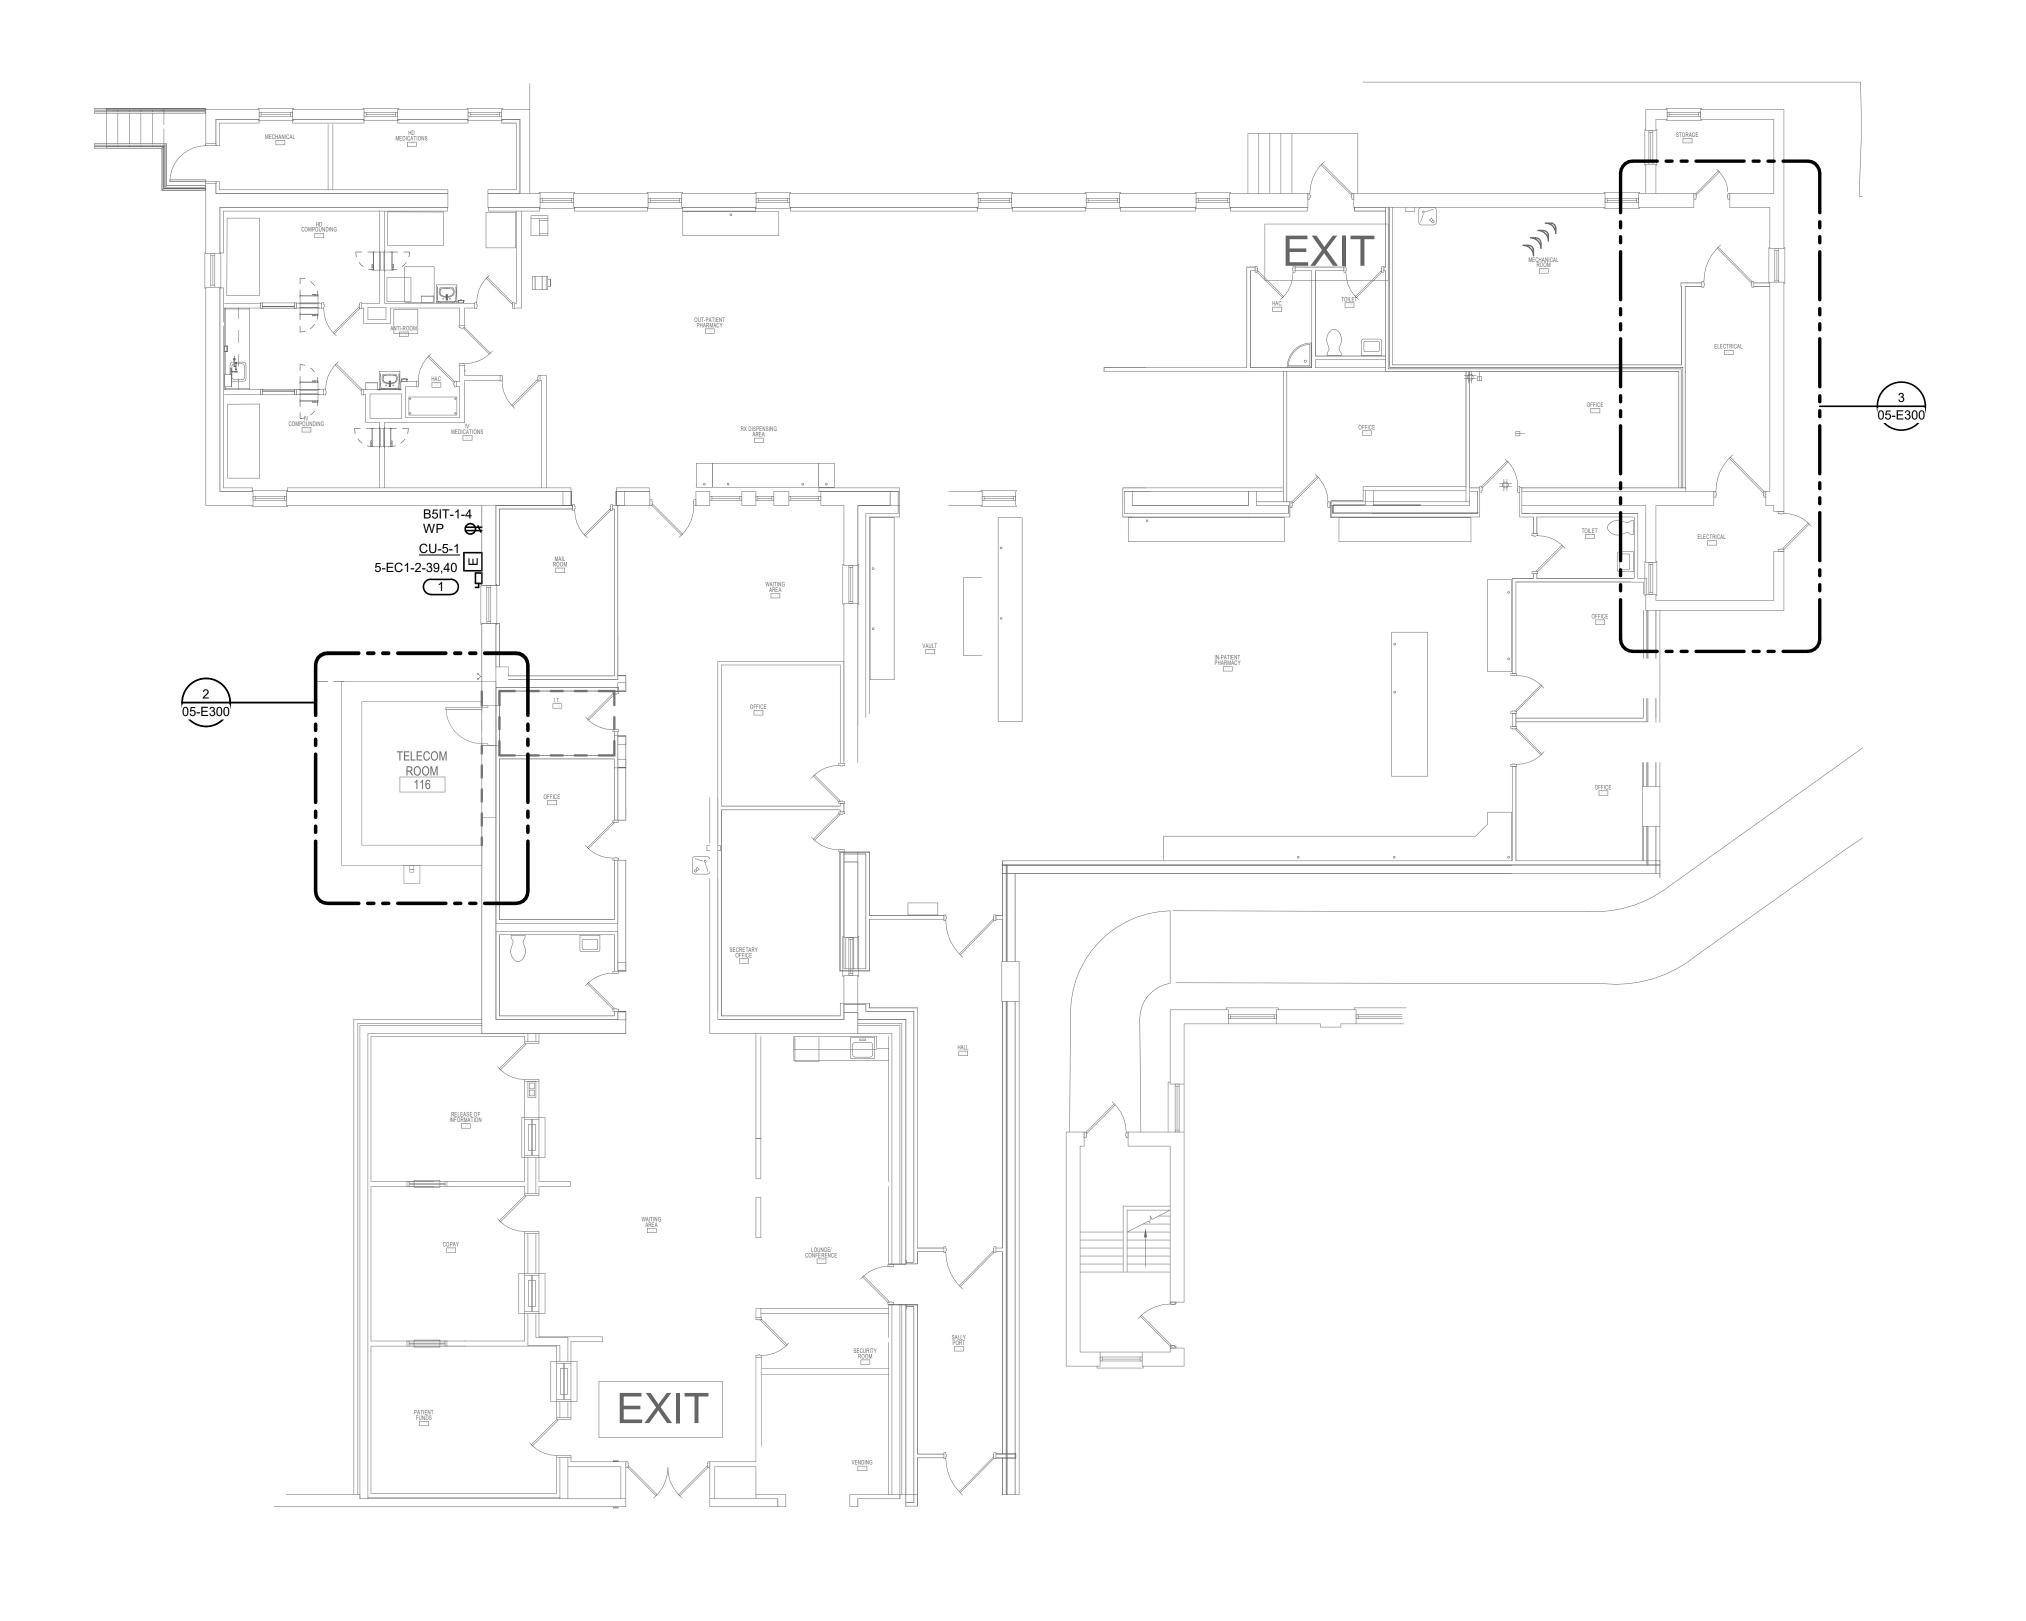

1 9 9

1 FIRST FLOOR PLAN - ELECTRICAL

1/8" = 1'-0"

CONSULTANT 03/30 Phone: 402.991.5520 DATE

Omaha, NE 68134

www.specializedeng.com

100% CD

REVISION

ARCHITECT/ENGINEER OF RECORD ANDERSON 13605 1st Ave. N. #100 Plymouth, MN 55441 P 763.412.4000 | F 763.412.4090 | ae-mn.com Anderson Engineering of Minnesota, LLC | Proj # 16305





PROJECT TITLE

EHRM INFRASTRUCTURE TBD CHECKED BY GJL


FULLY SPRINKLERED


LOCATION

VA MEDICAL CENTER
ST.CLOUD, MN 56303




U.S. Department of Veterans Affairs Veterans Health Administration St. Cloud VA Health Care System

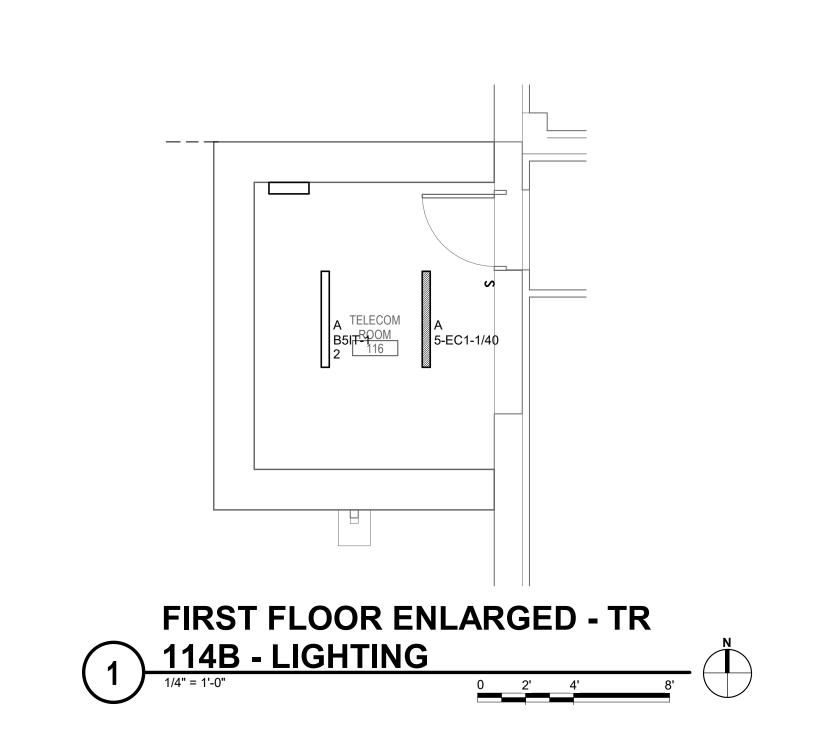

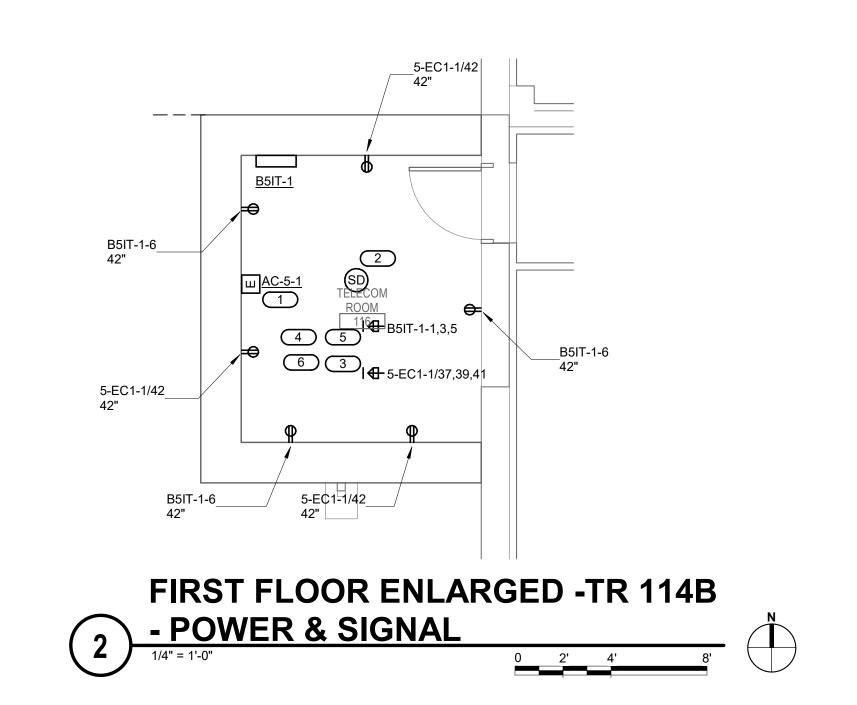

5 9

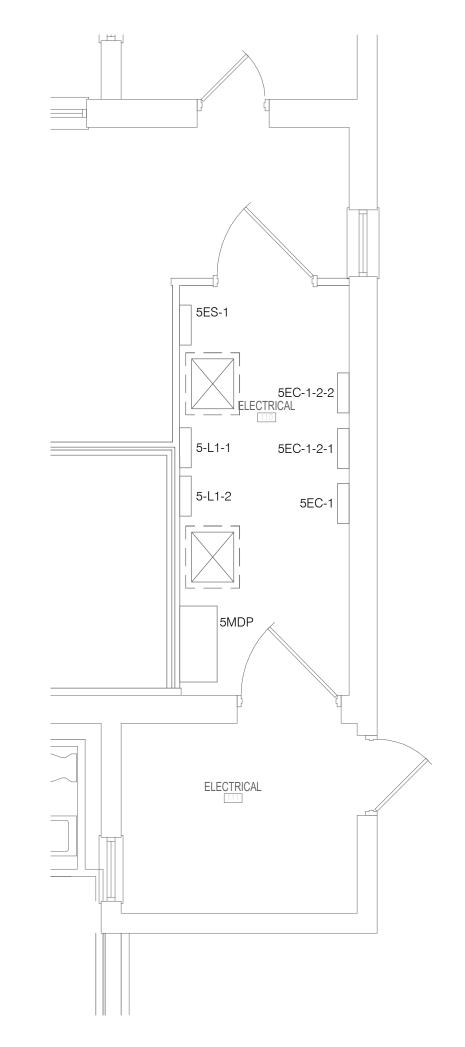

FIRST FLOOR ENLARGED - ELEC

110 - ELECTRICAL

1/4" = 1'-0"

0 2' 4' 8'

SHEET NOTES:

1. REFER TO TECHNOLOGY PLANS FOR IT ROOM LAYOUT AND RACK LAYOUT/DETAILS.

2. REFER TO SHEET 0-GE400 DETAIL FOR LAYOUT & ONE-LINE OF RACK.

KEYNOTES: #

INDOOR UNIT TO BE POWERED BY OUTDOOR UNIT. COORDINATE EXACT LOCATION WITH M.C.
 CONNECT SMOKE DETECTOR TO NEAREST EXISTING SLC.

EXISTING SLC.
COORDINATE FINAL LOCATION OF
RECEPTACLE L21-30R WITH TELECOM
CONTRACTOR. PROVIDE 3/4"C-4#10, 1#10 GND
TO PANEL FOR EACH RECEPTACLE.
PROVIDE EATON BLADEUPS, 5KW, 120/208V, 3-

PHASE,4-WIRE RACK MOUNTED UPS FOR EACH RACK TOWER.

5. PROVIDE APC#AP8861 RPDU RACK PDU 2G WITH L21-20P CORD. (120/208V, 3-PHASE, 20A, ZERO U, 5.7 KW, 208V, (36) C13 (6) C19 (2) 5-20R OUTLETS. PROVIDE TWO PER RACK, MOUNTED

PER MANUFACTURER'S REQUIREMENTS.

6. PROVIDE ONE RACK MOUNTED ZONE PDU UNIT. 30 AMP 3 PHASE, 120/208V, 5-WIRE WITH (4) L21-30R, (6) 5-20R AND TWO 10' POWER CORDS. ZONIT#ZPDS-208V-30A-L21-4L21-20R-CR.

CONSULTANT

SPECIALIZED
ENGINEERING
SOLUTIONS
10360 Ellison Circle
Omaha, NE 68134

Phone: 402.991.5520
www.specializedeng.com

ARCHITECT/ENGINEER OF RECORD

ARCHITECT/ENGINEER OF RECORD

13605 1st Ave. N. #100 Plymouth, MN 55441
P 763.412.4000 | F 763.412.4090 | ae-mn.com

Anderson Engineering of Minnesota, LLC | Proj # 16305

STAMP

ELECTRICAL ENLARGED
PLANS

PROJECT TITLE

EHRM INFRASTRUCTURE
UPGRADES

PLOT SC.

PROJECT
656
BUILDING No
5

CHECKED BY
TBD

DRAWN
GJL

DRAWING
05-E

FULLY SPRINKLERED


LOCATION


VA MEDICAL CENTER
ST.CLOUD, MN 56303

VA



1. PROVIDE NEW 100A/3P CIRCUIT BREAKER IN EXISTING SWITCHBOARD TO MATCH EXISTING TYPE AND AIC RATING.

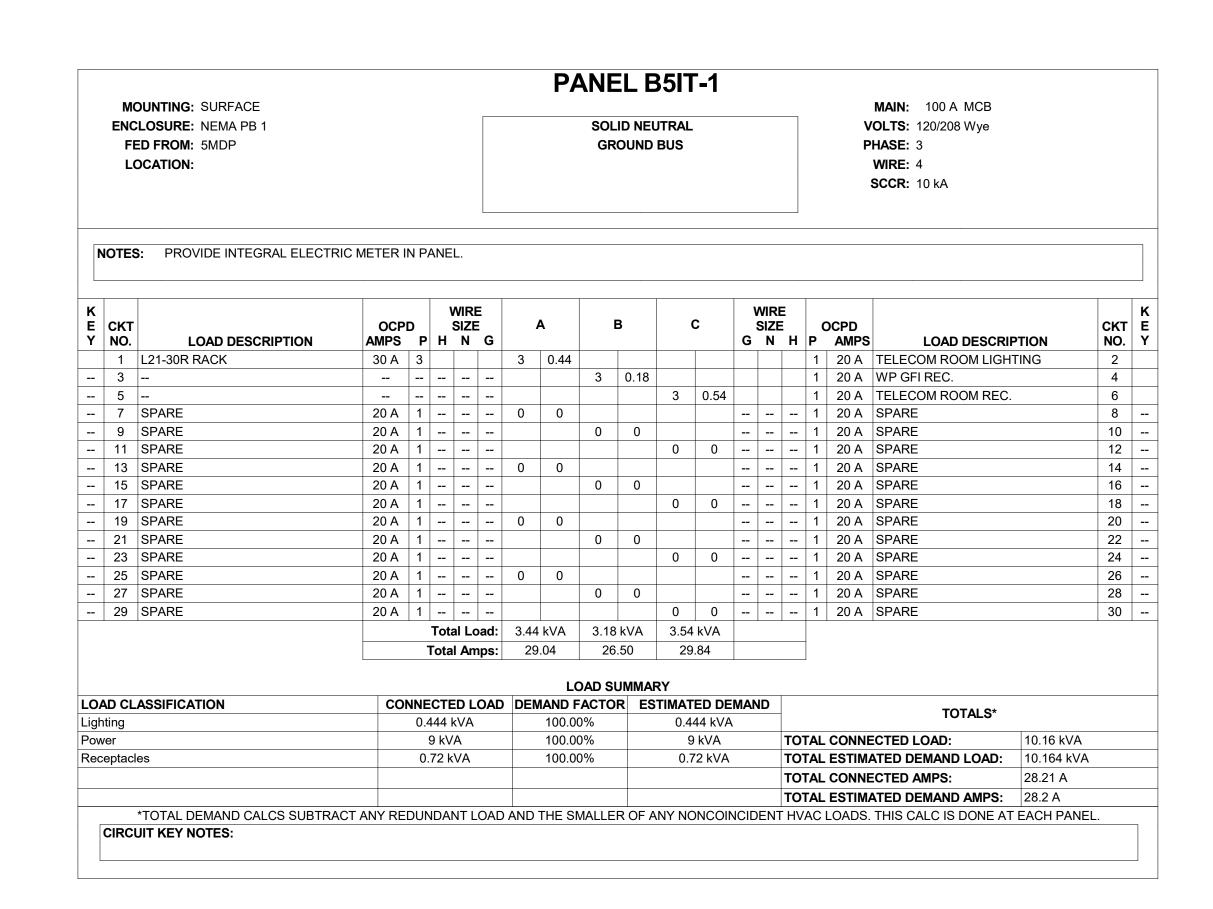

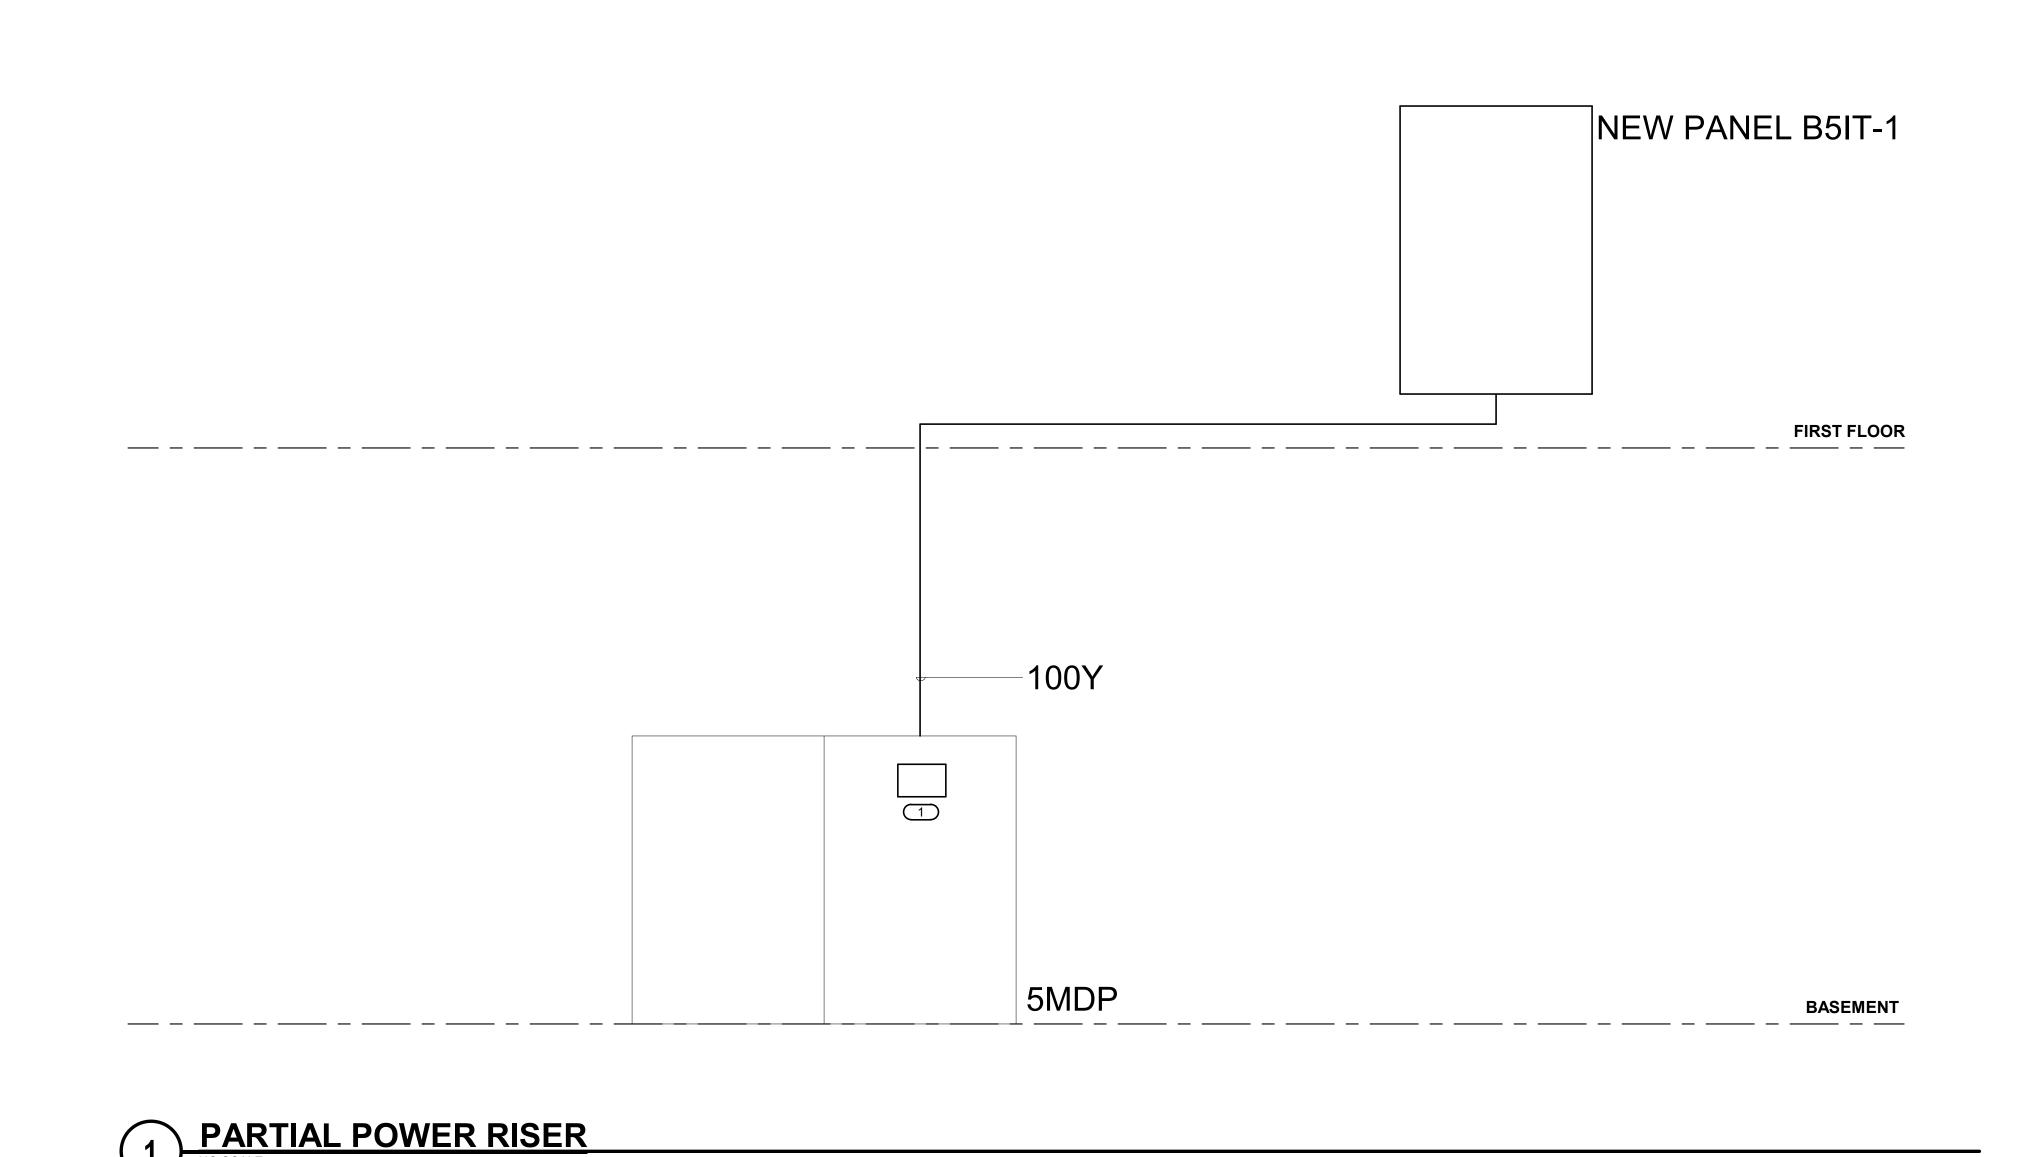

1 2 8

CONSULTANT

SPECIALIZED
ENGINEERING
SOLUTIONS

100% CD
No REVISION

DATE

CONSULTANT

SPECIALIZED
ENGINEERING
SOLUTIONS
Phone: 402.991.5520
www.specializedeng.com

ARCHITECT/ENGINEER OF RECORD

AND ERSON


13605 1st Ave. N. #100 Plymouth, MN 55441
P 763.412.4000 | F 763.412.4090 | ae-mn.com

Anderson Engineering of Minnesota, LLC | Proj # 16305

STAMP

ELECTRICAL DIAGRAMS & SCHEDULES

VA MEDICAL CENTER ST.CLOUD, MN 56303

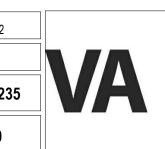



PANEL B5IT-1 **MOUNTING:** SURFACE MAIN: 100 A MCB **ENCLOSURE**: NEMA PB 1 **SOLID NEUTRAL** VOLTS: 120/208 Wye FED FROM: 5MDP **GROUND BUS** PHASE: 3 LOCATION: WIRE: 4 SCCR: 10 kA NOTES: PROVIDE INTEGRAL ELECTRIC METER IN PANEL. WIRE SIZE A B C SIZE OCPD G N H P AMPS LOAD DESCRIPTION E CKT Y NO. CKT E NO. Y LOAD DESCRIPTION 1 L21-30R RACK 1 L21-30R RACK
-- 3 --- 5 --- 7 TELECOM ROOM REC.
9 CU-5-1
-- 11 --- 13 SPARE
-- 15 SPARE
-- 17 SPARE
-- 19 SPARE
-- 19 SPARE
-- 21 SPARE
-- 23 SPARE 1 20 A TELECOM ROOM LIGHTING - 23 SPARE -- 25 SPARE -- 27 SPARE -- 29 SPARE **Total Load:** 7.08 kVA 7.18 kVA 7.89 kVA **Total Amps:** 59.00 59.96 65.87 LOAD SUMMARY LOAD CLASSIFICATION CONNECTED LOAD DEMAND FACTOR ESTIMATED DEMAND TOTALS* 0.889 kVA 100.00% 0.889 kVA 20 kVA 100.00% TOTAL CONNECTED LOAD: 20 kVA 22.15 kVA Receptacles 1.26 kVA 100.00% 1.26 kVA TOTAL ESTIMATED DEMAND LOAD: 22.149 kVA TOTAL CONNECTED AMPS: 61.48 A TOTAL ESTIMATED DEMAND AMPS: 61.5 A *TOTAL DEMAND CALCS SUBTRACT ANY REDUNDANT LOAD AND THE SMALLER OF ANY NONCOINCIDENT HVAC LOADS. THIS CALC IS DONE AT EACH PANEL. CIRCUIT KEY NOTES:

CONSULTANT

SPECIALIZED
ENGINEERING
SOLUTIONS

100% CD
REVISION
DATE

CONSULTANT

SPECIALIZED
ENGINEERING
SOLUTIONS
Phone: 402.991.5520
www.specializedeng.com

ARCHITECT/ENGINEER OF RECORD

AND ERSON

13605 1st Ave. N. #100 Plymouth, MN 55441
P 763.412.4000 | F 763.412.4090 | ae-mn.com

Anderson Engineering of Minnesota, LLC | Proj # 16305

I hereby certify that this plan, specification or report was prepared by me or under my direct supervision and that I am a duly Licensed Engineer under the laws of the State of Minnesota.

PROFESSIONAL


Date: 03/39/2022

License Number: MN# 53095

1 2 8

ELECTRICAL SCHEDULES

VA MEDICAL CENTER ST.CLOUD, MN 56303

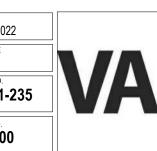



FIELD VERIFICATION NOTES


ARCHITECT FOR DIRECTION.

1. THE HVAC CONTRACTOR SHOULD VISIT THE SITE PRIOR TO BID TO FIELD VERIFY ALL EXISTING CONDITIONS WHICH MAY AFFECT THEIR BID. THE FOLLOWING ITEMS SHALL BE VERIFIED:

- A. EXACT PLACEMENT, SIZE, CAPACITY, MANUFACTURER AND CONDITION OF ALL EXISTING HVAC EQUIPMENT WITHIN SCOPE OF WORK, WHETHER EXPLICITLY SHOWN OR NOT.
- B. SIZE AND LOCATION OF ALL EXISTING DUCTWORK.
- C. SIZE AND LOCATION OF ALL EXISTING GRILLES, REGISTERS AND DIFFUSERS.
- D. SIZE AND LOCATION OF ALL EXISTING THERMOSTATIC CONTROL DEVICES.
- E. SIZE AND LOCATION OF ALL EXISTING PLUMBING AND HYDRONIC PIPING.
- 2. ALL REFERENCES ON THESE DRAWINGS TO EXISTING EQUIPMENT, DUCTWORK, DIFFUSERS, THERMOSTATS AND PIPING ARE FOR REFERENCE ONLY. IT IS THE RESPONSIBLITY OF THE CONTRACTOR TO VERIFY ALL THESE ITEMS PRIOR TO BID AND INCLUDE IN THEIR BID ANY AND ALL AMOUNTS REQUIRED TO ACCOMMODATE EXISTING CONDITIONS.
- 3. NO ALLOWANCES WILL BE MADE AFTER THE PROJECT HAS BEEN AWARDED FOR FAILURE TO VERIFY EXISTING CONDITIONS.
- 4. ANY DISCREPANCIES WHICH MAY AFFECT THE CONTRACTORS BID SHALL BE BROUGHT TO THE ATTENTION OF THE ENGINEER AND

KEYNOTES 1/05-M101:

- REMOVE AND DISPOSE OF EXISTING BASEBOARD FIN-TUBE RADIATION AND CABINET. CAP PIPES IN WALL.
- 2. EXISTING RA GRILLE AND SA DIFFUSER TO REMAIN.
- 3. EXISTING THERMOSTAT TO REMAIN.
- 4. EXISTING FIRE SPRINKLER HEAD TO REMAIN.

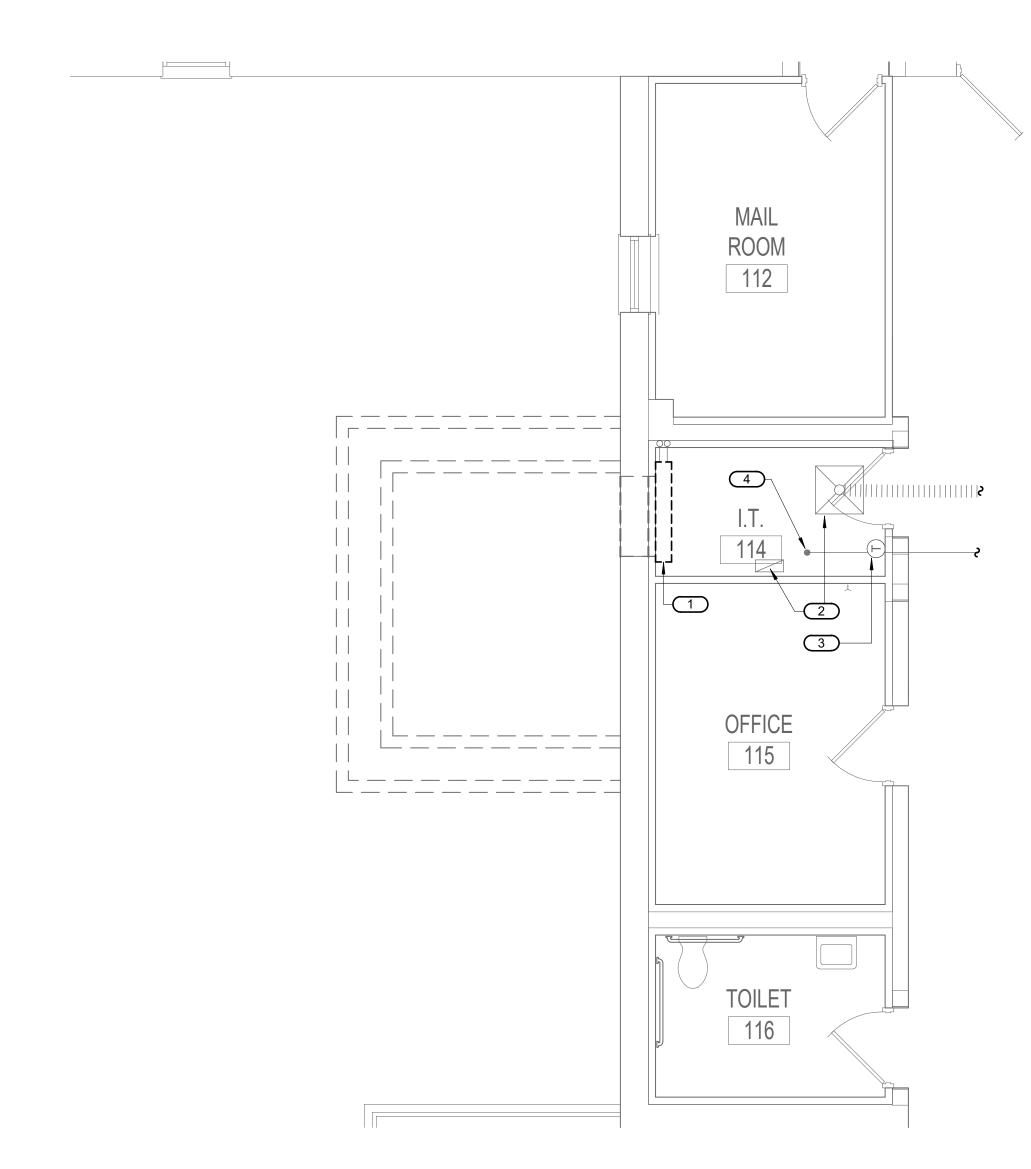

1 2 8






100% CD 03/3 0 No REVISION DATE





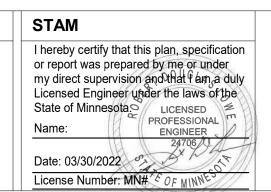



EHRM
INFRASTRUCTURE
UPGRADES

VA MEDICAL CENTER ST.CLOUD, MN 56303


BUILDING No

DATE: 03/30/2022
PLOT SCALE

PROJECT NO. 656-21-23

CHECKED BY RDL DRAWN DRAWING NO. 05-M101



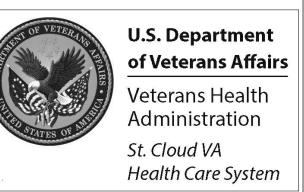


FIELD VERIFICATION NOTES

1. THE HVAC CONTRACTOR SHOULD VISIT THE SITE PRIOR TO BID TO FIELD VERIFY ALL EXISTING CONDITIONS WHICH MAY AFFECT THEIR BID. THE FOLLOWING ITEMS SHALL BE VERIFIED:

- A. EXACT PLACEMENT, SIZE, CAPACITY, MANUFACTURER AND CONDITION OF ALL EXISTING HVAC EQUIPMENT WITHIN SCOPE OF WORK, WHETHER EXPLICITLY SHOWN OR NOT.
- B. SIZE AND LOCATION OF ALL EXISTING DUCTWORK.
- C. SIZE AND LOCATION OF ALL EXISTING GRILLES, REGISTERS AND DIFFUSERS.
- D. SIZE AND LOCATION OF ALL EXISTING THERMOSTATIC CONTROL DEVICES.
- E. SIZE AND LOCATION OF ALL EXISTING PLUMBING AND HYDRONIC PIPING.
- 2. ALL REFERENCES ON THESE DRAWINGS TO EXISTING EQUIPMENT, DUCTWORK, DIFFUSERS, THERMOSTATS AND PIPING ARE FOR REFERENCE ONLY. IT IS THE RESPONSIBLITY OF THE CONTRACTOR TO VERIFY ALL THESE ITEMS PRIOR TO BID AND INCLUDE IN THEIR BID ANY AND ALL AMOUNTS REQUIRED TO ACCOMMODATE EXISTING CONDITIONS.
- 3. NO ALLOWANCES WILL BE MADE AFTER THE PROJECT HAS BEEN AWARDED FOR FAILURE TO VERIFY EXISTING CONDITIONS.
- 4. ANY DISCREPANCIES WHICH MAY AFFECT THE CONTRACTORS BID SHALL BE BROUGHT TO THE ATTENTION OF THE ENGINEER AND ARCHITECT FOR DIRECTION.


KEYNOTES 1/05-M201:


- 1. EXISTING RA GRILLE AND SA DIFFUSER TO REMAIN.
- 2. EXISTING THERMOSTAT TO REMAIN.
- 3. NEW WALL-MOUNTED COOLING UNIT AC-5-1.
- 4. ROUTE NEW REFRIGERANT PIPING TO CU-5-1 UNIT ON GRADE.
- 5. NEW AIR COOLED CONDENSING UNIT ON GRADE. PROVIDE NEW CONCRETE PAD.
- EXISTING FIRE SPRINKLER HEAD TO BE REMAIN.
- 7. NEW FIRE SPRINKLER HEAD. TIE INTO SPRINKLER MAIN IN CORRIDOR. FIELD VERIFY EXACT LOCATION.
- 8. NEW THERMOSTAT WIRE AS COMMON TO BOTH NEW AC UNIT AND NEW CUH.
- NEW HYDRONIC CABINET UNIT HEATER. REFERE TO DETAIL
- 10. RE-ROUTE EXISTING HEATING WATER PIPING TO SERVE NEW CUH. FIELD VERIFY REQUIREMENTS.
- 11. PIPE CONDENSATE TO MOP SINK LOCATED IN HAC ROOM, APPROX. 120 FEET NORTHEAST.
- 12. TIE NEW HEATING PIPING INTO EXISTING CAPPED LINES. FIELD VERIFY REQUIREMENTS. FIELD VERIFY PIPE SIZES AND LOCATIONS.
- 13. PROVIDE CONDENSATE DRIP PANS FOR ALL CONDENSATE PIPING.
- 14. REFER TO 3/0-GM401 FOR UNIT MOUNTING DETAIL.
- 15. REFERE TO 4/0-GM401 FOR WALL PENETRATION SEALING DETAIL.

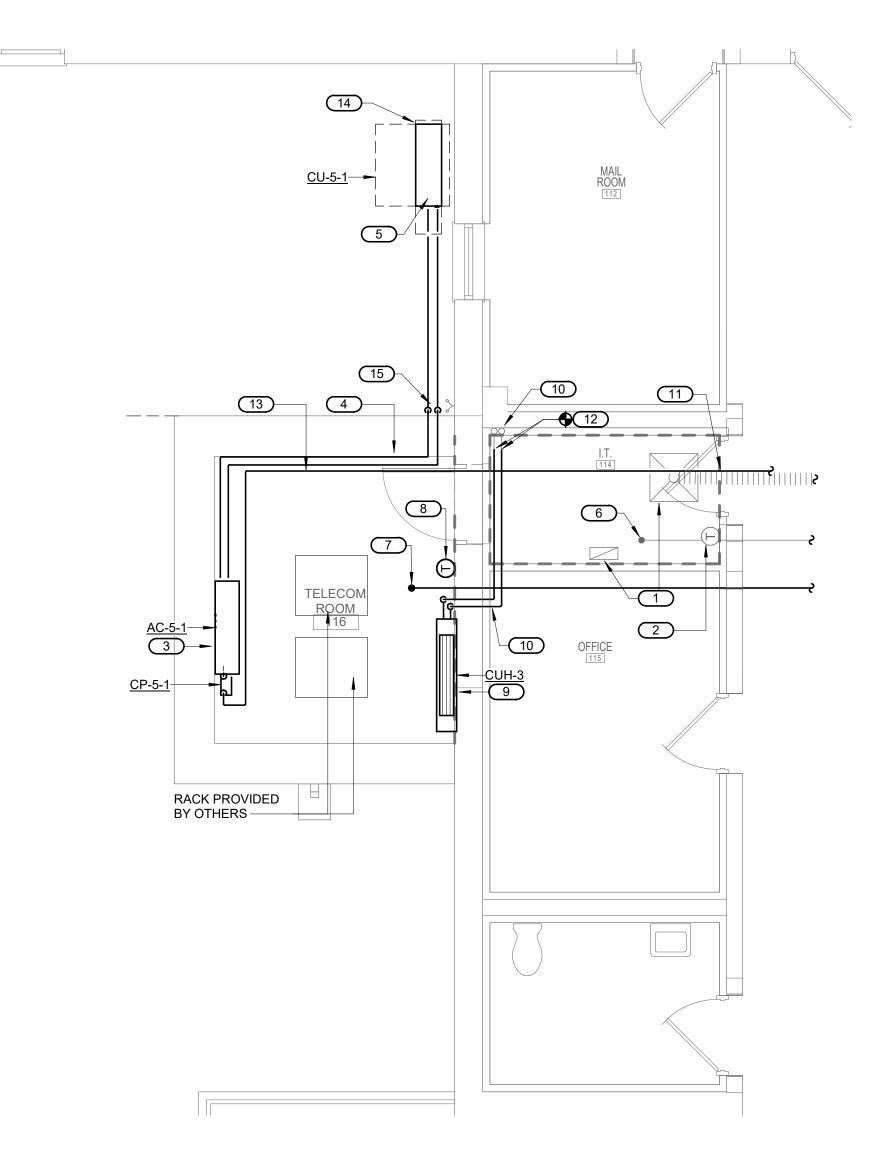




5 9

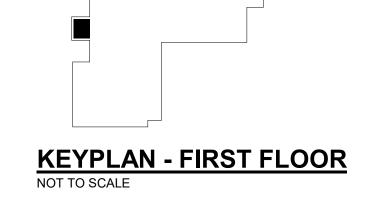


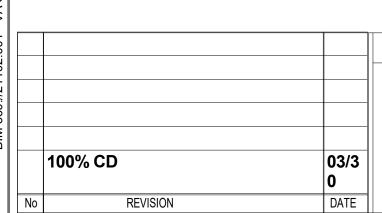




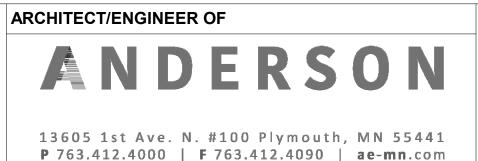

Anderson Engineering of Minnesota, LLC | Proj # 16305

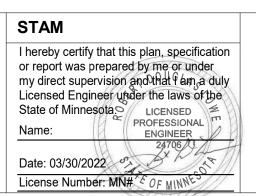



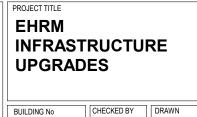

VA MEDICAL CENTER ST.CLOUD, MN 56303

RDL DJC



