




TYP MTL STUD PUNCHOUT REINFORCING

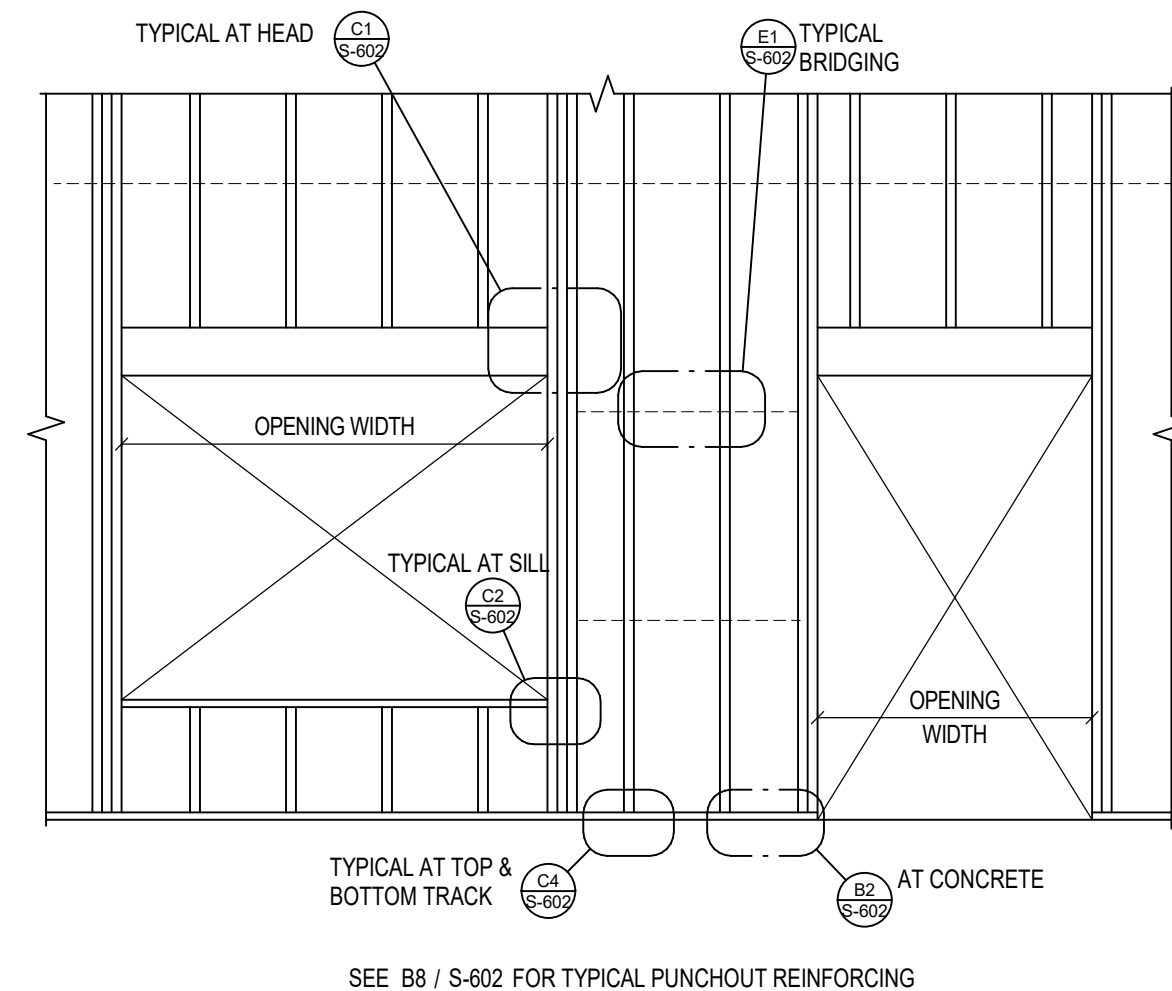

TYP MTL STUD WALL FRAMING

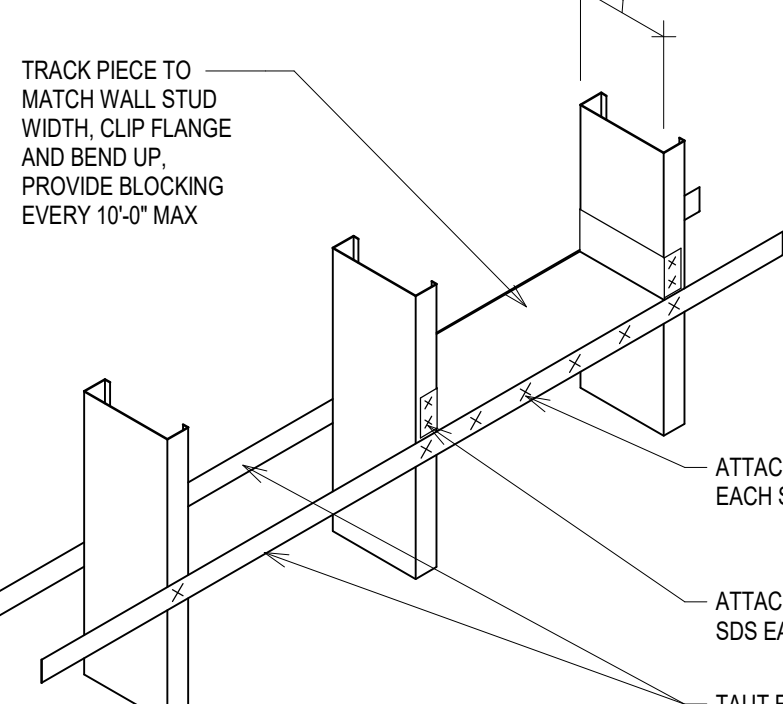

SCALE: 1" = 1'-0"

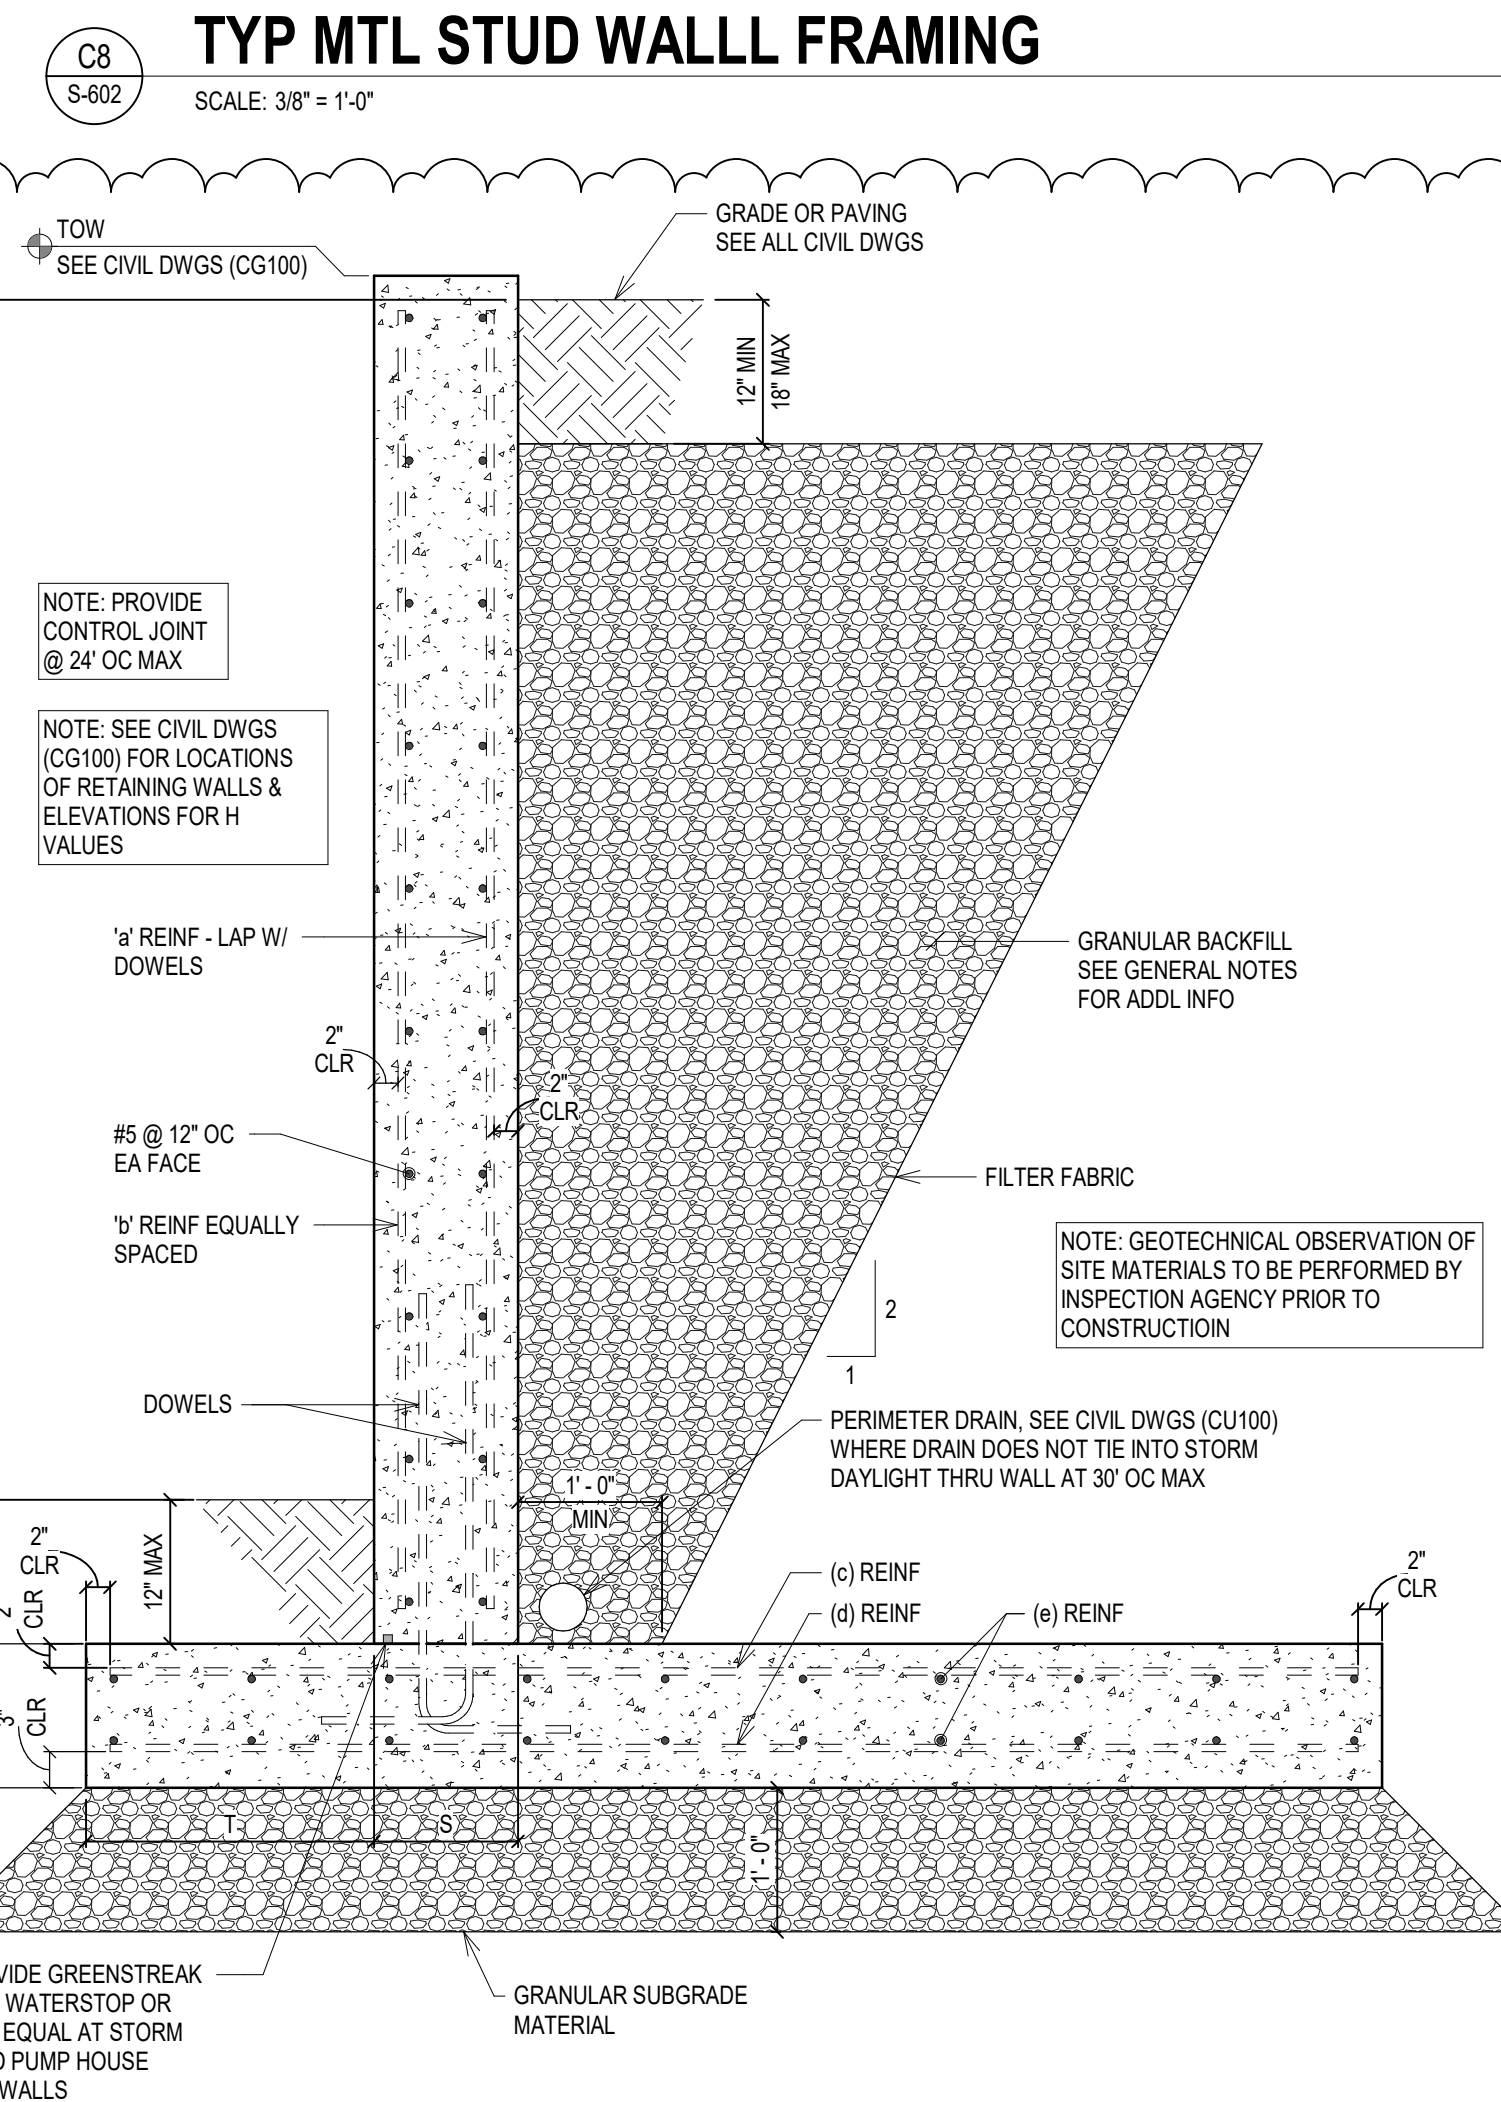

SCALE: $\frac{3}{4}" = 1'-0"$

SITE RETAINING WALL SCHEDULE			
	H5 ⁴	4' ⁴ H5 ⁶	
L	3'-0"	6'-0"	
T	1'-0"	1'-0"	
S	8"	8"	
D	12"	12"	
(a) REIN	#5 @ 16"	#5 @ 16"	
(b) REIN	-	-	
(c) REIN	-	-	
(d) REIN	#5 @ 12"	#5 @ 8"	
(e) REIN	#5 @ 12"	#5 @ 12"	
DOWELS	(1)	(1)	
1 (MN)	20 ²⁵	20 ²⁵	
2	8"	8"	

ADDITIONAL REMARKS:

1. DOWELS TO MATCH VERT REBAR.
2. AT CONTRACTOR'S OPTION, EXTEND DOWEL TO TOP OF WALL AND OMIT (a) REINFORCING.

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1. DOWELS TO MATCH VERT REBAR.
2. AT CONTRACTOR'S OPTION, EXTEND DOWEL TO TOP OF WALL AND OMIT (a) REINFORCING.

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575 MINNEHAHA AVE WEST
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 Department of
Veterans Affairs

D1
SF101
FLOOR FRAMING PLAN - 1ST LEVEL
SCALE: 1/8" = 1'-0"

SCHEDULES

SHEAR TAB CONNECTION SCHEDULE


BEAM	HEIGHT	THICKNESS	3/4"Ø A325N BOLTS	WELD SIZE TO COL
W8	5 1/2"	3/8"	2	5/16" FILLET
W12 & 14	8 1/2"	3/8"	3	5/16" FILLET
W16	11 1/2"	3/8"	4	5/16" FILLET
W18	14 1/2"	3/8"	5	5/16" FILLET
W21	17 1/2"	3/8"	6	5/16" FILLET
W27	23 1/2"	3/8"	8	3/8" FILLET

DOUBLE ANGLE CONNECTION SCHEDULE

BEAM	3/4"Ø A325N BOLTS F1852	CONNECTION ANGLES		ALTERNATE WELD TO BM SIZE (SHOP WELD ONLY)
		LENGTH	THICKNESS	
W8	2	5 1/2"	5/16"	1/4" FILLET
W12 & 14	3	8 1/2"	3/8"	1/4" FILLET
W16	4	11 1/2"	3/8"	5/16" FILLET
W18	5	14 1/2"	3/8"	5/16" FILLET
W21	6	17 1/2"	3/8"	5/16" FILLET
W27	8	23 1/2"	3/8"	5/16" FILLET

ADDITIONAL REMARKS:


- USE E70XX ELECTRODES.
- SIZE & NUMBER OF BOLTS INTO SUPPORTING MEMBER TO BE TWICE THE NUMBER OF BOLTS INTO THE BEAM & OF THE SAME SIZE.
- PROVIDE TEMPORARY SUPPORT AS REQUIRED TO INSTALL JOIST BEAMS ON EITHER SIDE OF GIRDER BEAMS.
- " INDICATES A 9' LONG ALL WELDED DOUBLE ANGLE CONNECTION TO BE USED, BOLTS MAY BE USED FOR ERECTION.
- " INDICATES A 6' LONG ALL WELDED DOUBLE ANGLE CONNECTION TO BE USED, BOLTS MAY BE USED FOR ERECTION.
- # INDICATES USING THE SMALLER BEAM DOUBLE ANGLE CONNECTION SIZE.

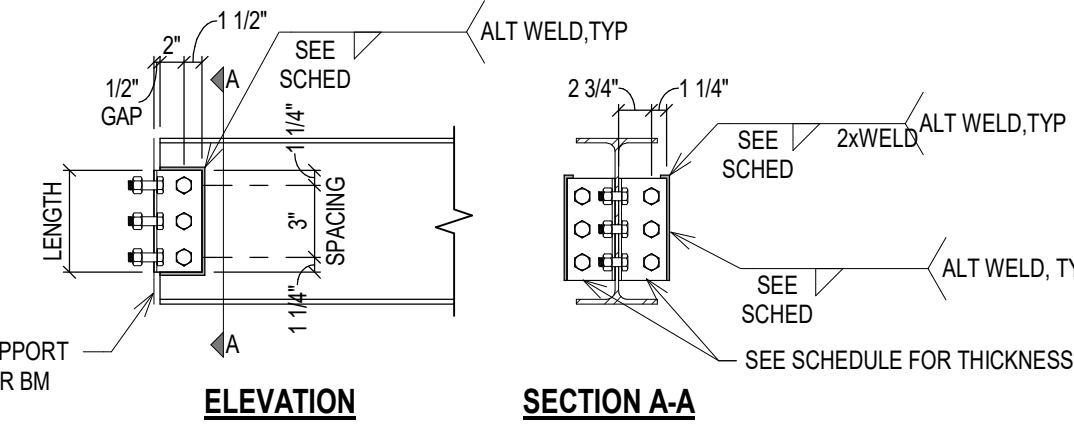

SHEET LEGEND

- W10X12 [X] DENOTES BEAM CALLOUT. [X] INDICATES NUMBER OF 3/4"Ø x 4" HSA SPACED EQUALLY OVER THE LENGTH OF THE BEAM BLW ELEVATED FLOOR SLAB, UNLESS NOTED OTHERWISE. HSA SPACING TO BE ADJUSTED WHERE GUSSET PLATE WELDS TO BEAM.
- 18' DENOTES LATERAL BRACED FRAME, SEE LATERAL BRACE ELEVATIONS AND DETAILS ON SHEET SERIES S-401 OR S-402.
- DENOTES FLOOR DRAIN IN SLAB, SEE MECH DWGS.

KEYPLAN

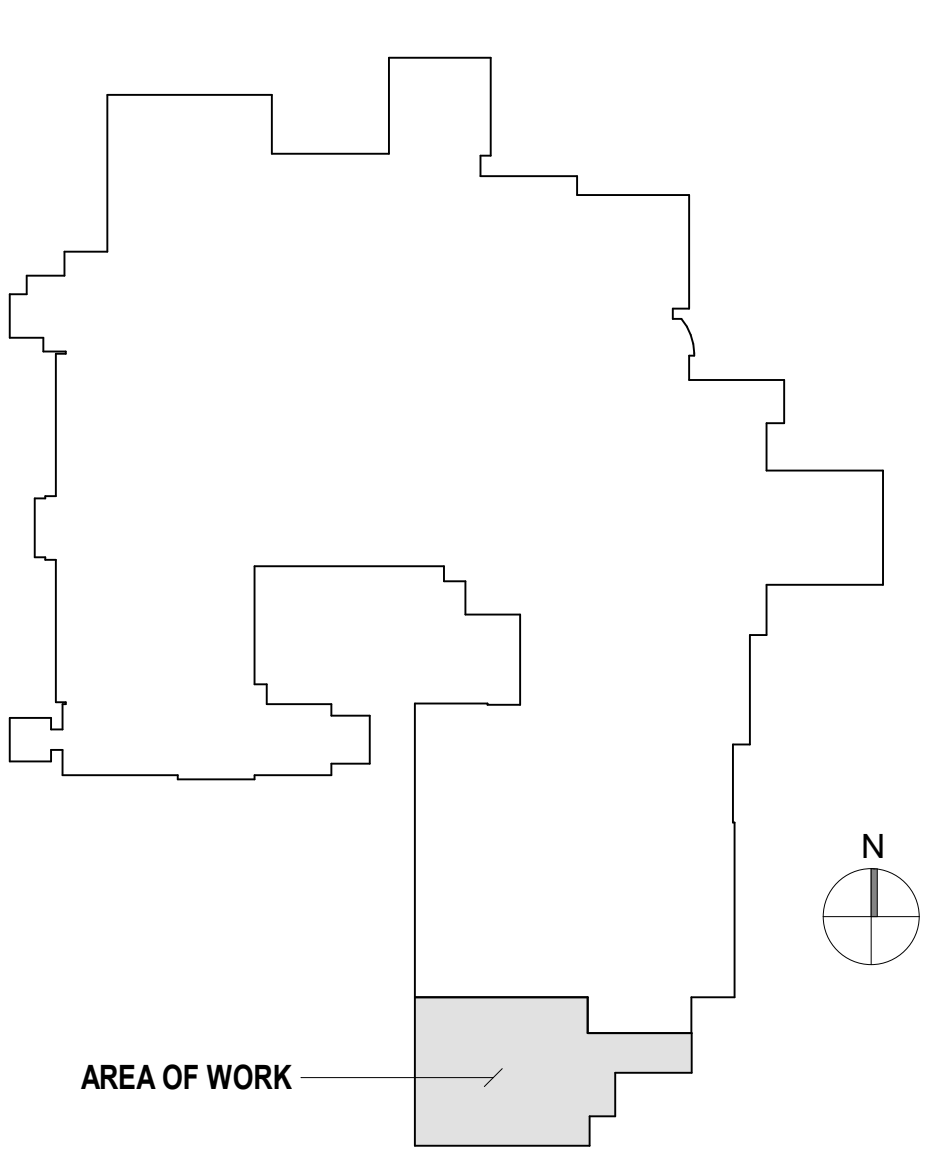

CONSTRUCTION DOCUMENTS

Revision Number Associated with Clouded Area:

ADDENDUM #1	01/04/23
Revisions:	Date

CONSULTANTS:

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Michael D. Albertson

REGISTERED PROFESSIONAL ENGINEER
PE-0261
DATE 11-16-21
NORTH DAKOTA

Drawing Title	FLOOR FRAMING PLAN LEVEL 01
Approved: Project Director	FARGO VAHCS

Project Title	EXPAND BLDG. 1 FOR PRIMARY CARE
Location	2101 ELM STREET FARGO, ND 58102
Date	11/16/2021
Checked	AJH
Drawn	MDR

Project Number	437-315
Building Number	1
Drawing Number	SF101
Dwg. 68 of	

Office of
Construction
and Facilities
Management

Department of
Veterans Affairs

