

PROJECT NAME:

## CONSTRUCT NEW SPS

SITE ADDRESS:

## 2501 WEST 22ND STREET. SIOUX FALLS, SD 57105

SIOUX FALLS, SD 57104

605.331.2505

2882 106TH STREET

DES MOINES, IA 50322

MECH/ELEC/PLUMB/FIRE ENGINEER:

CONTACT: Eric Henderson

VA PROJECT NUMBER:

VICINITY MAP:

hase Apartments

438-460

## OWNER AND CONSULTANTS:

605.336.3230 EX 7693 CIVIL ENGINEER: 13605 1ST AVE NORTH, SUITE 100 PLYMOUTH, MN 55441

LANDSCAPE ARCHITECTURE:


Great Plains Zoo & 👩

PHONE: 763-412-4000


13605 1ST AVE NORTH, SUITE 100 PLYMOUTH, MN 55441

EDWIN BRODMARKLE

SITE LOCATION MAP:

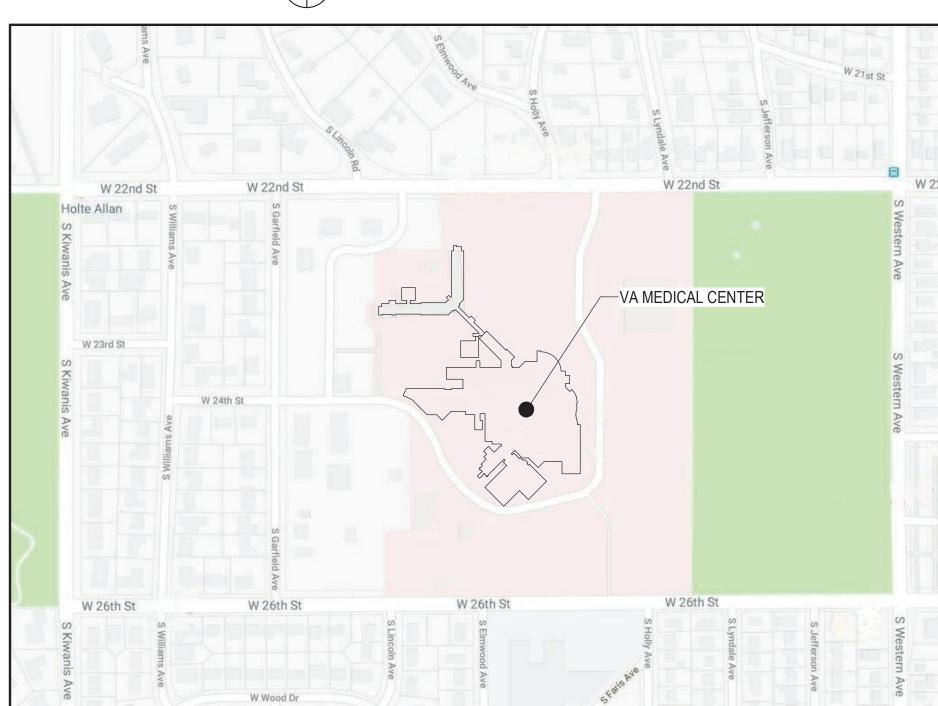

KEY PLAN:

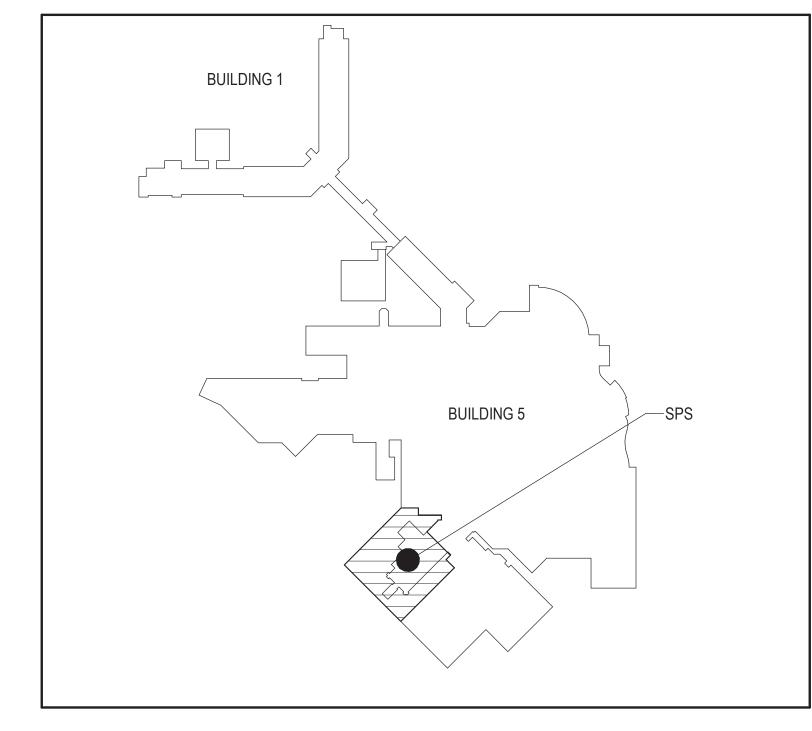

		CONSULTANT
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Revisions:	Date:	


Cinemark Century Stadium 14

Meadowbrook 6

The Country Club of Sioux Falls

Apartments, Sioux...


ARCHITECT/ENGINEER OF RECORD | STAMP ANDERSON 13605 1st Ave. N. #100 Plymouth, MN 55441 P 763.412.4000 | F 763.412.4090 | ae-mn.com Anderson Engineering of Minnesota, LLC | Proj # 16584

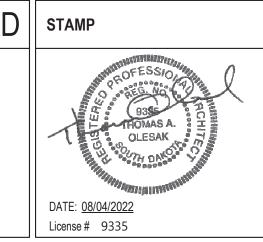



Office of Construction and Facilities Management U.S. Department of Veterans Affairs

Drawing Title **COVER SHEET** 

Project Number 438-460 CONSTRUCT NEW SPS **BID DOCUMENTS Building Number** Drawing Number Sioux Falls, SD. FULLY SPRINKLERED Checked GI000 08/04/2022 Checker Author

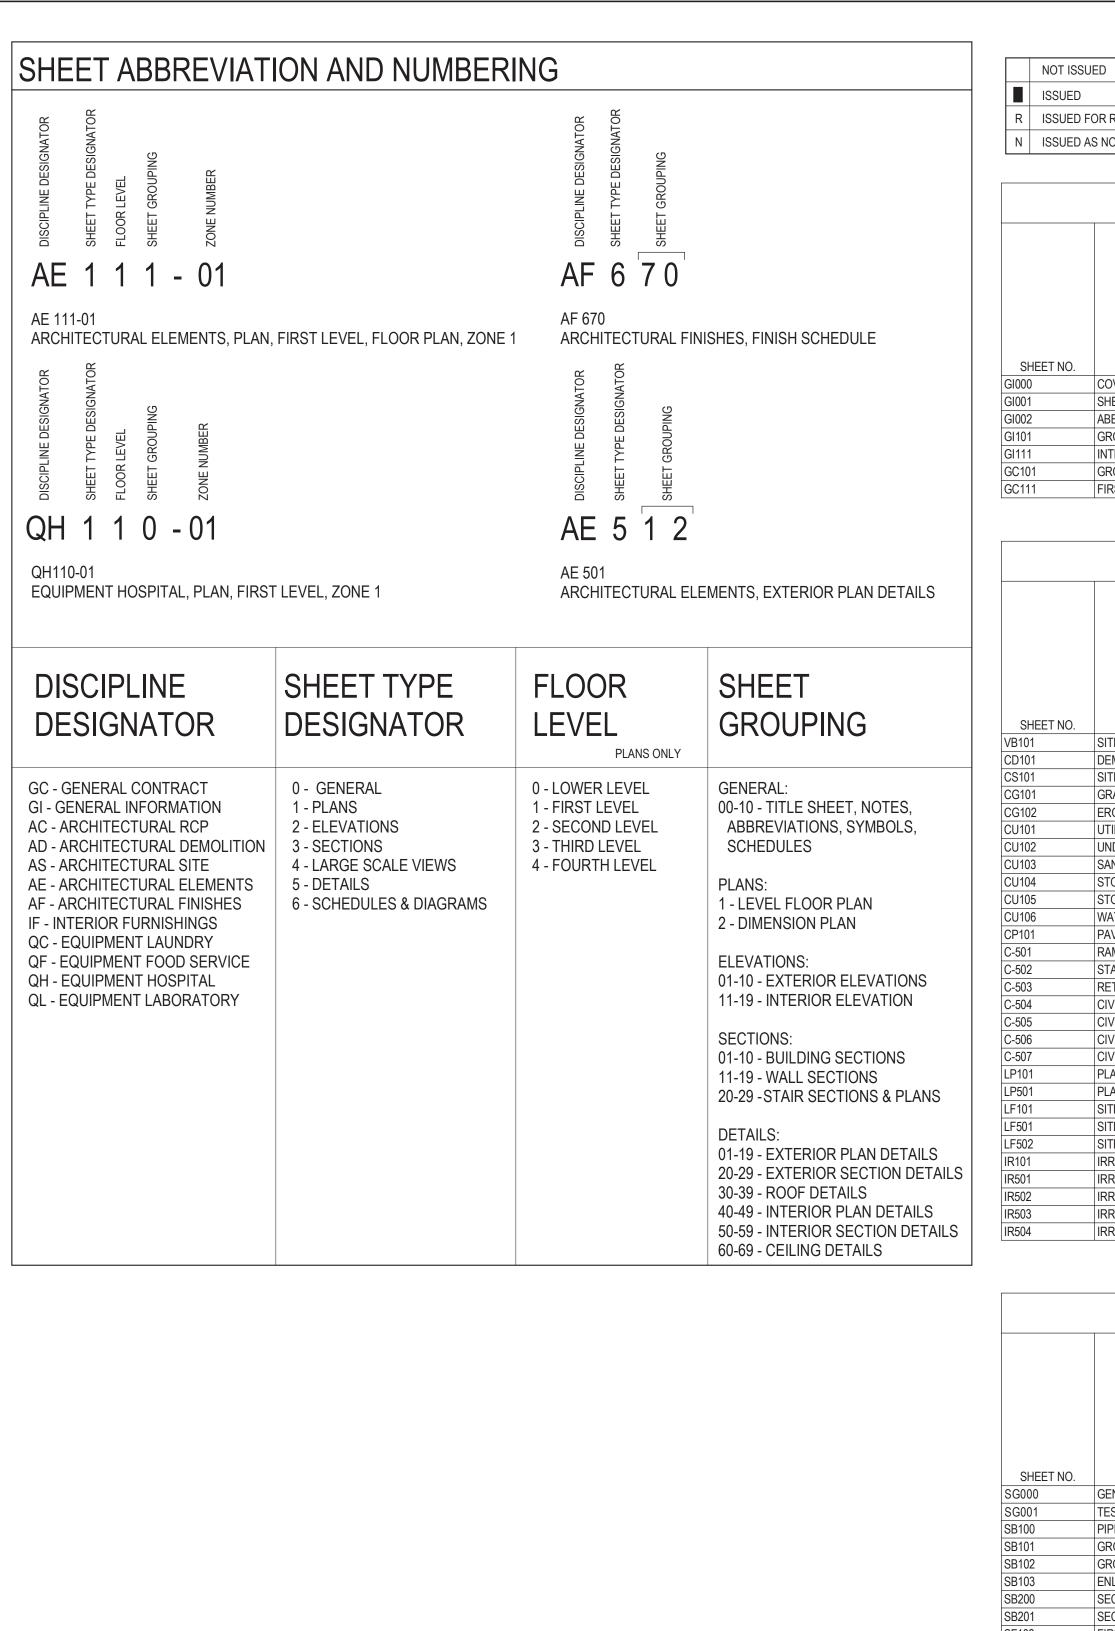

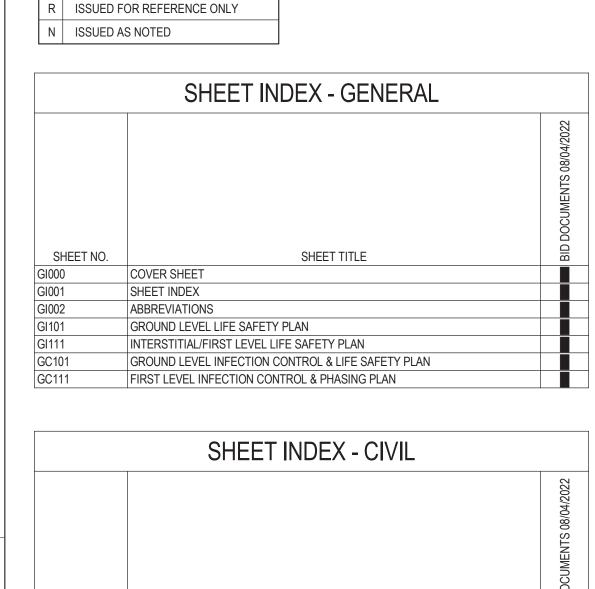

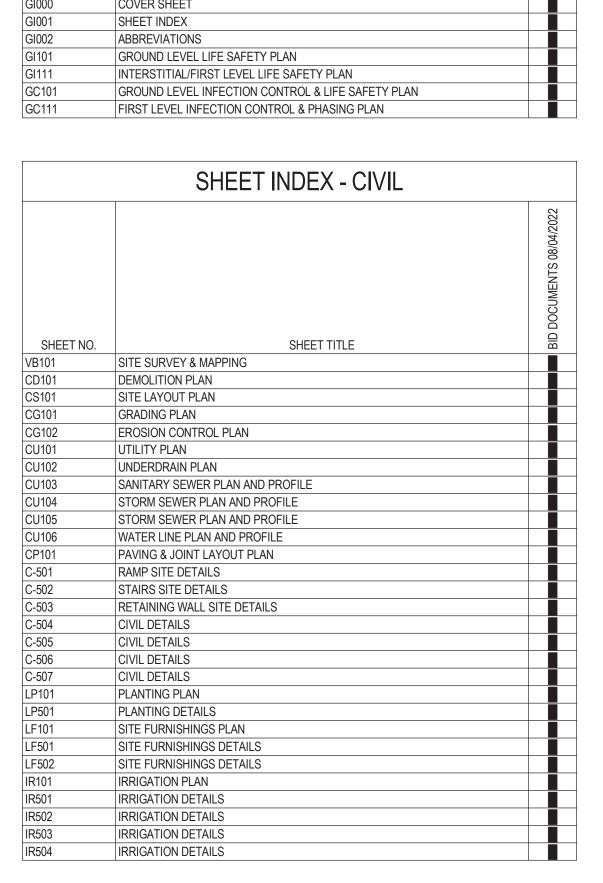

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SHEET TITLE

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ENLARGED PLANS SECTIONS - FOUNDATION SECTIONS - FOUNDATION

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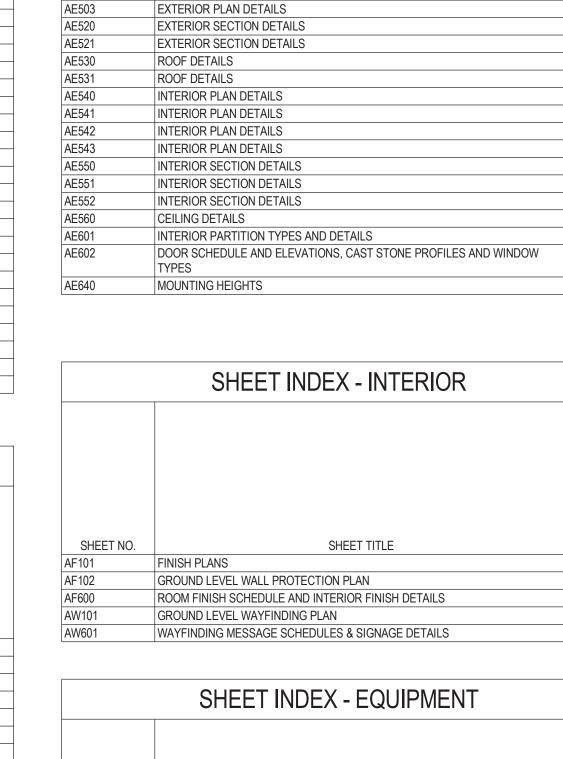
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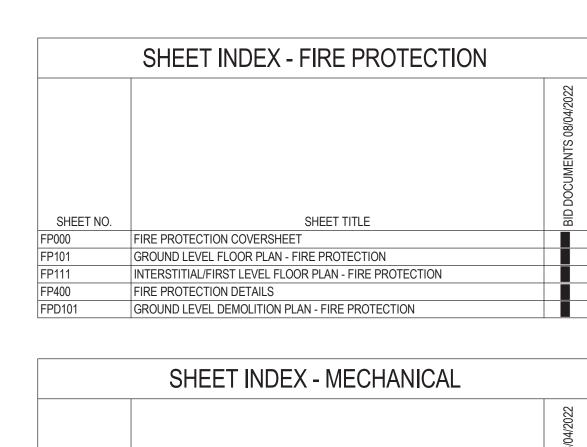
STAIR SECTIONS AND ENLARGED PLANS

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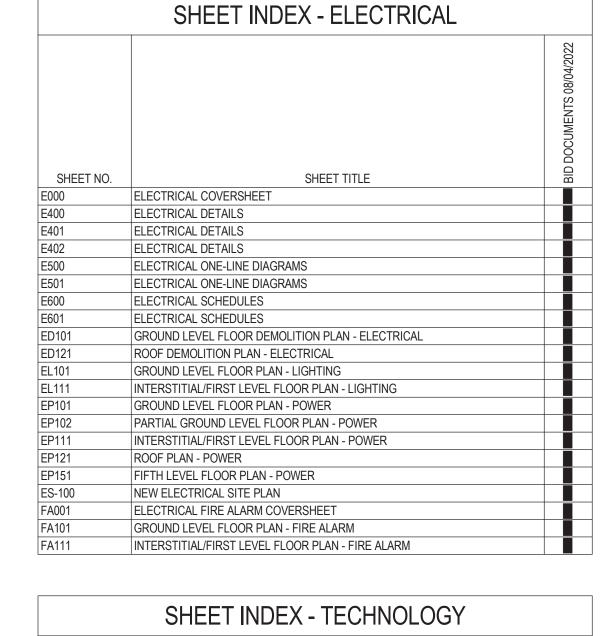
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STAIR SECTIONS - PARTITIONS AT EXISTING STAIR

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SHEET NO.

TECHNOLOGY COVERSHEET


TECHNOLOGY RISER DIAGRAMS


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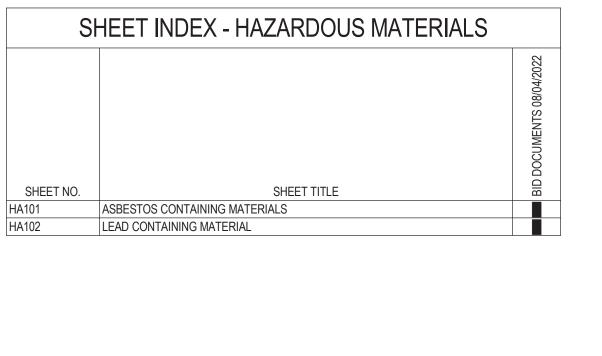
TECHNOLOGY DETAILS


GROUND LEVEL FLOOR PLAN - TECHNOLOGY

GROUND LEVEL FLOOR DEMOLITION PLAN - TECHNOLOGY



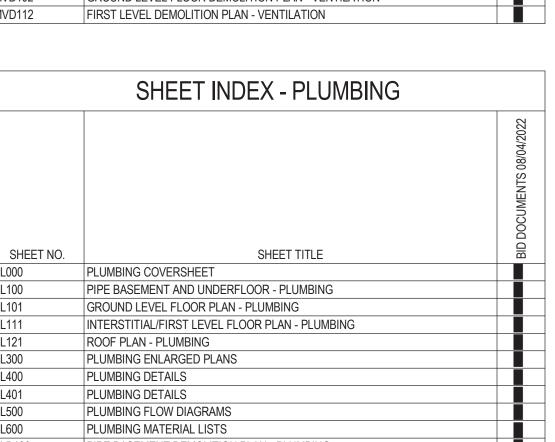

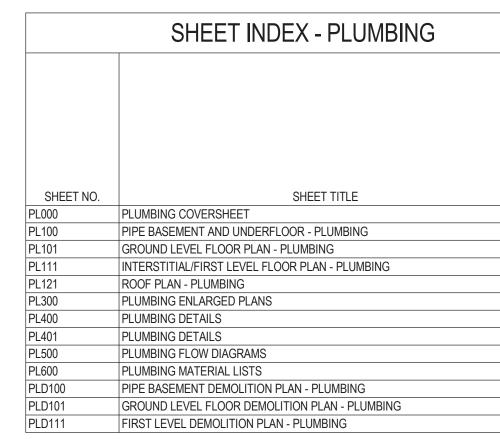

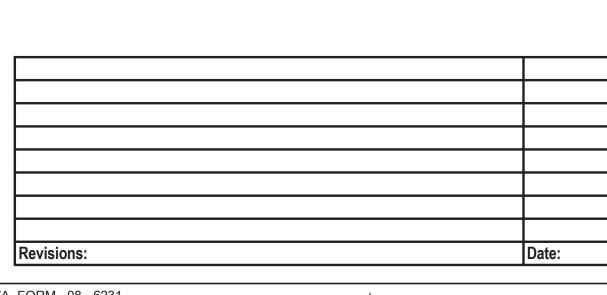




ARCHITECT/ENGINEER OF RECORD | STAMP

ANDERSON

13605 1st Ave. N. #100 Plymouth, MN 55441 P 763.412.4000 | F 763.412.4090 | ae-mn.com Anderson Engineering of Minnesota, LLC | Proj # 16584

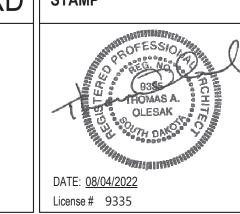





Drawing Title SHEET INDEX

$\neg$	Phase	Project Title			Project Number
	BID DOCUMENTS	CONSTRUC	CT NEW	SPS	438-460
	DID DOGGINEIVIO				Building Number  5
		Location Sioux Falls, SD.			Drawing Number
	FULLY SPRINKLERED	1ssue Date 08/04/2022	Checked Checker	Drawn Author	GI001

VA FORM 08 - 6231


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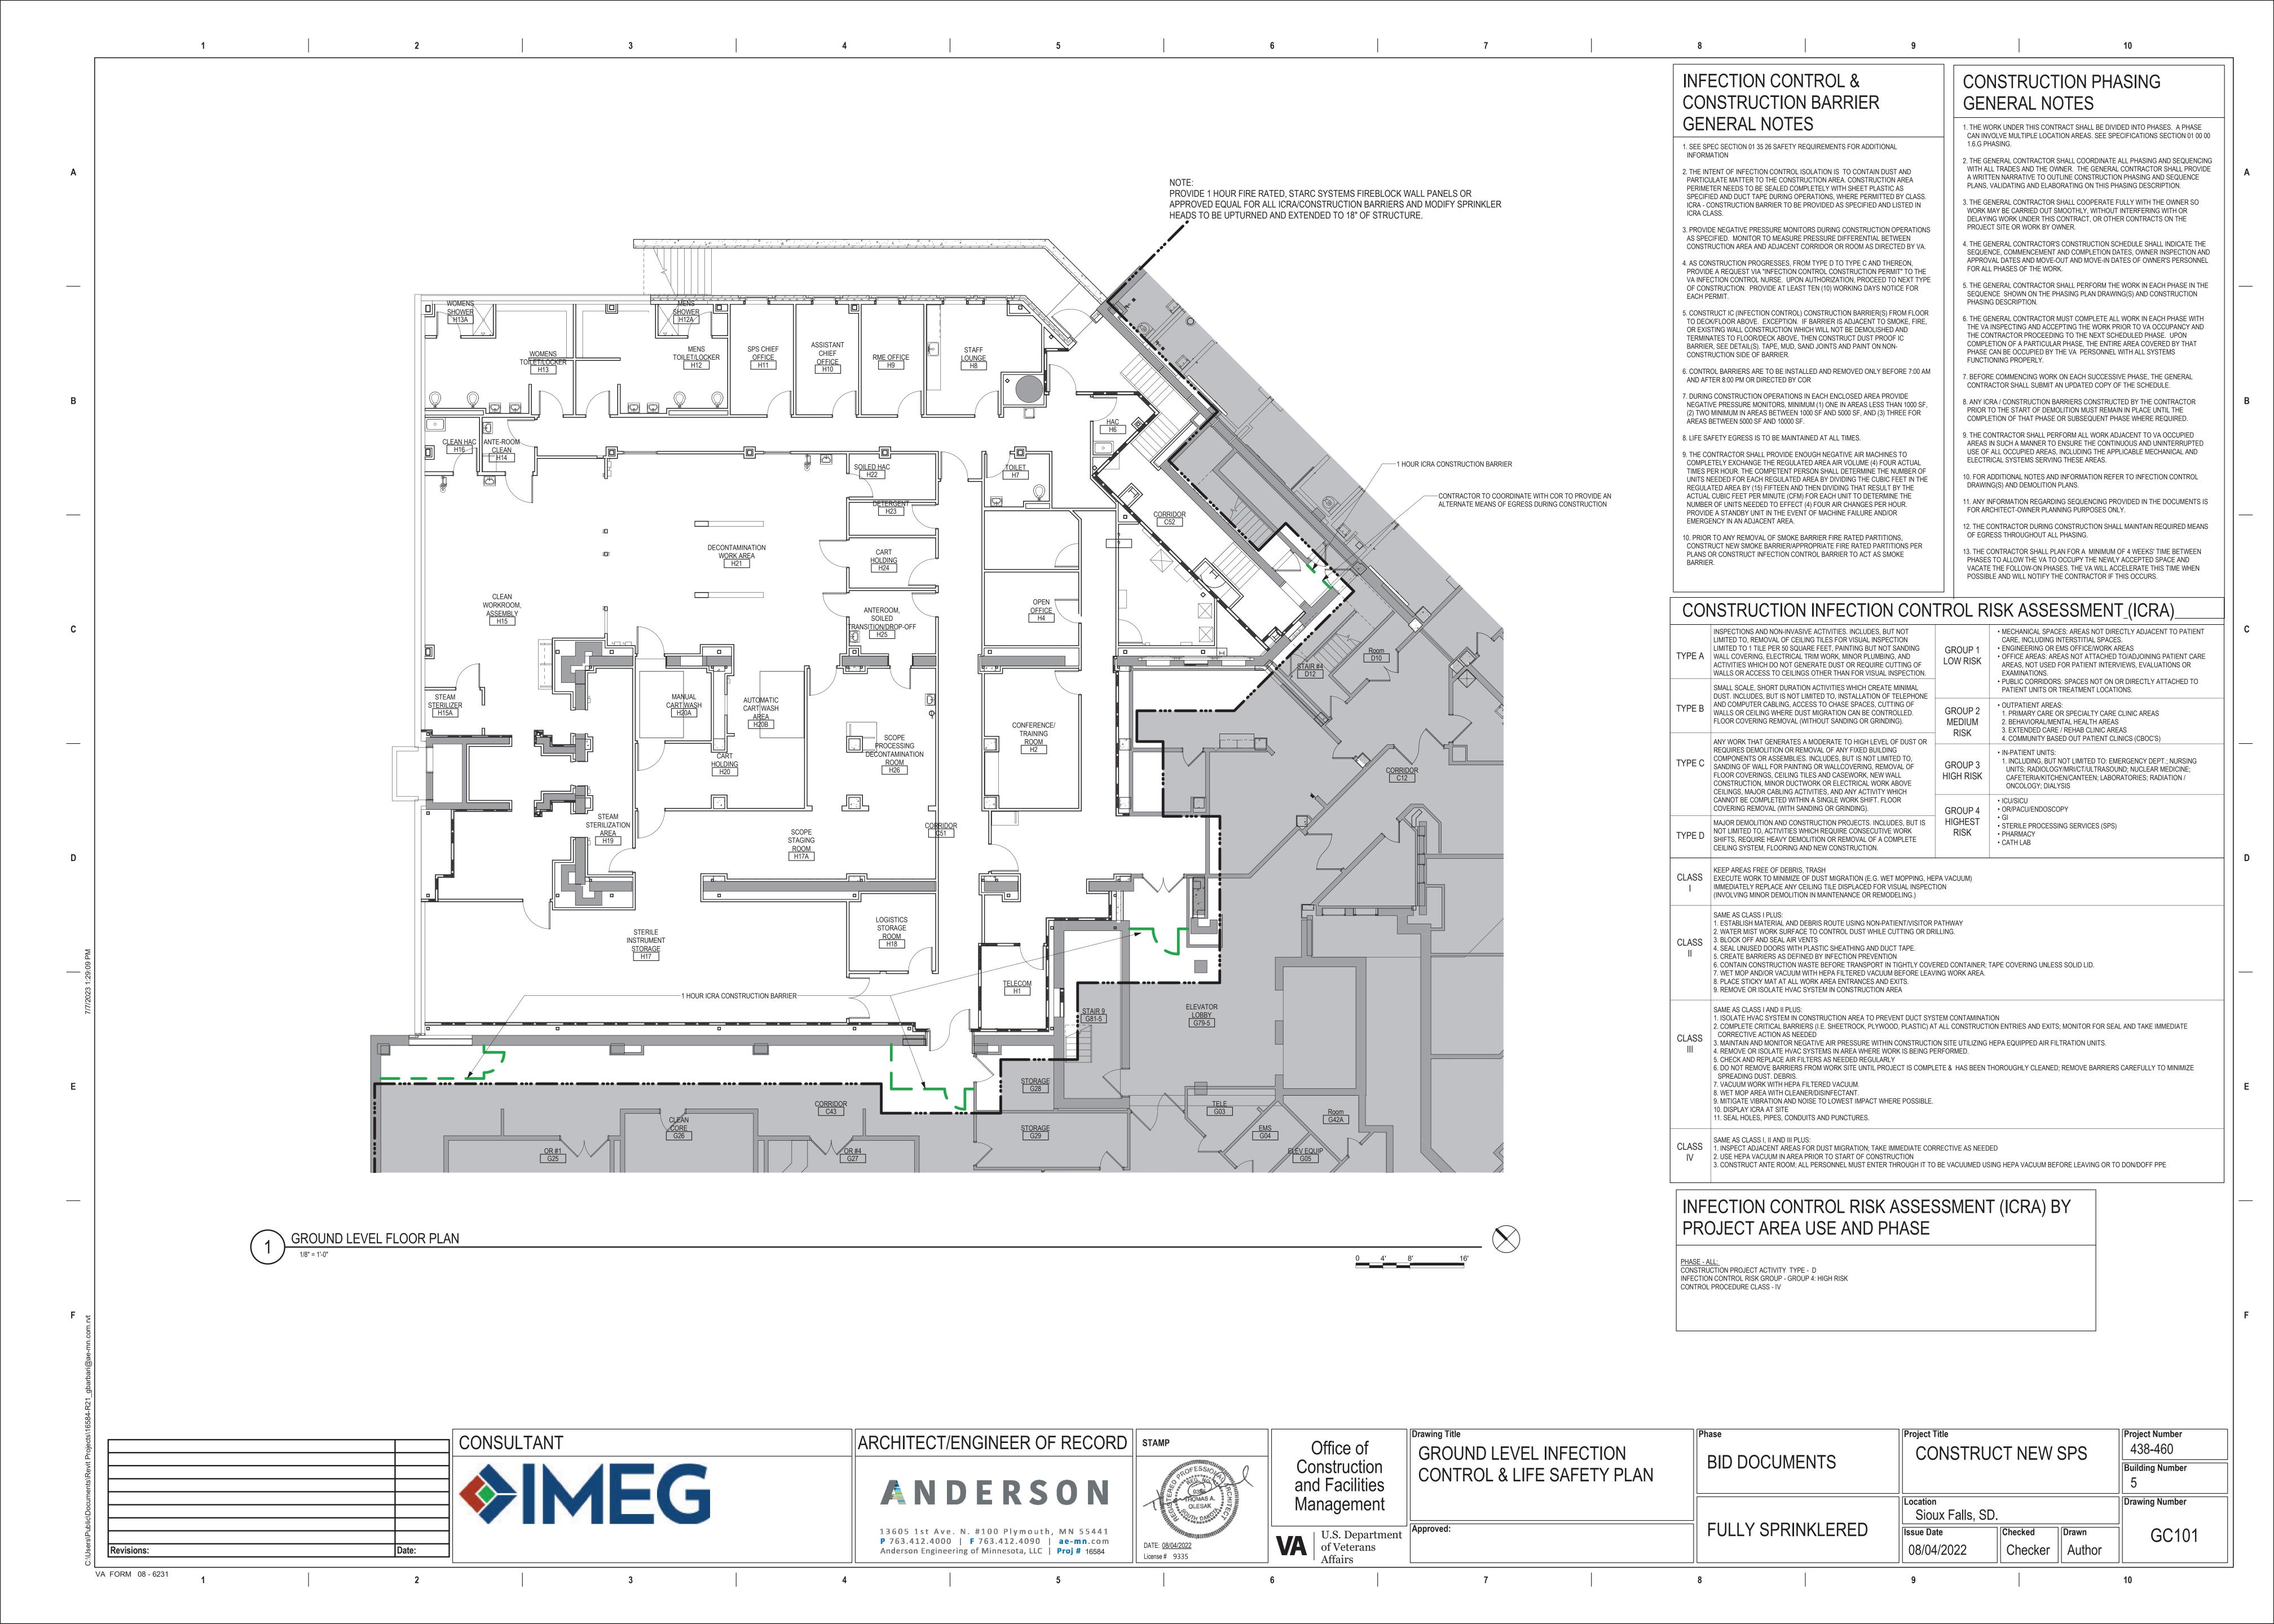
U.S. Department of Veterans Affairs


ARCHITECTURAL ABBREVIATIONS REMOTE CONTROL TREAD OR THERMOSTAT CNR CORNER HST HOIST FAHRENHEIT OR FEMALE NORTH CNTR COUNTER RCP REFLECTED CEILING PLAN T&M TIME AND MATERIALS AIR CONDITION FA HSS FIRE ALARM HOLLOW STRUCTURAL STEEL NOT APPLICABLE NA **RCVR** A/C UNIT AIR CONDITIONING UNIT **CRTP** COUNTERTOR RECEIVER **TOWEL BAR** HT **FABRIC** HEIGHT NAT NATURAL CO **TBD** TACK BOARD ARCHITECT/ENGINEER CARBON MONOXIDE ROAD OR ROOF DRAIN **FACTOR HVAC** HEATING, VENTILATING, AND AIR CONDITIONING NATL **NATIONAL** AMERICAN ARCHITECTURAL MANUFACTURERS ASSN CO2 **REC** TECH **TECHNICAL CARBON DIOXIDE** RECESSED HVY **FACIL FACILITY** HEAVY NOISE CRITERIA OR NURSE CALI AAP COL COLUMN RECD **RECEIVED** TELEPHONE ALARM ANNUNCIATOR PANEL FAS FASCIA HW **HOT WATER** NCOMBL NONCOMBUSTIBLE **RECEPTACLE** ANCHOR BOLT COM COMMON RECPT TEMP TEMPERATURE OR TEMPORARY FASCIA BOARD HYD HYDRANT NEC NATIONAL ELECTRICAL CODE COMB COMBINATION, COMBINED THERM ABC AGGREGATE BASE COURSE RECT **RECTANGLE** THERMAL FCU HYDF **HYDRAULIC FAN COIL UNIT** NEG **NEGATIVE** COMM ACC COMMUNICATION REF REFERENCE OR REFRIGERATOR THK **THICKNESS** ACCESSIBLE IAQ FCO FLOOR CLEANOUT INDOOR AIR QUALITY NEMA NATIONAL ELECTRICAL MANUFACTURERS ASSI COMP **THRESHOLD** AMERICAN CONCRETE INSTITUTE COMPONENT REFR REFRACTORY, REFRIGERATION THRES **FCTY** FACTORY INTERNATIONAL BUILDING CODE NEUT **NEUTRAL** ACT CONC CONCRETE THRU **THROUGH** ACOUSTICAL CEILING TILE REGISTER FLOOR DRAIN INFECTION CONTROL NFC NATIONAL FIRE CODE **CONC FLR** CONCRETE FLOOR **THRUOUT ACCESS DOOR** REINF REINFORCE THROUGHOUT FDC FIRE DEPARTMENT CONNECTION **ICW** INFECTION CONTROL WALL NFPA NATIONAL FIRE PROTECTION ASSOCIATION ACS FLR **ACCESS FLOOF** COND CONDENSER OR CONDITION REP REPAIR **TMPD** TEMPERED FDTN FOUNDATION INSIDE DIAMETER NOT IN CONTRACT CONF REPLACE ACS PNL ACCESS PANEL CONFERENCE TEMPERED GLASS FIRE EXTINGUISHER ID NO **IDENTIFICATION NUMBER** NO NUMBER **ACST** ACOUSTIC CONN CONNECT REQ REQUIRE TRUE NORTH FIRE EXTINGUISHER CABINET ILLUMINATION NOM NOMINAL AREA DRAIN **CONSTR** CONSTRUCTION REQD **REQUIRED** TOP OF FINISH FACE **INCL** INCLUDED NR **NOISE REDUCTION** ADA AMERICANS WITH DISABILITIES ACT **CONT** CONTINUE RET RETURN TO FDN TOP OF FOUNDATION FINISH FLOOR ELEVATION IND INDEPENDENT OR INDUSTRIAL NOISE REDUCTION COEFFICIENT ADC AUTOMATIC DOOR CLOSER **CONTR** CONTRACTOR REV **TOB** TOP OF BEAM REVISION INFO FURNITURE, FIXTURE, AND EQUIPMENT **INFORMATION** NRCA NATIONAL ROOFING CONTRACTORS ASSOCIATION **COORD** COORDINATE **ADDL** ADDITIONAL ROOFING TOP OF MASONRY INSUL **INSULATION** FIRE HOSE CABINET NRP **NONREMOVABLE** REQUEST FOR INFORMATION ADDN ADDITION CORR CORRIDOR TOP TOP OF PARAPET **FULL HEIGHT PARTITION** INT INTERIOR NARROW STILE CPM ADH ADHESIVE RFP TOS CRITICAL PATH METHOD REQUEST FOR PROPOSAL TOP OF STEEL **FIGURE** INTL INTERNATIONAL NUM NUMERAL ADJACENT, ADJOINING, OR ADJUSTABLE ADJ **CPRS** COMPRESSIBLE RFS **ROOM FINISH SCHEDULE** TOW TOP OF WALL FILLET IWH INSTANTANEOUS WATER HEATER O/O **OUT TO OUT TOILET PAPER DISPENSER ADMIN ADMINISTRATION** CR CARD READER **ROOF LEADER** TPD JAN FIN FINISH JANITOR OXYGEN CRS AFF ABOVE FINISHED FLOOR COLD ROLLED STEEL RLG RAILING **TRANS** TRANSOM KD **FINISH FLOOR** KILN DRIED OR KNOCKED DOWN OUTSIDE AIR OR OVERAL AFG CRSI **TRTD** TREATED CONCRETE REINFORCING STEEL INSTITUTE ROOM ABOVE FINISHED GRADE **FINISH GRADE** KITCHEN ON CENTER CSB AFS NURSE CALL LIGHT/ROOM LIGHT **TUBE STEEL** ABOVE FINISHED SLAB CONCRETE SPLASH BLOCK FINISH WOOD FIN WD KNOCKOUT OCC OCT OCCUPY CSG RND **TSTAT THERMOSTAT** ASSOCIATED GENERAL CONTRACTORS CASING ROUND FIXT FIXTURE **KPL KICKPLATE OCTAGON AGGR** CSI CONSTRUCTION SPECIFICATIONS INSTITUTE RO AGGREGATE ROUGH OPENING **TELEVISION FLOORLINE ANGLE** OD OUTSIDE DIAMETER, OUTSIDE DIMENSION **AUTHORITY HAVING JURISDICTION** CSK **COUNTER SUNK** RIGHT OF WAY TYP AHJ ROW TYPICAL FLASH **LABORATORY FLASHING** OD OUTSIDE DIAMETER/OUTSIDE DIMENSION **CSMT** CASEMENT AHR ANCHOR **ROUGH SAWN** HEAT TRANSFER COEFFICIENT FLDG **FOLDING** LAD LADDER OF/CI OWNER FURNISHED/CONTRACTOR INSTALLED AHU **CSWK** AIR HANDLING UNIT CASEWORK RESILIENT SHEET VINYL UNDERCUT UC **FLEX FLEXIBLE** LAM LAMINATE OFD OVERFLOW DRAIN CTG COATING AlA AMERICAN INSTITUTE OF ARCHITECTS RIGHT **UGND** UNDERGROUND **FLOORING** LAM G LAMINATED GLASS OFF OFFICE CTR **UNDERWRITERS LABORATORIES** AISC AMERICAN INSTITUTE OF STEEL CONSTRUCTION CENTER **ROOF VENT FLOOR** LAU LAUNDRY OF/OI OWNER FURNISHED/OWNER INSTALLED **CTRL ALTERNATE** CONTROL RVS REVERSE ULT ULTIMATE FLOOR FINISH **LAVATORY OVERHANG** CTV UNFIN ALTERNATE NUMBER CABLE TELEVISION RAIN WATER LEADER UNFINISH LBR FLR SK FLOOR SINK LUMBER OH DR OVERHEAD (COILING) DOOR **CUFT CUBIC FEET SOLID SURFACE** UNO **UNLESS NOTED OTHERWISE** ALUMINUM **FLUORESCENT** LBS **FLUOR** POUND OPH OPPOSITE HAND CU IN **CUBIC INCH** UNINTERRUPTIBLE POWER SUPPLY AMT AMOUNT SUPPLY AIR LCS LOCKABLE CHARTING STATION/MED CABINET **FLUOR FIX** FLUORESCENT FIXTURE **OPNG OPENING** ANOD ANODIZE **CU YD** CUBIC YARD SALV SALVAGE UR **URINAL FACTORY MUTUAL** LD BRG LOAD-BEARING OPP **OPPOSITE** AMERICAN NATIONAL STANDARDS INSTITUTE CURTAIN SAMPLE ANSI **CURT** SAMP UTIL UTILITY LDR FM-G FACTORY MUTUAL GLOBAL LEADER OPR **OPERABLE** SANITARY ANT ANTENNA CYL CYLINDER **ULTRAVIOLE** LED LIGHT EMITTING DIODE FINISHED OPENING OPT **OPTIONAL ACCESS PANEL** CYL L CYLINDER LOCK SPLASH BLOCK VACUUM FACE OF CONCRETE OR FACE OF CURB LINEAR FEET (FOOT) OR OPERATING ROOM OR OUTSIDE RADIUS APA AMERICAN PLYWOOD ASSOCIATION DEPTH OR PENNY (NAIL) SBS STYRENE BUTADIEN STYRENE VAR VARIES FOF LIB **LIBRARY** FACE OF FINISH ORD ORDNANCE OR OVERFLOW ROOF DRAIN APC ARCHITECTURAL PRECAST CONCRETE DAT DATUM **SBSTR** SUBSTRATE VEH **VEHICLE** FOM FACE OF MASONRY LIN LINEAR ORG **ORGANIC** APPD **DOUBLE VENT VENTILATION** APPROVED **DBL** SHARPS CONTAINER FACE OF SLAB OR FACE OF STUD LIQ LIQUID ORIG ORIGINAL **APPROX APPROXIMATE** DBL GLZ DOUBLE GLAZE SCH SCHOOL **VERT VERTICAL LOCKER** LKR FOUNTAIN ORN ORNAMENTA **VEST VESTIBULE** AS REQUIRED DCS DIAPER CHANGING STATION SCHED **SCHEDULE** FACE OF WALL LKR RM LOCKER ROOM FOW **OSHA** OCCUPATIONAL SAFETY AND HEALTH ADMINSTRATION VFD **ARCH SCHEMATIC ARCHITECT** DECORATIVE PANEL SCHEM VARIABLE FREQUENCY DRIVE FIRE PROTECTION OR FIREPROOF LEAD LINED OUT OUTLET DEGREE SCP SCUPPER VICINITY **ASBESTOS** FIRE RATING, FIRE RESISTANT, OR FRAME **LMST** LIMESTONE OUNCE ARCHITECT'S SUPPLEMENTAL INSTRUCTION **DEL** DELETE SCRN SCREEN **VIDEO** VID LRG FR SNK LARGE FLUSHING RIM SINK PAINT **ASKLR AUTOMATIC SPRINKLER DEMO DEMOLITION** SHOWER CURTAIN TRACK **VERIFY IN FIELD** FREQ FREQUENCY LRV LOUVERED ROOF VENT PARALLEL OR PARAPET **ASPH** ASPHALT **DEPT** DEPARTMENT SCWD SOLID CORE WOOD DOOR VNR VENEER FRMG LIGHT SWITCH FRAMING PARA PARAGRAPH DET **ASSN** ASSOCIATION SMOKE DETECTOR/SOAP DISPENSER **VOLATILE ORGANIC COMPOUND** DETAIL VOC FIBERGLASS REINFORCED PLASTIC LIGHT PART AMERICAN SOCIETY FOR TESTING AND MATERIALS LIGHT GAGE VOL PAT PATTERN **ATCH** DIAMETER **SECTION** VAPOR RETARDER ATTACHMENT DIA VR FEDERAL SPECIFICATION LT WT LIGHTWEIGHT PB **PUSHBUTTON** ATM DIAG AUTOMATIC TELLER MACHINE DIAGONAL **SEGMENT** VTR **VENT THROUGH ROOF** LTG LIGHTING FSB FOLDING SHOWER BENCH PBD **PARTICLEBOARD** DIFF AUTO AUTOMATIC DIFFERENCE OR DIFFUSER SEL SELECT WITH **LTNG** FASTENER LIGHTNING PIECE, POLYCARBONATE OR PORTLAND CEMENT DIM **SEPARATE WITHOUT** AUX AUXILIARY DIMENSION SEP W/O **FEET OR FOOT** LVD LOUVERED PCA PORTLAND CEMENT ASSOCIATION DIRECTION SQUARE FOOT (FEET) WOOD BLOCKING **AUDIO VISUAI** FOOTING LVR LOUVER PCC PRECAST CONCRETE DISPENSER WATER CLOSET AVG **AVERAGE** SOFTWOOD **FURRING LWC** LIGHTWEIGHT CONCRETE **FURG PCCP CONCRETE PAVEMENT** DISTANCE SGD **ACID WASTE** SLIDING GLASS DOOR WD WOOD FURN **FURNISH OR FURNITURE LWIC** LIGHTWEIGHT INSULATING CONCRETE PCD PAPER CUP DISPENSER DIV SGL WDW **WINDOW** AWI ARCHITECTURAL WOODWORKING INSTITUTE DIVIDE OR DIVISION SINGLE LYR FUT FUTURE PCF POUNDS PER CUBIC FOO WIDE FLANGE AMERICAN WOOD PRESERVERS' ASSOCIATION DEAD LOAD SHOWER MACH MACHINE FIRE VALVE CABINET PCP PORTLAND CEMENT PLASTER **WOOD FRAME** AWS AMERICAN WELDING SOCIETY DOCUMENT SHR HD SHOWER HEAD WFR MACH RM GAGE OR GYPSUM ASSOCIATION MACHINE ROOM PCT PRIVACY CURTAIN TRACK B PL DR SHOWER DRAIN WFS WOOD FURRING STRIPS BASE PLATE DOOR, DRAIN, DRESSING ROOM, OR DRIVE SHRD GALLON MAINTENANCE PED **PEDESTAL** BAT BATTEN DR CL DOOR CLOSER SHEET WH WATER HEATER MAN GALV GALVANIC OR GALVANIZED MANUAL PEN PENETRATE DR FR SHEATHING BD BOARD DOOR FRAME WHSE WAREHOUSE MATL **GALV STL GALVANIZED STEEL MATERIAL PEND** PENDANT DR OPNO SHELVING BD FT **BOARD FEET (FOOT)** DOOR OPENING WATERPROOFING **MATV** MASTER ANTENNA TELEVISION SYSTEM GRAB BAR **PERF PERFORATED** DOWNSPOUT SIMILAR WATERPROOF MEMBRANE BEV BEVEL MAX **GENERAL CONTRACTOR** MAXIMUM **PERIM** PERIMETER BUILDER'S HARDWARE MANUFACTURER'S ASSOCIATION DSGN **SCORED JOINT** BHMA DESIGN WEATHER RESISTANT GD MBD MARKER BOARD GUARD PERP **PERPENDICULAR BIFOLDING DOORS** DISHWASHER STEEL JOIST INSTITUTE WEATHERSTRIP OR WALL SCONCE **GUARD RAIL MCB** GDR METAL CORNER BEAD PHAR PHARMACY DRAWING **BITUM** ITUMINOUS **DWG** MD SKETCH **WSCT** WAINSCOT GEN **GENERAL OR GENERATOR** PHOTO **PHOTOGRAPH** BKG **EAST SKYLIGHT** WEIGHT OR WINDOW TREATMENT **BACKING** ME GLASS-FIBER-REINFORCED CONCRETE MECHANICAL ENGINEER PKG PACKAGE BLD SLDG SLIDING BUILD EACH CROSS BRACE GFRG **MEAS** GLASS-FIBER-REINFORCED GYPSUM MEASURE PROPERTY LINE **EFFICIENCY BLDG** BUILDING SLNT SEALANT EXTRUDED POLYSTYRENE BOARD GFRP **MECH** GLASS-FIBER-REINFORCED PLASTIC **MECHANICAL** PL GL PLATE GLASS SHEET METAL BEAM OR BENCHMARK EXTERIOR FINISH SYSTEM GALVANIZED IRON MECH RM MECHANICAL ROOM PLAM PLASTIC LAMINATE BOT **EIFS** EXTERIOR INSULATION AND FINISH SYSTEM SMK SMOKE MED MEDICAL, MEDIUM **PLAS** PLASTER OR PLASTIC **BRCG BRACING EXPANSION JOINT** MEK SND INS SOUND INSULATION **GLASS BLOCK** METHYL ETHYL KETONE GL BLK PLBG PLUMBING ELEVATION SPEC BRDG BRIDGING **MEMB SPECIFICATION MEMBRANE** GLUED LAMINATED WOOD PLYWD PLYWOOD BRIDGING JOIS **ELASTOMERIC BRDG JST** SPKLR SPRINKLER GP **MEMO** GRAB BAR **MEMORANDUM PMTL** PAINTED METAL SPKR BRG BEARING ELECTRIC SPEAKER **GROUND FLOOR** MEZZ MEZZANINE **PNEU PNEUMATIC BEARING PLATE** ELEC DR OP ELECTRIC DOOR OPENER SPLY SUPPLY MF GRAN GRANITE MILL FINISH PNL **BRKT** SINGLE PLY ROOF SYSTEM **BRACKET** ELEV ELEVATOR MFD GRTG GRATING **MANUFACTURED** POST OFFICE, PURCHASE ORDER BRZ **BRONZE EMER EMERGENCY** SQ **SQUARE** MFG GSB GYPSUM SHEATHING BOARD **MANUFACTURING** POLY POLYETHYLENE (PLASTIC) **BSMT** BASEMENT **EMER SHR SQUARE INCH** EMERGENCY SHOWER GSM MFR **MANUFACTURER** GALVANIZED SHEET METAL **PUSH PLATE** BETWEEN **ENCLOSURE SQUARE YARD ENCL** GSU GLAZED STRUCTURAL UNIT MFR RE MANUFACTURER'S RECOMMENDATION **PAIR BUILT-UP ROOFING ENGR ENGINEER** SST STAINLESS STEEL BUR GT MGT GROUT **MANAGEMENT** PRCST **PRECAST** C CONC CAST CONCRETE **ENVIR ENVIRONMENT** STAIRS OR STREET MIC **GUAR GUARANTEE** MICROPHONE PREFAB **PREFABRICATE** ELECTRICAL OUTLET SOUND TRANSMISSION CLASS CENTER TO CENTER MID **GUTTER PREFIN** PREFINISH CAB EPA STANDARD CABINET **ENVIRONMENTAL PROTECTION AGENCY** GYPSUM MILITARY STANDARD **PRELIMINARY EPDM** CEILING ATTENUATION CLASS ETHYLENE PROPYLENE DIENE MONOMER STIFFENER GYPSUM BOARD MIN MINIMUM PREP **PREPARATION** EPO STEEL JOIST CATCH BASIN OR CORNER BEAD EMERGENCY POWER OFF MIR **MIRROR** GYP PLAS GYPSUM PLASTER **PRESS PRESSURE** EPS CEMENTITIOUS (BACKER) BOARD EXPANDED POLYSTYRENE BOARD (INSULATION) STEEL LINTEL MISC STL LNTL HIGH OR HUMIDISTAT MISCELLANEOUS **PREV PREVIOUS** CCD STEEL PLATE CONSTRUCTION CHANGE DIRECTIVE **EQUAL** STL PL MIT HAZARDOUS MATERIALS **PRKG PARKING** CCTV **EQUALLY SPACED** CLOSED CIRCUIT TELEVISION EQL SP STL RF DK STEEL ROOF DECK **MARKER** HOSE BIBB **PRMLD** PREMOLDED CCW **EQUIPMENT** STL TB STEEL TUBE COUNTERCLOCKWISE HC HOLLOW CORE METAL LATH PROJ PROJECT CONSTRUCTION DOCUMENTS OR CONTRACT DOCUMENTS **EQUIVALENT** STL TR STEEL TRUSS **HCWD** HOLLOW CORE WOOD DOOR MOLDING (MOULDING) **PROP PROPERTY** CEM ERD EXISTING ROOF DRAIN CEMENT STNLS **STAINLESS** HDBD **MLWK** HARDBOARD MILLWORK PSF POUNDS PER SQUARE FOOT CEM PLAS ESC STORAGE CEMENT PLASTER ESCAPE OR ESCUTCHEON STOR HDO HIGH DENSITY OVERLAY **MILLIMETER** mm PSI POUNDS PER SQUARE INCH **ESMT STRINGERS** CER EASEMENT STR CERAMIC HDR MO HEADER MASONRY OPENING PORCELAIN TILE OR PRESSURE TREATED ESP **STRUCTURAL** CONTRACTOR FURNISHED **ESPECIALLY** STRUCT HDW **HARDWARE** MOD MODEL, MODIFY OR MODULE PTD PAPER TOWEL DISPENSER EST CF/CI **ESTIMATE** STRUCT STL STRUCTURAL STEE CONTRACTOR FURNISHED/CONTRACTOR INSTALLED **HDWD** HARDWOOD **MOD BIT** MODIFIED BITUMEN PTN PARTITION CF/OI SUBSTITUTE CONTRACTOR FURNISHED/OWNER INSTALLED AND SO FORTH OR ET CETERA HEPA HIGH EFFICIENCY PARTICULATE AIR (FILTER) MON MONITOR PTS PNEUMATIC TUBE STATION CFLG COUNTERFLASHING EW EACH WAY SURF SURFACE **MOPR** HEX **HEXAGON** MOP RACK POLYVINYL CHLORIDE (PLASTIC) SUSP SUSPEND CFMF COLD-FORMED METAL FRAMING **EWC** ELECTRIC WATER COOLER MR HANGER MOISTURE RESISTANT PVG PAVING CG **EWS** SUSPENDED CEILING CORNER GUARD EYE WASH STATION MS SUSP CLG HM**HOLLOW METAL** MOP SINK **PWR** POWER EXH CERAMIC GLAZED STRUCTURAL FACING UNITS **EXHAUST** SW SWITCH HMD MTD MOUNTED HOLLOW METAL DOOR **QUALITY ASSURANCE EXIST EXISTING** SWDR **SWING DOOR** COAT HOOK HMDF HOLLOW METAL DOOR AND FRAME MTG **MOUNTING** QUALITY CONTROL CHEM CHEMICAL EXP **EXPANSION OR EXPOSED** SYM SYMBOL HMF HOLLOW METAL FRAME MTL METAL **CHFR EXP BT** SYNTHETIC CHAMFER EXPANSION BOLT SYNTH MULL **HANDRAIL** MULLION QTR **QUARTER** CHK CHECK **EXST GR** EXISTING GRADE SYSTEM MW НО **HOLD OPEN MICROWAVE** QUANTITY **CAST IRON** EXT EXTERIOR, EXTERNAL, OR EXTINGUISHER MWP HORIZ **HORIZONTAL** MEMBRANE WATERPROOFING **QUAD** QUADRAN<sup>-</sup> CIP **EXT GR** CAST-IN-PLACE **EXTERIOR GRADE** HOSP HOSPITAL QUAL QUALITY CIR CIRCLE HIGH PRESSURE RADIUS OR RISER CIRC CIRCULAR HYGIENE PRODUCT DISPOSAL **RETURN AIR** CONSTRUCTION JOINT OR CONTROL JOINT HIGH PRESSURE DECORATIVE LAMINATE RADIATOR CENTER LINE HEADQUARTERS REINFORCED BRICK MASONRY CLDG CLADDING HEAT-STRENGTHENED (GLASS) OR HIGH STRENGTH RUBBER CEILING HSE CLR CLEAR HOUSEKEEPING CM CONSTRUCTION MANAGEMENT CONCRETE MASONRY UNIT Drawing Title **Project Title Project Number** CONSULTANT ARCHITECT/ENGINEER OF RECORD | STAMP Office of 438-460 **ABBREVIATIONS** CONSTRUCT NEW SPS BID DOCUMENTS Construction **Building Number** and Facilities ANDERSON Management **Drawing Number** Sioux Falls, SD. **FULLY SPRINKLERED** Checked **Issue Date** GI002 13605 1st Ave. N. #100 Plymouth, MN 55441 | U.S. Department of Veterans P 763.412.4000 | F 763.412.4090 | ae-mn.com DATE: <u>08/04/2022</u> 08/04/2022 Checker | Author Revisions: Anderson Engineering of Minnesota, LLC | Proj # 16584 License # 9335

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CONSULTANT

Revisions:

VA FORM 08 - 6231

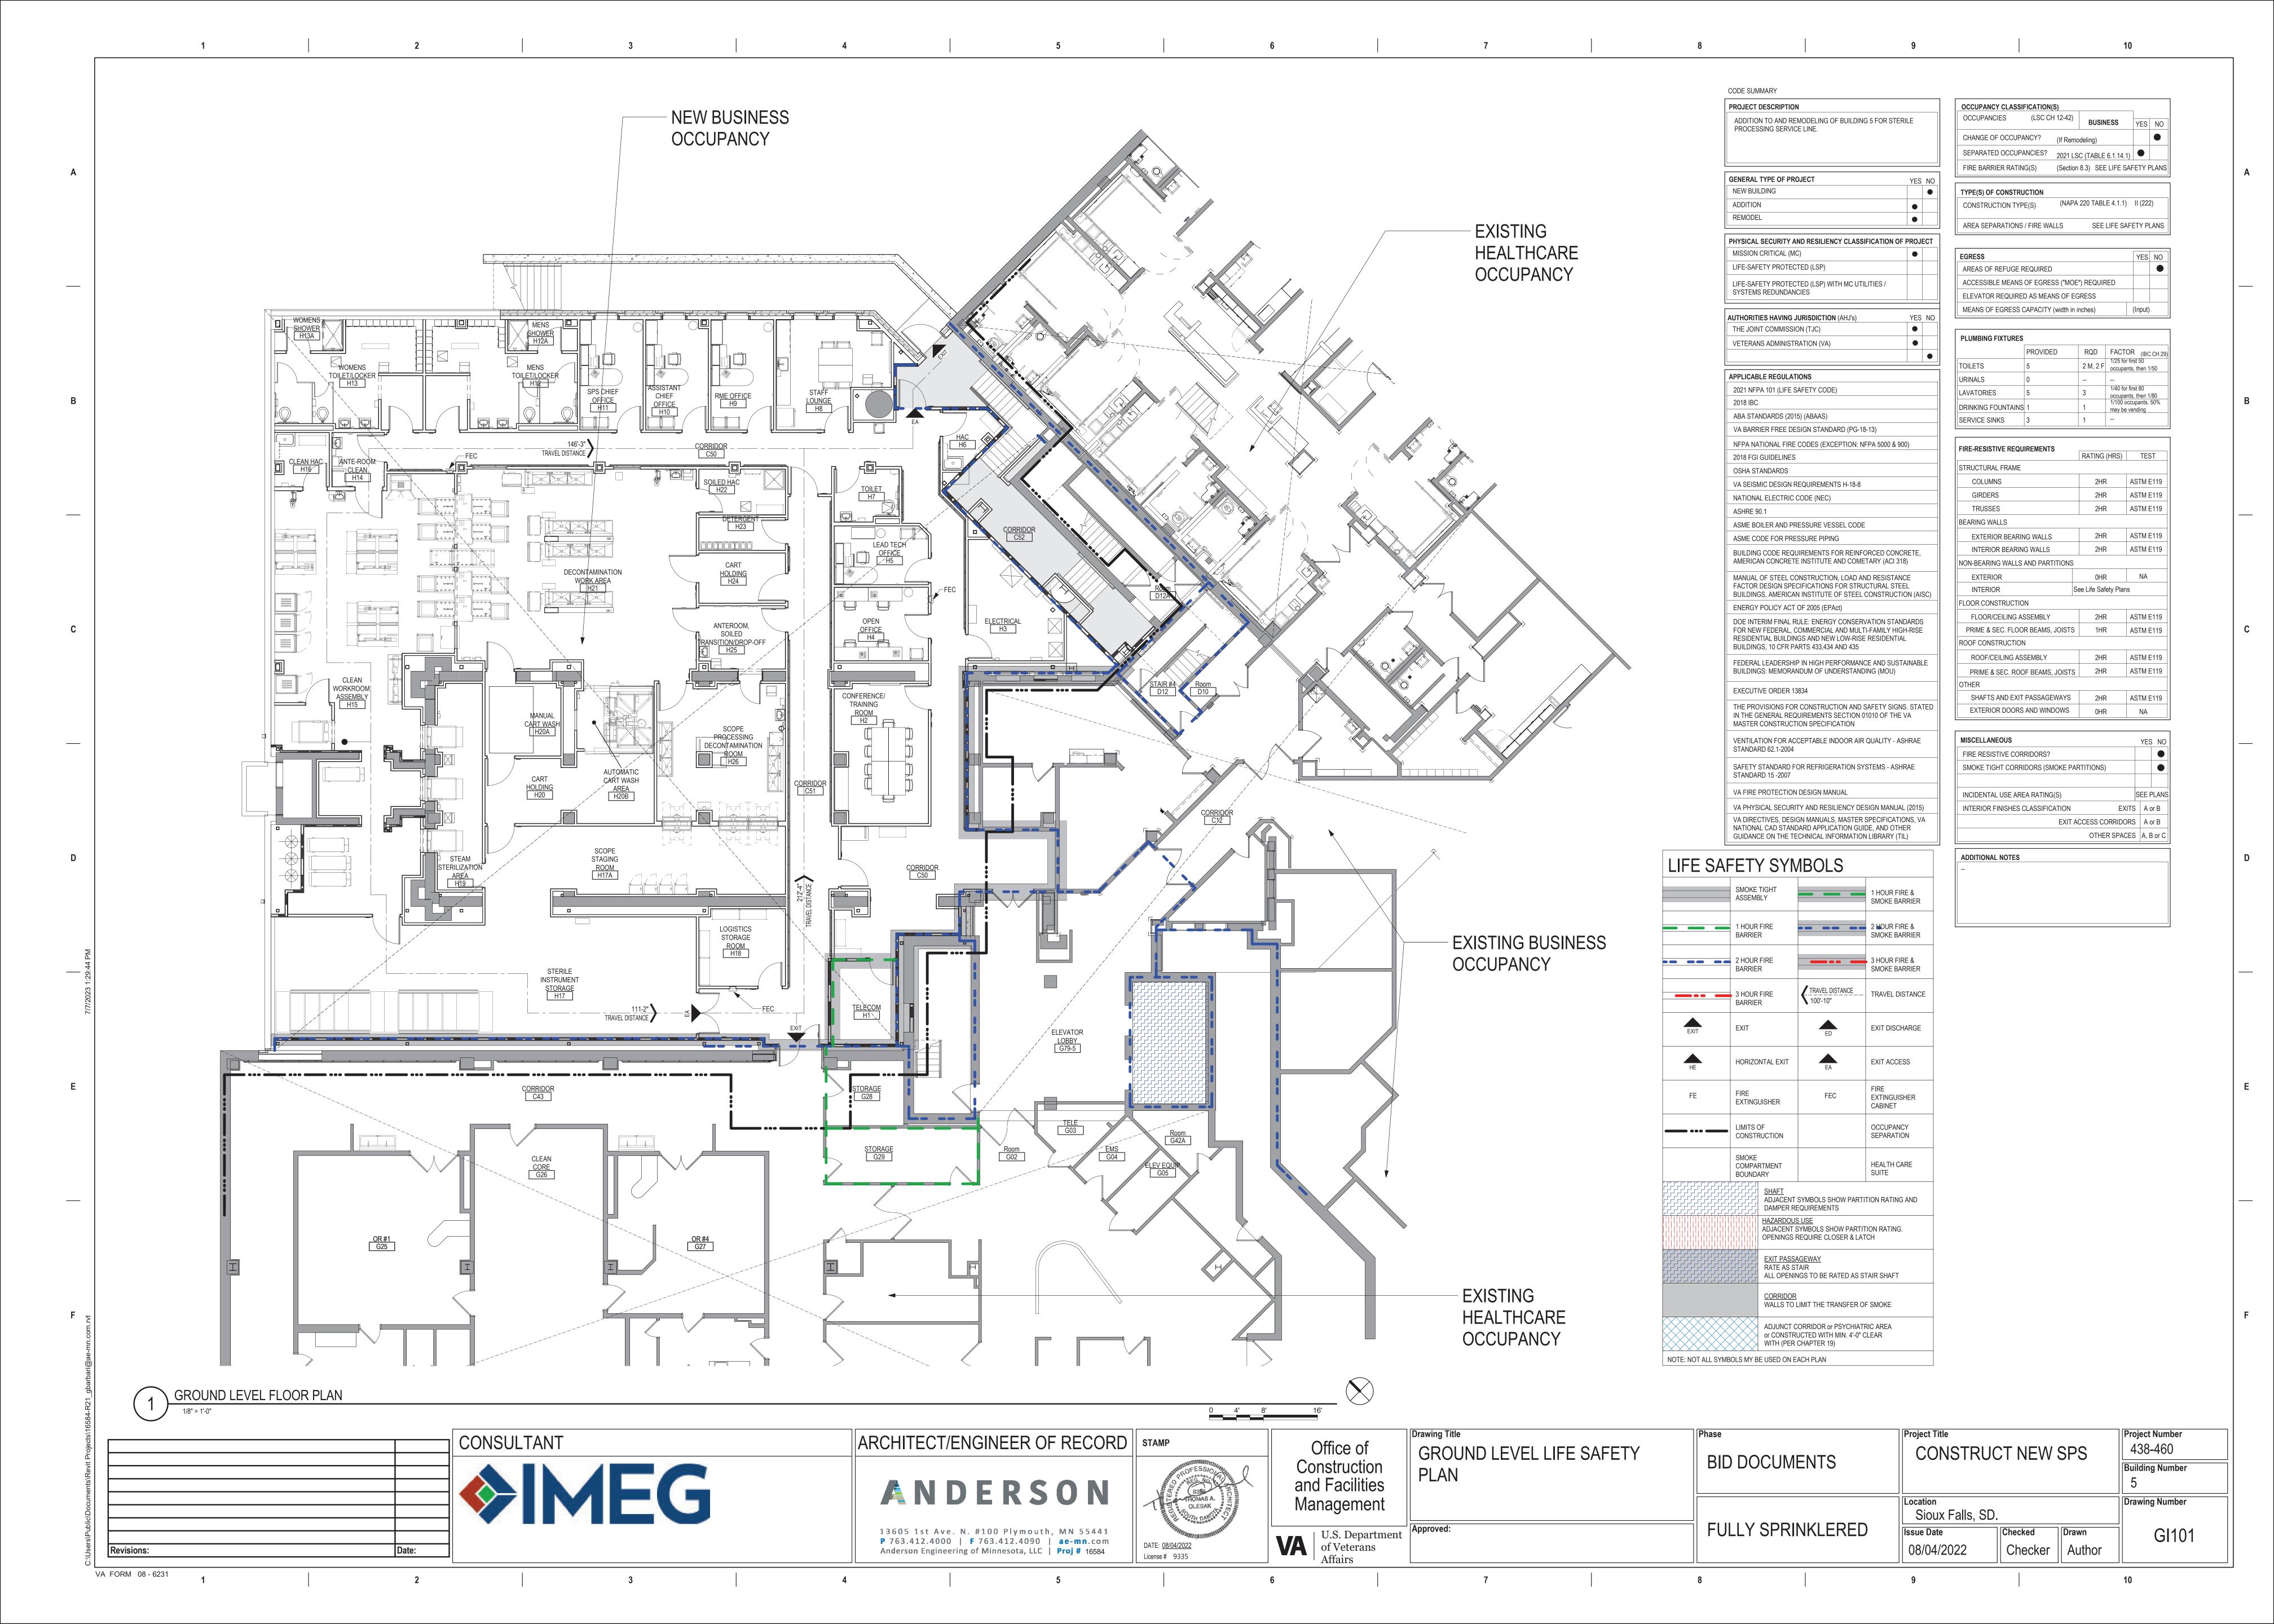**IMEG** 

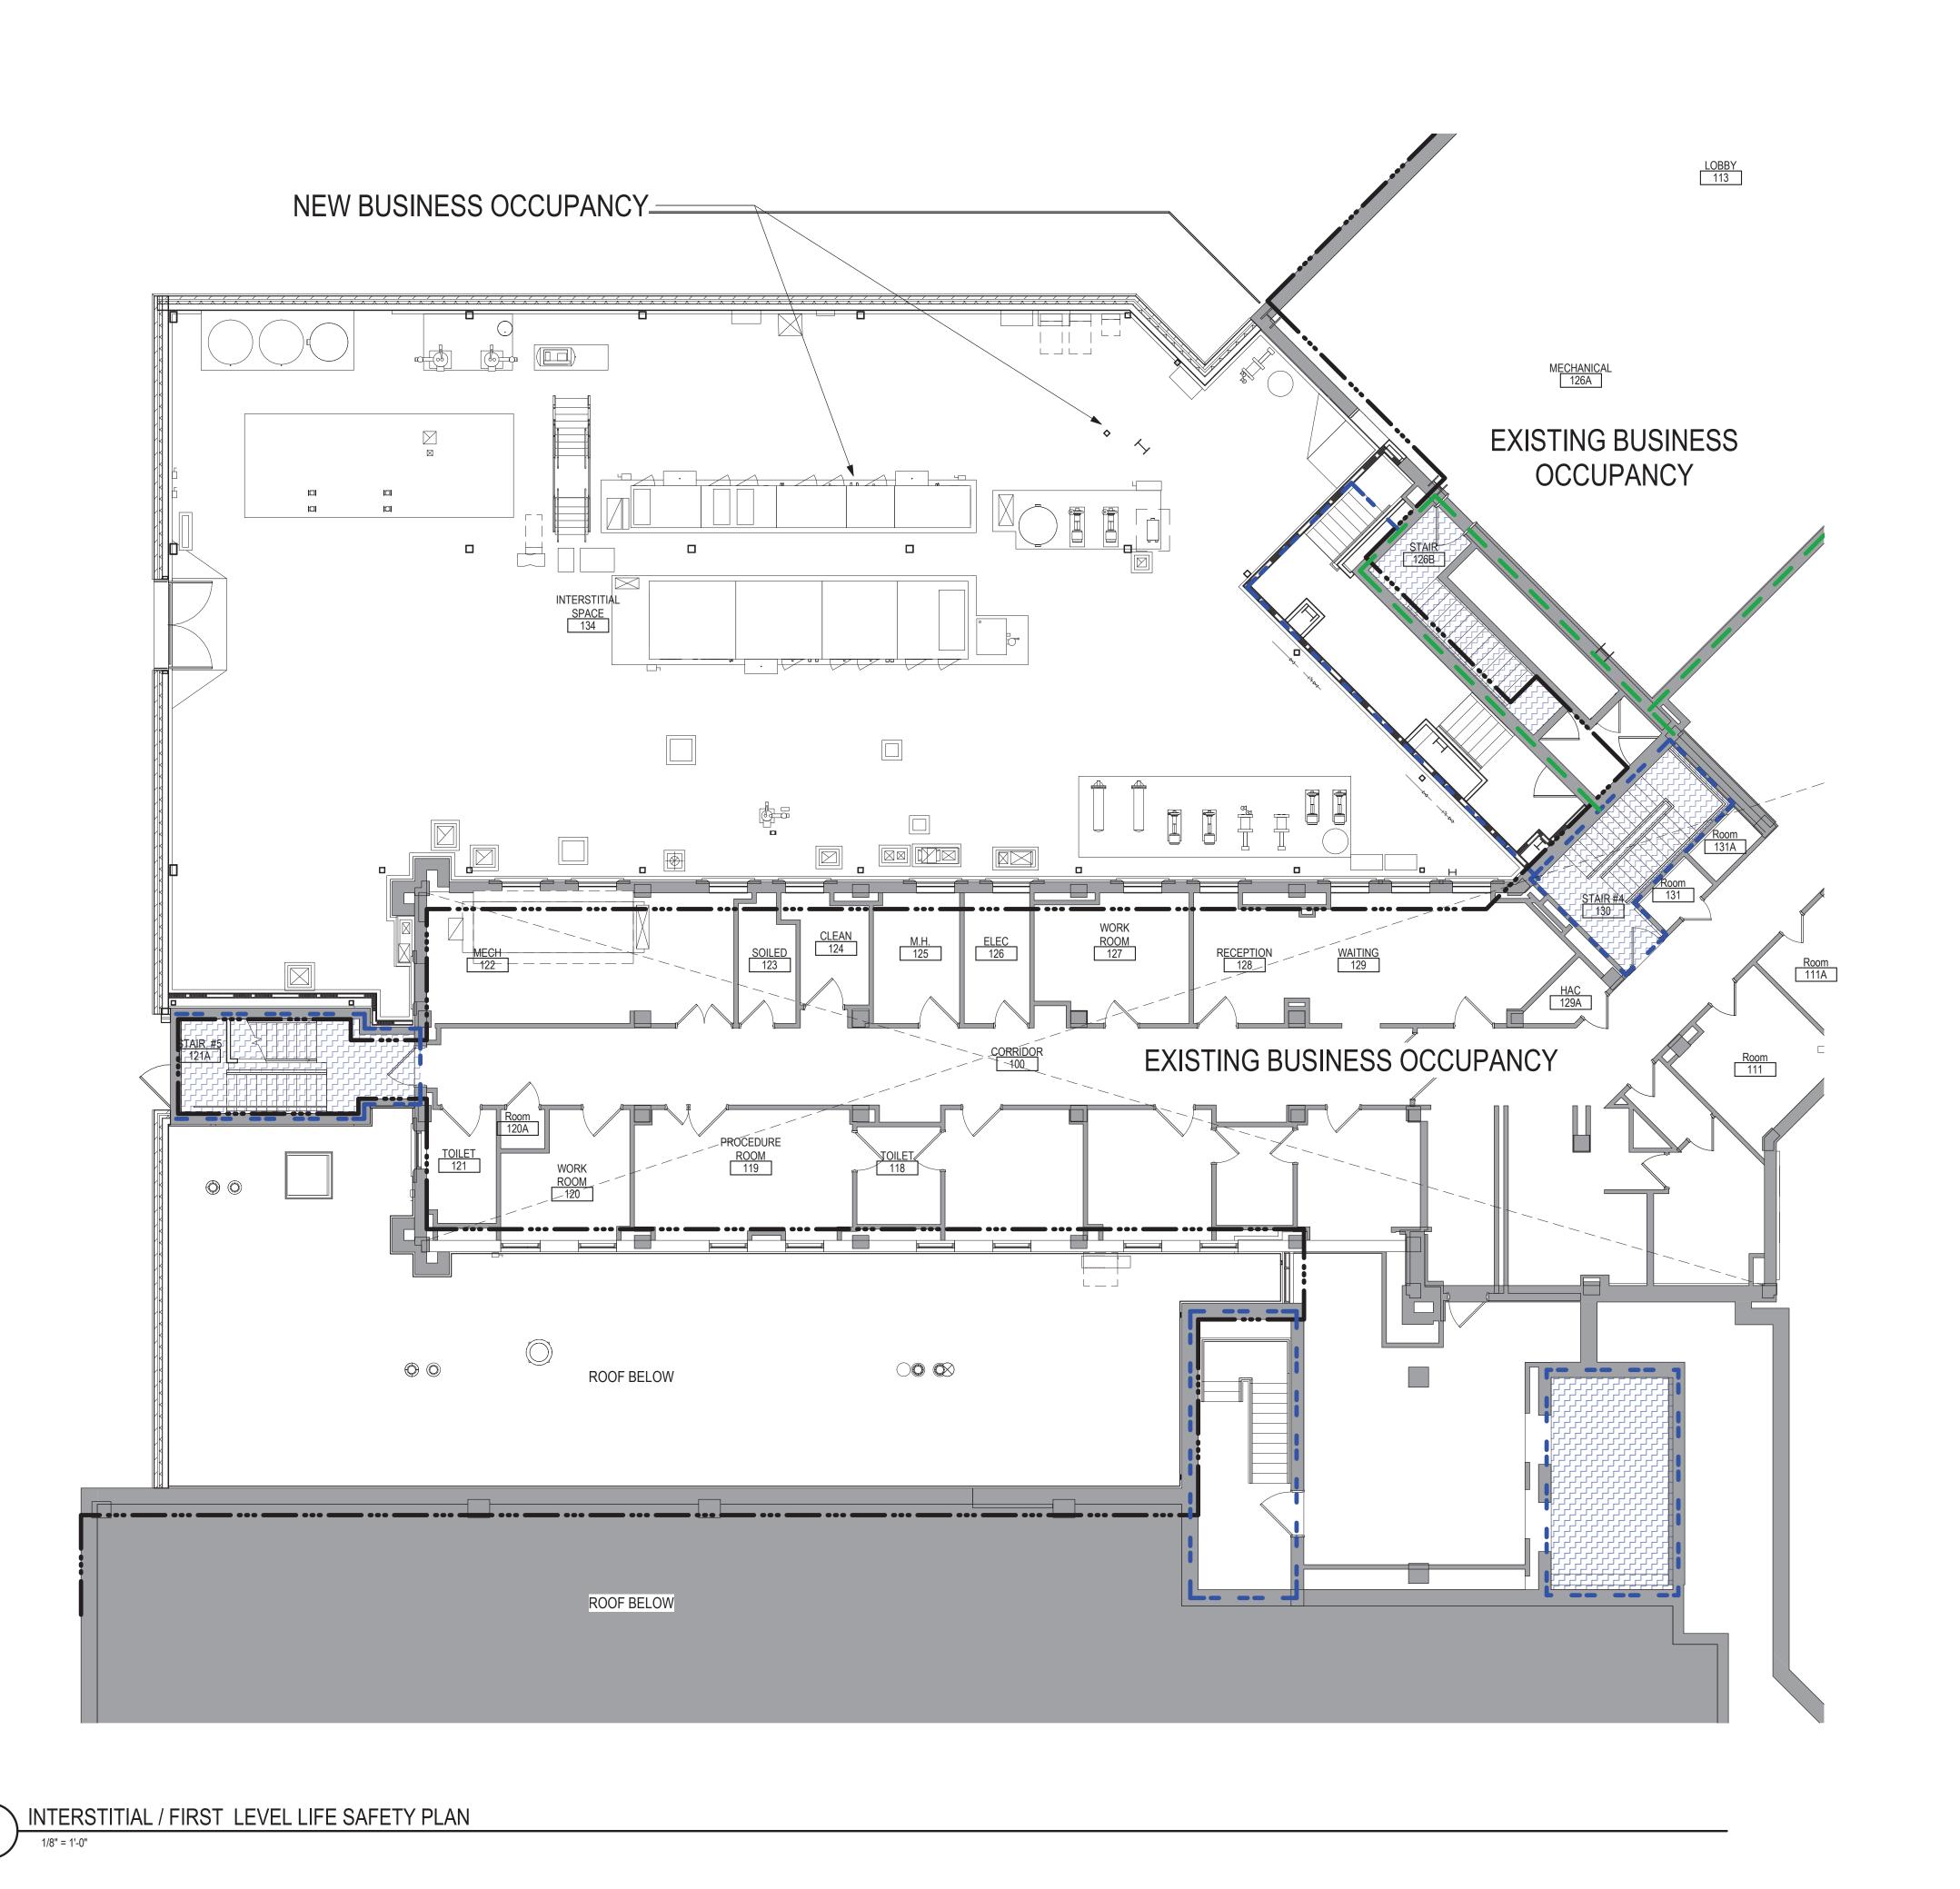CODE SUMMARY PROJECT DESCRIPTION ADDITION TO AND REMODELING OF BUILDING 5 FOR STERILE PROCESSING SERVICE LINE. **GENERAL TYPE OF PROJECT** NEW BUILDING ADDITION REMODEL PHYSICAL SECURITY AND RESILIENCY CLASSIFICATION OF PROJECT MISSION CRITICAL (MC) LIFE-SAFETY PROTECTED (LSP) LIFE-SAFETY PROTECTED (LSP) WITH MC UTILITIES / SYSTEMS REDUNDANCIES YES NO **AUTHORITIES HAVING JURISDICTION (AHJ'S** THE JOINT COMMISSION (TJC) VETERANS ADMINISTRATION (VA) APPLICABLE REGULATIONS 2021 NFPA 101 (LIFE SAFETY CODE) 2018 IBC ABA STANDARDS (2015) (ABAAS) VA BARRIER FREE DESIGN STANDARD (PG-18-13) NFPA NATIONAL FIRE CODES (EXCEPTION: NFPA 5000 & 900) 2018 FGI GUIDELINES OSHA STANDARDS VA SEISMIC DESIGN REQUIREMENTS H-18-8 NATIONAL ELECTRIC CODE (NEC) ASHRE 90.1 ASME BOILER AND PRESSURE VESSEL CODE ASME CODE FOR PRESSURE PIPING BUILDING CODE REQUIREMENTS FOR REINFORCED CONCRETE, AMERICAN CONCRETE INSTITUTE AND COMETARY (ACI 318) MANUAL OF STEEL CONSTRUCTION, LOAD AND RESISTANCE FACTOR DESIGN SPECIFICATIONS FOR STRUCTURAL STEEL BUILDINGS, AMERICAN INSTITUTE OF STEEL CONSTRUCTION (AISC) ENERGY POLICY ACT OF 2005 (EPAct) DOE INTERIM FINAL RULE: ENERGY CONSERVATION STANDARDS FOR NEW FEDERAL, COMMERCIAL AND MULTI-FAMILY HIGH-RISE RESIDENTIAL BUILDINGS AND NEW LOW-RISE RESIDENTIAL BUILDINGS, 10 CFR PARTS 433,434 AND 435 FEDERAL LEADERSHIP IN HIGH PERFORMANCE AND SUSTAINABLE BUILDINGS: MEMORANDUM OF UNDERSTANDING (MOU) EXECUTIVE ORDER 13834 THE PROVISIONS FOR CONSTRUCTION AND SAFETY SIGNS. STATED IN THE GENERAL REQUIREMENTS SECTION 01010 OF THE VA MASTER CONSTRUCTION SPECIFICATION VENTILATION FOR ACCEPTABLE INDOOR AIR QUALITY - ASHRAE STANDARD 62.1-2004 SAFETY STANDARD FOR REFRIGERATION SYSTEMS - ASHRAE STANDARD 15 -2007 VA FIRE PROTECTION DESIGN MANUAL VA PHYSICAL SECURITY AND RESILIENCY DESIGN MANUAL (2015) VA DIRECTIVES, DESIGN MANUALS, MASTER SPECIFICATIONS, VA NATIONAL CAD STANDARD APPLICATION GUIDE, AND OTHER GUIDANCE ON THE TECHNICAL INFORMATION LIBRARY (TIL)

GOIDANCE ON THE FECHINICAL INI ONWATION EIBRART (TIE)							
LIFE SAFETY SYMBOLS							
	SMOKE TIGHT ASSEMBLY		1 HOUR FIRE & SMOKE BARRIER				
	1 HOUR FIRE BARRIER		2 HOUR FIRE & SMOKE BARRIER				
	2 HOUR FIRE BARRIER		3 HOUR FIRE & SMOKE BARRIER				
	3 HOUR FIRE BARRIER	TRAVEL DISTANCE 100'-10"	TRAVEL DISTANCE				
EXIT	EXIT	ED	EXIT DISCHARGE				
HE	HORIZONTAL EXIT	EA	EXIT ACCESS				
FE	FIRE EXTINGUISHER	FEC	FIRE EXTINGUISHER CABINET				
	LIMITS OF CONSTRUCTION		OCCUPANCY SEPARATION				
	SMOKE COMPARTMENT BOUNDARY		HEALTH CARE SUITE				
	DAMPER RE HAZARDOUS ADJACENT S	SYMBOLS SHOW PARTI EQUIREMENTS SUSE SYMBOLS SHOW PARTIT REQUIRE CLOSER & LAT	TION RATING.				
	EXIT PASSAGEWAY RATE AS STAIR ALL OPENINGS TO BE RATED AS STAIR SHAFT						
	CORRIDOR WALLS TO LIMIT THE TRANSFER OF SMOKE						
	ADJUNCT CORRIDOR or PSYCHIATRIC AREA or CONSTRUCTED WITH MIN. 4'-0" CLEAR WITH (PER CHAPTER 19)						
NOTE: NOT ALL SYMB	OLS MY BE USED ON E	ACH PLAN					

OCCUPANCY CLAS	SIFICATION	(S)				
OCCUPANCIES	(LSC CI	H 12-42)	BL	JSINESS	YES	NO
CHANGE OF OCCU	PANCY?	(If Remo	deling	)		•
SEPARATED OCCU	PANCIES?	2021 LS	C (TAI	BLE 6.1.14.1)	•	
FIRE BARRIER RAT	ING(S)	(Section	8.3)	SEE LIFE SAF	ETY F	PLAN

TYPE(S) OF CONSTRUCTION CONSTRUCTION TYPE(S) (NAPA 220 TABLE 4.1.1) II (222)

AREA SEPARATIONS / FIRE WALLS SEE LIFE SAFETY PLANS

EGRESS	YES	NO
AREAS OF REFUGE REQUIRED		•
ACCESSIBLE MEANS OF EGRESS ("MOE") REQUIRED		
ELEVATOR REQUIRED AS MEANS OF EGRESS		
MEANS OF EGRESS CAPACITY (width in inches)	(Input)	

PLUMBING FIXTURES									
	PROVIDED	RQD	FACTOR (IBC CH 2						
TOILETS	5	2 M, 2 F	1/25 for first 50 occupants, then 1/50						
URINALS	0								
LAVATORIES	5	3	1/40 for first 80 occupants, then 1/80						
DRINKING FOUNTAINS	1	1	1/100 occupants. 50% may be vending						
SERVICE SINKS	3	1							

FIRE-RESISTIVE REQUIREMENTS	RATING (HRS)	TEST
STRUCTURAL FRAME	RATING (FIRS)	IESI
COLUMNS	2HR	ASTM E119
GIRDERS	2HR	ASTM E119
TRUSSES	2HR	ASTM E119
BEARING WALLS		_
EXTERIOR BEARING WALLS	2HR	ASTM E119
INTERIOR BEARING WALLS	2HR	ASTM E119
NON-BEARING WALLS AND PARTITIONS		
EXTERIOR	0HR	NA
INTERIOR	See Life Safety Plar	าร
FLOOR CONSTRUCTION		
FLOOR/CEILING ASSEMBLY	2HR	ASTM E119
PRIME & SEC. FLOOR BEAMS, JOISTS	S 1HR	ASTM E119
ROOF CONSTRUCTION	·	
ROOF/CEILING ASSEMBLY	2HR	ASTM E119
PRIME & SEC. ROOF BEAMS, JOISTS	3 2HR	ASTM E119
OTHER		
SHAFTS AND EXIT PASSAGEWAYS	2HR	ASTM E119
EXTERIOR DOORS AND WINDOWS	0HR	NA

MISCELLANEOUS	Υ	ES NO
FIRE RESISTIVE CORRIDORS?		
SMOKE TIGHT CORRIDORS (SMOKE PARTITIONS)		
INCIDENTAL USE AREA RATING(S)	SEI	E PLANS
INTERIOR FINISHES CLASSIFICATION EXIT	S	A or B
EXIT ACCESS CORRIDOR	S	A or B
OTHER SPACE	SA	, B or C

ADDITIONAL NOTES

Project Title **BID DOCUMENTS** 

Project Number 438-460 **CONSTRUCT NEW SPS Building Number** Drawing Number Sioux Falls, SD. | Checked | Drawn GI111

ARCHITECT/ENGINEER OF RECORD | STAMP ANDERSON 13605 1st Ave. N. #100 Plymouth, MN 55441 P 763.412.4000 | F 763.412.4090 | ae-mn.com DATE: <u>08/04/2022</u> Anderson Engineering of Minnesota, LLC | Proj # 16584

License # 9335

Office of Construction and Facilities Management

INTERSTITIAL/FIRST LEVEL LIFE SAFETY PLAN


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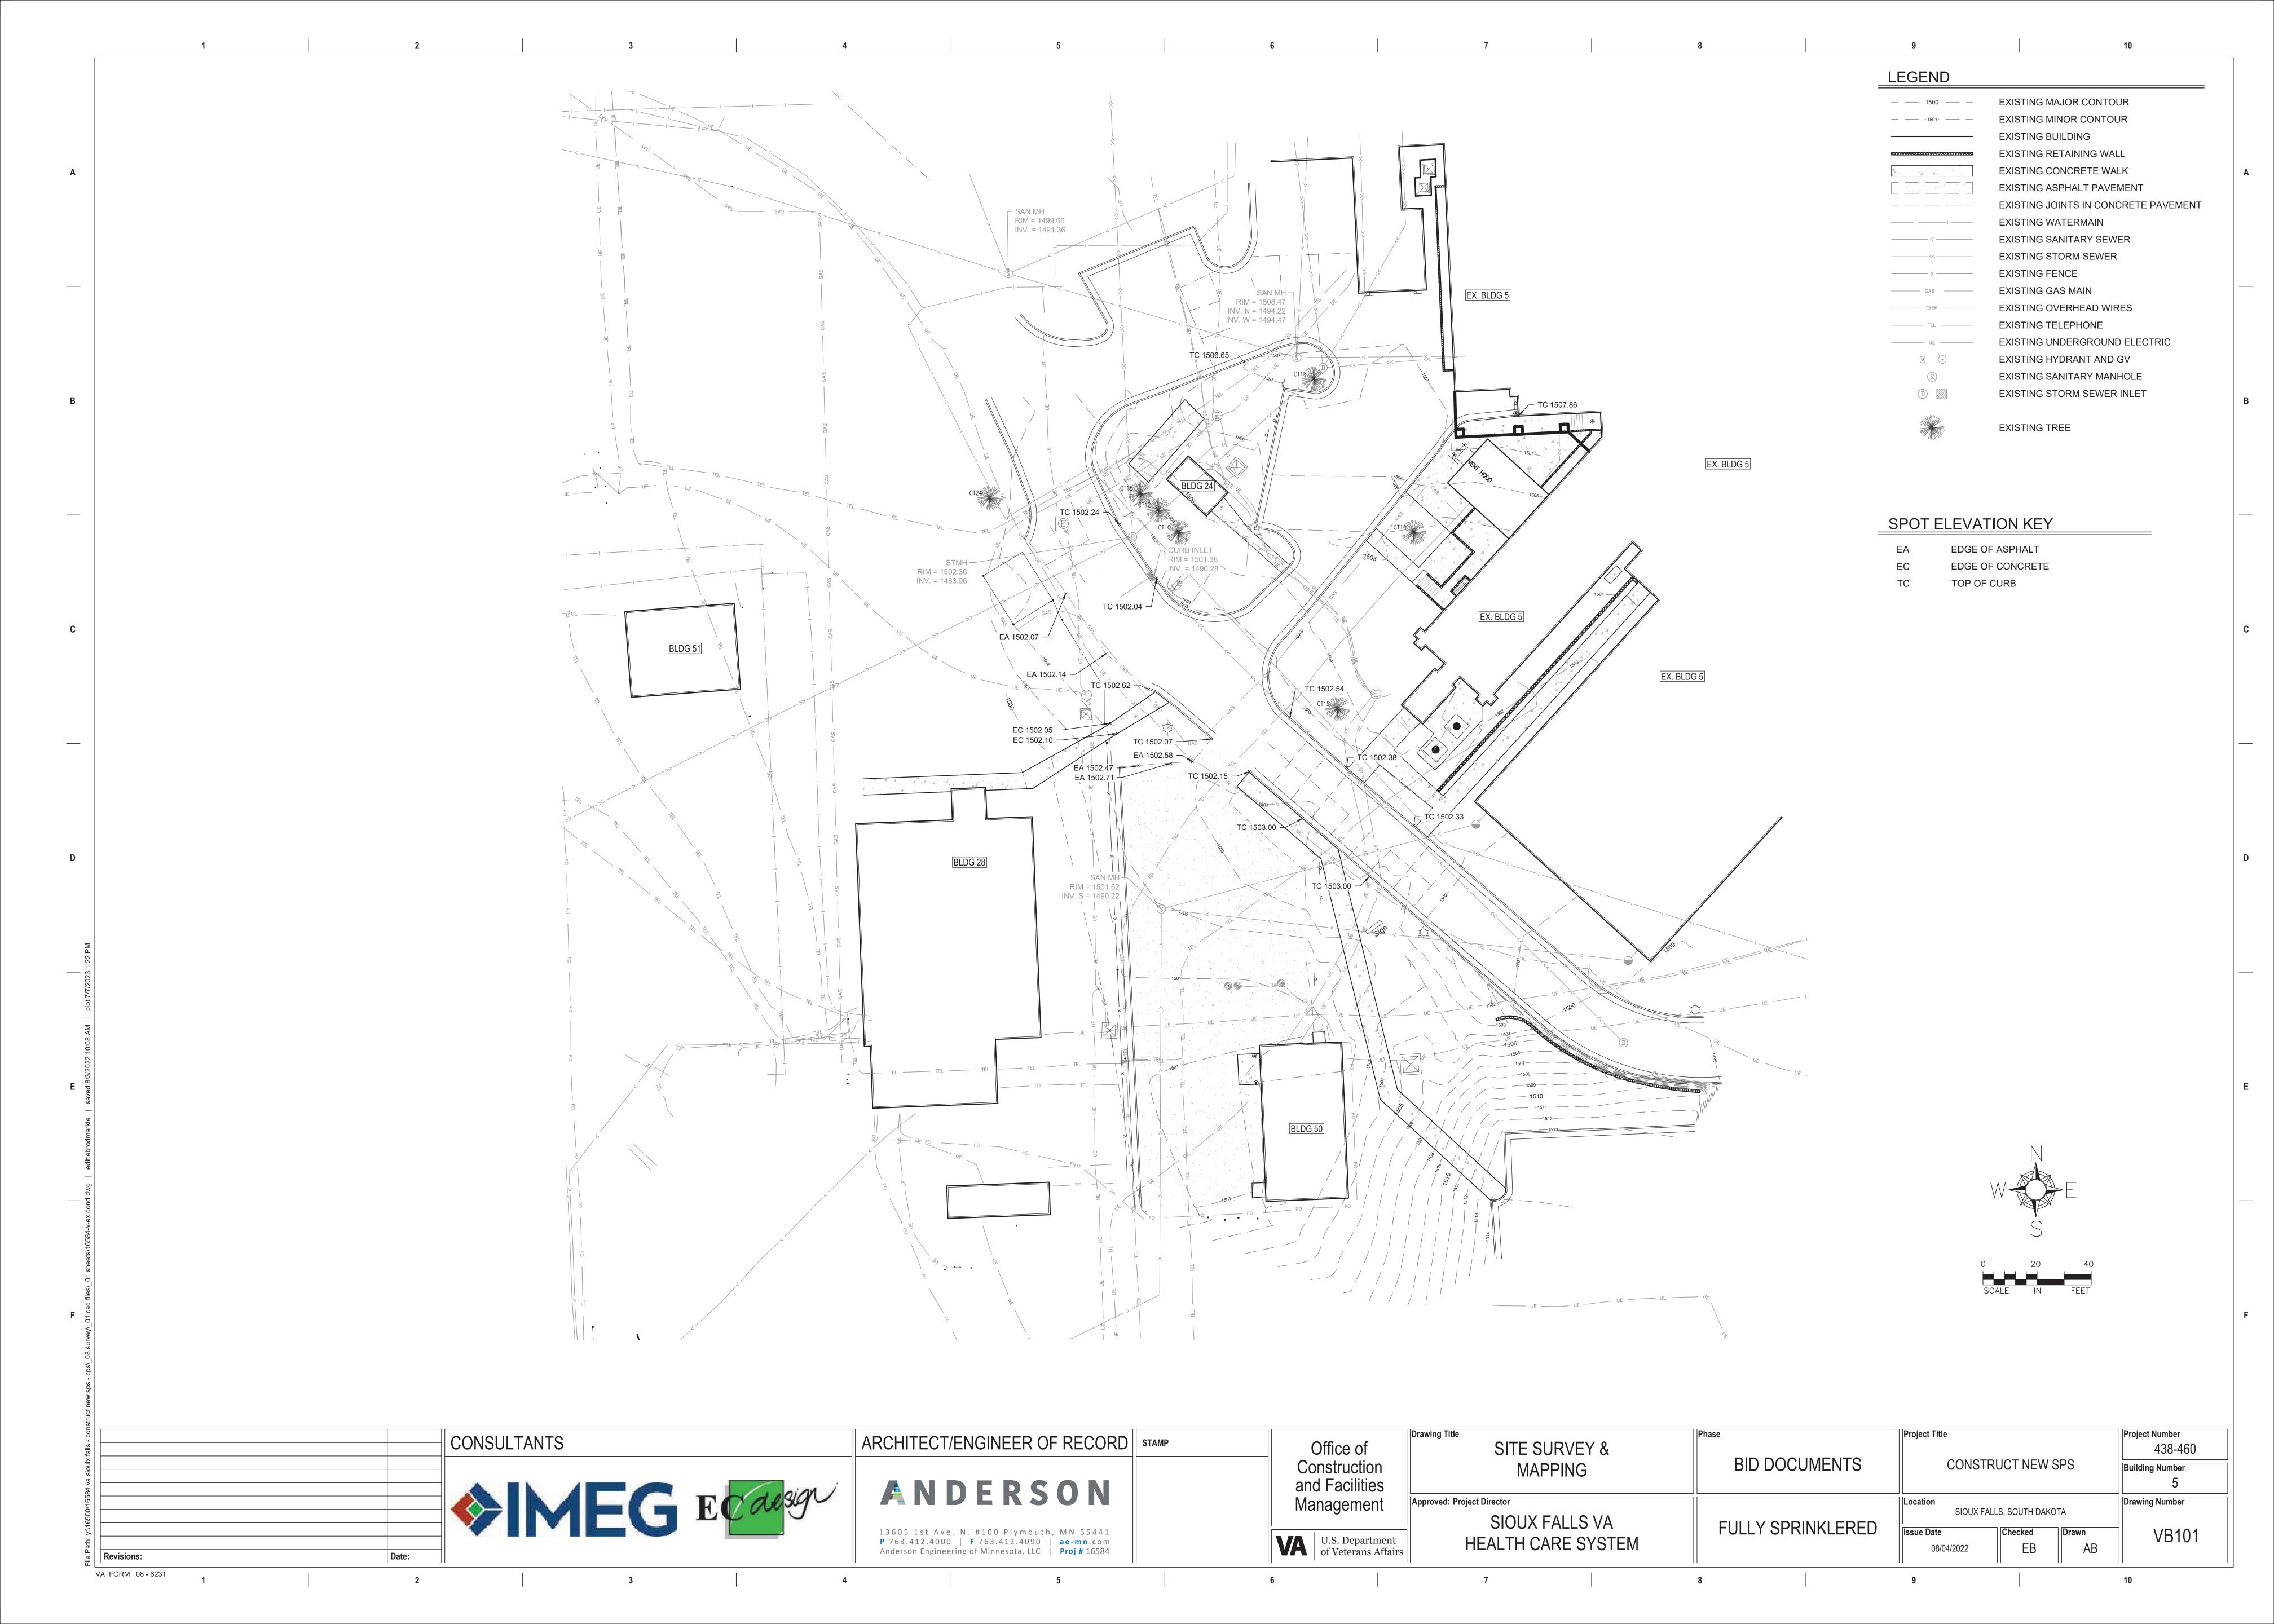
U.S. Department of Veterans Affairs


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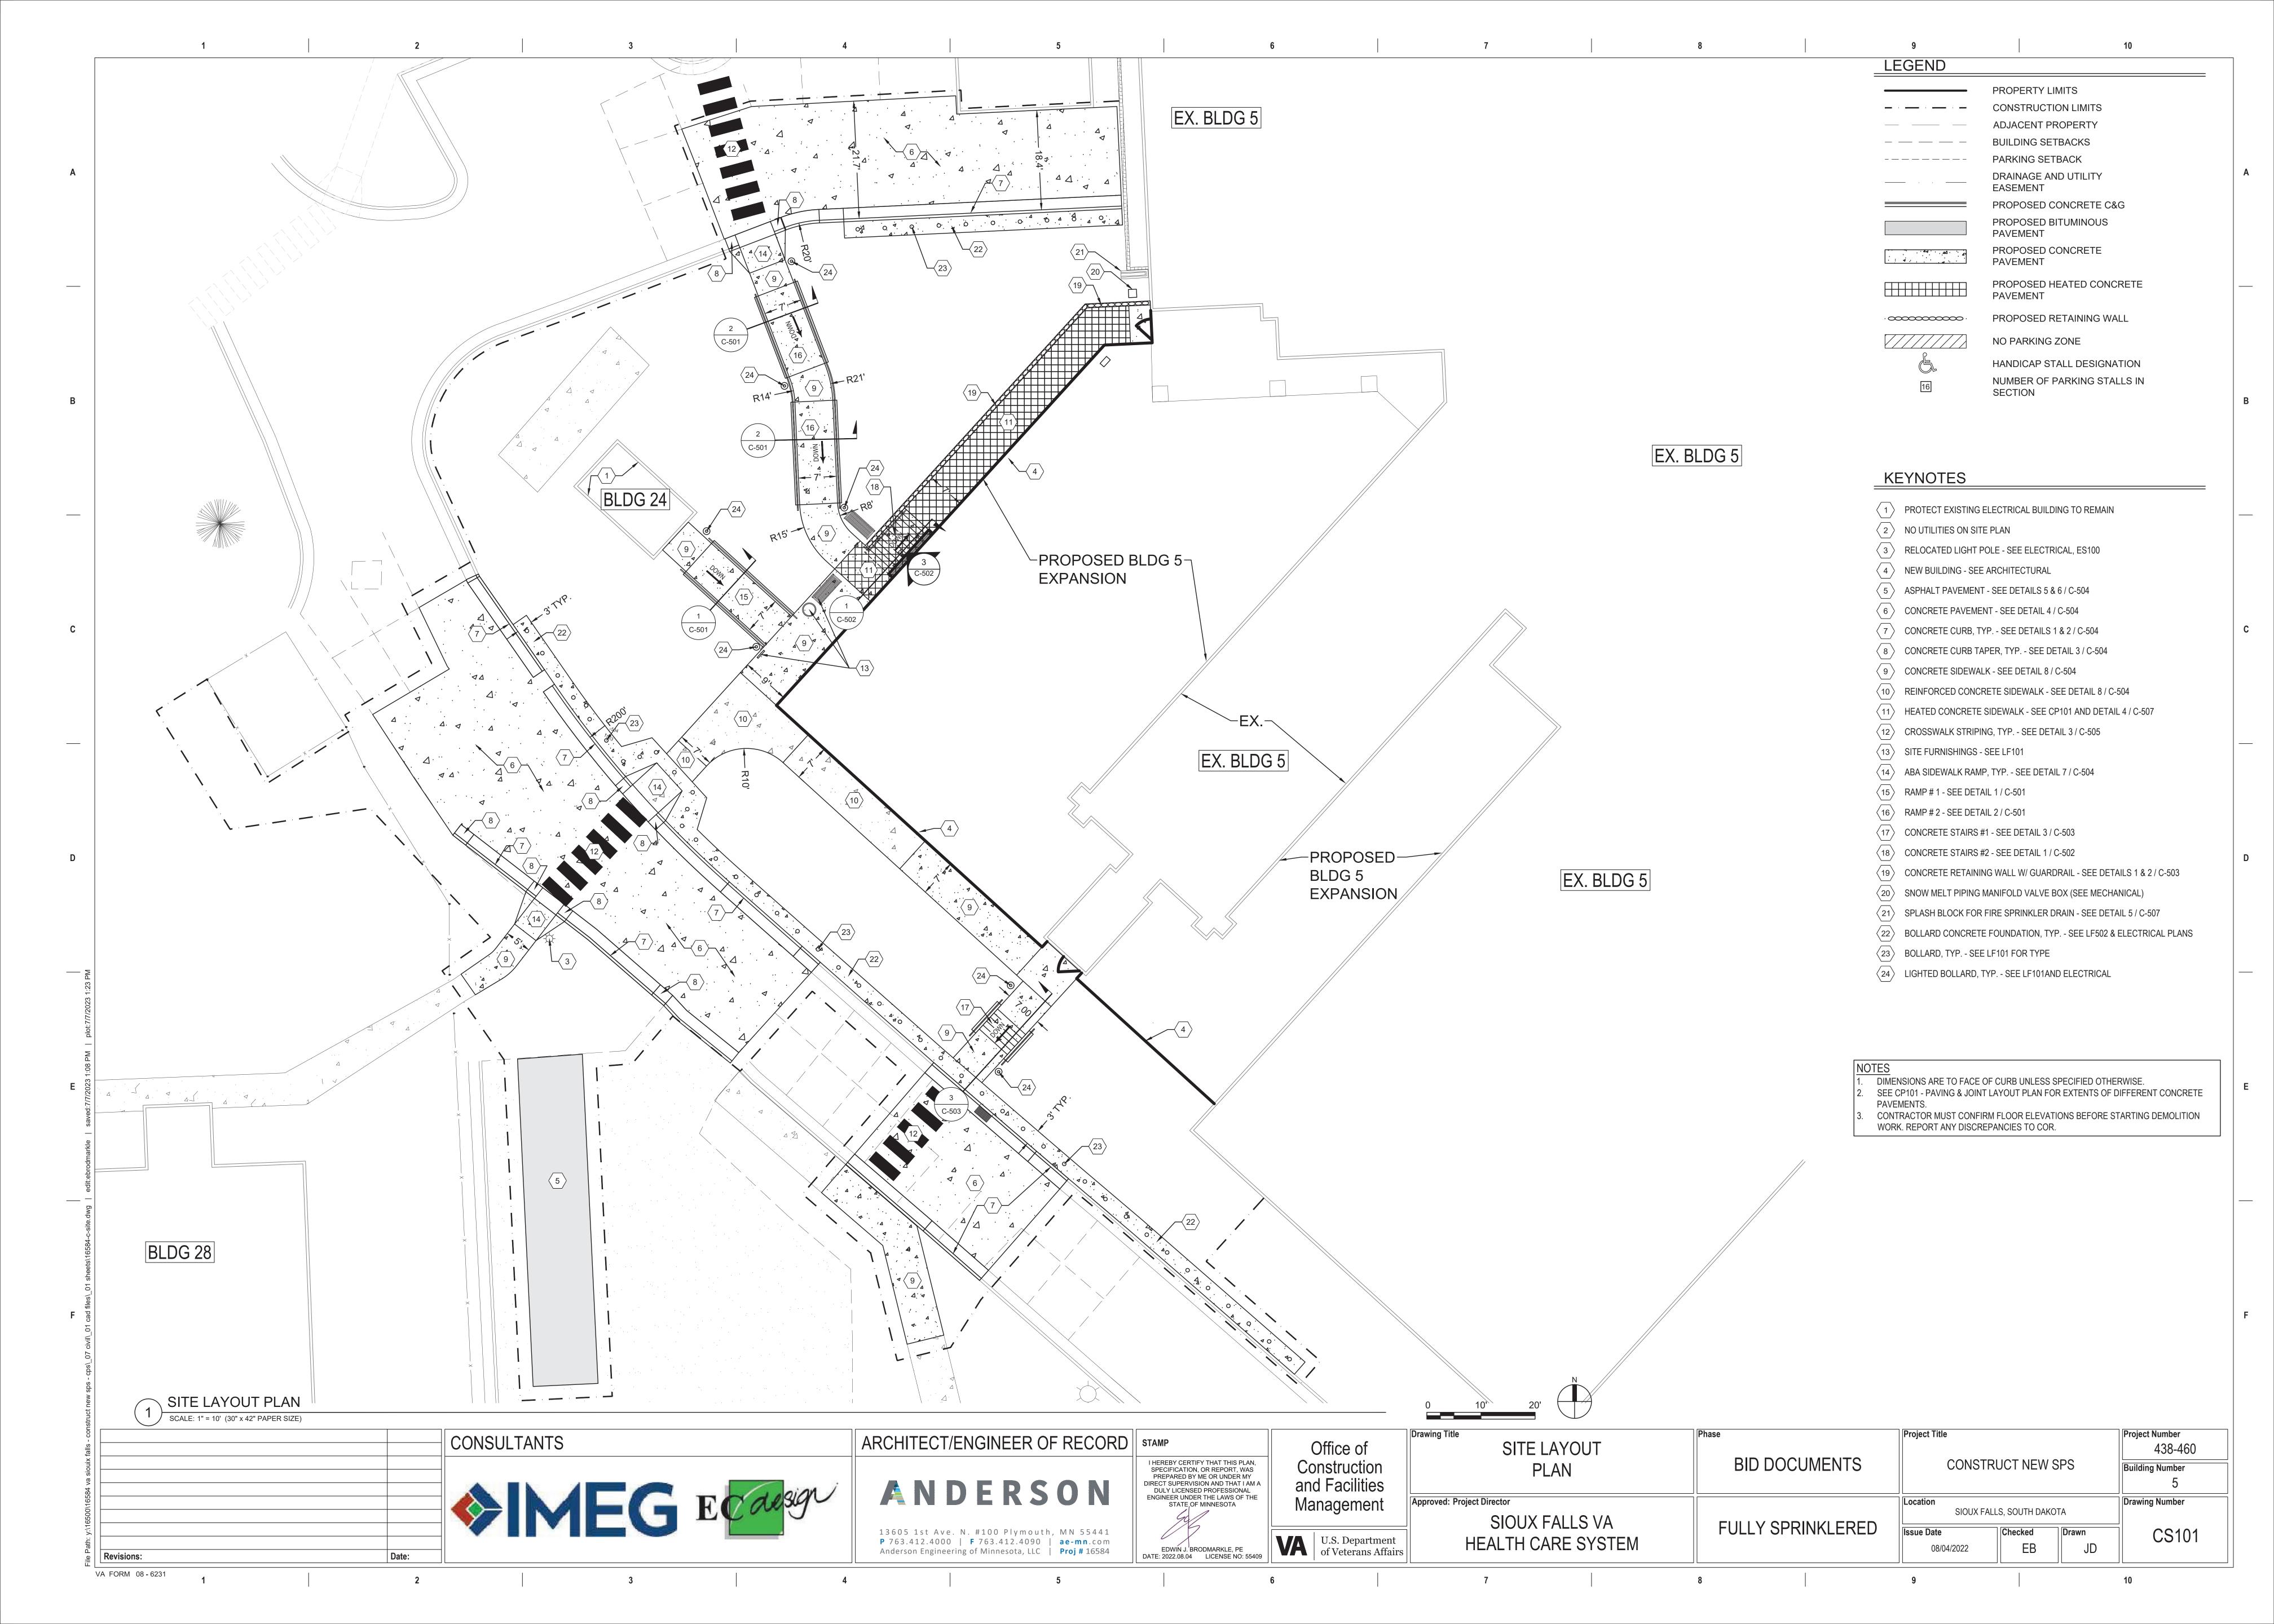
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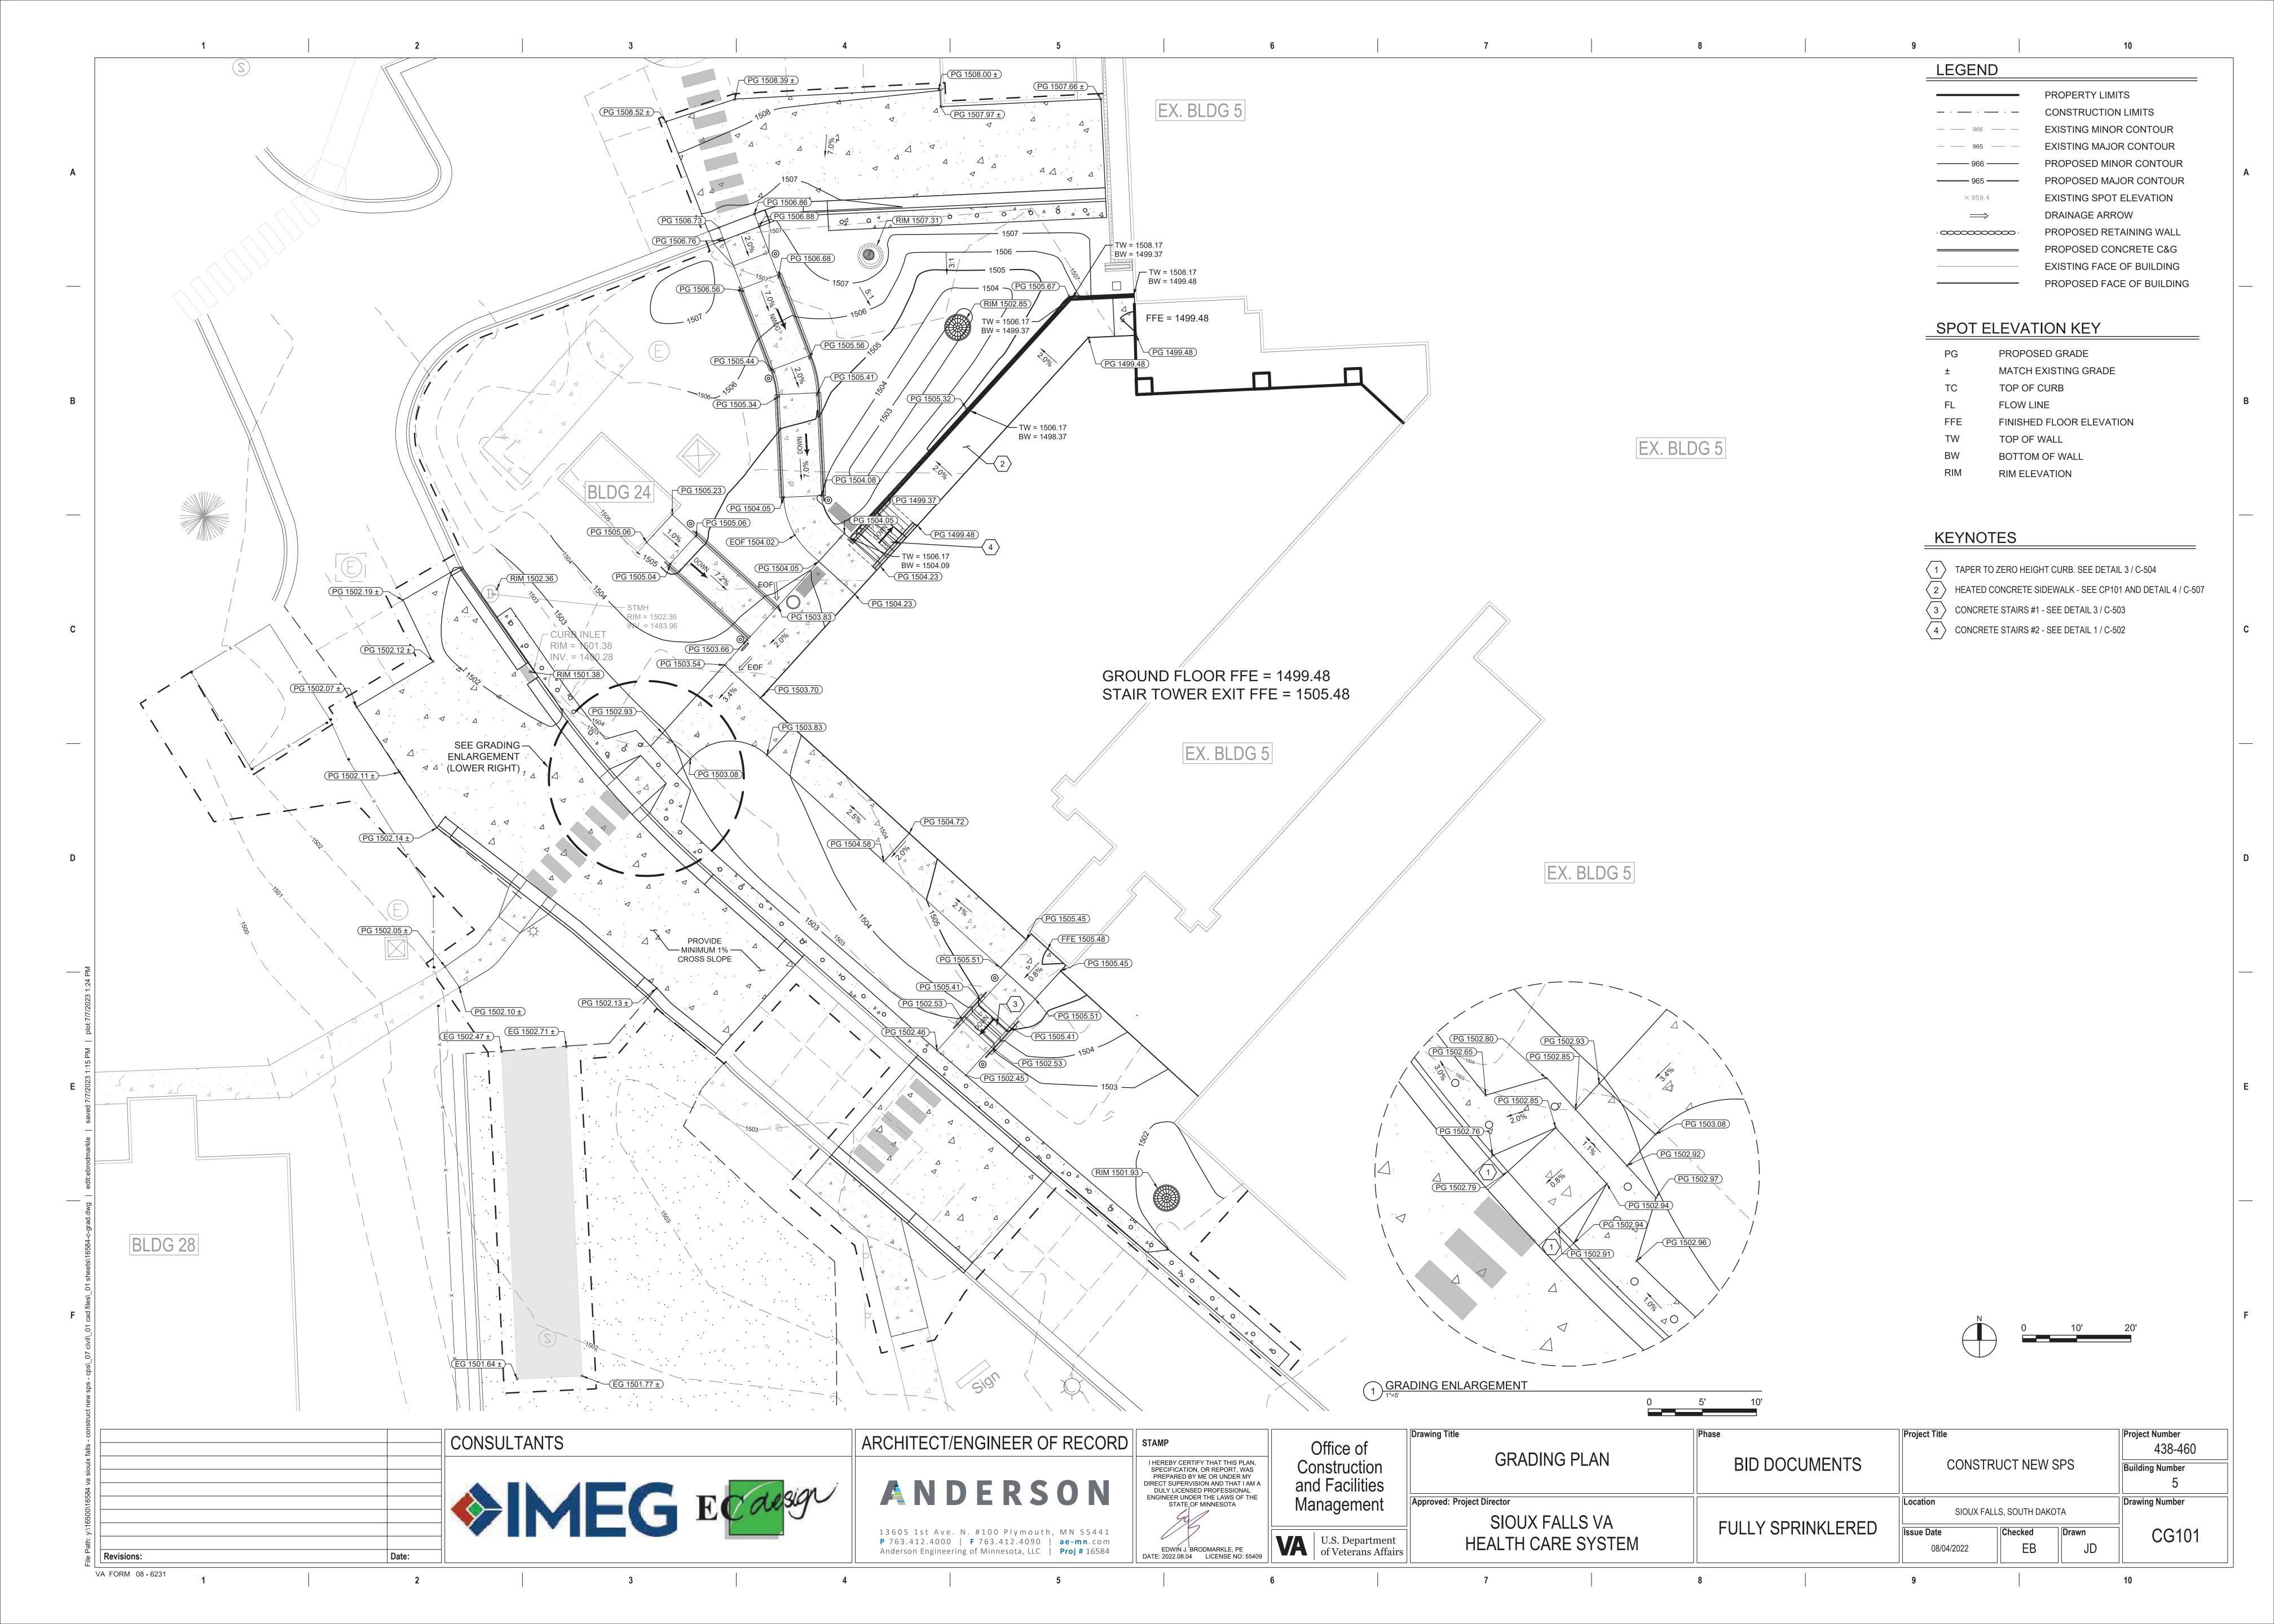
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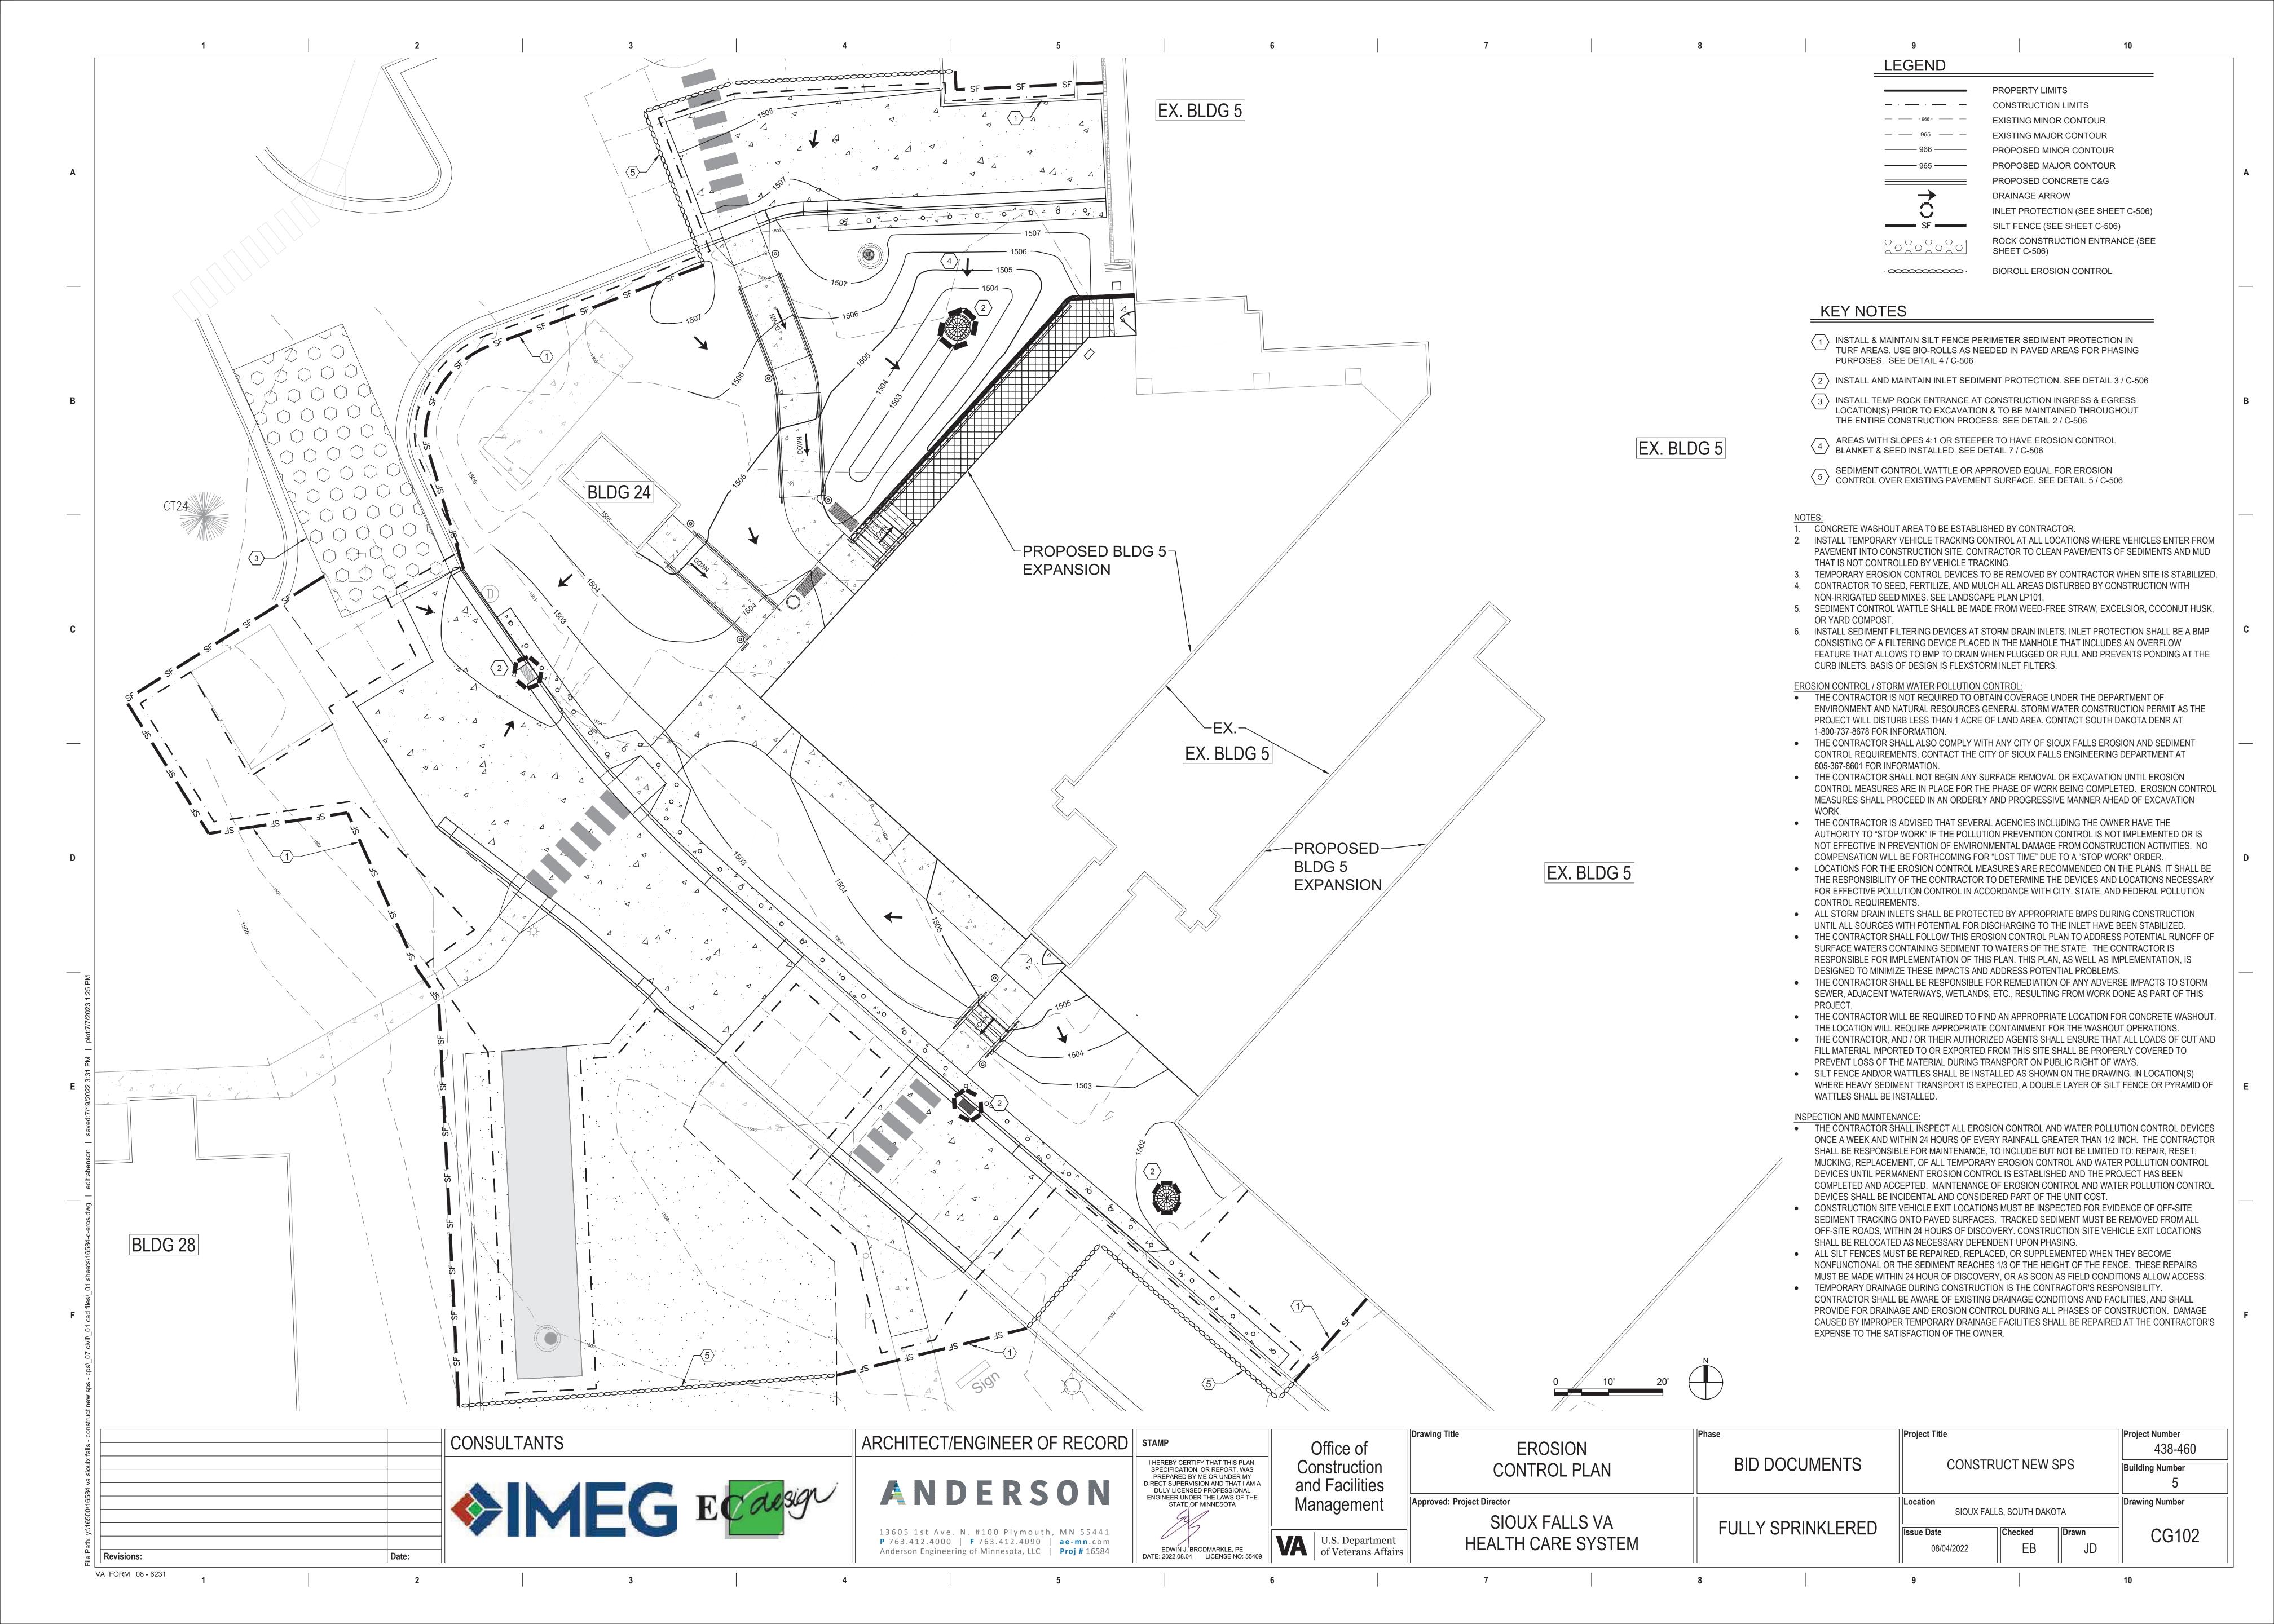











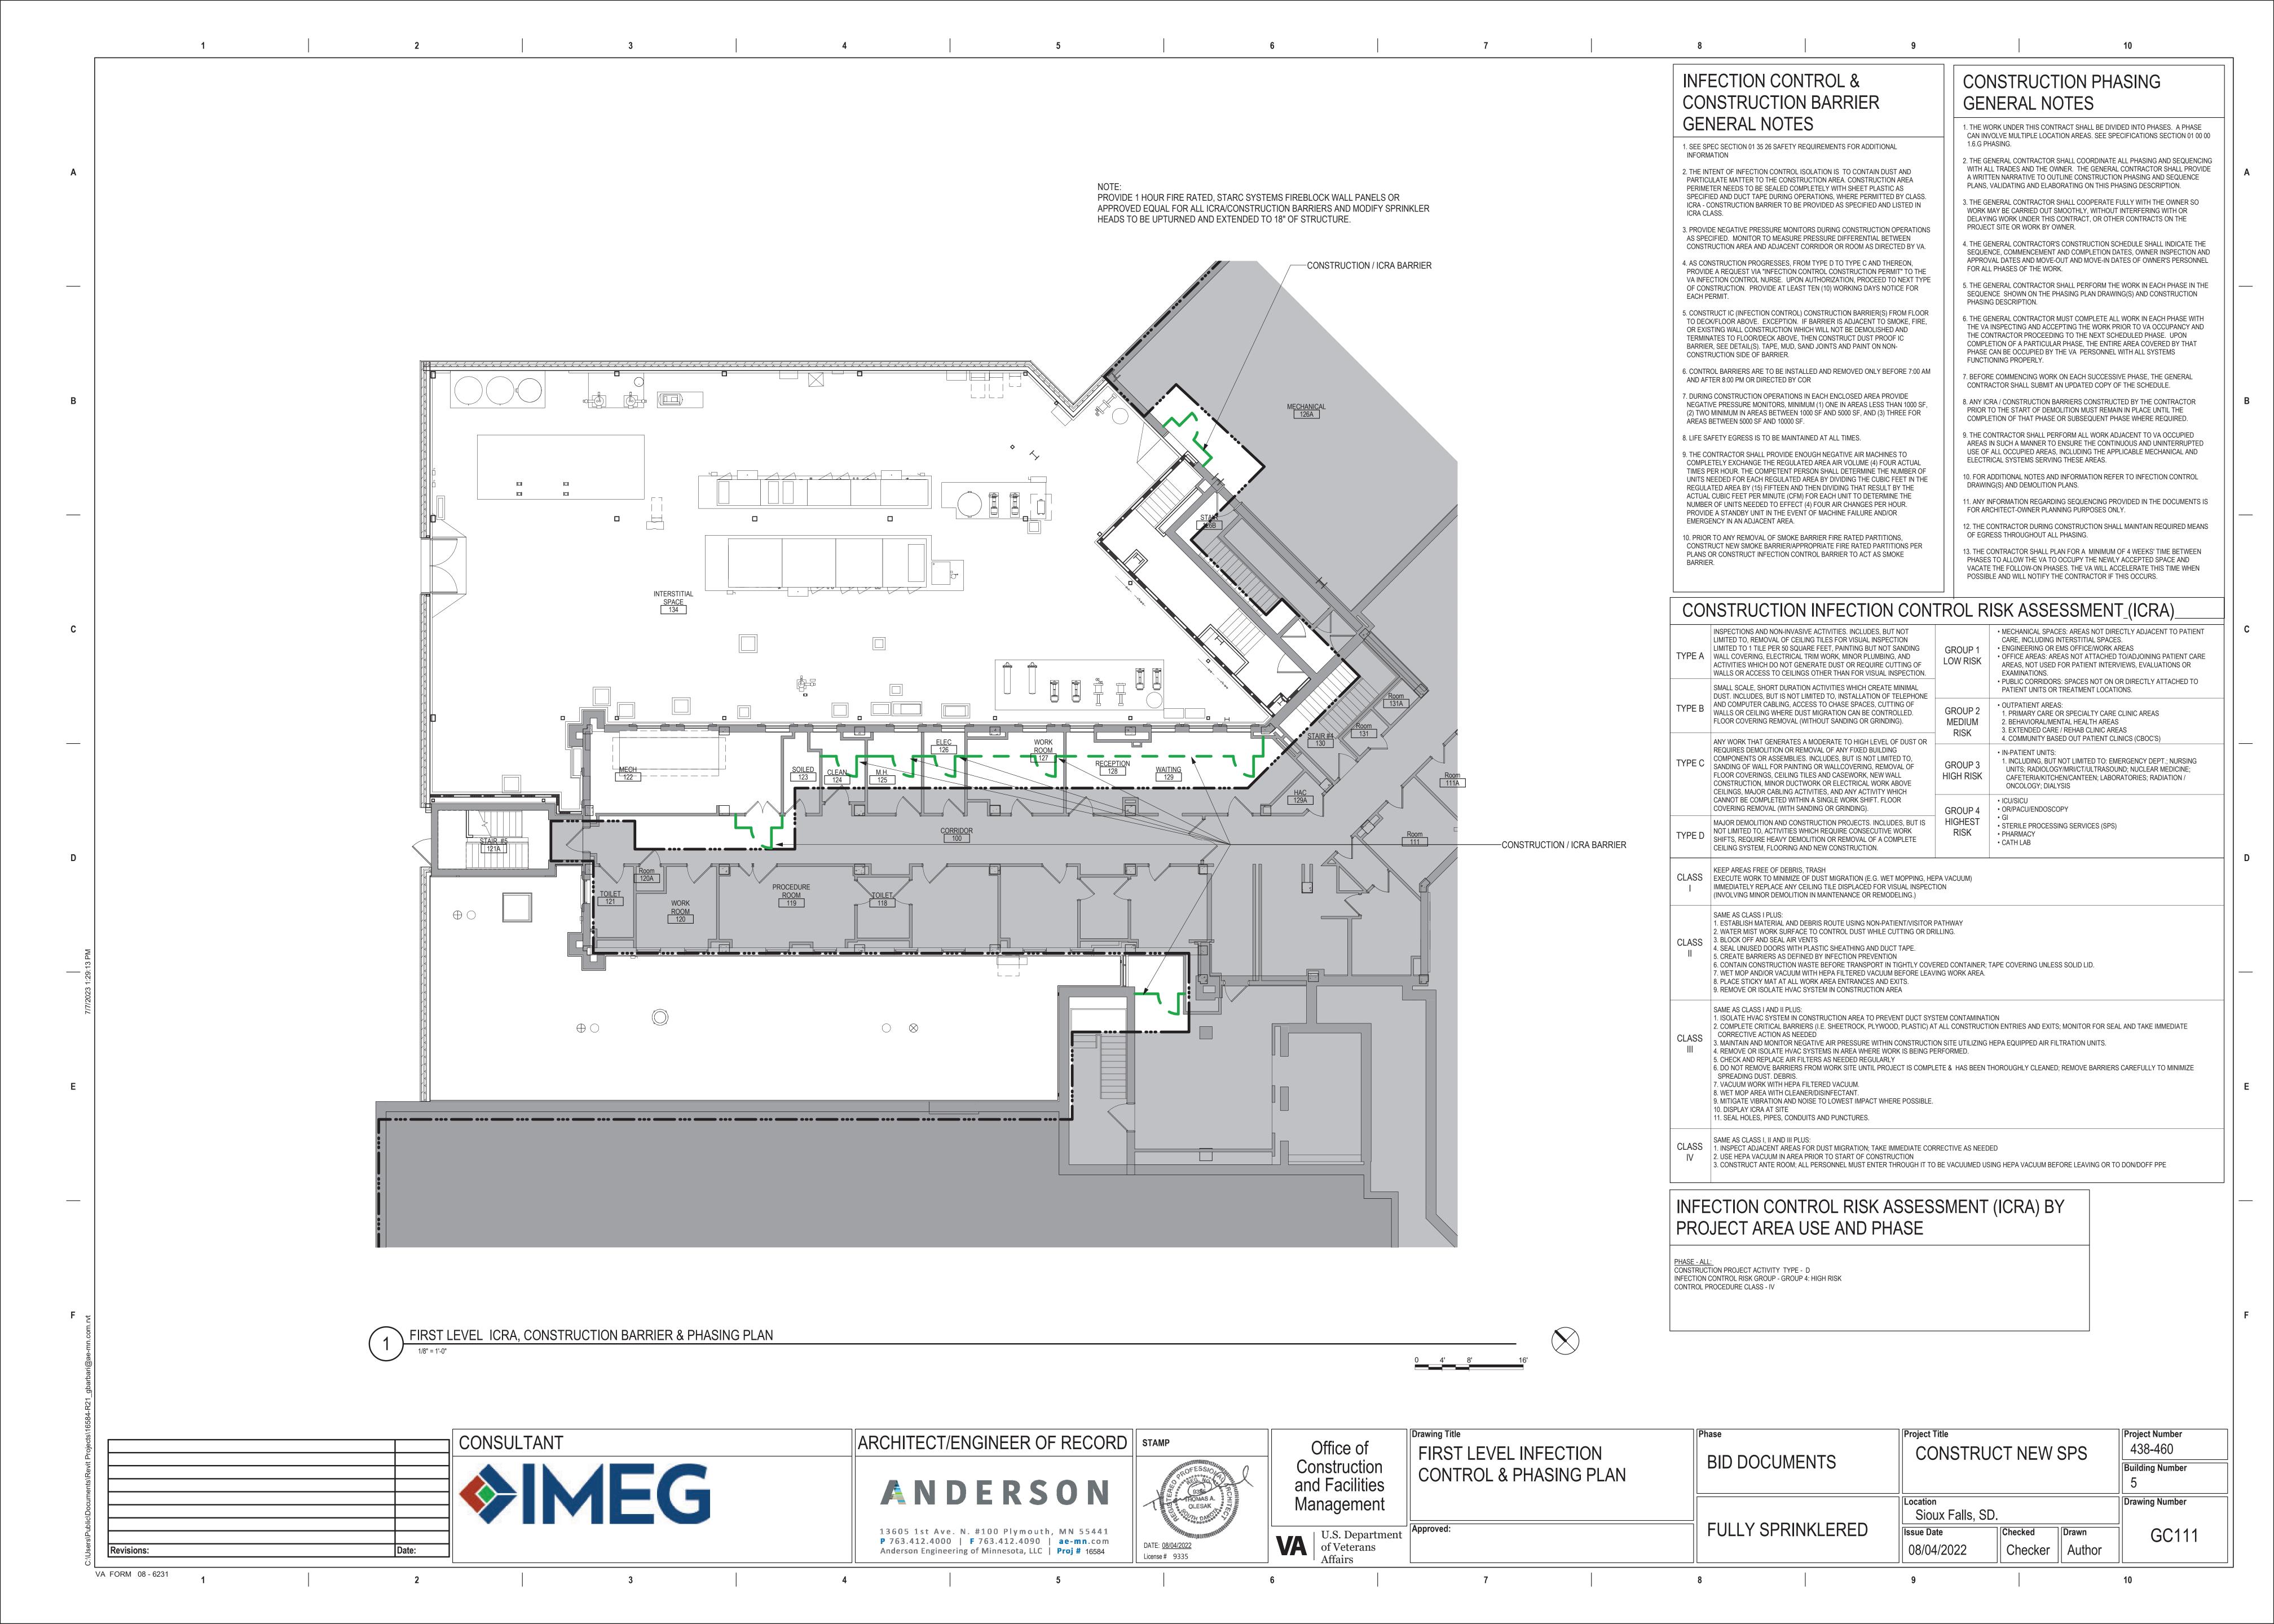


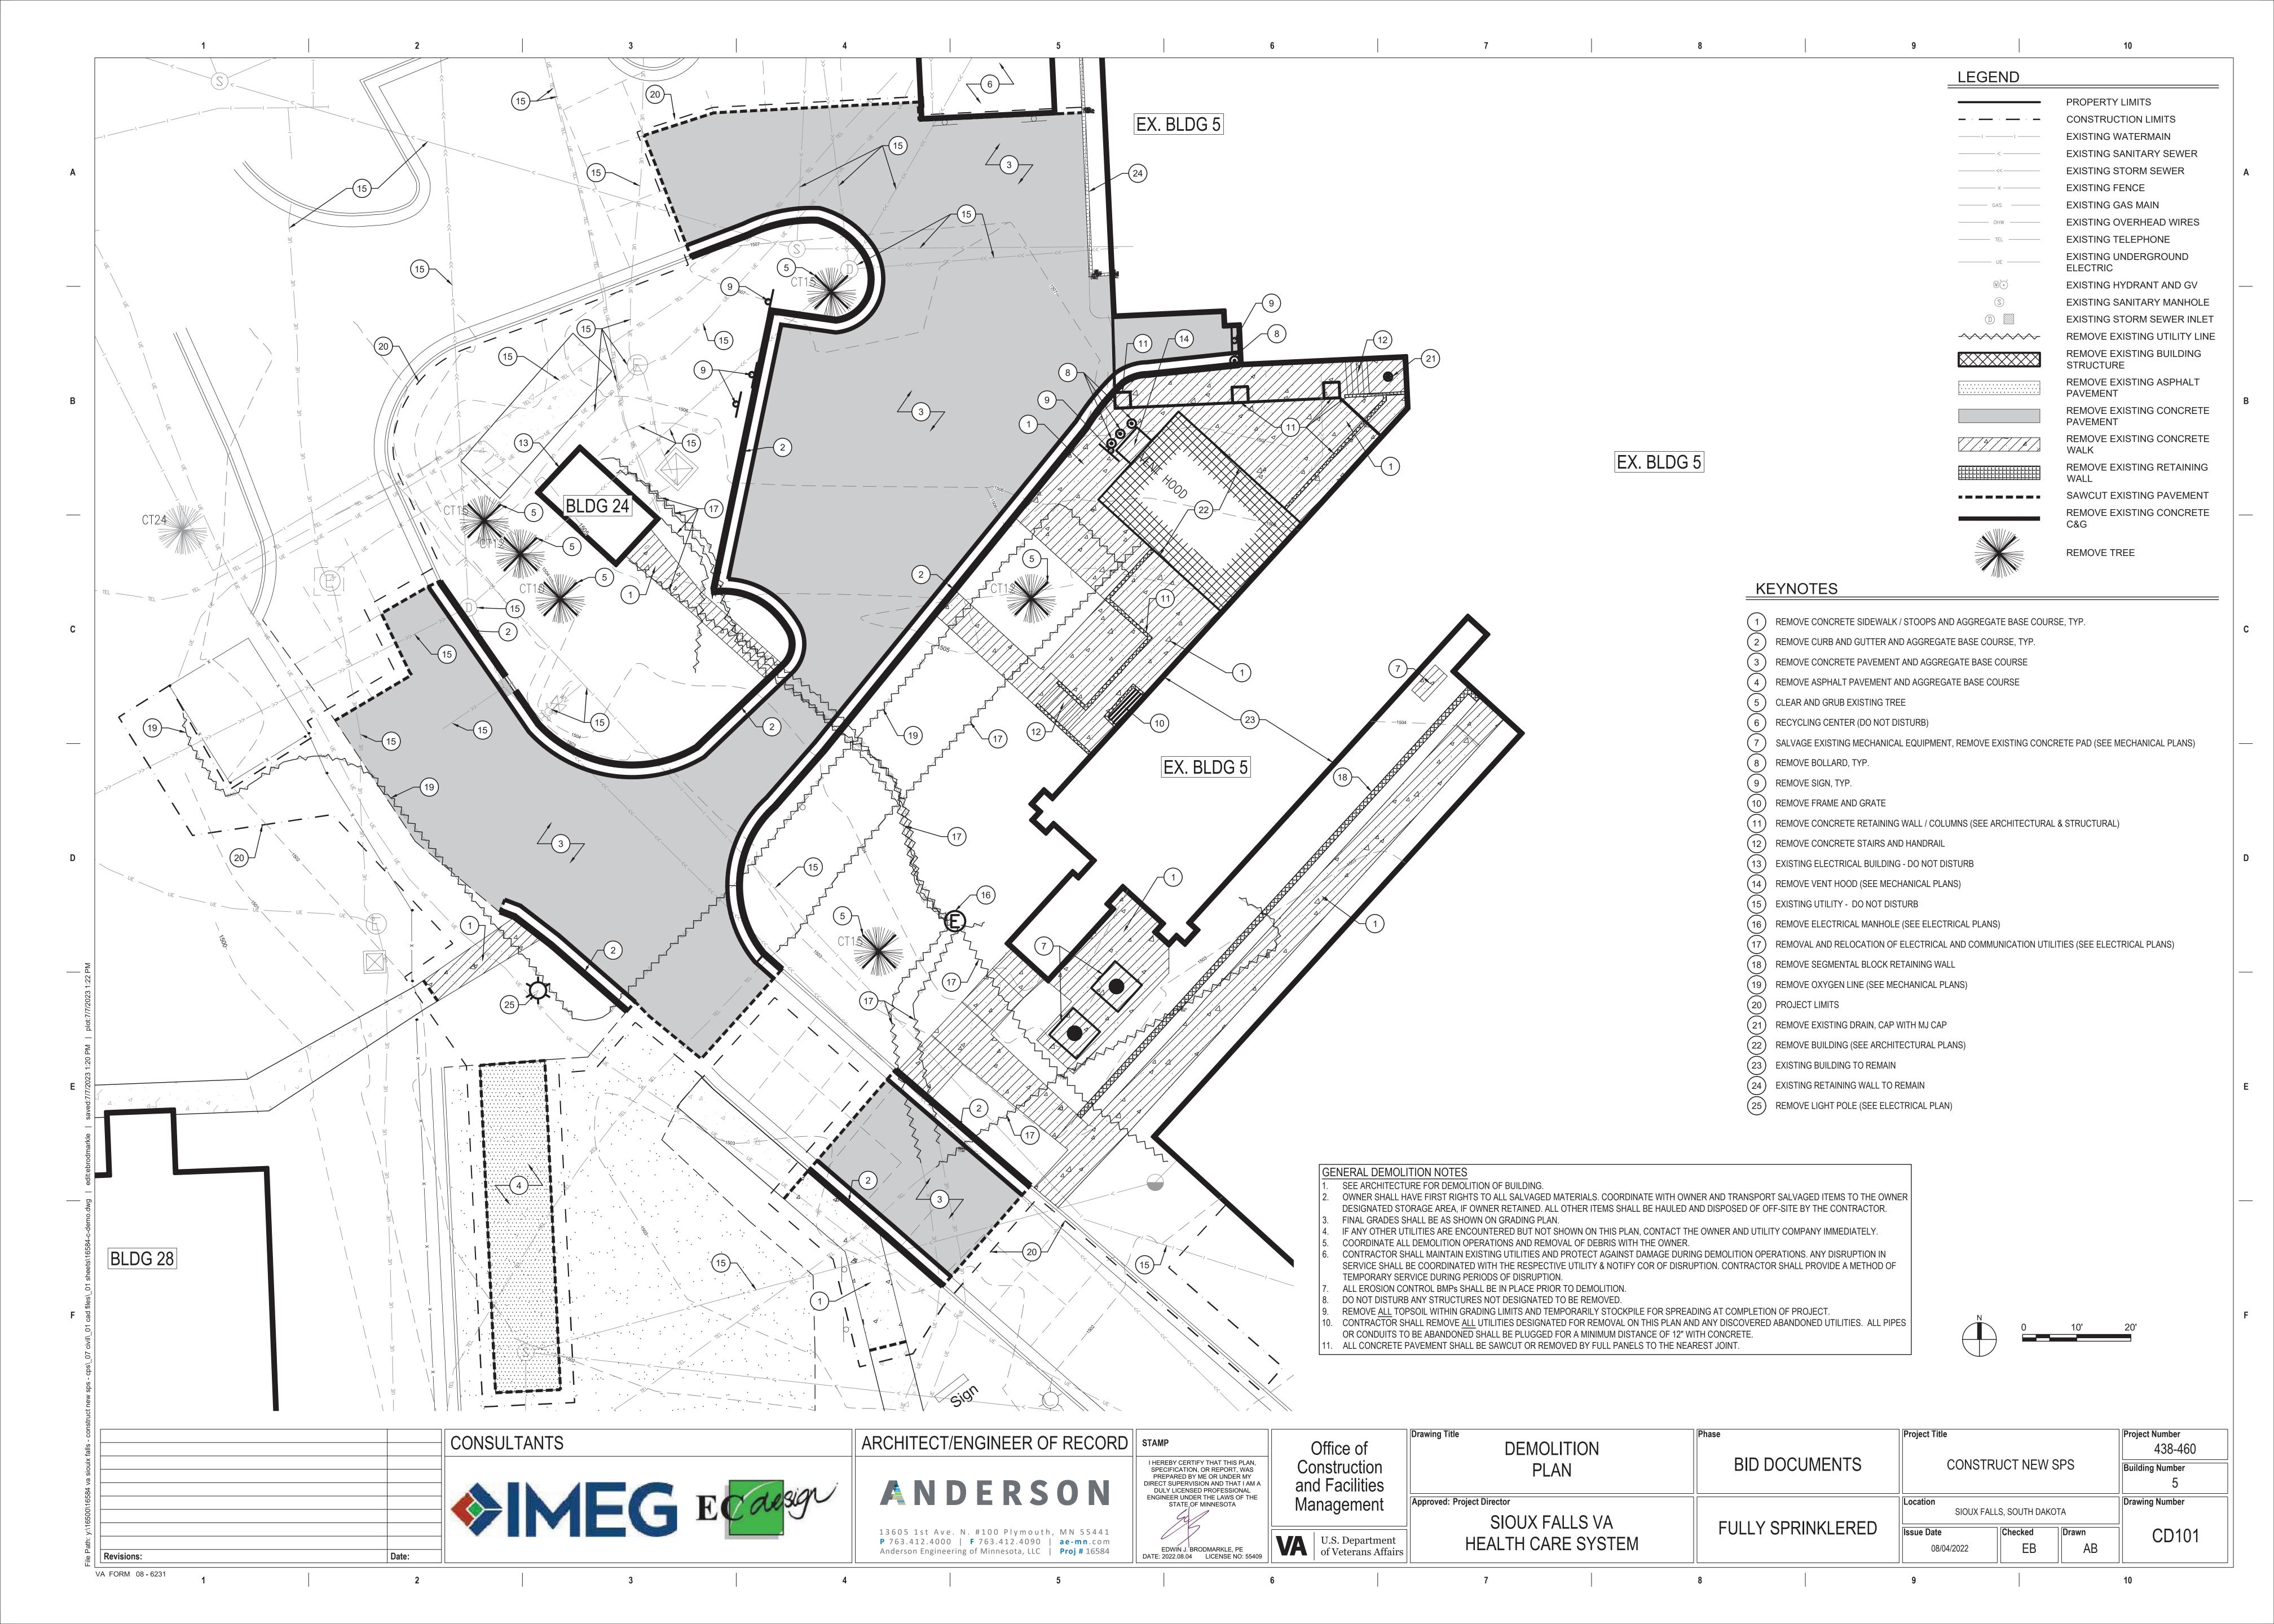


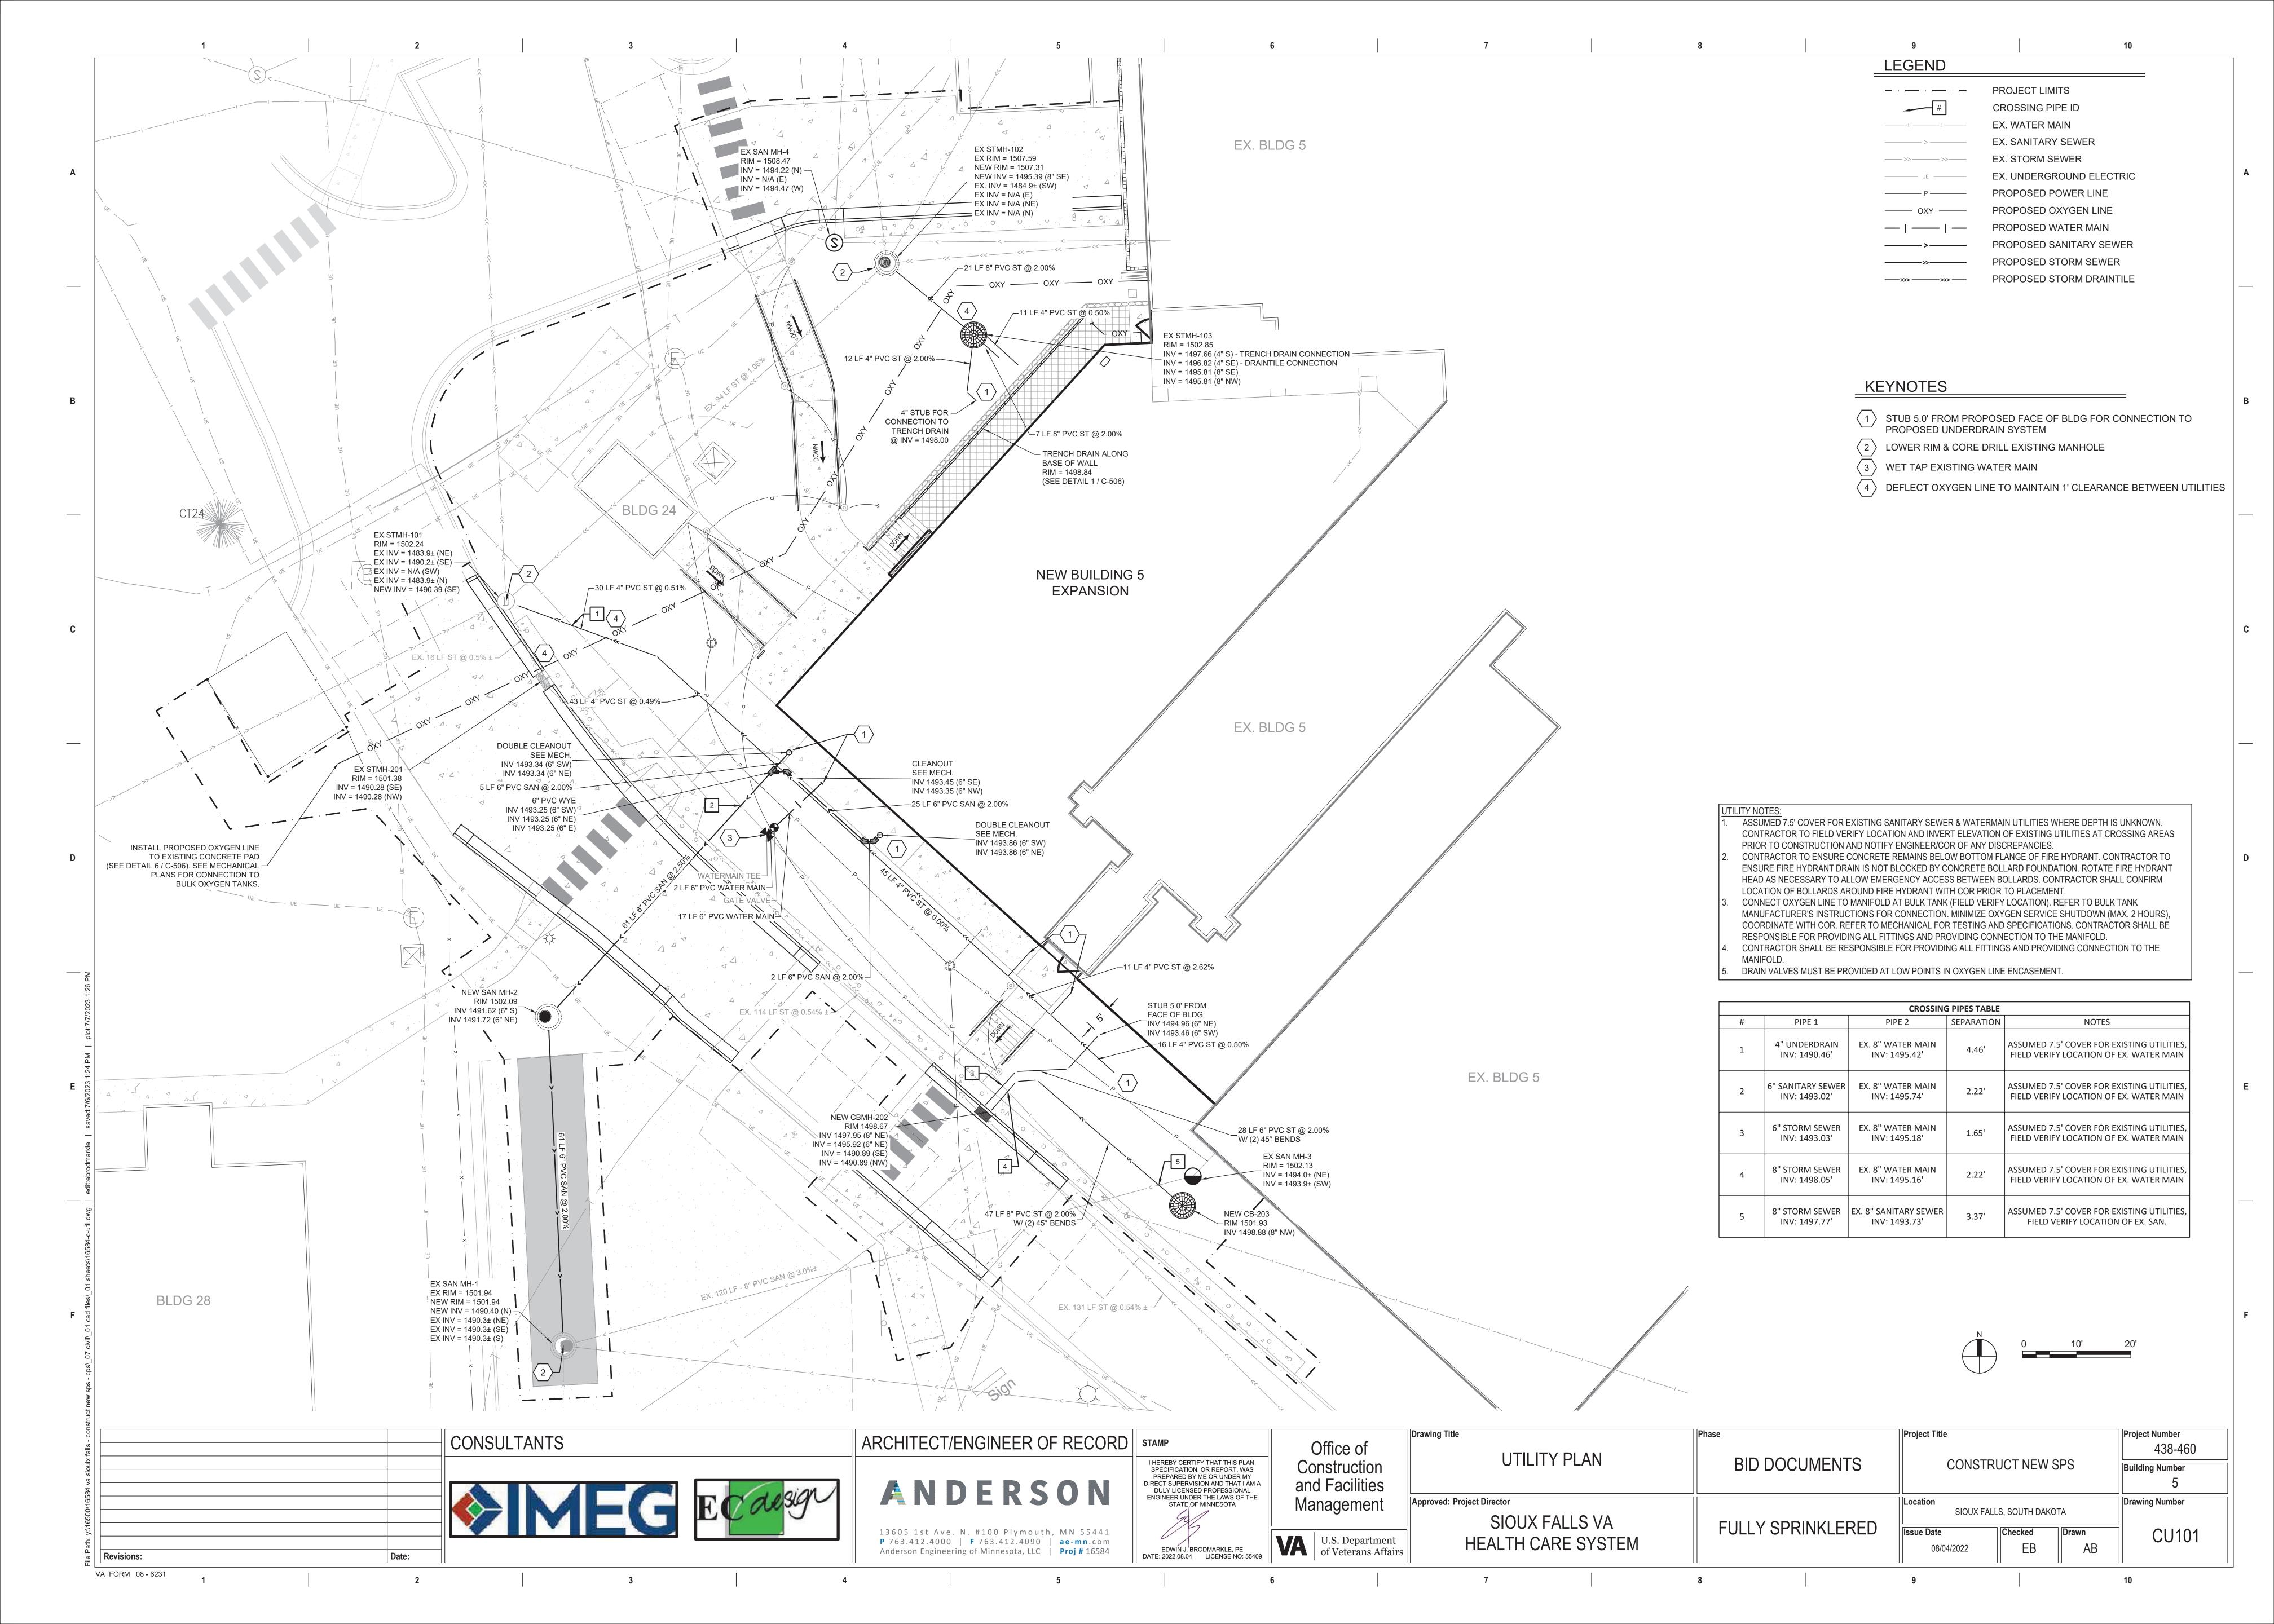


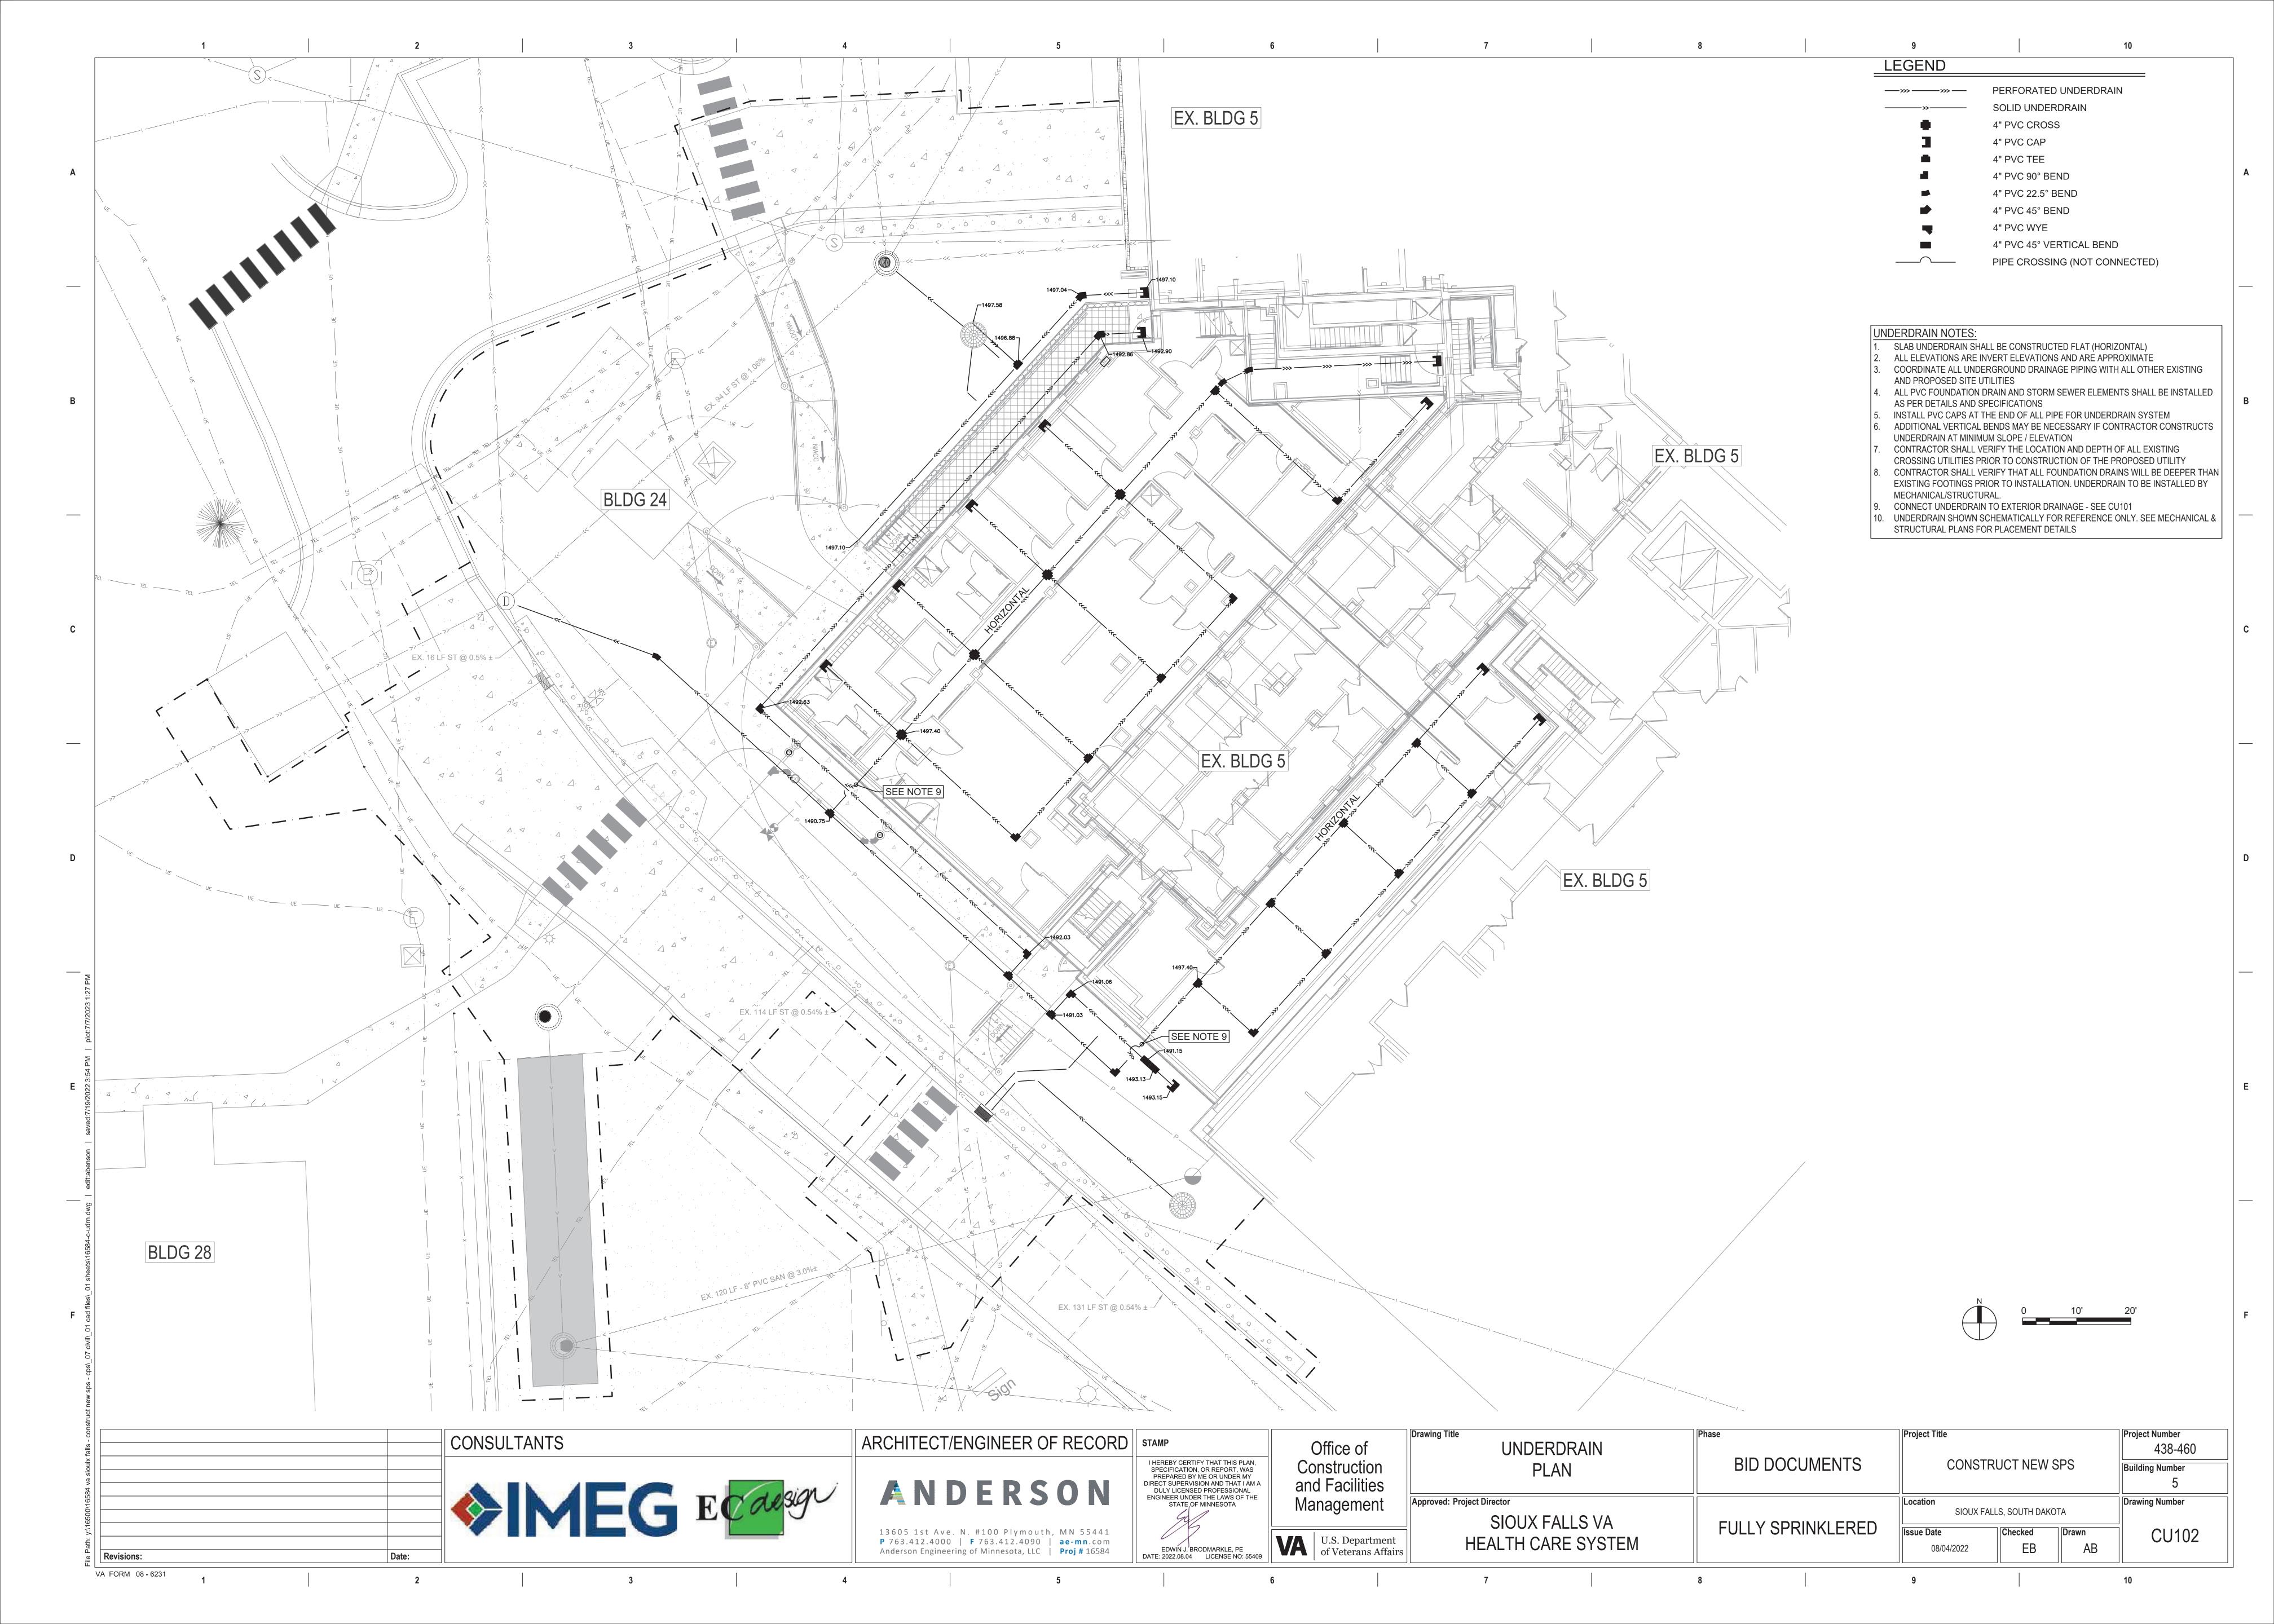


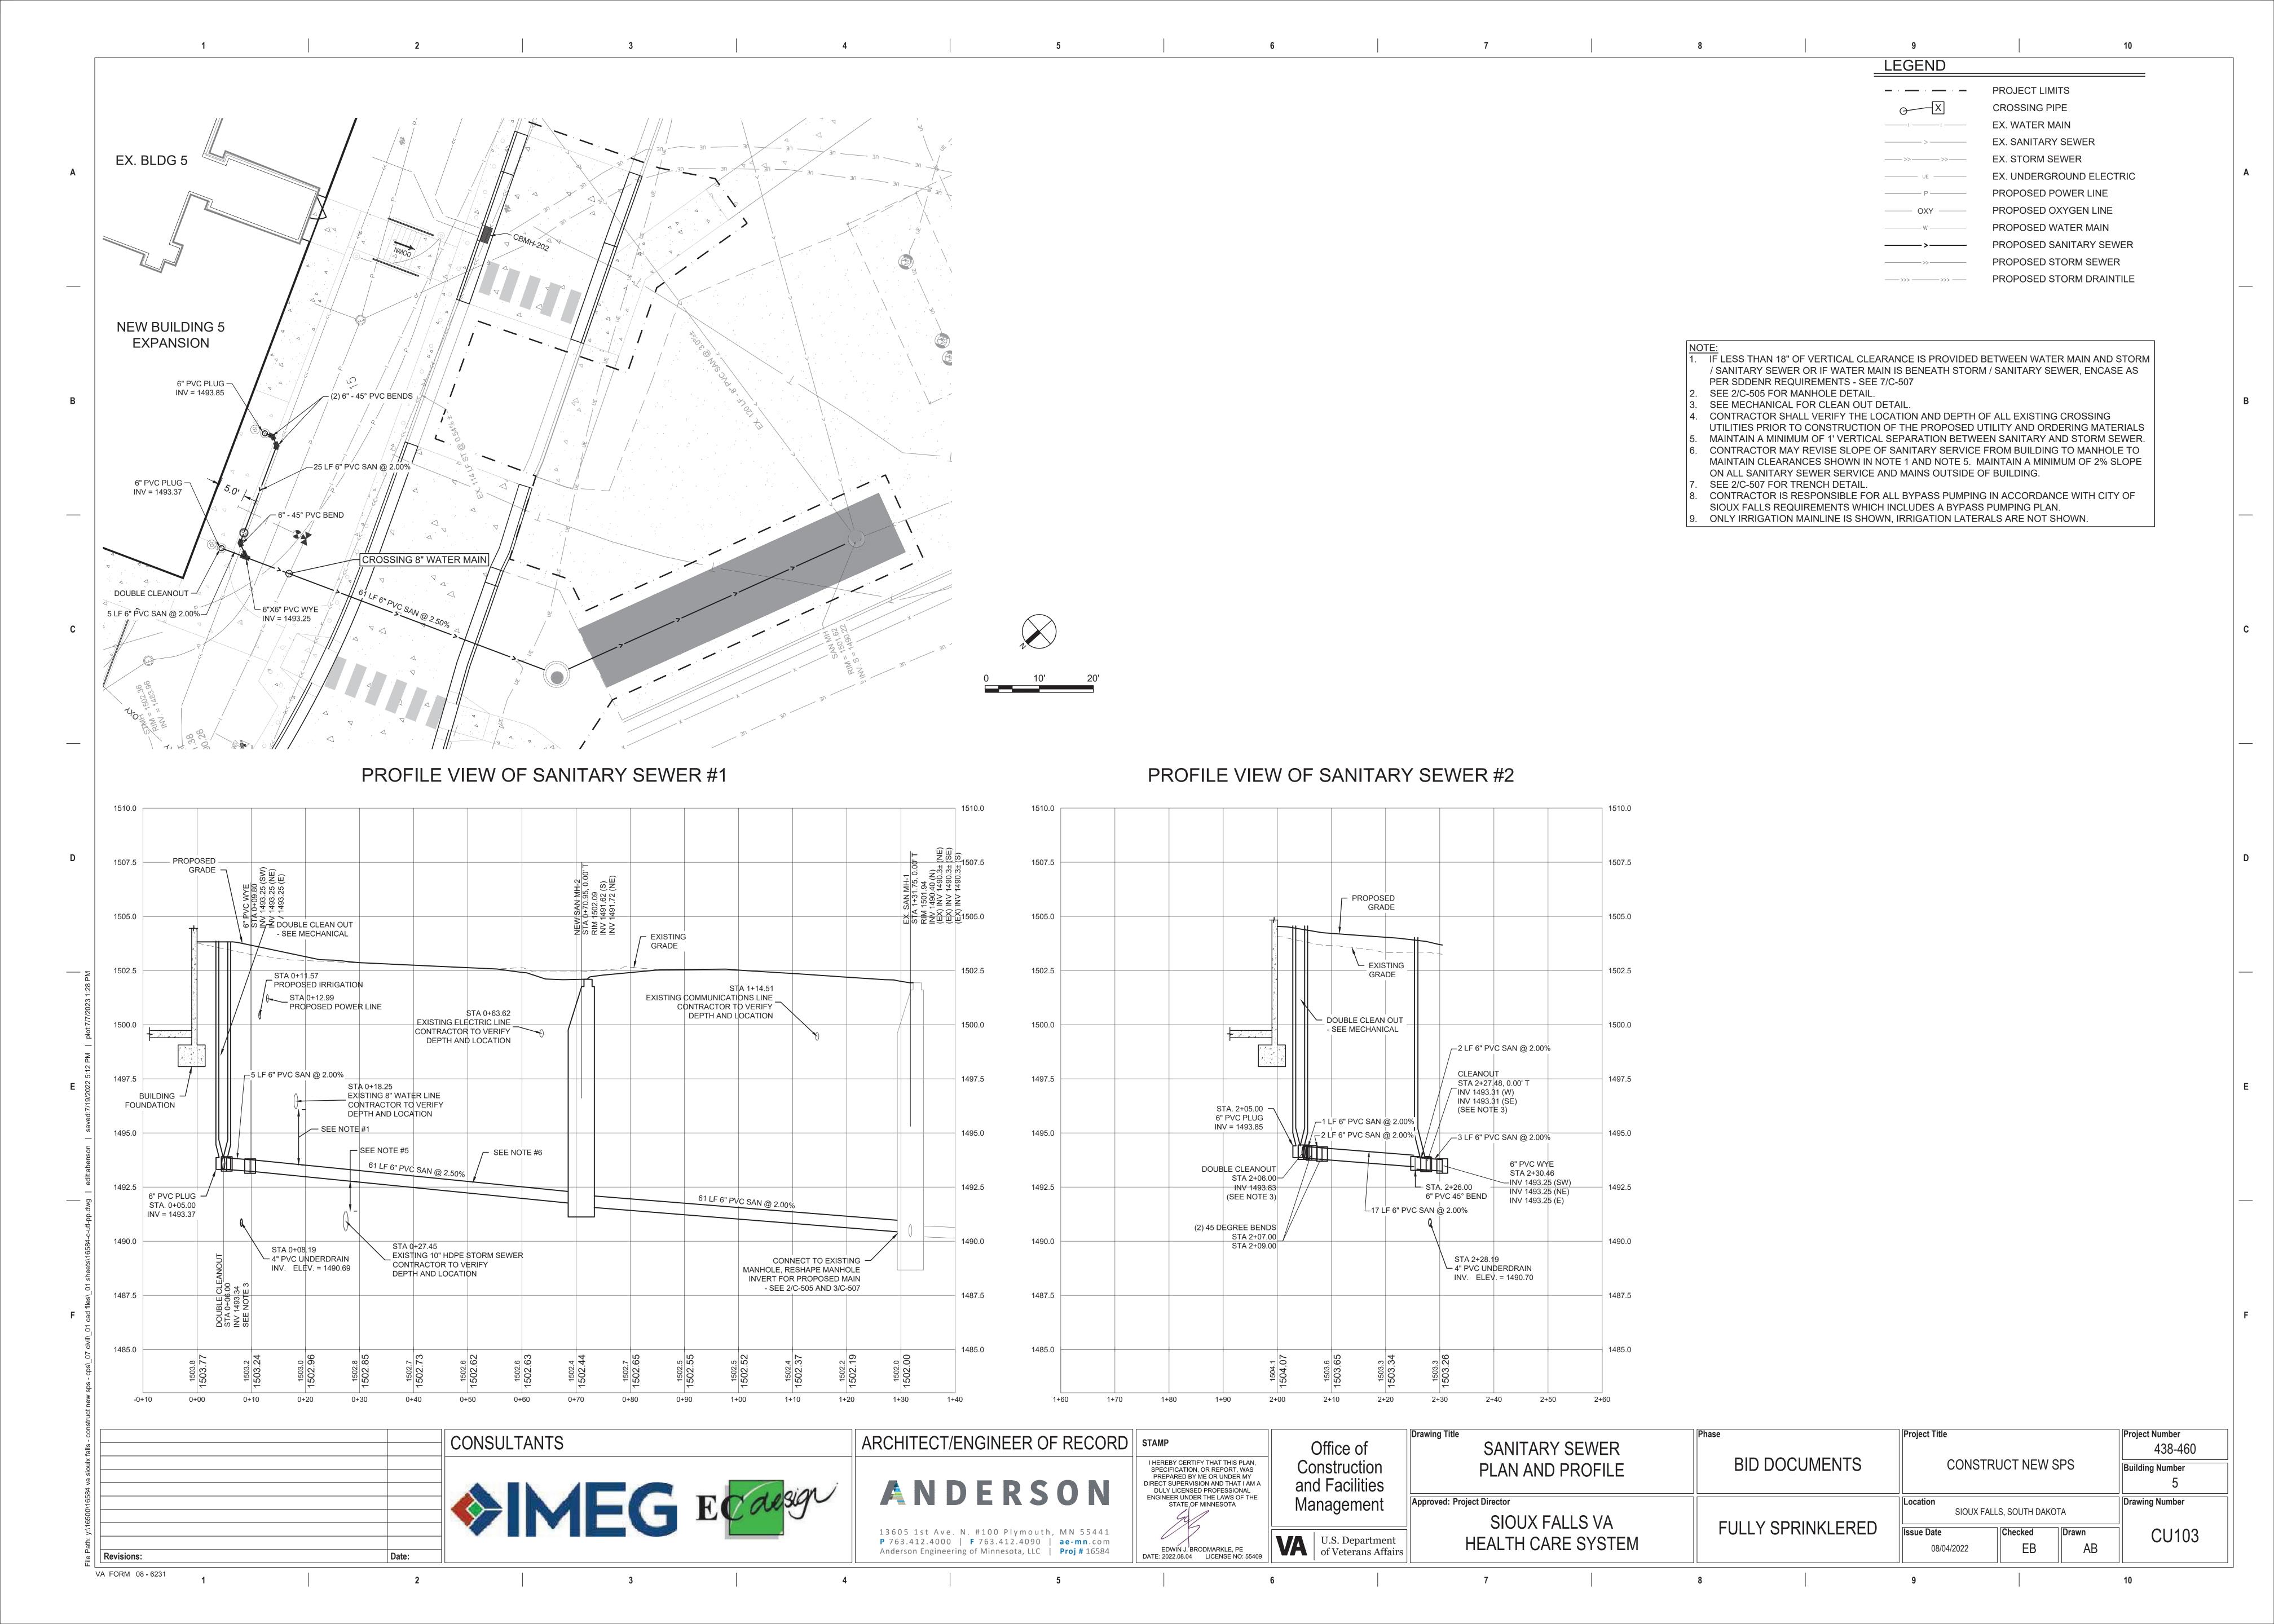


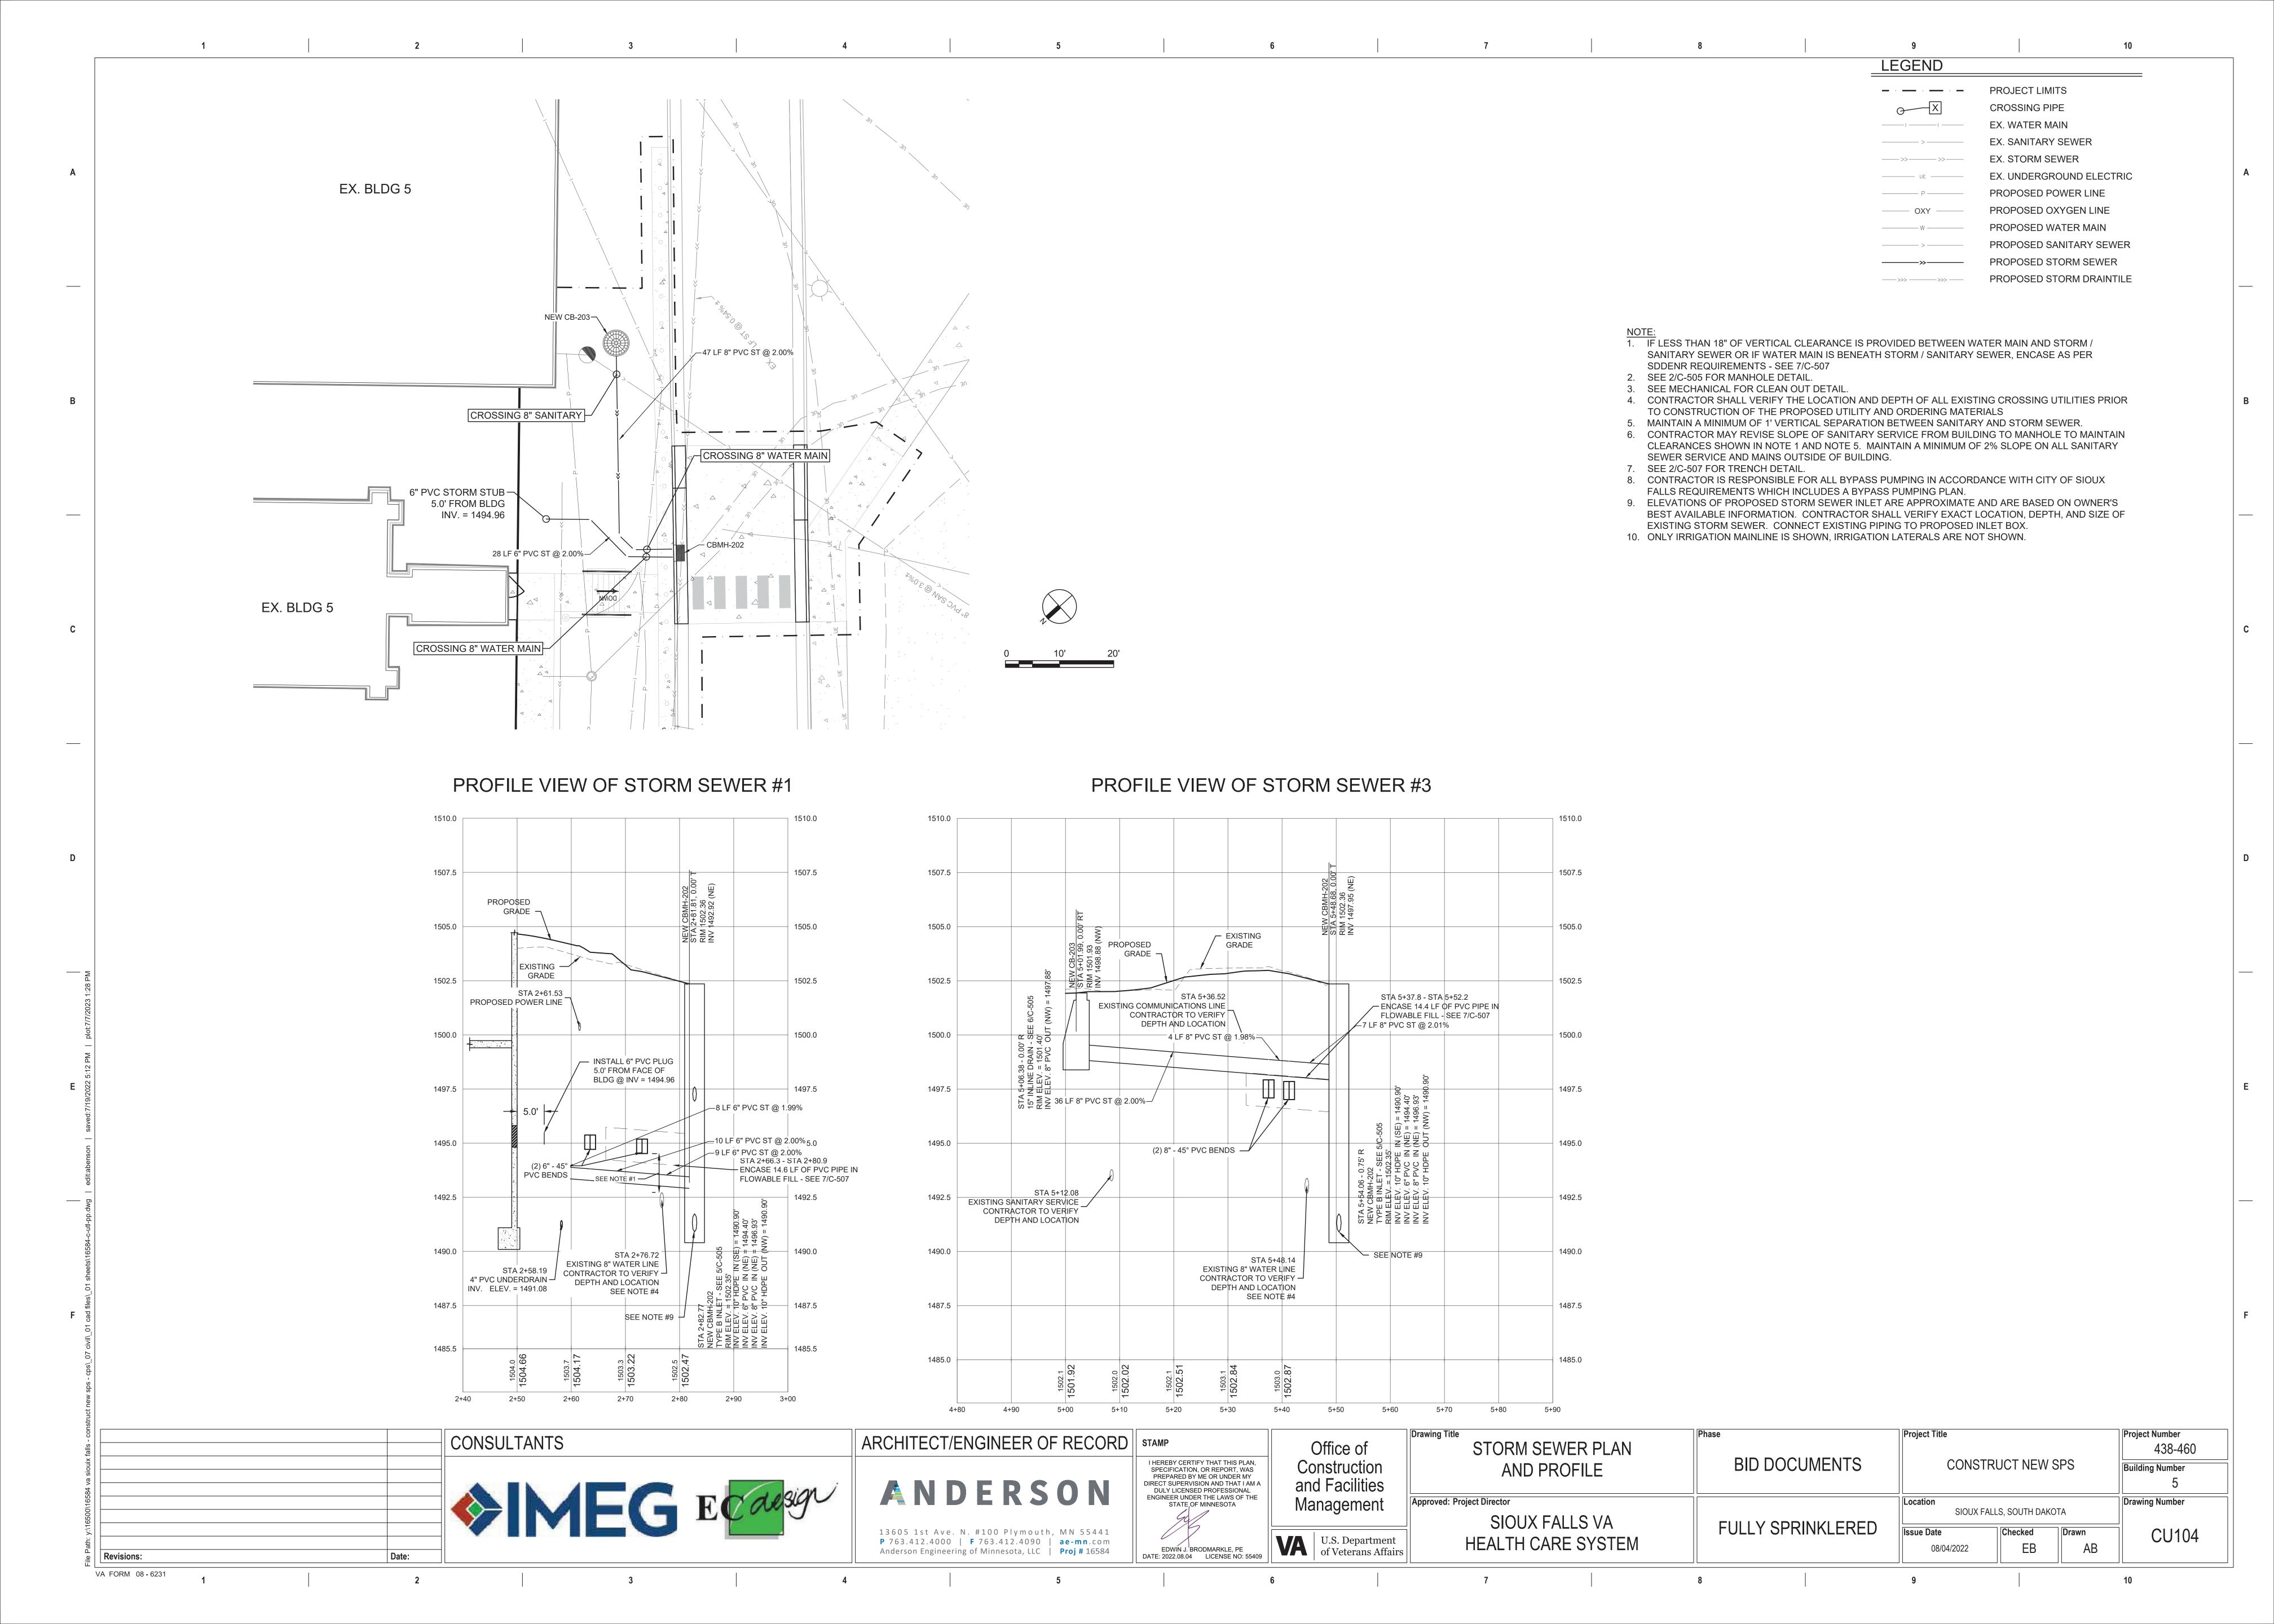


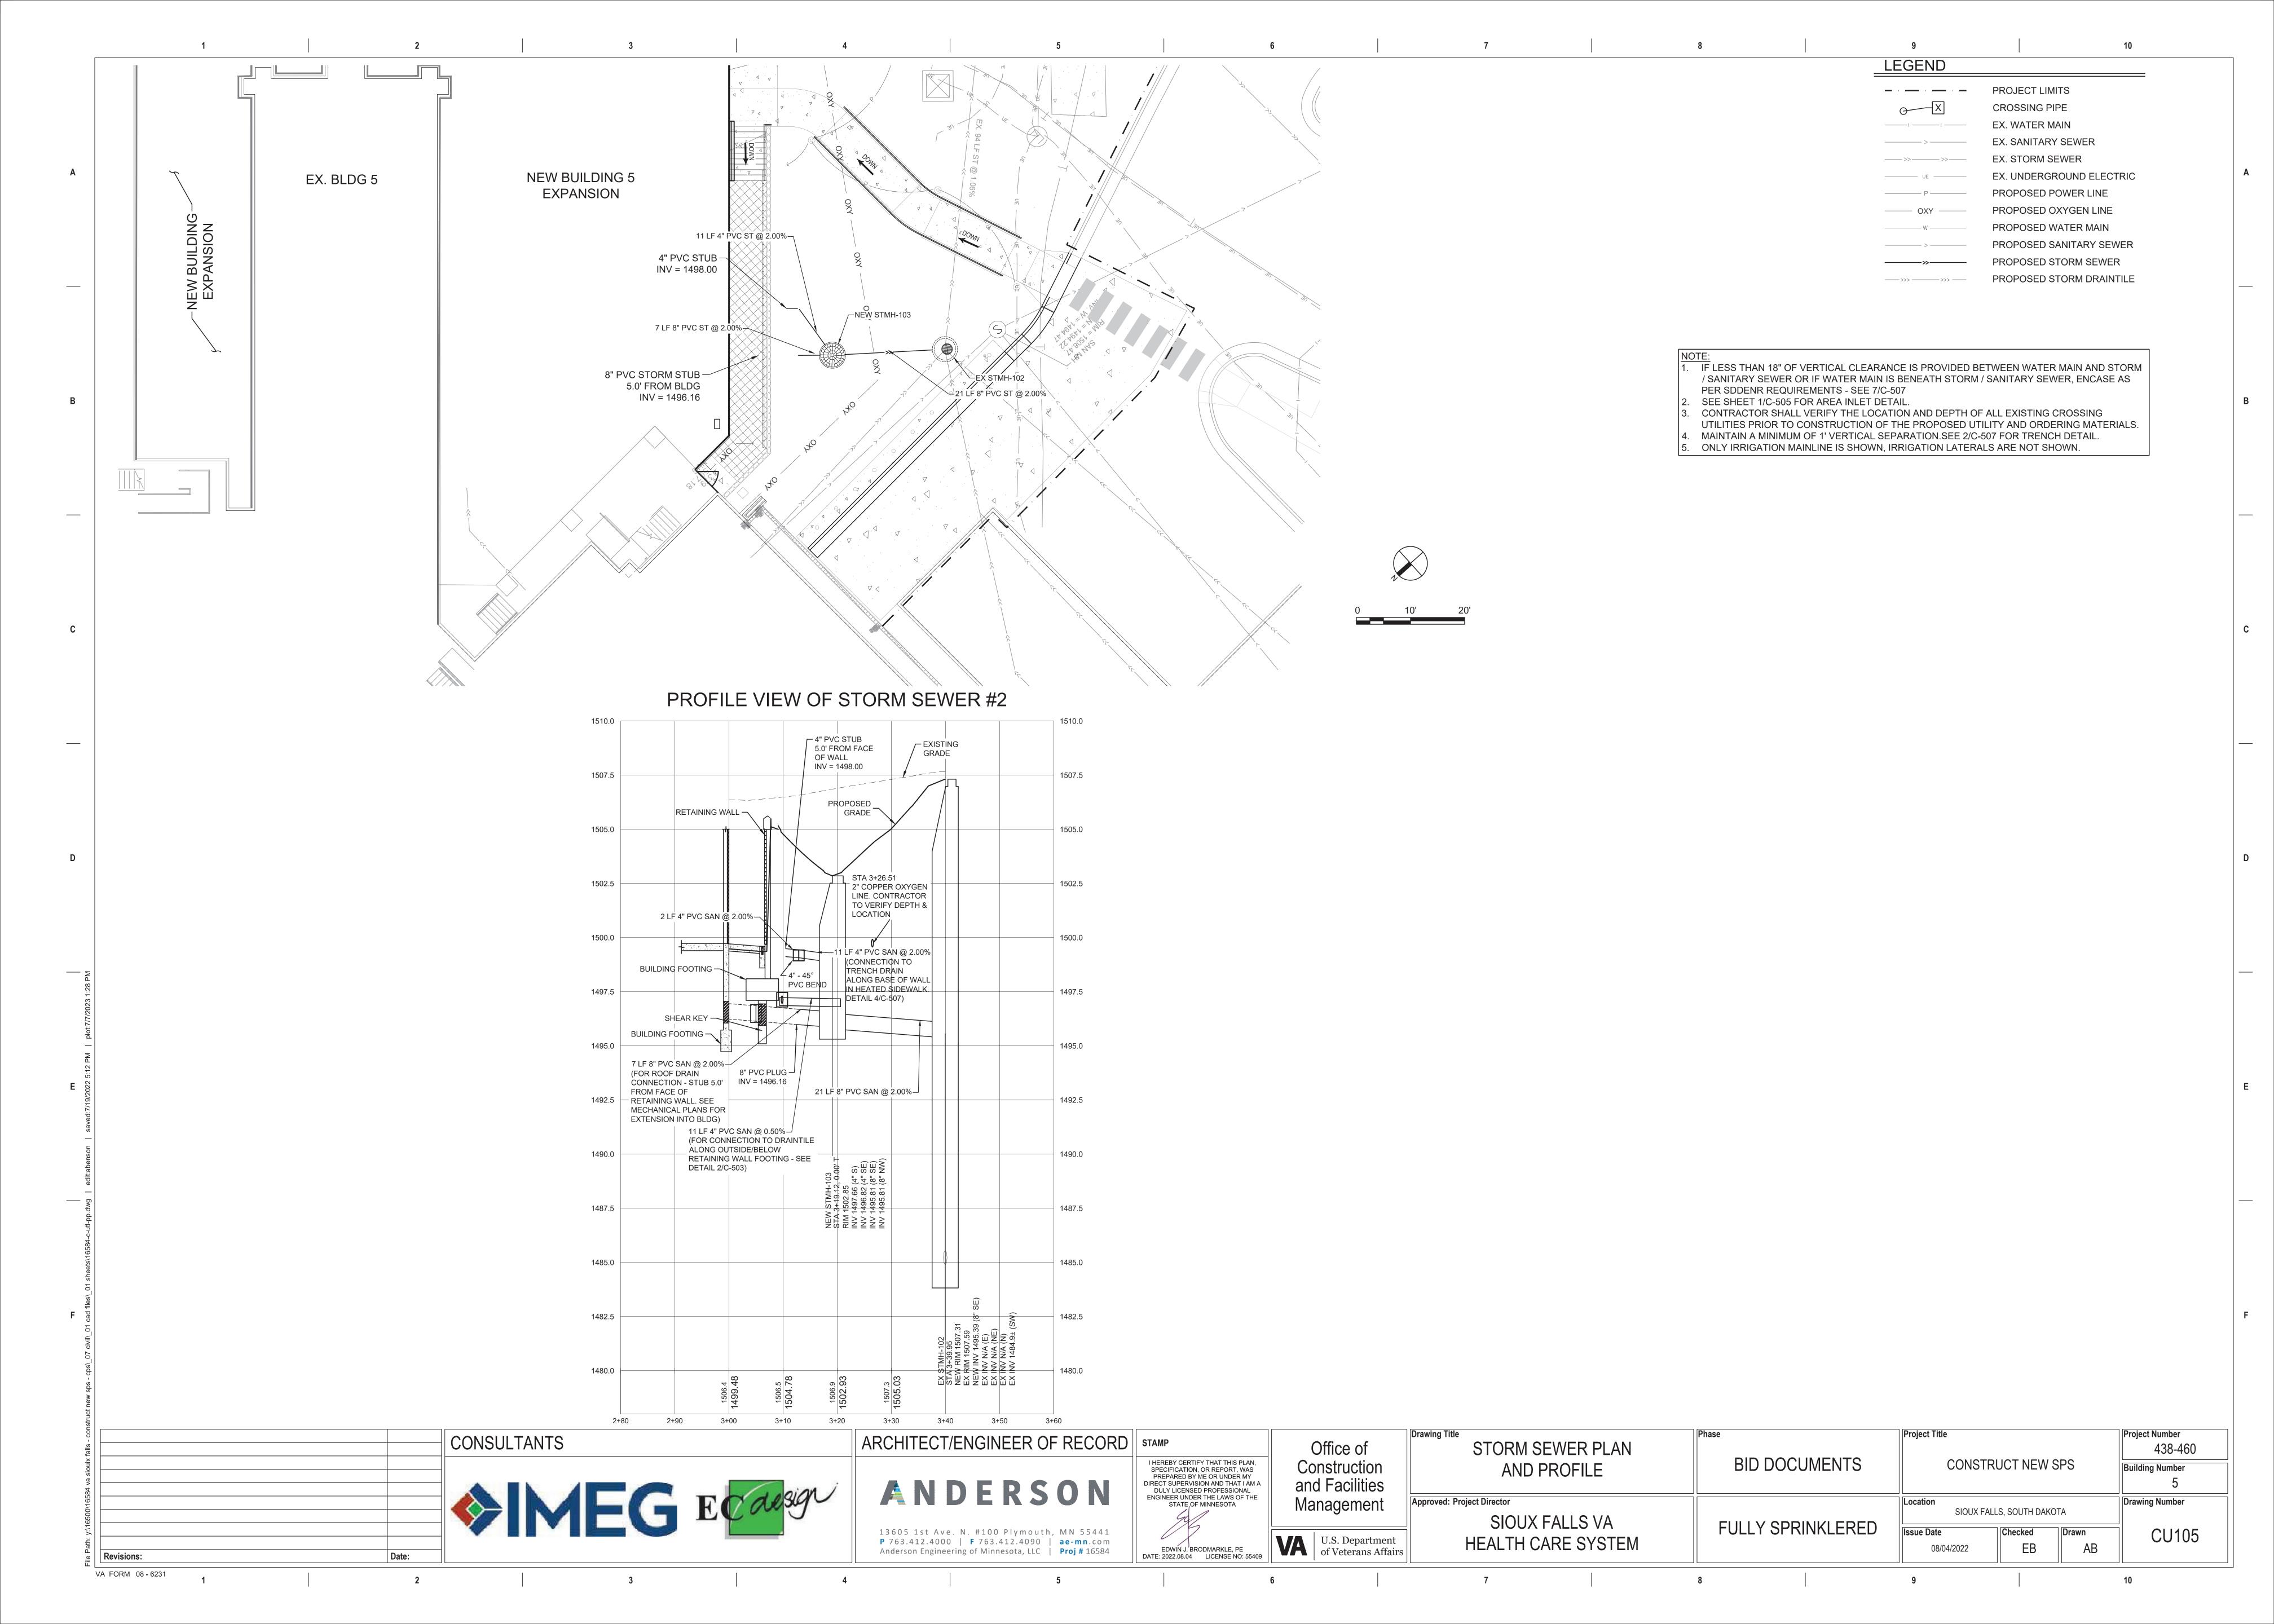


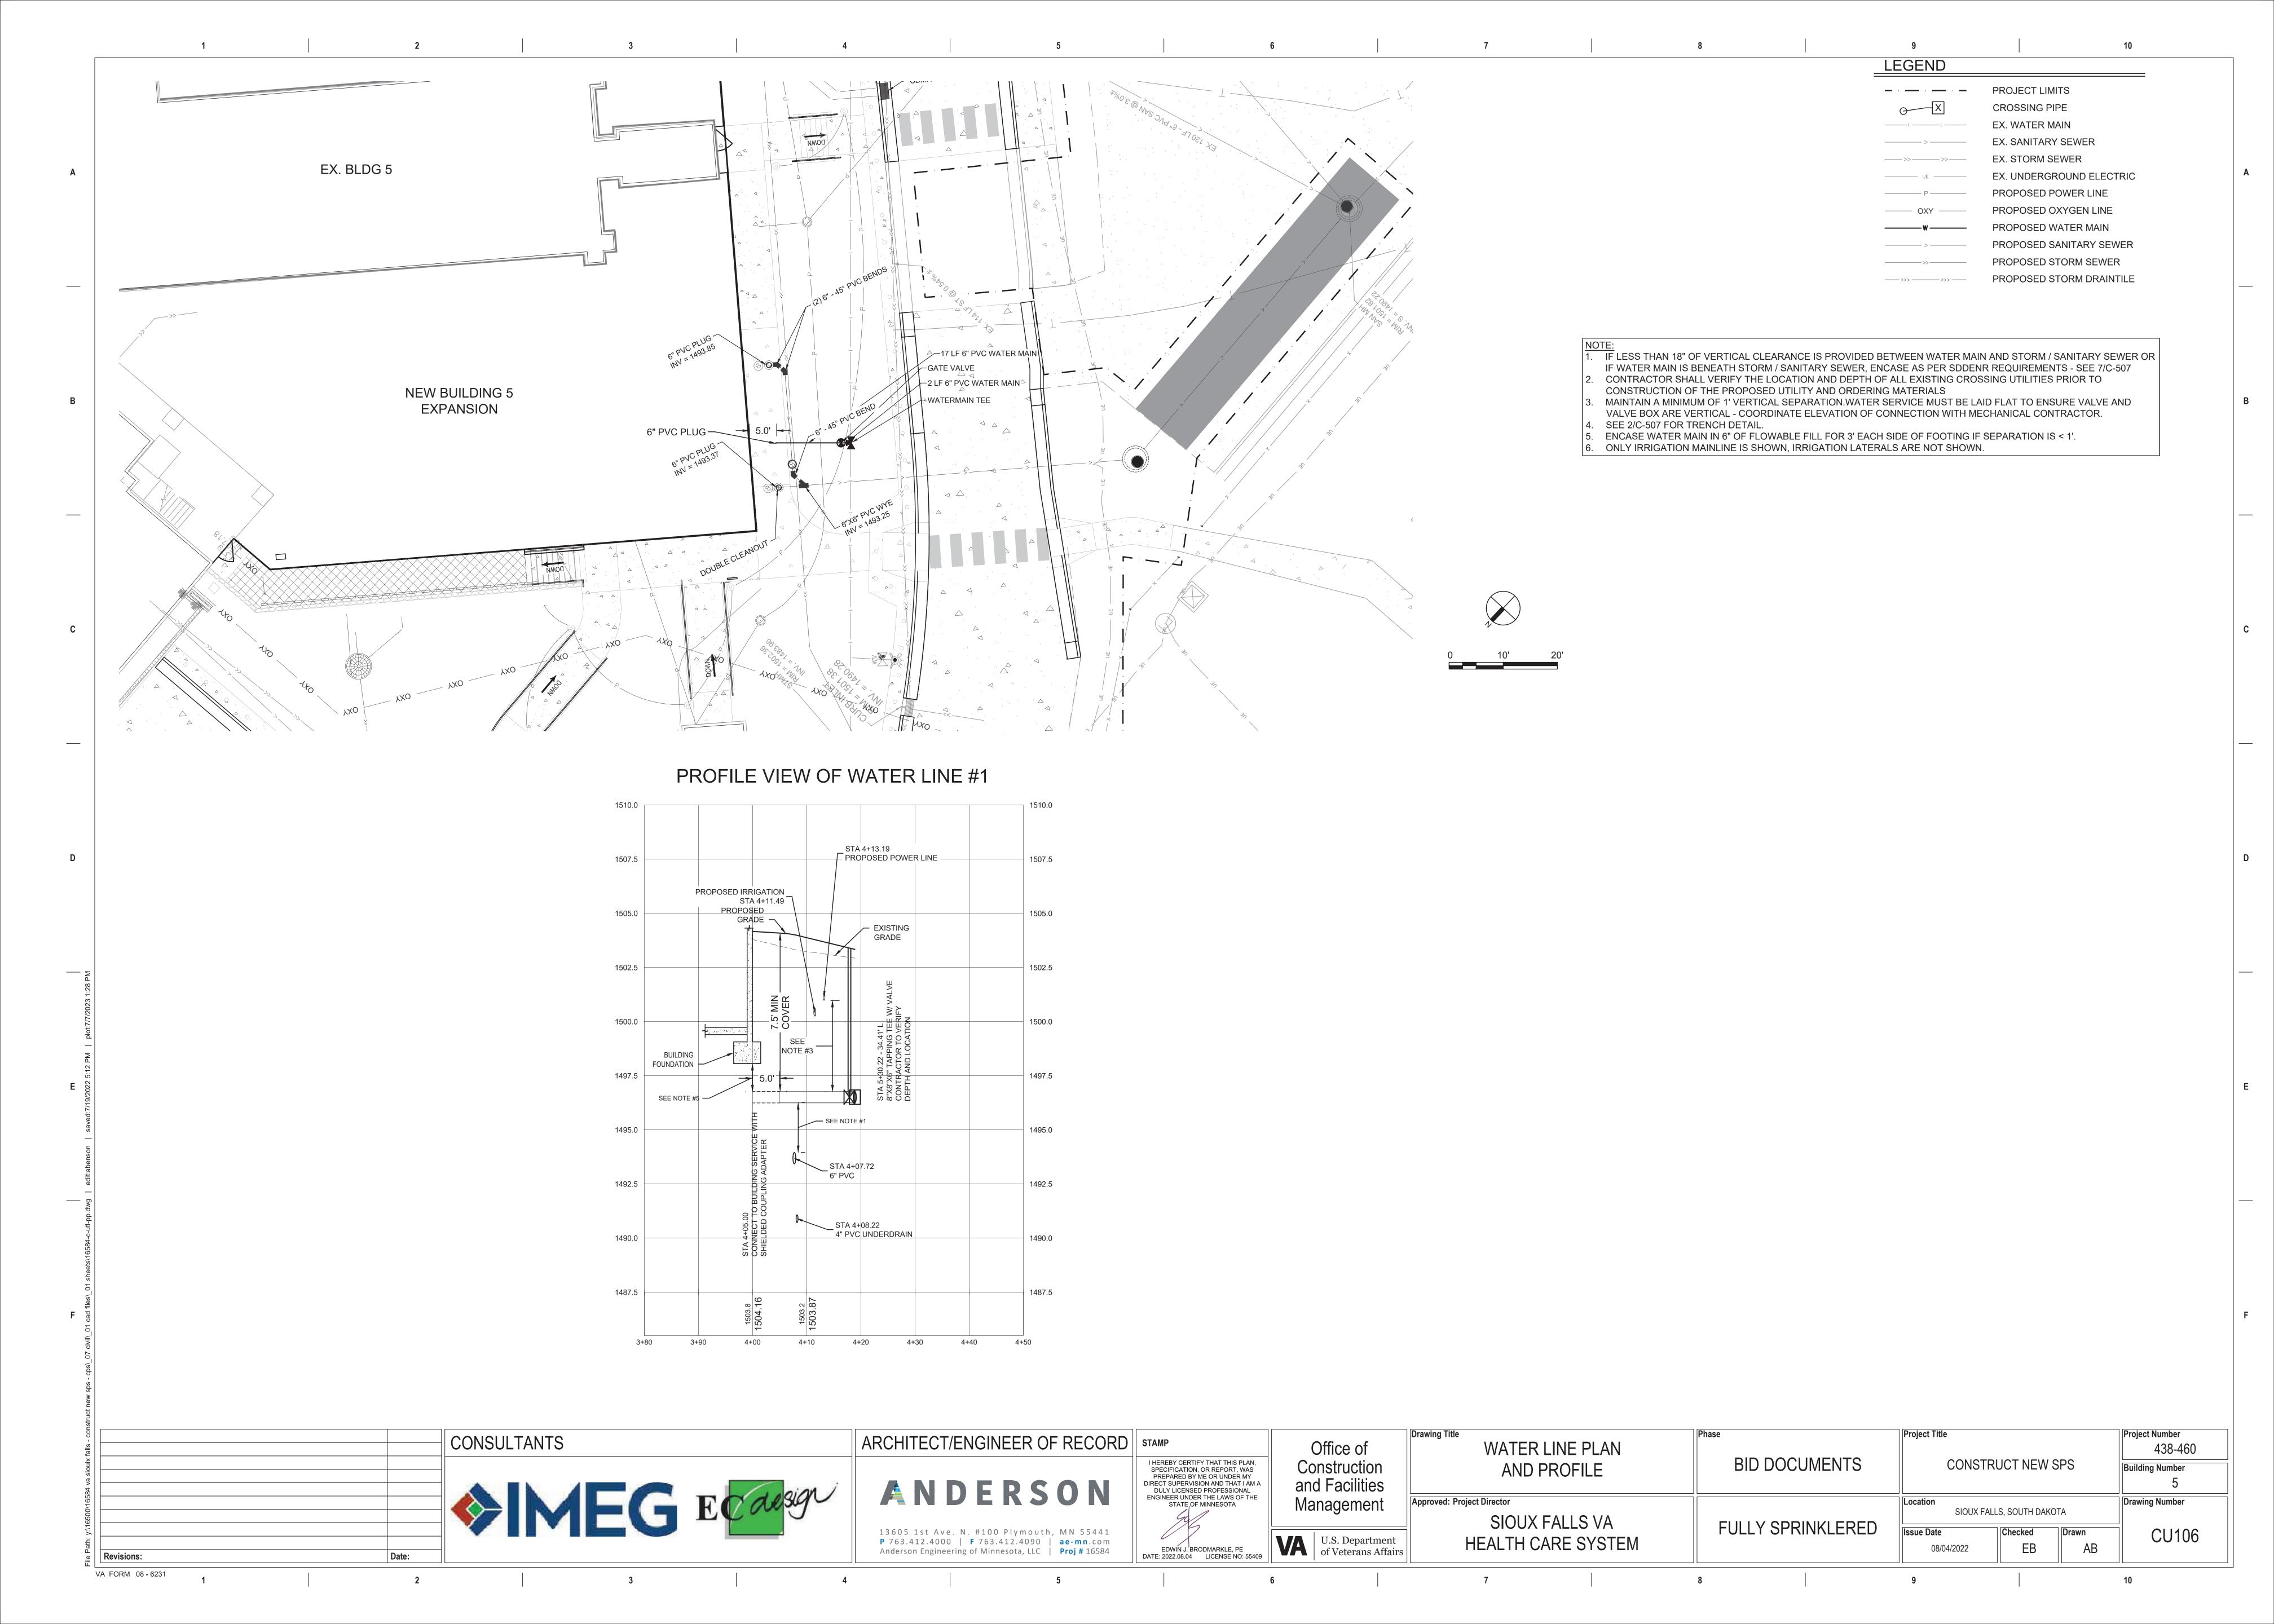


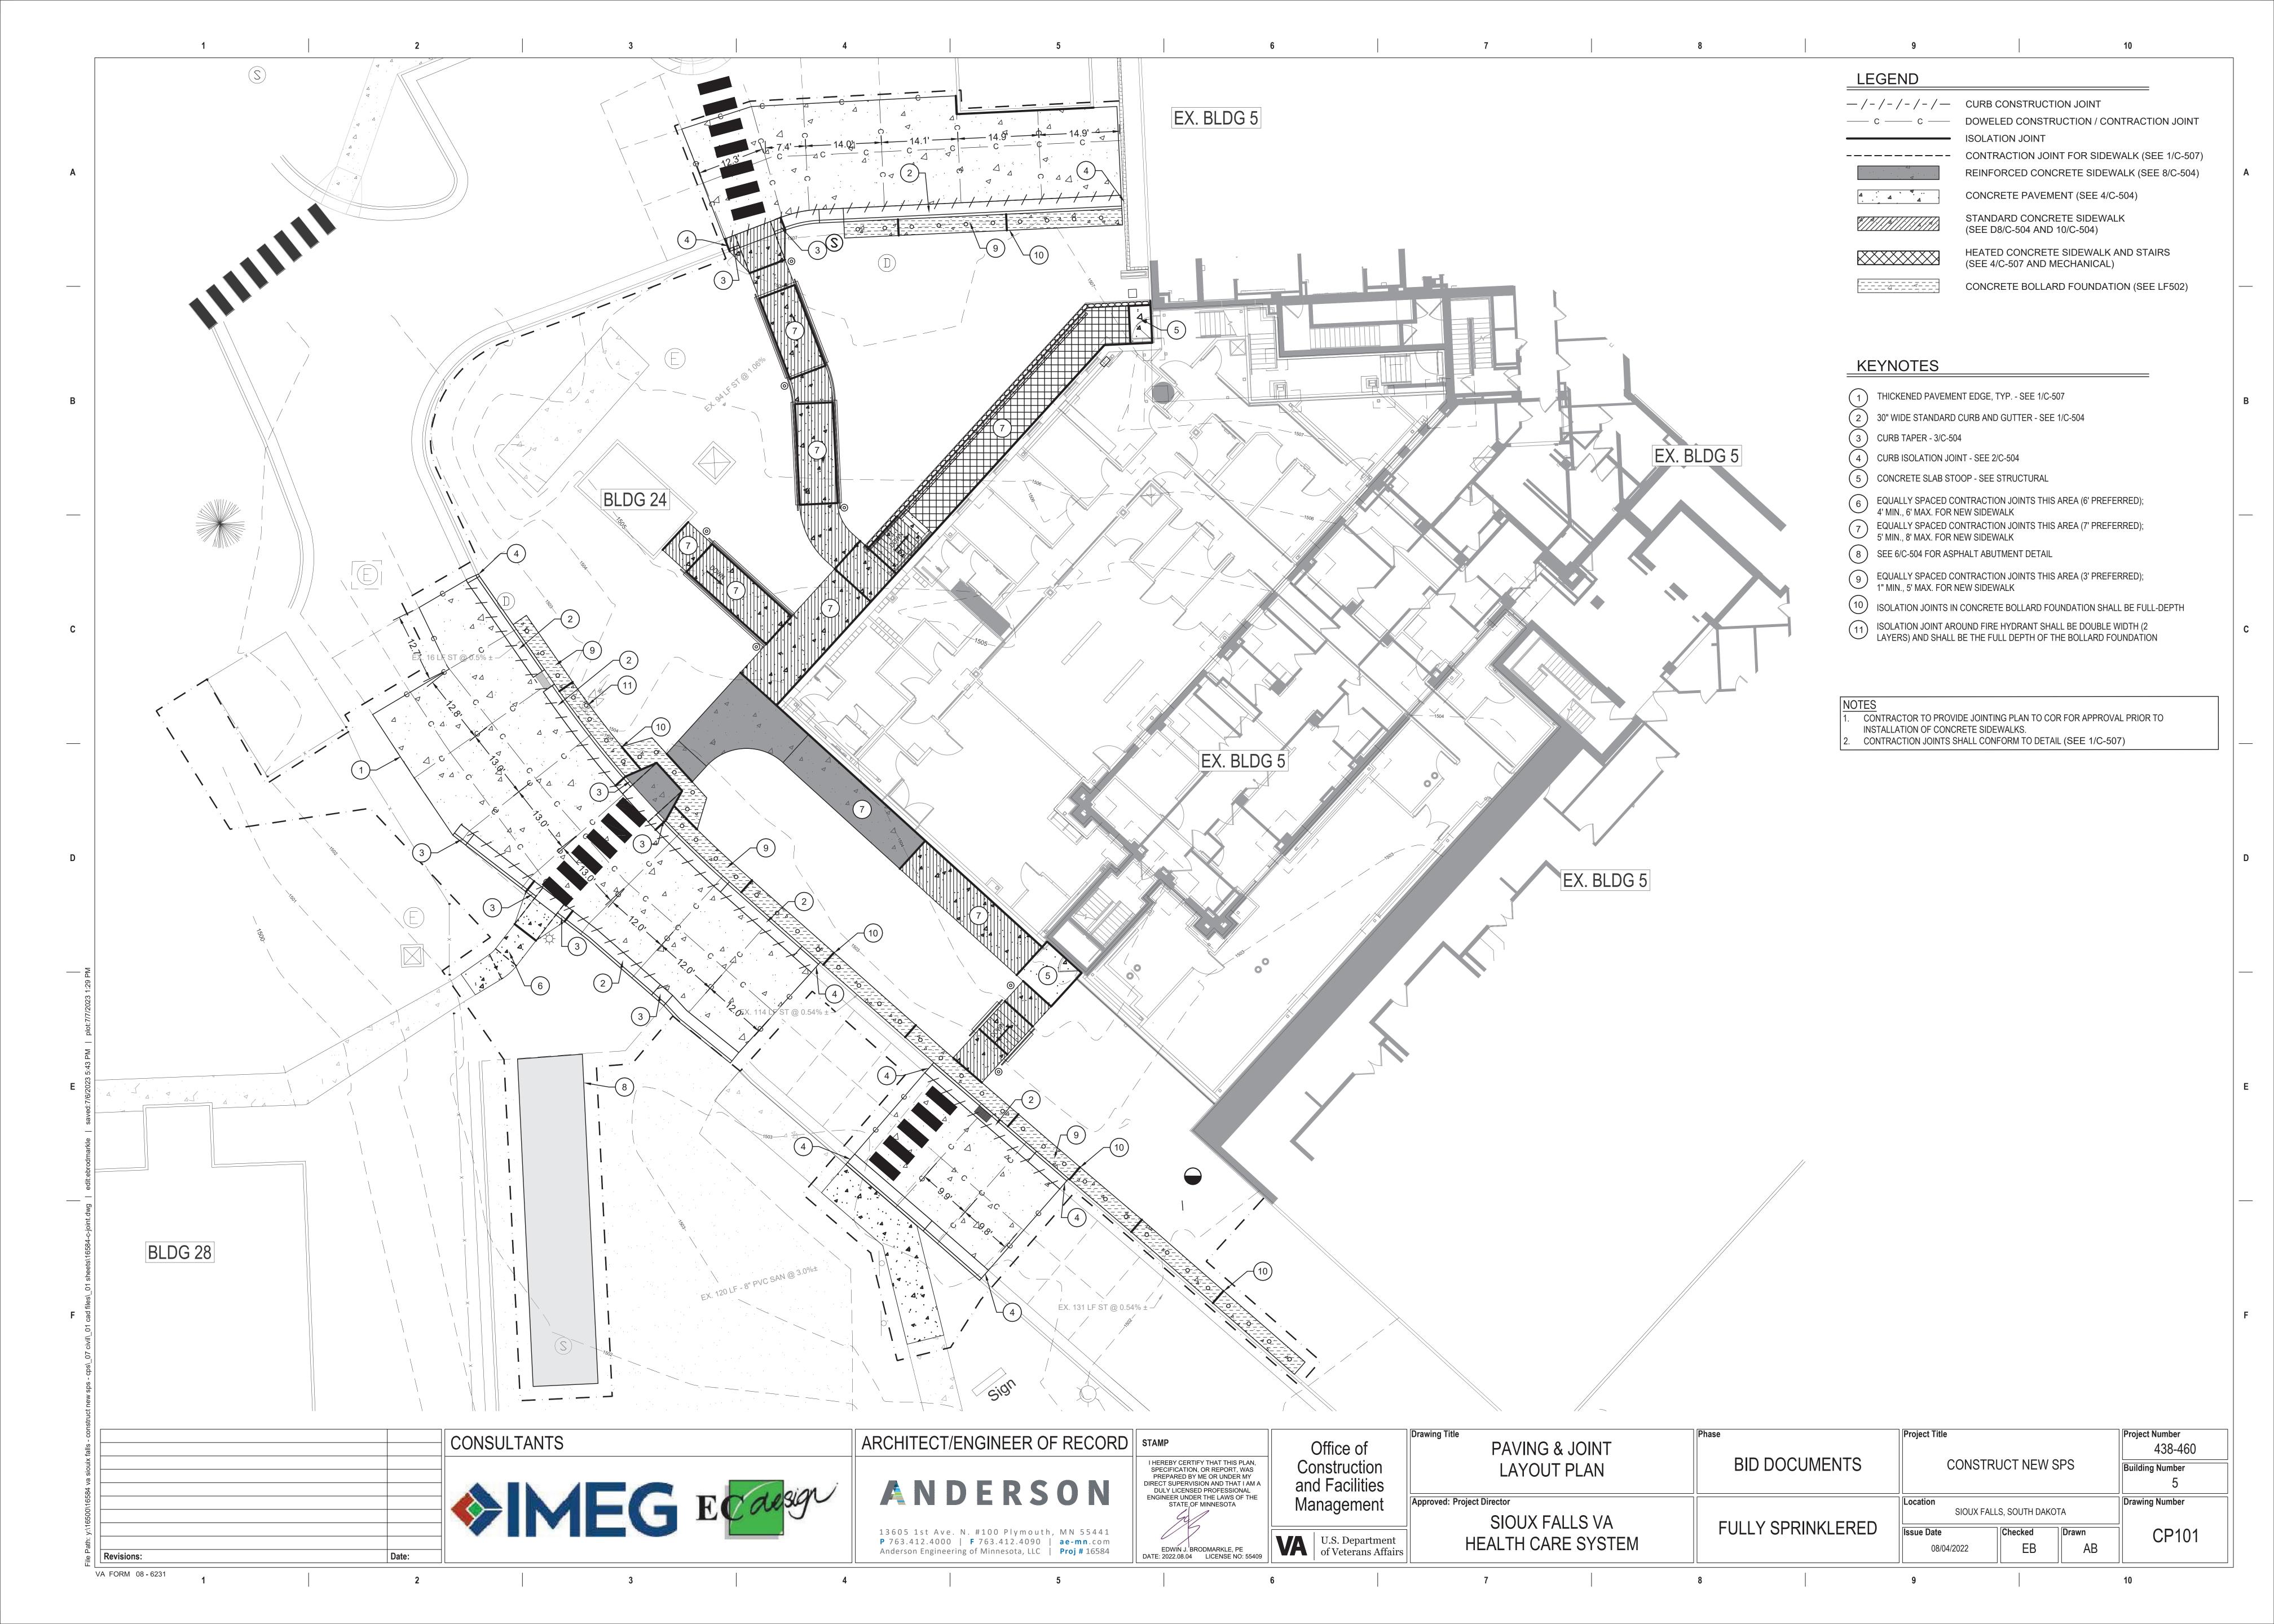


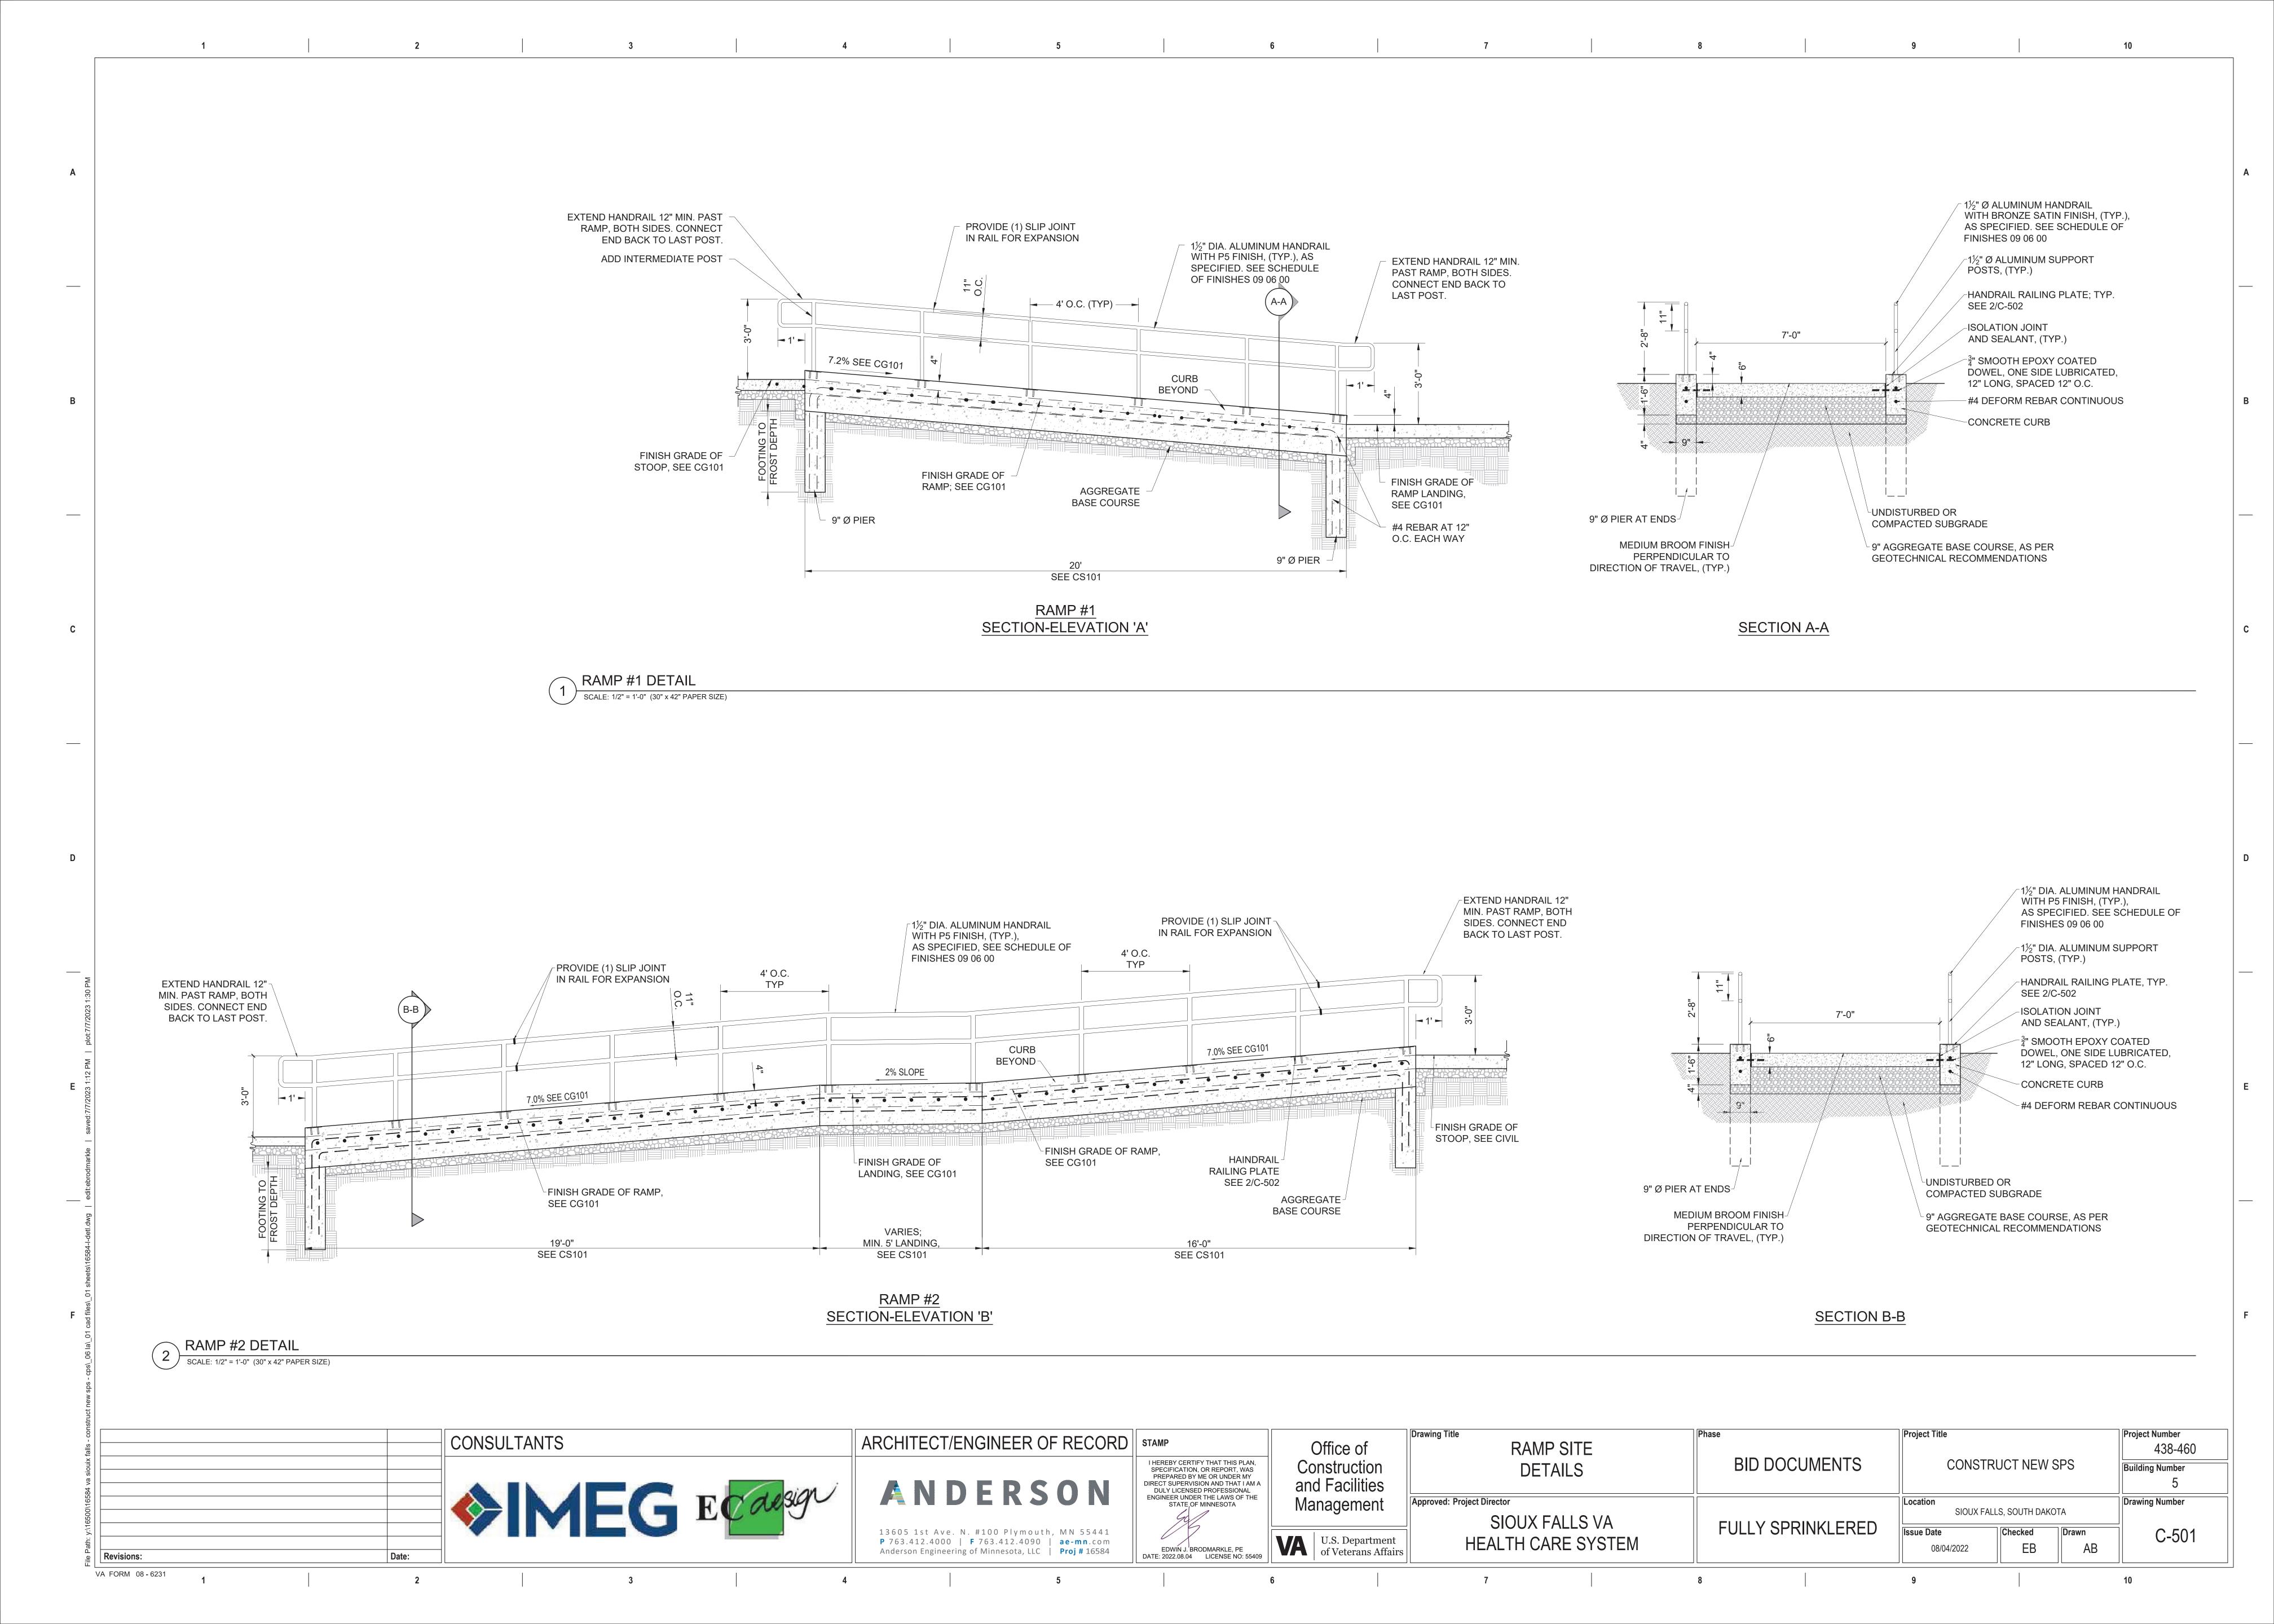


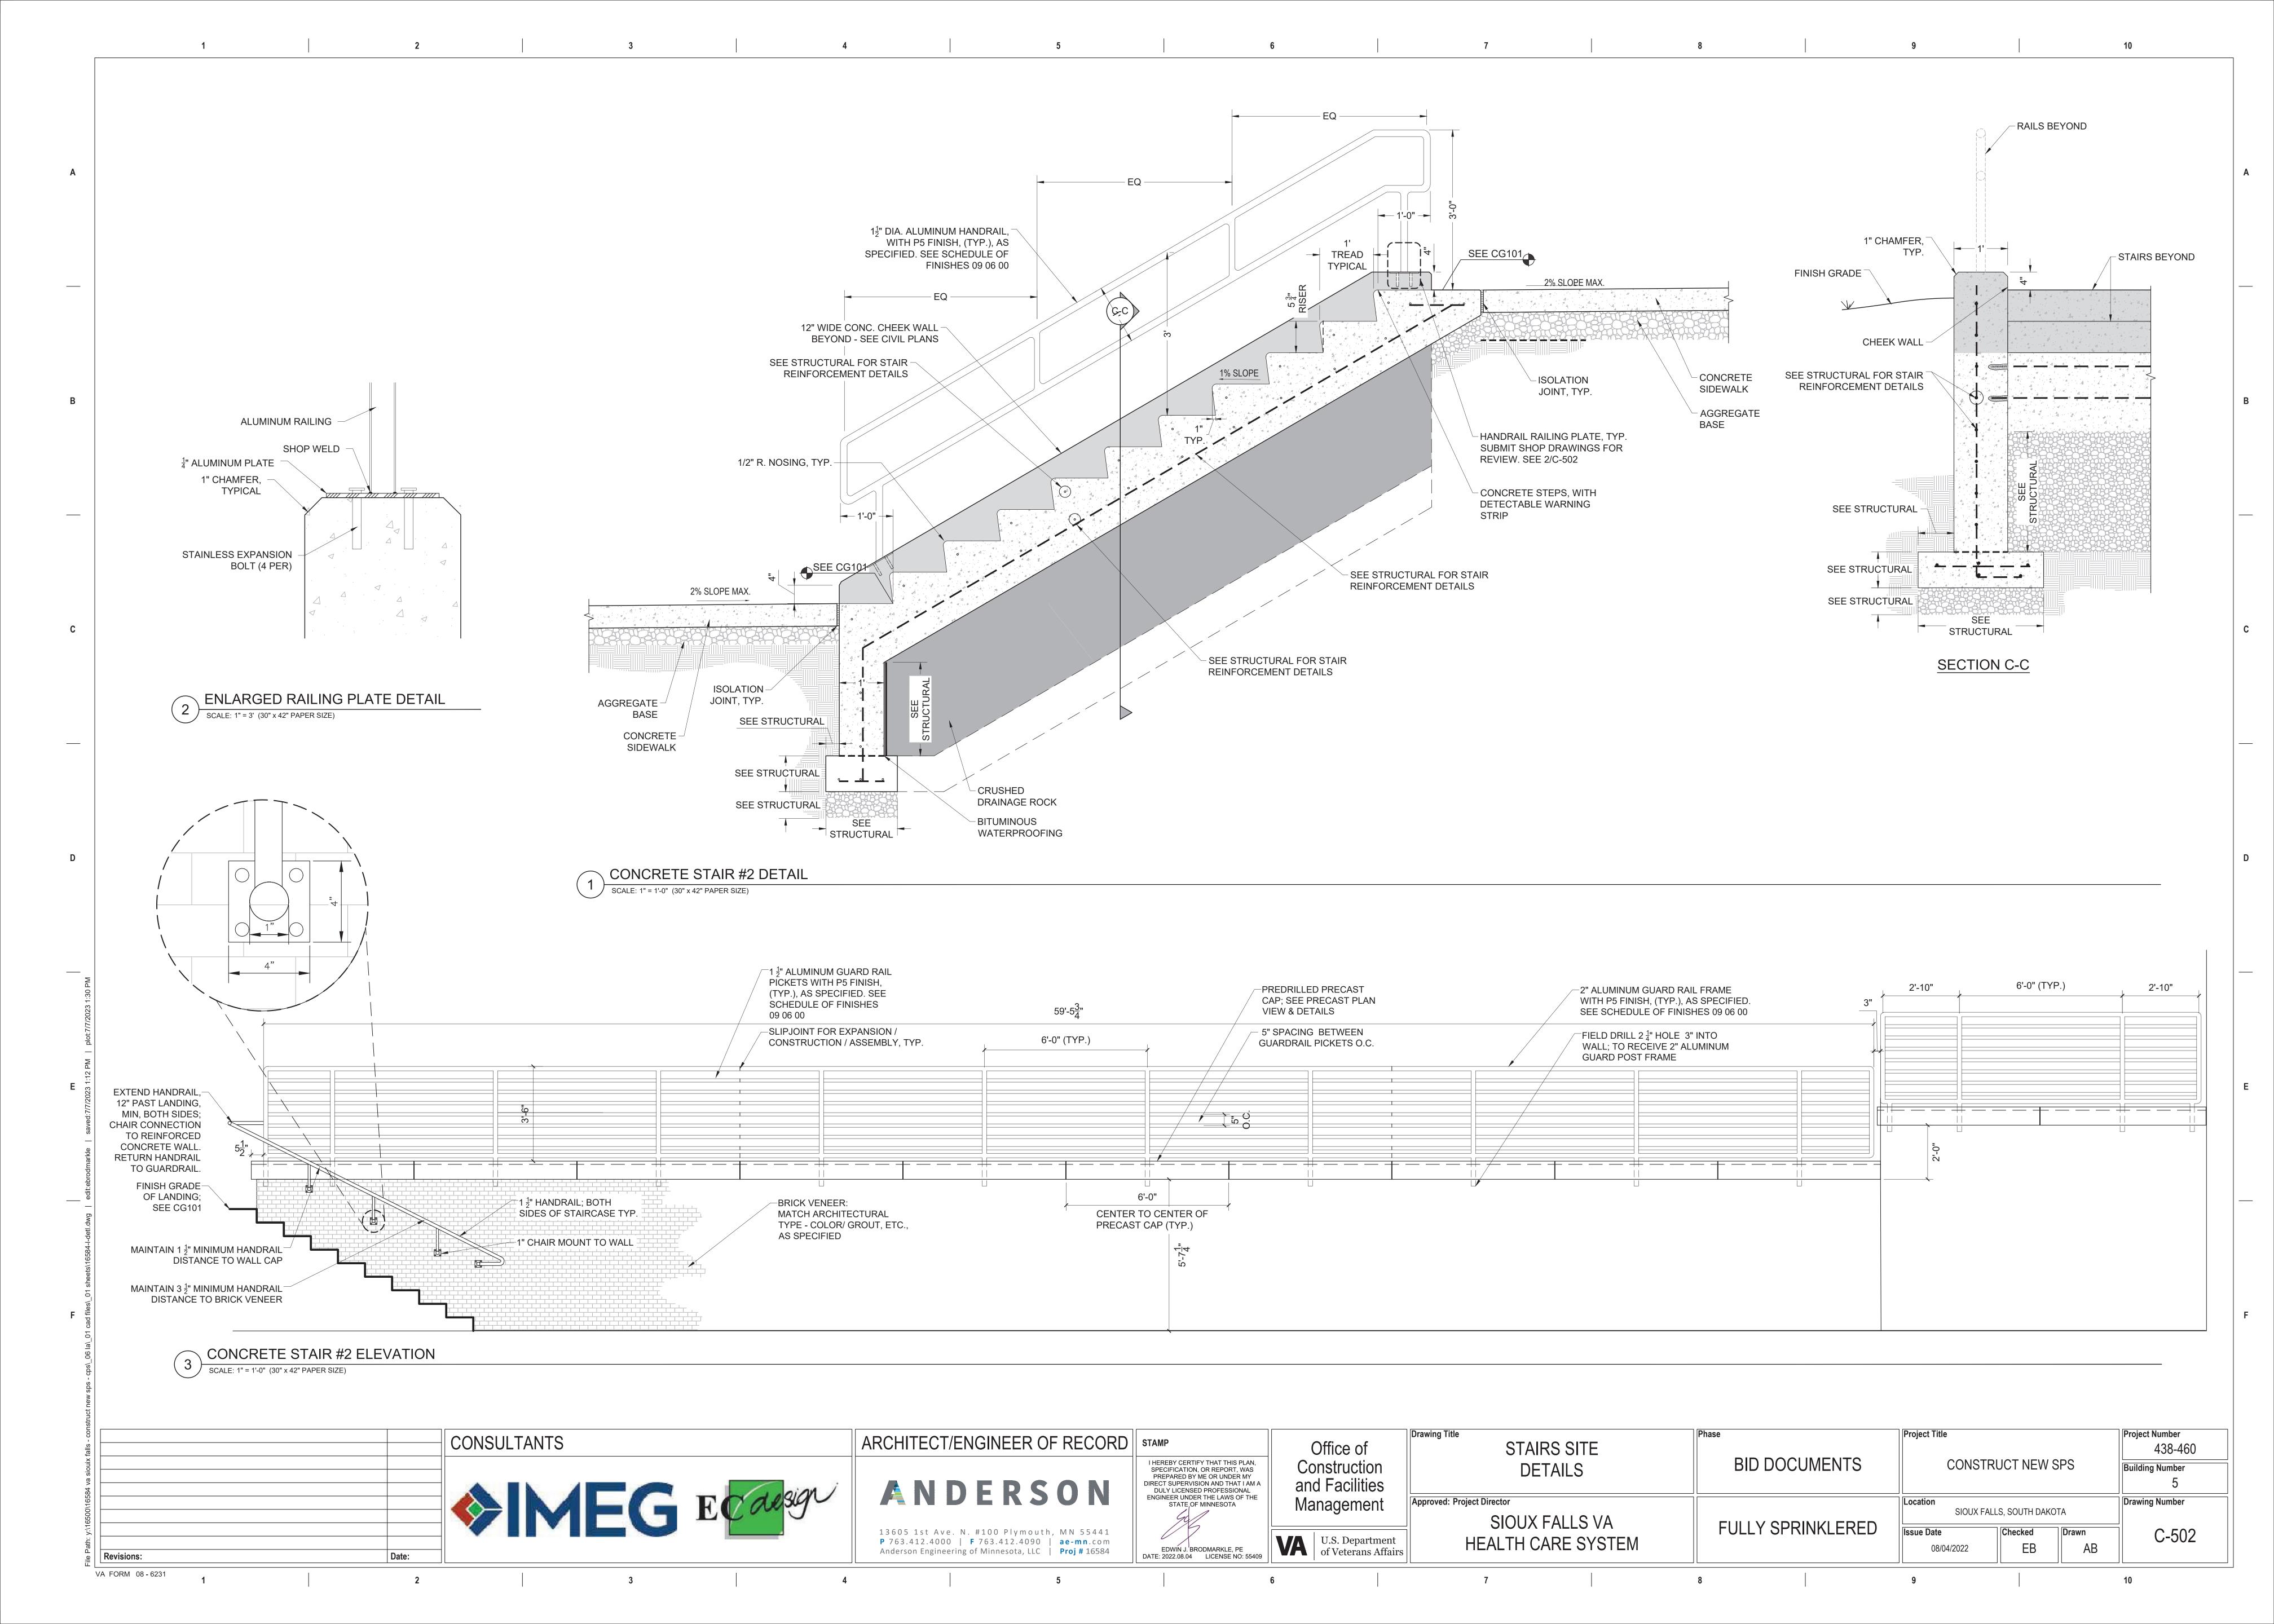

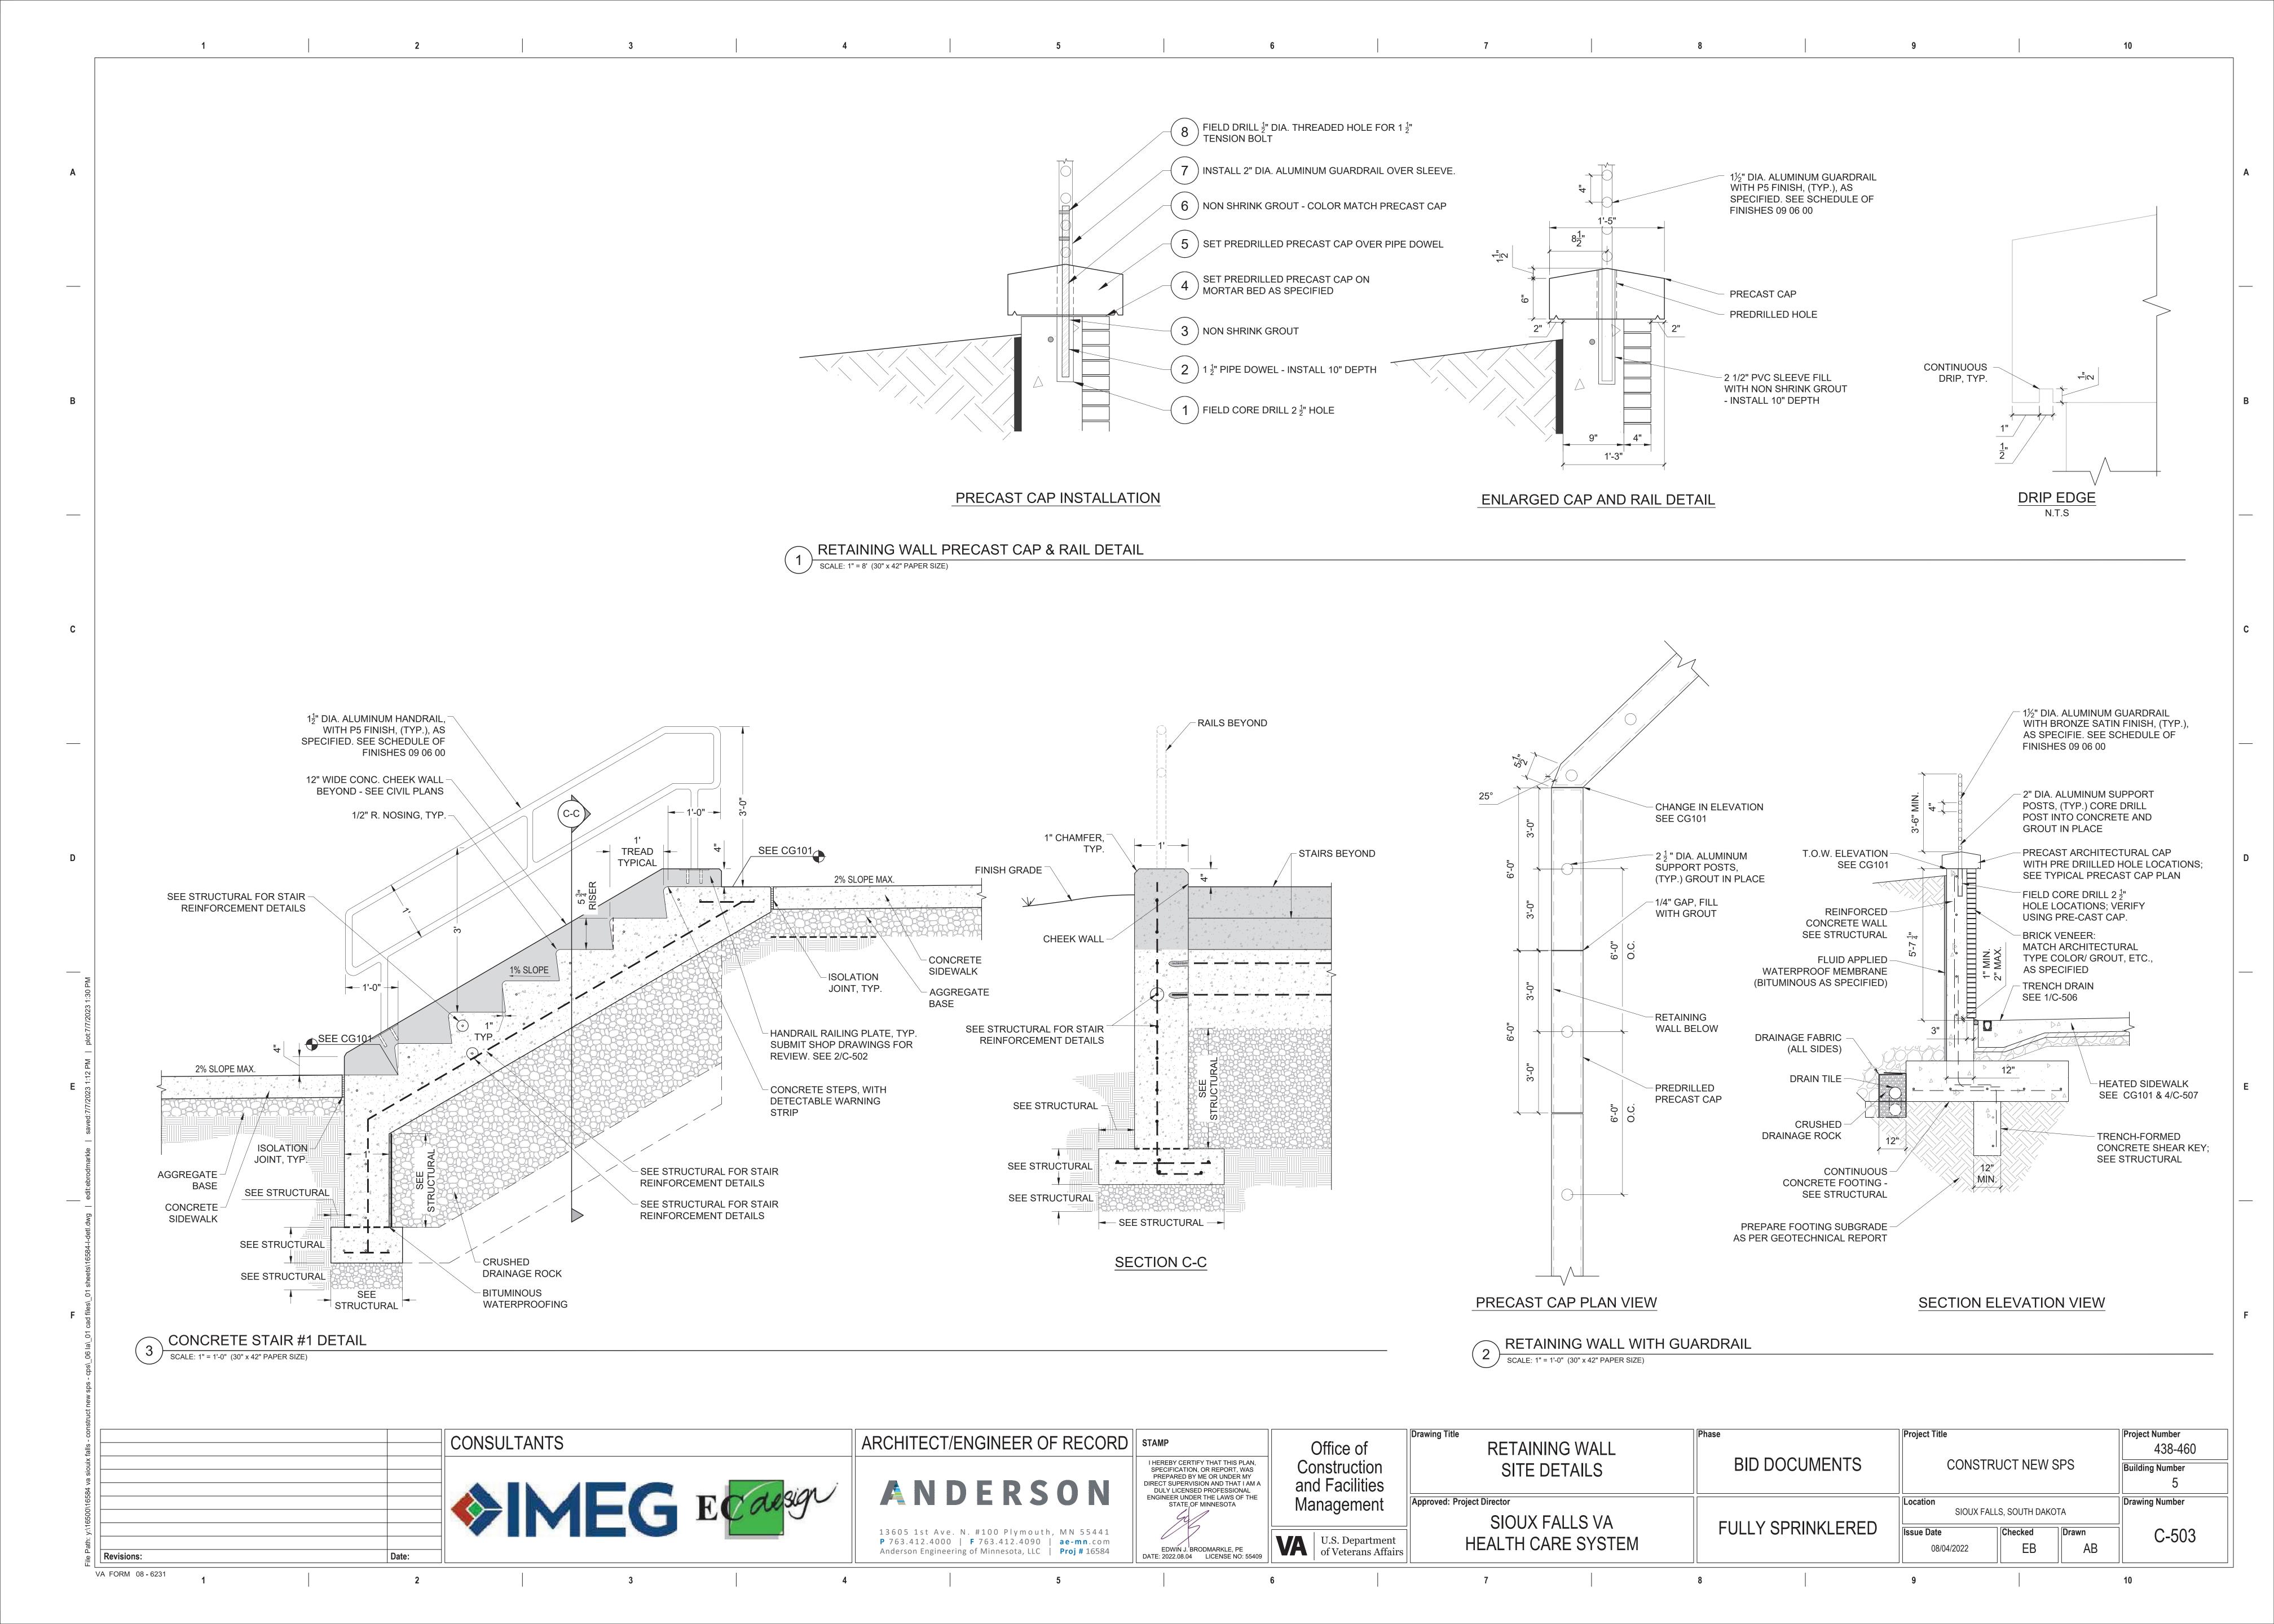

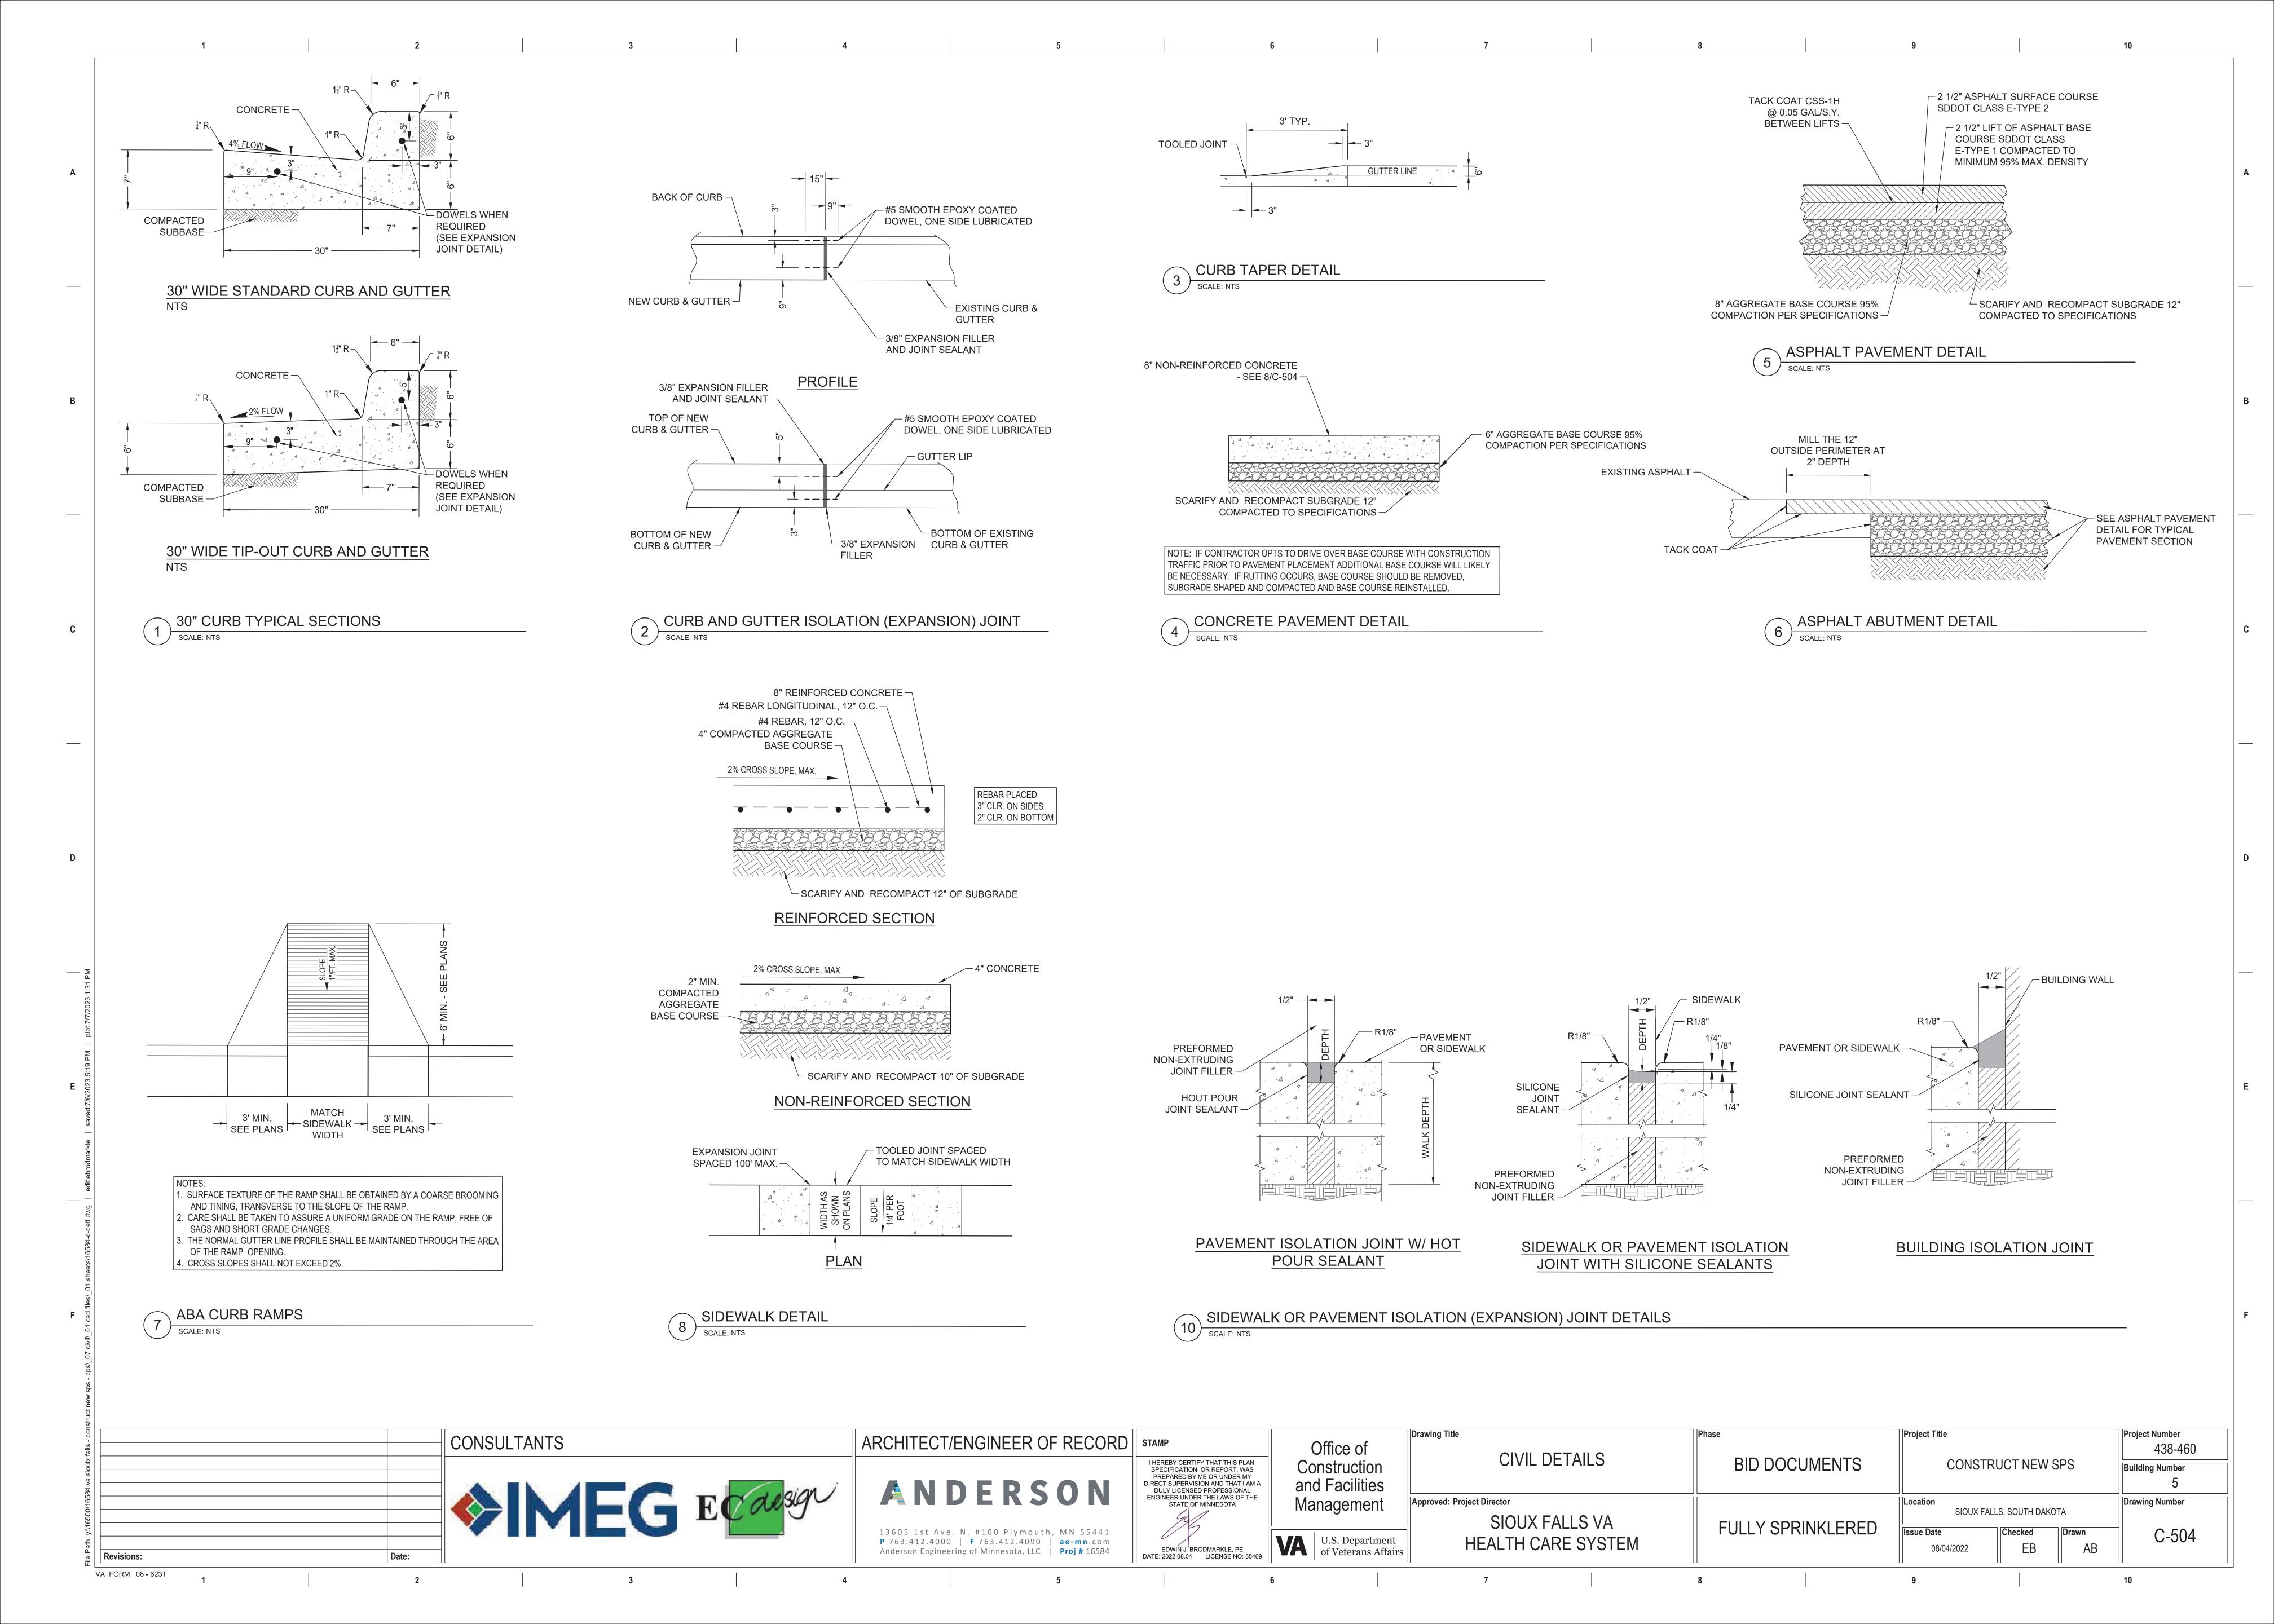

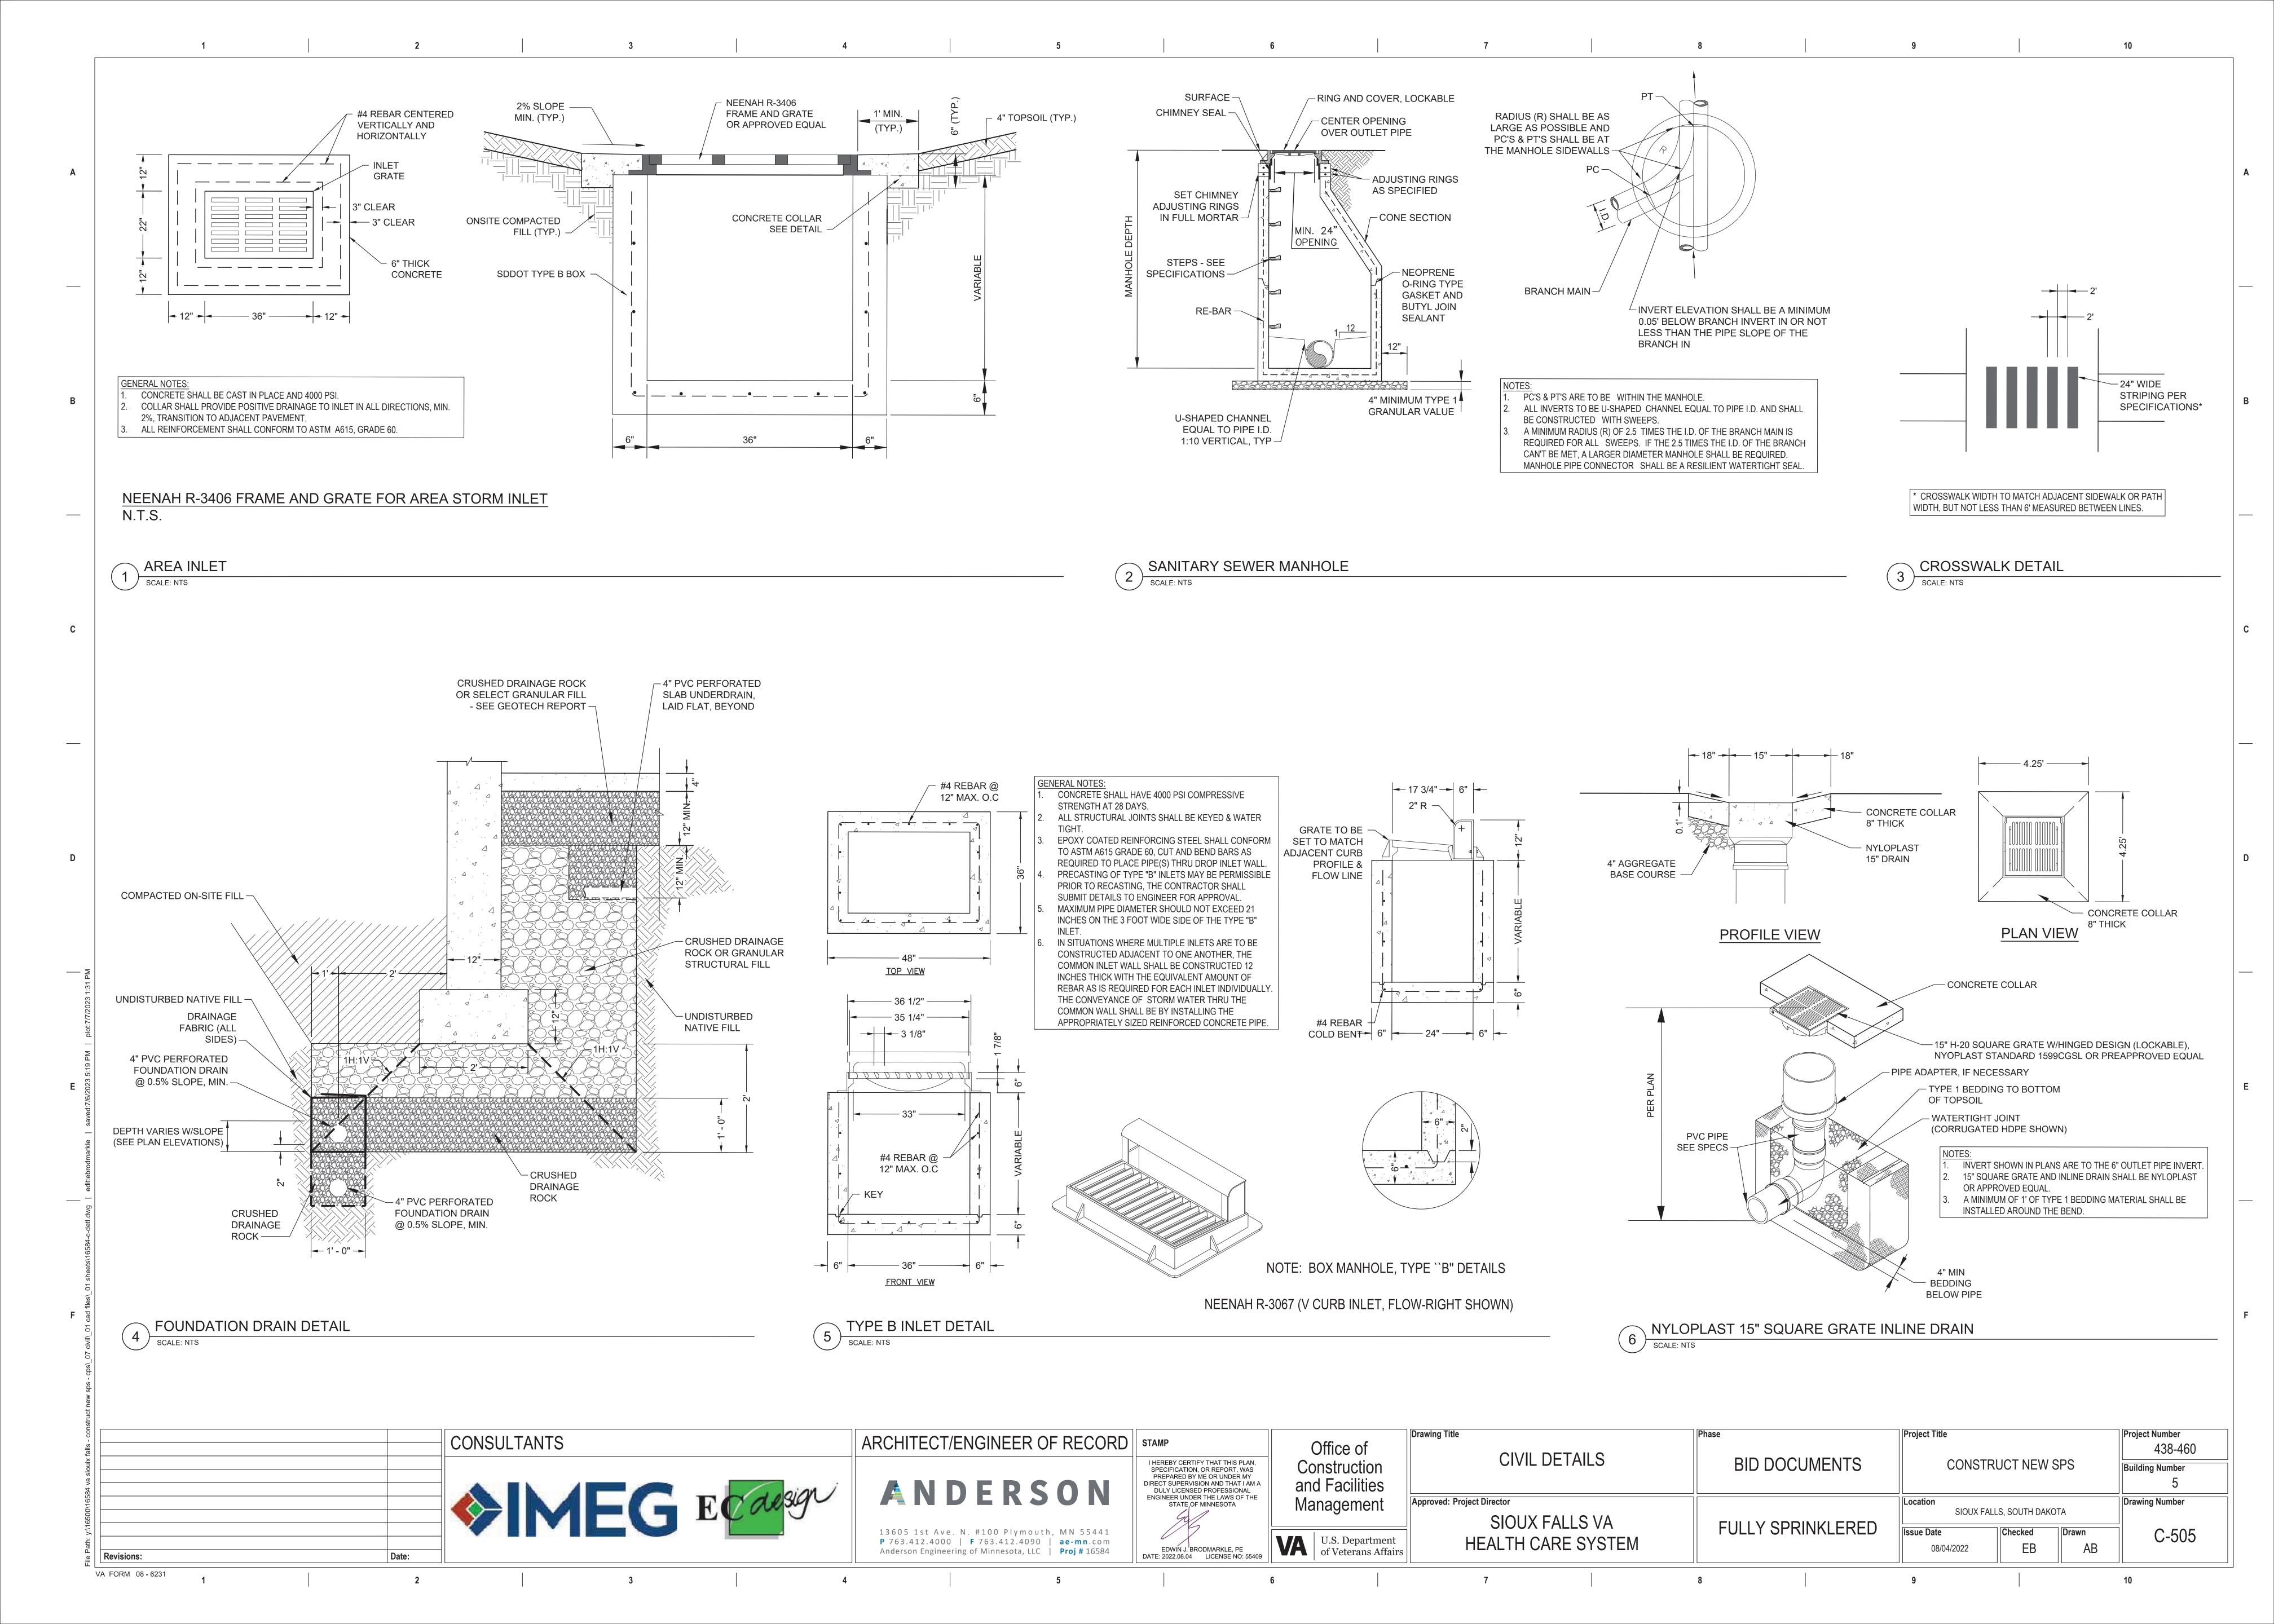

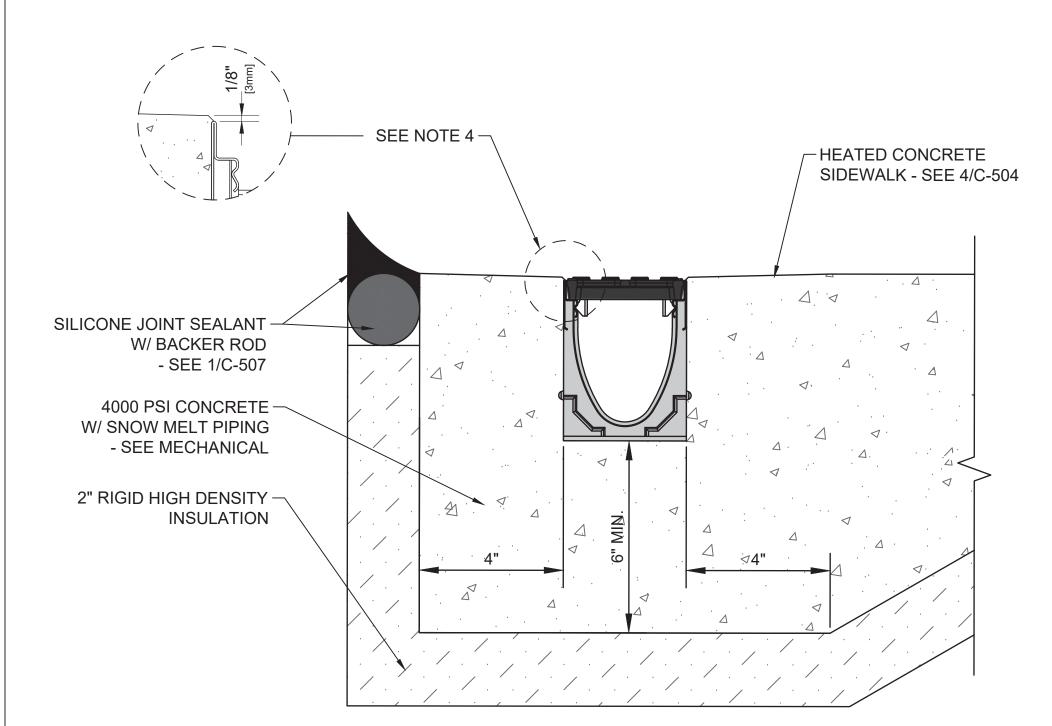

THE FINISHED LEVEL OF THE CONCRETE SURROUND MUST BE APPROX. 1/8" ABOVE THE TOP OF THE CHANNEL EDGE. INSTALL IN ACCORDANCE WITH MANUFACTURER'S INSTRUCTIONS. THE SYSTEM SHALL BE 4" NOMINAL INTERNAL WIDTH

WITH A 5.1" OVERALL WIDTH AND A BUILT-IN SLOPE OF 0.5%. CHANNEL INVERT SHALL HAVE DEVELOPED "V" SHAPE. ALL CHANNELS SHALL BE INTERLOCKING WITH THE COMPLETE DRAINAGE SYSTEM SHALL BE BY ACO

POLYMER PRODUCTS, INC. OR APPROVED EQUAL. CHANNELS SHALL BE MANUFACTURED FROM POLYESTER RESIN POLYMER CONCRETE WITH AN INTEGRALLY CAST-IN STAINLESS STEEL EDGE RAIL. MINIMUM PROPERTIES OF POLYMER CONCRETE WILL BE AS FOLLOWS: COMPRESSIVE STRENGTH: 14,000 PSI FLEXURAL STRENGTH: 4,000 PSI TENSILE STRENGTH: 1,500 PSI

0.07%

YES

FROST PROOF DILUTE ACID AND ALKALI RESISTANT B117 SALT SPRAY TEST COMPLIANT FOLLOW SEALANT MANUFACTURER'S **RECOMMENDATIONS FOR 2" WIDE JOINT** 

WATER ABSORPTION:

6" MINIMUM -1"-2" WASHED ROCK -

- DUMP STRAP 1" (25 mm) REBAR FOR BAG REMOVAL FROM INLET - 2 EACH DUMP SILT SACK -EXPANSION RESTRAINT [1/4" (6 mm) NYLON ROPE, 2" (51 mm) FLAT WASHERS]


TRENCH DRAIN DETAIL SCALE: NTS


SCALE: NTS

VA FORM 08 - 6231

ROCK CONSTRUCTION ENTRANCE DETAIL 2 SCALE: NTS

NINLET PROTECTION DETAIL 3 SCALE: NTS

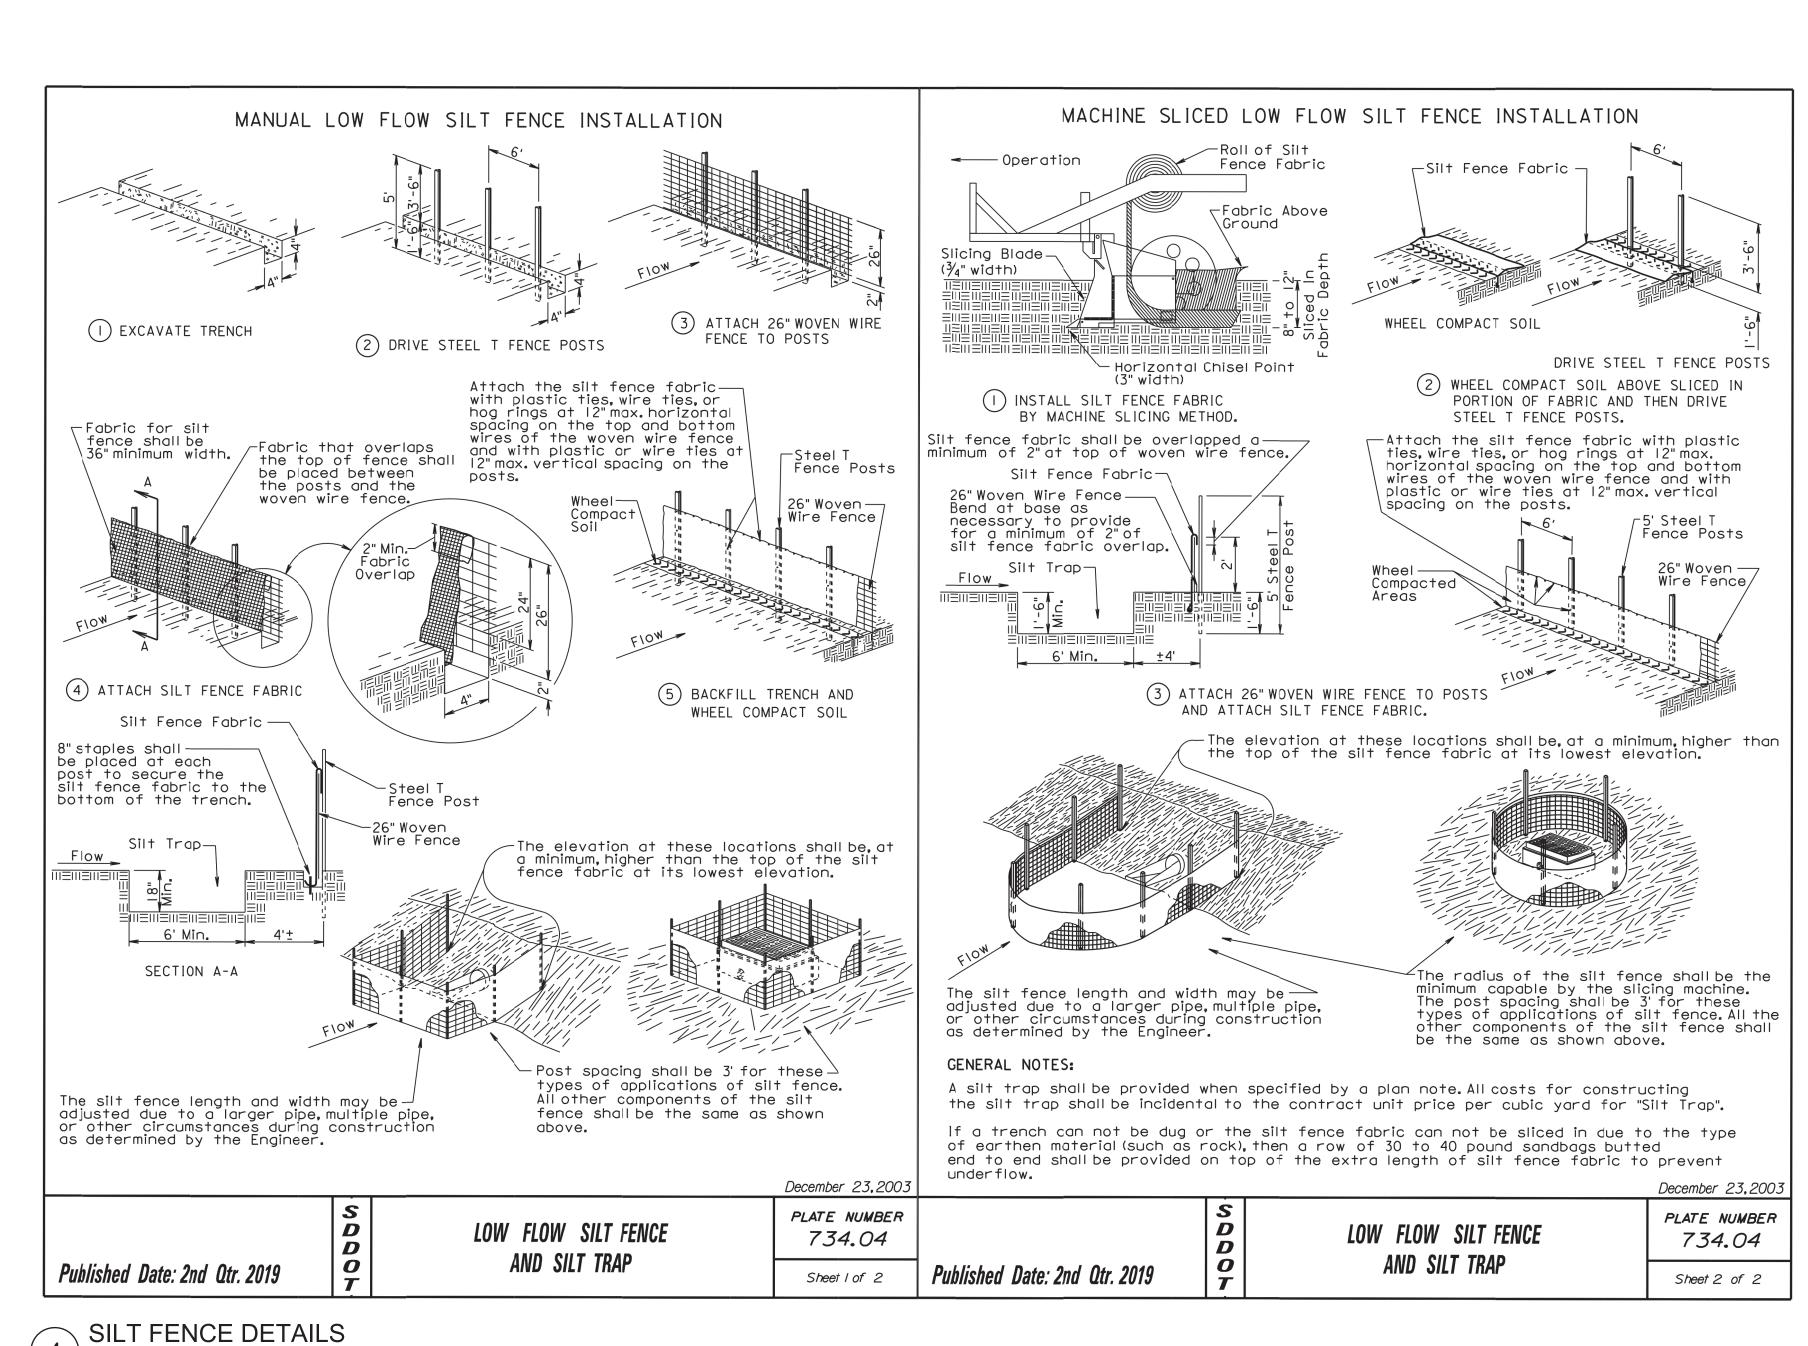

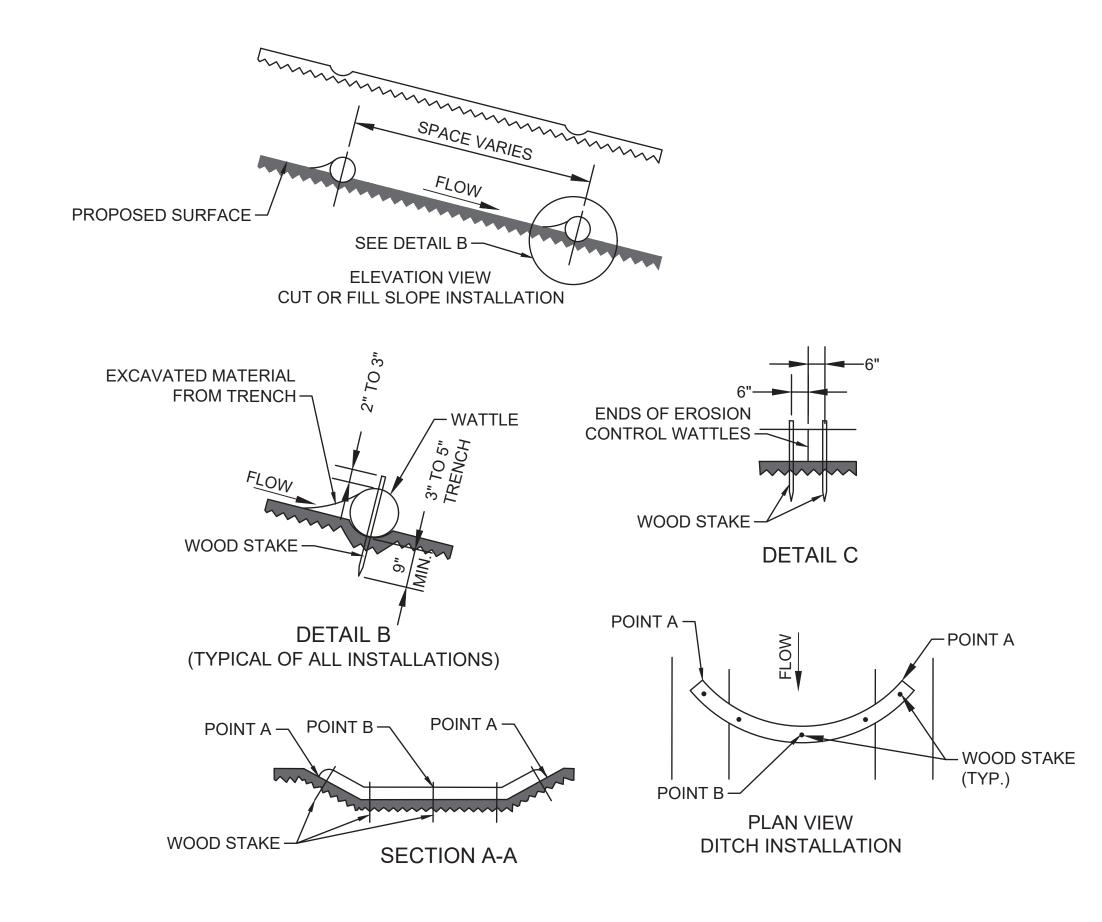


AT CUT OR FILL SLOPE INSTALLATIONS WATTLES SHALL BE INSTALLED ALONG THE CONTOUR AND PERPENDICULAR TO THE WATER FLOW.

AT DITCH INSTALLATIONS, POINT "A" MUST BE HIGHER THAN POINT "B" SO THAT WATER FLOWS OVER THE WATTLE AND

- NOT AROUND THE ENDS. THE CONTRACTOR SHALL DIG A 3" TO 5" TRENCH, INSTALL THE WATTLE TIGHTLY IN THE TRENCH SO THAT DAYLIGHT CAN NOT BE SEEN UNDER THE WATTLE, AND THEN COMPACT THE SOIL EXCAVATED FROM THE TRENCH AGAINST THE WATTLE ON THE UPHILL SIDE. SEE DETAIL B. THE STAKES SHALL BE 1"X2" OR 2"X2" WOOD STAKES. HOWEVER, OTHER TYPES OF STAKES SUCH AS REBAR MAY BE
- USED. THE STAKES SHALL BE PLACED 6" FROM THE ENDS OF THE WATTLES AND THE SPACING OF THE STAKES ALONG THE WATTLES SHALL BE 3' TO 4'. WHERE INSTALLING RUNNING LENGTHS OF WATTLES, THE CONTRACTOR SHALL BUTT THE SECOND WATTLE TIGHTLY

AGAINST THE FIRST AND SHALL NOT OVERLAP THE ENDS. SEE DETAIL C

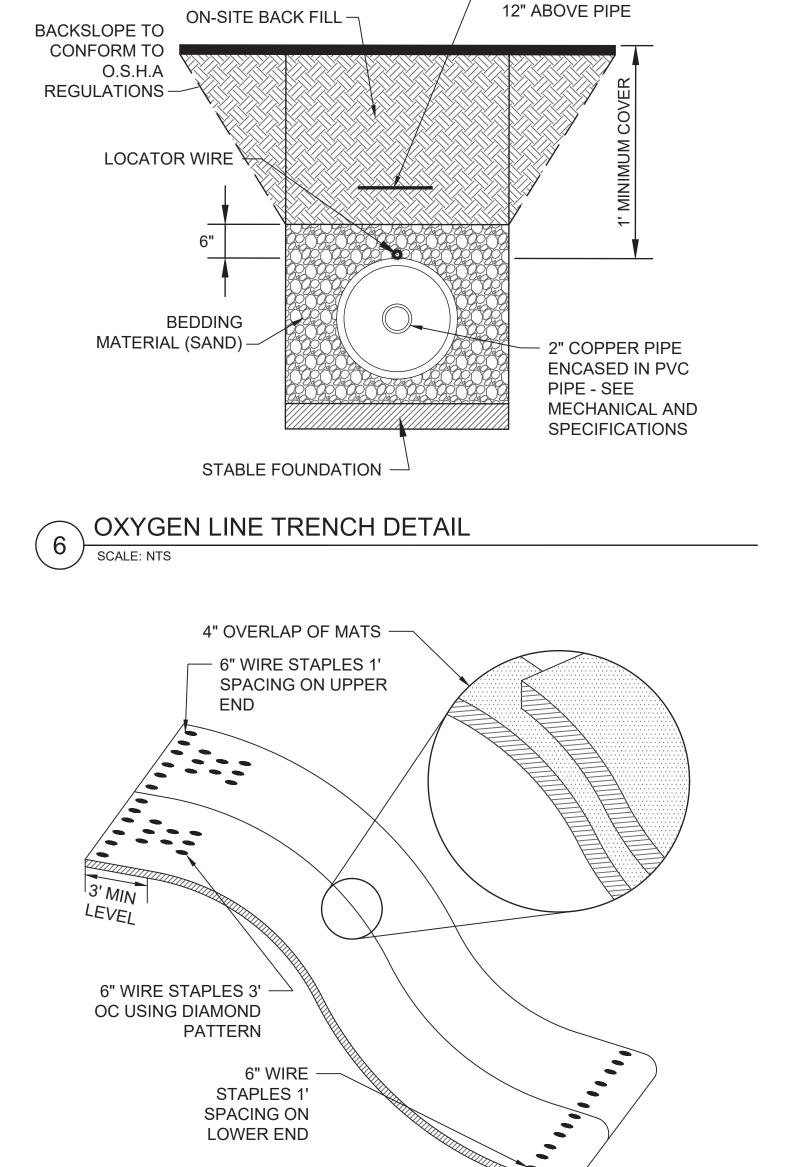

EROSION CONTROL BLANKET

WARNING TAPE

SEDIMENT CONTROL WATTLE SCALE: NTS



STAMP	Office of	
I HEREBY CERTIFY THAT THIS PLAN, SPECIFICATION, OR REPORT, WAS PREPARED BY ME OR UNDER MY DIRECT SUPERVISION AND THAT I AM A DULY LICENSED PROFESSIONAL ENGINEER UNDER THE LAWS OF THE STATE OF MINNESOTA	an	nstruction d Facilities nagement
	<b>\</b> /\	U.S. Department

	Drawing Title	Phase	Project Title			Project Number
on es	CIVIL DETAILS	BID DOCUMENTS	CONSTRUCT NEW SPS		438-460  Building Number  5	
nt	Approved: Project Director  SIOUX FALLS VA		Location SIOUX FALLS	S, SOUTH DAKOT		Drawing Number
ment Affairs	HEALTH CARE SYSTEM	FULLY SPRINKLERED	08/04/2022	Checked EB	Drawn AB	C-506

SCALE: NTS