


FORM	08-6231

VA

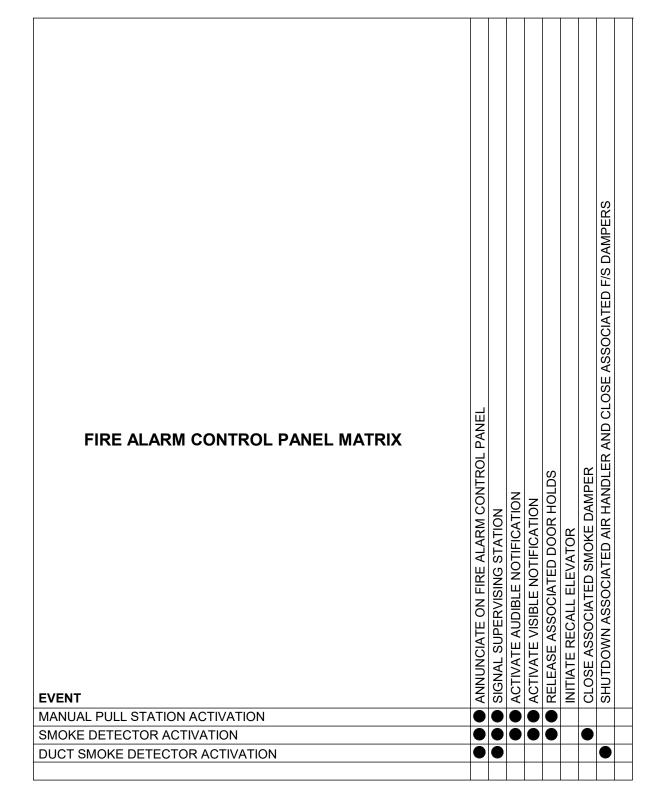


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1. MATRIX SHALL FOLLOW PROVISIONS OF VA FIRE PROTECTION DESIGN MANUAL FOR ZONED NOTIFICAITON REQUIREMENTS. 2. THE SAME SYSTEM RESPONSE SHALL BE USED IN THE ADDITION AS WHAT IS CURRENTLY USED IN THE EXISITNG FACILITY.

ALBERTSON ENGINEERING, INC. 315 NORTH MAIN AVENUE, SUITE 200 SIOUX FALLS, SOUTH DAKOTA 57104 PH: (605) 274-0880

SUMMIT FIRE CONSULTING 575 MINNEHAHA AVE WEST ST. PAUL, MINNESOTA 55103 (612) 387-7050



ARCHITECT

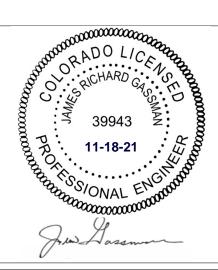

FOURFRONT DESIGN, INC. 517 7TH STREET RAPID CITY, SOUTH DAKOTA 57701 PH: (605) 342-9470 FOUFFRONT DESIGNINC. FAX: (605) 342-2377 WWW.FOURFRONTDESIGN.COM

GENERAL NOTES:

1. THIS PROJECT INCLUDES THE DESIGN OF AN EXTENSION TO THE EXISTING ADDRESSABLE FIRE ALARM SYSTEM FOR THE NEW BUILDING ADDITION SHOWN ON THESE PLANS PER NFPA 72 (2019 ed.), LOCAL BUILDING CODES, AND THE VA FIRE PROTECTION DESIGN MANUAL (SEVENTH ed.). NEW WIRING AND DEVICES WILL BE INSTALLED IN PROJECT AREAS ON ALL LEVELS.

2. FINAL DEVICE LOCATION AND CIRCUIT ROUTING IS TO BE DETERMINED BY THE FIRE ALARM CONTRACTOR AND IS SUBJECT TO APPROVAL BY THE ENGINEER OF RECORD.

3. REFER TO SPECIFICATION SECTION 28 31 00 FOR ADDITIONAL FIRE ALARM SYSTEM INFORMATION.

4. ALL DEVICES SHALL BE UL LISTED AND FM APPROVED PER THE VA FIRE PROTECTION DESIGN MANUAL. ALL NEW DEVICES SHALL BE PURCHASED FROM THE BUILDING FIRE ALARM MAINTENANCE CONTRACTOR TO ENSURE COMPATIBILITY WITH BUILDING'S FIRE ALARM SYSTEM.

5. DEVICES ARE REQUIRED TO BE PROTECTED DURING PAINTING.

6. CEILING MOUNTED DEVICES SHALL BE LOCATED IN THE CENTER POINT OF SQUARE CEILING TILES AND ALLOWED TO BE IN THE QUARTER AND/OR CENTER POINTS OF RECTANGULAR CEILING TILES.

7. NOT ALL REQUIRED DEVICES AND WIRING ARE SHOWN. CONSIDERATION OF ADDITIONAL DEVICES AND WIRING DUE TO INTERFERENCE WITH OTHER TRADES, OBSTRUCTIONS, IMPROVED AESTHETICS, OR OWNER/AHJ REQUESTS SHALL BE MADE PRIOR TO BID BY THE FIRE ALARM CONTRACTOR.

8. FIRE ALARM CONTRACTOR TO PROVIDE ALL NECESSARY MATERIAL TO PROVIDE COMPLETE SYSTEM(S) TO COMPLY WITH NFPA 72, LOCAL BUILDING CODES, AND THE VA FIRE PROTECTION DESIGN MANUAL. ANY AND ALL CLARIFICATIONS TO BID DOCUMENTS SHALL BE MADE PRIOR TO BID.

9. THE FIRE ALARM CONTRACTOR SHALL INSPECT THE SITE PRIOR TO BID. NO ALLOWANCES FOR EXTRA DEVICES ETC. WILL BE ALLOWED AFTER AWARD OF CONTRACT DUE TO MISUNDERSTANDING OF WORK INVOLVED OR LACK OF KNOWLEDGE OF ANY PROJECT SITE CONDITIONS.

10. CONTROL PANEL AND DEVICE LOCATIONS SHOWN ON THESE PLANS IS CONCEPTUAL BUT IS TO BE CLOSELY FOLLOWED BY THE FIRE ALARM CONTRACTOR. ANY MAJOR CHANGES TO WHAT IS BEING INDICATED ON THESE PLANS SHALL FIRST BE APPROVED BY THE ARCHITECT AND ENGINEER OF RECORD.

11. ALL ARCHITECTURAL, STRUCTURAL, MECHANICAL, & ELECTRICAL FEATURES INDICATED ON THE FA SHEETS SHALL BE VERIFIED BY CONSULTING THE A/S/M&E SHEETS.

12. ALL CALCULATIONS ARE THE RESPONSIBILITY OF THE FIRE ALARM CONTRACTOR. ANY AND ALL CLARIFICATION TO BID DOCUMENTS SHALL BE MADE PRIOR TO BID.

13. SHOULD ANY EXISTING SYSTEM DEFICIENCIES NOT INDICATED ON THESE PLANS BE DISCOVERED AS PART OF CONDUCTING THE WORK INCLUDED IN THIS SCOPE, THEY SHALL BE BROUGHT TO THE ATTENTION OF THE ENGINEER OF RECORD IMMEDIATELY.

14. THESE PLANS SHALL BE USED AS A GENERAL GUIDE IN THE GENERATION OF THE FIRE ALARM CONTRACTOR'S BID AND ARE NOT INTENDED TO INDICATE THE ENTIRE EXTENT OF ALARM PROTECTION REQUIRED. ANY AREAS REQUIRED TO BE PROTECTED PER NFPA 72 THAT MAY OR MAY NOT BE SHOWN WITH PROTECTION ON THESE PLANS SHALL BE INCLUDED IN THE CONTRACTOR'S BID.

15. FIRE ALARM CONTRACTOR SHALL BE RESPONSIBLE FOR THE REMOVAL AND RE-INSTALLING OF EXISTING CEILING TILE AND WALLS NOT REMOVED BY THE GENERAL CONTRACTOR FOR THE DEMOLITION OF EXISTING FIRE ALARM DEVICES, WIRING, ETC. ANY CEILING OR WALL COMPONENTS DAMAGED SHALL BE REPLACED OR PATCHED WITH NEW BY THIS CONTRACTOR.

16. FIRE ALARM RISER DIAGRAM AND SHOP DRAWINGS, INCLUDING BATTERY CALCULATIONS AND NOTIFICATION APPLIANCE CIRCUIT VOLTAGE DROP ANALYSIS PLUS SEQUENCE OF OPERATIONS, SHALL BE PREPARED AND SUBMITTED BY THE FIRE ALARM CONTRACTOR.

(он) S SPEAKER - CEILING MOUNT ISO ISOLATION MODULE

STROBE - WALL MOUNT

Drawing Title	Project Title			Project Number
FIRE ALARM COVER SHEET	EXPAND BLDG. 1 FOR			437-315
	PRIMARY CAF	RE		Building Numbe
Approved: Project Director	Location 2101 ELM S	STREET		Drawing Numbe
FARGO VAHCS	FARGO, NE	D 58102		
	Date	Checked	Drawn	FA1
	11/16/2021	NB	CJ	Dwg. 123

FIRE ALARM DEVICE SYMBOLS

SPOT-TYPE SMOKE DETECTOR

DUCT-TYPE SMOKE DETECTOR

MANUAL PULL STATION

SPRINKLER WATER FLOW MONITOR MODULE


() SPRINKLER TAMPER SWITCH MONITOR MODULE


MAGNETIC DOOR HOLD RELAY


SPEAKER STROBE - CEILING MOUNT

SPEAKER STROBE - WALL MOUNT

₩P SPEAKER STROBE - WALL MOUNT WATER PROOF

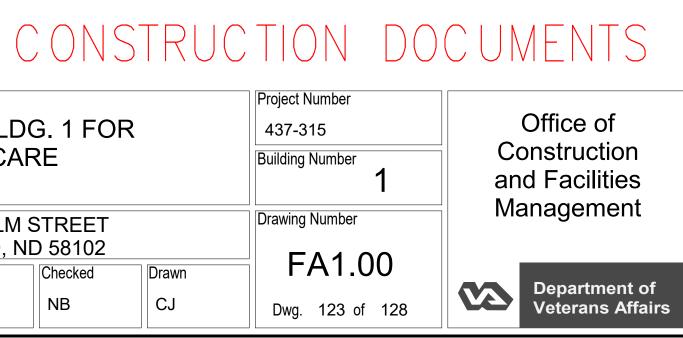

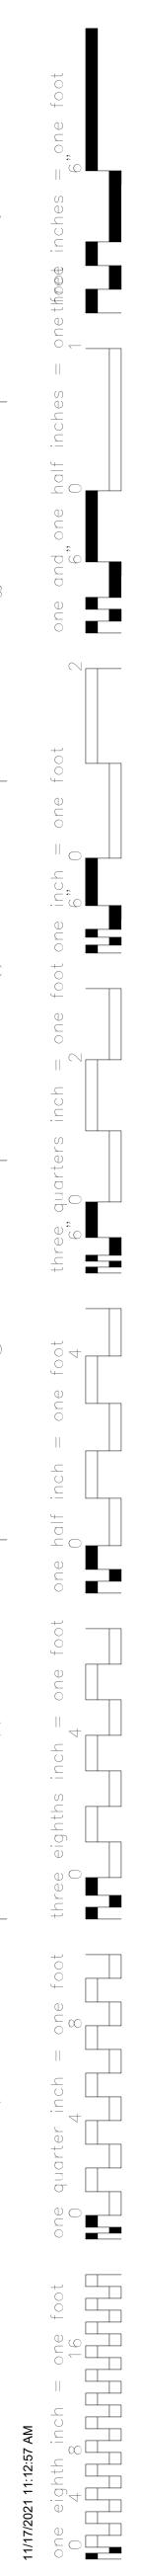

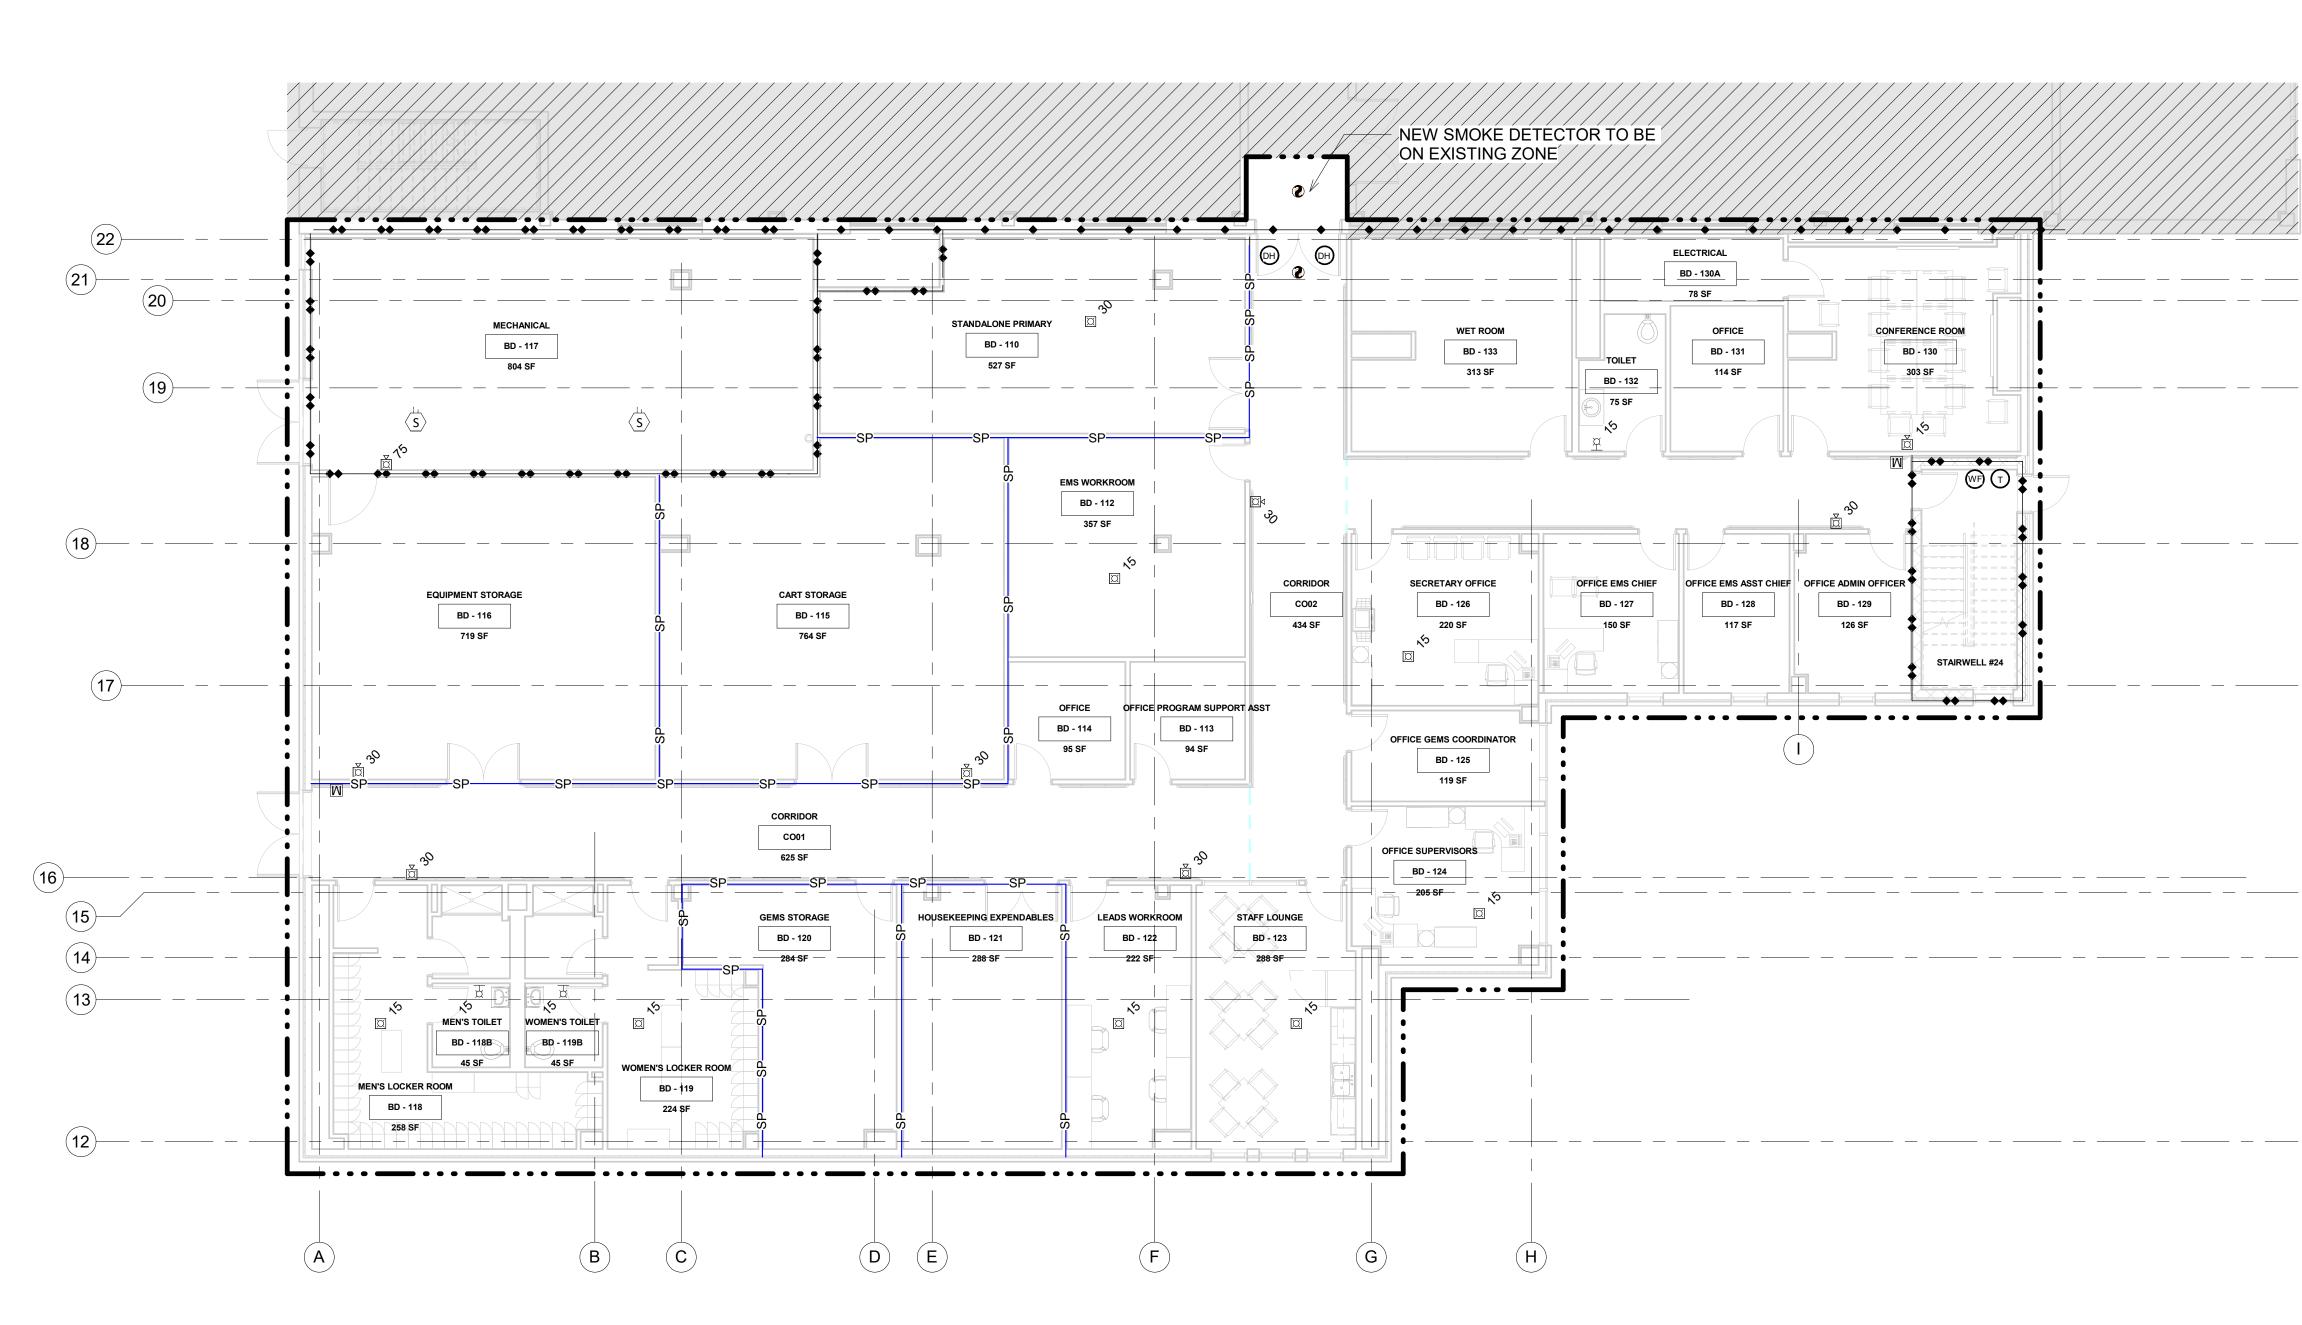



Revisions:	Date	
		CALIBRE 9090 S RIDGELINE BLVD, SUITE 105 HIGHLANDS RANCH COLORADO 80129 PHONE (303) 730-0434 Albertson Engineering In
		CONSULTANTS:

RICHARD G ALBERTSON ENGINEERING, INC. 315 NORTH MAIN AVENUE, SUITE 200 SIOUX FALLS, SOUTH DAKOTA 57104 PH: (605) 274-0880 11-18-21

SUMMIT FIRE CONSULTING 575 MINNEHAHA AVE WEST ST. PAUL, MINNESOTA 55103 (612) 387-7050



ARCHITECT



FOURFRONT DESIGN, INC. 517 7TH STREET RAPID CITY, SOUTH DAKOTA
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 FAX: (605) 342-2377

 WWW.FOURFRONTDESIGN.COM

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		E	IRE ALARM DEVICE SYMBO
			SPOT-TYPE SMOKE DETECTO
		Σ	MANUAL PULL STATION
		(w	SPRINKLER WATER FLOW MOI
		C	SPRINKLER TAMPER SWITCH
			MAGNETIC DOOR HOLD RELAY
		Ø	•

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MONITOR MODULE CH MONITOR MODULE IAY **G MOUNT** SPEAKER STROBE - WALL MOUNT S SPEAKER - CEILING MOUNT ISO ISOLATION MODULE WP SPEAKER STROBE - WALL MOUNT WATER PROOF STROBE - WALL MOUNT

NEW PLAN AREA LEGEND:

EXISTING TO REMAIN. FIRE BARRIER SYMBOLS 		UNDER THIS CONTRACT.
		EXISTING TO REMAIN.
SPSP SMOKE PARTITION		
	FIRE DAP	KRIER STINDULS
2-HOUR FIRE BARRIER		
······································		1-HOUR FIRE BARRIER
	• •	1-HOUR FIRE BARRIER SMOKE PARTITION

SHEET NOTES:


1. ALL EXISITNG DEV REMOVED AND REPI
2. ALL NEW FIRE ALA EXISTING FIRE ALAR
3. CONFIRM NEW SM ARCHITECT OF RECO
4. CONTRACTOR TO MESSAGE CHIPS, ET THE EXISTING FIRE A

Drawing Title	Project Title			Project Number
FIRE ALARM - BASEMENT LEVEL	EXPAND BL	DG. 1 FO	2	437-315
	PRIMARY C	CARE		Building Numbe
Approved: Project Director	Location 2101 EL	M STREET		Drawing Numbe
FARGO VAHCS	Date		Drawn	FA1
	11/16/2021	NB	CJ	Dwg. 124


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LIMITS OF PROJECT/CONSTRUCTION


ER SYMBOLS

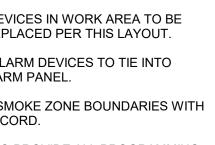

TO PROVIDE ALL PROGRAMMING, ETC. REQUIRED FOR CHANGE TO E ALARM SYSTEM.



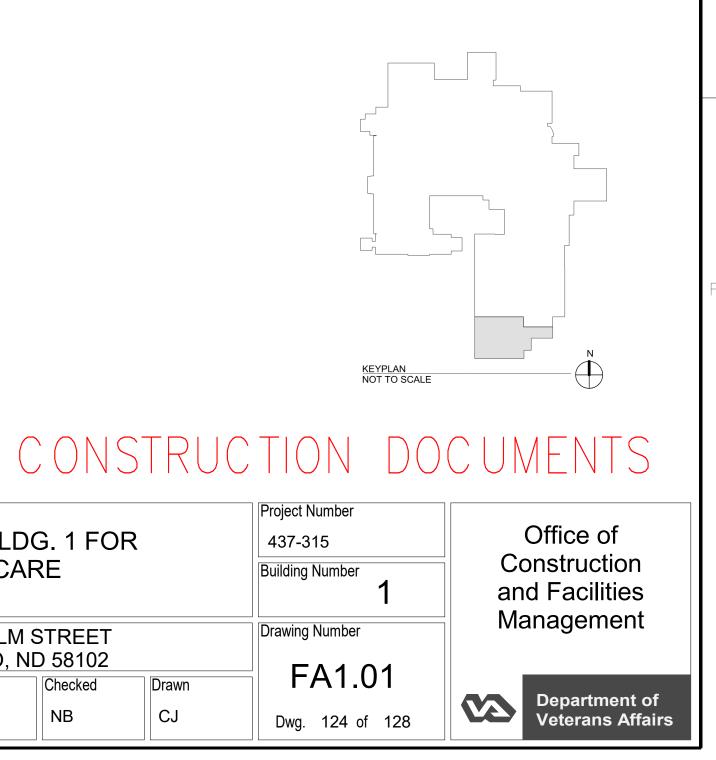

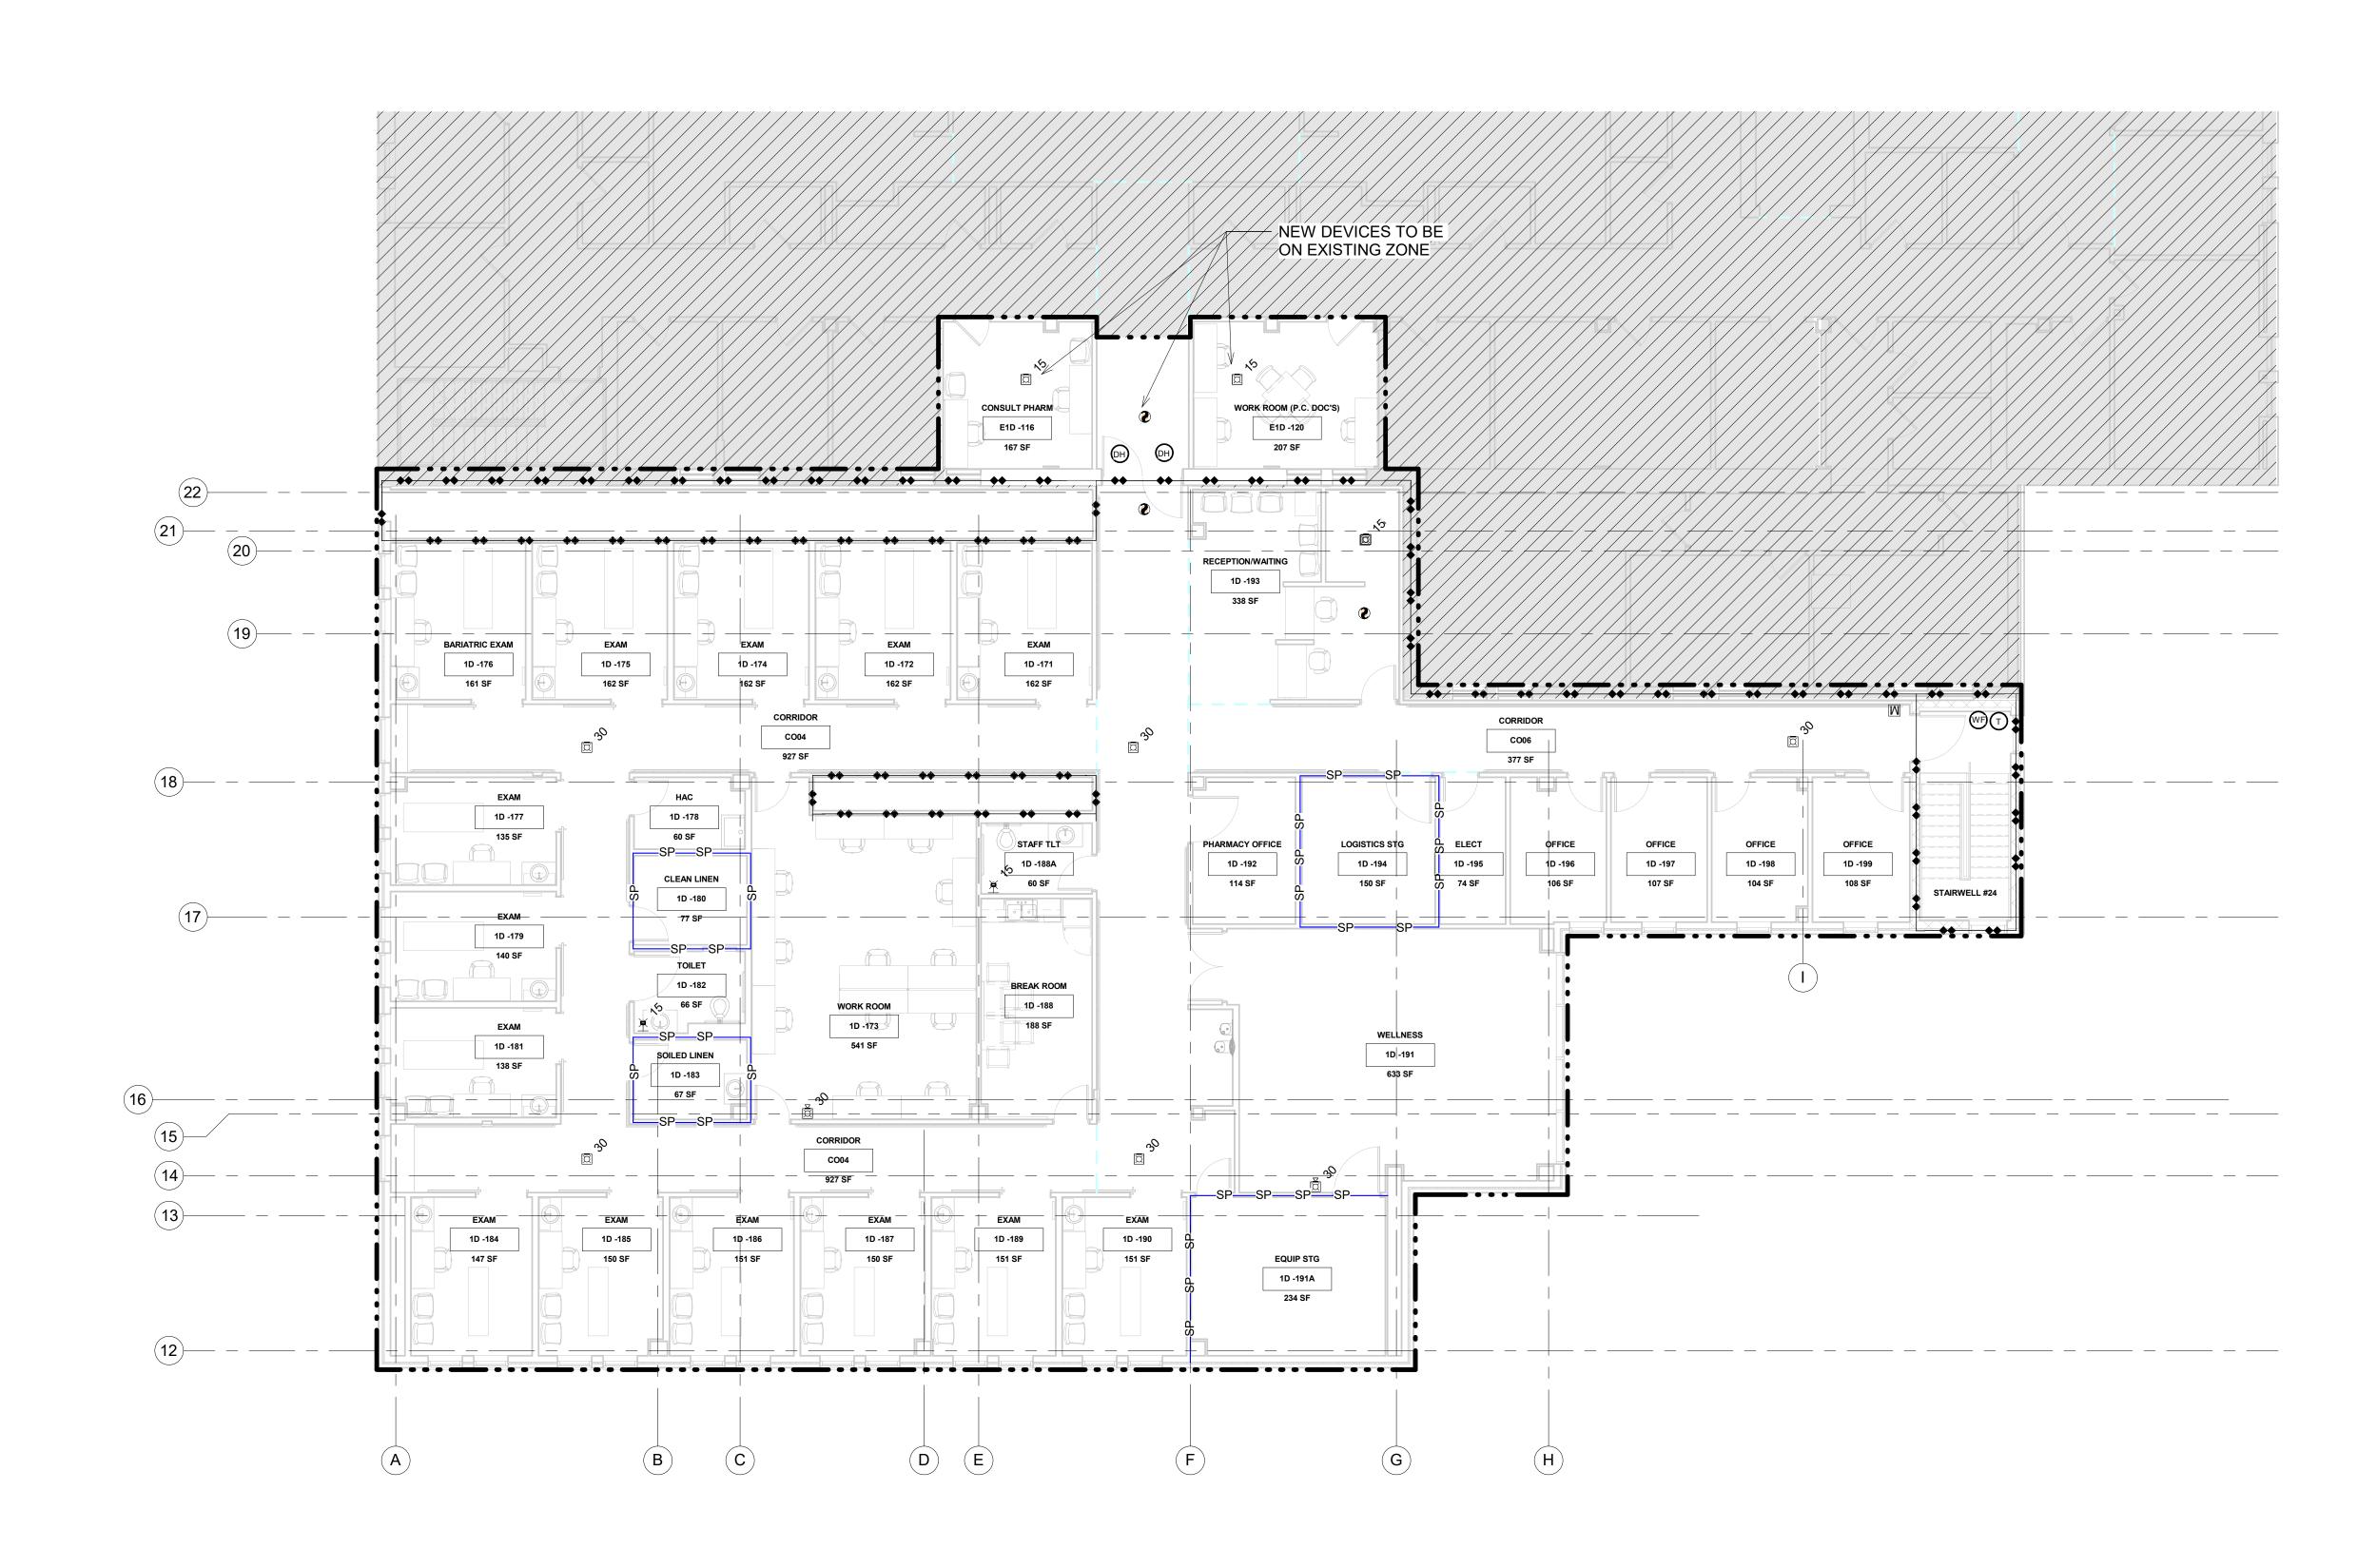

1 FIRE ALARM PLAN - FIRST LEVEL 1/8" = 1'-0"



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	6		7	8	

FIRE ALARM DEVICE SYMBOLS

Ø	SPOT-TYPE SI
$\langle \mathbf{S} \rangle$	DUCT-TYPE SI
N	MANUAL PULL
WF	SPRINKLER WA
T	SPRINKLER TA
	MAGNETIC DO
E S	SPEAKER STR
·ر. ل	SPEAKER STR
S	SPEAKER - CEI
ISO	ISOLATION MO
₩P	SPEAKER STR
₽ Ŷ	STROBE - WAL

NEW PLAN AREA LEGEND:

FIRE BARRIER				
+ +	1-HOUR FIF			
SP-SP	SMOKE PAR			
++ ++	2-HOUR FIF			

SHEET NOTES:

2. ALL NEW FIRE ALARM DEVICES TO TIE INTO EXISTING FIRE ALARM PANEL. 3. CONFIRM NEW SMOKE ZONE BOUNDARIES WITH ARCHITECT OF RECORD. DEVICES TO BE TIED INTO RESPECTIVE ZONES PER THEIR LOCATION. 4. CONTRACTOR TO PROVIDE ALL PROGRAMMING, MESSAGE CHIPS, ETC. REQUIRED FOR CHANGE TO THE EXISTING FIRE ALARM SYSTEM.

Drawing Title	Project Title	Project Title			
FIRE ALARM - FIRST LEVEL	EXPAND B	EXPAND BLDG. 1 FOR			
	PRIMARY	Building Number			
Approved: Project Director	Location 2101 ELM STREET			Drawing Number	
FARGO VAHCS	FARGC	FARGO, ND 58102			
	Date	Checked	Drawn	FA1.02	
	11/16/2021	NB	CJ	Dwg. 125 of 128	

SMOKE DETECTOR SMOKE DETECTOR L STATION VATER FLOW MONITOR MODULE AMPER SWITCH MONITOR MODULE OOR HOLD RELAY ROBE - CEILING MOUNT ROBE - WALL MOUNT EILING MOUNT ODULE ROBE - WALL MOUNT WATER PROOF ALL MOUNT

LIMITS OF PROJECT/CONSTRUCTION UNDER THIS CONTRACT.

EXISTING TO REMAIN.


SYMBOLS

RE BARRIER


RTITION

IRE BARRIER

1.. ALL EXISITNG DEVICES IN WORK AREA TO BE REMOVED AND REPLACED PER THIS LAYOUT.

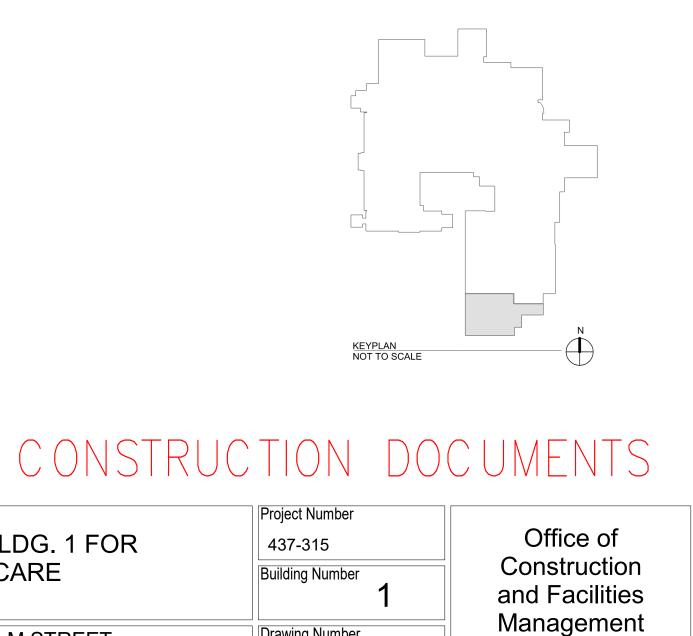

Department of Veterans Affairs

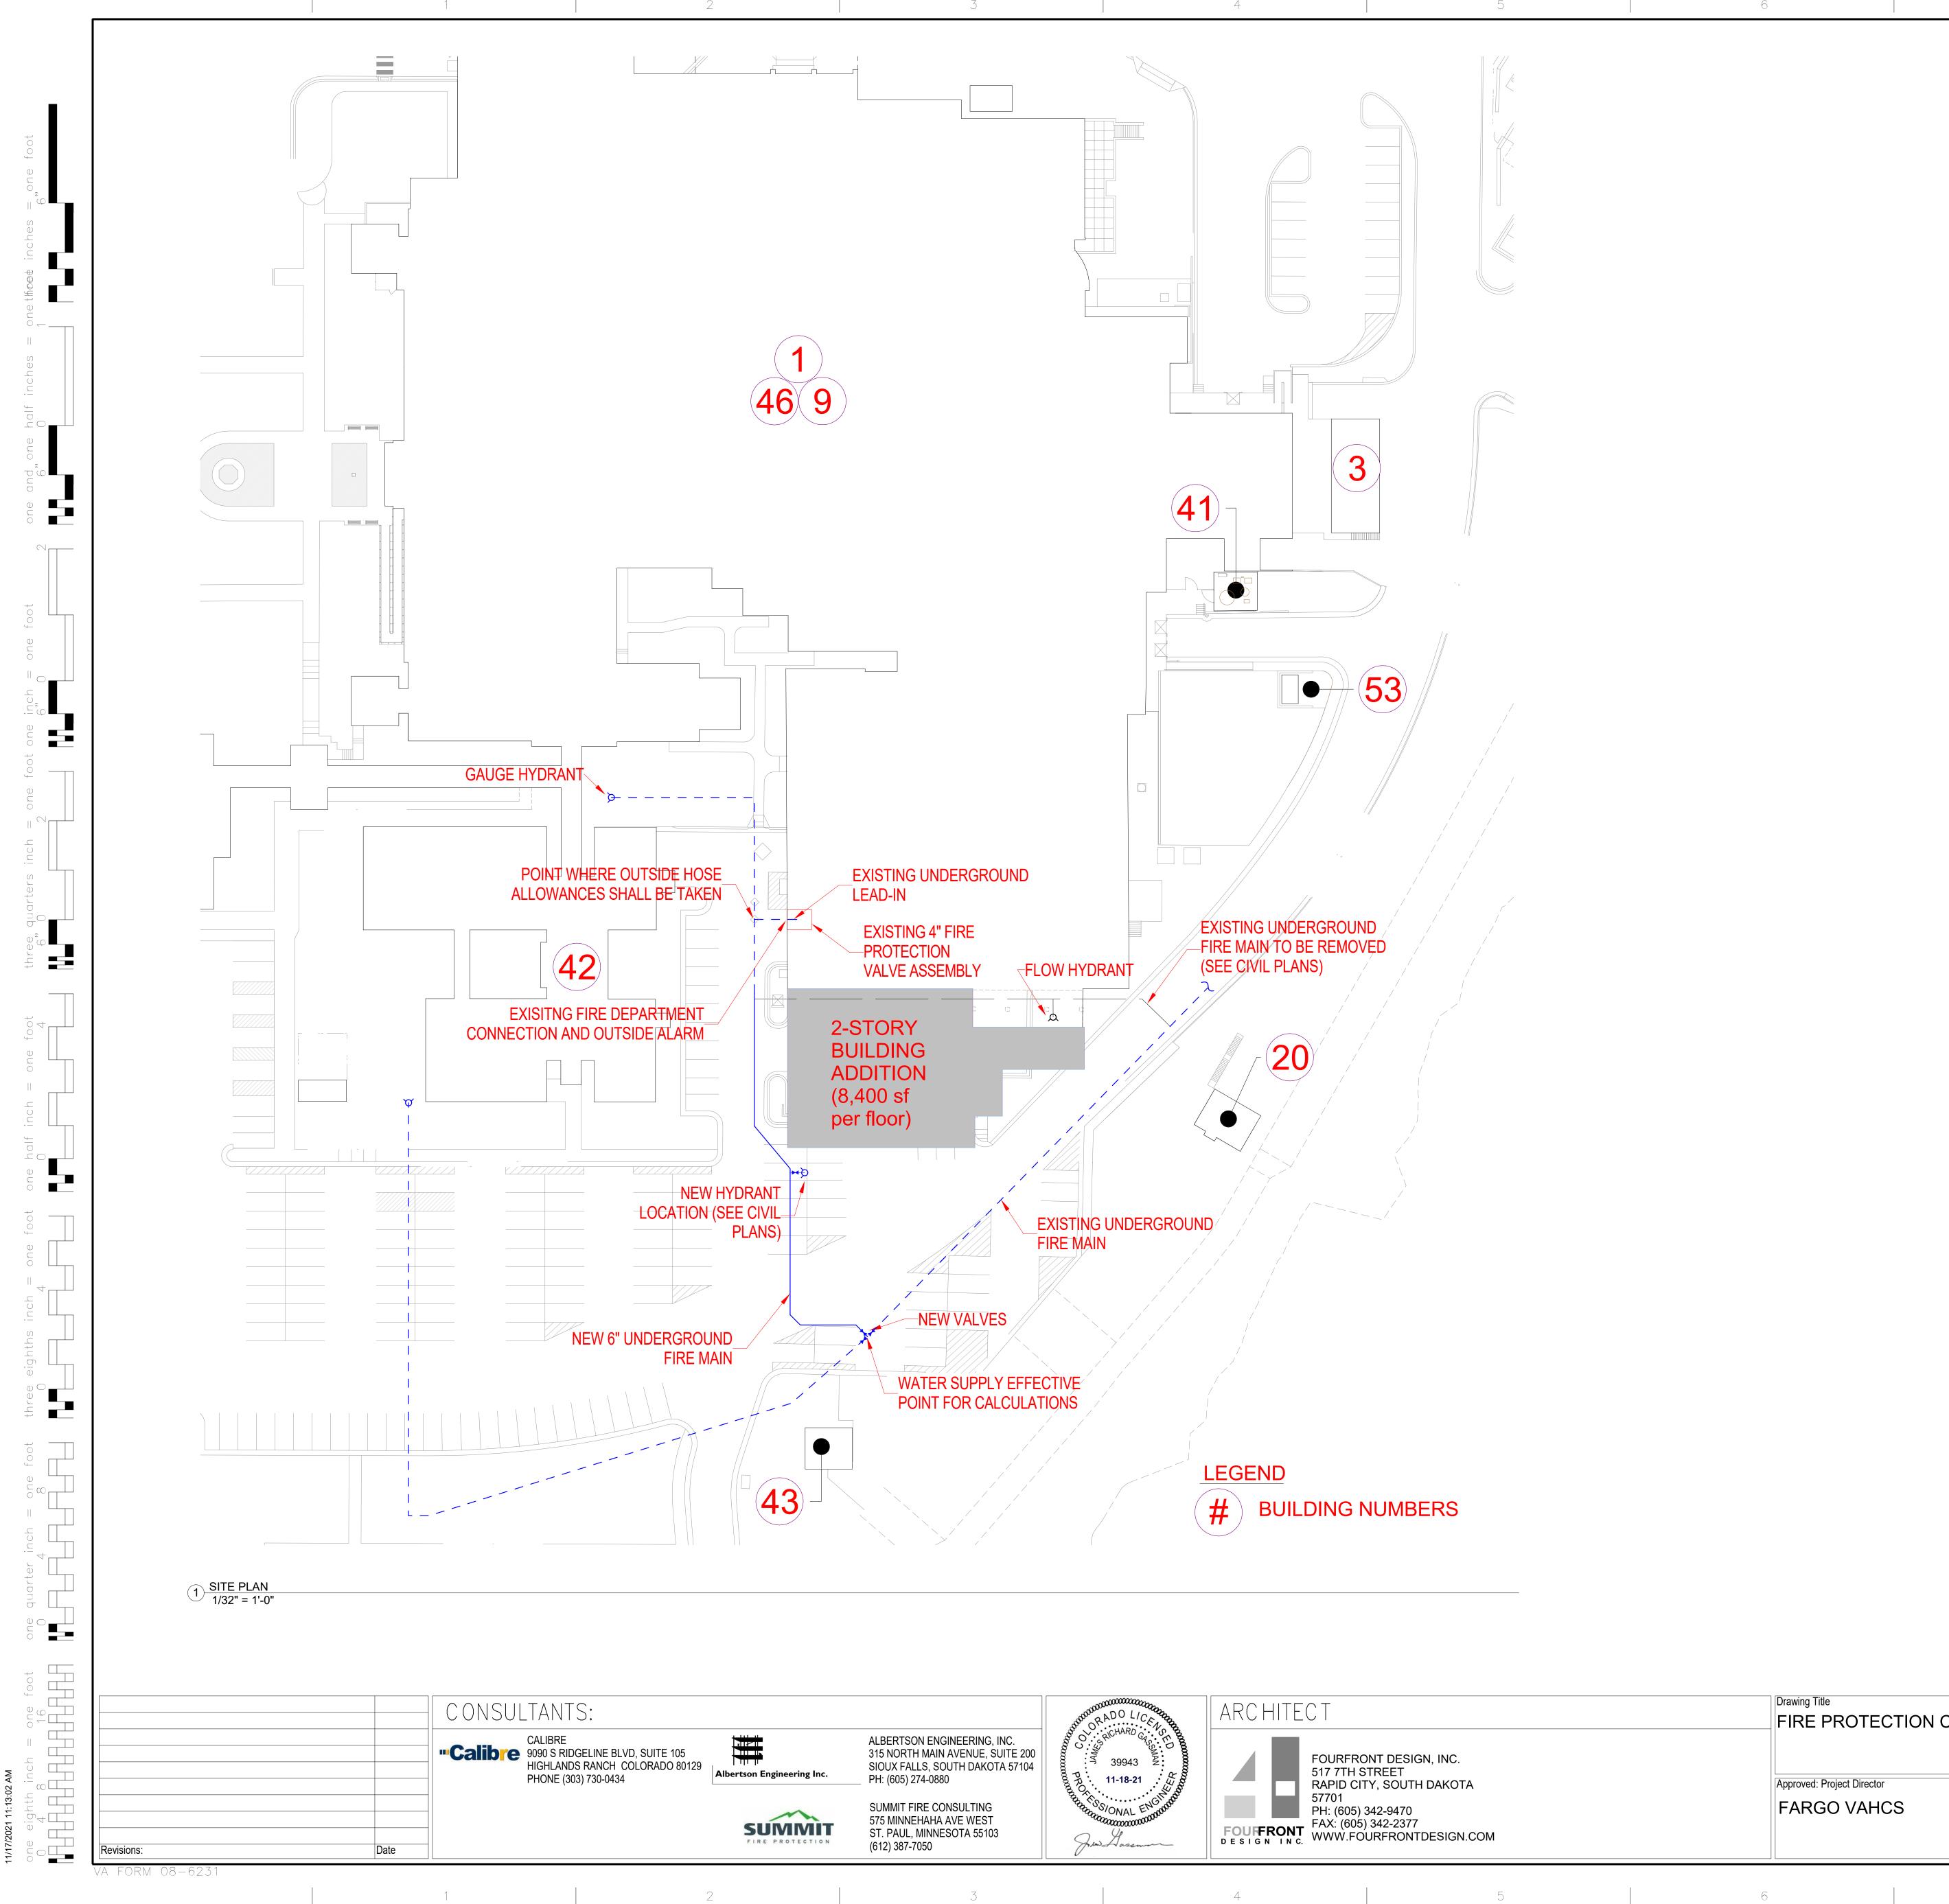

GENERAL NOTES: FIRE PROTECTION CONTRACTOR'S SCOPE OF WORK INC

1.

- STANDPIPE SYSTEM TIED INTO THE EXISTING 4" VALVE AS PROTECTION AT BASEMENT LEVEL AND FIRST LEVEL OF REWORK WITHIN THE EXISTING BUILDING IS REQUIRED.
- NEW ADDITION SHALL HAVE ENTIRELY NEW SPRINKLER 2 2. STAIRWELL AS SHOWN ON DRAWINGS. THIS IS TO MAINT. SPRINKLER ZONES TO THE NEW SMOKE ZONE OF THE AD
- ALL COMPONENTS OF THE SPRINKLER SYSTEM SHALL B 3. DESIGN GUIDELINES, NFPA 13 (2019), NFPA 14 (2019) AND TO SPECIFICATION SECTIONS 21 08 00 & 21 13 13 FOR AD SYSTEM INFORMATION.
- 4. ALL PATIENT CARE AREAS ASSUME LIGHT HAZARD PROT NFPA 13 (2019). PARKING, MECHANICAL/ELECTRICAL ROC 1 PROTECTION IN ACCORDANCE WITH NFPA 13 (2019). ST ORDINARY HAZARD GROUP 2 PROTECTION IN ACCORDAN
- EXIT STAIRWELL TO BE PROVIDED WITH PLUGGED/CAPP POTENTIAL FUTURE STANDPIPE SYSTEM. ZONE CONTRO AT EACH LEVEL. CONFIRM 3" ZONE CONTROL/MAINS AND 1 1/2" BRANCHLI 6.
- PIPE SIZING VIA HYDRAULIC CALCULATIONS. PROVIDE ALL SYSTEM COMPONENTS NECESSARY FOR A 7. SYSTEM COMPONENTS SHALL INCLUDE BUT ARE NOT LI SPRINKLER PIPING, SPRINKLERS, PIPE SUPPORTS, ALAR
- CONNECTIONS, CONTROL VALVES AND CHECK VALVES. SEMI RECESSED SPRINKLERS REQUIRED IN AREAS WITH 8. CONCEALED SPRINKLERS ARE NOT ALLOWED IN LIGHT H GUIDELINES. UPRIGHTS IN EXPOSED AREAS TO BE BRASS
- TAMPER SWITCHES AND FLOW SWITCHES ARE TO BE PR 9. FIRE PROTECTION CONTRACTOR AND WIRED PER SPECI
- TESTING OF SPRINKLER PIPING SHALL BE IN ACCORDAN 10. 2 HRS
- SHOP DRAWINGS SHALL BE APPROVED BY THE OWNER'S 11. REPRESENTATIVE AND THE AHJ PRIOR TO FABRICATION
- HANG ALL PIPING PER NFPA 13 CHAPTER 9. CONTRACT(12. SUPPORTS.
- 13. STEEL PIPING IS REQUIRED IN ALL AREAS .
- UNLESS NOTED OTHERWISE ALL AREAS INCLUDE WET S 14. TEMPERATURES MAINTAINED GREATER THAN OR EQUAL AT ALL TIMES.
- ALL PENETRATIONS AT FIRE BARRIERS OR OTHER RATED ASSEMBLIES ARE REQUIRED 15. TO BE SEALED IN ACCORDANCE WITH THE 2018 INTERNATIONAL BUILDING CODE OR OTHER APPROVED MEANS.
- 16. COORDINATION IS REQUIRED WITH ALL TRADES. PROVIDE SPRINKLER PROTECTION ABOVE AND BELOW ALL OBSTRUCTIONS.
- 16. COORDINATE SHUT DOWNS AND TIE IN WORK WITH AHJ AND GENERAL CONTRACTOR AND VA FP ENGINEERING.
- FLOW TEST PROVIDED FROM SUMMIT FIRE CONSULTING (SFC) 17. STATIC: 48 PSI RESIDUAL: 39 PSI
- FLOW: 809 GPM DATE: 9/1/2021 EFFECTIVE POINT: WHERE THE NEW 6" FIRE MAIN TIES INTO THE EXISTING LOOP MAIN SOUTH OF THE BUILDING. HOSE ALLOWANCES SHALL BE TAKEN AT THE POINT OF CONNECTION TO THE

EXISTING RISER.

RE PROTECTION COVER SHEET EXPAND BLDG. 1 FOR			437-315	
	PRIMARY (CARE		Building Numbe
Approved: Project Director	Location 2101 ELM STREET			
FARGO VAHCS	FARGO, ND 58102			
	Date	Checked	Drawn	FP1
	11/16/2021	NB	CJ	Dwg. 126


Drawing Title


Project Title

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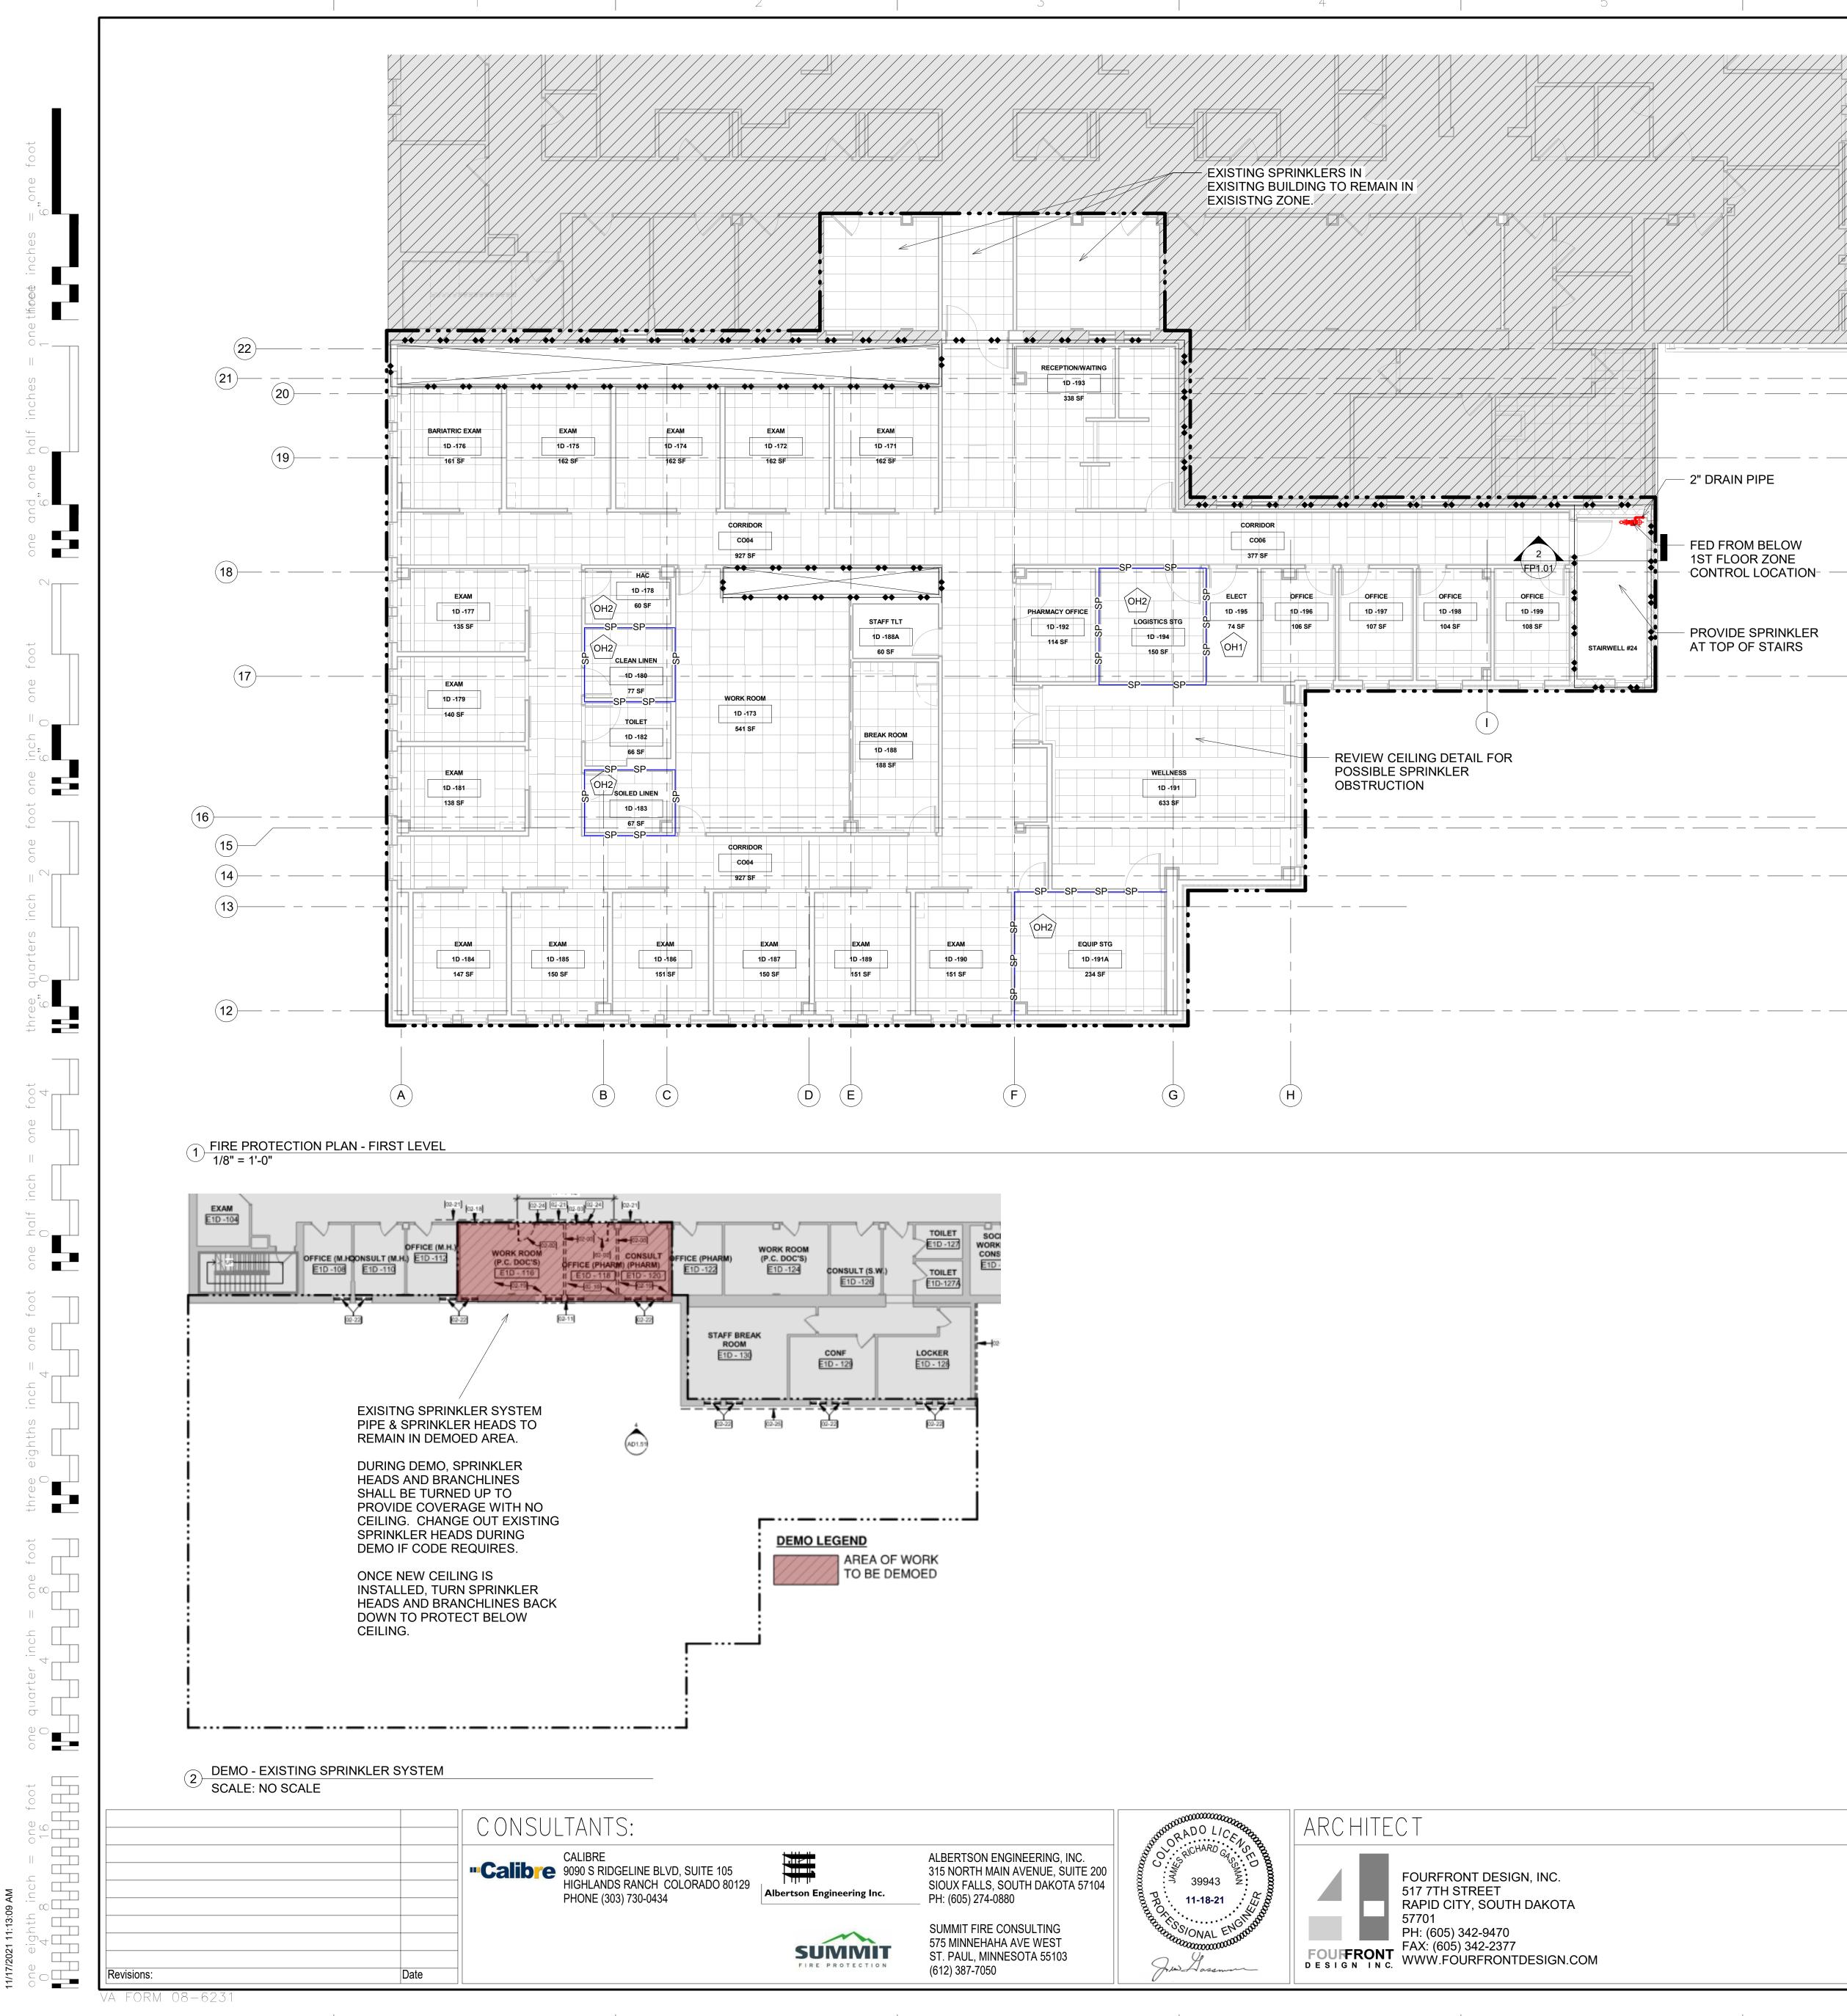
CLUDES INSTALLATION OF A ASSEMBLY AND WET SPRINKLER THE NEW ADDITION. LIMITED
ZONE SUPPLIED WITHIN NEW TAIN CORRELATION OF NEW ADDITION.
BE IN ACCORDANCE WITH VA D NFPA 25 (2020) EDITION. REFER DDITIONAL FIRE SPRINKLER
TECTION IN ACCORDANCE WITH OMS ORDINARY HAZARD GROUP TORAGE AREAS, LAUNDRY, NNCE WITH NFPA 13 (2019).
PED 2 1/2" OUTLETS FOR OL VALVES WILL BE PROVIDED
INES FOR SPRINKLER SYSTEM
A COMPLETE INSTALLATION. IMITED TO DISTRIBUTION PIPING, RMS, DRAINS, TEST
H FINISHED CEILINGS. HAZARD OCCUPANCIES PER VA SS FINISH.
ROVIDED AND INSTALLED BY THE CIFICATION - DIVISION 28.
NCE WITH NFPA 13 - 200 PSI FOR
'S DESIGNATED
FOR SHALL INDICATE ALL PIPE
SPRINKLER SYSTEMS. L TO 40 DEGREES FAHRENHEIT

EXISTING LEAD-IN MAIN TO THE EXISTING OUTSIDE MAIN JUST WEST OF THE



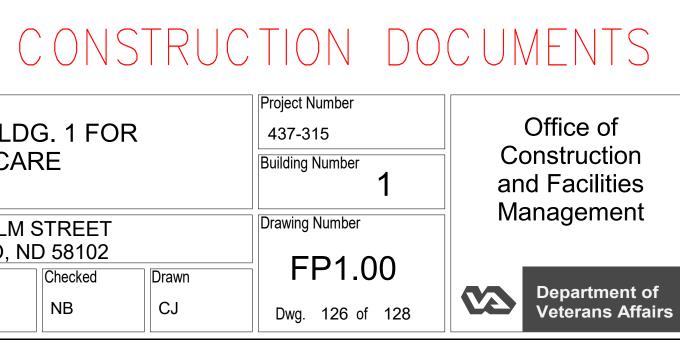

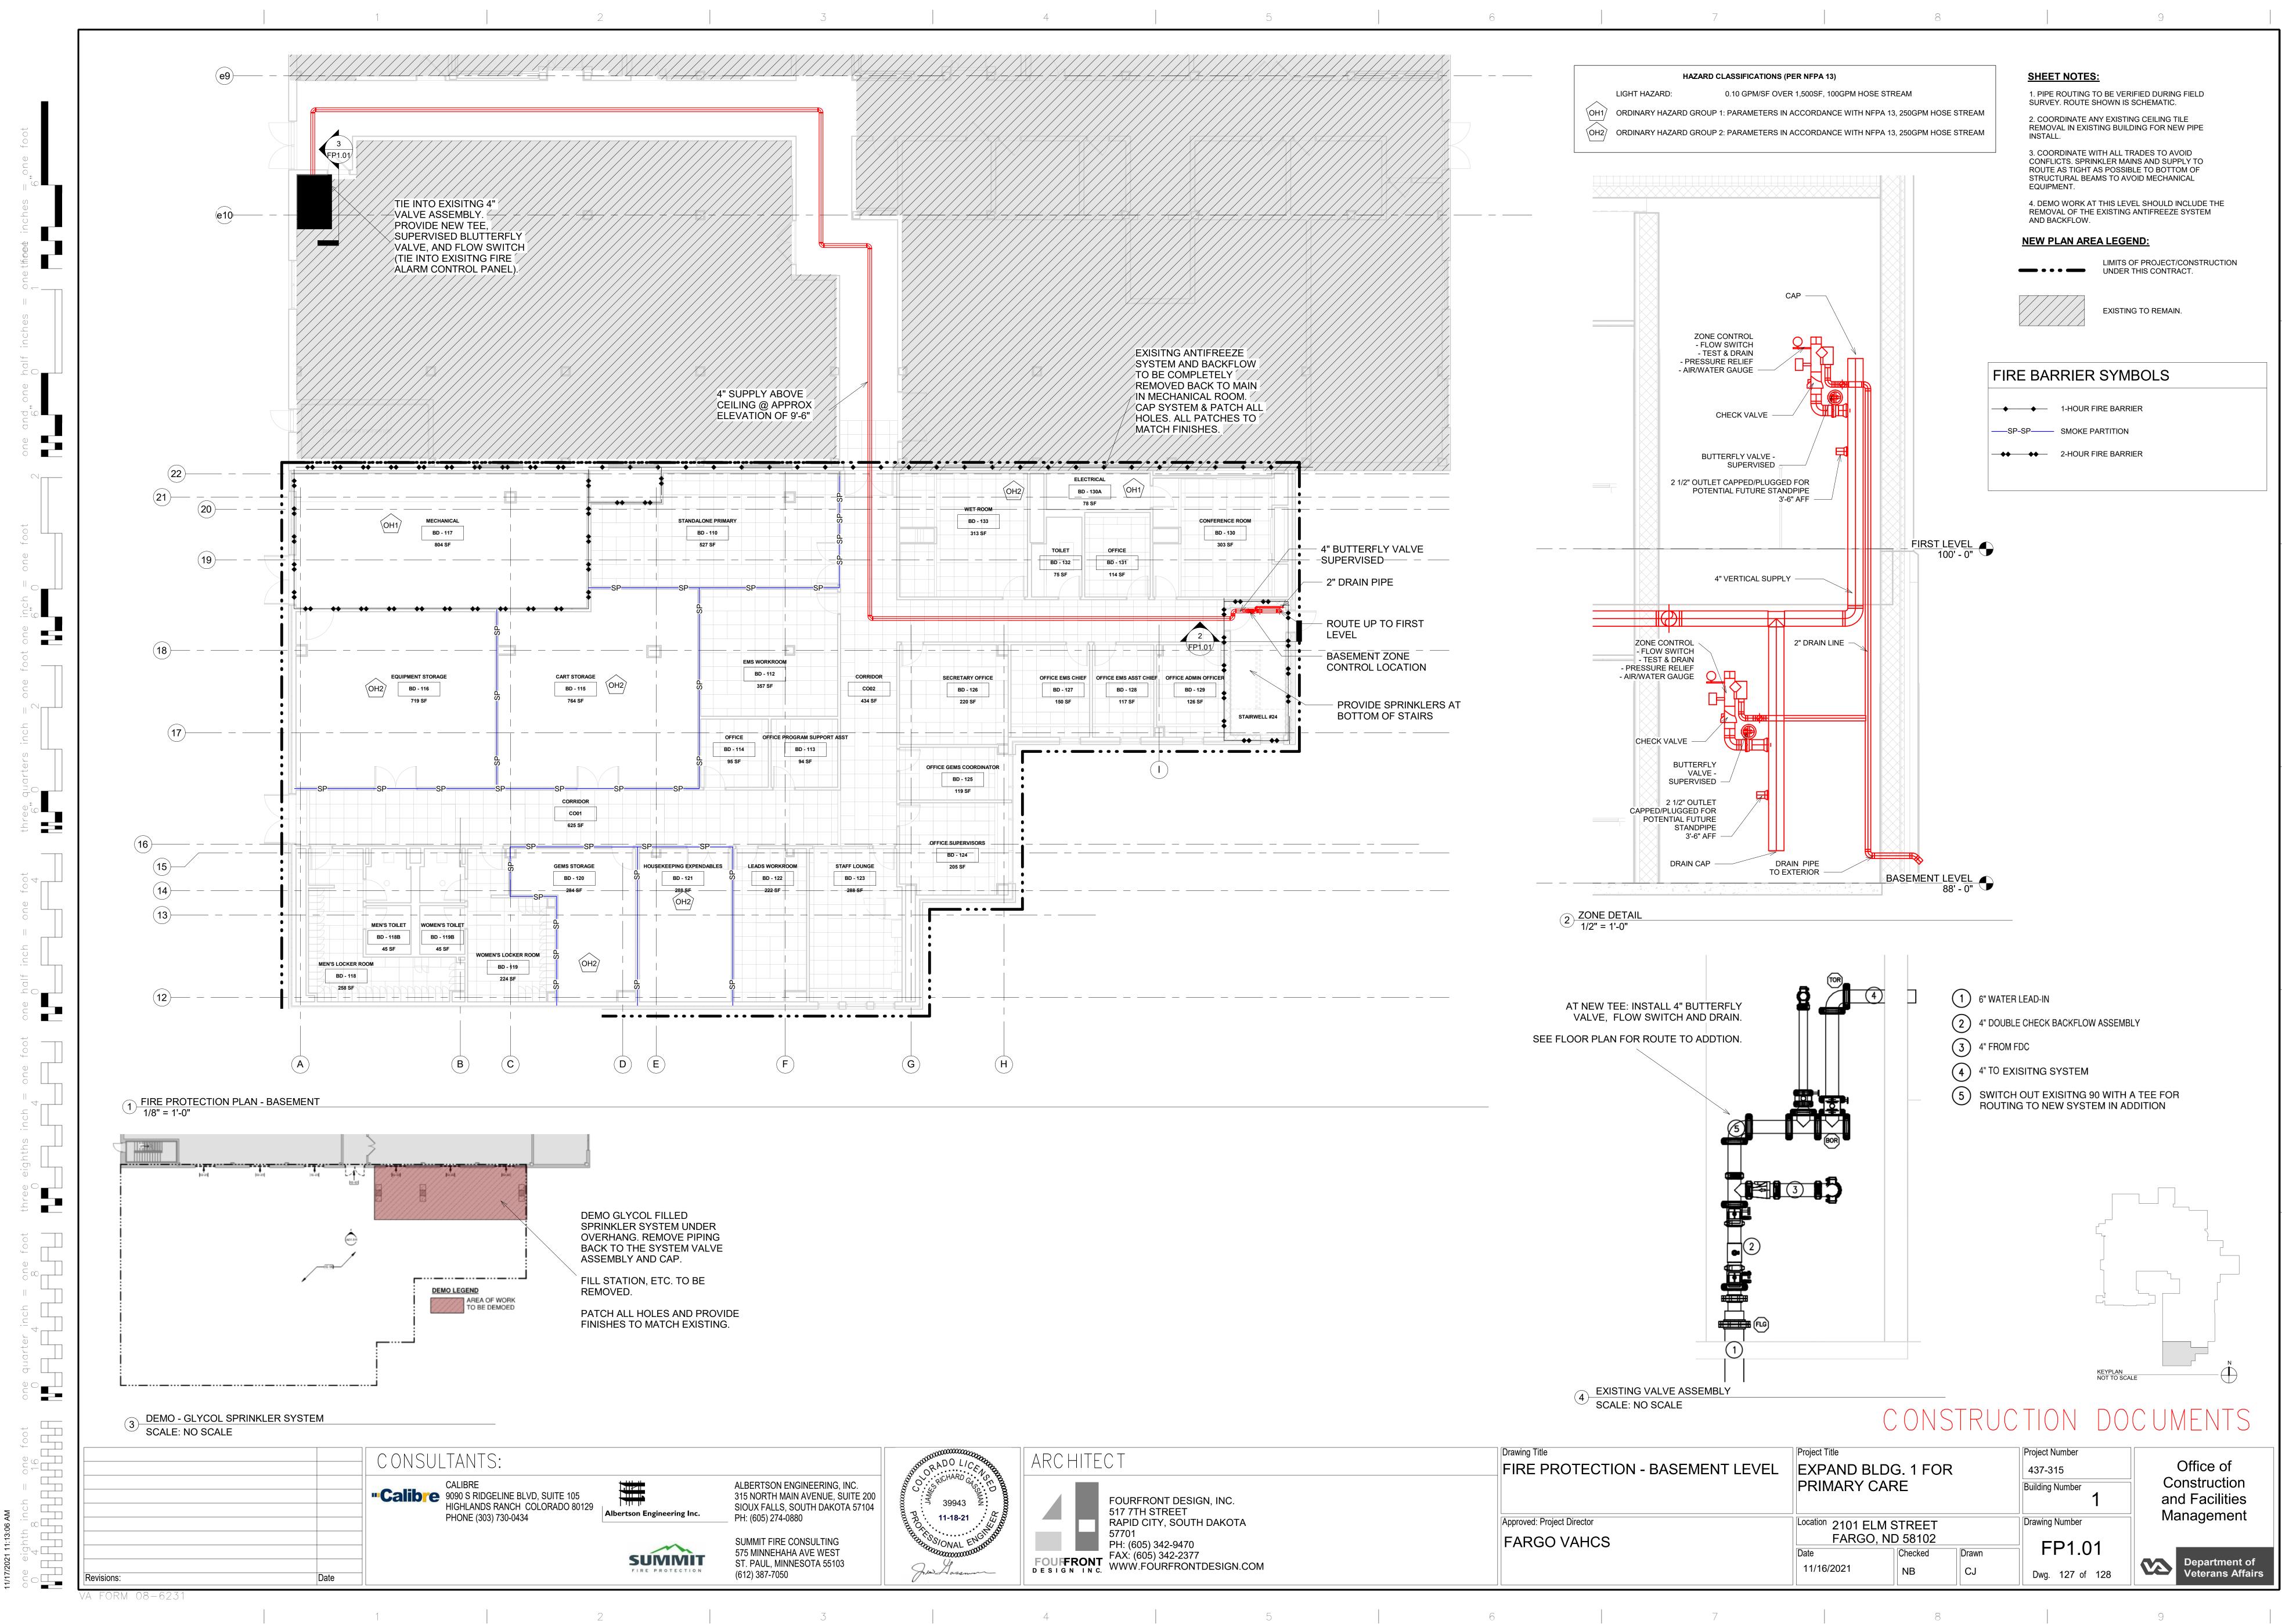N AREA LEGEND:
ORK AT THIS LEVEL SHOULD INCLUDE TH OF THE EXISTING ANTIFREEZE SYSTEM FLOW.
NATE WITH ALL TRADES TO AVOID 5. SPRINKLER MAINS AND SUPPLY TO TIGHT AS POSSIBLE TO BOTTOM OF AL BEAMS TO AVOID MECHANICAL T.
NATE ANY EXISTING CEILING TILE N EXISTING BUILDING FOR NEW PIPE
OUTE SHOWN IS SCHEMATIC.



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FED FROM BELOW 1ST FLOOR ZONE CONTROL LOCATION-

PROVIDE SPRINKLER AT TOP OF STAIRS

HAZARD CLASSIFICATIONS (PER NFPA 13)

LIGHT HAZARD: 0.10 GPM/SF OVER 1,500SF, 100GPM HOSE STREAM

(OH1) ORDINARY HAZARD GROUP 1: PARAMETERS IN ACCORDANCE WITH NFPA 13, 250GPM HOSE STREAM (OH2) ORDINARY HAZARD GROUP 2: PARAMETERS IN ACCORDANCE WITH NFPA 13, 250GPM HOSE STREAM **SHEET NOTES:**

1. COORDINATE WITH ALL TRADES TO AVOID CONFLICTS. SPRINKLER MAINS AND SUPPLY TO ROUTE AS TIGHT AS POSSIBLE TO BOTTOM OF STRUCTURAL BEAMS TO AVOID MECHANICAL EQUIPMENT.

FIRE BARRIER SYMBOLS

→ 1-HOUR FIRE BARRIER ——SP–SP——— SMOKE PARTITION → → 2-HOUR FIRE BARRIER

CONSTRUCTION DOCUMENTS

	Drawing Title	Project Title			Project Number
	FIRE PROTECTION - FIRST LEVEL	EXPAND BLDG. 1 FOR			437-315
		PRIMARY CARE Location 2101 ELM STREET FARGO, ND 58102			
	Approved: Project Director				
FARGO VAHCS		Date		Drawn	FP1 .
		11/16/2021	NB	CJ	Dwg. 128 (

NEW PLAN AREA LEGEND:

LIMITS OF PROJECT/CONSTRUCTION UNDER THIS CONTRACT.

EXISTING TO REMAIN.

