

CONSTRUCTION DOCUMENTS

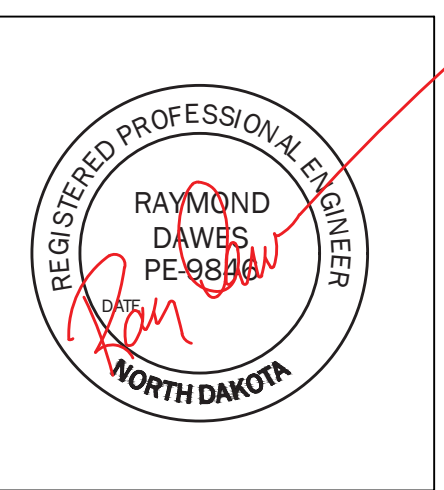
Revisions	Date

CONSULTANTS:

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 9090 S RIDGELINE BLVD, SUITE 105
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Drawing Title
ELECTRICAL DETAILS

Approved: Project Director
FARGO VAHCS

Project Title
EXPAND BLDG. 1 FOR PRIMARY CARE

Location
**2101 ELM STREET
 FARGO, ND 58102**

Date
11/16/2021

Checked
RD

Drawn
JS

Project Number
437-315

Building Number
1

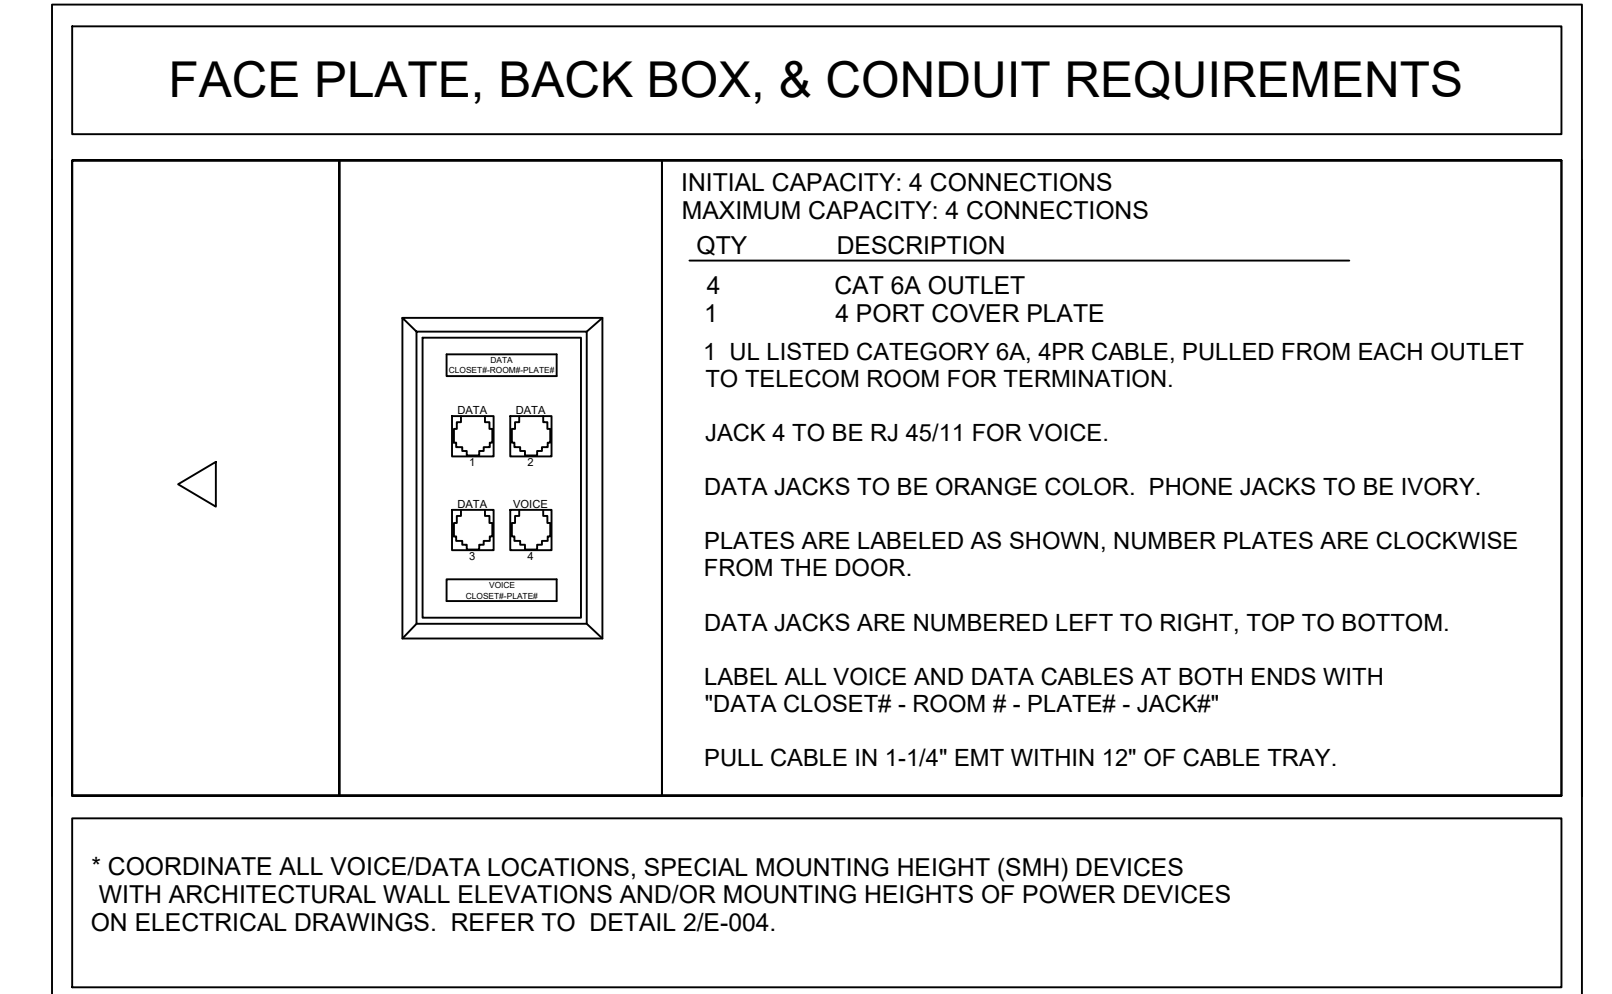
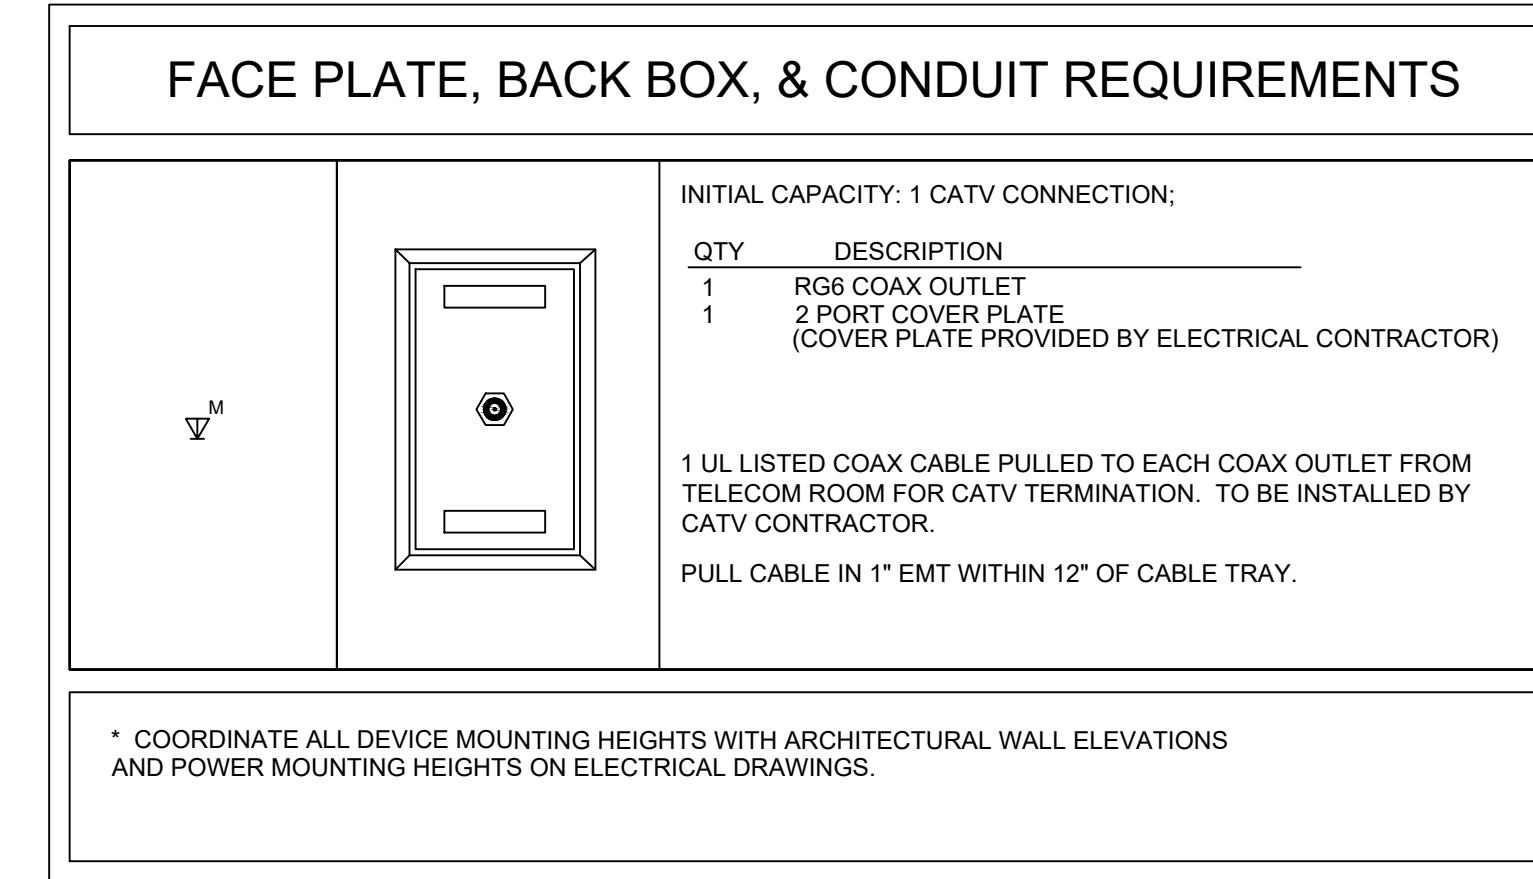
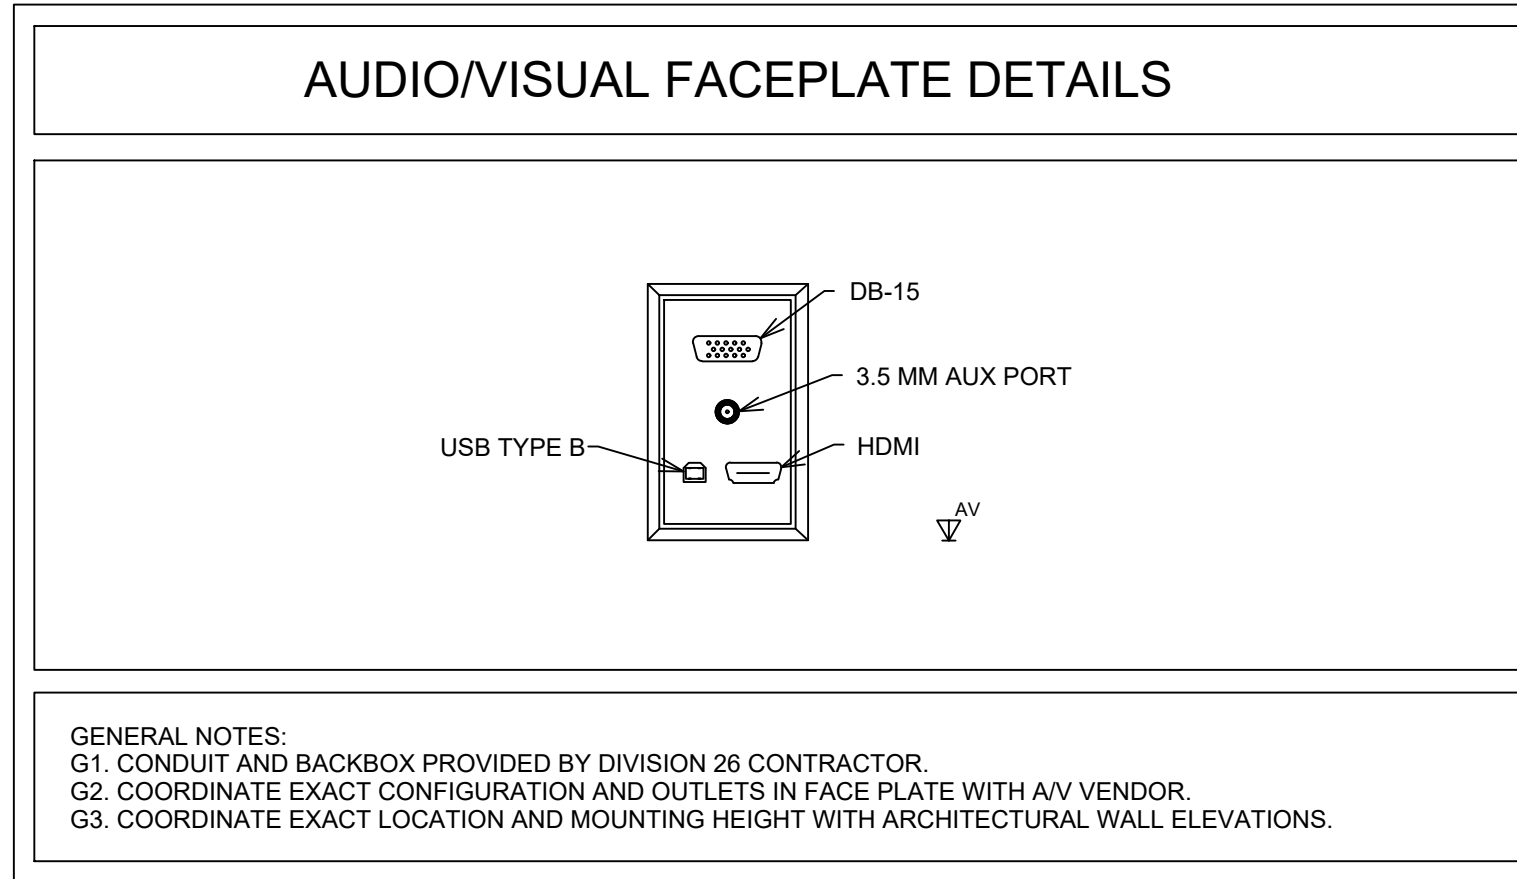
Drawing Number
E-004

Dwg. 95 of 128

Office of Construction and Facilities Management

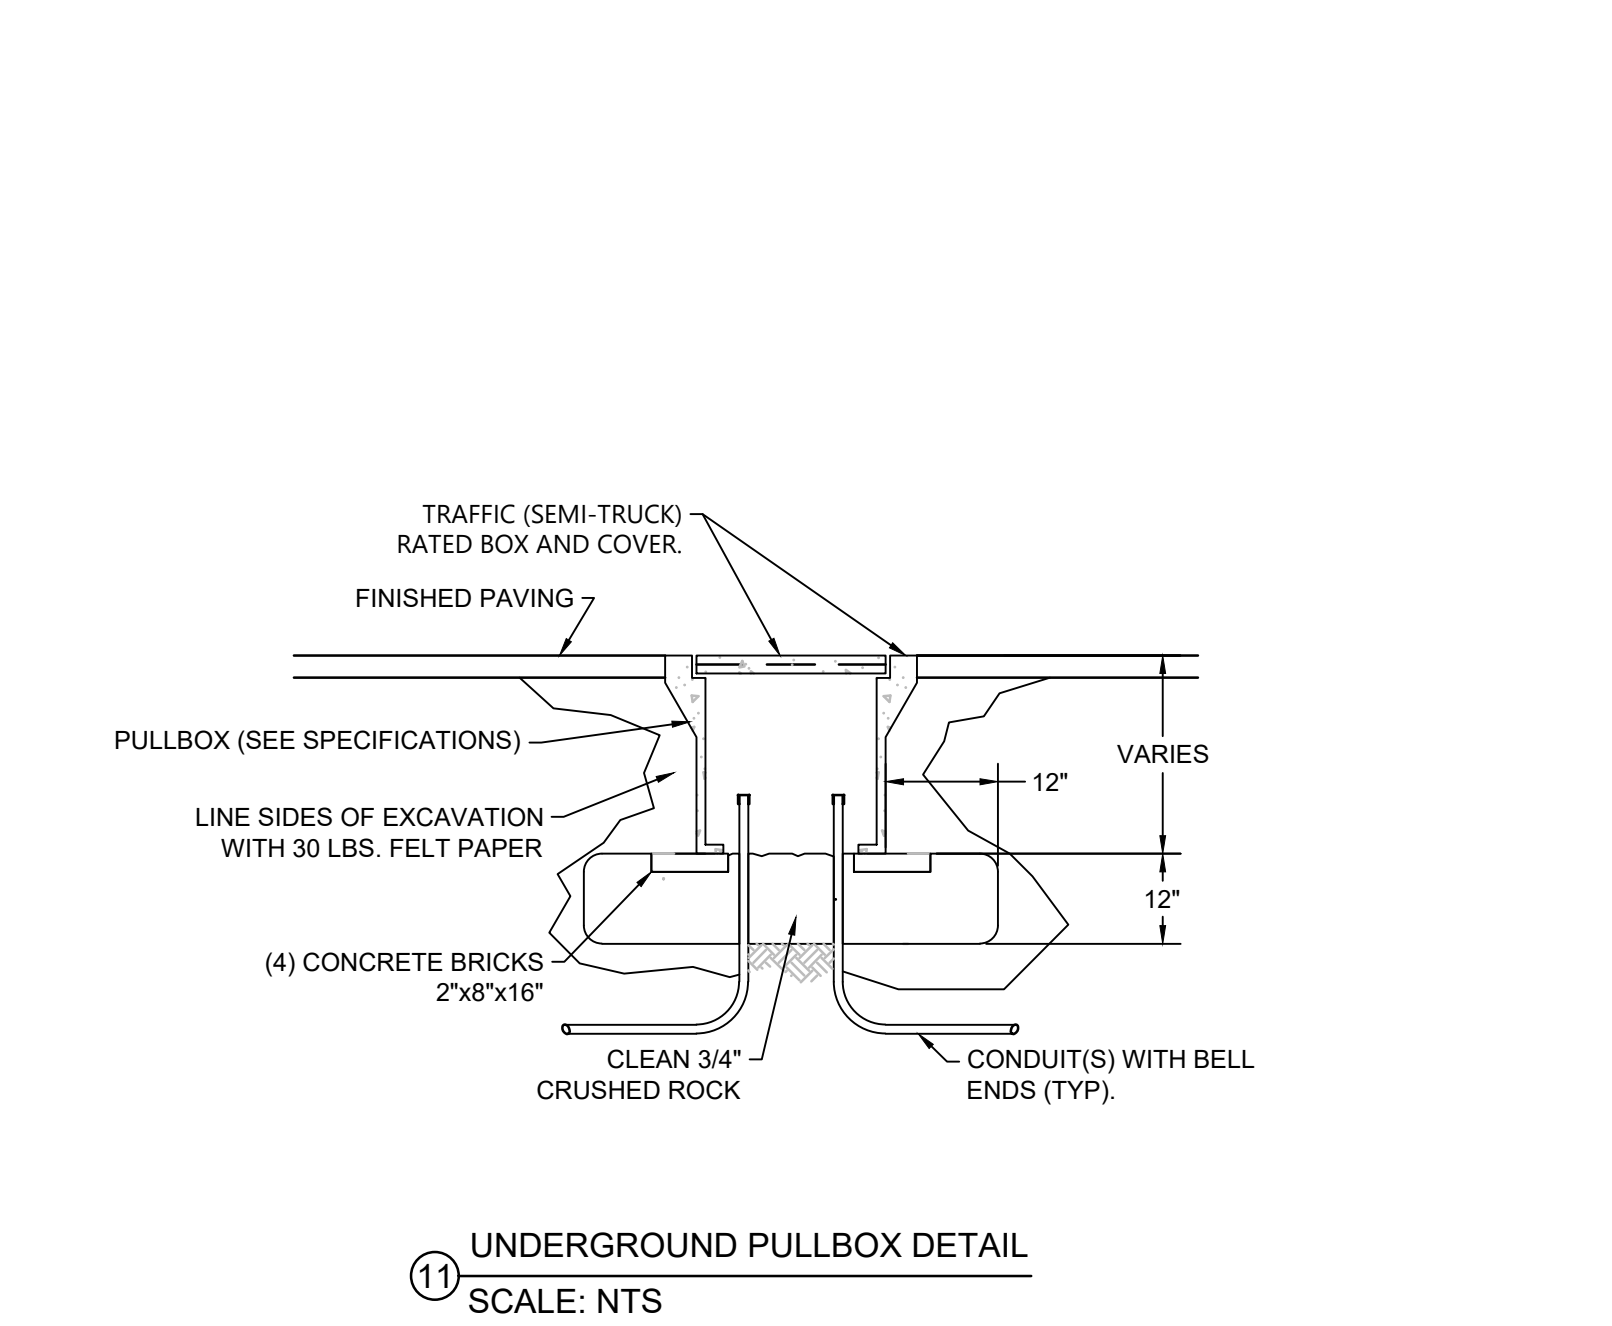
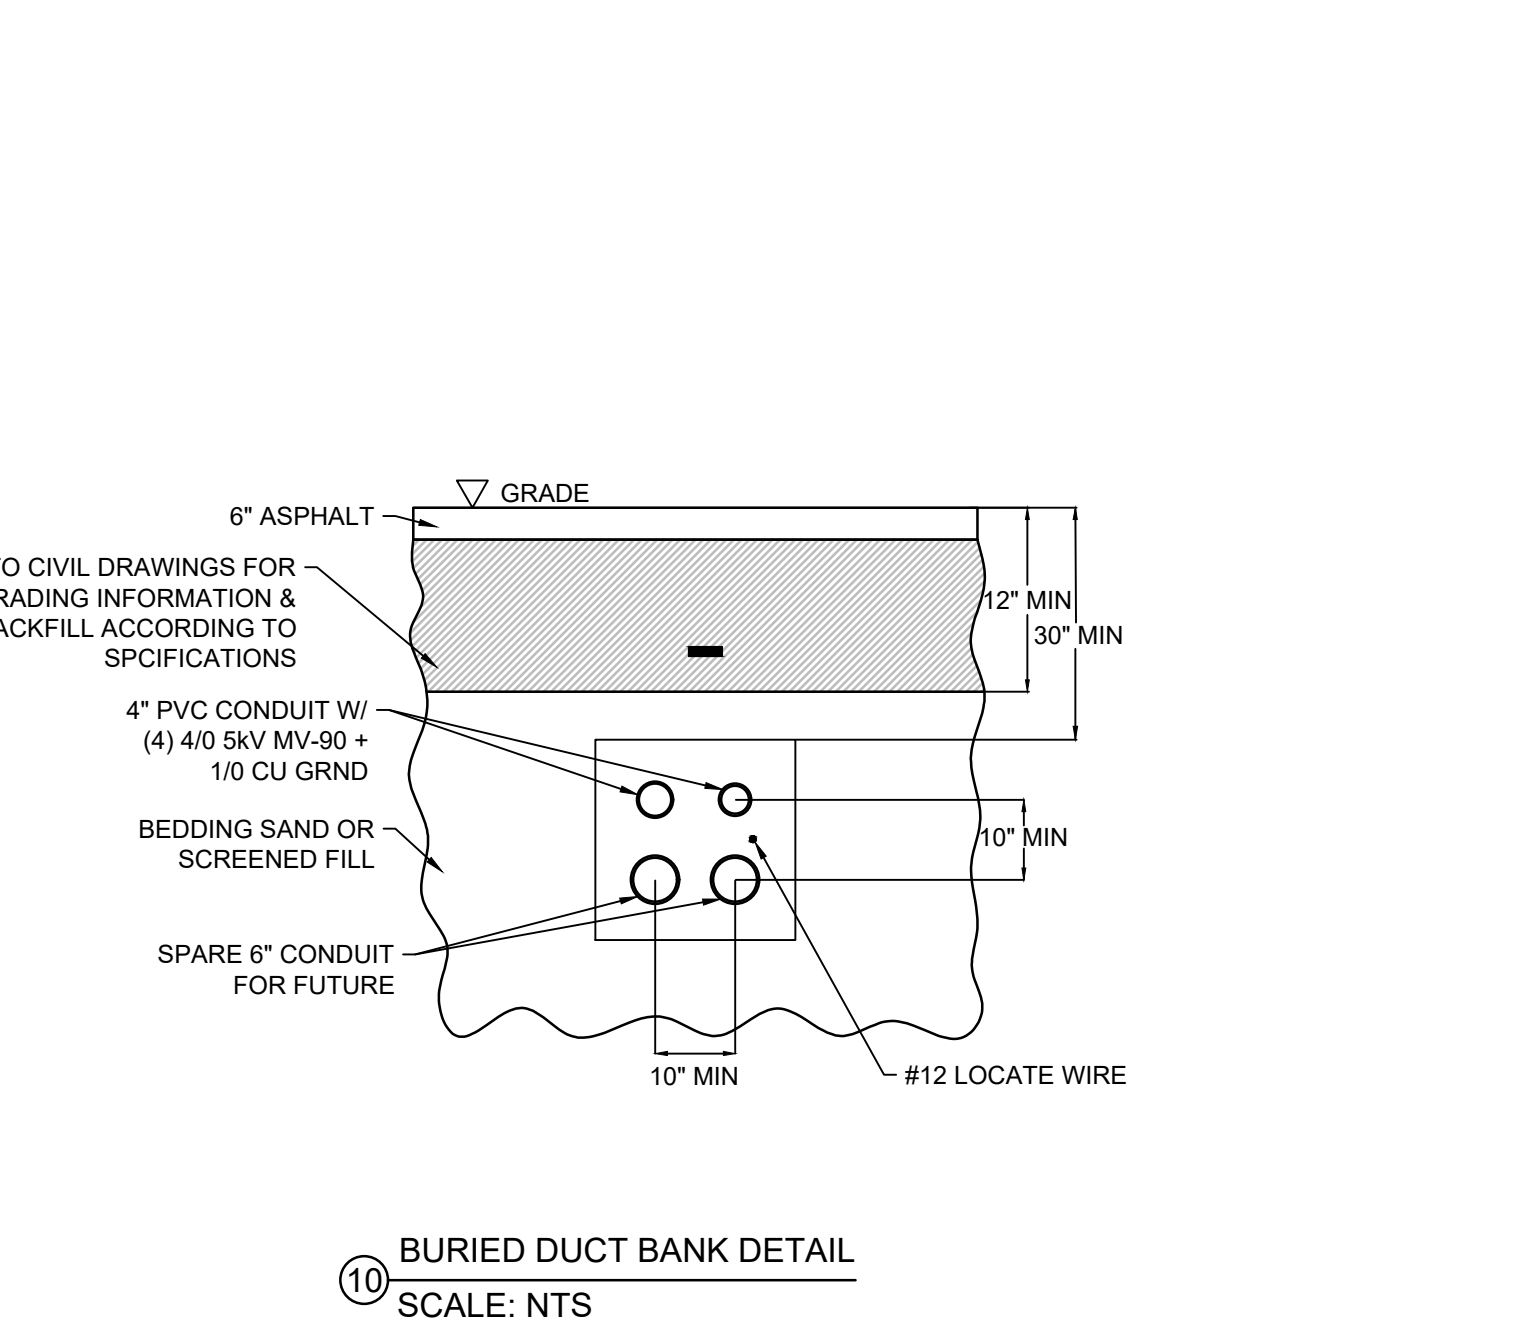
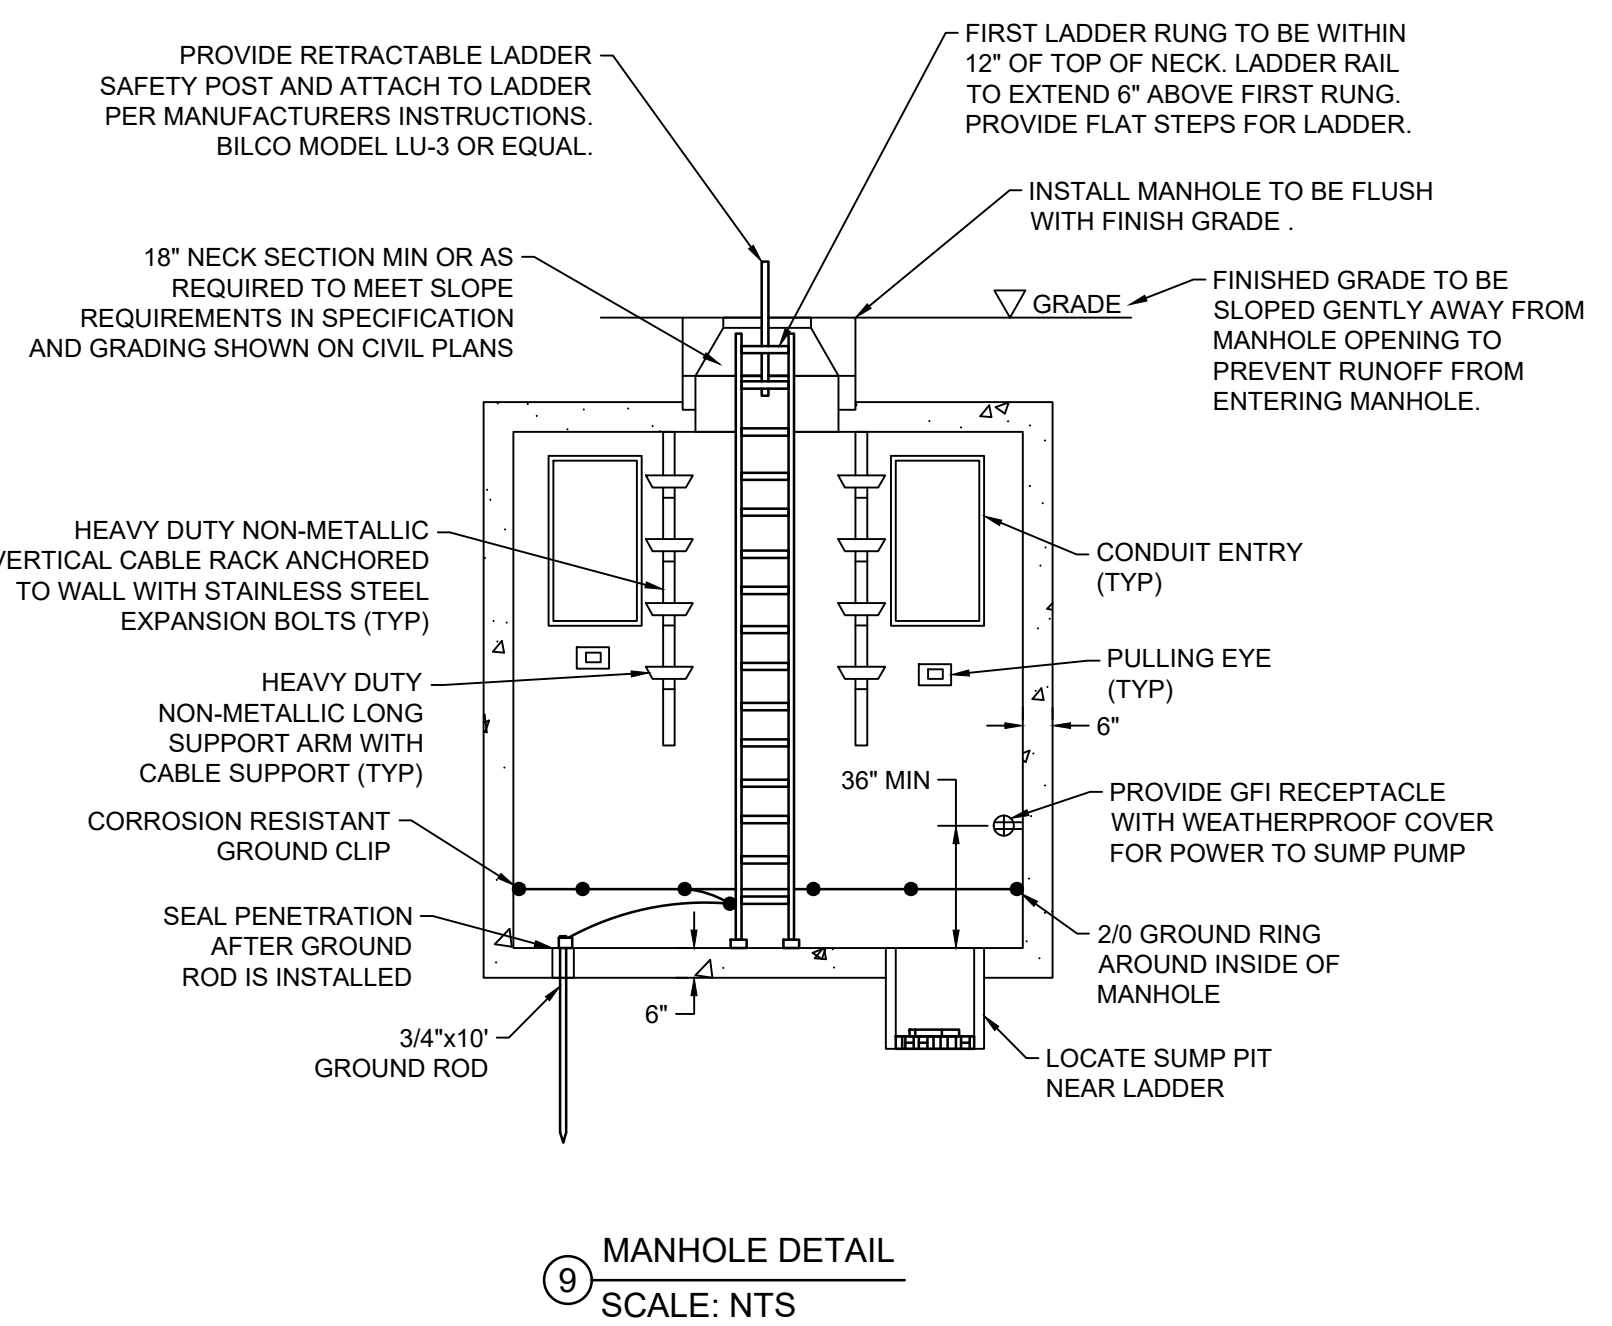
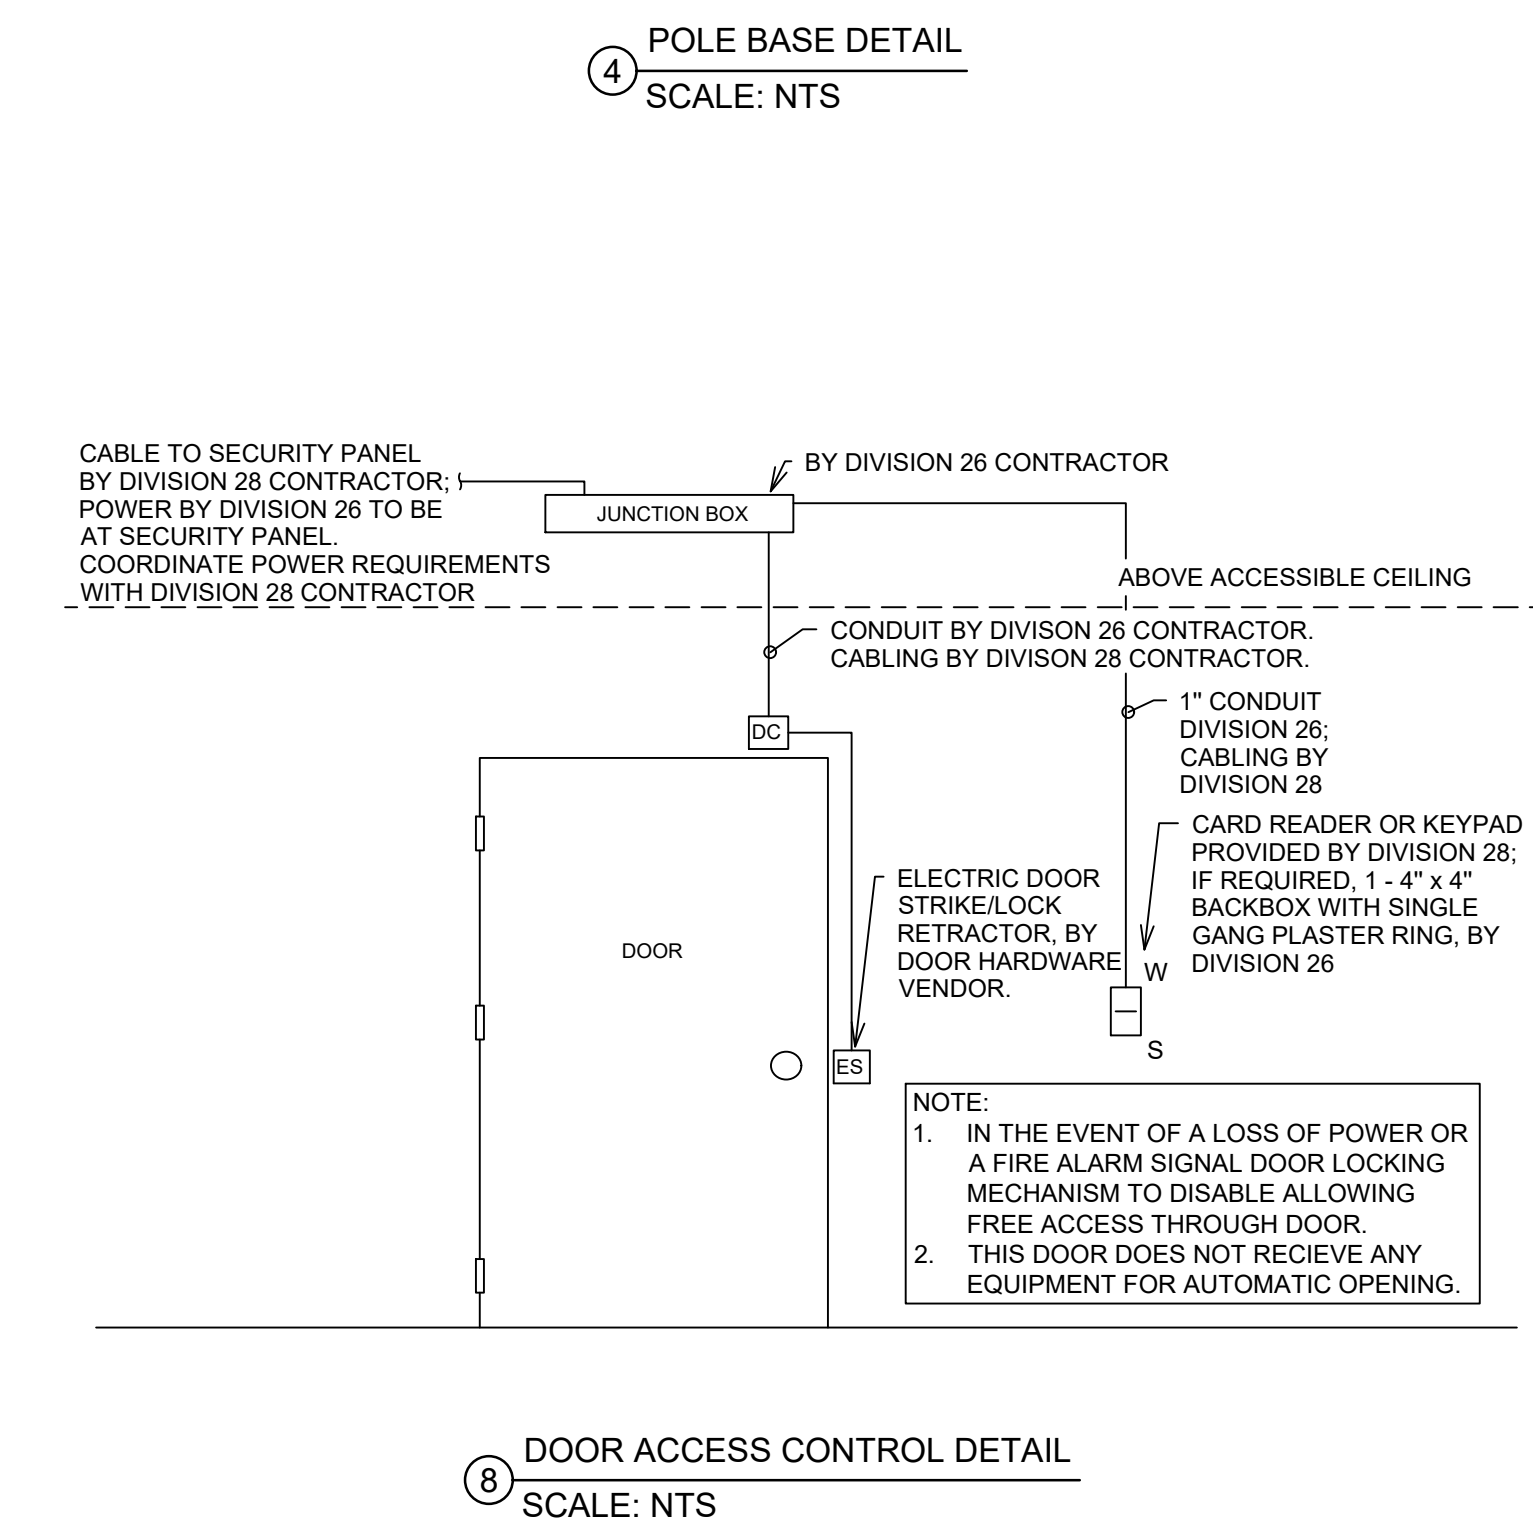
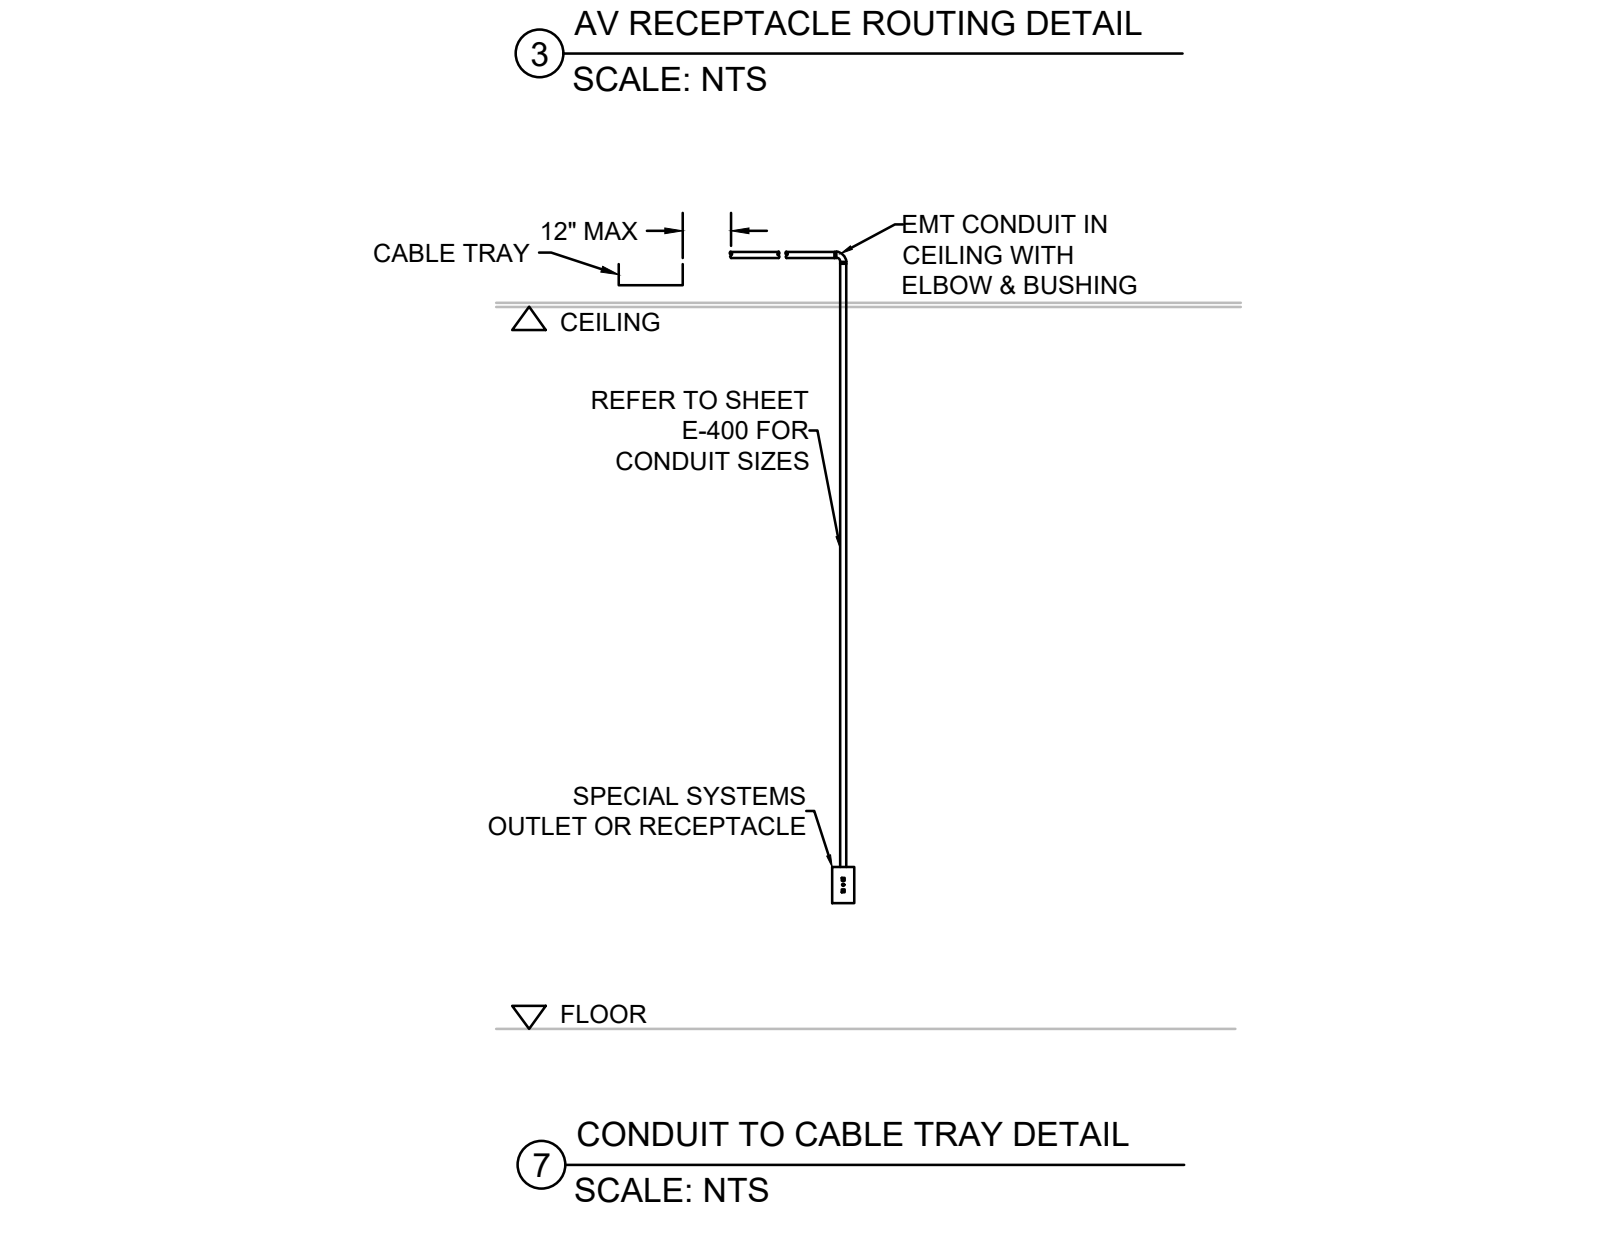
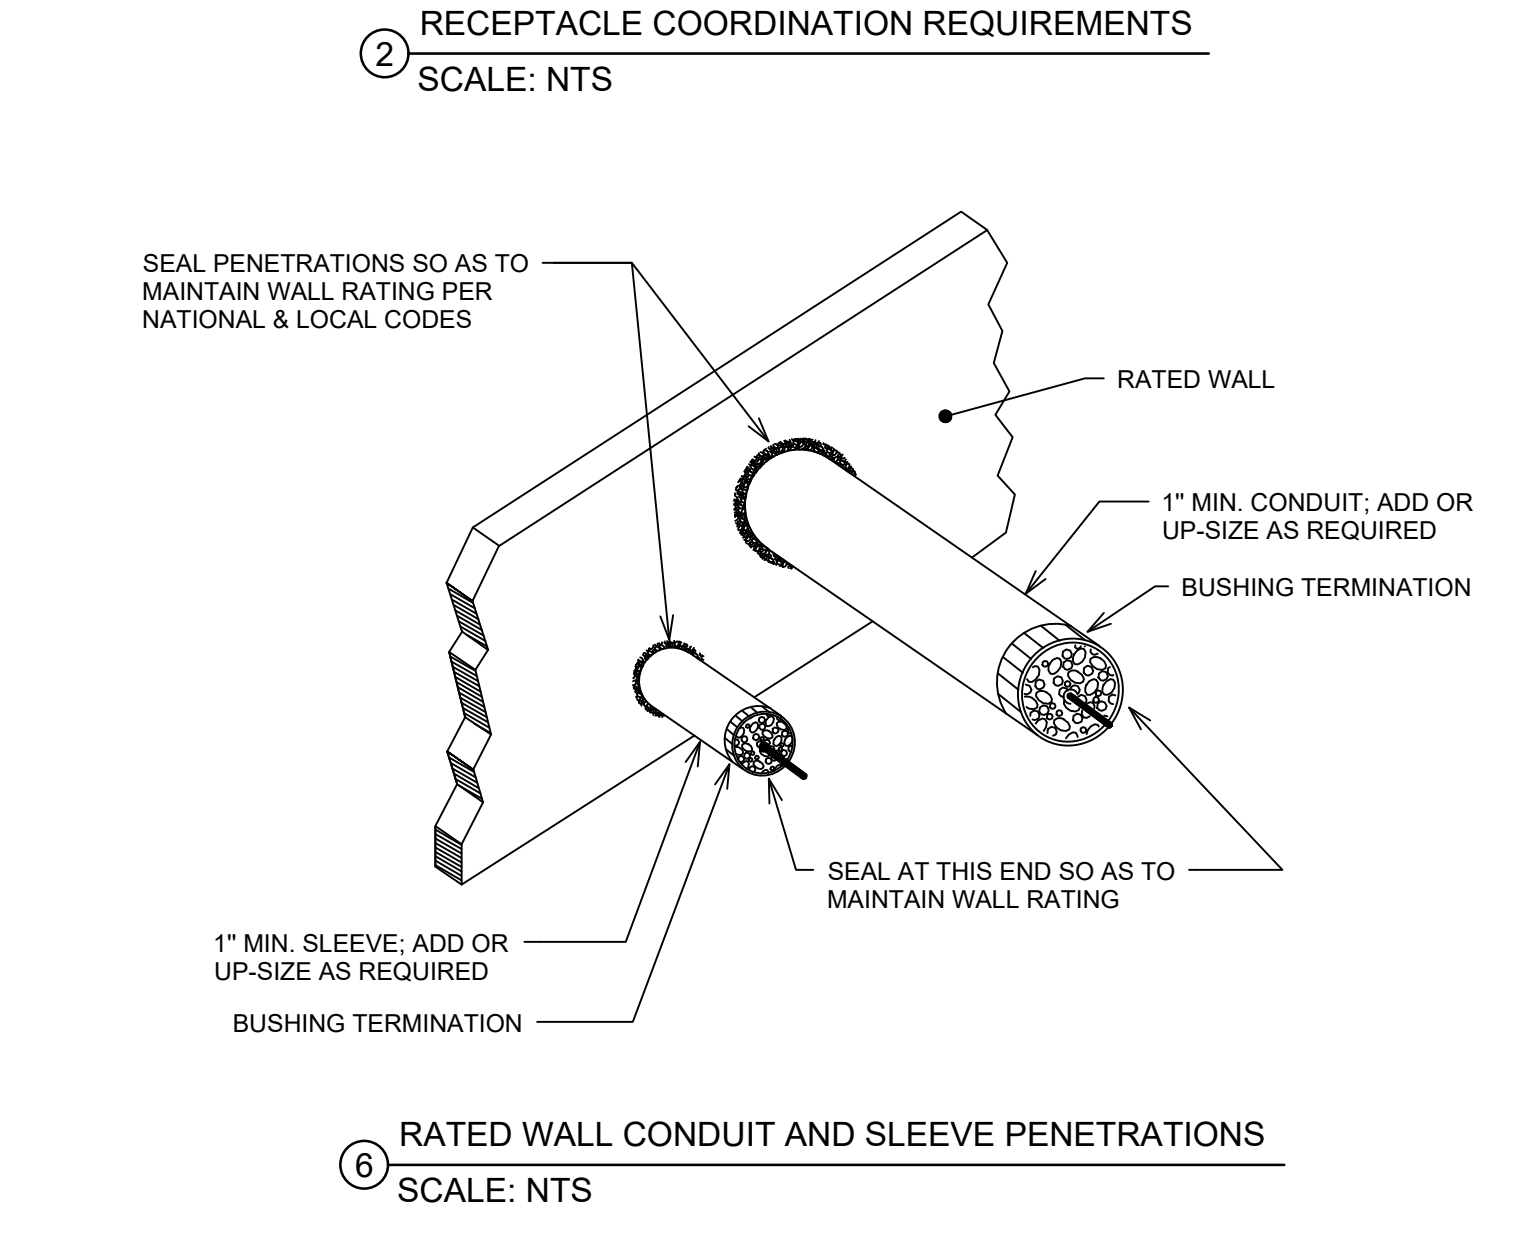
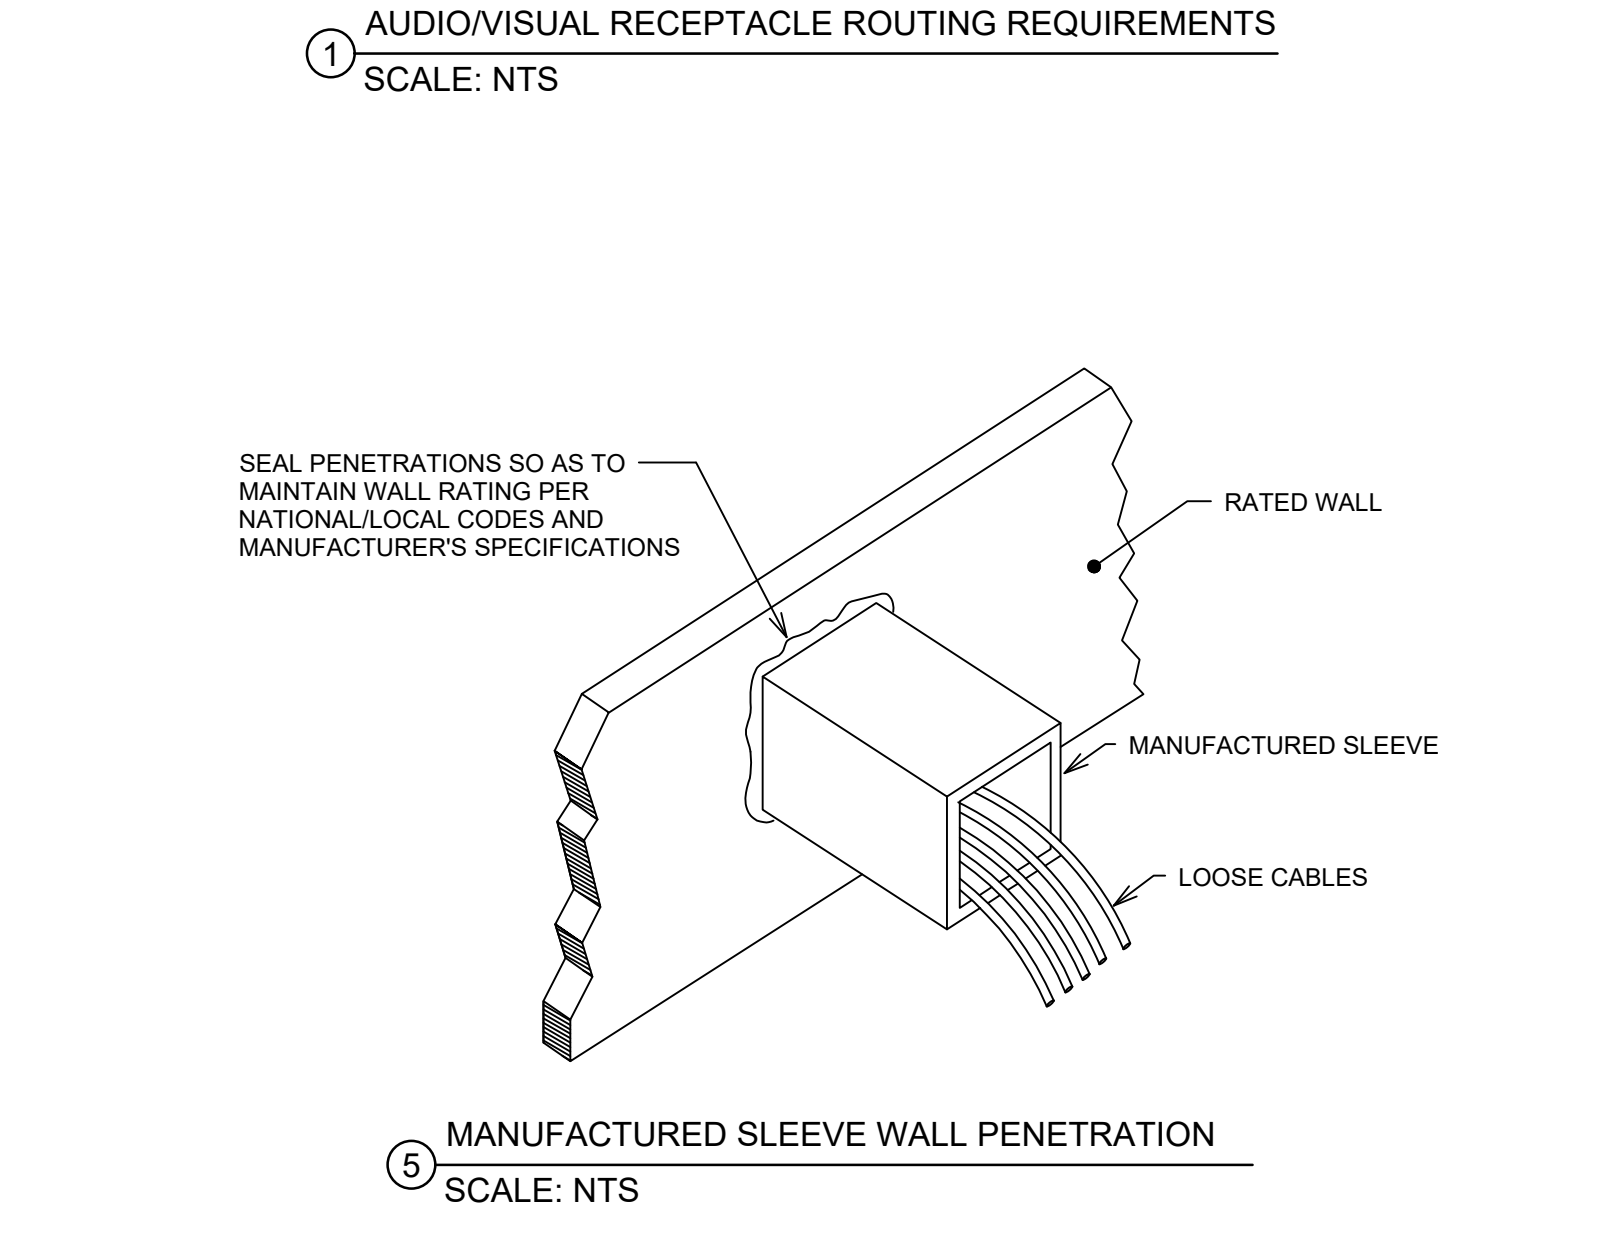
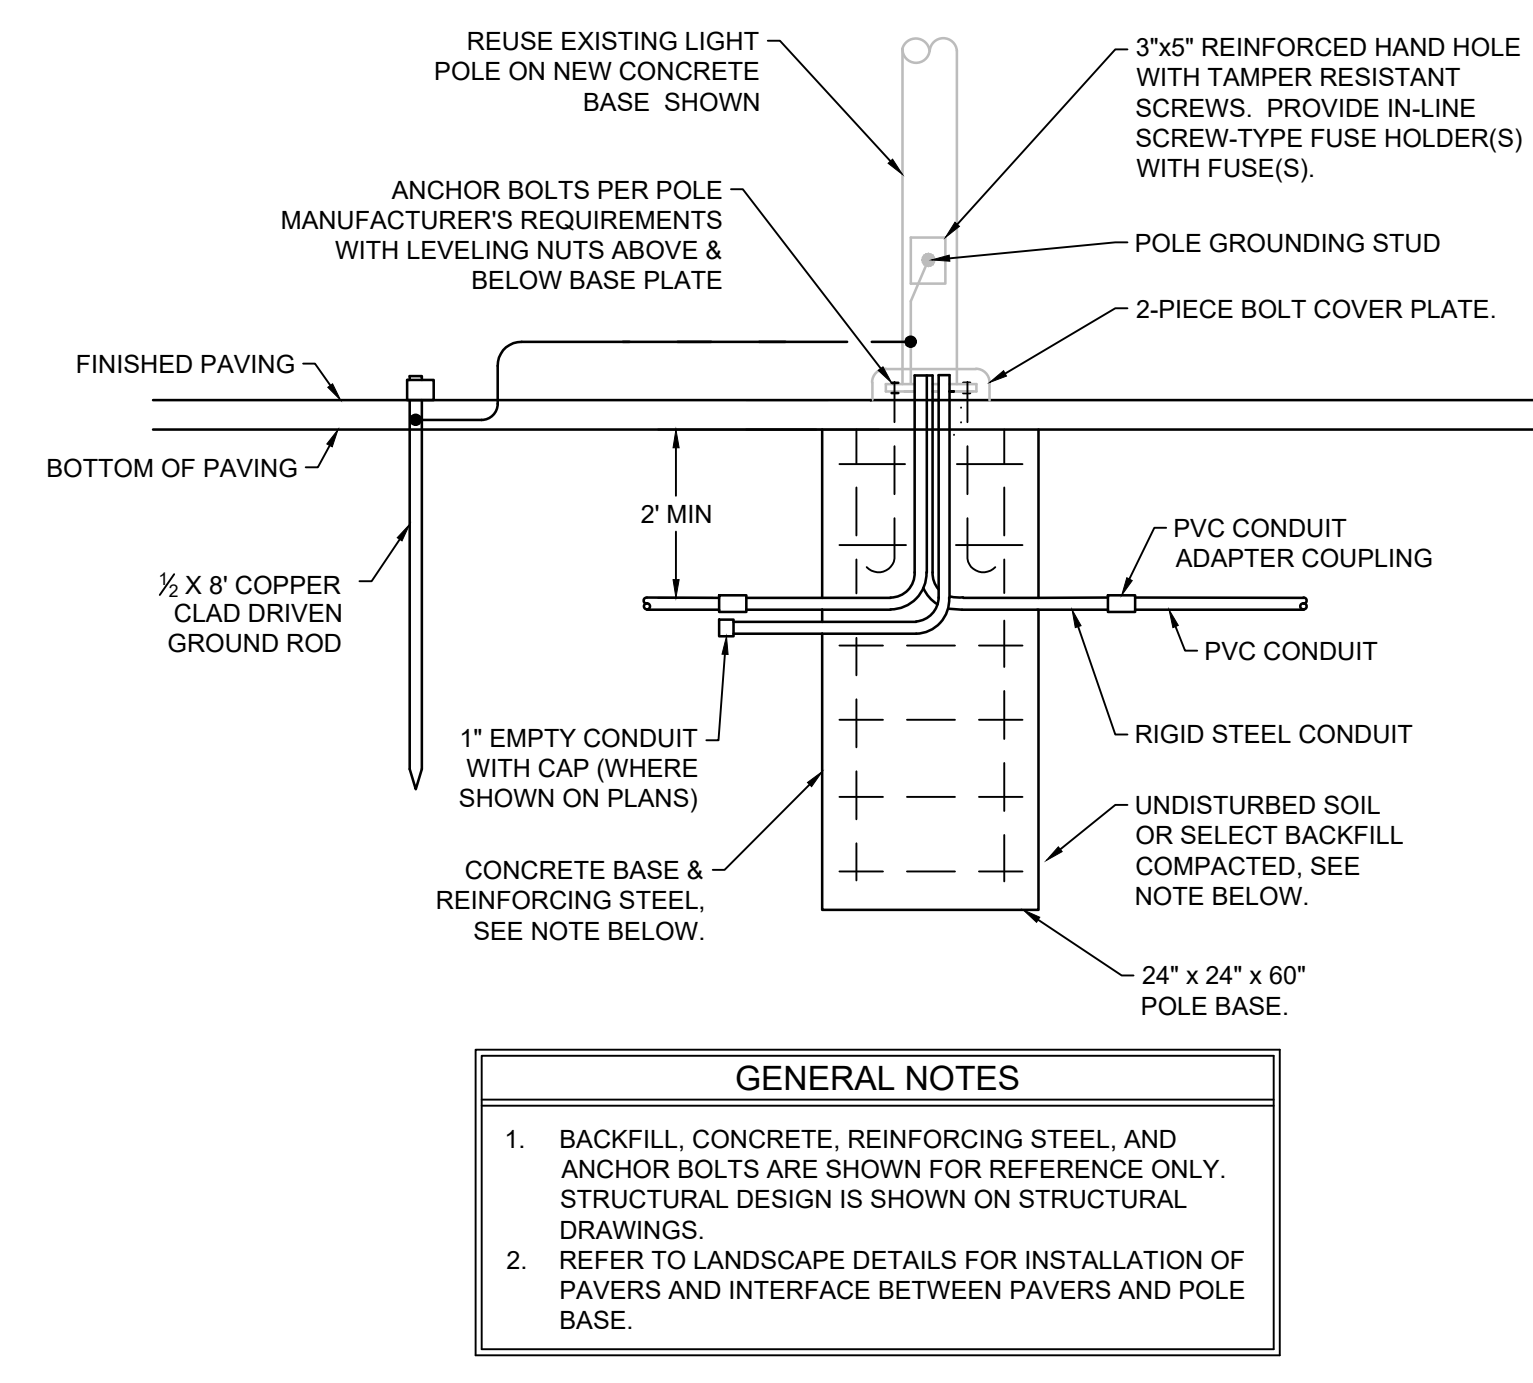
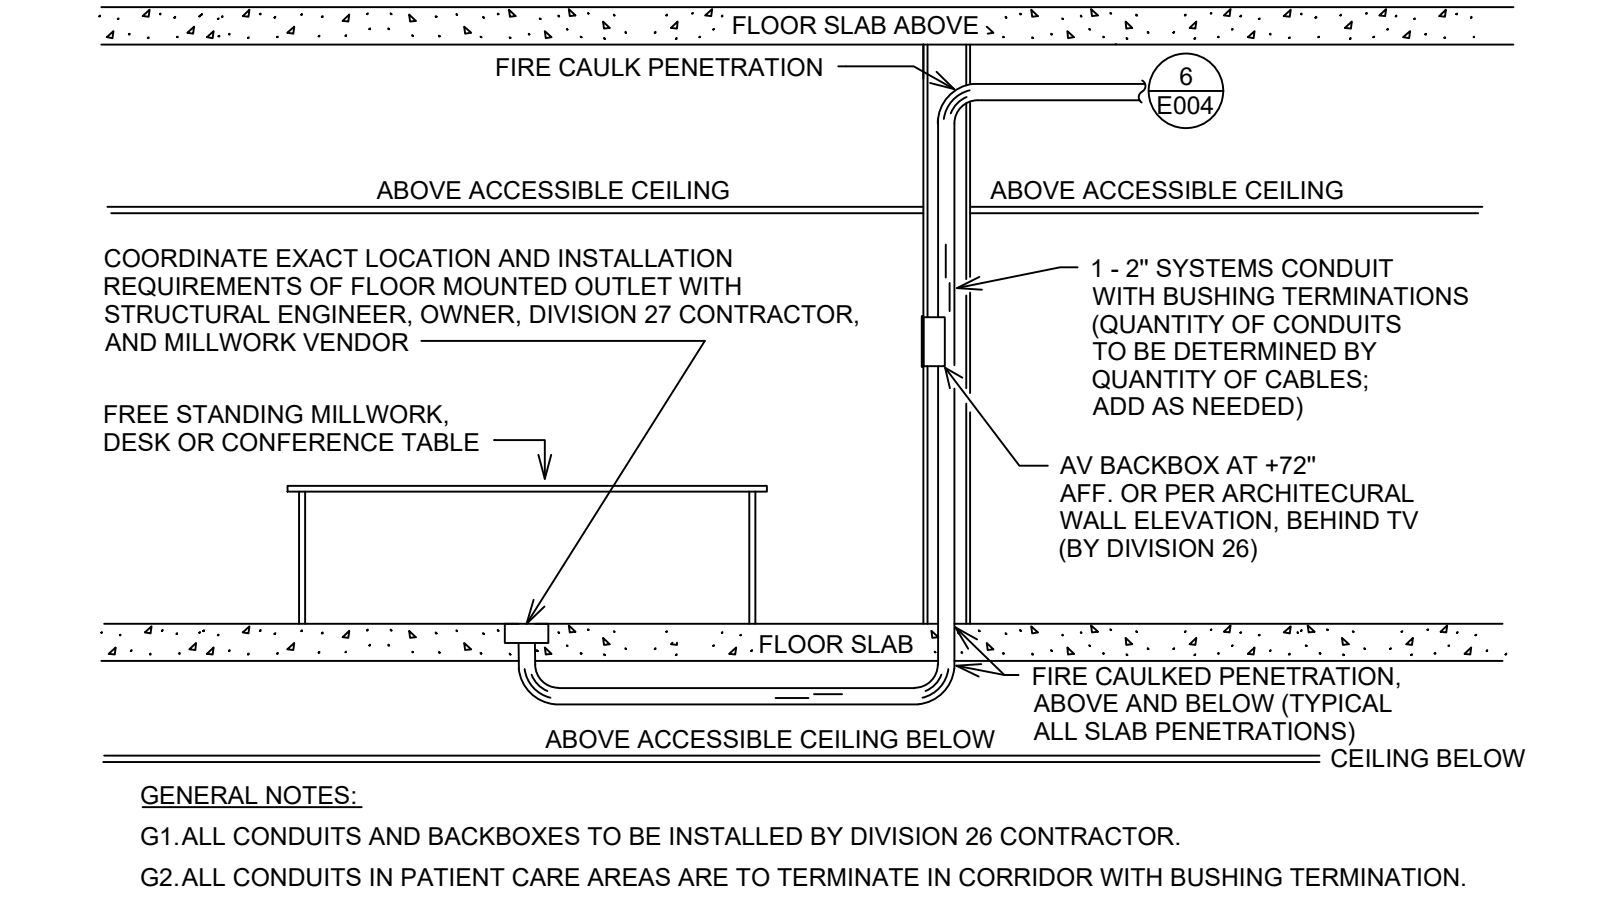
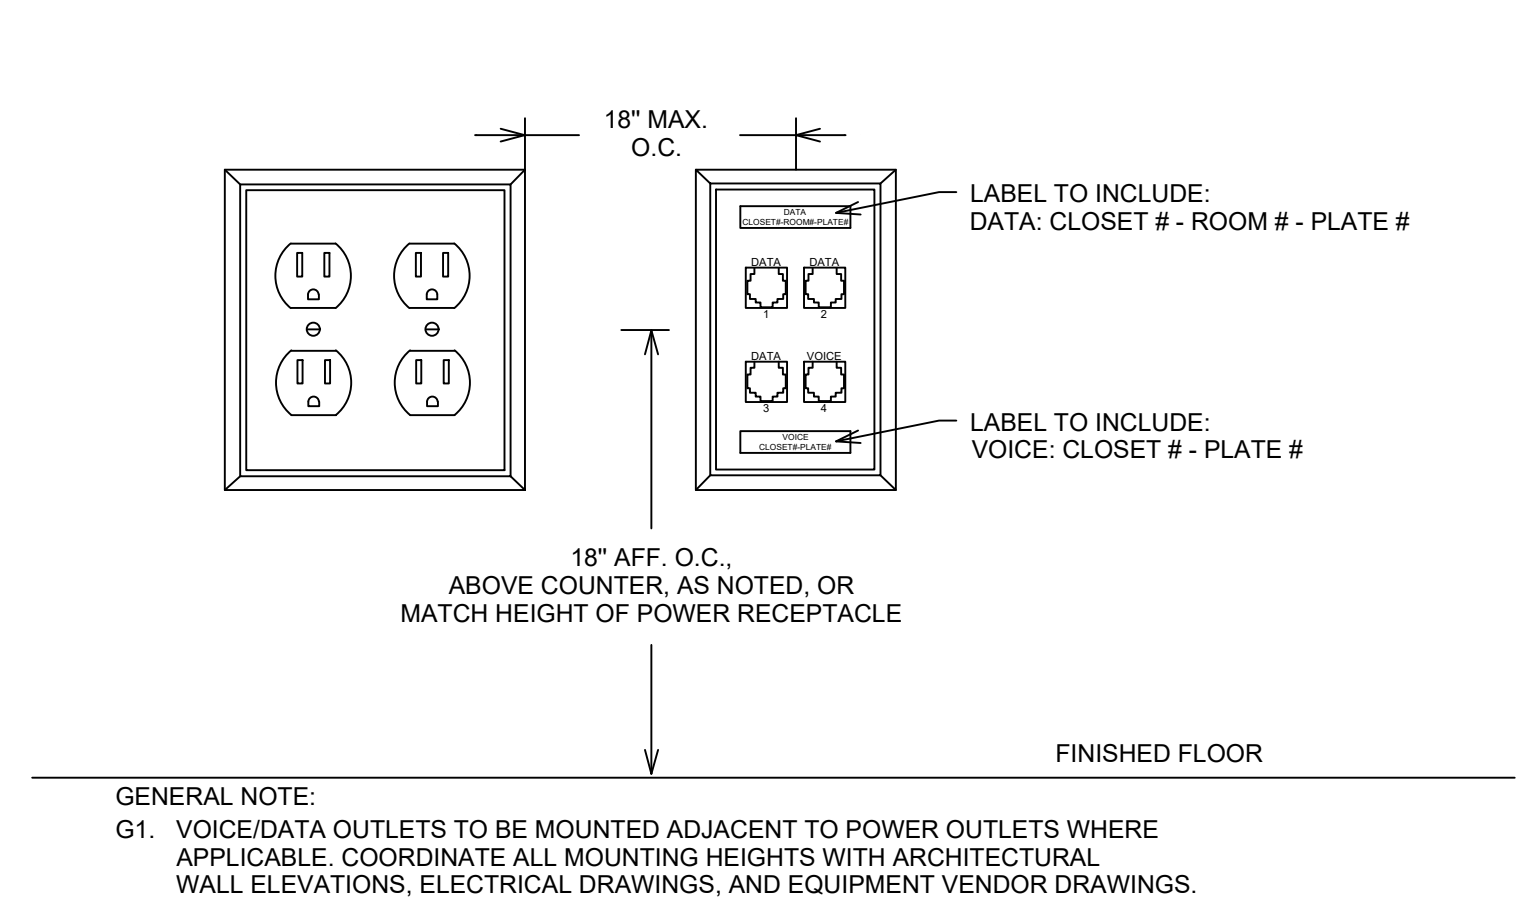
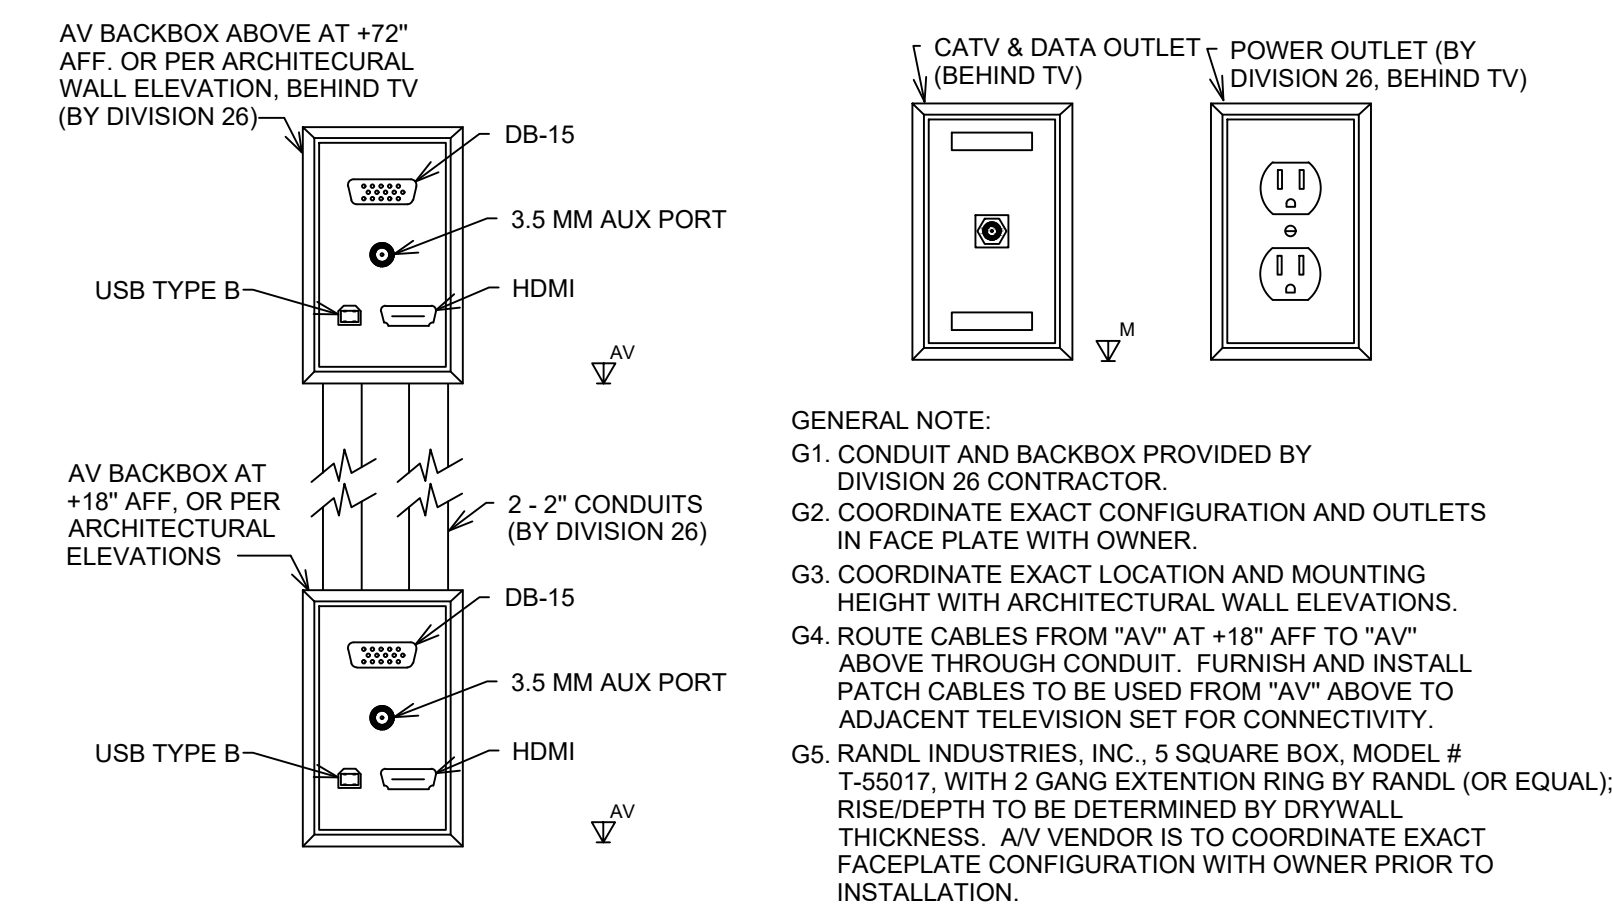
Department of Veterans Affairs

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CABLE JACKET COLOR LEGEND

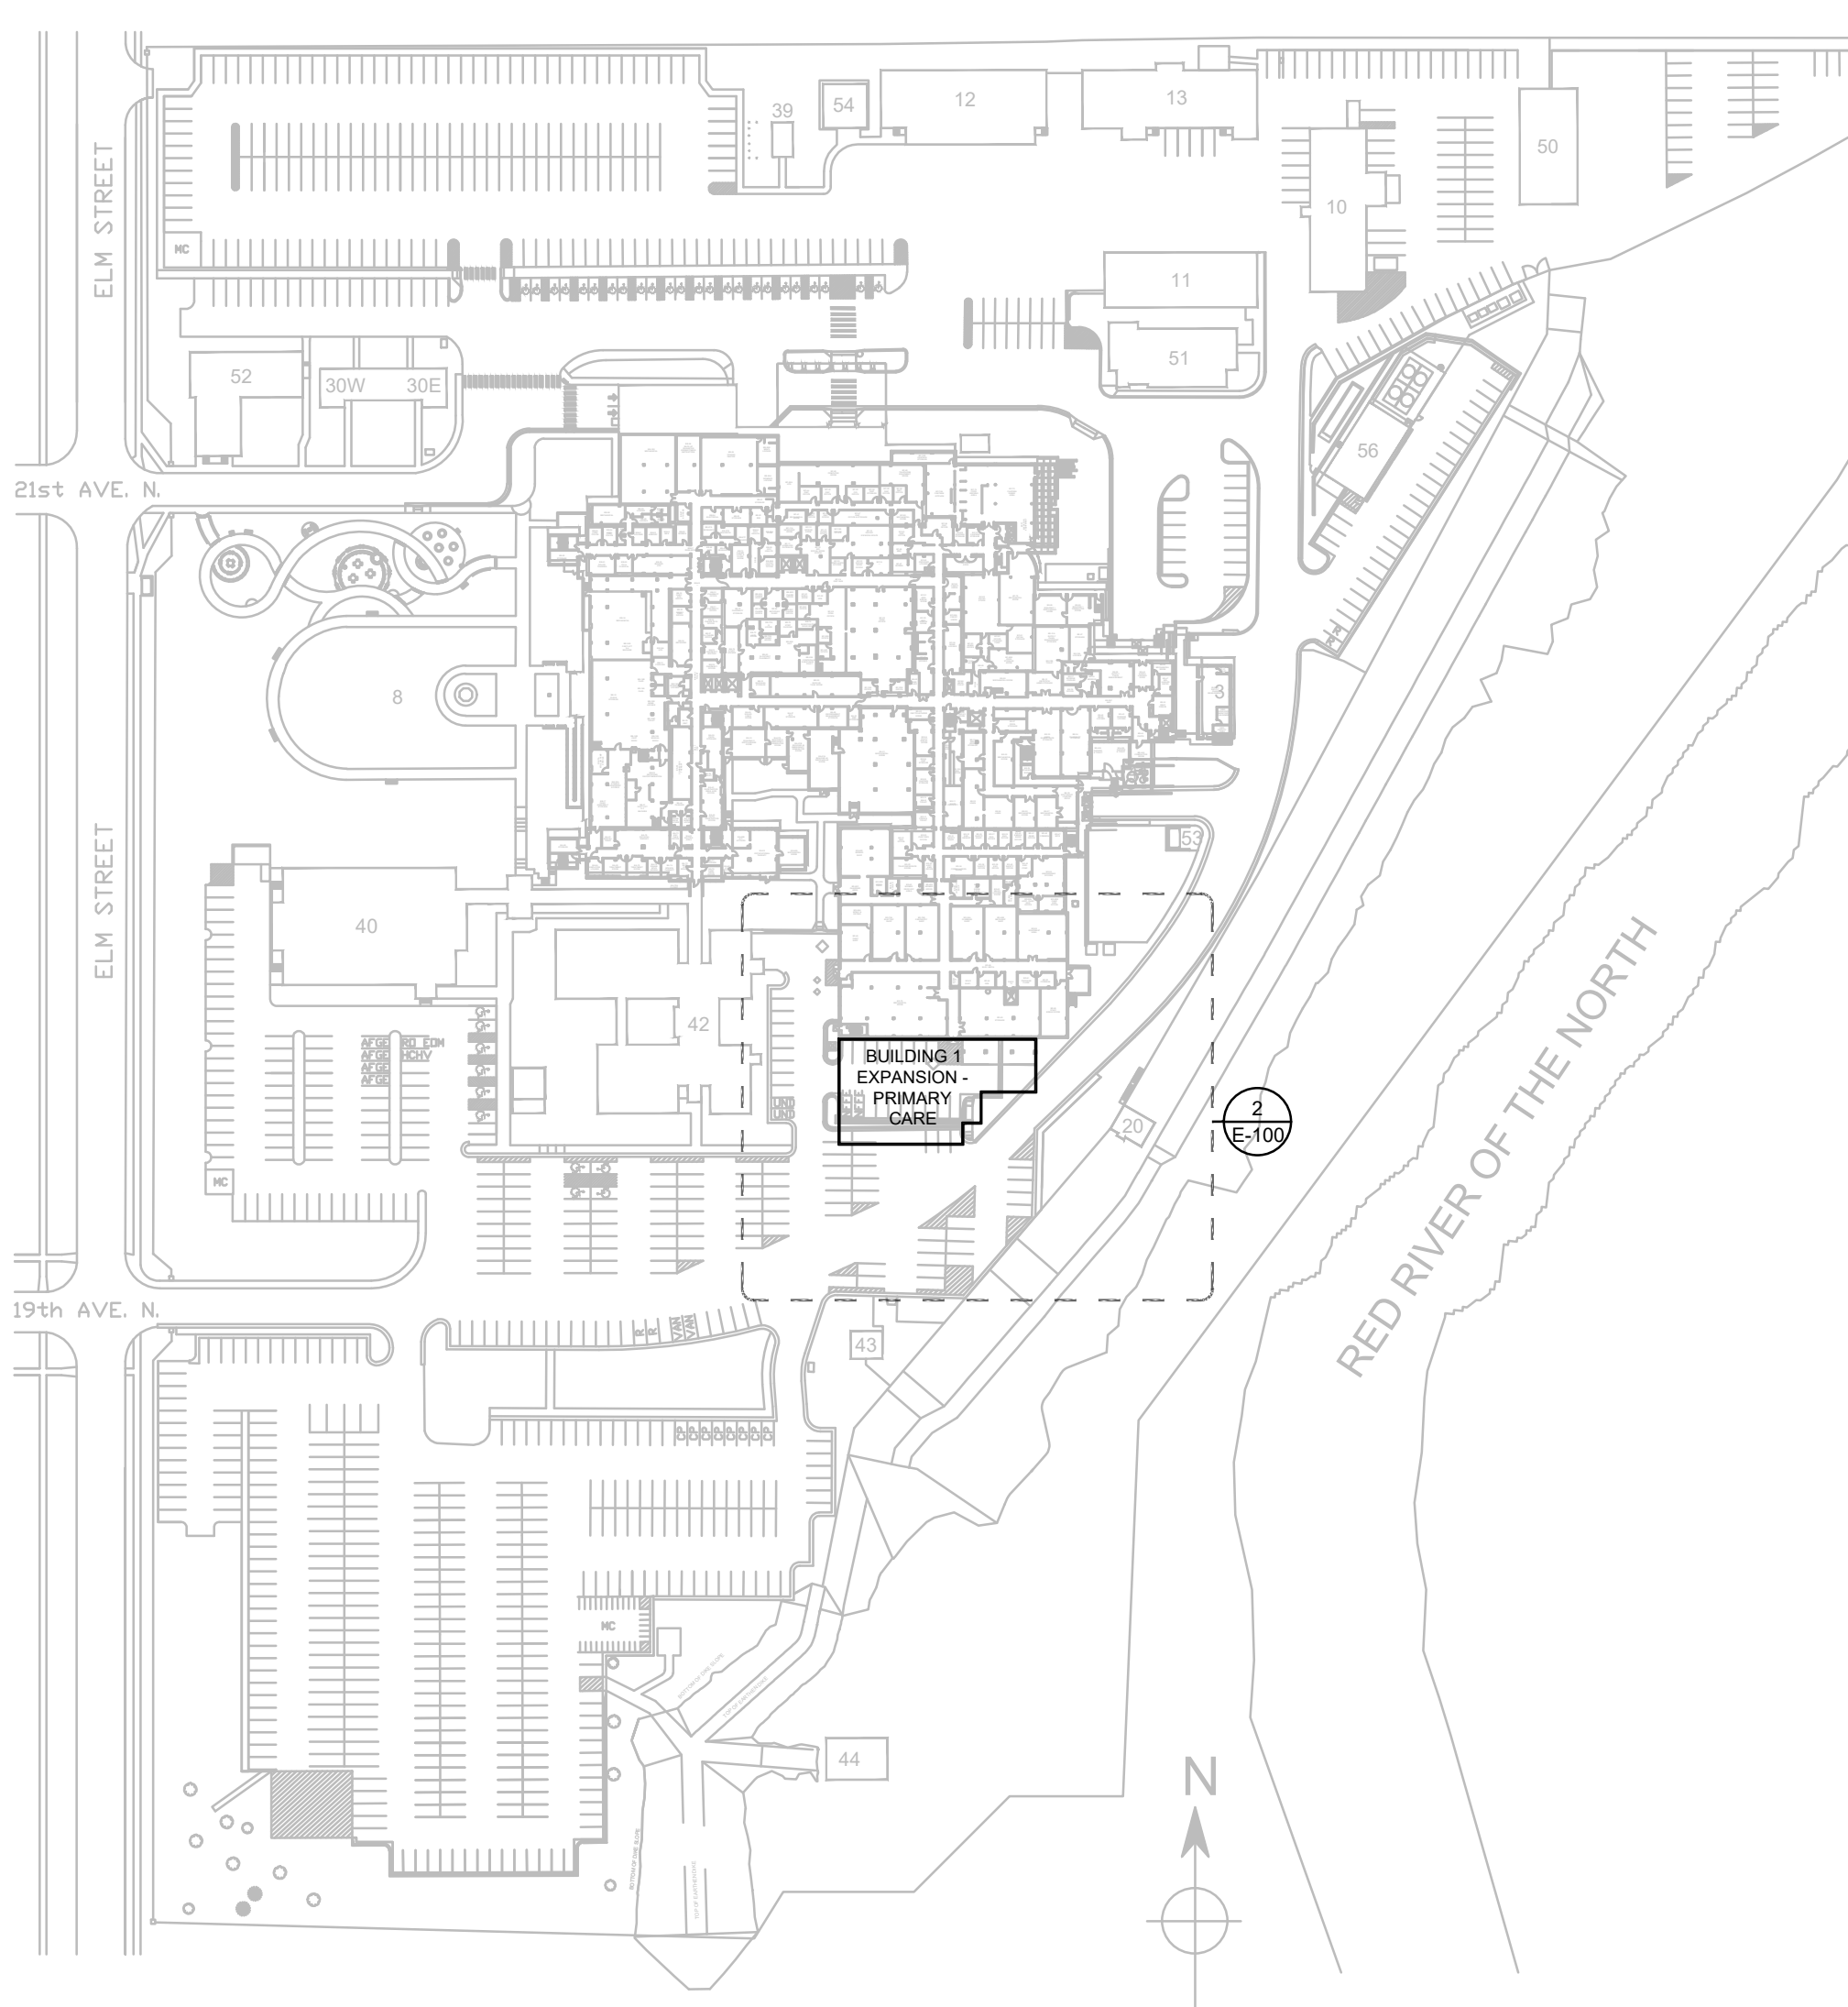
VOICE	- WHITE	VIDEO SURVEILLANCE	- VIOLET
DATA	- YELLOW	NURSE CALL	- BLUE
DATA	- GREEN	FIRE ALARM	- RED
DATA	- GREY	BAS & DAS	- BLACK
WIRELESS	- ORANGE		



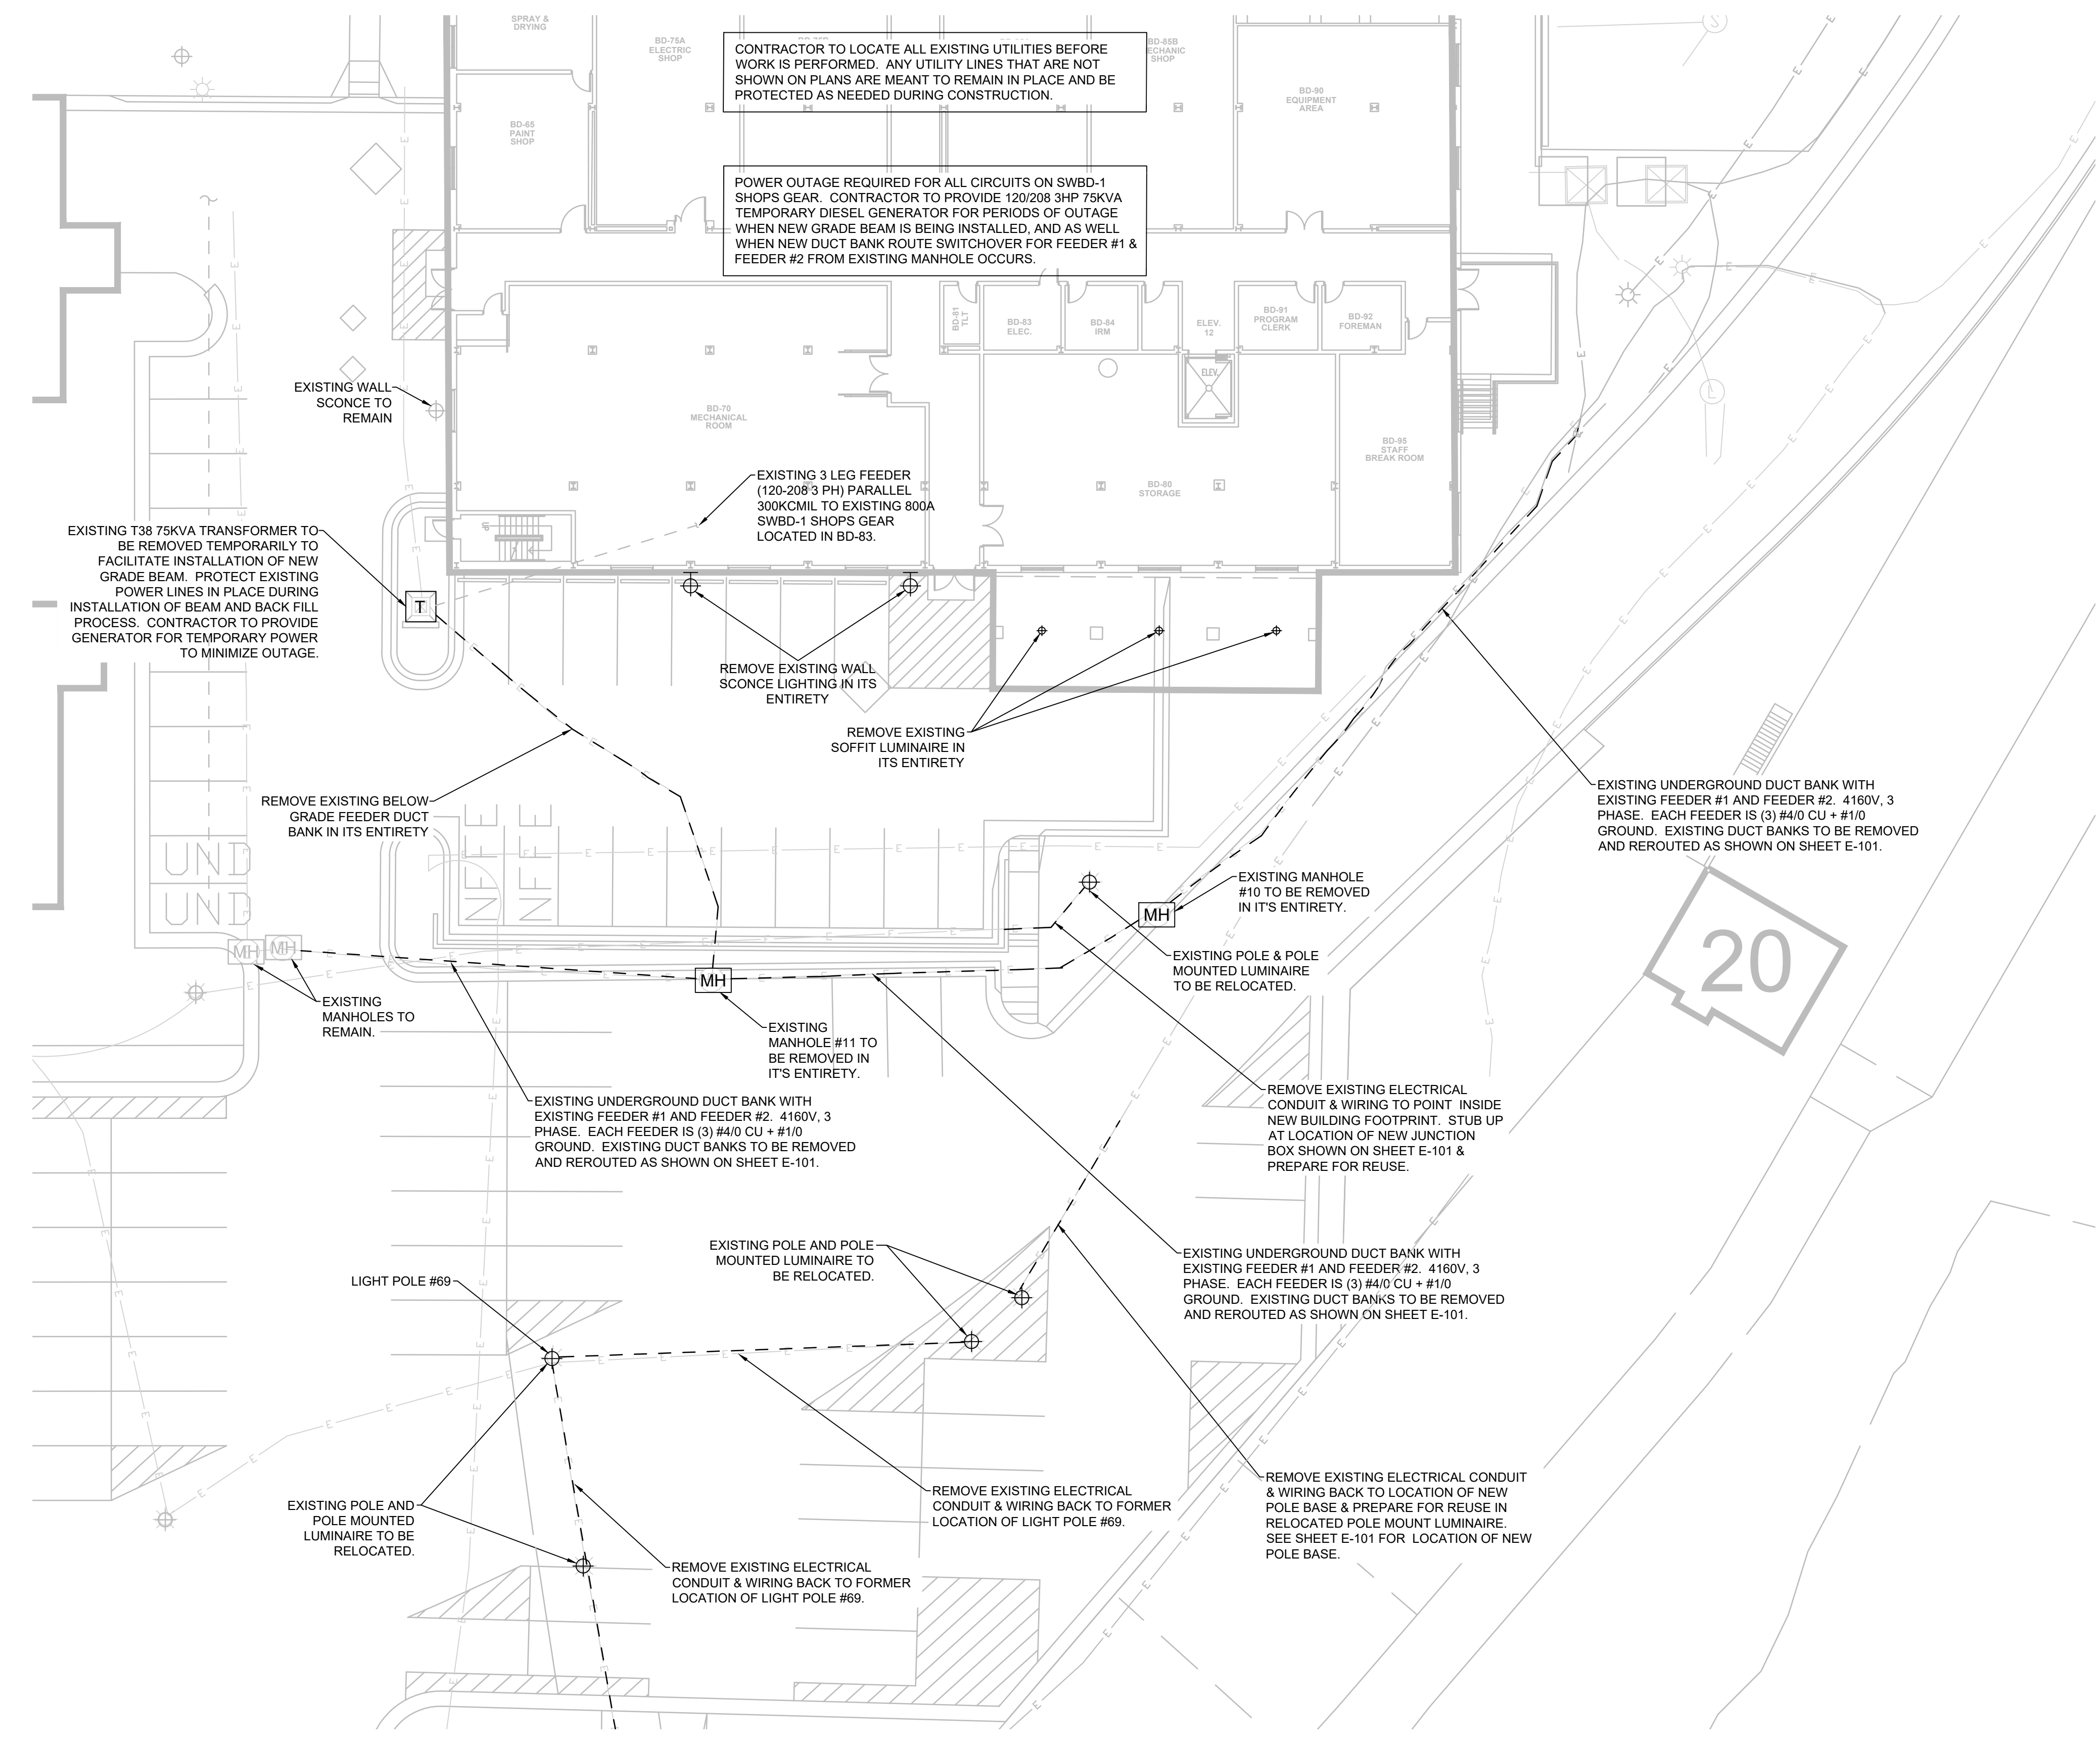
CONSTRUCTION DOCUMENTS

Revisions: _____ Date _____	CONSULTANTS: CALIBRE 9090 S RIDGELINE BLVD, SUITE 105 HIGHLANDS RANCH COLORADO 80129 PHONE (303) 730-0434 Albertson Engineering, Inc. ALBERTSON ENGINEERING, INC. 315 NORTH MAIN AVENUE, SUITE 200 SIOUX FALLS, SOUTH DAKOTA 57104 PH: (605) 274-0880 SUMMIT FIRE PROTECTION SUMMIT FIRE CONSULTING 575 MINNEHAHA AVE WEST ST. PAUL, MINNESOTA 55103 (612) 387-7050		ARCHITECT FOURFRONT DESIGN, INC. 517 7TH STREET RAPID CITY, SOUTH DAKOTA 57701 PH: (605) 342-9470 FAX: (605) 342-2377 WWW.FOURFRONTDESIGN.COM	Drawing Title SPECIAL SYSTEMS DETAILS Approved: Project Director FARGO VAHCS	Project Title EXPAND BLDG. 1 FOR PRIMARY CARE Location 2101 ELM STREET FARGO, ND 58102 Date 11/16/2021	Project Number 437-315 Building Number 1 Drawing Number E-005 Dwg. 96 of 128	Office of Construction and Facilities Management Department of Veterans Affairs
	VA FORM 08-6231						

12/22/2009 10:11:20 AM
 one eighth inch = one foot
 one quarter inch = one foot
 three eighths inch = one foot
 one half inch = one foot
 three quarters inch = one foot
 one inch = one foot
 one and one half inches = one foot
 two inches = one foot
 three inches = one foot
 four inches = one foot
 five inches = one foot
 six inches = one foot
 seven inches = one foot
 eight inches = one foot
 nine inches = one foot
 ten inches = one foot
 eleven inches = one foot
 twelve inches = one foot



1 OVERALL SITE PLAN
 SCALE: 1/128" = 1'



2 EXPANDED SITE POWER DEMOLITION PLAN
 SCALE: 1/16" = 1'

CONSTRUCTION DOCUMENTS

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Drawing Title
ELECTRICAL SITE DEMOLITION PLAN

Approved: Project Director
FARGO VAHCS

Project Title
EXPAND BLDG. 1 FOR PRIMARY CARE

Location
**2101 ELM STREET
 FARGO, ND 58102**

Date
11/16/2021

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Project Number
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Building Number
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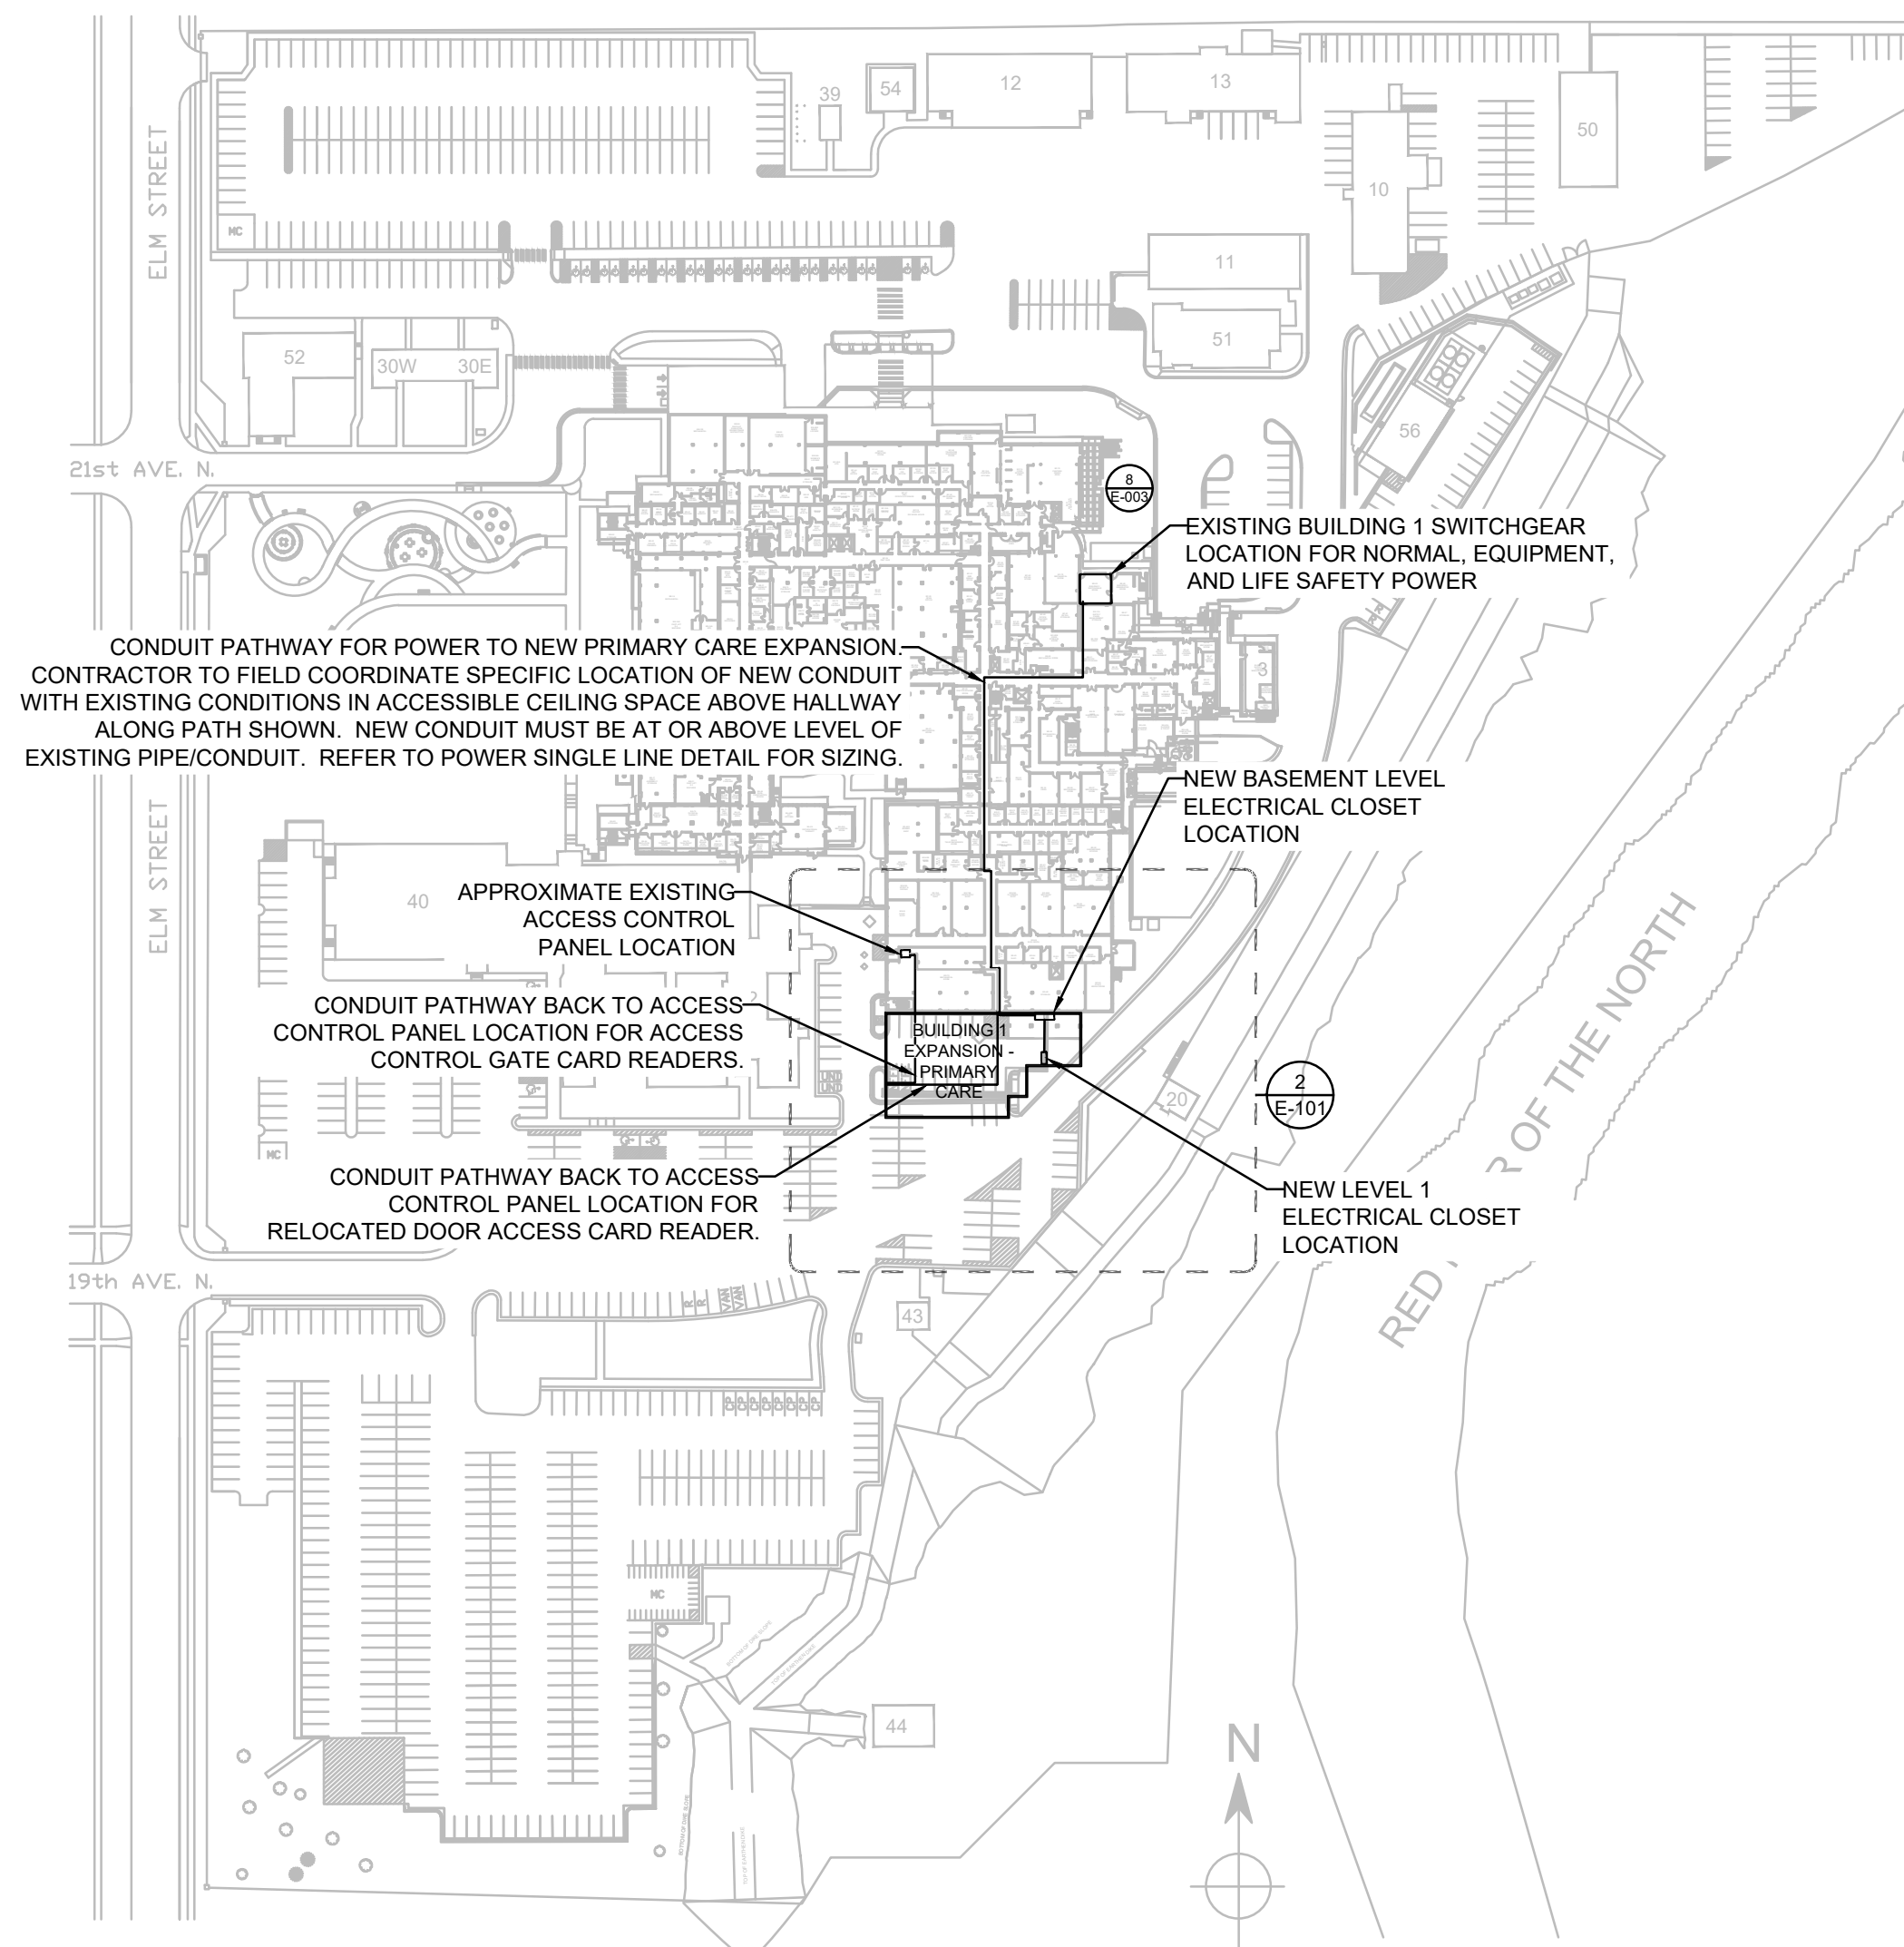
Drawing Number
E-100

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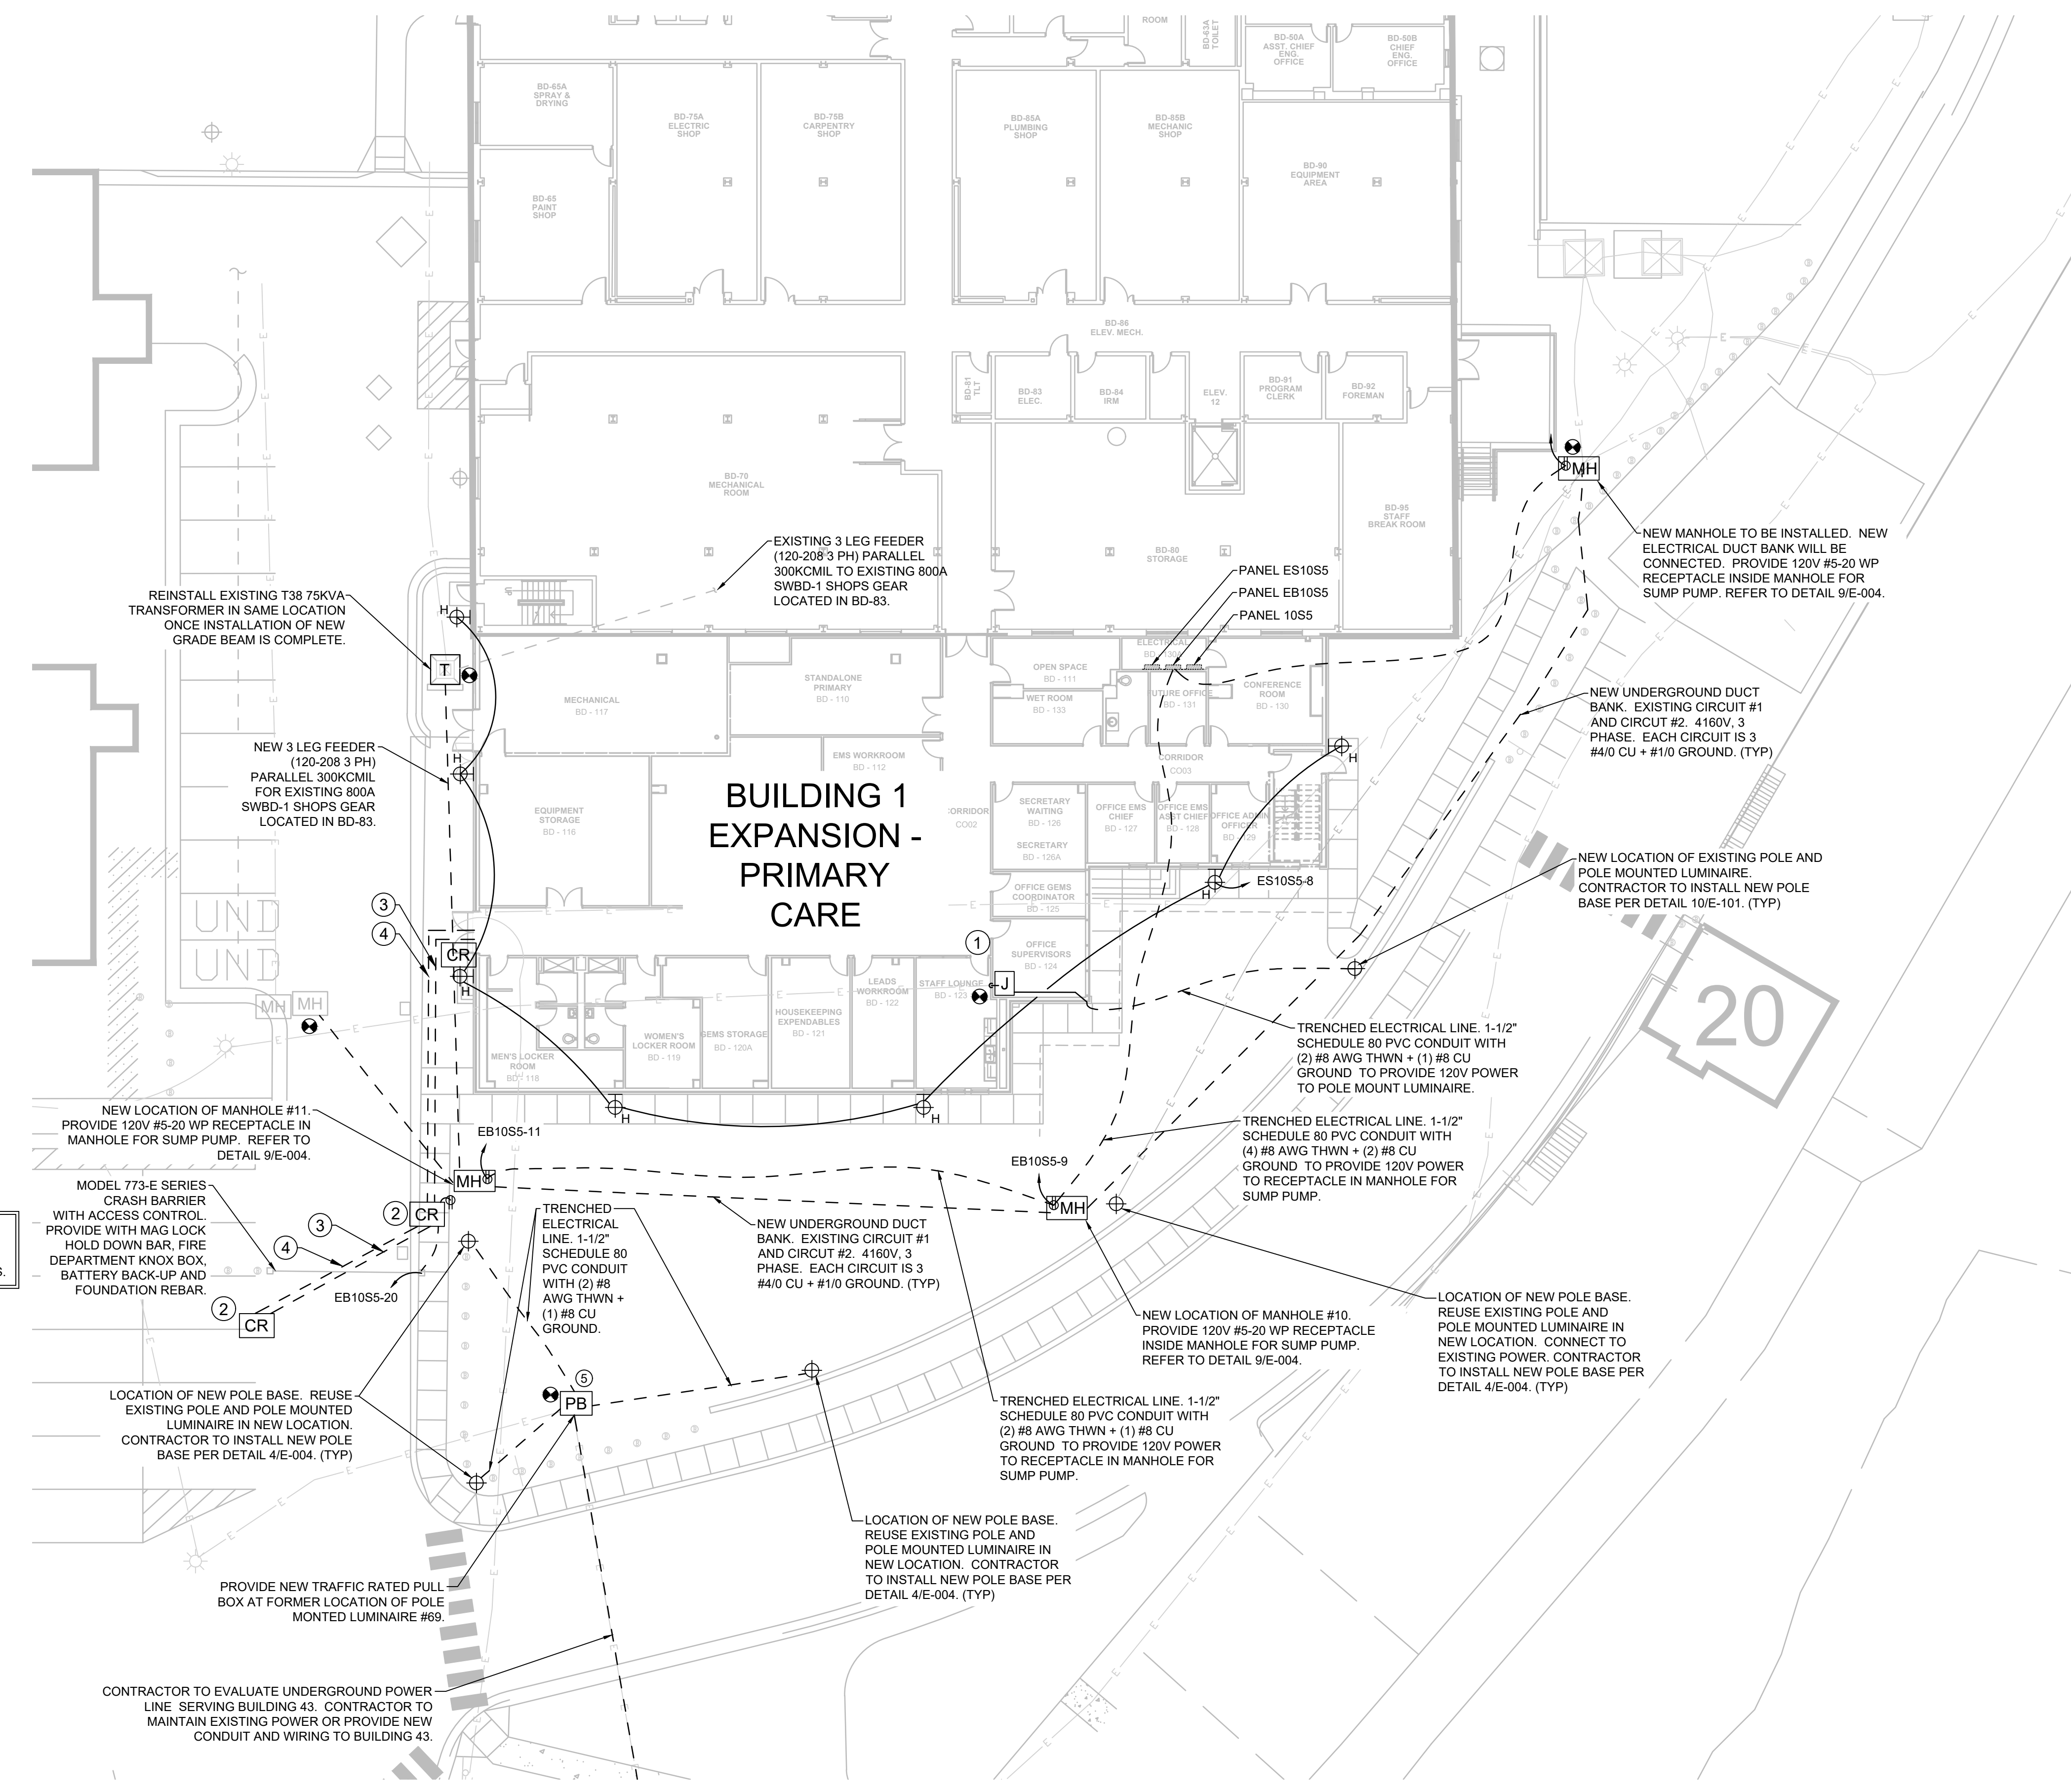
Office of Construction and Facilities Management

Department of Veterans Affairs

- KEYED ELECTRICAL NOTES**
- 2 NEW JUNCTION BOXES TO BE INSTALLED IN THIS LOCATION. EXISTING BURIED UTILITY LINE TO BE STUBBED UP INTO NEW JUNCTION BOX IN FLOOR. EXTENDED EXISTING POWER FROM FLOOR BOX. ROUTING INSIDE INTERIOR WALL, TO SECOND JUNCTION BOX INSTALLED ABOVE ACCESSIBLE CEILING. POWER WILL BE UTILIZED FOR EXTERIOR POLE MOUNTED LUMINAIRE.
 - INSTALL NEW CARD READER TO CONTROL ACCESS GATE.
 - 3/4" PVC CONDUIT BFG WITH (3) #12 AWG THWN TO PROVIDE 120V POWER TO CONTROLLED ACCESS GATE AND ASSOCIATED CARD READERS.
 - 1" PVC CONDUIT BFG WITH CAT 6A CABLING FROM SECURITY PANEL TO CARD READER FOR ACCESS GATE.
 - NEW PULL BOX TO BE INSTALLED IN FORMER LOCATION OF LIGHTPOLE #89. EXISTING POWER IS TO BE REUSED. NEW WIRE AND CONDUIT TO BE INSTALLED FROM JUNCTION BOX EXTENDING EXISTING POWER TO NEW LIGHT POLE LOCATIONS.



1 OVERALL SITE PLAN
SCALE: 1/128" = 1'



2 EXPANDED SITE POWER PLAN - NEW CONSTRUCTION
SCALE: 1/16" = 1'

BASE BID TO INCLUDE CONTROLLED ACCESS GATE AND ALL ASSOCIATED WIRING, CONDUIT AND BACK BOXES. BID ALTERNATE #2 DOES NOT INCLUDE CONTROLLED ACCESS GATE AND ALL ASSOCIATED WIRING CONDUIT AND BACK BOXES.

CONSTRUCTION DOCUMENTS

12/22/2009 10:11:25 AM
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three eighths inch = one foot
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three quarters inch = one foot
one inch = one foot
one and one half inches = one and one half feet
two inches = one and one half feet

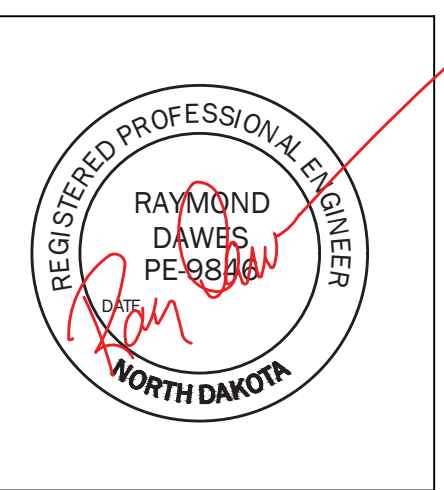
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Drawing Title
**ELECTRICAL SITE PLAN
NEW CONSTRUCTION**

Approved: Project Director
FARGO VAHCS

Project Title
**EXPAND BLDG. 1 FOR
PRIMARY CARE**

Location
**2101 ELM STREET
FARGO, ND 58102**

Date
11/16/2021

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Project Number
437-315

Building Number
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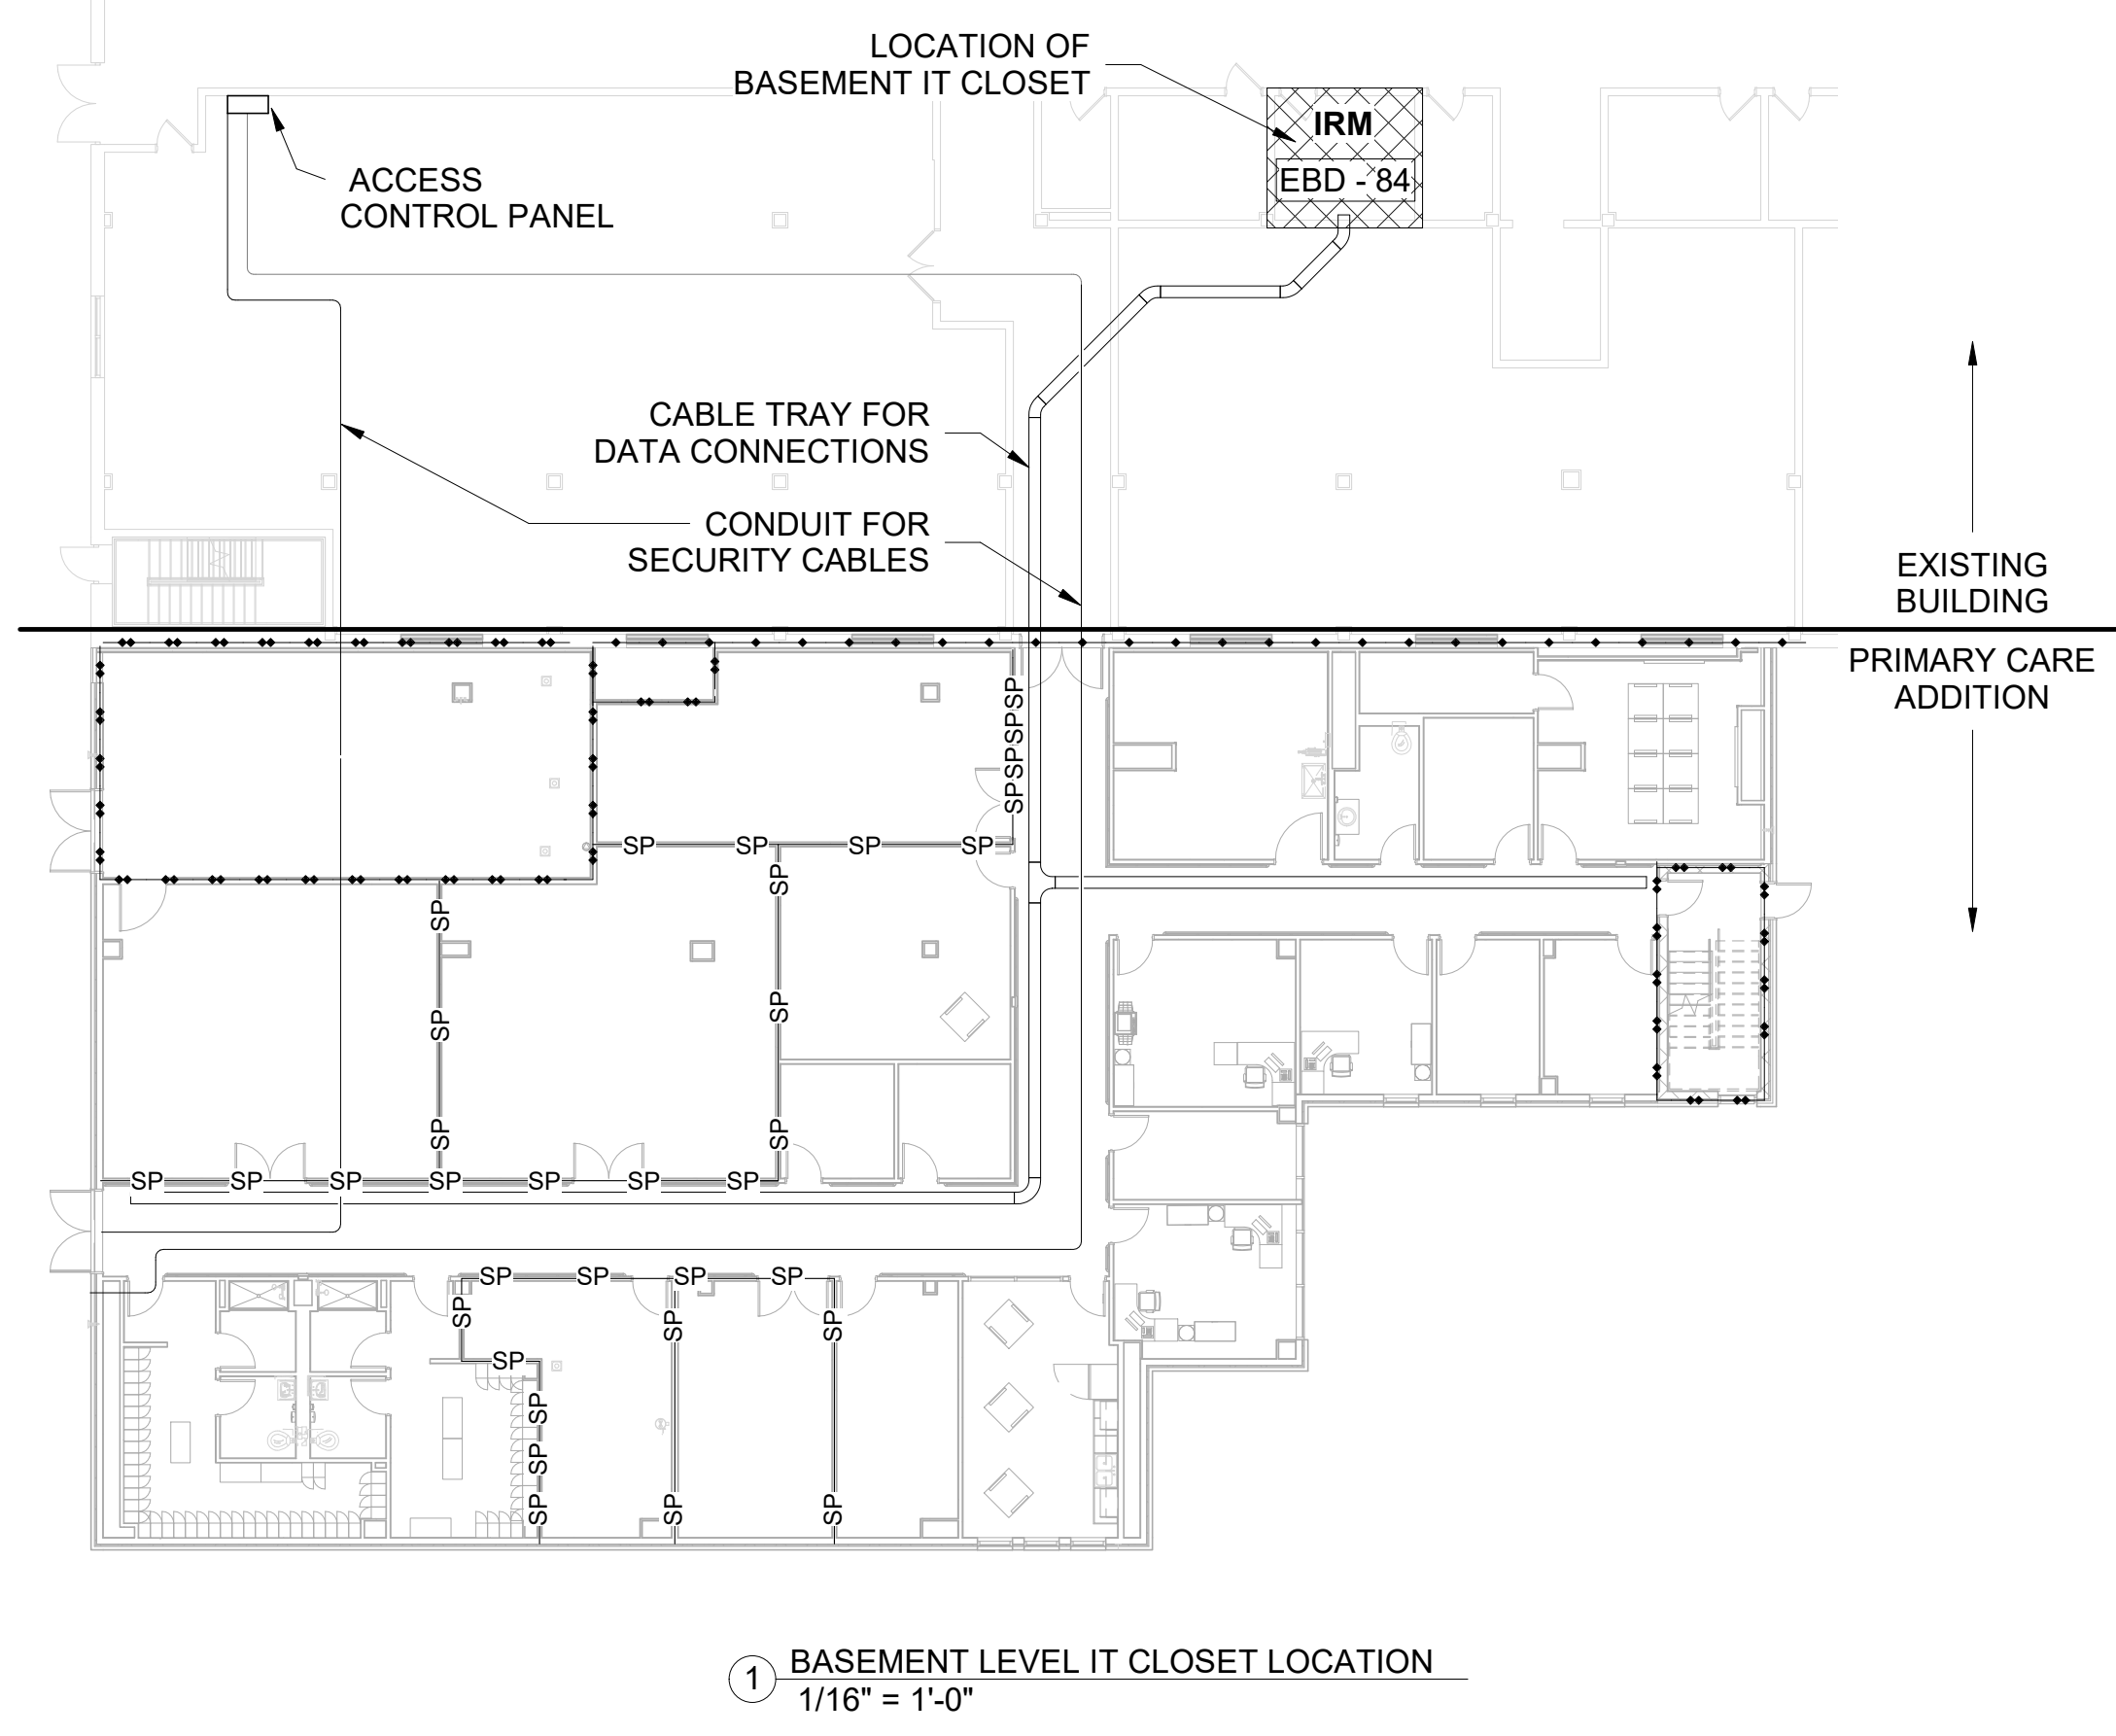
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E-101

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**Office of
Construction
and Facilities
Management**

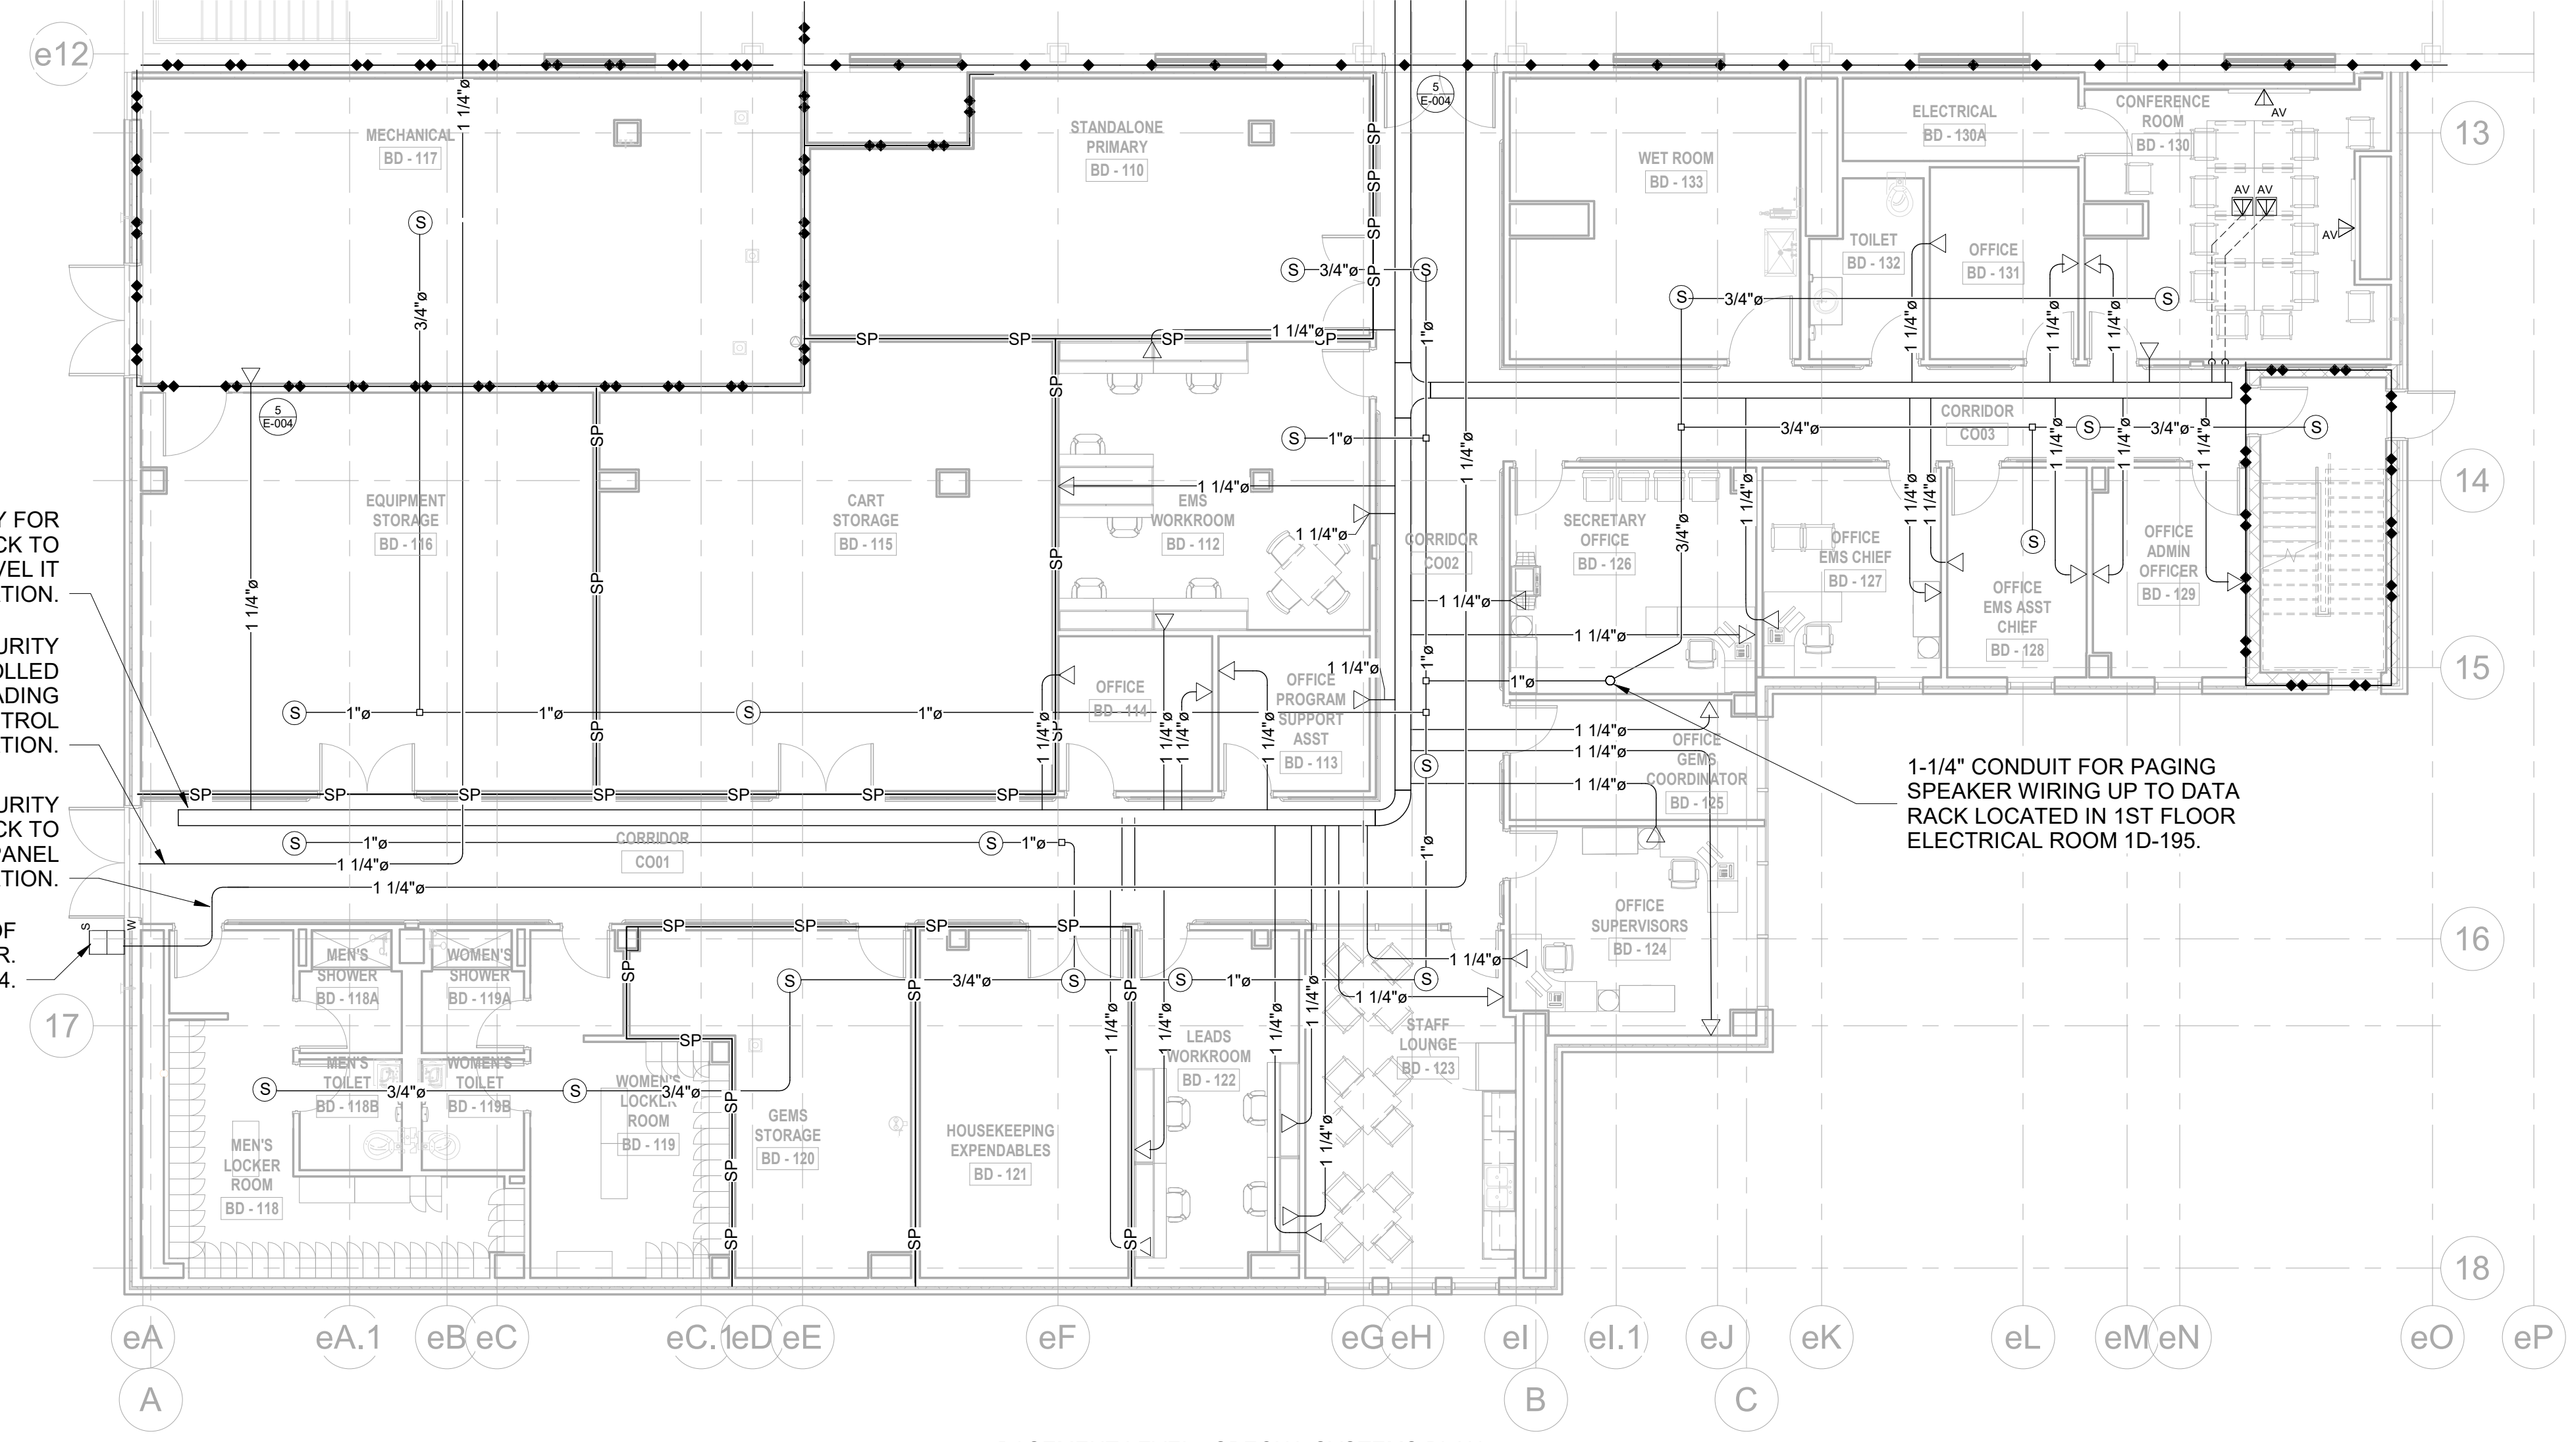
**Department of
Veterans Affairs**

KEYED ELECTRICAL NOTES
 ① TELEVISION WALL RECEPTACLE. SEE FACE PLATE, BACK BOX AND CONDUIT REQUIREMENT DETAIL ON SHEET E-004.

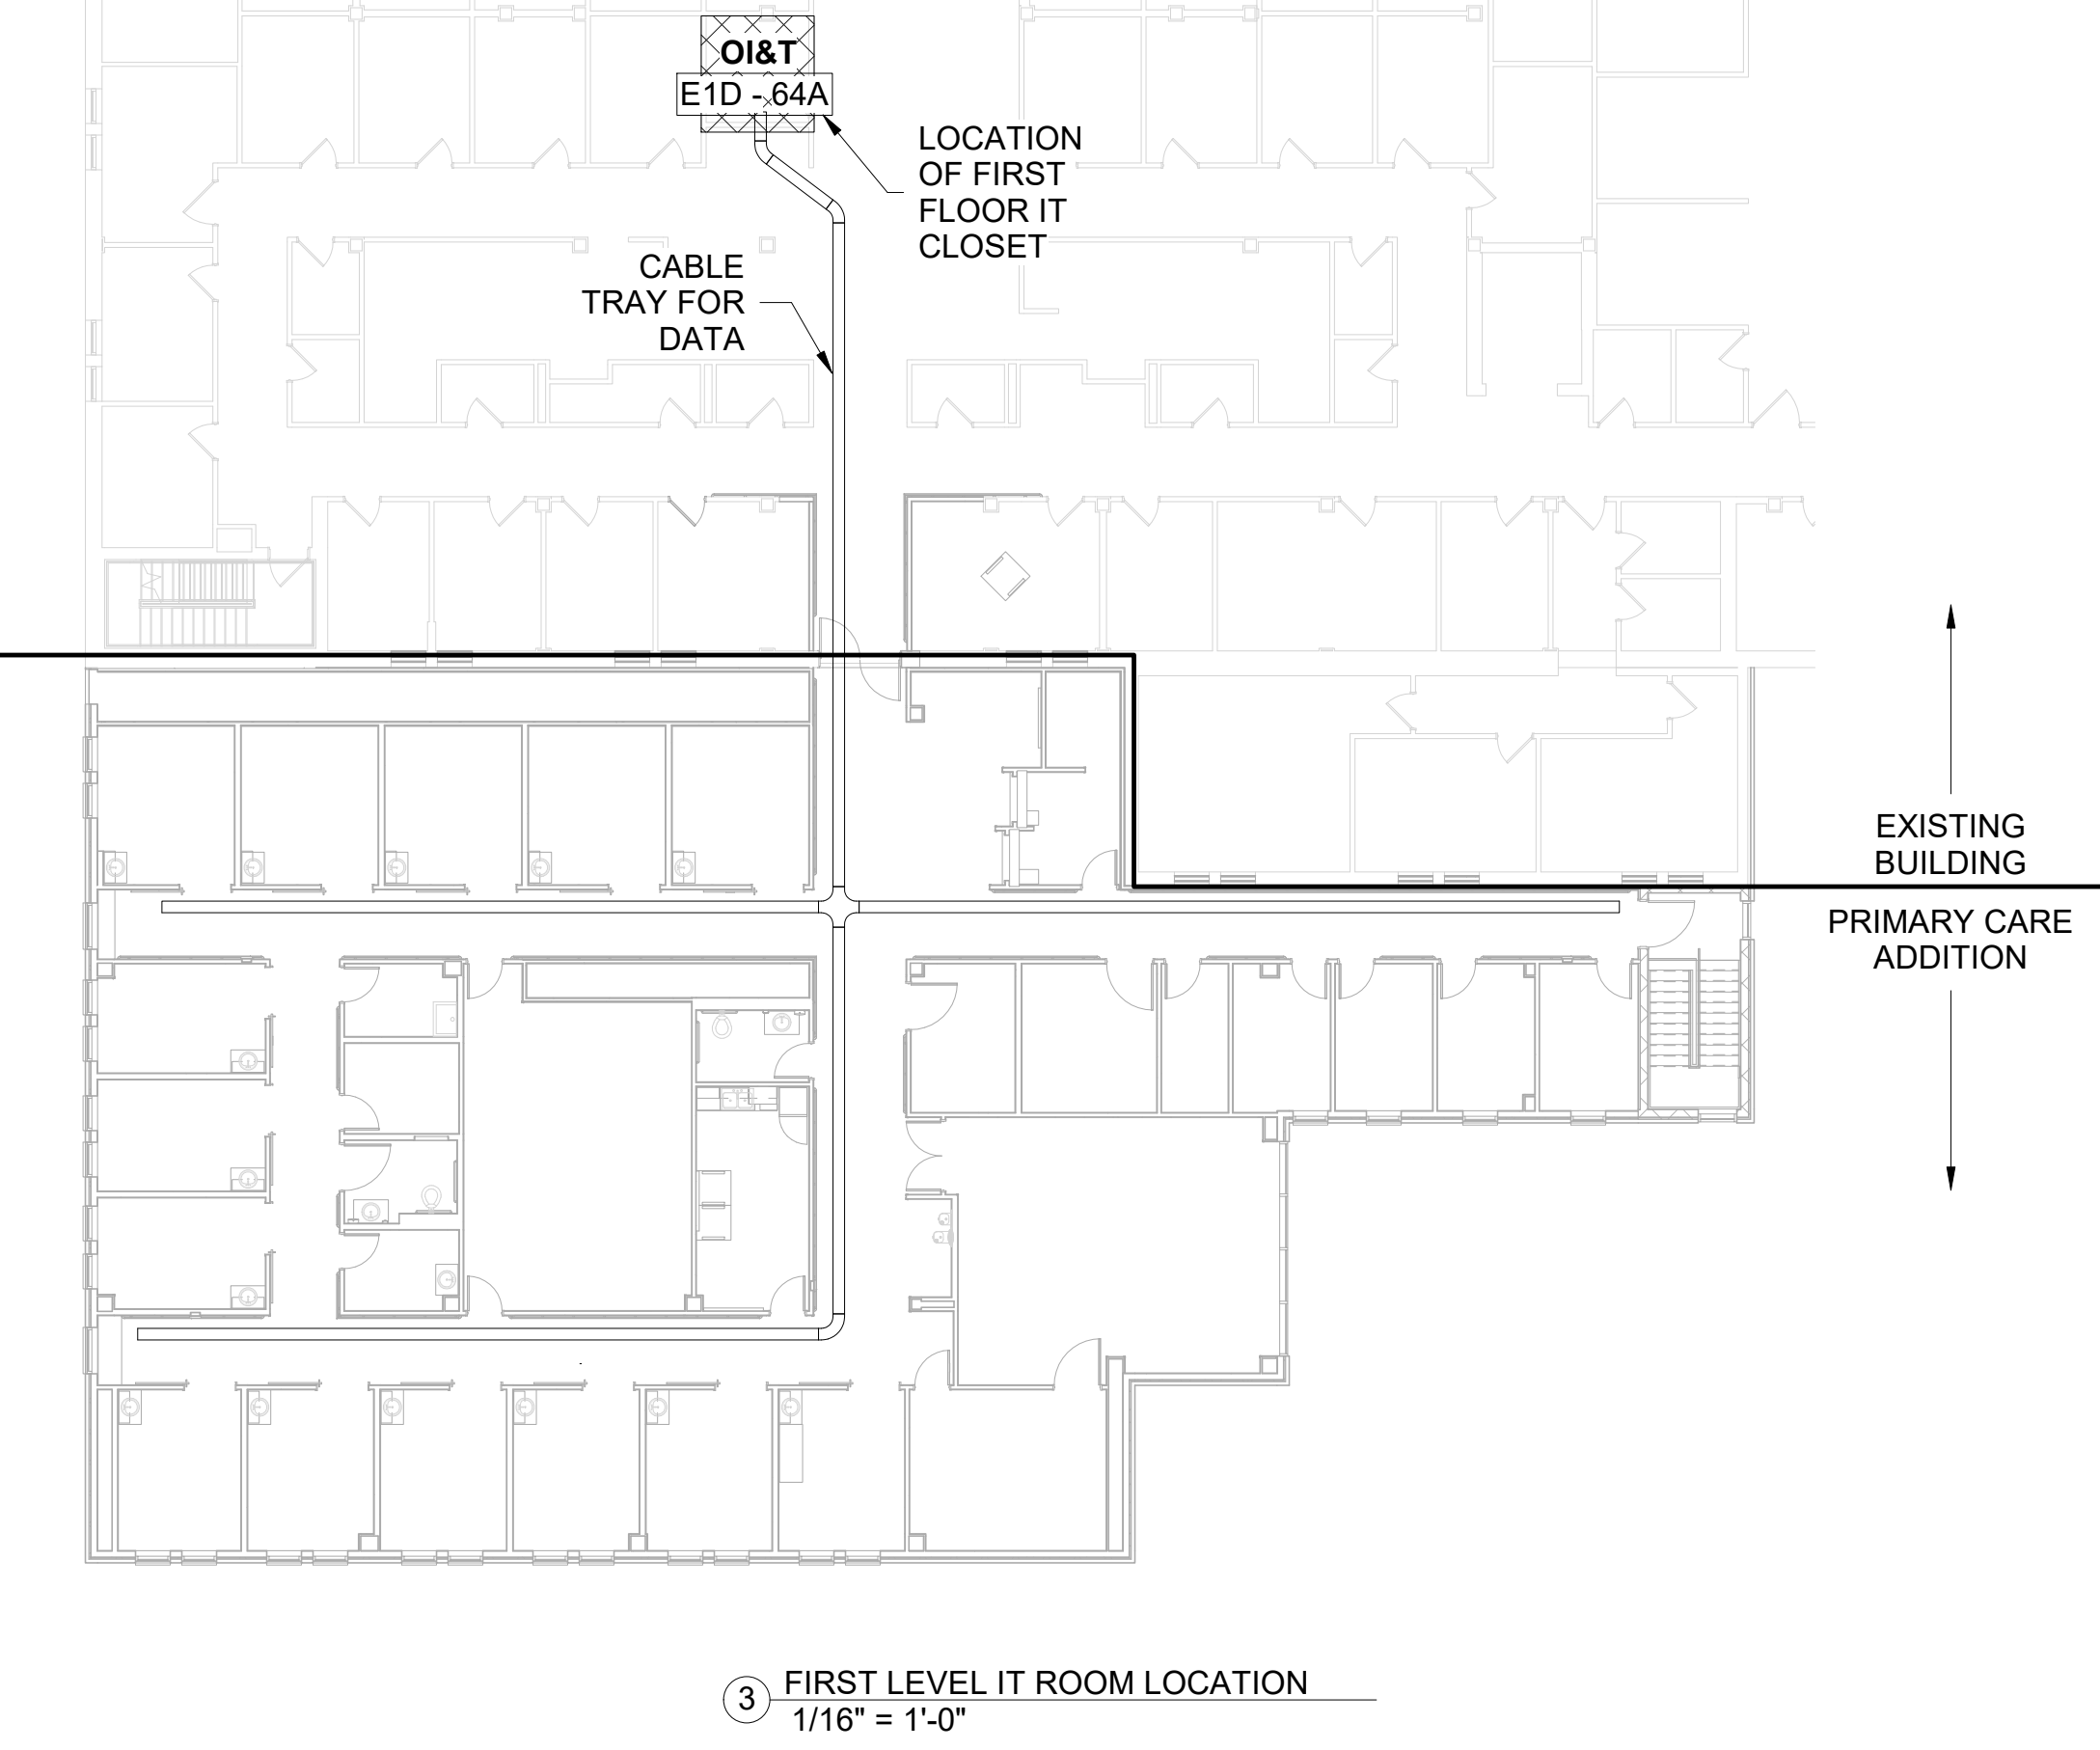


① BASEMENT LEVEL IT CLOSET LOCATION
1/16" = 1'-0"

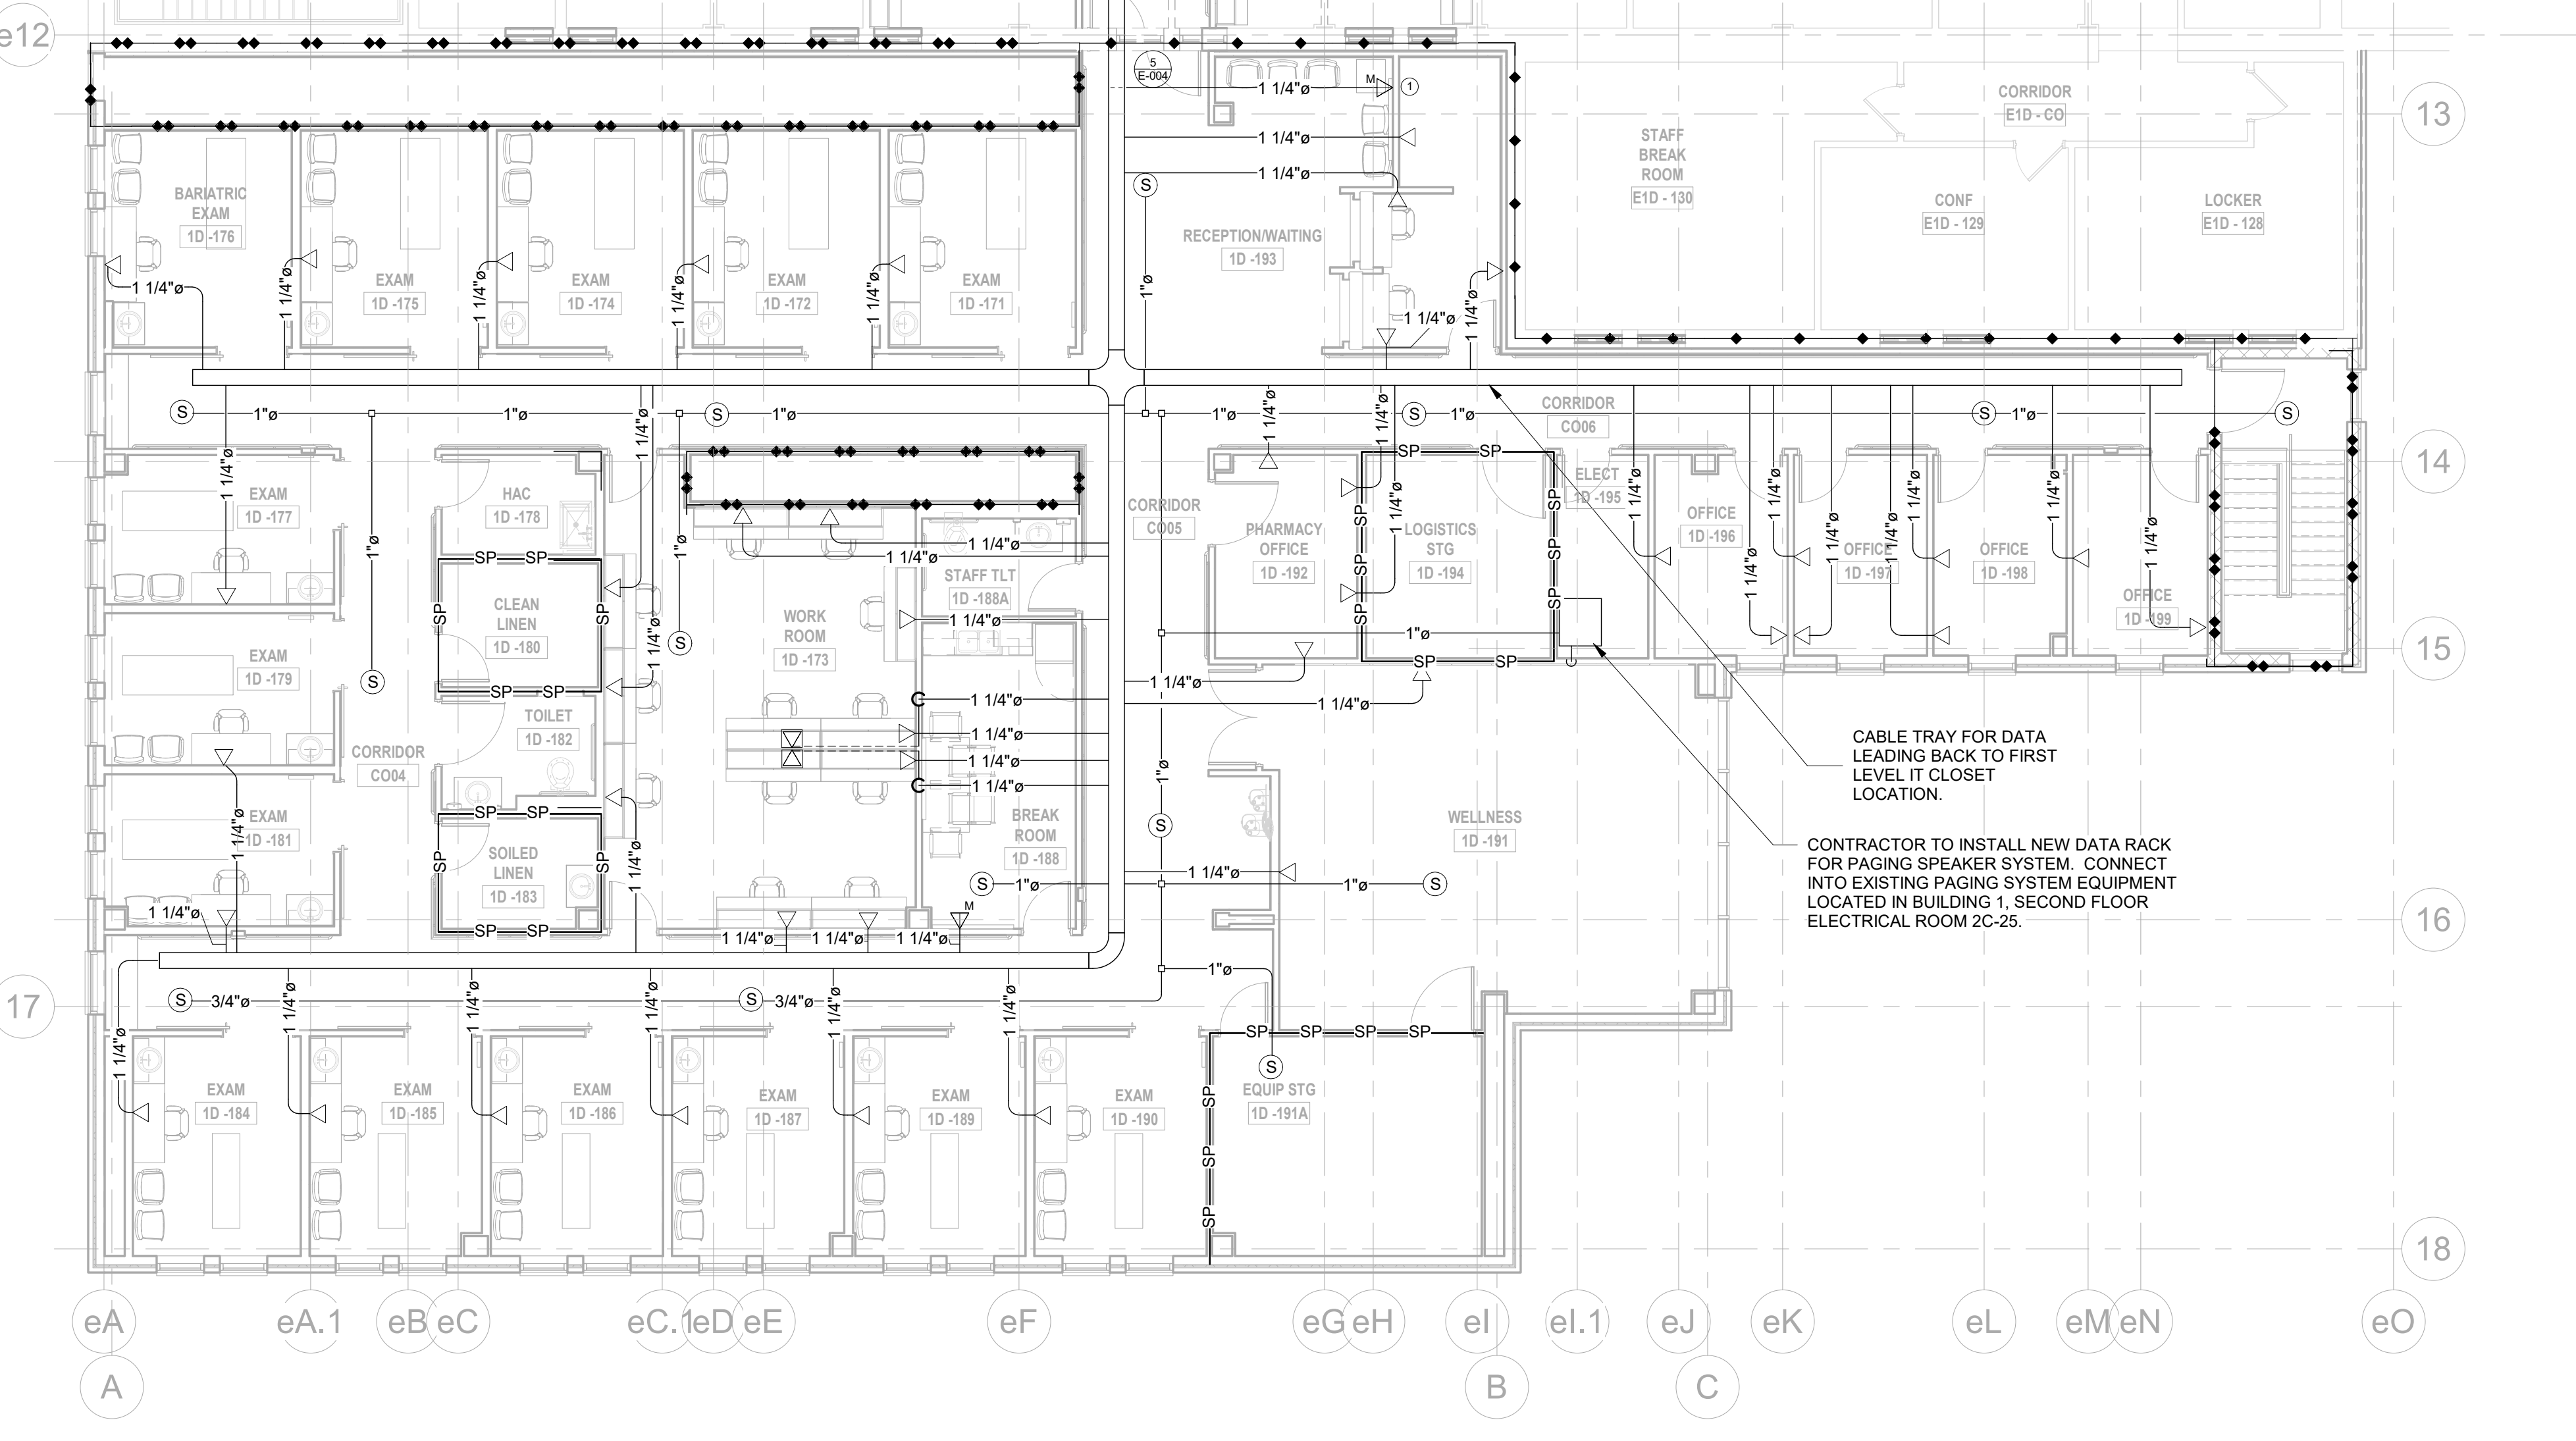
12"x4" CABLE TRAY FOR DATA LEADING BACK TO BASEMENT LEVEL IT CLOSET LOCATION.
 CONDUIT FOR SECURITY DEVICES AT CONTROLLED ACCESS GATE LEADING BACK TO ACCESS CONTROL PANEL LOCATION.
 CONDUIT FOR SECURITY DEVICES LEADING BACK TO ACCESS CONTROL PANEL LOCATION.
 NEW LOCATION OF EXISTING CARD READER. SEE DETAIL 7/E-004.



② BASEMENT LEVEL - SPECIAL SYSTEMS PLAN
1/8" = 1'-0"



③ FIRST LEVEL IT ROOM LOCATION
1/16" = 1'-0"



④ FIRST LEVEL - SPECIAL SYSTEMS PLAN
1/8" = 1'-0"

1-1/4" CONDUIT FOR PAGING SPEAKER WIRING UP TO DATA RACK LOCATED IN 1ST FLOOR ELECTRICAL ROOM 1D-195.

CABLE TRAY FOR DATA LEADING BACK TO FIRST LEVEL IT CLOSET LOCATION.
 CONTRACTOR TO INSTALL NEW DATA RACK FOR PAGING SPEAKER SYSTEM. CONNECT INTO EXISTING PAGING SYSTEM EQUIPMENT LOCATED IN BUILDING 1, SECOND FLOOR ELECTRICAL ROOM 2C-25.

CONSTRUCTION DOCUMENTS

11/16/2021 6:35:59 PM
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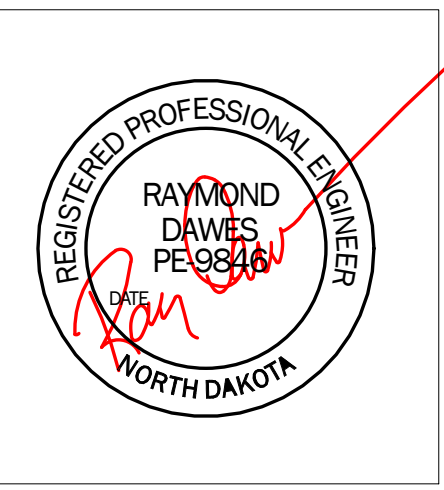
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Drawing Title
SPECIAL SYSTEMS PLAN

Approved: Project Director
FARGO VAHCS

Project Title
EXPAND BLDG. 1 FOR PRIMARY CARE

Project Number
 437-315
 Building Number
1

Location
 2101 ELM STREET
 FARGO, ND 58102

Date
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Drawing Number
E-400

Dwg. 101 of 128

Office of Construction and Facilities Management
 Department of Veterans Affairs

HVAC / MECHANICAL SYMBOLS

ABBREVIATIONS:

AC	ALTERNATING CURRENT	MECH	MECHANICAL
ADJ.	ADJUSTABLE	MFG	MANUFACTURER
AHJ	AUTHORITY HAVING JURISDICTION	MIN	MINIMUM
AHU	AIR HANDLING UNIT	MIN	MINUTE
AS	AIR SEPARATOR	mm	MILLIMETER
ASME	AMERICAN SOCIETY OF MECHANICAL ENGINEERS	MPS	MEDIUM PRESSURE STEAM
BHP	BRAKE HORSEPOWER	MT	MOISTURE (HUMIDITY) TRANSMITTER
BMS	BUILDING MANAGEMENT SYSTEM	MV	MANUAL VENT
CALC	CALCULATED	N.C.	NORMALLY CLOSED
CC	CHILLED WATER COOLING COIL - AHU	NC	NOISE CRITERIA LEVEL
CD	CONDENSATE DRAIN	NFPA	NATIONAL FIRE PROTECTION ASSOCIATION
CFM	CUBIC FEET PER MINUTE	NG	NATURAL GAS
CHR	CHILLED WATER RETURN	N.O.	NORMALLY OPEN
CHS	CHILLED WATER SUPPLY	NPT	NATIONAL PIPE THREAD
CHWR	CHILLED WATER RETURN	OA	OUTSIDE AIR
CHWS	CHILLED WATER SUPPLY	OAT	OUTSIDE AIR TEMPERATURE
C/L	CENTERLINE	ORD	OVERFLOW ROOF DRAIN
CO	CLEANOUT	OSA	OUTSIDE AIR
COEF	COEFFICIENT	OSHA	OCCUPATIONAL SAFETY AND HEALTH ADMINISTRATION
COMLINK	COMMUNICATION LINK	Pa	PASCAL
COND	CONDENSATION	PC	PUMPED CONDENSATE
CONFIG	CONFIGURED	PC	PREHEAT STEAM COIL - AHU
COR	CONTRACTING OFFICER'S REPRESENTATIVE	PD	PRESSURE DROP
CNTRL.	CONTROL	PDS	PRESSURE DIFFERENTIAL SENSOR
CP	CONDENSATE PUMP	PH	PHASE
CPVC	CHLORINATED POLYVINYL CHLORIDE	PHWR	PERIMETER HEAT WATER RETURN
CR	CONDENSATE RETURN	PHWS	PERIMETER HEAT WATER SUPPLY
CV	CONTROL VALVE	PI	PROPORTIONAL INTEGRAL
DAMP.	DAMP	PID	PROPORTIONAL INTEGRAL DERIVATIVE
DAMP.	DAMP	PRESS.	PRESSURE
DAT	DISCHARGE AIR TEMPERATURE	PSH	HIGH PRESSURE SWITCH
DB	DRY BULB	PSIG	POUNDS PER SQUARE INCH - GAUGE
DC	DIRECT CURRENT	PSL	LOW PRESSURE SWITCH
DCW	DOMESTIC COLD WATER	QUANT.	QUANTITY
DEG	DEGREES	R	RADIUS
DHR	DOMESTIC HOT WATER RETURN	R	RETURN
DHW	DOMESTIC HOT WATER	RA	RETURN AIR
DIFF.	DIFFERENTIAL	RC	REHEAT STEAM COIL - AHU
DIST	DISTRIBUTION	RD	ROOF DRAIN
DS	DOWNSPOUT	RE	RESIDENT ENGINEER
DSP	DEHUMIDIFICATION SET POINT	REQ'D	REQUIRED
DIVV	DRAIN, WASTE AND VENT	RH	RELATIVE HUMIDITY
EA	EXHAUST AIR	RHWR	RE-HEAT WATER RETURN
ECC	ENERGY CONTROL CENTER	RHWS	RE-HEAT WATER SUPPLY
ECC	ENERGY CONTROL CENTER	RP	RADIANT PANEL - CEILING
ELECT.	ELECTRICAL	RPM	REVOLUTIONS PER MINUTE
ELEV	ELEVATION	S	SUPPLY
ENT	ENTERING	SA	SUPPLY AIR
ERC	ENERGY RECOVERY COIL - AHU	SAN	SANITARY
ES	END SWITCH	SD	SMOKE DAMPER
EWC	ELECTRIC WATER COOLER	SF	FAN SECTION - AHU
F	FAHRENHEIT	SF	SQUARE FEET
FD	FLOOR DRAIN	SMACNA	SHEET METAL AND AIR CONDITIONING CONTRACTORS ASSOCIATION
FILT.	FILTER	SP	STATIC PRESSURE
FFM	FEET PER MINUTE	SPEC	SPECIFICATION
FT	FEET	SS	STAINLESS STEEL
FT	FIN TUBE BASEBOARD RADIATOR	SST	START/STOP
GAL	GALLONS	STM-HP	STEAM - HIGH PRESSURE
GALV	GALVANIZED	STM-LP	STEAM - LOW PRESSURE
G.C.	GENERAL CONTRACTOR	STM-MP	STEAM - MEDIUM PRESSURE
GPM	GALLONS PER MINUTE	SUH	STEAM UNIT HEATER
GT	GLYCOL TANK	SV	STEAM VALVE
H	HEIGHT	SV	STEAM VENT
H	HUMIDIFIER - AHU	T	THERMOSTAT
HP	HORSEPOWER	TEMP.	TEMPERATURE
HPS	HIGH PRESSURE STEAM	TSP	TOTAL STATIC PRESSURE
HR	HOUR	TT	TEMPERATURE SENSOR/TRANSMITTER
HRCS	HEAT RECOVERY RETURN	TU	TERMINAL UNIT
HRCS	HEAT RECOVERY SUPPLY	TYP	TYPICAL
HRP	HEAT RECOVERY PUMP	UH	UNIT HEATER
HSP	HUMIDIFICATION SET POINT	V	VENT
HVAC	HEATING, VENTILATION, AND AIR CONDITIONING	V	VOLTS
HX	HEAT EXCHANGER	VAV	VARIABLE AIR VOLUME
HZ	HERTZ	VFD	VARIABLE FREQUENCY DRIVE
IBC	INTERNATIONAL BUILDING CODE	VSMC	VARIABLE SPEED MOTOR CONTROLLER
ICVAMC	IOWA CITY VETERANS AFFAIRS MEDICAL CENTER	VTR	VENT THROUGH ROOF
IECC	INTERNATIONAL ENERGY CONSERVATION CODE	W	WIDTH
IFB	INTEGRAL FACE AND BYPASS	W/	WITH
IMC	INTERNATIONAL MECHANICAL CODE	WB	WET BULB
IO	INPUT/OUTPUT	WG	INCHES OF WATER
IPC	INTERNATIONAL PLUMBING CODE	ZAT	ZONE AIR TEMPERATURE
K.O.	COMMANDING OFFICER	ZC	VALVE OR DAMPER CONTROLLER
L	LENGTH		
LBS	POUNDS		
LPS	LOW PRESSURE STEAM		
LWA	SOUND POWER LEVEL		
MAX	MAXIMUM		
MBH	THOUSAND BRITISH THERMAL UNITS PER HOUR		
MC	MECHANICAL CONTRACTOR		
MD	MOTORIZED DAMPER		

	SUPPLY AIR DUCT FROM AHU		VANED ELBOW (PROVIDE ALL SQUARE OR RECTANGULAR ELBOWS WITH VANES EVEN IF SYMBOL IS MISSING)
	SUPPLY AIR DUCT FROM VAV		VANED RADIUS ELBOW (SHORT RADIUS)
	FRESH AIR DUCT FROM EXTERIOR		RADIUS ELBOW (SHORT RADIUS)
	RETURN AIR DUCT		NEW DUCT (INSIDE DIMENSIONS: WIDTH / DEPTH)
	EXHAUST AIR DUCT		SUPPLY DUCT UP
	HOT WATER SUPPLY		SUPPLY DUCT DOWN
	HOT WATER RETURN		RETURN/EXHAUST/RELIEF DUCT UP
	REHEAT HOT WATER SUPPLY		RETURN/EXHAUST/RELIEF DUCT DOWN
	REHEAT HOT WATER RETURN		MOTORIZED DAMPER W/ ACCESS DOOR
	HEAT RECOVERY WATER SUPPLY		FIRE DAMPER W/ ACCESS DOOR
	HEAT RECOVERY WATER RETURN		FIRE AND SMOKE DAMPER W/ ACCESS DOOR
	CHILLED WATER SUPPLY		SMOKE DAMPER W/ ACCESS DOOR
	CHILLED WATER RETURN		BACK DRAFT DAMPER W/ ACCESS DOOR
	REFRIGERANT - LIQUID		MANUAL VOLUME DAMPER
	REFRIGERANT - SUCTION		MODULATING CONTROL VALVE
	LOW PRESSURE STEAM		PIPE ELBOW
	MEDIUM PRESSURE STEAM		PIPE DOWN
	HIGH PRESSURE STEAM		PIPE UP
	LOW PRES. STEAM CONDENSATE RETURN		PIPE TEE DOWN
	MEDIUM PRES. STEAM CONDENSATE RETURN		WALL MOUNTED EXHAUST FAN
	HIGH PRES. STEAM CONDENSATE RETURN		VARIABLE AIR VOLUME BOX
	PUMPED STEAM CONDENSATE RETURN		DUCT HOT WATER REHEAT COIL
	STEAM BUCKET TRAP		HYDRONIC RADIANT HEATING PANEL
	FLOAT & THERMOSTATIC TRAP		GRILLE, REGISTER, DIFFUSER TAG WITH CFM
	STEAM THERMOSTATIC TRAP		EQUIPMENT TAG WITH NUMBER DESIGNATION
	STRAINER		THERMOSTAT
	UNION		TEMPERATURE SENSOR
	BALL VALVE		PRESSURE SENSOR
	GATE VALVE		DIFFERENTIAL PRESSURE SENSOR
	GLOBE VALVE		HUMIDITY SENSOR
	CHECK VALVE		SUPPLY DIFFUSER
	MODULATING CONTROL VALVE		LINEAR SLOT SUPPLY DIFFUSER
	PRESSURE REDUCING VALVE		RETURN GRILLE
	MANUAL BALANCING / SHUT-OFF VALVE		EXHAUST GRILLE
	CONCENTRIC PIPE REDUCER		MECHANICAL PLAN NOTE
	ECCENTRIC PIPE REDUCER		DUCT FLEX CONNECTOR
	TEE		FLEX DUCT
	PRESSURE GAUGE		POINT OF CONNECTION
	TEMPERATURE GAUGE		POINT OF DISCONNECTION
	SHELL AND TUBE HEAT EXCHANGER		TO BE DEMOLISHED
	STEAM CONDENSATE PUMP		ONE HOUR FIRE BARRIER
	STEAM FLASH TANK		SMOKE PARTITION
	EXPANSION TANK		TWO HOUR FIRE BARRIER
	LIQUID FLOW DIRECTION		
	DIRECTION OF AIR FLOW		

MECHANICAL SHEET INDEX

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GENERAL MECHANICAL NOTES:

ALL WORK SHALL BE IN ACCORDANCE WITH THE 2018 INTERNATIONAL MECHANICAL CODE (IMC), THE VHA HVAC AND MECHANICAL DESIGN MANUAL 2018 SPECIFICATIONS AND GUIDELINES, AND THE AUTHORITIES HAVING JURISDICTION (AHJ).

PRIOR TO BIDDING WORK, CONTRACTOR SHALL VISIT THE SITE AND FAMILIARIZE THEMSELVES WITH THE EXISTING CONDITIONS. THESE DRAWINGS WERE DEVELOPED FROM PREVIOUS PROJECT RECORD DRAWINGS AND THROUGH SITE INVESTIGATION. ALTHOUGH EVERY ATTEMPT HAS BEEN MADE TO INDICATE THE EXACT ROUTING AND LOCATION OF PROPOSED SYSTEMS, NOT ALL OFFSETS, REQUIRED FITTINGS, CONNECTIONS, AND/OR CONDITIONS COULD BE VERIFIED. THE CONTRACTOR SHALL COORDINATE WORK AND MAKE REQUIRED CHANGES TO THE ROUTING IN ORDER TO AVOID CONFLICTS WITHOUT ANY INCREASED COST TO THE OWNER.

CONTRACTOR IS TO VERIFY ALL DRAWING INFORMATION PRIOR TO STARTING WORK. MINOR CHANGES IN ROUTING ARE EXPECTED. WHERE EXISTING CONDITIONS VARY GREATLY FROM THE PLANS CONTRACTOR SHALL CONTACT THE CONTRACTING OFFICER'S REPRESENTATIVE (COR) IMMEDIATELY BEFORE STARTING WORK. NO EXTRA CONSIDERATION WILL BE GIVEN FOR IGNORANCE OF EXISTING CONDITIONS.

CONTRACTOR IS TO COORDINATE WITH THE COR FOR DIRECTION AND HANDLING OF ANY DEMOLISHED ITEMS OR EQUIPMENT. CONTRACTOR IS TO VERIFY WITH COR WHICH ITEMS OR EQUIPMENT SHALL BE TURNED OVER TO THE VA OR SHALL BECOME PROPERTY OF THE CONTRACTOR TO BE REMOVED FROM JOB SITE.

EXCEPT WHERE INDICATED, ALL EQUIPMENT, MATERIALS, AND ARTICLES INCORPORATED IN THE WORK SHALL BE NEW AND OF COMPARABLE QUALITY AS SPECIFIED. ALL WORKMANSHIP SHALL BE FIRST-CLASS AND SHALL BE PERFORMED BY PERSONNEL SKILLED AND REGULARLY EMPLOYED IN THEIR RESPECTIVE TRADES. ITEMS REUSED AND/OR RELOCATED SHALL BE BROUGHT TO LIKE NEW CONDITION PRIOR TO BEING PLACED INTO SERVICE.

ALL WORK SHALL BE COORDINATED WITH ALL AFFECTED TRADES PRIOR TO STARTING WORK. REWORK REQUIRED DUE TO COORDINATION ISSUES SHALL BE DONE BY THE INSTALLATION CONTRACTOR WITHOUT INCREASED COST TO THE OWNER.

SYSTEMS DESIGNATED TO BE PROVIDED AND INSTALLED WITHIN THESE CONTRACT DOCUMENTS ARE INTENDED TO BE COMPLETE AND OPERATIONAL. PROVIDE EVERYTHING ESSENTIAL FOR THE COMPLETION OF THE WORK TO MAKE THE SYSTEM READY FOR NORMAL AND PROPER OPERATION. THIS INCLUDES ALL WORK OR MATERIALS NOT DIRECTLY SHOWN ON THE DRAWINGS OR IN THE SPECIFICATIONS, BUT NECESSARY FOR THE PROPER OPERATION OF THE SYSTEM.

THE PROJECT IS REQUIRED TO BE PHASED AND AREAS MUST BE KEPT IN OPERATION THROUGHOUT THE PROJECT. SEE APPROPRIATE SECTIONS OF DIVISION 1.

IN GENERAL IT IS THE INTENT OF THESE DRAWINGS: ITEMS INSTALLED WHERE THE STRUCTURE IS EXPOSED - INSTALLED AS HIGH AS POSSIBLE. ALL VALVES AND CONTROL DEVICES SHOULD BE INSTALLED AS LOW AS POSSIBLE OR WHERE IT WILL BE MAINTAINABLE FROM A LADDER OR LIFT. CLOSE COORDINATION WILL BE REQUIRED IN ORDER TO AVOID ALL CONFLICTS. NEW INSTALLATIONS SHALL NOT BE LOWER THAN EXISTING UTILITIES.

ALL SUPPLY DUCTWORK BETWEEN AHU AND VAV'S SHALL BE 4" STATIC PRESSURE CLASS. ALL DUCT TO BE GALVANIZED STEEL.

ALL NEW MECHANICAL PIPING SHALL MATCH EXISTING SYSTEMS AND BE MADE OF BLACK IRON OR COPPER. NOTIFY COR AND ENGINEER FOR ANY DEVIATION FROM THESE MATERIALS. ALL NEW MECHANICAL PIPING SHALL BE INSULATED AND THICKNESS SHALL MATCH THE EXISTING SYSTEMS. CORE DRILLING WILL BE REQUIRED. CONTRACTOR IS TO IDENTIFY ANY LOCATIONS AND IS RESPONSIBLE FOR CORE DRILLING.

ALL SQUARE THROAT DUCT ELBOWS WITH ANY DIMENSIONS LARGER THAN 6" SHALL HAVE TURNING VANES, WHETHER SHOWN ON THE PLANS OR NOT.

COORDINATE WITH GC AND COR FOR WORK WITHIN SPACES SO AS TO NOT DISRUPT OCCUPIED AREAS DURING CONSTRUCTION.

MANUFACTURERS/MODEL NUMBERS INDICATED ON DRAWINGS ARE BASIS OF DESIGN. OTHER MANUFACTURERS/MODEL NUMBERS WILL BE ACCEPTED PROVIDING THEY MEET SPECIFICATIONS AND PERFORMANCE REQUIREMENTS OF THE BASIS OF DESIGN.

CONSTRUCTION DOCUMENTS

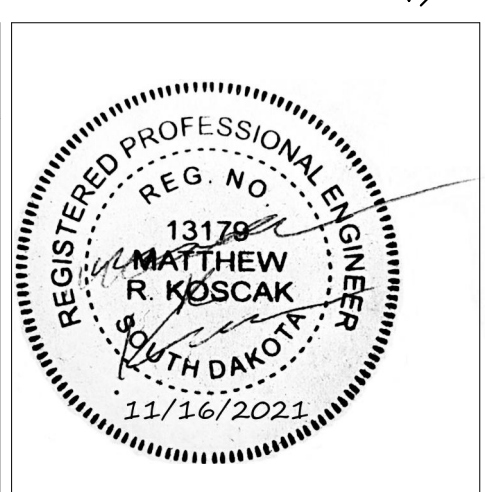
Revisions:	Date:

CONSULTANTS:

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Drawing Title: **SYMBOLS, LEGENDS AND ABBREVIATIONS**

Approved: Project Director **FARGO VAHCS**

Project Title: **EXPAND BLDG. 1 FOR PRIMARY CARE**

Project Number: 437-315
Building Number: **1**

Location: 2101 ELM STREET FARGO, ND 58102

Date: 11/16/2021
Checked: MK
Drawn: JB

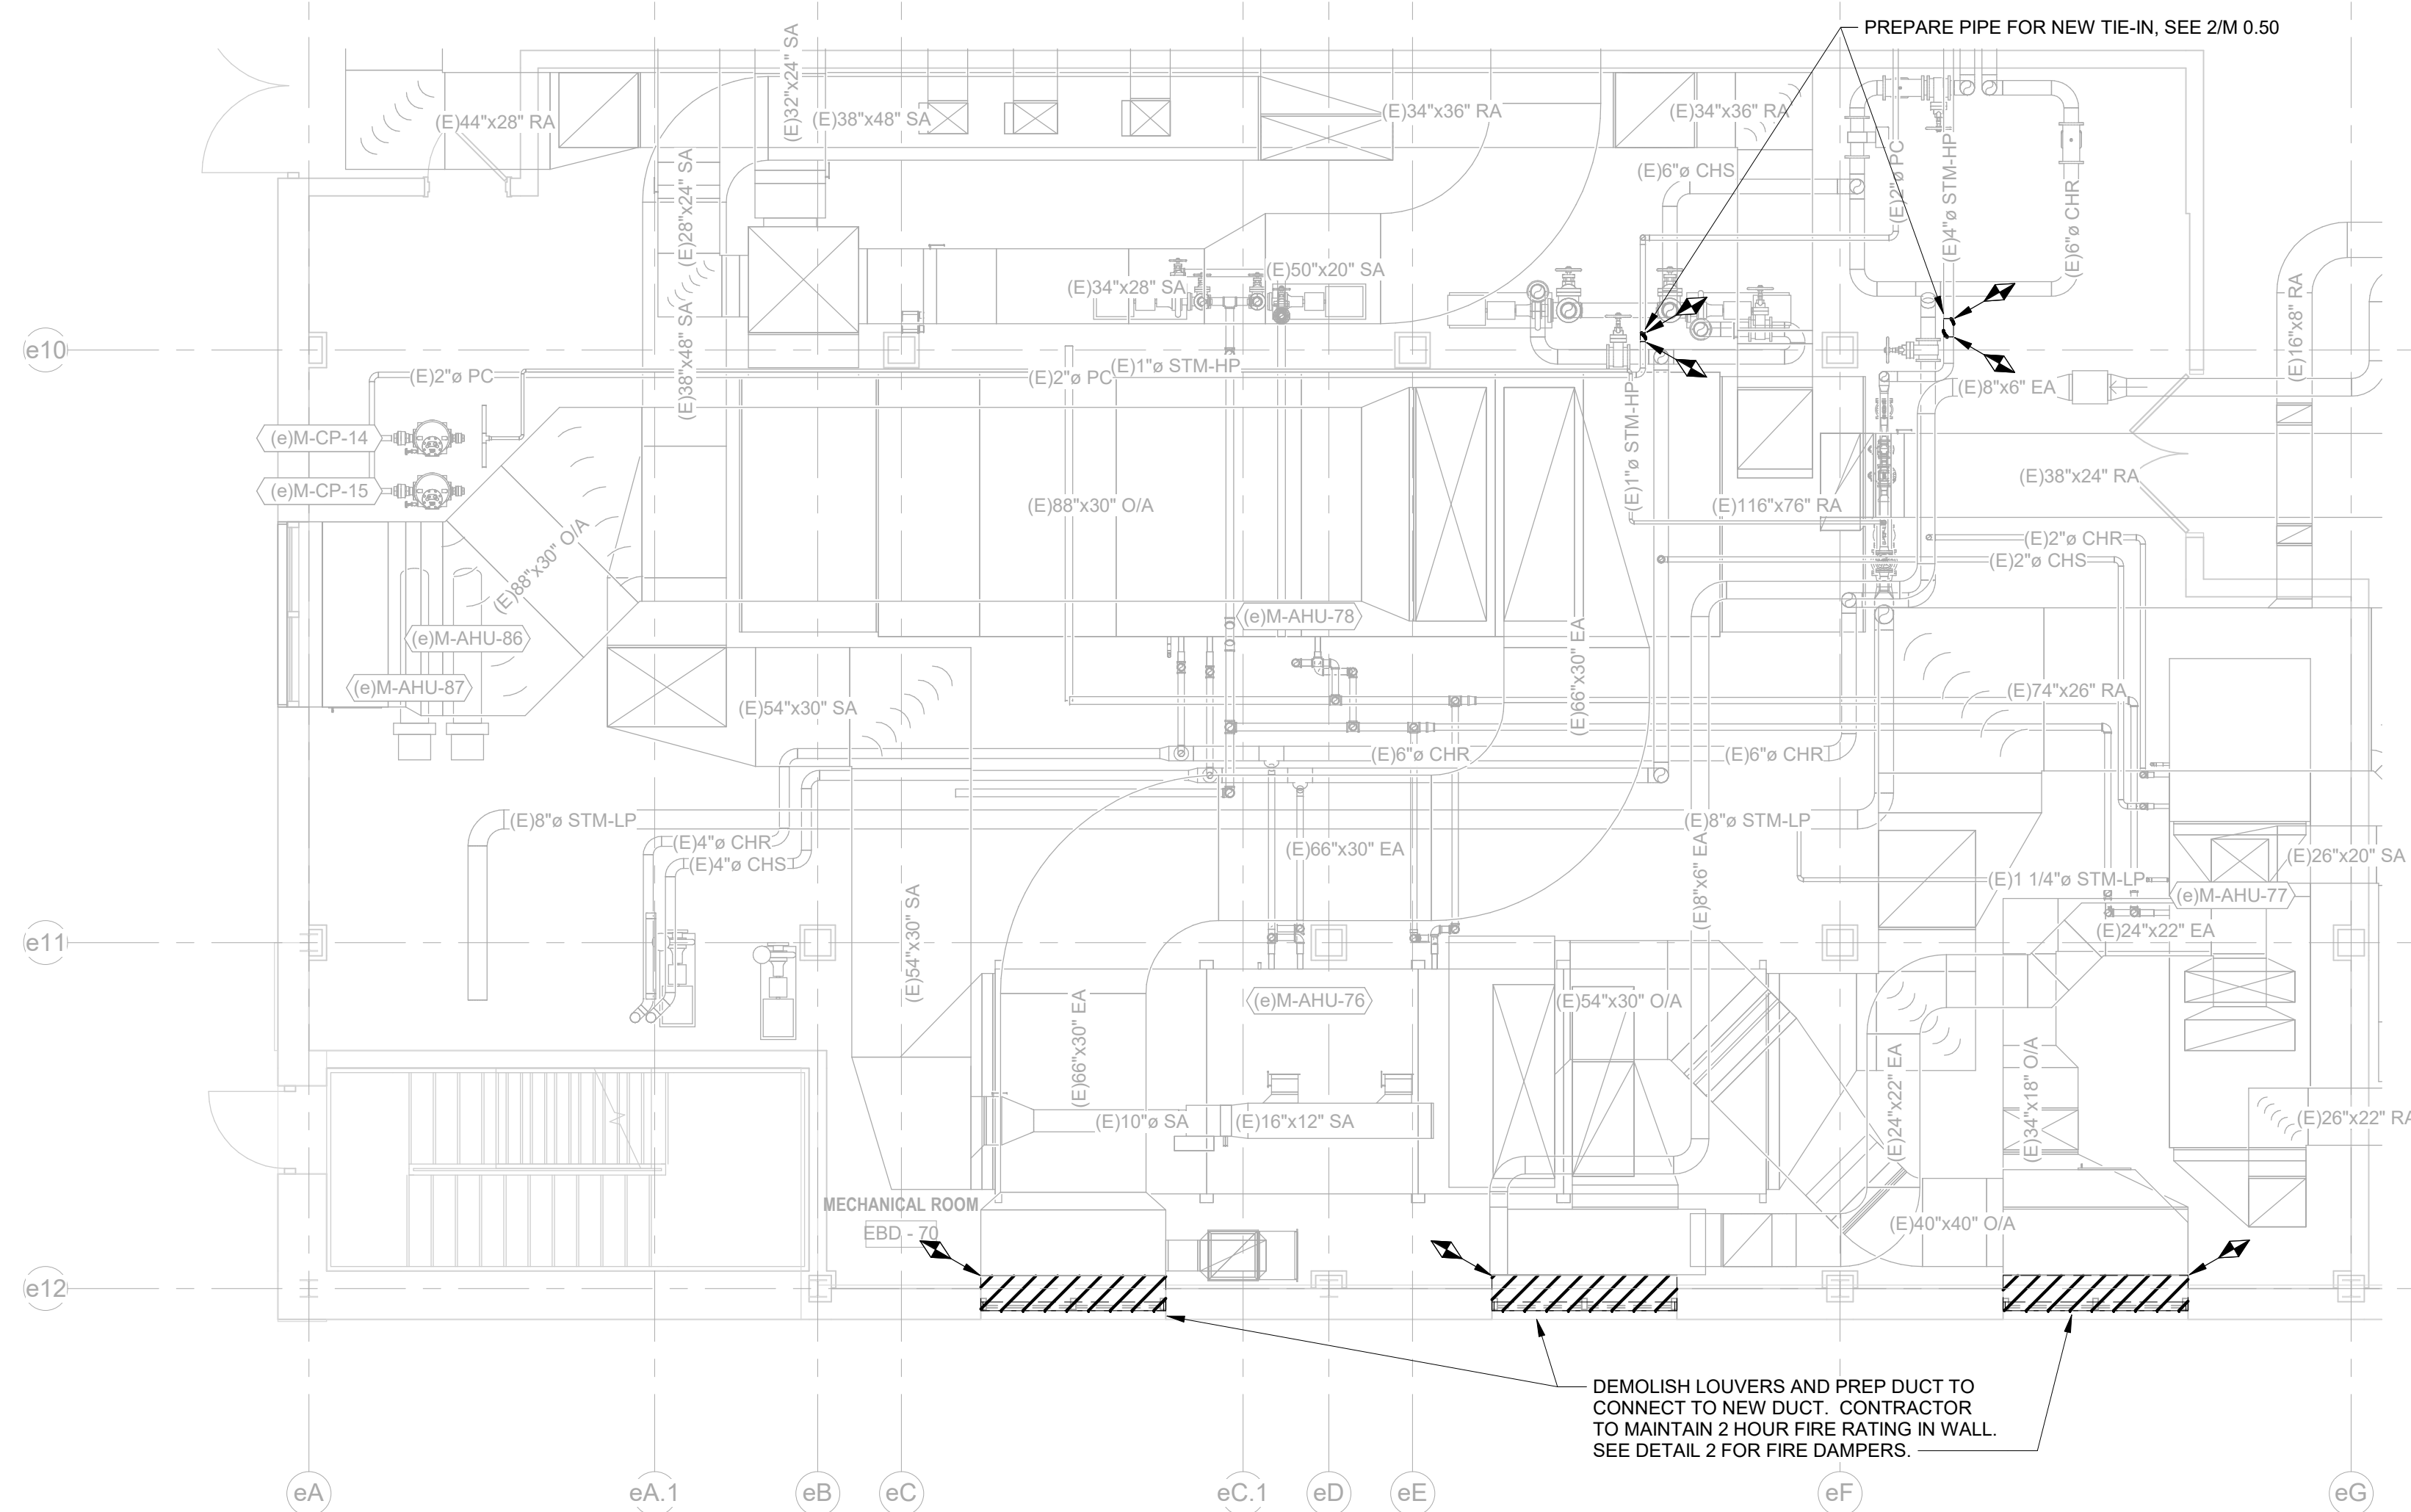
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Dwg. 102 of 128

Office of Construction and Facilities Management

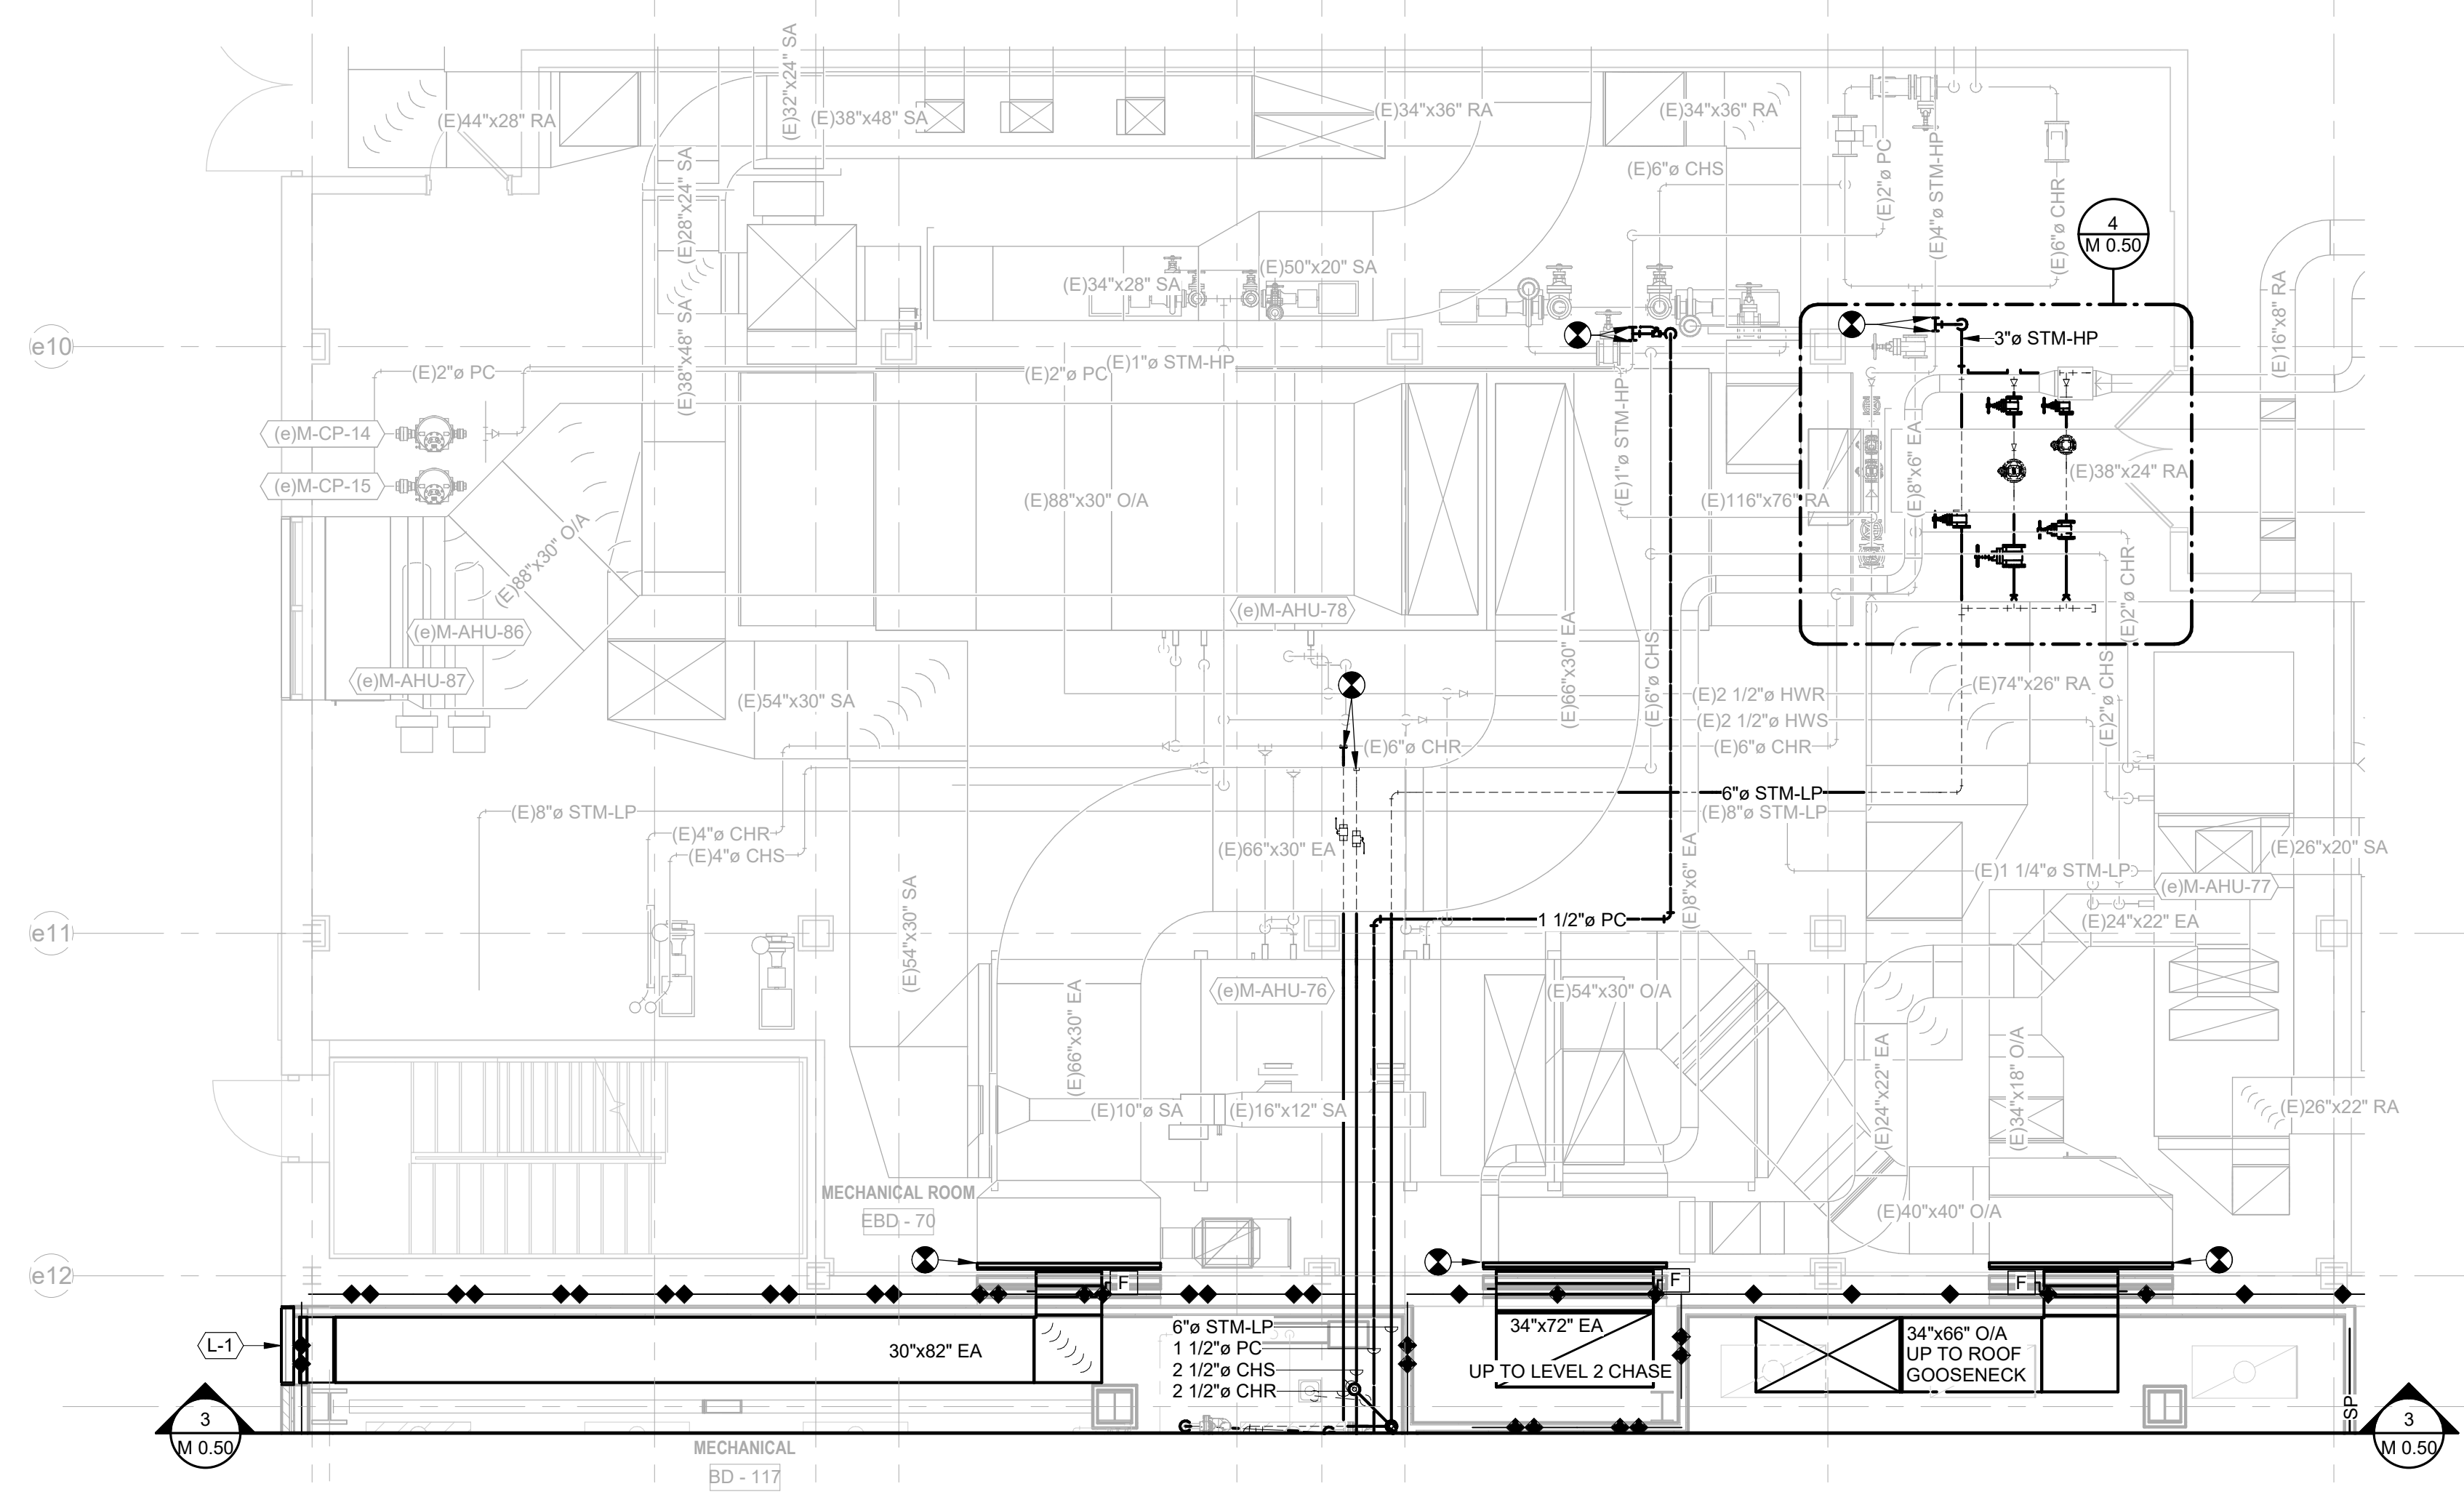
Department of Veterans Affairs

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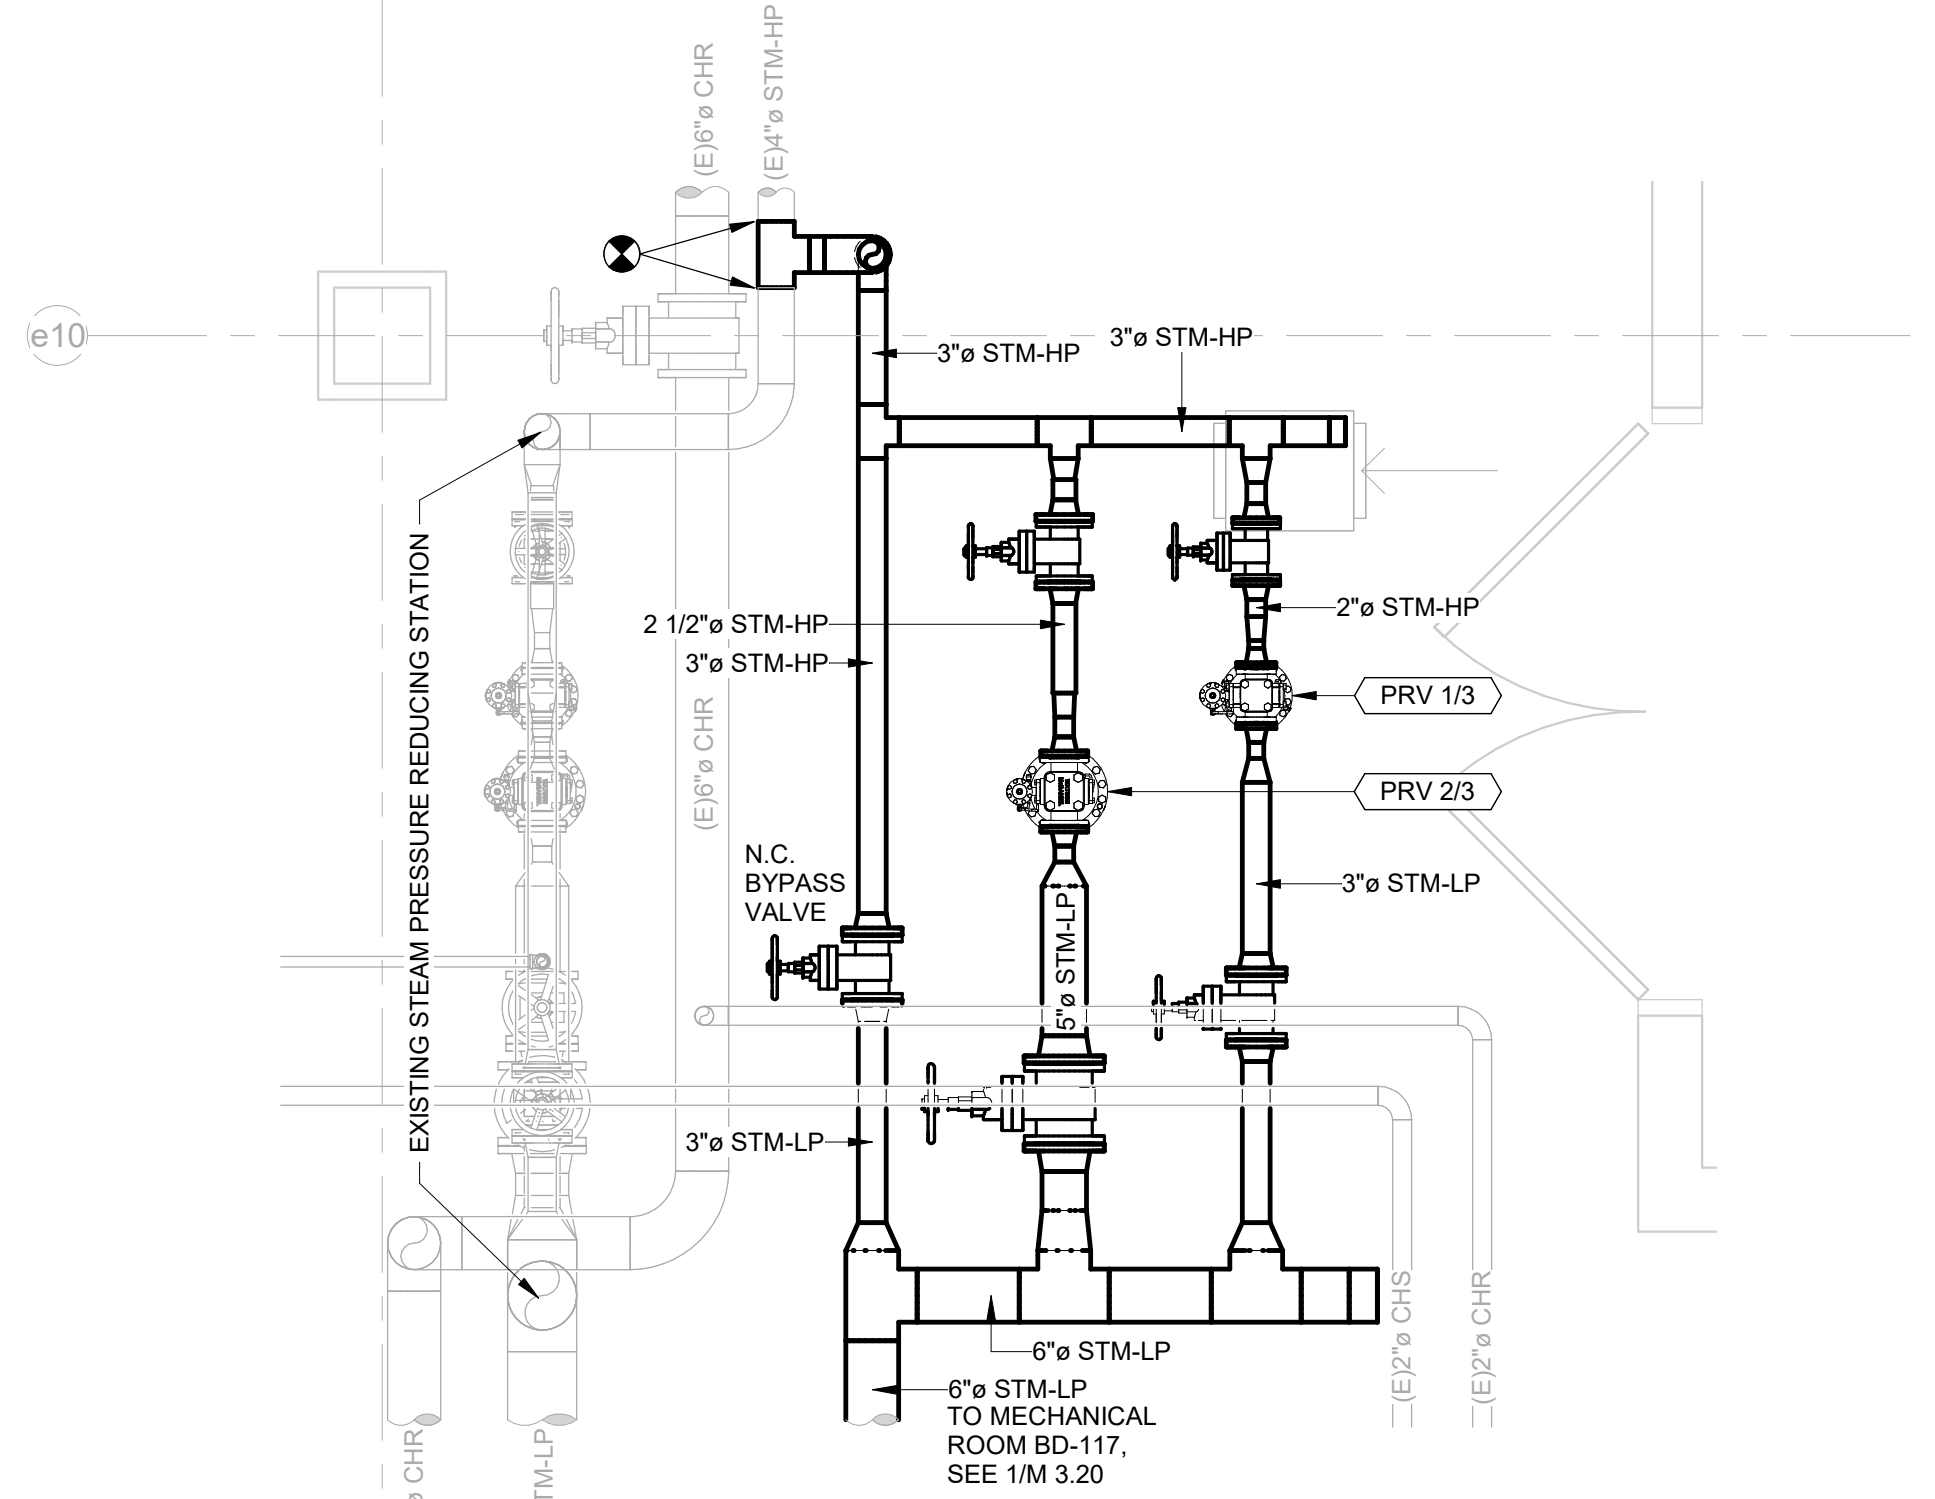
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 three quarters inch = one foot
 three eighths inch = one foot
 one quarter inch = one foot
 one eighth inch = one foot



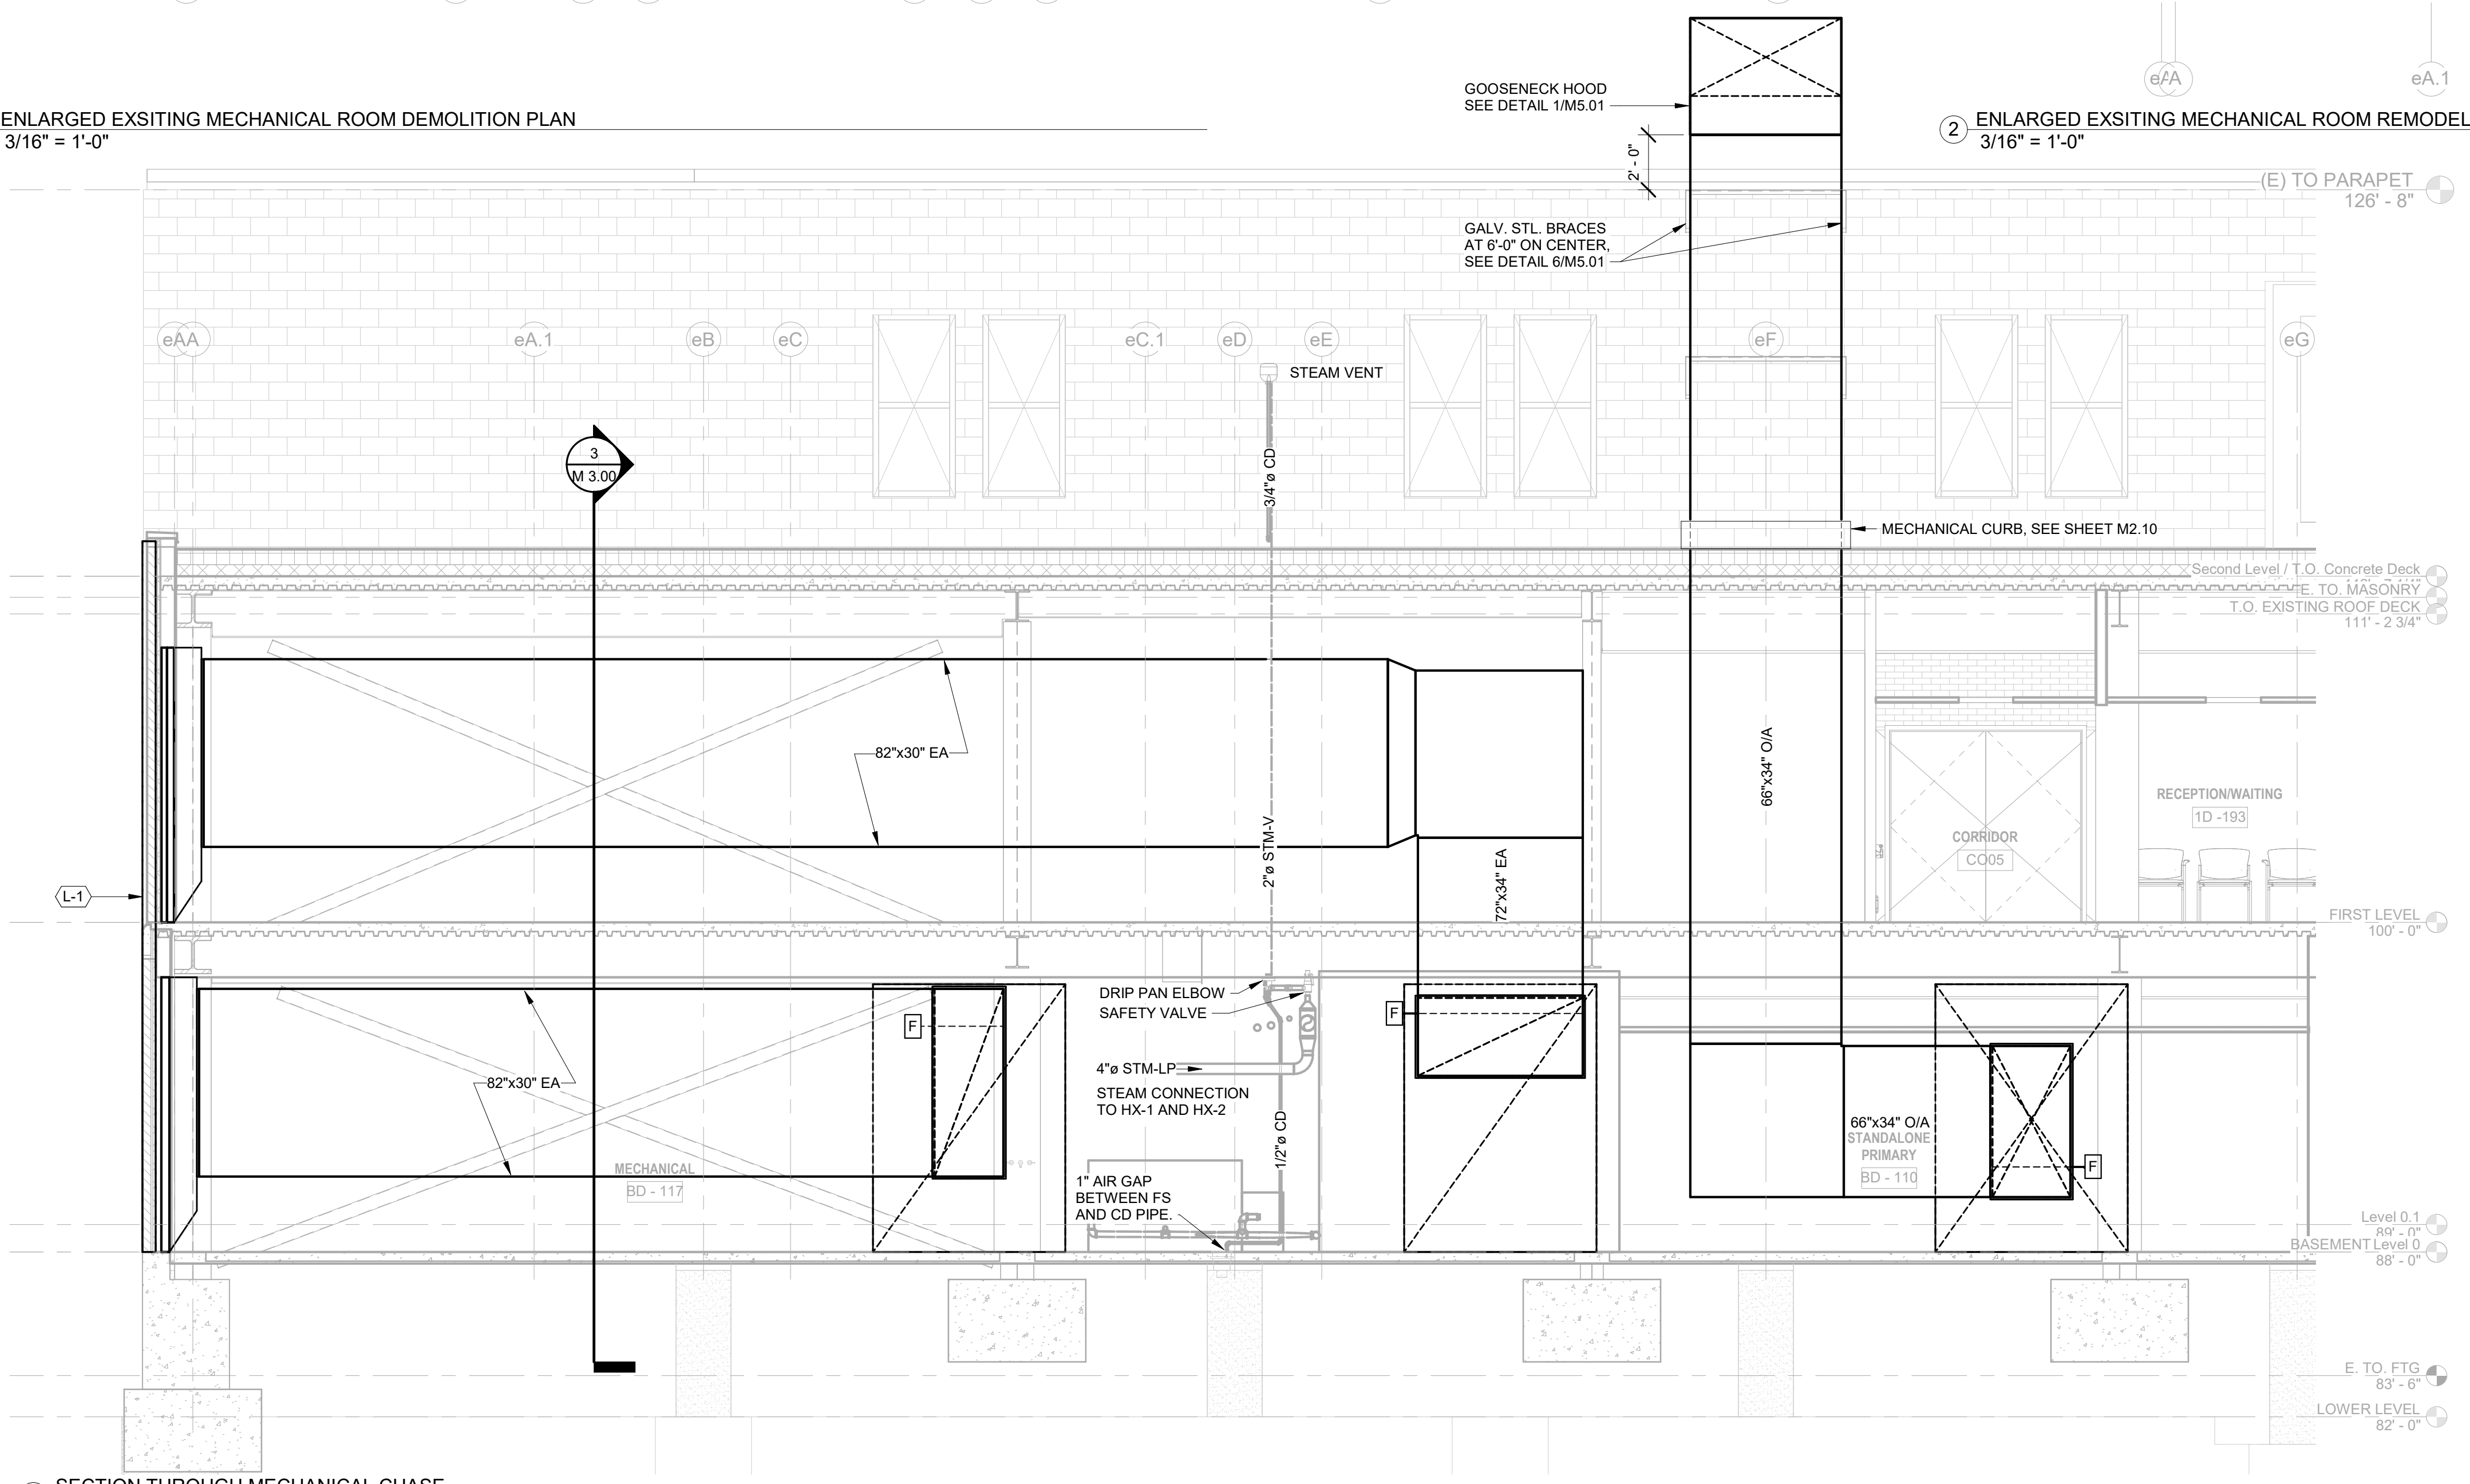
1 ENLARGED EXSISTING MECHANICAL ROOM DEMOLITION PLAN
 3/16" = 1'-0"



2 ENLARGED EXSISTING MECHANICAL ROOM REMODEL PLAN
 3/16" = 1'-0"



4 ENLARGED STEAM PRESSURE REDUCING STATION PLAN
 1/2" = 1'-0"



3 SECTION THROUGH MECHANICAL CHASE
 1/4" = 1'-0"

CONSTRUCTION DOCUMENTS

Revisions:	Date:

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Drawing Title
Existing Mechanical Room Plans

Approved: Project Director
FARGO VAHCS

Project Title
EXPAND BLDG. 1 FOR PRIMARY CARE

Location
**2101 ELM STREET
 FARGO, ND 58102**

Date
 11/16/2021

Checked
 MK

Drawn
 JB

Project Number
 437-315

Building Number
1

Drawing Number
M 0.50

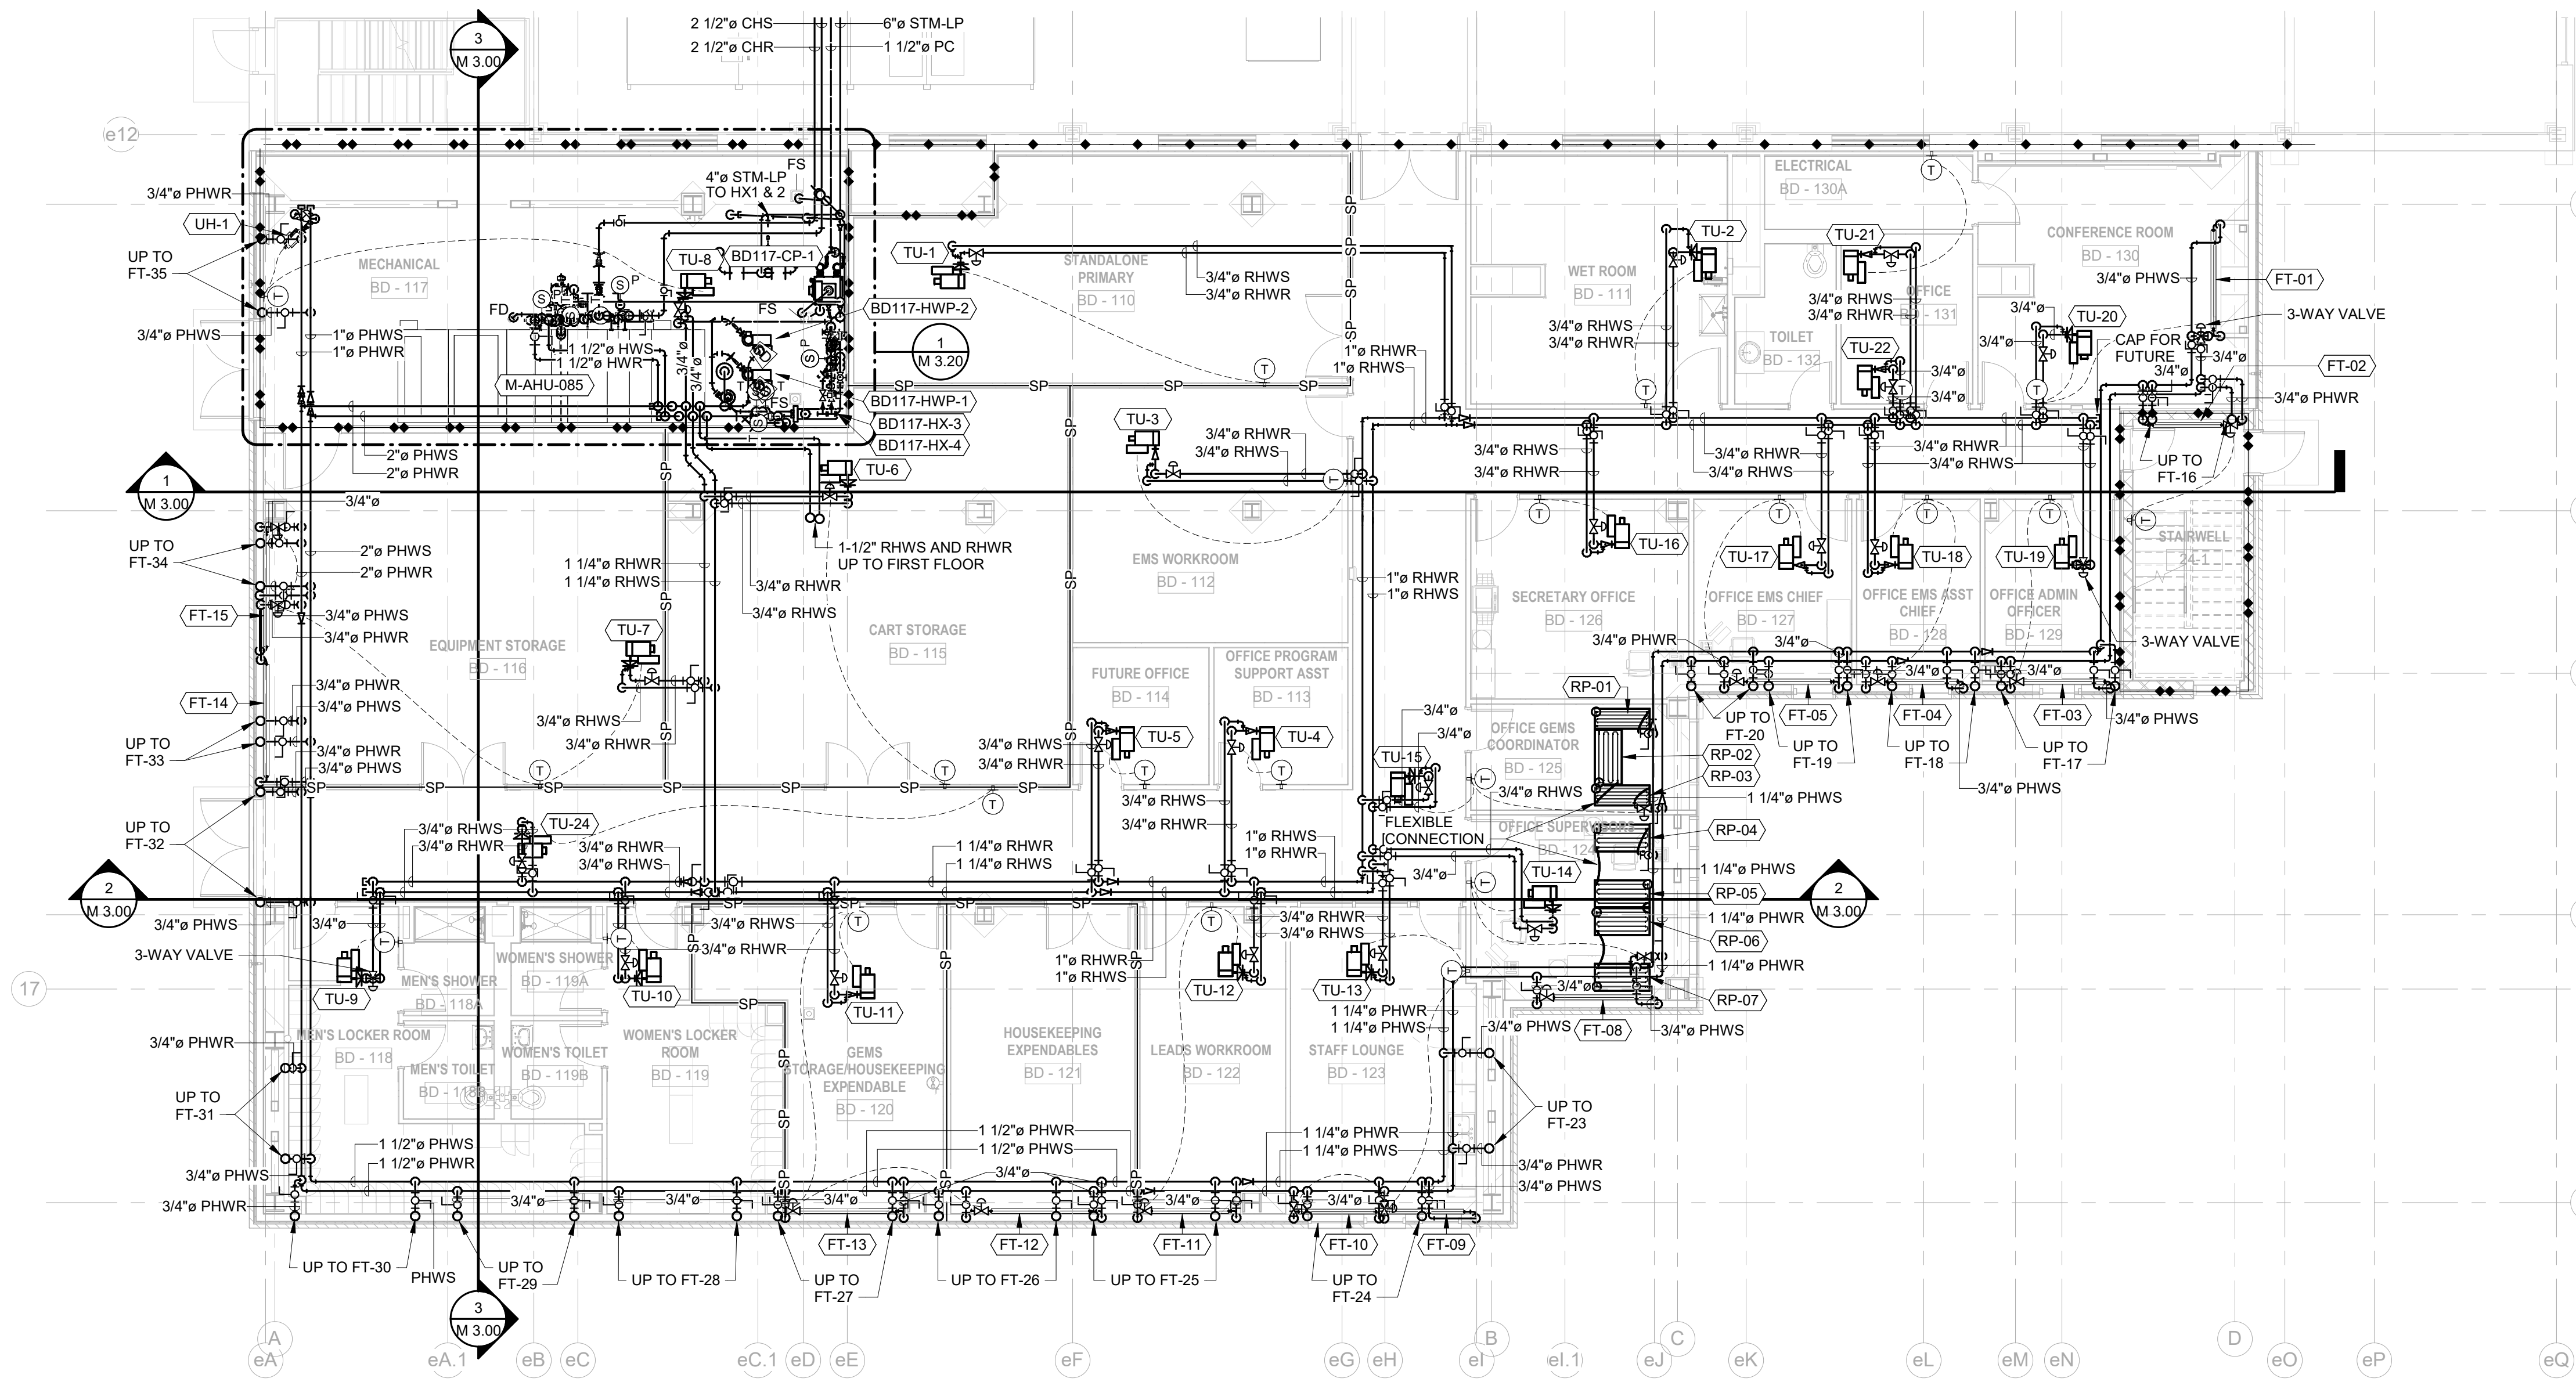
Dwg. 103 of 128

Office of Construction and Facilities Management

Department of Veterans Affairs

GENERAL NOTES

- A. ALL BRANCH PIPE SIZES TO FIN-TUBE RADIATORS, RADIANT CEILING PANELS AND TERMINAL UNITS ARE 3/4" Ø PIPE, UNLESS NOTED OTHERWISE.



① BASEMENT HYDRONIC PIPING PLAN
1/8" = 1'-0"

CONSTRUCTION DOCUMENTS

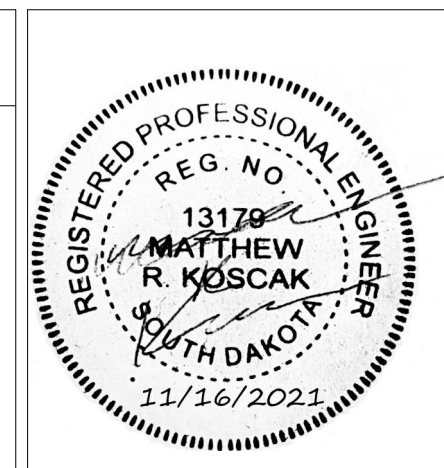
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Drawing Title

Basement Hydronic Piping Plan

Approved: Project Director

FARGO VAHCS

Project Title

EXPAND BLDG. 1 FOR
PRIMARY CARE

Location 2101 ELM STREET
FARGO, ND 58102

Date 11 / 16 / 2021

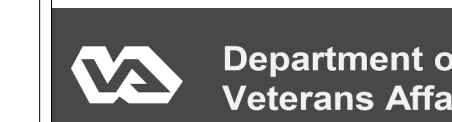
Project Number

437-315
Building Number
1

Drawing Number

M 1.00
Dwg. 104 of 128

Office of
Construction
and Facilities
Management



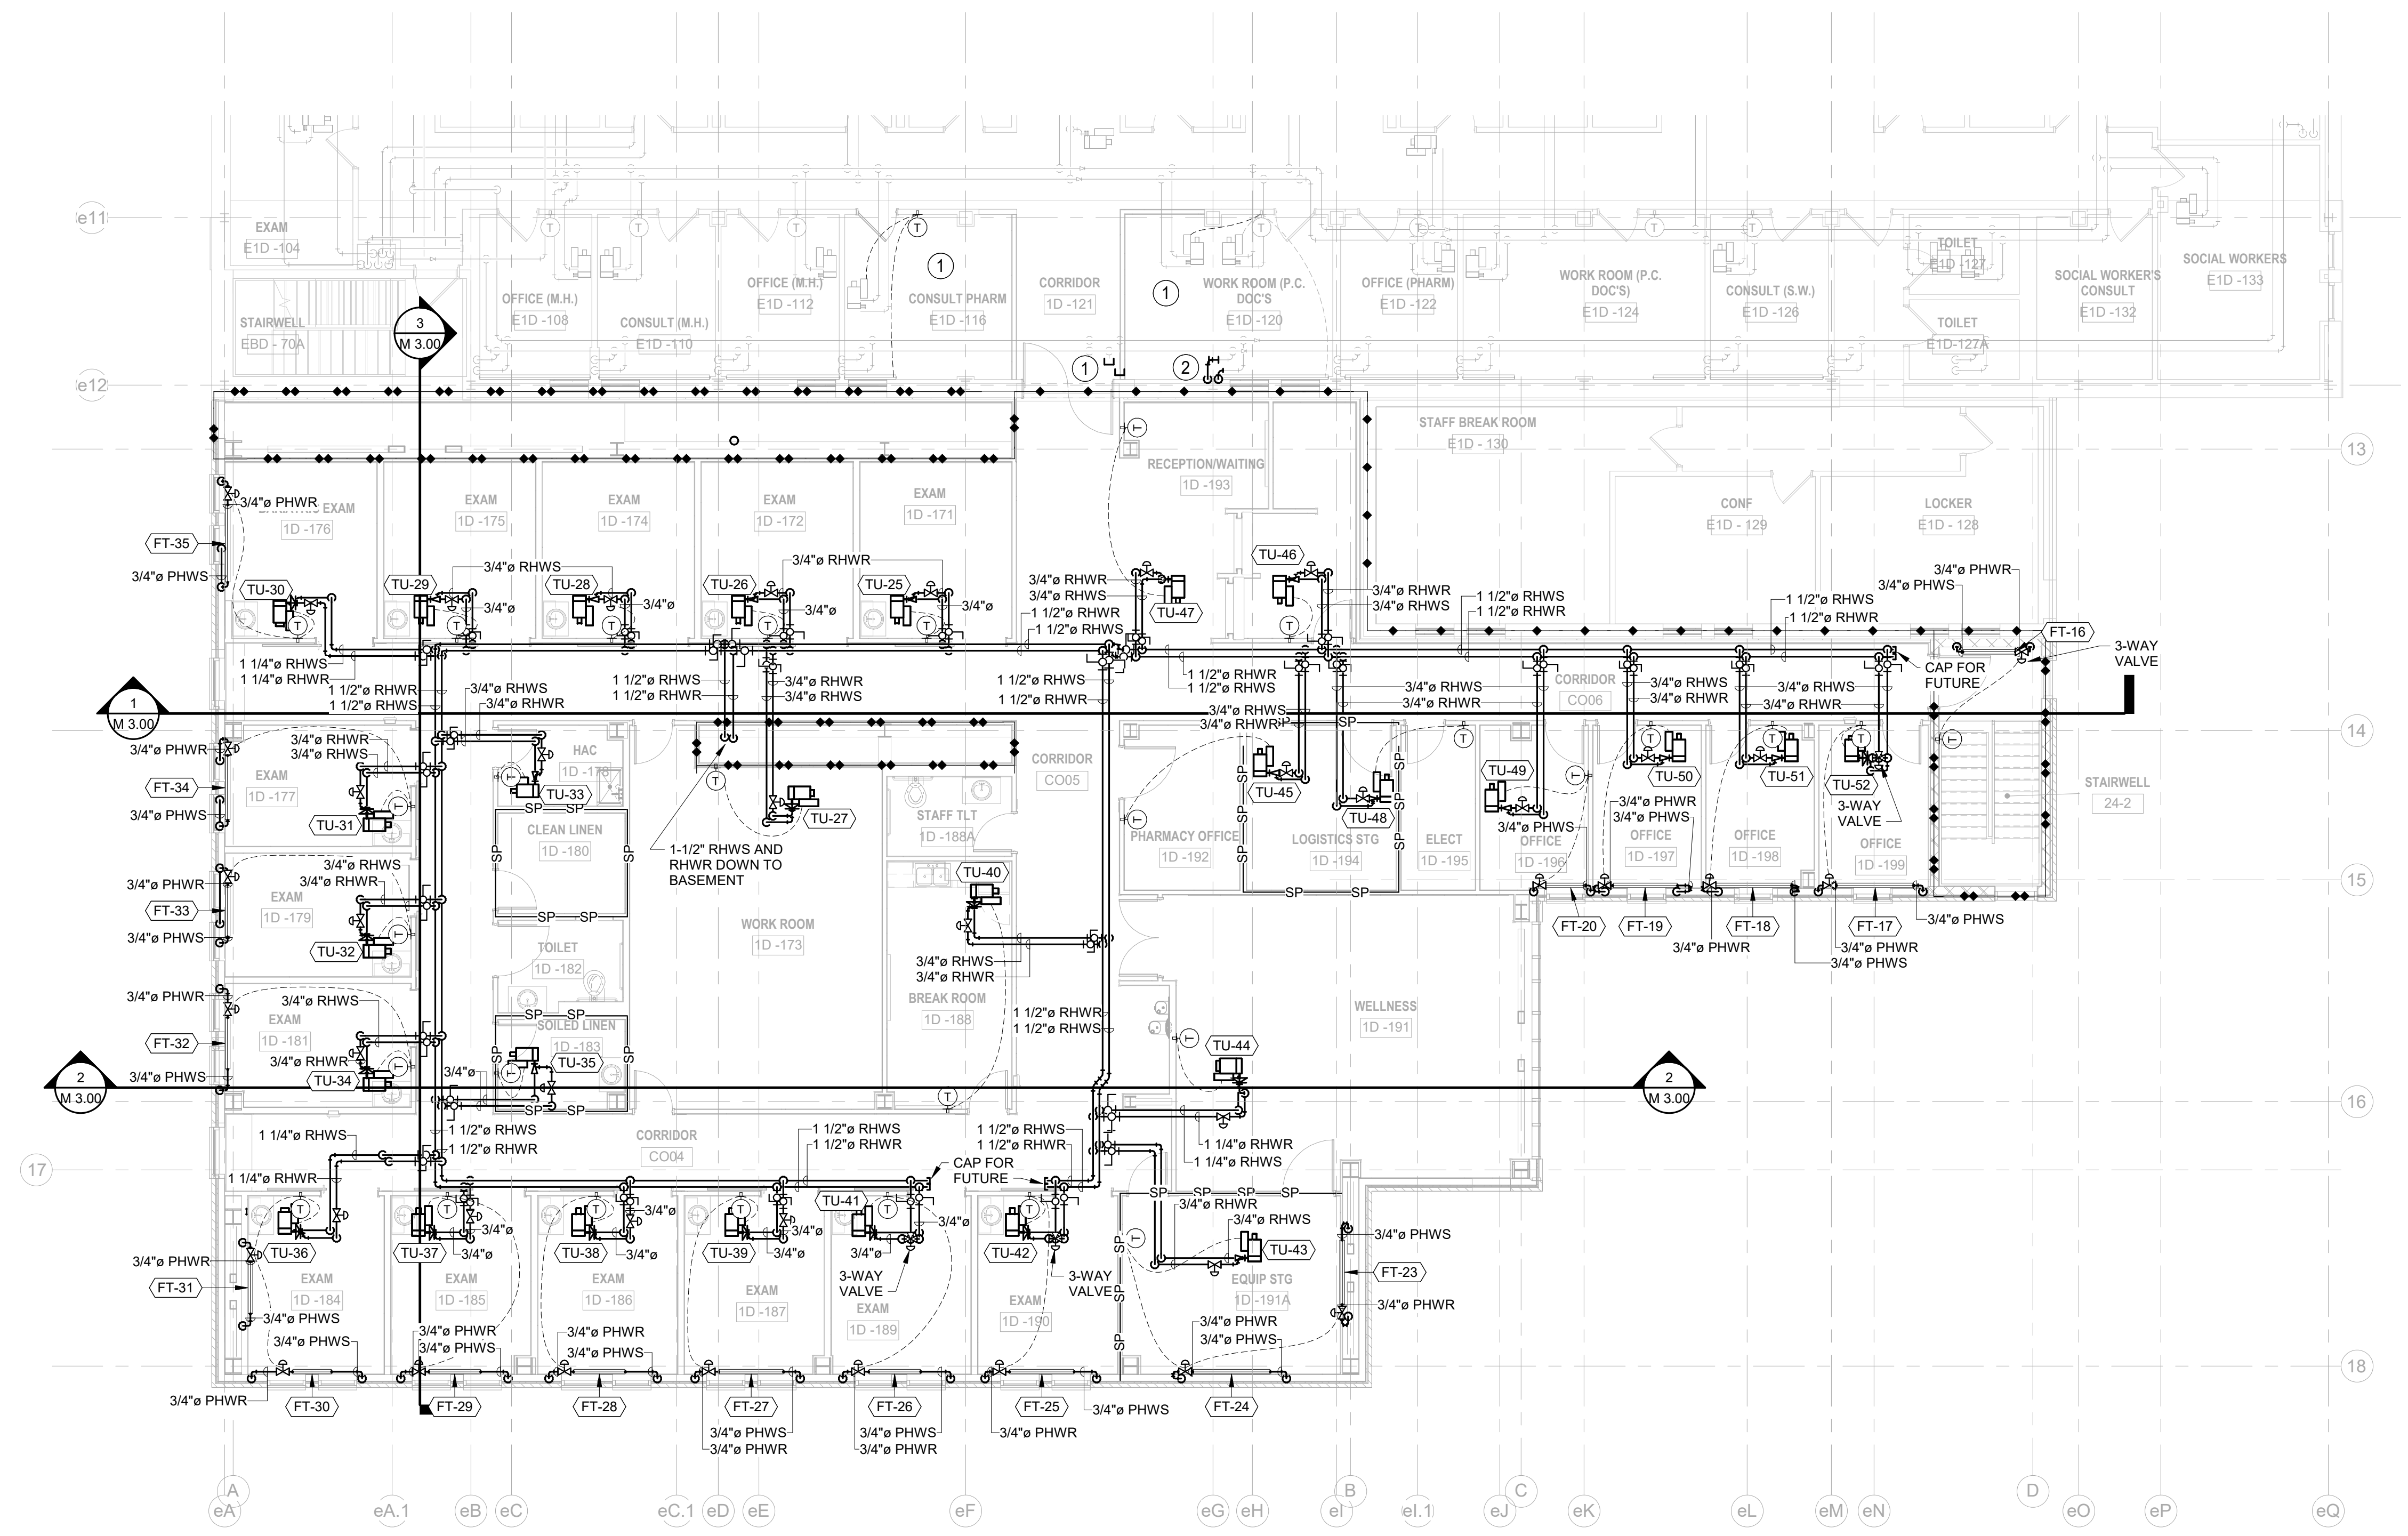
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 one eighth inch = one foot
 one quarter inch = one foot
 three eighths inch = one foot
 three quarters inch = one foot
 one half inch = one foot
 one and one half inches = one foot
 one and one half inches = one foot

GENERAL NOTES

- A. ALL BRANCH PIPE SIZES TO FIN-TUBE RADIATORS AND TERMINAL UNITS ARE 3/4"Ø PIPE, UNLESS NOTED OTHERWISE.

SPECIFIC NOTES

- ① SEE 2/M 2.01 FOR DEMOLITION OF BASEBOARD, PIPING AND THERMOSTATS FOR THIS AREA.
- ② REROUTE PIPES AS NEEDED TO RECONNECT EXISTING FIN-TUBE RADIATOR.



① Level 1 Pipe Plan DOC
 1/8" = 1'-0"

CONSTRUCTION DOCUMENTS

Revisions:	Date

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Drawing Title
First Floor Hydronic Piping Plan

Approved: Project Director
FARGO VAHCS

Project Title
EXPAND BLDG. 1 FOR PRIMARY CARE

Project Number
 437-315
 Building Number
1

Location
 2101 ELM STREET
 FARGO, ND 58102

Date
 11 / 16 / 2021

Checked
 MK

Drawn
 JB

Drawing Number
M 1.01

Dwg. 105 of 128

Office of Construction and Facilities Management

Department of Veterans Affairs