



LOCATION	TYPE OF PANEL	GAGES	SERVICE INDICATOR LIGHTS					
BOILER PLANT CONTROL OFFICE -OR- ENGINEERING CONTROL CENTER (ECC) -OR- OTHER LOCATION WITH ENGINEERING PERSONNEL SUPERVISION -AND- INTENSIVE CARE NURSING -OR- FIRE STATION -OR- PHONE SWITCHBOARD -OR- SECURITY OFFICE	MASTER (SYSTEM) ALARM PANEL	NO	LIQUID OXYGEN LEVEL LOW OXYGEN RESERVE SWITCHOVER OXYGEN RESERVE IN USE OXYGEN RESERVE LOW LIQUID LEVEL OXYGEN RESERVE PRESSURE LOW OXYGEN MAIN LINE PRESSURE LOW OXYGEN MAIN LINE PRESSURE HIGH NITROUS OXIDE CHANGE OVER TO SECONDARY NITROUS OXIDE RESERVE IN USE NITROUS OXIDE MAIN LINE PRESSURE LOW NITROUS OXIDE MAIN LINE PRESSURE HIGH NITROGEN CHANGE OVER TO SECONDARY NITROGEN RESERVE IN USE NITROGEN RESERVE IN USE NITROGEN MAIN LINE PRESSURE LOW NITROGEN MAIN LINE PRESSURE HIGH MEDICAL AIR DEWPOINT HIGH MA COMPRESSOR MALFUNCTION MEDICAL AIR MAIN LINE PRESSURE HIGH MA SYSTEM CARBON MONOXIDE HIGH DESICCANT DRYER MALFUNCTION DESICCANT DRYER MALFUNCTION DESICCANT DRYER POST FILTER DIRTY MAIN LINE FILTER BANK DIRTY MA REFRIGERATED DRYER POST FILTER DIRTY AFTER COOLER HIGH AIR TEMPERATURE MEDICAL VACUUM LINE VACUUM LOW MEDICAL VACUUM FILTER BACK PRESSURE TEST BUTTON					
SURGERY CONTROL ROOM	AREA ALARM PANEL	YES	OXYGEN LINE PRESSURE ABNORMAL NITROUS OXIDE LINE PRESSURE ABNORMAL NITROGEN LINE PRESSURE ABNORMAL MEDICAL AIR LINE PRESSURE ABNORMAL MEDICAL VACUUM LINE VACUUM LOW TEST BUTTON					
RECOVERY ROOMS CRITICAL CARE AREAS EMERGENCY AREAS PATIENT AREAS	AREA (ZONE) ALARM PANEL	YES	OXYGEN LINE PRESSURE ABNORMAL NITROUS OXIDE LINE PRESSURE ABNORMAL NITROGEN LINE PRESSURE ABNORMAL MEDICAL AIR LINE PRESSURE ABNORMAL MEDICAL VACUUM LINE VACUUM LOW TEST BUTTON					

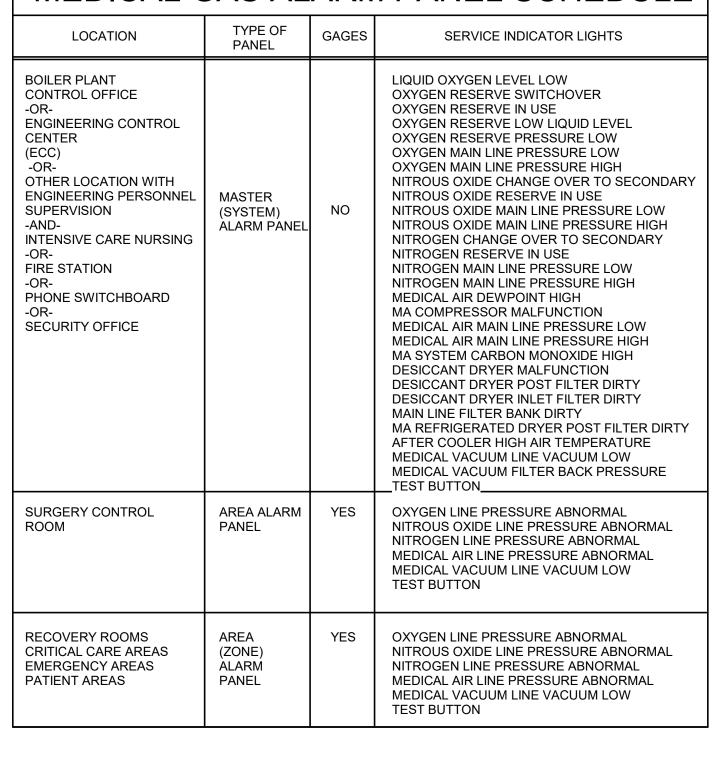


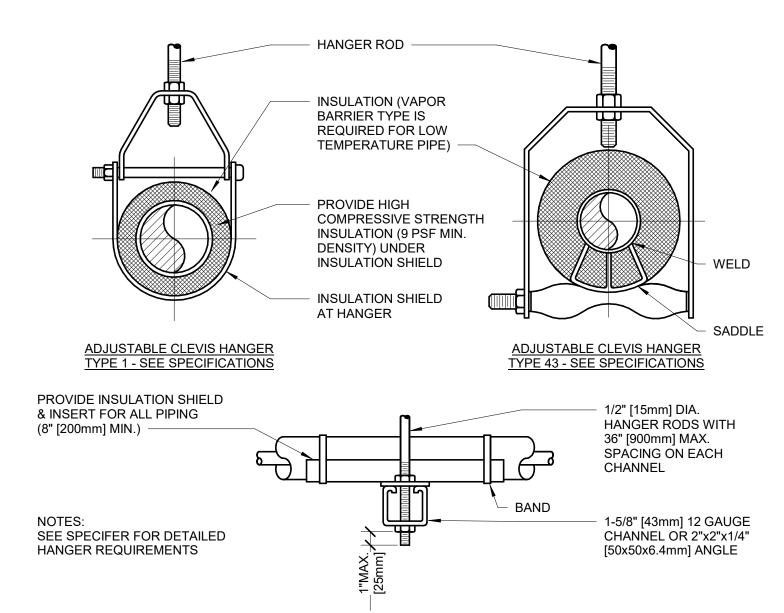

### SIDE VIEW TRAPEZE HANGER FOR UP TO 1000 LB. [453KG] UNIFORM LOAD

MAXIMUM PIPE/TUBING SUPPORT SPACING																			
NOM. SIZE	FT. [mm]	THRU 3/4 THRU [20]	1 [25]	1 1/4 [32]	1 1/2 [40]	2 [50]	2 1/2 [65]	3 [75]	4 [100]	5 [125]	6 [150]	8 [200]	10 [250]	12 [300]	14 [350]	16 [400]	18 [450]	20 [500]	24 [600]
PIPE	FT. [mm]	7 [2100]	7 [2100]	7 [2100]	9 [2700]	10 [3000]	11 [3400]	12 [3700]	14 [4100]	16 [4900]	17 [5200]	19 [5800]	22 [6700]	23 [7000]	25 [7600]	27 [8200]	28 [8500]	30 [9100]	32 [9600]
TUBING	FT. [mm]	5 FT [1500]	6 [1800]	7 [2100]	8 [2400]	8 [2400]	9 [2700]	10 [3000]	12 [3700]	13 [4000]	14 [4100]	16 [4900]	-	-	-	-	-	-	-
NOTE: FOR TRAPEZE HANGER TAKE SPACING OF SMALLEST SIZE ON TRAPEZE.																			



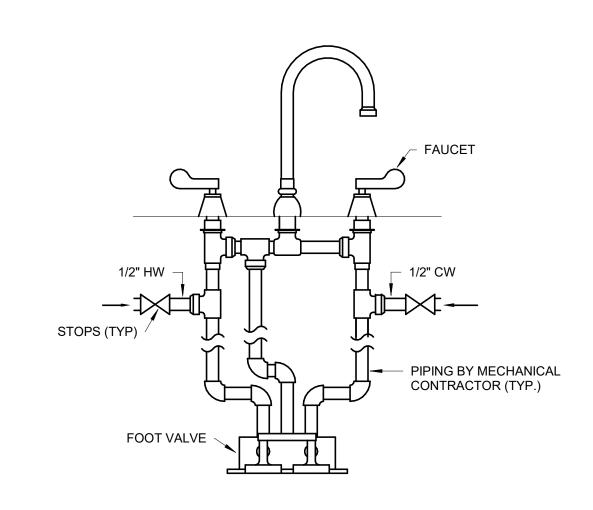

DOUBLE FAUCET CONTROL DETAIL

SCALE: NO SCALE

### MEDICAL GAS SYSTEM: DETAILS AND NOTES

### MEDICAL GAS PIPING

PIPING LAYOUT IS DIAGRAMMATIC ONLY. INSTALLING CONTRACTOR SHALL BE RESPONSIBLE FIELD VERIFICATION AND COORDINATION OF ACTUAL LOCATIONS AND COORDINATE WITH


ALL PRESSURE GAS PIPING SHALL BE INSTALLED BY THE PLUMBING CONTRACTOR AND SHALL HARD-DRAWN SEAMLESS TYPE "K" OR "L" COPPER TUBING (ASTM B-819) AND BEAR ONE OF THE FOLLOWING MARKING: OXY, MED, OXY/MED, ACR/OXY, OR ACR/MED. TYPE "K" ONLY FOR

ALL VACUUM PIPING SHALL BE INSTALLED BY THE PLUMBING CONTRACTOR AND SHALL BE HARD-DRAWN SEAMLESS TYPE "M" COPPER TUBING (ASTM B88) OR TYPE "L" COPPER MEDICAL GAS TUBING (ASTM B-819). SUPPORT PIPING AS FOLLOWS:

1-1/2" AND LARGER 10 FT

TRADES.

ALL MEDICAL GAS EQUIPMENT SHALL BE PROVIDED BY A SINGLE SOURCE SUPPLIER WITH A MINIMUM 10 YEARS EXPERIENCE WITH MEDICAL GAS SYSTEM MAINTENANCE, CERTIFICATION

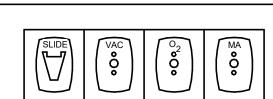

ROOMS #511, 512, 518, 519 48" AFF

## 100% CONSTRUCTION DRAWINGS


**CONSULTANTS:** PHONE: (605) 362-3753 • FAX: (605) 362-3759

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**ARCHITECTS/ ENGINEERS:** ARCHITECTS

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Drawing Title PLUMBING DETAILS

Project Title 438-15-201 V.A. HEALTH CARE SYSTEM RENOVATE 5TH FLOOR SURGERY **Building Number** 

Drawing Number SIOUX FALLS, SOUTH DAKOTA 5-PL501 Checked DNT OCTOBER 17, 2017 | WM

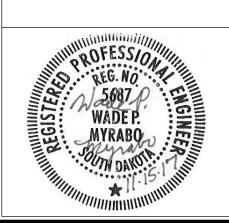Construction and Facilities Management

Office of

Dwg. 34 of 60

PLUMBING FIXTURE SCHEDULE WASTE VENT CW HW TYPE NUMBER MANUFACTURER TRIM/REMARKS 415B 2" OUTLET FLOOR DRAIN 2" 1 1/2" 3" 1 1/2" 3" OUTLET FLOOR DRAIN **GUY-GRAY** ICE MAKER BOX GUY-GRAY OUTLET BOX ZURN Z5645-BWL WATER CLOSET (FLOOR MOUNTED FLUSH VALVE - BACK OUTLET) 1.6 GPF, ADA BARIATRIC WATER CLOSET (FLOOR MOUNTED FLUSH VALVE - BACK OUTLET) 1.6 GPF, ADA 2125-A 2" 1 1/2" 1/2" 1/2" ZURN Z831B4-XL LAV INTERGRAL WITH COUNTERTOP, FAUCET ONLY CAST IRON SERVICE SINK 22"X18" 2" 1 1/2" 1/2" 1/2" ZURN Z5888 3" 1 1/2" 1/2" 1/2" 4" 1 1/2" 3/4" 3/4" Z1996-24 MOP SERVICE SINK ZURN CLINIC SERVICE SINK Z5420 2" 1 1/2" 1/2" 1/2" SINGLE COMPARTMENT SS WALL MOUNTED SCRUB SINK WITH DOUBLE PEDAL FOOT VALVE EWS2520FC SINGLE COMPARTMENT SS COUNTERTOP SINK, 1.5 GPM LAMINAR FLOW WITH FOOT PEDAL CONTROLS LRAD221965 2" 1 1/2" 1/2" 1/2" ELKAY LRAD221965 SINGLE COMPARTMENT SS COUNTERTOP SINK, 1.5 GPM LAMINAR FLOW 2" 1 1/2" 1/2" 1/2" 1/2" WATER CHILLER WITH BOTTLE FILLER (SPLIT LEVEL) ADA EZSTL8WSLK ELKAY 608 ADA SHOWER ASSEMBLY W/ SLIDE BAR AND HANDWALL SHOWER 2.5 GPM Z7300-SS-HW-MT ZURN BRADLEY S19-220FW EYE/FACE WASH FIXTURE WITH WALL BRACKET AND P-TRAP 2" 1 1/2"

#### COMMEN

- ZURN 415B CAST IRON FLOOR DRAIN WITH TYPE B POLISHED NICKEL BRONZE, LIGHT DUTY STRAINER AND 2" PIPE OUTLET SIZE.
- ZURN 415B CAST IRON FLOOR DRAIN WITH TYPE B POLISHED NICKEL BRONZE, LIGHT DUTY STRAINER AND 3" PIPE OUTLET SIZE.

  RECESSED ICE MAKER BOX WITH 1/2" SUPPLY GATE VALVE, CAPPED FOR FUTURE CONNECTION, FIXTURE MOUNTING HEIGHT 48" A.F.F.
- 4 PROVIDE WITH 1/2" WATER CONNECTION AND 2" WASTE CONNECTION.
- BEMIS 1955C WHITE OPEN FRONT SEAT WITH SS CHECK HINGE, VITREOUS CHINA ELONGATED BOWL SIPHON JET, DUAL FLUSH VALVE, 1.6 GPF.
  ACORN BARIATRIC FLOOR MOUNTED, TOP SUPPLY, BACK WASTE OUTLET FLUSH VALVE TOILET, OPEN FRONT, 1200 LBS RATED HINGED SEAT LESS COVER, DUAL FLUSH VALVE, 1.6 GPF.
- ZURN Z831B4-XL CHROME PLATED RIGID GOOSENECK FAUCET WITH 4" WRIST BLADE HANDLES AND VANDAL RESISTANT 1.5 GPM LAMINAR FLOW OUTLET. PROVIDE WITH 17 GAUGE CHROME PLATED P TRAP, LA12K SUPPLY KIT WITH KEYED ANGLED STOP VALVE AND TUBE RISERS, GRID DRAIN, TRUEBRO LAV PIPING SHIELD (WHITE), PROVIDE POWERS LFE480 THERMOSTATIC MIXING VALVE WITH INTERGRAL CHECK VALVES (SET TEMP. TO 110 DEG. F. MAX), ADA COMPLIANT.
- ZURN Z843M4-RC ROUGH CHROME PLATED FAUCET, ZURN TS2900-IP2 ADJUSTABLE 2" CAST IRON BODY P-TRAP W/ CHROME PLATED BRONZE STRAINER, GASKET, AND CLEAN OUT PLUG.
  ZURN Z843M4-RC, (BC) STAINLESS STEEL BUMPER GAURD, (HH) HOSE AND HOSE BRACKET, (SDL) 3" STAINLESS STEEL DRAIN WITH DOME STRAINER, (WG) STAINLESS STEEL WALL GUARD.
- SIPHON JET, VITREOUS CHINA, FLOOR MOUNTED, WITH ACORN CSB TERRAZZO CLINIC SINK BASE, ZURN Z60843AV-BWN BEDPAN WASHER FLUSH VALVE AND SERVICE SINK FAUCET WITH BEDPAN WASHER.

  STAINLESS STEEL, WALL MOUNTED, SINGLE STATION SCRUB SINK WITH ELKAY LK398C FOOT PEDAL VALVE, ELKAY 8-3/16" RIGID GOOSNECK SPOUT WITH AE19A VANDAL RESISTANT, ANTI-HOSE AERATOR. PROVIDE WITH ELKAY LK18B STAINLESS STEEL STRAINER WITH INTEGRAL TAILPIECE, P-TRAP, AND SUPPLY KIT WITH KEYED ANGLED STOP VALVE AND TUBE RISERS. PROVIDE POWERS LFE480 THERMOSTATIC MIXING VALVE WITH INTERGRAL CHECK VALVES (SET TEMP. TO 110 DEG. F. MAX),
- SINGLE COMPARTMENT STAINLESS STEEL COUNTERTOP SINK, DRAIN OUTLET IN CENTER OF BASIN, HOLE DRILLING CONFIGURATION 3 (3 HOLES AT 4" OC.). PROVIDE WITH ZURN Z831B4-XL CHROME PLATED RIGID GOOSENECK FAUCET WITH 4" WRIST BLADE HANDLES AND VANDAL RESISTANT 1.5 GPM LAMINAR FLOW OUTLET. PROVIDE ZURN Z85500-XL DOUBLE FOOT PEDAL VALVE PROVIDE WITH 17 GAUGE CHROME PLATED P TRAP, EBC SB8H STRAINER, AND LA12K SUPPLY KIT WITH KEYED ANGLED STOP VALVE AND TUBE RISERS. PROVIDE POWERS LFE480 THERMOSTATIC MIXING VALVE WITH INTERGRAL CHECK VALVES (SET TEMP. TO 110 DEG. F. MAX), SEE ARCHITECTURAL PLANS FOR COUNTERTOP ELEVATIONS. COORDINATE SINK OPENING WITH COUNTERTOP MILLWORK.
- SINGLE COMPARTMENT STAINLESS STEEL COUNTERTOP SINK, DRAIN OUTLET IN CENTER OF BASIN, HOLE DRILLING CONFIGURATION 3 (3 HOLES AT 4" OC.). PROVIDE WITH ZURN Z831B4-XL CHROME PLATED RIGID GOOSENECK FAUCET WITH 4" WRIST BLADE HANDLES AND VANDAL RESISTANT 1.5 GPM LAMINAR FLOW OUTLET. PROVIDE WITH 17 GAUGE CHROME PLATED P TRAP, EBC SB8H STRAINER, AND LA12K SUPPLY KIT WITH KEYED ANGLED STOP VALVE AND TUBE RISERS. PROVIDE POWERS LFE480 THERMOSTATIC MIXING VALVE WITH INTERGRAL CHECK VALVES (SET TEMP. TO 110 DEG. F. MAX), SEE ARCHITECTURAL PLANS FOR COUNTERTOP ELEVATIONS. COORDINATE SINK OPENING WITH COUNTERTOP MILLWORK.
- 4 WATER COOLER WITH ELECTRONIC SENSOR OPERATED BOTTLE FILLER. PROVIDE WITH 17 GAUGE P TRAP AND EBC VA12K KEYED ANGLED STOP VALVE.
- SHOWER TRIM, LEVER VOLUME CONTROL HANDLE, THERMOSTATIC VALVE CARTRIDGE, PERSONAL HAND HELD SHOWER 51701, 60 FLEXIBLE METAL HOSE HAND SPRAYER

  16 PROVIDE WITH STAINLESS STEEL BASIN, EYE/FACE WASH, STAINLESS STEELHANDLE AND FOOT ACTIVATION ACTIVATION, DUST/BAR COVER, STAINLESS STEEL BALL VALVE, SCALD PROTECTION VALVE, MIXING VALVE AND INLINE STRAINER. PROVIDE WITH BRADLEY S19-2000 EFX8 EMERGENCY THERMOSTATIC MIXING VALVE.

# 100% CONSTRUCTION DRAWINGS

CONSULTANTS:

WPE #: BS15052

WEST


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ARCHITECTS/ ENGINEERS:

MARCHITECTS/ ENGINEERS:

ARCHITECTS/ ENGINEERS:

625 S. MINNESOTA AVENUE, SUITE 204

SIOUX FALLS, SOUTH DAKOTA 57104-4873

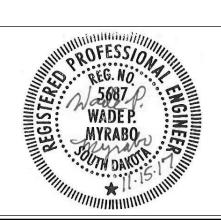TELE: (605) 332-7850 FAX: (605) 332-3539

Approved: Pro

Drawing Title

PLUMBING SCHEDULES

Approved: Project Director

Project Title

V.A. HEALTH CARE SYSTEM
RENOVATE 5TH FLOOR SURGERY


Location
SIOUX FALLS, SOUTH DAKOTA


Project Number
438-15-201


Building Number
5

Office of Construction and Facilities Management

sions:

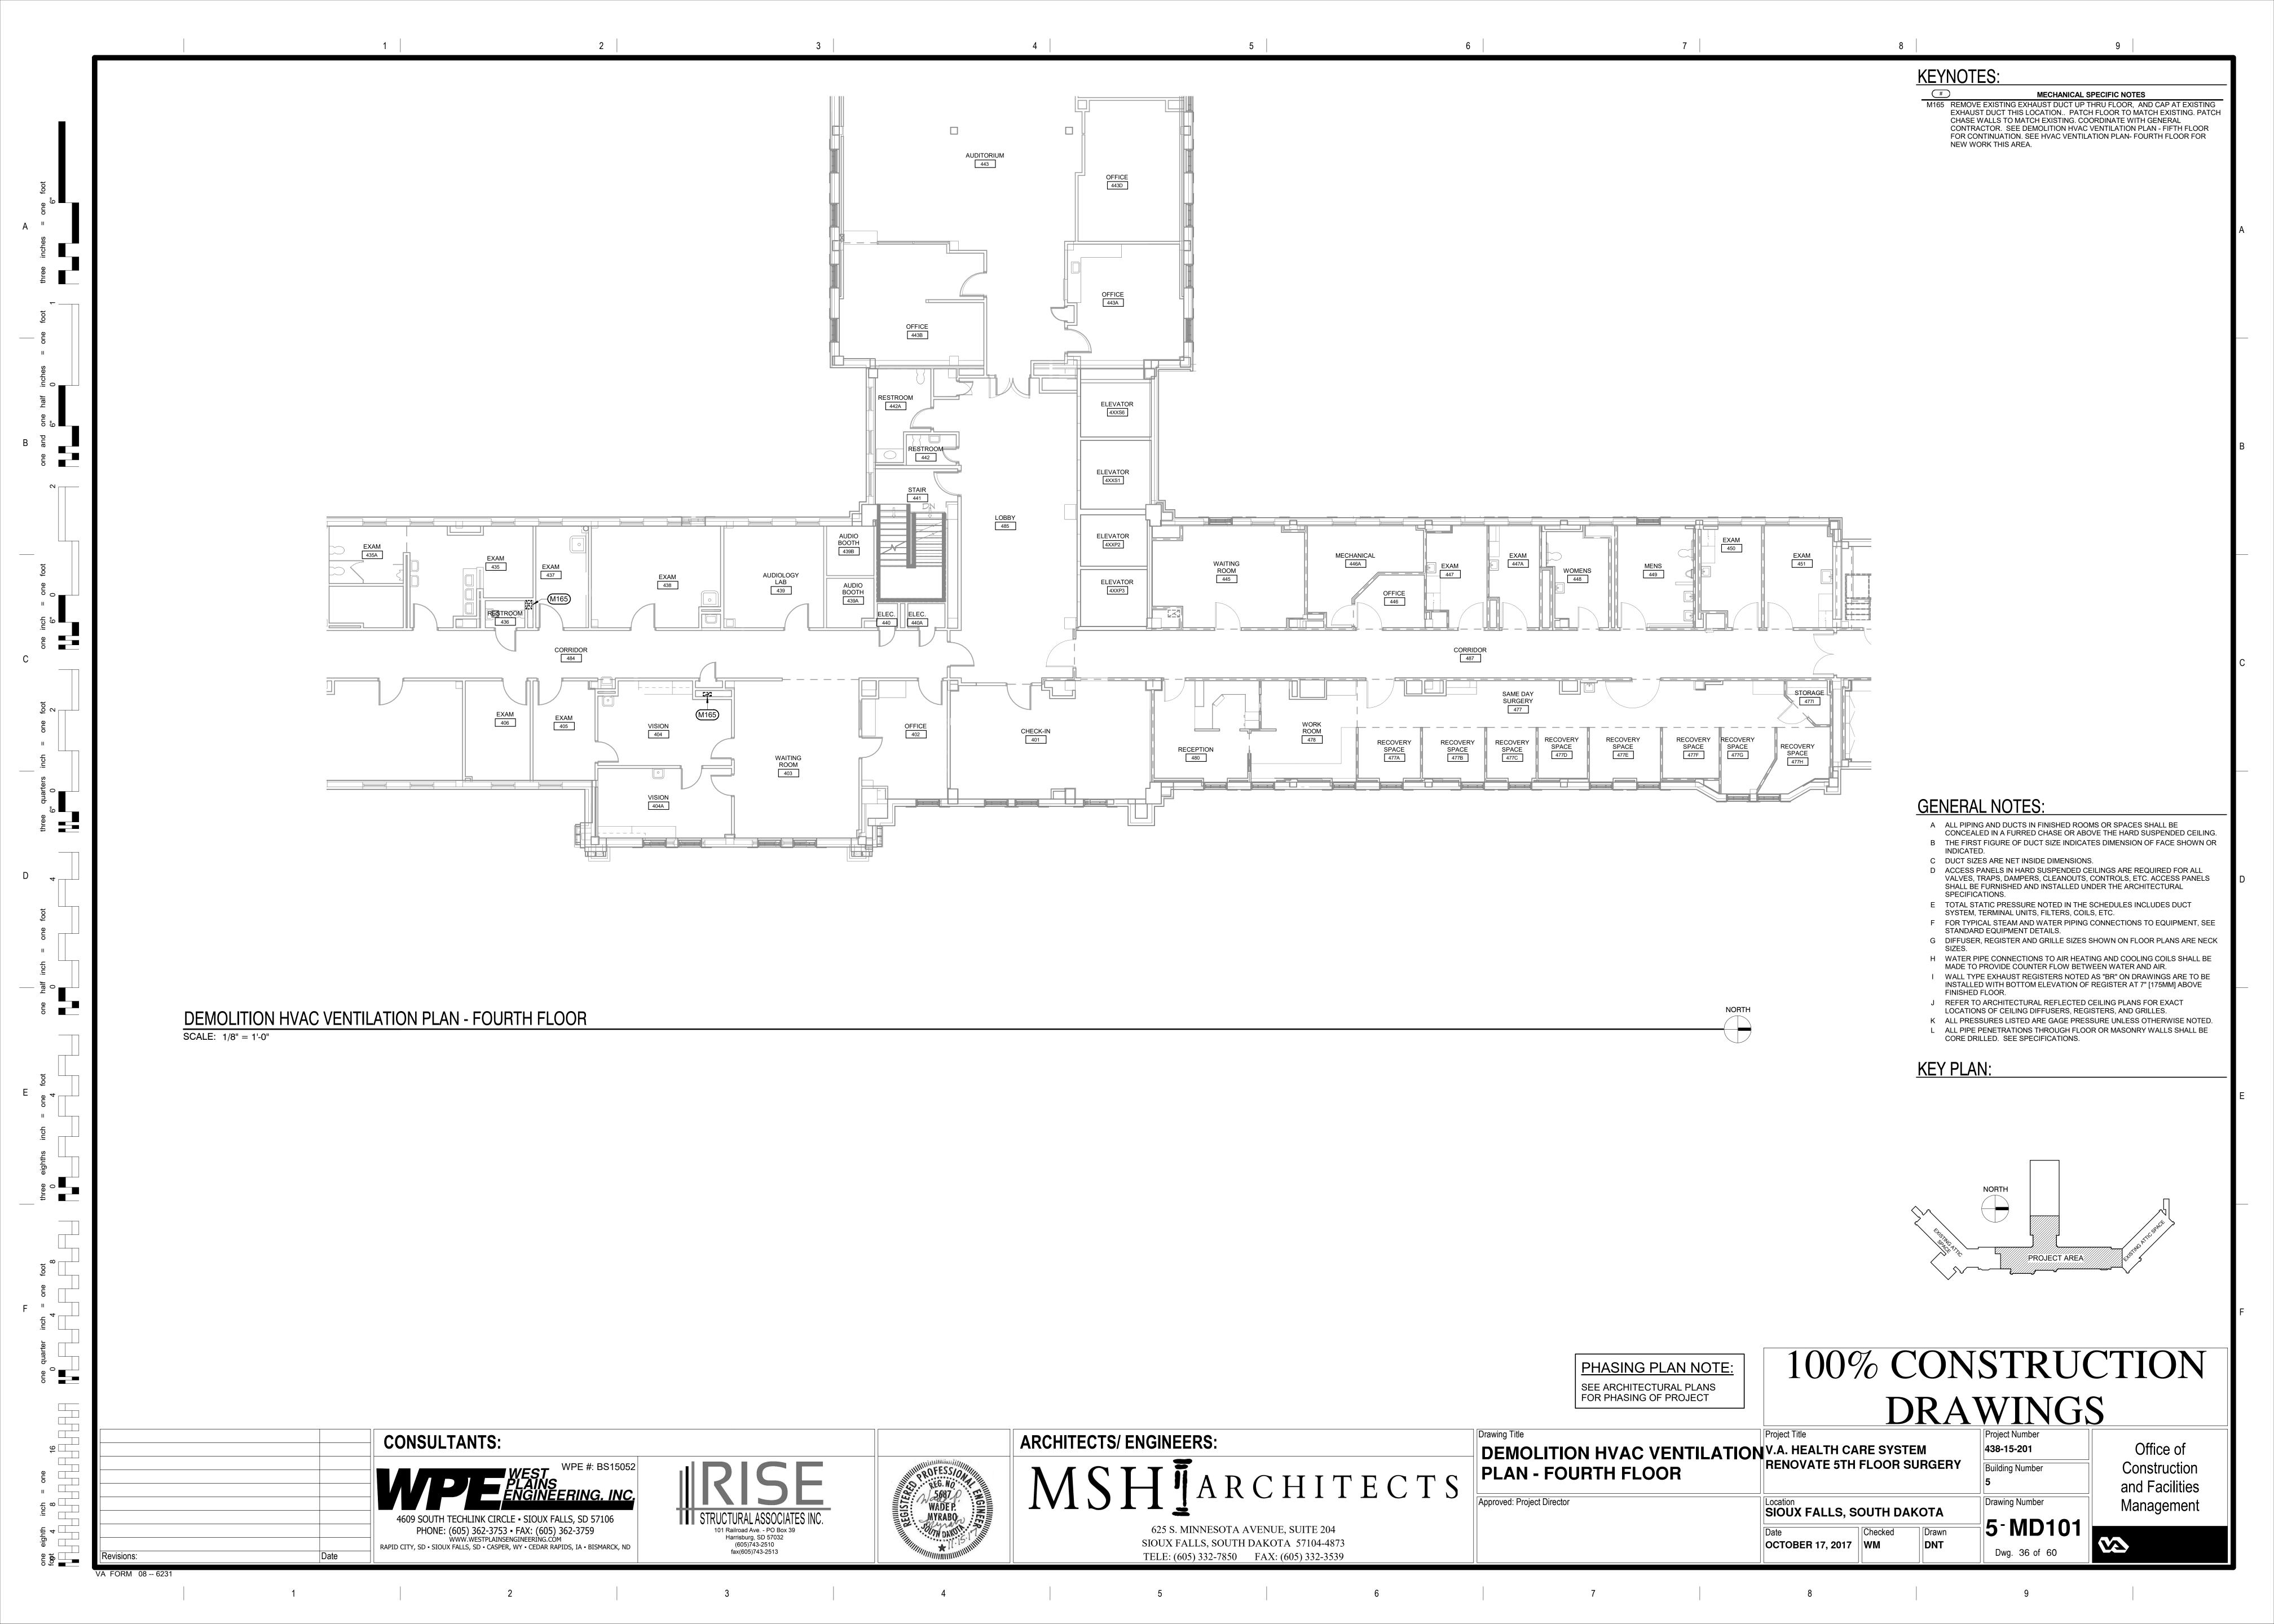

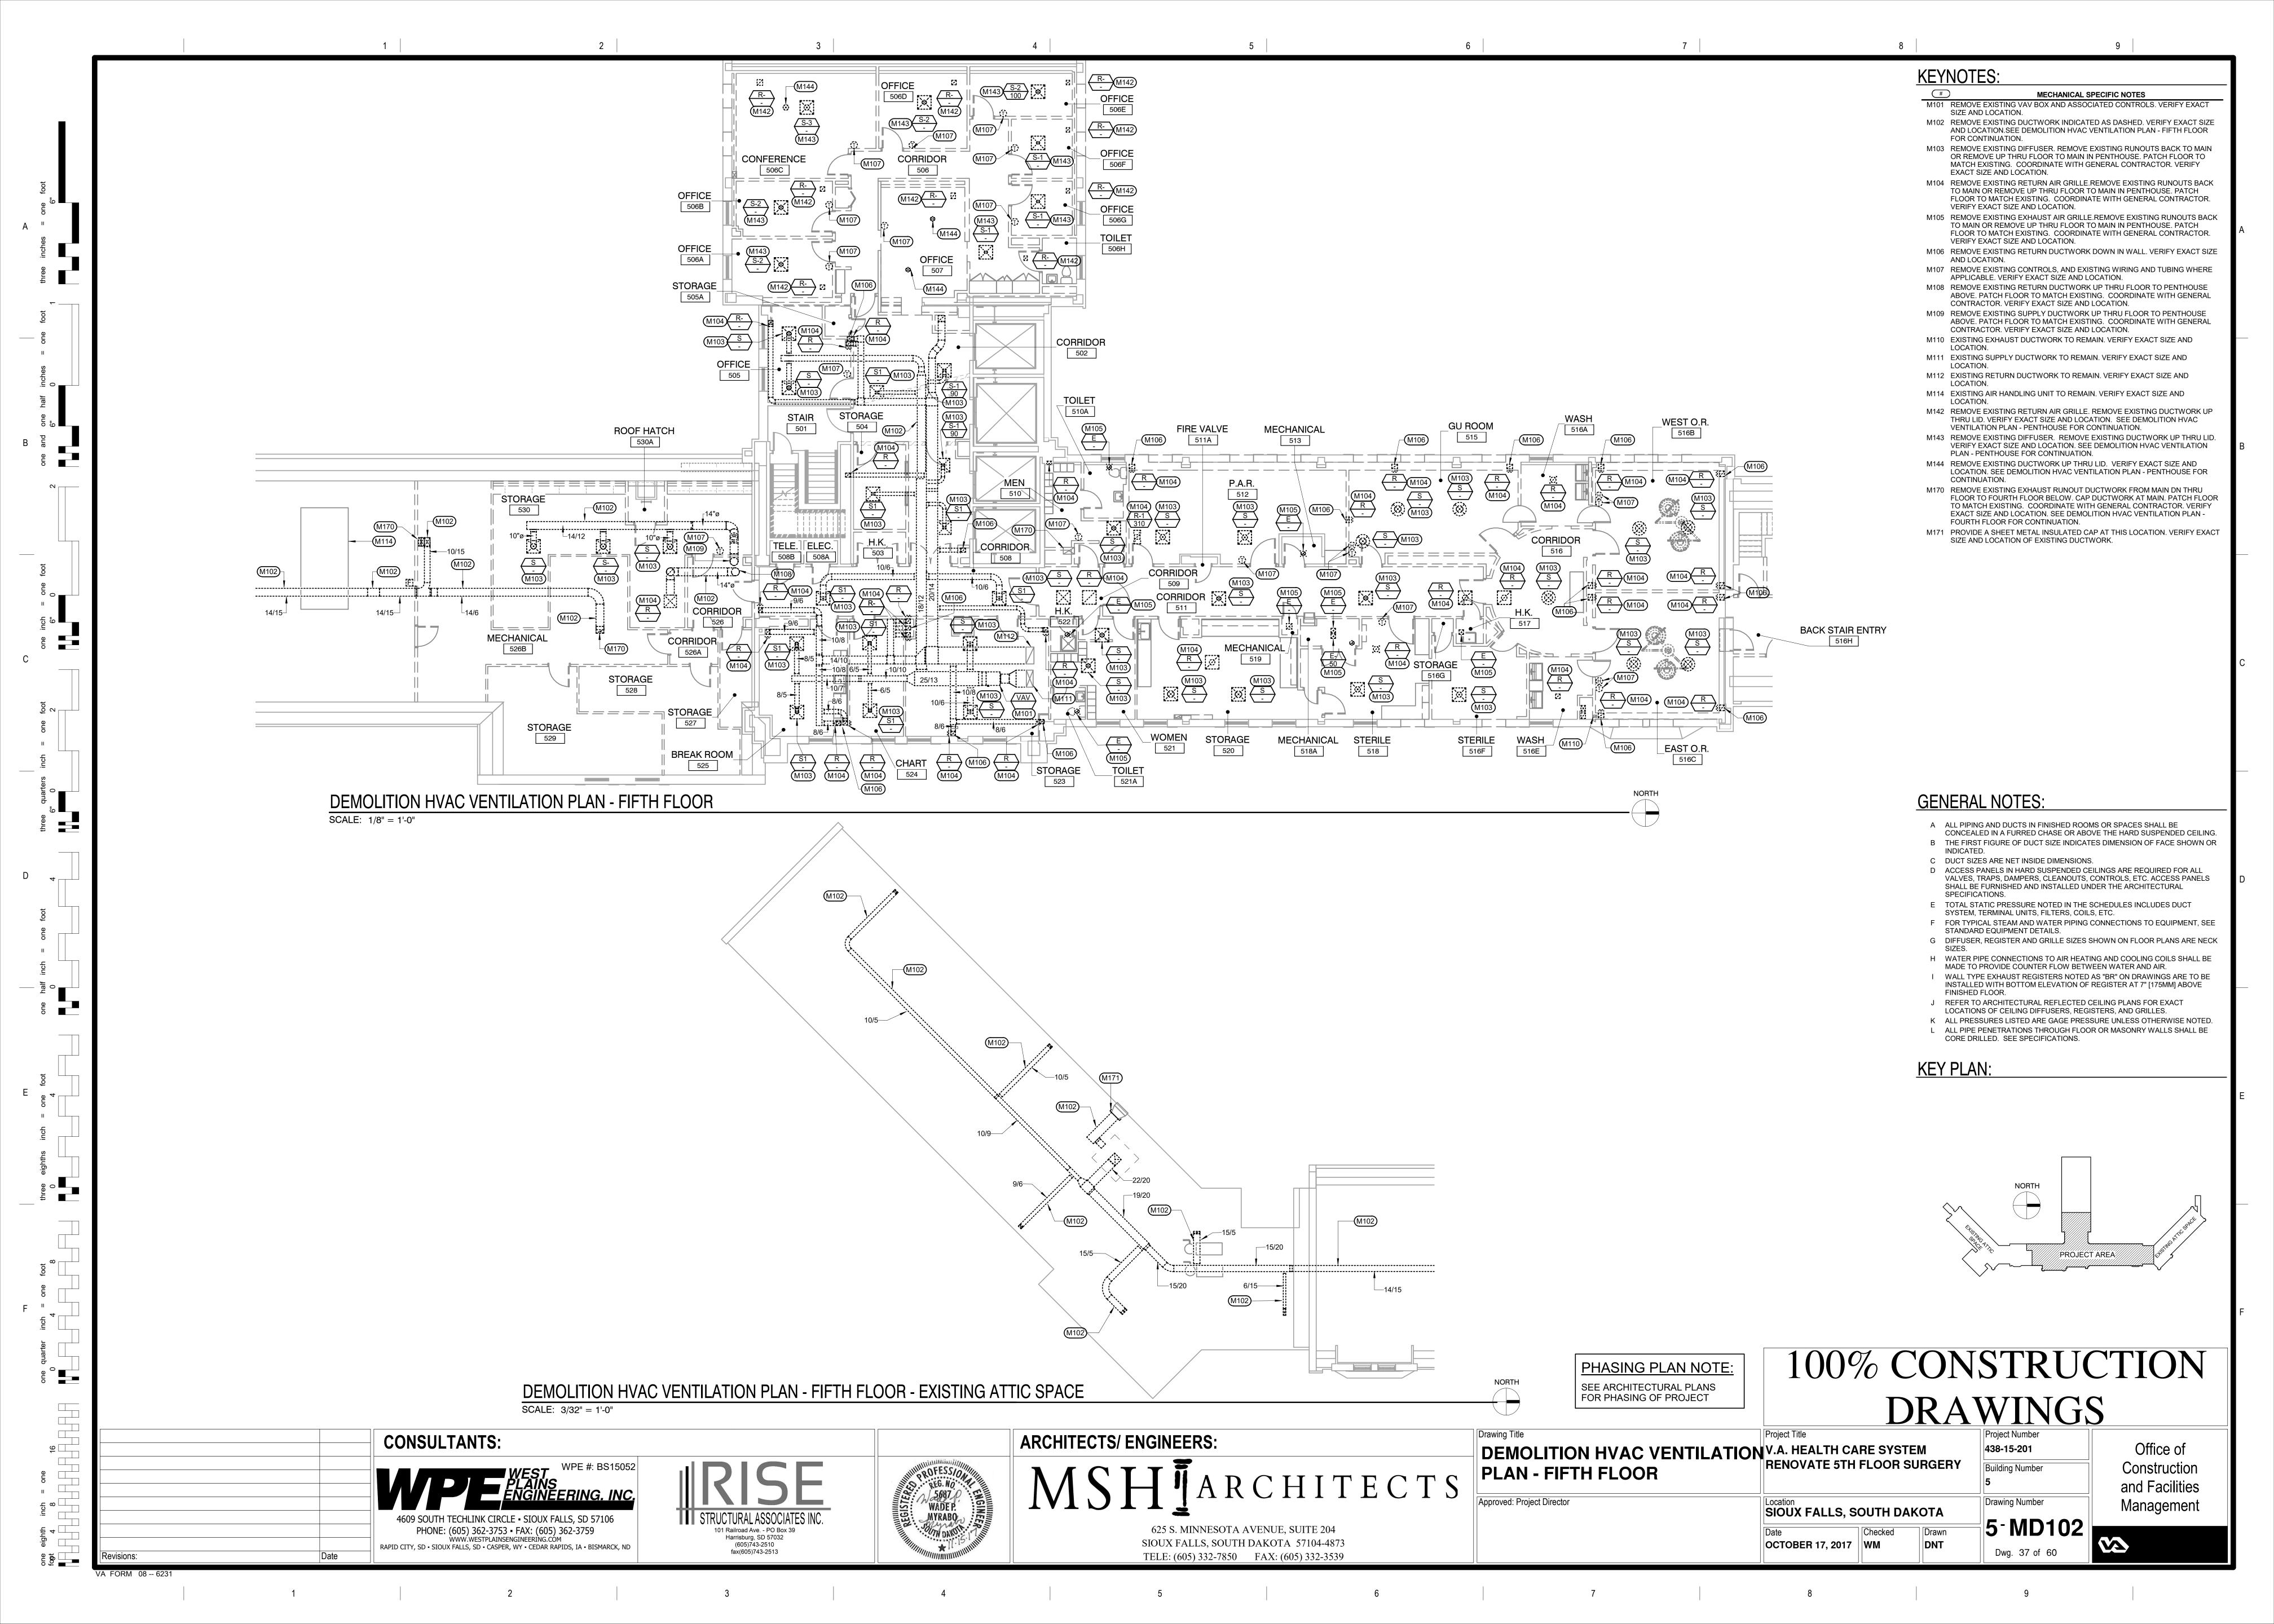

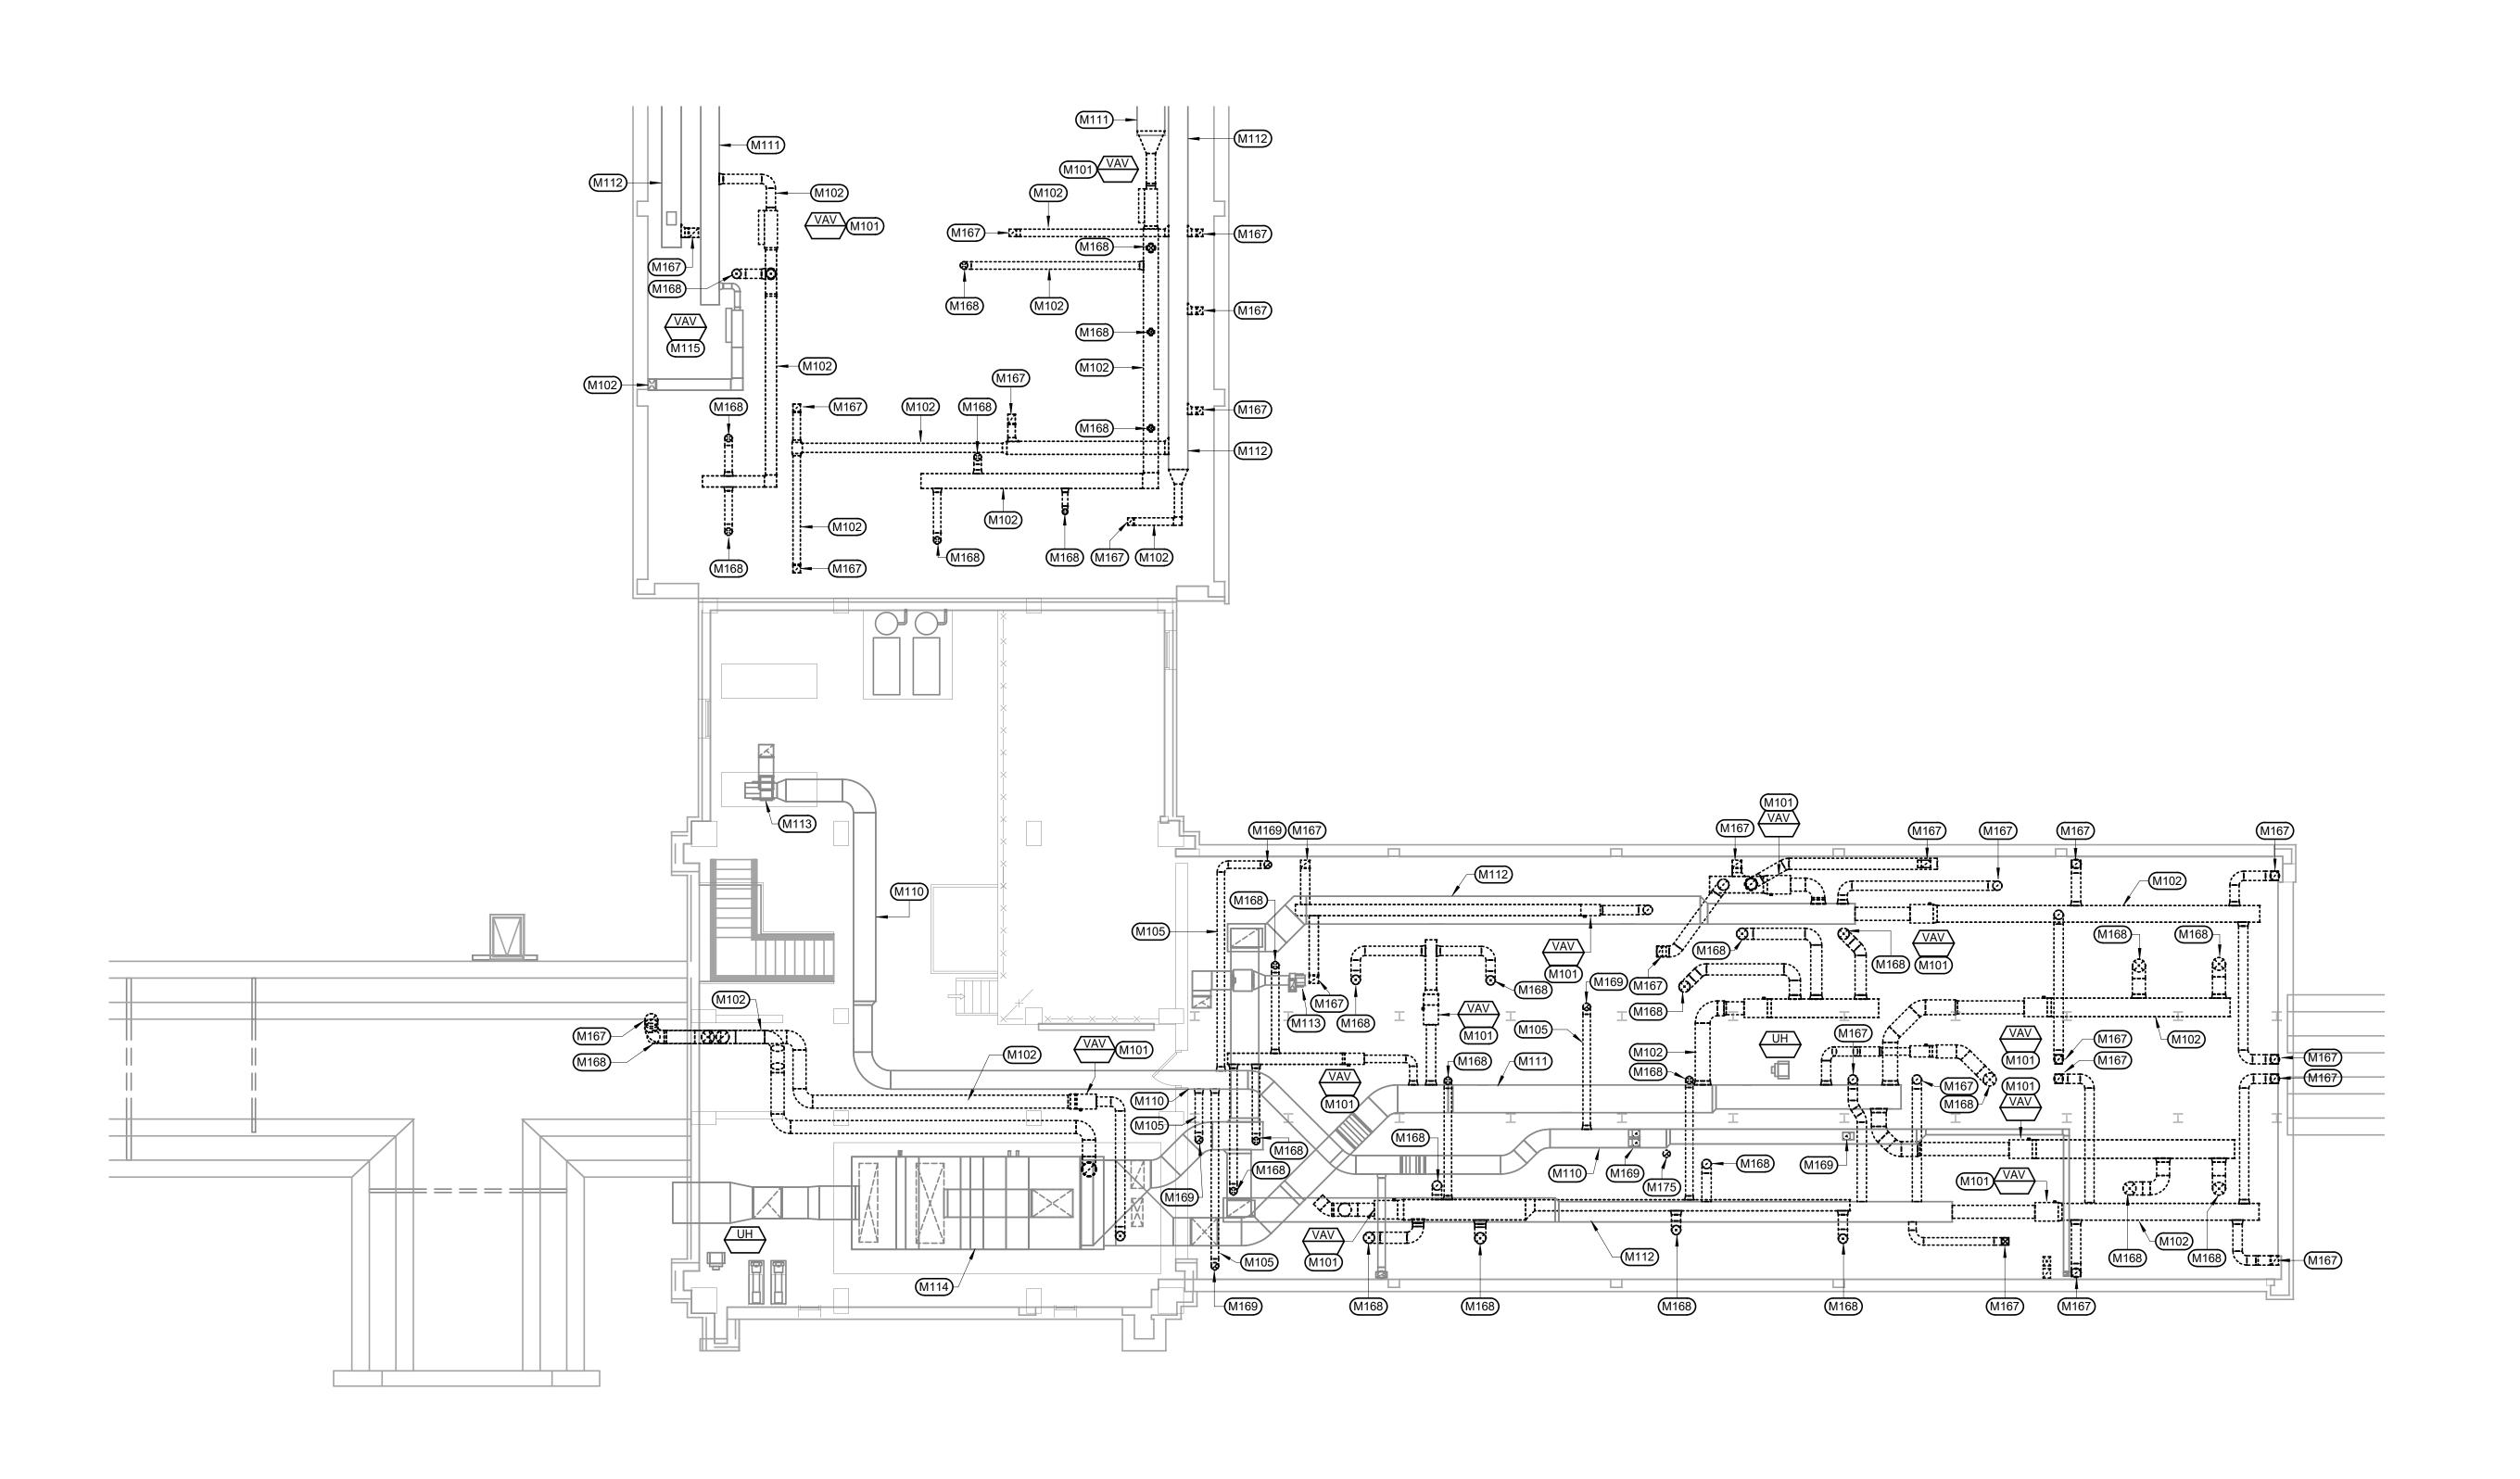

DEMOLITION HVAC VENTILATION PLAN - PENTHOUSE

SCALE: 1/8" = 1'-0"

**KEYNOTES**:

- MECHANICAL SPECIFIC NOTES M101 REMOVE EXISTING VAV BOX AND ASSOCIATED CONTROLS. VERIFY EXACT
- SIZE AND LOCATION. M102 REMOVE EXISTING DUCTWORK INDICATED AS DASHED. VERIFY EXACT SIZE AND LOCATION.SEE DEMOLITION HVAC VENTILATION PLAN - FIFTH FLOOR
- FOR CONTINUATION. M105 REMOVE EXISTING EXHAUST AIR GRILLE.REMOVE EXISTING RUNOUTS BACK TO MAIN OR REMOVE UP THRU FLOOR TO MAIN IN PENTHOUSE, PATCH
- FLOOR TO MATCH EXISTING. COORDINATE WITH GENERAL CONTRACTOR. VERIFY EXACT SIZE AND LOCATION. M110 EXISTING EXHAUST DUCTWORK TO REMAIN. VERIFY EXACT SIZE AND
- LOCATION. M111 EXISTING SUPPLY DUCTWORK TO REMAIN. VERIFY EXACT SIZE AND
- LOCATION. M112 EXISTING RETURN DUCTWORK TO REMAIN. VERIFY EXACT SIZE AND
- LOCATION. M113 EXISTING EXHAUST FAN TO REMAIN. VERIFY EXACT SIZE AND LOCATION.

FIFTH FLOOR FOR CONTINUATION.

- M114 EXISTING AIR HANDLING UNIT TO REMAIN. VERIFY EXACT SIZE AND LOCATION.
- M115 EXISTING VAV BOX TO REMAIN. VERIFY EXACT SIZE AND LOCATION. M167 REMOVE EXISTING RETURN RUNOUT DUCTWORK FROM MAIN DN THRU FLOOR TO FIFTH FLOOR BELOW. CAP DUCTWORK AT MAIN. PATCH FLOOR TO MATCH EXISTING. COORDINATE WITH GENERAL CONTRACTOR. VERIFY EXACT SIZE AND LOCATION. SEE DEMOLITION HVAC VENTILATION PLAN -
- M168 REMOVE EXISTING SUPPLY RUNOUT DUCTWORK FROM MAIN DN THRU FLOOR TO FIFTH FLOOR BELOW. PATCH FLOOR TO MATCH EXISTING. COORDINATE WITH GENERAL CONTRACTOR, VERIFY EXACT SIZE AND LOCATION. SEE DEMOLITION HVAC VENTILATION PLAN - FIFTH FLOOR FOR CONTINUATION.
- M169 REMOVE EXISTING EXHAUST RUNOUT DUCTWORK FROM MAIN DN THRU FLOOR TO FIFTH FLOOR BELOW. CAP DUCTWORK AT MAIN. PATCH FLOOR TO MATCH EXISTING. COORDINATE WITH GENERAL CONTRACTOR, VERIFY EXACT SIZE AND LOCATION. SEE DEMOLITION HVAC VENTILATION PLAN -FIFTH FLOOR FOR CONTINUATION.
- M175 REMOVE EXISTING EXHAUST STACK DUCTWORK FROM UP THRU ROOF, TO DOWN THRU PENTHOUSE FLOOR TO FIFTH FLOOR BELOW. PATCH PENTHOUSE FLOOR TO MATCH EXISTING. COORDINATE WITH GENERAL CONTRACTOR FOR FLOOR AND ROOF REPAIR. SEE ARCHITECTURAL PLANS. ALSO SEE ARCHITECTURAL PLANS FOR ASBESTOS REMOVE ON THIS DUCTWORK.. VERIFY EXACT SIZE AND LOCATION. SEE DEMOLITION HVAC VENTILATION PLAN - FIFTH FLOOR FOR CONTINUATION


### **GENERAL NOTES:**

A ALL PIPING AND DUCTS IN FINISHED ROOMS OR SPACES SHALL BE CONCEALED IN A FURRED CHASE OR ABOVE THE HARD SUSPENDED CEILING.

B THE FIRST FIGURE OF DUCT SIZE INDICATES DIMENSION OF FACE SHOWN OR

- C DUCT SIZES ARE NET INSIDE DIMENSIONS. D ACCESS PANELS IN HARD SUSPENDED CEILINGS ARE REQUIRED FOR ALL
- VALVES, TRAPS, DAMPERS, CLEANOUTS, CONTROLS, ETC. ACCESS PANELS SHALL BE FURNISHED AND INSTALLED UNDER THE ARCHITECTURAL SPECIFICATIONS.
- E TOTAL STATIC PRESSURE NOTED IN THE SCHEDULES INCLUDES DUCT SYSTEM, TERMINAL UNITS, FILTERS, COILS, ETC.
- F FOR TYPICAL STEAM AND WATER PIPING CONNECTIONS TO EQUIPMENT, SEE STANDARD EQUIPMENT DETAILS. G DIFFUSER, REGISTER AND GRILLE SIZES SHOWN ON FLOOR PLANS ARE NECK
- H WATER PIPE CONNECTIONS TO AIR HEATING AND COOLING COILS SHALL BE
- MADE TO PROVIDE COUNTER FLOW BETWEEN WATER AND AIR. I WALL TYPE EXHAUST REGISTERS NOTED AS "BR" ON DRAWINGS ARE TO BE
- INSTALLED WITH BOTTOM ELEVATION OF REGISTER AT 7" [175MM] ABOVE
- J REFER TO ARCHITECTURAL REFLECTED CEILING PLANS FOR EXACT
- LOCATIONS OF CEILING DIFFUSERS, REGISTERS, AND GRILLES. K ALL PRESSURES LISTED ARE GAGE PRESSURE UNLESS OTHERWISE NOTED.
- L ALL PIPE PENETRATIONS THROUGH FLOOR OR MASONRY WALLS SHALL BE CORE DRILLED. SEE SPECIFICATIONS.

### KEY PLAN:

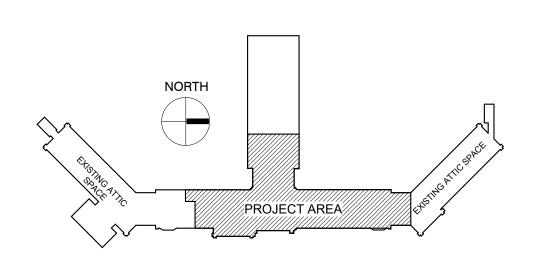


PHASING PLAN NOTE: SEE ARCHITECTURAL PLANS FOR PHASING OF PROJECT


## 100% CONSTRUCTION DRAWINGS

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DEMOLITION HVAC VENTILATION V.A. HEALTH CARE SYSTEM **PLAN - PENTHOUSE** 


RENOVATE 5TH FLOOR SURGERY Approved: Project Director


438-15-201 **Building Number** Drawing Number SIOUX FALLS, SOUTH DAKOTA
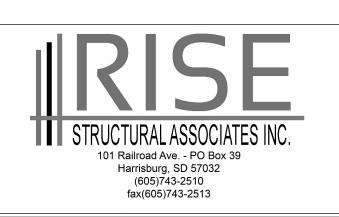
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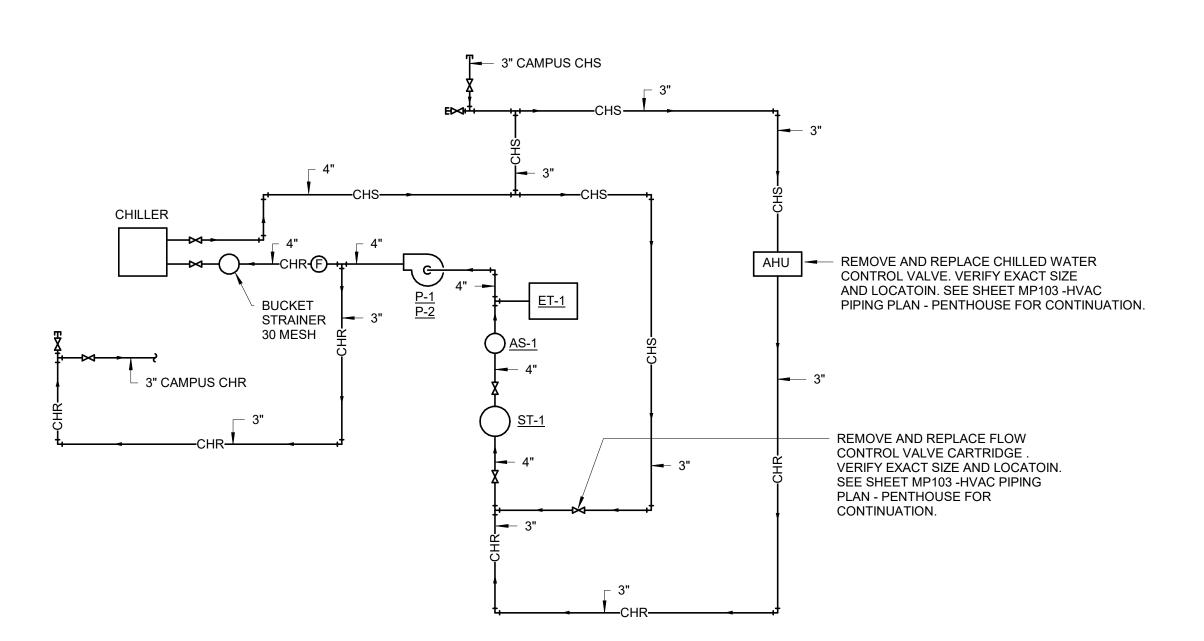
5-MD103 Dwg. 38 of 60

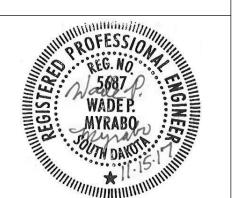

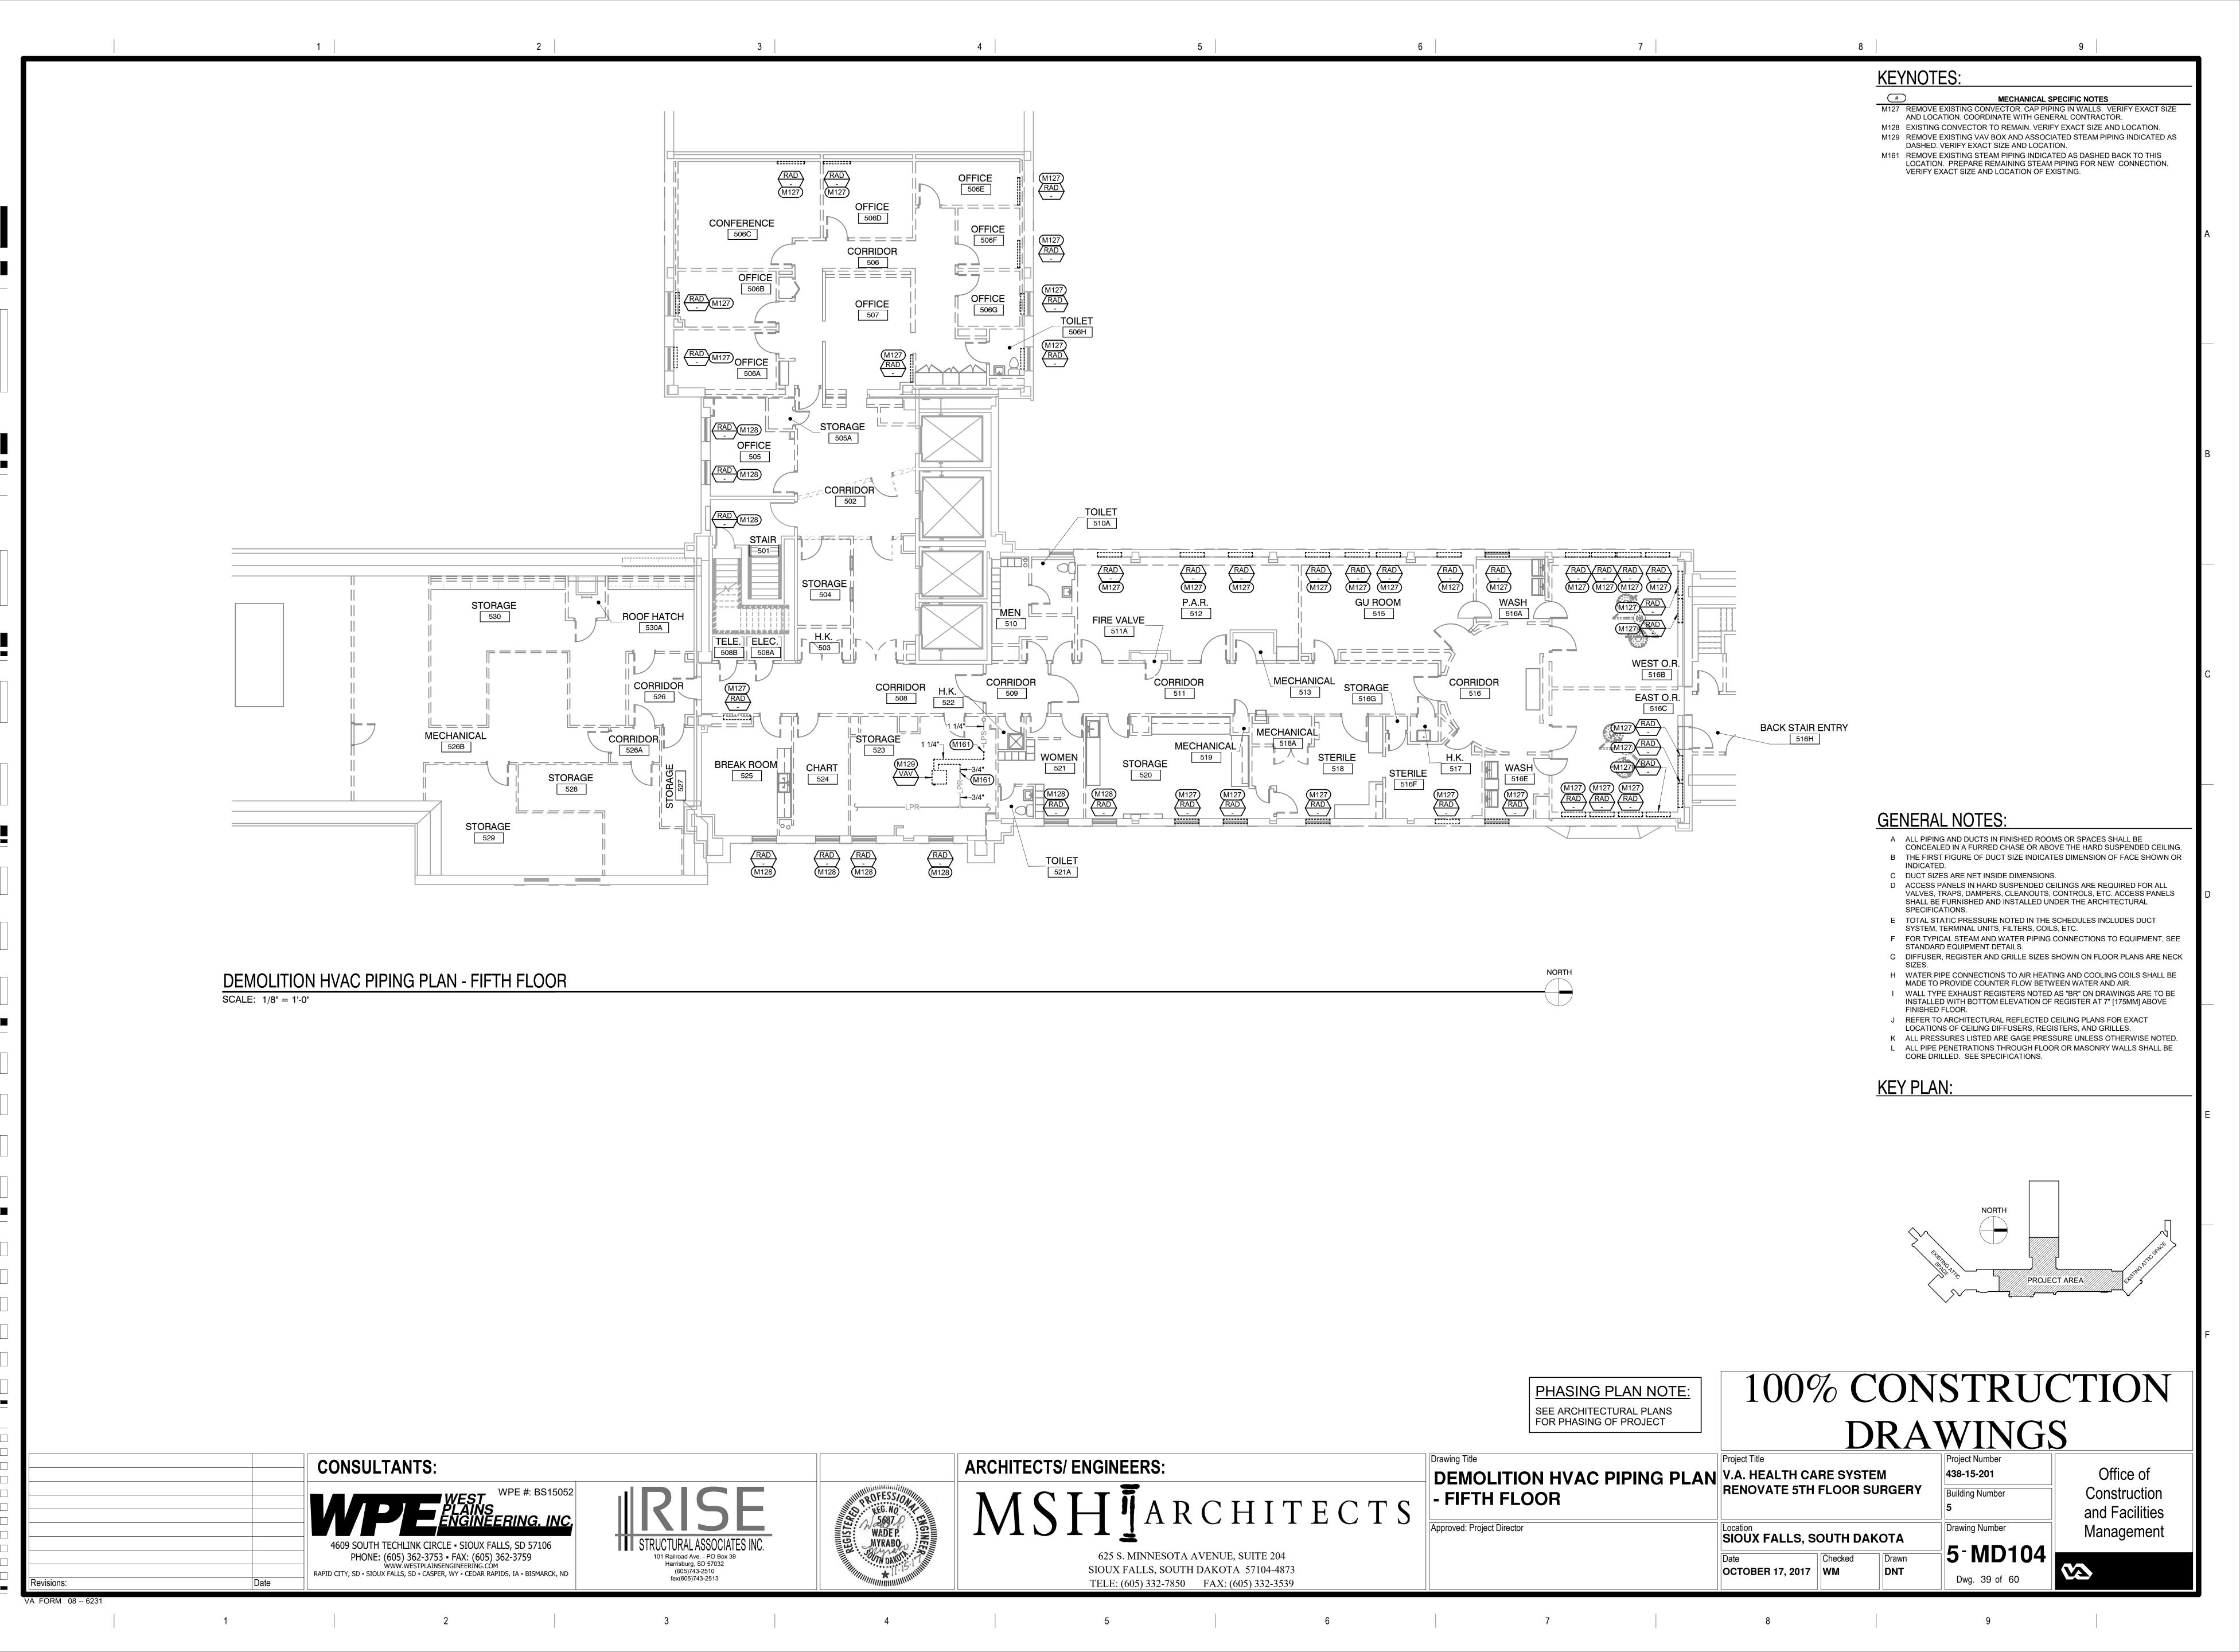

DEMOLITION HVAC PIPING PLAN - PENTHOUSE

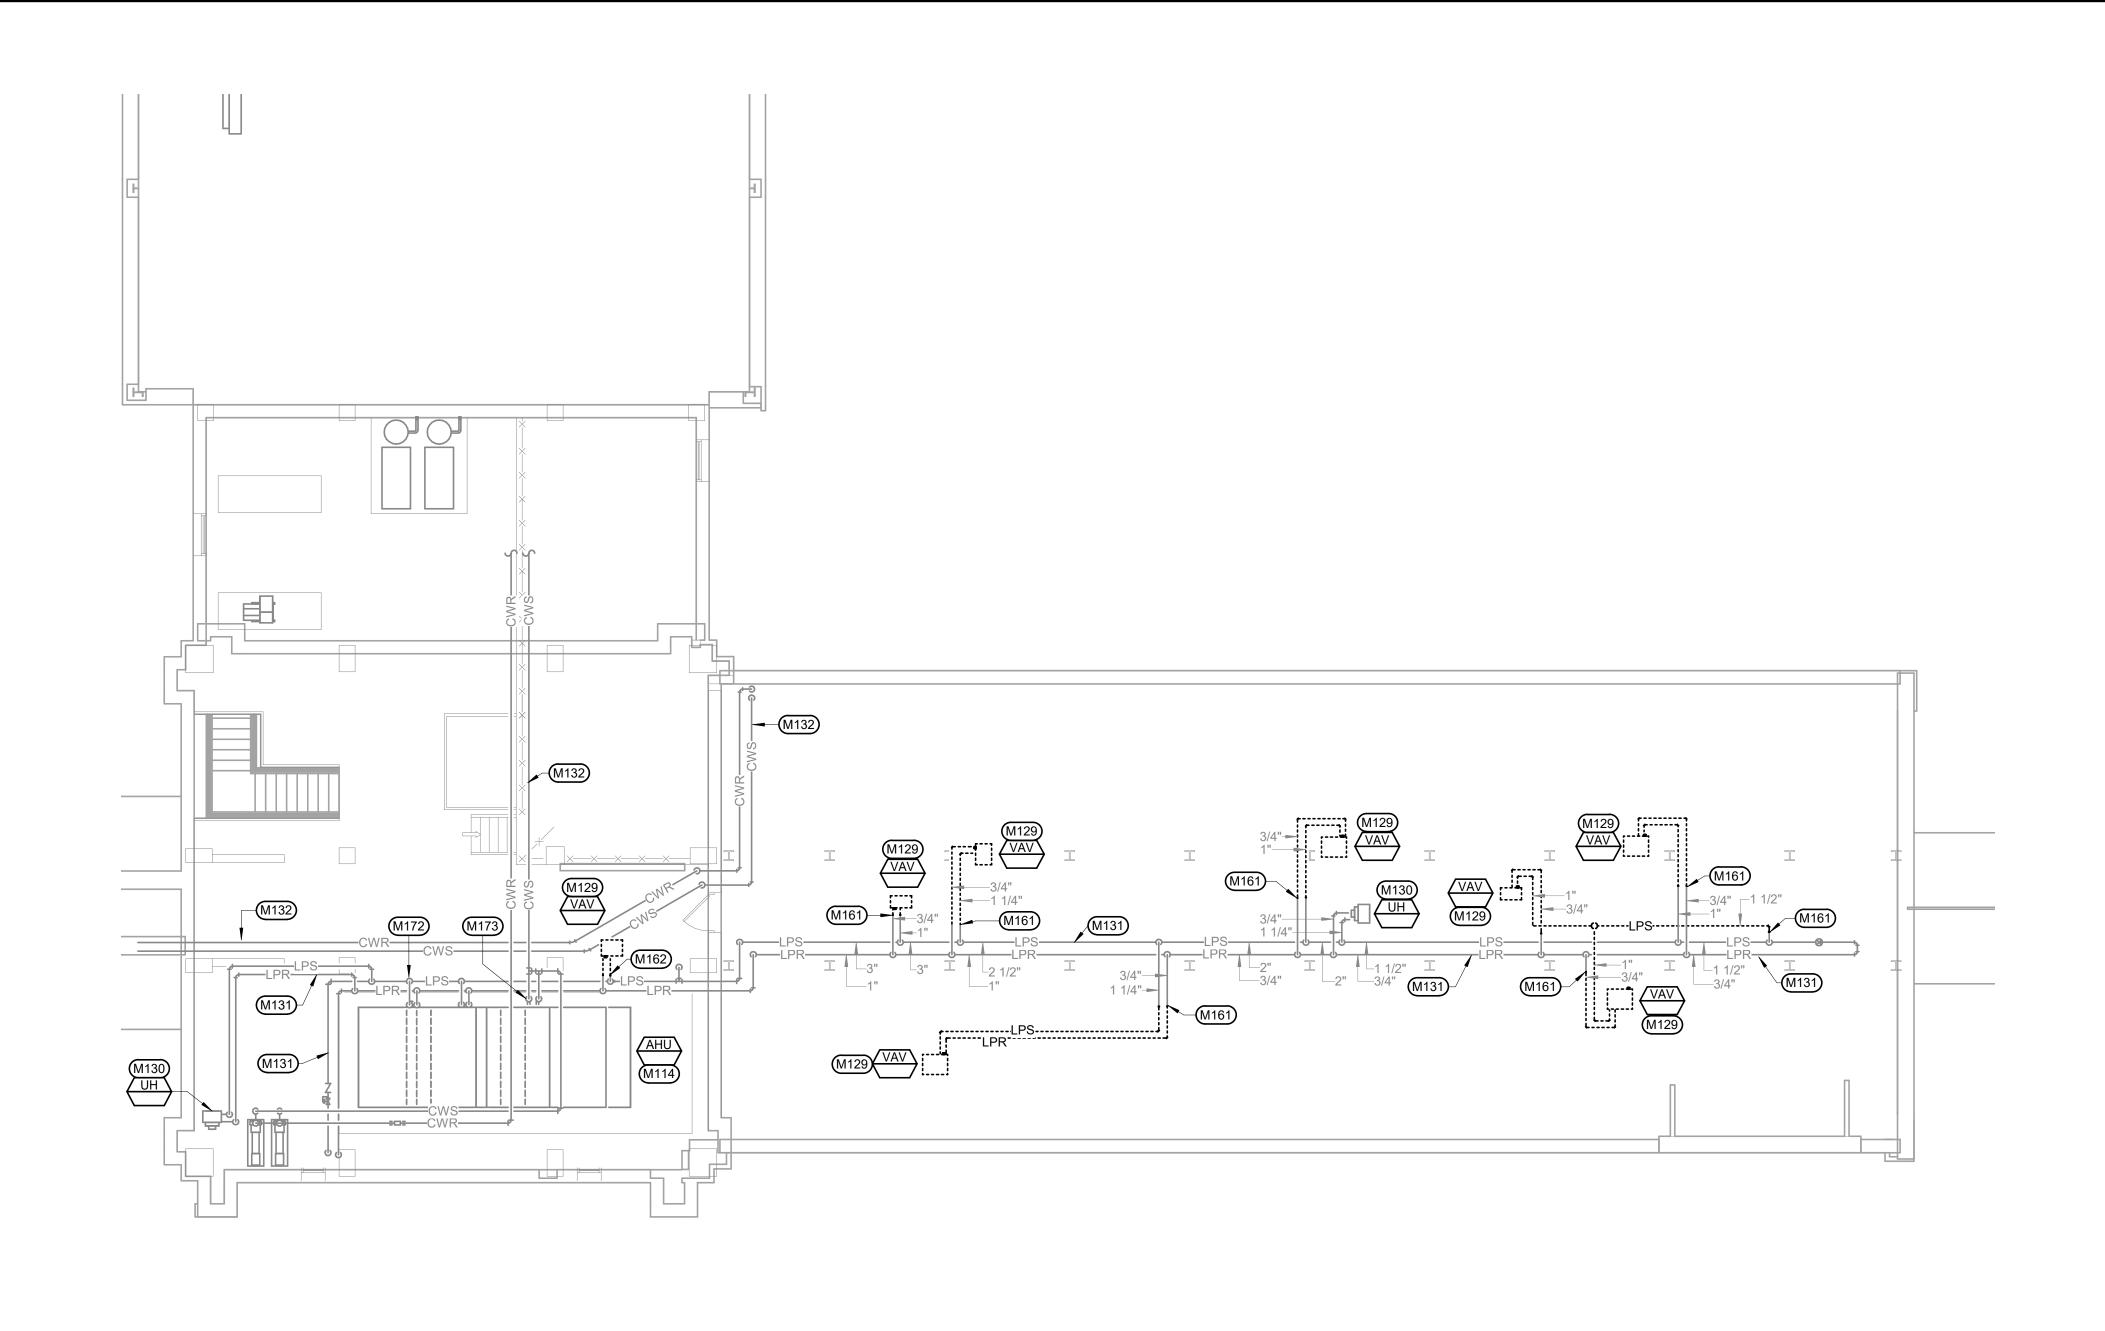SCALE: 1/8" = 1'-0"



PHASING PLAN NOTE: SEE ARCHITECTURAL PLANS FOR PHASING OF PROJECT

## 100% CONSTRUCTION DRAWINGS

438-15-201

**Building Number** 

Drawing Number

Checked

DNT

5-MD105

Dwg. 40 of 60

**CONSULTANTS: ARCHITECTS/ ENGINEERS:** DEMOLITION HVAC PIPING PLAN V.A. HEALTH CARE SYSTEM ARCHITECTS RENOVATE 5TH FLOOR SURGERY WEST
PLAINS
ENGINEERING. INC. WADE P. MYRABO WARDEN DANGTON - PENTHOUSE Approved: Project Director SIOUX FALLS, SOUTH DAKOTA STRUCTURAL ASSOCIATES INC.

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RAPID CITY, SD • SIOUX FALLS, SD • CASPER, WY • CEDAR RAPIDS, IA • BISMARCK, ND 625 S. MINNESOTA AVENUE, SUITE 204 SIOUX FALLS, SOUTH DAKOTA 57104-4873 OCTOBER 17, 2017 WM fax(605)743-2513 TELE: (605) 332-7850 FAX: (605) 332-3539

CHILLED WATER PIPING SCHEMATIC - DEMOLITION

SCALE: NO SCALE

**GENERAL NOTES:** 

**KEYNOTES**:

CONTINUATION.

MECHANICAL SPECIFIC NOTES

M114 EXISTING AIR HANDLING UNIT TO REMAIN. VERIFY EXACT SIZE AND LOCATION. M129 REMOVE EXISTING VAV BOX AND ASSOCIATED STEAM PIPING INDICATED AS

M131 EXISTING LPR AND LPS PIPING TO REMAIN. VERIFY EXACT SIZE AND LOCATION. M132 EXISTING CHILLED WATER PIPING TO REMAIN. VERIFY EXACT SIZE AND

LOCATION. PREPARE REMAINING STEAM PIPING FOR NEW CONNECTION.

M162 REMOVE EXISTING STEAM PIPING INDICATED AS DASHED BACK TO MAIN. CAP EXISTING LPR AT MAIN. PREPARE EXISTING LPS FOR NEW CONNECTION.

M173 REMOVE AND REPLACE CHILLED WATER CONTROL VALVE. VERIFY EXACT SIZE AND LOCATOIN. SEE SHEET MP103 -HVAC PIPING PLAN - PENTHOUSE FOR

M172 REMOVE AND REPLACE STEAM CONTROL VALVE. VERIFY EXACT SIZE AND LOCATOIN. SEE SHEET MP103 -HVAC PIPING PLAN - PENTHOUSE FOR

M130 EXISTING UNIT HEATER TO REMAIN. VERIFY EXACT SIZE AND LOCATION.

M161 REMOVE EXISTING STEAM PIPING INDICATED AS DASHED BACK TO THIS


DASHED. VERIFY EXACT SIZE AND LOCATION.

VERIFY EXACT SIZE AND LOCATION OF EXISTING.

VERIFY EXACT SIZE AND LOCATION OF EXISTING.

- A ALL PIPING AND DUCTS IN FINISHED ROOMS OR SPACES SHALL BE CONCEALED IN A FURRED CHASE OR ABOVE THE HARD SUSPENDED CEILING. B THE FIRST FIGURE OF DUCT SIZE INDICATES DIMENSION OF FACE SHOWN OR
- C DUCT SIZES ARE NET INSIDE DIMENSIONS. D ACCESS PANELS IN HARD SUSPENDED CEILINGS ARE REQUIRED FOR ALL VALVES, TRAPS, DAMPERS, CLEANOUTS, CONTROLS, ETC. ACCESS PANELS
- SHALL BE FURNISHED AND INSTALLED UNDER THE ARCHITECTURAL SPECIFICATIONS. E TOTAL STATIC PRESSURE NOTED IN THE SCHEDULES INCLUDES DUCT SYSTEM, TERMINAL UNITS, FILTERS, COILS, ETC.
- F FOR TYPICAL STEAM AND WATER PIPING CONNECTIONS TO EQUIPMENT, SEE STANDARD EQUIPMENT DETAILS.
- G DIFFUSER, REGISTER AND GRILLE SIZES SHOWN ON FLOOR PLANS ARE NECK H WATER PIPE CONNECTIONS TO AIR HEATING AND COOLING COILS SHALL BE
- MADE TO PROVIDE COUNTER FLOW BETWEEN WATER AND AIR. I WALL TYPE EXHAUST REGISTERS NOTED AS "BR" ON DRAWINGS ARE TO BE INSTALLED WITH BOTTOM ELEVATION OF REGISTER AT 7" [175MM] ABOVE
- J REFER TO ARCHITECTURAL REFLECTED CEILING PLANS FOR EXACT LOCATIONS OF CEILING DIFFUSERS, REGISTERS, AND GRILLES.
- K ALL PRESSURES LISTED ARE GAGE PRESSURE UNLESS OTHERWISE NOTED. L ALL PIPE PENETRATIONS THROUGH FLOOR OR MASONRY WALLS SHALL BE CORE DRILLED. SEE SPECIFICATIONS.

KEY PLAN:

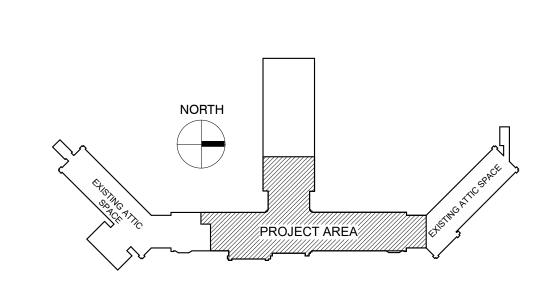

Office of

Construction

and Facilities

Management