




8	
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KEYNOTES:

(#)
M116	REMOVE EXISTING W. PLUMBING FIXTURE IN LOCATION OF EXISTIN WITH GENERAL CONT CONTRACTOR.
M117	REMOVE EXISTING VE RECONNECTION TO N COORDINATE WITH G FLOOR FOR NEW VEN
M119	REMOVE EXISTING CV
M120	PREPARE EXISTING W PLAN - FOURTH FLOO REPAIR WITH GENER
M121	REMOVE EXISTING W
M122	REMOVE EXISTING W. PREPARE REMAINING PIPING TRANSITIONS LOWER LEVELS. PATC GENERAL CONTRACT CONTRACTOR. SEE F




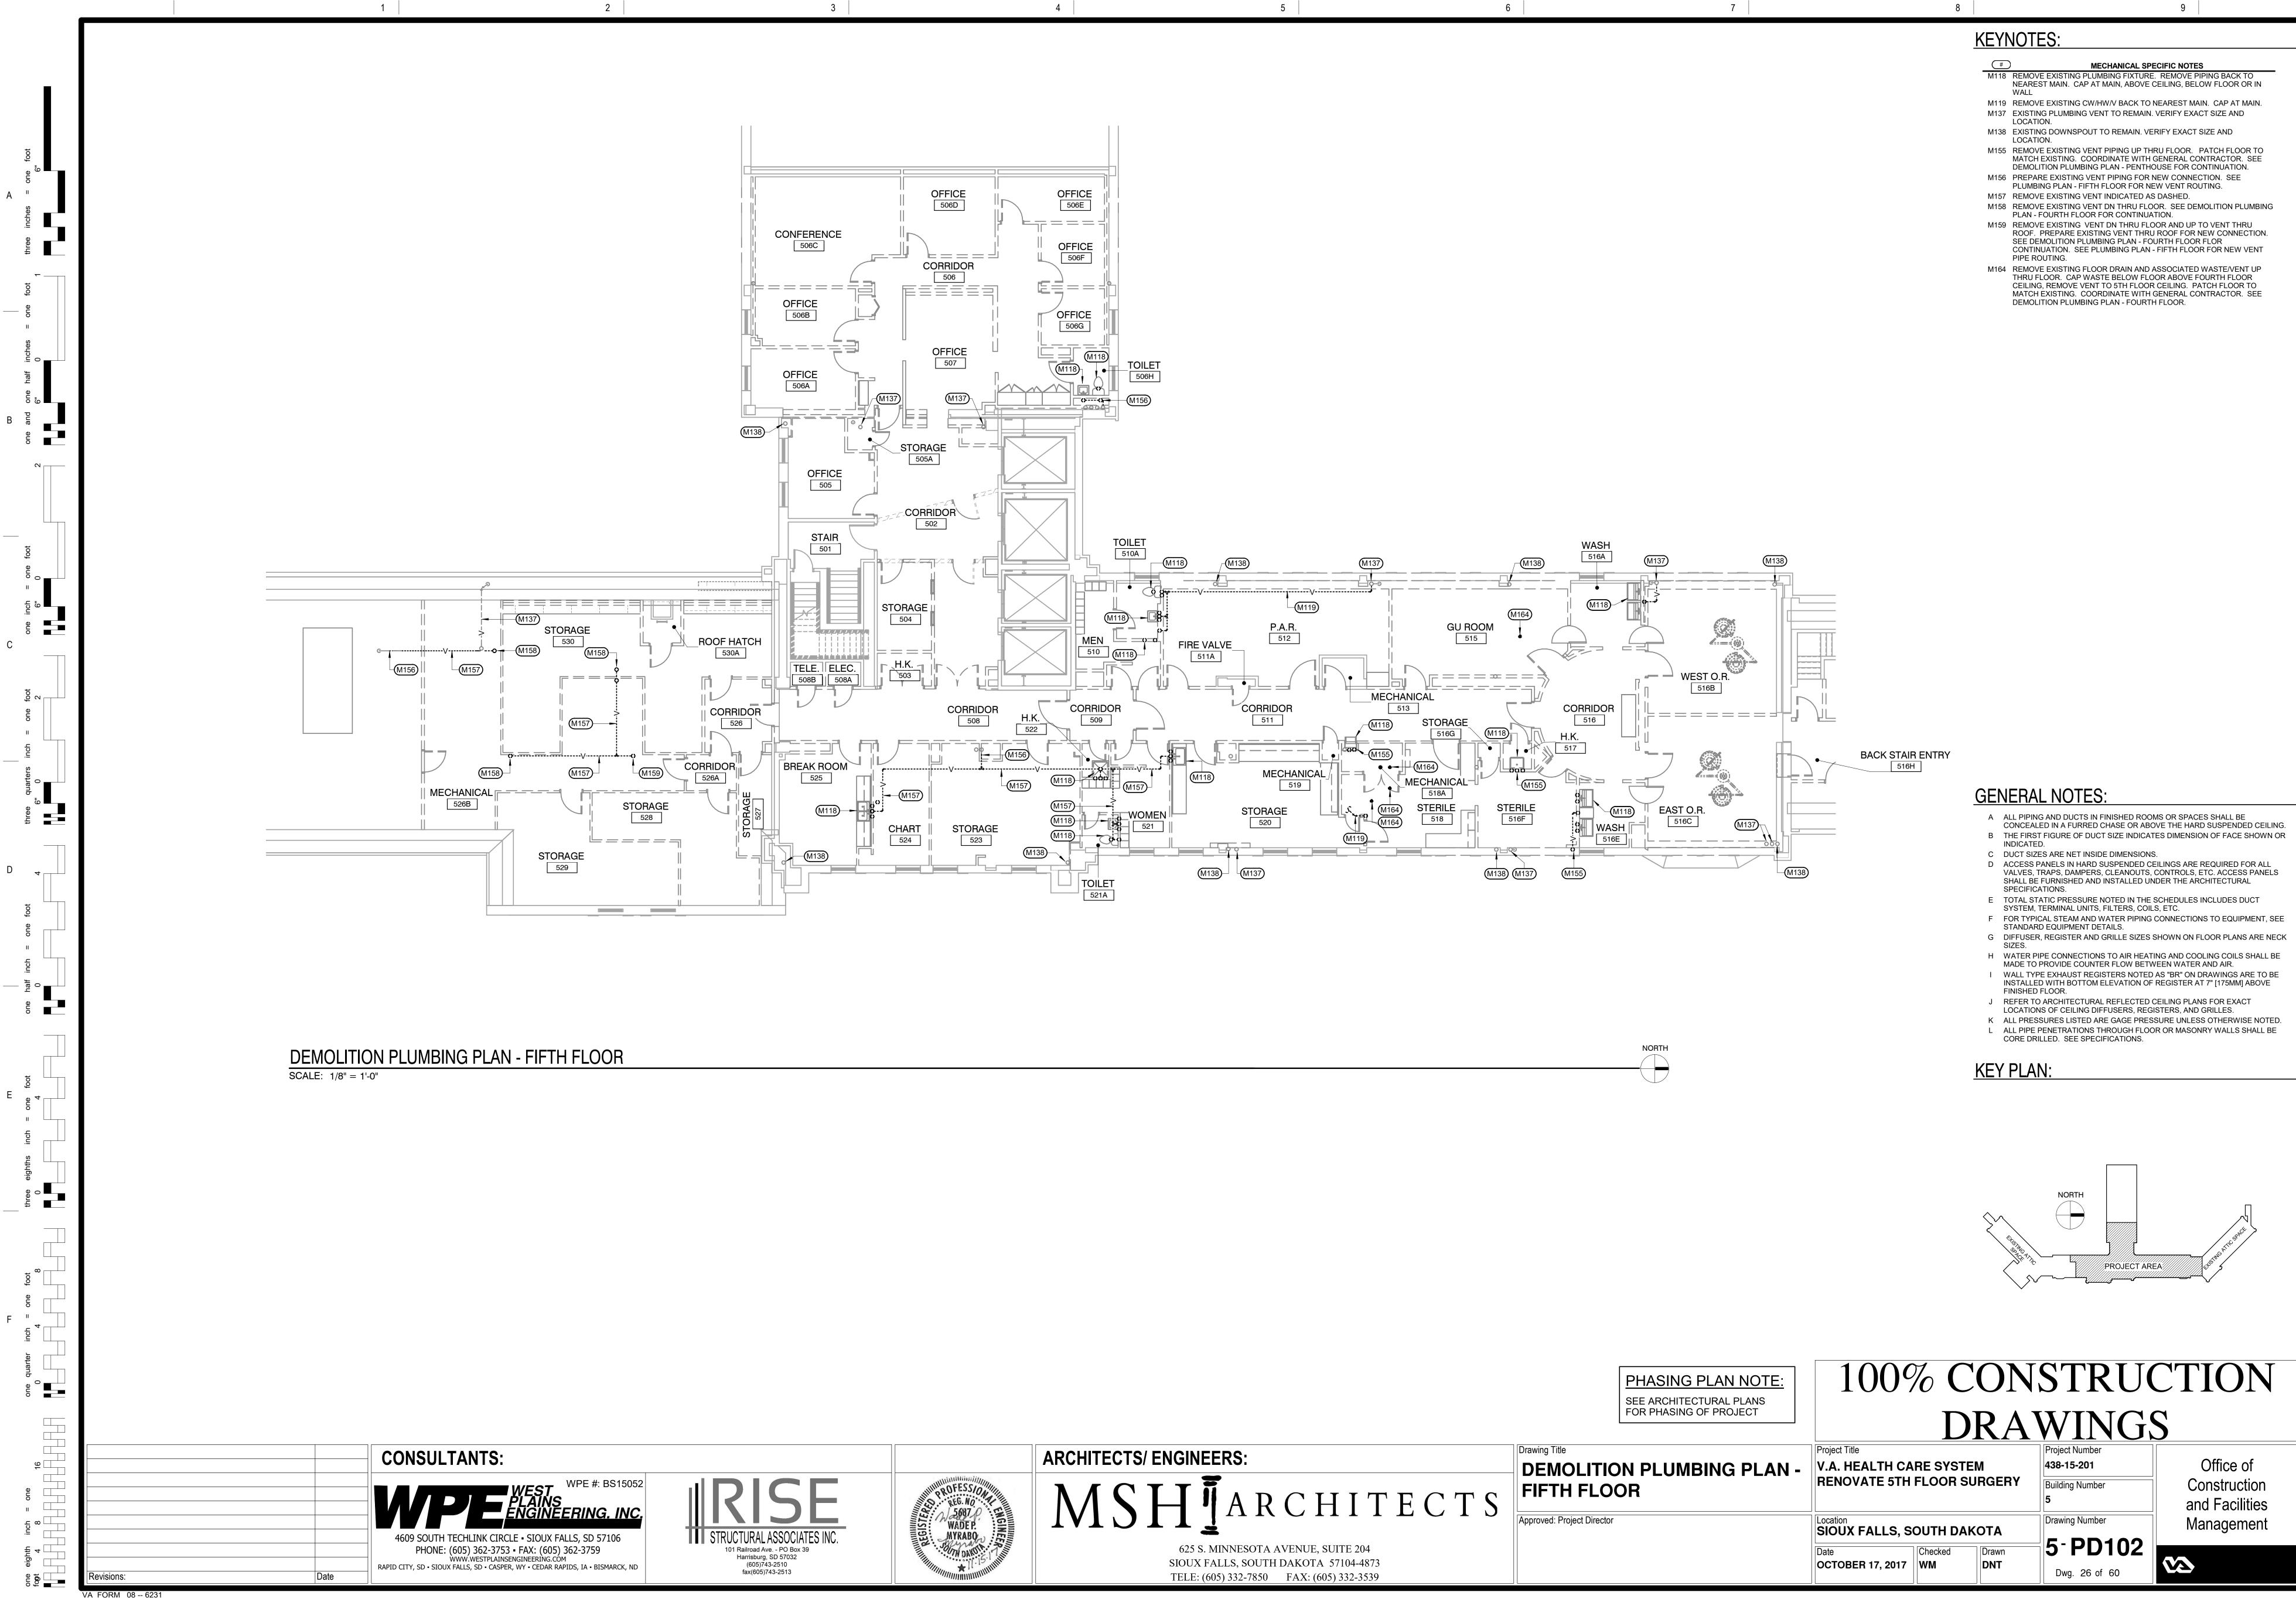






5		

	(#)
•	M118	REMOVE EXISTING PL NEAREST MAIN. CAP WALL
	M119	REMOVE EXISTING CV
	M137	EXISTING PLUMBING V LOCATION.
	M138	EXISTING DOWNSPOL LOCATION.
	M155	REMOVE EXISTING VE MATCH EXISTING. CO DEMOLITION PLUMBIN
	M156	PREPARE EXISTING V PLUMBING PLAN - FIF
	M157	REMOVE EXISTING VE
	M158	REMOVE EXISTING VE PLAN - FOURTH FLOO
	M159	REMOVE EXISTING VE ROOF. PREPARE EXIS SEE DEMOLITION PLU CONTINUATION. SEE PIPE ROUTING.
	M164	REMOVE EXISTING FL THRU FLOOR. CAP W

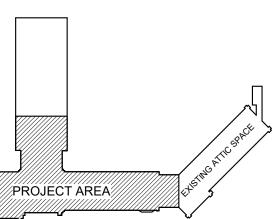

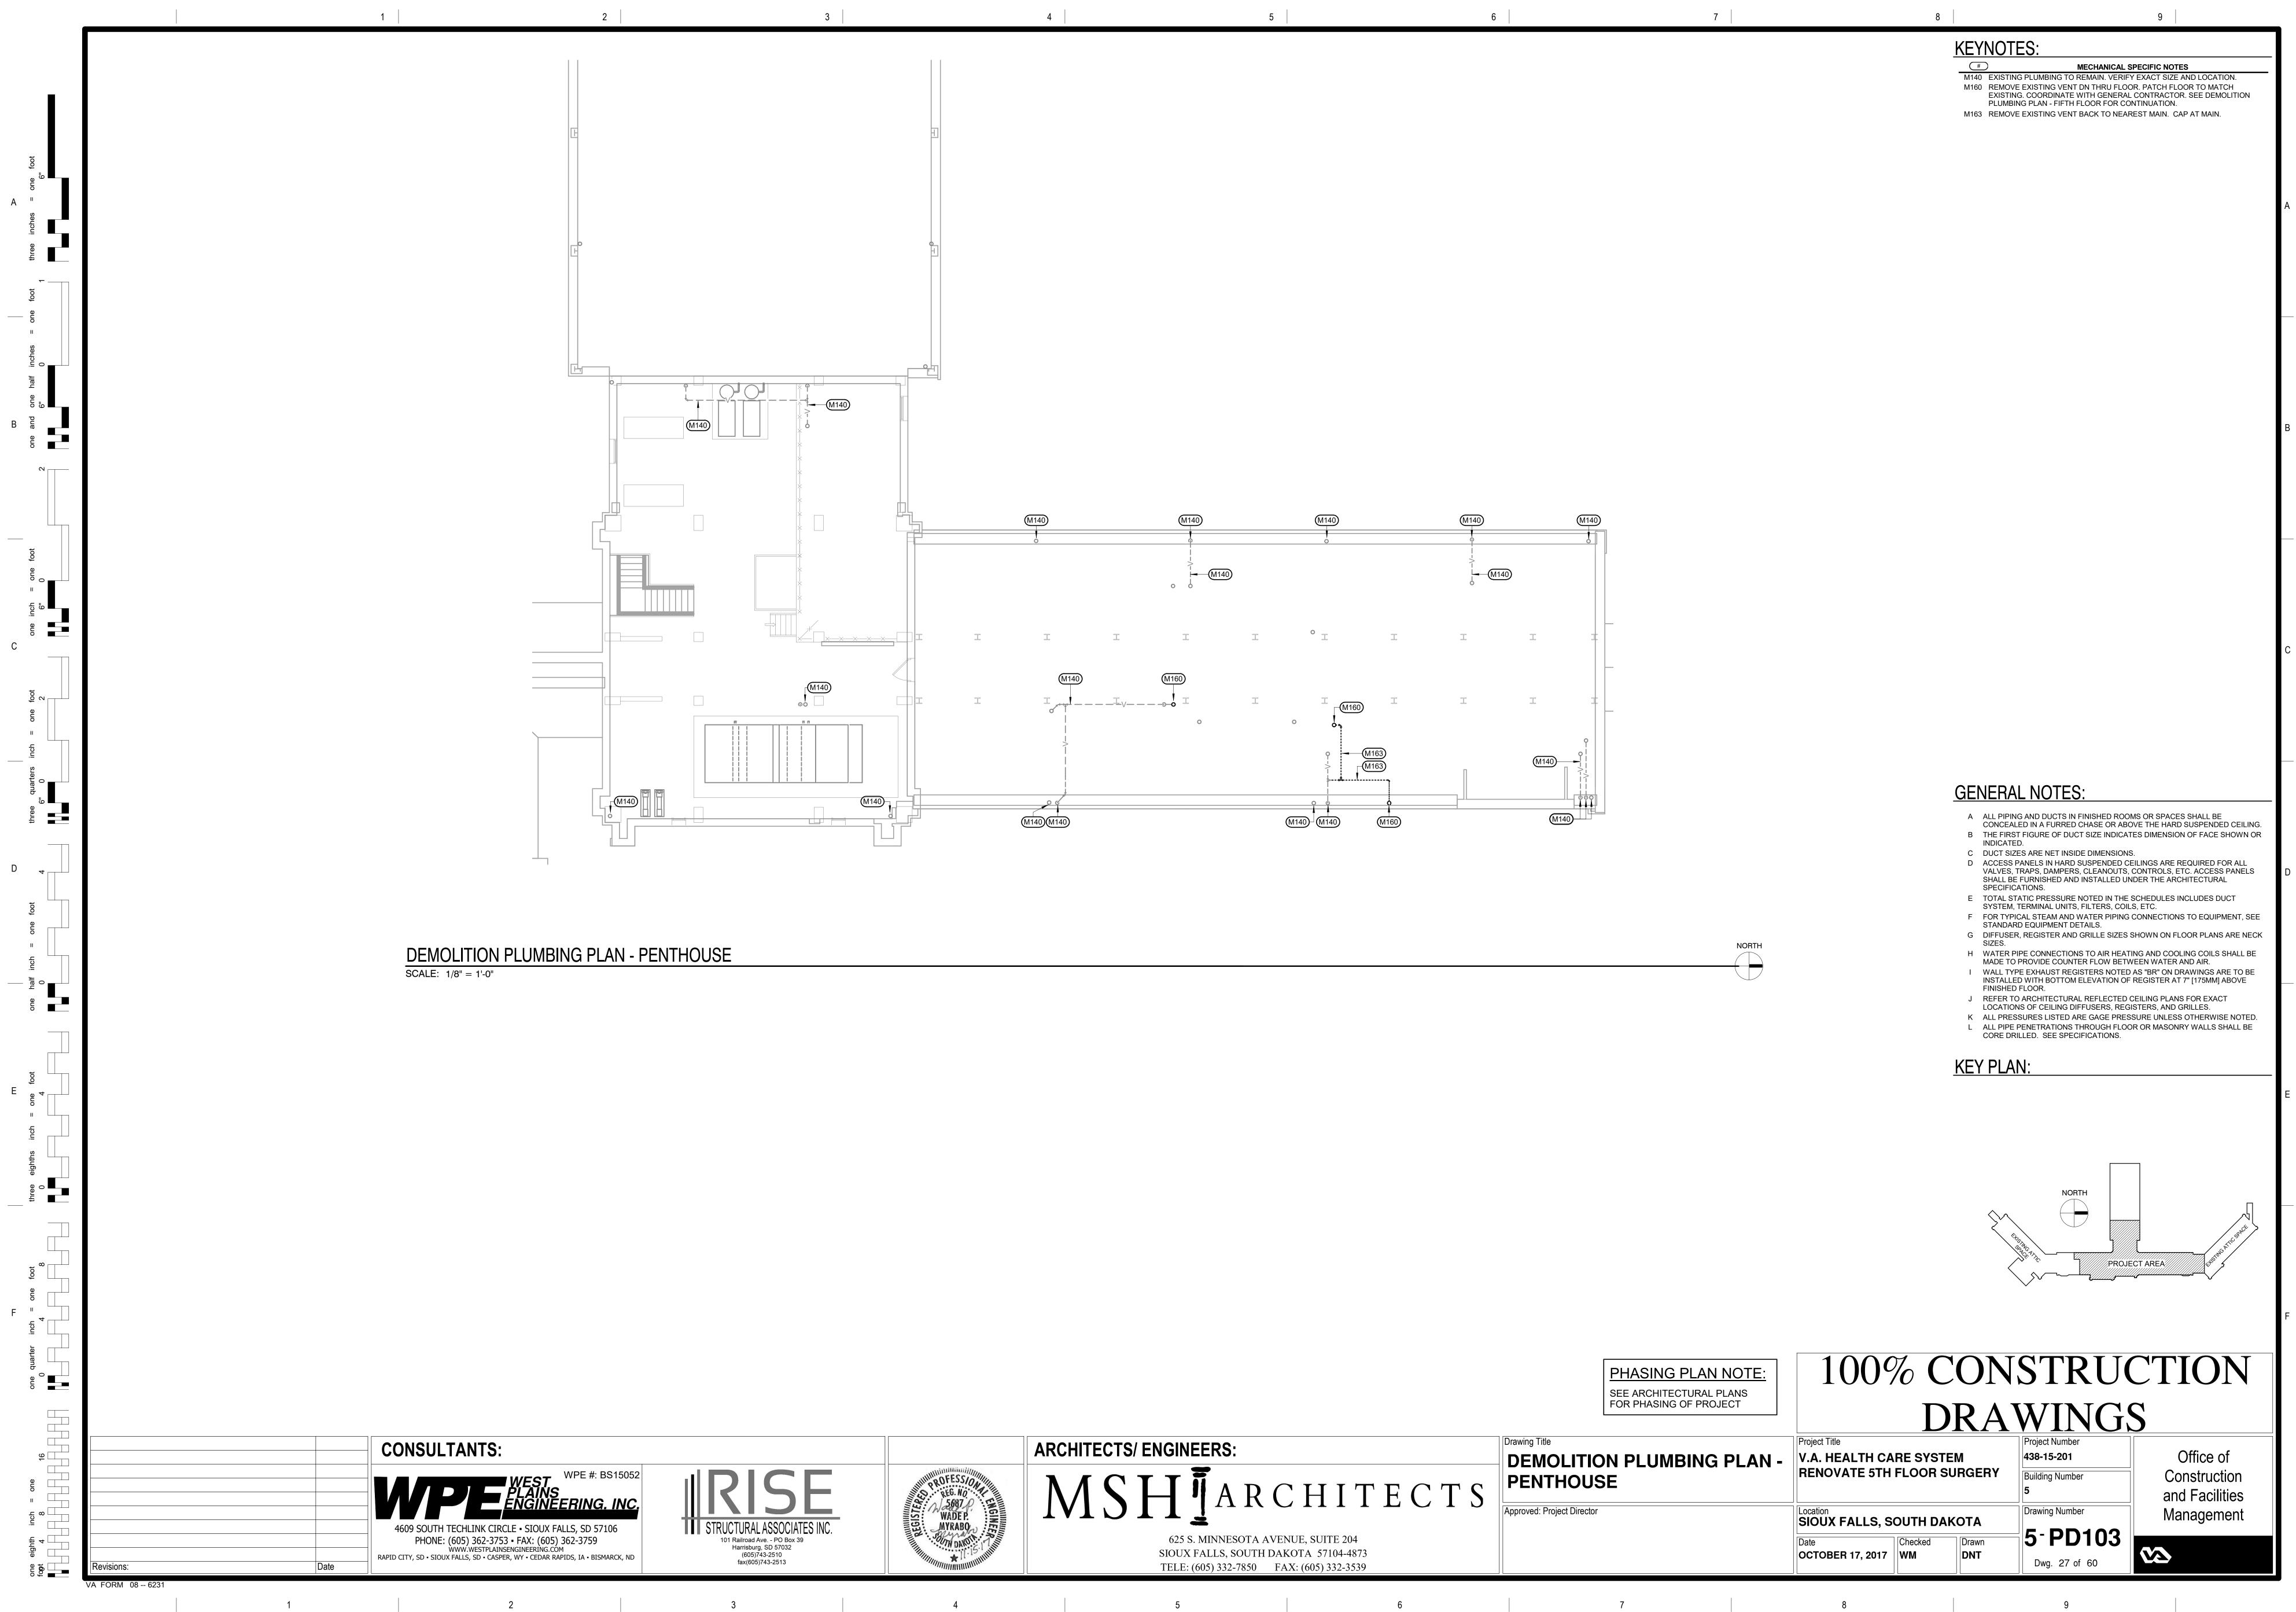

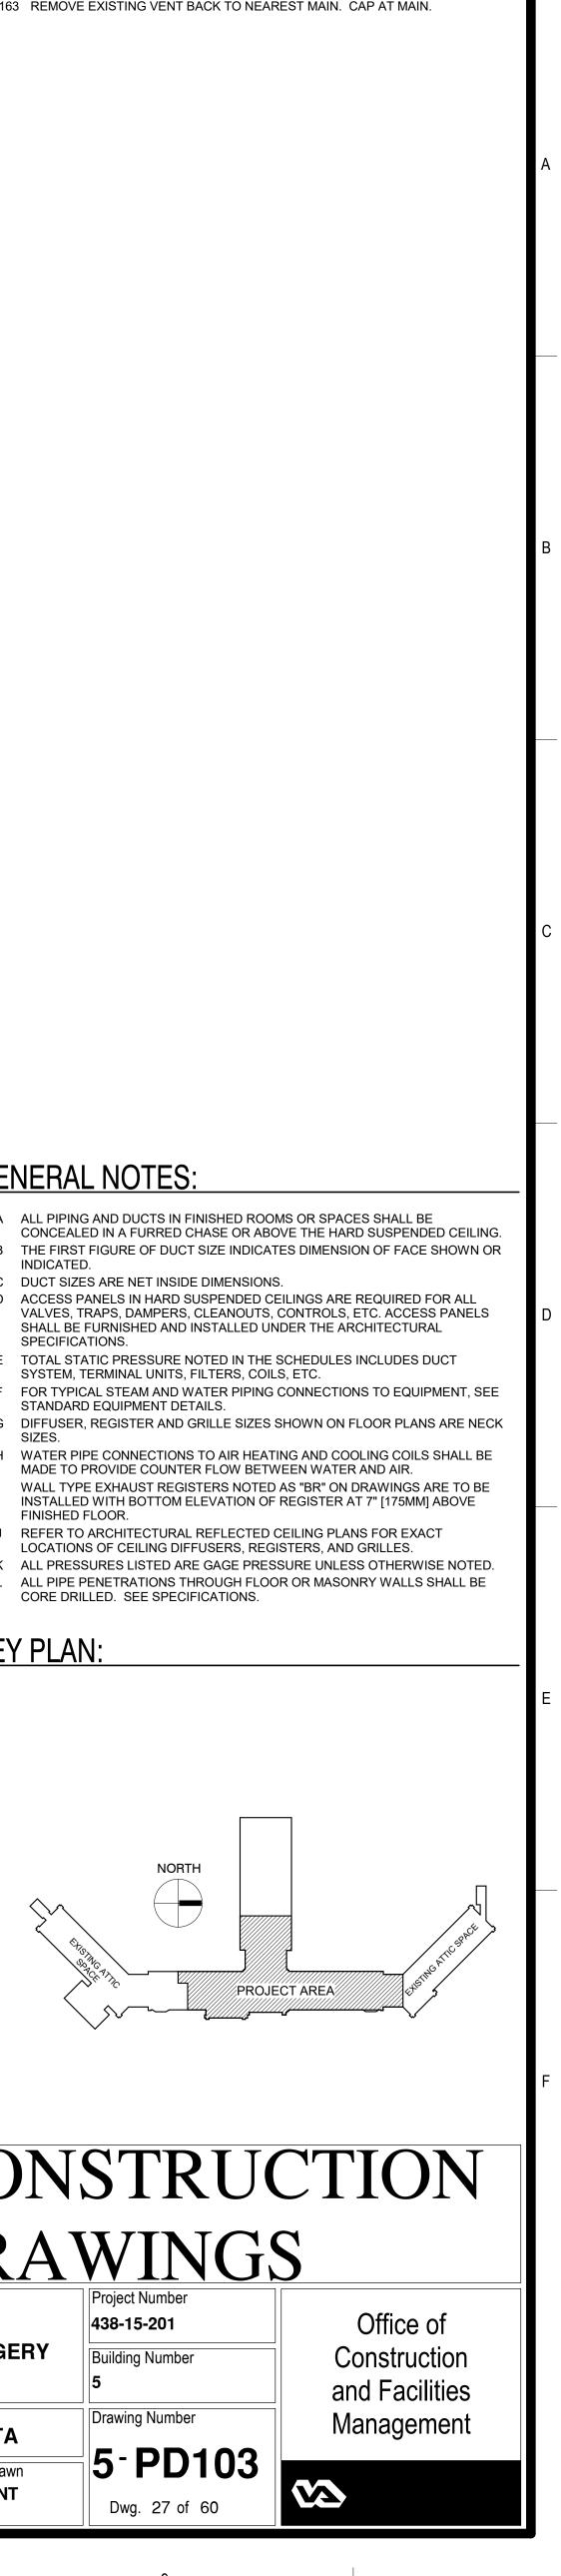

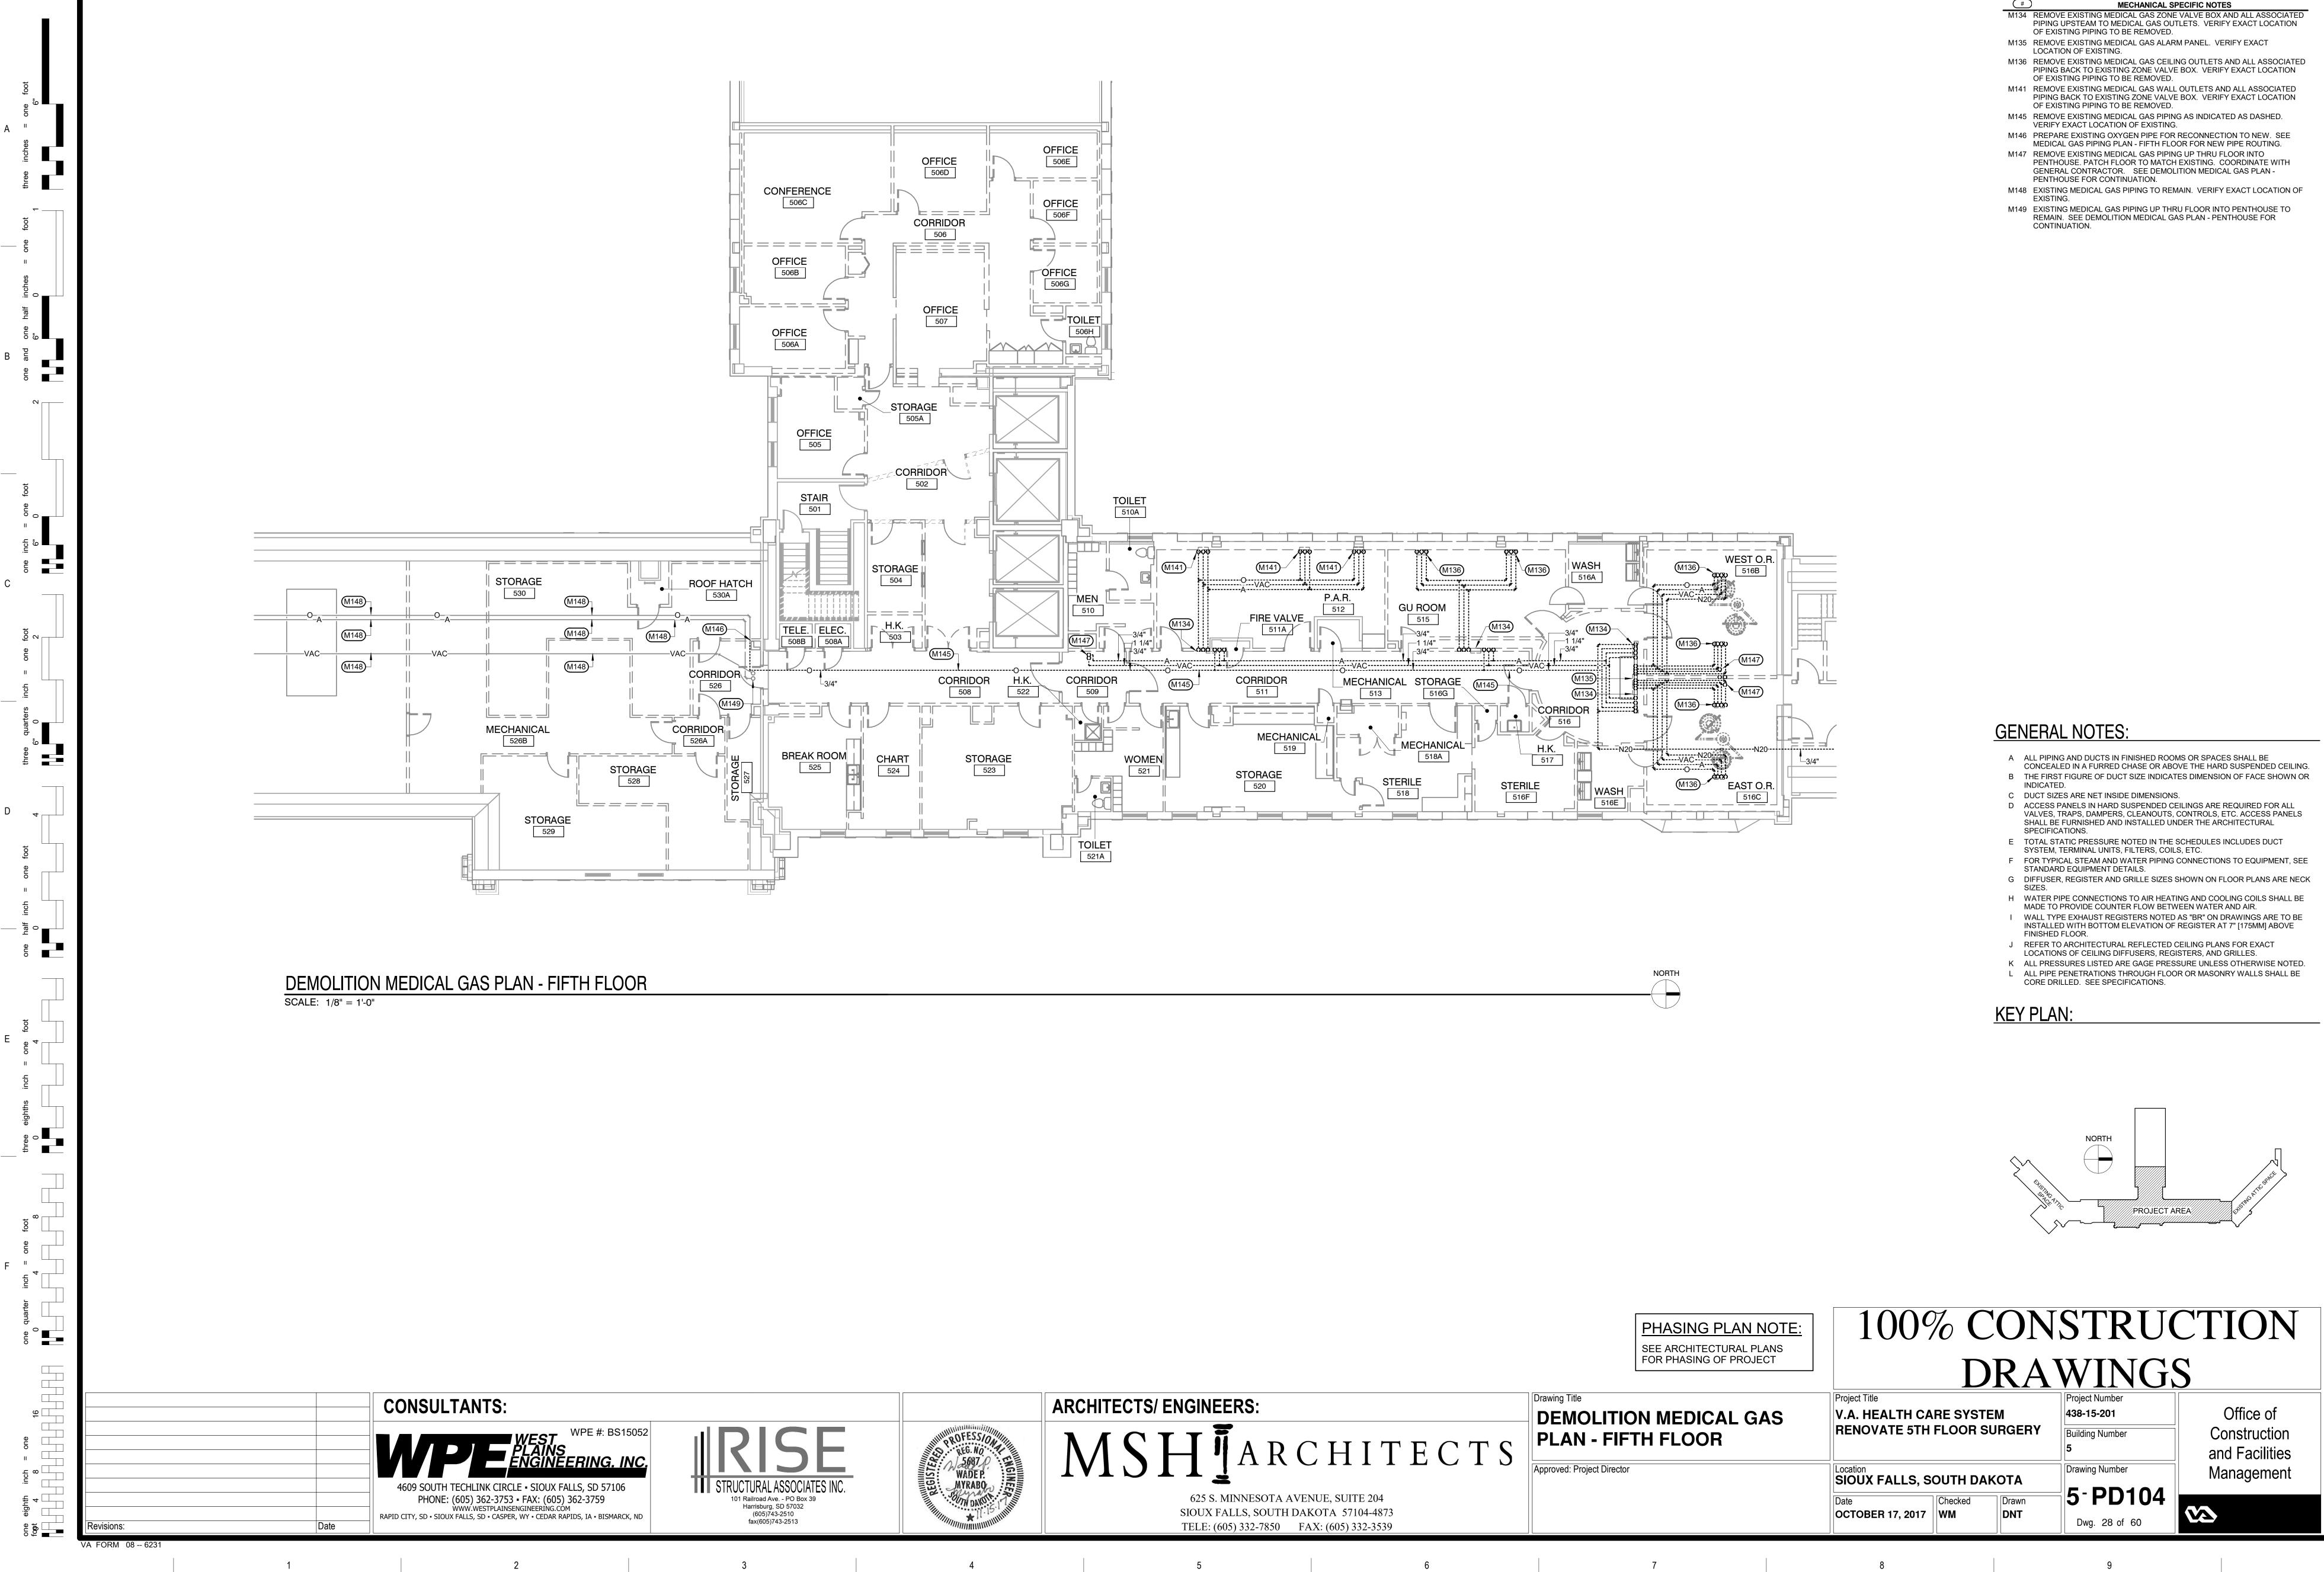







KEYNOTES:


#)
M134	REMOVE EXISTING MI PIPING UPSTEAM TO OF EXISTING PIPING
M135	REMOVE EXISTING MILOCATION OF EXISTIN
M136	REMOVE EXISTING ME PIPING BACK TO EXIS OF EXISTING PIPING T
M141	REMOVE EXISTING ME PIPING BACK TO EXIS OF EXISTING PIPING T
M145	REMOVE EXISTING MI VERIFY EXACT LOCAT
M146	PREPARE EXISTING C MEDICAL GAS PIPING
M147	REMOVE EXISTING MI PENTHOUSE. PATCH I GENERAL CONTRACT PENTHOUSE FOR COI
M148	EXISTING MEDICAL GA
M149	EXISTING MEDICAL GAR

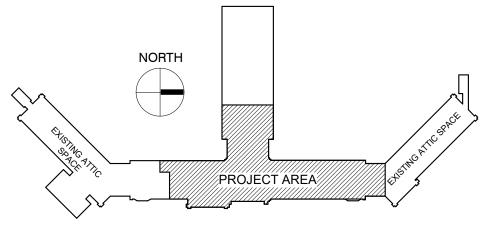


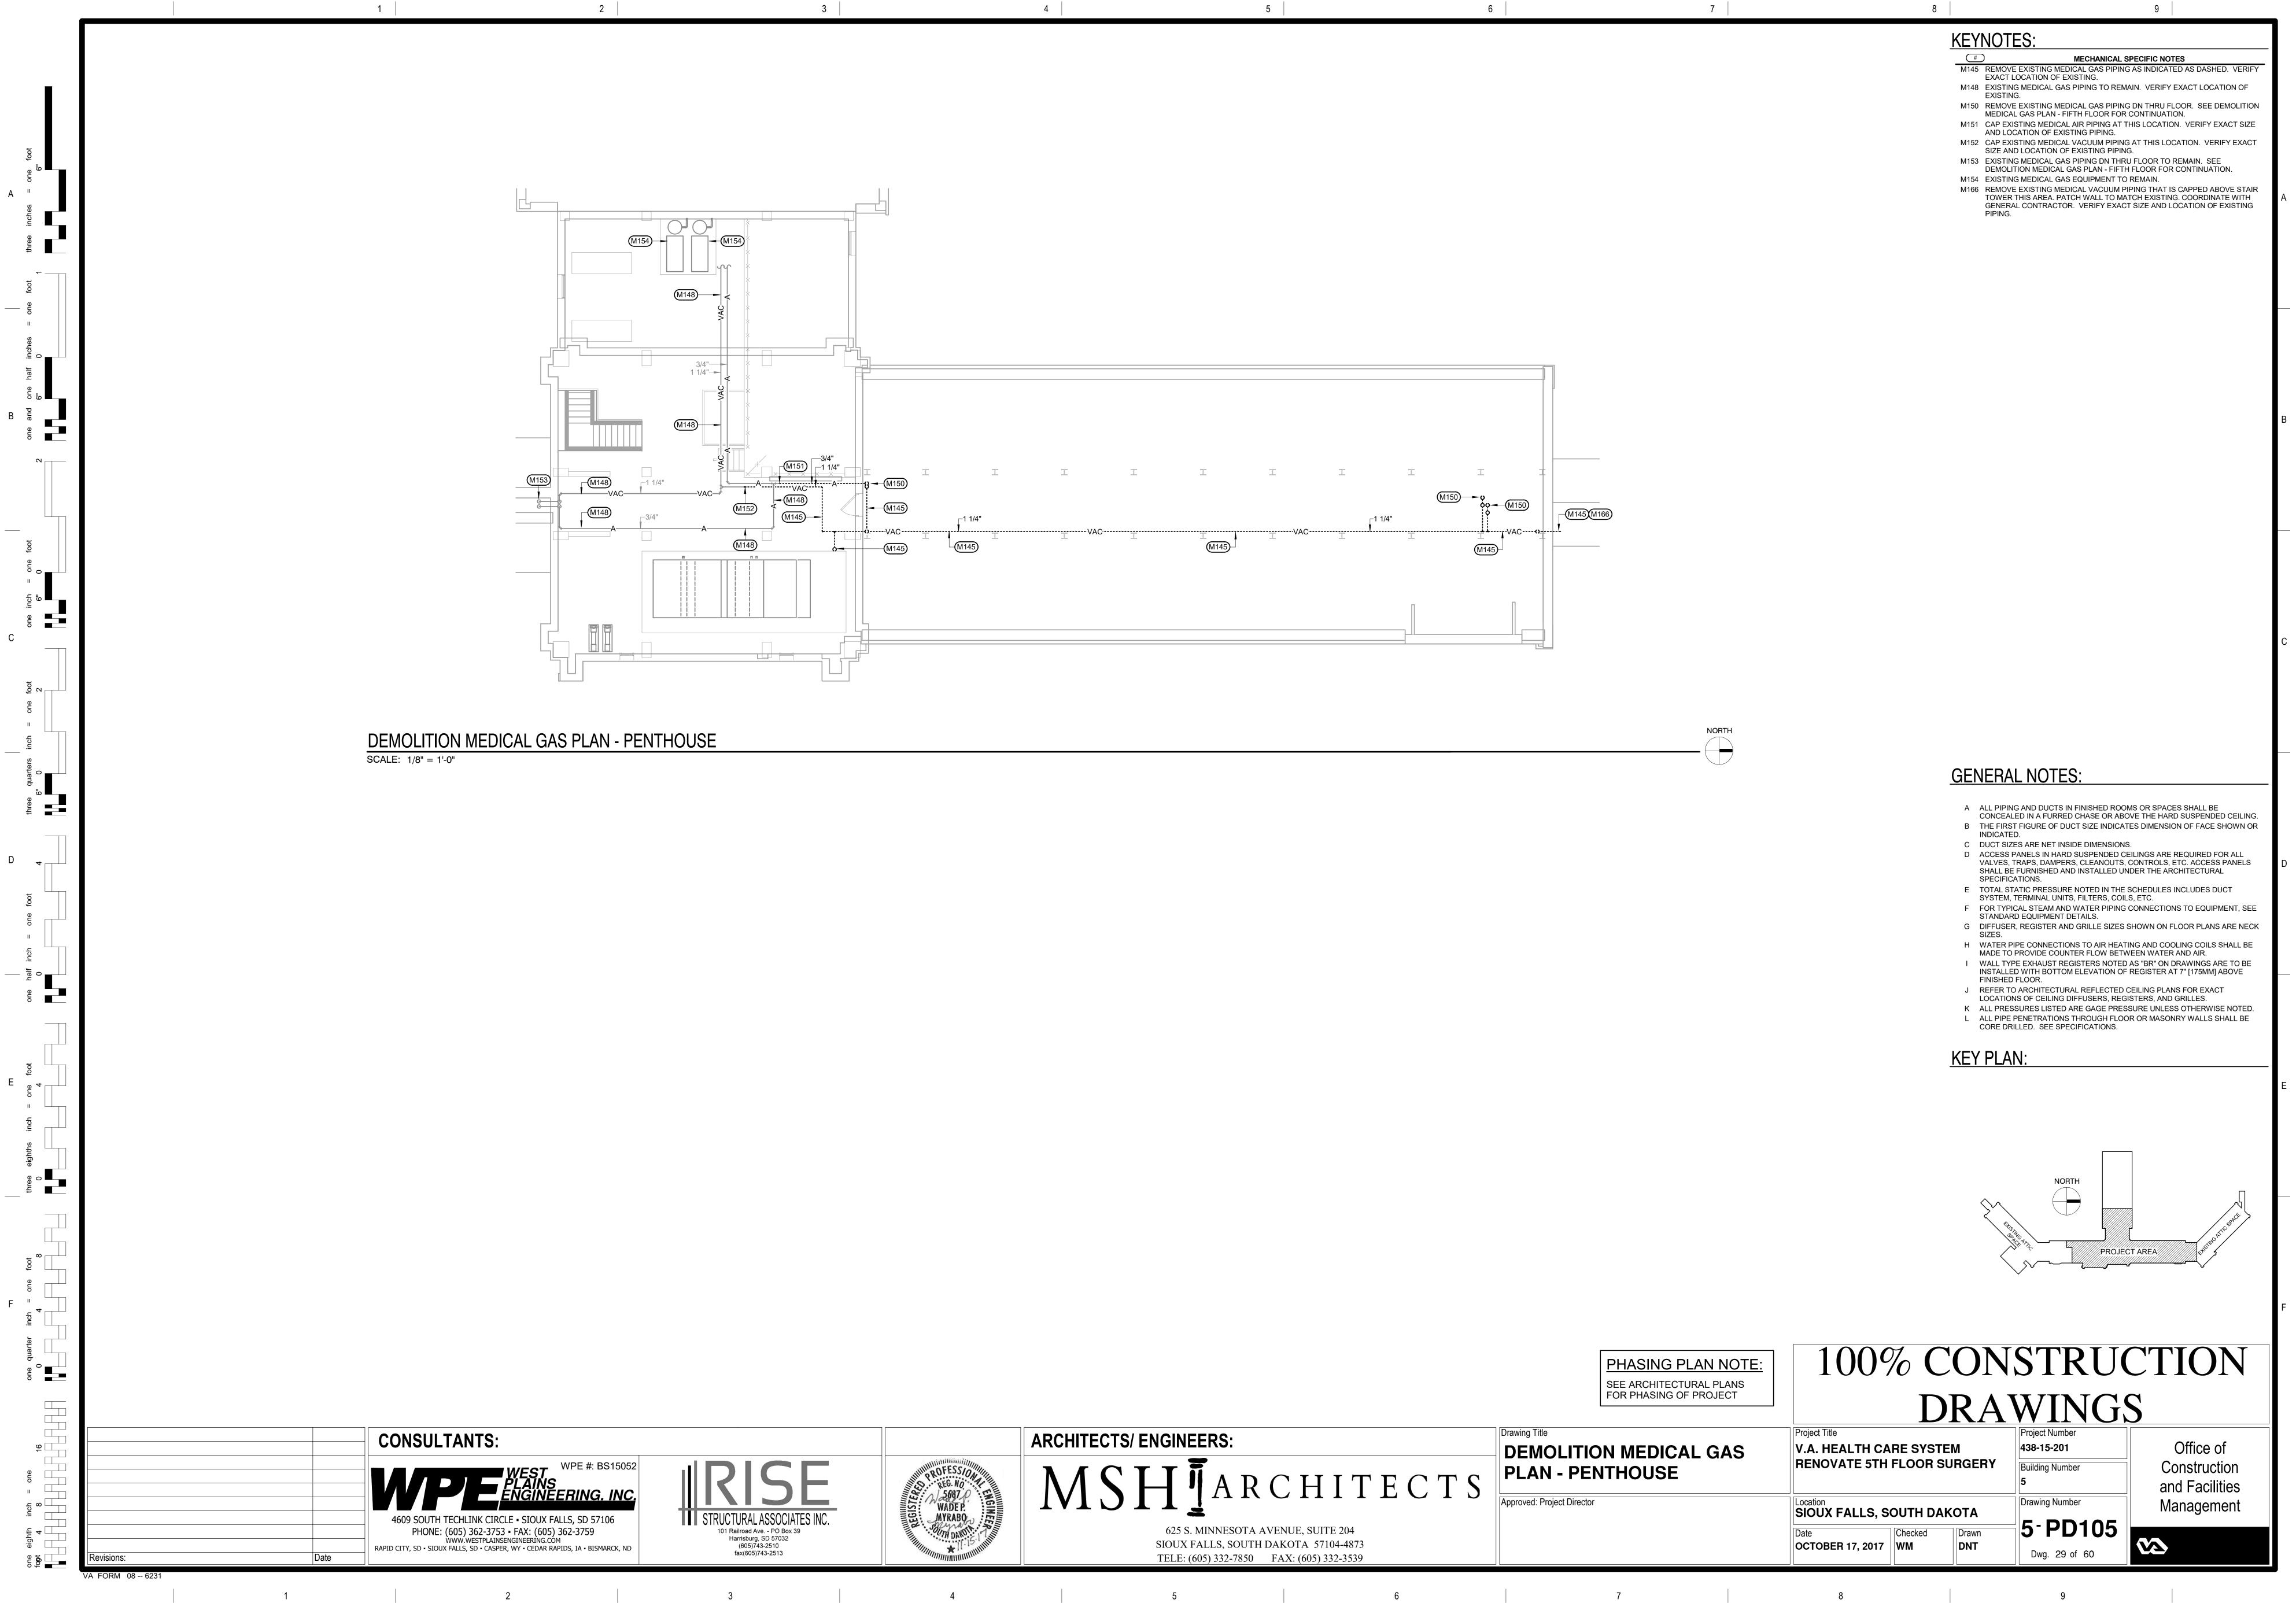

(#)
M145	REMOVE EXISTING ME EXACT LOCATION OF
M148	EXISTING MEDICAL G
M150	REMOVE EXISTING ME MEDICAL GAS PLAN -
M151	CAP EXISTING MEDICA
M152	CAP EXISTING MEDIC
M153	EXISTING MEDICAL GA
M154	EXISTING MEDICAL G
M166	REMOVE EXISTING ME TOWER THIS AREA. P. GENERAL CONTRACT



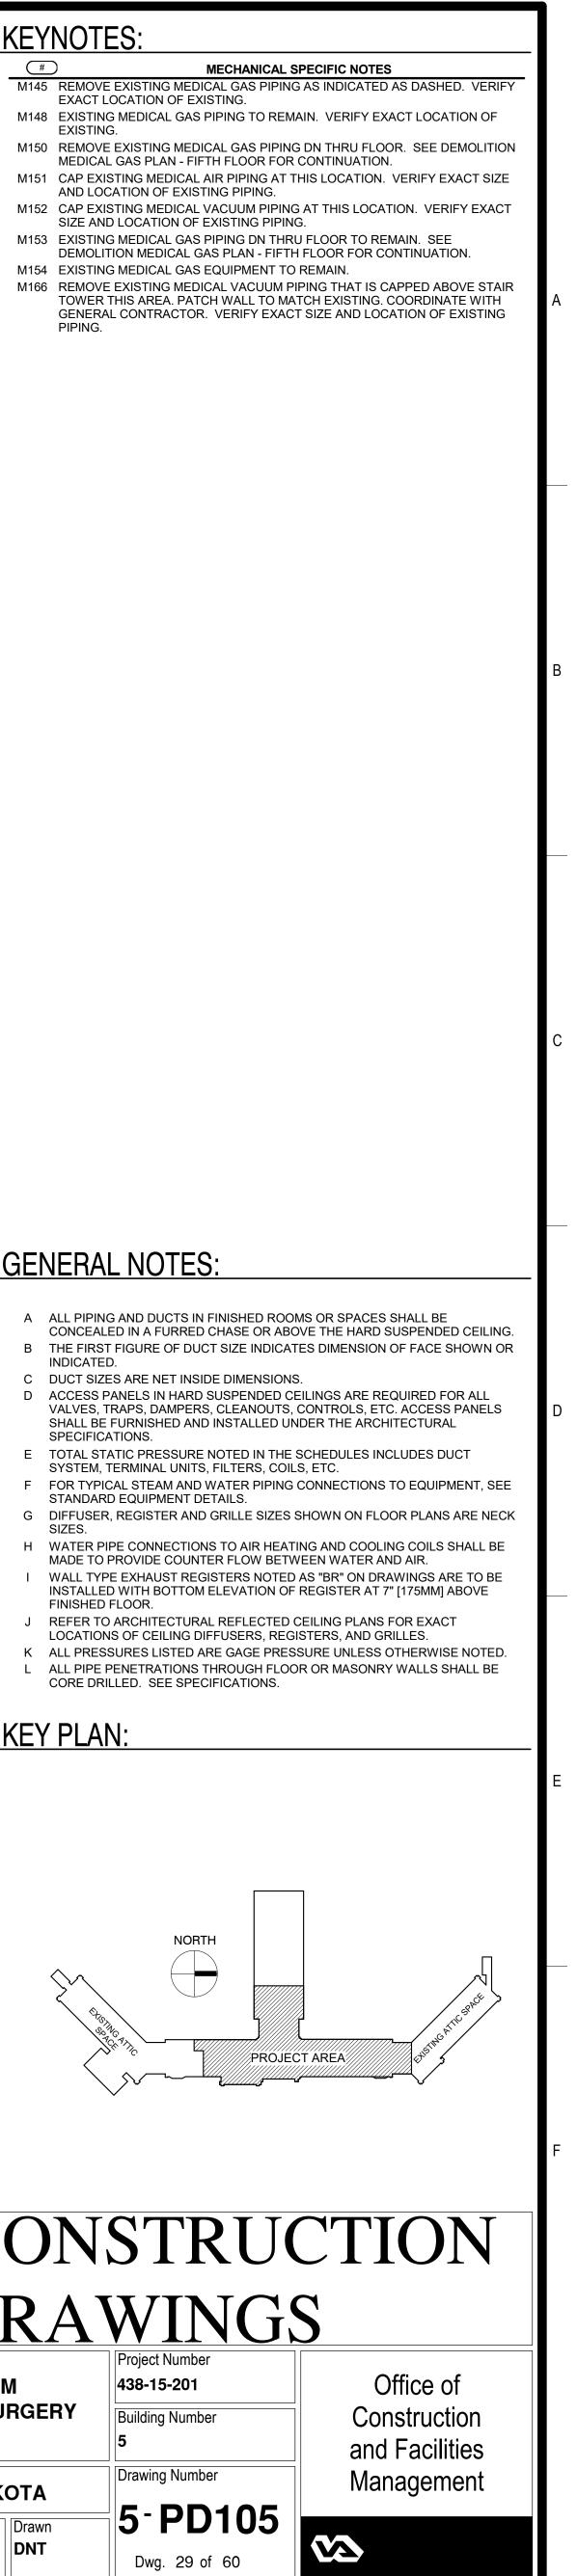

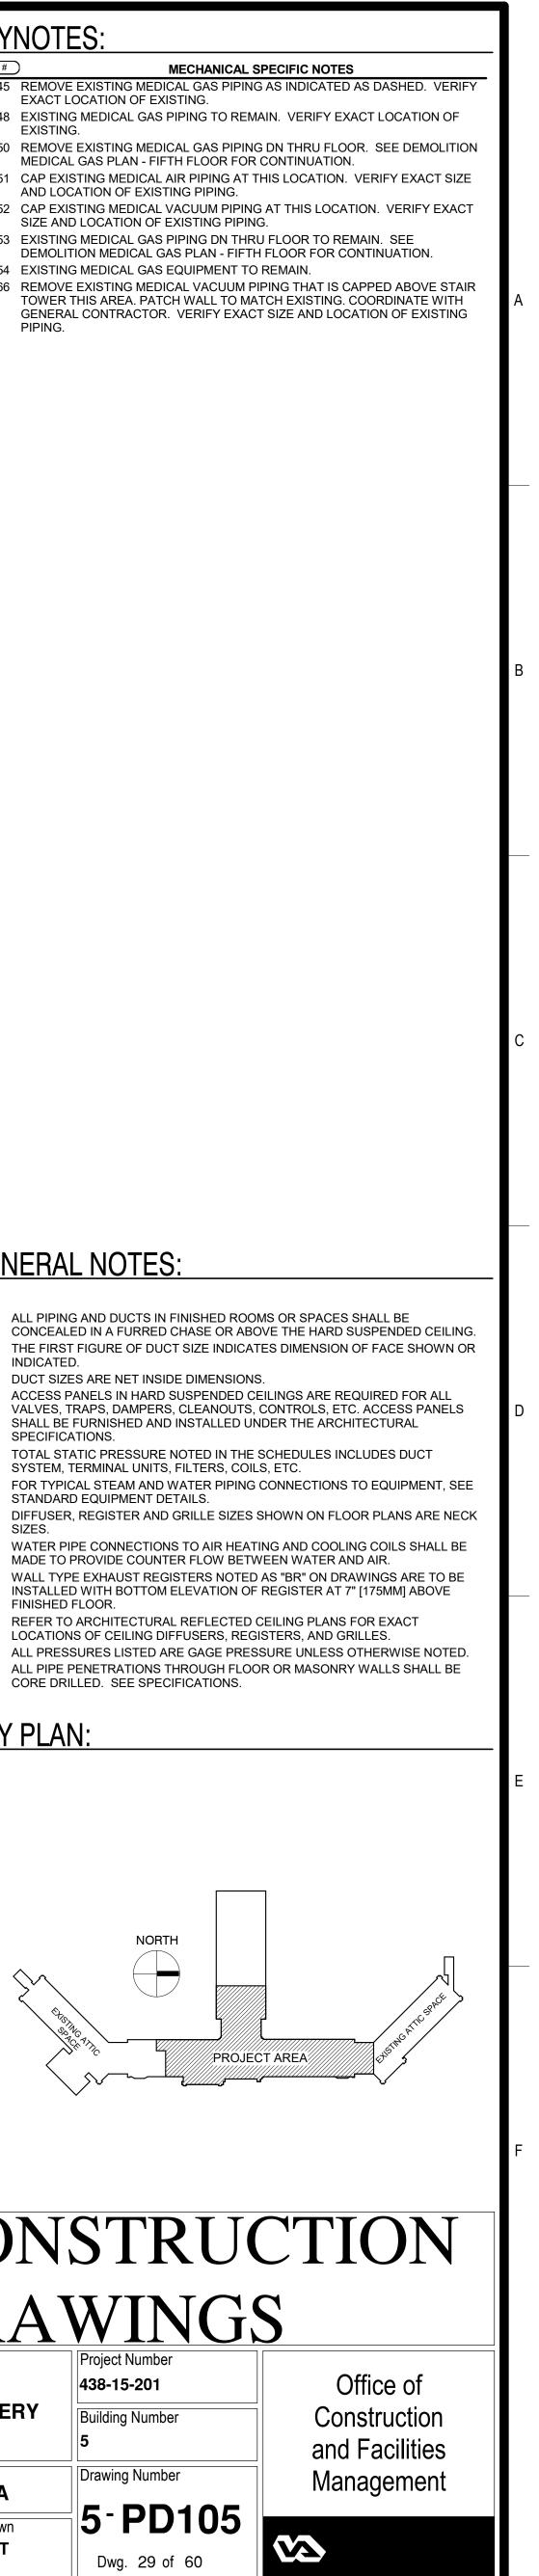



PLUMBING ABBREVIAT
A/E ARCHITECT / ENGINEER AD AREA DRAIN/ACCESS DOOR AFF ABOVE FINISH FLOOR AFG ABOVE FINISH GRADE AG AIR GAP AP ACCESS PANEL AS AUTOMATIC SPRINKLER ASD ADJUSTABLE SPEED DRIVES ASD AUTOMATIC SPRINKLER DRAIN ASHRAE AMERICAN SOCIETY OF HEATING, REFRIGERATION, AIR CONDITIONING ENGINEERS ASME AMERICAN SOCIETY OF ECHANICAL ENGINEERS ASPE AMERICAN SOCIETY OF PLUMBING ENGINEERS ASPE AMERICAN SOCIETY OF PLUMBING ENGINEERS ASR AUTOMATIC SPRINKLER RISER AV ACID VENT AW ACID WASTE
BFPREDUCED PRESSURE BACKFLOWPREVENTERBHPBREAK HORSEPOWERBSPBLACK STEEL PIPEBTBATHTUBBTUBRITISH THERMAL UNITBTUHBRITISH THERMAL UNIT PER HOUR
 C CELSIUS CA COMPRESSED AIR CGA COMPRESSED GAS ASSOCIATION CFM CUBIC FEET PER MINUTE CI CAST IRON CO CLEANOUT CS CLINICAL SINK CV CONTROL VALVE
DCW DOMESTIC COLD WATER DFU DRAINAGE FIXTURE UNITS DHW DOMESTIC HOT WATER DHWR DOMESTIC HOT WATER RETURN DHWS DOMESTIC HOT WATER SUPPLY DI DEIONIZED WATER DN DOWN DOE DEPARTMENT OF ENERGY DS DOWNSPOUT DW DISHWASHER DWG DRAWING DWH DOMESTIC WATER HEATER DWR DRINKING WATER RETURN DWS DRINKING WATER SUPPLY DWV DRAIN WASTE VENT

1

EL EMCS


PLUMBING PIPING SYMBOLS


	DOMESTIC COLD WATER, COLD WATER
	DOMESTIC HOT WATER, HOT WATER
	DOMESTIC HOW WATER RETURN, HOT WATER RETURN
MAMA MA	MEDICAL AIR
—_MV—_MV—_MV—_	MEDICAL VACUUM
LALALA	LABORATORY AIR
— LV — LV — LV —	LABORATORY VACUUM
— OA— OA— OA—	ORAL EVACUATION
IA IA IA	INDUSTRIAL AIR
— D — D — D —	DRAIN
—SAN—SAN—SAN—	SANITARY SEWER
—	SANITARY SEWER (OPTIONAL)
SANSANSAN	SANITARY SEWER, BELOW GRADE
—SD—SD—SD—	STORM WATER
SDSDSD	STORM WATER, BELOW GRADE
-OSD-OSD-OSD-	OVERFLOW STORM WATER
—SCW—SCW—SCW—	SOFTEN COLD WATER
—FCW—FCW—FCW—	FILTERED COLD WATER
—DWS—DWS—DWS—	DRINKING WATER SUPPLY
—DWR—DWR—DWR—	DRINKING WATER RETURN
—TWS—TWS—TWS—	TEMPERED WATER SUPPLY
—TWR—TWR—TWR—	TEMPERED WATER RETURN
N20N20	NITROUS OXIDE
0 0 0	OXYGEN
N ₂ N ₂	NITROGEN
—NG—NG—NG—	NATURAL GAS
NGNG	NATURAL GAS, BELOW GRADE
—FOD—FOD—FOD—	FUEL OIL DISCHARGE
—FOS—FOS—FOS—	FUEL OIL SUPPLY
—FOV—FOV—FOV—	FUEL OIL VENT
FORFORFOR	FUEL OIL RETURN

CONSULTAN ⁻	ΓS:
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	<u>PLUMBING AE</u>	BREVIATION	<u>NS</u>
GPD GPH	GALLON GRADE CLEANOUTS GALLONS PER DAY GALLONS PER HOUR	MBH	METER MEDICAL AIR MANUAL AIR VENT 1000 BTUH MEDICAL

	AGENCY	
EPACT	ENERGY POLICY ACT	
ESC	ESCUTCHEON	
ESH	EMERGENCY SHOWER	
ET	EXPANSION TANK	
EWH	ELECTRIC WATER HEATER	
FWS	EYE WASH STATION	

EWS EYE WASH STATION EWS/SH EYE WASH/DRENCH SHOWER

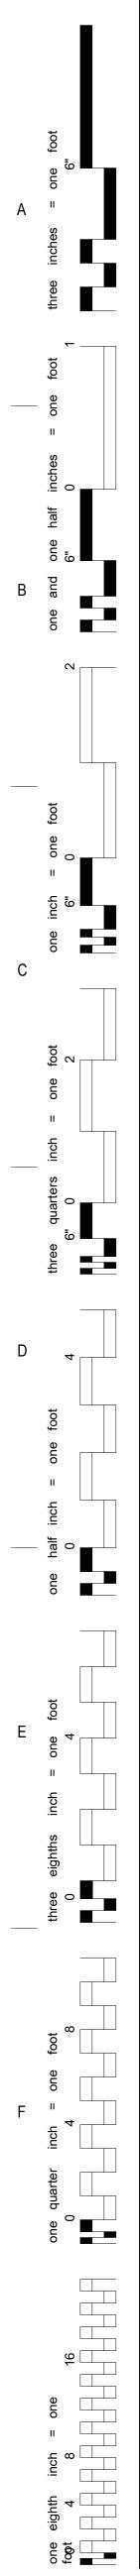ENERGY MONOSERRAT

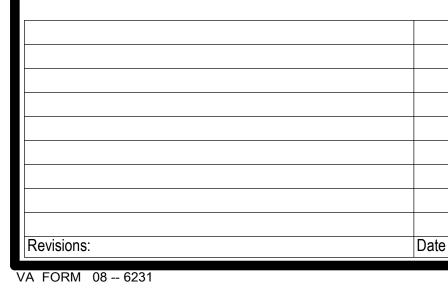ELEVATION

EPA ENVIROMENTAL PROTECTION

AND CENTRAL SYSTEM

AGENCY

EX EXISTING

F FAHRENHEIT

FD FLOOR DRAIN FDC FIRE DEPARTMENT (HOSE) CONNECTION FM FLOW METER FOP FUEL OIL PUMP

FC FAN COIL FCO FLOOR CLEANOUT

FOR FUEL OIL RETURN

FOS FUEL OIL SUPPLY FOV FUEL OIL VENT

FS FLOOR SINK FS FLOW SWITCH

FU FIXTURE UNITS

FCW FILTERED COLD WATER

 GAL GALLON GCO GRADE CLEANOUTS GPD GALLONS PER DAY GPH GALLONS PER HOUR GPM GALLONS PER MINUTE GPR GAS PRESSURE REGULATOR GRS GAS REGULATOR STATION GT GREASE TRAP GVTR GAS VENT THROUGH ROOF GWH GAS FIRED WATER HEATER
H&CW HOT AND COLD WATER HB HOSE BIBB HD HUB DRAIN HEX HEAT EXCHANGER HP HORSEPOWER HS HAND SINK HST HOT WATER STORAGE TANK (DOMESTIC) HWB HOT WATER BOILER HWCP HOT WATER CIRCULATING PUMP HWP HOT WATER PUMP HYD HYDRANT
ID INSIDE DIAMETER IE INVERT ELEVATION ICW INDUSTRIAL COLD WATER IHW INDUSTRIAL HOT WATER INV INVERT IPC INTERNATIONAL PLUMBING CODE IRW IRRIGATION WATER IW INDIRECT WASTE IWH INSTANTANEOUS WATER HEATER IWH INSTANTANEOUS WATER HEATER IWR INDUSTRIAL WATER RETURN IWS INDUSTRIAL WATER SUPPLY
KW KILOWATT KWH KILOWATT-HOUR

KW	KILOWATT
KWH	KILOWATT-HOUR
L/S	LITER PER SECOND
LA	LABORATORY AIR
LAV	LAVATORY
LBS/H	IR POUNDS PER HOUR

LCW	LABORATORY COLD WATER
LHW	LABORATORY HOT WATER
LNG	LIQUID NATURAL GAS
LOX	LIQUID OXYGEN
LV	LABORATORY VACUUM
LW	LOW WATER

MAV	MANUAL AIR VENT
MBH	1000 BTUH
MED	MEDICAL
MER	MECHANICAL EQUIPMENT
ROOM	Л
MH	MANHOLE
MOU	MEMORANDUM OF
UNDE	RSTADING
MSB	MOP SERVICE BASIN
MV	MEDICAL VACUUM
	NITROGEN
	NITROUS OXIDE
	NORMALLY CLOSED
-	NATURAL GAS
	NOT IN CONTRACT
	NORMALLY OPEN
	NOMINAL
	NON POTABLE WATER
NIS	NOT TO SCALE
02	OXYGEN
OC	ON CENTER
	OUTSIDE DIAMETER
OFD	OVERFLOW DRAIN
OR	OPERATING ROOM
-	OVERFLOW STORM DRAIN
	OVERFLOW

	FLUMBIN
IPC	INTERNATIONAL PLUMBI
PA	PASCAL
PA PD	PRESSURE DROP OR
DIFFEF	
PDI	
	TUTE
PG	PRESSURE GAGE
PP	PLUMBING PUMP
PPM	PARTS PER MILLION
PRS	PRESSURE REDUCING S
PRV	PRESSURE REDUCING V
PSI	POUNDS PER SQUARE IN
PSIA	POUNDS PER SQUARE IN
ATM	DSPHERE
	POUNDS PER SQUARE IN
GAG	
	PRESSURE TEMPERATU
VALV	
PW	POTABLE WATER
	ROOF DRAIN
RDL	ROOF DRAIN LEADER
RL	ROOF LEADER
RP	RECIRCULATION PUMP
RO	REVERSE OSMOSIS WAT
RWL	RAIN WATER LEADER
SAN	SANITARY SEWER
	NA SHEET METAL AND AIR
	DITIONING CONTRACTORS
	TIONAL ASSOCIATION
	STANDARD CUBIC FOOT
	SOFTENED COLD WATER
	STORM DRAIN MANHOLE
SMH SP	SANITARY MANHOLE SUMP PUMP
SPR	

SW	STORM WATER
TCV	TEMPERATURE CONTROL
TD	TEMPERATURE DIFFERENCE
TD	TRENCH DRAIN
TDH	TOTAL DYNAMIC HEAD
TEMP	TEMPERATURE
TMV	THERMOSTATIC MIXING VALV
TP	TRAP PRIMER
TSTAT	THERMOSTAT
TWR	TEMPERED WATER RETURN

TYP TYPICAL

ST STORAGE TANK

GENERAL PLUMBING SYMBOLS

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DIRECTION OF PIPE PITCH (DOWN)	———————————————————————————————————————
DIRECTION OF FLOW	——————————————————————————————————————
ANCHOR	
REDUCER OR INCREASER	
ECCENTRIC REDUCER	TL-
TOP CONNECTION, 45° OR 90°	
BOTTOM CONNECTION, 45° OR 90°	ø ′
SIDE CONNECTION	
CAPPED OUTLET	
RISE OR DROP IN PIPE	F.
UNION	
PIPE UP	
PIPE DOWN	Ţ
POINT OF CONNECTION BETWEEN NEW AND EXISTING WORK	
LIMIT OF DEMOLITION	
INVERTED BUCKET TRAP SET INCLUDING PIPING ACCESSORIES	
FLOAT & THERMOSTATIC TRAP SET INCLUDING PIPING ACCESSORIES	
STRAINER	\Box
THERMOMETER	
PRESSURE GAGE	
FLOW ELEMENT	
CLEAN OUT	
HOSE BIB	

PLUMBING VALVE SYMBOLS

NG VALVE SYNIBOLS				
GATE VALVE				
GLOBE VALVE				
GATE VALVE WITH 3/4 " HOSE ADAPTER				
CHECK VALVE				
ANGLE GLOBE VALVE				
BUTTERFLY VALVE				
BALL VALVE				
MODULATING CONTROL VALVE				
TWO POSITION CONTROL VALVE				
THREE-WAY MODULATING CONTROL VALVE				
THREE-WAY TWO POSITION CONTROL VALVE				
PRESSURE REGULATING VALVE				
AUTOMATIC FLOW CONTROL VALVE				
PRESSURE RELIEF VALVE				
MANUAL AIR VENT				

TEST PLUG (PRESSURE/TEMPERATURE)

AUTOMATIC AIR VENT





4

ARCHITECTS/ ENGINEERS:

ARCHIT MSH

5

625 S. MINNESOTA AVENUE, SUITE 204 SIOUX FALLS, SOUTH DAKOTA 57104-4873

 TELE: (605) 332-7850
 FAX: (605) 332-3539

6

PLUMBING ABBREVIATIONS


/BING CODE	VB VCO VP VS VSD	VENT VACUUM VACUUM BREAKER VACUUM CLEANER OUTLET VACUUM PUMP VENT STACK VARIABLE SPEED DRIVE VENT THROUGH ROOF
	WC WCO WG WH WH WHA WL WM WPD WS	WASTE WATER CLOSET WALL CLEANOUT WATER GAGE WALL HYDRANT WATER HEATER WATER HAMMER ARRESTER WATER LINE WATER METER WATER PRESSURE DROP WASTE STACK WATER SUPPLY FIXTURE UNITS
P /ATER	YCO YH	YARD CLEANOUT YARD HYDRANT

CTORS ; FOOT/MINUTE WATER ANHOLE

ONTROL FFERENCE IEAD 1IXING VALVE

TWS TEMPERED WATER SUPPLY

DRAWING SYMBOLS

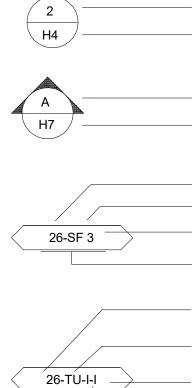

7

DETAIL NUMBER

DRAWING NUMBER WHERE DRAWN

DRAWING NUMBER WHERE SHOWN

SECTION LETTER

BUILDING NO. WHERE EQUIPMENT IS LOCATED. EQUIPMENT ABBREVIATION (SUPPLY FAN)

SUPPLY FAN NO. 3 IN BUILDING NO. 26 - TYPICAL UNIT NO.


BUILDING NO. WHERE EQUIPMENT IS LOCATED - ITEM (TERMINAL UNIT SHOWN)


ITEM NUMBER (TERMINAL UNIT NO. 1)

SERVED BY AIR HANDLER UNIT NO. 1

		100% CONSTE			
			D	RA	
	Drawing Title	Project Title			Project Numbe
		V.A. HEALTH CARE SYSTEM RENOVATE 5TH FLOOR SURGERY			438-15-201
					Building Number
ECTS		3			
	Approved: Project Director	Location SIOUX FALLS, SOUTH DAKOTA		КОТА	Drawing Numb
		Date	Checked	Drawn	5-PL
		OCTOBER 17, 2017	WM	DNT	Dwg. 30 o

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CONSULTANTS:

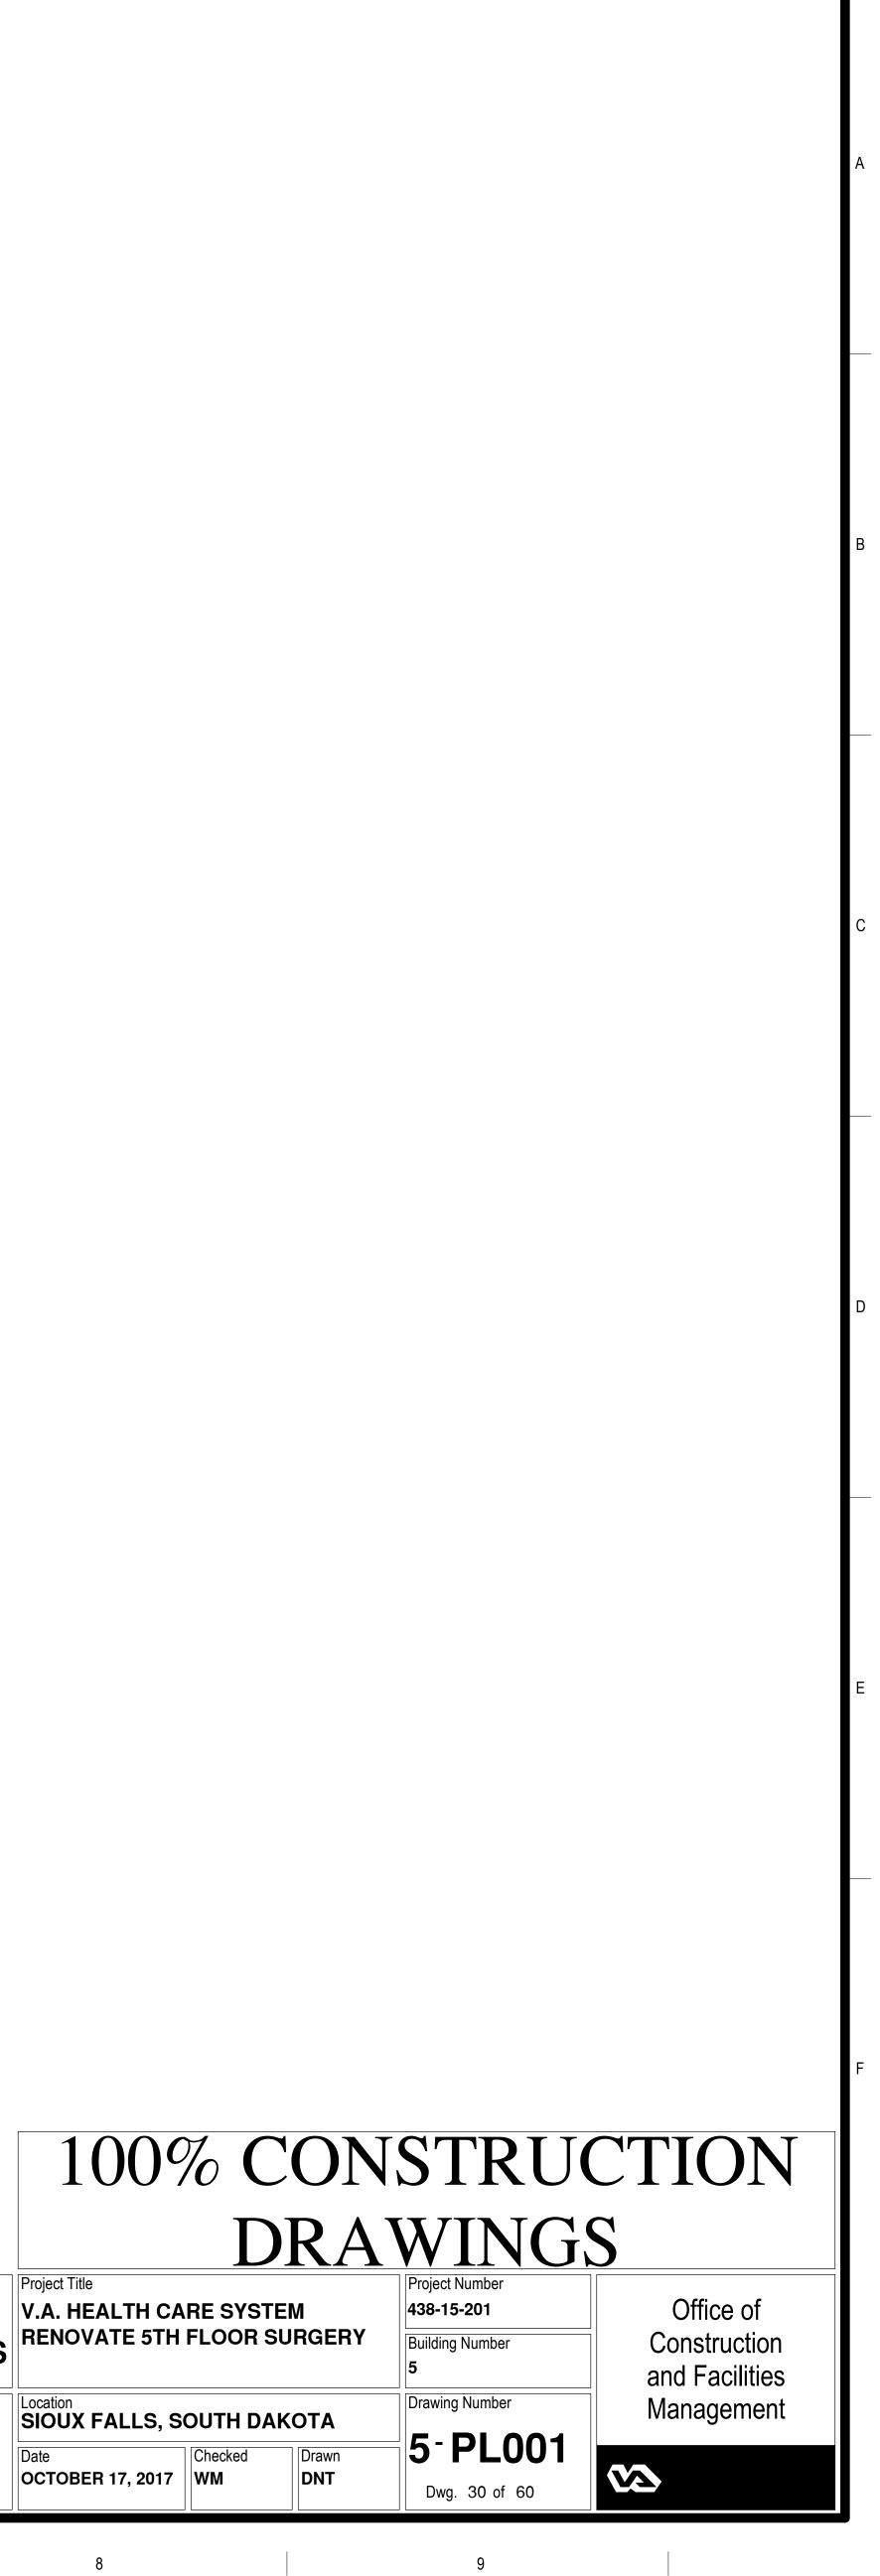
Date
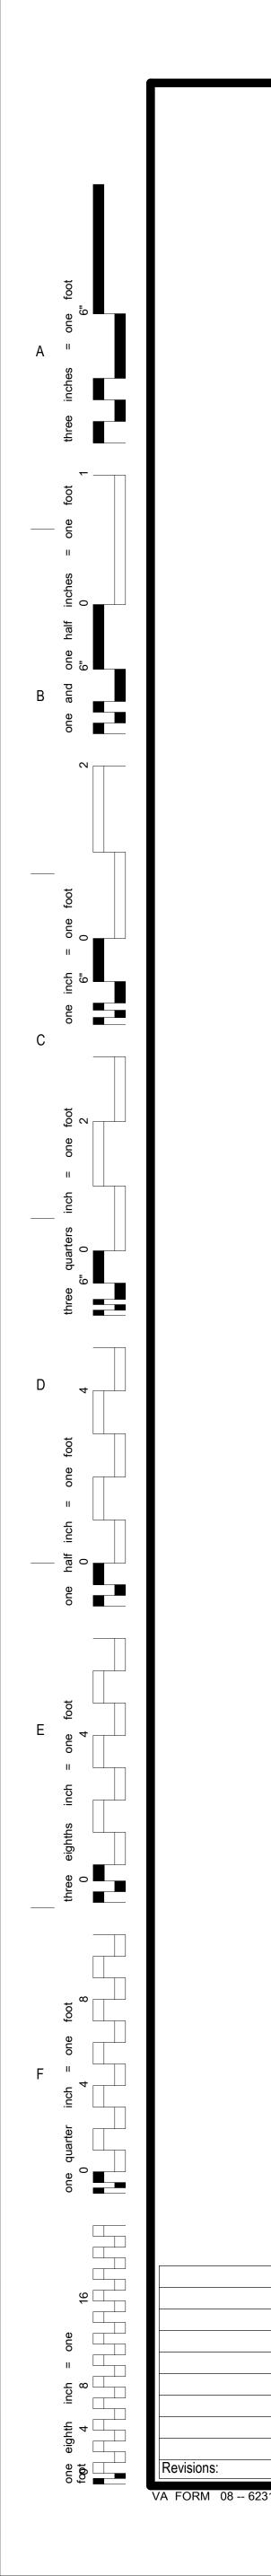
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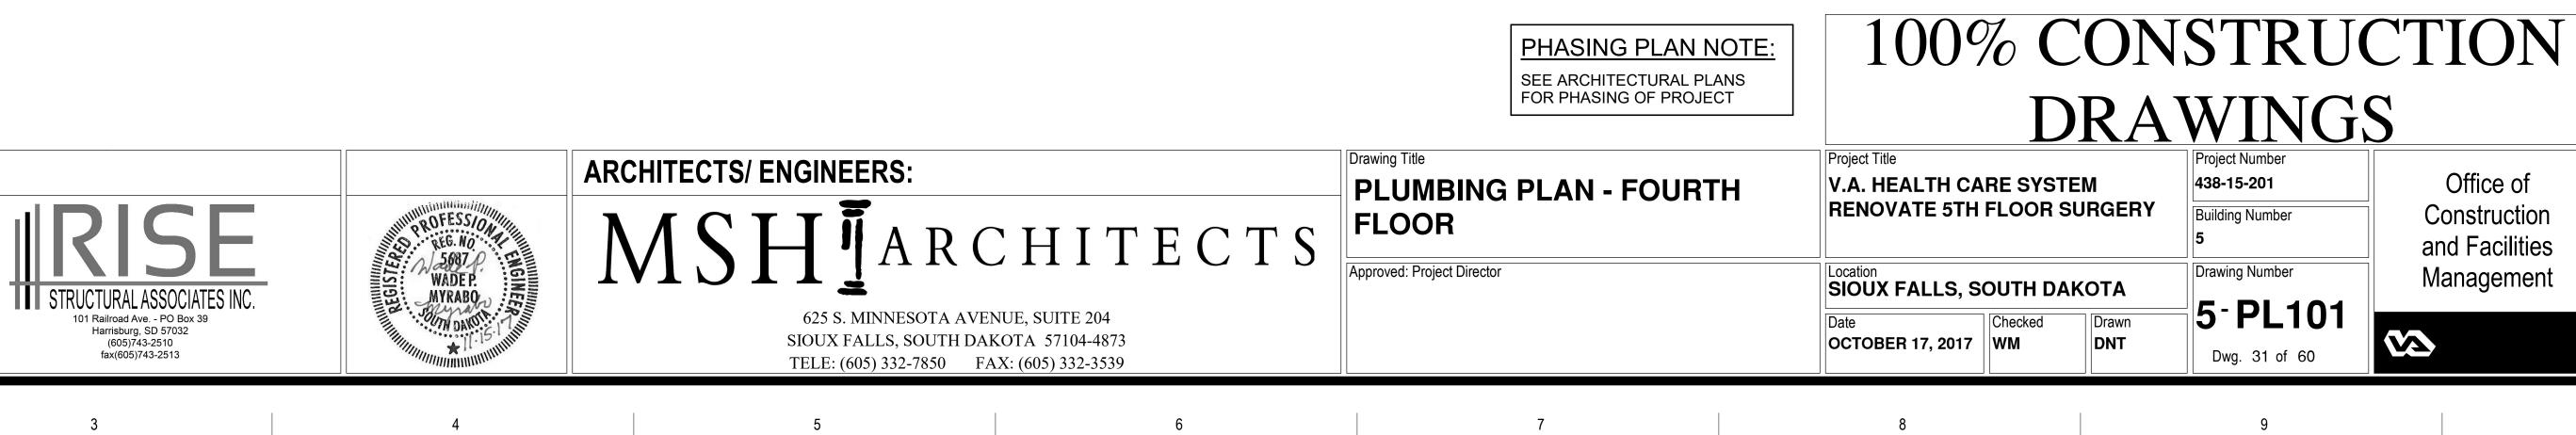


2

PLUMBING PLAN - FOURTH FLOOR SCALE: 1/8" = 1'-0"

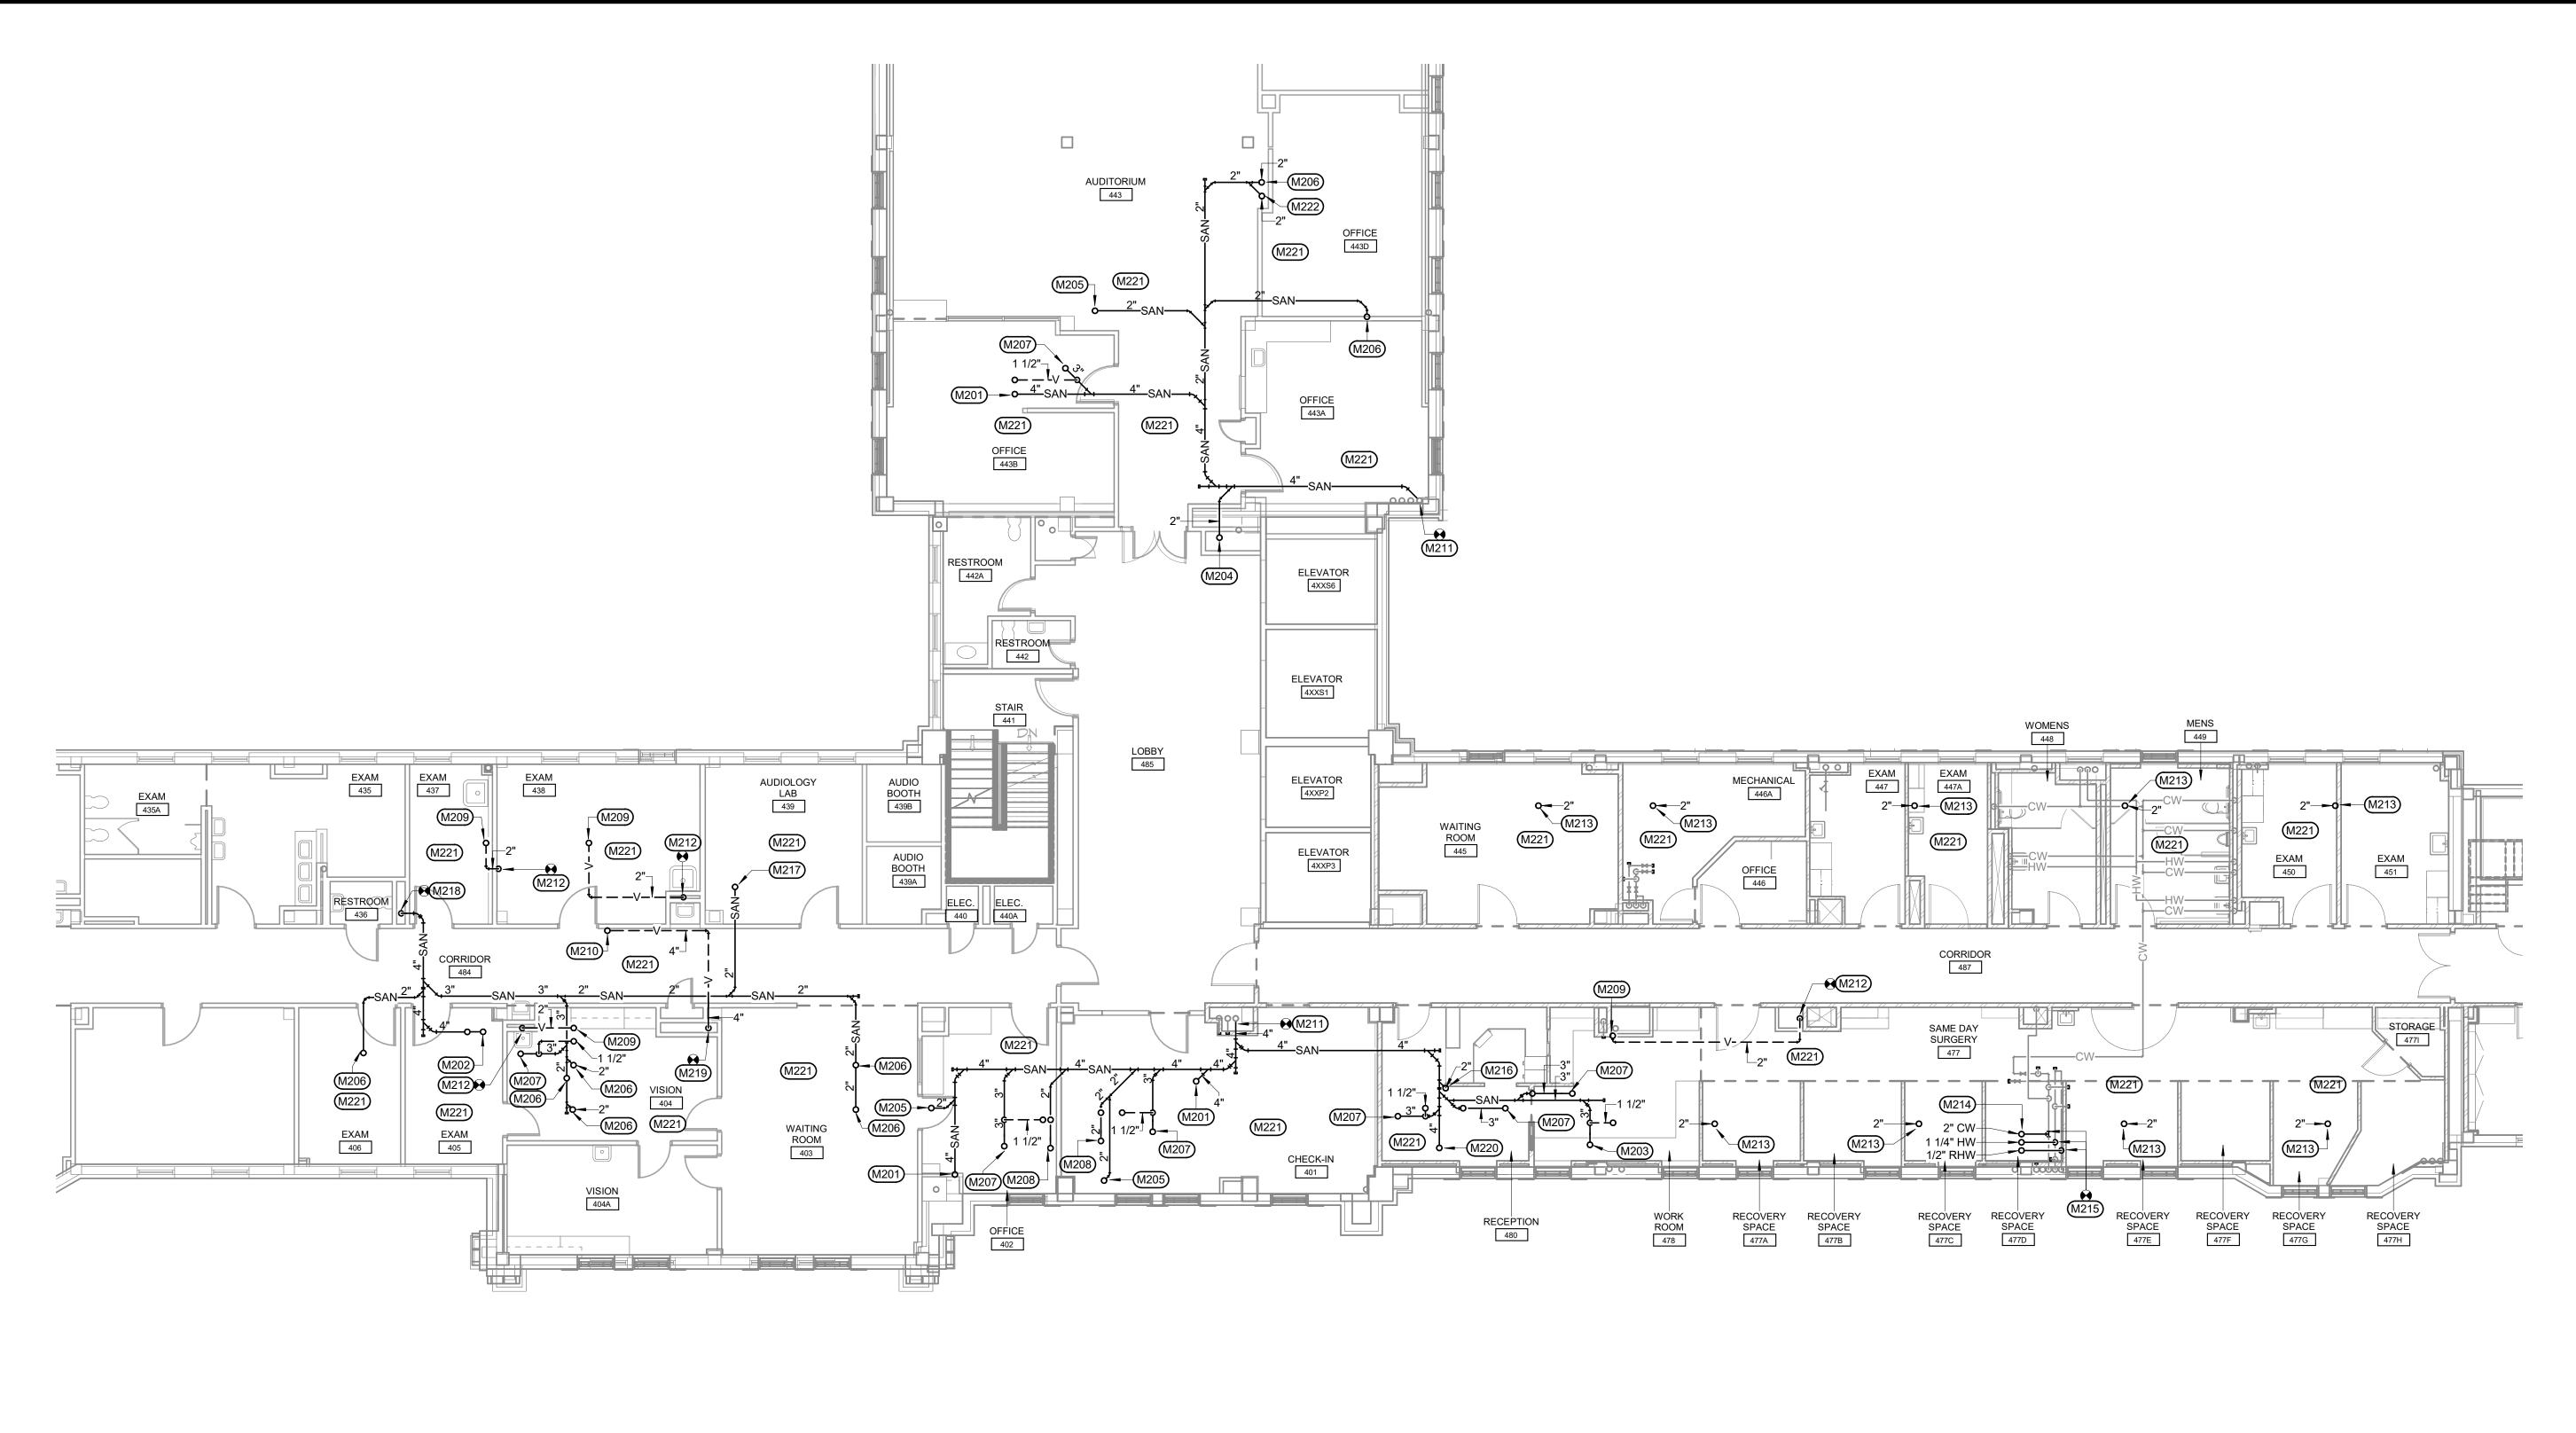

3



7

NORTH

 \frown


(#)
M201	4" WASTE UP TO WATE
M202	4" WASTE UP TO CLINI SHOWN.
M203	3" WASTE UP TO MOP
M204	2" WASTE UP TO ELEC
M205	2" WASTE UP TO LAVA
M206	2" WASTE UP TO SINK.
M207	3" WASTE UP TO FLOO SHOWN.
M208	2" WASTE UP TO SHOW
M209	2" VENT UP. SEE PLUN
M210	4" VENT UP. SEE PLUN
M211	CONNECT NEW 4" WAS VERIFY EXACT SIZE, LO FLOW OF EXISTING PR EXISTING. COORDINAT
M212	CONNECT NEW 2" VEN VERIFY EXACT SIZE AN PATCH WALL TO MATC CONTRACTOR.
M213	CAP 2" WASTE BELOW ROOM BUILD OUT ON F ALTERNATE #1.
M214	2" CW, 1-1/4" HW, AND FIFTH FLOOR FOR CON
M215	CONNECT NEW 2" CW, RHW IN THIS AREA. CO LOCATION EXISTING P
M216	2" WASTE UP TO BACK
M217	2" WASTE UP TO BACK
M218	4" WASTE DN IN EXISTI WASTE IN CHASE. COI LOCATION, INVERT ELE TO CONNECTION. PAT GENERAL CONTRACTO
M219	CONNECT NEW 4" VEN VERIFY EXACT SIZE AN PATCH WALL TO MATC CONTRACTOR.
M220	4" WASTE UP TO BACK
M221	REMOVE AND REINSTA INSTALLATION OF NEW IF TILE IS DAMAGED DU ADDITIONAL COST TO D
M222	2" WASTELIP TO OUTL


GENERAL NOTES:


Α	ALL PIPING AND DUCTS IN F IN A FURRED CHASE OR ABO
В	THE FIRST FIGURE OF DUCT INDICATED.
С	DUCT SIZES ARE NET INSIDE
D	ACCESS PANELS IN HARD S VALVES, TRAPS, DAMPERS, SHALL BE FURNISHED AND I SPECIFICATIONS.
E	TOTAL STATIC PRESSURE N TERMINAL UNITS, FILTERS, (
F	FOR TYPICAL STEAM AND W STANDARD EQUIPMENT DET
G	DIFFUSER, REGISTER AND G SIZES.
Н	WATER PIPE CONNECTIONS MADE TO PROVIDE COUNTE
Ι	WALL TYPE EXHAUST REGIS INSTALLED WITH BOTTOM E FINISHED FLOOR.
J	REFER TO ARCHITECTURAL


BOTH NEW WATER CLOSETS.

<u>KEY PLAN:</u>

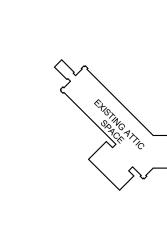

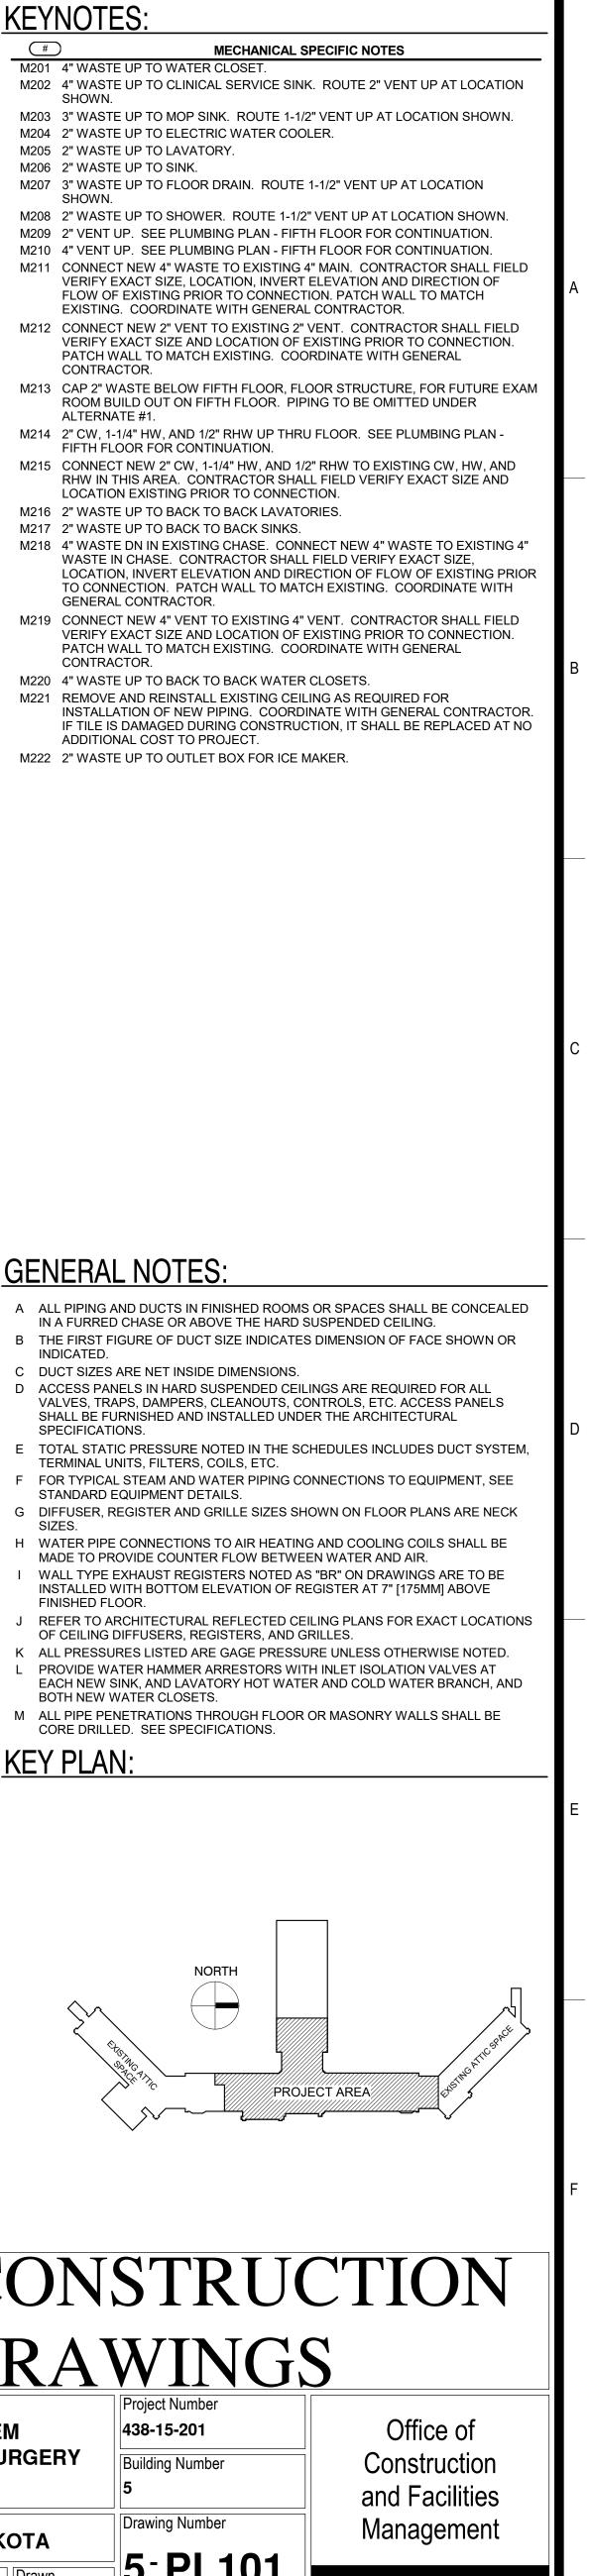

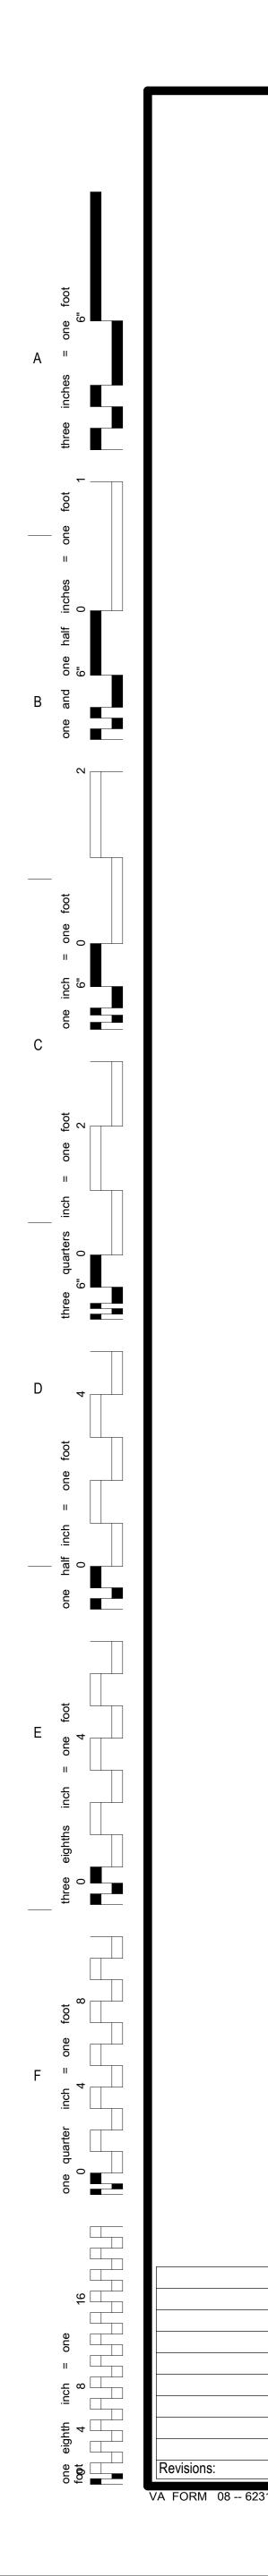

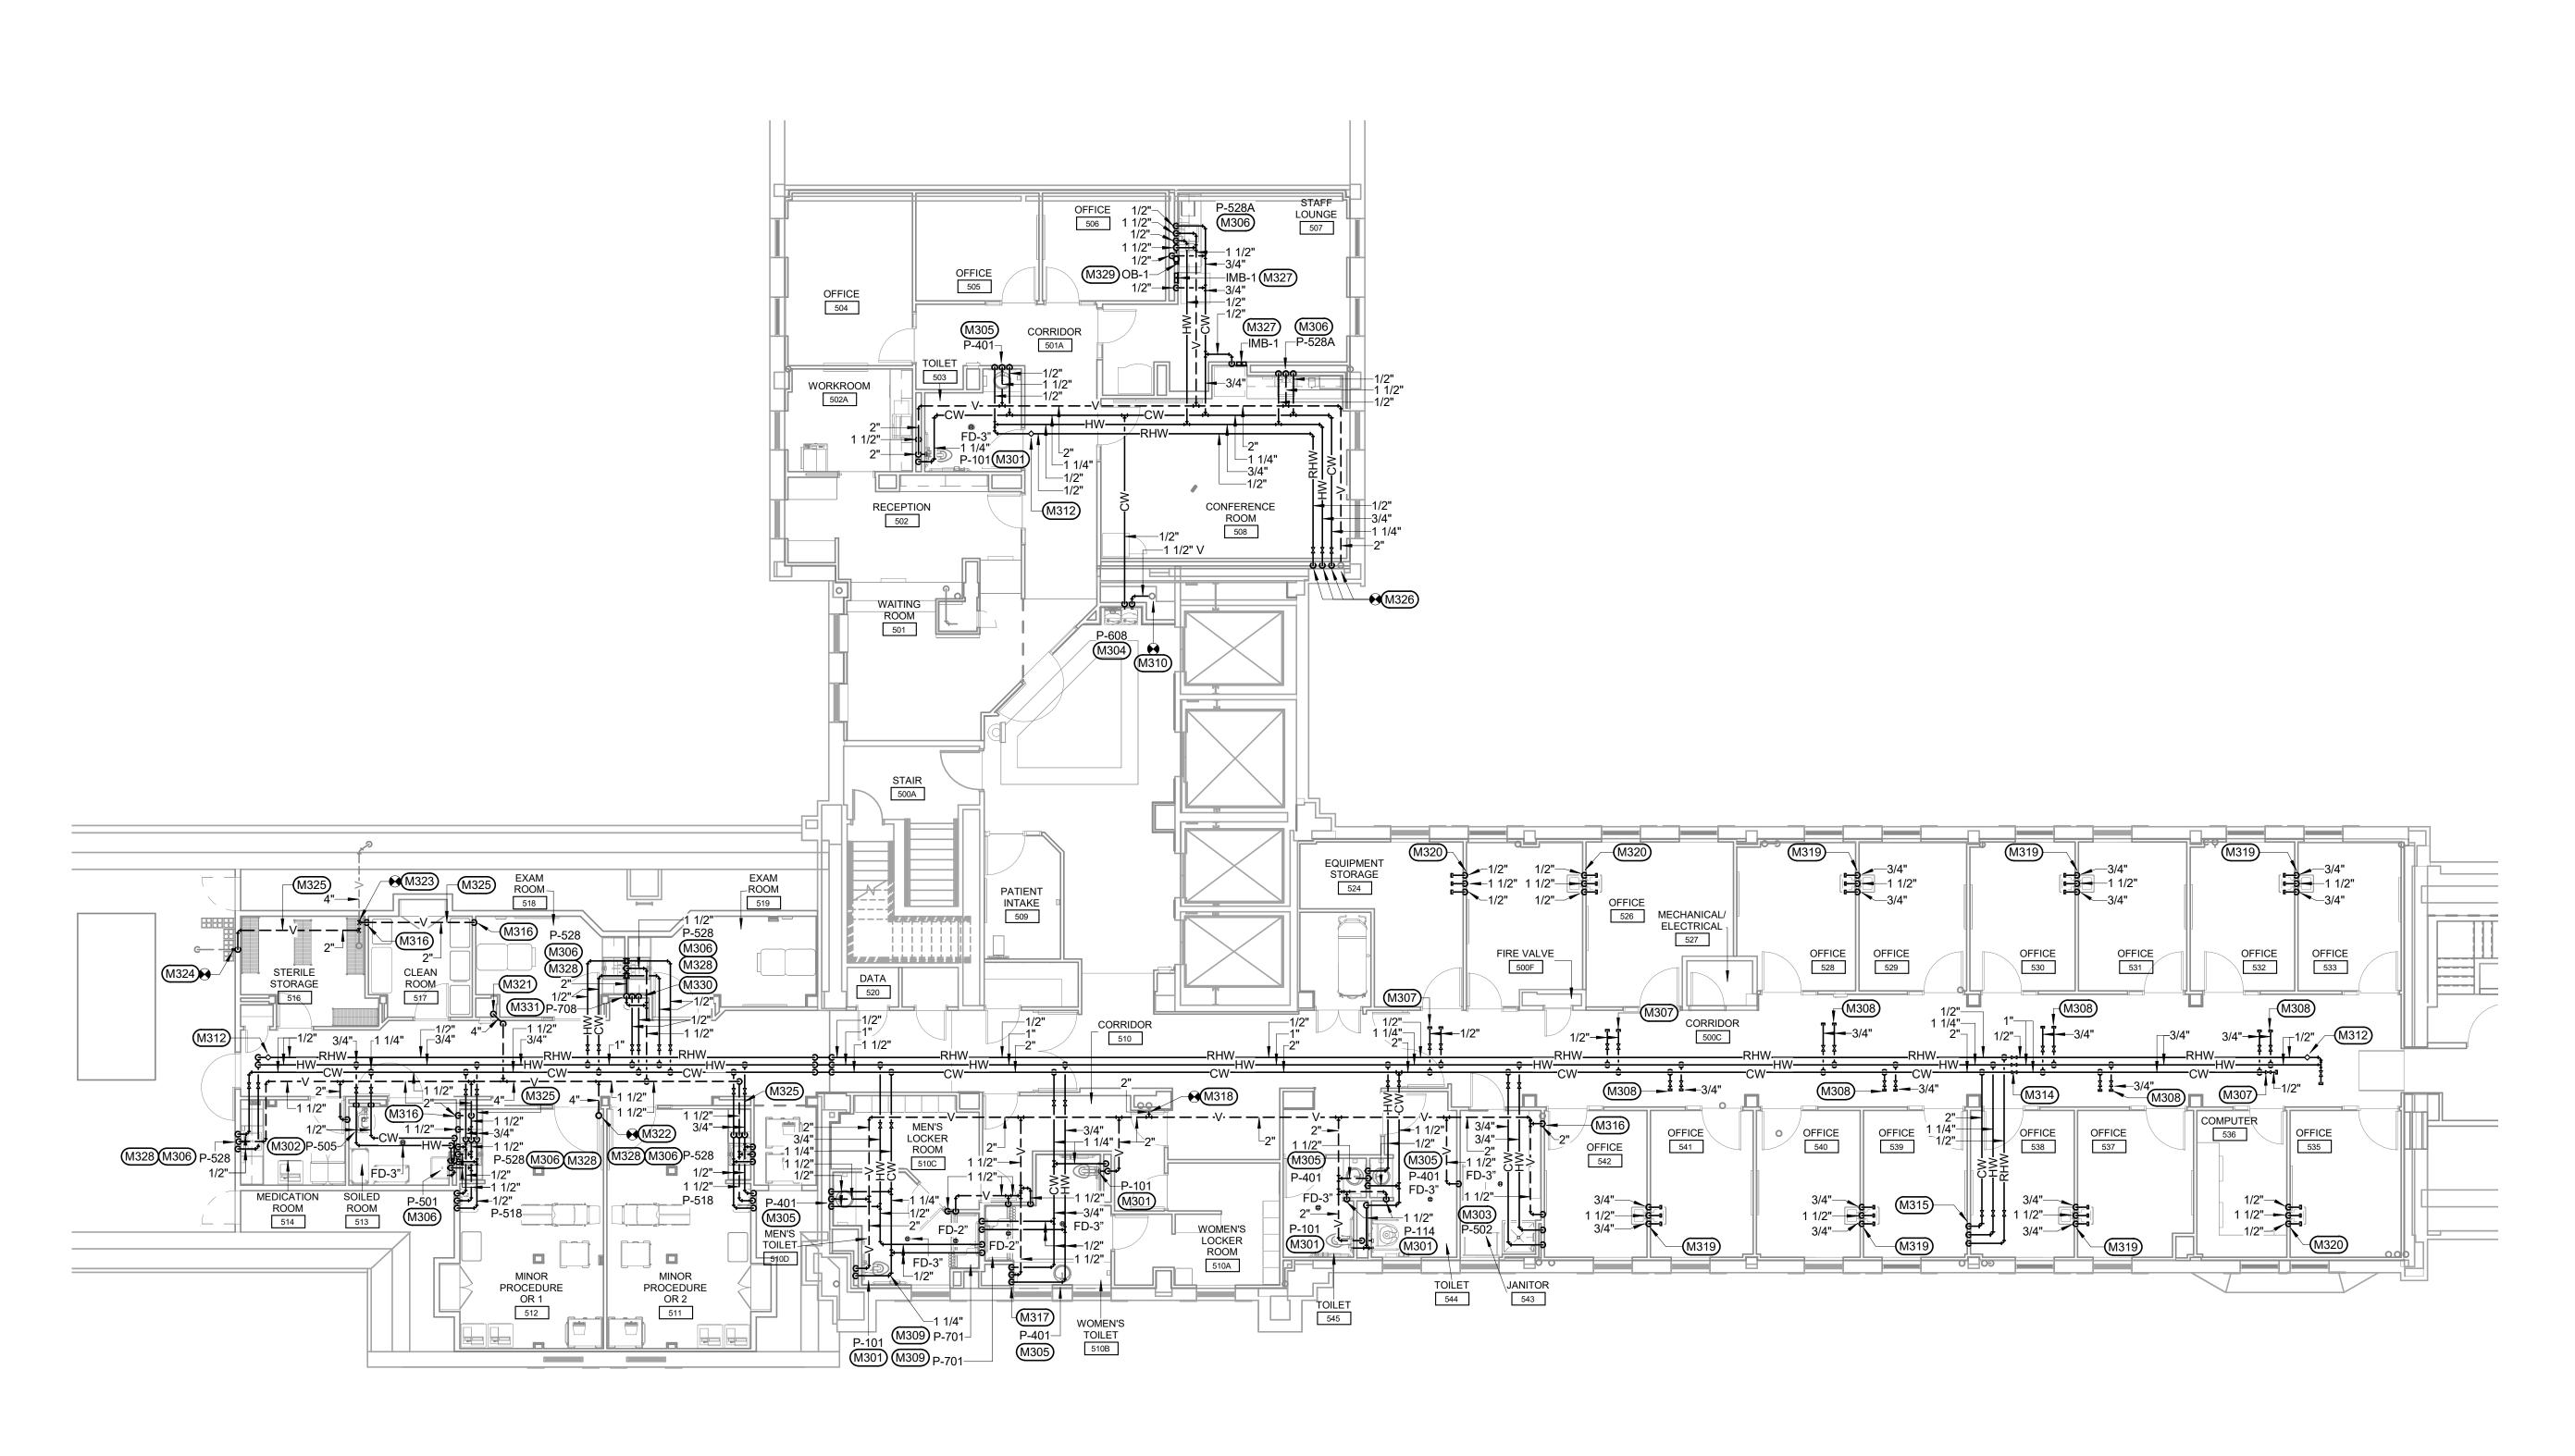

PLUMBING PLAN - FIFTH FLOOR SCALE: 1/8" = 1'-0"

1

2

CONSULTANTS:

Date


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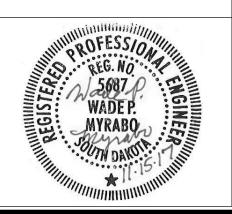
2







3

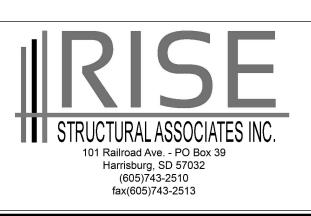

4

ARCHITECTS/ ENGINEERS:

5

MSF

625 S. MINNESOTA AVENUE, SUITE 204 SIOUX FALLS, SOUTH DAKOTA 57104-4873 TELE: (605) 332-7850 FAX: (605) 332-3539


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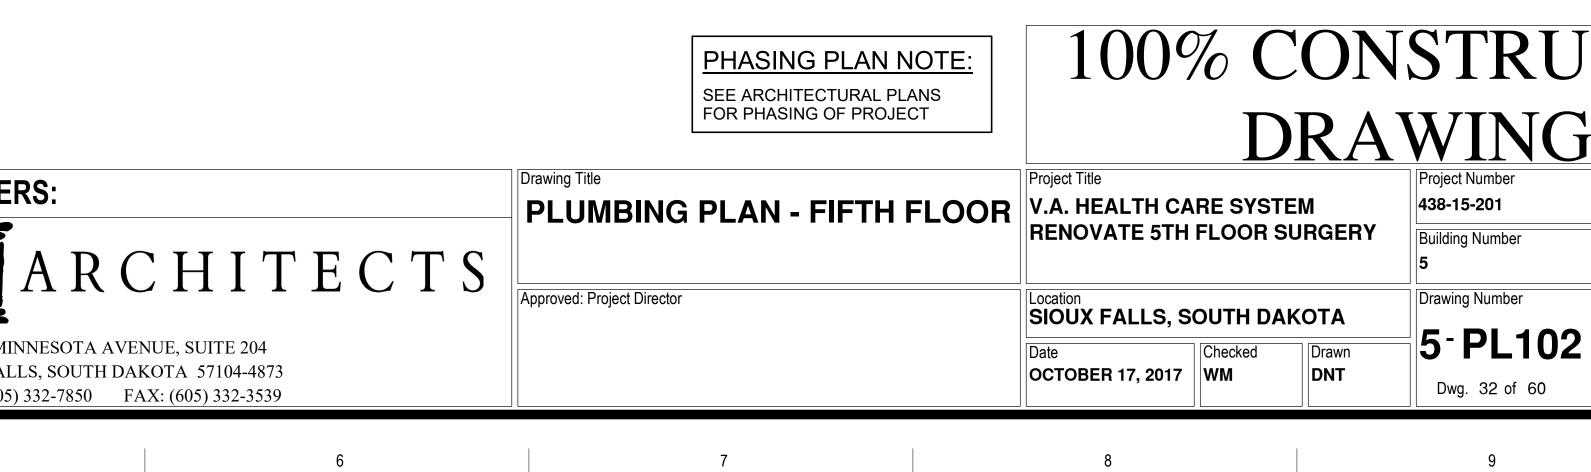
(#	\mathbf{D}
M301	1-1/4" CW, 4" WASTE, 2" VE
M302	3/4" CW, 3/4" HW, 4" WAST TO FLUSH VALVE.
M303	3/4" CW, 3/4" HW, 3" WAST
M304	1/2" CW, 2" WASTE, 1-1/2" \
M305	1/2" CW, 1/2" HW, 2" WAST
M306	1/2" CW, 1/2" HW, 2" WAST
M307	1/2" CW, 1/2" HW CAPPED
1007	VALVE ABOVE CEILING IN NO MORE THAN 6" OFF MA
M200	3/4" CW, 3/4" HW CAPPED
M308	VALVE ABOVE CEILING IN NO MORE THAN 6" OFF MA
M309	
M309 M310	1/2" CW, 1/2" HW DN TO SH CONNECT NEW 1-1/2" VEN
	VERIFY EXACT SIZE AND L
M312	INSTALL MANUAL BALANC BALANCE TO 0.5GPM.
M314	PIPING DOWN STREAM OF #1.
M315	2" CW, 1-1/4" HW, AND 1/2" FLOOR FOR CONTINUATIO
M316	2" VENT DN THRU FLOOR. CONTINUATION.
M317	1/2" CW, 1/2" HW, AND 1-1/ COUNTERTOP TO LAVATO
M318	CONNECT NEW 2" VENT T FIELD VERIFY EXACT SIZE
M319	3/4" CW, 3/4" HW, 1-1/2" VE BACK EXAM ROOM SINKS.
	CAP WASTE PIPING BELO CONTINUATION. VERIFY E ALTERNATE #1.
M320	1/2" CW, 1/2" HW, 1-1/2" VE SINK. CAP WATER AND VI BELOW FLOOR. SEE PLUI VERIFY EXACT LOCATION
M321	4" VENT DN THRU FLOOR. STRUCTURE. SEE PLUMB
M322	CONNECT NEW 4" VENT T FIELD VERIFY EXACT SIZE
M323	CONNECT (2) NEW 2" VEN VERIFY EXACT SIZE AND I
M324	CONNECT NEW 2" VENT T VERIFY EXACT SIZE AND I
M325	ROUTE NEW PIPING THRU
M326	CONNECT NEW 2" VENT, 1 HW, AND RHW. CONTRAC OF EXISTING PRIOR TO CO
M327	1/2" CW DN TO ICE MAKER COMPRESSION FITTING FO REFRIGERATOR. PROVID MAXIMUM PRESSURE SER
M328	PROVIDE FOOT PEDAL CC DETAIL 2/PL501.
M329	1/2" CW, 1-1/2" VENT, AND SHUT-OFF VALVE AND CO OWNER-PROVIDED ICE M/ REQUIRED . MAXIMUM PR DRAIN FROM OWNER PRO
M330	1/2"HW, 1/2" CW DN TO TH WATER FROM THERMOST

А	ALL PIPING AND DUCTS IN
	IN A FURRED CHASE OR A
_	

- INDICATED.
- SPECIFICATIONS.

- FINISHED FLOOR.



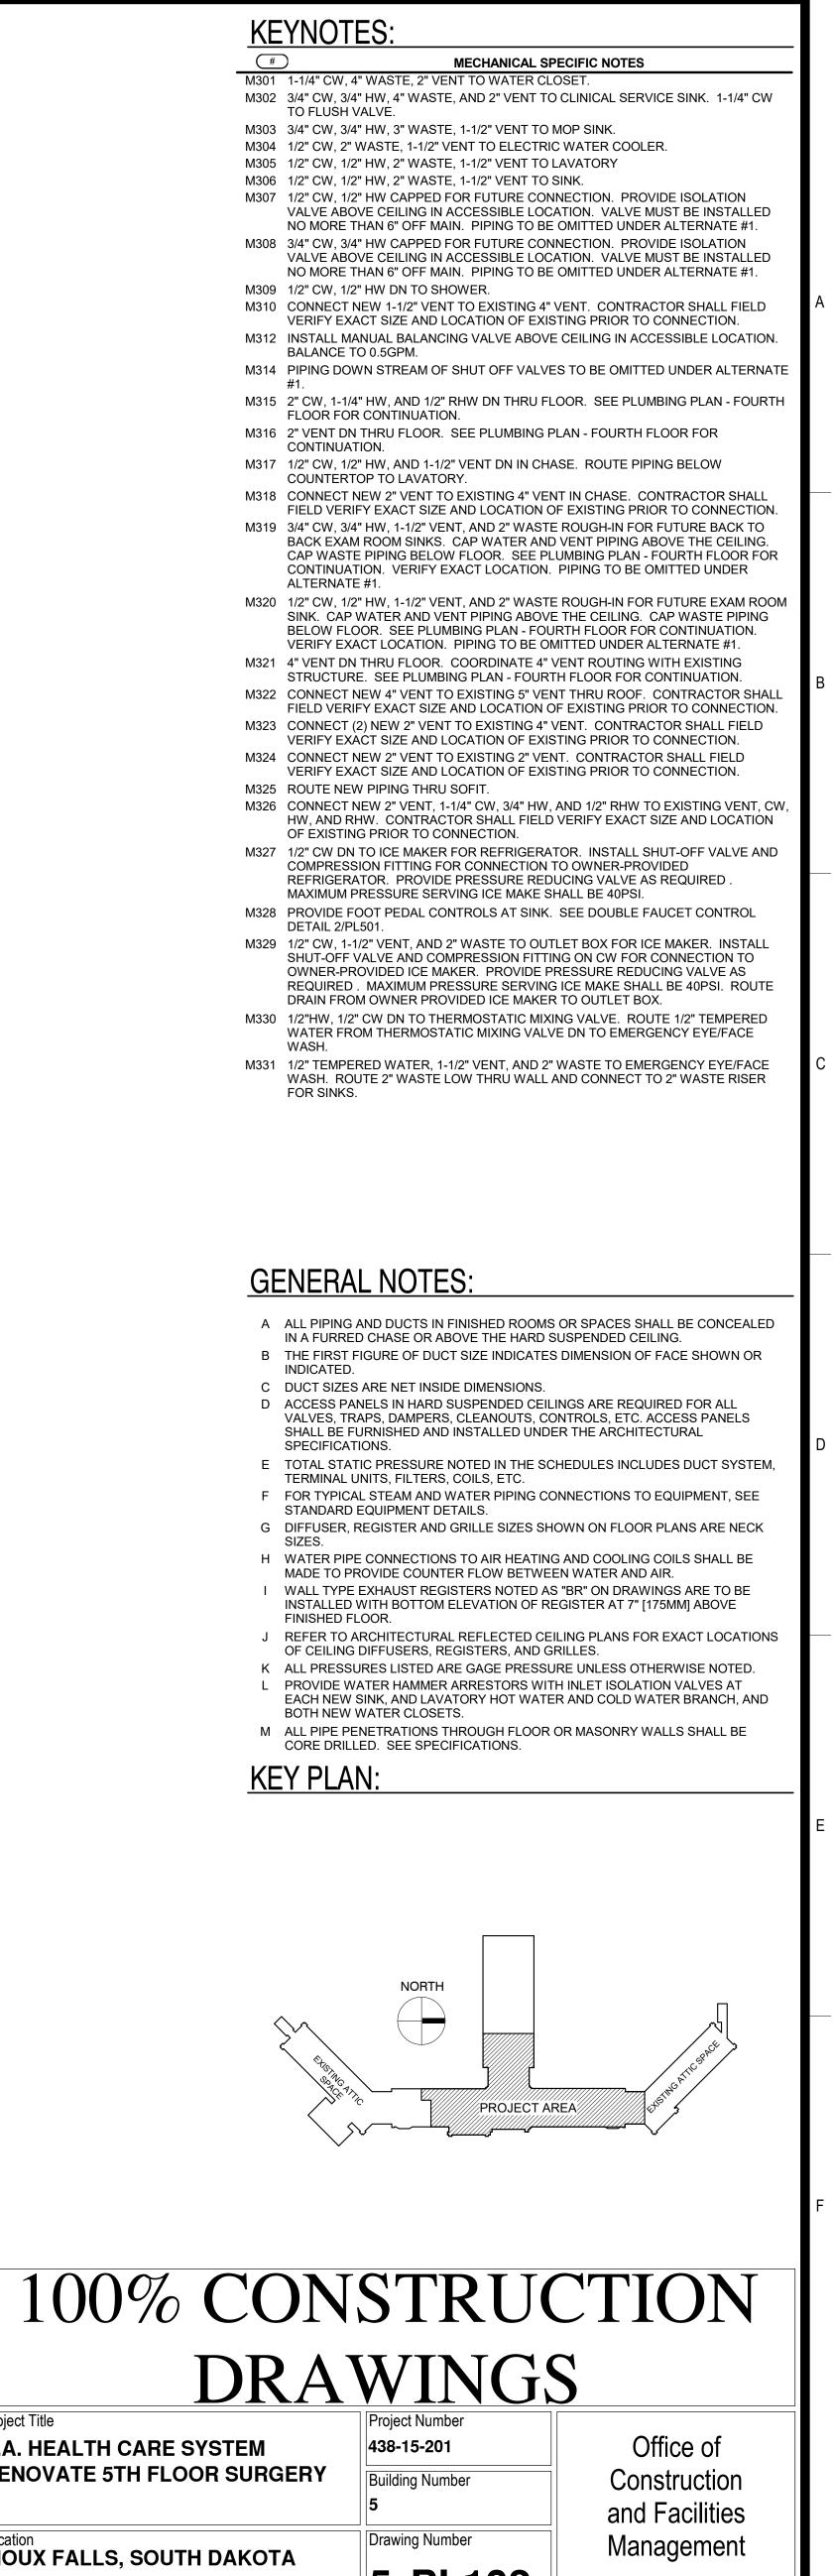

NORTH