

INFECTION CONTROL RISK ASSESSMENT

STEP ONE: CATEGORY C
USING THE FOLLOWING TABLE, IDENTIFY THE TYPE OF CONSTRUCTION PROJECT ACTIVITY (TYPE A-D)

Table with 2 columns: CATEGORY (A, B, C) and DESCRIPTION. Category A includes infection control activities like patient care, while B and C include general maintenance and construction.

STEP TWO: HIGHEST RISK
USING THE FOLLOWING TABLE, IDENTIFY THE PATIENT RISK GROUPS THAT WILL BE AFFECTED, IF MORE THAN ONE RISK GROUP WILL BE AFFECTED, SELECT THE HIGHER RISK GROUP

Table with 3 columns: LOW RISK, MEDIUM RISK, and HIGHEST RISK. Lists various medical and surgical units under each risk level.

STEP THREE: MATCH THE PATIENT RISK GROUP (LOW, MEDIUM, HIGH, HIGHEST) WITH THE PLANNED... CONSTRUCTION PROJECT TYPE (A, B, C, D) ON THE FOLLOWING MATRIX TO FIND THE... CLASS OF PRECAUTIONS (I, II, III, IV) OR LEVEL OF INFECTION CONTROL ACTIVITIES REQUIRED.

Matrix table mapping Patient Risk Category (I-IV) and Activity Category (Type A-D) to Infection Control Class (I-IV).

CLASS I, IV OR COLOR-CODED PRECAUTIONS ARE DELINEATED ON THE FOLLOWING PAGE.
IC MATRIX - CLASS OF PRECAUTIONS: CONSTRUCTION PROJECT BY PATIENT RISK

IC MATRIX table showing Class of Precautions (I-IV) for different Patient Risk Categories (I-IV) and Activity Categories (Type A-D).

NOTE: INFECTION CONTROL APPROVAL WILL BE REQUIRED WHEN THE CONSTRUCTION ACTIVITY AND RISK LEVEL INDICATE THAT CLASS III OR CLASS IV CONTROL PROCEDURES ARE NECESSARY.

CONSULTANTS: section with fields for Name, Title, and Date.

STEP THREE: CLASS IV
DESCRIPTION OF REQUIRED INFECTION CONTROL PRECAUTIONS BY CLASS

Table with 2 columns: CLASS I and CLASS II. Describes required infection control precautions for each class.

Table with 2 columns: CLASS III and CLASS IV. Describes required infection control precautions for each class.

Table with 2 columns: CLASS I and CLASS II. Describes required infection control precautions for each class.

INFECTION CONTROL NOTES - CLASS IV CONSTRUCTION:

Table with 2 columns: LEVEL I and LEVEL II. Lists specific infection control measures for each level.


INFECTION CONTROL NOTES - CLASS I CONSTRUCTION:

Table with 2 columns: LEVEL III and LEVEL IV. Lists specific infection control measures for each level.

PHASE LEGEND

Table defining symbols for Phase 1, Phase 2, and Phase 3 construction areas.

1 SUSPENDED GYP DETAIL
3" = 1'-0"

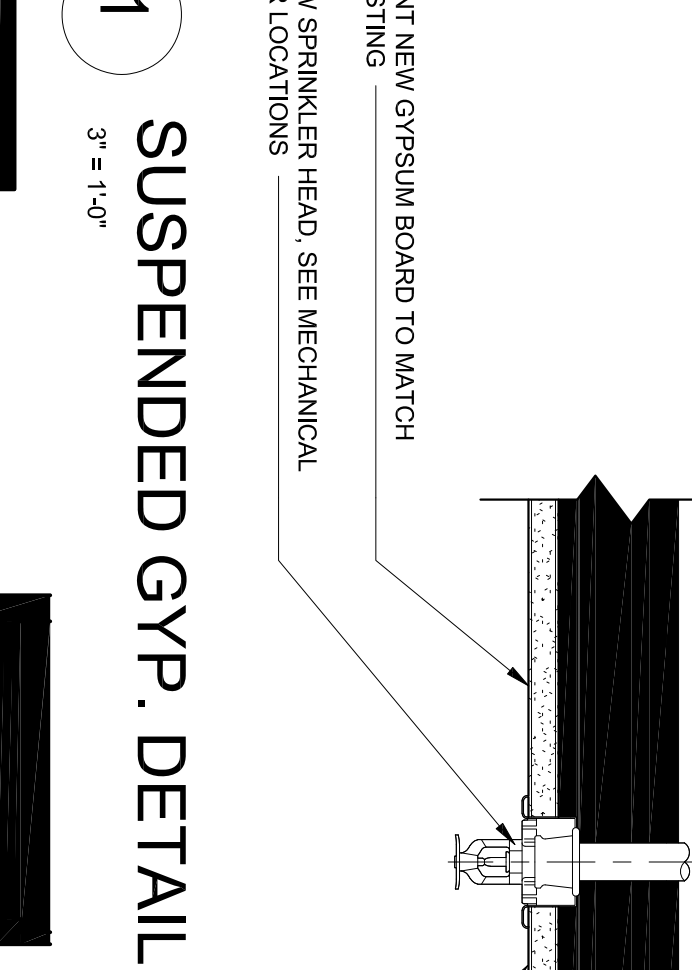


KEYNOTES:

- 99-01 SEE DETAIL 24.21 FOR PATTERNING OF EXISTING GYP BOARD... 99-03 IDENTIFY EXISTING GYP BOARD IN PLAN, FOLLOW BY... 99-04 IDENTIFY EXISTING GYP BOARD IN PLAN, FOLLOW BY...

GENERAL NOTES:

- 1. SHEET SIZE FOR PROPER SCALE IS 36X48. CONTRACTOR SHALL NOT SCALE DRAWINGS BUT SHALL... 2. IT IS THE RESPONSIBILITY OF THE CONTRACTOR TO... 3. EXISTING WALL SHOWN FOR CLARITY... 4. ABOVE FINISH FLOOR, TYPICAL UNLESS NOTED OTHERWISE.

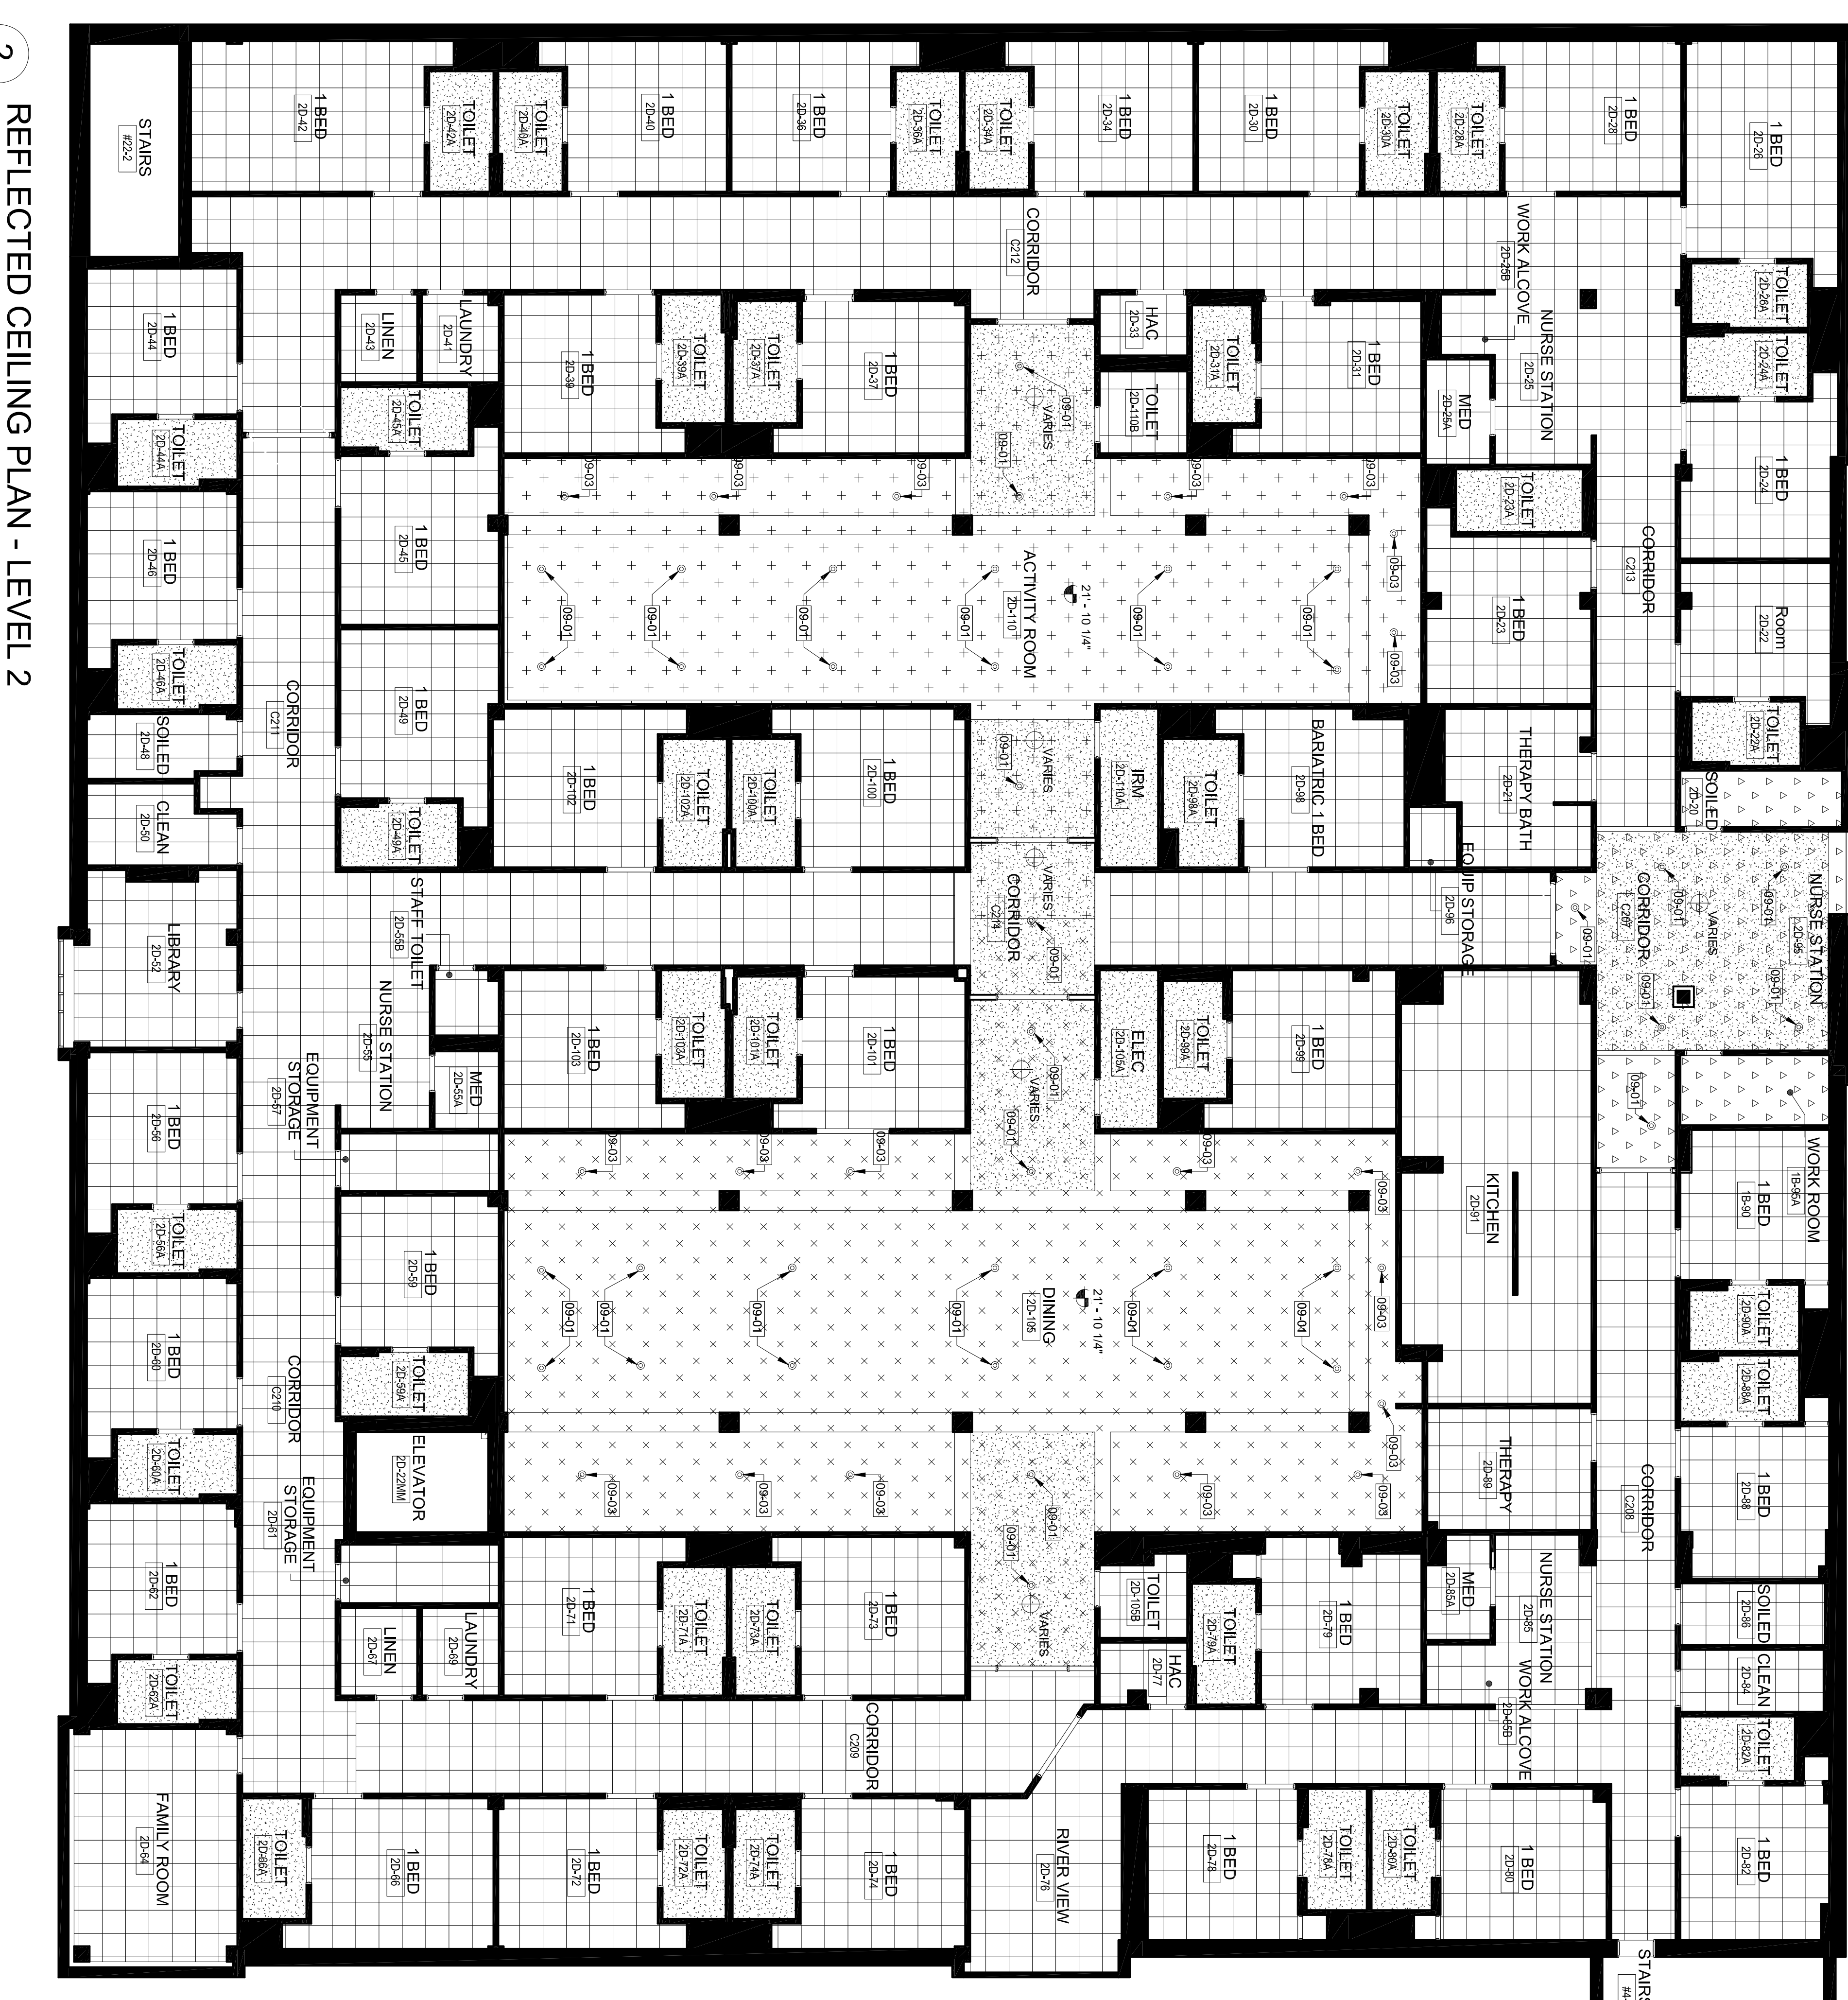

2 REFLECTED CEILING PLAN - LEVEL 2
1/8" = 1'-0"


ARCHITECT: FOURFRONT DESIGN, INC. 517 7TH STREET SOUTHWEST, SOUTH DAKOTA 57701-0605. PROJECT TITLE: REPLACE SELECTED SPRINKLER MAINS AND FIRE PUMP. DRAWING NUMBER: A1.21. DATE: 3/27/2024.

Office of Construction and Facilities Management logo and contact information.

Revisions:	Date



CONSULTANTS:

ARCHITECT/ENGINEERS

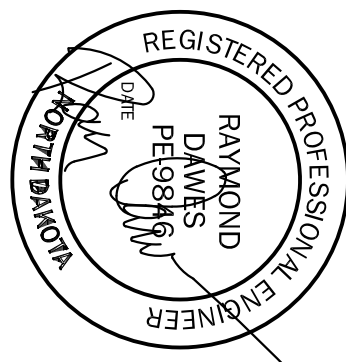

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1 LEVEL 1 FP SPRINKLER HEADS
1/8" = 1'-0"

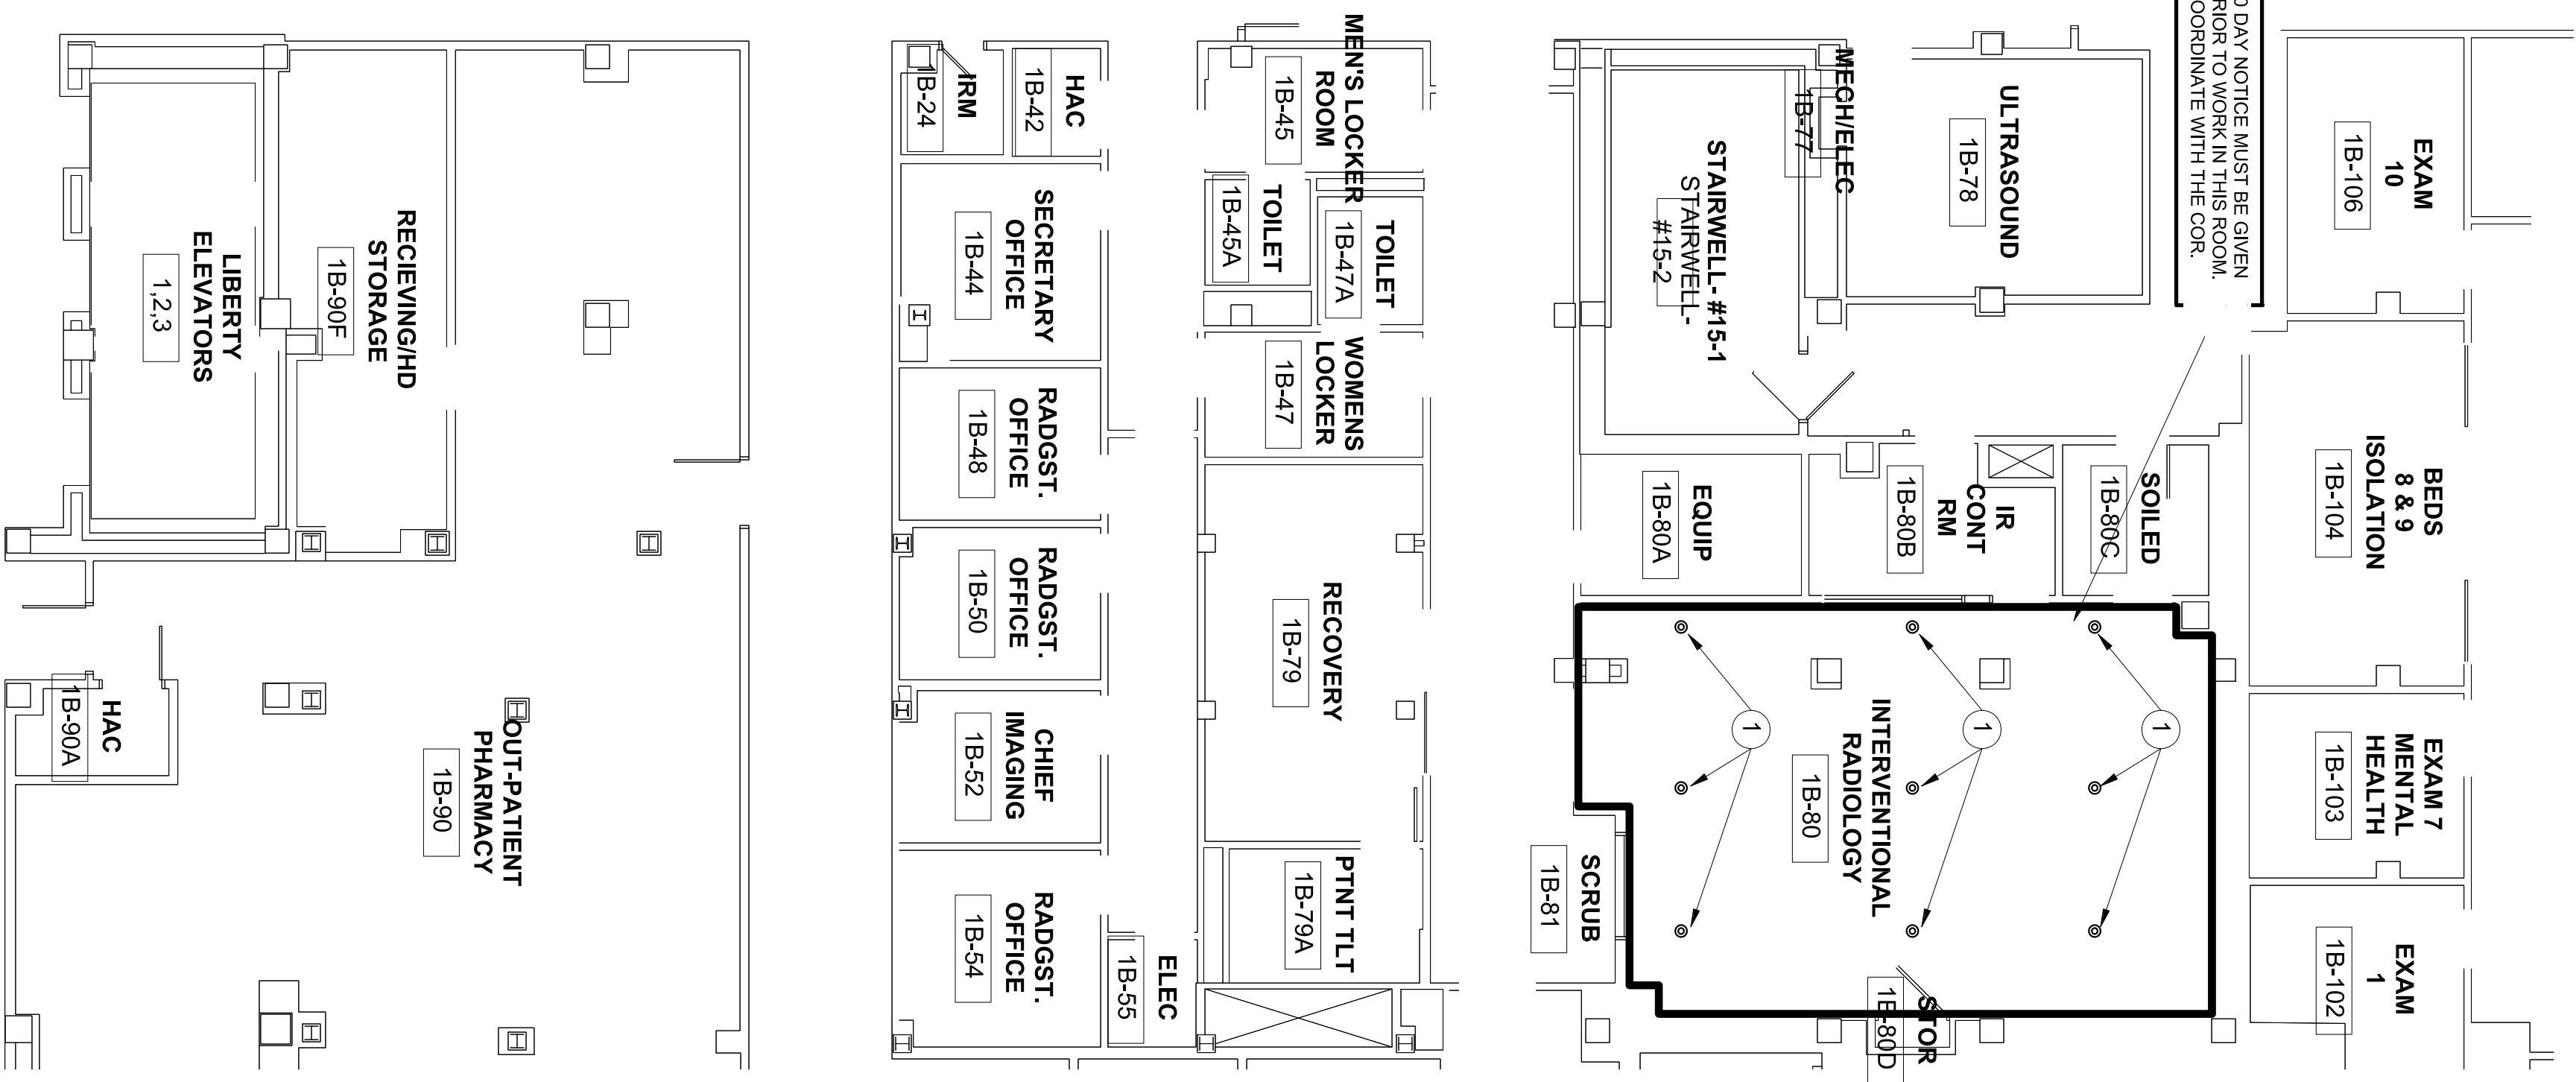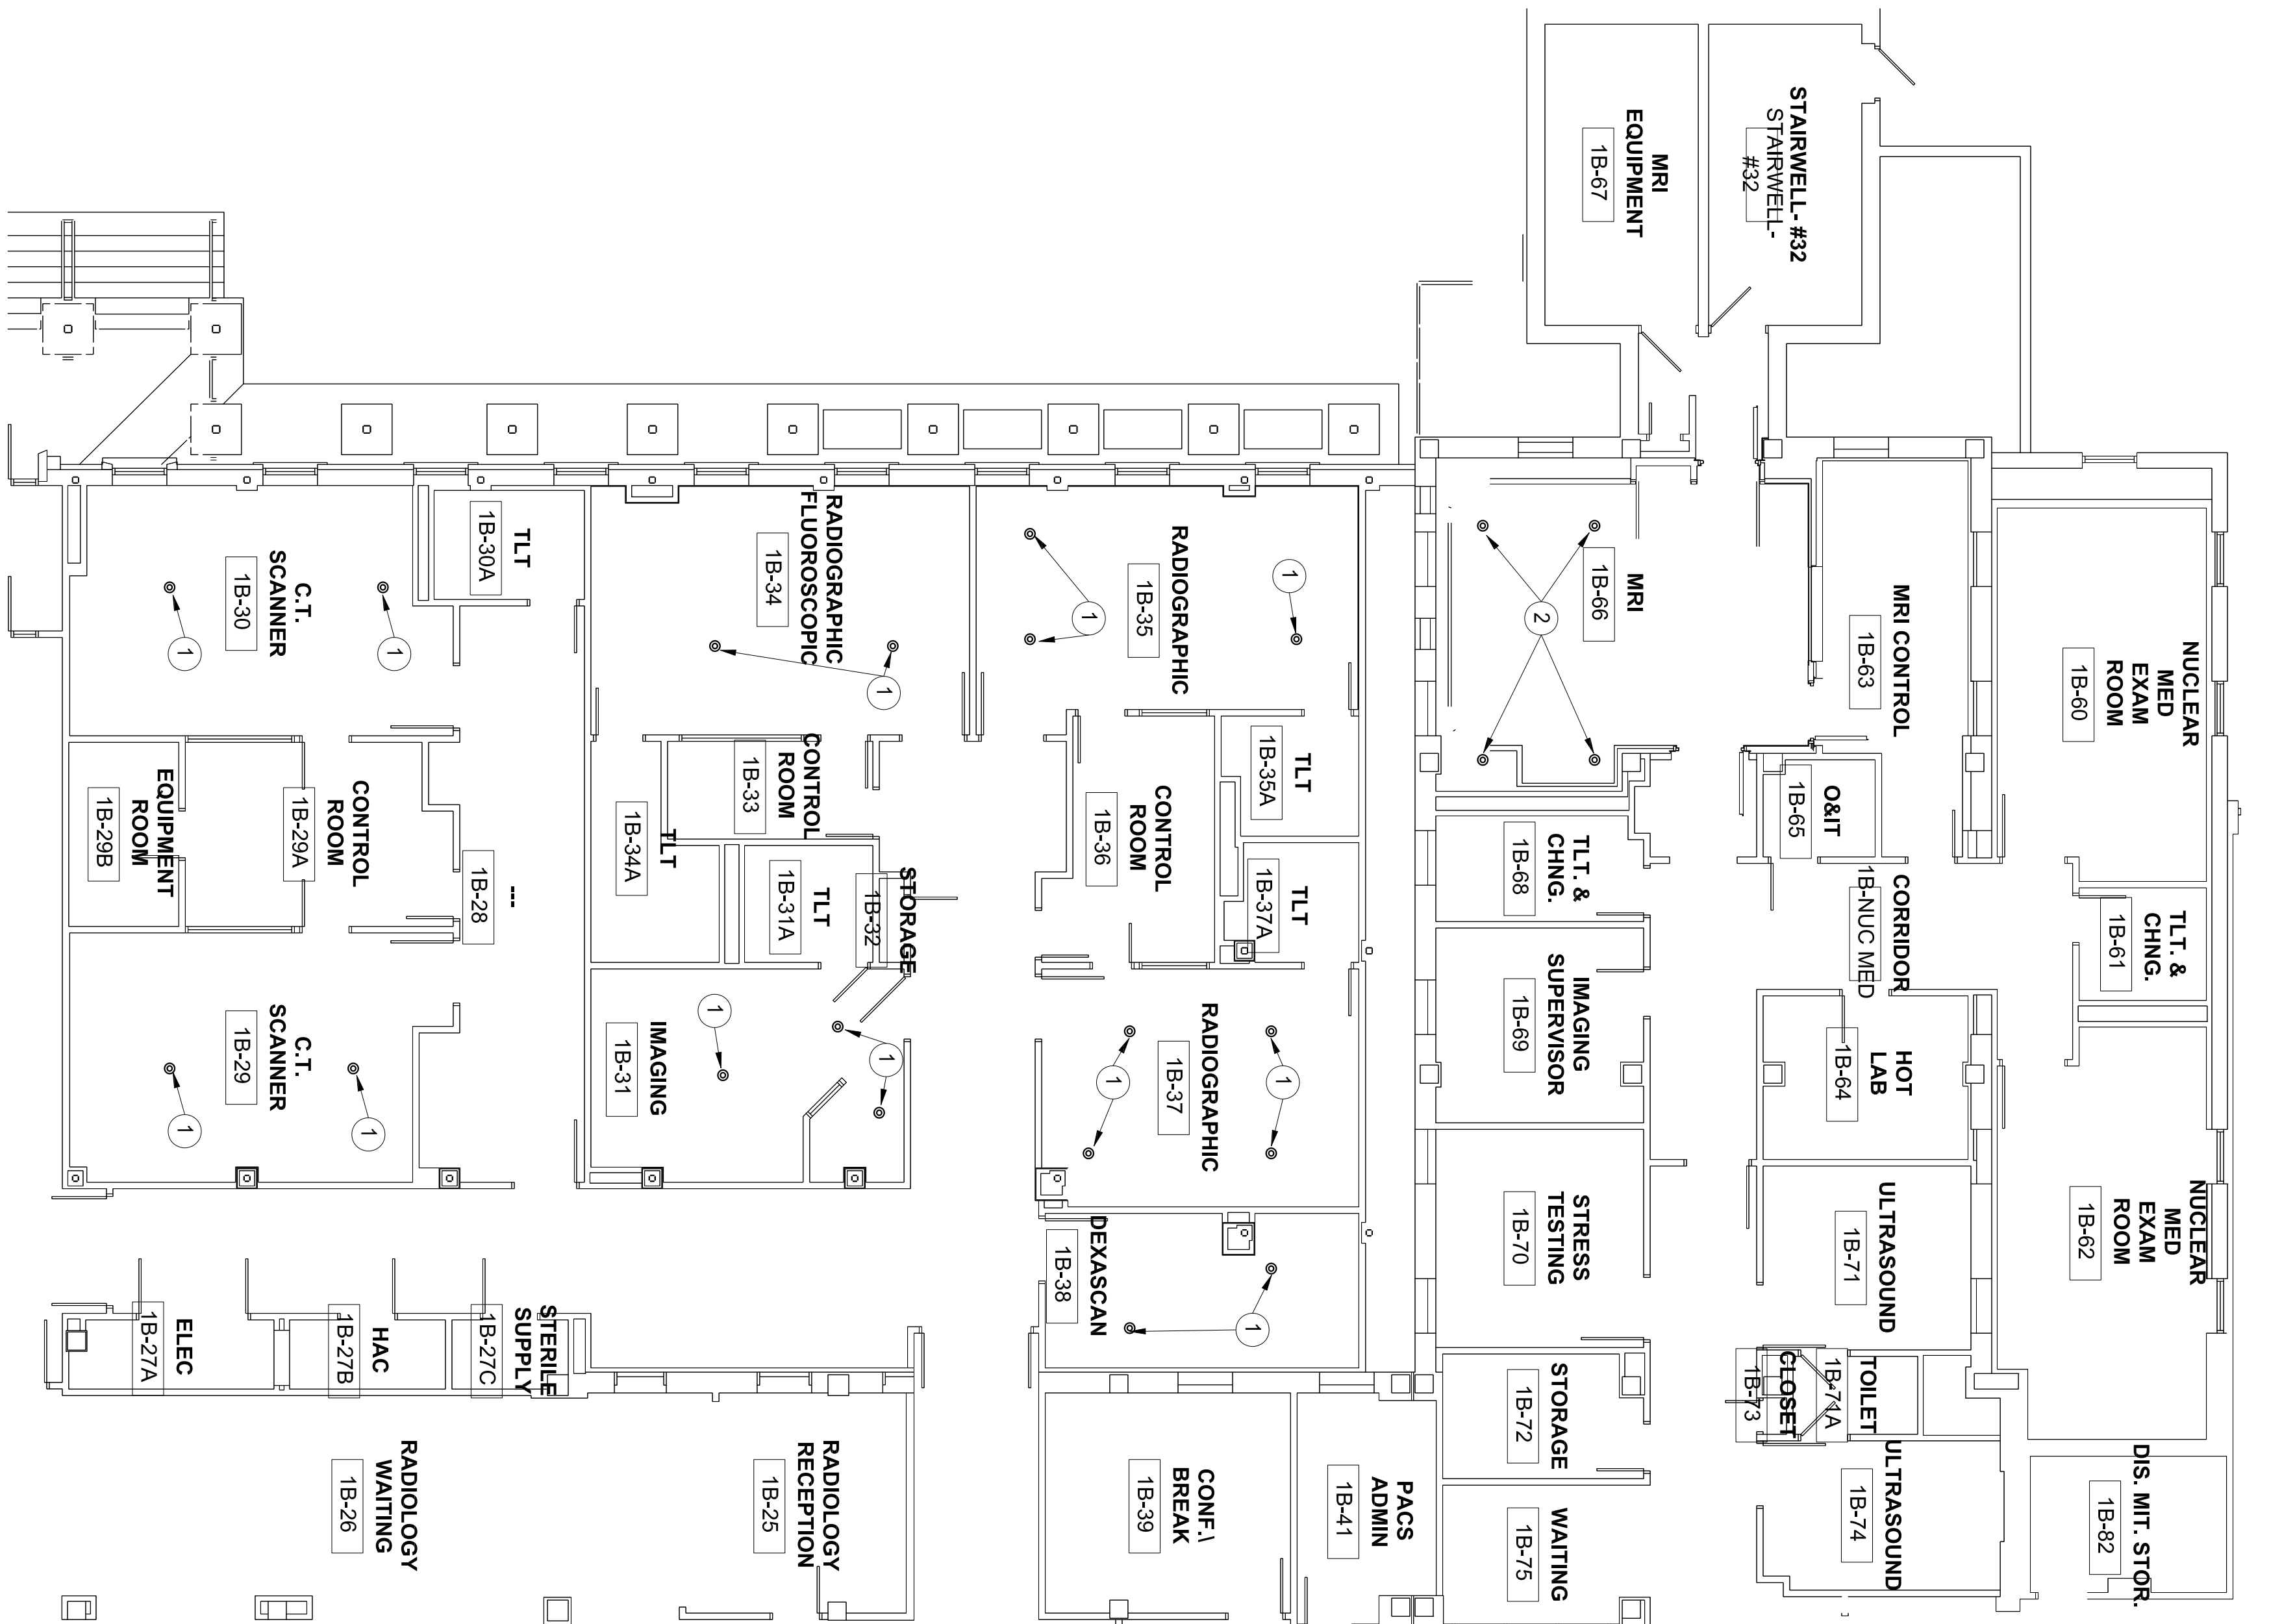

NO DATA NOTICE MUST BE GIVEN PRIOR TO WORK IN THIS ROOM COORDINATE WITH THE COR.


GENERAL NOTES

FIRE WATCH TO BE PROVIDED BY THE CONTRACTOR ANYTIME FIRE EQUIPMENT IS USED FOR TESTING OR MAINTENANCE. THIS IS A FULL BUILDING SPRINKLER PUMP REPLACEMENT PROJECT AND WE ANTICIPATE SHUTDOWN OF THE EXISTING SPRINKLER PUMP PRIOR TO DEMOLITION OF THE EXISTING FIRE PUMP, AND FOR A SWITCH-OVER TO THE NEW FIRE SPRINKLER PUMP.

KEYED NOTES

1 REPAIRED SPRINKLER CONSOLE FIRE SPRINKLER HEADS SHOWN IN DARK WITH QUICK RESPONSE PENDENT FIRE SPRINKLER HEADS IN THE SAME LOCATION. THERE ARE OTHER EXISTING QUICK RESPONSE PENDENT FIRE SPRINKLER HEADS NOT SHOWN IN THE DRAWINGS THAT ARE TO REMAIN AND ARE NOT TO BE REPAIRED.

2 EXISTING CONSOLE SPRINKLER HEADS IN RM 1B-80 ARE TO BE REPAIRED PER VA FIRE PROTECTION DESIGN MANUAL 11/01/23 SECTION 8.1 PARAGRAPH K, EXCEPTION #5. EXISTING SPRINKLER HEADS TO REMAIN.

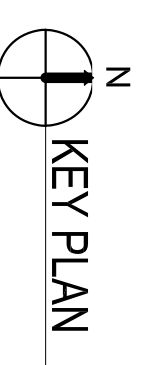

CONSTRUCTION DOCUMENTS

Drawing Title: **FIRST FLOOR SPRINKLERS PLAN**

Project Title: **REPLACE SELECTED SPRINKLER MAINS & FIRE PUMP**

Location: **2101 ELM STREET FARGO, ND 58102**

Project Number: **437-23-110**

Building Number: **1,946**

Drawing Number: **FP1.12**

Date: **3/27/24**


Checked: **RD**

Drawn: **BMP/PM**

Dwg. 10 of 13

Approved: Project Director
CHAD HOLMAN

Office of Construction and Facilities Management

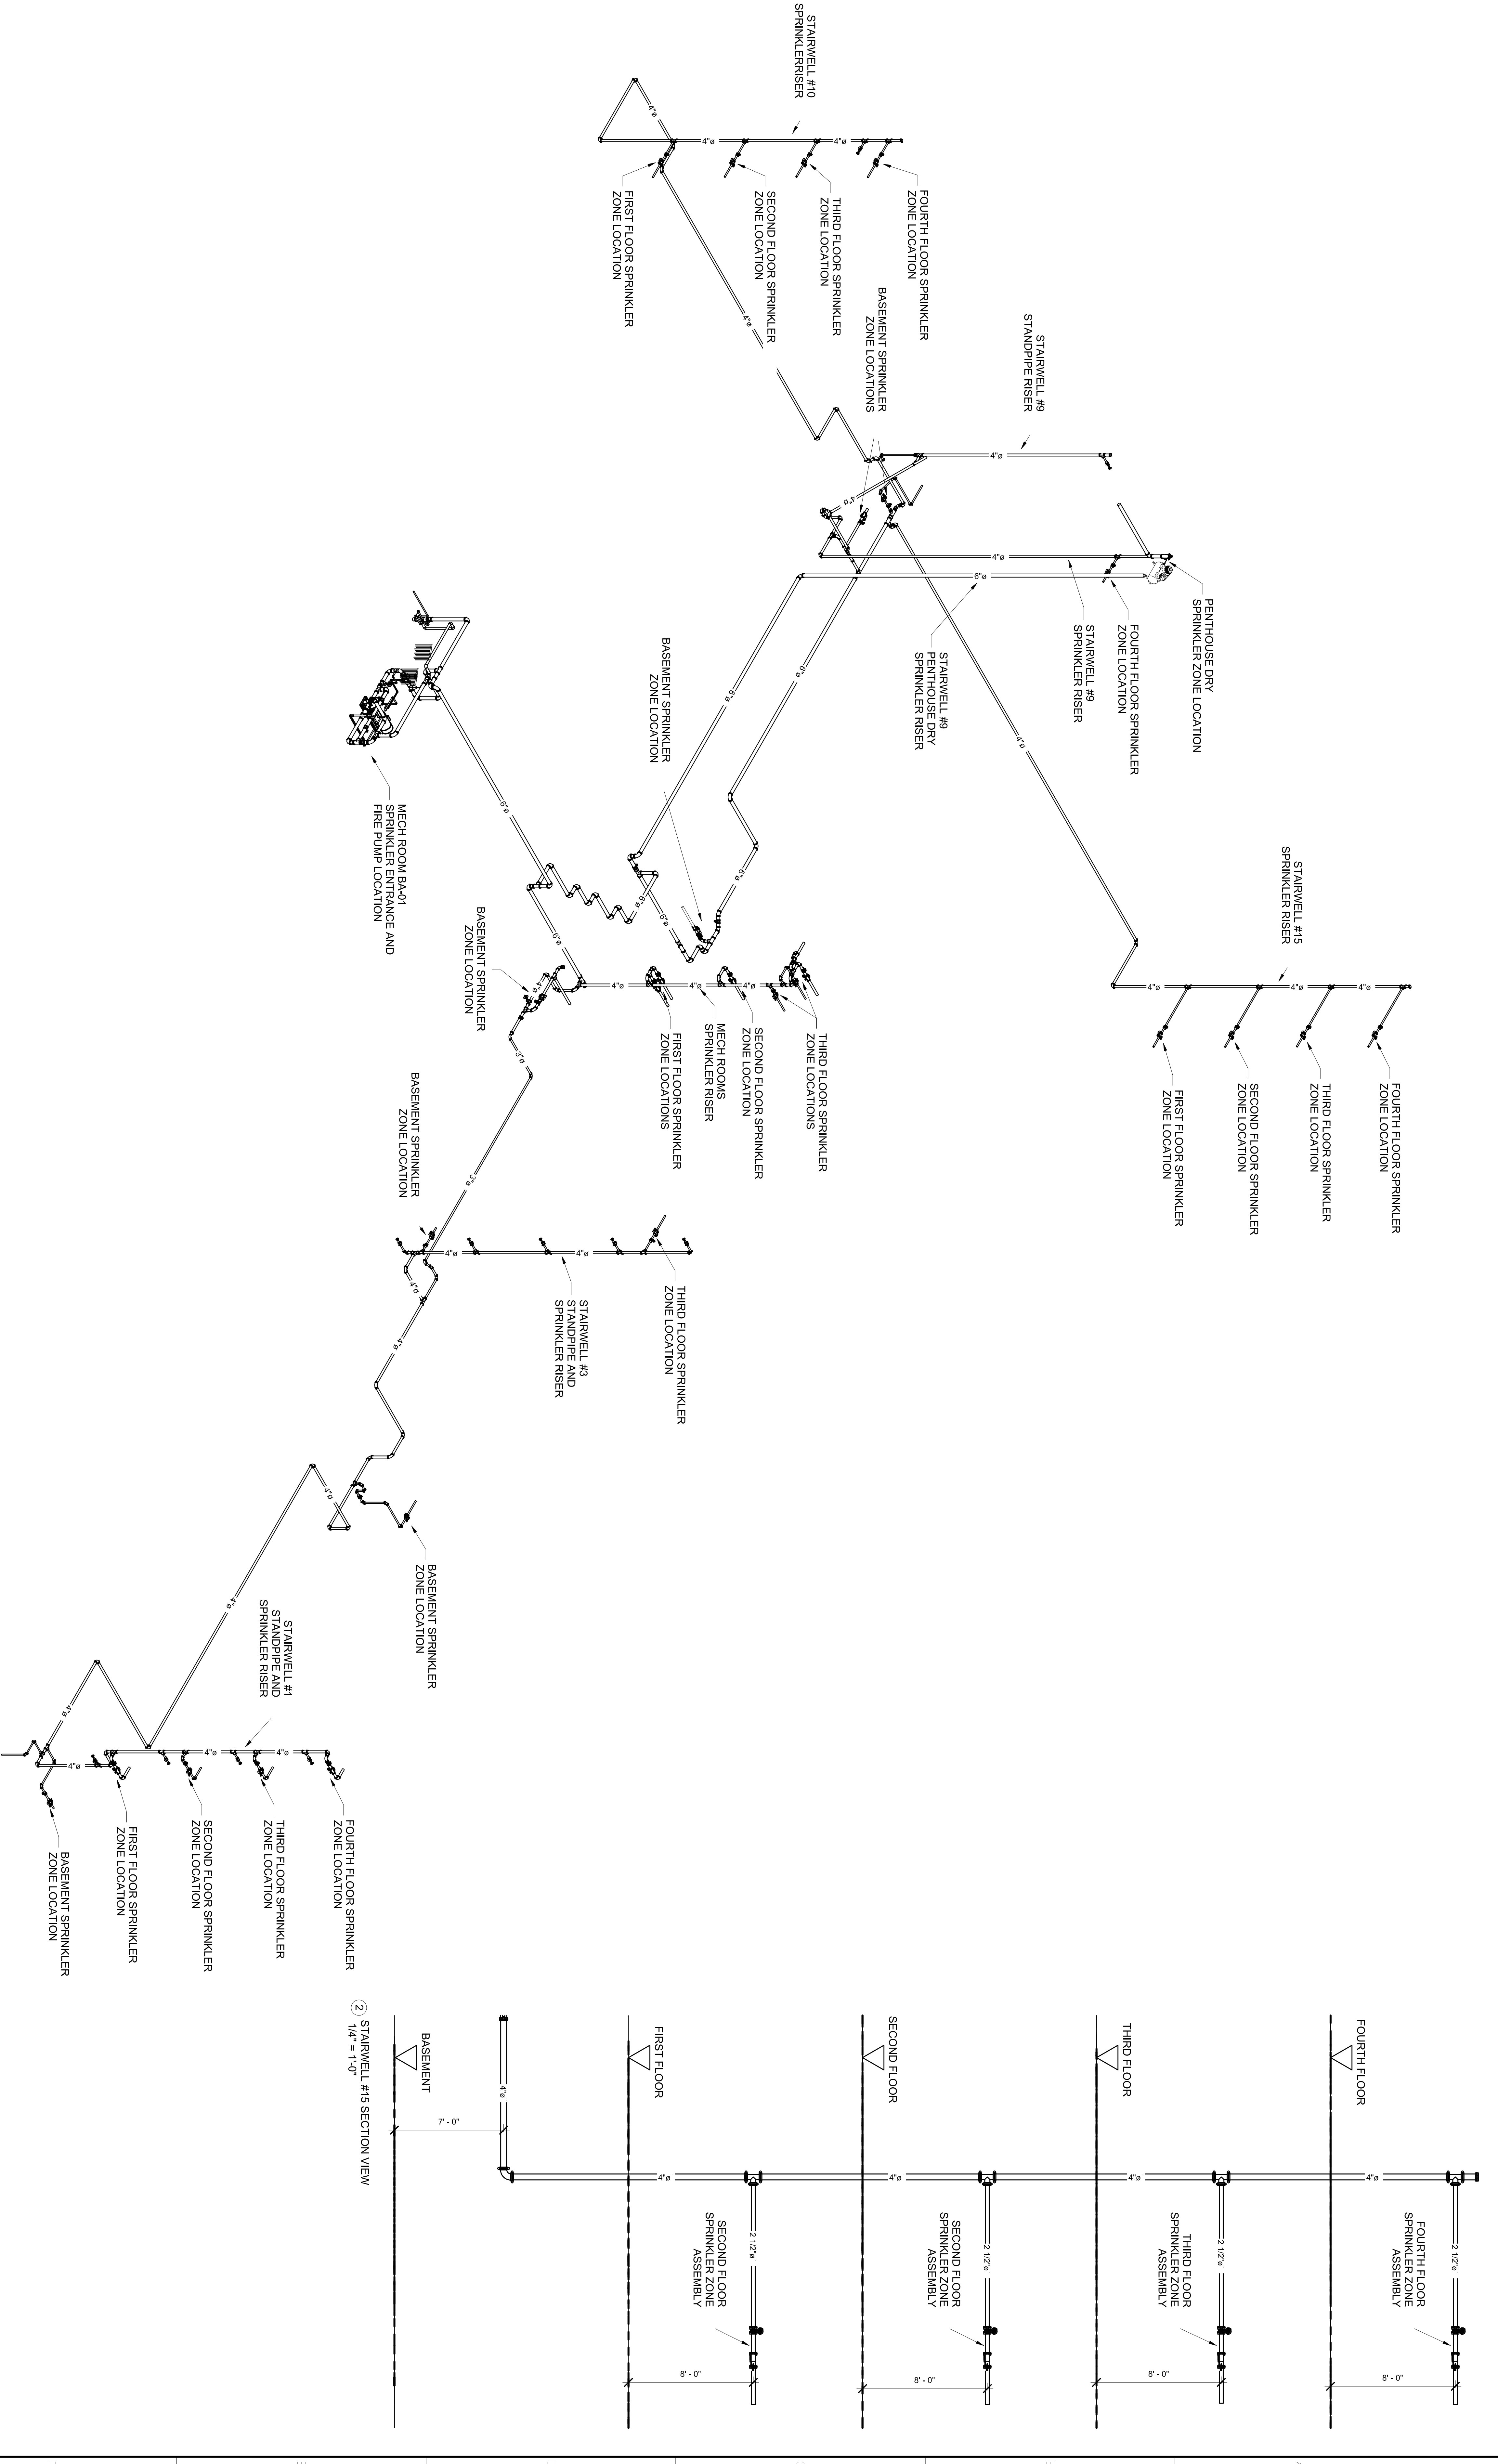


1 FIRE SPRINKLER BUILDING RISER ISO DIAGRAM

CONSULTANTS:

ARCHITECT/ENGINEERS

Revisions:	Date

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REGISTERED PROFESSIONAL ENGINEER
 RAYMOND DAMES
 STATE OF NORTH DAKOTA
 LICENSE NO. 12074

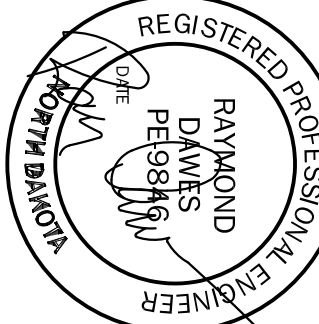Drawing Title
FIRE SPRINKLER BUILDING RISER ISO DIAGRAM AND STARWELL 15 SECTION VIEW

Project Title
REPLACE SELECTED SPRINKLER MAINS & FIRE PUMP

Location
2101 ELM STREET FARGO, ND 58102

Project Number
437-23-110

Building Number
1,946

Drawing Number
FP2.02

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Office of Construction and Facilities Management

CONSTRUCTION DOCUMENTS

