
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OUTPUT → INPUT DEVICE ↓	1.Sound general building alarm for Other and Non- High Rise (non-Health Care). See Section 7.2.1	2. Notify necessary staff for response for Health Care, Ambulatory Health Care***, and High Rise buildings only (alarm signal may be different on different floors).	3. Notify Fire Department.	4. Initiate supervisory signal to a 24-hour manned point for immediate response.	5. Close associated smoke barrier doors on the floor.	6. Close dampers on fan	7. Shut down air handler	8. Recall elevator.	 Initiate elevator shut down and disconnect elevator power. 	10. Open **locked egress doors on floor of fire origin.	11. Disconnect fuel source from cooking equipment.
Duct Smoke Detector*				Xp		X	Xa				
Area Smoke Detector*	Х	Х	X							Х	
Door Release Smoke Detector*	Х	Х	X		X	Χ				Х	
Elevator Smoke Detector*	X	X	X					X			
Manual Pull Station	X	Х	X		Х					Х	
Elevator Machine Room Heat Detector	X	X	X						Χ		
Generator Room Heat Detector	Х	X	X							Х	
Sprinkler Waterflow / Pressure Switch	Х	Х	Χ		X					Х	
Water Control Valve Tamper				Х							
Fire Pump (Any alarm condition required by NFPA 20)				X							
High/Low Pressure Dry-Pipe Sprinkler System				Х							
Kitchen Hood Suppression System	X	X	X		Х					Х	Х
Gas Extinguishing Systems	Χ	X	X		X					Х	
Dry-Pipe Valve Room Temperature Alarm				Х							
Dedicated Fire Water Storage Tank Low Level				Х							
Dedicated Fire Water Storage Tank Low Temperature				Χ							

B – The facility is permitted to sound the general alarm or notify necessary staff in lieu of initiating a supervisory signal to be consistent with the operation of existing systems.

one eighth inch = one foot

4 8 16

16

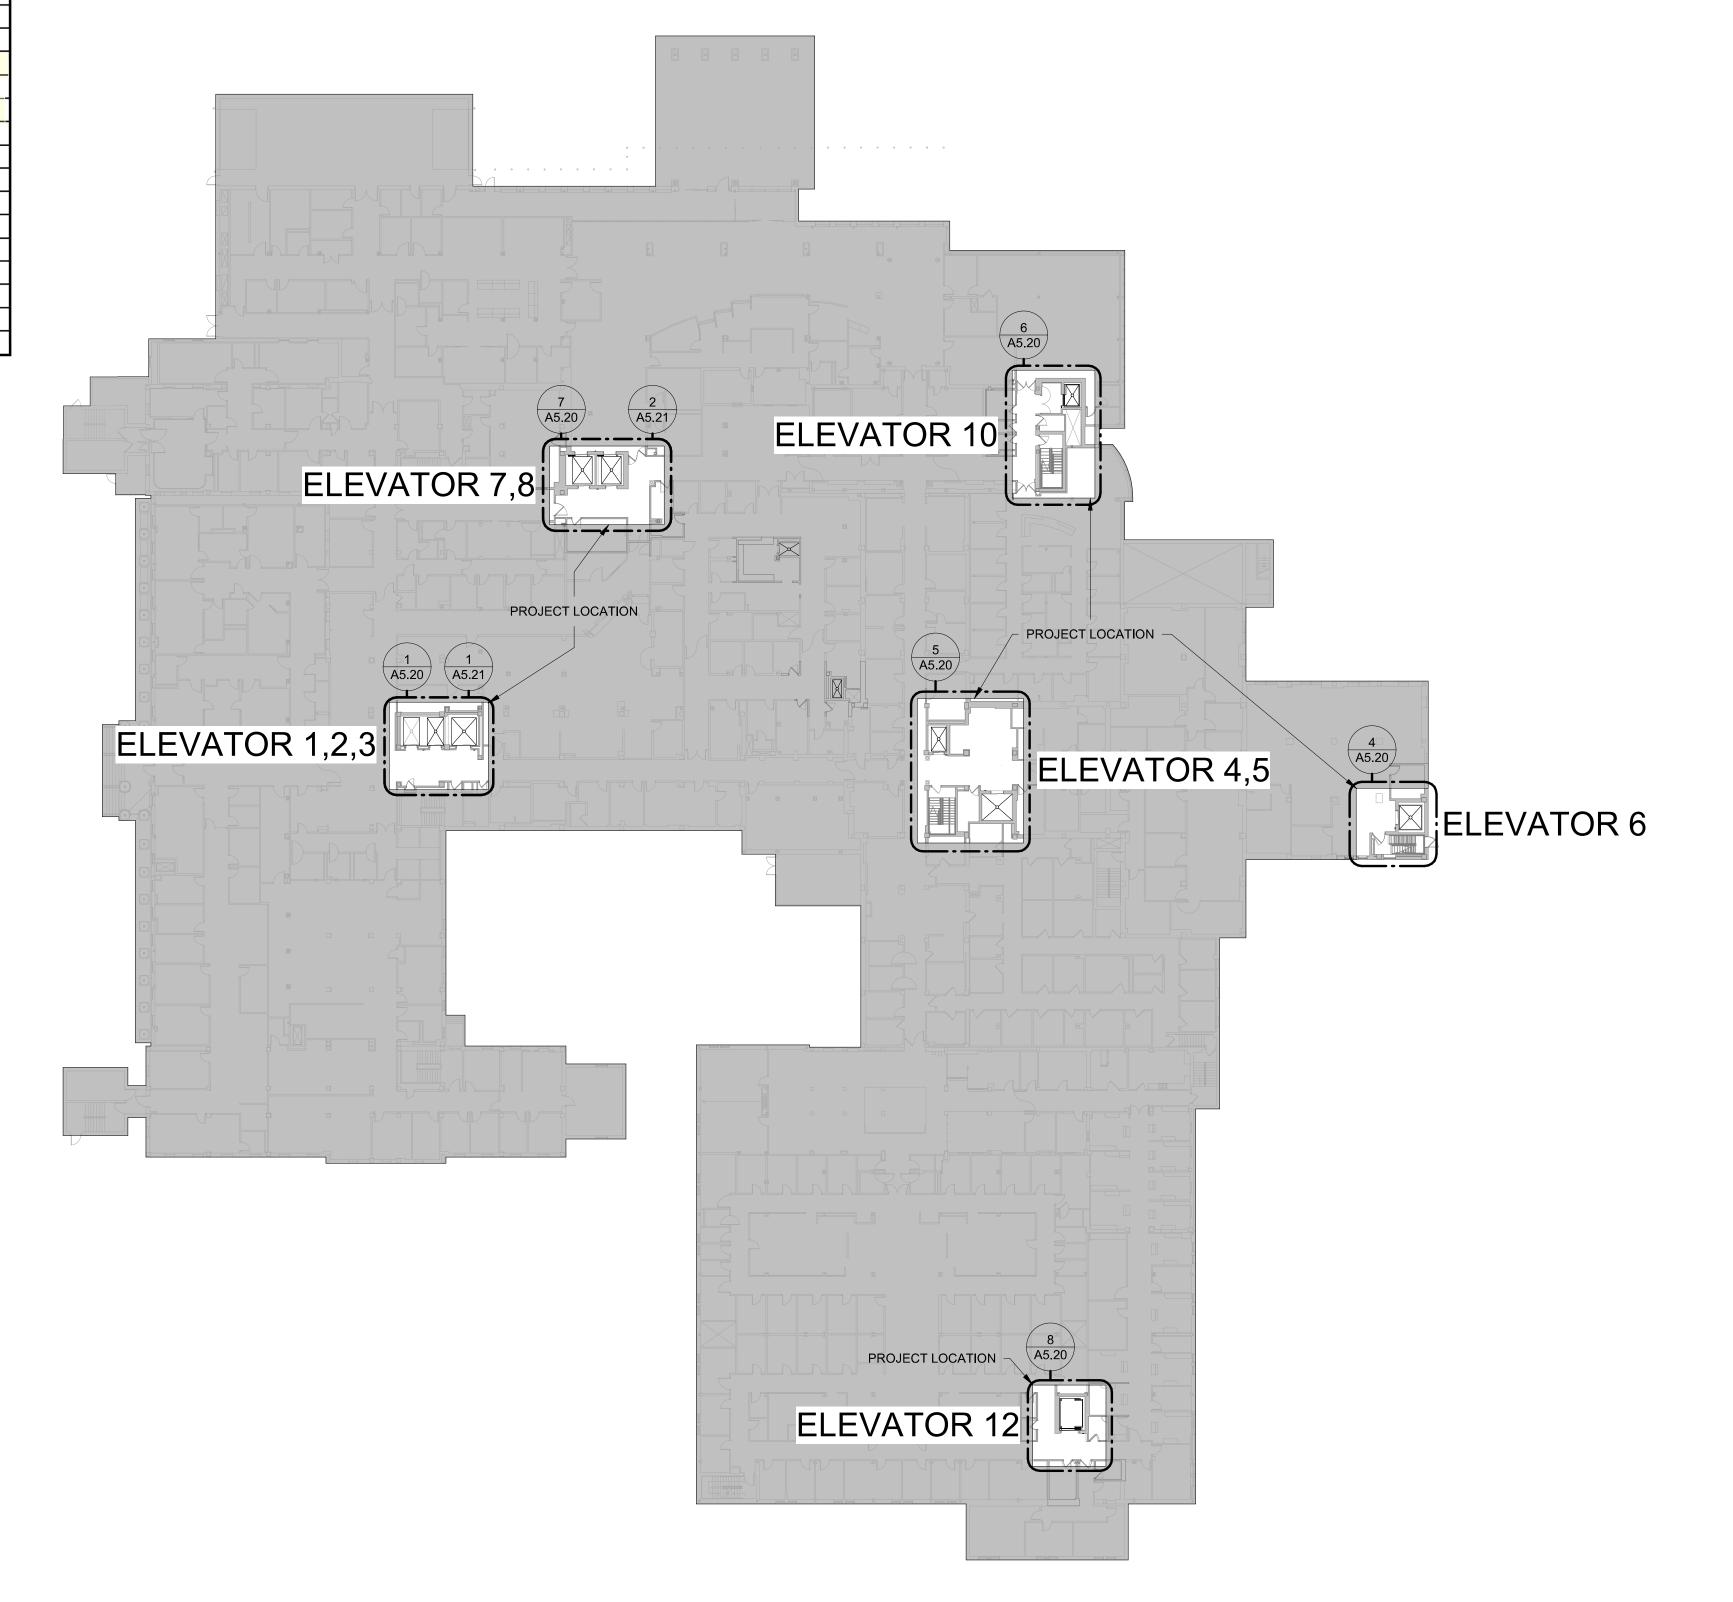

1) FLOOR PLAN - LEVEL 1 - OVERALL REFRENCE PLAN 1/32" = 1'-0"

(612) 387-7050

GENERAL NOTES:

1. THIS PROJECT INCLUDES THE DESIGN, INSTALLATION, AND REMODEL OF AN EXISTING ADDRESSABLE FIRE ALARM SYSTEM FOR THE REMODELED AREAS FOR THE ELEVATOR REHAB PROJECT OF THE EXISTING BUILDING AS SHOWN ON THESE PLANS PER NFPA 72 (2019 ed.), LOCAL BUILDING CODES, AND THE VA FIRE PROTECTION DESIGN MANUAL (SEVENTH ed.). ALL DEMOLITION AND DISPOSAL OF EXISTING SYSTEM COMPONENTS SHALL BE PERFORMED AS REQUIRED.

2. FINAL DEVICE LOCATION AND CIRCUIT ROUTING IS TO BE DETERMINED BY THE FIRE ALARM CONTRACTOR AND IS SUBJECT TO APPROVAL BY THE ENGINEER OF RECORD.

3. REFER TO SPECIFICATION SECTION 28 31 00 FOR ADDITIONAL FIRE ALARM SYSTEM INFORMATION.

4. ALL DEVICES SHALL BE UL LISTED AND FM APPROVED PER THE VA FIRE PROTECTION DESIGN

5. DEVICES ARE REQUIRED TO BE PROTECTED DURING PAINTING. EXISTING SMOKE DETECTORS TO REMAIN IN AREAS ADJACENT TO THE WORK AREA SHALL BE PROTECTED AGAINST CONTAMINATION DURING CONSTRUCTION.

6. CEILING MOUNTED DEVICES SHALL BE LOCATED IN THE CENTER POINT OF SQUARE CEILING TILES AND ALLOWED TO BE IN THE QUARTER AND/OR CENTER POINTS OF RECTANGULAR CEILING

7. NOT ALL REQUIRED DEVICES AND WIRING ARE SHOWN. CONSIDERATION OF ADDITIONAL DEVICES AND WIRING DUE TO INTERFERENCE WITH OTHER TRADES, OBSTRUCTIONS, IMPROVED AESTHETICS, OR OWNER/AHJ REQUESTS SHALL BE MADE PRIOR TO BID BY THE FIRE ALARM CONTRACTOR.

8. FIRE ALARM CONTRACTOR TO PROVIDE ALL NECESSARY MATERIAL TO PROVIDE COMPLETE SYSTEM(S) TO COMPLY WITH NFPA 72, LOCAL BUILDING CODES, AND THE VA FIRE PROTECTION DESIGN MANUAL. ANY AND ALL CLARIFICATIONS TO BID DOCUMENTS SHALL BE MADE PRIOR TO BID

9. THE FIRE ALARM CONTRACTOR SHALL INSPECT THE SITE PRIOR TO BID. NO ALLOWANCES FOR EXTRA DEVICES ETC. WILL BE ALLOWED AFTER AWARD OF CONTRACT DUE TO MISUNDERSTANDING OF WORK INVOLVED OR LACK OF KNOWLEDGE OF ANY PROJECT SITE CONDITIONS.

10. CONTROL PANEL AND DEVICE LOCATIONS SHOWN ON THESE PLANS IS CONCEPTUAL BUT IS TO BE CLOSELY FOLLOWED BY THE FIRE ALARM CONTRACTOR. ANY MAJOR CHANGES TO WHAT IS BEING INDICATED ON THESE PLANS SHALL FIRST BE APPROVED BY THE ARCHITECT AND ENGINEER OF RECORD.


11. ALL ARCHITECTURAL, STRUCTURAL, MECHANICAL, & ELECTRICAL FEATURES INDICATED ON THE FA SHEETS SHALL BE VERIFIED BY CONSULTING THE A/S/M&E SHEETS.

12. ALL CALCULATIONS ARE THE RESPONSIBILITY OF THE FIRE ALARM CONTRACTOR. ANY AND ALL CLARIFICATION TO BID DOCUMENTS SHALL BE MADE PRIOR TO BID.


13. SHOULD ANY EXISTING SYSTEM DEFICIENCIES NOT INDICATED ON THESE PLANS BE DISCOVERED AS PART OF CONDUCTING THE WORK INCLUDED IN THIS SCOPE, THEY SHALL BE BROUGHT TO THE ATTENTION OF THE ENGINEER OF RECORD IMMEDIATELY.

14. THESE PLANS SHALL BE USED AS A GENERAL GUIDE IN THE GENERATION OF THE FIRE ALARM CONTRACTOR'S BID AND ARE NOT INTENDED TO INDICATE THE ENTIRE EXTENT OF ALARM PROTECTION REQUIRED. ANY AERAS REQUIRED TO BE PROTECTED PER NFPA 72 THAT MAY OR MAY NOT BE SHOWN WITH PROTECTION ON THESE PLANS SHALL BE INCLUDED IN THE CONTRACTOR'S BID.

15. FIRE ALARM CONTRACTOR SHALL BE RESPONSIBLE FOR THE REMOVAL AND RE-INSTALLING OF EXISTING CEILING TILE AND WALLS NOT REMOVED BY THE GENERAL CONTRACTOR FOR THE DEMOLITION OF EXISITNG FIRE ALARM DEVICES, WIRING, ETC. ANY CEILING OR WALL COMPONENTS DAMAGED SHALL BE REPLACED OR PATCHED WITH NEW BY THIS CONTRACTOR.

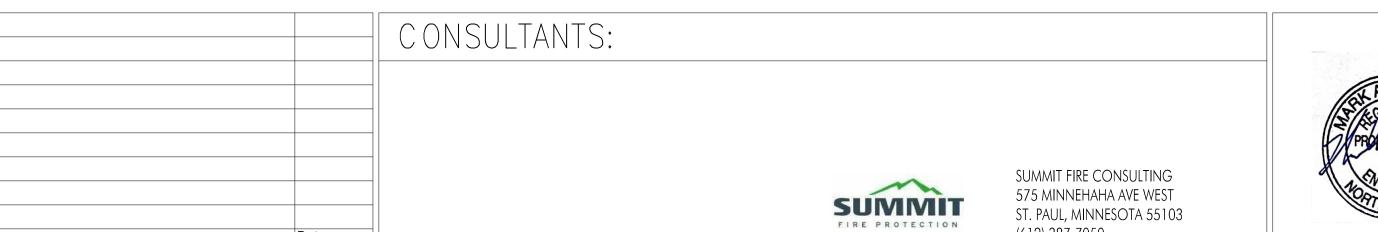




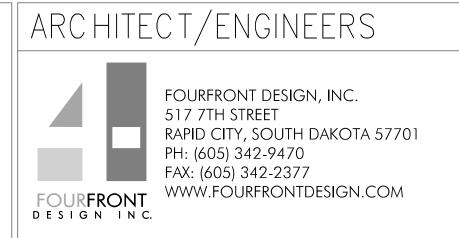

rawing Title	Project Title			Project Number
FIRE ALARM - GENERAL NOTES	REFURBISH REPLACE CO			437-22-101 Building Number
oproved: Project Director Dwner	Location 2101 ELM FARGO, N	Drawing Number FA1.00		
	12.20.22	MAS	NB	Dwg. of

Office of Construction and Facilities Management

Department of Veterans Affairs

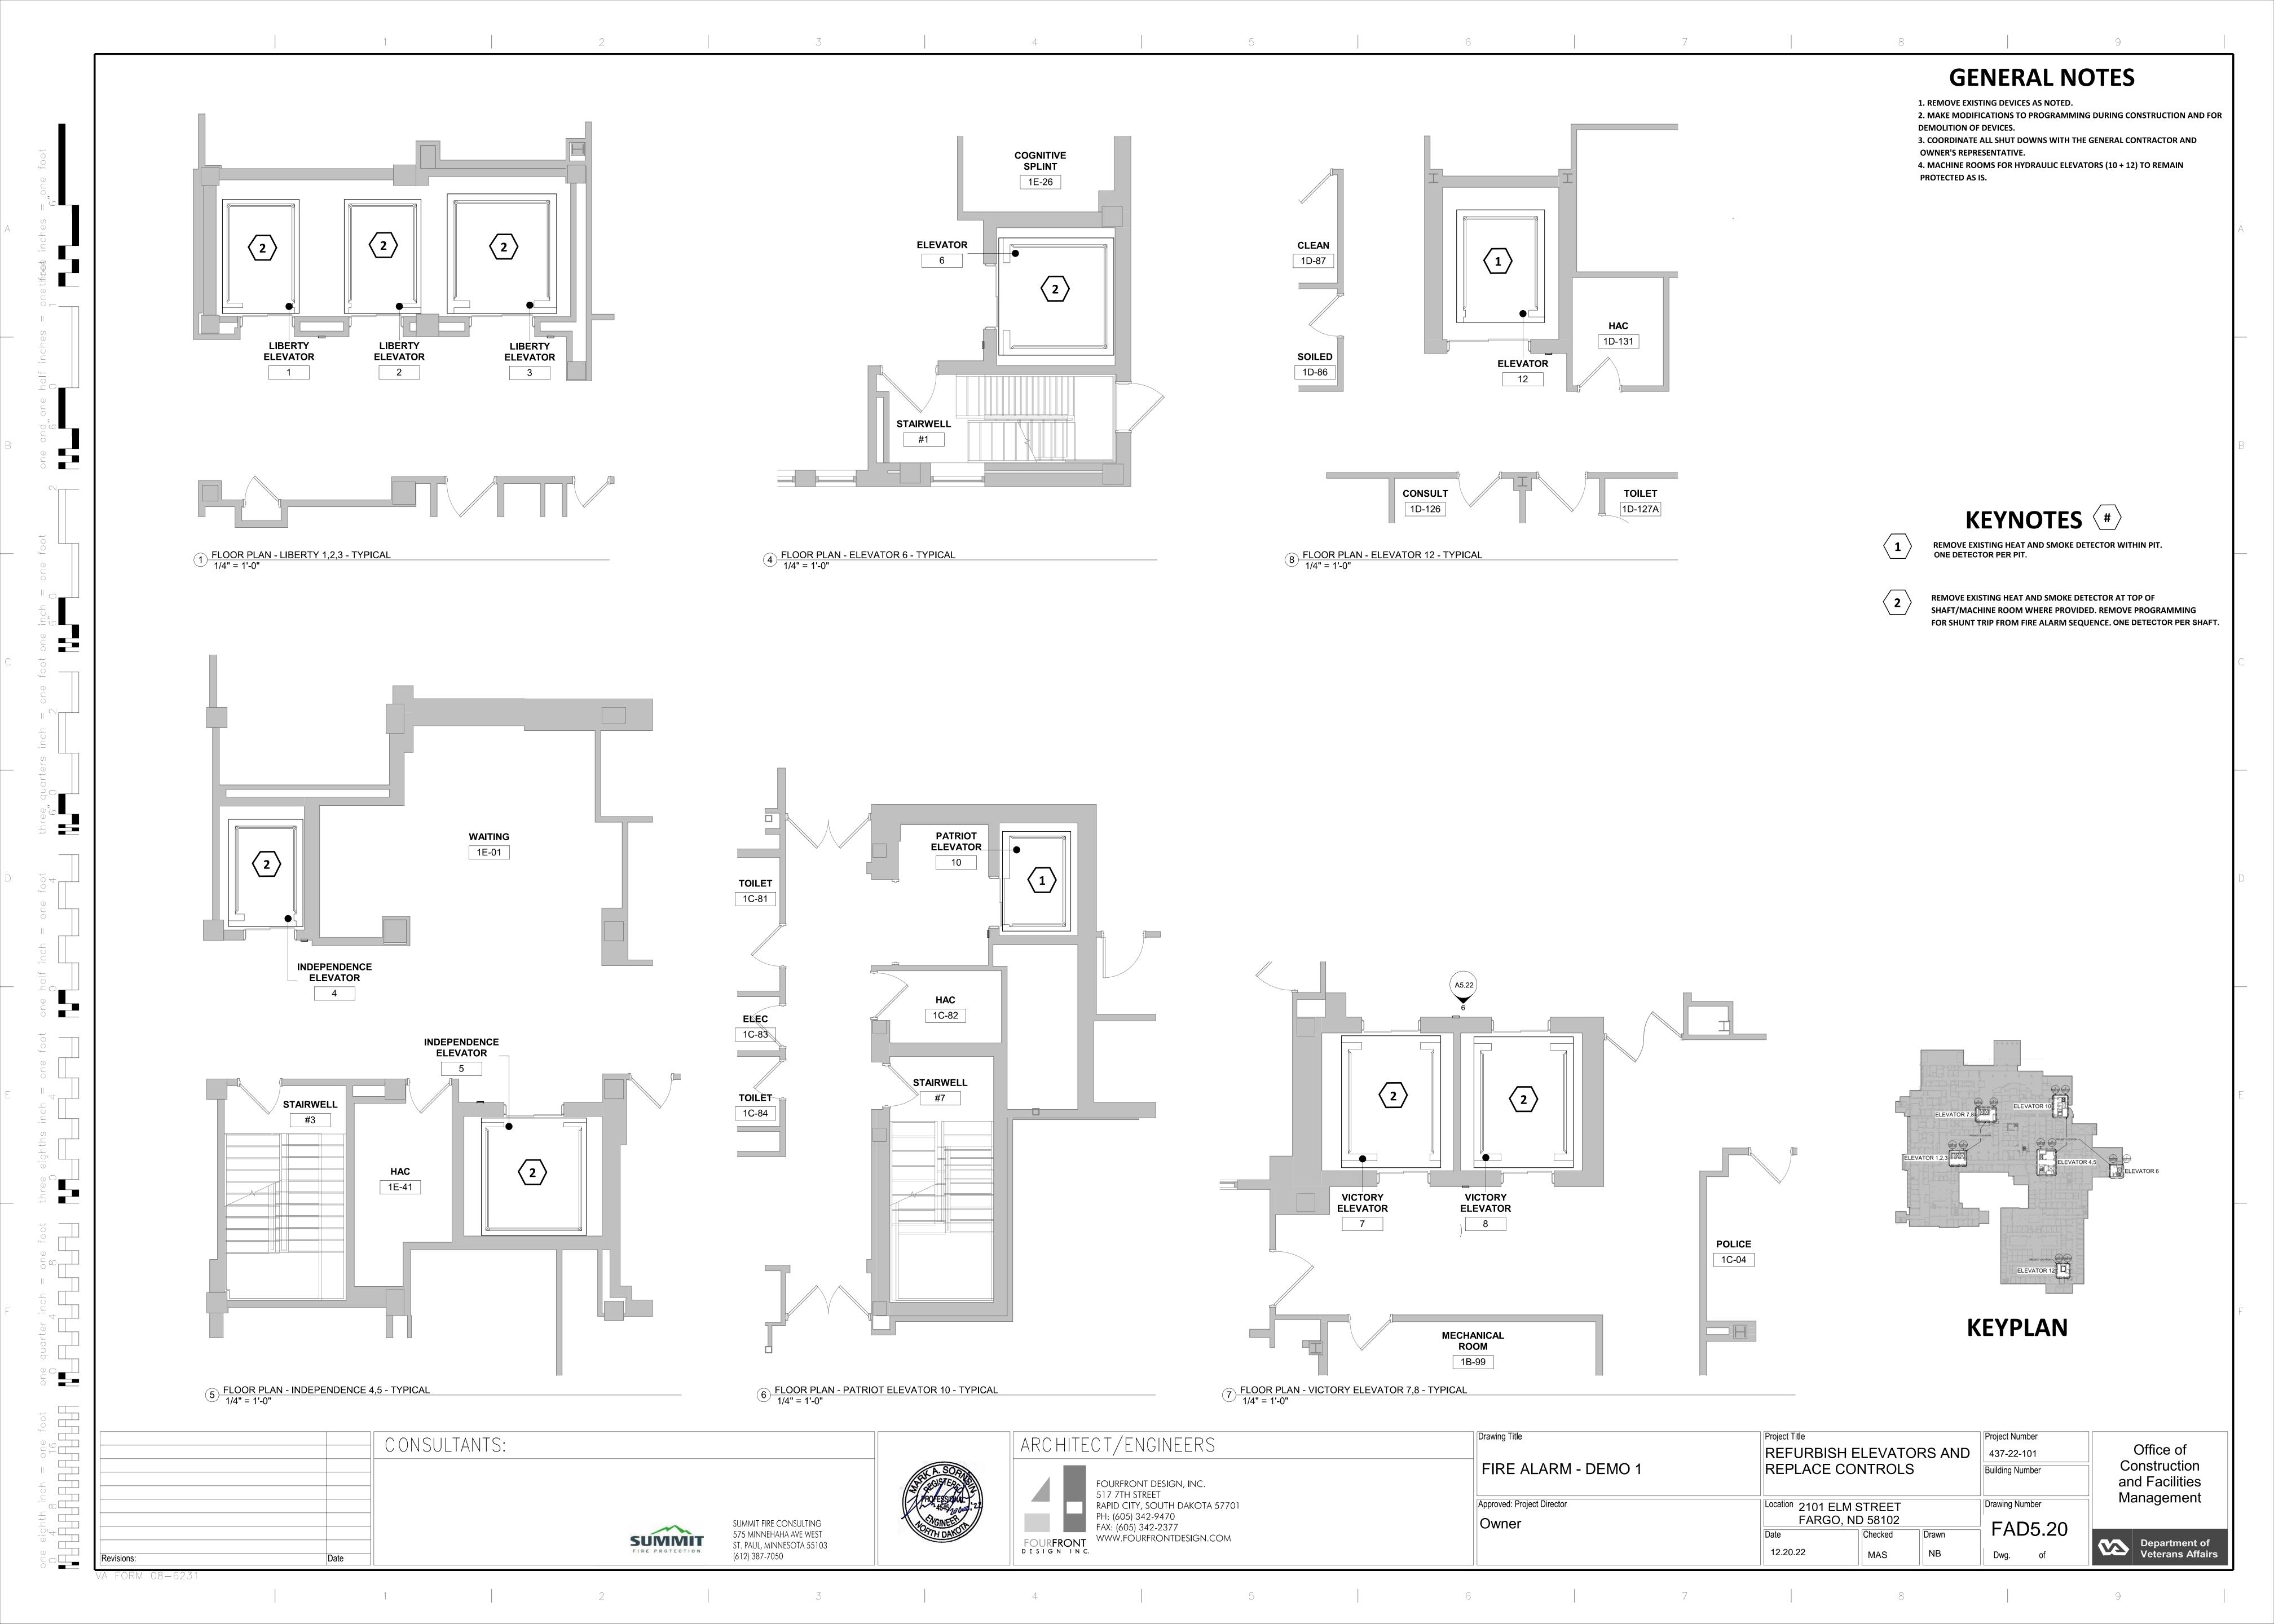




1. REMOVE EXISTING DEVICES AT TOP OF ELEVATOR SHAFT/PENTHOUSE.
2. MODIFY PROGRAMMING AS NOTED FOR MODIFICATIONS


KEYNOTES (#)

REMOVE EXISTING HEAT AND SMOKE DETECTOR AT TOP OF SHAFT/MACHINE ROOM WHERE PROVIDED. REMOVE PROGRAMMING FOR SHUNT TRIP FROM FIRE ALARM SEQUENCE. ONE DETECTOR PER SHAFT.

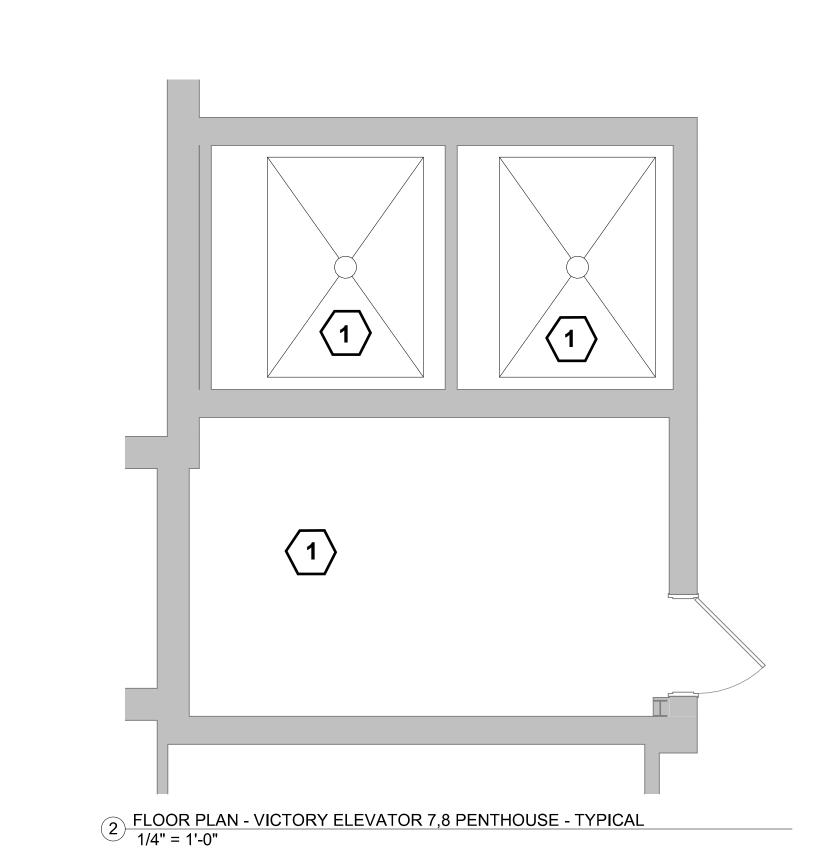


1 FLOOR PLAN - LIBERTY 1,2,3 PENTHOUSE - TYPICAL 1/4" = 1'-0"


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KEYPLAN

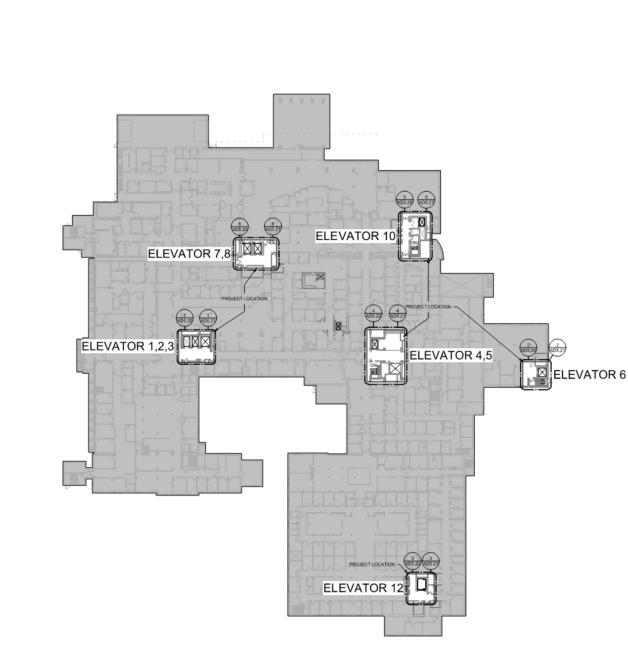


1 2 5 7

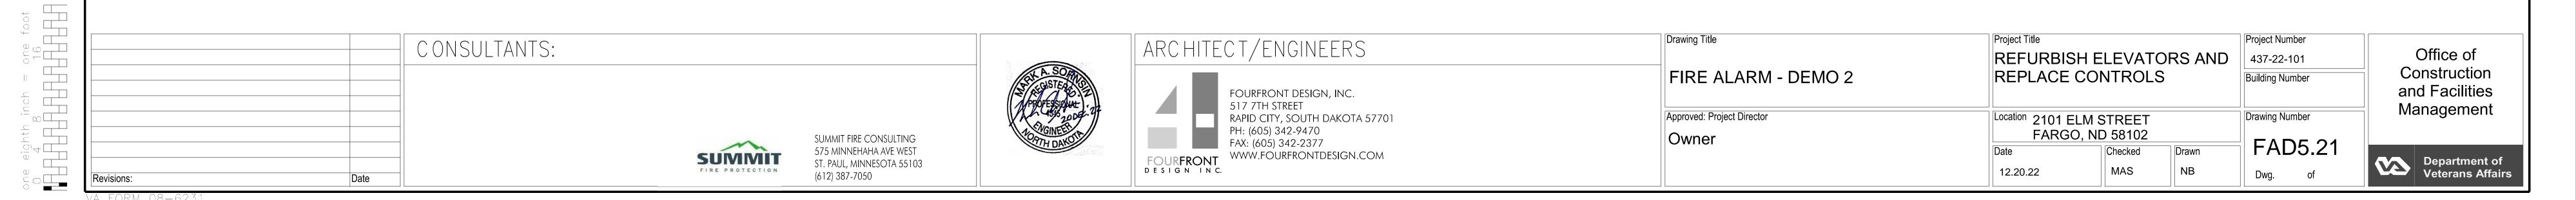


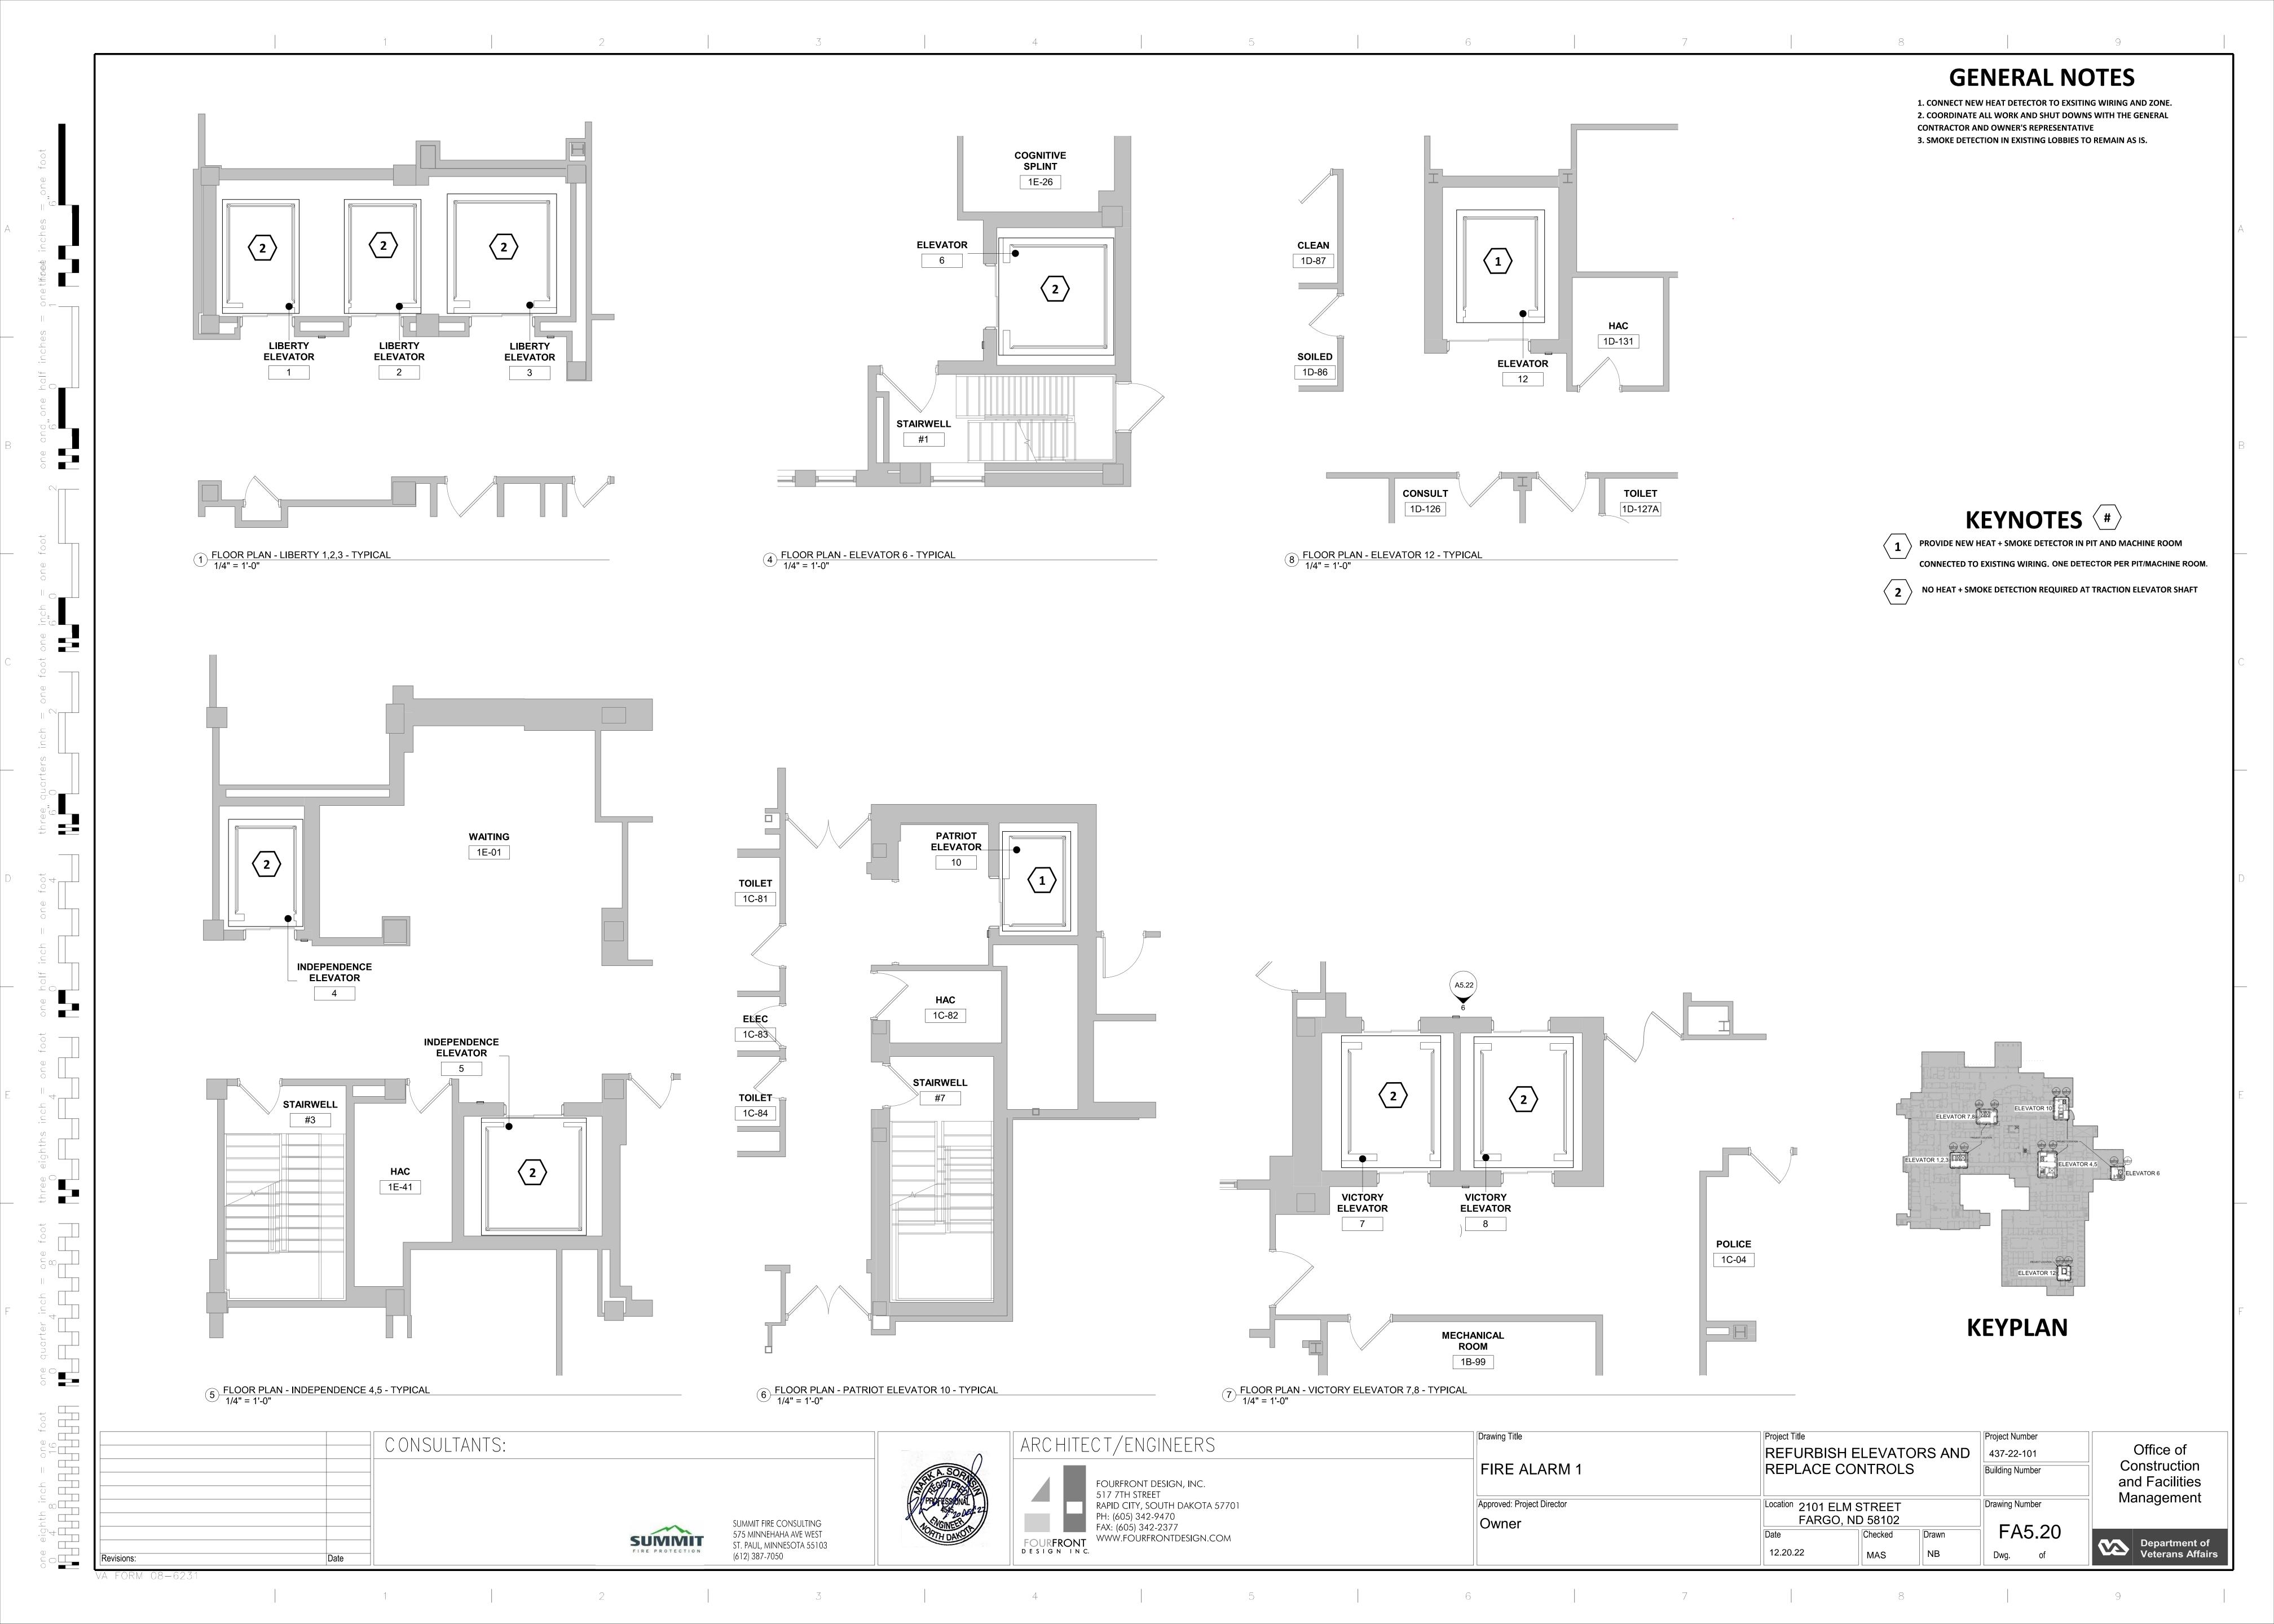

1. NO WORK IN PENTHOUSE OR TOP OF ELEVATOR SHAFT.

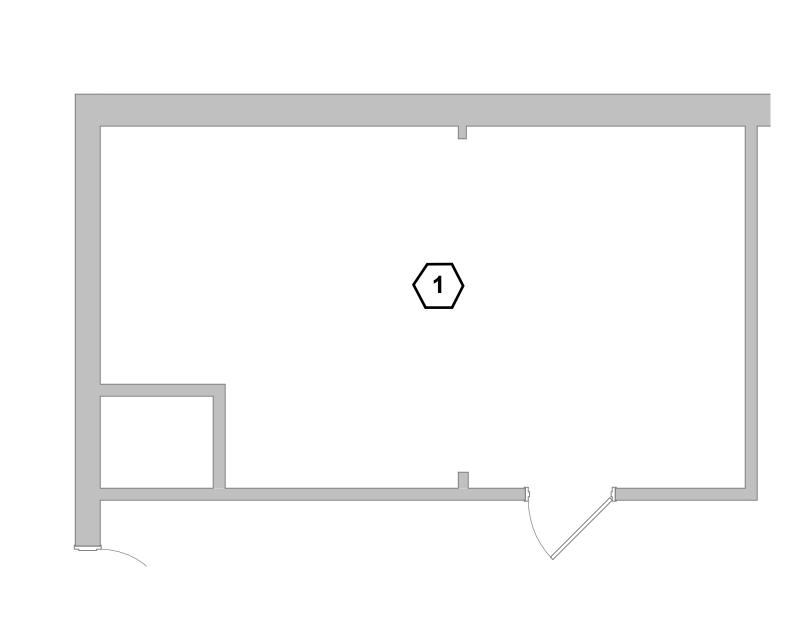


1 FLOOR PLAN - LIBERTY 1,2,3 PENTHOUSE - TYPICAL 1/4" = 1'-0"

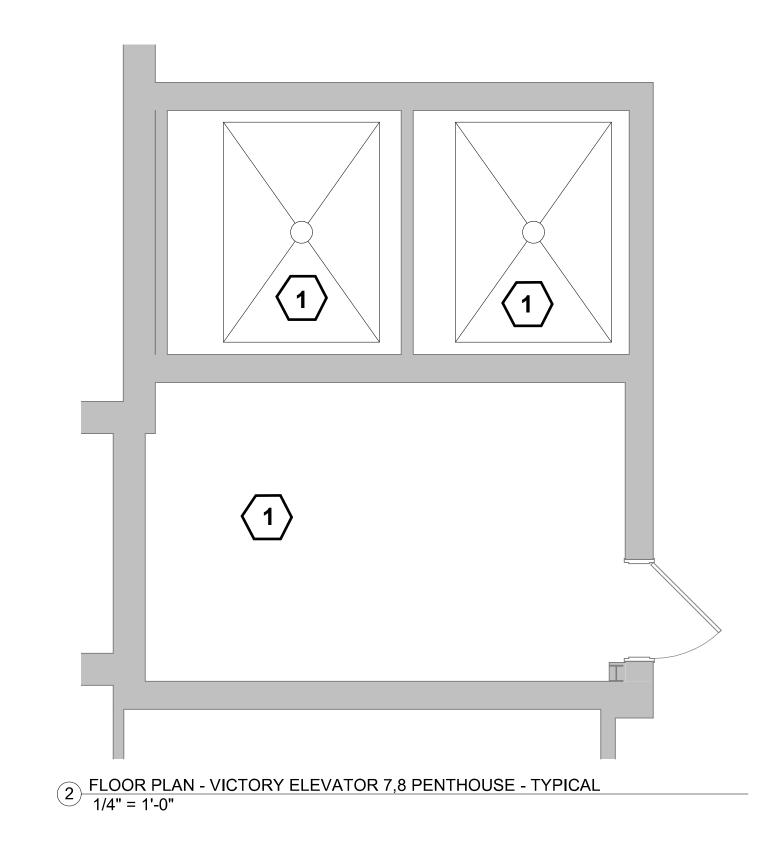


KEYNOTES (#)

NO HEAT + SMOKE DETECTION REQUIRED AT TRACTION ELEVATOR SHAFT

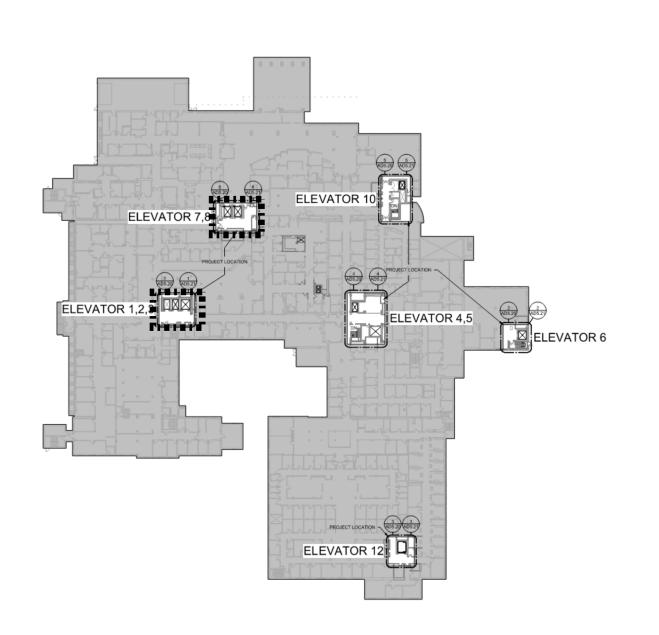

KEYPLAN

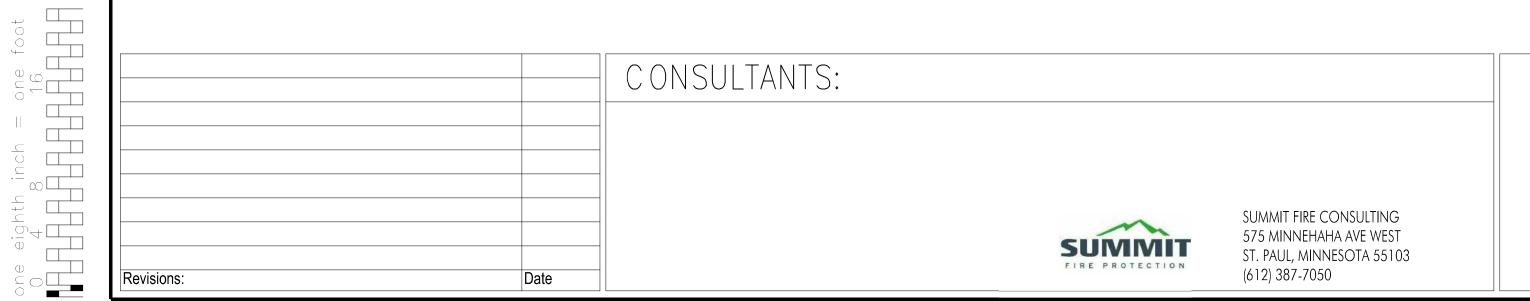



ARCHITECT/ENGINEERS					
FOURFRONT DESIGNINC.	FOURFRONT DESIGN, INC. 517 7TH STREET RAPID CITY, SOUTH DAKOTA 57701 PH: (605) 342-9470 FAX: (605) 342-2377 WWW.FOURFRONTDESIGN.COM				

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wing Title	Project Title	Project Title			
IRE ALARM 2		REFURBISH ELEVATORS AND REPLACE CONTROLS			
proved: Project Director	Location 2101 ELN	1 STREET		Drawing Number	
wner		FARGO, ND 58102			
	12.20.22	MAS	NB	Dwg. of	

Office of
Construction
and Facilities
Management

Department of
Veterans Affairs