

- 1. REFERENCE SPECIFICATION 02 82 13.13 FOR ABATEMENT WORK. THE VA TO PROVIDE APPLICABLE ABATEMENT REPORT.
- 2. COORDINATE INSTALLATION OF NEW PIPING AND NEW DUCTWORK. ALL LOCATIONS FOR DUCTWORK AND PIPING ARE APPROXIMATE. PROVIDE OFFSETS AS REQUIRED TO AVOID EXISTING OBSTACLES. RELOCATE EXISTING HANGERS AND COMPONENTS AS REQUIRED
- TO ALLOW FOR INSTALLATION OF NEW EQUIPMENT AND COMPONENTS. 3. ALL WALL PENETRATIONS TO BE TREATED AS AN 1 HOUR RATED WALL UNLESS OTHERWISE NOTED ON THE DRAWING. REPAIR AND PAINT THE WALLS/CEILING TO MATCH EXISTING CONDITIONS AFTER THE REMOVAL OF THE EXISTING EQUIPMENT OR INSTALLATION OF NEW WORK.
- 4. MODIFY SPRINKLER PIPING IF REQUIRED TO INSTALL NEW WORK. INSTALL AND SUPPORT PIPING PER NFPA 99, SPECIFICATIONS AND DRAWINGS.
- 5. MAINTAIN SERVICE CLEARANCE ON NEW AND EXISTING EQUIPMENT. REFER TO MECHANICAL DRAWINGS AND MANUFACTURER'S INSTALLATION MANUALS FOR ADDITIONAL
- 6. ADHERE TO ALL ICRA REQUIREMENTS LISTED IN THE ARCHITECTURAL SET. THE ICRA LEVEL HAS BEEN DEFINED BY THE VA AS LEVEL 3 UNLESS OTHERWISE INDICATED. PROTECT ALL EQUIPMENT IN THE ROOM FROM DUST, DEBRIS AND PHYSICAL DAMAGE
- AT ALL TIMES. 7. AVOID ALL CEILING OR WALL MOUNTED DEVICES (I.E. SIGNAGE, LIGHT FIXTURE, NURSE CALL) WHEN LOCATING ICRA BARRIERS. WHEN EXISTING DEVICE(S) CANNOT BE
- COMPLETED AS APPROVED BY THE COR. 8. REMOVE AND REPLACE EXISTING CEILINGS REFER TO THE ARCHITECTURAL DRAWING FOR

AVOIDED, TEMPORARILY RELOCATE THE DEVICE(S) AND REINSTALL AFTER WORK IS

- 9. NOT ALL PIPING COMPONENTS ARE SHOWN. REFER TO DETAILS AND SPECIFICATIONS FOR ALL REQUIRED VALVES, UNIONS, GAUGES, STRAINERS ETC.
- 10. ALL PIPING PENETRATIONS SHALL BE CORE DRILLED. REFERENCE STRUCTURAL DRAWINGS FOR DETAILS.
- 11. INSTALLING CONTRACTOR IS RESPONSIBLE FOR PROVIDING AND INSTALLING THE REFRIGERATION PIPING IN ACCORDANCE WITH THE MANUFACTURER'S GUIDELINES. THE CONTRACTOR IS TO PROVIDE DETAILED PIPING LAYOUT TO THE MANUFACTURER FOR PIPE SIZING AND OTHER REQUIREMENTS. FINAL SHOP DRAWING APPROVAL IS BY THE ENGINEER. THE INSTALLING CONTRACTOR IS RESPONSIBLE FOR LEAK CHECKS, EVACUATION AND INITIAL REFRIGERATION CHARGE. THE INSTALLING CONTRACTOR SHALL PROVIDE EXTRA REFRIGERANT TO THE FACTORY START-UP TECHNICIAN FOR FINAL REFRIGERANT CHARGE. THE INSTALLING CONTRACTOR IS RESPONSIBLE FOR WIRING AND COMMUNICATIONS BETWEEN AHU'S AND CONDENSING UNITS.
- 12. CONTRACTOR CANNOT START ANY WORK PER SYSTEM (AHU) UNTIL THE COORDINATED SHOP DRAWINGS AND PRODUCT SUBMITTALS HAVE BEEN APPROVED BY THE ENGINEER.

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ADDITIONAL INFORMATION.

- 1. MINIMUM PIPE SIZES FOR UP TO 50 EQUIVALENT FT. INCREASE PIPE SIZES AS REQUIRED TO ACCOMMODATE THE ACTUAL ROUTING:
- SUCTION LINE 5/8" ø LIQUID LINE 3/8" ø
- HOT GAS REHEAT 3/8" ø
- MINIMUM PIPE SIZES FOR OVER 60 EQUIVALENT FT. INCREASE PIPE SIZES AS REQUIRED TO ACCOMMODATE THE ACTUAL ROUTING:
- SUCTION LINE 3/4" ø
- LIQUID LINE 1/2" ø
- HOT GAS REHEAT 1/2" ø
- INSTALL AND INSULATE PIPING ACCORDING TO SPECIFICATIONS AND AHU MANUFACTURER RECOMMENDATIONS. VERIFY PIPE SIZING WITH AHU MANUFACTURER. PIPING MUST BE SIZED TO MEET THE ACTUAL INSTALLATION CONDITIONS. INSTALL SUCTION LINE ACCUMULATOR AND 1/8" CAPILLARY TUBING FOR PURGE CIRCUIT. SEE AHU MANUFACTURER'S INSTALLATION INSTRUCTIONS.
- 2. RUN PIPING ABOVE THE (E) CEILING AND OUT THROUGH THE EXTERIOR WALL AND TO 28-CU-210.
- 3. CONDENSING UNIT IS SUPPORTED BY DUNNAGE 3'-0" ABOVE GRADE. PROVIDE EXTERIOR PIPING STRUCTURAL COVER. REFER TO STRUCTURAL DRAWINGS FOR DUNNAGE AND PIPE COVER DETAILS.
- 4. MAINTAIN 6'-0" MINIMUM IN ALL DIRECTIONS FROM THE BUILDING TO PROTECT AGAINST FALLING SNOW AND ICE.

NORTH

PLAN / ACTUAL

PRINTS OF THIS DRAWING SHALL NOT BE USED FOR ANY PURPOSE WHATSOEVER WITHOUT THE SEAL AND SIGNATURE OF THE Drawing Title Project Title Project Number ENGINEER OF RECORD MILLER-REMICK LLC Office of 656-18-300 **MECHANICAL UPGRADE SPS HVAC &** PROFESSIONAL ENGINEER 100% CONSTRUCTION PROFESSIONAL ENGINEER. DOCUMENTS Miller-Remick LLC


M.E.P. & Structural Engineering


A Service Disabled Veteran Owned PIPING PLAN Construction **ENVIRONMENTAL CONTROLS** Building Number 1, 2, 3, 28, 29, 49, 50, 51, NOT FOR CONSTRUCTION BASEMENT - BUILDING 28 and Facilities MEP Engineers + Architects 111, 116 1173 Research Way 701 Forest Ave Portland, ME 04103 Management Approved: Project Director Drawing Number Forest, VA 24551 1-866-267-6839 1010 KINGS HIGHWAY SOUTH CHERRY HILL, NEW JERSEY 08034 ST. CLOUD VA MEDICAL CENTER, MN (207) 828-4511 **FULLY SPRINKLERED** PHONE: (856)429-4000 Checked 28-MP101 Drawn FAX: (856)429-5002 U.S. Department of Veterans Affairs MR BJS MR PROJECT NO: 0376-0011 2022-07-15 DESCRIPTION DATE

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3

VA FORM 08-6231



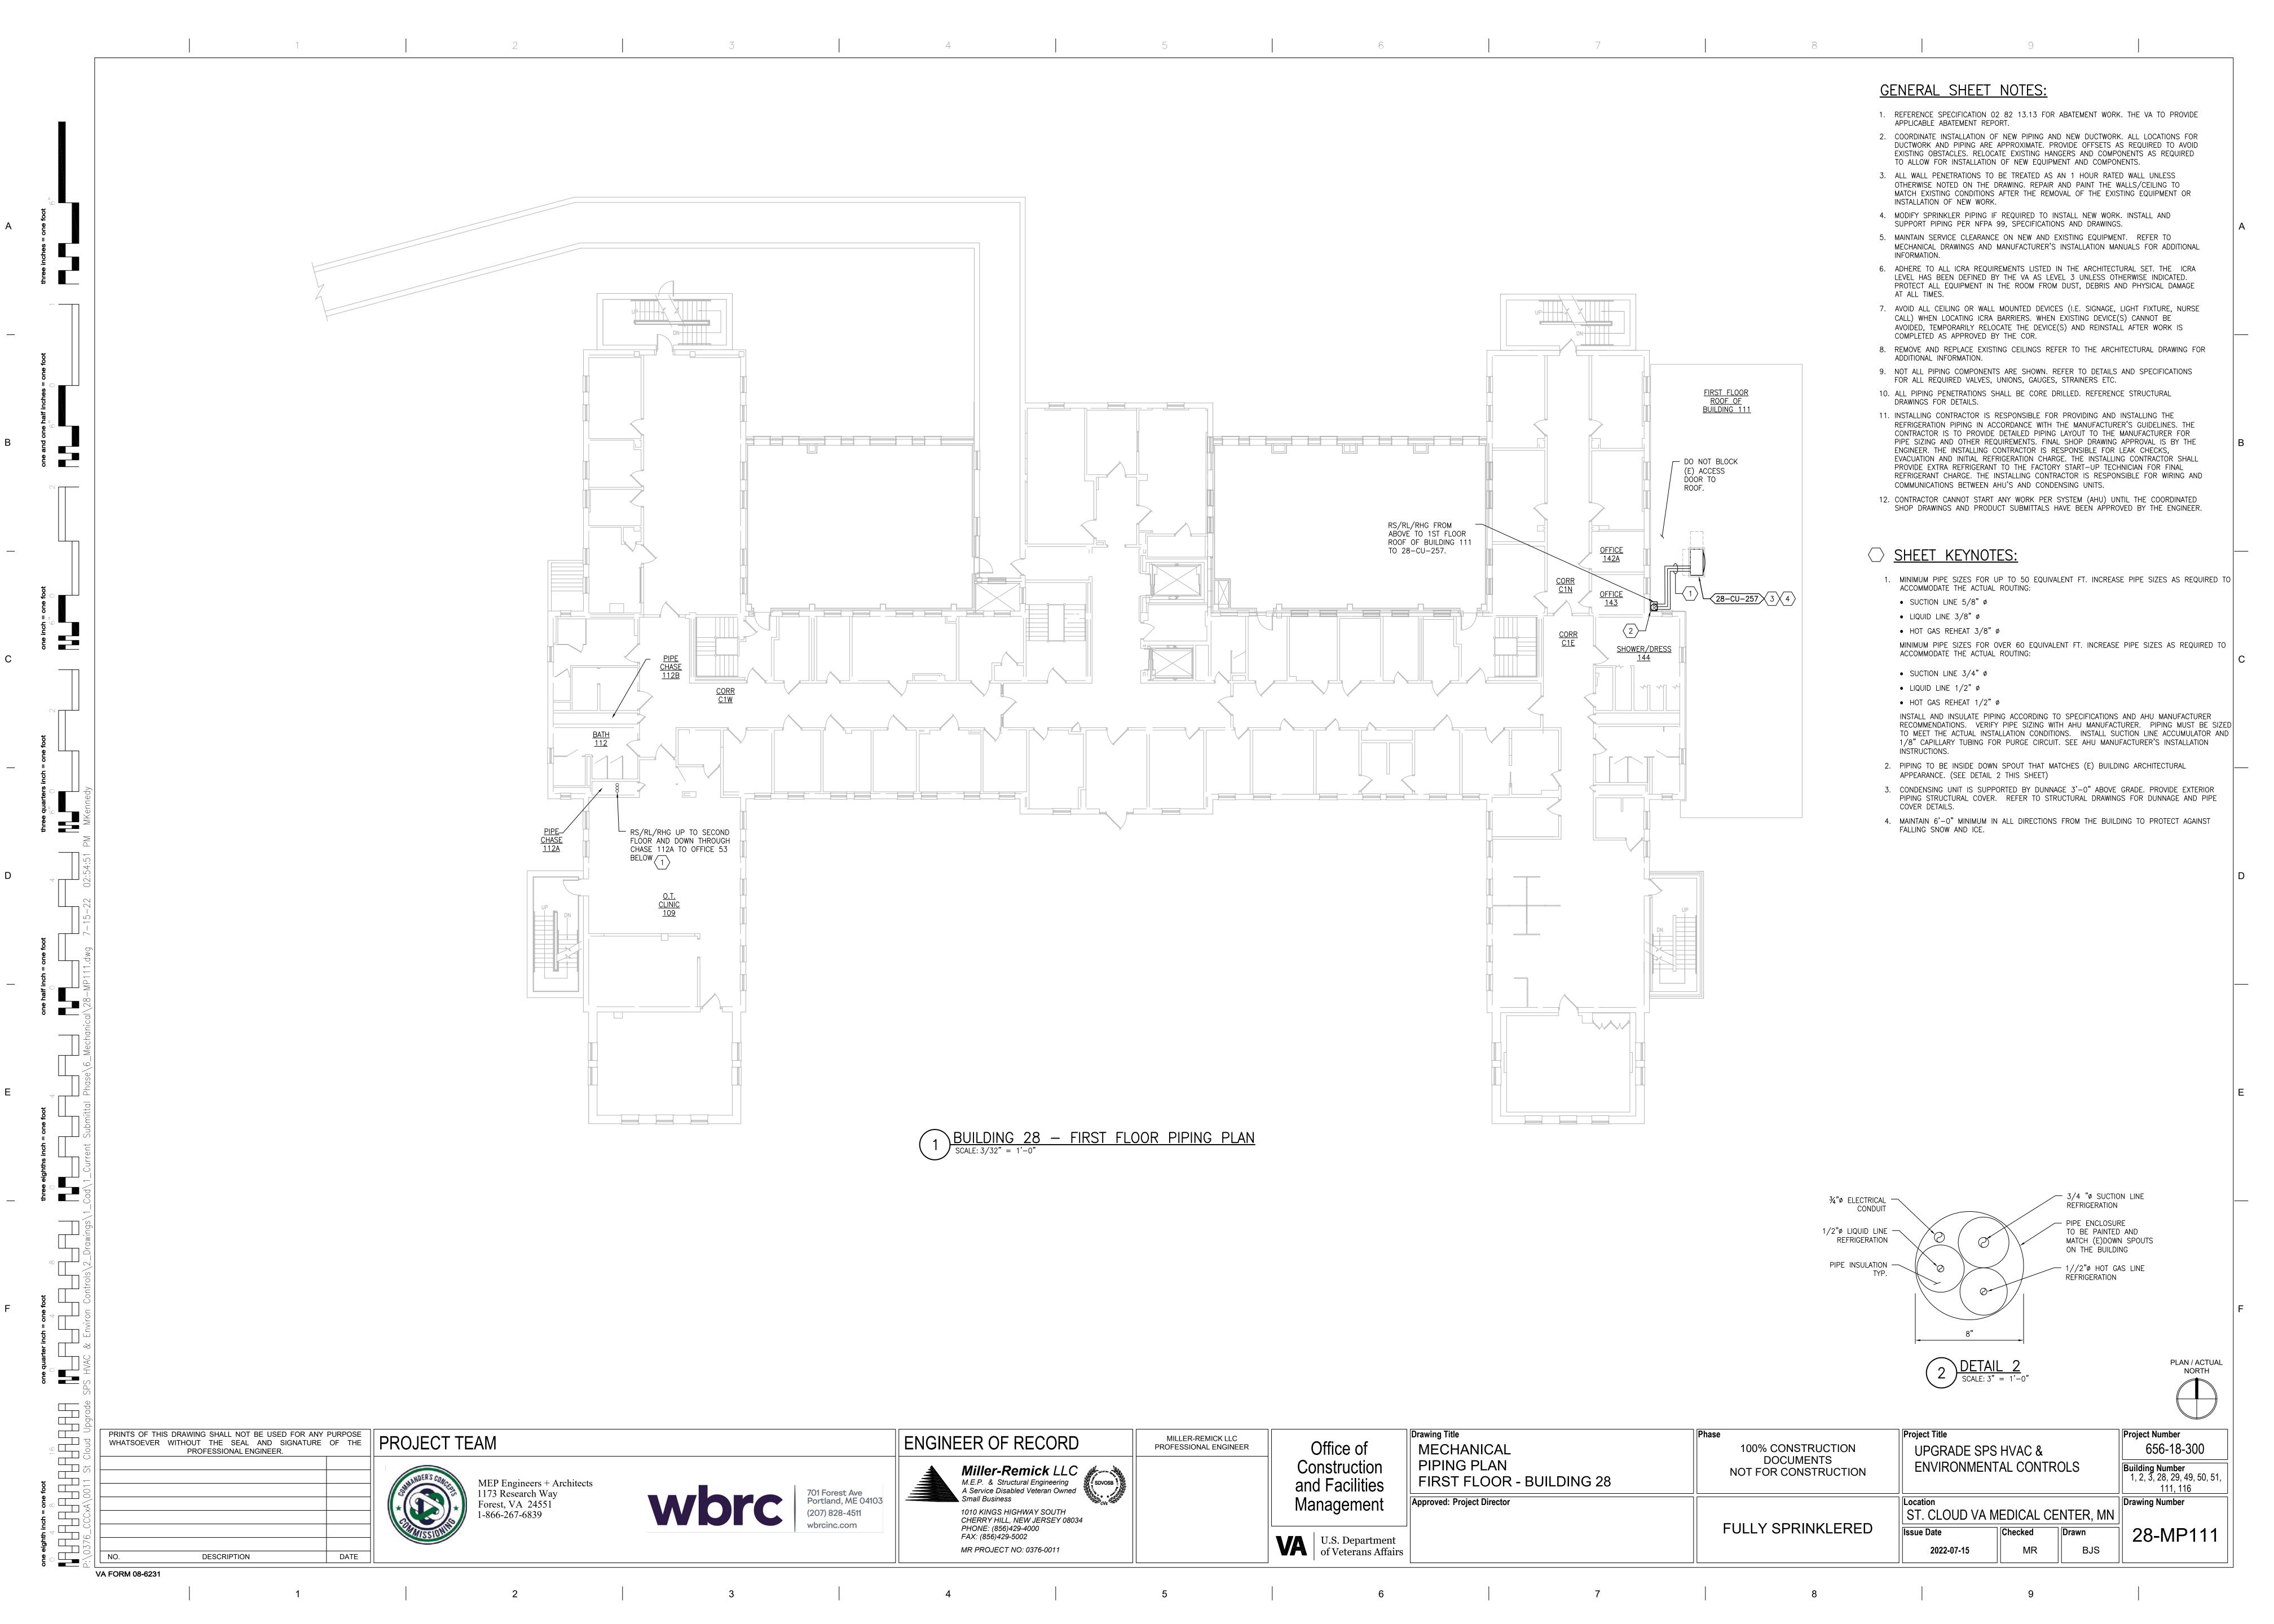
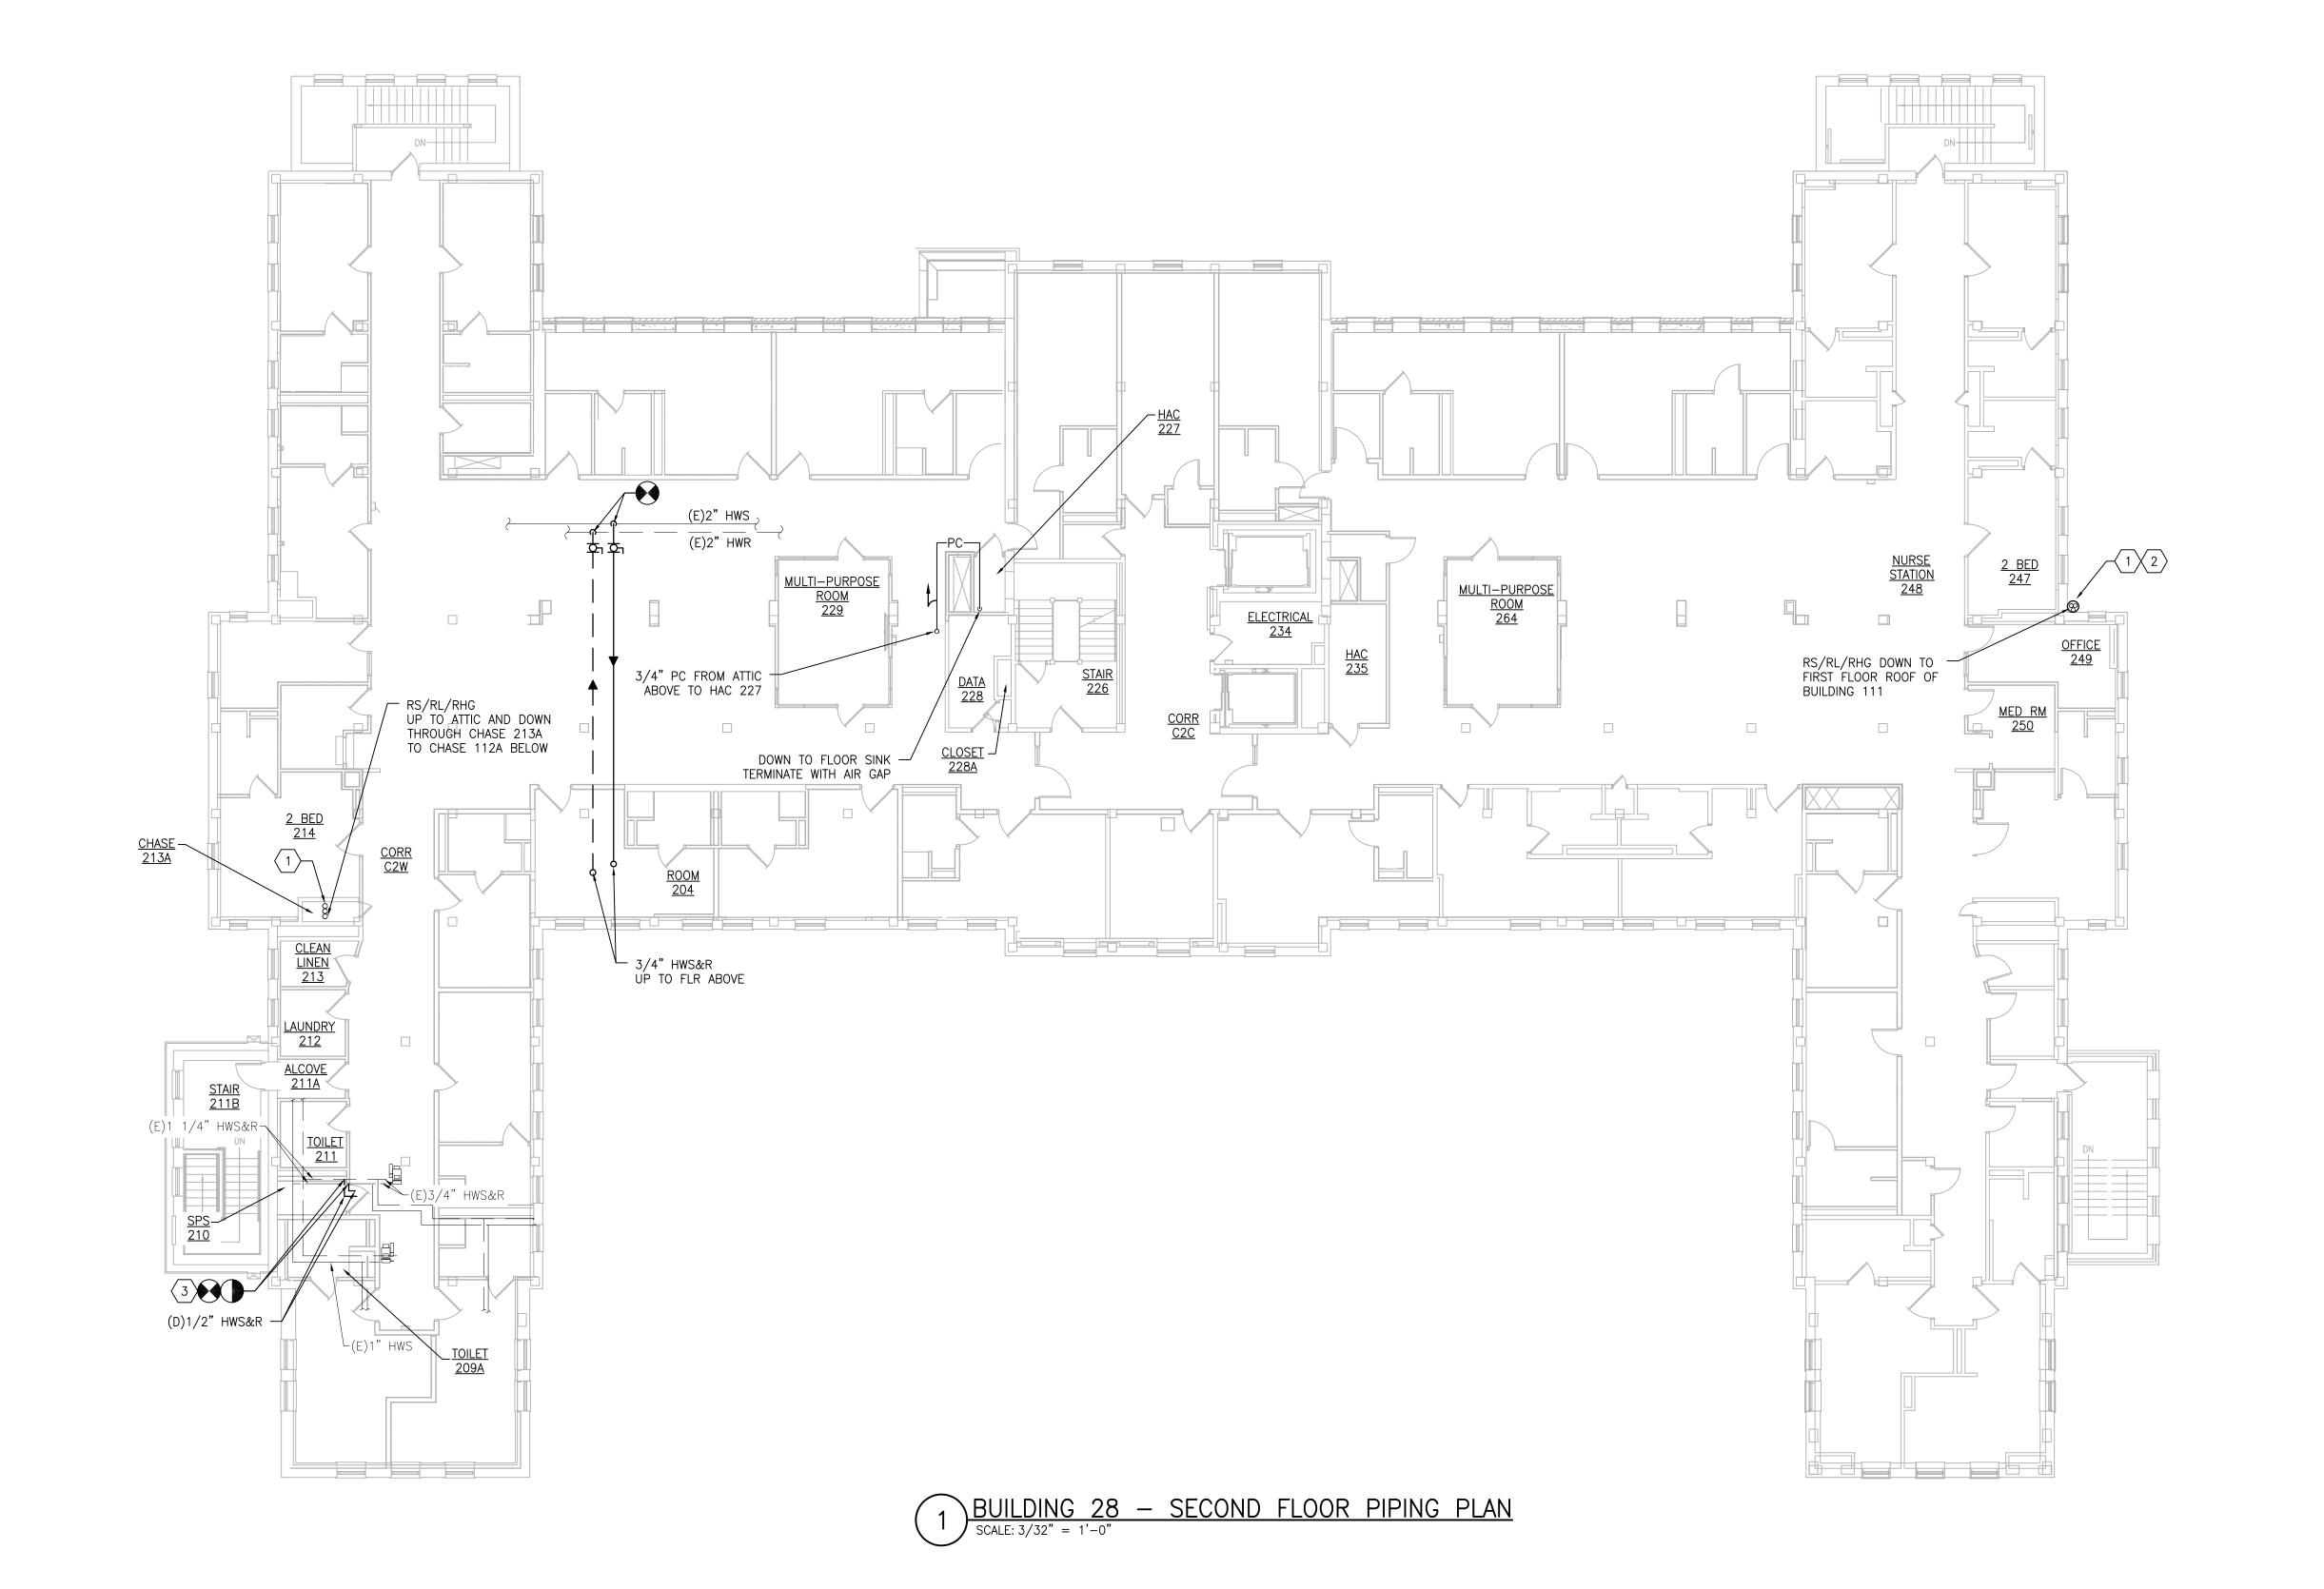
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- 2. PIPING TO BE INSIDE DOWN SPOUT ENCLOSURE THAT MATCHES (E) BUILDING ARCHITECTURAL APPEARANCE. (SEE DETAIL 2/28-MP111)
- 3. DEMOLISH 1/2" HWS&R PIPING FROM 2-VAV-219 AND ALL APPURTENANCES BACK TO THE EXISTING 1-1/4" MAIN AND CAP.

PLAN / ACTUAL NORTH

Project Title PRINTS OF THIS DRAWING SHALL NOT BE USED FOR ANY PURPOSE WHATSOEVER WITHOUT THE SEAL AND SIGNATURE OF THE Drawing Title Project Number ENGINEER OF RECORD MILLER-REMICK LLC Office of 656-18-300 **MECHANICAL** PROFESSIONAL ENGINEER 100% CONSTRUCTION UPGRADE SPS HVAC & PROFESSIONAL ENGINEER. DOCUMENTS Miller-Remick LLC

M.E.P. & Structural Engineering

A Service Disabled Veteran Owned


Small Rusiness PIPING PLAN Construction **ENVIRONMENTAL CONTROLS** Building Number 1, 2, 3, 28, 29, 49, 50, 51, NOT FOR CONSTRUCTION SECOND FLOOR - BUILDING 28 and Facilities MEP Engineers + Architects 111, 116 1173 Research Way 701 Forest Ave Portland, ME 04103 Management Approved: Project Director Drawing Number Forest, VA 24551 1-866-267-6839 1010 KINGS HIGHWAY SOUTH CHERRY HILL, NEW JERSEY 08034 ST. CLOUD VA MEDICAL CENTER, MN (207) 828-4511 **FULLY SPRINKLERED** PHONE: (856)429-4000 28-MP121 Checked Drawn FAX: (856)429-5002 U.S. Department of Veterans Affairs MR BJS MR PROJECT NO: 0376-0011 2022-07-15

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VA FORM 08-6231

DESCRIPTION

DATE

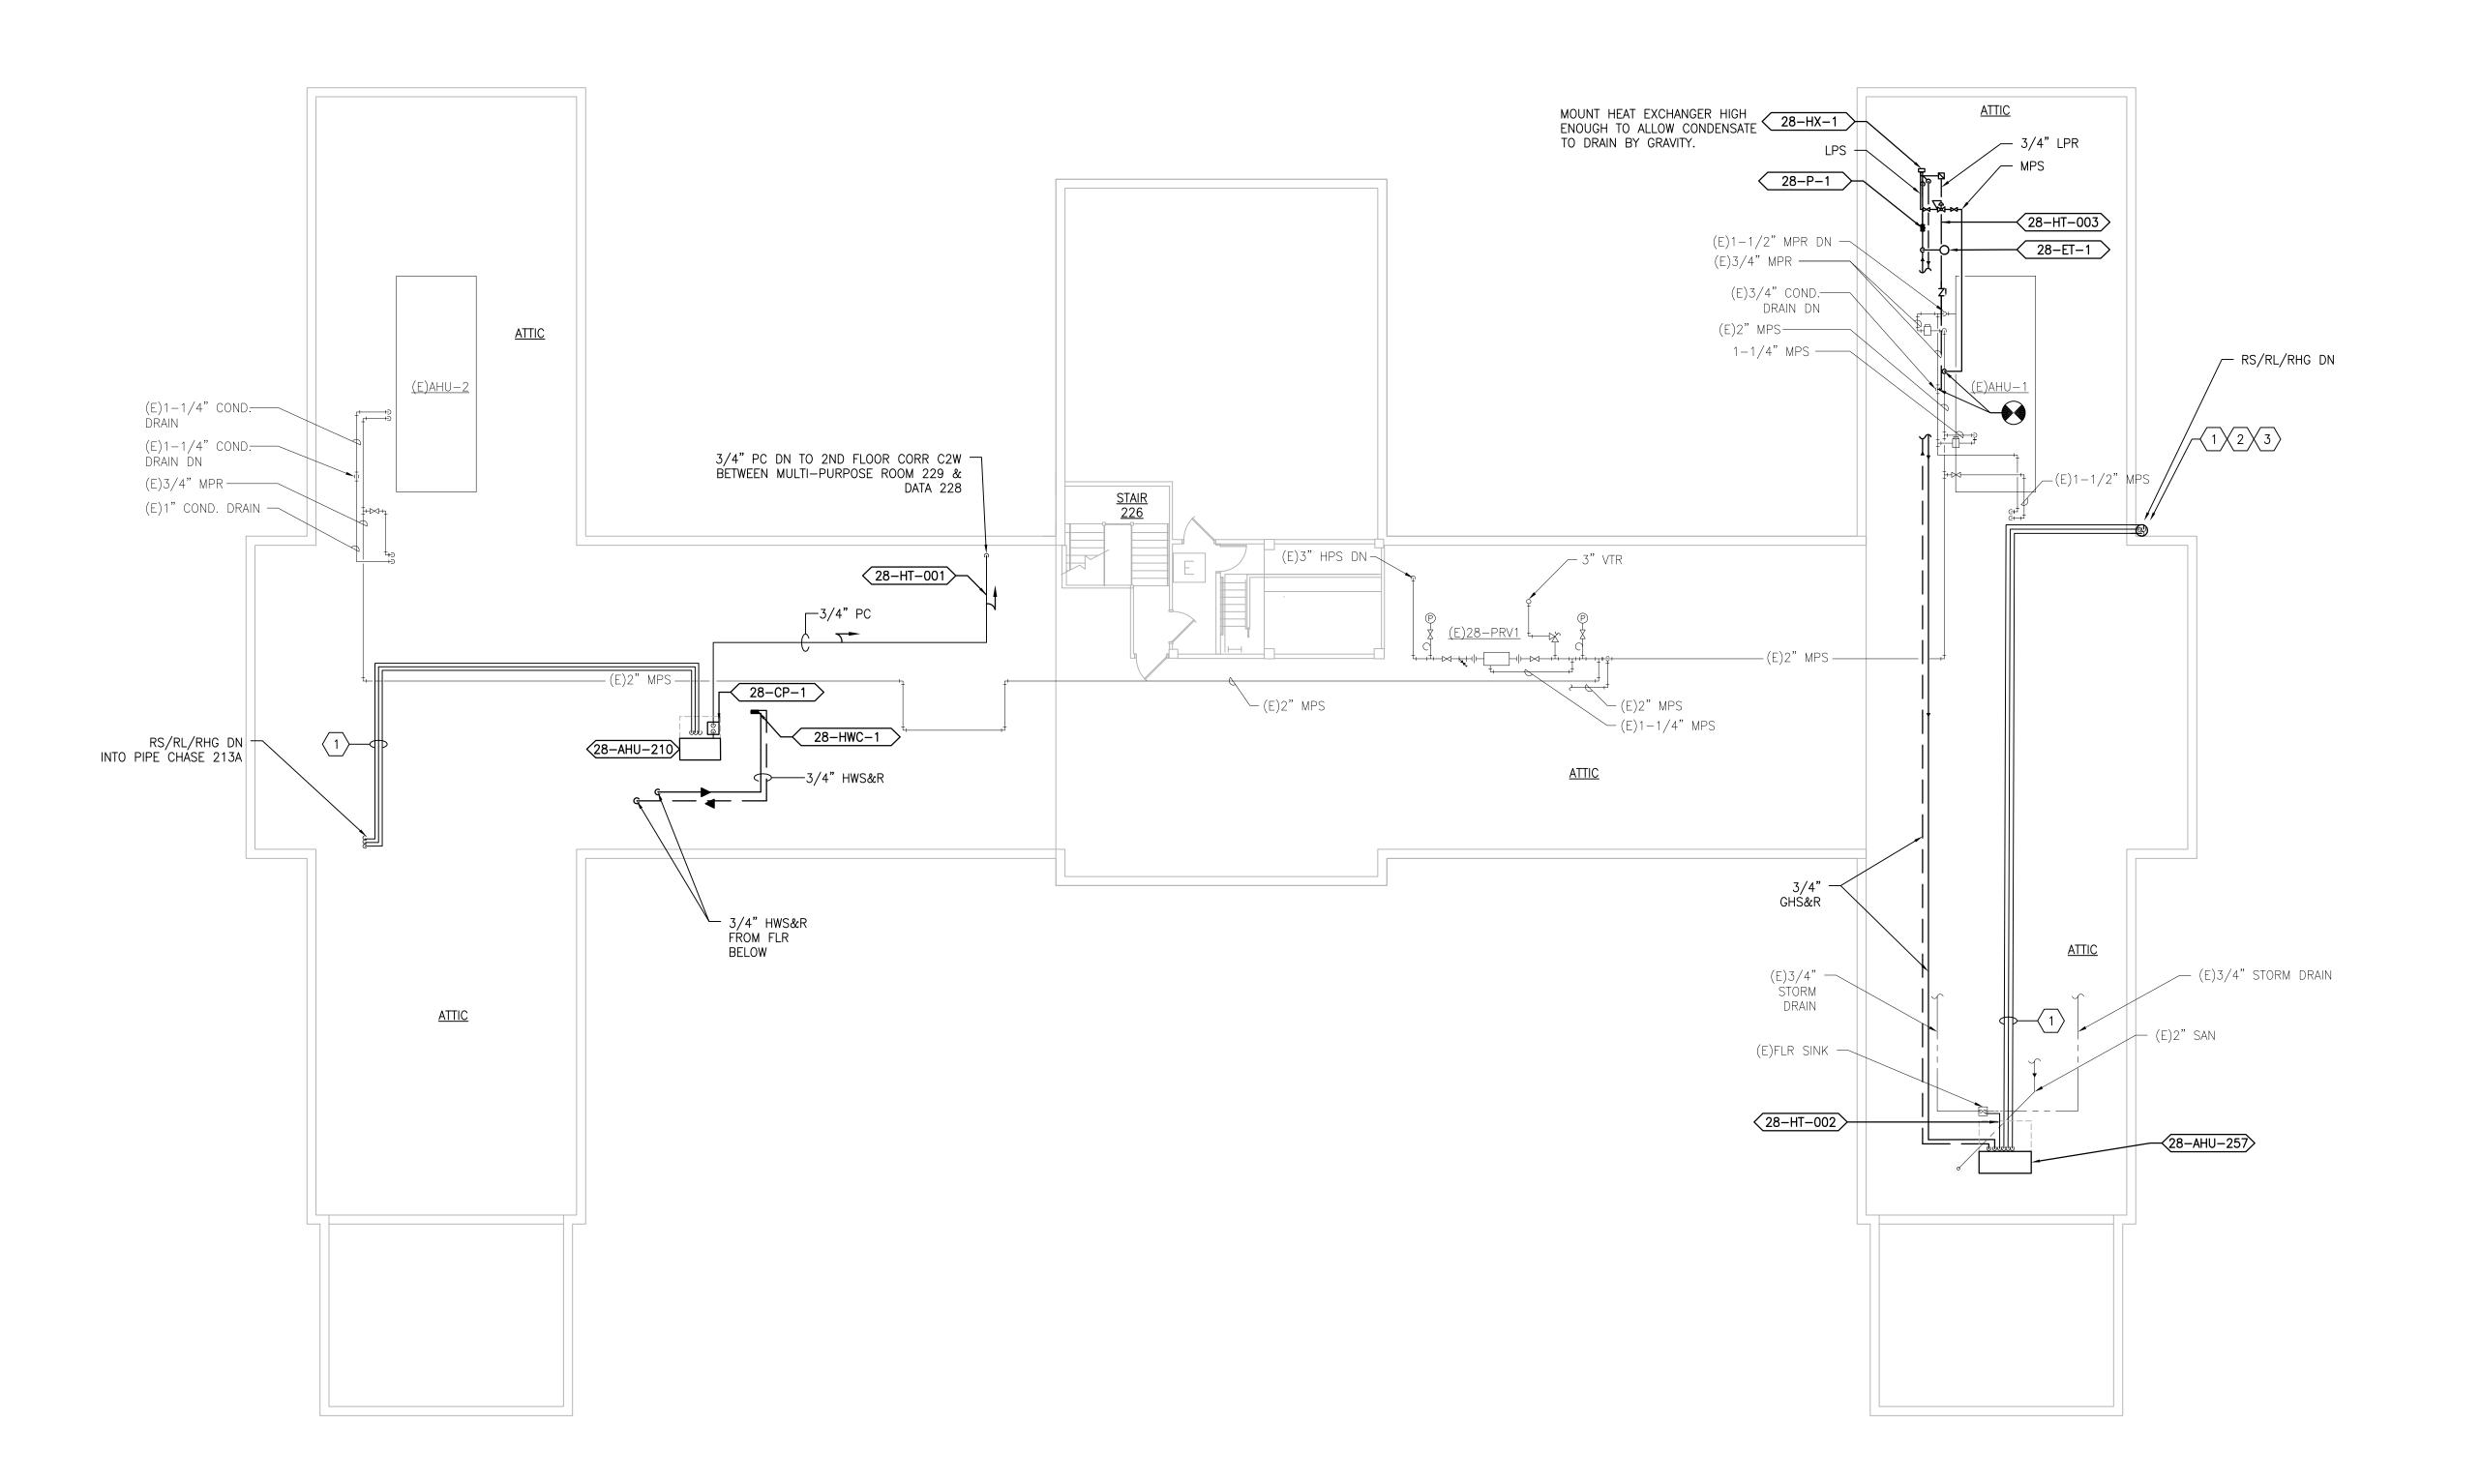

1 BUILDING 28 - ATTIC PIPING PLAN

SCALE: 3/32" = 1'-0"

VA FORM 08-6231

DESCRIPTION

DATE

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#### **SHEET KEYNOTES:**

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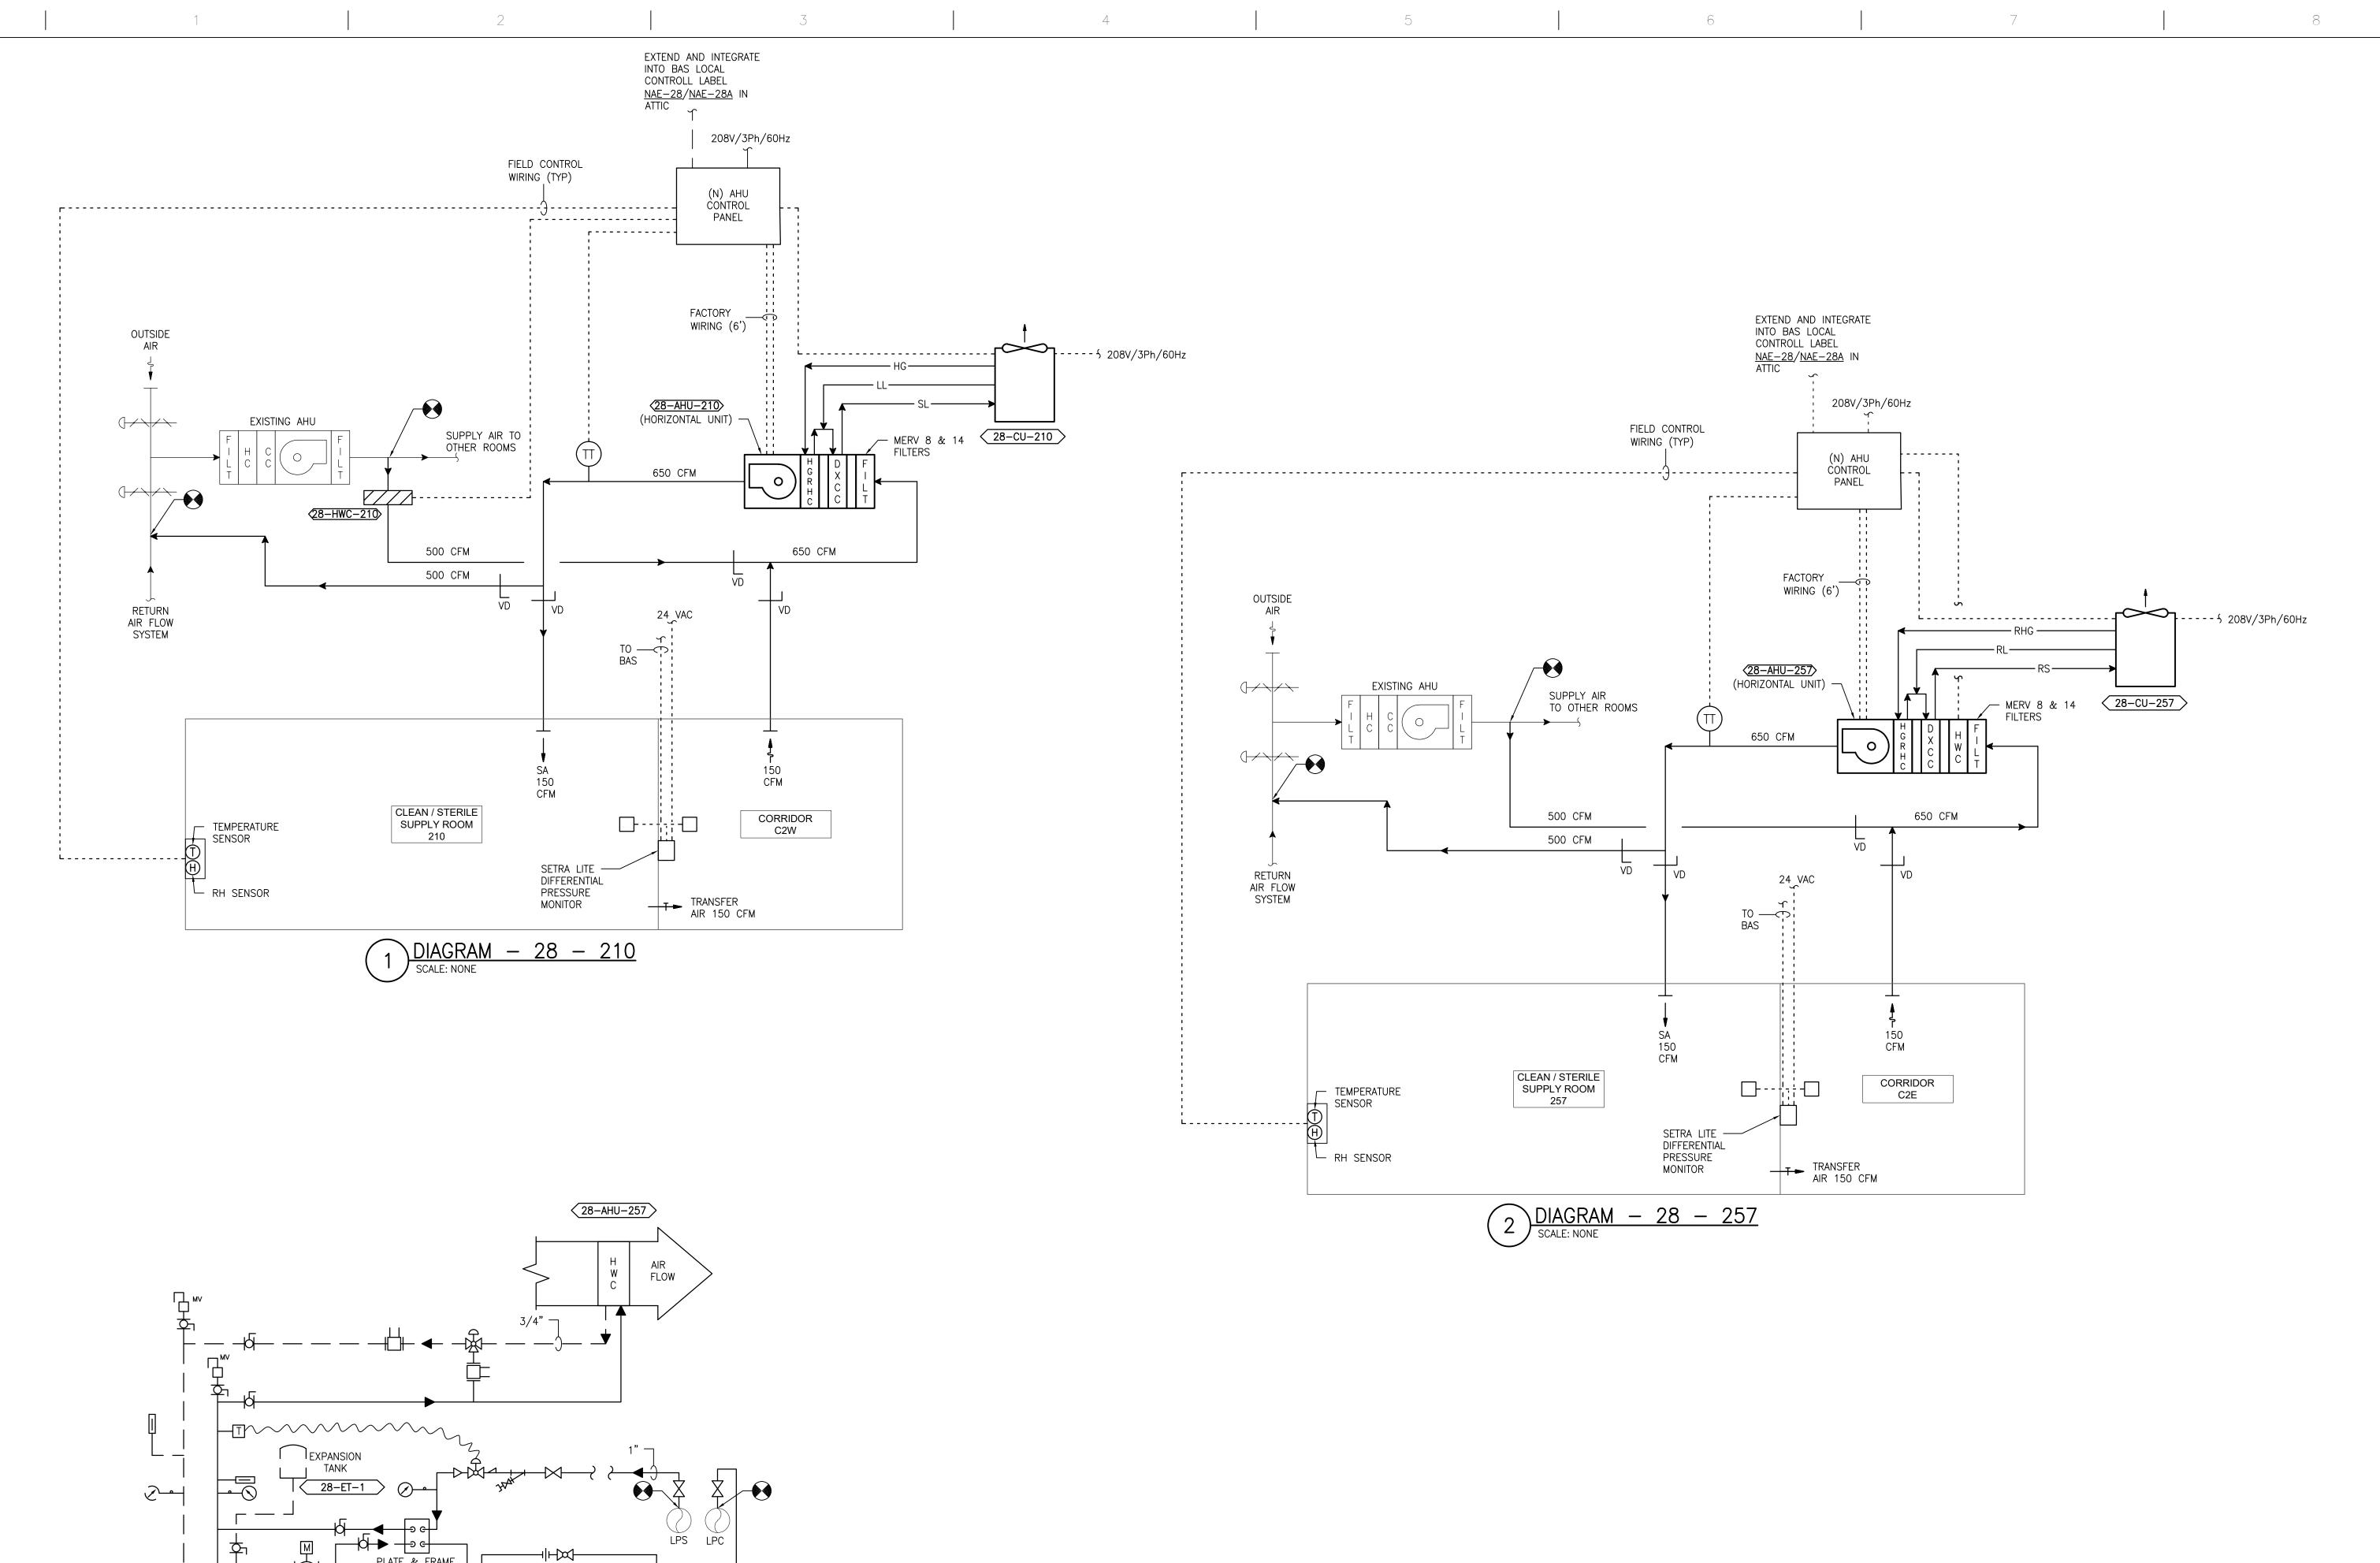
NORTH

Project Title PRINTS OF THIS DRAWING SHALL NOT BE USED FOR ANY PURPOSE WHATSOEVER WITHOUT THE SEAL AND SIGNATURE OF THE Drawing Title Project Number ENGINEER OF RECORD MILLER-REMICK LLC Office of 656-18-300 **MECHANICAL** 100% CONSTRUCTION PROFESSIONAL ENGINEER UPGRADE SPS HVAC & PROFESSIONAL ENGINEER. DOCUMENTS PIPING PLAN Miller-Remick LLC

M.E.P. & Structural Engineering

A Service Disabled Veteran Owned

Small Business Construction **ENVIRONMENTAL CONTROLS** Building Number 1, 2, 3, 28, 29, 49, 50, 51, NOT FOR CONSTRUCTION ATTIC - BUILDING 28 and Facilities MEP Engineers + Architects 111, 116 701 Forest Ave Portland, ME 04103 1173 Research Way Management Approved: Project Director Drawing Number Forest, VA 24551 1-866-267-6839 1010 KINGS HIGHWAY SOUTH CHERRY HILL, NEW JERSEY 08034 (207) 828-4511 ST. CLOUD VA MEDICAL CENTER, MN **FULLY SPRINKLERED** PHONE: (856)429-4000 28-MP131 Checked Drawn U.S. Department of Veterans Affairs FAX: (856)429-5002 MR BJS MR PROJECT NO: 0376-0011 2022-07-15



ENGINEER OF RECORD

701 Forest Ave Portland, ME 04103

(207) 828-4511

Miller-Remick LLC

M.E.P. & Structural Engineering

A Service Disabled Veteran Owned

Small Business

1010 KINGS HIGHWAY SOUTH CHERRY HILL, NEW JERSEY 08034

PHONE: (856)429-4000

MR PROJECT NO: 0376-0011

FAX: (856)429-5002

MILLER-REMICK LLC

PROFESSIONAL ENGINEER

5

Office of

Construction

and Facilities

Management

U.S. Department of Veterans Affairs

3 DIAGRAM - 28 - 257
SCALE: NONE

MEP Engineers + Architects

1173 Research Way

Forest, VA 24551 1-866-267-6839

VA FORM 08-6231

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PROFESSIONAL ENGINEER.

DESCRIPTION

DATE

#### SEQUENCE OF OPERATION

OCCUPIED MODE

THE EXISTING HVAC SYSTEMS WILL CONTINUE TO OPERATE INDEPENDENT OF THE NEW SUPPLEMENTAL SYSTEM.

SUPPLEMENTAL HVAC SYSTEM CONTROL

THE UNIT SHALL BE PROVIDED WITH A FACTORY PREWIRED AND TESTED EXTERNAL CONTROL PANEL. THE UNIT CONTROLLER SHALL BE CAPABLE OF CONTROLLING ALL FEATURES AND OPTIONS OF THE UNIT. THE CONTROLLER SHALL BE CAPABLE OF STAND-ALONE OPERATION WITH UNIT CONFIGURATION, SETPOINT ADJUSTMENT, SENSOR STATUS VIEWING, UNIT ALARM VIEWING, AND OCCUPANCY SCHEDULING WITHOUT DEPENDENCE ON THE JOHNSON CONTROLS BUILDING MANAGEMENT SYSTEM (BMS). THE CONTROLLER SHALL COMMUNICATE AND INTEGRATE WITH THE BMS SYSTEM VIA BACNET. ALL SETPOINTS SHALL BE VISIBLE AND RESETTABLE, ALL SENSOR READINGS SHALL BE VISIBLE, OCCUPIED AND UNOCCUPIED SCHEDULING SHALL BE RESETTABLE, THROUGH THE BAS SYSTEM VIA BACNET.

OCCUPIED/UNOCCUPIED OCCUPIED/UNOCCUPIED MODE SHALL BE BASED ON A COMMAND FROM THE BMS.

IN THE OCCUPIED MODE THE SUPPLY FAN SHALL RUN CONTINUOUSLY.

IF ROOM TEMPERATURE RISES ABOVE SETPOINT AS SENSED BY THE WALL MOUNTED TEMPERATURE SENSOR THE COMPRESSOR SHALL MODULATE TO MAINTAIN ROOM TEMPERATURE. <u>DEHUMIDIFYING</u>

IF ROOM RELATIVE HUMIDITY RISES ABOVE SETPOINT AS SENSED BY THE WALL MOUNTED HUMIDITY SENSOR THE SYSTEM SHALL OVERRIDE THE COOLING COIL SETPOINT AND MODULATE THE HOT GAS REHEAT COIL TO MAINTAIN ROOM TEMPERATURE AND HUMIDITY SETPOINTS. DEHUMIDIFICATION SHALL BE INITIATED ANYTIME IN THE OCCUPIED, UNOCCUPIED, COOLING OR HEATING MODE.

HEATING (ONLY PROVIDED ON SOME UNITS)

IF ROOM TEMPERATURE FALLS BELOW SETPOINT AS SENSED BY THE WALL MOUNTED TEMPERATURE SENSOR THE HEATING COIL SHALL MODULATE TO MAINTAIN ROOM TEMPERATURE. UNOCCUPIED MODE


IN THE UNOCCUPIED MODE THE SUPPLY FAN SHALL RUN CONTINUOUSLY. IN THE UNOCCUPIED MODE THE UNIT SHALL OPERATE IF THE ROOM TEMPERATURE OR RELATIVE

HUMIDITY LIMITS ARE REACHED.


ON A CALL FOR COOLING, DEHUMIDIFYING, OR HEATING THE CONTROL SHALL BE THE SAME AS IN THE OCCUPIED MODE. ROOM PRESSURE MONITOR

THE ROOM PRESSURE MONITOR SETRA LITE SHALL MONITOR AND ALARM THE DIFFERENTIAL PRESSURE BETWEEN THE CLEAN / STERILE SATELLITE STORAGE ROOM AND THE ADJACENT ROOM LOCALLY AND AT THE BAS.

Project Title Drawing Title Project Number 656-18-300 **MECHANICAL** 100% CONSTRUCTION UPGRADE SPS HVAC & DOCUMENTS AIRFLOW CONTROL & PIPING DIAGRAM **ENVIRONMENTAL CONTROLS** Building Number 1, 2, 3, 28, 29, 49, 50, 51, NOT FOR CONSTRUCTION **BUILDING 28** 111, 116 Approved: Project Director Drawing Number ST. CLOUD VA MEDICAL CENTER, MN **FULLY SPRINKLERED** Checked 28-M-821 Drawn MR PNL 2022-07-15

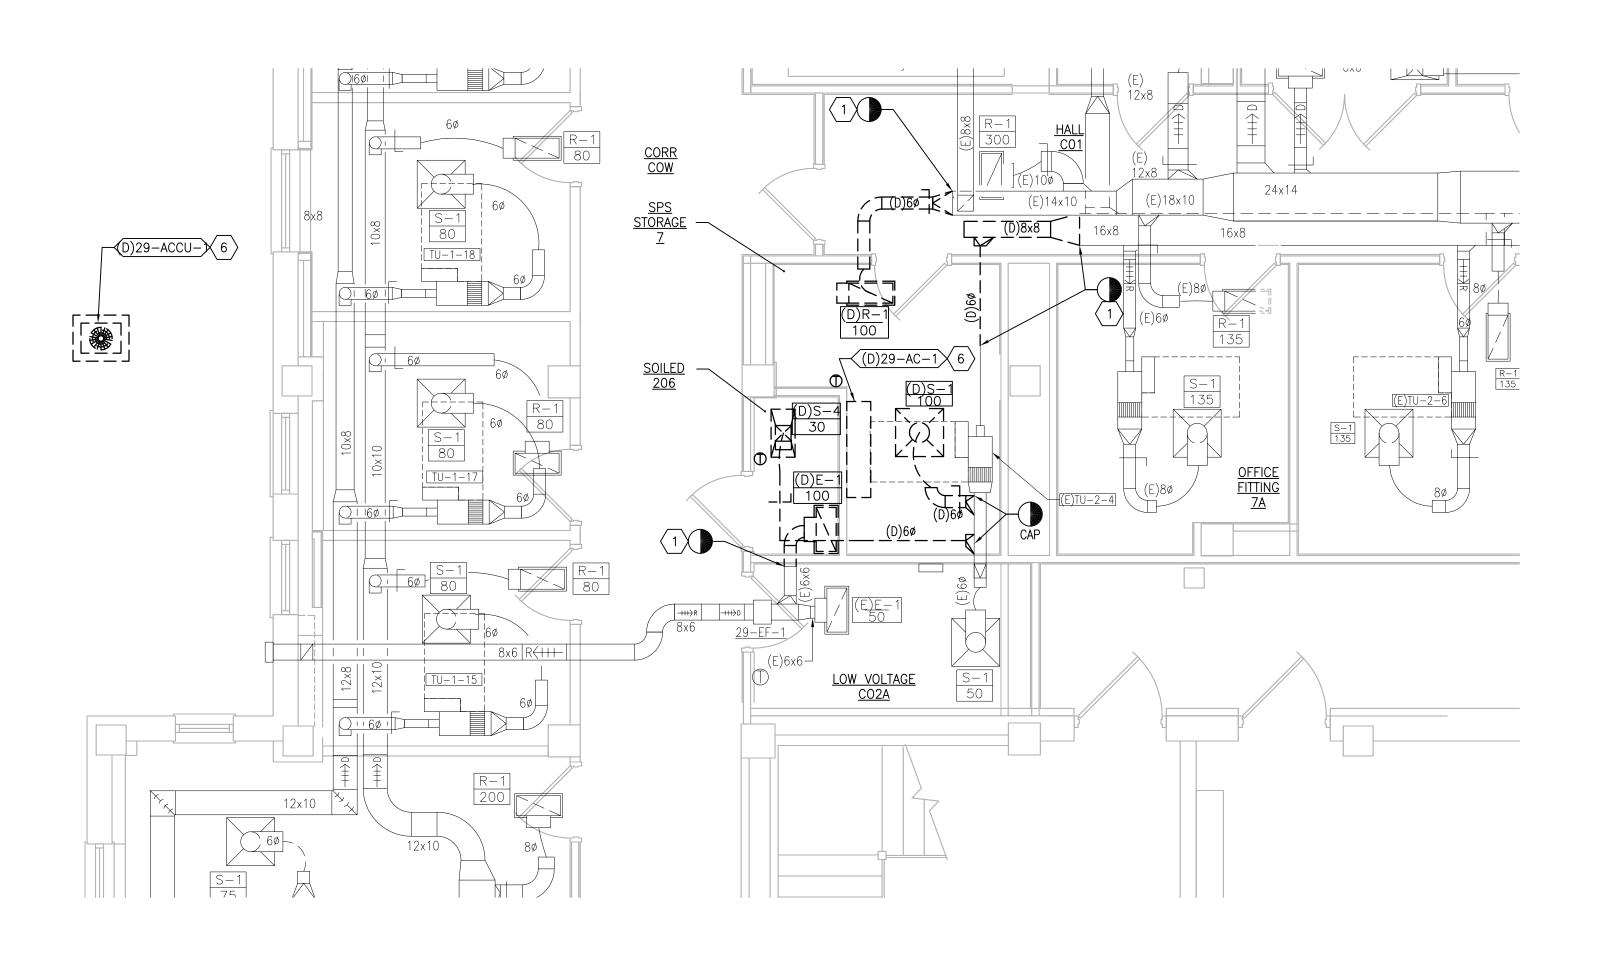


1 BUILDING 29 BASEMENT ROOM 7 - DEMOLITION
SCALE: 1/4" = 1'-0"

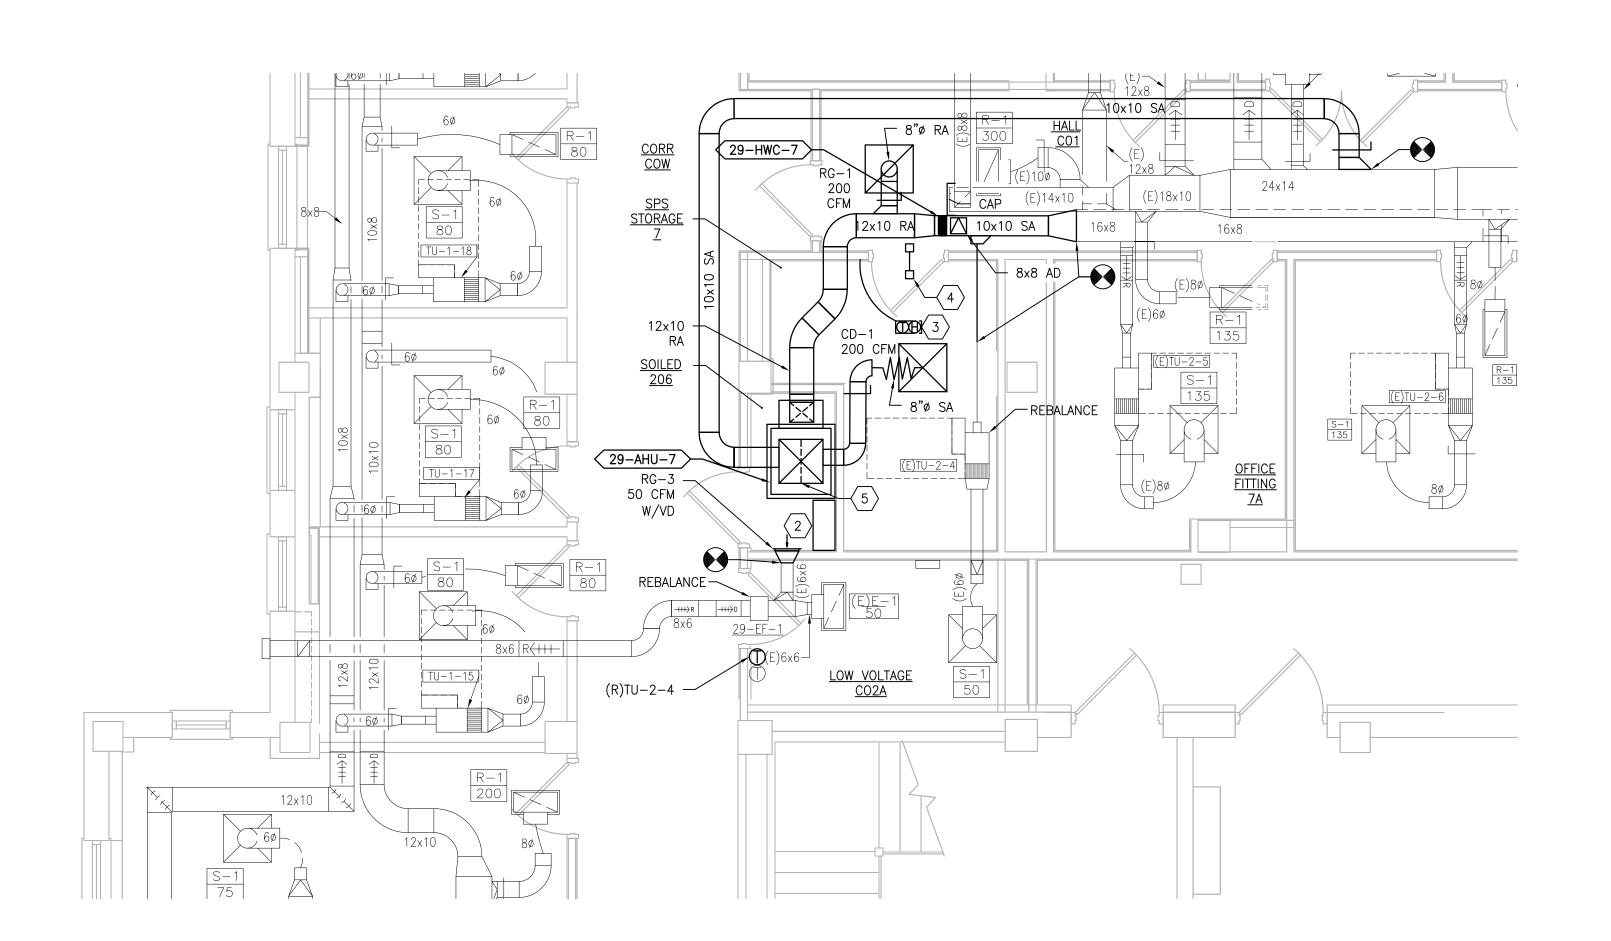

2 BUILDING 29 BASEMENT 7 - NEW WORK

SCALE: 1/4" = 1'-0"

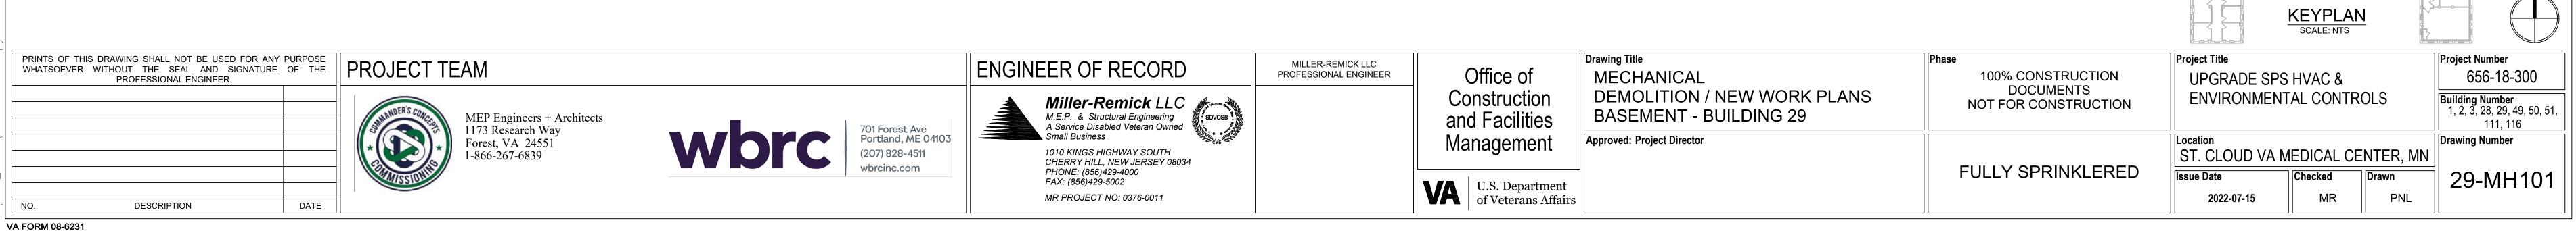

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    7. AVOID ALL CEILING OR WALL MOUNTED DEVICES (I.E. SIGNAGE, LIGHT FIXTURE, NURSE CALL) WHEN LOCATING ICRA BARRIERS. WHEN EXISTING DEVICE(S) CANNOT BE AVOIDED, TEMPORARILY RELOCATE THE DEVICE(S) AND REINSTALL AFTER WORK IS COMPLETED AS
  - 8. REMOVE AND REPLACE EXISTING CEILINGS REFER TO THE ARCHITECTURAL DRAWING FOR ADDITIONAL INFORMATION.
  - 9. TAKE PREDEMOLITION READINGS OF ALL ROOM AIR INLETS AND OUTLETS OF ANY SYSTEM THE WILL BE MODIFIED AND SUBMIT TO THE VA AND ENGINEER FOR RECORD PRIOR TO STARTING ANY NEW WORK. BALANCE THE NEW SYSTEMS AND REBALANCE THE EXISTING ASSOCIATED AHU SYSTEM TO THE NEW AIR QUANTITIES. AFTER THE NEW WORK IS COMPLETE REBALANCE THE EXISTING SYSTEM, AS REQUIRED, AND MEASURE ALL ROOM AIR INLETS AND OUTLETS TO VERIFY THAT THE PREDEMOLITION AIRFLOWS HAVE BEEN MAINTAINED. SUBMIT FOR APPROVAL. REFERENCE SPECIFICATIONS FOR TESTING AND BALANCING REQUIREMENTS.
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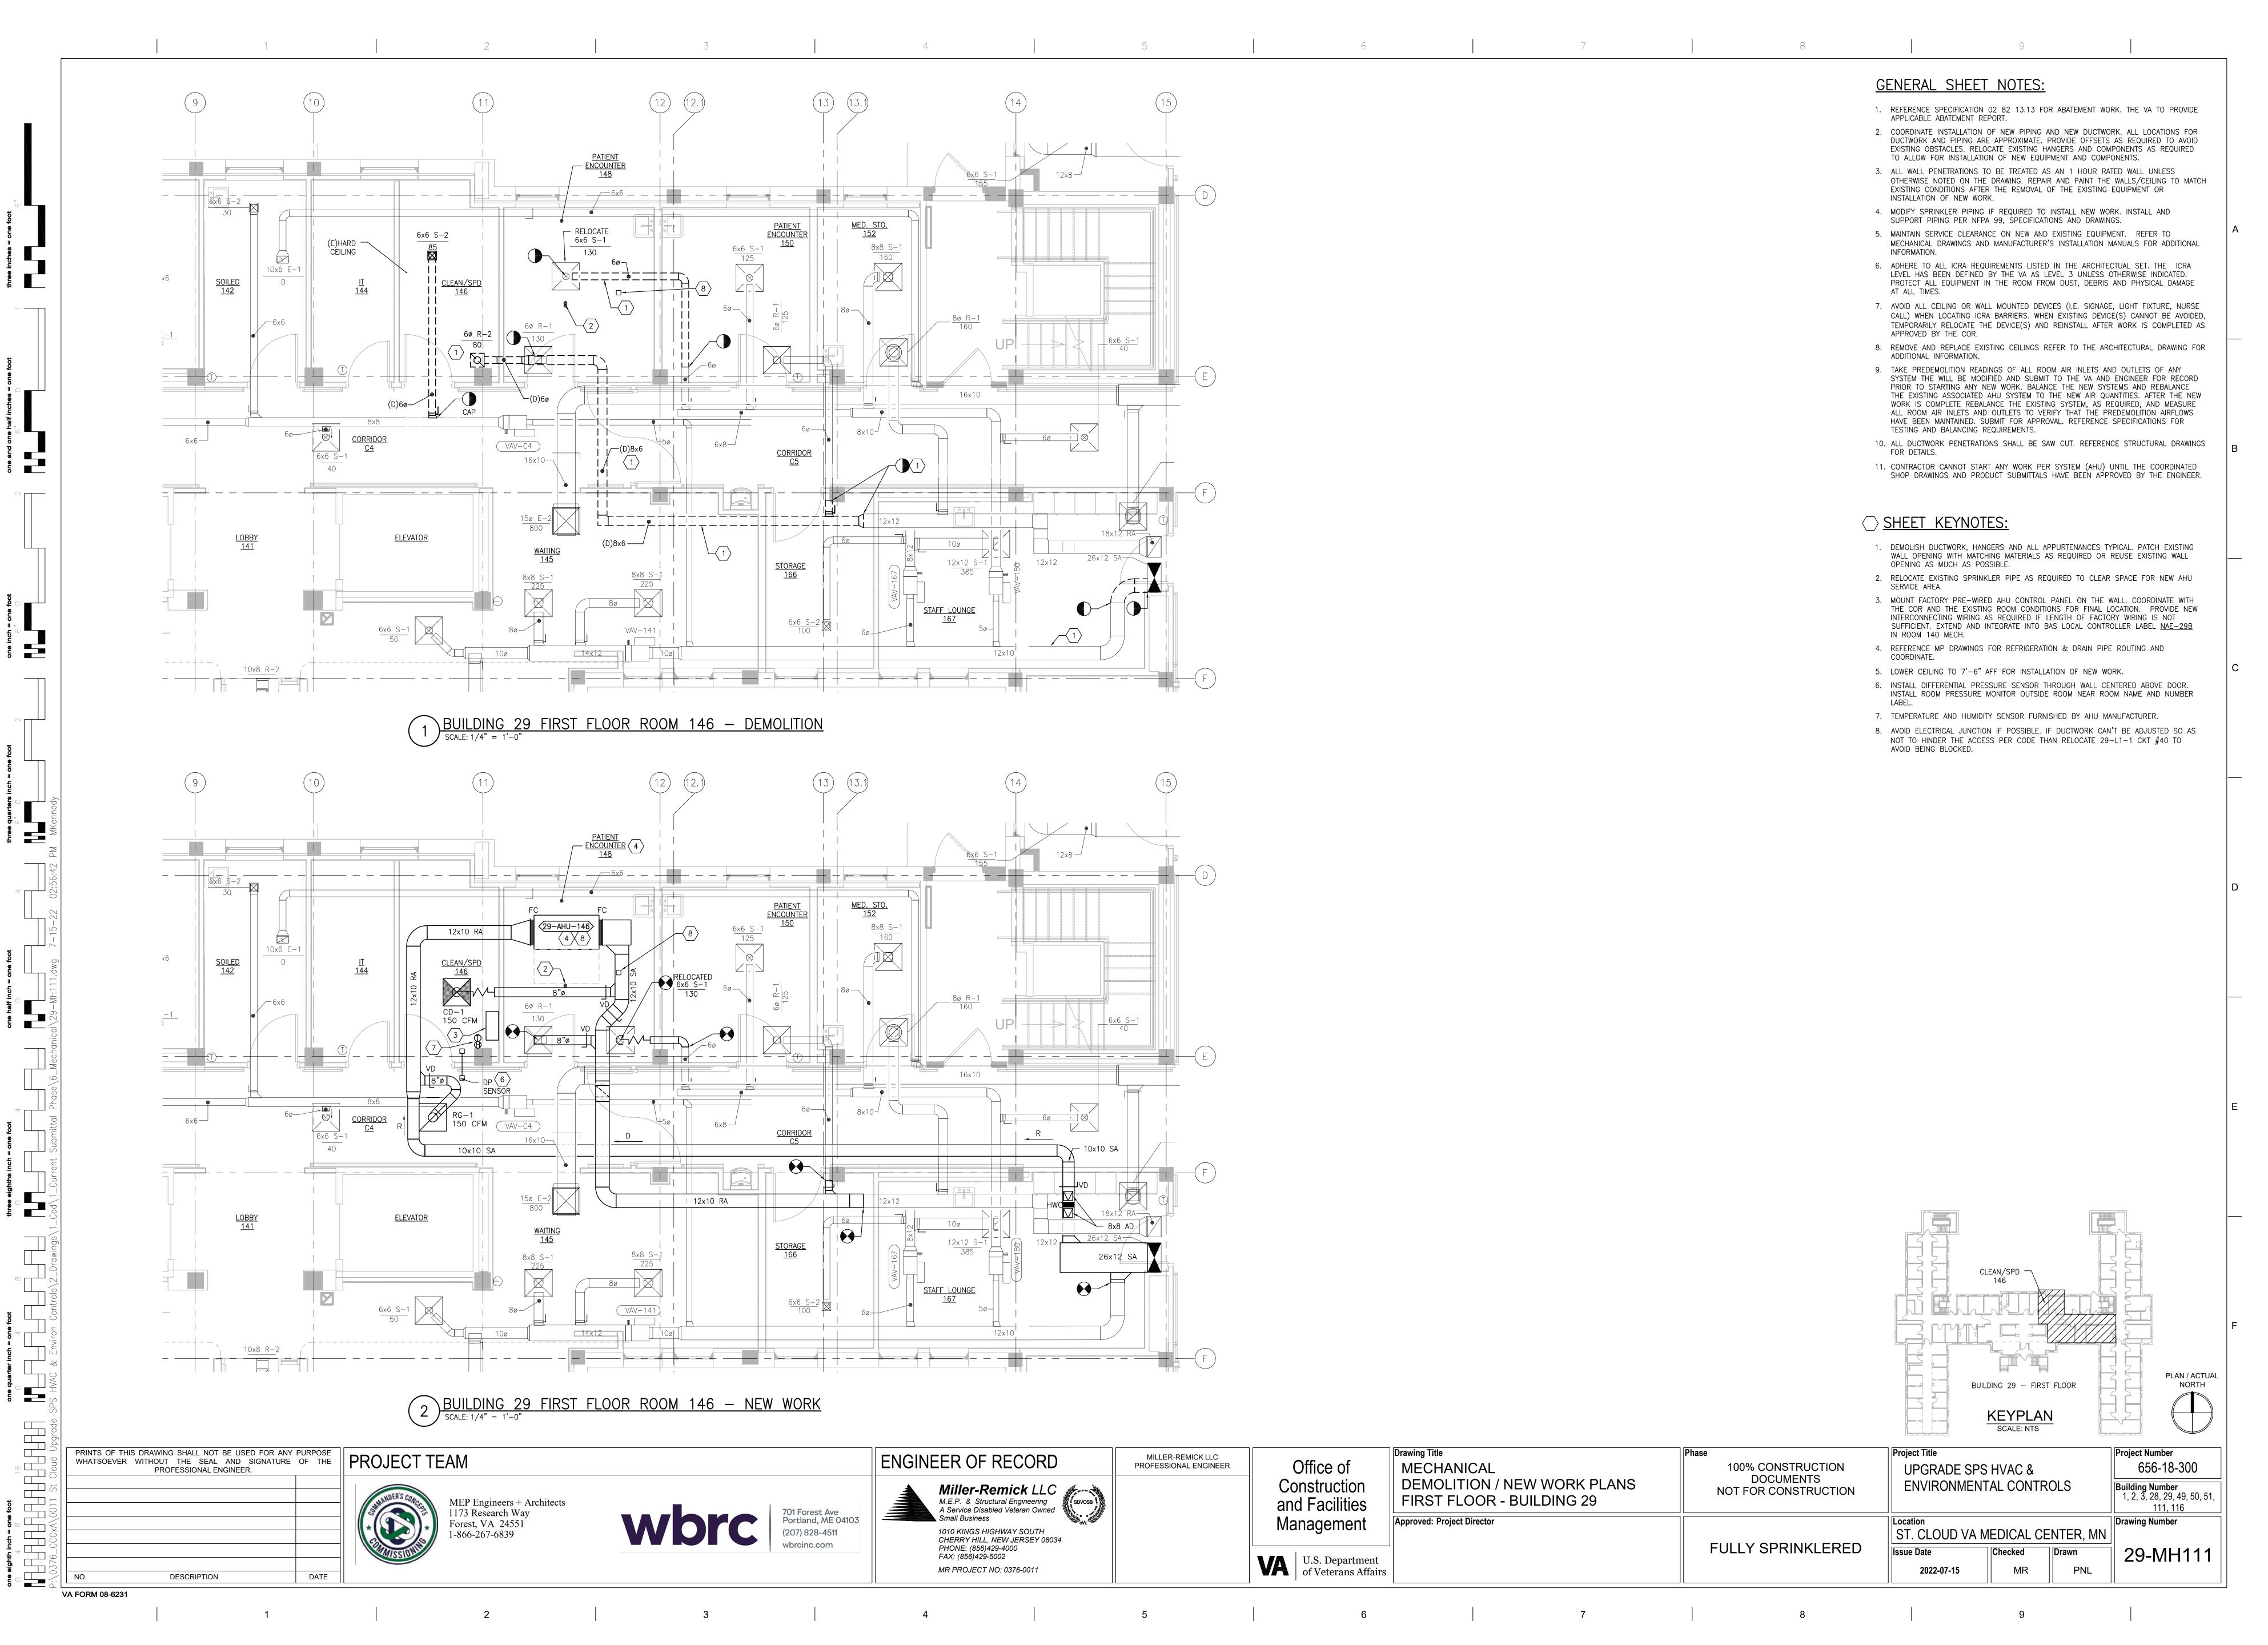
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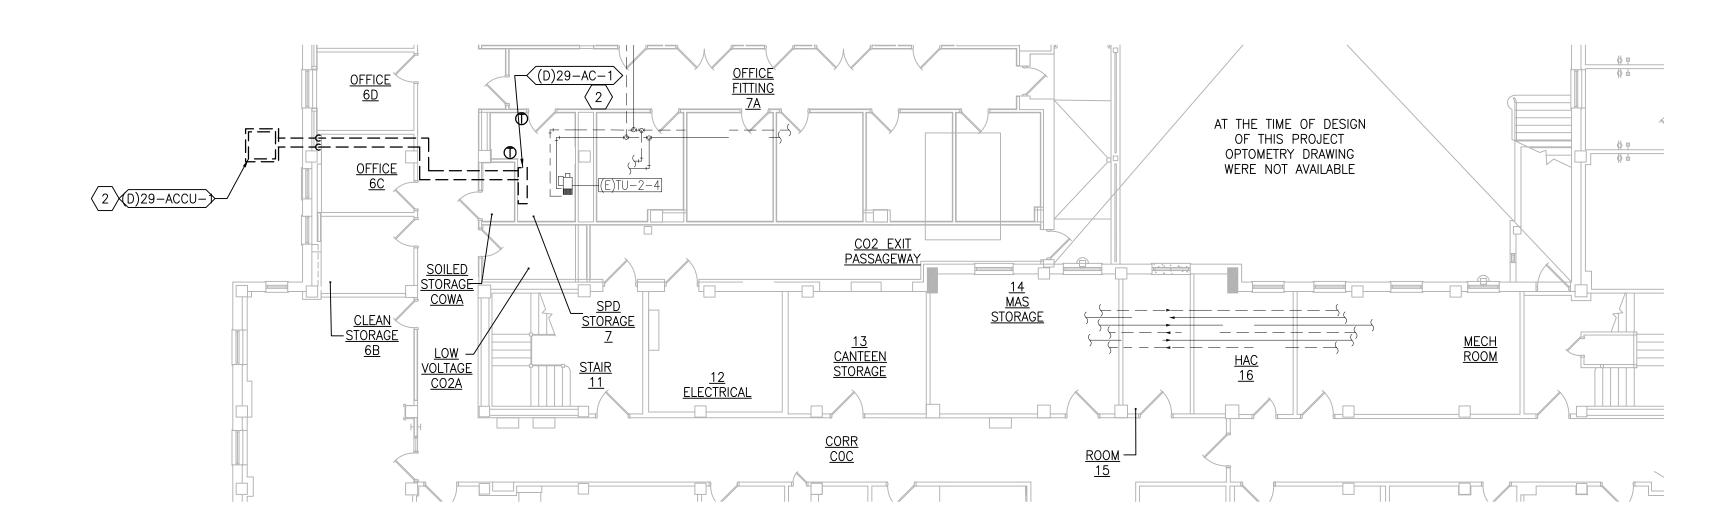
APPROVED BY THE COR.

- 1. DEMOLISH DUCTWORK, HANGERS AND ALL APPURTENANCES TYPICAL. PATCH EXISTING WALL OPENING WITH MATCHING MATERIALS AS REQUIRED OR REUSE EXISTING WALL OPENING AS MUCH AS POSSIBLE.
- 2. MOUNT FACTORY PREWIRED AHU CONTROL PANEL ON THE WALL. COORDINATE WITH THE COR AND THE EXISTING ROOM CONDITIONS FOR FINAL LOCATION. PROVIDE NEW INTERCONNECTING WIRING AS REQUIRED IF LENGTH OF FACTORY WIRING IS NOT SUFFICIENT. EXTEND AND INTEGRATE INTO BAS LOCAL CONTROLLER LABEL NAE—29A IN ROOM 20 MECH.
- 3. TEMPERATURE AND HUMIDITY SENSOR FURNISHED BY AHU MANUFACTURER.
- 4. INSTALL DIFFERENTIAL PRESSURE SENSOR THROUGH WALL, CENTERED ABOVE DOOR. INSTALL ROOM PRESSURE MONITOR OUTSIDE ROOM NEAR ROOM NAME AND NUMBER
- DISCHARGE AIR TEMPERATURE SENSOR FURNISHED BY AHU MANUFACTURER.
   REMOVE EXISTING WALL MOUNT AIR CONDITIONER (29-AC-1) AND ASSOCIATED CONDENSING UNIT (29-ACCU-1) AND TURN OVER TO VA. DEMOLISH ALL APPURTENANCES INCLUDING PIPING, WIRING HANGERS ETC. PATCH AND PAINT WALL TO MATCH EXISTING CONDITIONS.


BUILDING 29 - BASEMENT

PLAN / ACTUAL NORTH





# 1 BUILDING 29 - BASEMENT-DEMOLITION PIPING PLAN

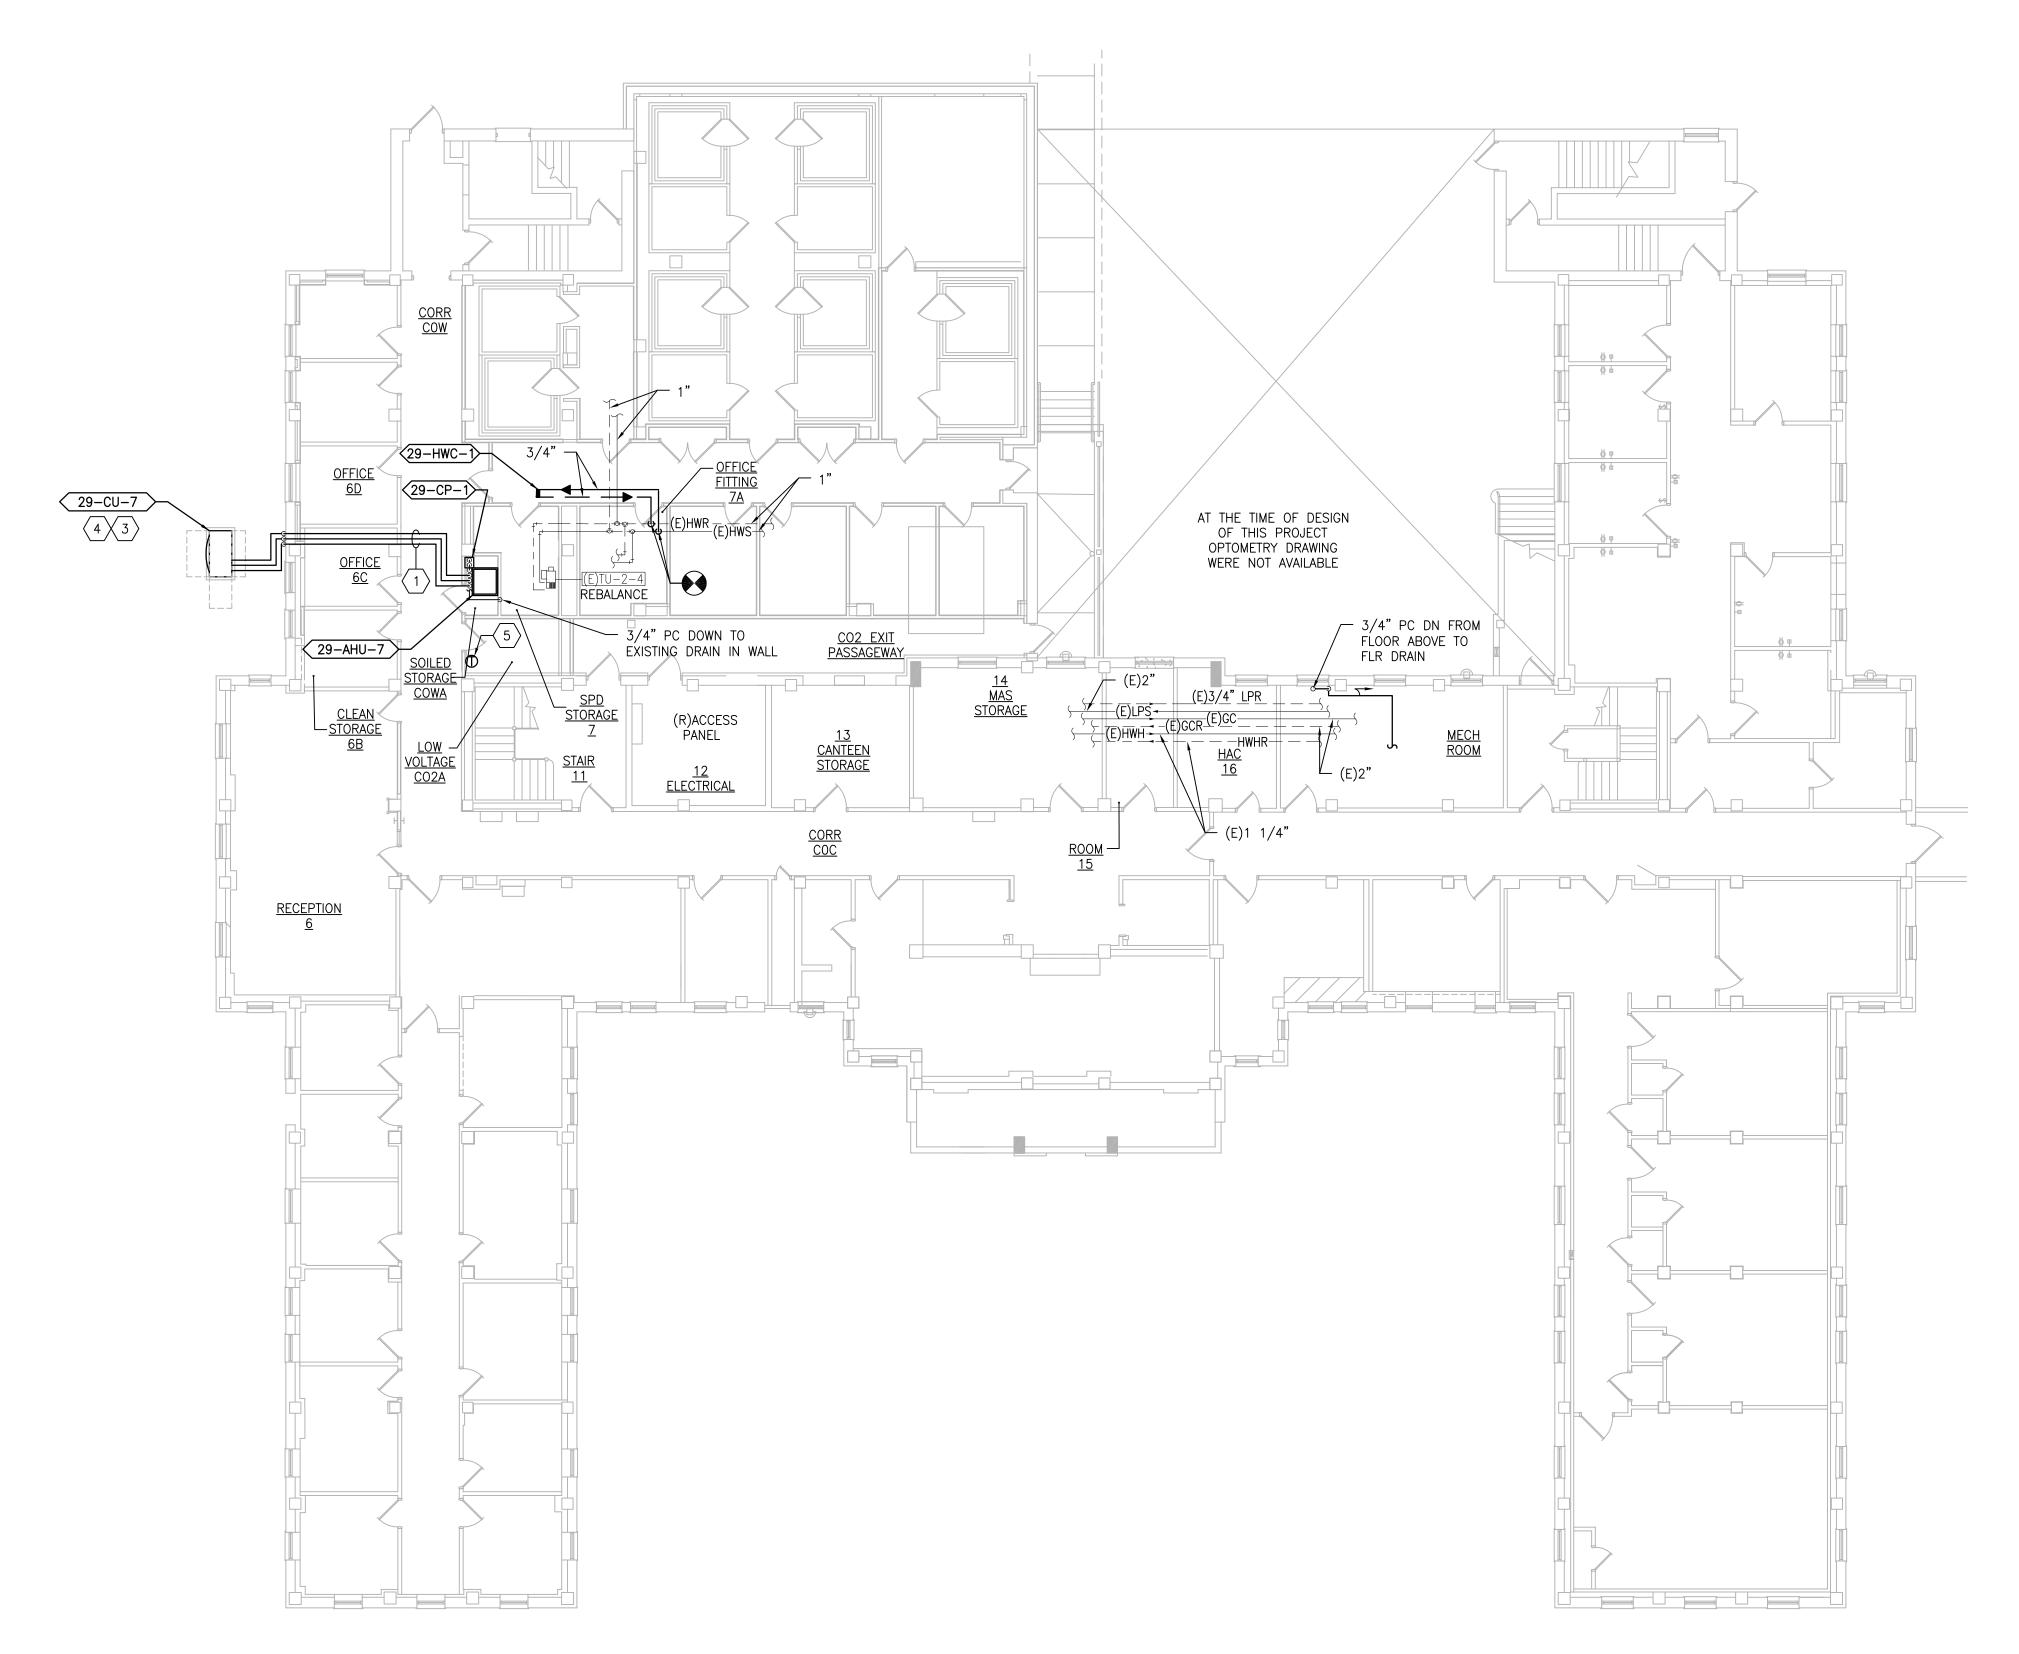

2 BUILDING 29 - BASEMENT NEW WORK PIPING PLAN

SCALE: 3/32" = 1'-0"



- 1. REFERENCE SPECIFICATION 02 82 13.13 FOR ABATEMENT WORK. THE VA TO PROVIDE APPLICABLE ABATEMENT REPORT.
- 2. COORDINATE INSTALLATION OF NEW PIPING AND NEW DUCTWORK. ALL LOCATIONS FOR DUCTWORK AND PIPING ARE APPROXIMATE. PROVIDE OFFSETS AS REQUIRED TO AVOID EXISTING OBSTACLES. RELOCATE EXISTING HANGERS AND COMPONENTS AS REQUIRED
- TO ALLOW FOR INSTALLATION OF NEW EQUIPMENT AND COMPONENTS.

  3. ALL WALL PENETRATIONS TO BE TREATED AS AN 1 HOUR RATED WALL UNLESS OTHERWISE NOTED ON THE DRAWING. REPAIR AND PAINT THE WALLS/CEILING TO MATCH EXISTING CONDITIONS AFTER THE REMOVAL OF THE EXISTING EQUIPMENT OR INSTALLATION OF NEW WORK.
  - 4. MODIFY SPRINKLER PIPING IF REQUIRED TO INSTALL NEW WORK. INSTALL AND SUPPORT PIPING PER NFPA 99, SPECIFICATIONS AND DRAWINGS.
- 5. MAINTAIN SERVICE CLEARANCE ON NEW AND EXISTING EQUIPMENT. REFER TO MECHANICAL DRAWINGS AND MANUFACTURER'S INSTALLATION MANUALS FOR ADDITIONAL INFORMATION
- 6. ADHERE TO ALL ICRA REQUIREMENTS LISTED IN THE ARCHITECTURAL SET. THE ICRA LEVEL HAS BEEN DEFINED BY THE VA AS LEVEL 3 UNLESS OTHERWISE INDICATED. PROTECT ALL EQUIPMENT IN THE ROOM FROM DUST, DEBRIS AND PHYSICAL DAMAGE
- AT ALL TIMES.

  7. AVOID ALL CEILING OR WALL MOUNTED DEVICES (I.E. SIGNAGE, LIGHT FIXTURE, NURSE CALL) WHEN LOCATING ICRA BARRIERS. WHEN EXISTING DEVICE(S) CANNOT BE
- COMPLETED AS APPROVED BY THE COR.

  8. REMOVE AND REPLACE EXISTING CEILINGS REFER TO THE ARCHITECTURAL DRAWING FOR

AVOIDED, TEMPORARILY RELOCATE THE DEVICE(S) AND REINSTALL AFTER WORK IS

- 9. NOT ALL PIPING COMPONENTS ARE SHOWN. REFER TO DETAILS AND SPECIFICATIONS FOR ALL REQUIRED VALVES, UNIONS, GAUGES, STRAINERS ETC.
- 10. ALL PIPING PENETRATIONS SHALL BE CORE DRILLED. REFERENCE STRUCTURAL DRAWINGS FOR DETAILS.
- 11. INSTALLING CONTRACTOR IS RESPONSIBLE FOR PROVIDING AND INSTALLING THE REFRIGERATION PIPING IN ACCORDANCE WITH THE MANUFACTURER'S GUIDELINES. THE CONTRACTOR IS TO PROVIDE DETAILED PIPING LAYOUT TO THE MANUFACTURER FOR PIPE SIZING AND OTHER REQUIREMENTS. FINAL SHOP DRAWING APPROVAL IS BY THE ENGINEER. THE INSTALLING CONTRACTOR IS RESPONSIBLE FOR LEAK CHECKS, EVACUATION AND INITIAL REFRIGERATION CHARGE. THE INSTALLING CONTRACTOR SHALL PROVIDE EXTRA REFRIGERANT TO THE FACTORY START—UP TECHNICIAN FOR FINAL REFRIGERANT CHARGE. THE INSTALLING CONTRACTOR IS RESPONSIBLE FOR WIRING AND COMMUNICATIONS BETWEEN AHU'S AND CONDENSING UNITS.
- 12. CONTRACTOR CANNOT START ANY WORK PER SYSTEM (AHU) UNTIL THE COORDINATED SHOP DRAWINGS AND PRODUCT SUBMITTALS HAVE BEEN APPROVED BY THE ENGINEER.

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ADDITIONAL INFORMATION.

- 1. MINIMUM PIPE SIZES FOR UP TO 50 EQUIVALENT FT. INCREASE PIPE SIZES AS REQUIRED TO ACCOMMODATE THE ACTUAL ROUTING:
- SUCTION LINE 5/8" Ø
- LIQUID LINE 3/8" Ø
- HOT GAS REHEAT 3/8" Ø
- PUMPED CONDENSATE 3/4" Ø
- PUMPED CONDENSATE 3/4 Ø

  MINIMUM PIPE SIZES FOR OVER 60 EQUIVALENT FT. INCREASE PIPE SIZES AS
- REQUIRED TO ACCOMMODATE THE ACTUAL ROUTING:
- SUCTION LINE 3/4" ØLIQUID LINE 1/2" Ø
- HOT GAS REHEAT 1/2" ø
- PLIMPED CONDENSATE 3/4" (
- PUMPED CONDENSATE 3/4" Ø

  NOTHER AND MODIFIED STREET
- INSTALL AND INSULATE PIPING ACCORDING TO SPECIFICATIONS AND AHU MANUFACTURER RECOMMENDATIONS. VERIFY PIPE SIZING WITH AHU MANUFACTURER. PIPING MUST BE SIZED TO MEET THE ACTUAL INSTALLATION CONDITIONS. INSTALL SUCTION LINE ACCUMULATOR AND 1/8" CAPILLARY TUBING FOR PURGE CIRCUIT. SEE AHU MANUFACTURER'S INSTALLATION INSTRUCTIONS.
- 2. REMOVE EXISTING WALL MOUNT AIR CONDITIONER (29-AC-1) AND ASSOCIATED CONDENSING UNIT (29-ACCU-1) AND TURN OVER TO VA. DEMOLISH ALL APPURTENANCES INCLUDING PIPING, WIRING HANGERS ETC. PATCH AND PAINT WALL TO MATCH EXISTING CONDITIONS.
- EXTERIOR PIPING STRUCTURAL COVER. REFER TO STRUCTURAL DRAWINGS FOR DUNNAGE AND PIPE COVER DETAILS.

3. CONDENSING UNIT IS SUPPORTED BY DUNNAGE 3'-0" ABOVE GRADE. PROVIDE

- 4. MAINTAIN 6'-0" MINIMUM IN ALL DIRECTIONS FROM THE BUILDING TO PROTECT AGAINST FALLING SNOW AND ICE.
- 5. RELOCATE EXISTING THERMOSTAT FROM ROOM 7 TO ROOM CO2A. EXTEND CONTROL WIRING AS REQUIRED.
- 6. ADJUST EXISTING SPRINKLER HEAD AND SPRINKLER PIPING TO ALLOW INSTALLATION OF NEW WORK. ADJUST TWO EXISTING 3/4" PIPES TO ALLOW INSTALLATION OF NEW WORK
- 7. REMOVE ABANDONED PIPES TO FACILITATE INSTALLATION OF NEW WORK.

PLAN / ACTUAL NORTH


PRINTS OF THIS DRAWING SHALL NOT BE USED FOR ANY PURPOSE WHATSOEVER WITHOUT THE SEAL AND SIGNATURE OF THE Drawing Title Project Title Project Number PROJECT TEAM ENGINEER OF RECORD MILLER-REMICK LLC Office of 656-18-300 **MECHANICAL** PROFESSIONAL ENGINEER 100% CONSTRUCTION UPGRADE SPS HVAC & PROFESSIONAL ENGINEER. DOCUMENTS PIPING PLANS Miller-Remick LLC


M.E.P. & Structural Engineering
A Service Disabled Veteran Owned
Small Business Construction **ENVIRONMENTAL CONTROLS** Building Number 1, 2, 3, 28, 29, 49, 50, 51, NOT FOR CONSTRUCTION BASEMENT - BUILDING 29 and Facilities MEP Engineers + Architects 111, 116 1173 Research Way 701 Forest Ave Portland, ME 04103 Management Approved: Project Director Drawing Number Forest, VA 24551 1-866-267-6839 1010 KINGS HIGHWAY SOUTH CHERRY HILL, NEW JERSEY 08034 (207) 828-4511 ST. CLOUD VA MEDICAL CENTER, MN **FULLY SPRINKLERED** PHONE: (856)429-4000 Checked 29-MP101 Drawn FAX: (856)429-5002 U.S. Department of Veterans Affairs MR BJS MR PROJECT NO: 0376-0011 2022-07-15 DESCRIPTION DATE

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Controls\2\_Drawings\1\_Cad\1\_Curr

VA FORM 08-6231



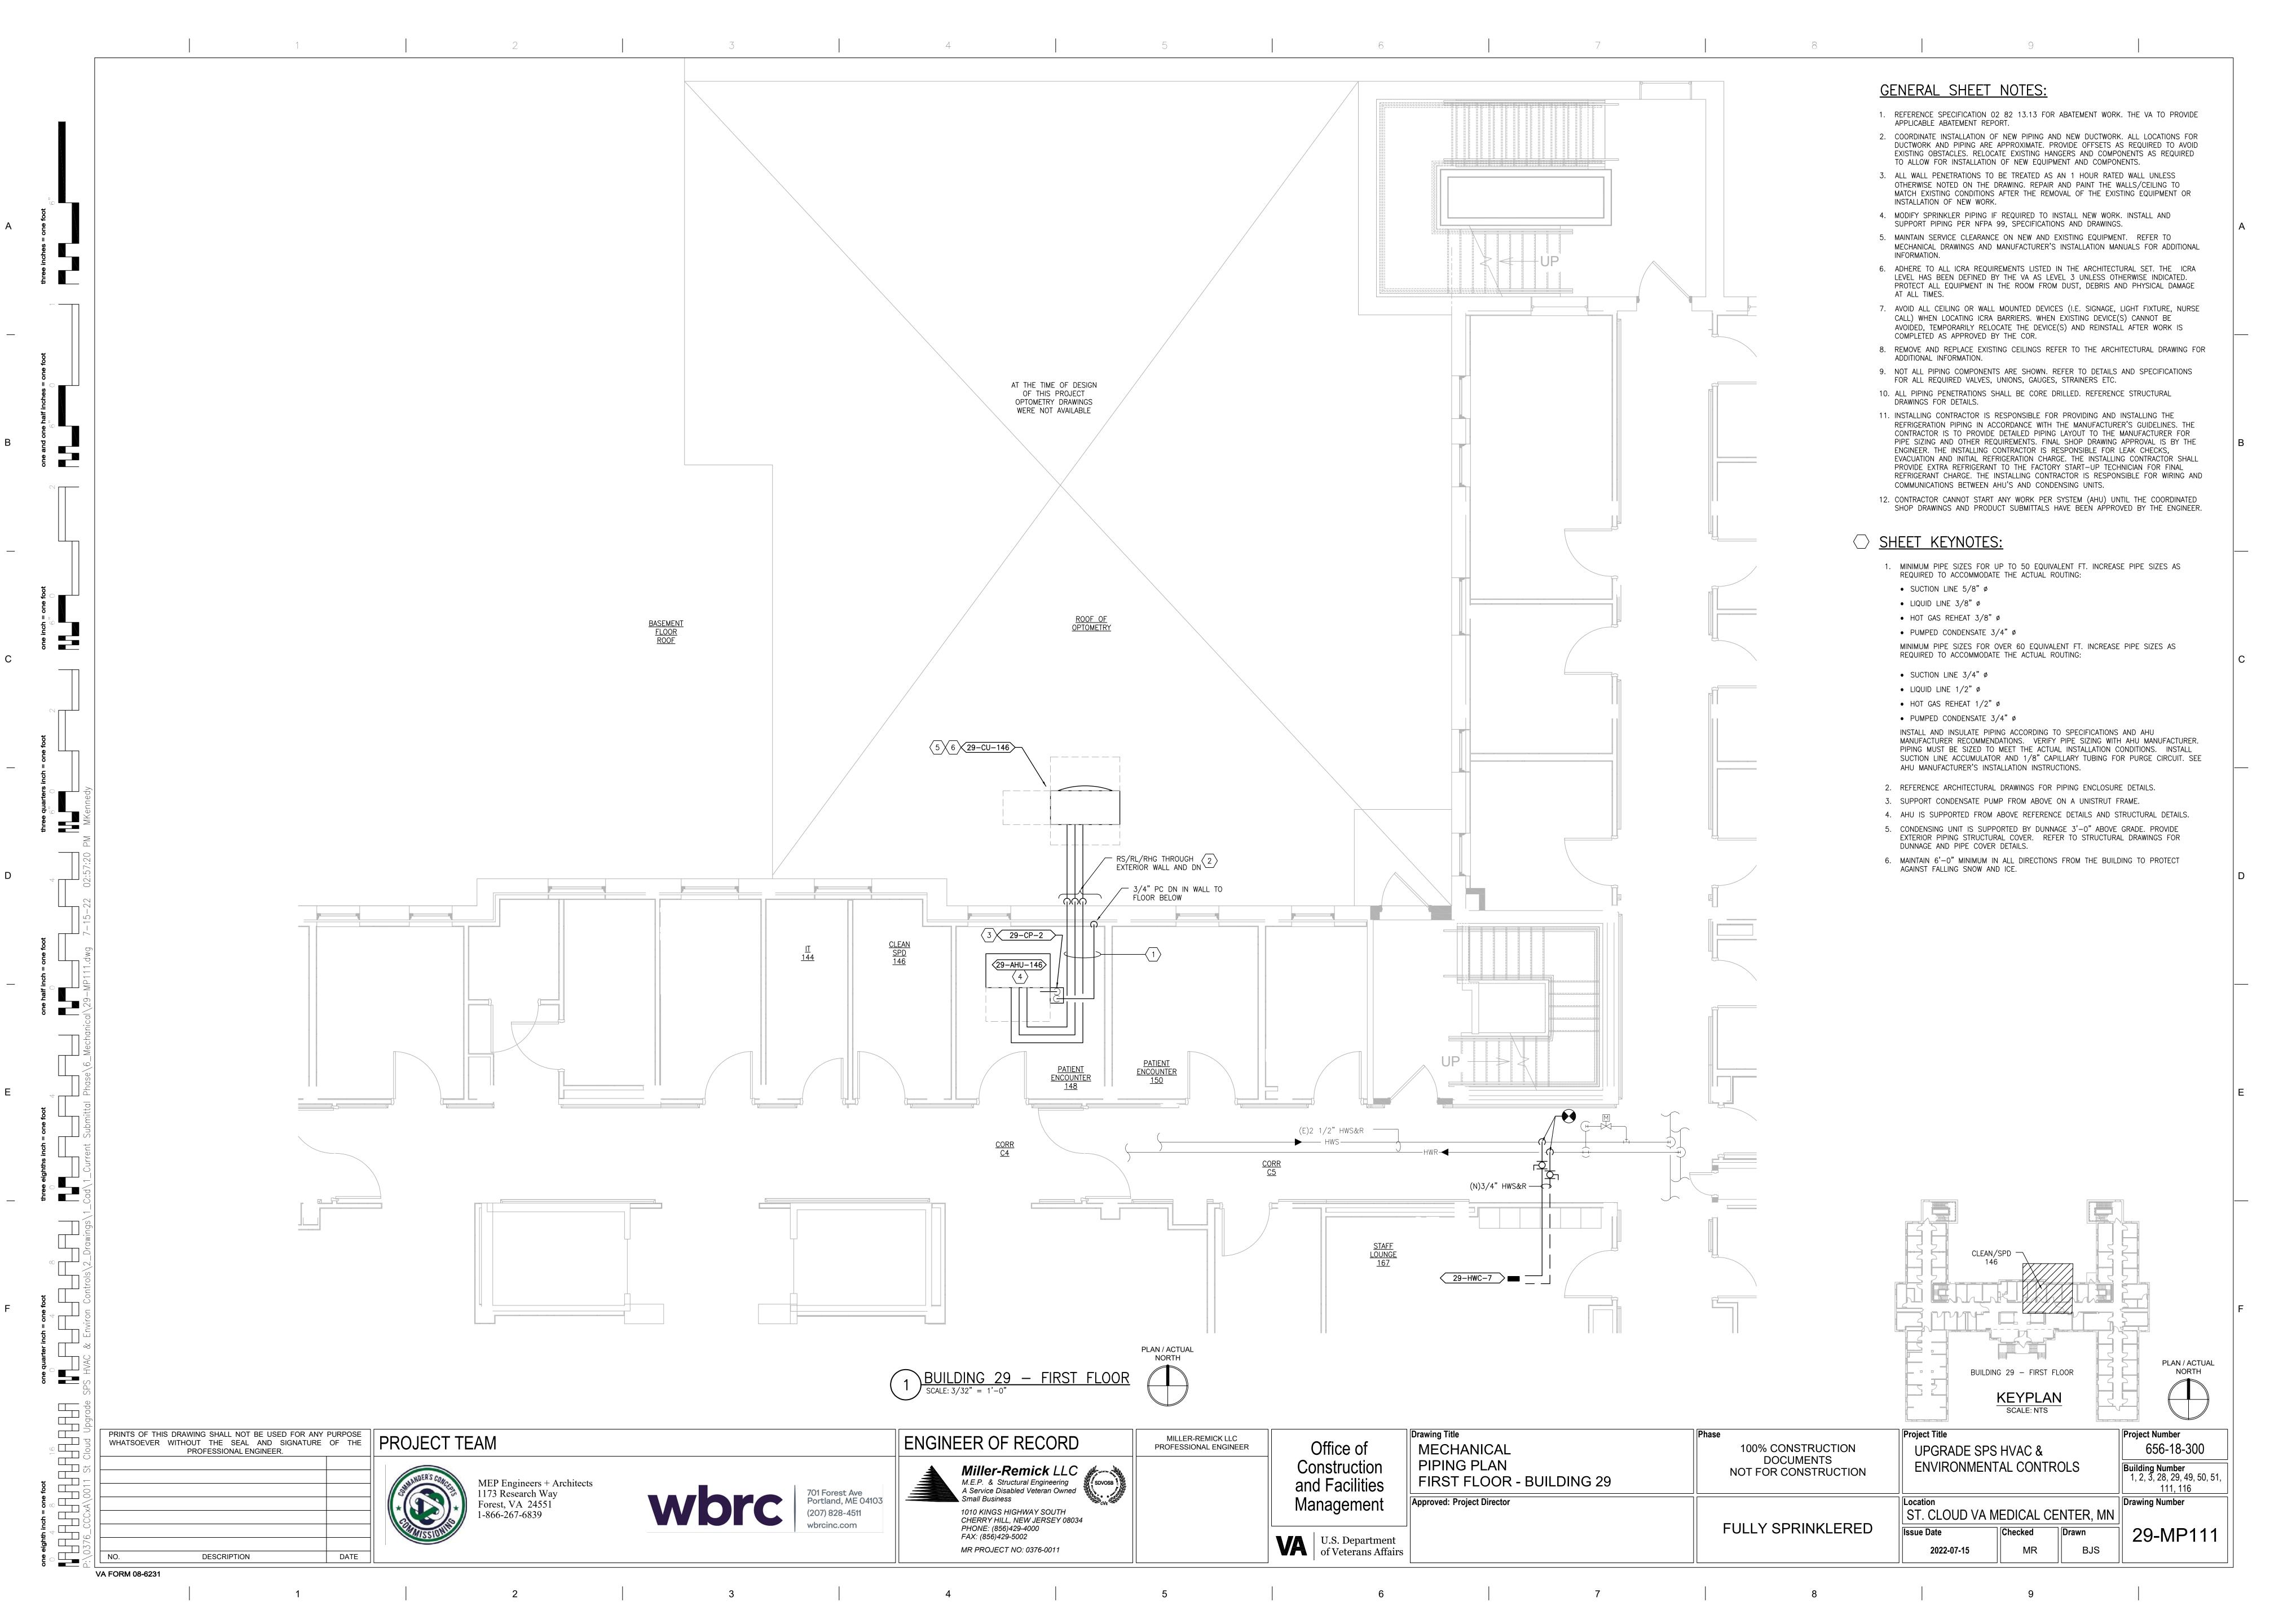

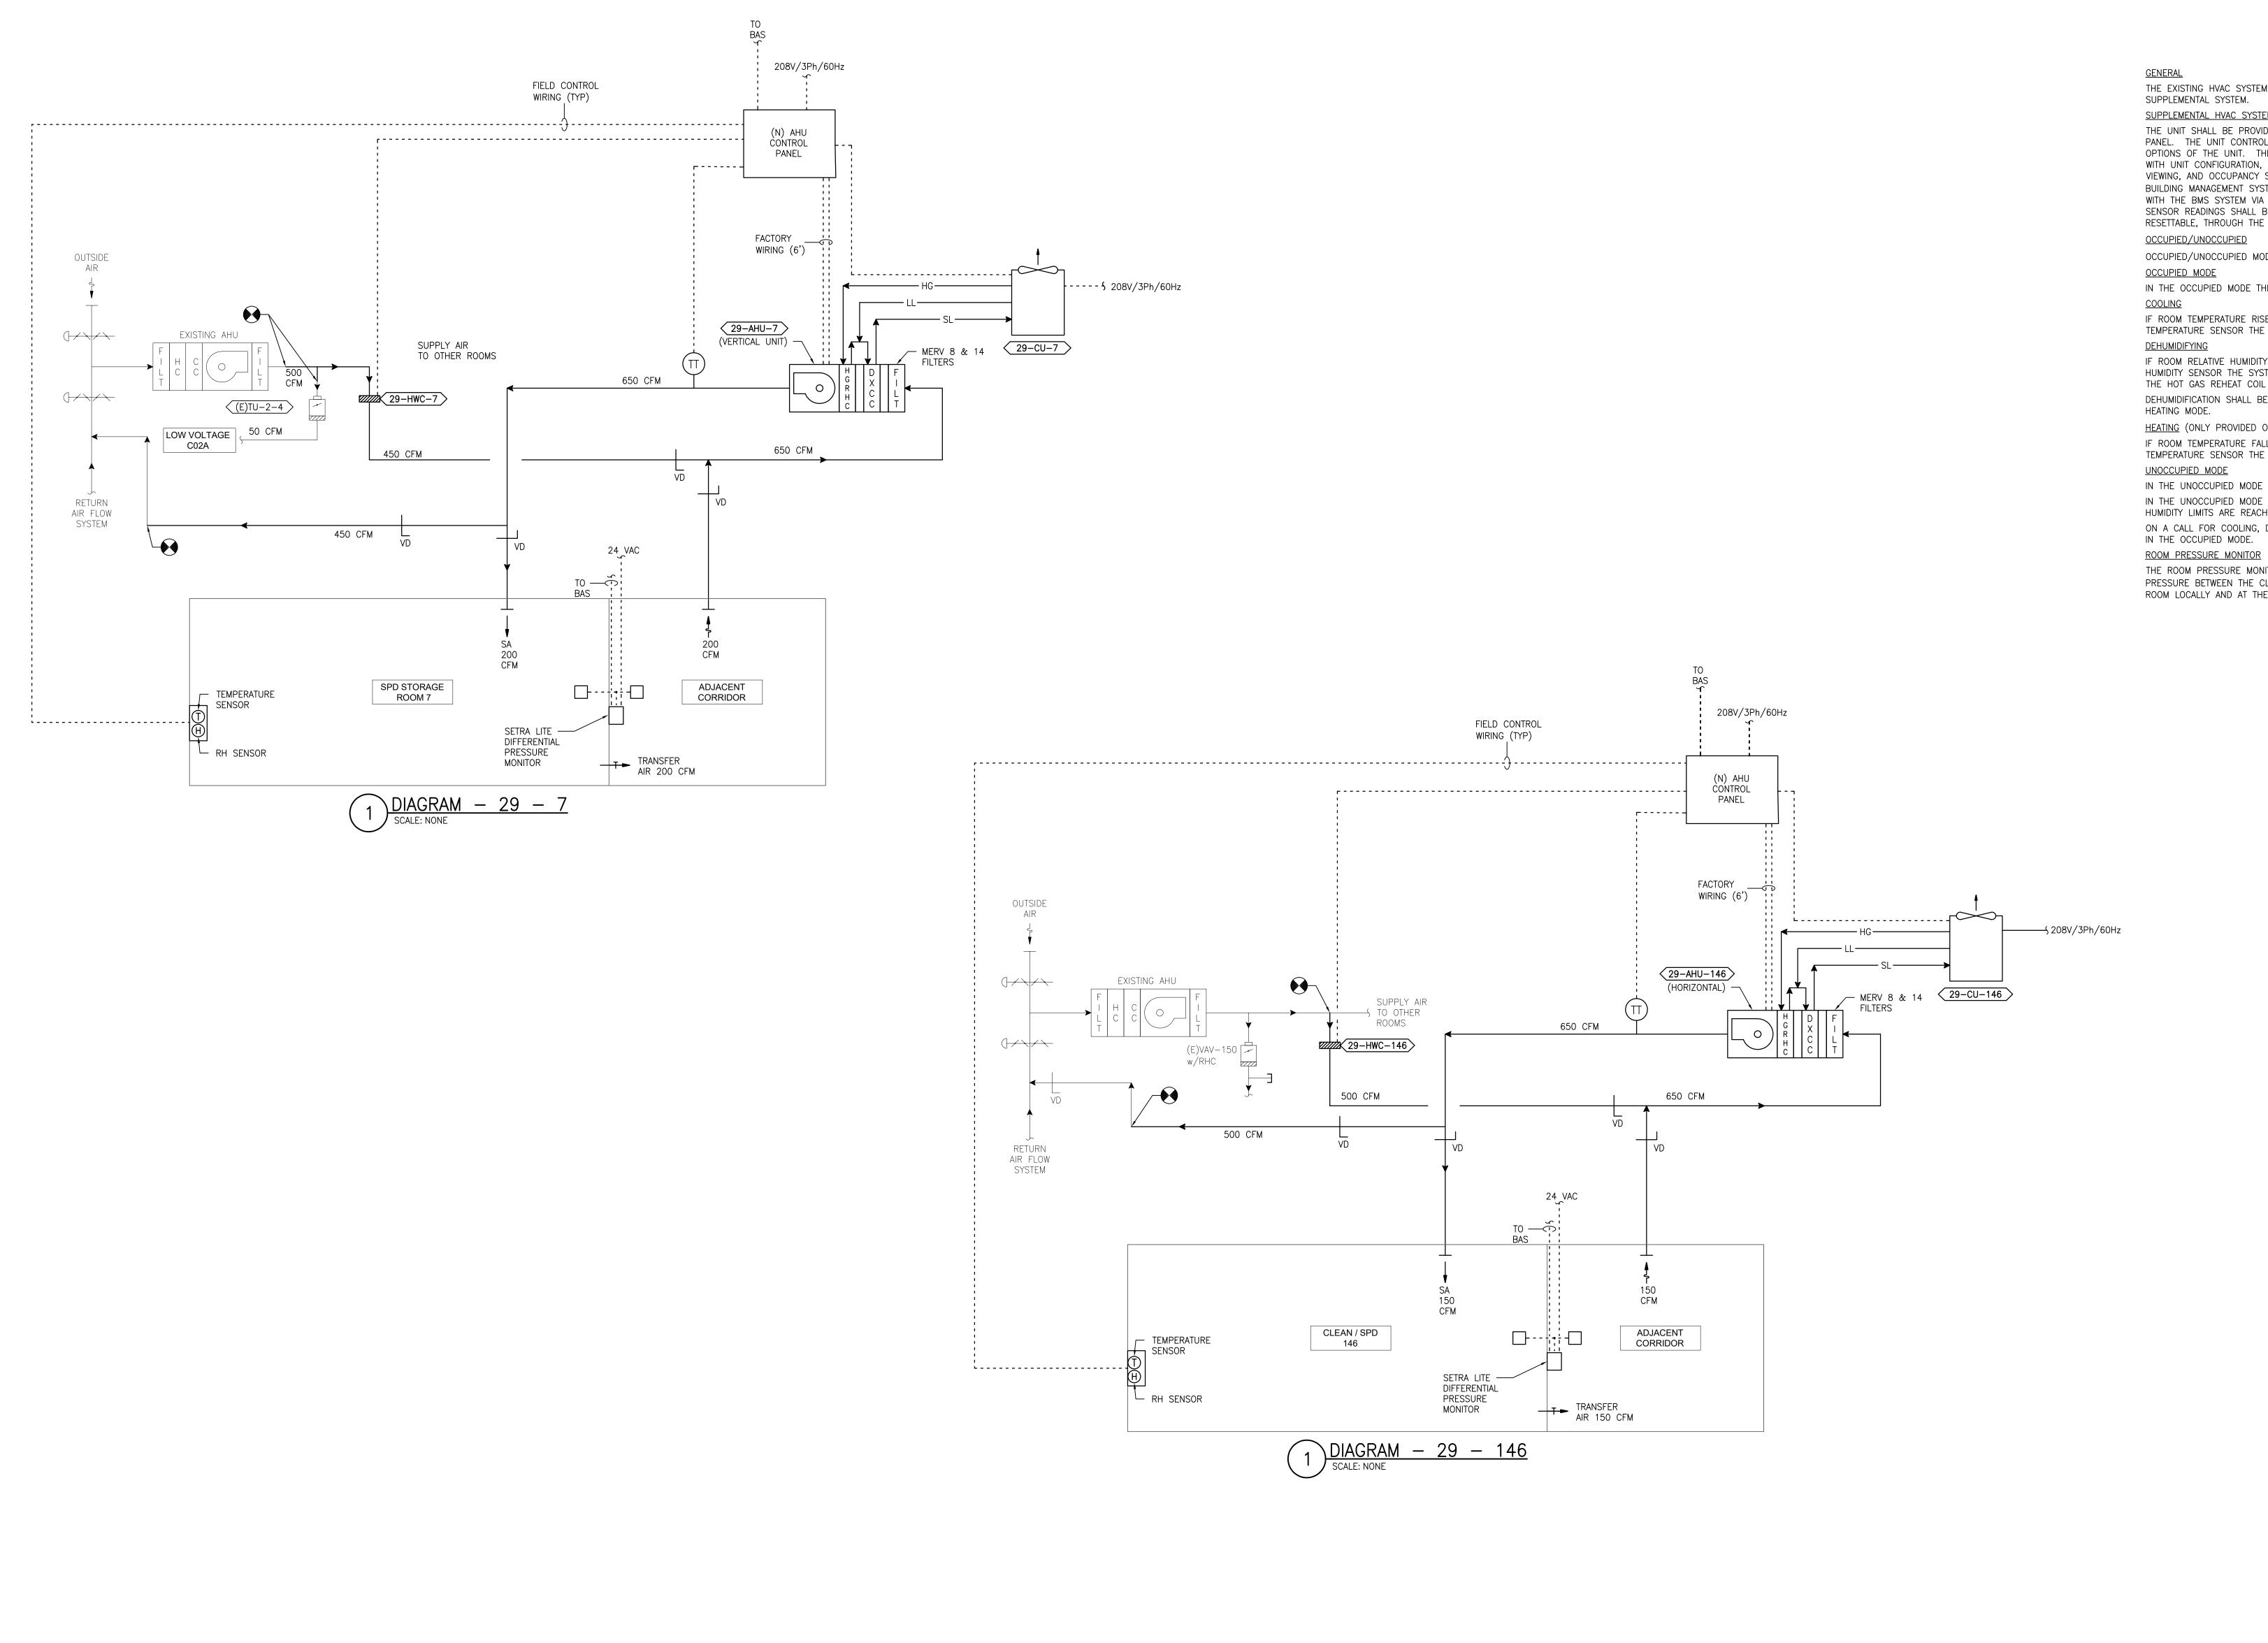ENGINEER OF RECORD

701 Forest Ave Portland, ME 04103

(207) 828-4511

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Miller-Remick LLC

M.E.P. & Structural Engineering
A Service Disabled Veteran Owned
Small Business

1010 KINGS HIGHWAY SOUTH CHERRY HILL, NEW JERSEY 08034

PHONE: (856)429-4000

MR PROJECT NO: 0376-0011

FAX: (856)429-5002

MILLER-REMICK LLC

PROFESSIONAL ENGINEER

5

Office of

Construction

and Facilities

Management

U.S. Department of Veterans Affairs

VA FORM 08-6231

PRINTS OF THIS DRAWING SHALL NOT BE USED FOR ANY PURPOSE WHATSOEVER WITHOUT THE SEAL AND SIGNATURE OF THE PROFESSIONAL ENGINEER.

DESCRIPTION

DATE

MEP Engineers + Architects

1173 Research Way

Forest, VA 24551 1-866-267-6839

SEQUENCE OF OPERATION

THE EXISTING HVAC SYSTEMS WILL CONTINUE TO OPERATE INDEPENDENT OF THE NEW SUPPLEMENTAL SYSTEM.

SUPPLEMENTAL HVAC SYSTEM CONTROL

THE UNIT SHALL BE PROVIDED WITH A FACTORY PREWIRED AND TESTED EXTERNAL CONTROL PANEL. THE UNIT CONTROLLER SHALL BE CAPABLE OF CONTROLLING ALL FEATURES AND OPTIONS OF THE UNIT. THE CONTROLLER SHALL BE CAPABLE OF STAND-ALONE OPERATION WITH UNIT CONFIGURATION, SETPOINT ADJUSTMENT, SENSOR STATUS VIEWING, UNIT ALARM VIEWING, AND OCCUPANCY SCHEDULING WITHOUT DEPENDENCE ON THE JOHNSON CONTROLS BUILDING MANAGEMENT SYSTEM (BMS). THE CONTROLLER SHALL COMMUNICATE AND INTEGRATE WITH THE BMS SYSTEM VIA BACNET. ALL SETPOINTS SHALL BE VISIBLE AND RESETTABLE, ALL SENSOR READINGS SHALL BE VISIBLE, OCCUPIED AND UNOCCUPIED SCHEDULING SHALL BE RESETTABLE, THROUGH THE BMS SYSTEM VIA BACNET.

OCCUPIED/UNOCCUPIED OCCUPIED/UNOCCUPIED MODE SHALL BE BASED ON A COMMAND FROM THE BMS.

IN THE OCCUPIED MODE THE SUPPLY FAN SHALL RUN CONTINUOUSLY.

IF ROOM TEMPERATURE RISES ABOVE SETPOINT AS SENSED BY THE WALL MOUNTED TEMPERATURE SENSOR THE COMPRESSOR SHALL MODULATE TO MAINTAIN ROOM TEMPERATURE. <u>DEHUMIDIFYING</u>

IF ROOM RELATIVE HUMIDITY RISES ABOVE SETPOINT AS SENSED BY THE WALL MOUNTED HUMIDITY SENSOR THE SYSTEM SHALL OVERRIDE THE COOLING COIL SETPOINT AND MODULATE THE HOT GAS REHEAT COIL TO MAINTAIN ROOM TEMPERATURE AND HUMIDITY SETPOINTS. DEHUMIDIFICATION SHALL BE INITIATED ANYTIME IN THE OCCUPIED, UNOCCUPIED, COOLING OR

HEATING (ONLY PROVIDED ON SOME UNITS)

IF ROOM TEMPERATURE FALLS BELOW SETPOINT AS SENSED BY THE WALL MOUNTED TEMPERATURE SENSOR THE HEATING COIL SHALL MODULATE TO MAINTAIN ROOM TEMPERATURE. UNOCCUPIED MODE

IN THE UNOCCUPIED MODE THE SUPPLY FAN SHALL RUN CONTINUOUSLY.


IN THE UNOCCUPIED MODE THE UNIT SHALL OPERATE IF THE ROOM TEMPERATURE OR RELATIVE HUMIDITY LIMITS ARE REACHED.

ON A CALL FOR COOLING, DEHUMIDIFYING, OR HEATING THE CONTROL SHALL BE THE SAME AS IN THE OCCUPIED MODE.

THE ROOM PRESSURE MONITOR SETRA LITE SHALL MONITOR AND ALARM THE DIFFERENTIAL

PRESSURE BETWEEN THE CLEAN / STERILE SATELLITE STORAGE ROOM AND THE ADJACENT ROOM LOCALLY AND AT THE BAS.

Project Title Drawing Title Project Number 656-18-300 **MECHANICAL** 100% CONSTRUCTION UPGRADE SPS HVAC & DOCUMENTS NOT FOR CONSTRUCTION AIRFLOW CONTROL DIAGRAMS **ENVIRONMENTAL CONTROLS** Building Number 1, 2, 3, 28, 29, 49, 50, 51, **BUILDING 29** 111, 116 Approved: Project Director Drawing Number ST. CLOUD VA MEDICAL CENTER, MN **FULLY SPRINKLERED** Checked 29-M-801 Drawn PNL MR 2022-07-15

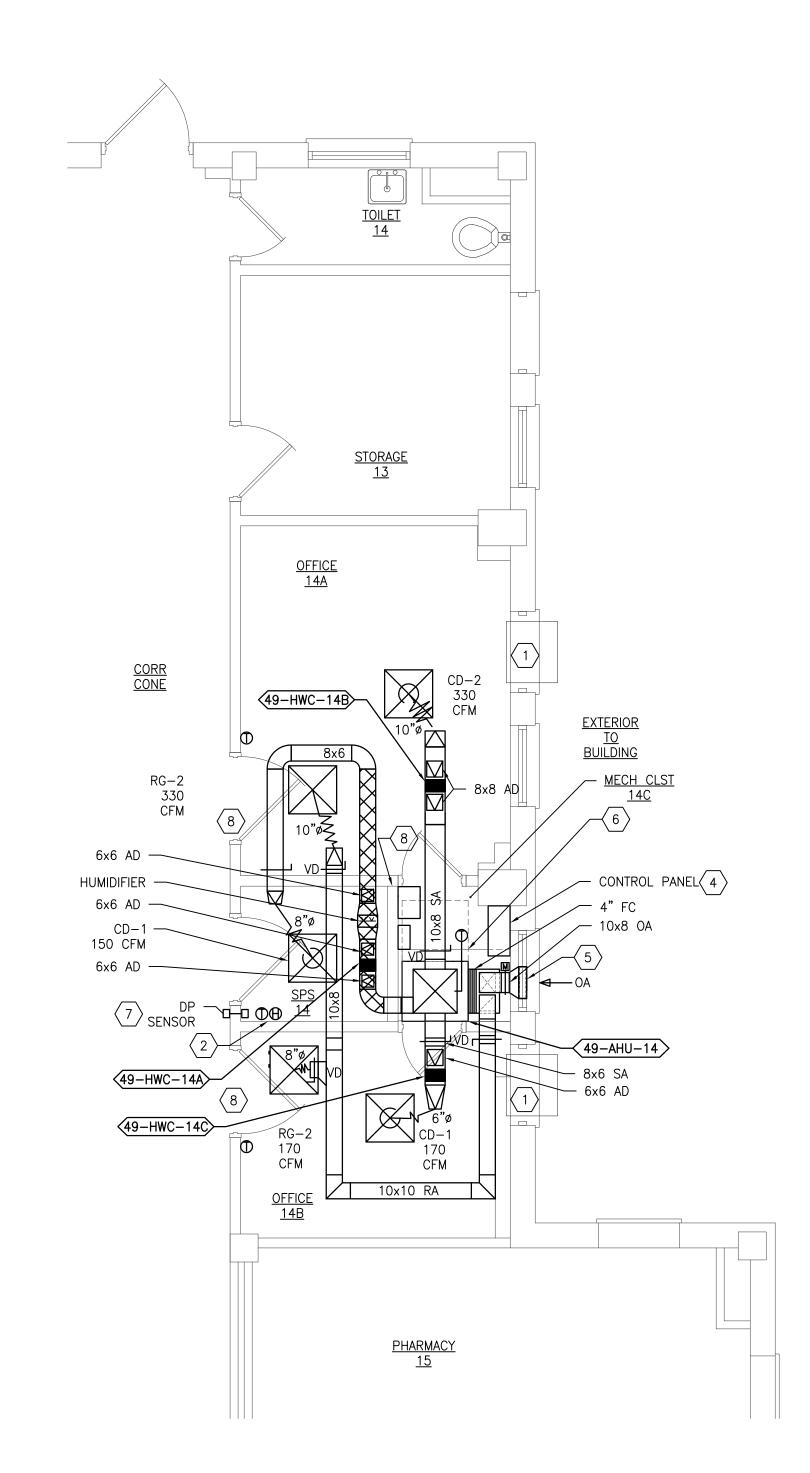


BUILDING 49 BASEMENT FLOOR ROOM 14 - NEW WORK

SCALE: 1/4" = 1'-0"

VA FORM 08-6231

DESCRIPTION

DATE

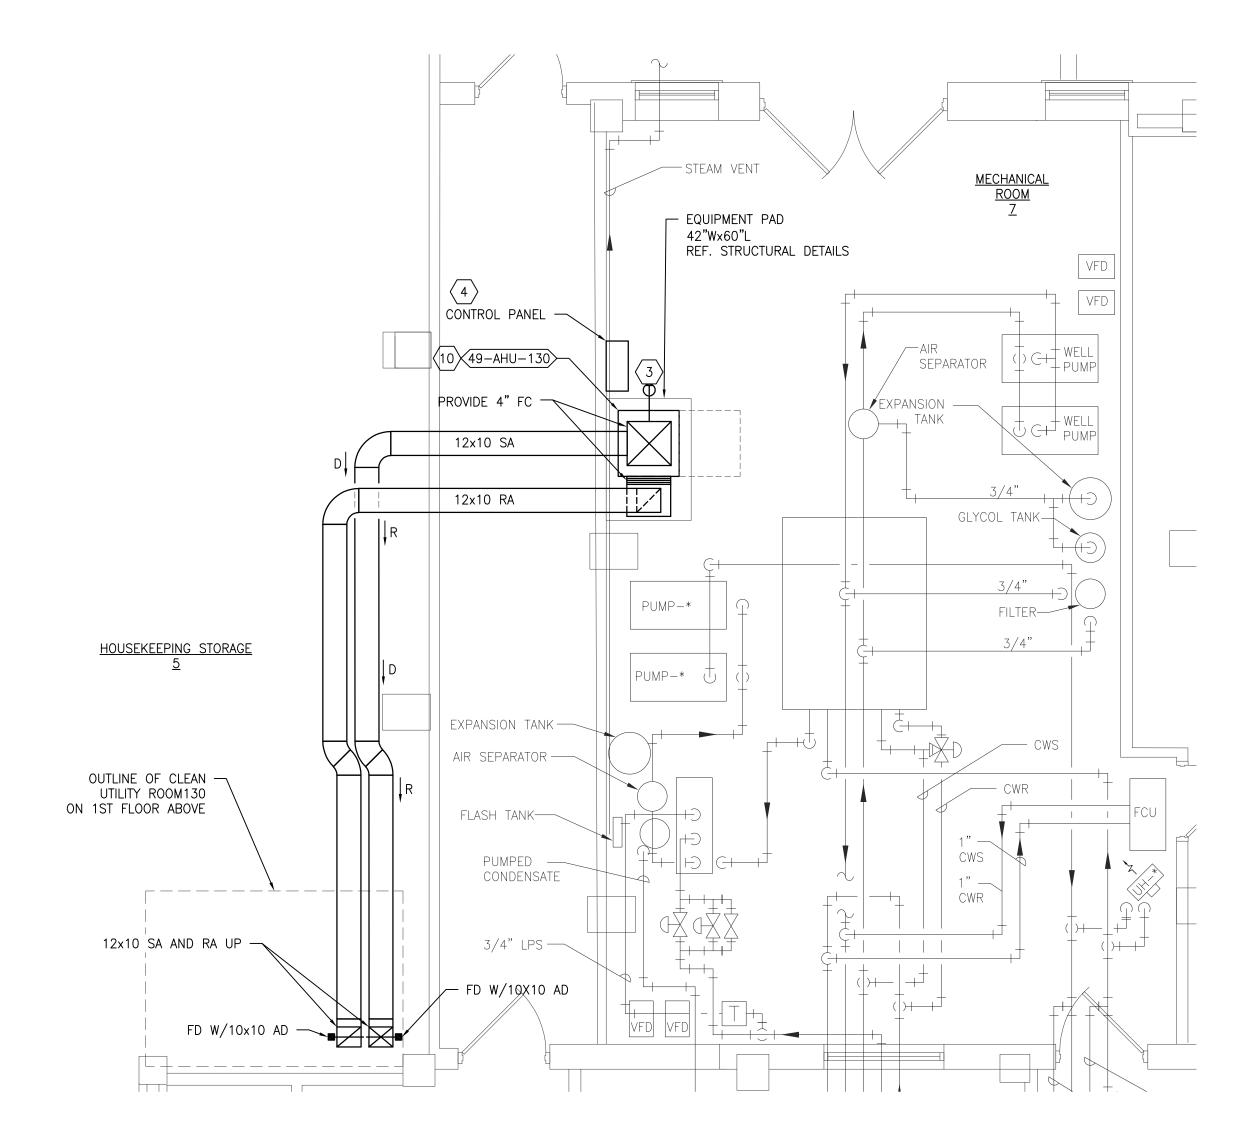

2 BUILDING 49 BASEMENT ROOM 7 - NEW WORK
SCALE: 1/4" = 1'-0"

# **GENERAL SHEET NOTES:**

INSTALLATION OF NEW WORK.


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- TO ALLOW FOR INSTALLATION OF NEW EQUIPMENT AND COMPONENTS. 3. ALL WALL PENETRATIONS TO BE TREATED AS AN 1 HOUR RATED WALL UNLESS OTHERWISE NOTED ON THE DRAWING. REPAIR AND PAINT THE WALLS/CEILING TO MATCH EXISTING CONDITIONS AFTER THE REMOVAL OF THE EXISTING EQUIPMENT OR
- 4. MODIFY SPRINKLER PIPING IF REQUIRED TO INSTALL NEW WORK. INSTALL AND SUPPORT PIPING PER NFPA 99, SPECIFICATIONS AND DRAWINGS.
- 5. MAINTAIN SERVICE CLEARANCE ON NEW AND EXISTING EQUIPMENT. REFER TO MECHANICAL DRAWINGS AND MANUFACTURER'S INSTALLATION MANUALS FOR ADDITIONAL
- 6. ADHERE TO ALL ICRA REQUIREMENTS LISTED IN THE ARCHITECTURAL SET. THE ICRA LEVEL HAS BEEN DEFINED BY THE VA AS LEVEL 3 UNLESS OTHERWISE INDICATED. PROTECT ALL EQUIPMENT IN THE ROOM FROM DUST, DEBRIS AND PHYSICAL DAMAGE AT ALL TIMES.
- 7. AVOID ALL CEILING OR WALL MOUNTED DEVICES (I.E. SIGNAGE, LIGHT FIXTURE, NURSE CALL) WHEN LOCATING ICRA BARRIERS. WHEN EXISTING DEVICE(S) CANNOT BE AVOIDED, TEMPORARILY RELOCATE THE DEVICE(S) AND REINSTALL AFTER WORK IS COMPLETED AS
- APPROVED BY THE COR. 8. REMOVE AND REPLACE EXISTING CEILINGS REFER TO THE ARCHITECTURAL DRAWING FOR ADDITIONAL INFORMATION.
- 9. TAKE PREDEMOLITION READINGS OF ALL ROOM AIR INLETS AND OUTLETS OF ANY SYSTEM THE WILL BE MODIFIED AND SUBMIT TO THE VA AND ENGINEER FOR RECORD PRIOR TO STARTING ANY NEW WORK. BALANCE THE NEW SYSTEMS AND REBALANCE THE EXISTING ASSOCIATED AHU SYSTEM TO THE NEW AIR QUANTITIES. AFTER THE NEW WORK IS COMPLETE REBALANCE THE EXISTING SYSTEM, AS REQUIRED, AND MEASURE ALL ROOM AIR INLETS AND OUTLETS TO VERIFY THAT THE PREDEMOLITION AIRFLOWS HAVE BEEN MAINTAINED. SUBMIT FOR APPROVAL. REFERENCE SPECIFICATIONS FOR TESTING AND BALANCING REQUIREMENTS.
- 10. ALL DUCTWORK PENETRATIONS SHALL BE SAW CUT. REFERENCE STRUCTURAL DRAWINGS FOR DETAILS.
- 11. CONTRACTOR CANNOT START ANY WORK PER SYSTEM (AHU) UNTIL THE COORDINATED SHOP DRAWINGS AND PRODUCT SUBMITTALS HAVE BEEN APPROVED BY THE ENGINEER.

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- 1. EXISTING WINDOW AC UNIT TO REMAIN.
- 2. THERMOSTAT AND HUMIDISTAT TO CONTROL NEW SPS CLOSET AHU.
- 3. DISCHARGE AIR TEMPERATURE SENSOR FURNISHED BY AHU MANUFACTURER.
- EXISTING ROOM CONDITIONS FOR FINAL LOCATION. EXTEND AND INTEGRATE INTO BAS LOCAL CONTROLLER LABEL <u>NAE-49</u>. 5. PROVIDE NEW 16x12 OUTDOOR AIR INTAKE LOUVER BOD: GREENECK ESD-635 IN UPPER

4. MOUNT AAON CONTROL PANEL ON THE WALL. COORDINATE WITH THE COR AND THE

- WINDOW SASH. PROVIDE INSULATED METAL PANEL FOR UNUSED WINDOW PORTION. 24V MOTORIZED DAMPER ACTUATOR AND BIRDSCREEN.
- 6. EQUIPMENT PAD 36"Wx54"L REFERENCE STRUCTURAL DETAILS FOR ADDITIONAL INFORMATION. 7. INSTALL DIFFERENTIAL PRESSURE SENSOR THROUGH WALL CENTERED ABOVE DOOR.
- INSTALL ROOM PRESSURE MONITOR OUTSIDE ROOM NEAR ROOM NAME AND NUMBER LABEL.
- 8. REFERENCE ARCHITECTURAL DRAWINGS FOR NEW WALLS AND DOORS AND INFILL.

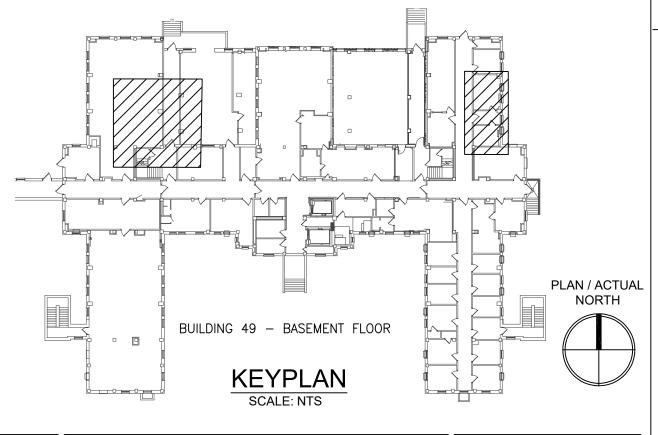


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M.E.P. & Structural Engineering

A Service Disabled Veteran Owned Construction **ENVIRONMENTAL CONTROLS** Building Number 1, 2, 3, 28, 29, 49, 50, 51, NOT FOR CONSTRUCTION BASEMENT - BUILDING 49 and Facilities MEP Engineers + Architects 111, 116 1173 Research Way 701 Forest Ave Portland, ME 04103 Management Approved: Project Director Drawing Number Forest, VA 24551 1-866-267-6839 1010 KINGS HIGHWAY SOUTH CHERRY HILL, NEW JERSEY 08034 (207) 828-4511 ST. CLOUD VA MEDICAL CENTER, MN **FULLY SPRINKLERED** PHONE: (856)429-4000 Checked 49-MH101 Drawn U.S. Department of Veterans Affairs FAX: (856)429-5002 MR PNL MR PROJECT NO: 0376-0011 2022-07-15

1 BUILDING 49 FIRST FLOOR ROOM 130 — DEMOLITION SCALE: 1/4" = 1'-0"

VA FORM 08-6231

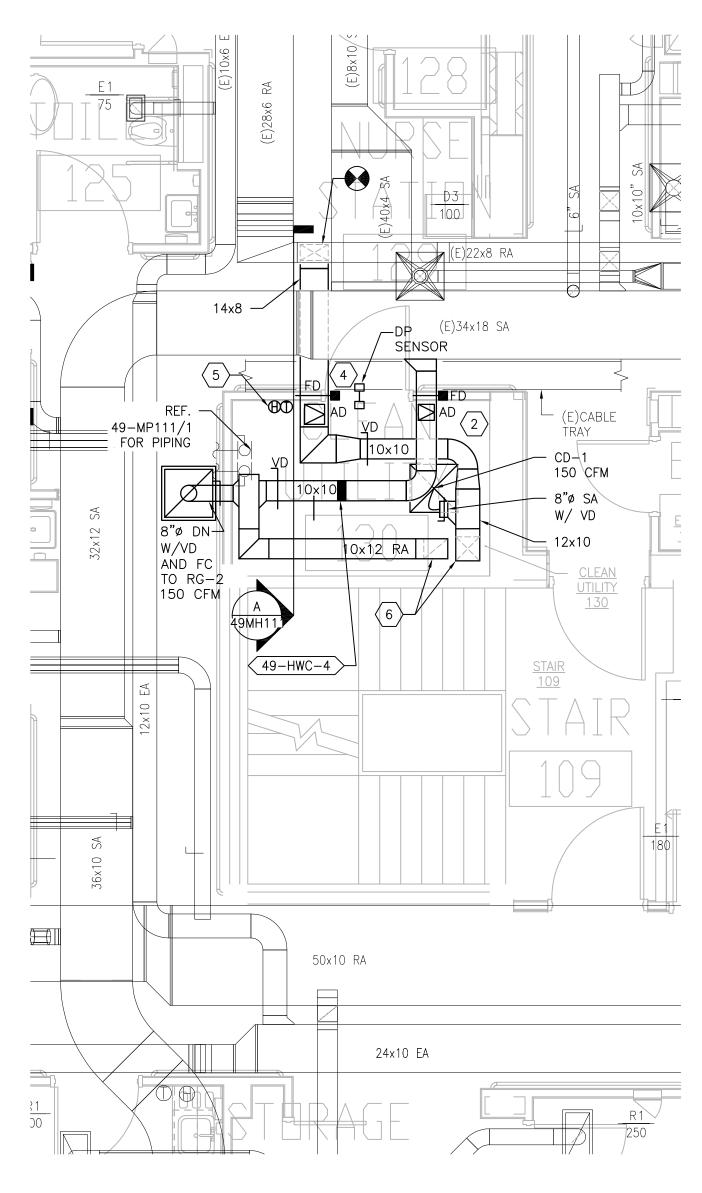

2 BUILDING 49 FIRST FLOOR ROOM 130 - NEW WORK

SCALE: 1/4" = 1'-0"

# **GENERAL SHEET NOTES:**

INSTALLATION OF NEW WORK.

- 1. REFERENCE SPECIFICATION 02 82 13.13 FOR ABATEMENT WORK. THE VA TO PROVIDE APPLICABLE ABATEMENT REPORT.
- 2. COORDINATE INSTALLATION OF NEW PIPING AND NEW DUCTWORK. ALL LOCATIONS FOR DUCTWORK AND PIPING ARE APPROXIMATE. PROVIDE OFFSETS AS REQUIRED TO AVOID EXISTING OBSTACLES. RELOCATE EXISTING HANGERS AND COMPONENTS AS REQUIRED TO ALLOW FOR INSTALLATION OF NEW EQUIPMENT AND COMPONENTS.
- 3. ALL WALL PENETRATIONS TO BE TREATED AS AN 1 HOUR RATED WALL UNLESS
  OTHERWISE NOTED ON THE DRAWING. REPAIR AND PAINT THE WALLS/CEILING TO MATCH
  EXISTING CONDITIONS AFTER THE REMOVAL OF THE EXISTING EQUIPMENT OR
- 4. MODIFY SPRINKLER PIPING IF REQUIRED TO INSTALL NEW WORK. INSTALL AND SUPPORT PIPING PER NFPA 99, SPECIFICATIONS AND DRAWINGS.
- 5. MAINTAIN SERVICE CLEARANCE ON NEW AND EXISTING EQUIPMENT. REFER TO MECHANICAL DRAWINGS AND MANUFACTURER'S INSTALLATION MANUALS FOR ADDITIONAL INFORMATION.
- 6. ADHERE TO ALL ICRA REQUIREMENTS LISTED IN THE ARCHITECTURAL SET. THE ICRA LEVEL HAS BEEN DEFINED BY THE VA AS LEVEL 3 UNLESS OTHERWISE INDICATED. PROTECT ALL EQUIPMENT IN THE ROOM FROM DUST, DEBRIS AND PHYSICAL DAMAGE
- AT ALL TIMES.

  7. AVOID ALL CEILING OR WALL MOUNTED DEVICES (I.E. SIGNAGE, LIGHT FIXTURE, NURSE CALL) WHEN LOCATING ICRA BARRIERS. WHEN EXISTING DEVICE(S) CANNOT BE AVOIDED,
- TEMPORARILY RELOCATE THE DEVICE(S) AND REINSTALL AFTER WORK IS COMPLETED AS APPROVED BY THE COR.


  8. REMOVE AND REPLACE EXISTING CEILINGS REFER TO THE ARCHITECTURAL DRAWING FOR
- 9. TAKE PREDEMOLITION READINGS OF ALL ROOM AIR INLETS AND OUTLETS OF ANY SYSTEM THE WILL BE MODIFIED AND SUBMIT TO THE VA AND ENGINEER FOR RECORD PRIOR TO STARTING ANY NEW WORK. BALANCE THE NEW SYSTEMS AND REBALANCE THE EXISTING ASSOCIATED AHU SYSTEM TO THE NEW AIR QUANTITIES. AFTER THE NEW WORK IS COMPLETE REBALANCE THE EXISTING SYSTEM, AS REQUIRED, AND MEASURE ALL ROOM AIR INLETS AND OUTLETS TO VERIFY THAT THE PREDEMOLITION AIRFLOWS HAVE BEEN MAINTAINED. SUBMIT FOR APPROVAL. REFERENCE SPECIFICATIONS FOR TESTING AND BALANCING REQUIREMENTS.
- 10. ALL DUCTWORK PENETRATIONS SHALL BE SAW CUT. REFERENCE STRUCTURAL DRAWINGS FOR DETAILS.
- 13. CONTRACTOR CANNOT START ANY WORK PER SYSTEM (AHU) UNTIL THE COORDINATED SHOP DRAWINGS AND PRODUCT SUBMITTALS HAVE BEEN APPROVED BY THE ENGINEER.

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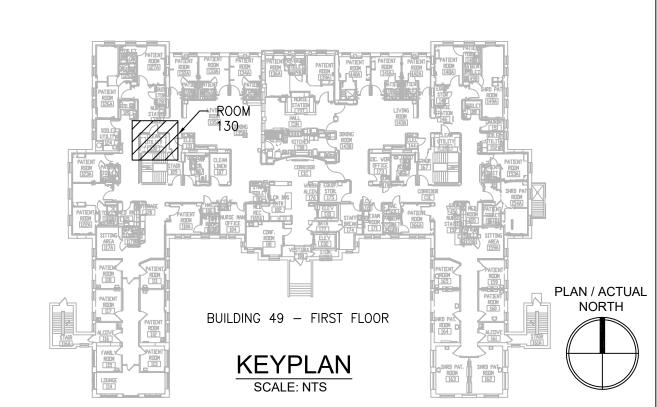
ADDITIONAL INFORMATION.

- 1. DEMOLISH DUCTWORK, HANGERS AND ALL APPURTENANCES TYPICAL. PATCH EXISTING WALL OPENING WITH MATCHING MATERIALS AS REQUIRED OR REUSE EXISTING WALL OPENING AS MUCH AS POSSIBLE.
- LOWER CEILING TO 7'-4" AFF IF REQUIRED FOR INSTALLATION OF NEW WORK. IF LOWER CEILING IS REQUIRED THAN LOWER SPRINKLER HEADS AND EXTEND WIRING TO EXISTING DEVICES
- 3. RELOCATE EXISTING SPRINKLER PIPE AS REQUIRED TO CLEAR SPACE FOR NEW RETURN
- 4. INSTALL DIFFERENTIAL PRESSURE SENSOR THROUGH WALL CENTERED ABOVE DOOR.
  INSTALL ROOM PRESSURE MONITOR OUTSIDE ROOM NEAR ROOM NAME AND NUMBER
- LABEL.

  5. TEMPERATURE AND HUMIDITY SENSOR FURNISHED BY AHU MANUFACTURER.
- 6. NEW 12x10 SUPPLY AND RETURN DUCT FROM BELOW. REFERENCE DRAWING 29-MH111 FOR ADDITIONAL INFORMATION.
- 7. CABLE TRAY TO BE DEMOLISHED AT THIS LOCATION. REFERENCE ELECTRICAL DRAWINGS

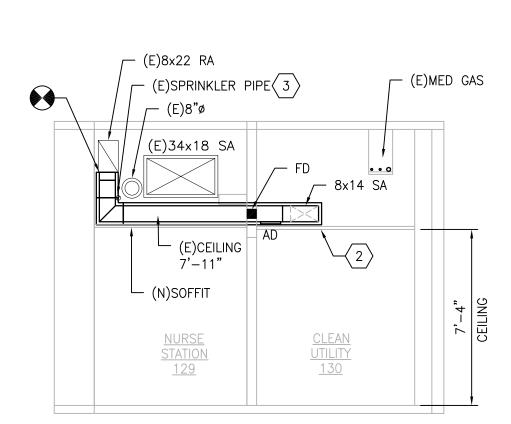


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A & \underline{SECTION} & A \\
\underline{SCALE: 1/4" = 1'-0"}
\end{array}$ 



PRINTS OF THIS DRAWING SHALL NOT BE USED FOR ANY PURPOSE WHATSOEVER WITHOUT THE SEAL AND SIGNATURE OF THE PROFESSIONAL ENGINEER. Project Title Drawing Title Project Number PROJECT TEAM ENGINEER OF RECORD MILLER-REMICK LLC Office of 656-18-300 **MECHANICAL** 100% CONSTRUCTION UPGRADE SPS HVAC & PROFESSIONAL ENGINEER Building Number
1, 2, 3, 28, 29, 49, 50, 51, 111, 116 DOCUMENTS NOT FOR CONSTRUCTION DEMOLITION / NEW WORK PLANS Miller-Remick LLC

M.E.P. & Structural Engineering
A Service Disabled Veteran Owned
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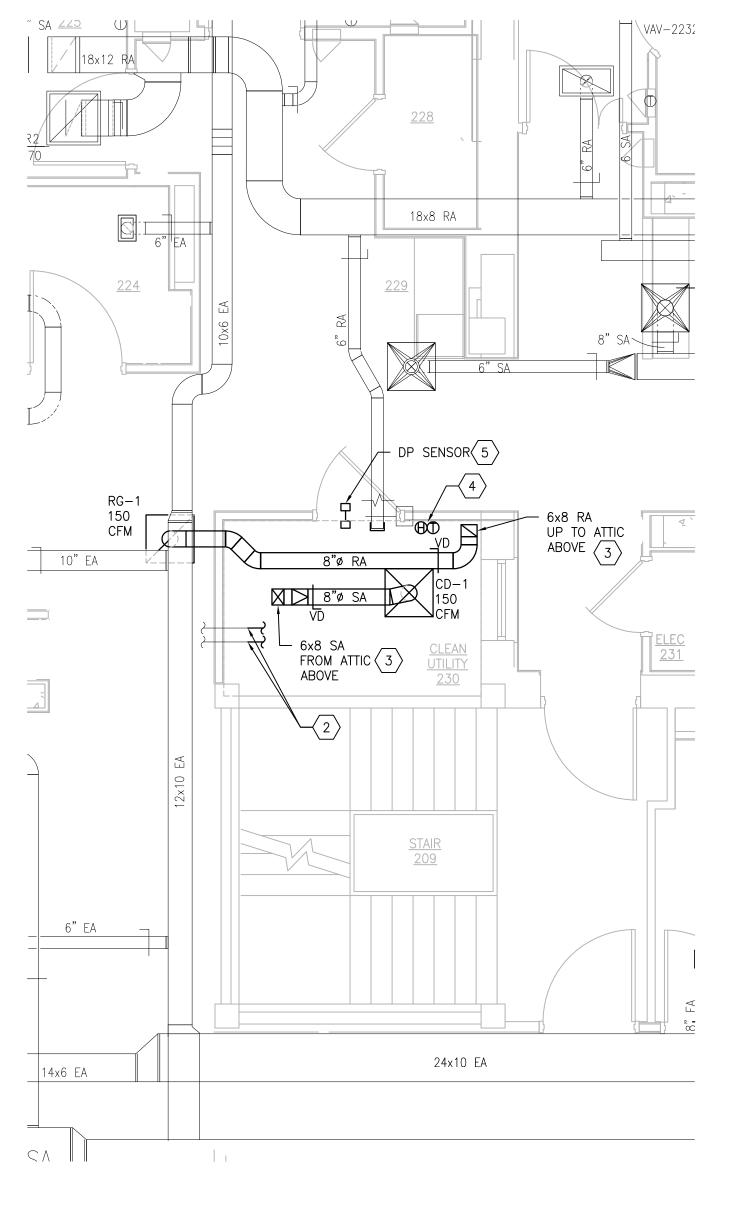


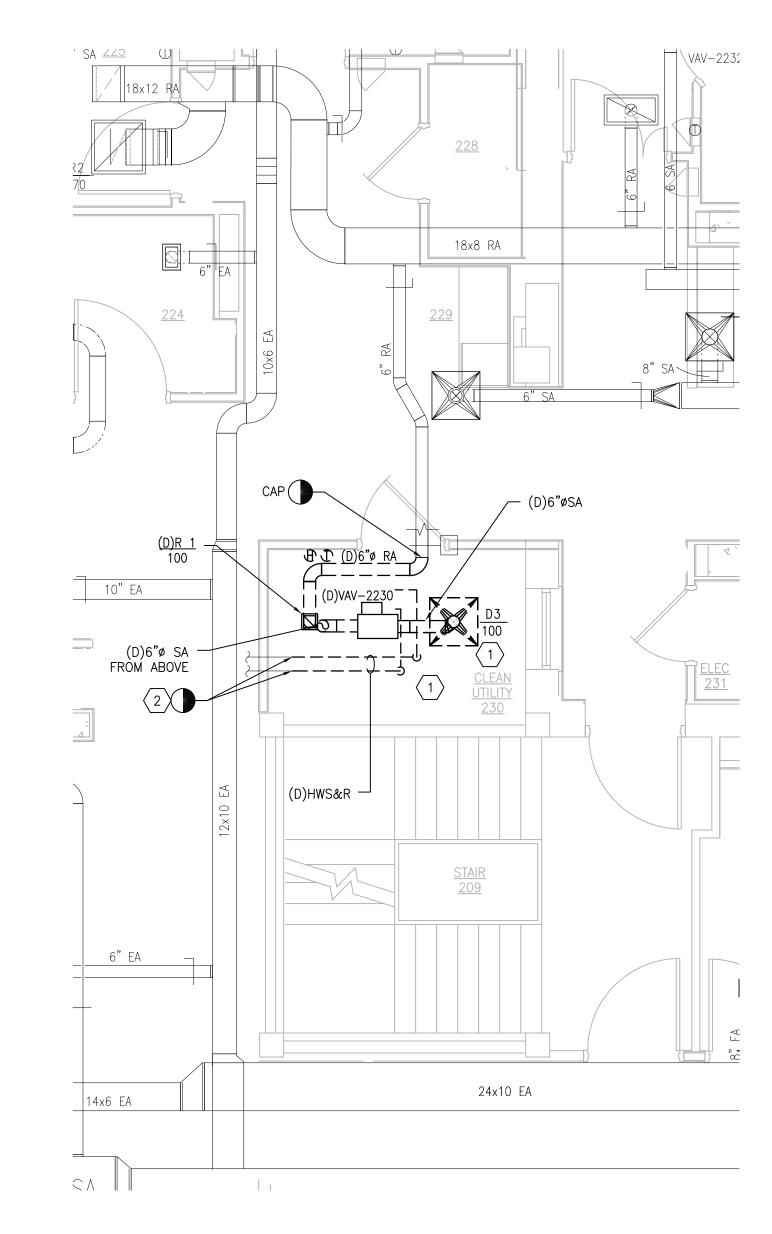1 BUILDING 49 SECOND FLOOR ROOM 230 — DEMOLITION SCALE: 1/4" = 1'-0"

VA FORM 08-6231

DESCRIPTION

DATE



2 BUILDING 49 SECOND FLOOR ROOM 230 - NEW WORK

SCALE: 1/4" = 1'-0"

# **GENERAL SHEET NOTES:**


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- 4. MODIFY SPRINKLER PIPING IF REQUIRED TO INSTALL NEW WORK. INSTALL AND SUPPORT PIPING PER NFPA 99, SPECIFICATIONS AND DRAWINGS.
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- 11. CONTRACTOR CANNOT START ANY WORK PER SYSTEM (AHU) UNTIL THE COORDINATED SHOP DRAWINGS AND PRODUCT SUBMITTALS HAVE BEEN APPROVED BY THE ENGINEER.

#### > SHEET KEYNOTES:

ADDITIONAL INFORMATION.

TESTING AND BALANCING REQUIREMENTS.

- 1. DEMOLISH DUCTWORK, HANGERS AND ALL APPURTENANCES TYPICAL. PATCH EXISTING WALL OPENING WITH MATCHING MATERIALS AS REQUIRED OR REUSE EXISTING WALL OPENING AS MUCH AS POSSIBLE.
- 2. DISCONNECT (E)HOT WATER SUPPLY AND RETURN PIPING FROM TERMINAL UNIT. PREPARE (E)PIPING TO BE CONNECTED TO (N)PIPING. REFERENCE DRAWING 49-MP121 & 49-MP131 FOR (N)PIPING.
- 3. FIELD VERIFY EXISTING CONDITIONS AND COORDINATE WITH NEW WORK PARTICULARLY THE NEW DECK PENETRATION ABOVE.
- 4. THERMOSTAT AND HUMIDISTAT TO CONTROL NEW AHU.
- 5. INSTALL DIFFERENTIAL PRESSURE SENSOR THROUGH WALL CENTERED ABOVE DOOR. INSTALL ROOM PRESSURE MONITOR OUTSIDE ROOM NEAR ROOM NAME AND NUMBER

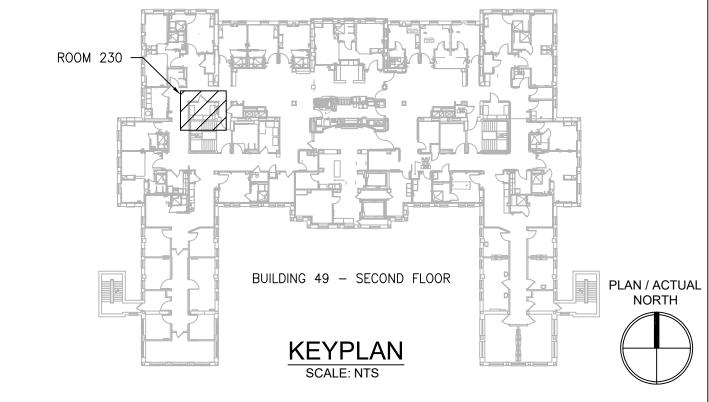

MR


2022-07-15

PRINTS OF THIS DRAWING SHALL NOT BE USED FOR ANY PURPOSE WHATSOEVER WITHOUT THE SEAL AND SIGNATURE OF THE PROFESSIONAL ENGINEER. Project Title Drawing Title Project Number PROJECT TEAM ENGINEER OF RECORD MILLER-REMICK LLC Office of 656-18-300 **MECHANICAL** 100% CONSTRUCTION PROFESSIONAL ENGINEER UPGRADE SPS HVAC & DOCUMENTS NOT FOR CONSTRUCTION DEMOLITION / NEW WORK PLANS Miller-Remick LLC

M.E.P. & Structural Engineering
A Service Disabled Veteran Owned
Small Business Construction **ENVIRONMENTAL CONTROLS** Building Number 1, 2, 3, 28, 29, 49, 50, 51, SECOND FLOOR - BUILDING 49 and Facilities MEP Engineers + Architects 111, 116 701 Forest Ave Portland, ME 04103 1173 Research Way Approved: Project Director Management Drawing Number Forest, VA 24551 1-866-267-6839 1010 KINGS HIGHWAY SOUTH CHERRY HILL, NEW JERSEY 08034 ST. CLOUD VA MEDICAL CENTER, MN (207) 828-4511 **FULLY SPRINKLERED** PHONE: (856)429-4000 Checked 49-MH121 Drawn U.S. Department of Veterans Affairs FAX: (856)429-5002 PNL

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MR PROJECT NO: 0376-0011

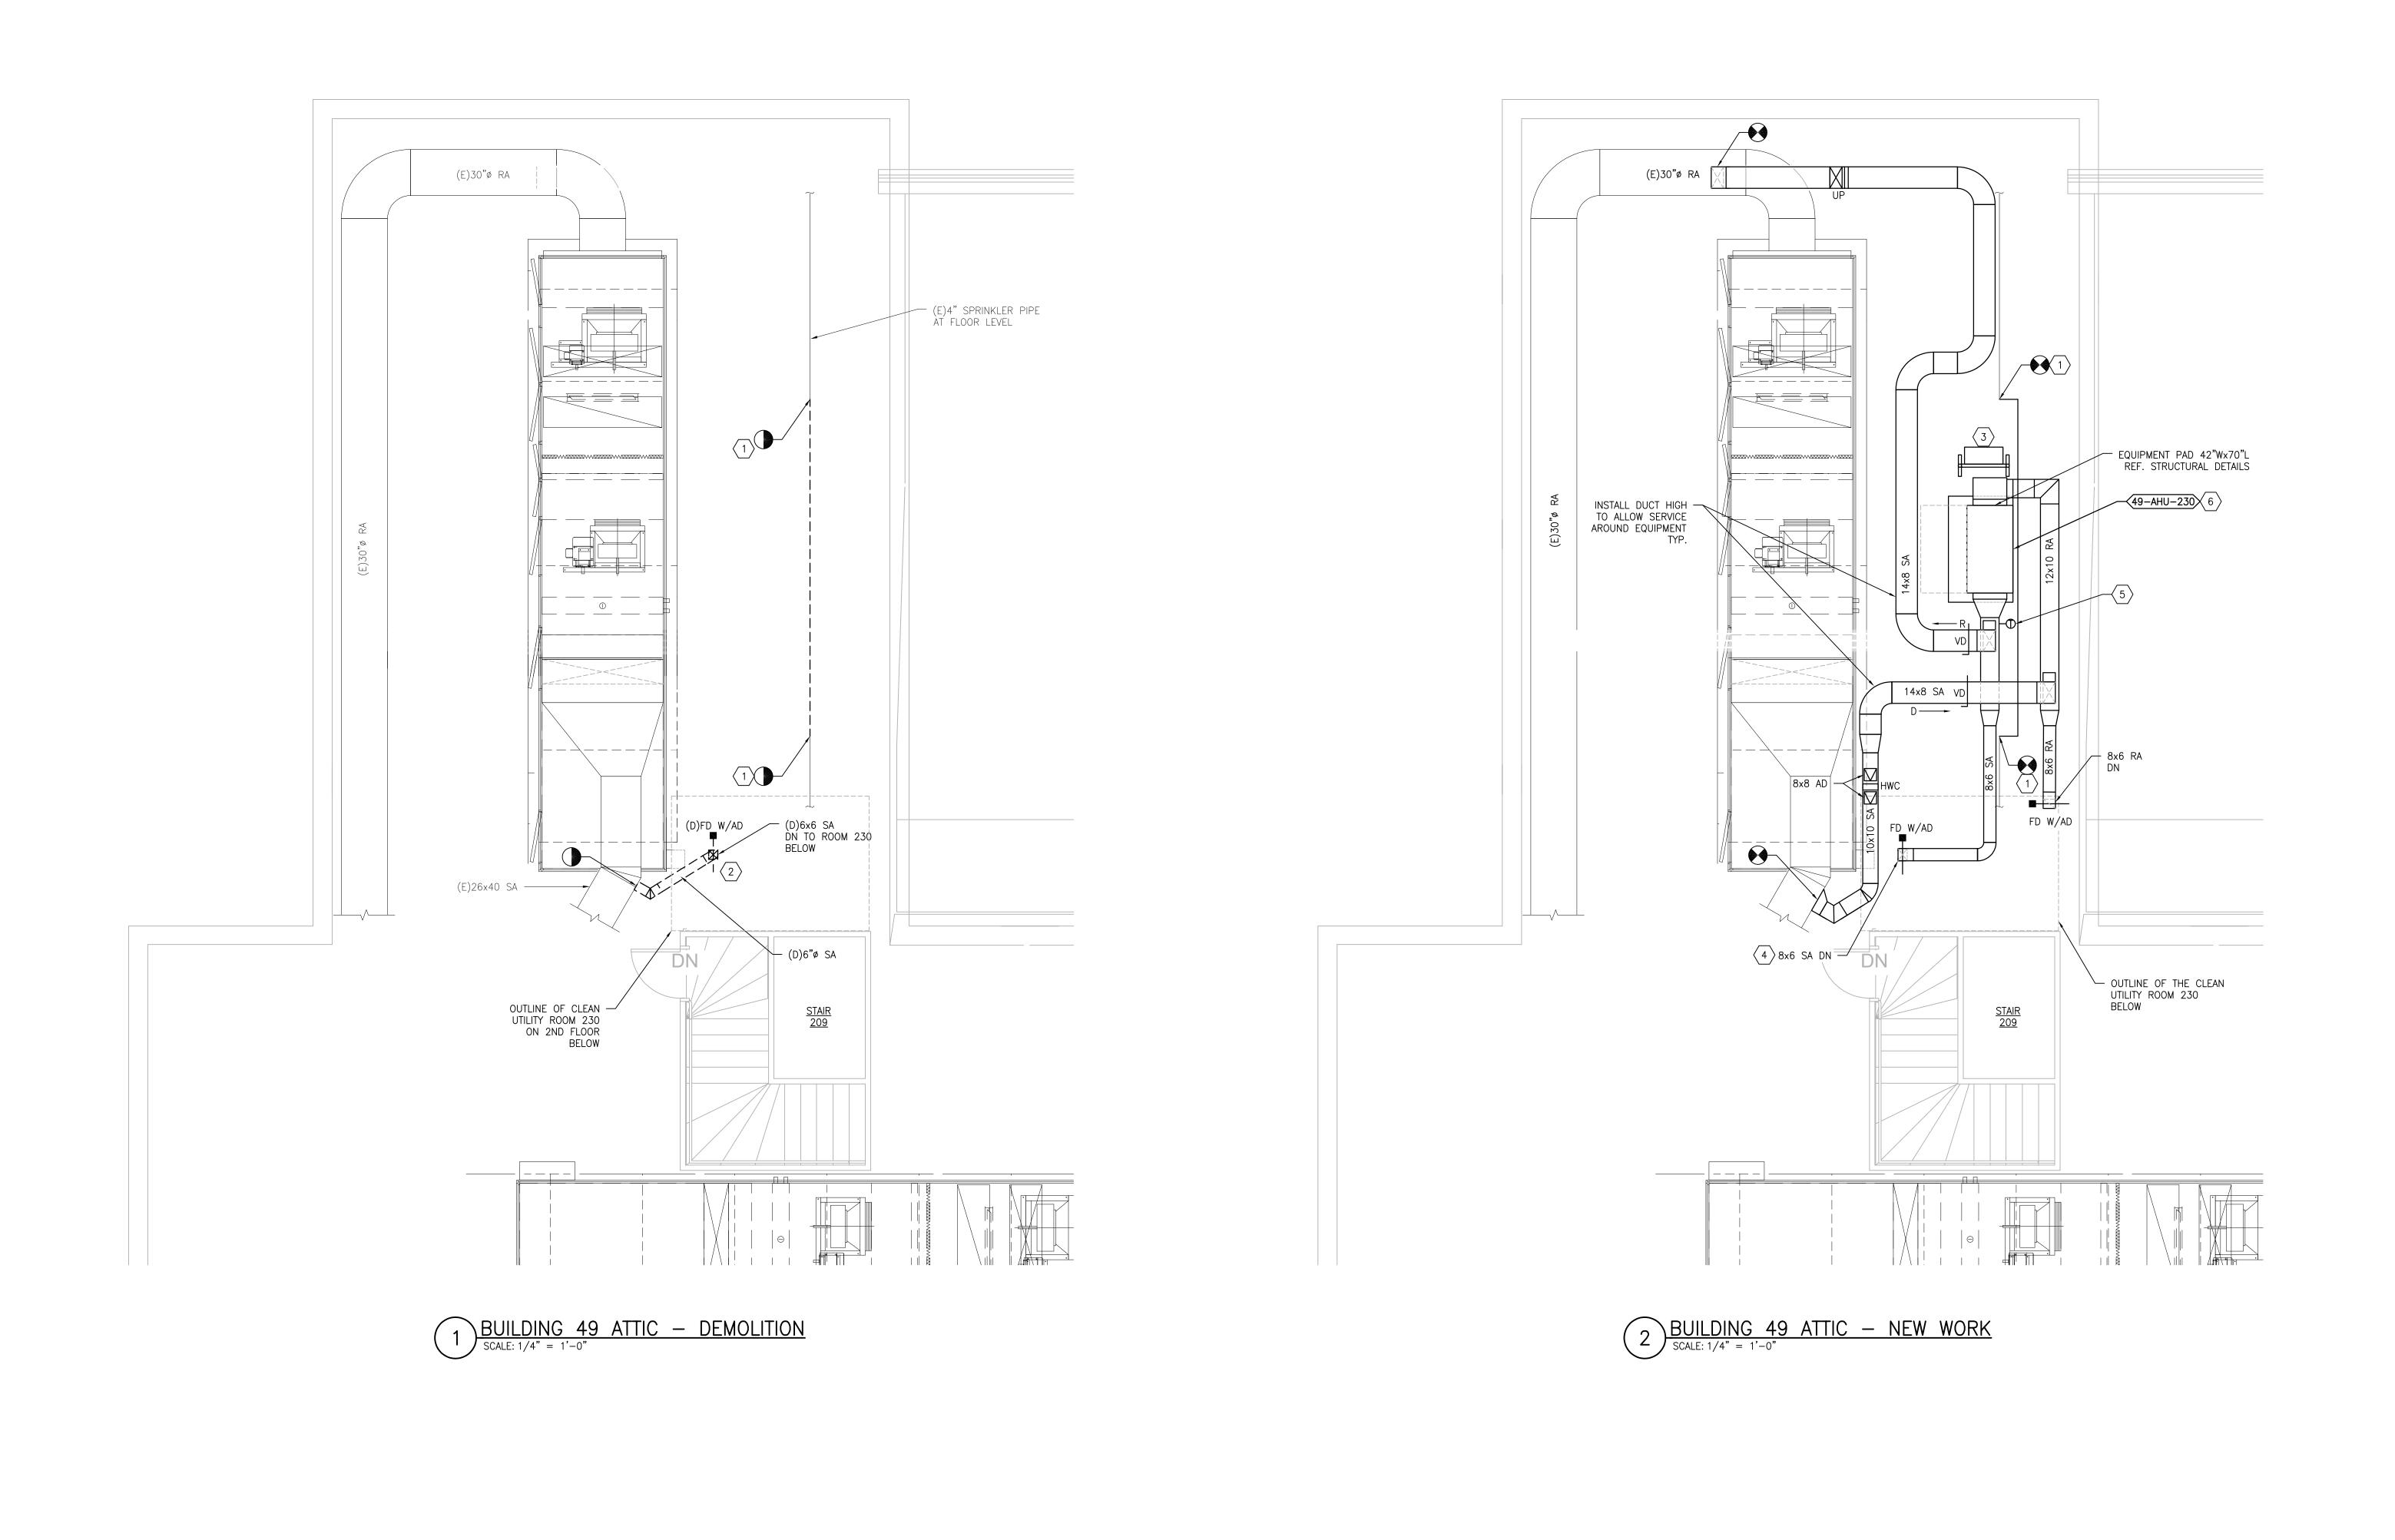

VA FORM 08-6231

# **GENERAL SHEET NOTES:**

ADDITIONAL INFORMATION.


TESTING AND BALANCING REQUIREMENTS.

- 1. REFERENCE SPECIFICATION 02 82 11 APPENDIX A1 FOR ABATEMENT REPORT. CONTRACTOR TO ADHERE TO AND FOLLOW REPORT FOR ALL KNOW ABATEMENT
- LOCATIONS.

  2. COORDINATE INSTALLATION OF NEW PIPING AND NEW DUCTWORK.
- ALL LOCATIONS FOR DUCTWORK AND PIPING ARE APPROXIMATE. PROVIDE OFFSETS AS
  REQUIRED TO AVOID EXISTING OBSTACLES. RELOCATE EXISTING HANGERS AND
  COMPONENTS AS REQUIRED TO ALLOW FOR INSTALLATION OF NEW EQUIPMENT AND
  COMPONENTS.
- 4. ALL WALL PENETRATIONS TO BE TREATED AS AN 1 HOUR RATED WALL UNLESS OTHERWISE NOTED ON THE DRAWING. REPAIR AND PAINT THE WALLS/CEILING TO MATCH EXISTING CONDITIONS AFTER THE REMOVAL OF THE EXISTING EQUIPMENT OR INSTALLATION OF NEW WORK.
- 5. MODIFY SPRINKLER PIPING IF REQUIRED TO INSTALL NEW WORK. INSTALL AND SUPPORT PIPING PER NFPA 99, SPECIFICATIONS AND DRAWINGS.
- 6. MAINTAIN SERVICE CLEARANCE ON NEW AND EXISTING EQUIPMENT. REFER TO MECHANICAL DRAWINGS AND MANUFACTURER'S INSTALLATION MANUALS FOR ADDITIONAL INFORMATION.
- 7. ADHERE TO ALL ICRA REQUIREMENTS LISTED IN THE ARCHITECTURAL SET. THE ICRA LEVEL HAS BEEN DEFINED BY THE VA AS LEVEL 3 UNLESS OTHERWISE INDICATED. PROTECT ALL EQUIPMENT IN THE ROOM FROM DUST, DEBRIS AND PHYSICAL DAMAGE AT ALL TIMES.
- 8. AVOID ALL CEILING OR WALL MOUNTED DEVICES (I.E. SIGNAGE, LIGHT FIXTURE, NURSE CALL) WHEN LOCATING ICRA BARRIERS. WHEN EXISTING DEVICE(S) CANNOT BE AVOIDED, TEMPORARILY RELOCATE THE DEVICE(S) AND REINSTALL AFTER WORK IS COMPLETED AS
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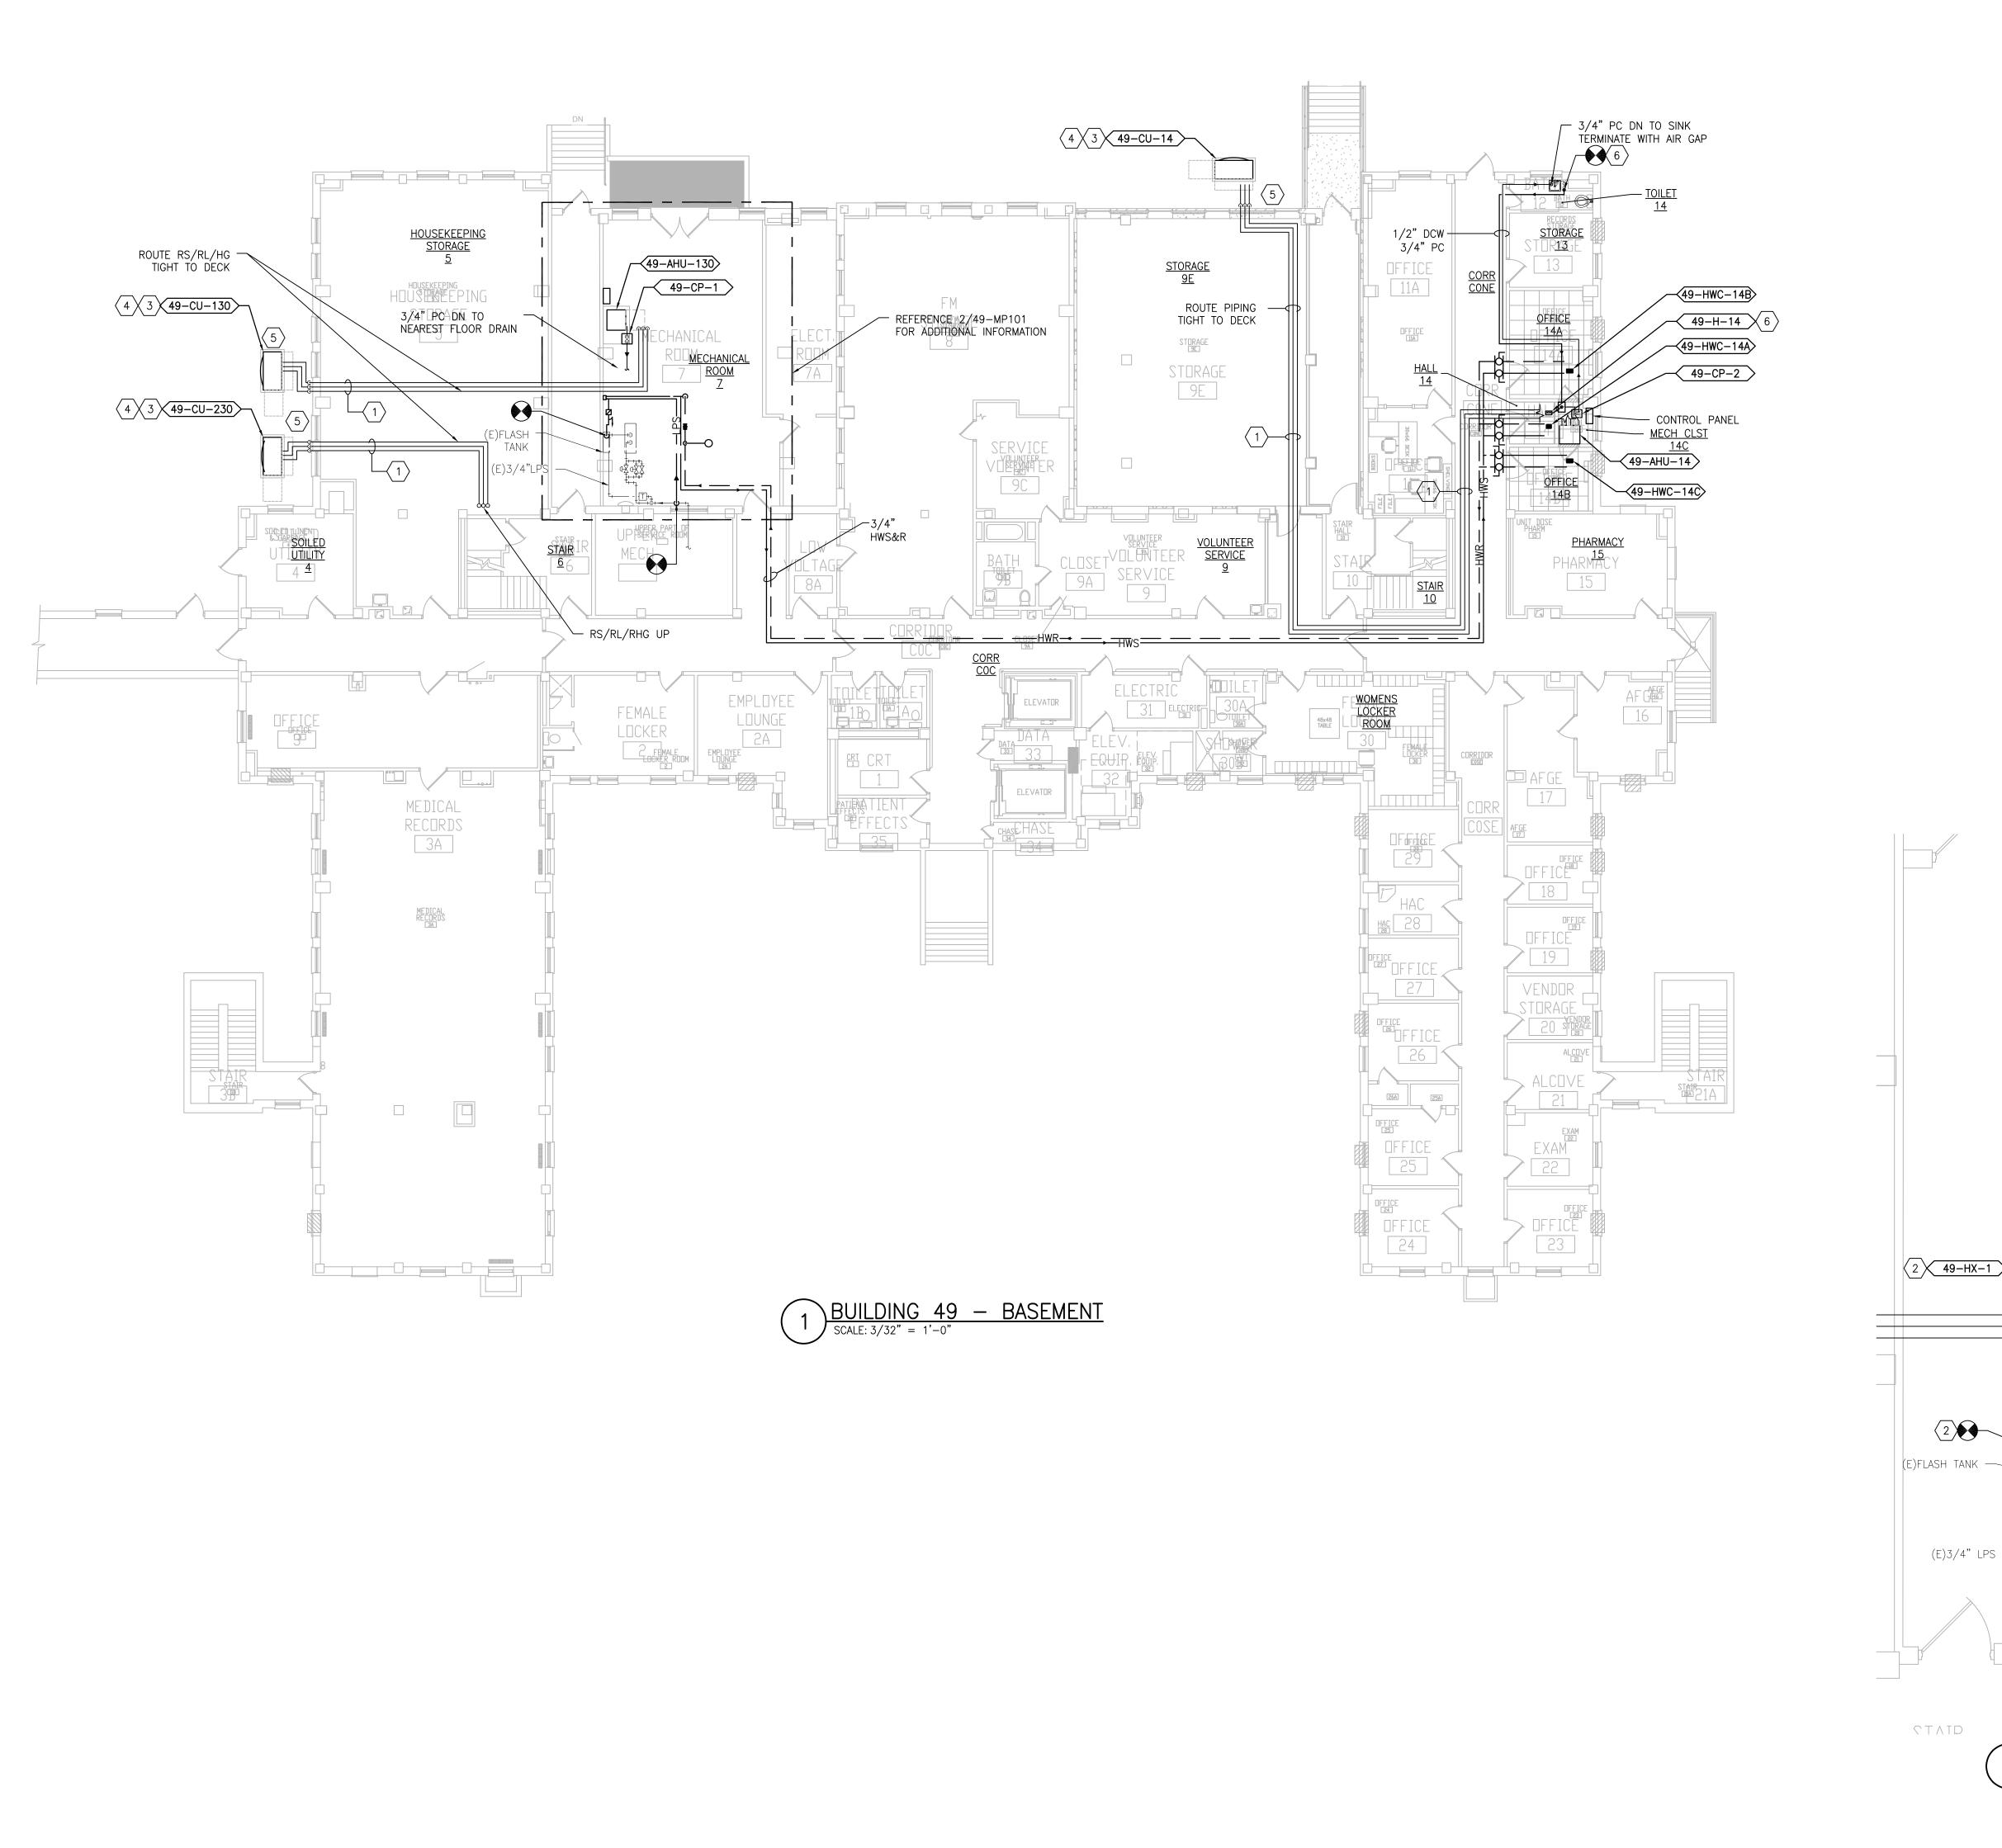
  9. REMOVE AND REPLACE EXISTING CEILINGS REFER TO THE ARCHITECTURAL DRAWING FOR
- 10. TAKE PREDEMOLITION READINGS OF ALL ROOM AIR INLETS AND OUTLETS OF ANY SYSTEM THE WILL BE MODIFIED AND SUBMIT TO THE VA AND ENGINEER FOR RECORD PRIOR TO STARTING ANY NEW WORK. BALANCE THE NEW SYSTEMS AND REBALANCE THE EXISTING ASSOCIATED AHU SYSTEM TO THE NEW AIR QUANTITIES. AFTER THE NEW WORK IS COMPLETE REBALANCE THE EXISTING SYSTEM, AS REQUIRED, AND MEASURE ALL ROOM AIR INLETS AND OUTLETS TO VERIFY THAT THE PREDEMOLITION AIRFLOWS HAVE BEEN MAINTAINED. SUBMIT FOR APPROVAL. REFERENCE SPECIFICATIONS FOR
- 11. ALL DUCTWORK PENETRATIONS SHALL BE SAW CUT. REFERENCE STRUCTURAL DRAWINGS FOR DETAILS.
- 13. CONTRACTOR CANNOT START ANY WORK PER SYSTEM (AHU) UNTIL THE COORDINATED SHOP DRAWINGS AND PRODUCT SUBMITTALS HAVE BEEN APPROVED BY THE ENGINEER.

  SHEET KEYNOTES:
- 1. DEMOLISH SPRINKLER PIPE AND REROUTE TO ALLOW INSTALLATION OF (N)AHU'S, PIPING, DUCTWORK AND CONTROL PANELS. REFERENCE DRAWING 49—MP131 FOR ADDITIONAL INFORMATION AND COORDINATION.
- 2. DEMOLISH DUCTWORK, HANGERS AND ALL APPURTENANCES TYPICAL. PATCH EXISTING WALL OPENING WITH MATCHING MATERIALS AS REQUIRED OR REUSE EXISTING WALL OPENING AS
- 3. MOUNT CONTROL PANEL ON UNISTRUT FRAME. COORDINATE WITH (E)ROOM CONDITIONS FOR FINAL LOCATION.
- 4. ENLARGE THE EXISTING OPENING TO ALLOW INSTALLATION OF NEW SUPPLY DUCT AND FIRE DAMPER. COORDINATE WITH CLEAN UTILITY ROOM 230 BELOW.
- 5. DISCHARGE AIR TEMPERATURE SENSOR FURNISHED BY AHU MANUFACTURER.
- 6. REFERENCE 2/M-504 FOR ADDITIONAL AHU INFORMATION. 8" SUPPLEMENTAL STEEL NOT REQUIRED FOR THIS INSTALLATION.

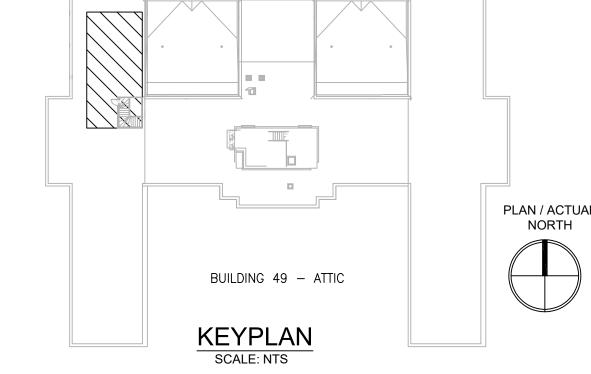

Project Title PRINTS OF THIS DRAWING SHALL NOT BE USED FOR ANY PURPOSE WHATSOEVER WITHOUT THE SEAL AND SIGNATURE OF THE Drawing Title Project Number ENGINEER OF RECORD MILLER-REMICK LLC Office of 656-18-300 **MECHANICAL** 100% CONSTRUCTION PROFESSIONAL ENGINEER UPGRADE SPS HVAC & PROFESSIONAL ENGINEER. DOCUMENTS NOT FOR CONSTRUCTION DEMOLITION / NEW WORK PLAN Miller-Remick LLC

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VA FORM 08-6231

DESCRIPTION

DATE

# **GENERAL SHEET NOTES:**

- 1. REFERENCE SPECIFICATION 02 82 13.13 FOR ABATEMENT WORK. THE VA TO PROVIDE APPLICABLE ABATEMENT REPORT.
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- AVOIDED, TEMPORARILY RELOCATE THE DEVICE(S) AND REINSTALL AFTER WORK IS COMPLETED AS APPROVED BY THE COR. 8. REMOVE AND REPLACE EXISTING CEILINGS REFER TO THE ARCHITECTURAL DRAWING FOR


CALL) WHEN LOCATING ICRA BARRIERS. WHEN EXISTING DEVICE(S) CANNOT BE

- ADDITIONAL INFORMATION. 9. NOT ALL PIPING COMPONENTS ARE SHOWN. REFER TO DETAILS AND SPECIFICATIONS
- FOR ALL REQUIRED VALVES, UNIONS, GAUGES, STRAINERS ETC. 10. ALL PIPING PENETRATIONS SHALL BE CORE DRILLED. REFERENCE STRUCTURAL DRAWINGS FOR DETAILS.
- 11. INSTALLING CONTRACTOR IS RESPONSIBLE FOR PROVIDING AND INSTALLING THE REFRIGERATION PIPING IN ACCORDANCE WITH THE MANUFACTURER'S GUIDELINES. THE CONTRACTOR IS TO PROVIDE DETAILED PIPING LAYOUT TO THE MANUFACTURER FOR PIPE SIZING AND OTHER REQUIREMENTS. FINAL SHOP DRAWING APPROVAL IS BY THE ENGINEER. THE INSTALLING CONTRACTOR IS RESPONSIBLE FOR LEAK CHECKS, EVACUATION AND INITIAL REFRIGERATION CHARGE. THE INSTALLING CONTRACTOR SHALL PROVIDE EXTRA REFRIGERANT TO THE FACTORY START-UP TECHNICIAN FOR FINAL REFRIGERANT CHARGE. THE INSTALLING CONTRACTOR IS RESPONSIBLE FOR WIRING AND COMMUNICATIONS BETWEEN AHU'S AND CONDENSING UNITS.
- 12. CONTRACTOR CANNOT START ANY WORK PER SYSTEM (AHU) UNTIL THE COORDINATED SHOP DRAWINGS AND PRODUCT SUBMITTALS HAVE BEEN APPROVED BY THE ENGINEER.

#### 

- 1. MINIMUM PIPE SIZES FOR UP TO 50 EQUIVALENT FT. INCREASE PIPE SIZES AS REQUIRED TO ACCOMMODATE THE ACTUAL ROUTING:
- SUCTION LINE 5/8" ø
- LIQUID LINE 3/8" ø
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- PUMPED CONDENSATE 3/4" ø
- MINIMUM PIPE SIZES FOR OVER 60 EQUIVALENT FT. INCREASE PIPE SIZES AS
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- INSTALL AND INSULATE PIPING ACCORDING TO SPECIFICATIONS AND AHU MANUFACTURER RECOMMENDATIONS. VERIFY PIPE SIZING WITH AHU MANUFACTURER. PIPING MUST BE SIZED TO MEET THE ACTUAL INSTALLATION CONDITIONS. INSTALL SUCTION LINE ACCUMULATOR AND 1/8" CAPILLARY TUBING FOR PURGE CIRCUIT. SEE
- 2. MOUNT HEAT EXCHANGER HIGH ON WALL TO ALLOW CONDENSATE TO DRAIN BY GRAVITY BACK TO EXISTING FLASH TANK.
- 3. MAINTAIN 6'-0" MINIMUM IN ALL DIRECTIONS FROM THE BUILDING TO PROTECT AGAINST FALLING SNOW AND ICE.
- 4. CONDENSING UNIT IS SUPPORTED BY DUNNAGE 3'-0" ABOVE GRADE. PROVIDE
- EXTERIOR PIPING STRUCTURAL COVER. REFER TO STRUCTURAL DRAWINGS FOR DUNNAGE AND PIPE COVER DETAILS.
- 5. PIPING TO PENETRATE WALL HIGH AND DROP DOWN THE EXTERIOR WALL AND EXTEND ABOVE GRADE TO THE CONDENSING UNIT. PENETRATION TO BE WEATHER TIGHT.
- 6. FOLLOW DETAIL 8/M-503 FOR PIPING REQUIREMENTS.

AHU MANUFACTURER'S INSTALLATION INSTRUCTIONS.

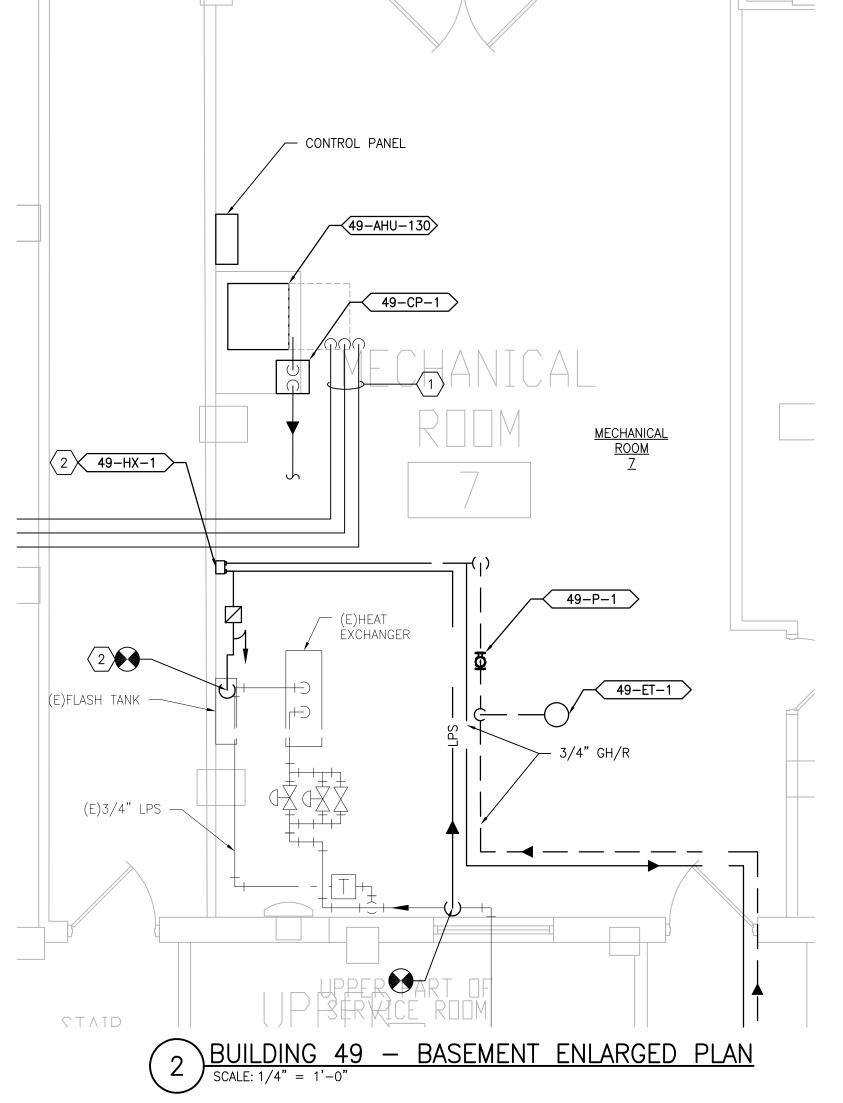




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1, 2, 3, 28, 29, 49, 50, 51, 111, 116 DOCUMENTS PIPING PLANS Miller-Remick LLC

M.E.P. & Structural Engineering

A Service Disabled Veteran Owned

Small Business Construction **ENVIRONMENTAL CONTROLS** NOT FOR CONSTRUCTION BASEMENT - BUILDING 49 and Facilities MEP Engineers + Architects 1173 Research Way 701 Forest Ave Portland, ME 04103 Management Approved: Project Director Drawing Number Forest, VA 24551 1-866-267-6839 1010 KINGS HIGHWAY SOUTH CHERRY HILL, NEW JERSEY 08034 (207) 828-4511 ST. CLOUD VA MEDICAL CENTER, MN **FULLY SPRINKLERED** PHONE: (856)429-4000 Checked 49-MP101 Drawn FAX: (856)429-5002 U.S. Department of Veterans Affairs MR BJS MR PROJECT NO: 0376-0011 2022-07-15

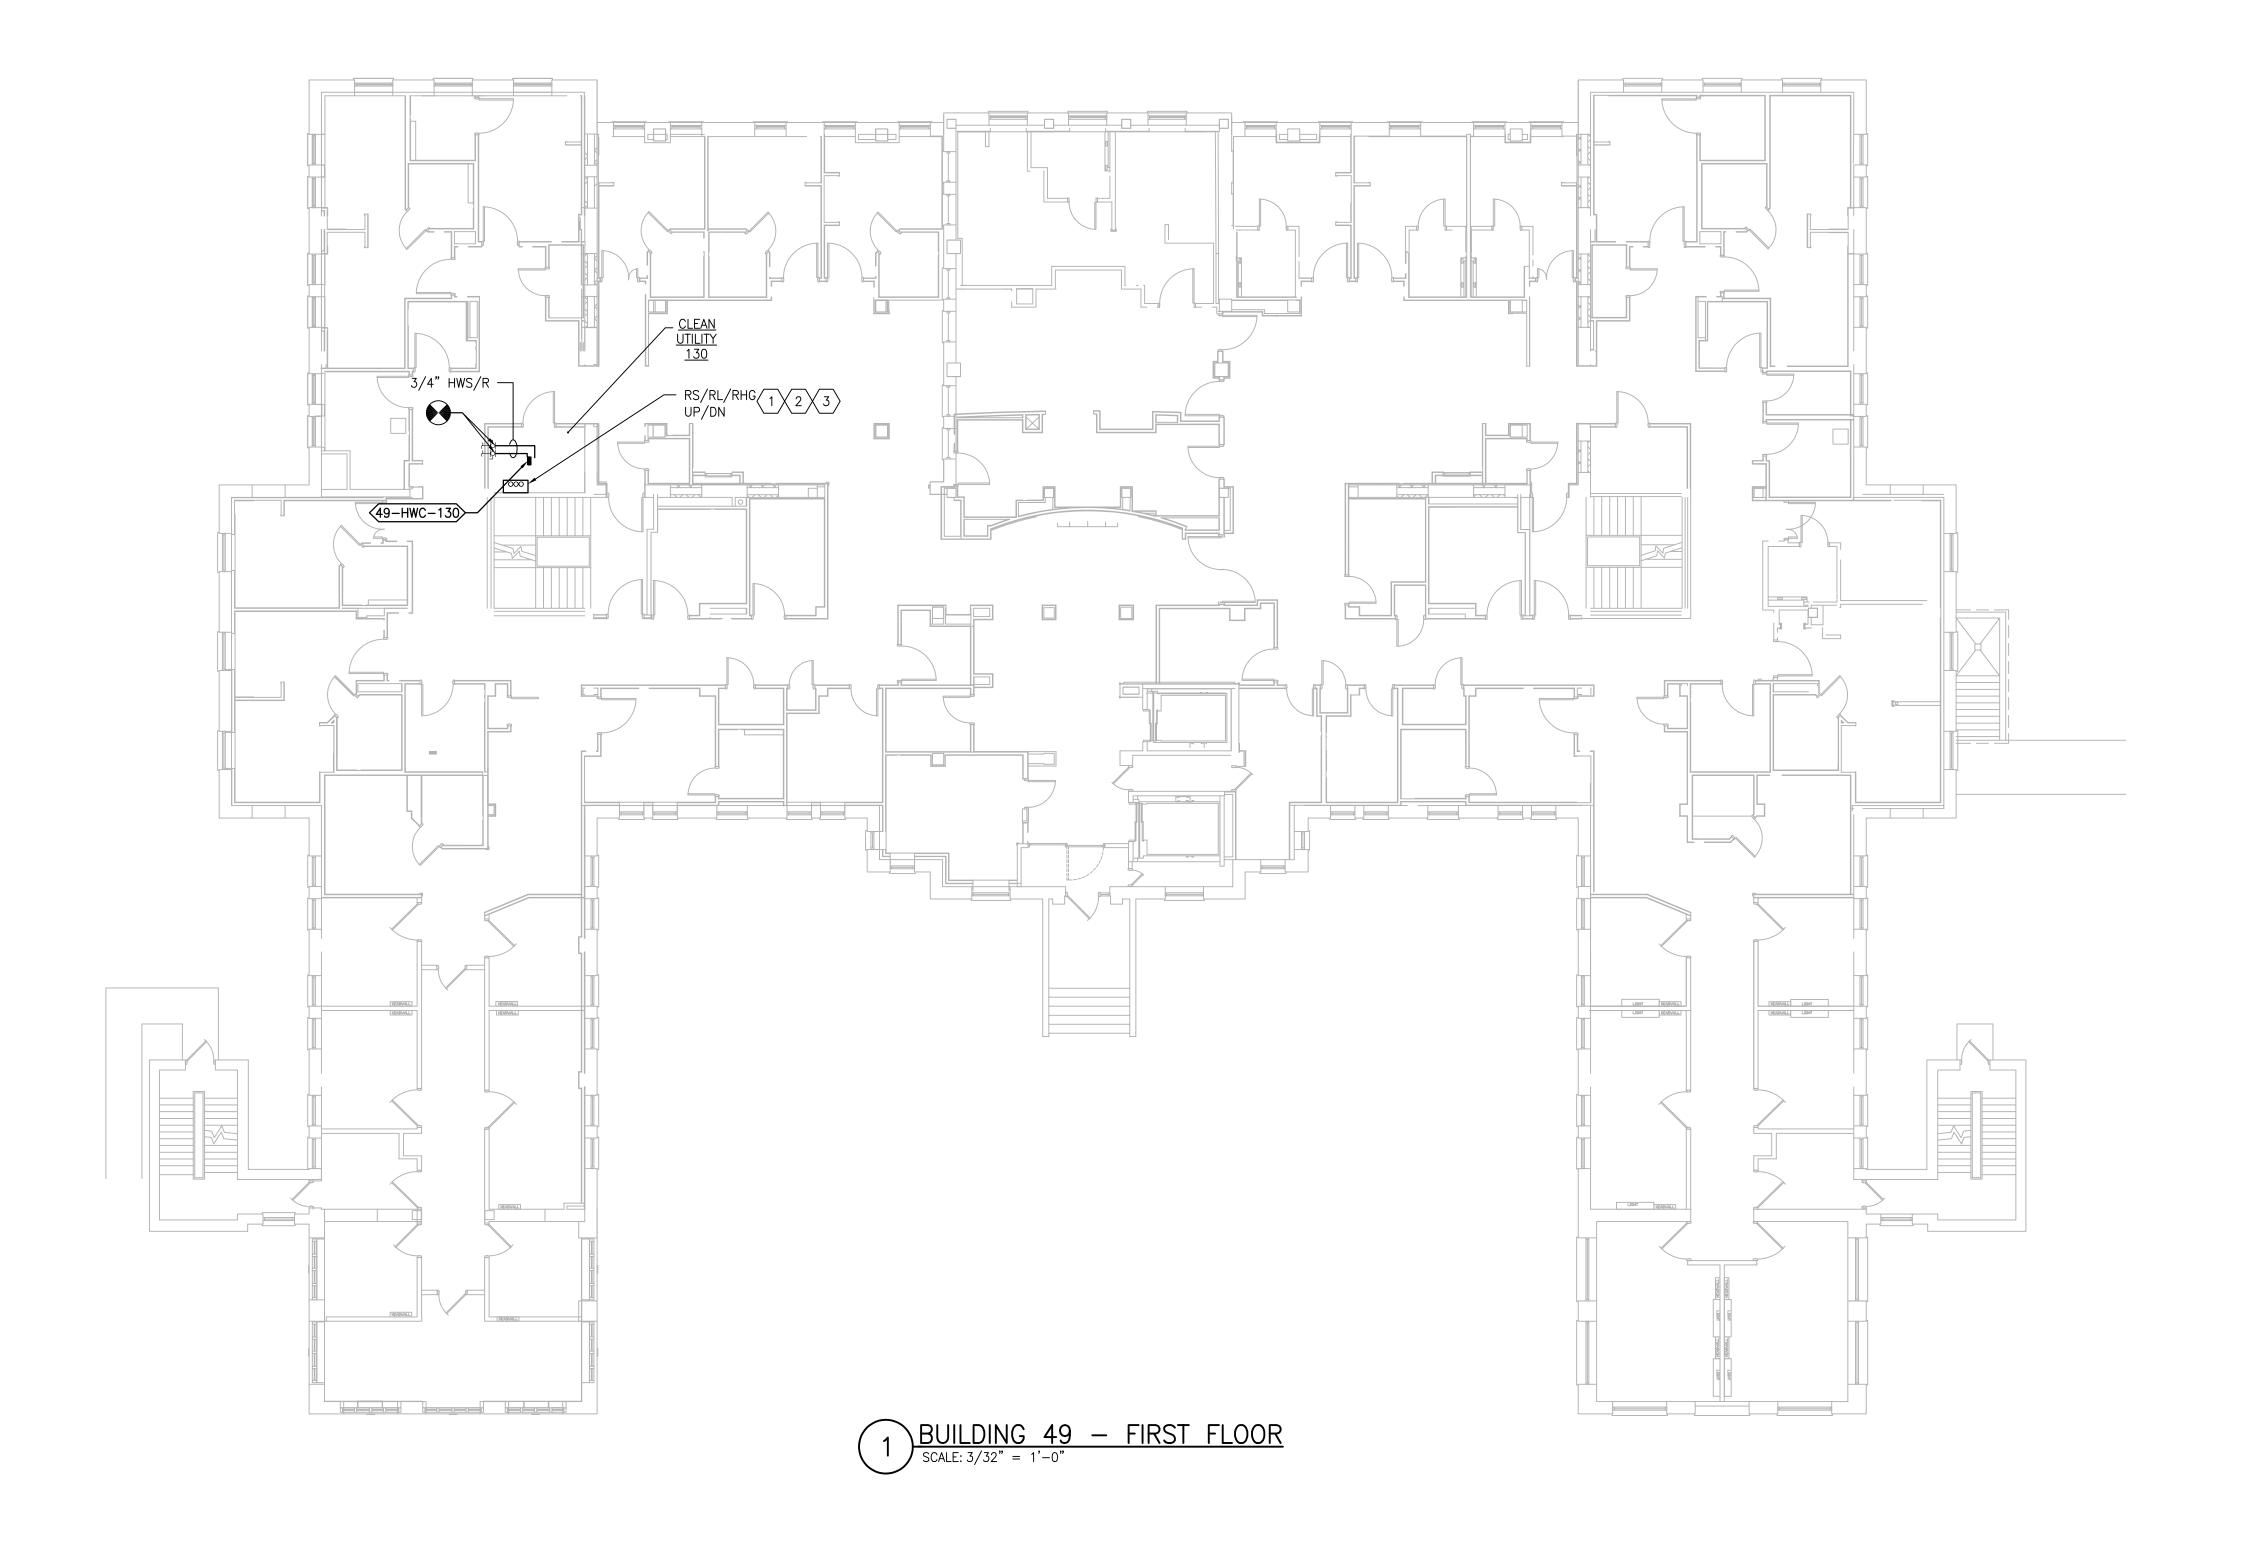

- 1. REFERENCE SPECIFICATION 02 82 13.13 FOR ABATEMENT WORK. THE VA TO PROVIDE APPLICABLE ABATEMENT REPORT.
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- MINIMUM PIPE SIZES FOR OVER 60 EQUIVALENT FT. INCREASE PIPE SIZES AS REQUIRED TO ACCOMMODATE THE ACTUAL ROUTING:
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- COORDINATE (N)PIPING WITH (E)WALL BUMP OUT AND (E)PIPING. (N) PIPING WILL BE REQUIRED TO OFFSET IN CEILING TO PASS THROUGH UNOBSTRUCTED.
- 3. REFERENCE ARCHITECTURAL DRAWINGS FOR ENCLOSURE DETAILS.

AHU MANUFACTURER'S INSTALLATION INSTRUCTIONS.

PLAN / ACTUAL NORTH

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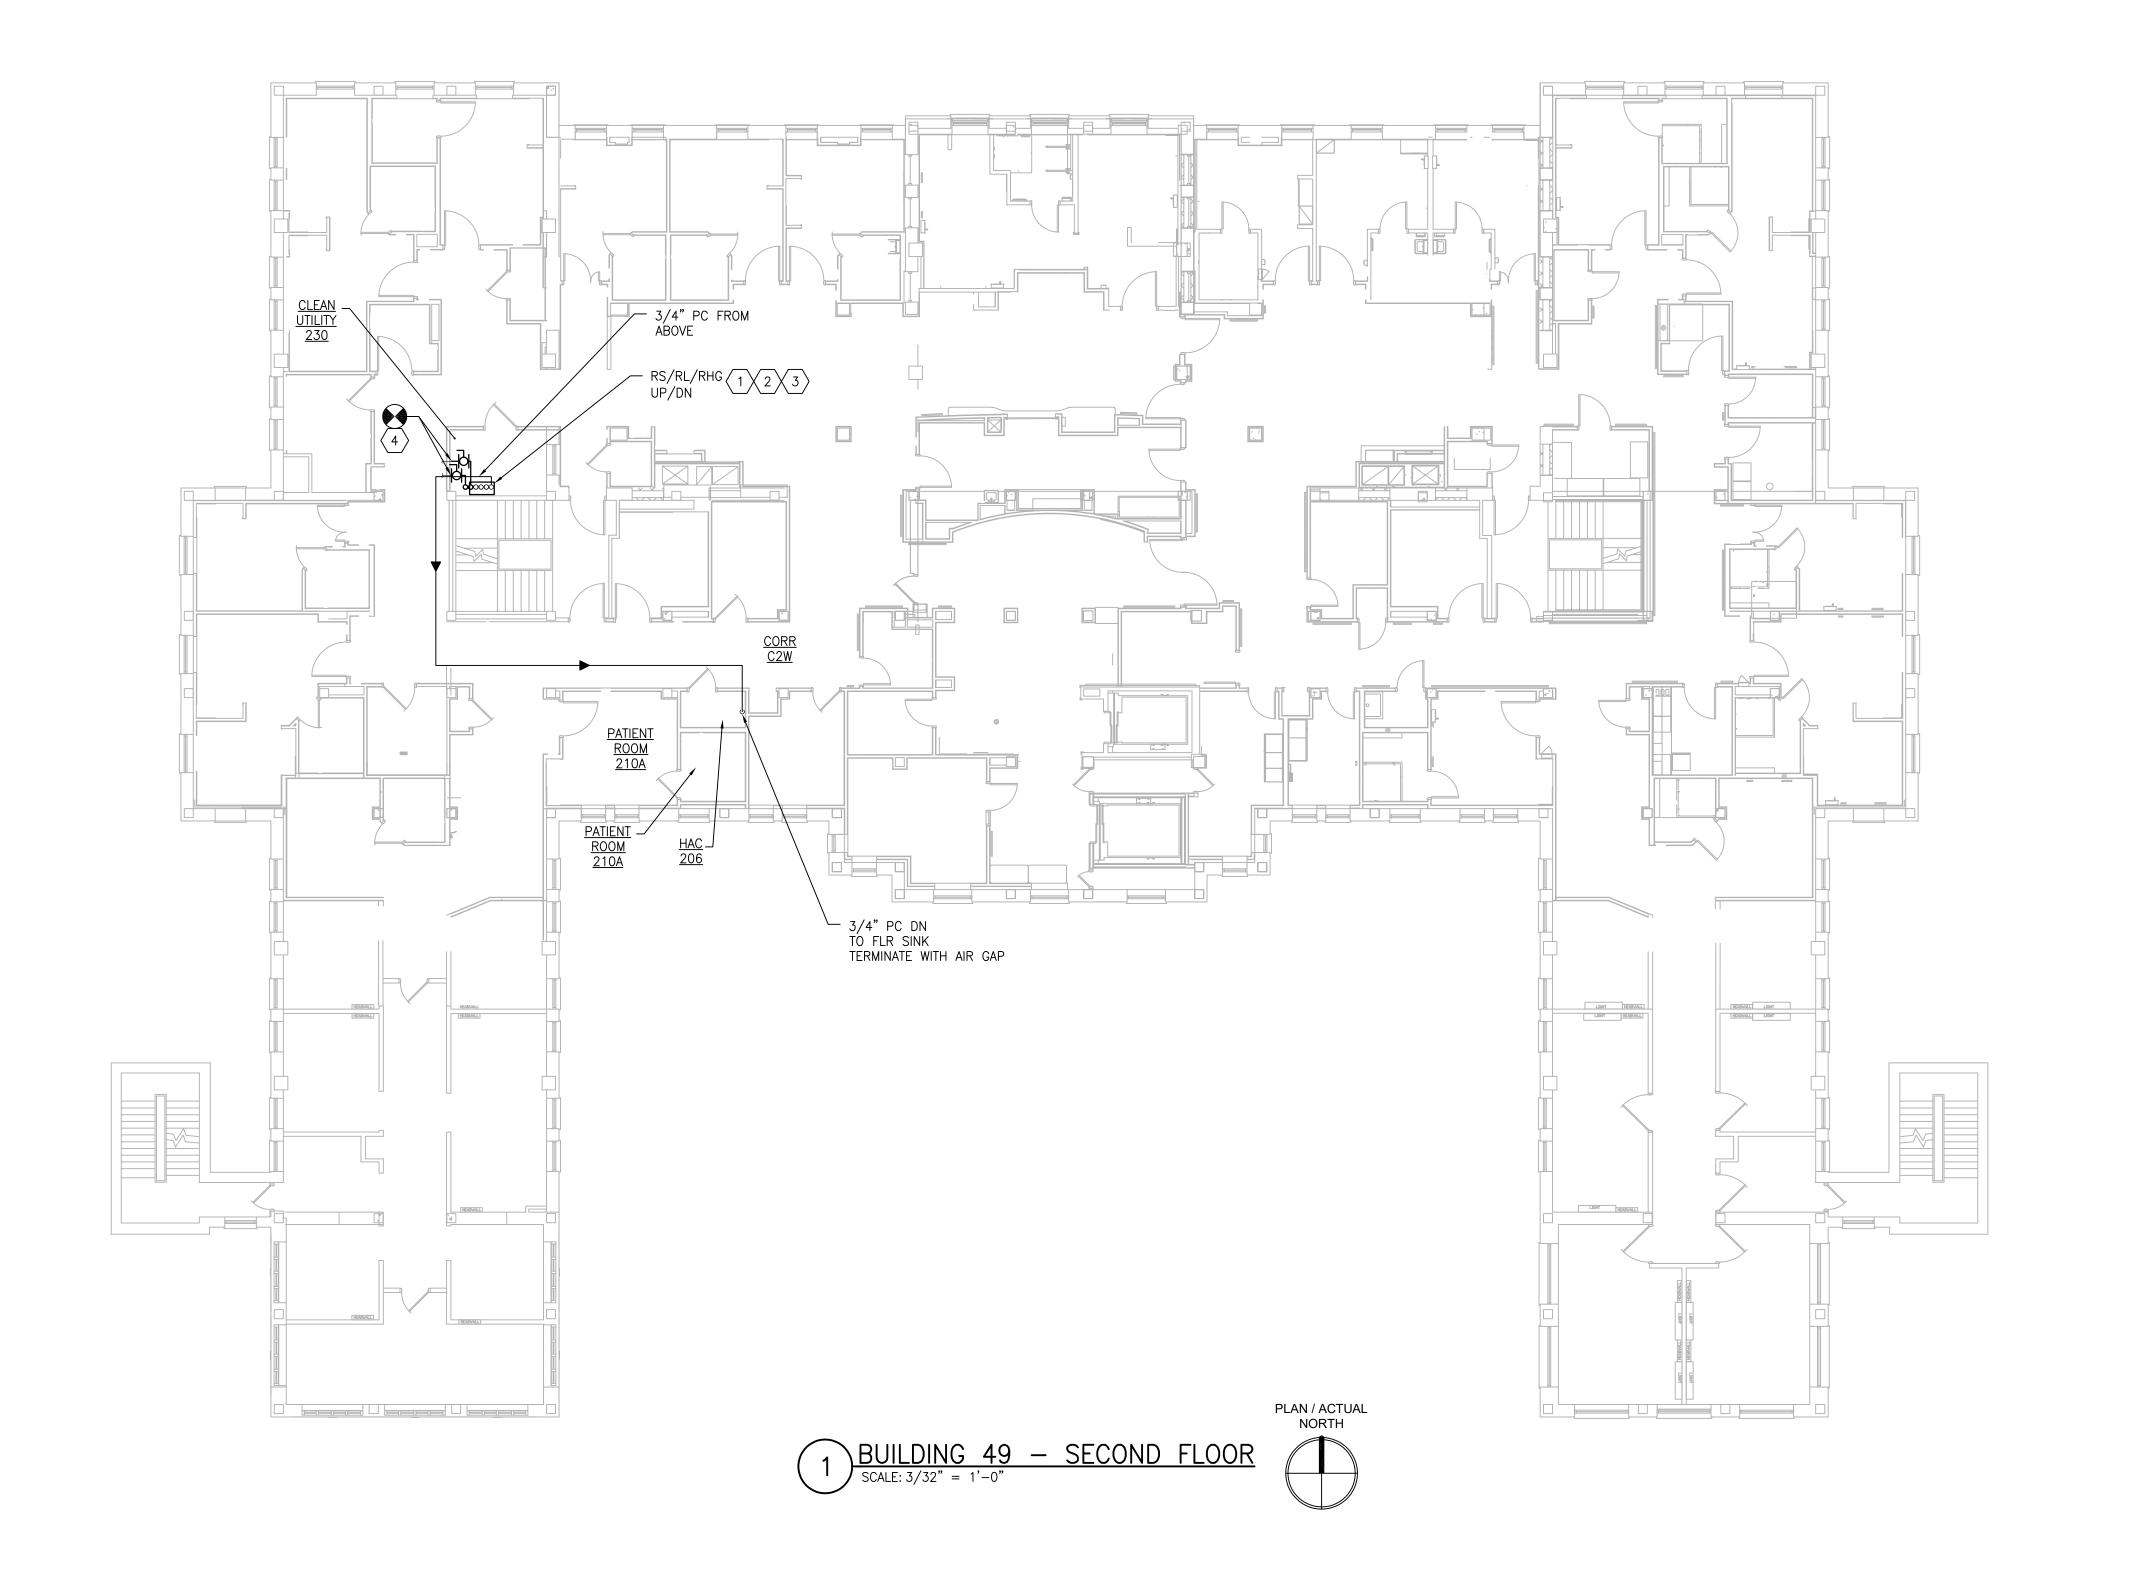
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VA FORM 08-6231

DESCRIPTION



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- 4. CONNECT (E)HWS&R PIPING TO (N)3/4" HWS&R PIPING. RUN PIPING UP TO ATTIC ABOVE AND CONNECT TO (N)49-HWC-5 HOT WATER COIL.

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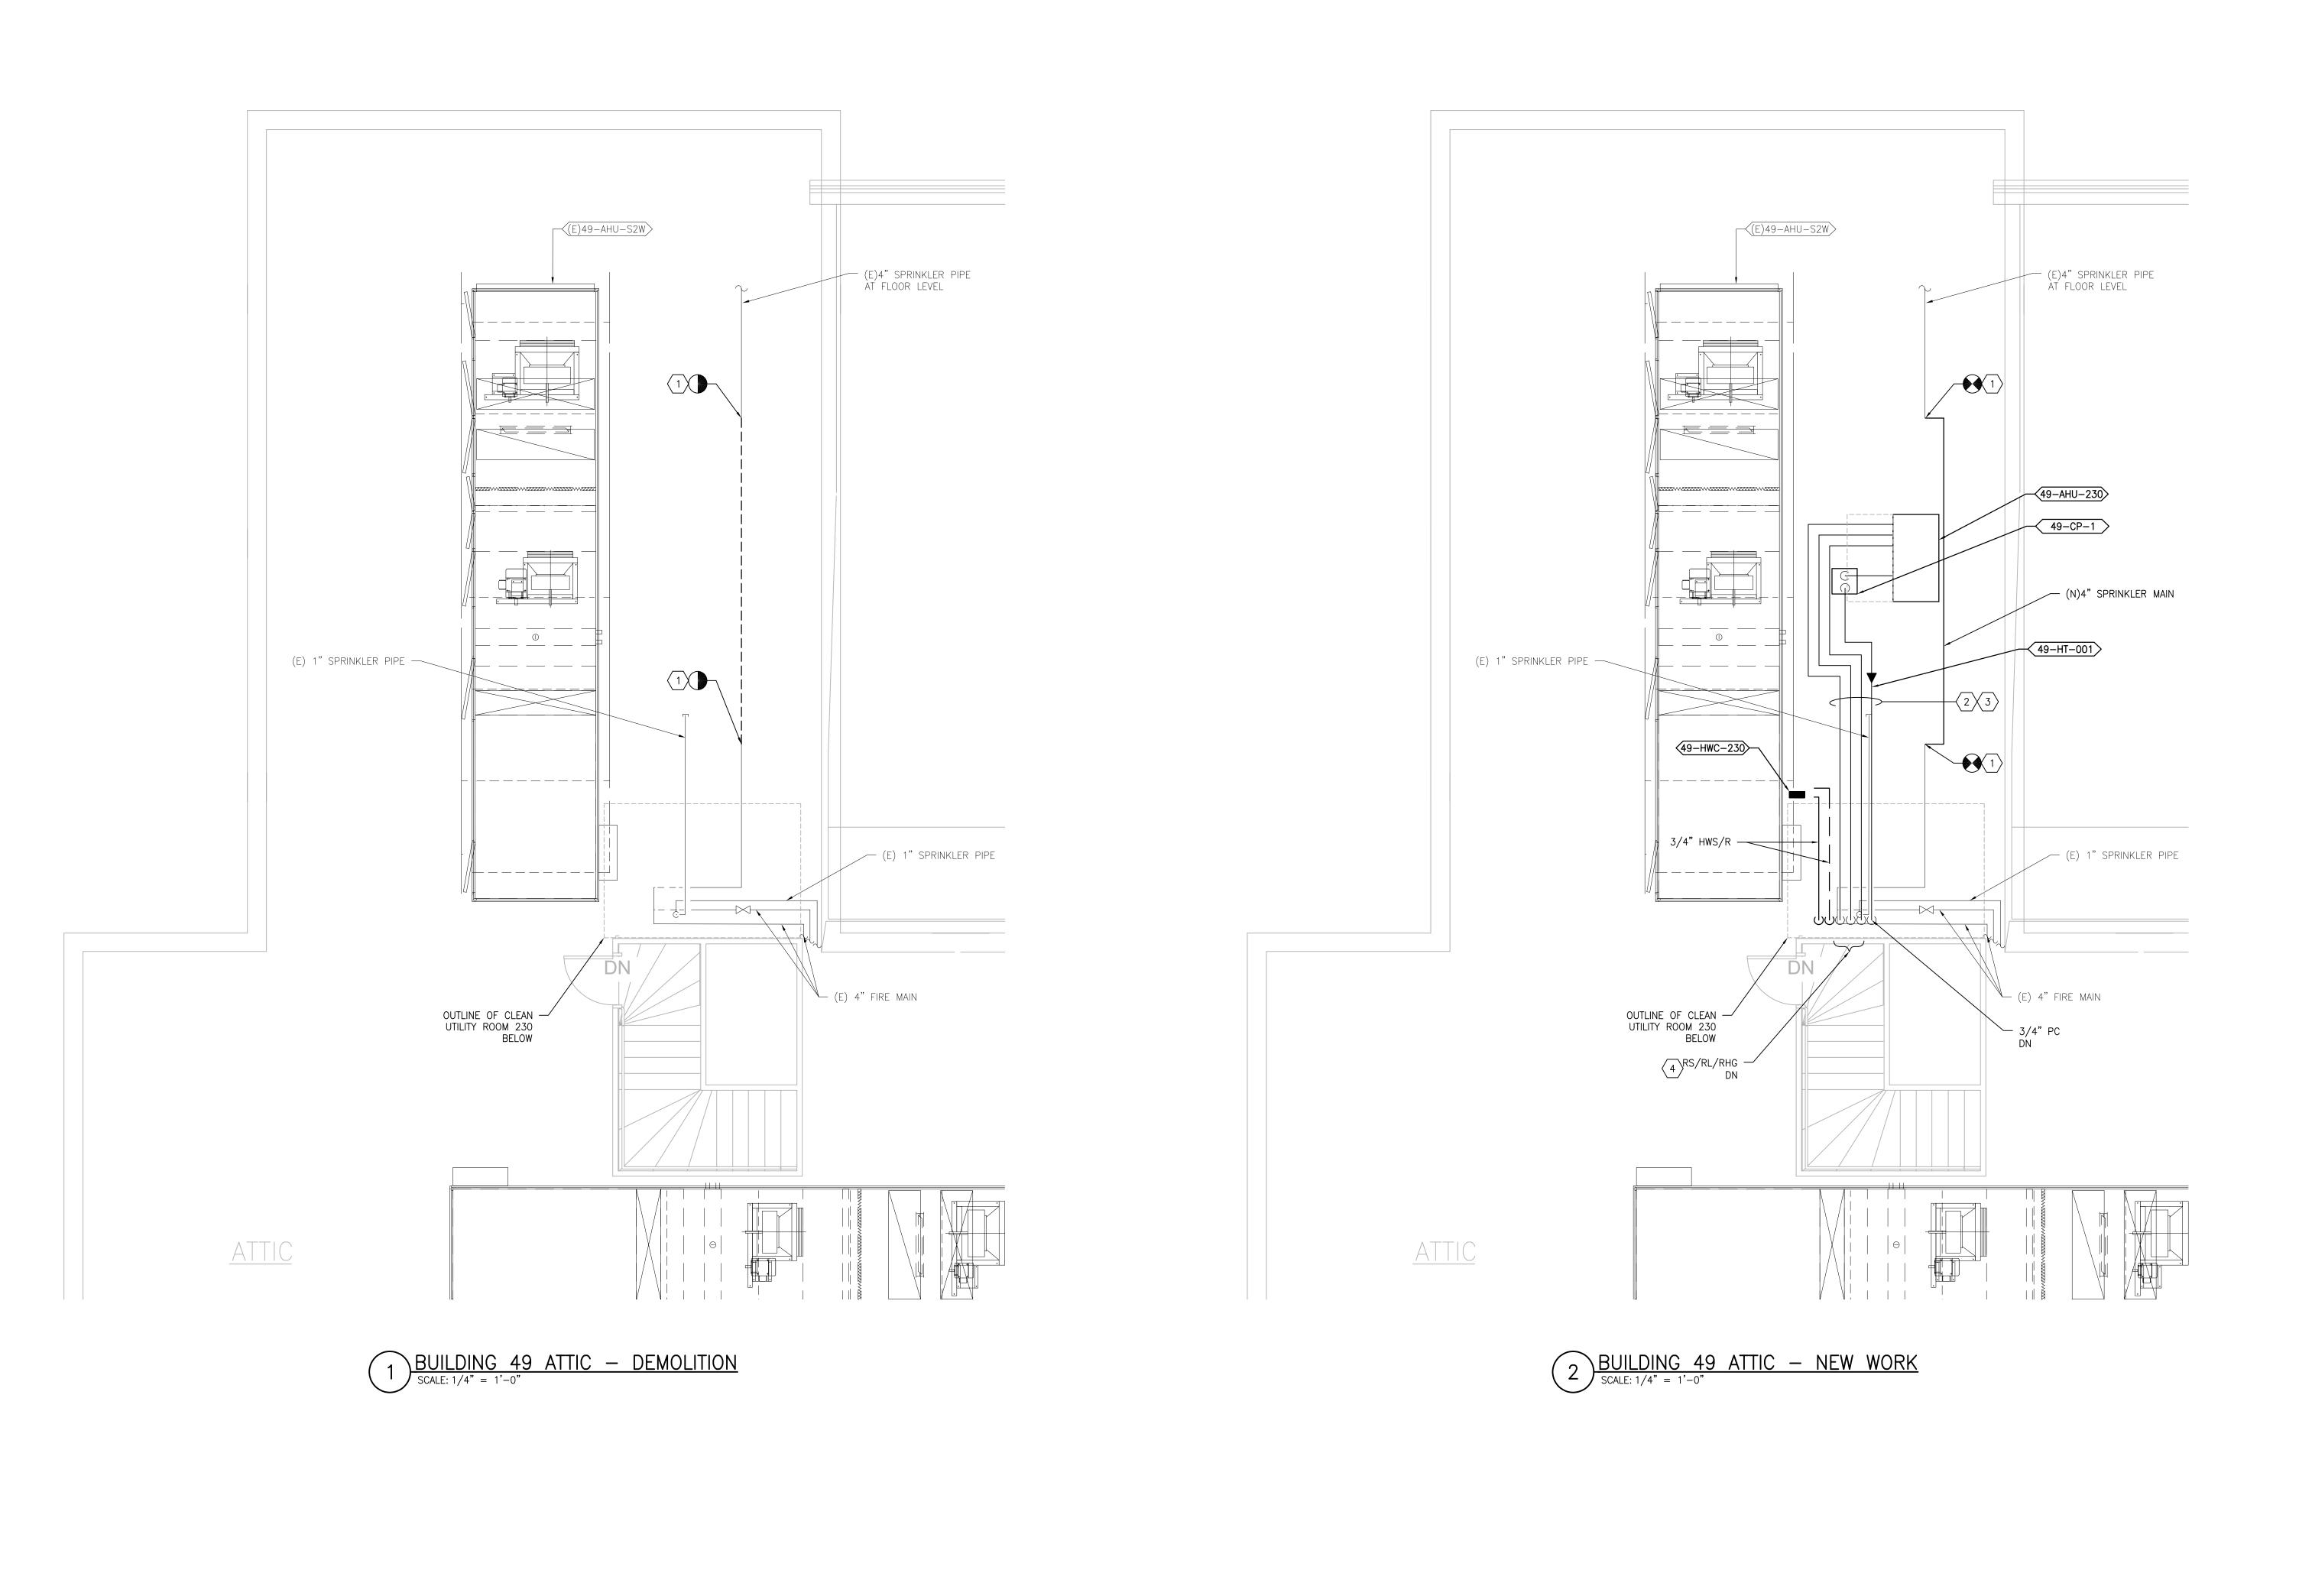
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CALL) WHEN LOCATING ICRA BARRIERS. WHEN EXISTING DEVICE(S) CANNOT BE

COMPLETED AS APPROVED BY THE COR.

8. REMOVE AND REPLACE EXISTING CEILINGS REFER TO THE ARCHITECTURAL DRAWING FOR

AVOIDED, TEMPORARILY RELOCATE THE DEVICE(S) AND REINSTALL AFTER WORK IS

- 9. NOT ALL PIPING COMPONENTS ARE SHOWN. REFER TO DETAILS AND SPECIFICATIONS FOR ALL REQUIRED VALVES, UNIONS, GAUGES, STRAINERS ETC.
- 10. ALL PIPING PENETRATIONS SHALL BE CORE DRILLED. REFERENCE STRUCTURAL DRAWINGS FOR DETAILS.

COMMUNICATIONS BETWEEN AHU'S AND CONDENSING UNITS.


- 11. INSTALLING CONTRACTOR IS RESPONSIBLE FOR PROVIDING AND INSTALLING THE REFRIGERATION PIPING IN ACCORDANCE WITH THE MANUFACTURER'S GUIDELINES. THE CONTRACTOR IS TO PROVIDE DETAILED PIPING LAYOUT TO THE MANUFACTURER FOR PIPE SIZING AND OTHER REQUIREMENTS. FINAL SHOP DRAWING APPROVAL IS BY THE ENGINEER. THE INSTALLING CONTRACTOR IS RESPONSIBLE FOR LEAK CHECKS, EVACUATION AND INITIAL REFRIGERATION CHARGE. THE INSTALLING CONTRACTOR SHALL PROVIDE EXTRA REFRIGERANT TO THE FACTORY START—UP TECHNICIAN FOR FINAL REFRIGERANT CHARGE. THE INSTALLING CONTRACTOR IS RESPONSIBLE FOR WIRING AND
- 12. CONTRACTOR CANNOT START ANY WORK PER SYSTEM (AHU) UNTIL THE COORDINATED SHOP DRAWINGS AND PRODUCT SUBMITTALS HAVE BEEN APPROVED BY THE ENGINEER.

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ADDITIONAL INFORMATION.

- DEMOLISH SPRINKLER PIPE AND REROUTE TO ALLOW INSTALLATION OF (N)AHU'S, PIPING, DUCTWORK AND CONTROL PANELS. REFERENCE DRAWING 49-MH131 FOR ADDITIONAL INFORMATION AND COORDINATION.
- 2. MINIMUM PIPE SIZES FOR UP TO 50 EQUIVALENT FT. INCREASE PIPE SIZES AS REQUIRED TO ACCOMMODATE THE ACTUAL ROUTING:
- SUCTION LINE 5/8" Ø
- LIQUID LINE 3/8" ø
- HOT GAS REHEAT 3/8" Ø
- PUMPED CONDENSATE 3/4" ø
- MINIMUM PIPE SIZES FOR OVER 60 EQUIVALENT FT. INCREASE PIPE SIZES AS REQUIRED TO ACCOMMODATE THE ACTUAL ROUTING:
- EQUIRED TO ACCOMMODATE THE ACTUAL ROUTING:
- SUCTION LINE 3/4" ØLIQUID LINE 1/2" Ø
- HOT GAS REHEAT 1/2" ø
- PUMPED CONDENSATE 3/4" ø
- INSTALL AND INSULATE PIPING ACCORDING TO SPECIFICATIONS AND AHU
  MANUFACTURER RECOMMENDATIONS. VERIFY PIPE SIZING WITH AHU MANUFACTURER.
  PIPING MUST BE SIZED TO MEET THE ACTUAL INSTALLATION CONDITIONS. INSTALL
- SUCTION LINE ACCUMULATOR AND 1/8" CAPILLARY TUBING FOR PURGE CIRCUIT. SEE AHU MANUFACTURER'S INSTALLATION INSTRUCTIONS.
- 3. RUN PIPING HIGH TO UNDERSIDE OF DECK.
- 4. COORDINATE (N)PIPING WITH (E)SPRINKLER PIPING AND ROOM BELOW. ADJUST (N) PIPING TO FACILITATE INSTALLATION TO ROOM BELOW.

PIPING TO FACILITATE INSTALLATION TO ROOM BELOW.

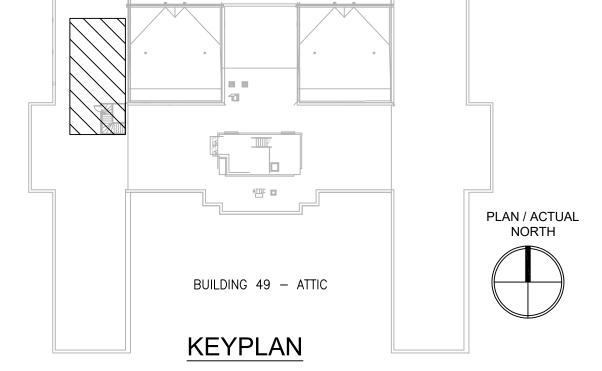


Project Title PRINTS OF THIS DRAWING SHALL NOT BE USED FOR ANY PURPOSE WHATSOEVER WITHOUT THE SEAL AND SIGNATURE OF THE Drawing Title Project Number ENGINEER OF RECORD MILLER-REMICK LLC Office of 656-18-300 **MECHANICAL** PROFESSIONAL ENGINEER 100% CONSTRUCTION UPGRADE SPS HVAC & PROFESSIONAL ENGINEER. DOCUMENTS Miller-Remick LLC


M.E.P. & Structural Engineering

A Service Disabled Veteran Owned

Small Rusiness PIPING PLANS Construction **ENVIRONMENTAL CONTROLS** Building Number 1, 2, 3, 28, 29, 49, 50, 51, NOT FOR CONSTRUCTION ATTIC - BUILDING 49 and Facilities MEP Engineers + Architects 111, 116 1173 Research Way 701 Forest Ave Portland, ME 04103 Management Approved: Project Director Drawing Number Forest, VA 24551 1-866-267-6839 1010 KINGS HIGHWAY SOUTH CHERRY HILL, NEW JERSEY 08034 (207) 828-4511 ST. CLOUD VA MEDICAL CENTER, MN **FULLY SPRINKLERED** PHONE: (856)429-4000 Checked 49-MP131 Drawn FAX: (856)429-5002 U.S. Department of Veterans Affairs MR BJS MR PROJECT NO: 0376-0011 2022-07-15 DESCRIPTION DATE VA FORM 08-6231

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VA FORM 08-6231
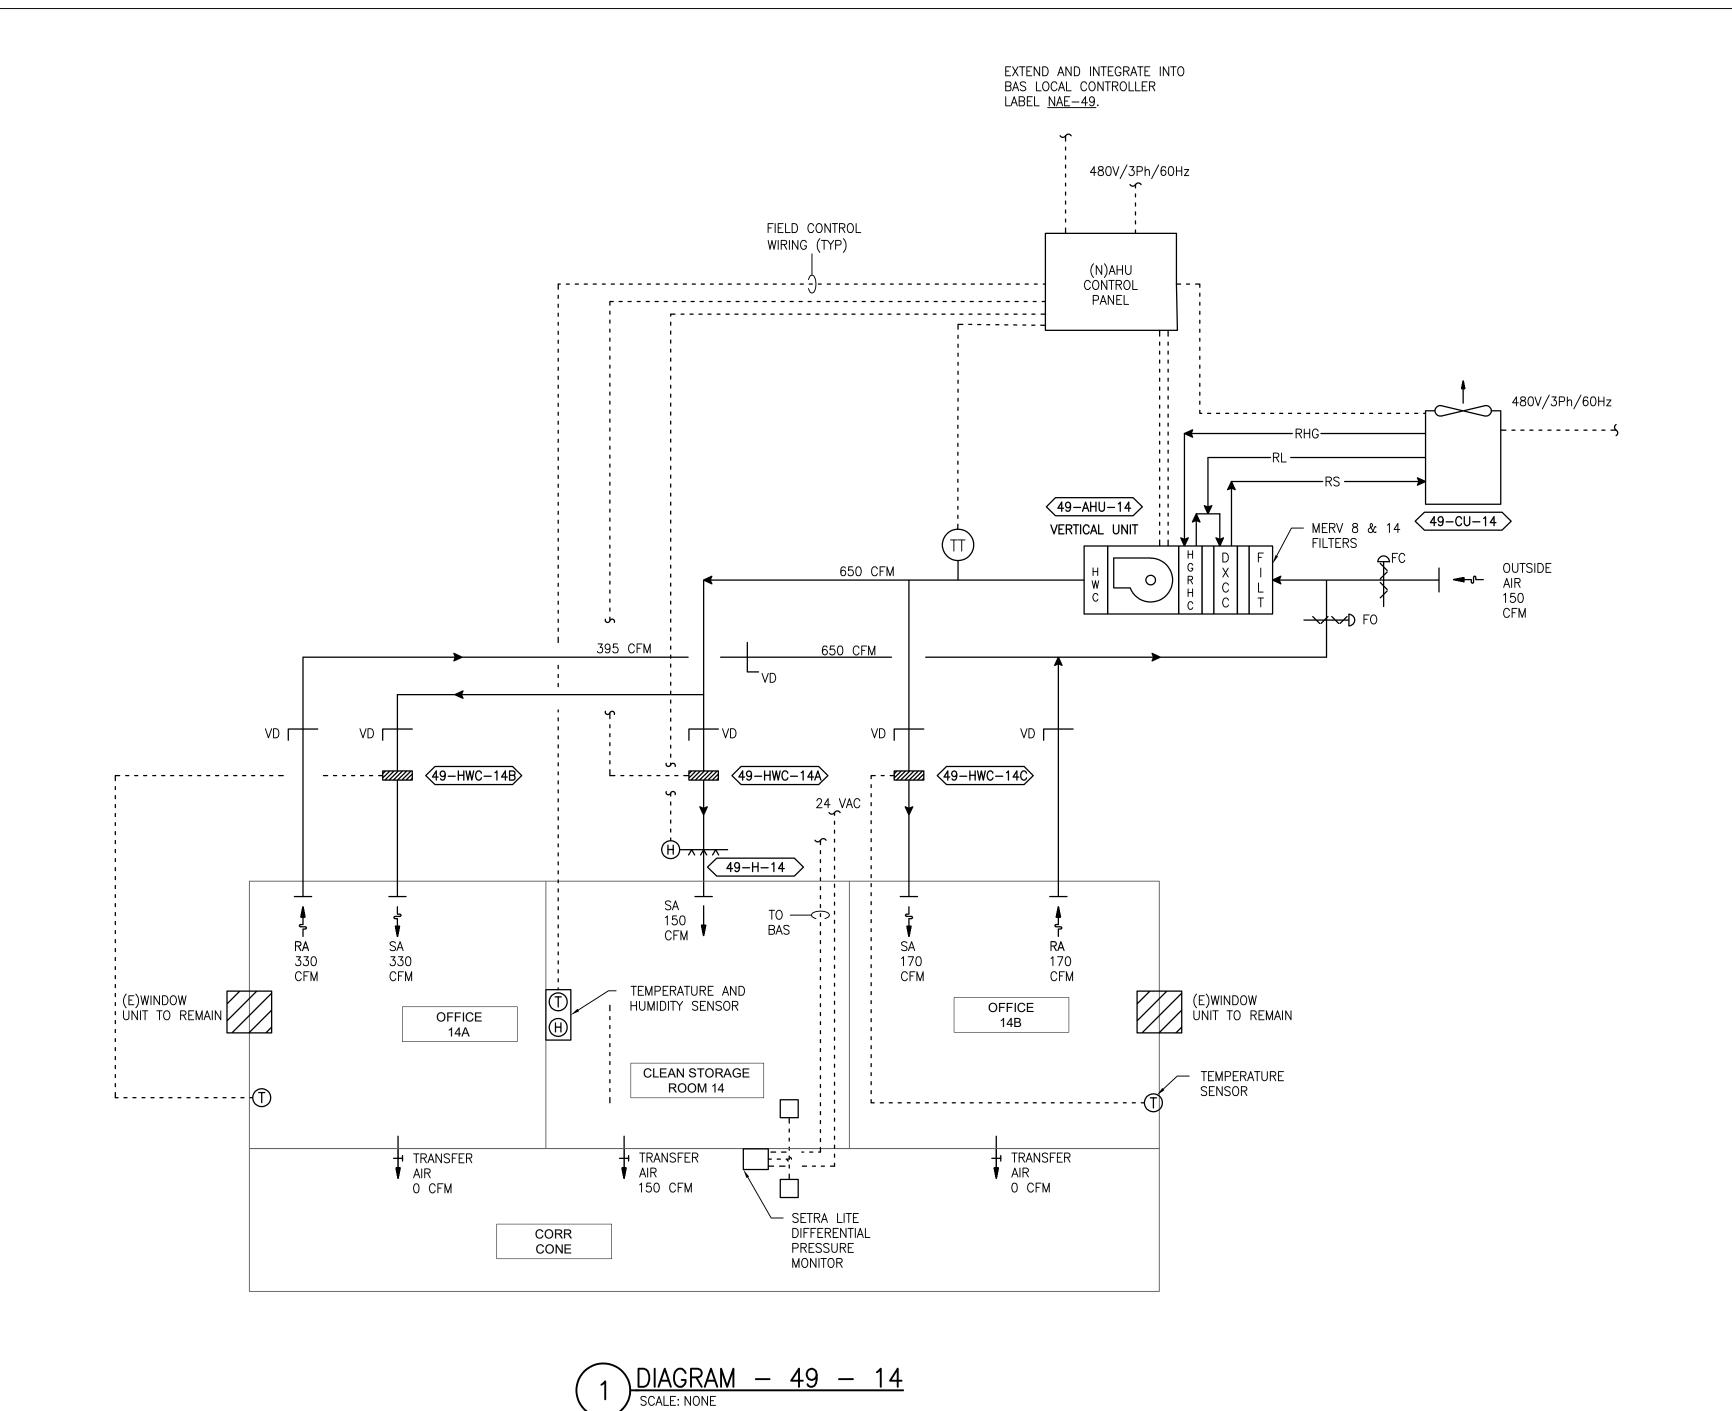
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DESCRIPTION

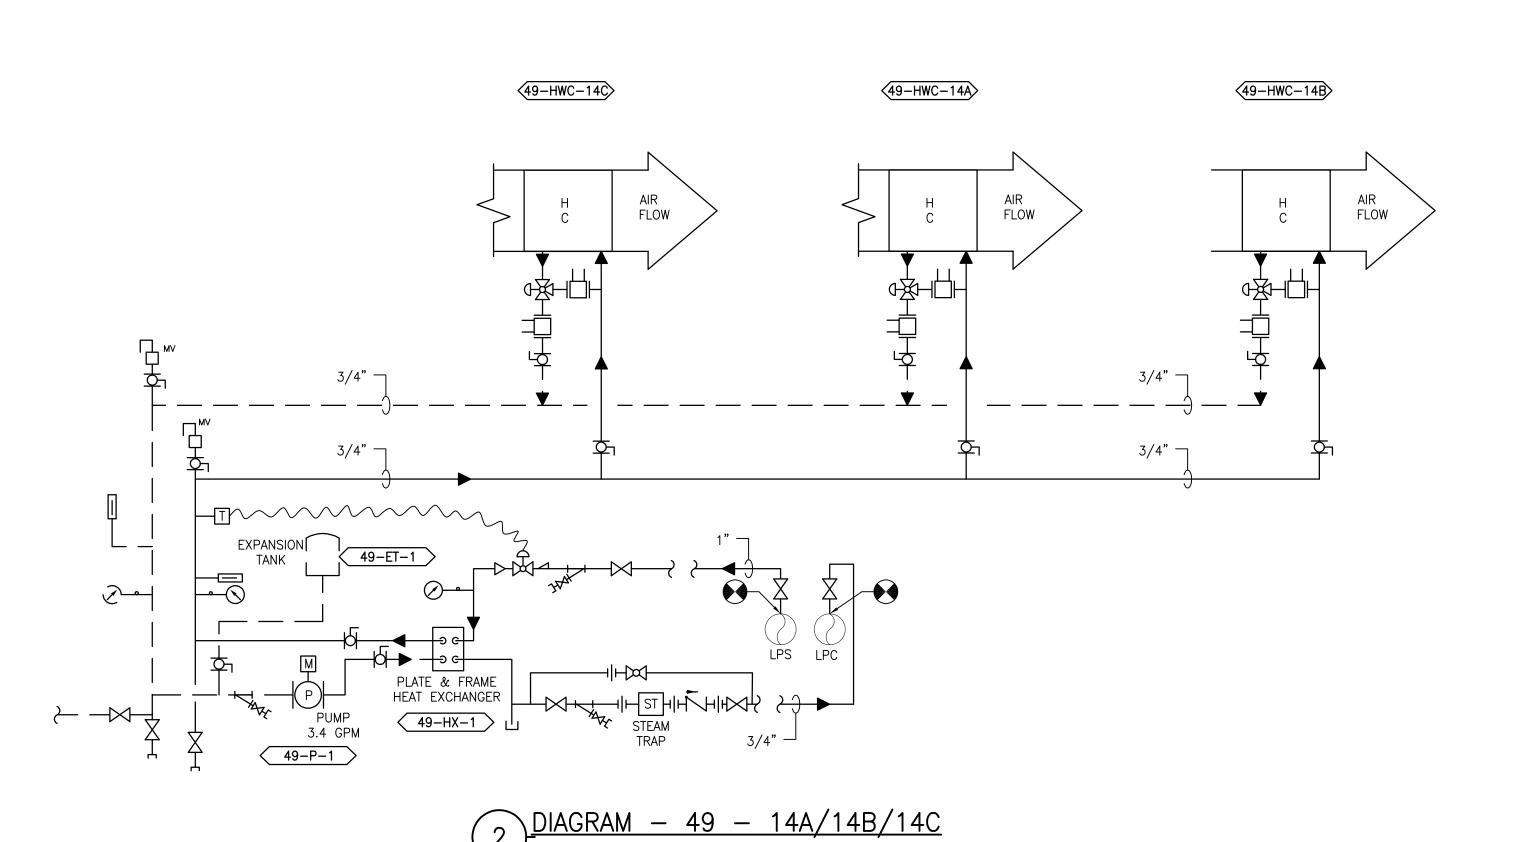DATE

MEP Engineers + Architects 1173 Research Way

Forest, VA 24551 1-866-267-6839

# 

SEQUENCE OF OPERATION

THE EXISTING HVAC SYSTEMS WILL CONTINUE TO OPERATE INDEPENDENT OF THE NEW

THE UNIT SHALL BE PROVIDED WITH A FACTORY PREWIRED AND TESTED EXTERNAL CONTROL PANEL. THE UNIT CONTROLLER SHALL BE CAPABLE OF CONTROLLING ALL FEATURES AND OPTIONS OF THE UNIT. THE CONTROLLER SHALL BE CAPABLE OF STAND—ALONE OPERATION

WITH UNIT CONFIGURATION, SETPOINT ADJUSTMENT, SENSOR STATUS VIEWING, UNIT ALARM

OCCUPIED/UNOCCUPIED MODE SHALL BE BASED ON A COMMAND FROM THE BMS.

IF ROOM TEMPERATURE RISES ABOVE SETPOINT AS SENSED BY THE WALL MOUNTED

IF ROOM TEMPERATURE FALLS BELOW SETPOINT AS SENSED BY THE WALL MOUNTED

IN THE UNOCCUPIED MODE THE SUPPLY FAN SHALL RUN CONTINUOUSLY.

TEMPERATURE SENSOR THE COMPRESSOR SHALL MODULATE TO MAINTAIN ROOM TEMPERATURE.

DEHUMIDIFICATION SHALL BE INITIATED ANYTIME IN THE OCCUPIED, UNOCCUPIED, COOLING OR

TEMPERATURE SENSOR THE HEATING COIL SHALL MODULATE TO MAINTAIN ROOM TEMPERATURE.

IN THE UNOCCUPIED MODE THE UNIT SHALL OPERATE IF THE ROOM TEMPERATURE OR RELATIVE

ON A CALL FOR COOLING, DEHUMIDIFYING, OR HEATING THE CONTROL SHALL BE THE SAME AS

THE ROOM PRESSURE MONITOR SETRA LITE SHALL MONITOR AND ALARM THE DIFFERENTIAL PRESSURE BETWEEN THE CLEAN / STERILE SATELLITE STORAGE ROOM AND THE ADJACENT

IF ROOM RELATIVE HUMIDITY RISES ABOVE SETPOINT AS SENSED BY THE WALL MOUNTED HUMIDITY SENSOR THE SYSTEM SHALL OVERRIDE THE COOLING COIL SETPOINT AND MODULATE THE HOT GAS REHEAT COIL TO MAINTAIN ROOM TEMPERATURE AND HUMIDITY SETPOINTS.

IN THE OCCUPIED MODE THE SUPPLY FAN SHALL RUN CONTINUOUSLY.

VIEWING, AND OCCUPANCY SCHEDULING WITHOUT DEPENDENCE ON THE JOHNSON CONTROLS BUILDING MANAGEMENT SYSTEM (BMS). THE CONTROLLER SHALL COMMUNICATE AND INTEGRATE WITH THE BMS SYSTEM VIA BACNET. ALL SETPOINTS SHALL BE VISIBLE AND RESETTABLE, ALL SENSOR READINGS SHALL BE VISIBLE, OCCUPIED AND UNOCCUPIED SCHEDULING SHALL BE

SUPPLEMENTAL SYSTEM.

OCCUPIED/UNOCCUPIED

HEATING MODE.

UNOCCUPIED MODE

HUMIDITY LIMITS ARE REACHED.

ROOM LOCALLY AND AT THE BAS.

IN THE OCCUPIED MODE.

ROOM PRESSURE MONITOR


SUPPLEMENTAL HVAC SYSTEM CONTROL

RESETTABLE, THROUGH THE BMS SYSTEM VIA BACNET.

<u>HEATING</u> (ONLY PROVIDED ON SOME UNITS)

Project Title Drawing Title ENGINEER OF RECORD MILLER-REMICK LLC Office of **MECHANICAL** 100% CONSTRUCTION PROFESSIONAL ENGINEER UPGRADE SPS HVAC & DOCUMENTS NOT FOR CONSTRUCTION AIRFLOW CONTROL & PIPING DIAGRAM Miller-Remick LLC

M.E.P. & Structural Engineering
A Service Disabled Veteran Owned
Small Business Construction **ENVIRONMENTAL CONTROLS** BASEMENT - BUILDING 49 and Facilities 111, 116 701 Forest Ave Portland, ME 04103 Approved: Project Director Management Drawing Number (207) 828-4511 1010 KINGS HIGHWAY SOUTH CHERRY HILL, NEW JERSEY 08034 ST. CLOUD VA MEDICAL CENTER, MN **FULLY SPRINKLERED** PHONE: (856)429-4000 Checked 49-M-801 Drawn U.S. Department of Veterans Affairs FAX: (856)429-5002 PNL MR PROJECT NO: 0376-0011 MR 2022-07-15

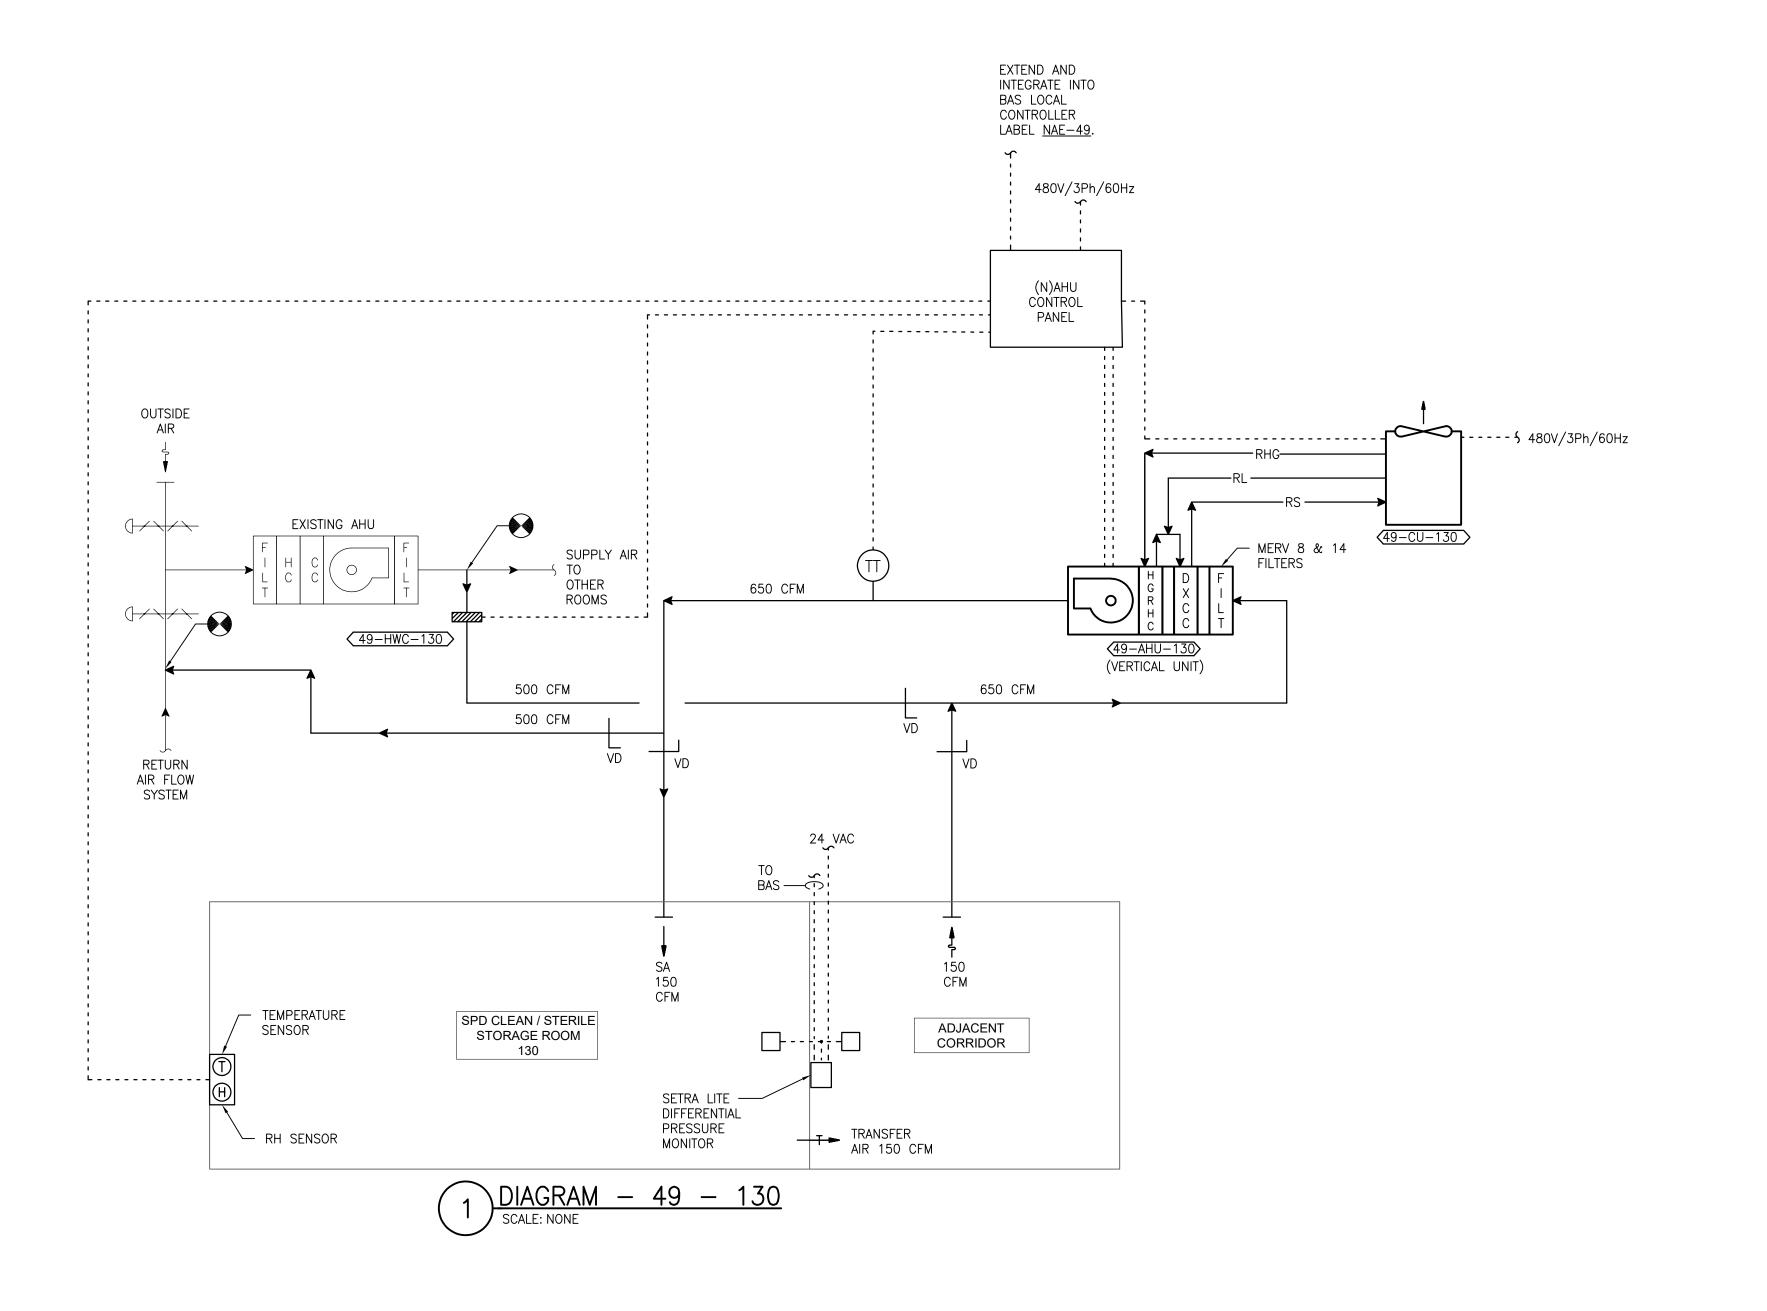

#### SEQUENCE OF OPERATION

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OCCUPIED/UNOCCUPIED OCCUPIED/UNOCCUPIED MODE SHALL BE BASED ON A COMMAND FROM THE BMS.

#### OCCUPIED MODE IN THE OCCUPIED MODE THE SUPPLY FAN SHALL RUN CONTINUOUSLY.

IF ROOM TEMPERATURE RISES ABOVE SETPOINT AS SENSED BY THE WALL MOUNTED TEMPERATURE SENSOR THE COMPRESSOR SHALL MODULATE TO MAINTAIN ROOM TEMPERATURE. <u>DEHUMIDIFYING</u>

IF ROOM RELATIVE HUMIDITY RISES ABOVE SETPOINT AS SENSED BY THE WALL MOUNTED HUMIDITY SENSOR THE SYSTEM SHALL OVERRIDE THE COOLING COIL SETPOINT AND MODULATE THE HOT GAS REHEAT COIL TO MAINTAIN ROOM TEMPERATURE AND HUMIDITY SETPOINTS. DEHUMIDIFICATION SHALL BE INITIATED ANYTIME IN THE OCCUPIED, UNOCCUPIED, COOLING OR

HEATING (ONLY PROVIDED ON SOME UNITS)

HEATING MODE.

IF ROOM TEMPERATURE FALLS BELOW SETPOINT AS SENSED BY THE WALL MOUNTED TEMPERATURE SENSOR THE HEATING COIL SHALL MODULATE TO MAINTAIN ROOM TEMPERATURE. UNOCCUPIED MODE

IN THE UNOCCUPIED MODE THE SUPPLY FAN SHALL RUN CONTINUOUSLY.

IN THE UNOCCUPIED MODE THE UNIT SHALL OPERATE IF THE ROOM TEMPERATURE OR RELATIVE HUMIDITY LIMITS ARE REACHED.

ON A CALL FOR COOLING, DEHUMIDIFYING, OR HEATING THE CONTROL SHALL BE THE SAME AS IN THE OCCUPIED MODE.

ROOM PRESSURE MONITOR THE ROOM PRESSURE MONITOR SETRA LITE SHALL MONITOR AND ALARM THE DIFFERENTIAL PRESSURE BETWEEN THE CLEAN / STERILE SATELLITE STORAGE ROOM AND THE ADJACENT ROOM LOCALLY AND AT THE BAS.

Project Title Project Number Drawing Title 656-18-300 **MECHANICAL** 100% CONSTRUCTION UPGRADE SPS HVAC & DOCUMENTS NOT FOR CONSTRUCTION AIRFLOW CONTROL DIAGRAM **ENVIRONMENTAL CONTROLS** Building Number 1, 2, 3, 28, 29, 49, 50, 51, FIRST FLOOR - BUILDING 49 111, 116 Approved: Project Director Drawing Number ST. CLOUD VA MEDICAL CENTER, MN **FULLY SPRINKLERED** Checked Drawn 49-M-811 PNL MR 2022-07-15

VA FORM 08-6231

DESCRIPTION

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DATE

MEP Engineers + Architects 1173 Research Way

701 Forest Ave Portland, ME 04103 (207) 828-4511

ENGINEER OF RECORD Miller-Remick LLC

M.E.P. & Structural Engineering
A Service Disabled Veteran Owned Small Business 1010 KINGS HIGHWAY SOUTH CHERRY HILL, NEW JERSEY 08034 PHONE: (856)429-4000 FAX: (856)429-5002 MR PROJECT NO: 0376-0011


Office of Construction and Facilities Management

MILLER-REMICK LLC

PROFESSIONAL ENGINEER

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U.S. Department of Veterans Affairs

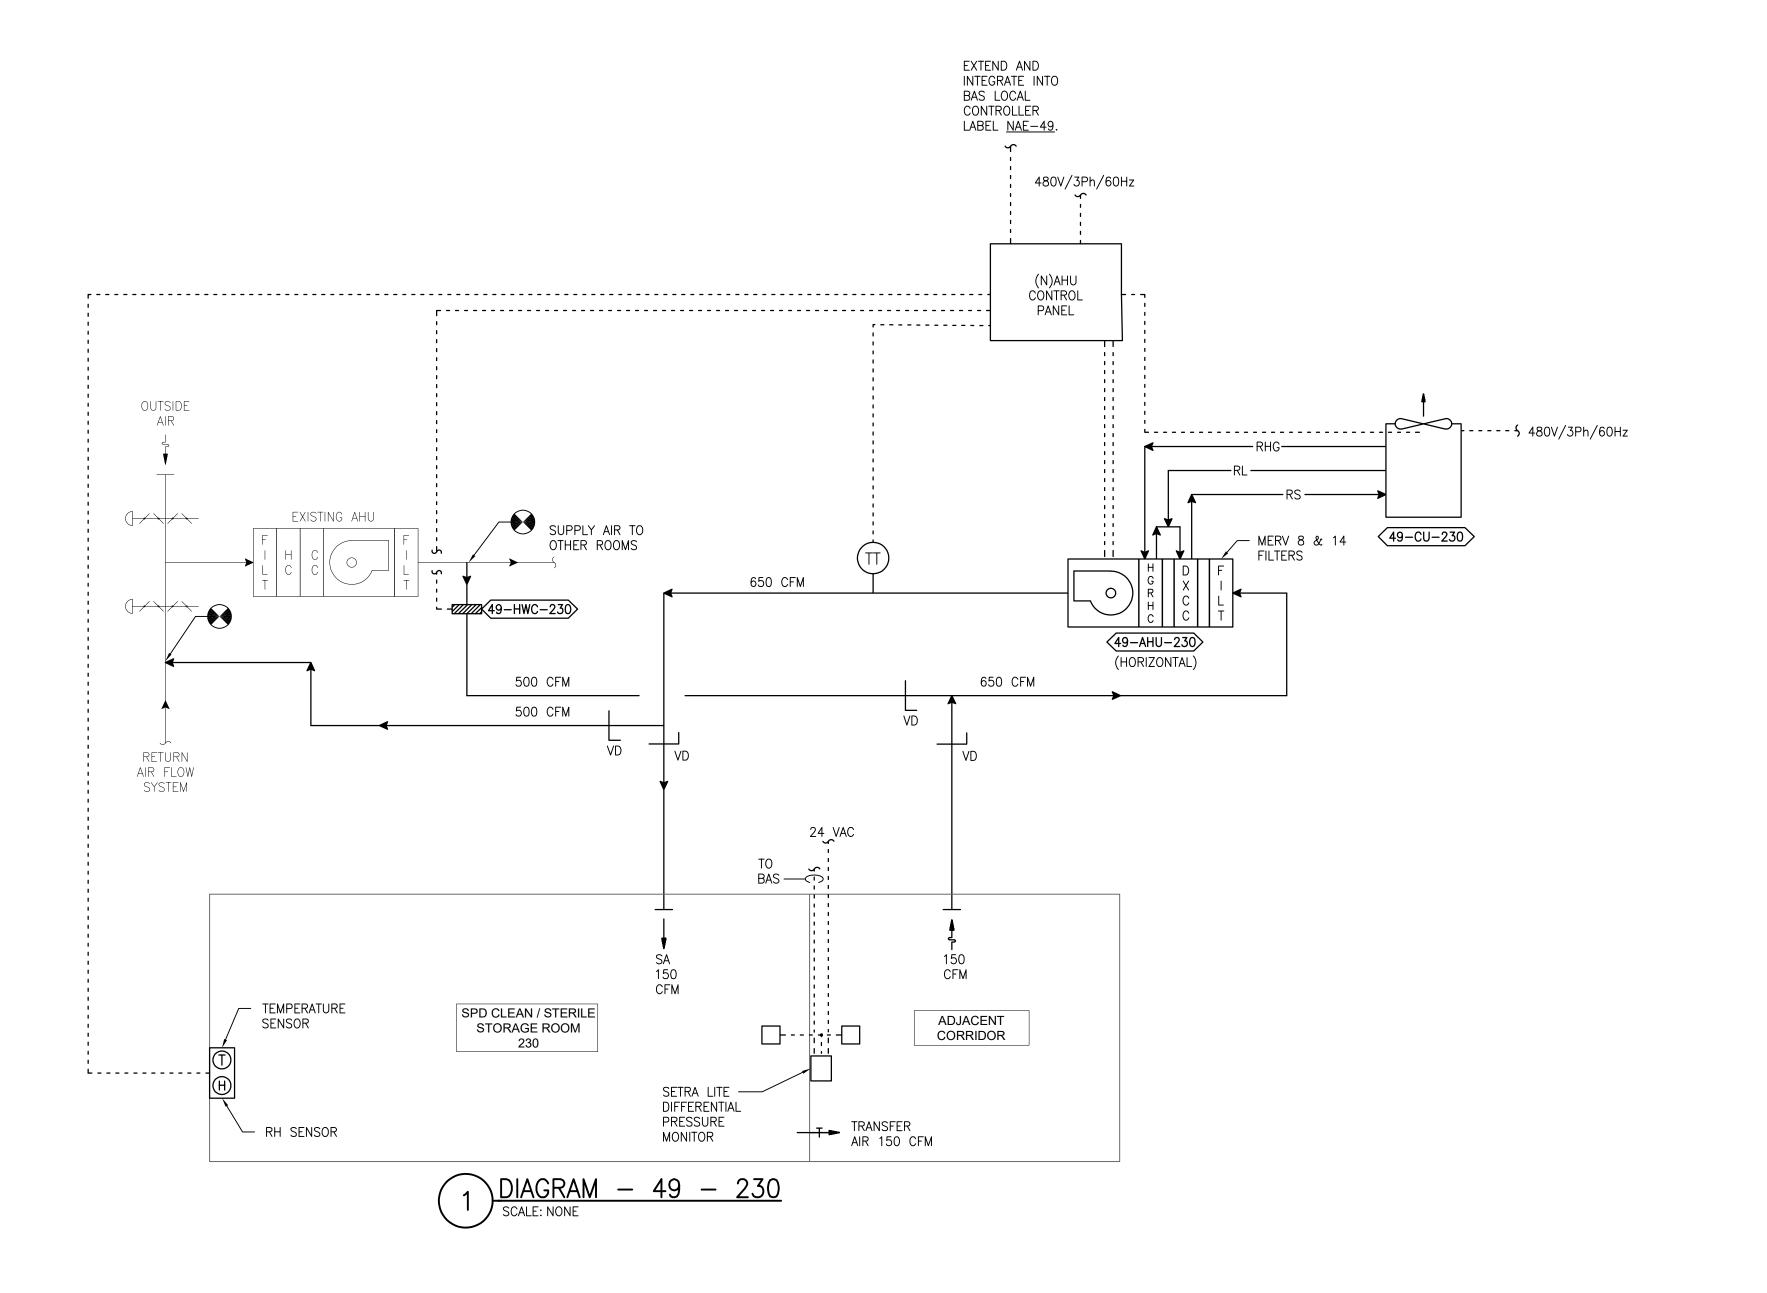

#### SEQUENCE OF OPERATION

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VA FORM 08-6231