

1 SECOND FLOOR AREA B WASTE AND VENT PLAN
1/8" = 1'-0"

GENERAL MECHANICAL NOTES

- CONTRACTOR SHALL COORDINATE PIPE ROUTING WITH OTHER TRADES. PROVIDE ALL ADDITIONAL OFFSETS AS REQUIRED TO COMPLETE INSTALLATION.
- CONTRACTOR TO CONFIRM SIZE AND LOCATION OF EXISTING PIPING.
- PIPING SHOWN FOR CLARITY. ROUTE ALL PIPING ABOVE CEILING, IN CHASES, AND IN WALLS AS REQUIRED.
- COORDINATE LOCATION OF ALL CLEANOUTS FOR ACCESSIBILITY.
- COORDINATE PHASING WITH CONTRACTING OFFICER AND REFER TO PHASING PLAN. FOR PIPING SERVING BUILDING AREAS THAT WILL REMAIN IN OPERATION, THE NEW PIPING IS TO BE INSTALLED AND CONNECTED PRIOR TO EXISTING PIPING BEING REMOVED. TEMPORARY PIPING SHALL BE INSTALLED AS REQUIRED.

MECHANICAL SPECIFIC NOTES

- P450 4" ST DOWN FROM NEW 4" ROOF DRAIN TO FIRST FLOOR. REFER TO SHEET PP102, FIRST FLOOR AREA B & C WASTE AND VENT PIPING PLAN, FOR CONTINUATION.
- P451 NEW 2" VENT UP FROM FIRST FLOOR. REFER TO SHEET PP102, FIRST FLOOR AREA B & C WASTE AND VENT PIPING PLAN, FOR CONTINUATION.
- P452 NEW 4" VENT UP FROM FIRST FLOOR. REFER TO SHEET PP102, FIRST FLOOR AREA B & C WASTE AND VENT PIPING PLAN, FOR CONTINUATION.
- P453 RELOCATE EXISTING 3" VENT FROM FIRST FLOOR AS REQUIRED FOR INSTALLATION IN NEW WALLS ON SECOND FLOOR. REFER TO SHEET PP102, FIRST FLOOR AREA B & C WASTE AND VENT PIPING PLAN, FOR CONTINUATION.
- P454 2" SANITARY DOWN AND 1-1/2" VENT UP FROM SHOWERS. REFER TO PP102, FIRST FLOOR AREA B & C WASTE AND VENT PIPING PLAN, FOR CONTINUATION.
- P455 4" VENT UP, 3" VTR THROUGH EXISTING ROOF PENETRATION.
- P457 3" VENT UP, 4" VTR THROUGH EXISTING ROOF PENETRATION.
- P458 CONNECT EXISTING 2" VENT TO NEW WITHIN THIS LOCATION.
- P459 2" SANITARY DOWN FROM LAVATORY. REFER TO PP102, FIRST FLOOR AREA B & C WASTE AND VENT PIPING PLAN, FOR CONTINUATION.
- P461 2" SANITARY DOWN TO FIRST FLOOR. REFER TO PP102, FIRST FLOOR AREA B & C WASTE AND VENT PIPING PLAN, FOR CONTINUATION.
- P462 CONNECT NEW 2" VENT TO EXISTING WITHIN THIS LOCATION.
- P463 CONNECT NEW 1-1/2" VENT TO EXISTING FROM FIRST FLOOR.
- P464 4" SANITARY DOWN FROM WATER CLOSETS. REFER TO PP102, FIRST FLOOR AREA B & C WASTE AND VENT PIPING PLAN, FOR CONTINUATION.
- P465 4" SANITARY DOWN FROM CLINICAL SERVICE SINK. REFER TO PP102, FIRST FLOOR AREA B & C WASTE AND VENT PIPING PLAN, FOR CONTINUATION.
- P466 2" SANITARY DOWN FROM SINK. REFER TO PP102, FIRST FLOOR AREA B & C WASTE AND VENT PIPING PLAN, FOR CONTINUATION.
- P467 2" VENT UP, 3" VTR THROUGH EXISTING ROOF PENETRATION.
- P468 2" SANITARY DOWN FROM EYEWASH. REFER TO PP102, FIRST FLOOR AREA B & C WASTE AND VENT PIPING PLAN, FOR CONTINUATION.

- A Three inches = one foot
- B One and one half inches = one foot
- C One inch = one foot
- D Three quarters inch = one foot
- E One half inch = one foot
- F One quarter inch = one foot
- G Three eighths inch = one foot
- H One eighth inch = one foot
- I One sixteenth inch = one foot

C:\Revit\Local Files\2025\BRZ102-RENOVATE AND CONSOLIDATE INPATIENT FUNCTIONS BUILDING 113-MEPP-CENTRAL_Mat reggie.rvt 6/10/2025 8:19:37 AM

Revision#	Description	Date

CONSULTANTS

STRUCTURAL:
Albertson Engineering Inc.

MECHANICAL / ELECTRICAL / PLUMBING:
WPE
West Plains Engineering, Inc.

ARCHITECT OF RECORD

A/E
STONE GROUP ARCHITECTS, INC.
319 N. MAIN AVE.
SIOUX FALLS, SD 57104
605.271.1144
TODD STONE, AIA

STONE GROUP ARCHITECTS

STAMP

REGISTERED PROFESSIONAL ENGINEER
REG. NO. 8462
MICHAEL SEAN HENNINGSEN
SOUTH DAKOTA
6/10/2025


Office of Construction and Facilities Management

VA U.S. Department of Veterans Affairs

Drawing Title SECOND FLOOR AREA B WASTE AND VENT PLAN	Phase CONSTRUCTION DOCUMENTS
Approved:	FULLY SPRINKLERED

Project Title RENOVATE AND CONSOLIDATE INPATIENT FUNCTIONS	Project Number VA #568-14-110 WPE #BR21020
Location FORT MEADE, SOUTH DAKOTA	Building Number 113
Issue Date 06/10/2025	Drawing Number PP104
Checked MSH	Drawn MMM

three inches = one foot
one and one half inches = one foot
one inch = one foot
three quarters inch = one foot
one half inch = one foot
three eighths inch = one foot
one quarter inch = one foot
one eighth inch = one foot

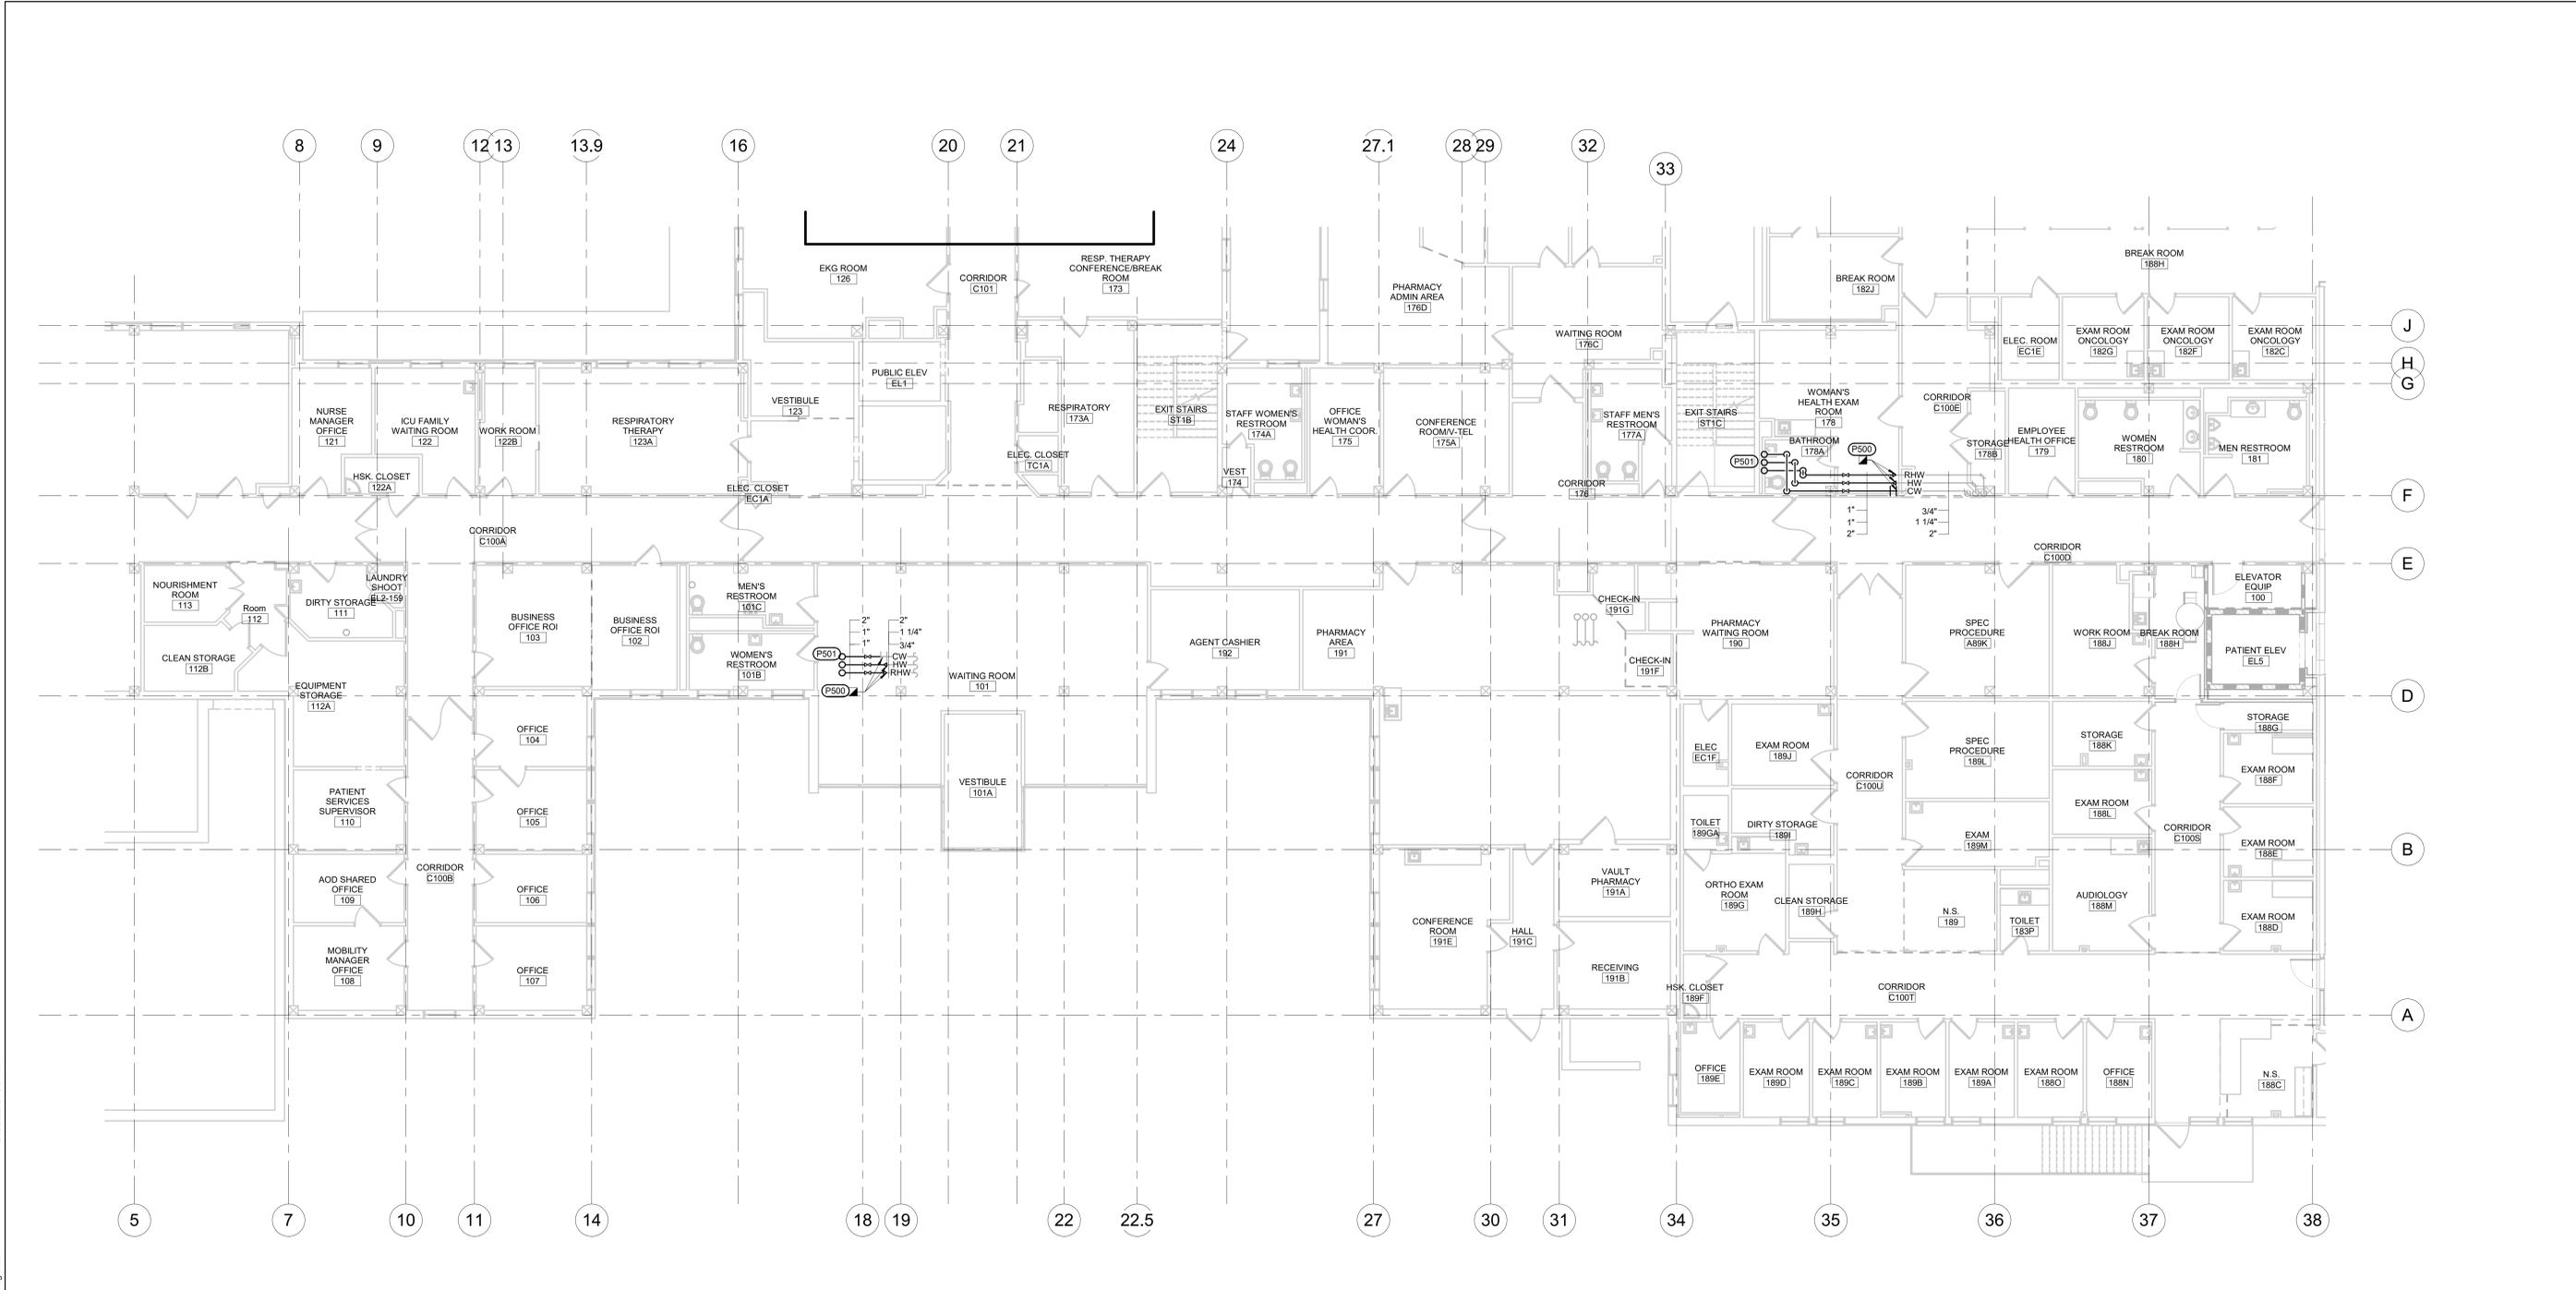

1 FIRST FLOOR AREA A DOMESTIC PLUMBING PLANS
1/8" = 1'-0"

GENERAL MECHANICAL NOTES
A CONTRACTOR SHALL COORDINATE PIPE ROUTING WITH OTHER TRADES. PROVIDE ALL ADDITIONAL OFFSETS AS REQUIRED TO COMPLETE INSTALLATION.
B ISOLATE ALL COPPER PIPES FROM BEARING ON FERROUS HANGERS, ETC. WITH ELECTRICALLY INSULATING MATERIALS AS SPECIFIED. USE DIELECTRIC UNIONS IN CONNECTION OF ALL COPPER PIPING TO FERROUS PIPING AS SPECIFIED.
C DOMESTIC WATER RECIRCULATION BALANCING VALVES SHALL BE AN AUTOFLOW STYLE VALVE, 0.33 GPM.
D COORDINATE PHASING WITH CONTRACTING OFFICER AND REFER TO PHASING PLAN. FOR PIPING SERVING BUILDING AREAS THAT WILL REMAIN IN OPERATION, THE NEW PIPING IS TO BE INSTALLED AND CONNECTED PRIOR TO EXISTING PIPING BEING REMOVED. TEMPORARY PIPING SHALL BE INSTALLED AS REQUIRED.

MECHANICAL SPECIFIC NOTES
P500 CONNECT NEW 2" CW, 1" HW, AND 1" RHW TO EXISTING WITHIN THIS LOCATION.
P501 2" CW, 1" HW, AND 1" RHW UP TO SECOND FLOOR. REFER TO PP107, SECOND FLOOR AREA A DOMESTIC PIPING PLAN, FOR CONTINUATION.


Revision#	Description	Date:

CONSULTANTS

STRUCTURAL: Albertson Engineering, Inc. 3202 W. Main St. #C Rapid City, South Dakota 57702 Phone: 605-343-9606	MECHANICAL / ELECTRICAL / PLUMBING: WPE West Plains Engineering, Inc. 1750 Road Road Rapid City, South Dakota 57702 Phone: 605-348-7455
---	--

ARCHITECT OF RECORD

A/E/C
STONE GROUP ARCHITECTS, INC.
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SIOUX FALLS, SD 57104
605.271.1144
TODD STONE, AIA

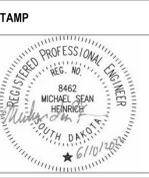

Office of Construction and Facilities Management

VA U.S. Department of Veterans Affairs

Drawing Title
FIRST FLOOR AREA A DOMESTIC PIPING PLAN

Approved: _____

Phase
CONSTRUCTION DOCUMENTS

FULLY SPRINKLERED

Project Title
RENOVATE AND CONSOLIDATE INPATIENT FUNCTIONS


Location
FORT MEADE, SOUTH DAKOTA

Issue Date: 06/10/2022
Checked: MSH
Drawn: MMM


Project Number
VA #568-14-110
WPE #BR21020
Building Number
113

Drawing Number
PP105

Scale indicators: Three inches = one foot, One and one half inches = one foot, One inch = one foot, Three quarters inch = one foot, One half inch = one foot, One quarter inch = one foot, One eighth inch = one foot.

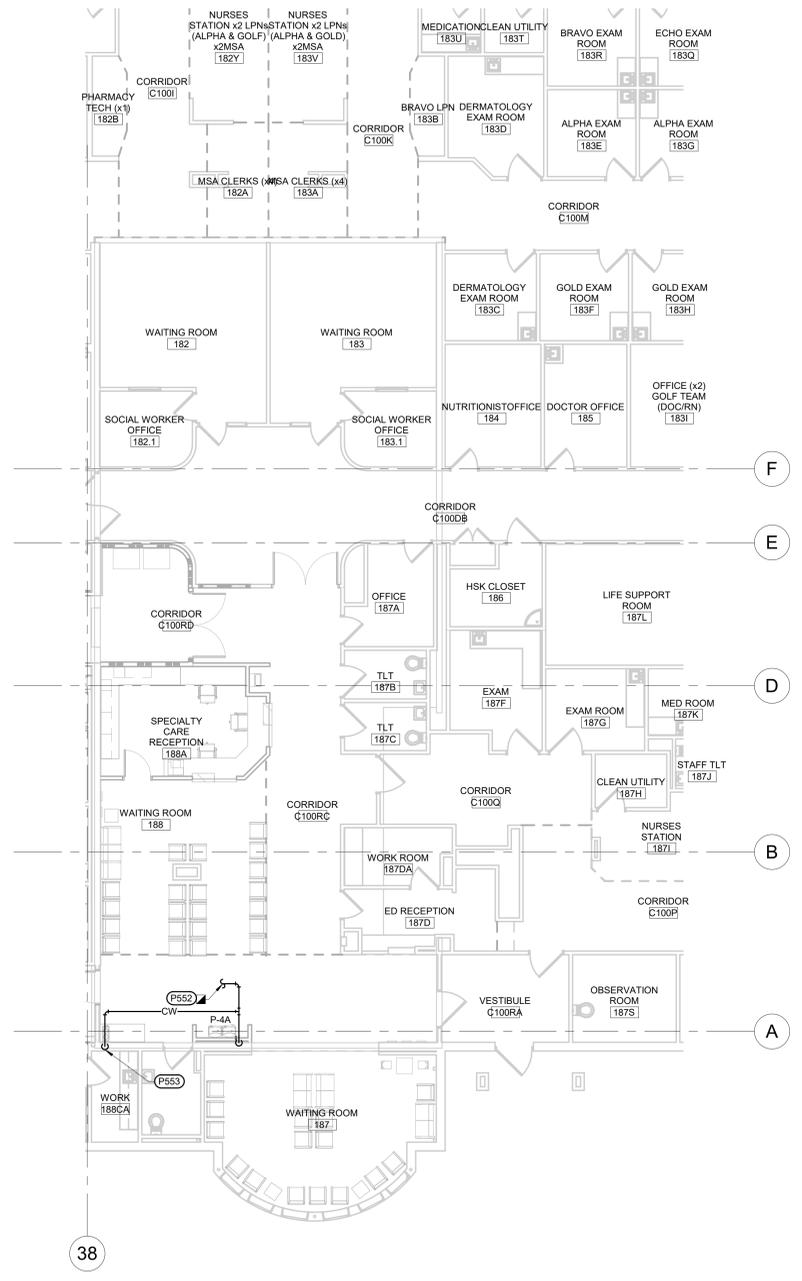

2 FIRST FLOOR AREA C DOMESTIC PLUMBING PLANS
1/8" = 1'-0"

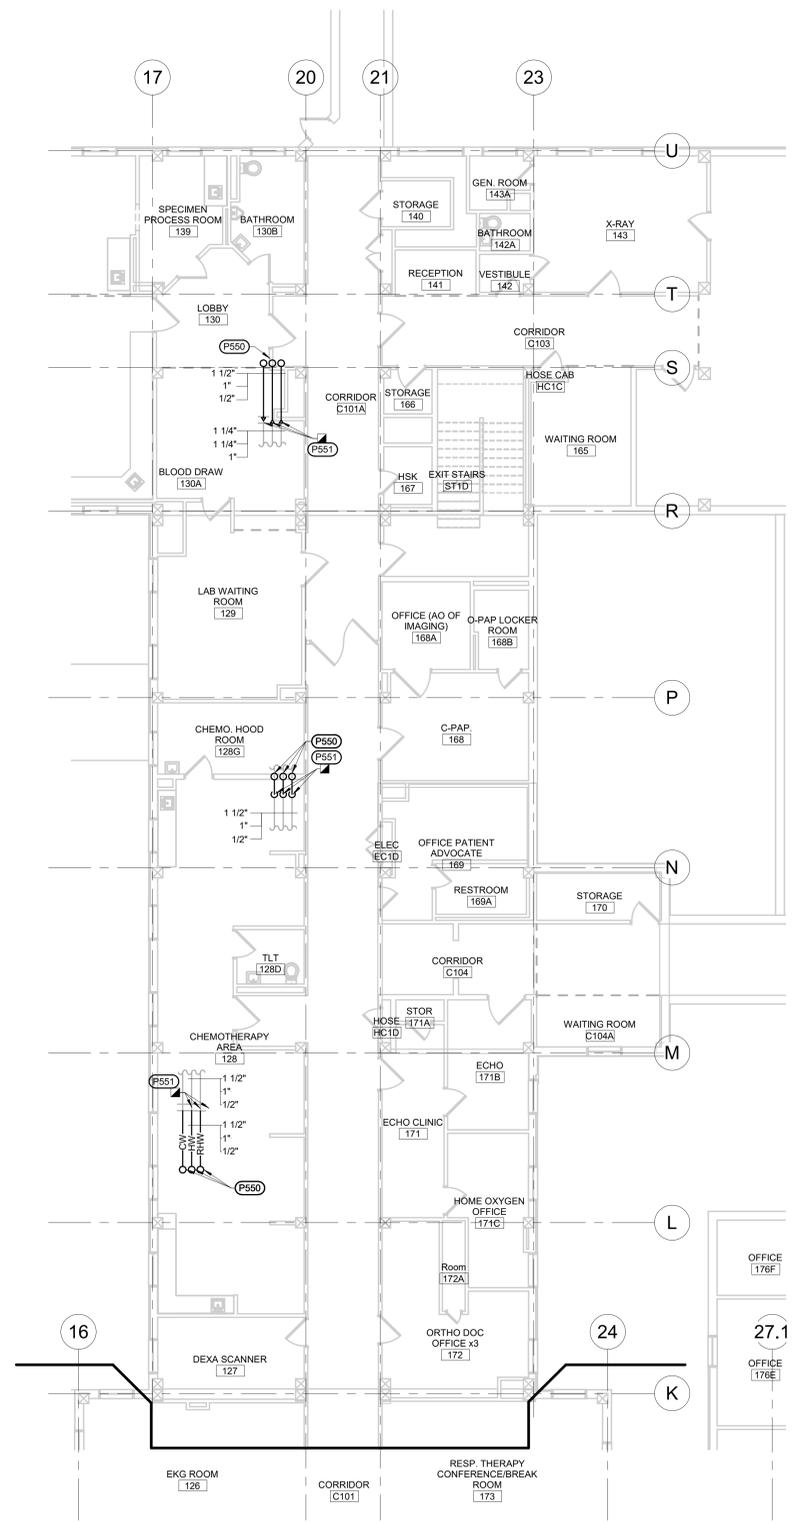

1 FIRST FLOOR AREA B DOMESTIC PLUMBING PLANS
1/8" = 1'-0"

GENERAL MECHANICAL NOTES
A CONTRACTOR SHALL COORDINATE PIPE ROUTING WITH OTHER TRADES. PROVIDE ALL ADDITIONAL OFFSETS AS REQUIRED TO COMPLETE INSTALLATION.
B ISOLATE ALL COPPER PIPES FROM BEARING ON FERROUS HANGERS, ETC. WITH ELECTRICALLY INSULATING MATERIALS AS SPECIFIED. USE DIELECTRIC UNIONS IN CONNECTION OF ALL COPPER PIPING TO FERROUS PIPING AS SPECIFIED.
C DOMESTIC WATER RECIRCULATION BALANCING VALVES SHALL BE AN AUTOFLOW STYLE VALVE, 0.33 GPM.
D COORDINATE PHASING WITH CONTRACTING OFFICER AND REFER TO PHASING PLAN. FOR PIPING SERVING BUILDING AREAS THAT WILL REMAIN IN OPERATION, THE NEW PIPING IS TO BE INSTALLED AND CONNECTED PRIOR TO EXISTING PIPING BEING REMOVED. TEMPORARY PIPING SHALL BE INSTALLED AS REQUIRED.

MECHANICAL SPECIFIC NOTES
P550 1-1/2" CW, 1" HW, AND 1/2" RHW UP TO SECOND FLOOR. REFER TO PP108, SECOND FLOOR AREA B & C DOMESTIC PIPING PLAN, FOR CONTINUATION.
P551 CONNECT NEW 1-1/2" CW, 1" HW, AND 1/2" RHW TO EXISTING WITHIN THIS LOCATION.
P552 EXTEND NEW 1/2" CW FOR NEW WATER CHILLER AND CONNECT TO CW SERVING DEMOLISHED WATER CHILLER.
P553 PROVIDE 1/2" CW PIPE WITH VALVE BOX IN WALL TO SERVE OWNER PROVIDED COFFEE MAKER. PROVIDE CONNECTION FROM VALVE BOX TO COFFEE MAKER.

Revision table with columns: Revision#, Description, Date.

CONSULTANTS
STRUCTURAL: Albertson Engineering, Inc.
MECHANICAL / ELECTRICAL / PLUMBING: WEST PLAINS ENGINEERING, INC.

ARCHITECT OF RECORD
A/E: STONE GROUP ARCHITECTS, INC.
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TODD STONE, AIA

STAMP
Professional Engineer Seal for Michael Sean Hennessy, State of South Dakota, No. 8462.


Office of Construction and Facilities Management
U.S. Department of Veterans Affairs

Drawing Title: FIRST FLOOR AREA B & C DOMESTIC PIPING PLAN
Approved: [Signature]

Phase: CONSTRUCTION DOCUMENTS
FULLY SPRINKLERED

Project Title: RENOVATE AND CONSOLIDATE INPATIENT FUNCTIONS
Location: FORT MEADE, SOUTH DAKOTA
Issue Date: 06/10/2022

Project Number: VA #568-14-110 WPE #BR21020
Building Number: 113
Drawing Number: PP106

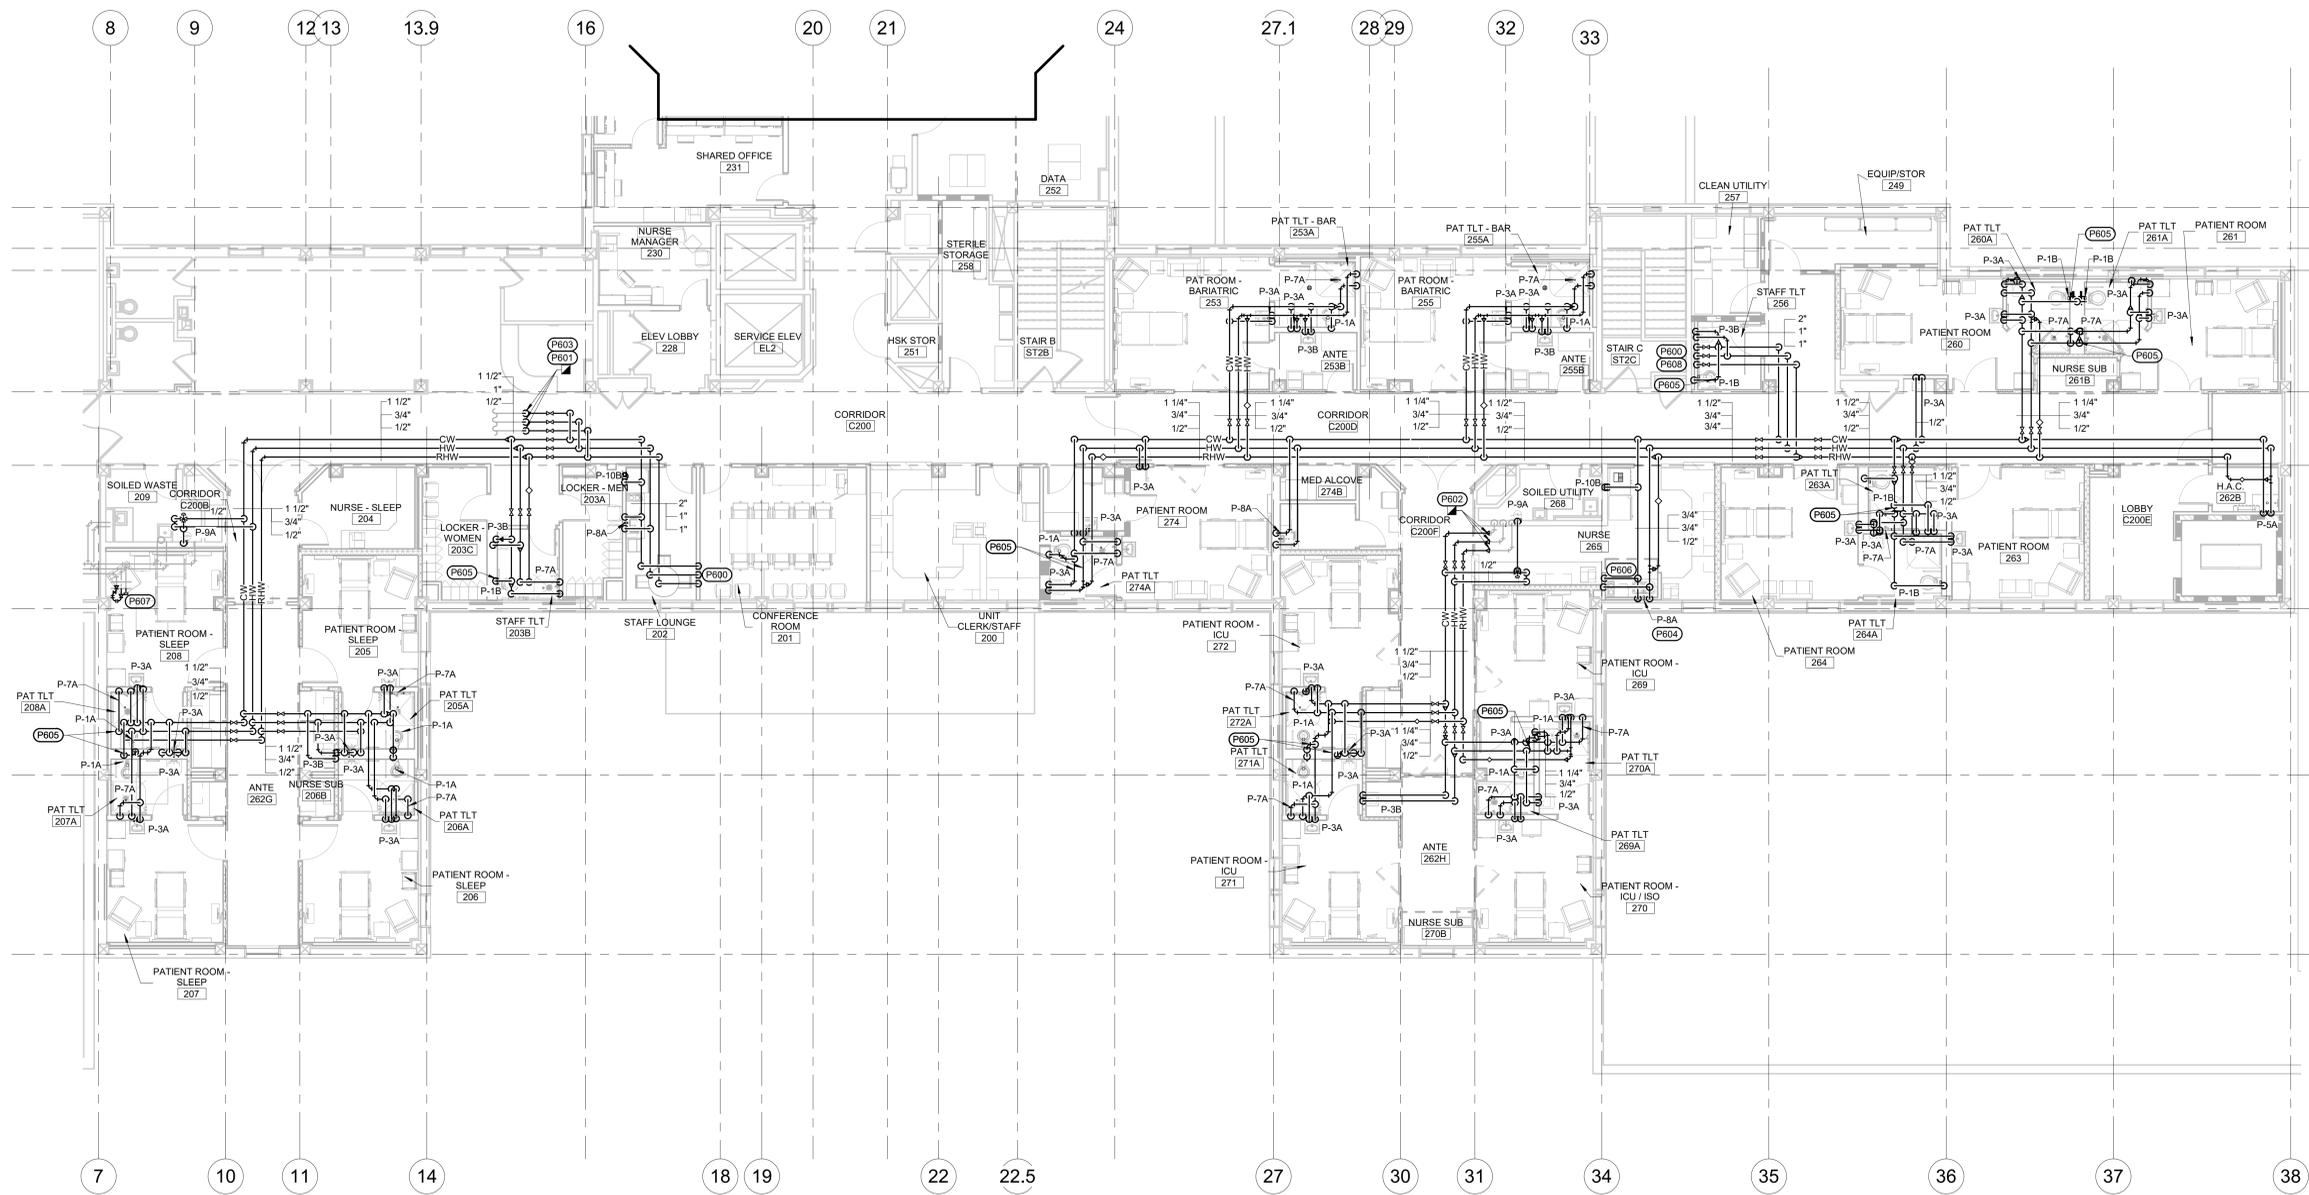

1 2ND FLOOR DOMESTIC PLUMBING PLAN - AREA A
1/8" = 1'-0"

GENERAL MECHANICAL NOTES

- A CONTRACTOR SHALL COORDINATE PIPE ROUTING WITH OTHER TRADES. PROVIDE ALL ADDITIONAL OFFSETS AS REQUIRED TO COMPLETE INSTALLATION.
- B ISOLATE ALL COPPER PIPES FROM BEARING ON FERROUS HANGERS, ETC. WITH ELECTRICALLY INSULATING MATERIALS AS SPECIFIED. USE DIELECTRIC UNIONS IN CONNECTION OF ALL COPPER PIPING TO FERROUS PIPING AS SPECIFIED.
- C DOMESTIC WATER RECIRCULATION BALANCING VALVES SHALL BE AN AUTOFLOW STYLE VALVE, 0.33 GPM.
- D COORDINATE PHASING WITH CONTRACTING OFFICER AND REFER TO PHASING PLAN. FOR PIPING SERVING BUILDING AREAS THAT WILL REMAIN IN OPERATION, THE NEW PIPING IS TO BE INSTALLED AND CONNECTED PRIOR TO EXISTING PIPING BEING REMOVED. TEMPORARY PIPING SHALL BE INSTALLED AS REQUIRED.

MECHANICAL SPECIFIC NOTES

- P600 2" CW, 1" HW, AND 1" RHW DOWN TO FIRST FLOOR. REFER TO P6105, FIRST FLOOR AREA A DOMESTIC PIPING PLAN, FOR CONTINUATION.
- P601 CONNECT NEW 1-1/2" CW, 1" HW, AND 1/2" RHW TO EXISTING WITHIN THIS LOCATION.
- P602 CONNECT NEW 1-1/2" CW, 3/4" HW, AND 1/2" RHW TO EXISTING WITHIN THIS LOCATION.
- P603 EXISTING DOMESTIC WATER TO REMAIN IN SERVICE THROUGHOUT PROJECT. ROUTE PIPING AND PROVIDE TEMPORARY CONNECTIONS AS NECESSARY FOR DOMESTIC SERVICE TO STAY ACTIVE THROUGHOUT PROJECT.
- P604 PROVIDE 1/2" CW PIPE FROM SINK TO OWNER PROVIDED COFFEE MAKER.
- P605 PROVIDE AND INSTALL JOSAM MODEL NUMBER 75002B STAINLESS STEEL BELLOWS STYLE WATER HAMMER ARRESTOR ON INDICATED DOMESTIC WATER PIPE.
- P606 INSTALL 1/2" CW AND 1/2" HW TO SINK BELOW COUNTER. DO NOT INSTALL PIPING WITHIN EXTERIOR WALL.
- P607 CAP EXISTING CW PIPING WITHIN THIS LOCATION WITHIN 1 FT OF MAIN. PROVIDE NEW 0.33 GPM RECIRCULATION VALVE BETWEEN HW AND RHW PIPING.
- P608 PROVIDE NEW B&G PL-36 DOMESTIC WATER RECIRCULATION PUMP, 1/6 HP, 120V/1PH, 20 GPM, 20 FT H2O, BRONZE OR STAINLESS STEEL IMPELLOR, FOR REPLACEMENT OF EXISTING DOMESTIC WATER RECIRCULATION PUMP, LOCATED IN BASEMENT OF FACILITY. COORDINATE INSTALLATION WITH COR.

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 one eighth inch = one foot
 one quarter inch = one foot
 one half inch = one foot
 three eighths inch = one foot
 one inch = one foot
 one and one half inches = one foot
 three inches = one foot

Revision#	Description	Date:

CONSULTANTS

<p>STRUCTURAL:</p> <p>Albertson Engineering, Inc. 3202 W. Main St. #C Rapid City, South Dakota 57702 Phone: 605-343-9606</p>	<p>MECHANICAL / ELECTRICAL / PLUMBING:</p> <p>WPE West Plains Engineering, Inc. 1750 Rand Road Rapid City, South Dakota 57702 Phone: 605-348-7455</p>
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ARCHITECT OF RECORD

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 TODD STONE, AIA

STAMP

Office of Construction and Facilities Management

VA U.S. Department of Veterans Affairs

Drawing Title
SECOND FLOOR AREA A DOMESTIC PIPING PLAN

Phase
CONSTRUCTION DOCUMENTS

Approved:

Project Title
RENOVATE AND CONSOLIDATE INPATIENT FUNCTIONS

Location
FORT MEADE, SOUTH DAKOTA

Issue Date
06/10/2022

Checked
MSH


Drawn
MMM

Project Number
VA #568-14-110
WPE #BR21020
Building Number
113

Drawing Number
PP107

Three inches = one foot
one and one half inches = one foot
one inch = one foot
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one half inch = one foot
three eighths inch = one foot
one eighth inch = one foot
one quarter inch = one foot
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- GENERAL MECHANICAL NOTES**
- A. CONTRACTOR SHALL COORDINATE PIPE ROUTING WITH OTHER TRADES. PROVIDE ALL ADDITIONAL OFFSETS AS REQUIRED TO COMPLETE INSTALLATION.
 - B. ISOLATE ALL COPPER PIPES FROM BEARING ON FERROUS HANGERS, ETC. WITH ELECTRICALLY INSULATING MATERIALS AS SPECIFIED. USE DIELECTRIC UNIONS IN CONNECTION OF ALL COPPER PIPING TO FERROUS PIPING AS SPECIFIED.
 - C. DOMESTIC WATER RECIRCULATION BALANCING VALVES SHALL BE AN AUTOFLOW STYLE VALVE, 0.33 GPM.
 - D. COORDINATE PHASING WITH CONTRACTING OFFICER AND REFER TO PHASING PLAN. FOR PIPING SERVING BUILDING AREAS THAT WILL REMAIN IN OPERATION, THE NEW PIPING IS TO BE INSTALLED AND CONNECTED PRIOR TO EXISTING PIPING BEING REMOVED. TEMPORARY PIPING SHALL BE INSTALLED AS REQUIRED.
- MECHANICAL SPECIFIC NOTES**
- P650 1-1/2\" CW, 1\" RW, AND 1/2\" RW DOWN TO FIRST FLOOR. REFER TO PP106, FIRST FLOOR AREA B & C DOMESTIC PIPING PLAN, FOR CONTINUATION.
 - P651 PROVIDE 1/2\" CW PIPE FROM SINK TO OWNER PROVIDED COFFEE MAKER.
 - P652 PROVIDE AND INSTALL JOSAM MODEL NUMBER 75002B STAINLESS STEEL BELLOWS STYLE WATER HAMMER ARRESTOR ON INDICATED DOMESTIC WATER PIPE.

1 SECOND FLOOR DOMESTIC PLUMBING PLAN - AREA B
1/8\" = 1'-0\"

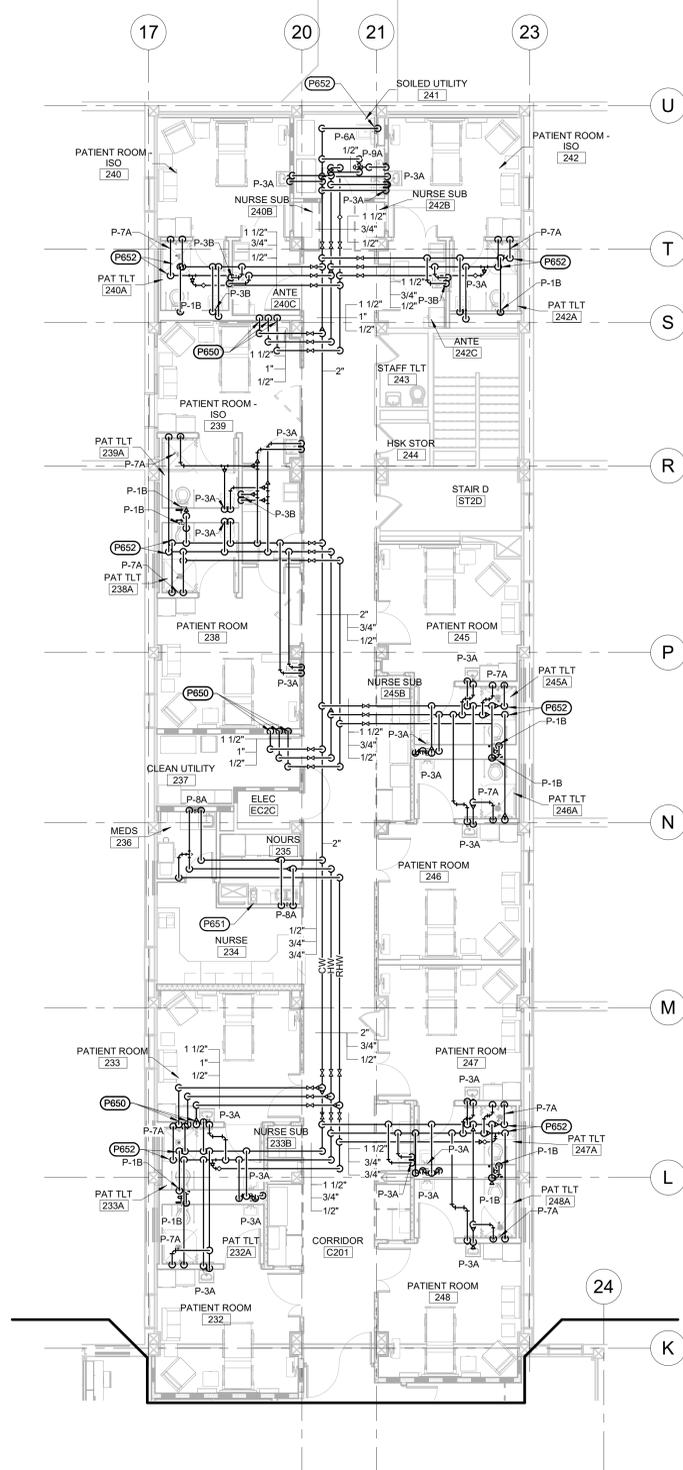Revision#	Description	Date:

CONSULTANTS

STRUCTURAL:
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3202 W. Main St. #C
Rapid City, South Dakota 57702
Phone: 605-343-9606

MECHANICAL / ELECTRICAL / PLUMBING:
West Plains Engineering, Inc.
1750 Rand Road
Rapid City, South Dakota 57702
Phone: 605-348-7455

ARCHITECT OF RECORD

A/E:
STONE GROUP ARCHITECTS, INC.
319 N. MAIN AVE.
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TODD STONE, AIA

STAMP

Office of Construction and Facilities Management

VA U.S. Department of Veterans Affairs

Drawing Title
SECOND FLOOR AREA B & C DOMESTIC PIPING PLAN

Approved:

Phase
CONSTRUCTION DOCUMENTS

FULLY SPRINKLERED

Project Title
RENOVATE AND CONSOLIDATE INFIRIARY FUNCTIONS

Location
FORT MEADE, SOUTH DAKOTA

Issue Date
06/10/2022

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MSH

Drawn
MMM



Project Number
VA #568-14-110
WPE #BR21020

Building Number
113

Drawing Number
PP108

Three inches = one foot
 one and one half inches = one foot
 one inch = one foot
 three quarters inch = one foot
 one half inch = one foot
 three eighths inch = one foot
 one quarter inch = one foot
 one eighth inch = one foot

PLUMBING FIXTURE SCHEDULE									
UNIT TYPE	UNIT NUMBER	MANUFACTURER	MODEL	FIXTURE TYPE	WASTE	VENT	SUPPLY		TRIM/REMARKS
							CW	HW	
P	1A	AMERICAN STANDARD	MADERA 3481.001	WATER CLOSET (FLOORMOUNT FV HET) 1.28 GPF ADA	4"	2"	1 1/4"		OLSONITE #95, WHITE OPEN FRONT SS CHECK HINGE, ELONGATED BOWL, SIPHON JET, SLOAN REGAL, 11-1.2 XL, ADA COMPLIANT, MINIMUM 800 MAP FLUSH PERFORMANCE **
P	1B	AMERICAN STANDARD	AFWALL 3351.101	WATER CLOSET (WALLHUNG FV HET) 1.2 GPF MOUNT AT ADA HEIGHT	4"	2"	1 1/4"		OLSONITE #95, WHITE OPEN FRONT SS CHECK HINGE, ADA ELONGATED BOWL, SIPHON JET, SLOAN REGAL, 11-1.2 XL, ADA COMPLIANT, MINIMUM 800 MAP FLUSH PERFORMANCE **
P	3A	AMERICAN STANDARD	LUCERNE 0355.012	LAVATORY (WALLHUNG) ADA MEDICAL	2"	1 1/2"	1/2"	1/2"	SYMMONS S-264-GLOW-GNA, WRIST SLIDE HANDLE, GRID DRAIN, HAND-TRAP SUPPLY/DRAIN PROTECTION, POWERS LFG480 THERMOSTATIC MIXING VALVE WITH INTEGRAL CHECK VALVES, LAMINAR FLOW, ADA
P	3B	AMERICAN STANDARD	9141.011	LAVATORY (WALLHUNG) ADA MEDICAL	2"	1 1/2"	1/2"	1/2"	SLOAN ETF-770 GOOSENECK SENSOR OPERATED, 120V TRANSFORMER (INTERCONNECTING WIRING BY THIS CONTRACTOR, COORDINATE WITH DIV 28) GRID DRAIN, HAND-TRAP SUPPLY/DRAIN PROTECTION, POWERS LFG480 THERMOSTATIC MIXING VALVE, LAMINAR FLOW, SPEARMAN SE-577-SD-ADA EYEWASH W/MIXING VALVE, ADA
P	4A	ELKAY	LZS8WSLK	WATER CHILLER WITH BOTTLE FILLER (SINGLE) ADA	2"	1 1/2"	1/2"	1/2"	ANTI-SQUIRT BUBBLER, SS TOP AND SHROUD, FRONT/SIDE PUSH BARS, 3-PACK FILTER REPLACEMENT, ADA
P	5A	FIAT	MSB-2424	SERVICE SINK 24"x24"	3"	1 1/2"	1/2"	1/2"	CHICAGO 540-LD-8975-WXF, FIAT NO. 895-CC MOP HANGER, NO. 832-AA 30" HOSE AND HOSE BRACKET, INTEGRAL STOPS, 2" SS DRAIN AND DOME STRAINER
P	6A	AMERICAN STANDARD	9504.010	CLINIC SERVICE SINK (FLOORMOUNT FLUSH VALVE) 1.6 GPF	4"	2"	1 1/4"		SS RIM GUARD, 7880 124 BEDPAN CLEANSER ASSEMBLY, SLOAN ROYAL 117 STANDARD HYVO FLUSH VALVE
P	7A	TRIM ONLY		SHOWER	2"	1 1/2"	1/2"	1/2"	SYMMONS TEMPITROL 96-500-B30-L-V PRESSURE-BALANCE MIXING VALVE, 30" SLIDE BAR WITH 60" FLEXIBLE METAL HOSE, HAND SPRAY WITH INLINE VACUUM BREAKER, DIVERTER VALVE SYMMONS NO. 4-270, HEAD, ADA COMPLIANT
P	8A	TRIM ONLY		SINK	2"	1 1/2"	1/2"	1/2"	ELKAY MODEL LK-3000CR SUPPLY FITTING, POWERS LFG480 THERMOSTATIC MIXING VALVE WITH INTEGRAL CHECK VALVES, LK99 GRID DRAIN, ADA COMPLIANT
P	9A	GUARDIAN	G1750	EYE/FACE WASH FIXTURE WITH WALL BRACKET	2"	1 1/2"	1/2"		EYE/FACE RECEPTOR AND HEAD, SS BOWL, DUST COVER, INTERNAL FILTERS, STAY OPEN BALL VALVES, POWDER-COATED CAST ALUMINUM FLAG HANDLE AND WALL BRACKET, GUARDIAN G6020 MIXING VALVE, ANSI COMPLIANT EMERGENCY SIGN
P	10B	GUY-GRAY	BIM875	ICE MAKER BOX			1/2"		RECESSED ICE MAKER BOX WITH 1/2" SUPPLY GATE VALVE, CAPPED FOR FUTURE CONNECTION, FIXTURE MOUNTING HEIGHT 48" A.F.F.

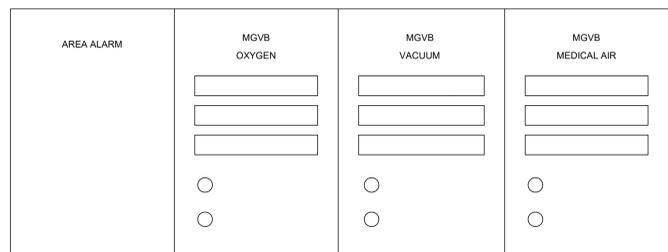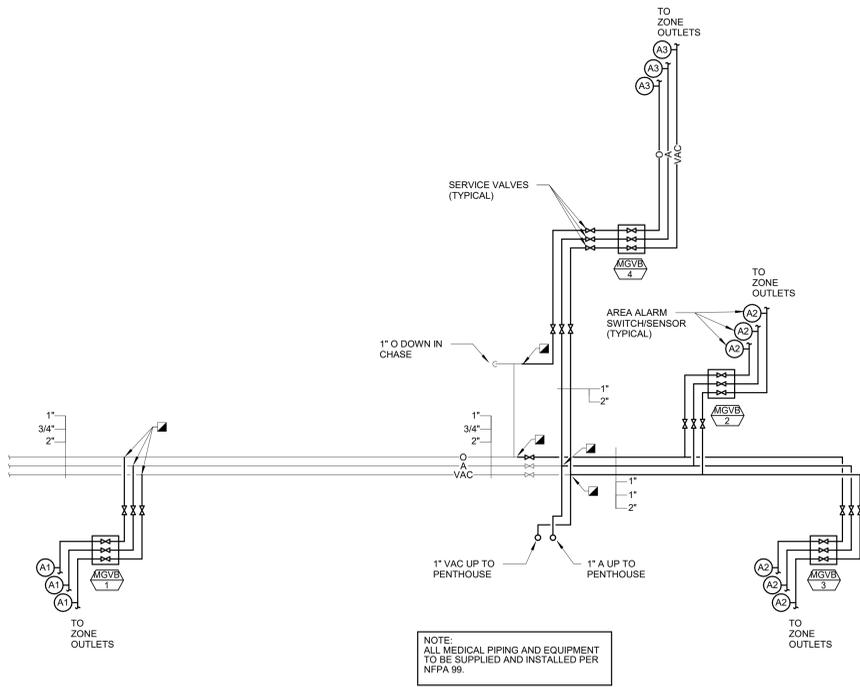

MEDICAL GAS AREA ALARM PANELS
 A1: NURSE'S STATION 204
 A2: NURSE'S STATION 265
 A3: NURSE'S STATION 234

Revision#	Description	Date:

CONSULTANTS

STRUCTURAL:
 Albertson Engineering, Inc.
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 Rapid City, South Dakota 57702
 Phone: 605-343-9606

MECHANICAL / ELECTRICAL / PLUMBING:
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 TODD STONE, AIA

STAMP

Professional Engineer
 REG. NO. 8462
 MICHAEL SEAN HENNING
 SIOUX FALLS, SD
 6/10/2022

Office of Construction and Facilities Management

VA U.S. Department of Veterans Affairs

Drawing Title
PLUMBING DETAILS AND SCHEDULES

Approved:

Phase
CONSTRUCTION DOCUMENTS

FULLY SPRINKLERED

Project Title
RENOVATE AND CONSOLIDATE INPATIENT FUNCTIONS

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FORT MEADE, SOUTH DAKOTA

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PJ101