

GENERAL NOTES:


1. THERE ARE OTHER UTILITIES, EQUIPMENT, ETC IN THIS SPACE THAT ARE NOT SHOWN FOR CLARITY. CONTRACTOR TO ACCOUNT FOR THESE ITEMS.
2. ALL MED GAS PIPING IS LOCATED IN CEILINGS AND WALLS. PATCH WALLS AFTER WORK IS COMPLETE.
3. PAINT TO MATCH EXISTING, COORDINATE WITH OWNER. IF COLOR CANNOT BE MATCHED, CONTRACTOR TO PAINT CORNER TO CORNER AND MAKE ACCENT WALL.
4. CONTRACTOR TO SCHEDULE WORK WITH THE VA COR.
5. MEDICAL GAS CERTIFICATIONS TO BE PERFORMED IN EACH AREA OR SYSTEM IMMEDIATELY AFTER IT IS COMPLETED.
6. ALL OLD TO NEW SWITCH OVER NEEDS TO HAPPEN IN ONE NIGHT SHUTDOWN AND CERTIFIED AT THE SAME TIME.

KEYED PLUMBING NOTES

- ① REMOVE EXISTING ALARM PANEL AND GAS PRESSURE PIPING FROM ALARM PANEL TO BRANCH.
- ② REMOVE AND RETAIN LOCKING ACCESS PANEL.
- ③ REMOVE EXISTING MEDICAL VACUUM EXHAUST PIPING ONLY AFTER NEW EXHAUST PIPING IS INSTALLED AND OPERATIONAL. PATCH HOLE IN CONCRETE DECK AND SEAL PENETRATION WITH SAME ROOFING MATERIAL.

LINE LEGEND

	EXISTING
	DEMO
	NEW CONSTRUCTION
	ALARM PANEL
	ZONE VALVES
	SENSORS
	CONNECT POINT
	DISCONNECT POINT
	DUST BARRIER
	1-HR FIRE RATED WALL
	2-HR FIRE RATED WALL
	SMOKE BARRIER

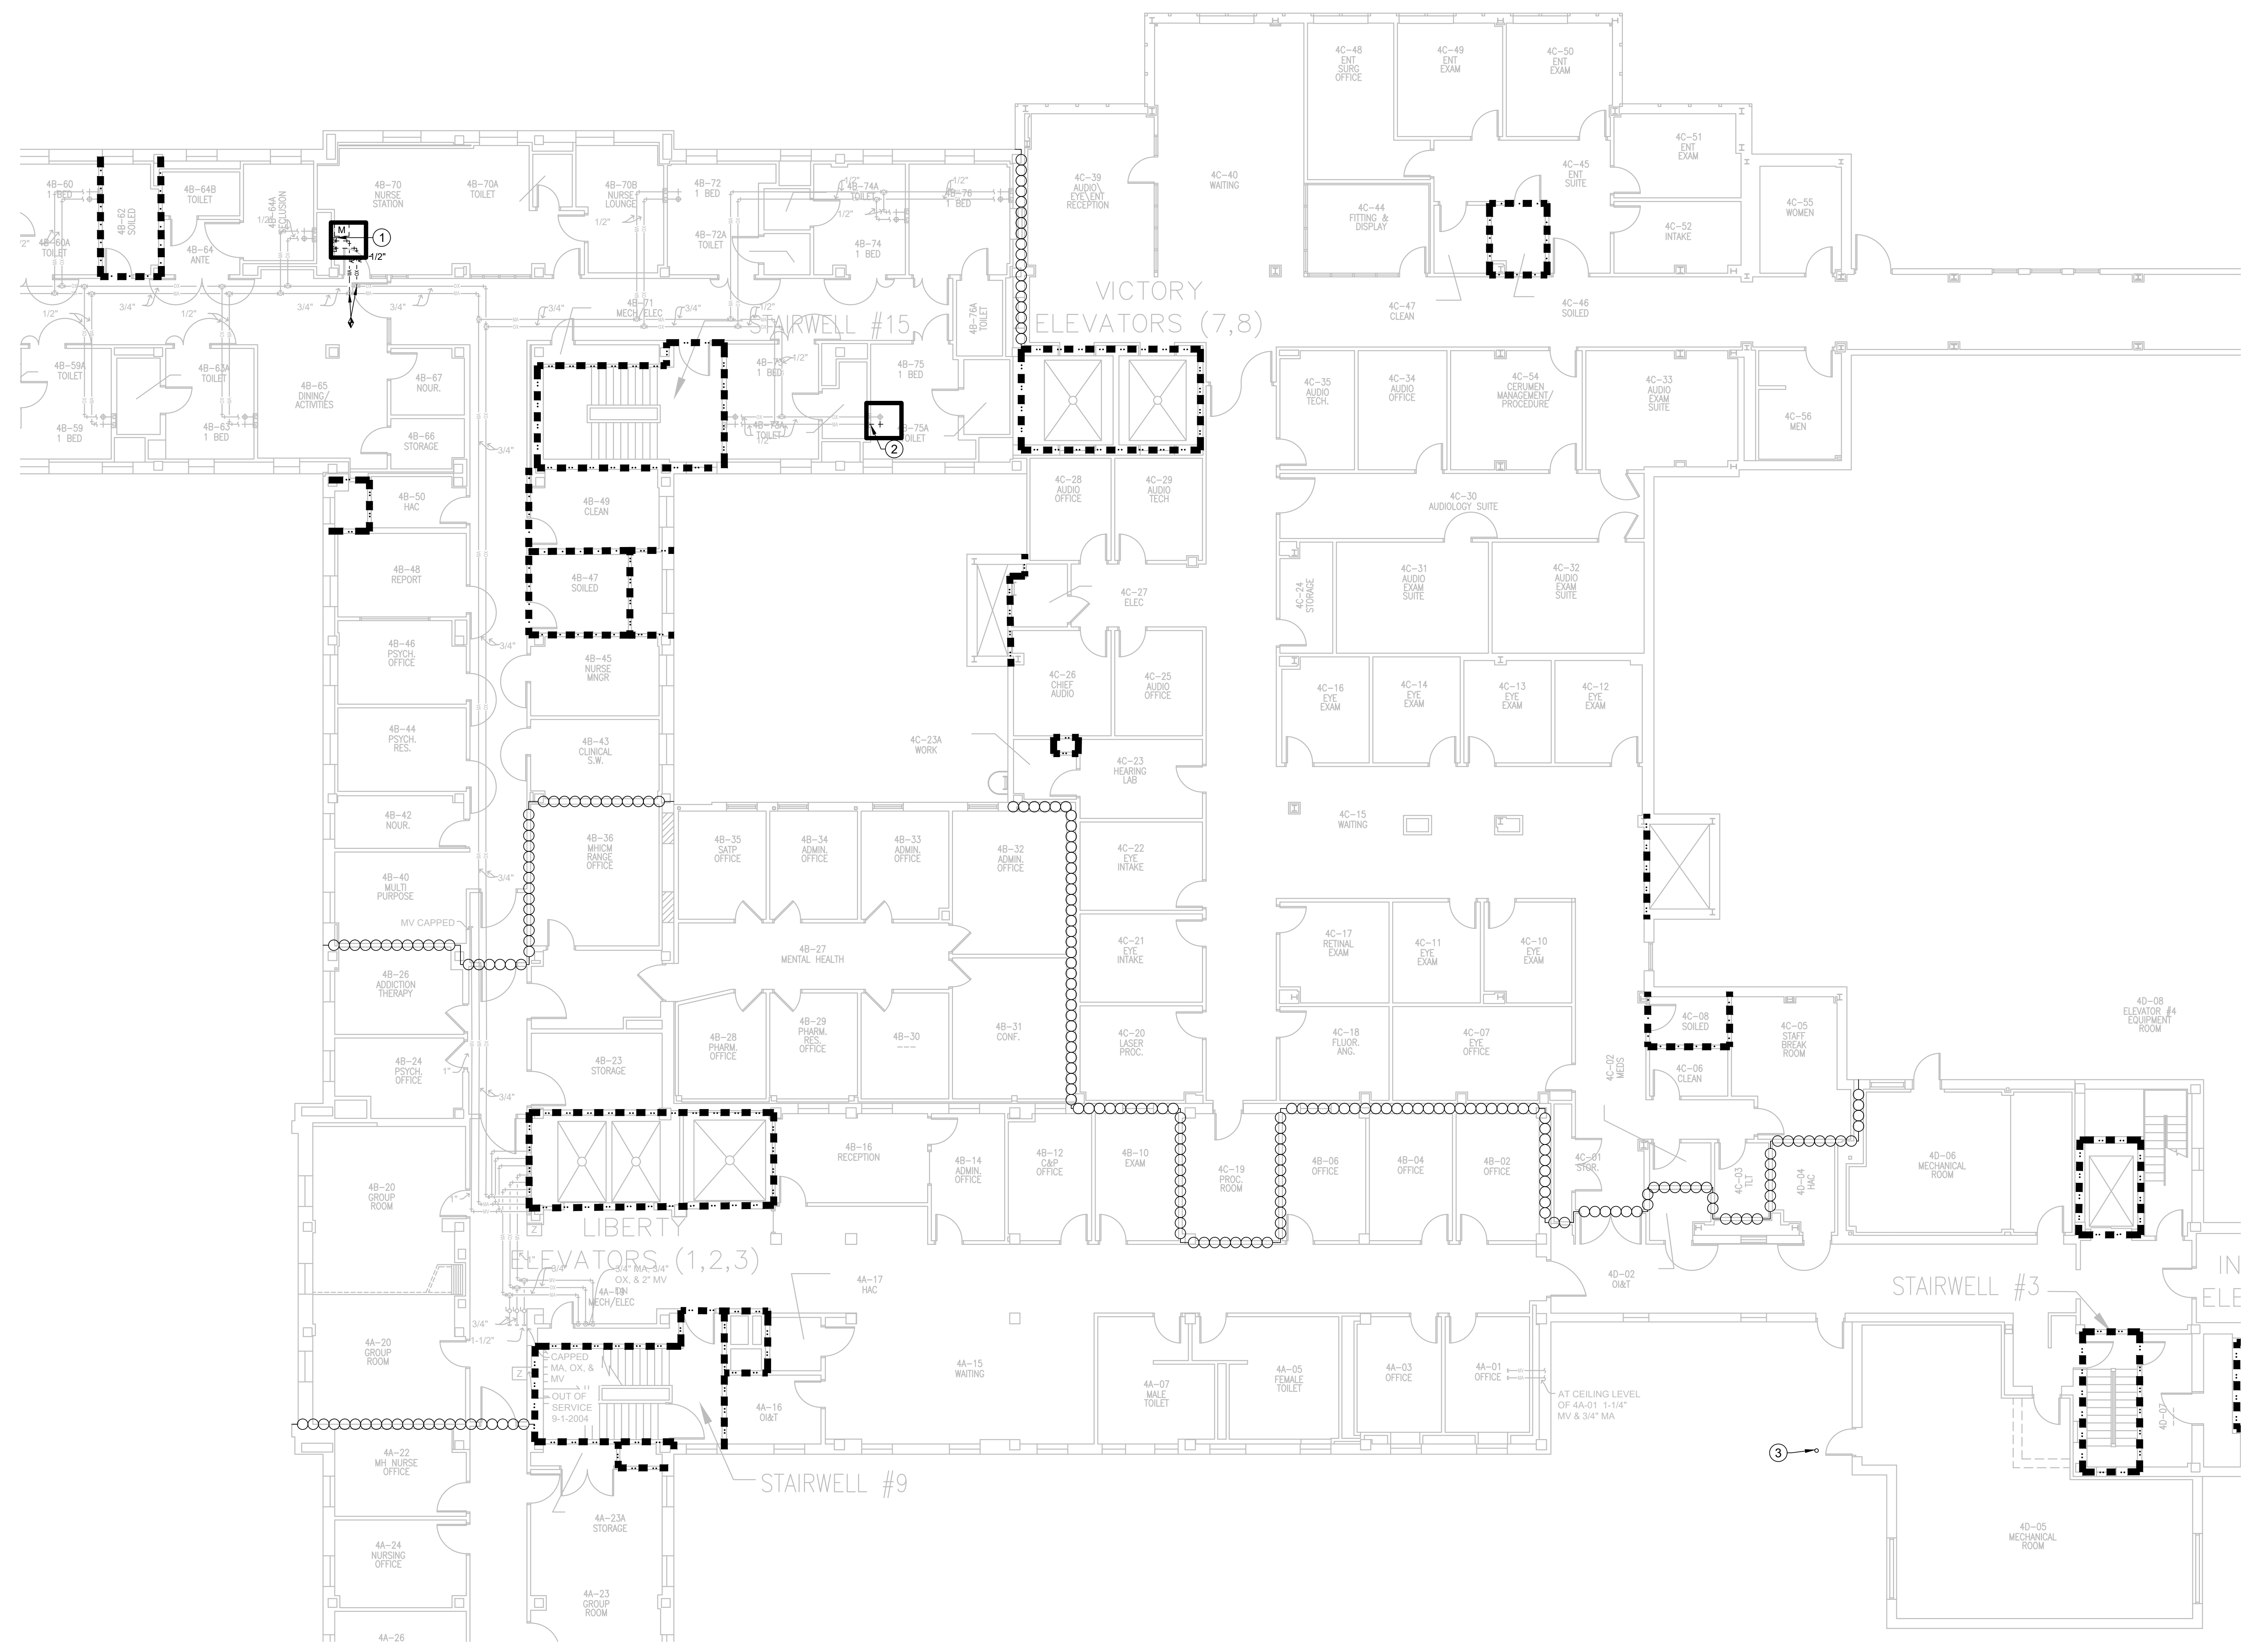

1 FOURTH FLOOR - DEMOLITION PLAN
 P-1.41 SCALE: 1/8" = 1'-0"
 PLAN NORTH TRUE NORTH

100% CONSTRUCTION DOCUMENTS

CONSULTANTS: Revisions: _____ Date _____	ARCHITECT FOURFRONT DESIGN, INC. 517 7TH STREET RAPID CITY, SOUTH DAKOTA 57701 PH: (605) 342-9470 FAX: (605) 342-2377 WWW.FOURFRONTDESIGN.COM	Drawing Title FOURTH FLOOR - DEMOLITION PLAN	Project Title UPGRADE MEDICAL GAS SYSTEM	Project Number 437-21-160	Office of Construction and Facilities Management
		Approved: Project Director Fargo VA Health Care System	Location 2101 ELM ST N, FARGO, ND 58102	Building Numbers 1,9,46	

GENERAL NOTES:


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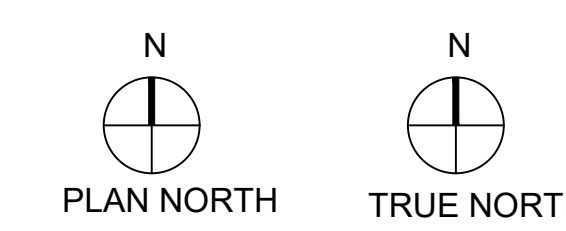
- ① INSTALL NEW ALARM PANELS IN LOCATION SHOWN. INSTALL NEW PRESSURE SENSORS IN ZONE BRANCH PIPING DOWNSTREAM OF ZONE VALVES. 4B LOCKED WARD TRAINING, RECORD FORMS ALL HAVE TO BE COMPLETE BEFORE WORK STARTS. PATCH TO MATCH FINISHES.
- ② INSTALL NEW MEDICAL GAS OUTLET FOR MEDICAL AIR IN THE SHOWN LOCATION. REUSE EXISTING LOCKING ACCESS PANEL. NEW OUTLET SHALL BE CERTIFIED, APPROVED AND OPERATIONAL IMMEDIATELY AFTER INSTALLATION.
- ③ COREDRILL AND INSTALL 3" VACUUM PIPING UP TO GOOSENECK ON THE ROOF OF 4D-05 MECHANICAL ROOM AT THE SAME TIME AS VACUUM EQUIPMENT REPLACEMENT SO IT CAN BE COMPLETED WITHIN ONE SHUTDOWN. NEW VACUUM EXHAUST PIPING SHALL BE OPERATIONAL.

LINE LEGEND

	EXISTING
	DEMO
	NEW CONSTRUCTION
	ALARM PANEL
	ZONE VALVES
	SENSORS
	CONNECT POINT
	DISCONNECT POINT
	DUST BARRIER
	1-HR FIRE RATED WALL
	2-HR FIRE RATED WALL
	SMOKE BARRIER



1 FOURTH FLOOR - REMODEL PLAN
P-1.42 SCALE: 1/4" = 1'-0"

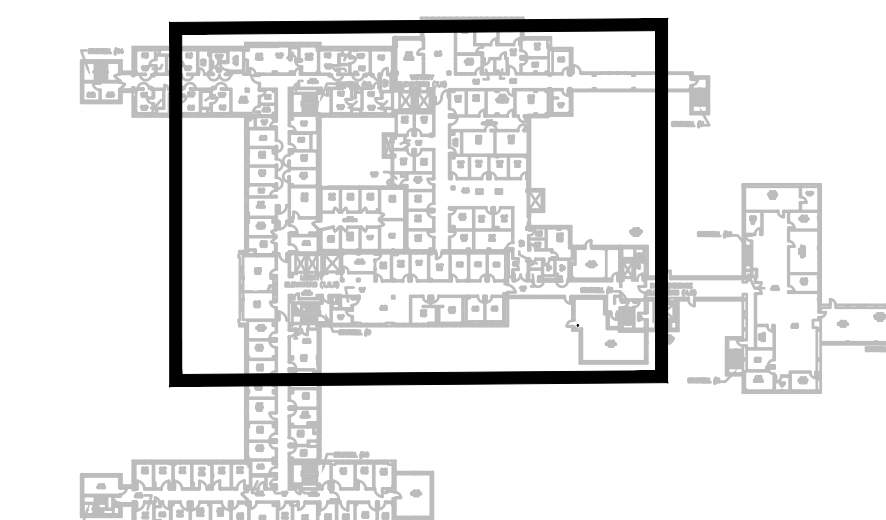

100% CONSTRUCTION DOCUMENTS

<p>CONSULTANTS:</p>	<p>ARCHITECT</p> <p>FOURFRONT DESIGN, INC. 517 7TH STREET RAPID CITY, SOUTH DAKOTA 57701 PH: (605) 342-9470 FAX: (605) 342-2377 WWW.FOURFRONTDESIGN.COM</p>	<p>Drawing Title</p> <p>FOURTH FLOOR - REMODEL PLAN</p>	<p>Project Title</p> <p>UPGRADE MEDICAL GAS SYSTEM</p>	<p>Project Number</p> <p>437-21-160</p>	<p>Office of Construction and Facilities Management</p>				
		<p>Approved: Project Director</p> <p>Fargo VA Health Care System</p>	<p>Location</p> <p>2101 ELM ST N, FARGO, ND 58102</p>	<p>Building Numbers</p> <p>1,9,46</p>		<p>Drawing Number</p> <p>P-1.42</p>			
		<p>Date</p> <p>07/07/2021</p>	<p>Checked</p> <p>RD</p>	<p>Drawn</p> <p>BM</p>		<p>Dwg. 27 of 40</p>			
		<p>Revisions:</p> <table border="1"> <tr> <th>No.</th> <th>Description</th> <th>Date</th> </tr> <tr> <td> </td> <td> </td> <td> </td> </tr> </table>	No.	Description		Date			
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one and one half inches = one foot
 three quarters inch = one foot
 one half inch = one foot
 three eighths inch = one foot
 one quarter inch = one foot
 one eighth inch = one foot

ELECTRICAL LEGEND (FLOORPLAN)			
SYMBOL	DESCRIPTION	SYMBOL	DESCRIPTION
	MOTOR, SINGLE-PHASE		INSTANTANEOUS OVERCURRENT RELAY
	MOTOR, THREE-PHASE		AC-TIME OVERCURRENT RELAY
	TRANSFORMER		AC-DIRECTIONAL OVERCURRENT RELAY
	WYE CONNECTION		LOCKING OUT RELAY
	DUCT, CELL FLOOR HEADER		DISCONNECT SWITCH, FUSED
	DUCT, TROLLEY		DISCONNECT SWITCH, UNFUSED
	DUCT, UNDERFLOOR JUNCTION BOX		STARTER, COMBINATION WITH DISCONNECT SWITCH
	EARTH GROUND		STARTER OR MOTOR CONTROLLER
	JUNCTION BOX		VARIABLE FREQUENCY DRIVE
	LADDER CABLE TRAY		TIME CLOCK
	BRANCH CIRCUIT HOMERUN. LINES INDICATE NUMBER OF CIRCUITS, NEUTRAL, AND SWITCH LEG CONDUCTORS. ONE SEPARATE GREEN GROUNDING CONDUCTOR SHALL BE PROVIDED FOR EACH HOMERUN, NOT SHOWN		RECTIFIER, CATHODIC PROTECTION SANITARY
	PULL BOX		VENTILATOR OR FAN COIL UNIT OUTLET
	WIREWAY		CONDUIT TERMINATED 6" (152mm) AFF IN STANDARD BOX FOR EXTENSION TO EQUIPMENT AS DIRECTED.
	RIGID CONDUIT LINE = RC		CONDUIT TERMINATED W/COUPLING (FLUSH W/FINISHED FLOOR) FOR EXTENSION TO EQUIPMENT AS DIRECTED.
	DIRECT BURIAL CABLE = DB		W-WALL
	POWER DUCT = P		T-TECHNOLOGY/TYPE
	AUDIO VISUAL LINE = AV		B-BARCODE
	CABLE TELEVISION LINE = CATV		F-ELEVATOR FLOOR CALL
	CLOSED CIRCUIT TELEVISION LINE = CCTV		H-ELEVATOR HALL CALL
	FIBEROPTICS LINE = FO		S-SMART CARD
	COMMUNICATIONS LINE = COM		M-MAGNETIC
	INTERCOM LINE = I		D-DEADBOLT
	NURSE CALL LINE = NC		H-HYBRID
	SUBSTATION		L-LATCH SET
	HI VOLTAGE SWITCH ON CONCRETE PAD		M-MAGNETIC S-STRIKE
	LOW VOLTAGE SWITCH ON CONCRETE PAD		INTERCOM. LETTER INDICATES AS FOLLOWS:
	DUAL POWER AND TELECOMMUNICATIONS MANHOLE		M-MOUNT
	BUSWAY		C-CEILING
	DISTRIBUTION PANEL		D-DESK
	LIGHTING PANEL		F-FLUSH
	PANELBOARD CABINET, FLUSH MOUNTED		H-HIDDEN
	PANELBOARD CABINET, SURFACE MOUNTED		R-RACK
	RECEPTACLE, CLOCK HANGER		S-SURFACE
	RECEPTACLE, DUPLEX		TELEVISION WALL RECEPTACLE
	RECEPTACLE, DUPLEX ON EMERGENCY POWER		C = CAMERA (CCTV SYSTEM)
	RECEPTACLE, GFCI DUPLEX		M = MONITOR (CATV SYSTEM)
	RECEPTACLE, QUADRUPLEX		AV = AUDIO VISUAL (CONFERENCE ROOM CONNECTION RECEPTABLES)
	RECEPTACLE, SPECIAL PURPOSE 120V, 20A, 1 PHASE, 2-POLE, 3W, NEMA 5-20R		TELEVISION CEILING RECEPTACLE
	RECEPTACLE, SPECIAL PURPOSE 208V, 30A, 1 PHASE, 2-POLE, 3W, NEMA 5-30R		C = CAMERA (CCTV SYSTEM)
	RECEPTACLE, SPECIAL PURPOSE 120V, 30A, 1 PHASE, 2-POLE, 3W, NEMA 5-30R		M = MONITOR (CATV SYSTEM)
	RECEPTACLE, SPECIAL PURPOSE 208V, 30A, 1 PHASE, 2-POLE, 3W, NEMA 5-30R		AV = AUDIO VISUAL (CONFERENCE ROOM CONNECTION RECEPTABLES)
	RECEPTACLE, SPECIAL PURPOSE 208V, 60A, 1 PHASE, 3-POLE, 4W, NEMA 14-60R		TELEVISION FLOOR RECEPTACLE
	RECEPTACLE, SPECIAL PURPOSE 208V, 30A, 3 PHASE, 3-POLE, 4W, NEMA 15-30R		C = CAMERA (CCTV SYSTEM)
	RECEPTACLE, SPECIAL PURPOSE 208V, 60A, 3 PHASE, 3-POLE, 4W, NEMA 15-60R		M = MONITOR (CATV SYSTEM)
	RECEPTACLE, SPECIAL PURPOSE 208V, 20A, 3 PHASE, 3-POLE, 4W, NEMA 15-20R		AV = AUDIO VISUAL (CONFERENCE ROOM CONNECTION RECEPTABLES)
	RECEPTACLE, SWITCHED DUPLEX		PAGING SPEAKER, CEILING MOUNTED
	RECEPTACLE, SPECIAL PURPOSE 208V, 60A, 3 PHASE, 3-POLE, 4W, NEMA 15-60R		PAGING SPEAKER, WALL MOUNTED
	RECEPTACLE, SPECIAL PURPOSE 208V, 20A, 3 PHASE, 3-POLE, 4W, NEMA 15-20R		NURSES CALL MASTER STATION
	RECEPTACLE, SWITCHED DUPLEX		NURSE CALL TERMINAL CABINET.
	DROP CORD, SINGLE CONVENIENCE OUTLET, 3-WIRE, GROUNDING TYPE, 20A, W#12 CONDUCTORS IN FLEXIBLE CORD (CENTER LINE OF OUTLET: 6" [151mm] AFF. MINIMUM)		NURSE CALL STATION
	ELECTRICAL STRIP MOLD (OUTLETS ON 2" [51mm] CENTERS OR AS DESIGNATED ON DRAWINGS, MTD 3'-6" [1067mm] AFF OR AS INDICATED)		D = DUTY STATION, MTD 5' AFF
			E = MTD 6' AFF FOR SHOWER LOCATION
			F = MTD 4'-6" AFF FOR TUB LOCATION
			M = MTD 3' AFF FOR TOILET LOCATION
			P = PSYCHIATRIC CORRIDOR STATION WITH KEY SWITCH
			S = AUDIO VISUAL STAFF STATION MTD 5' AFF
			U = UTILITY CALL STATION, MTD 5' AFF

ELECTRICAL LEGEND (DETAILS)	
SYMBOL	DESCRIPTION
	DELTA CONNECTION
	MOTOR, SINGLE-PHASE
	MOTOR, THREE-PHASE
	TRANSFORMER
	WYE CONNECTION
	EARTH GROUND
	JUNCTION BOX
	PULL BOX
	PRESSURE SWITCH-CLOSE ON INCREASE
	PRESSURE SWITCH-OPEN ON INCREASE
	SWITCH, MULTIPosition
	SWITCH, NORMALLY CLOSED FLOAT
	SWITCH, NORMALLY CLOSED FOOT OPERATED
	SWITCH, NORMALLY CLOSED LIMIT
	SWITCH, NORMALLY CLOSED TEMPERATURE ACTIVATED
	SWITCH, NORMALLY CLOSED TIME DELAY
	SWITCH, NORMALLY OPEN FLOAT
	SWITCH, NORMALLY OPEN LIMIT
	SWITCH, NORMALLY OPEN TEMPERATURE ACTIVATED
	SWITCH, NORMALLY OPEN TIME DELAY
	SWITCH, SINGLE BREAK
	NORMALLY CLOSED RELAY CONTACT
	NORMALLY OPEN RELAY CONTACT
	FUSE WITH RATING
	MOLDED CASE CIRCUIT BREAKER
	LOW-VOLTAGE DRAWOUT AIR CIRCUIT BREAKER
	HIGH-VOLTAGE OIL CIRCUIT BREAKER
	HIGH-VOLTAGE DRAWOUT AIR CIRCUIT BREAKER
	SWITCH AND FUSE UNIT
	FUSED DRAWOUT POTENTIAL TRANSFORMER
	INSTANTANEOUS OVERCURRENT RELAY
	AC-TIME OVERCURRENT RELAY
	AC-DIRECTIONAL OVERCURRENT RELAY
	LOCKING OUT RELAY
	DISCONNECT SWITCH, FUSED
	DISCONNECT SWITCH, UNFUSED
	FUSIBLE LINK
	STARTER, COMBINATION WITH DISCONNECT SWITCH
	STARTER OR MOTOR CONTROLLER
	TIME CLOCK
	GENERATOR, POWER
	BATTERY
	CAPACITOR
	POTHEAD
	STRESS CONE
	LIGHTNING ARRESTOR
	RECTIFIER, CATHODIC PROTECTION SANITARY
	METER
	AMMETER
	VOLTMETER
	WATTMETER
	WATT-HOUR METER


ELECTRICAL ABBREVIATIONS			
SYMBOL	DESCRIPTION	SYMBOL	DESCRIPTION
1PH	SINGLE-PHASE	ELEC	ELECTRIC OR ELECTRICAL
2/C	TWO-CONDUCTOR	ELEV	ELEVATOR
3/C	THREE-CONDUCTOR	EMCP	EMERGENCY MONITORING CONTROL PANEL
3PH	THREE-PHASE	EMER	EMERGENCY ENCLOSURE
4/C	FOUR-CONDUCTOR	EMI	ELECTROMAGNETIC INTERFERENCE
4W	FOUR-WIRE	EMT	ELECTRICAL METALLIC TUBING
AAP	ALARM ANNUNCIATOR PANEL	ENCLOSURE	ENCLOSURE
AC	ALTERNATING CURRENT OR ARMORED CABLE	EPO	EMERGENCY POWER OFF
AH	AMPERE HOUR	EPF	EXPLOSION PROOF
AHJ	AUTHORITY HAVING JURISDICTION	ESMT	EASEMENT
ACC	ACCESSIBLE	EWC	ELECTRIC WATER COOLER
ADD	AUTOMATIC DOOR OPENER	EWV	ELECTRIC WATER HEATER
AFC	ABOVE FINISHED COUNTER, AUTOMATIC FREQUENCY CONTROL, OR AVAILABLE FAULT CURRENT	EXIST	EXISTING
AFS	ABOVE FINISHED FLOOR	FA	FIRE ALARM
AFB	FIRE ALARM BELL	FAAP	FIRE ALARM ANNUNCIATOR PANEL
AH	AMPERE HOUR	FAB	FIRE ALARM BOX
AHJ	AUTHORITY HAVING JURISDICTION	FABX	FIRE ALARM BOX
AMP	AMPERE	FACP	FIRE ALARM CONTROL PANEL
ASC	AMPS SHORT CIRCUIT	FC	FOOT CANDLE
AT	AUTOMATIC	FIXT	FIXTURE
AV	AUDIO VISUAL	FLA	FULL LOAD AMPS
BAS	BUILDING AUTOMATION SYSTEM	FLX	FLEXIBLE METALLIC CONDUIT
BFF	BELOW FINISH FLOOR	FLT	FLOODLIGHT
BLDG	BUILDING	FLOR	FLOOR
BRP	BOILER PLANT INSTRUMENTATION PANEL	FLOR FIX	FLOURESCENT FIXTURE
BRKR	BREAKER	FOUITT	FOUR INCH TELEPHONE FLOOR OUTLET
BYP	BY PASS	FT	FEET OR FOOT
C	CONDUIT	FU SW	FUSED SWITCH
CAB	CABINET	FVR	FULL VOLTAGE NON-REVERSING POWER FACTOR
CALC	CALCULATE	G OR GND	GROUND
CAP	CAPACITY	GEN	GENERATOR
CAT	CATALOG	GFCI	GROUND FAULT CIRCUIT INTERRUPTER
CATV	COMMUNITY ANTENNA TELEVISION	GTB	GROUND TERMINAL BOX
CD	CONSTRUCTION DOCUMENTS	HID	HIGH INTENSITY DISCHARGE
CCTV	CLOSED CIRCUIT TELEVISION	HOA	HAND-OFF AUTOMATIC HORSEPOWER
CD	CANDELA	HT	HEIGHT
CF	CONTRACTOR DOCUMENTS	IESNA	ILLUMINATION ENGINEERING SOCIETY OF NORTH AMERICA
CF/CI	CONTRACTOR FURNISHED/CONTRACTOR INSTALLED	IMC	INTERMEDIATE METAL CONDUIT
CF/CI	CONTRACTOR FURNISHED/OWNER INSTALLED	INCAND	INCANDESCENT
CHW	CHILLED WATER	IR	INFRARED
CHWP	CHILLED WATER PUMP	IWH	INSTANTANEOUS WATER HEATER
CKT	CIRCUIT	J-BOX	JUNCTION BOX
CKT BRKR	CIRCUIT BREAKER	KV	KILOVOLT
CLF	CURRENT LIMITING FUSE	KVA	KILOVOLT AMPERE
CLG	CEILING	KVAH	KILOVOLT AMPERE PER HOUR
CMU	CONCRETE MASONRY UNIT	KVAR	KILOVOLT AMPERE REACTIVE
COAK	COAX CABLE	KW	KILOWATT
COMM	COMMUNICATION	KWH	KILOWATT HOUR
CONC	CONCRETE	MHM	KILOWATT HOUR METER
CONTR	CONTRACTOR	LED	LIGHT EMITTING DIODE
COORD	COORDINATE	LEAF	LINEAR FEET (FOOT)
CR	COLOR RENDERING INDEX	LM	LUMEN
CT	CURRENT TRANSFORMER	LP	LIGHT POLE
CTV	CABLE TELEVISION	LPS	LOW PRESSURE SODIUM
CJ	COPPER	LRA	LOCKED ROTOR AMPS
CJ FT	CUBIC FEET	LTC	LOCAL TEMPERATURE CONTROL PANEL
CUR	CURRENT	LT	LIGHT
DAS	DISTRIBUTED ANTENNA SYSTEM	LTD	LIGHTING
DB	DECIBEL	LTC PNL	LIGHTING PANEL
DC	DIRECT CURRENT	LTNG	LIGHTNING
DCP	DIMMER CONTROL PANEL	LV	LOW VOLTAGE
DEG C	DEGREES CELSIUS	MATV	MASTER ANTENNA TELEVISION SYSTEM
DEG F	DEGREES FAHRENHEIT	MAX	MAXIMUM
DEMO	DEMOLITION	MC	METAL-CLAD
DIAG	DIAGRAM	MCA	MINIMUM CIRCUIT AMPS
DISC	DISCONNECT	MCC	MAIN CIRCUIT BREAKER
DISTR	DISTRIBUTION	MCC	MOTOR CONTROL CENTER
DISTR PNL	DISTRIBUTION PANEL	MCP	MAIN DISTRIBUTION PANEL
DMR SW	DIMMER SWITCH	MECH	MECHANICAL
DN	DOWN	MG	MOTOR GENERATOR
DPT	DOUBLE POLE, DOUBLE THROW	MANVLE	MANHANDLE
DRSW	DOOR SWITCH	MIN	MINIMUM
DS	DISCONNECT SWITCH	MOC	MAXIMUM OVERCURRENT PROTECTION
DWG	DRAWING	MU	MAIN LUGS ONLY
EC	EMPTY CONDUIT	MT	MOUNT
EG	ELEVATION	MTG	MOUNTING
EL	EQUIPMENT GROUND	MVA	MANUAL TRANSFER SWITCH
		MVA	MEGAVOLT-AMPERE
		MW	MEGAWATT MICROWAVE
		NA	NOT APPLICABLE
		NEG	NATIONAL ELECTRICAL CODE
		NEMA	NATIONAL ELECTRICAL MANUFACTURERS ASSOCIATION
		NEUT OR N	NEUTRAL
		NFPA	NATIONAL FIRE PROTECTION ASSOCIATION
		NIC	NOT IN CONTRACT
		NL	NIGHT LIGHT
		NO	NORMALLY OPEN
		NS	NO SCALE
		NTS	NOT TO SCALE
		OC	ON CENTER
		OD	OUTSIDE DIAMETER
		OF	OWNER FURNISHED
		OF/CI	OWNER FURNISHED/CONTRACTOR INSTALLED
		OF/CI	OWNER FURNISHED/OWNER INSTALLED
		OL	OVERLOAD
		OS	OCCUPANCY SENSOR
		P	POLE
		PA	PUBLIC ADDRESS
		PB	PANELBOARD, PULL BOX, OR PUSHBUTTON
		PBPV	PREFABRICATED BEDSIDE PATIENT UNIT
		PCB	POLYCHLORINATED BIPHENYL
		PEC	PHOTOELECTRIC CELL
		PEDESTAL	PEDESTAL
		PEND	PENDANT
		PH	PHASE
		PNL	PANEL
		PO	POWER OPERATED DAMPER
		PT	POTENTIAL TRANSFORMER
		PTRV	POWER TYPE ROOF VENTILATION
		PVC	POLYVINYL CHLORIDE (PLASTIC)
		PWR	POWER
		RCP	REFLECTED CEILING PLAN
		RECPT	RECESSED RECEPTACLE
		RGS	RIGID GALVANIZED STEEL
		RM	ROOM
		RMS	ROOT MEAN SQUARE
		REQD	REQUIRED
		SCC	SHORT CIRCUIT CAPACITY
		SES	SERVICE ENTRANCE SECTION
		SD	SMOKE DETECTOR
		SF	SQUARE FOOT (FEET)
		SHT	SHEET
		SI	INTERNATIONAL SYSTEM OF UNITS
		SPEC	SPECIFICATION
		SPST	SINGLE POLE, SINGLE THROW
		SPDT	SINGLE POLE, DOUBLE THROW
		SURF	SURFACE
		SW	SWITCH
		SWBD	SWITCHBOARD
		SWGR	SWITCHGEAR
		TC	TIME CLOCK
		TEL	TELEPHONE
		TP	TWISTED PAIR
		TPS	TWISTED PAIR SHIELDED
		TTB	TELEPHONE TERMINAL BOARD
		TV	TELEVISION
		TYP	TYPICAL
		UPD	UNDERFLOOR DUCT
		UGND	UNDERGROUND
		UL	UNDERWRITERS LABORATORY
		UNL	UNLESS OTHERWISE NOTED
		UPS	UNINTERRUPTIBLE POWER SUPPLY
		UTILITY	UTILITY
		V	VOLT
		VA	VOLT AMPERE
		VAR	VOLT AMPERE REACTIVE
		VFD	VARIABLE FREQUENCY DRIVE
		VOLT	VOLTAGE
		VS	VACUANCY SENSOR
		W	WATT
		WH	WATER HEATER
		WP	WEATHERPROOF
		XFER	TRANSFER
		XFMR	TRANSFORMER

SHEET LIST TABLE	
SHEET NUMBER	SHEET TITLE
E-0.00	ELECTRICAL LEGEND AND ABBREVIATIONS
E-1.01	BASEMENT ELECTRICAL PLANS
E-1.02	BASEMENT I&C PLANS AND ALARM PANEL COMMUNICATION DETAIL
E-1.11	FIRST FLOOR ELECTRICAL DEMOLITION PLAN
E-1.12	FIRST FLOOR NEW ELECTRICAL PLAN
E-1.21	SECOND FLOOR ELECTRICAL DEMOLITION PLAN AREA 1
E-1.22	SECOND FLOOR ELECTRICAL DEMOLITION PLAN AREA 2
E-1.23	SECOND FLOOR NEW ELECTRICAL PLAN AREA 1
E-1.24	SECOND FLOOR NEW ELECTRICAL PLAN AREA 2
E-1.31	THIRD FLOOR ELECTRICAL DEMOLITION PLAN
E-1.32	THIRD FLOOR NEW ELECTRICAL PLAN
E-1.41	FOURTH FLOOR ELECTRICAL DEMOLITION PLAN
E-1.42	FOURTH FLOOR NEW ELECTRICAL PLAN


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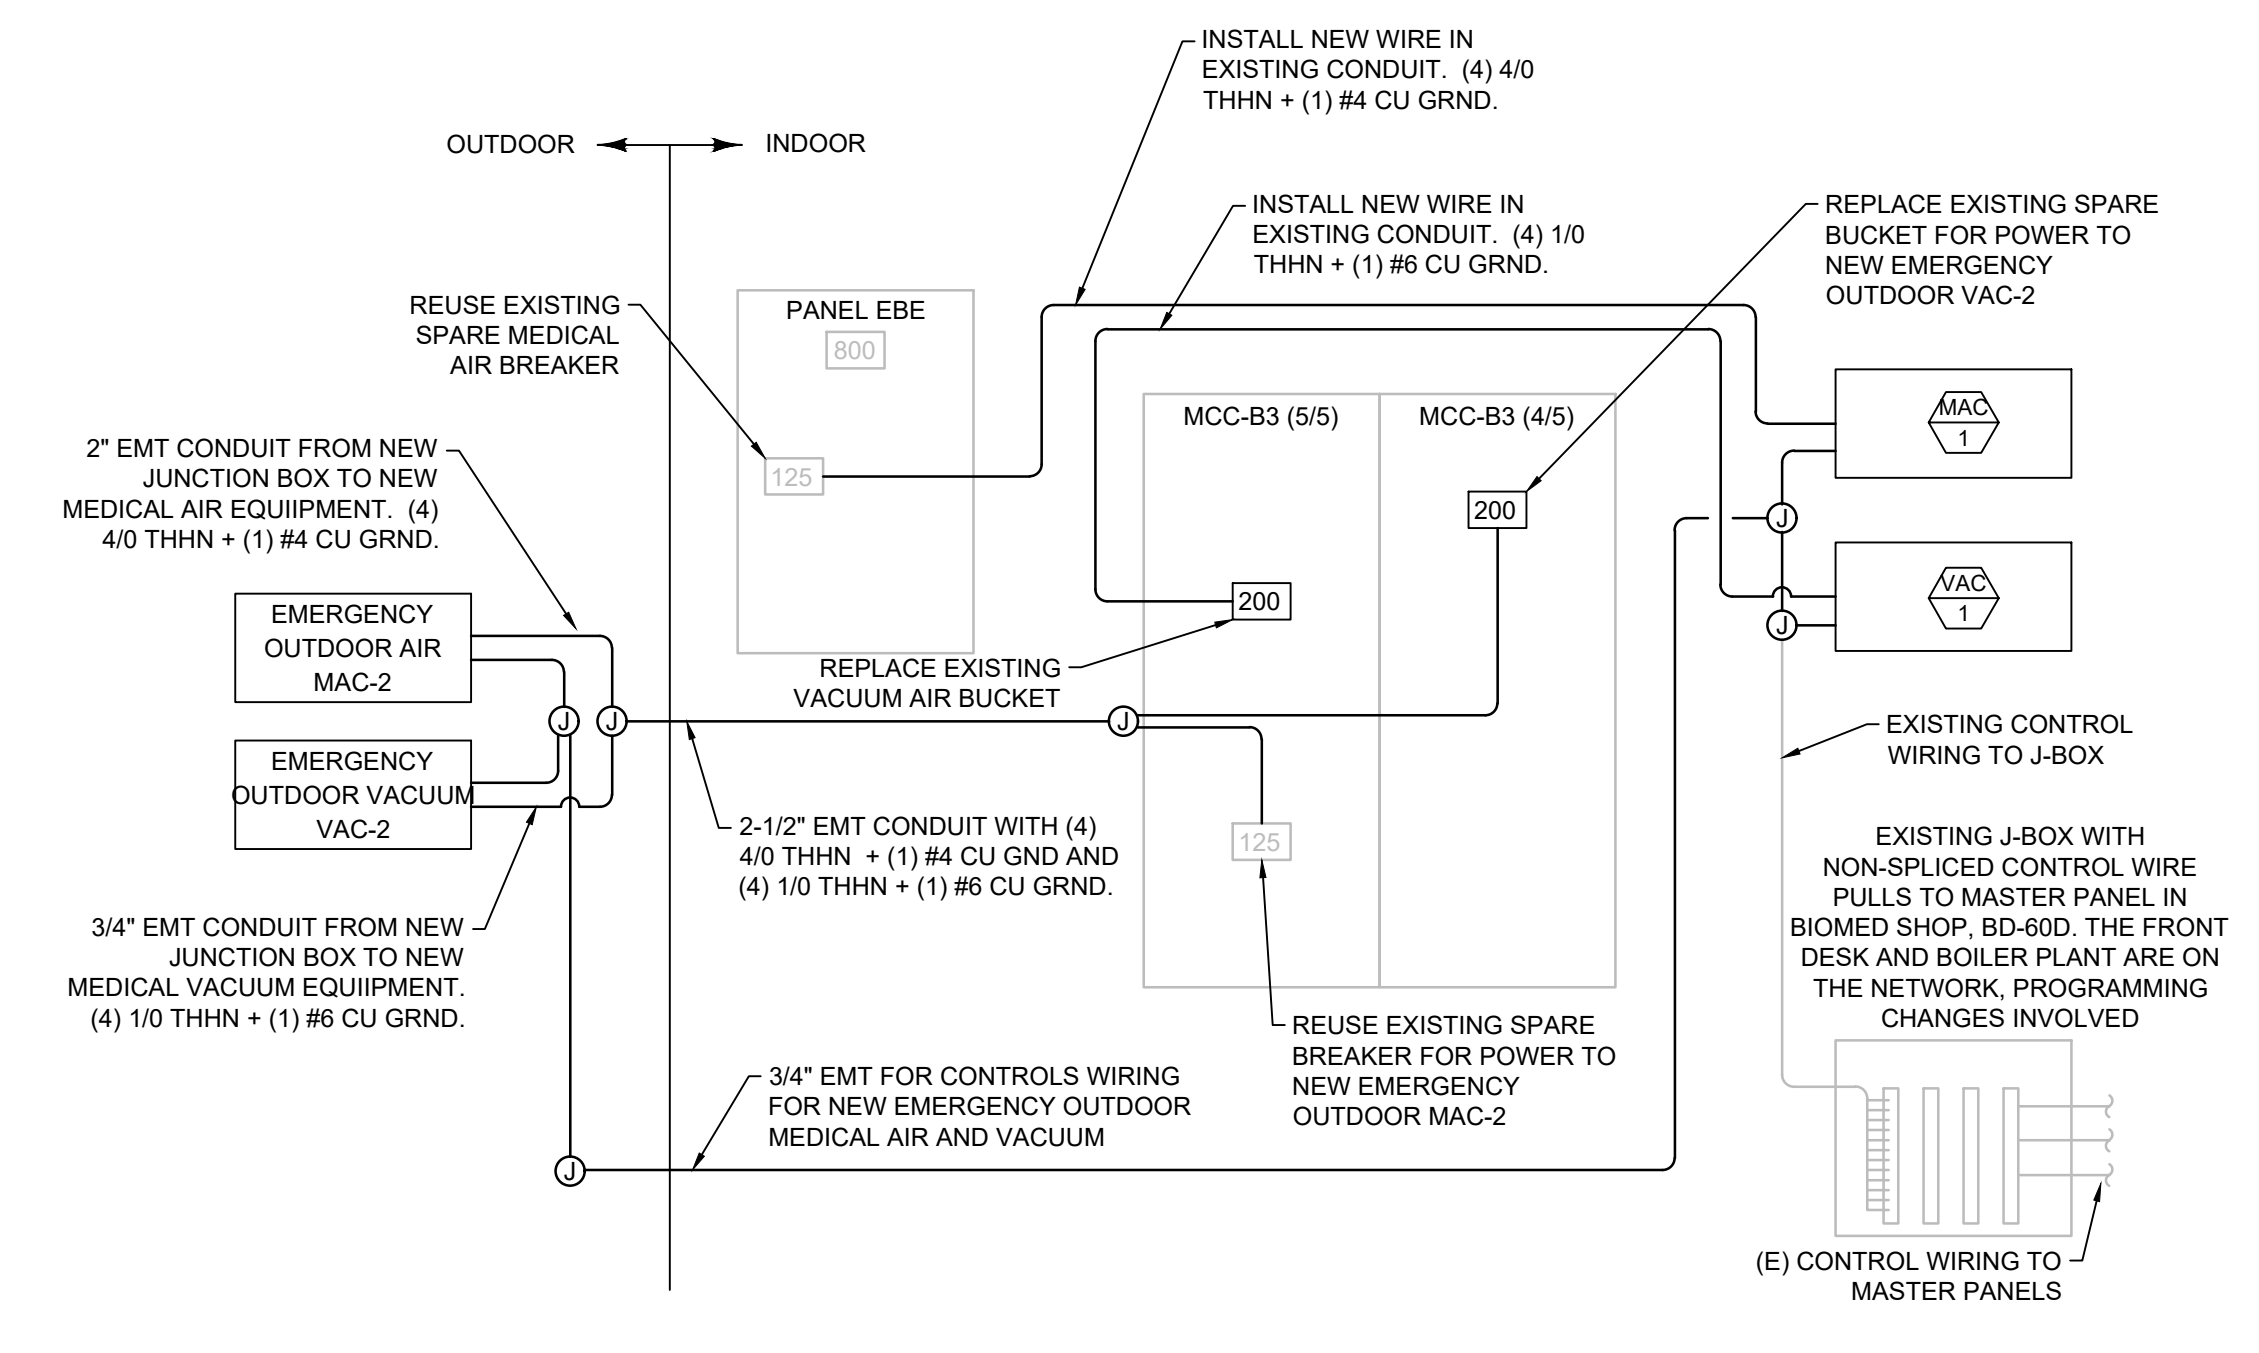
1 BASEMENT - ELECTRICAL DEMOLITION PLAN
 E-1.01 SCALE 1/8"=1'-0"




2 BASEMENT - ELECTRICAL REMODEL PLAN
 E-1.01 SCALE 1/8"=1'-0"

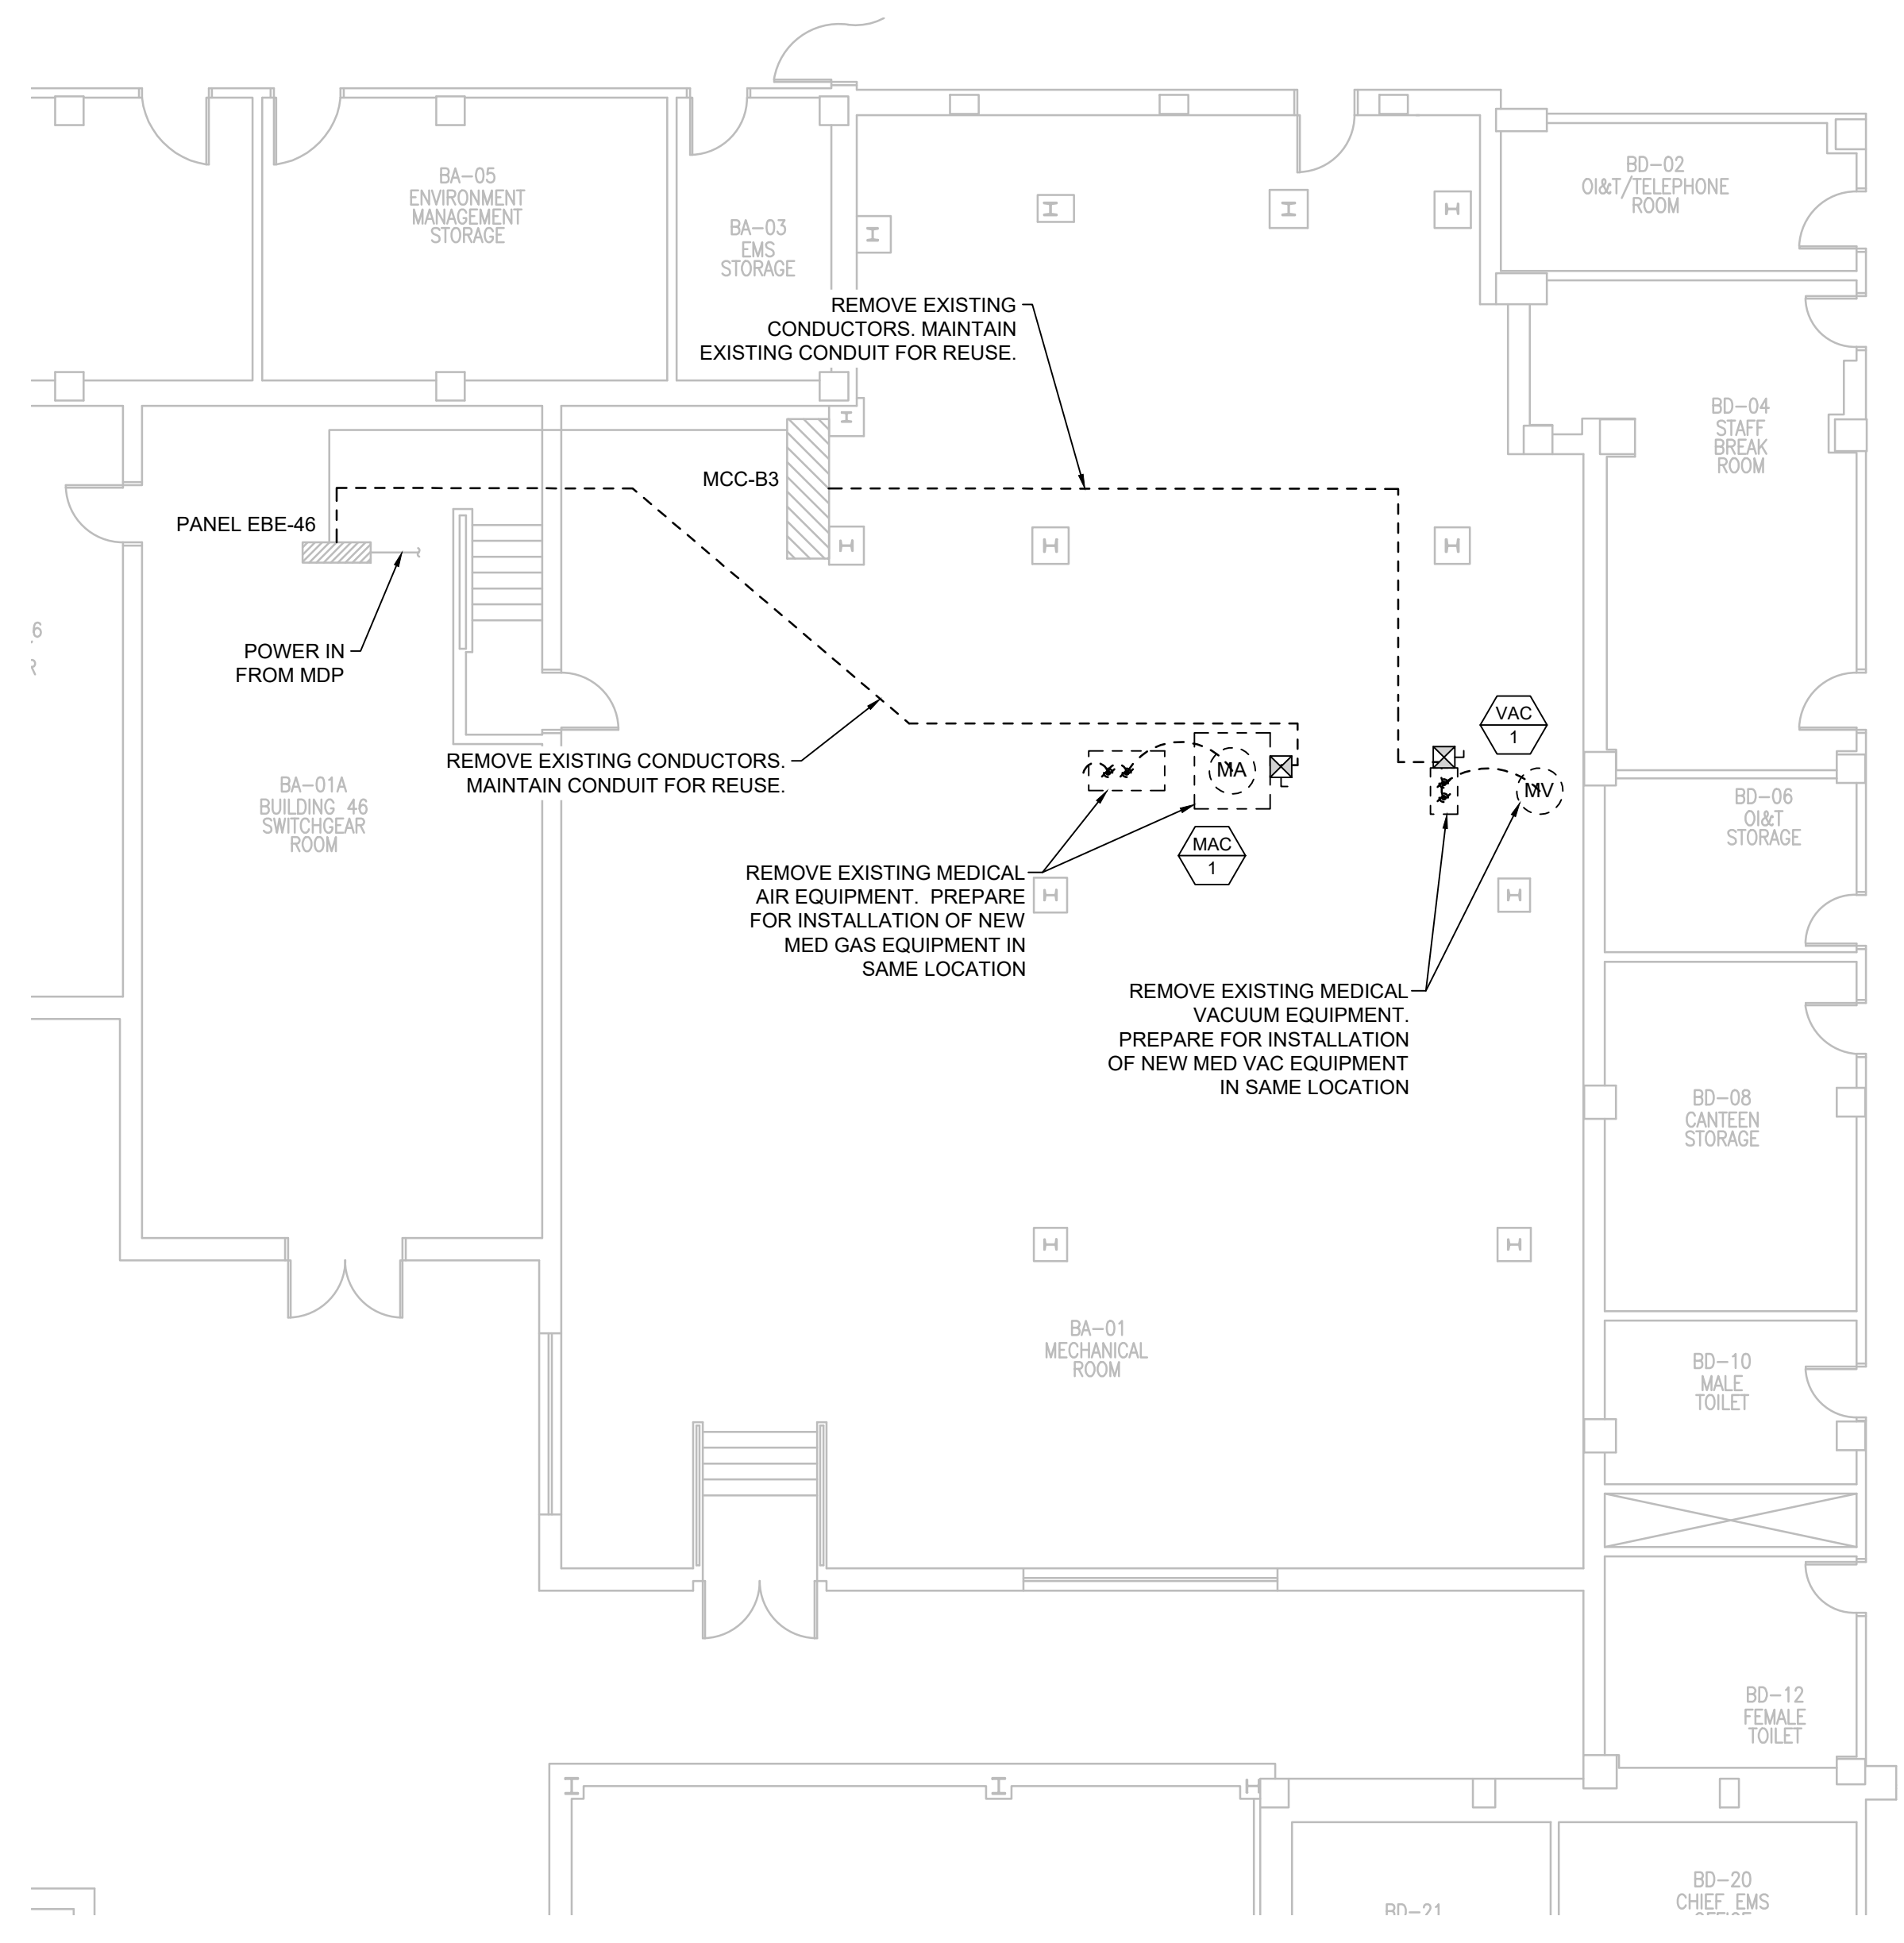EQUIPMENT	CONNECTED LOAD					RECONNECT	CIRCUIT NO.	TYPE	RISK	SIZE	POLES	SIZE	TYPE	GRND	NOTES	
	HP	W	FLA	MVA	PH											
MAC-1	50	-	150	-	3	208	STARTER/DISCONNECT	SCHNEIDER ELECTRIC	SGG15208H30	CLASS H FUSE CLIP	200A	3	(4) 4/0	THHN	#4	1
VAC-1	26	-	90	-	3	208	STARTER/DISCONNECT	SCHNEIDER ELECTRIC	SFG15208H30	CLASS H FUSE CLIP	120A	3	(4) 1/0	THHN	#6	1
MAC-2	50	-	150	-	3	208	STARTER/DISCONNECT	SCHNEIDER ELECTRIC	SGW15208H30	CLASS H FUSE CLIP	200A	3	(4) 4/0	THHN	#4	1
VAC-2	26	-	150	-	3	208	STARTER/DISCONNECT	SCHNEIDER ELECTRIC	SFW15208H30	CLASS H FUSE CLIP	120A	3	(4) 1/0	THHN	#6	1

NOTES:
 1. MANUFACTURER SHOWN AS BASIS OF DESIGN. APPROVED EQUALS TO BE ALLOWED.

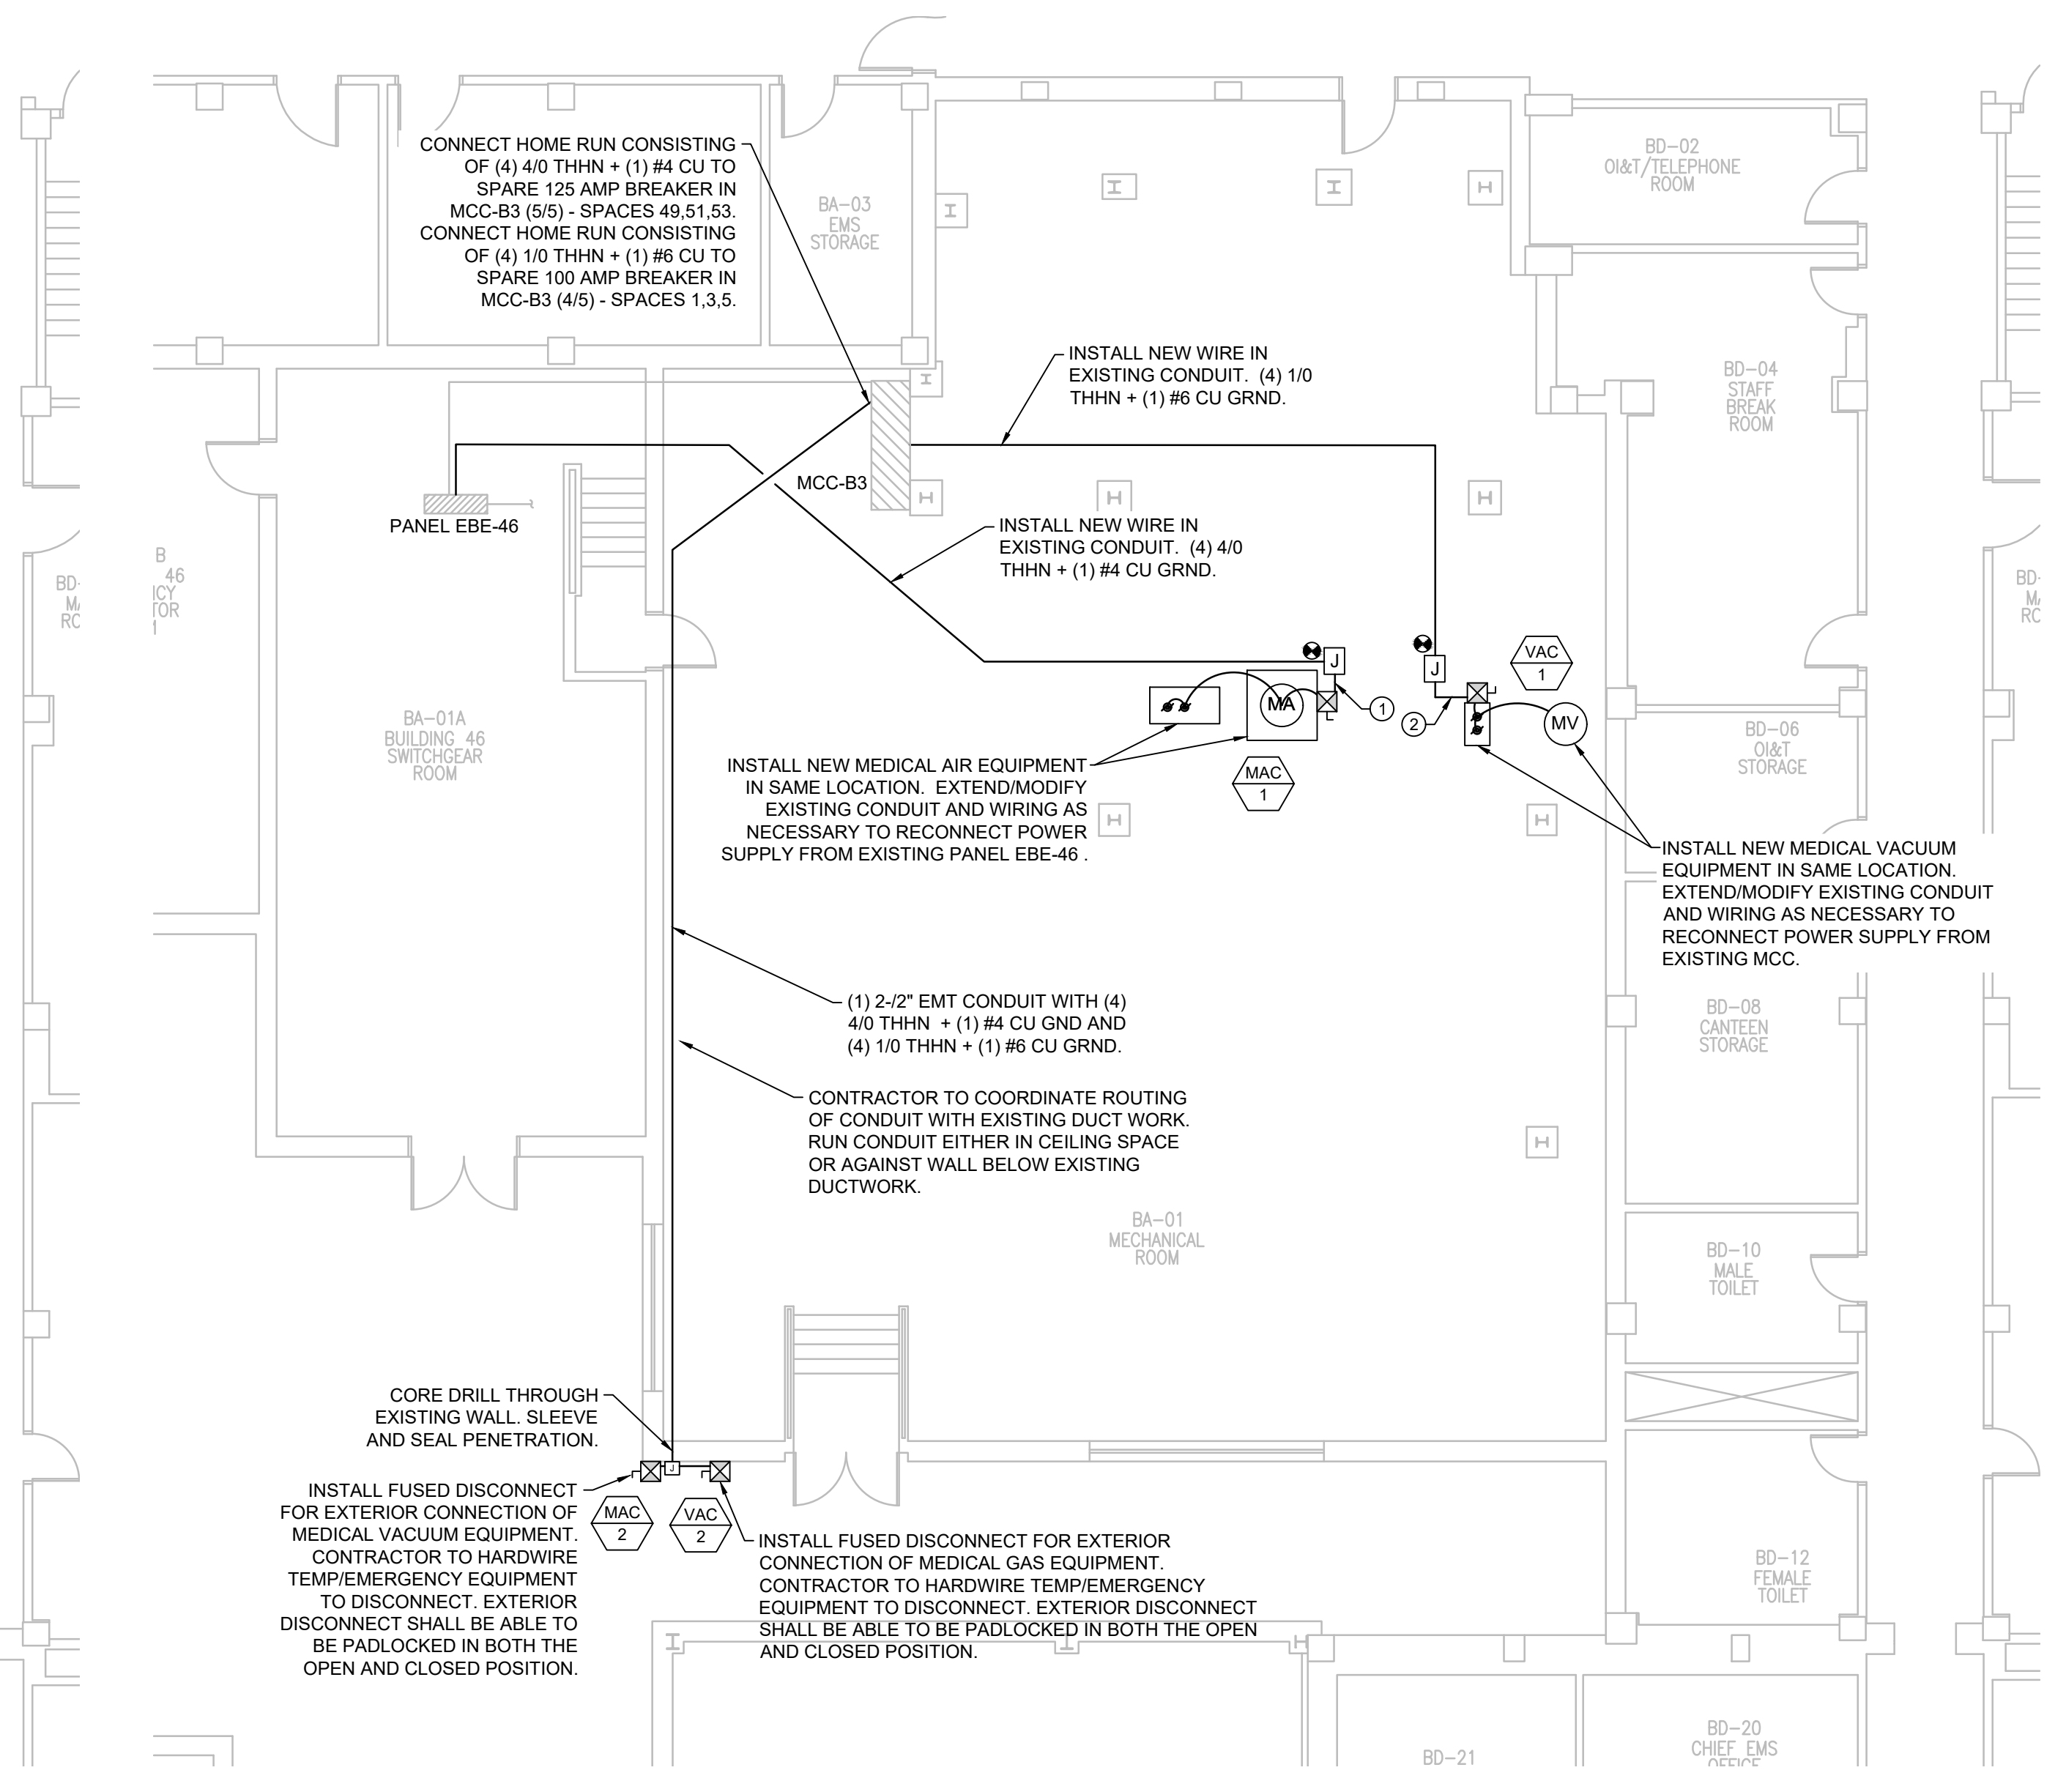

3 ELECTRICAL SCHEMATIC DIAGRAM
 E-1.01 SCALE NTS

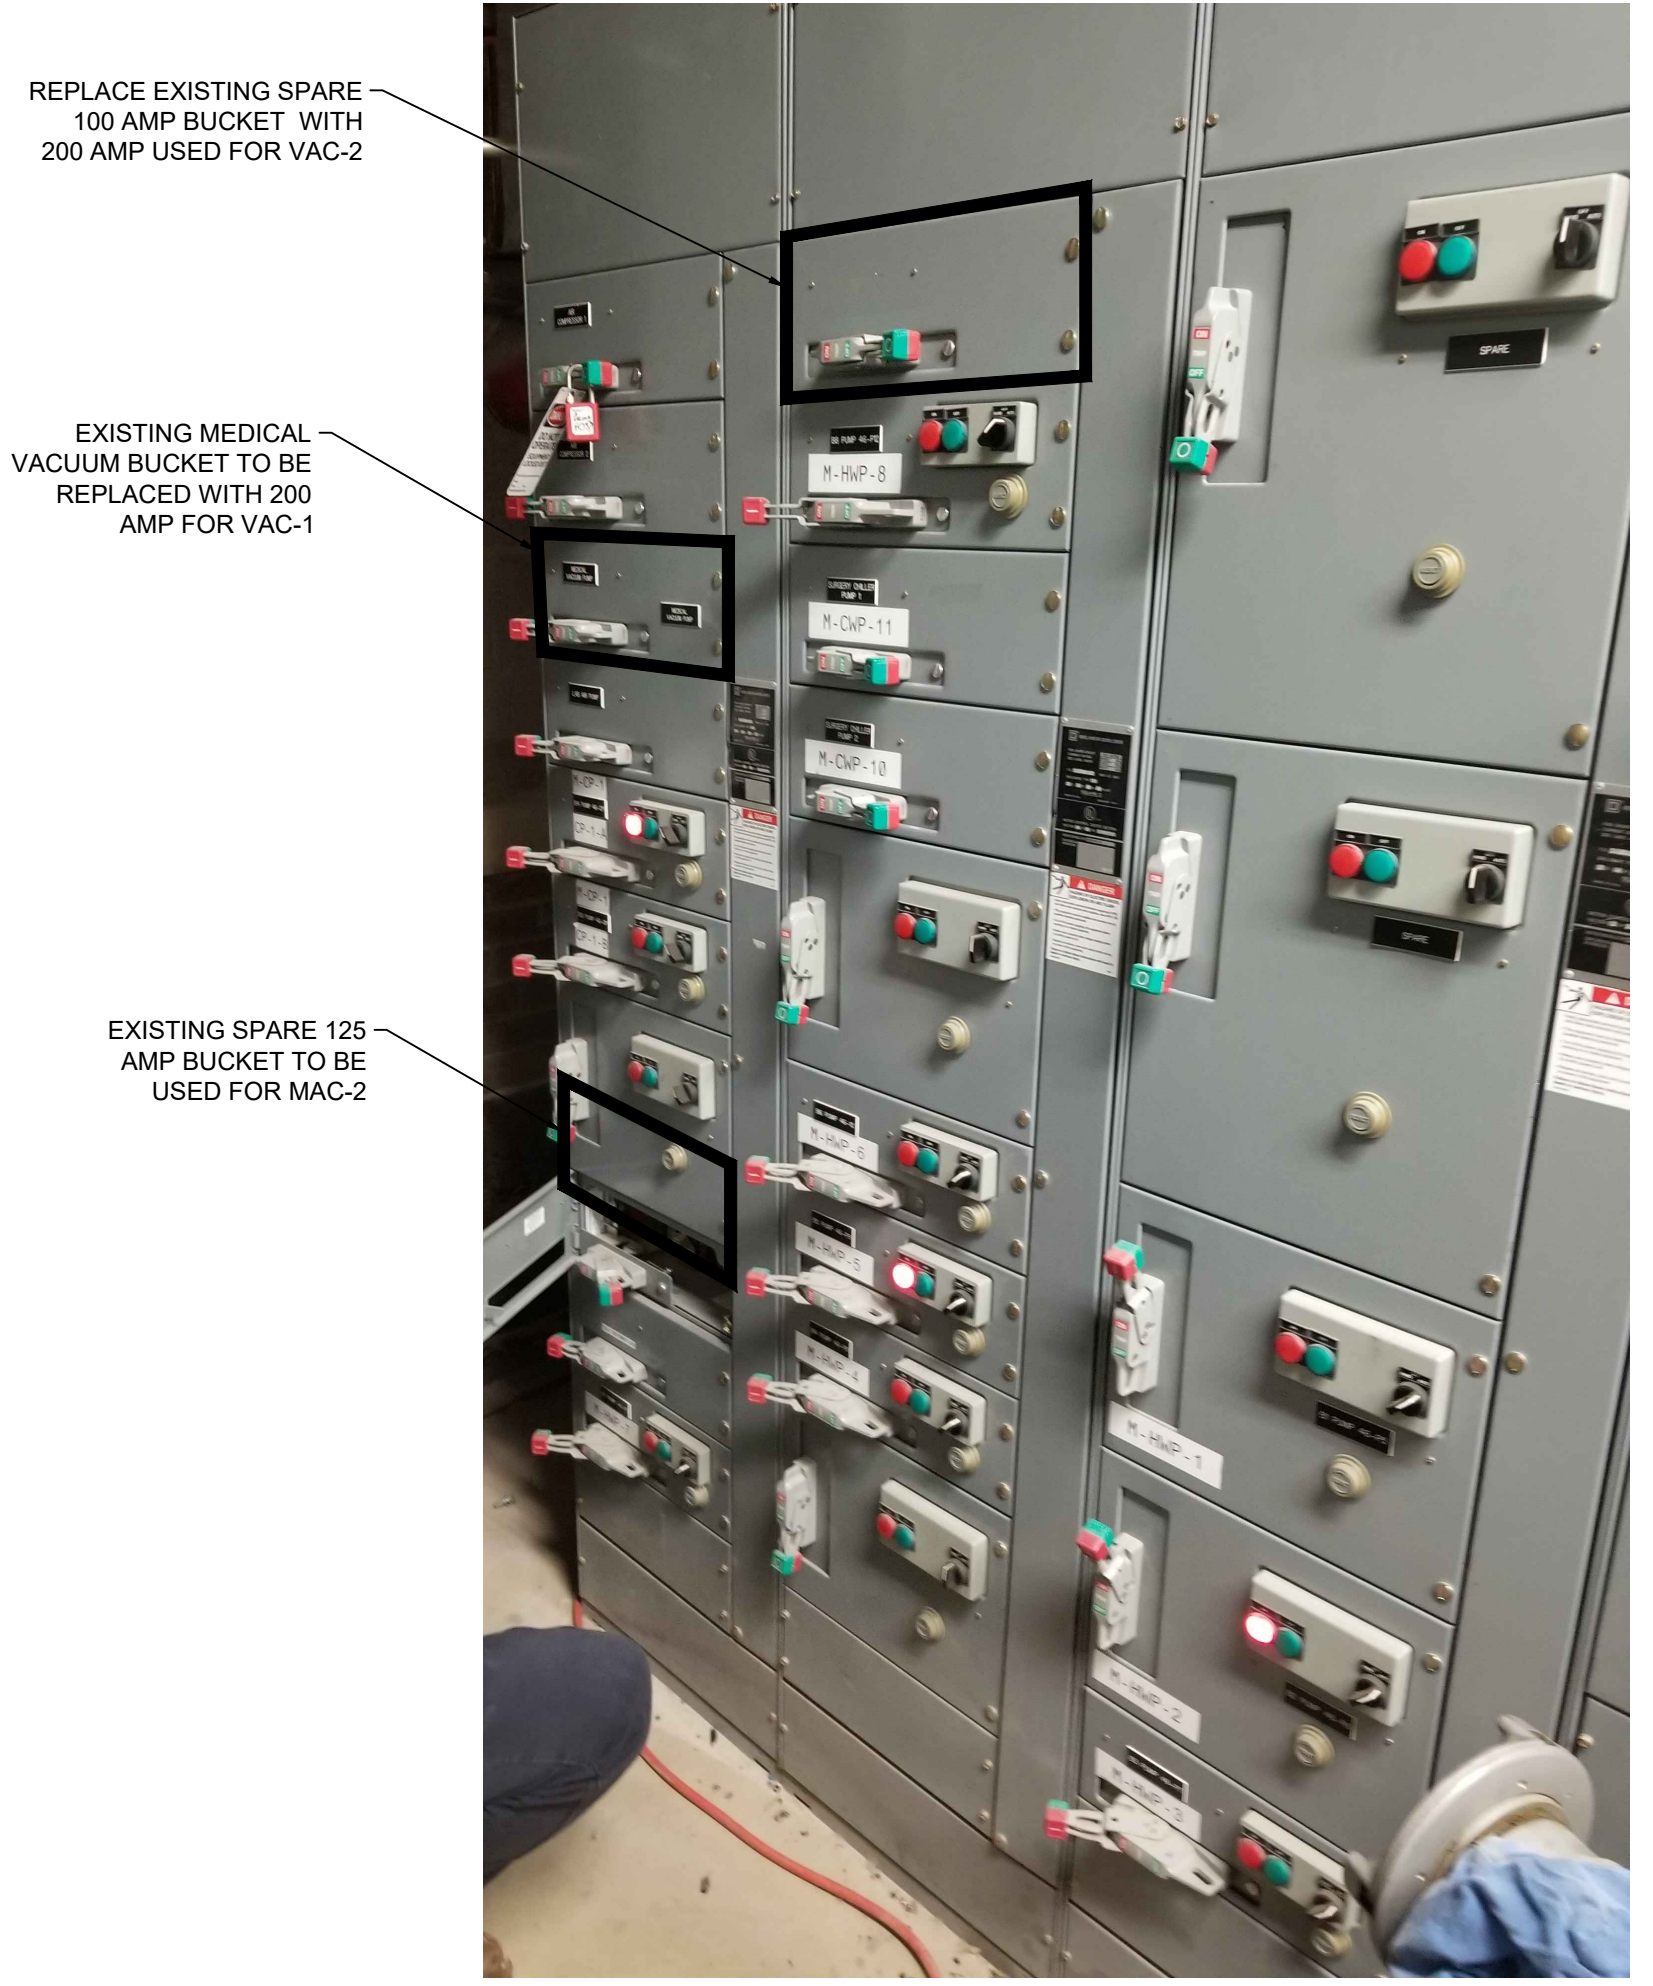

4 EXISTING MCC
 E-1.01 SCALE NTS

GENERAL ELECTRICAL NOTES

REFER TO PHASING PLANS FOR PROPOSED ORDER OF WORK TO BE COMPLETED. CONTRACTOR TO SCHEDULE ALL PHASES WITH THE VA/COR PRIOR TO ANY WORK BEING STARTED.

REFER TO PLUMBING SHEETS FOR ALARM PANEL REPLACEMENT LOCATIONS. RE-USE EXISTING ALARM PANEL POWER FOR NEW ALARM PANELS.

KEYED ELECTRICAL NOTES

① 1-1/2" EMT CONDUIT FROM NEW JUNCTION BOX TO NEW MEDICAL AIR EQUIPMENT. (4) #2 THHN + (1) #6 CU GRND.

② 3/4" EMT CONDUIT FROM NEW JUNCTION BOX TO NEW MEDICAL VACUUM EQUIPMENT. (4) #10 THHN + (1) #10 CU GRND.

CONSULTANTS:

ARCHITECT/ENGINEER

FOURFRONT DESIGN INC.
 517 7TH STREET
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Drawing Title
BASEMENT ELECTRICAL PLANS

Approved: Project Director
Fargo VA Health Care System

Project Title
UPGRADE MEDICAL GAS SYSTEMS

Location
 2101 ELM ST N, FARGO, ND 58102

Date
 07/07/2021

Checked
 RD

Drawn
 PM

Project Number
 437-21-160


Building Numbers
1,9,46

Drawing Number
E-1.01

Dwg. 29 of 40

Office of Construction and Facilities Management
 Department of Veterans Affairs

one and one half inches = one foot
 three quarters inch = one foot
 one half inch = one foot
 three eighths inch = one foot
 one quarter inch = one foot
 one eighth inch = one foot

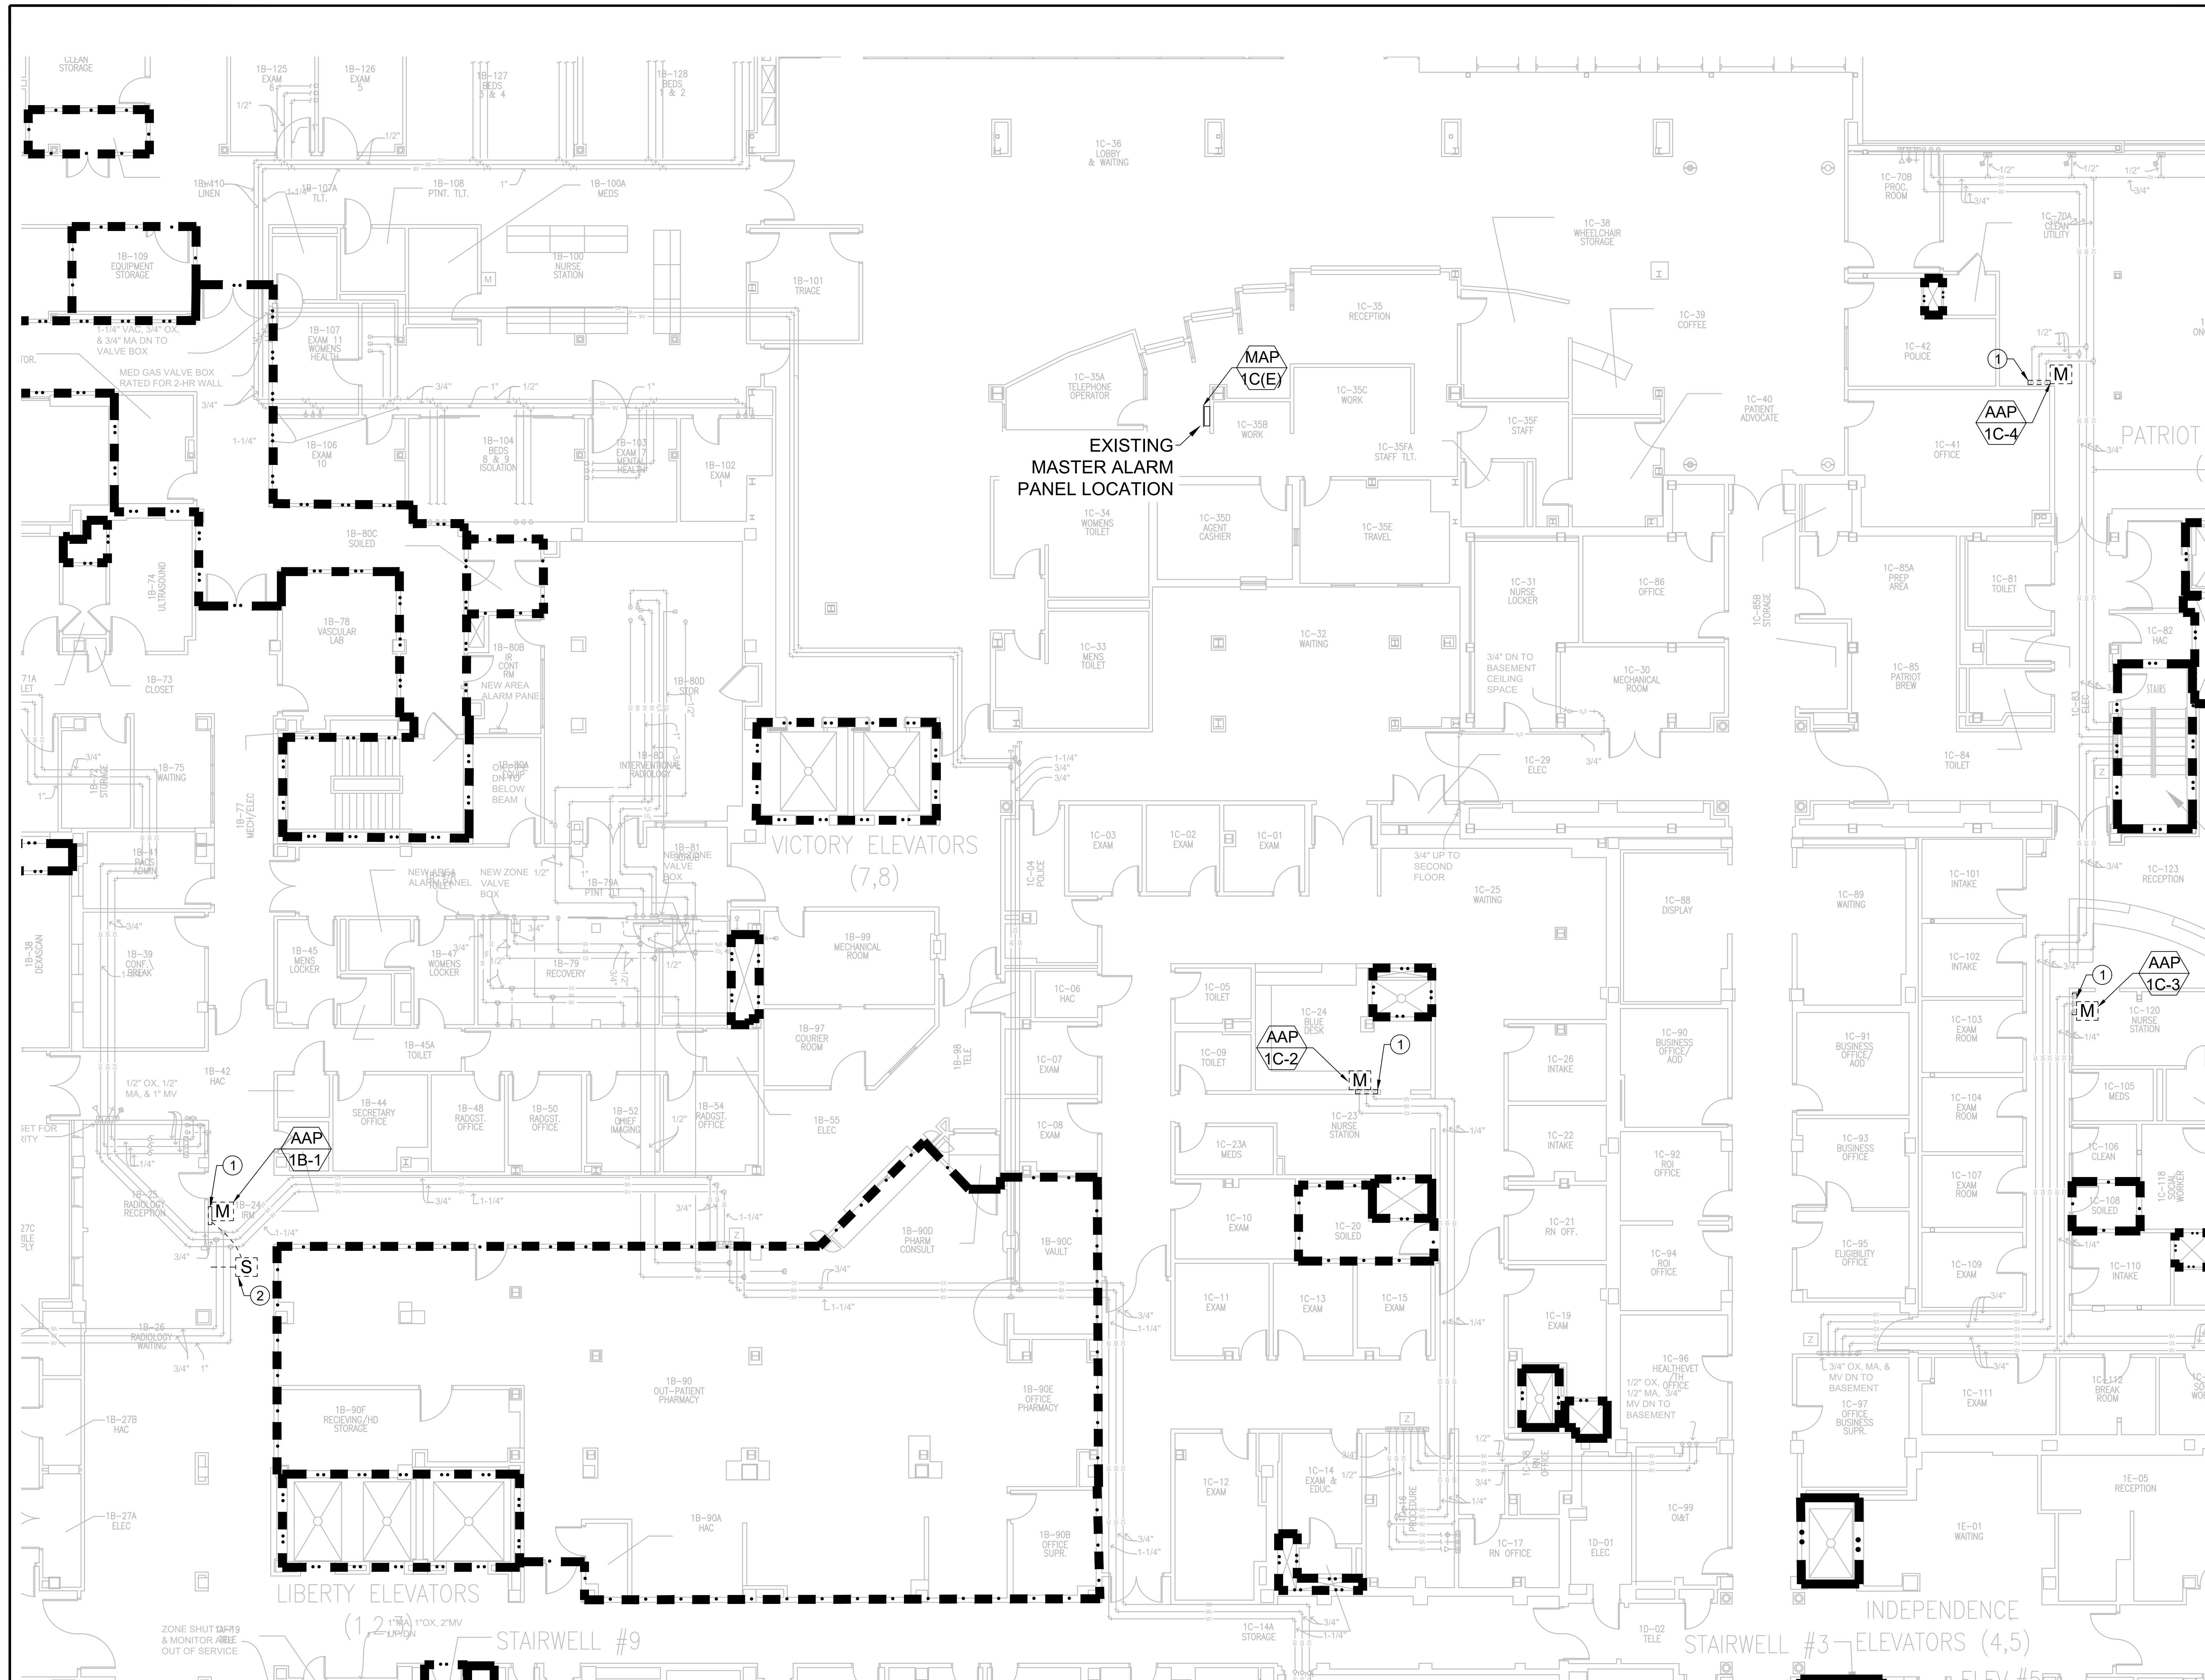


- GENERAL NOTES:**
1. THERE ARE OTHER UTILITIES, EQUIPMENT, ETC IN THIS SPACE THAT ARE NOT SHOWN FOR CLARITY. CONTRACTOR TO ACCOUNT FOR THESE ITEMS.
 2. CONTRACTOR TO SCHEDULE WORK WITH THE VA COR.

KEYED ELECTRICAL NOTES

- ① REMOVE EXISTING ZONE ALARM PANEL. EXISTING POWER TO BE RE-USED WITH NEW ALARM PANEL SHOWN IN THESE PLANS, EXTEND AS REQUIRED.
- ② REMOVE EXISTING ZONE ALARM PRESSURE SENSORS AND ASSOCIATED WIRING.

LINE LEGEND

	EXISTING
	DEMO
	NEW CONSTRUCTION ZONE ALARM PANEL
	ZONE ALARM SENSORS
	1-HR FIRE RATED WALL
	2-HR FIRE RATED WALL

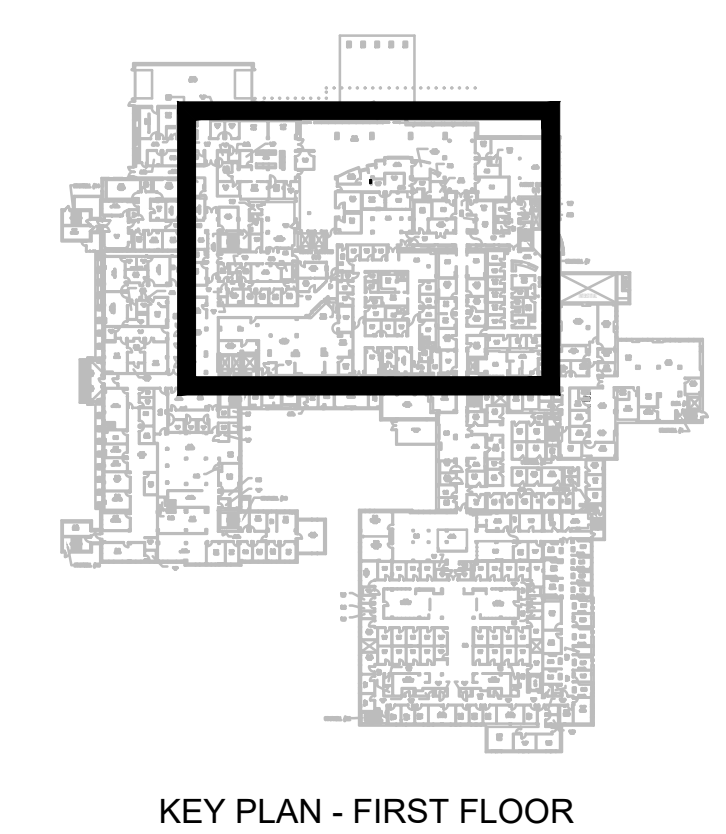

1 FIRST FLOOR - ELECTRICAL DEMOLITION PLAN
 E-1.11 SCALE 1/8" = 1'-0"
 PLAN NORTH TRUE NORTH

100% CONSTRUCTION DOCUMENTS

CONSULTANTS: 	ARCHITECT/ENGINEER FOURFRONT DESIGN INC. 517 7TH STREET RAPID CITY, SOUTH DAKOTA 57701 PH: (605) 342-9470 FAX: (605) 342-2377 WWW.FOURFRONTDESIGN.COM	Drawing Title FIRST FLOOR ELECTRICAL DEMOLITION PLANS	Project Title UPGRADE MEDICAL GAS SYSTEMS	Project Number 437-21-160	Office of Construction and Facilities Management 						
		Approved: Project Director Fargo VA Health Care System	Location 2101 ELM ST N, FARGO, ND 58102	Building Numbers 1,9,46		Drawing Number E-1.11					
Revisions: <table border="1"> <tr> <th>No.</th> <th>Description</th> <th>Date</th> </tr> <tr> <td> </td> <td> </td> <td> </td> </tr> </table>	No.	Description	Date				Date 07/07/2021	Checked RD	Drawn PM	Dwg. 31 of 40	Department of Veterans Affairs
No.	Description	Date									

