



# U.S. DEPARTMENT OF VETERANS AFFAIRS ROYAL C. JOHNSON VETERANS MEMORIAL MEDICAL CENTER UPGRADE PHARMACY 797

**BUILDING #5**  
**SIOUX FALLS, SOUTH DAKOTA**  
**VA #438-20-109**  
**02/10/2021 - BID SET**

**SYMBOLS USED AS ABBREVIATIONS:**

&	AND
LL	DOUBLE ANGLE
@	AT
#	PENNEY
0	ROUND OR NUMBER
Ø	ROUND OR DIAMETER

**ABBREVIATIONS:**

AE	ARCHITECT/ENGINEER
AB	ANCHOR BOLT/ROD
ABV	ABOVE
AC	ASPHALTIC CONCRETE/EAR CONDITIONER
ACC	ACCESSIBLE
ADM	ALUMINUM COMPOSITE MATERIAL
ACOUS	ACOUSTICAL
ADA	AMERICANS WITH DISABILITIES ACT
ADD	ADDENDUM
ADH	ADHESIVE
ADJ	ADJUSTABLE, ADJACENT, ADJOINING
AFF	ABOVE FINISH FLOOR
AFG	ABOVE FINISH GRADE
AHJ	AUTHORITY HAVING JURISDICTION
ALT	ALTERNATE
ALUM	ALUMINUM
ANSI	AMERICAN NATIONAL STANDARDS
APC	ACOUSTICAL PANEL CEILING
APPROX	APPROXIMATE
ARCH	ARCHITECT (URAL)
ASI	ARCHITECTURAL SUPPLEMENTAL INFORMATION
BD	BOARD
BEV	BEVELED
BF	BELOW FINISH FLOOR
BL	BRICK LEDGE
BLDG	BUILDING
BLK	BLOCK (ING)
BM	BEAM
BOT	BOTTOM
BO	BOTTOM OF
BCC	BOTTOM OF CONCRETE
BOF	BOTTOM OF FOOTING
BRG	BEARING
BRK	BRICK
BSMT	BASEMENT
BTWN	BETWEEN
BUR	BUILT-UP ROOFING
C	CABINET
CB	CERAMIC TILE
CC	CONTRACTOR
CD	CONTRACTOR INSTALLED
CEM	CEMENT
CF	CUBIC FEET OR FOOT
CG	CORNER GUARD
CPC	CAST-IN-PLACE CONCRETE
CJ	CONSTRUCTION JOINT
CL	CENTER LINE
CLG	Ceiling
CLGK	CALLING
CLR	CLEAR, CLEARANCE
CMU	CONCRETE MASONRY UNIT
CO	CHANGE ORDER/CLEAN OUT
COL	COLUMN
COMB	COMBINATION
COMP	COMPOSITE/COMPOSITION
CONC	CONCRETE
CONN	CONNECT (ION)
CONST	CONSTRUCTION
CONT	CONTINUOUS, CONTINUE
CONTR	CONTRACT (OR)
COORD	COORDINATE
CORR	CORROSION/CORROSION
CPT	CARPET
CRPT	CARPET TILE
CSMT	CASHEMANT
CT	CERAMIC TILE
CTB	CERAMIC TILE BASE
CTR	CENTER
D	DEPTH
DBL	DOUBLE
DEM	DEMOLITION, DEMOLISH
DEPT	DEPARTMENT
DET	DETAIL
DF	DRINKING FOUNTAIN
DI	DIAMETER
DIA	DIAGONAL
DM	DIMENSION
DIV	DIVIDE, DIVISION
DISP	DISPENSER
DN	DOWN
DR	DOOR
DS	DOWNSPOUT
DW	DISPATCHER
DWG	DRAWING (S)
DWR	DRAWER
DWTR	DUMBWATER
(E)	EXISTING
EAST	EAST
ETC	EACH
EF	EACH FACE
ELEV	ELEVATION
EL	ELECTRICAL
EMER	EMERGENCY
ENGR	ENGINEER
EP	EDGE OF PAVEMENT
EPDM	ETHYLENE PROPYLENE DIENE MONOMER
EPS	EXPANDED POLYSTYRENE BOARD
EPT	EPOXY PAINT
EQ	EQUAL
EQUIP	EQUIPMENT
ES	EACH SIDE
EST	ESTIMATE
ETCETERA	ETCETERA
ETR	EXISTING TO REMAIN
EW	EACH WAY
EX	EXISTING
EXC	EXCAVATE/EXCAVATION
EXH	EXHAUST
EXP	EXPANSION/EXPANDED
EXT	EXTERIOR
EW	ELECTRIC WATER COOLER
FA	FIRE ALARM
FAB	FABRICATE/FABRICATION
FDD	FLOOR DRAIN
FDC	FIRE DEPARTMENT CONNECTION
FDN	FOUNDATION
FE	FIRE EXTINGUISHER
FEC	FIRE EXTINGUISHER CABINET
FF	FINISHED FLOOR
FFE	FINISH FLOOR ELEVATION
FN	FINISH (ED)
FLR	FLOOR
FLR (ING)	FLOOR (ING)
FO	FACE OF CONCRETE
FOM	FACE OF MASONRY
FOS	FACE OF STUD
FF	FACE OF FINISH
FR	FIRE RESISTANT FRAME
FRP	FIBERGLASS REINFORCED PANEL
FS	FLOOR SINK
FT	FOOT, FEET/FIRE TREATED
FRT	FOOTING
FURG	FURRING
FUT	FUTURE
GA	GAGE, GAUGE
GB	GRAB BAR
GC	GENERAL CONTRACTOR
GLV	GALVANIZED
GC	GENERAL CONTRACTOR
GL	GALVANIZED IRON
LVT	LUXURY VINYL TILE
MAS	MASONRY
MATL	MATERIAL
MAX	MAXIMUM
MC	MEDICINE CABINET
MECH	MECHANICAL
MEZ	MEZZANINE
MFR	MANUFACTURE (R)
MIN	MINIMUM
MISC	MISCELLANEOUS
MO	MASONRY OPENING
MR	MIRROR
MTL	METAL
(N)	NEW
N	NORTH
NA	NOT APPLICABLE
NC	NOT IN CONTRACT
NO	NUMBER
NOM	NOMINAL
NIS	NOT TO SCALE
OC	ON CENTER
OD	OUTSIDE DIAMETER
OO	OWNER FURNISHED/OWNER INSTALLED
OF	OWNER FURNISHED/INSULATED (OR) INSULATION
OFCI	CONTRACTOR INSTALLED OVERHEAD
OH	OVERHEAD
JAN	JANITOR
JST	JOIST
JT	JOINT
KCJ	KEYED CONSTRUCTION JOINT
KO	KNOCK OUT
L	LENGTH / ANGLE
LAB	LABORATORY
LAM	LAMINATE (ED)
LAV	LAVATORY
LB	POUND
LF	LINEAR FEET
LH	LEFT HAND
LKR	LOCKER
LOC	LOCATION
LONG	LONGITUDINAL
LT	LIGHT
LVR	LOUVER
M	MAXIMUM
M	MEDICINE CABINET
M	MECHANICAL
M	MEZZANINE
M	MANUFACTURE (R)
M	MINIMUM
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M	MASONRY OPENING
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OFCI	CONTRACTOR INSTALLED OVERHEAD
OH	OVERHEAD
OP	OPPOSITE
ORIG	ORIGINAL
ORD	OVERFLOW ROOF DRAIN
OZ	OUNCE
PAR	PARALLEL
PCF	POUNDS PER CUBIC FOOT
PCD	PEDESTAL
PERF	PERFORATED
PERP	PERPENDICULAR
PLAM	PLASTIC LAMINATE
PLMB	PLUMBING
PLYWD	PLYWOOD
PNL	PANEL
PR	PAIR/PROPOSAL REQUEST
PRCST	PRECAST CONCRETE
PRFAB	PREFABRICATED
PSF	POUNDS PER SQUARE INCH
PT	PAINT / PRESSURE TREATED
PTD	PAPER TOWEL DISPENSER
PTN	PARTITION
PTR	PAPER TOWEL RECEPTACLE
PVC	POLYVINYL CHLORIDE
Q	QUARRY TILE
R	RADIUS/RISER
RB	RUBBER BASE
RBR	RUBBER
RCB	REFLECTED CEILING PLAN
RD	ROOF DRAIN
REBAR	REINFORCING BAR
REC	RECESSED
T&G	TONGUE AND GROOVE
TB	TOWEL BAR
TBD	TO BE DETERMINED
TEMP	TEMPORARY/TEMPERED
TER	TERRAZZO
THU	THROUGH
THD	THREAD (ED) (S)
TRK	THICKNESS
TRU	THROUGH
TKBD	TACKBOARD
TL	TILE
TO	TOP OF
TOB	TOP OF BEAM
TOC	TOP OF CONCRETE/CURB
TOP	TOP OF DECK
TOM	TOP OF MASONRY
TOP	TOP OF PIER
TOJ	TOP OF JOIST
TOS	TOP OF SLAB/STEEL
TOW	TOP OF WALL
TOW	TOP OF MASONRY
TOW	TOP OF JOIST
TPO	THERMOPLASTIC POLYOLEFIN
TFTN	TILE PARTITION
TRANS	TRANSVERSE
TS	TUBE STEEL
TYP	TYPICAL
UG	UNDERGROUND
UH	UNIT HEATER
UNFIN	UNFINISHED
UNO	UNLESS NOTED OTHERWISE
UNO	UNLESS OTHERWISE NOTED
UTIL	UTILITY
V	SHEAR
VAR	VARIABLES
VB	VAPOR BARRIER
VC	VA FURNISHED / CONTRACTOR INSTALLED
VCT	VINYL COMPOSITION TILE
VERT	VERTICAL
VEST	VESTIBULE
VIF	VERIFY IN FIELD
VR	VAPOR RETARDER
VV	VA FURNISHED / VA INSTALLED
VWC	VINYL WALL COVERING
W	WEST/WIDTH
W	WITH
WO	WITHOUT
WA	WEDGE ANCHOR
WB	WOOD BASE
WC	WATER CLOSET
WD	WOOD/WOODWORK
WOW	WINDOW
WF (W)	WIDE FLANGE
WG	WALL GUARD
WH	WATER HEATER
WI	WROUGHT IRON
WL	WIND LOAD
WR	WATER RESISTANT
WST	WAINSCOT
WT	WEIGHT/WINDOW TREATMENT
WVF	WELODED WIRE FABRIC

**COMMON ABBREVIATIONS**

OP	OPPOSITE
ORIG	ORIGINAL
ORD	OVERFLOW ROOF DRAIN
OZ	OUNCE
PAR	PARALLEL
PCF	POUNDS PER CUBIC FOOT
PCD	PEDESTAL
PERF	PERFORATED
PERP	PERPENDICULAR
PLAM	PLASTIC LAMINATE
PLMB	PLUMBING
PLYWD	PLYWOOD
PNL	PANEL
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TRK	THICKNESS
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TO	TOP OF
TOB	TOP OF BEAM
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TOJ	TOP OF JOIST
TOS	TOP OF SLAB/STEEL
TOW	TOP OF WALL
TOW	TOP OF MASONRY
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TPO	THERMOPLASTIC POLYOLEFIN
TFTN	TILE PARTITION
TRANS	TRANSVERSE
TS	TUBE STEEL
TYP	TYPICAL
UG	UNDERGROUND
UH	UNIT HEATER
UNFIN	UNFINISHED
UNO	UNLESS NOTED OTHERWISE
UNO	UNLESS OTHERWISE NOTED
UTIL	UTILITY
V	SHEAR
VAR	VARIABLES
VB	VAPOR BARRIER
VC	VA FURNISHED / CONTRACTOR INSTALLED
VCT	VINYL COMPOSITION TILE
VERT	VERTICAL
VEST	VESTIBULE
VIF	VERIFY IN FIELD
VR	VAPOR RETARDER
VV	VA FURNISHED / VA INSTALLED
VWC	VINYL WALL COVERING
W	WEST/WIDTH
W	WITH
WO	WITHOUT
WA	WEDGE ANCHOR
WB	WOOD BASE
WC	WATER CLOSET
WD	WOOD/WOODWORK
WOW	WINDOW
WF (W)	WIDE FLANGE
WG	WALL GUARD
WH	WATER HEATER
WI	WROUGHT IRON
WL	WIND LOAD
WR	WATER RESISTANT
WST	WAINSCOT
WT	WEIGHT/WINDOW TREATMENT
WVF	WELODED WIRE FABRIC

**SYMBOLS LEGEND**

	BATT INSULATION
	GYPSUM BOARD
	EARTH
	CONCRETE
	RIGID INSULATION
	EXISTING CONSTRUCTION TO BE REMOVED
	NEW CONSTRUCTION
	WOOD ROUGH (CONTINUOUS)
	WOOD ROUGH (SPACED)
	PLYWOOD
	BLOCK WALL/VENEER
	DIMENSION LINE
	BREAK LINE
	DETAIL INDICATOR
	BUILDING SECTION INDICATOR
	ELEVATION INDICATOR, EXTERIOR
	ELEVATION INDICATOR
	CENTER LINE
	ELEVATION INDICATOR, INTERIOR, SINGLE VIEW
	ELEVATION INDICATOR, INTERIOR MULTIPLE VIEW
	V V ITEM - VA SUPPLIED & INSTALLED
	VC ITEM - VA SUPPLIED & CONTRACTOR INSTALLED
	CC ITEM - CONTRACTOR SUPPLIED & INSTALLED
	NORTH ARROW

**SYMBOLS LEGEND**

	CENTER LINE INDICATOR
	CONTRACT LIMIT LINE
	DEMOLITION LINE
	EXISTING TO REMAIN
	FEATURE ABOVE LINE INDICATOR
	FIRE RESISTIVE RATED LINE, 1 HOUR
	FIRE RESISTIVE RATED LINE, 2 HOUR
	FIRE RATED, FIRE/SMOKE BARRIER LINE, 1 HOUR
	FIRE RATED, FIRE/SMOKE BARRIER LINE, 2 HOUR
	FIRE RATED, SMOKE BARRIER LINE, 1 HOUR
	FIRE RATED, SMOKE BARRIER LINE, 2 HOUR
	HIDDEN LINE FEATURES
	NEW LINE
	PROPERTY LINE
	STUD SIZE
	PARTITION MODIFIER (OPTIONAL)
	OR FIRE RATING (OPTIONAL)
	DRAWING TITLE
	DETAIL INDICATOR FOR SMALL CONDITIONS
	CORNER GUARD
	FIRE EXTINGUISHER CABINET
	WALL OR PARTITION TYPE
	KEYNOTE
	COLUMN GRID
	ROOM NAME AND NUMBER
	FURNITURE, FIXTURE, EQUIPMENT INDICATOR
	DOOR OPENING/BORROWED LIGHT IDENTIFIER

**STUD SIZE OR CMU NOMINAL THICKNESS**

A = 3/8" MTL. STUD, (1) LAYER GYP BO BOTH SIDES  
B = 4" MTL. STUD, (1) LAYER GYP BO BOTH SIDES  
C = 2 1/2" MTL. STUD, (1) LAYER GYP BO BOTH SIDES  
F = FURRING

**PARTITION MODIFIERS**

A = ONE SIDED G.W.B.  
B = 4" HIGH WALL  
C = 48" HIGH WALL

**OTHER POSSIBLE MODIFIERS**



\* SMOKE BARRIER  
\* SOUND RATINGS

**RATINGS**

1 = 1 HOUR  
2 = 2 HOUR  
3 = 3 HOUR  
4 = 4 HOUR

**SHEET INDEX**

01 - GENERAL	G000 COVER SHEET
	G001 ACCESSIBILITY DETAILS
	G002 CONSTRUCTION NOTES, PCRA, ICLM
	G003 LIFE SAFETY CODE REVIEW AND PHASING PLAN
05 - ARCHITECTURAL DEMOLITION	AD100 OVERALL DEMOLITION PLAN
	AD101 ENLARGED DEMOLITION PLAN
AD102	DEMOLITION RCP
06 - ARCHITECTURAL	AE100 GROUND FLOOR PLAN
	AE101 ENLARGED PLAN
	AE201 REFLECTED CEILING PLAN
	AE401 INTERIOR ELEVATIONS
	AE601 DOOR SCHEDULE AND DETAILS
	AE101 FINISH PLAN AND SCHEDULE
10 - MECHANICAL/PLUMBING	MP101 GROUND LEVEL FIRE PROTECTION PLANS
	M600 MECHANICAL TITLE SHEET
	M500 MECHANICAL DETAILS
	M501 MECHANICAL SEQUENCE OF OPERATIONS
	M600 MECHANICAL/ELECTRICAL SCHEDULES
	MHD101 GROUND LEVEL DEMOLITION HVAC PLAN
	MHD111 FIRST LEVEL INTERSTITIAL ROOF MECHANICAL DEMOLITION
	MDP101 GROUND LEVEL DEMOLITION PIPING PLAN
	MH101 GROUND LEVEL HVAC PLAN
	MH111 FIRST LEVEL INTERSTITIAL ROOF MECHANICAL PLANS
	MP101 GROUND LEVEL PIPING PLAN
	PP101 GROUND LEVEL PLUMBING PLANS
	PP500 PLUMBING RISERS
11 - ELECTRICAL	E000 ELECTRICAL TITLE SHEET
	ED100 OVERALL ELECTRICAL DEMOLITION PLAN
	ED101 GROUND LEVEL DEMOLITION LIGHTING PLAN
	ED102 GROUND LEVEL DEMOLITION POWER PLAN
	ED103 GROUND LEVEL DEMOLITION SYSTEM PLAN
	EE100 OVERALL ELECTRICAL PLAN
	EE111 FIRST LEVEL INTERSTITIAL ROOF ELECTRICAL PLAN
	EL101 GROUND LEVEL LIGHTING PLAN
	EP101 GROUND LEVEL POWER PLAN
	EY101 GROUND LEVEL SYSTEM PLAN
	EE301 ELECTRICAL RISERS
	EE600 ELECTRICAL SCHEDULES
	TOTAL SHEET COUNT: 38

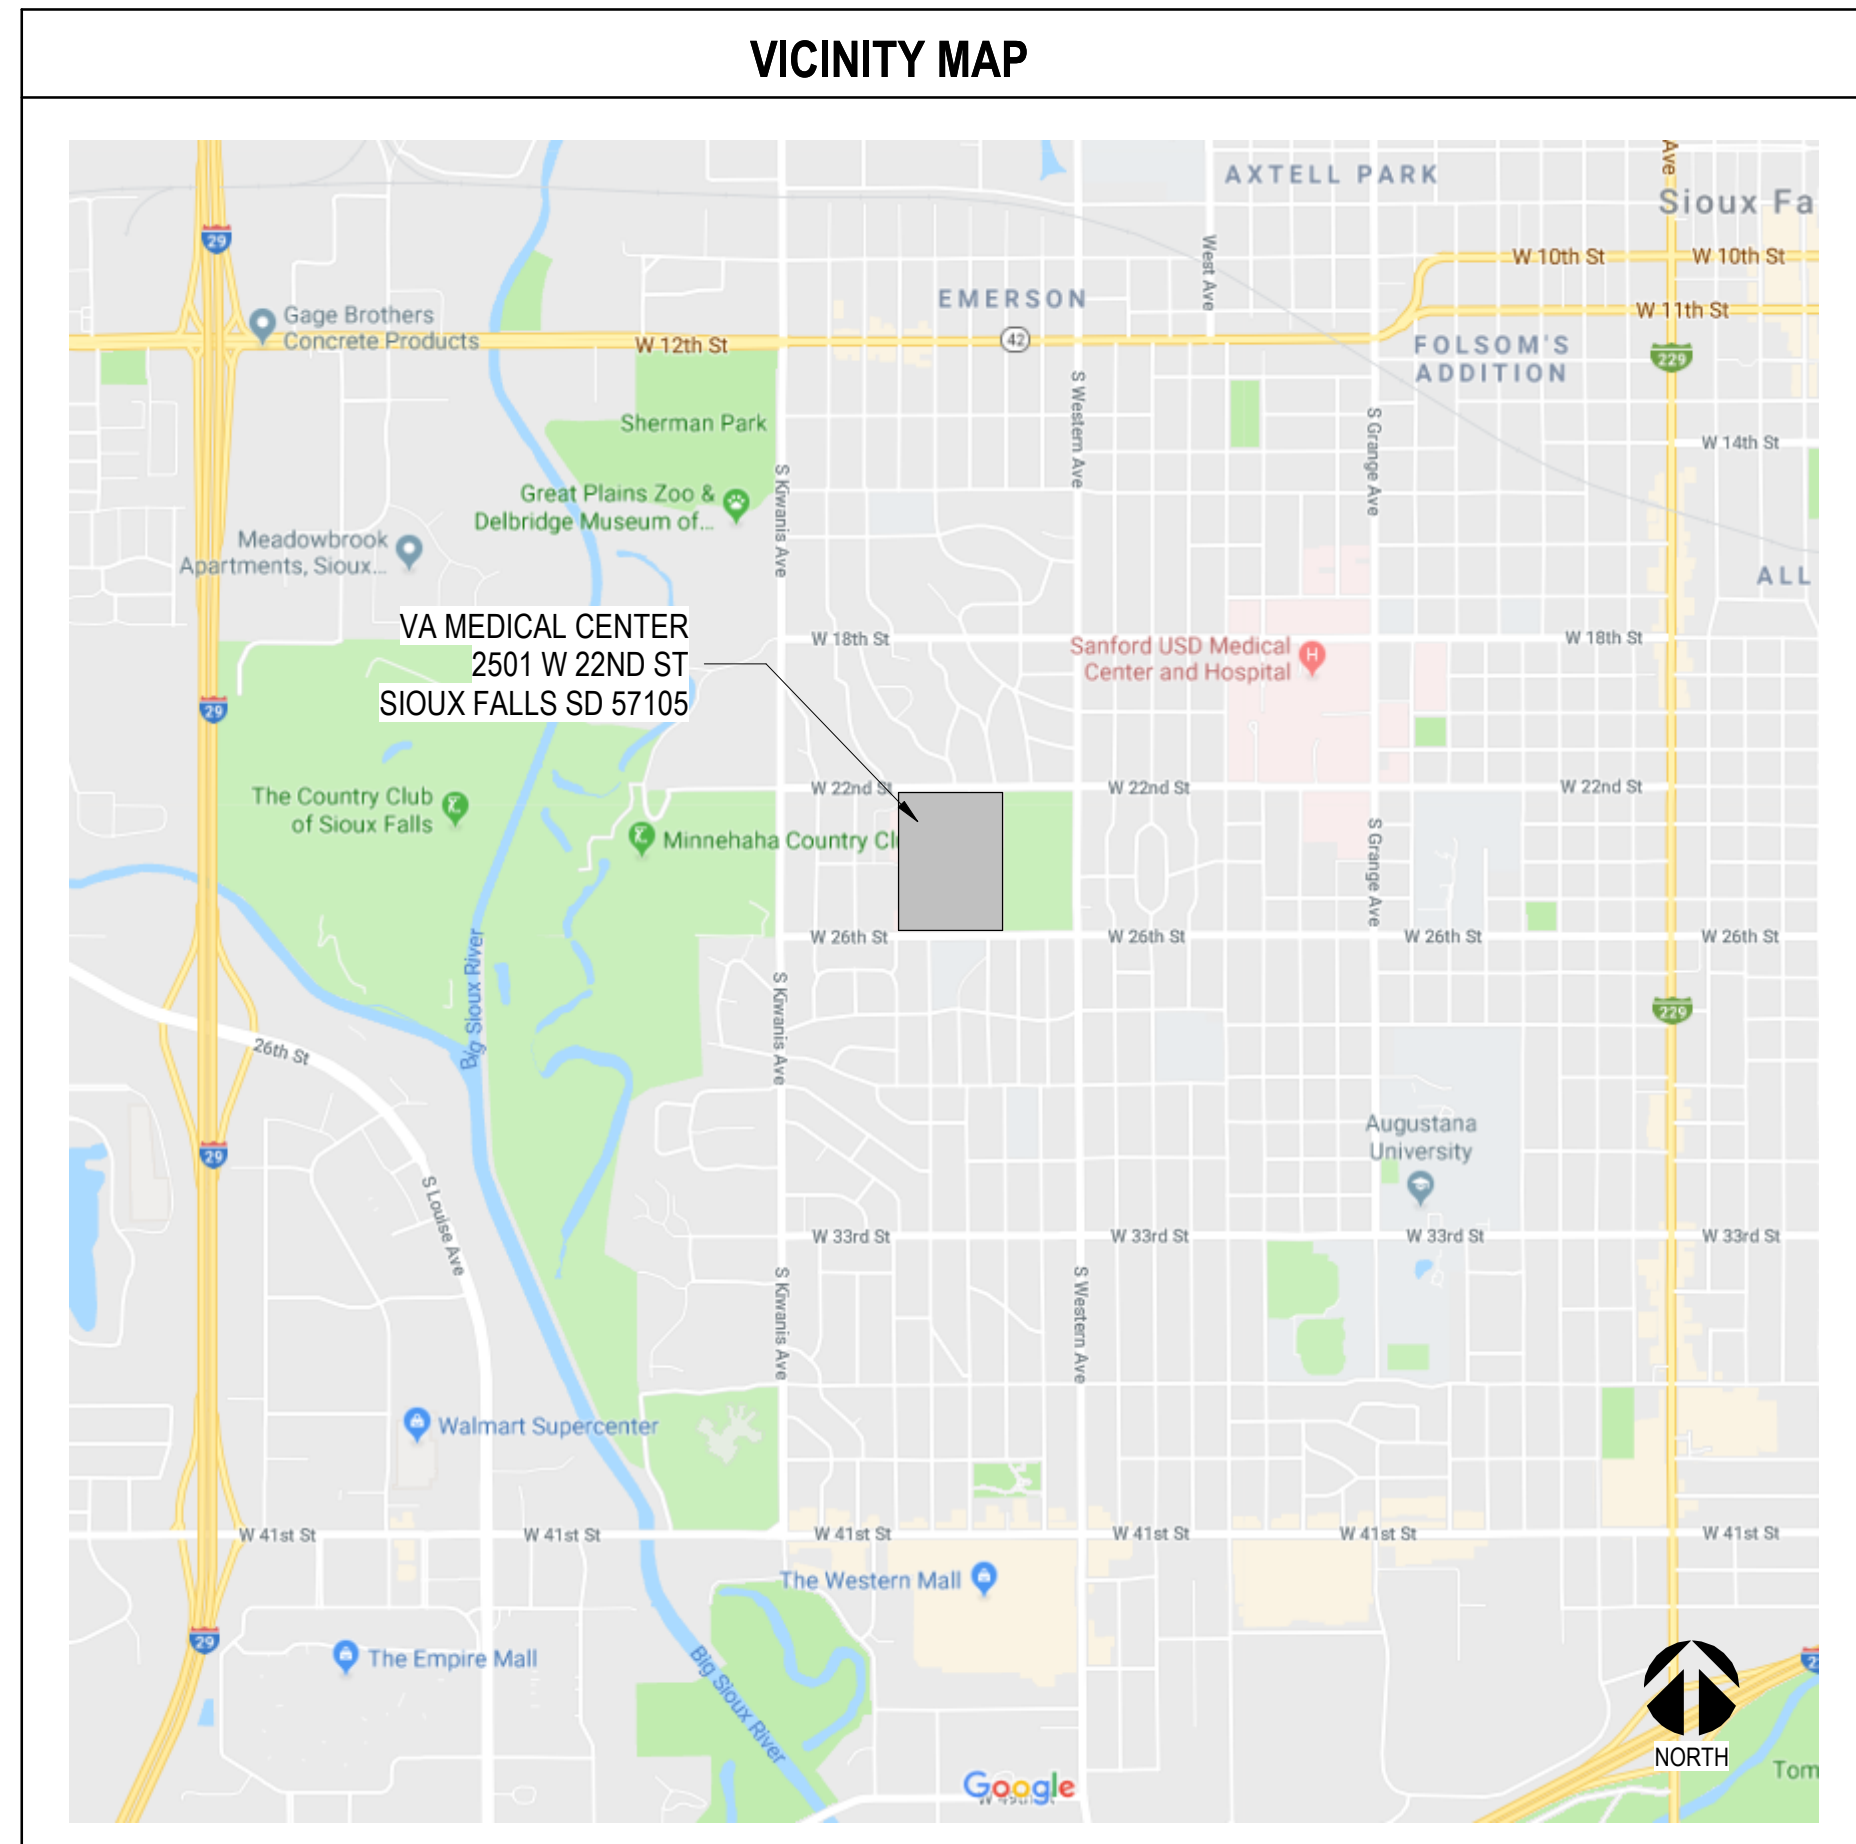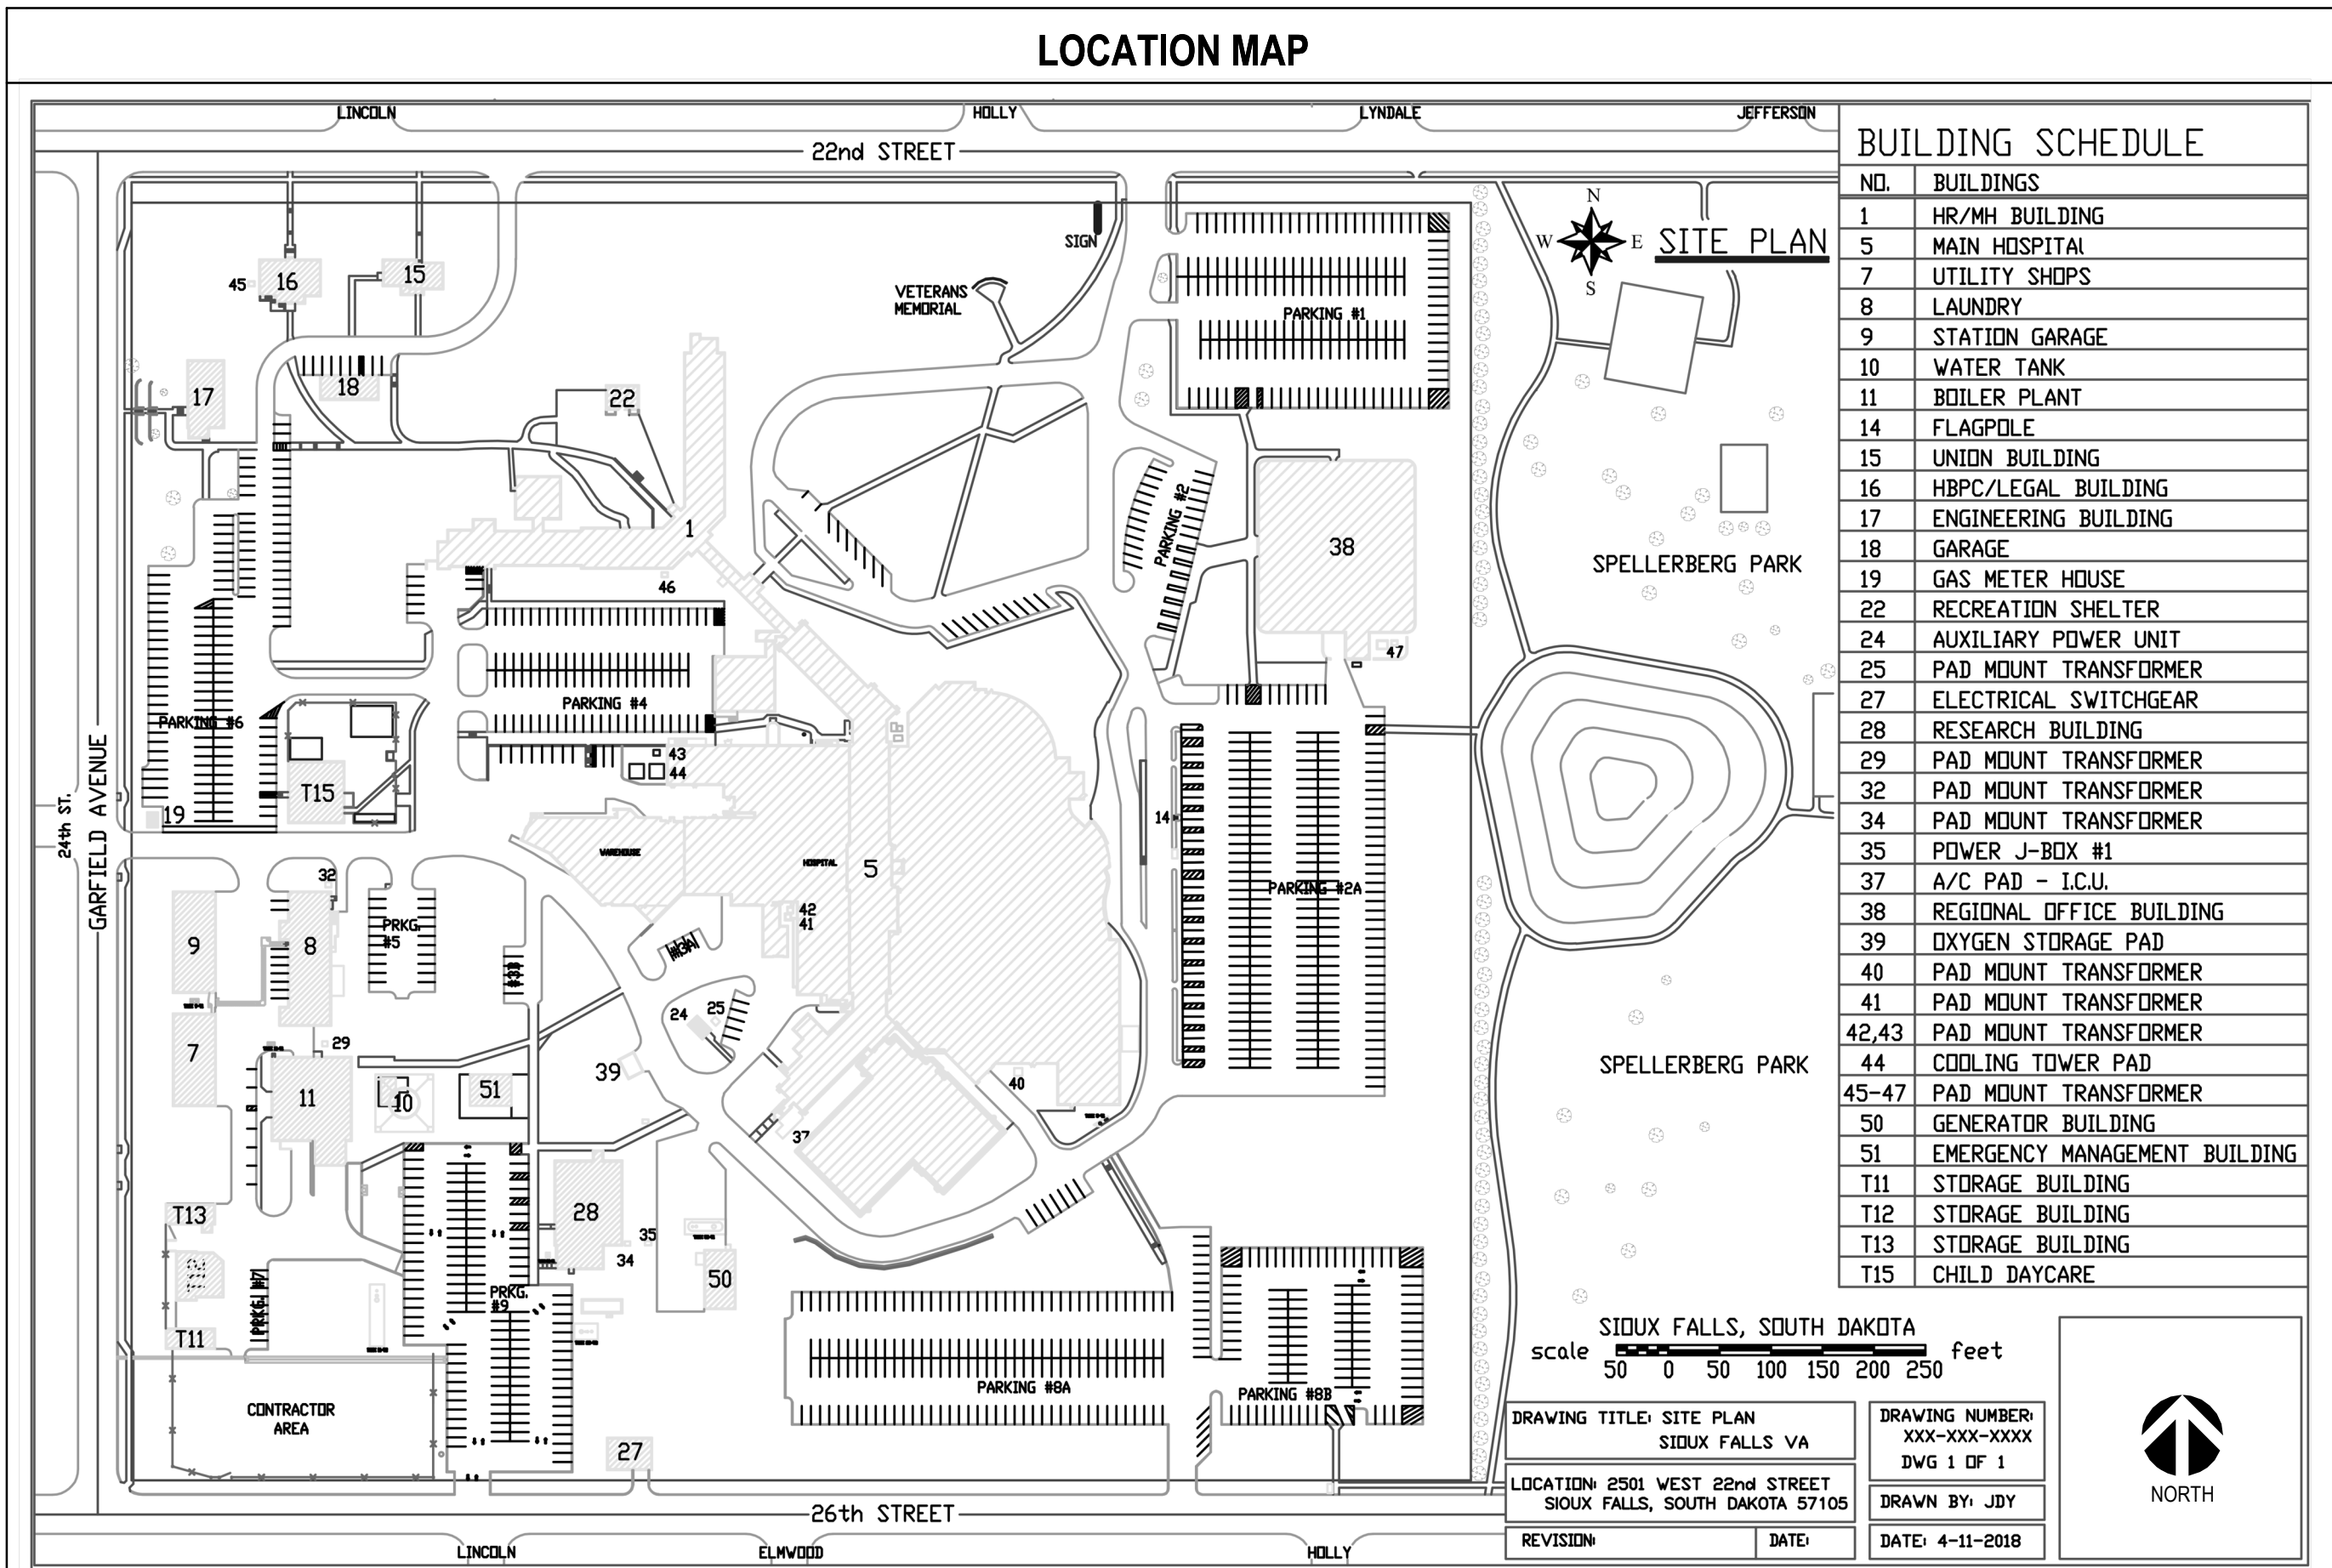



### PRE-CONSTRUCTION RISK ASSESSMENT (PCRA)

**Project #**  
**Project Title:** \_\_\_\_\_ **Est. Start Date:** \_\_\_\_\_  
**Area of Construction:** \_\_\_\_\_ **Est. Duration:** \_\_\_\_\_  
**Contractor/Supervisor:** \_\_\_\_\_  
**PCRA Completed by:** \_\_\_\_\_

SAFETY/ENGINEERING		IF YES, CIRCLE ILSM FROM list below or describe other intervention	
Y	N		
	<input type="checkbox"/>	Will exits or egress routes from occupied areas change?	A, E, H, J, L
	<input type="checkbox"/>	Will the construction area have less than two remote exits?	A, E, H, J, L
	<input type="checkbox"/>	Will there be excessive distance to exit?	A, E, H, J, L
	<input type="checkbox"/>	Will access to Emergency Services become blocked or obstructed?	A, B, I, J, L
	<input type="checkbox"/>	Will any part of the fire protection systems (detection, notification or suppression) be shut down or impaired for >4 hours in a 24-hour period?	C, E, H, I, K
	<input type="checkbox"/>	Will smoke or firewalls be breached?	A, E, G, H
	<input type="checkbox"/>	Will any temporary construction partitions be built?	D
	<input type="checkbox"/>	Will the project result in the accumulation of construction debris?	E, F, G, H
	<input type="checkbox"/>	Will construction affect grounds safety (pits, storage, equipment, etc.)?	H
	<input type="checkbox"/>	Will construction present other life safety hazards?	H, J
	<input type="checkbox"/>	Will protection of hazardous areas be compromised?	H

**INTERVENTION**

A. Ensure Alternate Egress Routes	E. Additional Fire Fighting Equipment	I. Additional Training of Emergency Personnel
B. Ensure Alternate Emergency Access	F. Control Combustible Loads	J. Ensure Additional Employee Education
C. Fire Department Notification	G. Conduct 2 Fire Drills Per Shift in All Areas	K. Institute a Fire Watch w/documentation
D. Ensure Smoke-Tight Temporary Construction	H. Increase Hazard Surveillance Rounds	L. Post temporary signage

Y	N	CONSTRUCTION ACTIVITY	IF YES, describe intervention
	<input type="checkbox"/>	Will there be any anticipated utility shutdowns? (Communications, electrical, heating/cooling, HVAC, medical gases, vacuum, water, sewer)	
	<input type="checkbox"/>	Will noise levels be excessive?	
	<input type="checkbox"/>	Will vibration levels be excessive?	
	<input type="checkbox"/>	Will additional security measures be implemented?	

**Additional Requirements:**

**PATIENT SAFETY COORDINATOR**

Y	N	CONSTRUCTION ACTIVITY
	<input type="checkbox"/>	Does this project involve a patient care area either directly or adjacent to?
	<input type="checkbox"/>	List: _____
	<input type="checkbox"/>	Do areas involved have knowledge of construction?
	<input type="checkbox"/>	List: _____
	<input type="checkbox"/>	Does this project alter patient access building/patient care area, either temporarily or permanently?

**If YES, indicate intervention:**

Access	1. The new/temporary access path should be intuitive, i.e. easy to follow. 2. Signage should be adequate for decreased visual acuity and at appropriate viewing levels for both ambulating and w/c bound individuals.	3. The access path should be smooth, without tripping hazards. 4. The access path should be handicap accessible.
Construction Areas/Materials	1. Construction areas should not be accessible by unauthorized personnel. 2. Construction areas should be visually identified.	3. Construction materials and tools should be moved and stored appropriately to preclude unauthorized access?
Critical Alarms	<b>Critical clinical alarms shall be functional and audible within and adjacent to the construction zone! Including but not limited to:</b> a. Emergency CODE Systems b. Medical Gas Alarms (Oxygen, Air, Suction) c. Wander guard technology d. Vital Sign Monitoring/Telemetry Systems e. Medication/Nutrition Pumps f. Nurse Call Systems	

**Additional Requirements:**

### INFECTION CONTROL RISK ASSESSMENT

**INFECTION CONTROL COORDINATOR**

Y	N	CONSTRUCTION ACTIVITY TYPE	PATIENT RISK GROUP (may modify as appropriate)
	<input type="checkbox"/>	A. Inspection, non-invasive activity-includes, not limited to removal of ceiling tiles for inspection (1.50 sq ft), painting (not sanding), wall covering, electrical trim work, minor plumbing, activities which do not generate dust or require cutting of walls or access to ceilings other than for visual inspection.	Low Risk - (ex Office Areas)
	<input type="checkbox"/>	B. Small scale, short duration, moderate to high levels-includes but not limited to installation of telephone/computer cabling, access to phase spaces, cutting of walls or ceiling where dust migration can be controlled.	Medium Risk - (ex Cardiology, ECHO, Endoscopy, Nuclear Medicine, Physical Therapy, Radiology/MRI, Respiratory Therapy)
	<input type="checkbox"/>	C. Work that generates a moderate to high level of dust or requires demolition or removal of any fixed building components or assemblies. Includes but not limited to sanding of walls for painting or wall covering; removal of floor coverings, ceiling tiles, and casework; new wall construction; minor duct work or electrical work above the ceiling; major cabling activity, any activity which cannot be completed in a single work shift.	High Risk - (ex CCU, ER, Labor & Delivery, Laboratories (specimen), Newborn Nursery, Outpatient Surgery, Pediatrics, Pharmacy, Post Anesthesia care, Surgical Units)
	<input type="checkbox"/>	D. Major duration and construction activities-includes, but not limited to activities that require consecutive work shifts; requires heavy demolition or removal of a complete cabling system; new construction.	Highest Risk - (ex Any area caring for immunocompromised patients, Burn Unit, Cardiac Cath Lab, Central Sterile Supply, ICU, Medical Unit, Negative pressure isolation rooms, Oncology, Operating rooms including C-section)

Patient Risk Group	TYPE A	TYPE B	TYPE C	TYPE D
LOW Risk	I	II	III	IIIV
MEDIUM Risk	I	II	IIIV	IV
HIGH Risk	I	II	IIIV	IV
HIGHEST Risk	II	IIIV	IIIV	IV

**During Construction Project**

CLASS	1	2	3	4	5
CLASS I	1. Execute work by methods to minimize raising dust from construction operations. 2. Immediately replace any ceiling tile displaced for visual inspection.				
CLASS II	1. Include all items from Class I above 2. Provides active means to prevent air-borne dust from dispersing into atmosphere 3. Water mist work surfaces to control dust while cutting. 4. Seal unused doors with duct tape. 5. Block off and seal air vents. 6. Place dust mat at access points of work area. 7. Contain construction waste before transport in tightly covered containers. 8. Isolate HVAC system in areas where work is being performed to prevent contamination of duct system.	1. Wipe surfaces with disinfectant. 2. Contain construction waste before transport in tightly covered containers. 3. Wet mop and/or vacuum with HEPA filtered vacuum before leaving work area. 4. Remove isolation of HVAC system in areas where work is being performed.			
CLASS III	1. Include all items from Class I/II above 2. Involve Infection Control in design/planning before construction begins. 3. Complete all critical barriers i.e. sheetrock, plywood, plastic, to seal area from non-work area with HEPA vacuum for vacuuming prior to exit before construction begins. 4. Maintain negative air pressure within work site utilizing HEPA equipped air filtration units. 5. Cover transport receptacles or carts. Tape covering unless solid lid.	1. Do not remove barriers from work area until completed project is thoroughly cleaned as required by Chief, EMS and Infection Control Coordinator. 2. Remove barrier materials carefully to minimize spreading of dirt and debris associated with construction. 3. Vacuum work area with HEPA filtered vacuums. 4. Wet mop area with disinfectant.			
CLASS IV	1. Include all items from Class I/II/III above 2. Involve Infection Control in design/planning before construction begins. 3. Seal holes, pipes, conduits, and punctures appropriately. 4. If exiting to a patient care area, construct anteroom and require all personnel to pass through this room so they can be vacuumed using a HEPA vacuum cleaner before leaving work site or they can wear cloth or paper coveralls that are removed each time they leave the work site. 5. Walk-off mats are recommended to minimize tracking of heavy dirt and dust from construction areas. Shoe covers may be considered in certain areas.	1. Include all items from Class I/II/III above			

**ICRA PROJECT CLASS:**

Y	N	RISK OF TB EXPOSURE	TYPE OF RISK:
	<input type="checkbox"/>	<input type="checkbox"/>	

**If yes, describe intervention:**

**Additional Requirements:**

Patient Safety Coordinator/Date \_\_\_\_\_ Infection Control Coordinator/Date \_\_\_\_\_

IH/Safety Date \_\_\_\_\_ Project Engineer/Date \_\_\_\_\_

### PROJECT GENERAL NOTES

- CONTRACTOR IS NOT AUTHORIZED TO SCALE CONSTRUCTION DOCUMENTS. ARCHITECT IS TO BE NOTIFIED IN THE EVENT A DISCREPANCY IS FOUND IN EITHER SPECIFICATIONS OR CONTRACT DOCUMENTS AT THE EARLIEST PRACTICAL OPPORTUNITY.
- GENERAL CONTRACTOR SHALL OBSERVE ALL REGULATIONS IMPOSED BY GOVERNING BODIES.
- CONSTRUCTION SHALL PROCEED IN AN ORDERLY AND CONTINUOUS FASHION IN ACCORDANCE WITH THE INTERNATIONAL BUILDING CODES AND ALL OTHER APPLICABLE CODES.
- THE CONTRACTOR SHALL CONTAIN ALL CONSTRUCTION ACTIVITY, INCLUDING STORAGE OF MATERIAL AND EQUIPMENT, WITHIN THE CONSTRUCTION LIMITS AT ALL TIMES BEING RESPONSIBLE FOR AND ABIDING BY RULES AND REGULATIONS OF THE OWNER.
- GENERAL CONTRACTOR TO BE RESPONSIBLE FOR REPAIRING ANY AND ALL SURFACES DAMAGED BY HIMSELF OR SUBCONTRACTORS UNDER HIS CONTROL. REPAIRS ARE TO MATCH EXISTING MATERIALS AND MUST BE ACCEPTABLE TO OWNER.
- ADEQUATELY PATCH/REPAIR TO MATCH ADJACENT CONSTRUCTION, ALL BUILDING STRUCTURES, COMPONENTS, AND UTILITIES WHICH ARE DISTURBED AND REQUIRE REPAIR AS A RESULT OF WORK PERFORMED UNDER THIS CONTRACT.
- ALL FLOOR TRANSITIONS BETWEEN DIFFERENT MATERIALS SHALL BE SMOOTH AND FLUSH (MAXIMUM SLOPE = 1/8" PER FOOT).
- GENERAL CONTRACTOR SHALL REMOVE ALL CONSTRUCTION DEBRIS FROM JOBSITE. ALL CONSTRUCTION DEBRIS SHALL BE CONTAINED INSIDE CONSTRUCTION LIMITS.
- ALL WALLS WITH ITEMS SUCH AS GRAB BARS, TOILET ACCESSORIES, WOOD TRIM, SHELVEING, CASEWORK, ETC. SHALL BE REINFORCED WITH CONCEALED, FIRE TREATED WOOD BLOCKING OR METAL STUD BLOCKING. (GENERAL CONTRACTOR TO INSTALL BLOCKING TYP.)
- BUILDING 5 WILL REMAIN OCCUPIED THROUGHOUT THE CONSTRUCTION PERIOD. THE CONTRACTOR SHALL TAKE EVERY NECESSARY PRECAUTION TO ENSURE THE UNINTERRUPTED OPERATION OF THE FACILITY. STAFF, PATIENTS AND VISITORS, DISRUPTION TO ADJACENT DEPARTMENTS AS WELL AS DEPARTMENTS ON FLOORS ABOVE OR BELOW SHALL BE COORDINATED WITH THE FACILITY CONTRACT OFFICER. THE CONTRACTOR SHALL COORDINATE ALL WORK, CONSTRUCTION, PATHWAYS, ELEVATOR USAGE, AND UTILITY INTERRUPTION WITH THE OWNER.
- CONTRACTOR TO EXERCISE ALL PRECAUTIONS TO PROVIDE FOR STAFF, PATIENTS, VISITORS, AND WORKMENS SAFETY DURING THE PERFORMANCE OF THIS CONTRACT PER EPA, OSHA, AND OTHER APPLICABLE CODES, STANDARDS, AND REGULATIONS.
- THE CONTRACTOR SHALL MAINTAIN A KEEP BARRIER FREE THE EXISTING MEANS OF EGRESS.
- ALL GYPSUM BOARD TO BE MOISTURE/MOLD RESISTANT TYPE X.
- THE CONTRACTOR IS RESPONSIBLE FOR CONSTRUCTION OF TEMPORARY PARTITIONS AND TEMPORARY VENTILATION SYSTEMS AS REQUIRED TO PREVENT THE SPREAD OF DUST FROM THE CONSTRUCTION AREA TO OCCUPIED AREAS OF THE BUILDING. OCCUPIED AREAS SHALL REMAIN DUST FREE THROUGHOUT THE CONSTRUCTION. THE CONTRACTOR SHALL MAINTAIN THE AFFECTED AREAS OF THE BUILDING (INCLUDING MATERIAL TRANSPORT ROUTES) CLEAN AND DUST FREE.
- ALL WOOD USED IN WALL CONSTRUCTION SHALL BE FIRE-RETARDANT-TREATED LUMBER.
- ALL WRITTEN CORRESPONDENCE WILL BE TRANSMITTED FROM SUBCONTRACTOR THROUGH GENERAL CONTRACTOR THROUGH ARCHITECT TO OWNER. ALL PARTIES CORRESPONDENCE ARE TO RECEIVE WRITTEN AND SIGNED COPIES OF SUCH. NO VERBAL AGREEMENTS AFFECTING COST OR ALTERNATIVE CONSTRUCTION METHODS AND ARRANGEMENTS WILL BE CONSIDERED VALID OR BINDING, AND ARE THEREFORE, DISALLOWED.
- GENERAL CONTRACTOR SHALL COMPLY WITH ALL DIRECTIVES OF THE OWNER. IF CONFLICTS BETWEEN DRAWINGS, SPECIFICATIONS AND REQUIREMENTS OF BUILDING OWNER AND/OR OPERATIONAL SYSTEM, THEY SHALL BE BROUGHT TO THE ATTENTION OF THE ARCHITECT IMMEDIATELY.
- THE HVAC, PLUMBING AND ELECTRICAL CONTRACTORS SHALL COORDINATE THEIR WORK WITH THE WORK OF OTHER TRADES TO ASSURE THAT THE WORK CAN BE INSTALLED IN A WORKMAN-LIKE MANNER. EACH CONTRACTOR SHALL BE EXPECTED TO COOPERATE WITH OTHER CONTRACTORS IN THE PLACEMENT OF WORK TO AVOID CONFLICTS AND MAINTAIN JOB PROGRESS.
- ALL EXISTING DUCTWORK, ELECTRICAL OR PIPING IS NOT NECESSARILY SHOWN ON THE DRAWINGS.
- BEFORE CONTRACTOR'S BID THE JOB, IT IS IMPERATIVE THEY VISIT THE JOBSITE AND FIELD VERIFY THE EXACT LOCATION OF ALL EXISTING EQUIPMENT, DUCTWORK, ETC. IT WILL BE PART OF THE CONTRACTOR'S RESPONSIBILITY AND THE CONTRACTOR WILL BEAR THE COST TO ENGINEER AND RELOCATE ANY EXISTING OBSTACLES WHICH WILL INTERFERE WITH THE CONTRACTOR'S ABILITY TO INSTALL ALL NEW OR RELOCATED WORK ON HIS CONTRACT.

### CONTRACTOR GENERAL NOTES

- ALL EXISTING DUCTWORK, ELECTRICAL OR PIPING IS NOT NECESSARILY SHOWN ON THE DRAWINGS.
- BEFORE CONTRACTOR'S BID THE JOB, IT IS IMPERATIVE THEY VISIT THE JOBSITE AND FIELD VERIFY THE EXACT LOCATION OF ALL EXISTING EQUIPMENT, DUCTWORK, ETC. IT WILL BE PART OF THE CONTRACTOR'S RESPONSIBILITY AND COST TO ENGINEER AND RELOCATE ANY EXISTING OBSTACLES WHICH WILL INTERFERE WITH THE CONTRACTOR'S ABILITY TO INSTALL ALL NEW OR RELOCATED WORK ON HIS CONTRACT.
- CONTRACTOR SHALL VERIFY ALL DIMENSIONS IN FIELD AND NOTIFY PROJECT ENGINEER OF ALL DISCREPANCIES IF ANY, FOUND PRIOR TO PLACEMENT OF ANY COMPONENTS.
- THE CONTRACTOR WILL TAKE ALL NECESSARY PRECAUTIONS INCLUDING THE BUILDING AND MAINTENANCE OF DUST TIGHT PARTITIONS, DAILY VACUUMING, SWEEPING, AND PROVISION OF CLEAN FLOOR MATS AT THE PROJECT ENTRANCES. TO PREVENT THE INFILTRATION OF DIRT AND DUST FROM THE CONSTRUCTION AREAS INTO THE OCCUPIED AREAS.
- PATCH ALL FINISHES WHERE DISTURBED BY THE WORK AND WHERE UNFINISHED SURFACES HAVE BEEN EXPOSED BY DEMOLITION. PATCHING MUST MATCH ADJACENT MATERIALS, COLORS, AND FINISHES. WALL SURFACES THAT ARE PATCHED SHALL HAVE THE FINISHES (PAINT, VINYL WALL COVERING, ETC.) REPLACED FROM CORNER TO CORNER AND FLOOR TO CEILING.
- UNLESS OTHERWISE INDICATED FINISH ALL NEW FRAMES AND PARTITIONS TO MATCH SURROUNDING. NEW HOLLOW METAL DOORS SHALL BE PAINTED SAME COLOR AS FRAMES. EXISTING PARTITIONS RECEIVING NEW DOOR FRAMES THAT HAVE VINYL WALL COVERING (WVC) SHALL HAVE THE WVC COMPLETELY REMOVED AND REFINISHED WITH NEW VINYL OF MATCHING TEXTURE AND COLOR.
- PAINT ALL EXPOSED NEW AND EXISTING PIPING, CONDUIT, WIRE MOLD, ELECTRICAL PANELS, ACCESS PANELS, ETC. TO MATCH WALL FINISH UNLESS OTHERWISE NOTED.
- CORRIDOR WALLS AND PLUMBING PARTITIONS SHALL BE CONSIDERED 1 HOUR FIRE RATED WALLS AND NEW OR EXISTING PARTITIONS MUST BE SEALED ACCORDINGLY WITH APPROVED FIRESTOPPING MATERIAL. THE SAME DAY THE WORK IS MADE IN THE CORRIDOR SHALL BE MADE IN THE STAIRWELLS AND STAIRWELLS SHALL BE CONSIDERED 2 HOUR RATED PARTITIONS AND BE SEALED ACCORDINGLY. ALL PENETRATIONS THROUGH THE EXTERIOR WALLS SHALL BE SEALED WATER/TIGHT.
- ALL NEW VERTICAL AND HORIZONTAL DUCTS, PIPES, CONDUITS, ETC. IN FINISHED ROOMS OR AREAS THROUGHOUT BUILDING, NOT ENCASED IN MASONRY OR CONCRETE CONSTRUCTION, SHALL BE FURRED IN, THE FURRING FINISHED TO MATCH THE ROOM FINISH.
- WHENEVER EXISTING EQUIPMENT, PIPING, DUCTS, ETC. ARE REQUIRED TO BE REMOVED, SUCH REMOVAL SHALL INCLUDE ALL ANCHORS, HANGERS, FOUNDATIONS, ETC. UNLESS NOTED OTHERWISE. AFTER REMOVAL, FLOORS, WALLS, AND CEILINGS SHALL BE FINISHED TO MATCH ADJOINING SURFACES.
- UTILITY WORK THAT WILL REQUIRE A SHUTDOWN OF EXISTING SERVICE(S) WILL BE REMOVED. SUCH REMOVAL SHALL INCLUDE ALL ANCHORS, HANGERS, FOUNDATIONS, ETC. UNLESS NOTED OTHERWISE. WORK MUST BE SCHEDULED WITH THE COR WITH MINIMUM TWO WEEKS NOTICE.
- WORK THAT MUST OCCUR IN OCCUPIED AREAS OF THE MEDICAL CENTER OR DISRUPT A MEDICAL CENTER'S FUNCTION WILL BE DONE AT TIMES OTHER THAN NORMAL WORKING HOURS (NIGHTS, WEEKENDS, HOLIDAYS, ETC.) AT NO ADDITIONAL COST TO THE GOVERNMENT. WORK MUST BE SCHEDULED WITH THE COR WITH MINIMUM TWO WEEKS NOTICE.
- WORK THAT MUST OCCUR IN OCCUPIED AREAS OF THE MEDICAL CENTER OR DISRUPT A MEDICAL CENTER'S FUNCTION WILL BE DONE AT TIMES OTHER THAN NORMAL WORKING HOURS (NIGHTS, WEEKENDS, HOLIDAYS, ETC.) AT NO ADDITIONAL COST TO THE GOVERNMENT. WORK SCHEDULE MUST BE COORDINATED WITH THE PROJECT COR. ALL WORK DONE IN THE WORKING PHASES OF THE PROJECT SHALL BE COORDINATED WITH THE PHARMACEUTICAL.
- ALL ELECTRICAL, CIRCUITRY TO BE CONCEALED UNLESS OTHERWISE SPECIFIED. CIRCUITING FOR ELECTRIC DOOR HOLD OPENS IN MASONRY WALLS SHALL BE SURFACE RACEWAY.
- COORDINATE ALL WORK WITH OTHER TRADES AND EXISTING CONDITIONS TO ELIMINATE CONFLICTS AND/OR INTERFENCES. THE CONTRACTOR SHALL PROVIDE ALL OFFSETS, FITTINGS, TRANSITIONS, EXTENSIONS, ETC. REQUIRED FOR A COMPLETE AND FUNCTIONAL SYSTEM.
- DRAWINGS ARE DIAGNOSTIC AND SHOW ONLY THE GENERAL ARRANGEMENT OF EACH SYSTEM. BECAUSE OF SMALL SIZES OF DRAWINGS IT IS NOT POSSIBLE TO SHOW OR INDICATE ALL BRANCHES, OFFSETS, FITTINGS, BOXES, AND ACCESSORIES WHICH MAY BE REQUIRED. CONTRACTOR MUST CAREFULLY INVESTIGATE STRUCTURAL AND FINISH CONDITIONS AFFECTING ALL WORK. FURNISHING SUCH FITTINGS, TRAPS, VALVES, BOXES, ACCESSORIES, ETC., AS MAY BE REQUIRED.
- LOCATIONS OF NEW EQUIPMENT, PIPING, AND ASSOCIATED ITEMS SHOWN ON THE DRAWINGS ARE SCHEMATIC ONLY. THE CONTRACTOR SHALL FIELD VERIFY EXACT LOCATION AND ELEVATION FOR ALL WORK, INCLUDING CONNECTIONS TO EXISTING. ALL OFFSETS, FITTINGS, TRANSITIONS, EXTENSIONS, ETC. REQUIRED FOR A COMPLETE AND FUNCTIONAL SYSTEM SHALL BE PROVIDED AT NO ADDITIONAL COST.
- ALL EXISTING DUCTWORK, ELECTRICAL OR MECHANICAL PIPING, CABLE TRAYS, ETC. IS NOT NECESSARILY SHOWN ON THE DRAWINGS. BEFORE CONTRACTOR PLACES A BID IT IS IMPERATIVE THEY VISIT THE JOBSITE AND FIELD VERIFY THE EXACT LOCATION OF ALL EXISTING EQUIPMENT, DUCTWORK, PIPING, ETC. IT WILL BE PART OF THE CONTRACTOR'S RESPONSIBILITY AND THE CONTRACTOR WILL BEAR THE COST TO ENGINEER AND RELOCATE ANY EXISTING OBSTACLES WHICH WILL INTERFERE WITH THE CONTRACTOR'S ABILITY TO INSTALL ALL NEW OR RELOCATED WORK IN THIS PROJECT.
- CONTRACTOR SHALL NOT INSTALL CONDUIT, PIPING, LIGHTING, OR OTHER OBSTRUCTIONS UNDER OR ADJACENT TO HVAC EQUIPMENT THAT WILL ELIMINATE OR OBSTRUCT ACCESS TO COILS, MOTORS, VALVES, SWITCHES, PANELS, ETC.
- BEFORE THE CONTRACTOR BEGINS WORK ALL EXISTING SYSTEM INFORMATION SHALL BE RECORDED SUCH AS TEMPERATURE, FLOW RATE, PRESSURE, CURRENT, VOLTAGE, OR ANY OTHER INFORMATION NECESSARY FOR HIM TO RETURN THE AFFECTED SYSTEM TO ORIGINAL OPERATING CONDITION. UNLESS NOTED OTHERWISE IF IT IS ASSUMED THAT ALL SYSTEMS (HVAC, ELECTRICAL, PLUMBING, ETC.) ARE WORKING PROPERLY IN EVERY MANNER AT THE BEGINNING OF THE PROJECT. THE CONTRACTOR'S RECORDED MEASUREMENTS MUST BE SUBMITTED TO THE PROJECT ENGINEERS FOR REVIEW AND ACCEPTANCE BEFORE ANY DEMOLITION OR OTHER RELATED WORK CAN PROCEED.
- FOR DOORS BEING REPLACED: IF THE EXISTING DOOR HAS SIGNAGE APPLIED TO IT, THIS SIGNAGE SHOULD BE CAREFULLY REMOVED AND REAPPLIED TO THE NEW DOOR. IF THE SIGNAGE IS DAMAGED DURING REMOVAL OR CANNOT OTHERWISE BE REAPPLIED IT SHOULD BE REPLACED WITH NEW SIGNAGE OF IDENTICAL TYPE.
- THE CONTRACTOR WILL BE RESPONSIBLE FOR MAINTAINING ALL EXISTING ACCESS DOORS TO CONSTRUCTION AREAS, EXISTING MECHANICAL AND ELECTRICAL AREAS, ASSIGNED STORAGE AREAS, EQUIPMENT ACCESS AREAS, ETC. DOORS MUST BE RESTORED TO THE CONDITION ENCOUNTERED AT BEGINNING OF PROJECT. THIS INCLUDES DOOR REPLACEMENT, HARDWARE REPLACEMENT, HARDWARE REPAIR, DOOR REPAIR, ETC.
- IT IS IMPORTANT THAT ALL REPLACEMENT FIRE RATED DOORS HAVE A GAP OF LESS THAN 3/16" BETWEEN THE BOTTOM OF THE DOOR AND THE FLOOR AT ALL POINTS. CONTRACTOR MUST COORDINATE INSTALLED DOOR FRAME HEIGHT OR MAKE OTHER NECESSARY MODIFICATIONS TO MEET THIS REQUIREMENT AND KEEP ALL FIRE RATED DOORS AND FRAME. BOTTOM SWEEPS ARE NOT ACCEPTABLE UNLESS SPECIFICALLY STATED ON DRAWING.
- IF THERE IS ANY WORK TO BE DONE ON EXISTING ROOFS, SUCH AS ROOF PENETRATIONS OR STANDS, OR ANYTHING THAT DAMAGES THE INTEGRITY OF THE ROOF, THIS WORK MUST BE DONE BY A CONTRACTOR LICENSED BY THE ROOFING MEMBRANE MANUFACTURER. HE MUST BE APPROVED BY THE MEMBRANE MANUFACTURER SO AS TO NOT VOID OR INTERRUPT EXISTING SINGLE PLY MEMBRANE ROOF WARRANTIES.
- EXISTING CIRCUITRY (CONDUIT, BOXES, WIRE, ETC.) MAY BE REUSED AT THE CONTRACTOR'S OPTION AS LONG AS IT MEETS THE SAME SPECIFICATIONS REQUIRED FOR NEW CIRCUITRY. ALL WORK, NEW AND EXISTING, SHALL COMPLY WITH THE LATEST NEC CODE.
- WHERE DOOR AND HARDWARE ARE SHOWN TO BE REMOVED, THE DOOR STOPS ARE TO REMAIN AND BE REUSED UNLESS NOTED OTHERWISE.
- ALL FIRE PROTECTION SPRINKLERS TO REMAIN IN SERVICE DURING CONSTRUCTION.

### ILSM EVALUATION


**PROJECT LOCATION:** \_\_\_\_\_ **START DATE:** \_\_\_\_\_

Evaluated Item	YES	NO	Joint Commission ILSM Administrative Actions	If answer is "Yes", see actions required to be taken	Training/Review Date
Will any exit be obstructed?	<input type="checkbox"/>	<input type="checkbox"/>	Ensuring unobstructed exits. When alternative exits have been designed, staff members in affected areas must receive additional training. Buildings or areas under construction must maintain escape routes for construction workers at all times, and the means of exiting construction areas are inspected daily.	Personnel in the building will receive training on alternate routes and exits  Construction areas will have designated and marked exits to be clear at all times if necessary	Date: _____  Date: _____
Will any entrance be obstructed to limit the access to emergency services?	<input type="checkbox"/>	<input type="checkbox"/>	Ensuring free and unobstructed access to emergency services and for fire, police, and other emergency forces.	The construction plans will be reviewed to ensure proper access and will be maintained	Date: _____
Will any fire detection or suppression system be impaired for > 8 hours in a 24 hour period?	<input type="checkbox"/>	<input type="checkbox"/>	Ensuring that the fire detection and suppression systems are in good working order. A temporary but equivalent system must be provided when any fire system is impaired. Temporary systems must be inspected and tested monthly.	Contractor will be briefed to schedule work to minimize time systems impaired and notify appropriate offices prior to system being impaired	Date: _____
Will construction be open to other areas without any smoke tight barriers?	<input type="checkbox"/>	<input type="checkbox"/>	Ensuring that temporary construction partitions are smoke tight and built of noncombustible materials that will not contribute to the development or spread of fire.	Contractor will be briefed at pre-construction conference of requirement	Date: _____
Will fire hazard be substantially higher?	<input type="checkbox"/>	<input type="checkbox"/>	Providing additional firefighting equipment and training staff in its use.	Contractor will be briefed at the pre-construction conference for the need to provide adequate firefighting equipment and training construction employees	Date: _____
Will smoking be permitted in construction areas?	<input type="checkbox"/>	<input type="checkbox"/>	Prohibiting smoking throughout the organization's buildings and in and near construction areas.	Refer to Fargo VA HCS Smoking Policy	Date: _____
Will storage, housekeeping and debris removal practices increase the fire load?	<input type="checkbox"/>	<input type="checkbox"/>	Developing and enforcing storage, housekeeping, and debris removal practices that reduce the building's flammable and combustible fire load to the lowest feasible level.	Contractor will be briefed at preconstruction conference of requirement	Date: _____

Evaluated Item	YES	NO	Joint Commission ILSM Administrative Actions	If answer is "Yes", see actions required to be taken	Training/Review Date
Will the fire hazard increase to justify extra fire drills?	<input type="checkbox"/>	<input type="checkbox"/>	Conducting a minimum of two fire drills per shift per quarter.	Safety Department will evaluate effects of work on life safety and determine if there is a need to increase frequency of drills	Date: _____
Will hazardous conditions substantially increase in or around the buildings to require extra surveillance activities?	<input type="checkbox"/>	<input type="checkbox"/>	Increasing hazard surveillance of buildings, grounds, and equipment, with special attention to excavations, construction areas, construction storage, and field offices.	A Fire Watch will be implemented as needed	Date: _____
Will structural features of fire safety be impaired?	<input type="checkbox"/>	<input type="checkbox"/>	Training staff to compensate for impaired structural or compartmentalization features of fire safety.	Personnel in the building will receive training in response for life safety deficiencies if necessary	Date: _____
Will this project affect the life safety features of all areas?	<input type="checkbox"/>	<input type="checkbox"/>	Conducting organization wide safety education programs to promote awareness of LSC building deficiencies, construction hazards, and ILSMs.	Staff will be made aware of deficiencies, hazards, and interim measures during personal contact, training, and/or information channels. ILSM will be posted by project site.	Date: _____
Other Life Safety Code considerations?	<input type="checkbox"/>	<input type="checkbox"/>		If Ceiling Tiles are out for more than 4 hours a fire watch will be implemented.	Date: _____

ILSM Required:  Yes  No ILSM Issue Date: Evaluation determines no ILSM needed

Prepared by: \_\_\_\_\_ Reviewed By: \_\_\_\_\_
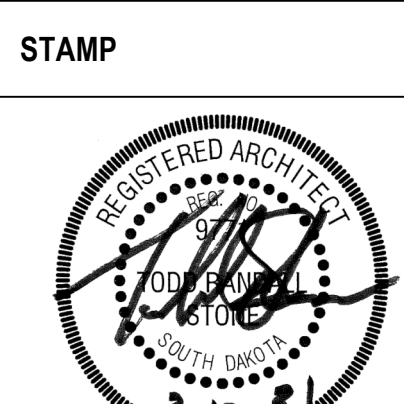
<p><b>CONSULTANTS</b></p> <p>MECHANICAL / ELECTRICAL / PLUMBING:</p> <p><b>DUNHAM</b> 52 South Sixth Street, Suite 1100 Minneapolis, MN 55402 Phone: 612-465-7550</p> <p>STRUCTURAL:</p> <p><b>ERA</b> ERIKSEN ROAD ERIKSEN ROAD &amp; ASSOCIATES 2500 University Avenue West, Suite 201-S Saint Paul, MN 55114 Phone: 651-251-7570</p>	<p><b>ARCHITECT OF RECORD</b></p> <p>A/E:</p> <p><b>Stone Group Architects</b> 600 E 7th Street Sioux Falls, SD 57103 605-271-1144</p> <p><b>STONE GROUP ARCHITECTS</b></p>	<p>STAMP</p> 	<p><b>Office of Construction and Facilities Management</b></p> <p>VA U.S. Department of Veterans Affairs</p>	<p>Drawing Title</p> <p><b>CONSTRUCTION NOTES, PCRA, ICLM</b></p> <p>Approved: _____</p>	<p>Phase</p> <p><b>BID SET</b></p>	<p>Project Title</p> <p><b>UPGRADE PHARMACY 797</b></p>	<p>Project Number</p> <p><b>VA #438-20-109 SGA #201927</b></p>
<p>Revision# Description Date:</p>						<p>Building Number</p> <p><b>5</b></p>	
						<p>Drawing Number</p> <p><b>G002</b></p>	
						<p>Location</p> <p><b>SIoux FALLS, SOUTH DAKOTA</b></p>	
						<p>Issue Date</p> <p><b>02/10/2021</b></p>	
						<p>Checked</p> <p><b>TRS</b></p>	
						<p>Drawn</p> <p><b>DAN</b></p>	



**PHASING INFORMATION:**

**PHASE 1:**  
EMERGENCY POWER UPDATES THROUGHOUT PHARMACY B89 AND B92. COORDINATE FULL EXTENTS OF CONSTRUCTION AREAS WITH ELECTRICAL DRAWINGS. REMOVE AND REPLACE CEILING TILES AS NEEDED FOR NEW ELECTRICAL CONDUIT. PHASE 1 CEILING WORK TO BE REINSTALLED DIRECTLY AFTER WORK IS COMPLETE. ORDER LONG LEAD ITEMS.

**PHASE 2:**  
RELOCATE PHARMACY REFRIGERATORS TO EMERGENCY POWER LOCATION PRIOR TO CASEWORK DEMOLITION. REMOVE EXISTING CASEWORK INSTALL NEW CASEWORK AS SHOWN ON THE ARCHITECTURAL DOCUMENTS. PATCH AND SEAL EXISTING FLOORING AS REQUIRED TO MATCH ADJACENT FLOORING.

**PHASE 3:**  
CONSTRUCT TEMPORARY PARTITIONS UP TO PHARMACY SECURITY REQUIREMENTS PRIOR TO ANY DEMOLITION WORK. RELOCATE EXISTING PASS THROUGH REFRIGERATORS TO EMERGENCY POWER AS SHOWN ON ARCHITECTURAL AND ELECTRICAL DRAWINGS. UPGRADE EXISTING COMPOUNDING AREA TO MEET USP 797 REQUIREMENTS.

**CODE INFORMATION**

<p><b>PROJECT INFORMATION:</b></p> <p>1. CONSTRUCTION PURPOSE: RENOVATION</p> <p>2. REASON FOR SUBMITTAL: RENOVATION</p> <p>3. I CERTIFY THAT TO THE BEST OF OUR KNOWLEDGE THE SUBMITTED PLANS FOR THE ABOVE-REFERENCED PROJECT COMPLY WITH THE REQUIREMENTS OF THE FOLLOWING:                  NFPA 101-18 (AND ALL REFERENCED DOCUMENTS)                  2018 INTERNATIONAL MECHANICAL CODE (IMC)                  2015 UNIFORM PLUMBING CODE (UPC)                  2017 NATIONAL ELECTRICAL CODE (NFPA-70)                  2018 LIFE SAFETY CODE (NFPA-101)                  2015 ADA ACCESSIBILITY STANDARDS                  BARRIER FREE DESIGN                  2018 IBC WITH LOCAL AMENDMENTS                  ASHRAE STANDARD 90.1 (2007)</p> <p>4. LOCATION OF ANY ANTICIPATED FUTURE ADDITIONS: UNKNOWN</p> <p>5. OWNER:                  DEPARTMENT OF VETERANS AFFAIRS                  OFFICE OF CONSTRUCTION AND FACILITIES MANAGEMENT                  ROYAL C. JOHNSON VETERANS MEMORIAL MEDICAL CENTER                  2501 W 22ND STREET                  PO BOX 5048                  SIOUX FALLS SD 57117-5046</p> <p>6. DESIGN TEAM:                  ARCHITECT:                  STONE GROUP ARCHITECTS                  600 E 7th STREET                  SIOUX FALLS SD 57103                  605-271-1144                  ARCHITECT: TODD STONE                  CONTACT: TODD STONE                  TODD.STONE@STONEGROUPARCH.COM</p> <p>DUNHAM:                  50 SOUTH SIXTH STREET, SUITE 1100                  MINNEAPOLIS, MN 55402                  612-465-7550                  CONTACT: JASON GOTTLWALT (MECHANICAL)                  JASON.GOTTLWALT@DUNHAMENG.COM</p> <p>ERICKSEN ROED &amp; ASSOCIATES                  2550 UNIVERSITY AVENUE WEST                  SUITE 422-S                  SAINT PAUL, MN 55114                  651-251-7570                  CONTACT:                  STEVE CLARK (STRUCTURAL)                  SCLARK@ERENG.COM</p>	<p>10. OCCUPANCY GROUP TYPE:                  OCCUPANCY - HEALTHCARE</p> <p>11. CONSTRUCTION TYPE: TYPE II (222)</p> <p>A. ALLOWABLE FLOOR AREA FROM NFPA-101                  PROJECT AREA: 4,283 SF</p> <p>B. ALLOWABLE HEIGHT CALCULATIONS                  OCCUPANCY - B-BUSINESS/1ST FLOOR OF HOSPITAL TO BE DETERMINED BY VA                  TYPE OF CONSTRUCTION: TYPE IIB                  ALLOWABLE STORIES: N/A                  ALLOWABLE HEIGHT: N/A                  ACTUAL STORIES: MULTIPLE (EXISTING)                  ACTUAL HEIGHT: 22'-0" (EXISTING)                  NO HEIGHT MODIFICATIONS REQUIRED</p> <p>C. FIRE-RESISTANCE RATING FOR BUILDING ELEMENTS: TYPE IIB</p> <p>BEARING WALLS (EXTERIOR): 0 HR                  BEARING WALLS (INTERIOR): 0 HR                  NON-BEARING WALLS (EXTERIOR): 0 HR                  PARTITIONS: 0 HR                  SMOKE BARRIERS BETWEEN SMOKE COMPARTMENTS: 1 HR                  STRUCTURAL FRAME: FLOOR AND FLOOR/CEILING: 0 HR                  ROOF AND ROOF/CEILING: 0 HR                  SHAFT ENCLOSURES: 1 HR                  STAIRWAY CONSTRUCTION: 1 HR</p> <p>12. ACTIVE FIRE SAFETY SYSTEMS                  (a) GENERATOR POWERED EMERGENCY LIGHTING                  (b) BATTERY POWERED EXIT LIGHTING                  (c) HOOD SUPPRESSION SYSTEM                  (d) PORTABLE EXTINGUISHERS                  (e) AUTOMATIC AIR-HANDLING SHUT-DOWN                  (f) FIRE ALARM SYSTEM</p> <p>13. WATER SUPPLY: CITY OF SIOUX FALLS</p> <p>14. SEWAGE TREATMENT: CITY OF SIOUX FALLS                  ACCESSIBLE ROUTE, LAVATORIES AND SIGNAGE</p> <p>15. HANDICAP PROVISIONS:                  BUSINESS: 100 SF PER PERSON GROSS</p> <p>16. OCCUPATIONAL LOAD:                  BUSINESS: 100 SF PER PERSON GROSS</p> <p>EGRESS CAPACITY:                  STAIRWAY: 3 IN/PERSON                  DOOR: 2 IN/PERSON</p> <p>DEAD END CORRIDORS: NOT TO EXCEED 50 FT                  TRAVEL DISTANCE TO EXIT: 300 FT</p> <p>SMOKE COMPARTMENTS (USING HEALTHCARE OCCUPANCY BASIS):                  (18.3.7.12) AT LEAST 2 PER FLOOR                  (18.3.7.13) NOT TO EXCEED 40,000 SF EACH</p>
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**BUILDING CODES, GUIDES, MANUALS**

NOTE: ALL WORK IS TO BE PERFORMED TO THE LATEST EDITION OF THE FOLLOWING CODES, ORDINANCES, AND LAWS WHICH INCLUDE, BUT ARE NOT LIMITED TO:


- VA DIRECTIVES, DESIGN MANUALS, MASTER SPECIFICATIONS, VA NATIONAL CAD STANDARD APPLICATION GUIDE, AND OTHER GUIDANCE INFORMATION ON THE TECHNICAL INFORMATION LIBRARY (TIL)
- INTERNATIONAL BUILDING CODE (IBC) (ONLY WHEN SPECIFICALLY REFERENCED IN VA DESIGN DOCUMENTS)
- NFPA 101 LIFE SAFETY CODE
- NFPA NATIONAL FIRE CODES WITH THE EXCEPTION OF NFPA 5000 AND NFPA 900
- OCCUPATIONAL SAFETY AND HEALTH ADMINISTRATION (OSHA) STANDARDS
- VA SEISMIC DESIGN REQUIREMENTS, H-18-8
- NATIONAL ELECTRICAL CODE (NEC)
- INTERNATIONAL PLUMBING CODE (IPC)
- ASME BOILER AND PRESSURE VESSEL CODE
- ASME CODE FOR PRESSURE PIPING
- ARCHITECTURAL BARRIER ACT ACCESSIBILITY STANDARDS (ABAS) INCLUDING VA SUPPLEMENT, BARRIER FREE DESIGN GUIDE (PG-18-13)
- BUILDING CODE REQUIREMENTS FOR REINFORCED CONCRETE, AMERICAN CONCRETE INSTITUTE AND COMMENTARY (ACI 318)
- MANUAL OF STEEL CONSTRUCTION, LOAD AND RESISTANCE FACTOR DESIGN SPECIFICATIONS FOR STRUCTURAL STEEL BUILDINGS, AMERICAN INSTITUTE OF STEEL CONSTRUCTION (AISC)
- ENERGY POLICY ACT OF 2005 (EPACT)
- DOE INTERIM FINAL RULE: ENERGY CONSERVATION STANDARDS FOR NEW FEDERAL, COMMERCIAL AND MULTI-FAMILY HIGH-RISE RESIDENTIAL BUILDINGS AND NEW LOW-RISE RESIDENTIAL BUILDINGS, 10 CFR PARTS 433, 434, AND 435
- FEDERAL LEADERSHIP IN HIGH PERFORMANCE AND SUSTAINABLE BUILDINGS: MEMORANDUM OF UNDERSTANDING (MOU)
- EXECUTIVE ORDER 13423: STRENGTHENING FEDERAL ENVIRONMENT, ENERGY, AND TRANSPORTATION MANAGEMENT
- THE PROVISIONS FOR CONSTRUCTION AND SAFETY SIGNS, STATED IN THE GENERAL REQUIREMENTS SECTION 01010 IF THE VA MASTER CONSTRUCTION SPECIFICATION.
- VENTILATION FOR THE ACCEPTABLE INDOOR AIR QUALITY - ASHRAE STANDARD 62.1 - 2004.
- SAFETY STANDARD FOR REFRIGERATION SYSTEMS - ASHRAE STANDARD 15 - 2007.
- USP 800
- USP 797
- USP 795
- VA PHARMACY SERVICE DESIGN (PG-18-12) DATED SEPTEMBER 24, 2020

**GENERAL CODE PLAN NOTES:**



A. ANY DISCREPANCIES OR CONFLICTS FOUND IN THE VARIOUS PARTS OF THE CONSTRUCTION DOCUMENTS SHALL BE BROUGHT TO THE ATTENTION OF THE ARCHITECT AND THE OWNER BEFORE PROCEEDING WITH THE WORK.

B. SEE MECHANICAL, ELECTRICAL AND PLUMBING DRAWINGS FOR ADDITIONAL INFORMATION.

**CODE PLAN LEGEND**

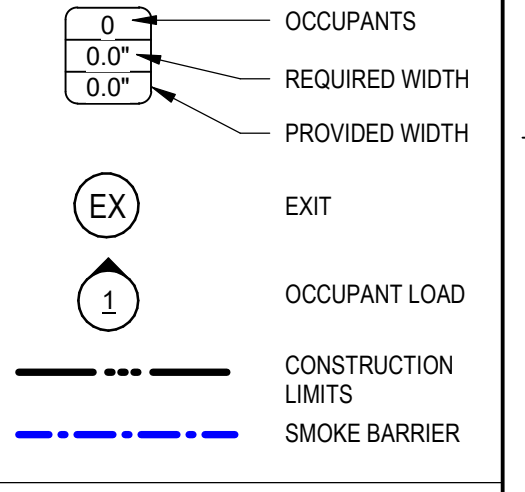

Scale indicators on the left margin: 1/8" = 1'-0", 1/4" = 1'-0", 1/2" = 1'-0", 3/8" = 1'-0", 1/2" = 1'-0", 3/4" = 1'-0", 1" = 1'-0", 1 1/4" = 1'-0", 1 1/2" = 1'-0", 1 3/4" = 1'-0", 2" = 1'-0", 2 1/4" = 1'-0", 2 1/2" = 1'-0", 2 3/4" = 1'-0", 3" = 1'-0", 3 1/4" = 1'-0", 3 1/2" = 1'-0", 3 3/4" = 1'-0", 4" = 1'-0", 4 1/4" = 1'-0", 4 1/2" = 1'-0", 4 3/4" = 1'-0", 5" = 1'-0", 5 1/4" = 1'-0", 5 1/2" = 1'-0", 5 3/4" = 1'-0", 6" = 1'-0", 6 1/4" = 1'-0", 6 1/2" = 1'-0", 6 3/4" = 1'-0", 7" = 1'-0", 7 1/4" = 1'-0", 7 1/2" = 1'-0", 7 3/4" = 1'-0", 8" = 1'-0", 8 1/4" = 1'-0", 8 1/2" = 1'-0", 8 3/4" = 1'-0", 9" = 1'-0", 9 1/4" = 1'-0", 9 1/2" = 1'-0", 9 3/4" = 1'-0", 10" = 1'-0".

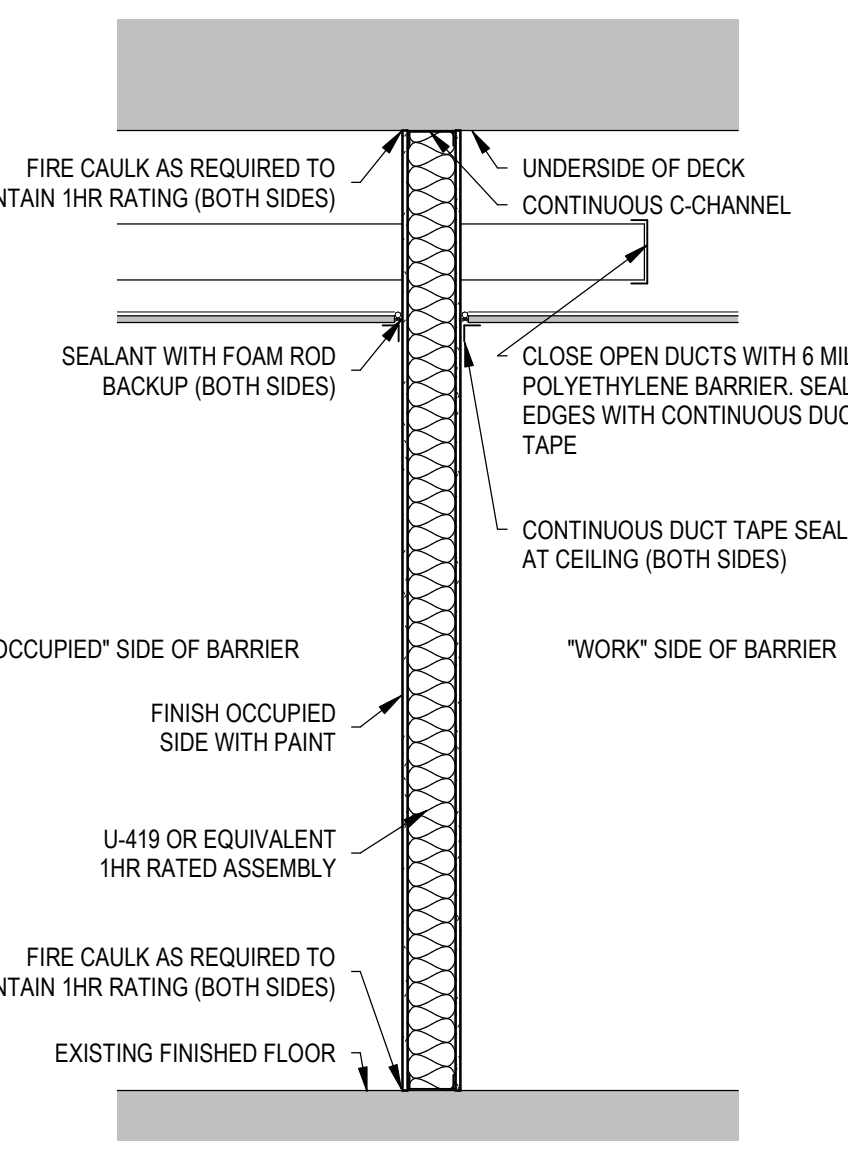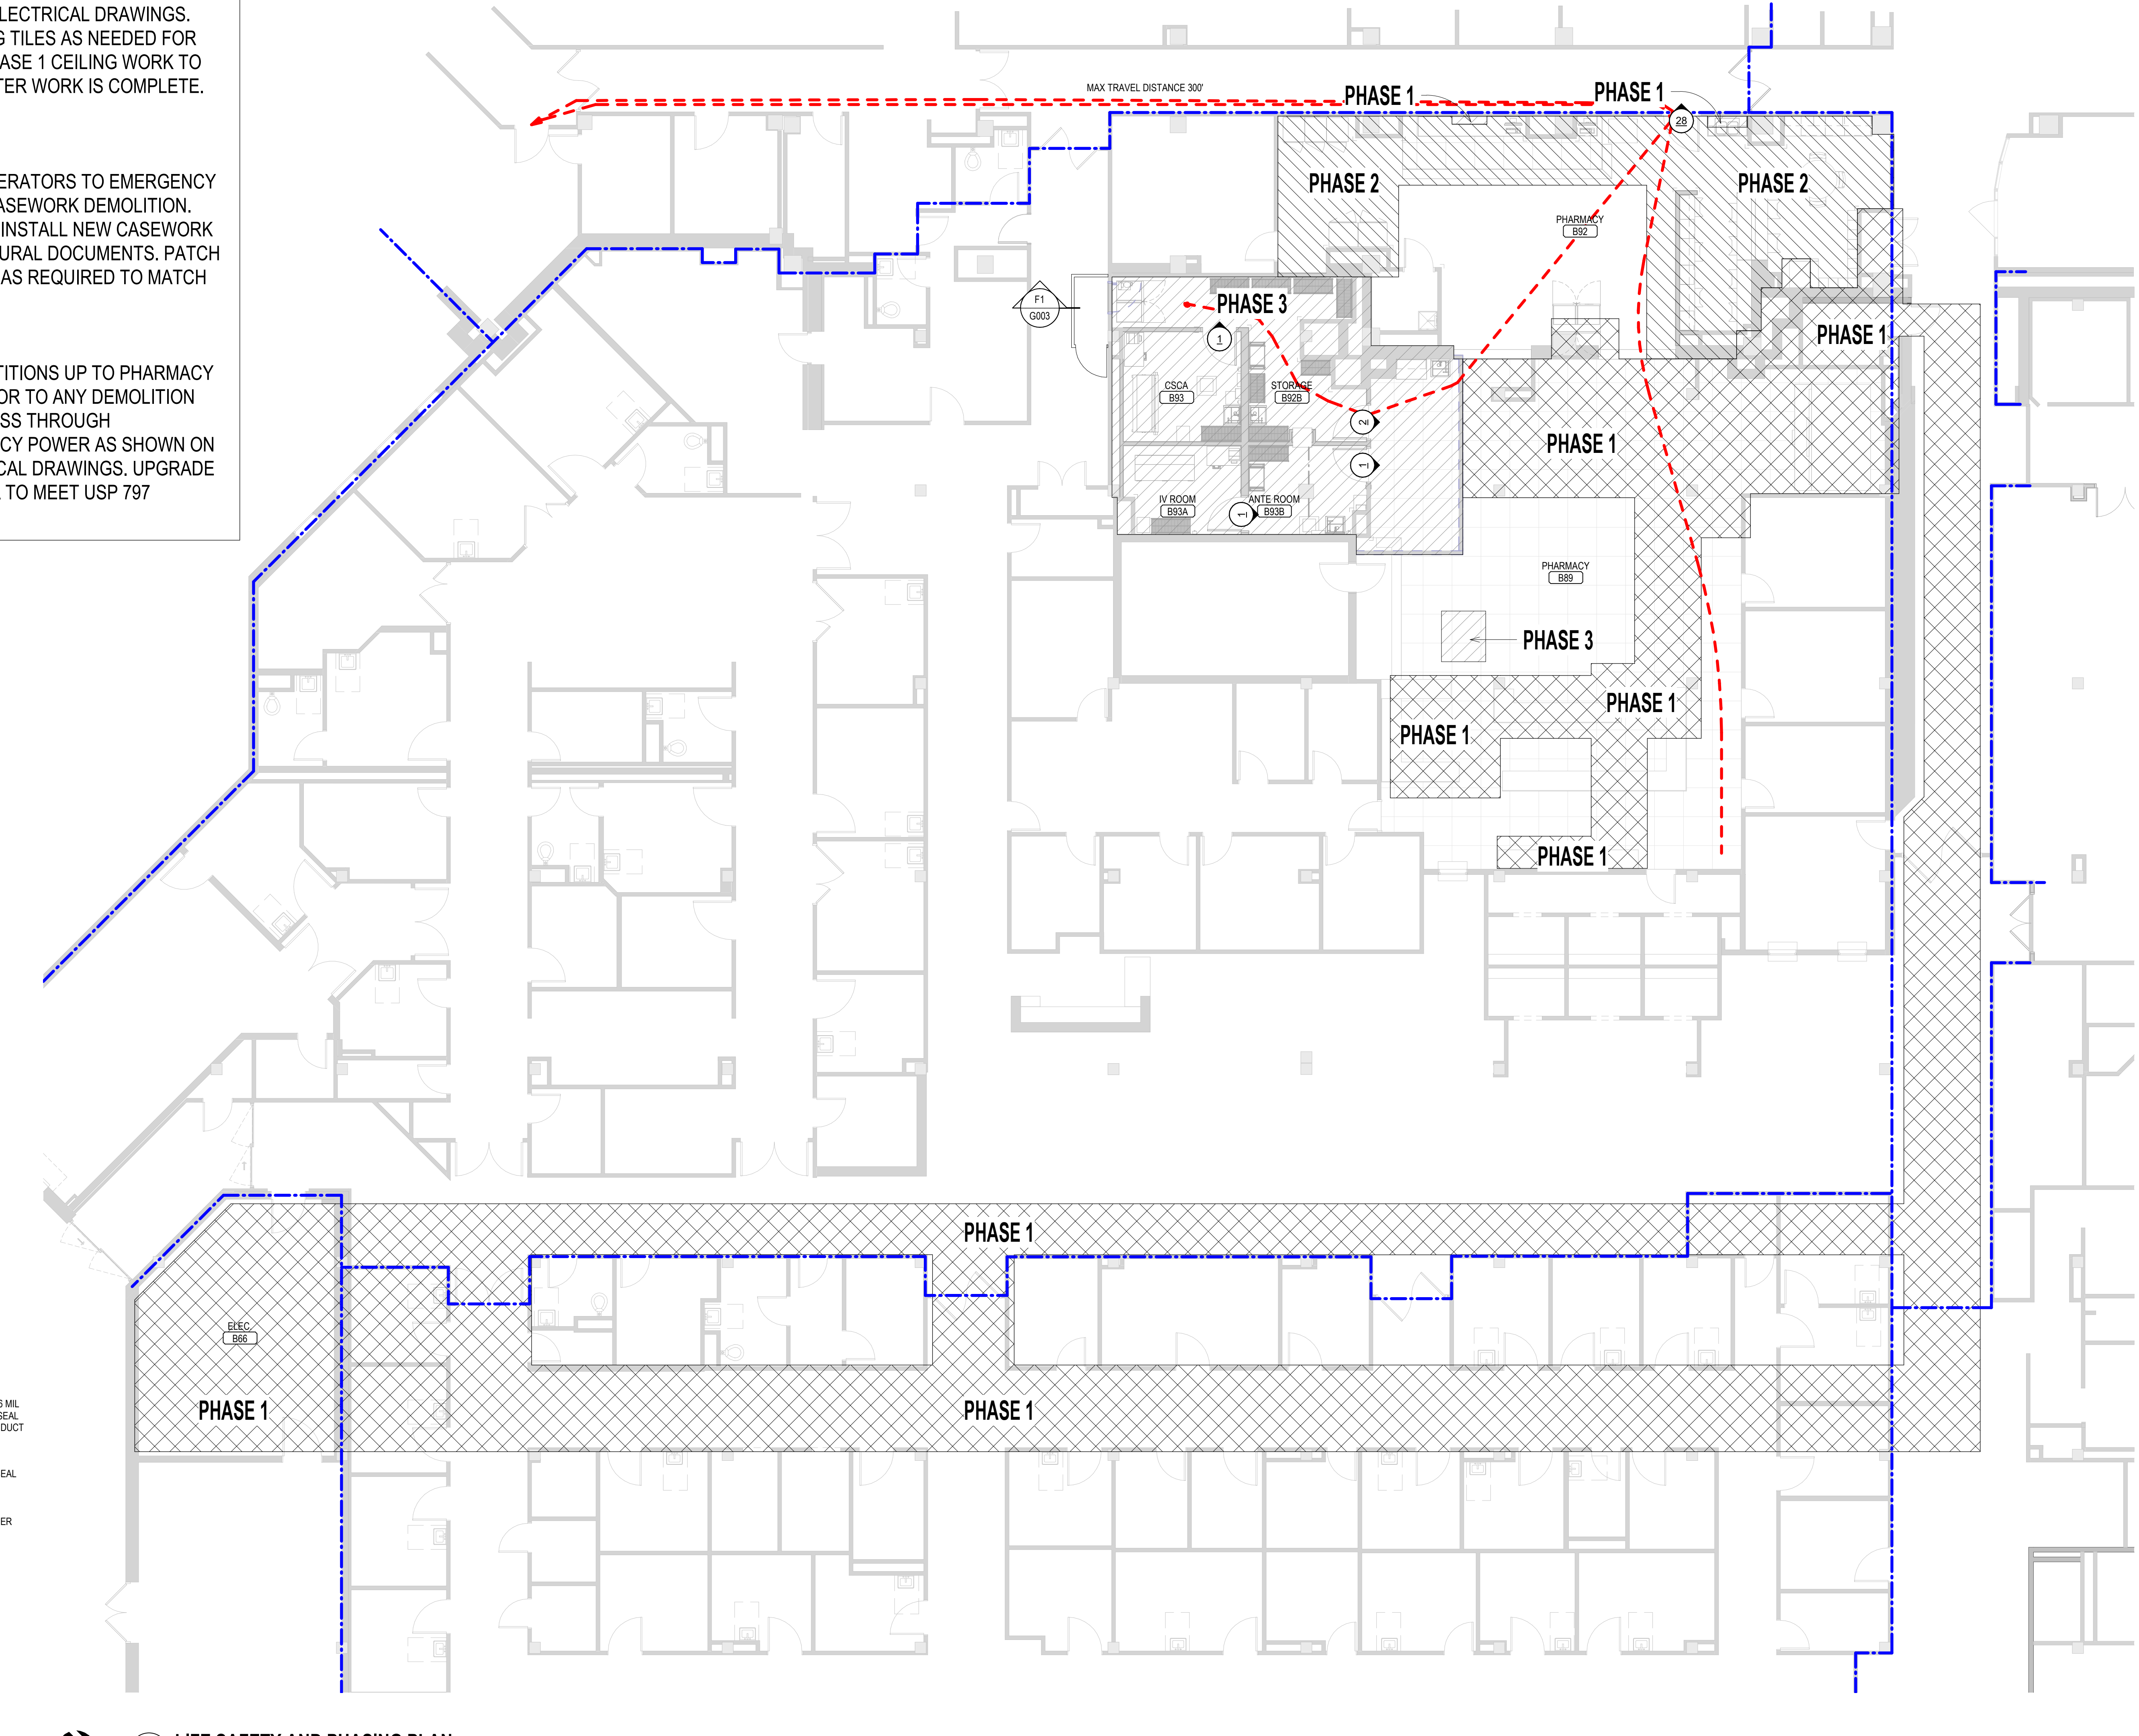

**F1 CONSTRUCTION BARRIER**  
1/2" = 1'-0"

**F2 LIFE SAFETY AND PHASING PLAN**  
1/8" = 1'-0"

**CONSULTANTS**

MECHANICAL / ELECTRICAL / PLUMBING:  
**DUNHAM**  
 50 South Sixth Street, Suite 1100  
 Minneapolis, MN 55402  
 Phone: 612-465-7550

STRUCTURAL:  
**ERA**  
 ERICKSEN ROED & ASSOCIATES  
 2550 University Avenue West, Suite 201-S  
 Saint Paul, MN 55114  
 Phone: 651-251-7570

**ARCHITECT OF RECORD**

A/E:  
**Stone Group Architects**  
 600 E 7th Street  
 Sioux Falls, SD 57103  
 605-271-1144

**STONE GROUP ARCHITECTS**

**STAMP**

**Office of Construction and Facilities Management**

U.S. Department of Veterans Affairs

*PRELIMINARY NOT FOR CONSTRUCTION*

Drawing Title  
**LIFE SAFETY CODE REVIEW AND PHASING PLAN**

Approved:

**VA** U.S. Department of Veterans Affairs

Phase  
**BID SET**

**FOR OFFICIAL USE ONLY**


Project Title  
**UPGRADE PHARMACY 797**

Location  
**SIOUX FALLS, SOUTH DAKOTA**

Project Number  
**VA #438-20-109  
 SGA #201927**

Building Number  
**5**




Drawing Number  
**G003**

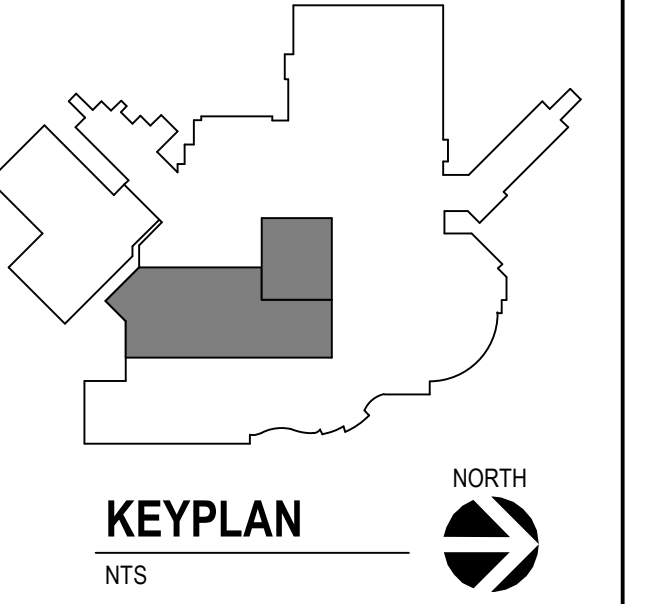

**GENERAL DEMOLITION PLAN NOTES:**

- A. PROTECT ALL EXISTING UTILITIES.
- B. CONTRACTOR TO VERIFY ALL EXISTING CONDITIONS AT THE PROJECT SITE.
- C. PATCH REMAINING EXISTING CONSTRUCTION, AFFECTED BY DEMOLITION, TO MATCH EXISTING U.O.N.
- D. EXISTING ITEMS TO REMAIN ARE SHOWN AS HALFTONE.
- E. DEMO ITEMS ARE SHOWN AS DASHED.
- F. INFILL OF THE PENETRATIONS IN FIRE RATED WALLS SHALL MAINTAIN THE INTEGRITY OF THE RATING.
- G. COORDINATE RELOCATION OF SALVAGED ITEMS WITH THE OWNER.
- H. SEE MECHANICAL AND ELECTRICAL DRAWINGS FOR ADDITIONAL INFORMATION RELEVANT TO DEMOLITION & PATCHING.
- I. EXISTING PHARMACY SHELVING NOT SHOWN IN PLAN. COORDINATE WITH OWNER TO REMOVE EXISTING SHELVING PRIOR TO WORK IN EACH PHASE.
- J. COORDINATE REMOVAL AND REINSTALLATION OF WALL MOUNTED ITEMS WITH OWNER.
- K. CONTRACTOR IS TO PROTECT THE EXISTING FLOORING IN ROOM B92 AND PATCH AND SEAL AS REQUIRED TO MATCH EXISTING.

SGA KEYNOTES	
Key Value	Keynote Text
2.07	EXISTING EXPANSION JOINT TO REMAIN.
2.13	EXISTING ANTIFATIGUE FLOORING TO REMAIN.
2.15	EXISTING CAROUSEL TO REMAIN.
2.31	REMOVE EXISTING CASEWORK.
2.33	EQUIPMENT TO BE RELOCATED TO OWNER.
2.33A	EQUIPMENT TO BE RELOCATED TO EMERGENCY POWER OUTLETS THROUGHOUT CONSTRUCTION.
2.37	REMOVE AND SALVAGE LOCKERS FOR REINSTALLATION.
2.41	PATCH AND SEAL UNDER SYSTEMS FURNITURE AS NEEDED TO MATCH EXISTING FLOORING.
2.90	TEMPORARY CONSTRUCTION BARRIER WALL FOR PHASE 3 CONSTRUCTION. TERMINATE AT DECK ABOVE. CONSTRUCTION PRIOR TO DEMOLITION.
11.52	TUG ROBOT LOCATION. REINSTALL AFTER PHASE 2 IS COMPLETE.

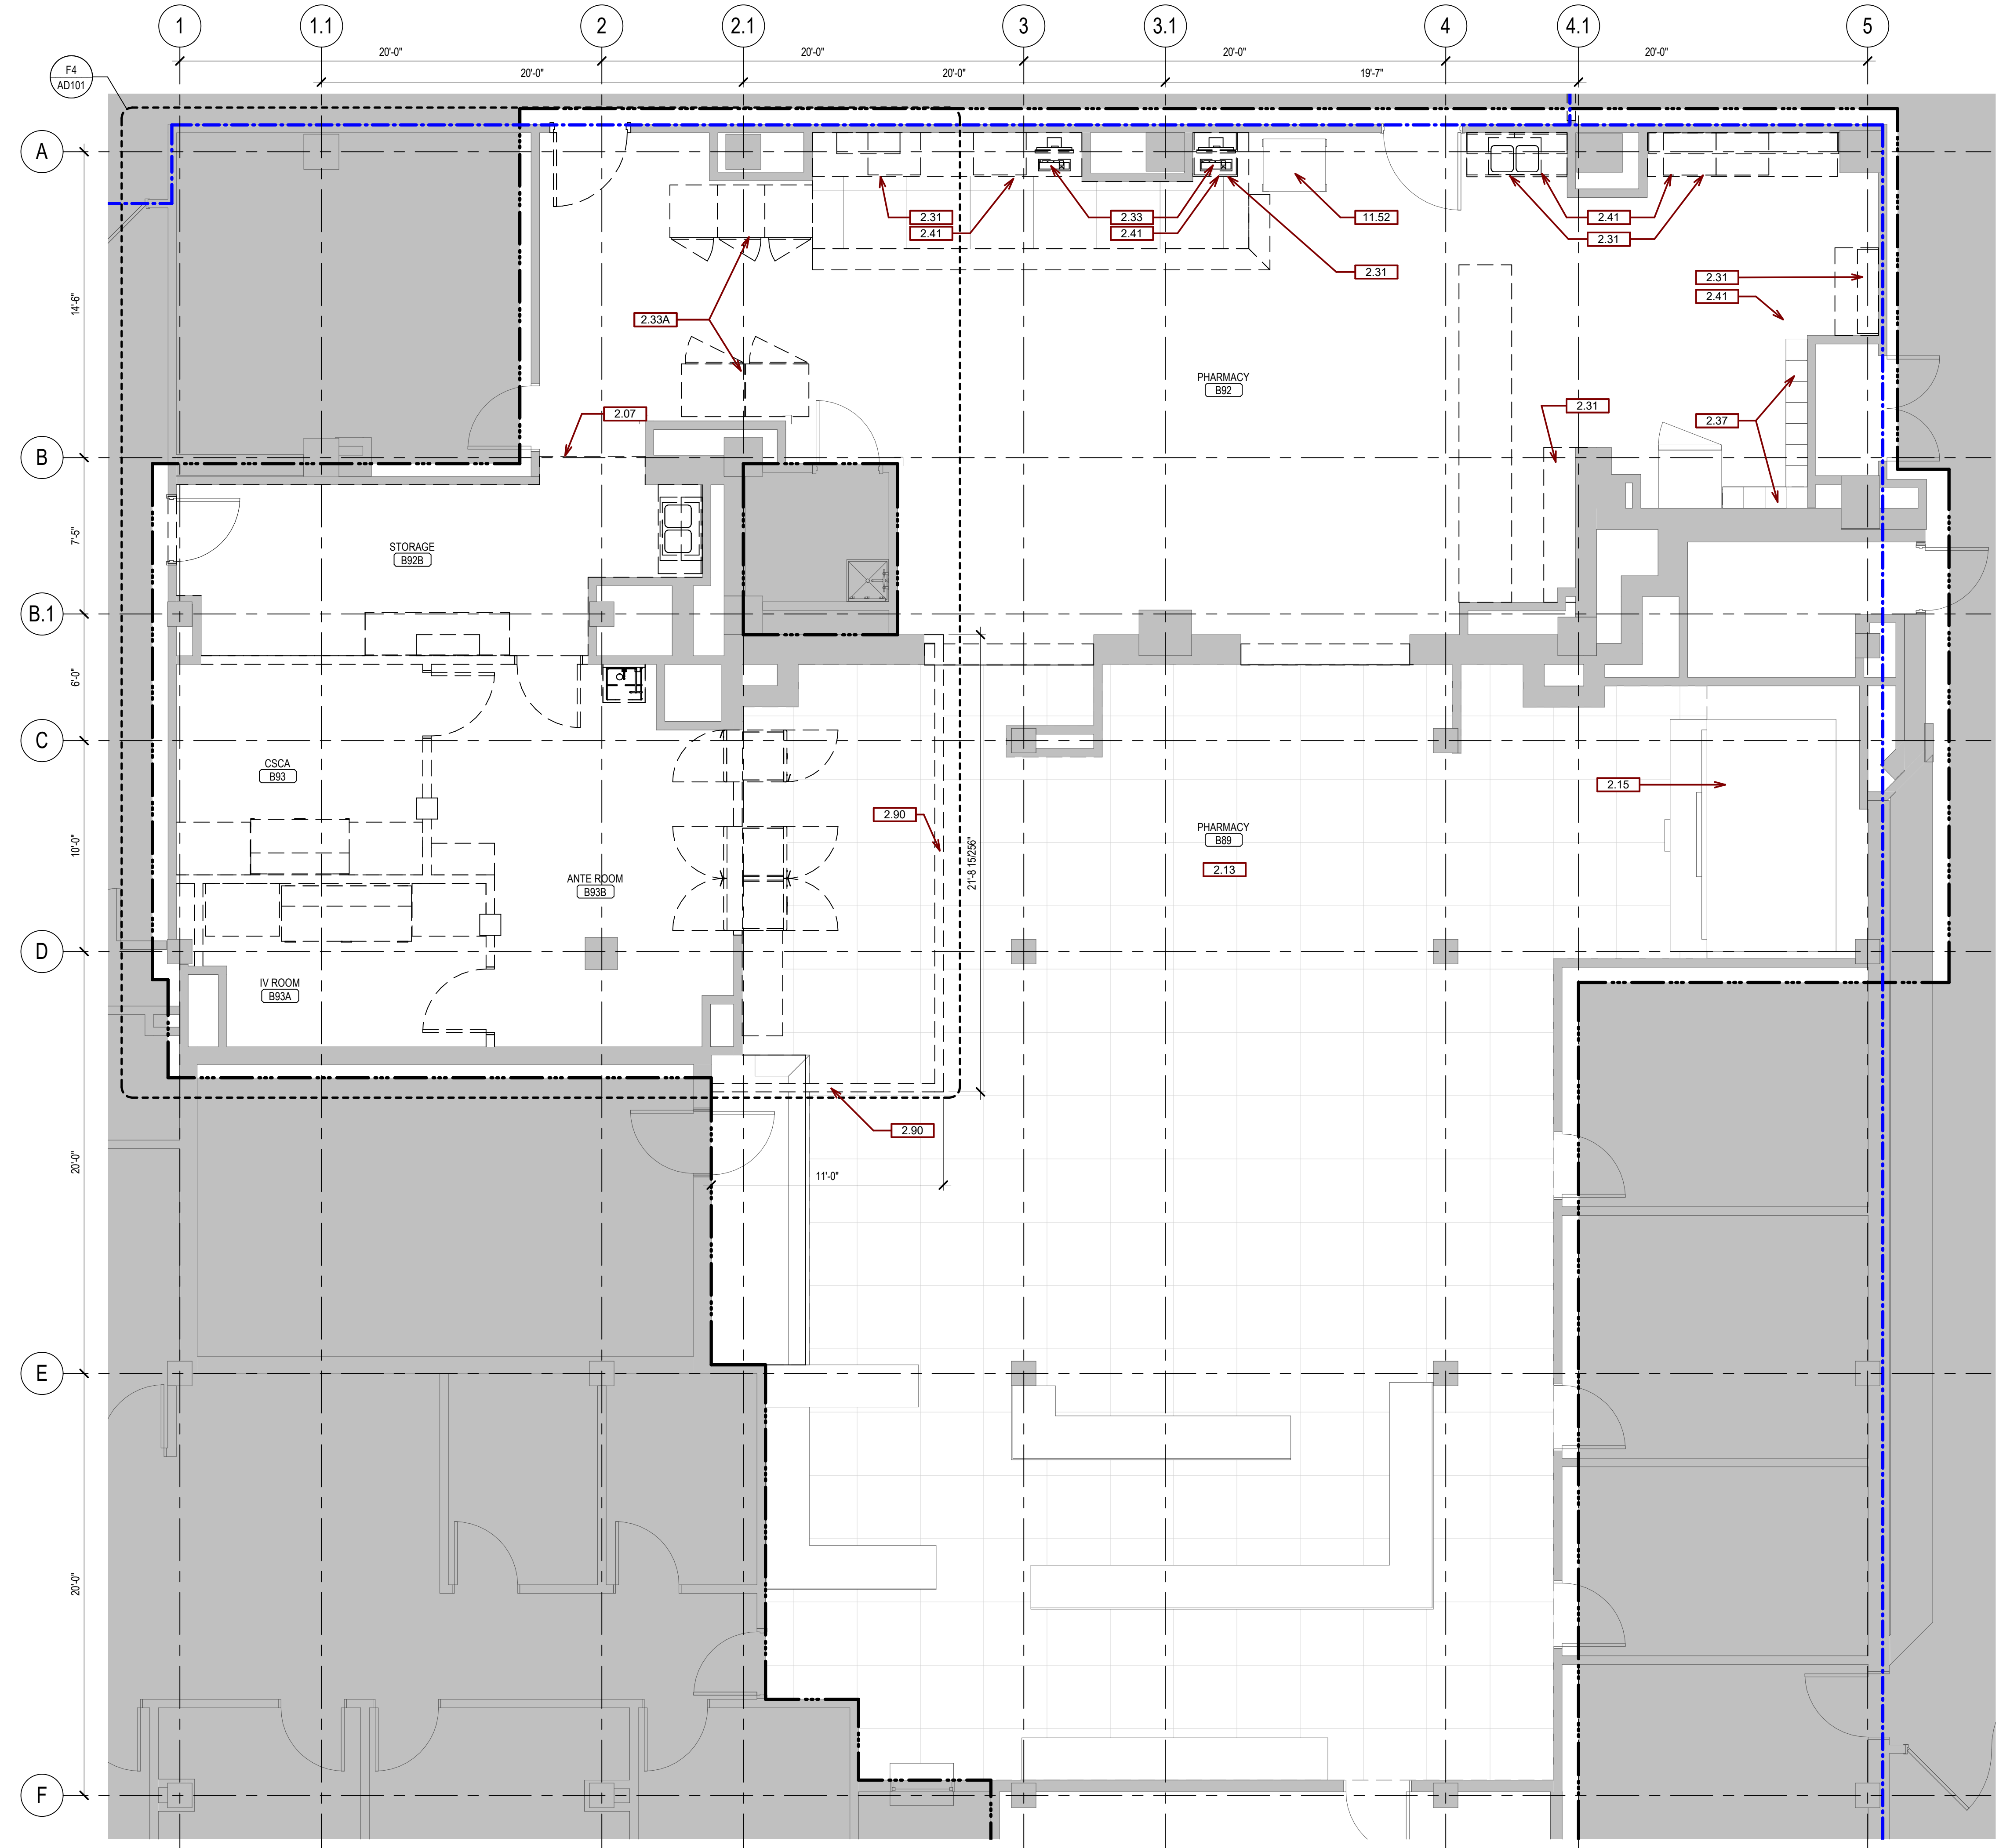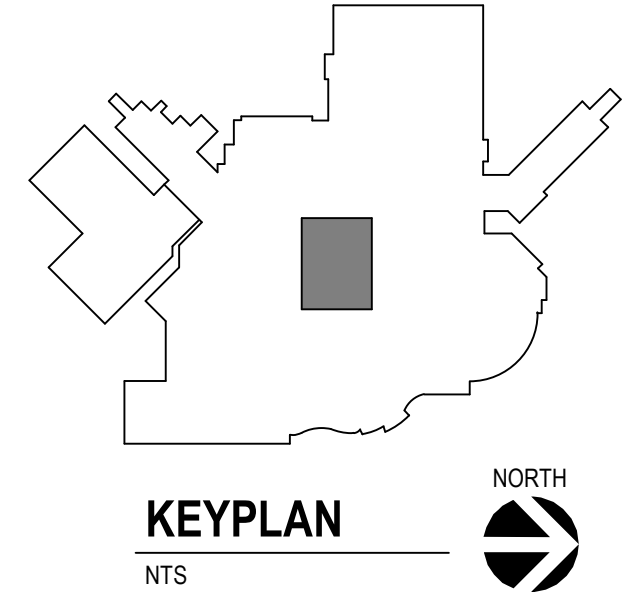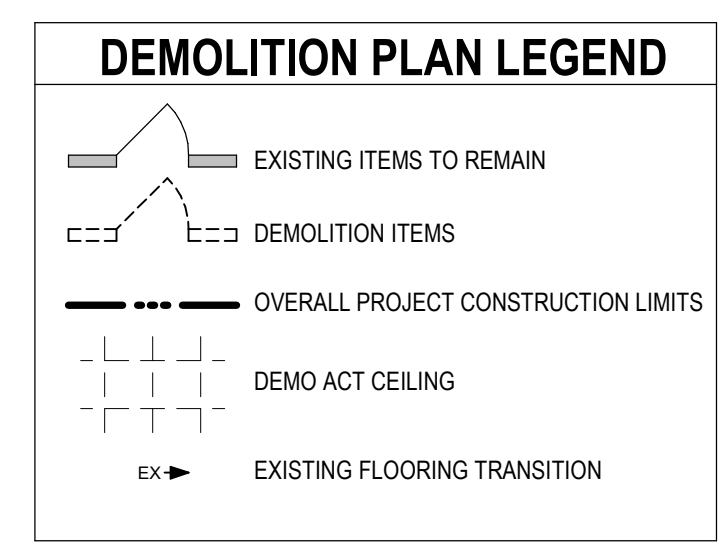

**F4 OVERALL DEMO PLAN**  
1/4" = 1'-0"

Revision#	Description	Date:

**CONSULTANTS**

MECHANICAL / ELECTRICAL / PLUMBING:  
**DUNHAM**  
32 South Sixth Street, Suite 1100  
Minneapolis, MN 55402  
Phone: 612-465-7550

STRUCTURAL:  
**ERA**  
ERICKSEN ROAD ASSOCIATES  
2501 University Avenue West, Suite 201-S  
Saint Paul, MN 55114  
Phone: 651-251-7570

**ARCHITECT OF RECORD**

A/E:  
**Stone Group Architects**  
600 E 7th Street  
Sioux Falls, SD 57103  
605-271-1144

**STONE GROUP ARCHITECTS**



Office of Construction and Facilities Management

**VA** U.S. Department of Veterans Affairs

Drawing Title  
**OVERALL DEMOLITION PLAN**

Approved:

Phase  
**BID SET**

Project Title  
**UPGRADE PHARMACY 797**

Project Number  
**VA #438-20-109 SGA #201927**

Building Number  
**5**

Location  
**SIoux FALLS, SOUTH DAKOTA**

Issue Date  
**02/10/2021**

Checked  
**TRS**




Drawn  
**DAN**

Drawing Number  
**AD100**

**GENERAL DEMOLITION PLAN NOTES:**

- A. PROTECT ALL EXISTING UTILITIES.
- B. CONTRACTOR TO VERIFY ALL EXISTING CONDITIONS AT THE PROJECT SITE.
- C. PATCH REMAINING EXISTING CONSTRUCTION, AFFECTED BY DEMOLITION, TO MATCH EXISTING U.O.N.
- D. EXISTING ITEMS TO REMAIN ARE SHOWN AS HALFTONE.
- E. DEMO ITEMS ARE SHOWN AS DASHED.
- F. INFILL OF THE PENETRATIONS IN FIRE RATED WALLS SHALL MAINTAIN THE INTEGRITY OF THE RATING.
- G. COORDINATE RELOCATION OF SALVAGED ITEMS WITH THE OWNER.
- H. SEE MECHANICAL AND ELECTRICAL DRAWINGS FOR ADDITIONAL INFORMATION RELEVANT TO DEMOLITION & PATCHING.
- I. EXISTING PHARMACY SHELVING NOT SHOWN IN PLAN. COORDINATE WITH OWNER TO REMOVE EXISTING SHELVING PRIOR TO WORK IN EACH PHASE.
- J. COORDINATE REMOVAL AND REINSTALLATION OF WALL MOUNTED ITEMS WITH OWNER.
- K. CONTRACTOR IS TO PROTECT THE EXISTING FLOORING IN ROOM B92 AND PATCH AND SEAL AS REQUIRED TO MATCH EXISTING.

SGA KEYNOTES	
Key Value	Keynote Text
2.03	REMOVE DOOR & FRAME.
2.03A	REMOVE DOOR & FRAME, INFILL TO MATCH EXISTING WALL AND FLOORING.
2.05	REMOVE WALL.
2.09	REMOVE CASEWORK.
2.10	REMOVE HOOD.
2.11	REMOVE PORTION OF WALL.
2.16	REMOVE EXISTING DRAIN FROM ABANDONED SINK. SEE PLUMBING.
2.17	REMOVE SINK.
2.33A	EQUIPMENT TO BE RELOCATED TO EMERGENCY POWER OUTLETS THROUGHOUT CONSTRUCTION.
2.36	REMOVE AND SALVAGE PASS THROUGH REFRIGERATORS FOR USE DURING CONSTRUCTION. CONNECT TO EMERGENCY POWER AS SHOWN ON PLANS.
2.39	REMOVE STAINLESS STEEL DESK.
2.40	REMOVE PASSTHROUGH.
2.43	TEMPORARY CONSTRUCTION ACCESS DOOR.
2.48	SAWCUT SLAB AND REPAIR AS REQUIRED FOR INSTALLATION OF WASTE PIPE. SEE PLUMBING.
2.49	DEMO PORTION OF GYPSUM WALL BOARD AND REPAIR AS REQUIRED FOR CHAIR CARRIER AND PLUMBING ROUGH-IN CONNECTION.
2.50	DEMO PORTION OF GYPSUM WALL BOARD AND REPAIR FOR REMOVAL OF CHAIR CARRIER AND PLUMBING ROUGH-IN CONNECTION.
2.90	TEMPORARY CONSTRUCTION BARRIER WALL FOR PHASE 1 CONSTRUCTION. TERMINATE AT DECK ABOVE. CONSTRUCT PRIOR TO DEMOLITION.
2.92	REMOVE AND REINSTALL EXISTING RUBBER FLOOR AS NEEDED TO AVOID GAP AROUND REFRIGERATORS.

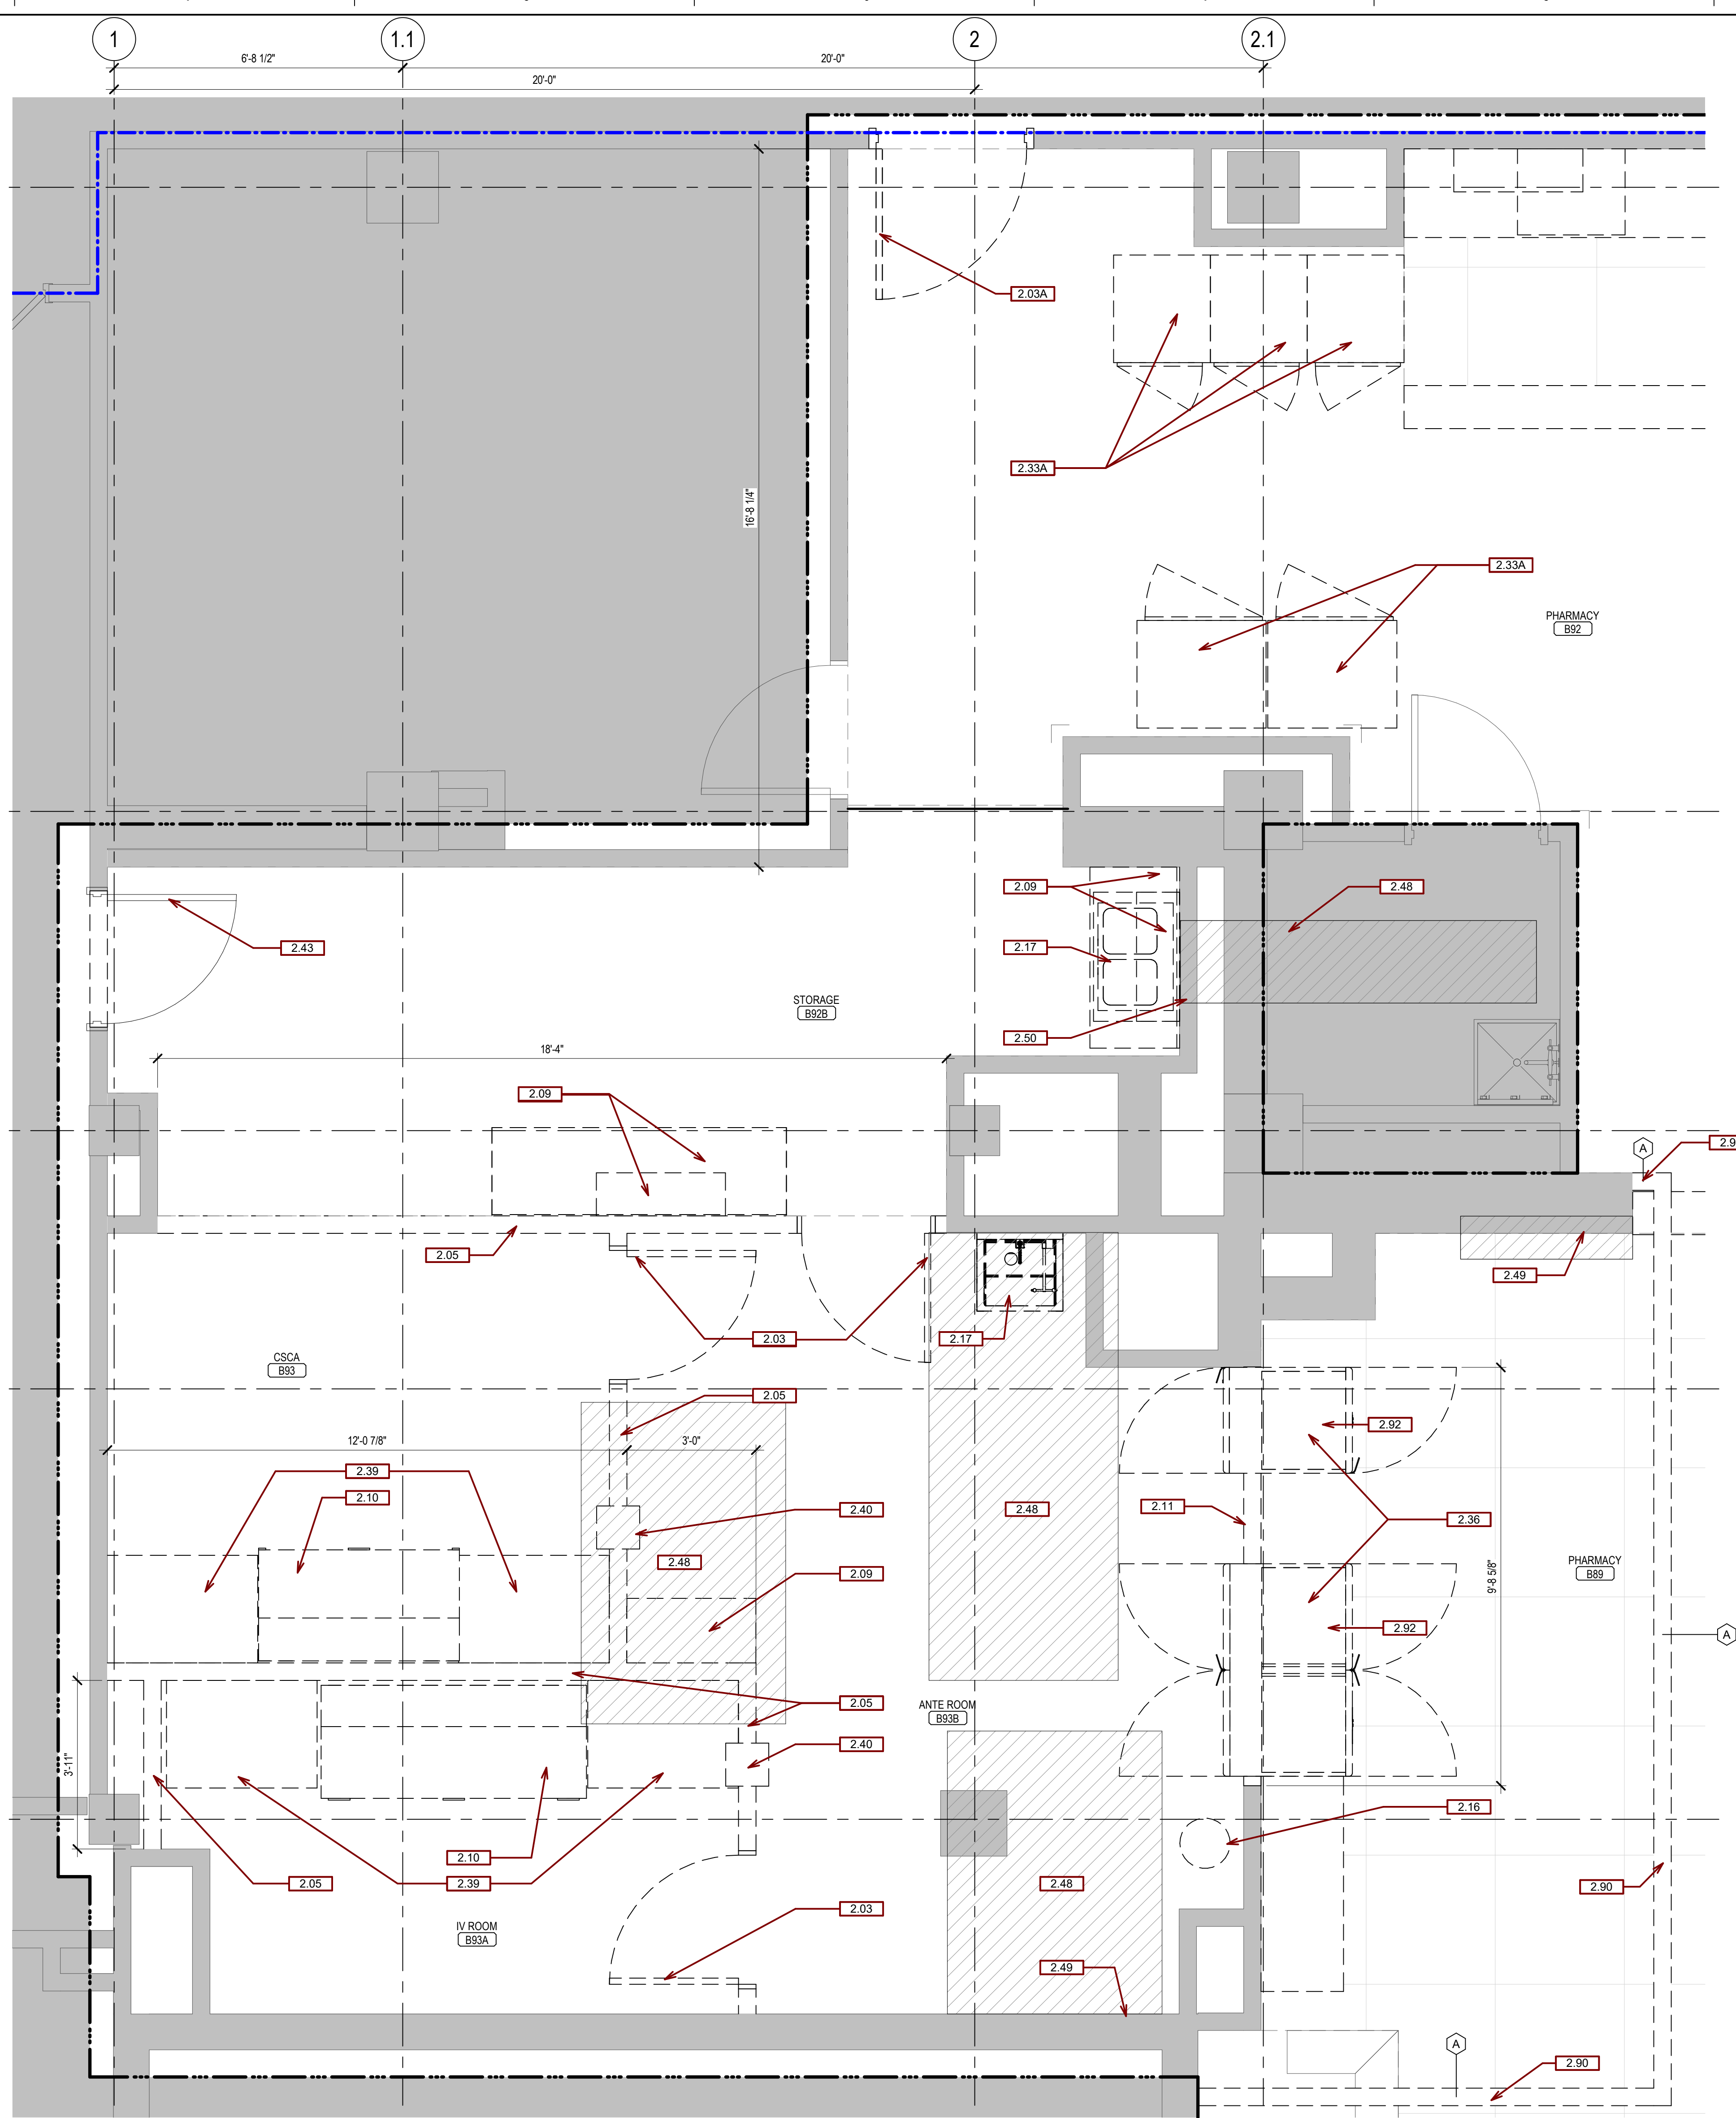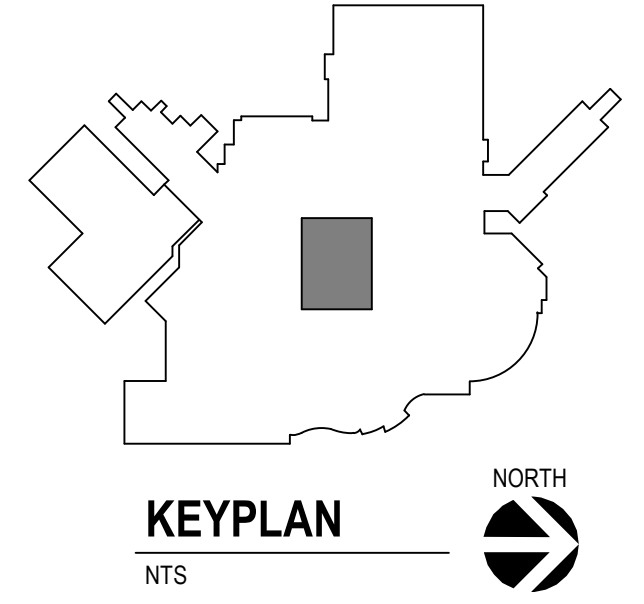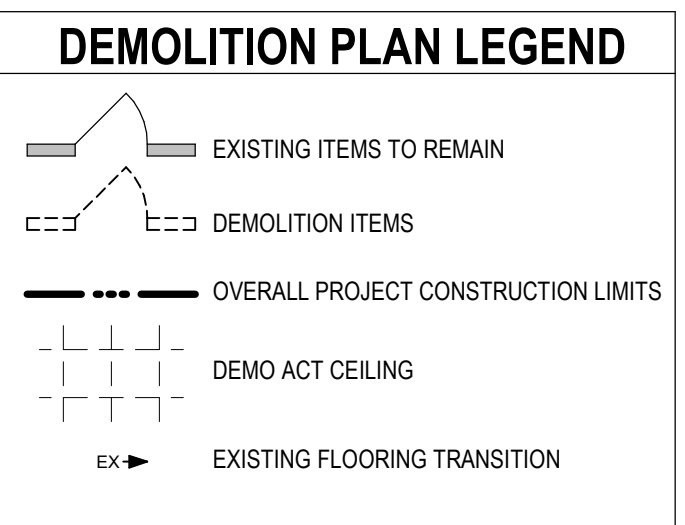

**F4 DEMOLITION PLAN**  
1/2" = 1'-0"

Revision#	Description	Date:

**CONSULTANTS**

MECHANICAL / ELECTRICAL / PLUMBING:  
**DUNHAM**  
32 South Sixth Street, Suite 1100  
Minneapolis, MN 55402  
Phone: 612-465-7550

STRUCTURAL:  
**ERA**  
ERICKSEN ROAD  
A ASSOCIATES  
Ericksen Road & Associates  
2501 University Avenue West, Suite 201-S  
Saint Paul, MN 55114  
Phone: 651-251-7570

**ARCHITECT OF RECORD**

A/E:  
**Stone Group Architects**  
600 E 7th Street  
Sioux Falls, SD 57103  
605-271-1144

**STONE GROUP ARCHITECTS**

**STAMP**

Office of Construction and Facilities Management  
**VA** U.S. Department of Veterans Affairs

Drawing Title  
**ENLARGED DEMOLITION PLAN**

Approved: \_\_\_\_\_

Phase  
**BID SET**

Project Title  
**UPGRADE PHARMACY 797**

Location  
**SIoux FALLS, SOUTH DAKOTA**

Issue Date  
02/10/2021

Checked  
TRS

Drawn  
DAN

Project Number  
VA #438-20-109  
SGA #201927

Building Number  
5


Drawing Number  
**AD101**

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 one-quarter inch = one foot  
 one-half inch = one foot  
 three-eighths inch = one foot  
 one inch = one foot  
 one and one-half inches = one foot  
 two inches = one foot  
 three inches = one foot  
 four inches = one foot  
 six inches = one foot  
 eight inches = one foot  
 one foot = one foot


**GENERAL DEMOLITION PLAN NOTES:**

- A. PROTECT ALL EXISTING UTILITIES.
- B. CONTRACTOR TO VERIFY ALL EXISTING CONDITIONS AT THE PROJECT SITE.
- C. PATCH REMAINING EXISTING CONSTRUCTION, AFFECTED BY DEMOLITION, TO MATCH EXISTING U.O.N.
- D. EXISTING ITEMS TO REMAIN ARE SHOWN AS HALFTONE.
- E. DEMO ITEMS ARE SHOWN AS DASHED.
- F. INFILL OF THE PENETRATIONS IN FIRE RATED WALLS SHALL MAINTAIN THE INTEGRITY OF THE RATING.
- G. COORDINATE RELOCATION OF SALVAGED ITEMS WITH THE OWNER.
- H. SEE MECHANICAL AND ELECTRICAL DRAWINGS FOR ADDITIONAL INFORMATION RELEVANT TO DEMOLITION & PATCHING.
- I. EXISTING PHARMACY SHELVING NOT SHOWN IN PLAN. COORDINATE WITH OWNER TO REMOVE EXISTING SHELVING PRIOR TO WORK IN EACH PHASE.
- J. COORDINATE REMOVAL AND REINSTALLATION OF WALL MOUNTED ITEMS WITH OWNER.
- K. CONTRACTOR IS TO PROTECT THE EXISTING FLOORING IN ROOM B92 AND PATCH AND SEAL AS REQUIRED TO MATCH EXISTING.

SGA KEYNOTES	
Key Value	Keynote Text
2.06	REMOVE CEILING
2.44	EXISTING CEILING TO REMAIN.
2.46	DEMO AND REPLACE CEILING AS NEEDED FOR MECHANICAL AND ELECTRICAL UPDATES. SEE MECHANICAL AND ELECTRICAL.
2.90	TEMPORARY CONSTRUCTION BARRIER WALL FOR PHASE 3 CONSTRUCTION. TERMINATE AT DECK ABOVE. CONSTRUCT PRIOR TO DEMOLITION.

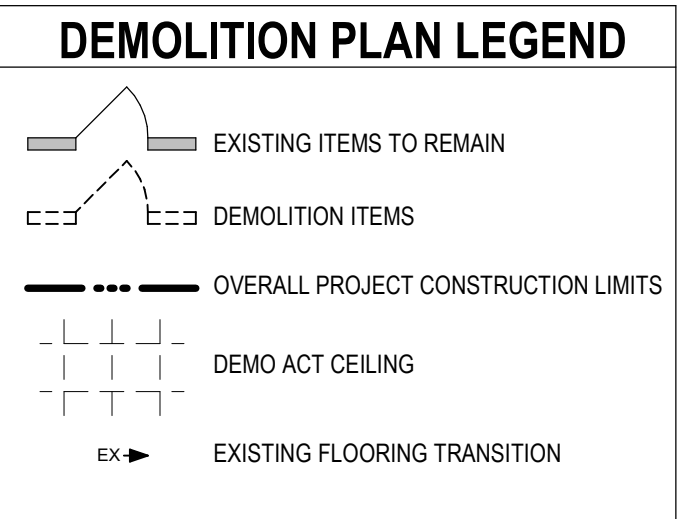

**F4 DEMOLITION RCP**  
1/4" = 1'-0"

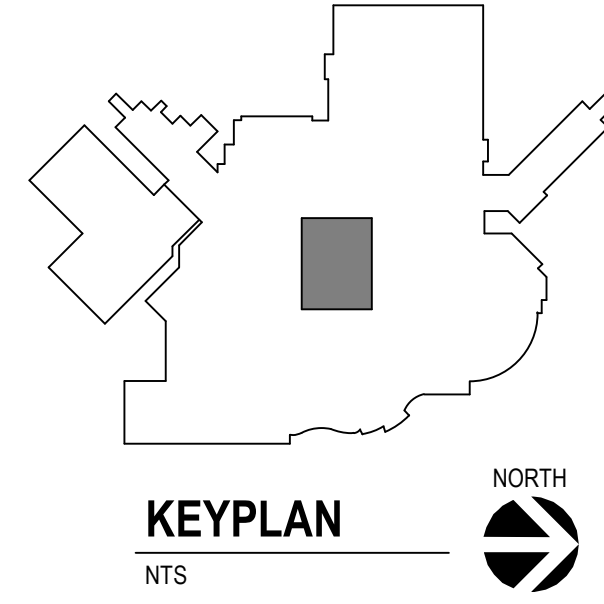

Revision#	Description	Date:


**CONSULTANTS**

MECHANICAL / ELECTRICAL / PLUMBING:  
**DUNHAM**  
32 South Sixth Street, Suite 1100  
Minneapolis, MN 55402  
Phone: 612-465-7550

STRUCTURAL:  
**ERA**  
ERICKSEN ROAD  
A ASSOCIATES  
Ericksen Road & Associates  
250 University Avenue West, Suite 201-S  
Saint Paul, MN 55114  
Phone: 651-251-7570

**ARCHITECT OF RECORD**

A/E:  
**Stone Group Architects**  
600 E 7th Street  
Sioux Falls, SD 57103  
605-271-1144

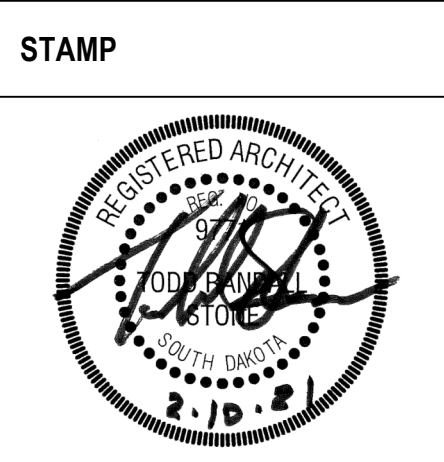

Office of Construction and Facilities Management  
**VA** U.S. Department of Veterans Affairs

Drawing Title  
**DEMOLITION RCP**

Approved: \_\_\_\_\_

Phase  
**BID SET**

Project Title  
**UPGRADE PHARMACY 797**

Project Number  
**VA #438-20-109**  
**SGA #201927**

Building Number  
**5**

Location  
**SIOUX FALLS, SOUTH DAKOTA**

Issue Date  
**02/10/2021**

Checked  
**TRS**

Drawn  
**DAN**

Drawing Number  
**AD102**


**GENERAL FLOOR PLAN NOTES:**

- A. ANY DISCREPANCIES OR CONFLICTS FOUND IN THE VARIOUS PARTS OF THE CONSTRUCTION DOCUMENTS SHALL BE BROUGHT TO THE ATTENTION OF THE ARCHITECT AND THE OWNER BEFORE PROCEEDING WITH THE WORK.
- B. FURNITURE IS PROVIDED AND INSTALLED BY OTHERS.
- C. WRITTEN DIMENSIONS TAKE PRECEDENCE OVER SCALED DIMENSIONS. DO NOT SCALE THE DRAWINGS.
- D. CONTRACTOR & SUBCONTRACTORS TO VERIFY ALL EXISTING CONDITIONS AT THE PROJECT SITE.
- E. ALL MATERIALS & EQUIPMENT SHALL BE INSTALLED PER MANUFACTURER'S INSTRUCTIONS. DETAILS SHOWN ARE TYPICAL UNLESS OTHERWISE NOTED. SIMILAR DETAILS APPLY IN SIMILAR CONDITIONS.
- F. PROVIDE WOOD BACKING FOR ALL BATH ACCESSORIES, HANDRAILS, OR OTHER ITEMS ATTACHED TO BUILDING WALLS.
- G. PROVIDE ADA COMPLIANT SIGNAGE FOR ALL REQUIRED AREAS, ROOMS, & ACCESSIBLE PATHS.
- H. HEIGHT OF OPERATIONAL OR DISPENSING PORTION OF ACCESSORIES & FIXTURES NOT TO EXCEED 48" A.F.F. SEE SHEET G-002.
- I. WINDOWS TYPES, SEE SCHED.
- J. ALL WALLS ARE WALL TYPE A U/O.N.
- K. SEE ENLARGED FLOOR PLANS FOR UNIT WALL TYPES.
- L. PROVIDE CONTROL JOINTS IN DRYWALL EVERY 30'-0".
- M. ALL DIMENSIONS ARE TO OUTSIDE OF WALL FRAMING.
- N. FOR TILE FLOOR INSTALLATION: CONTRACTOR TO USE SCHLUTER PRODUCTS AS BASIS OF DESIGN FOR WATERPROOFING & KERDI & DITRA PRODUCTS AS APPLICABLE TO MANUFACTURER RECOMMENDATIONS.
- P. SEE MECHANICAL, ELECTRICAL AND PLUMBING DRAWINGS FOR ADDITIONAL INFORMATION.
- Q. FLOORING TRANSITIONS TO BE PROVIDED BY CONTRACTOR.
- R. CONTRACTOR IS TO PROTECT THE EXISTING FLOORING IN ROOM B92 AND PATCH AND SEAL AS REQUIRED TO MATCH EXISTING.


SGA KEYNOTES	
Key Value	Keynote Text
2.13	EXISTING ANTIFATIGUE FLOORING TO REMAIN.
2.91	TEMPORARY LOCATION OF RELOCATED PASS THROUGH REFRIGERATOR DURING CONSTRUCTION. CONNECT TO EMERGENCY POWER.
2.93	PROVIDE QUIET PROTECTION DURING PHASE 2 UNTIL WALL IS AIR TIGHT.
9.61	PATCH AND SEAL FLOORING UNDER SYSTEMS FURNITURE TO MATCH EXISTING FLOORING AS NEEDED.
9.63	PATCH AND SEAL FLOORING AT DOOR TO MATCH EXISTING.
11.01	PHARMACY REFRIGERATOR. CONNECT TO EMERGENCY POWER AFTER COMPLETION OF PHASE 1.
11.52	TUG ROBOT LOCATION. REINSTALL AFTER PHASE 2 IS COMPLETE.
12.32	REINSTALL SALVAGED LOCKERS.
26.02	SECURITY CAMERA - SEE ELECTRICAL.

WALL TYPES		INDICATED THUS ON FLOOR PLANS
A	NON-RATED: 5/8" G.W.B., 3/8" MTL STUD, 5/8" G.W.B.	◆
AA	NON-RATED: 5/8" G.W.B., 3/8" MTL STUD	
B	NON-RATED: 5/8" G.W.B., 8" MTL STUD, 5/8" G.W.B.	
F	NON-RATED: 5/8" G.W.B., 2 1/2" MTL STUD	

NOTE: SEE SHEET A-901 FOR MORE DESCRIPTION OF WALL TYPE.

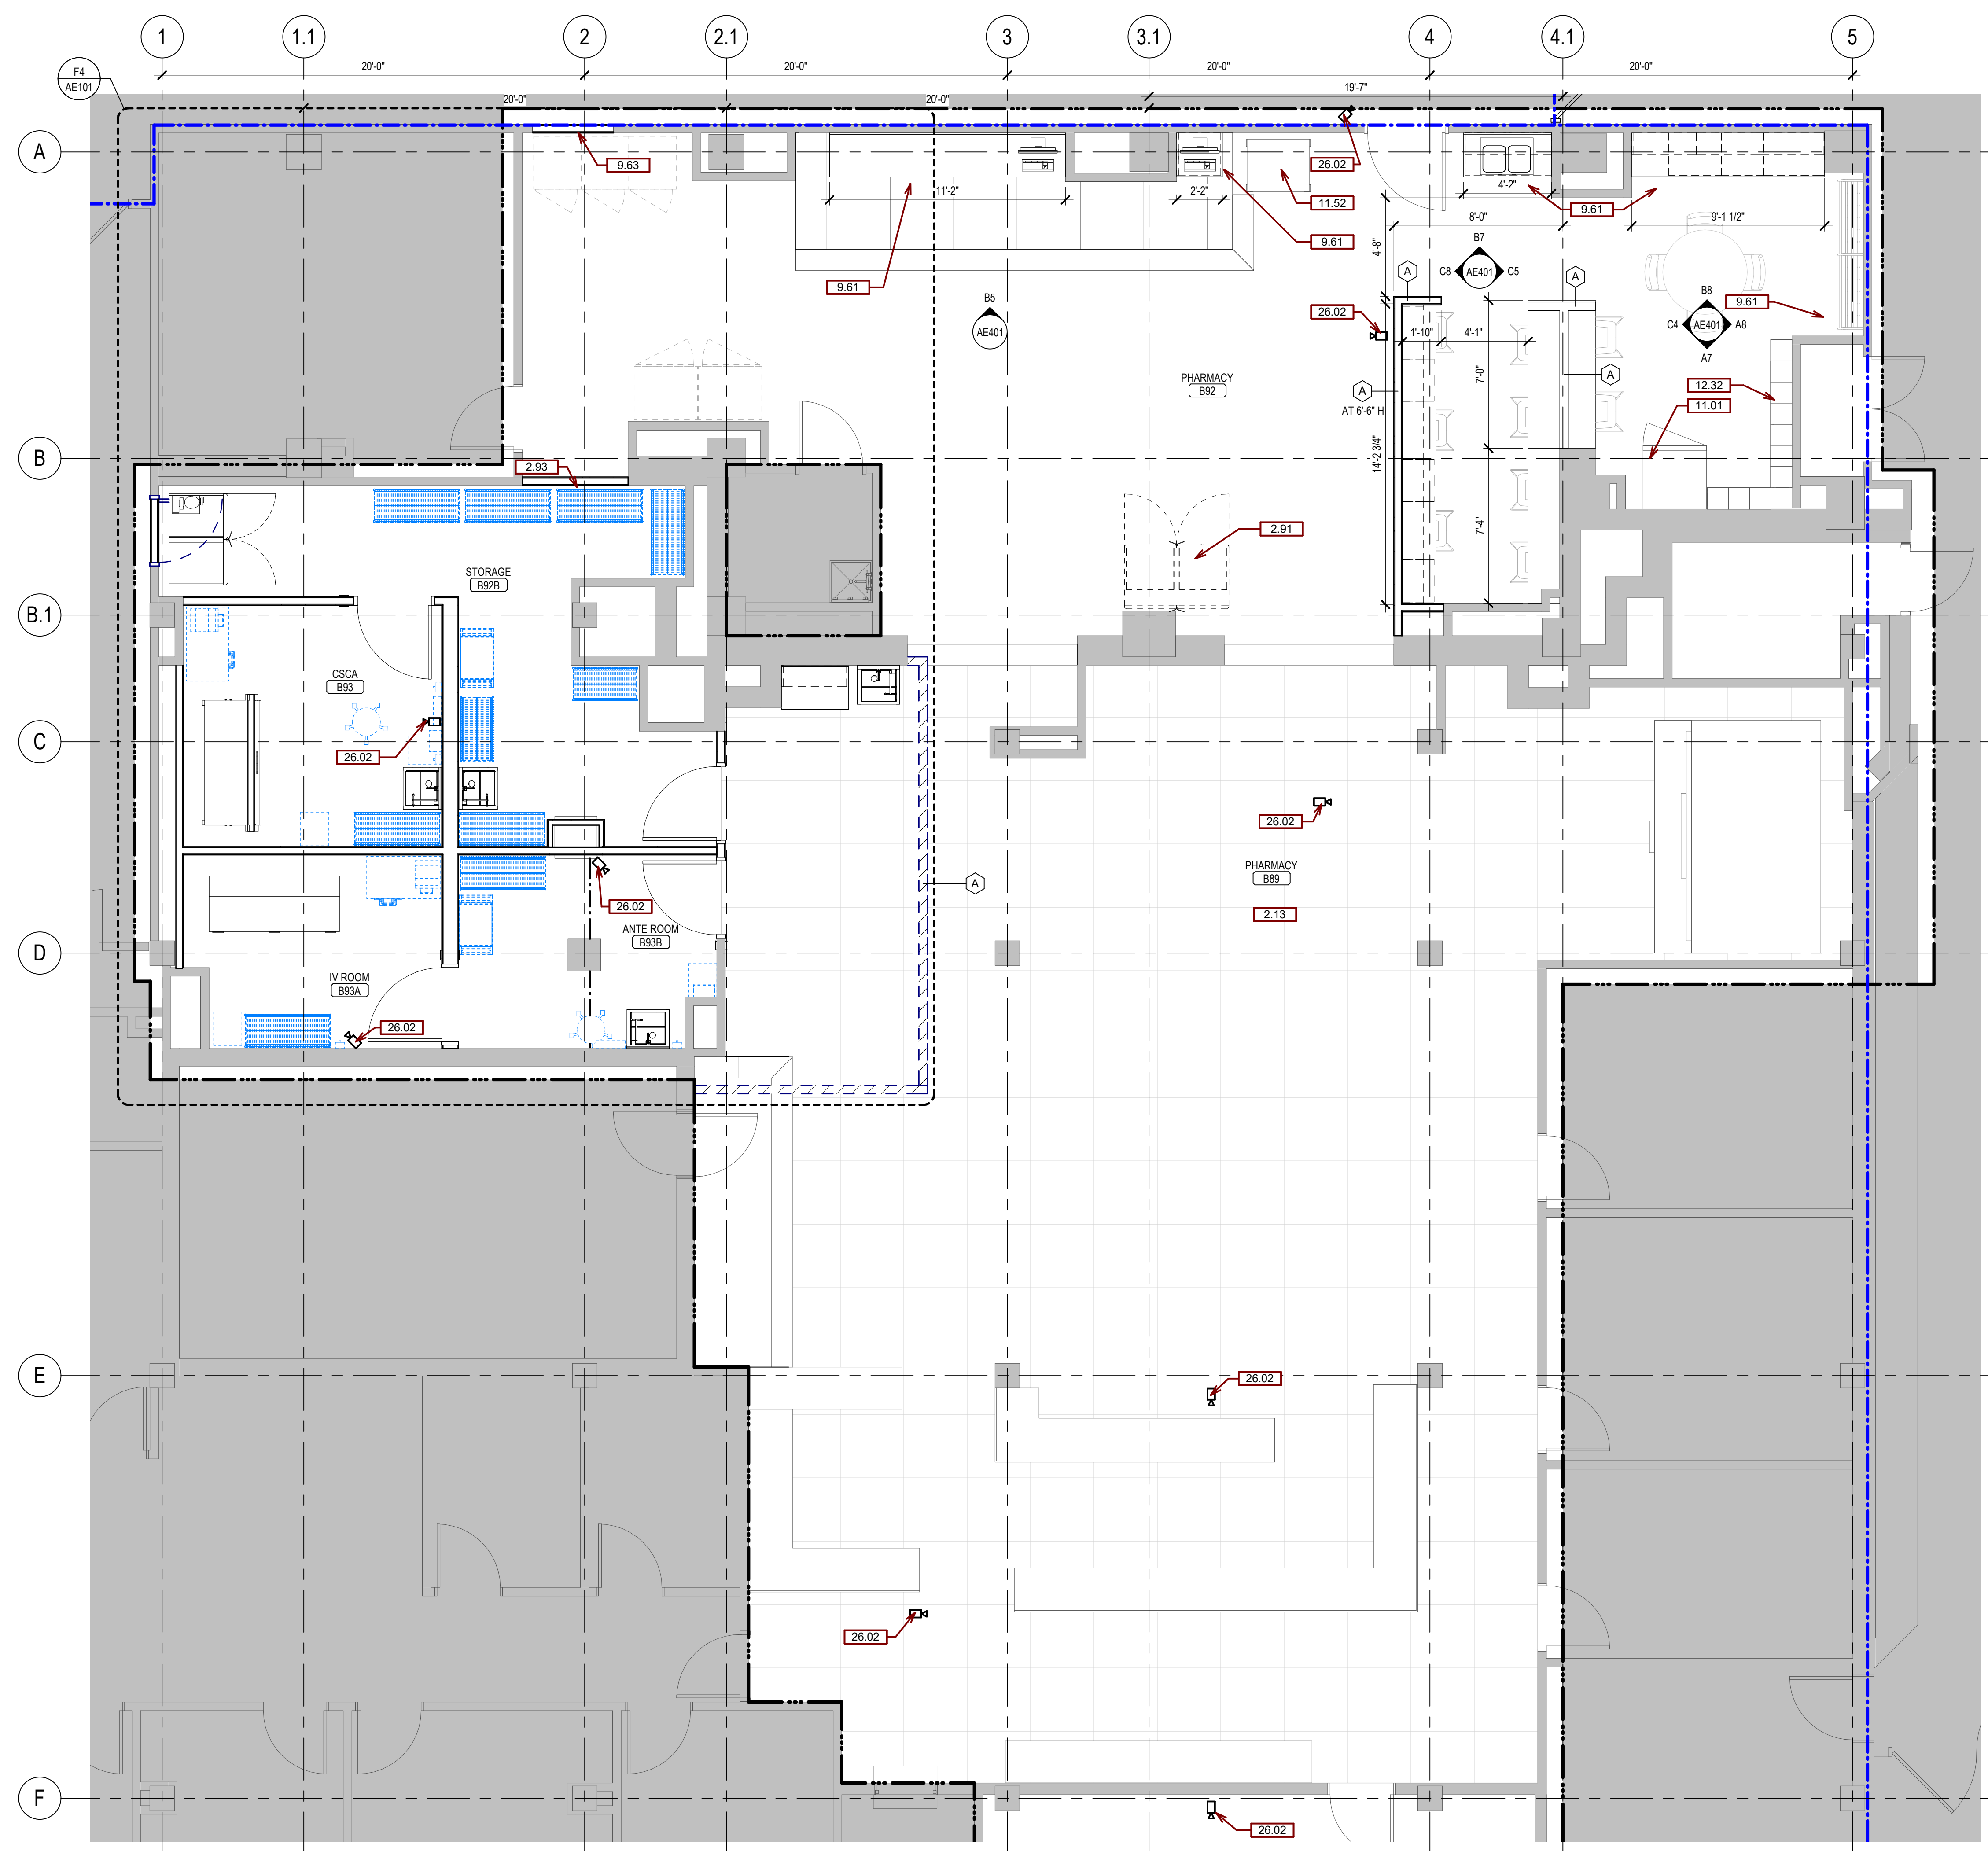

**F4 GROUND FLOOR PLAN**  
1/4" = 1'-0"

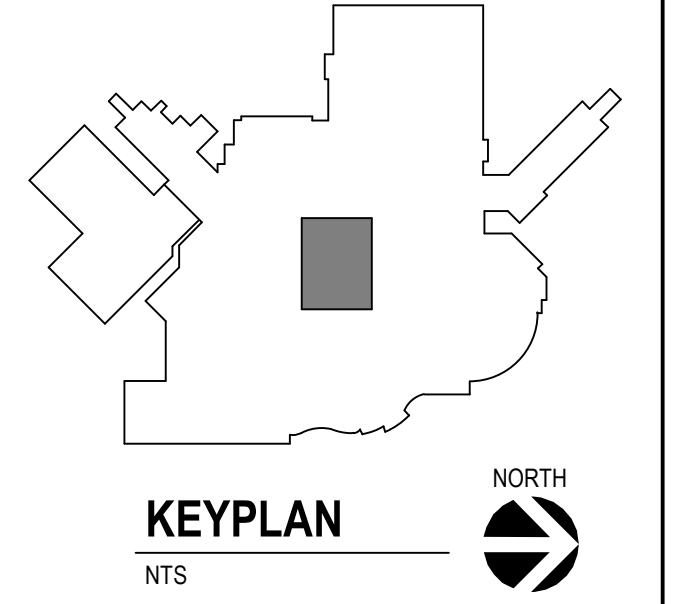

Revision#	Description	Date:

**CONSULTANTS**

MECHANICAL / ELECTRICAL / PLUMBING:  
**DUNHAM**  
32 South Sixth Street, Suite 1100  
Minneapolis, MN 55402  
Phone: 612-465-7550

STRUCTURAL:  
**ERA**  
ERICKSEN ROAD  
A ASSOCIATES  
Ericksen Road & Associates  
2501 University Avenue West, Suite 201-S  
Saint Paul, MN 55114  
Phone: 651-251-7570

**ARCHITECT OF RECORD**

A/E:  
**Stone Group Architects**  
600 E 7th Street  
Sioux Falls, SD 57103  
605-271-1144

**STONE GROUP ARCHITECTS**

**STAMP**

Office of Construction and Facilities Management  
**VA** U.S. Department of Veterans Affairs

Drawing Title  
**GROUND FLOOR PLAN**

Phase  
**BID SET**

Approved:

Project Title  
**UPGRADE PHARMACY 797**

Location  
**SIoux FALLS, SOUTH DAKOTA**

Issue Date  
02/10/2021

Checked  
TRS

Drawn  
DAN

Project Number  
VA #438-20-109  
SGA #201927

Building Number  
5

Drawing Number  
**AE100**

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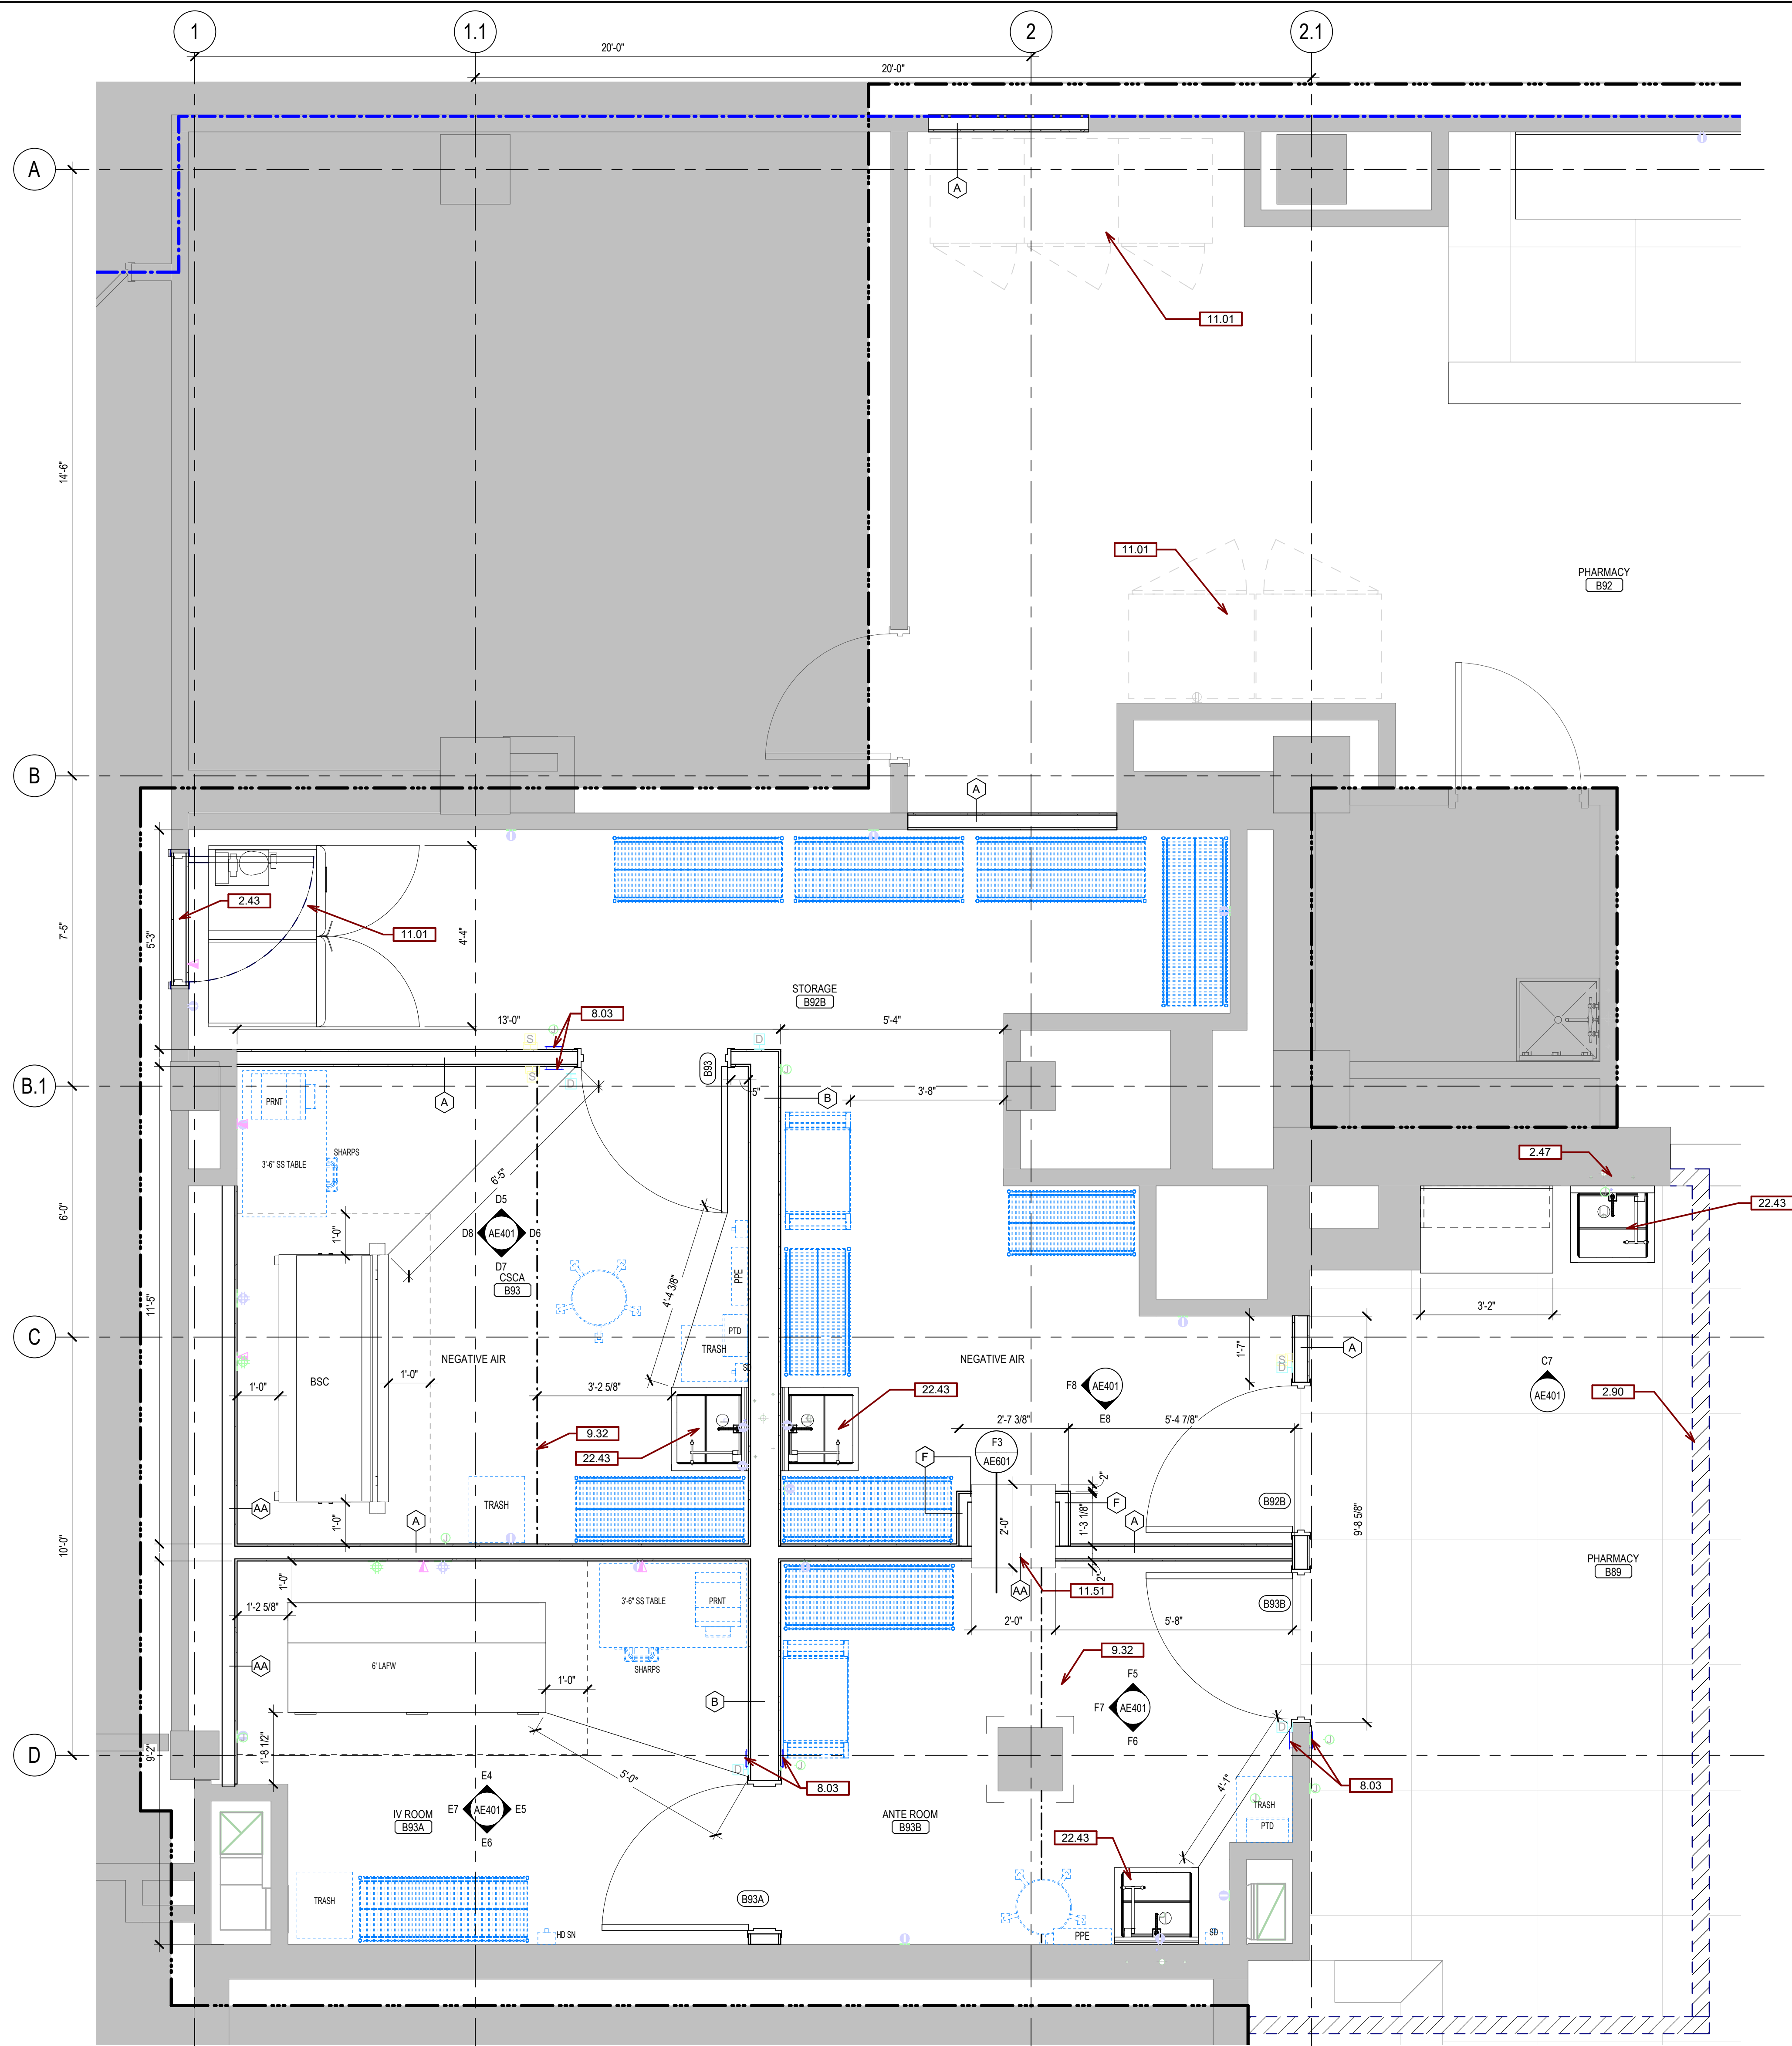
**GENERAL FLOOR PLAN NOTES:**

- A. ANY DISCREPANCIES OR CONFLICTS FOUND IN THE VARIOUS PARTS OF THE CONSTRUCTION DOCUMENTS SHALL BE BROUGHT TO THE ATTENTION OF THE ARCHITECT AND THE OWNER BEFORE PROCEEDING WITH THE WORK.
- B. FURNITURE IS PROVIDED AND INSTALLED BY OTHERS.
- C. WRITTEN DIMENSIONS TAKE PRECEDENCE OVER SCALED DIMENSIONS. DO NOT SCALE THE DRAWINGS.
- D. CONTRACTOR & SUBCONTRACTORS TO VERIFY ALL EXISTING CONDITIONS AT THE PROJECT SITE.
- E. ALL MATERIALS & EQUIPMENT SHALL BE INSTALLED PER MANUFACTURERS INSTRUCTIONS. DETAILS SHOWN ARE TYPICAL UNLESS OTHERWISE NOTED. SIMILAR DETAILS APPLY IN SIMILAR CONDITIONS.
- F. PROVIDE WOOD BACKING FOR ALL BATH ACCESSORIES, HANDRAILS, OR OTHER ITEMS ATTACHED TO BUILDING WALLS.
- G. PROVIDE ADA COMPLIANT SIGNAGE FOR ALL REQUIRED AREAS, ROOMS, & ACCESSIBLE PATHS.
- H. HEIGHT OF OPERATIONAL OR DISPENSING PORTION OF ACCESSORIES & FIXTURES NOT TO EXCEED 48" A.F.F. SEE SHEET G-002.
- I. WINDOWS TYPES, SEE SCHED.
- J. ALL WALLS ARE WALL TYPE A UNLESS NOTED.
- K. SEE ENLARGED FLOOR PLANS FOR UNIT WALL TYPES.
- L. PROVIDE CONTROL JOINTS IN DRYWALL EVERY 30'-0".
- M. ALL DIMENSIONS ARE TO OUTSIDE OF WALL FRAMING.
- N. FOR TILE FLOOR INSTALLATION, CONTRACTOR TO USE SCHLUTER PRODUCTS AS BASIS OF DESIGN FOR WATERPROOFING & KERDI & DITRA PRODUCTS AS APPLICABLE TO MANUFACTURER RECOMMENDATIONS.
- O. SEE MECHANICAL, ELECTRICAL AND PLUMBING DRAWINGS FOR ADDITIONAL INFORMATION.
- P. FLOORING TRANSITIONS TO BE PROVIDED BY CONTRACTOR.
- Q. CONTRACTOR IS TO PROTECT THE EXISTING FLOORING IN ROOM B92 AND PATCH AND SEAL AS REQUIRED TO MATCH EXISTING.
- R.


SGA KEYNOTES	
Key Value	Keynote Text
2.43	TEMPORARY CONSTRUCTION ACCESS DOOR.
2.47	GYPSONUM WALL BOARD PARTITION CUTTING AND REPAIR REQUIRED FOR CHAIR CARRIER AND PLUMBING ROUGH-IN CONNECTION.
2.90	TEMPORARY CONSTRUCTION BARRIER WALL FOR PHASE 3 CONSTRUCTION. TERMINATE AT DECK ABOVE. CONSTRUCT PRIOR TO DEMOLITION.
8.03	TOUCHLESS ADA ACTUATOR.
9.32	LINE OF DEMARCATION
11.01	PHARMACY REFRIGERATOR. CONNECT TO EMERGENCY POWER AFTER COMPLETION OF PHASE 1.
11.51	PASSTHROUGH WITH HEPA FILTER.
22.43	SINK WITH EYEWASH STATION - SEE PLUMBING.

WALL TYPES		INDICATED THUS ON FLOOR PLANS
A	- NON-RATED: 5/8" G.W.B., 3/8" MTL STUD, 5/8" G.W.B.	
AA	- NON-RATED: 5/8" G.W.B., 3/8" MTL STUD	
B	- NON-RATED: 5/8" G.W.B., 8" MTL STUD, 5/8" G.W.B.	
F	- NON-RATED: 5/8" G.W.B., 2 1/2" MTL STUD	

NOTE: SEE SHEET A-601 FOR MORE DESCRIPTION OF WALL TYPE.



**F4 ENLARGED FLOOR PLAN**  
1/2" = 1'-0"

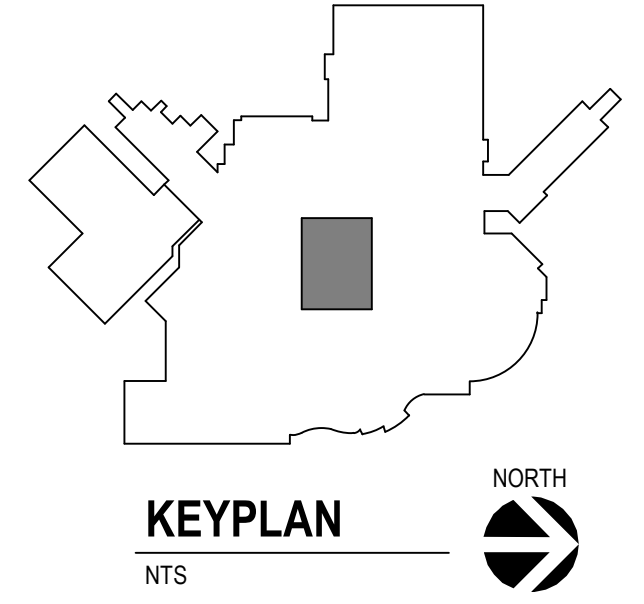

Revision#	Description	Date:

**CONSULTANTS**

**MECHANICAL / ELECTRICAL / PLUMBING:**  
**DUNHAM**  
 32 South Sixth Street, Suite 1100  
 Minneapolis, MN 55402  
 Phone: 612-465-7550

**STRUCTURAL:**  
**ERA**  
 ERICKSEN ROAD  
 A ASSOCIATES  
 Ericksen Road & Associates  
 2501 University Avenue West, Suite 201-S  
 Saint Paul, MN 55114  
 Phone: 651-251-7570

**ARCHITECT OF RECORD**

**A/E:**  
**STONE GROUP ARCHITECTS**  
 Stone Group Architects  
 600 E 7th Street  
 Sioux Falls, SD 57103  
 605-271-1144

**STAMP**

**Office of Construction and Facilities Management**

**VA** U.S. Department of Veterans Affairs

**Drawing Title**  
ENLARGED PLAN

**Approved:**

**Phase**  
BID SET

**Project Title**  
UPGRADE PHARMACY 797

**Location**  
SIOUX FALLS, SOUTH DAKOTA

**Issue Date**  
02/10/2021

**Checked**  
TRS

**Drawn**  
DAN

**Project Number**  
VA #438-20-109  
SGA #201927




**Building Number**  
5

**Drawing Number**  
AE101

**GENERAL RCP NOTES:**

- A. ANY DISCREPANCIES FOUND IN THE VARIOUS PARTS OF THE CONSTRUCTION DOCUMENTS SHALL BE BROUGHT TO THE ATTENTION OF THE ARCHITECTS AND THE OWNER BEFORE PROCEEDING WITH ALL THE WORK.
- B. ALL ITEMS INSTALLED IN CEILINGS ARE TO BE CENTERED AND/OR SYMMETRICAL ON THE CENTERLINE OF ROOMS AND CENTERED IN TILES.
- C. INSTALL ALL WALL MOUNTED EXIT SIGNS AND OTHER FIXTURES CENTERED ABOVE OPENINGS WHERE POSSIBLE.
- D. REFLECTED CEILING PLANS SHOW LOCATIONS OF ITEMS THAT ARE ARCHITECTURALLY SIGNIFICANT ONLY. MECHANICAL AND ELECTRICAL ITEMS INDICATED ARE FOR REFERENCE ONLY. REFER TO MECHANICAL AND ELECTRICAL DOCUMENTS.
- E. GYPSUM USED IN RESTROOM AND OTHER AREAS EXPOSED TO MOISTURE SHALL BE WATER RESISTANT GYPSUM BOARD.
- F. SUSPENDED CEILING TO BE CENTERED WITH THE BALANCE GRID DESIGN WITH EDGE UNITS NO LESS THAN 50% OF THE TILE SIZE.
- G. PAINT HORIZONTAL AND VERTICAL FACES OF THE SOFFITS SPECIFIED PAINT COLOR, UNLESS NOTED OTHERWISE.
- H. ALL BULKHEAD HORIZONTAL AND VERTICAL FACES TO BE PAINTED TO MATCH EXISTING, UNLESS NOTED OTHERWISE.
- I. ALL GYPSUM BOARD CEILINGS TO BE PAINTED SPECIFIED ROOM COLOR, UNLESS OTHERWISE NOTED.
- J. ALL BULKHEADS TO EXTEND PAST ADJACENT CEILING HEIGHT 2" UNLESS OTHERWISE NOTED.
- K. AT RCP SECTIONS REFER TO REFLECTED CEILING PLAN FOR CEILING/SOFFIT ELEVATIONS.

SGA KEYNOTES	
Key Value	Keynote Text
2.19	REMOVE CEILING AS NEEDED FOR CONSTRUCTION AND REPLACE AT COMPLETION.
2.44	EXISTING CEILING TO REMAIN.
2.90	TEMPORARY CONSTRUCTION BARRIER WALL FOR PHASE 3 CONSTRUCTION. TERMINATE AT DECK ABOVE. CONSTRUCT PRIOR TO DEMOLITION.
23.01	MECH ELEMENT - SEE MECH.
26.01	LIGHT FIXTURE - SEE ELEC.

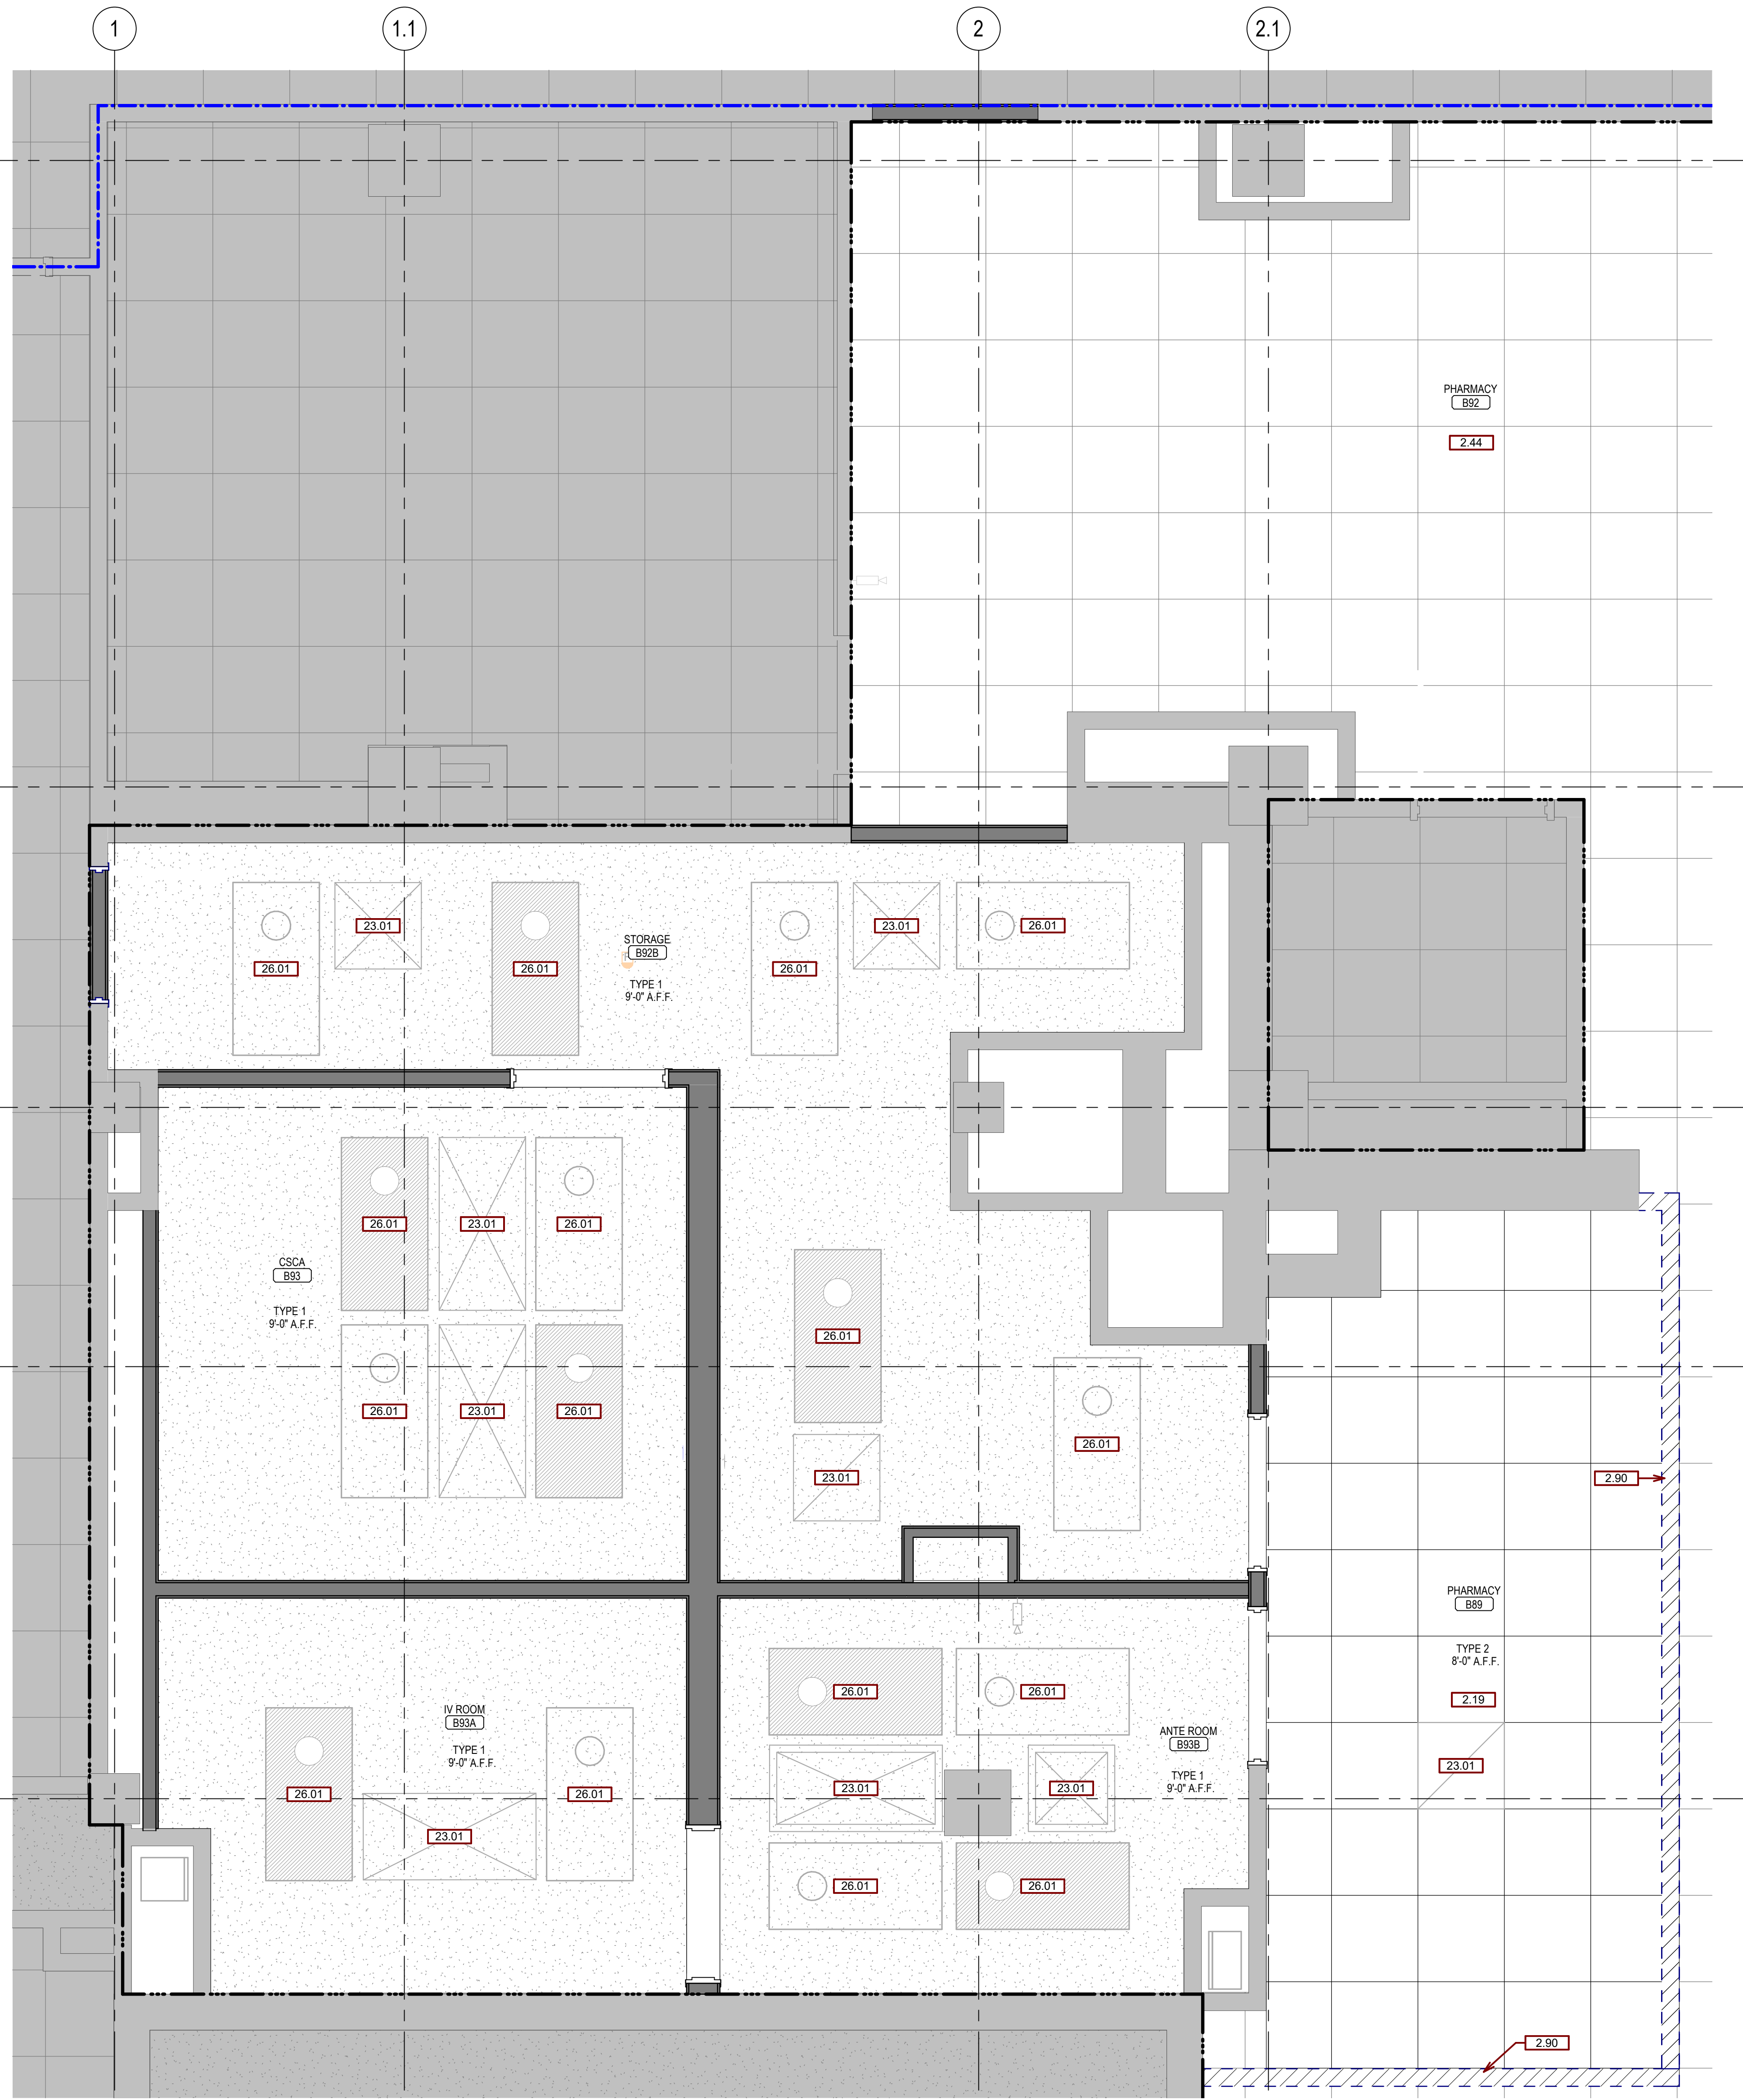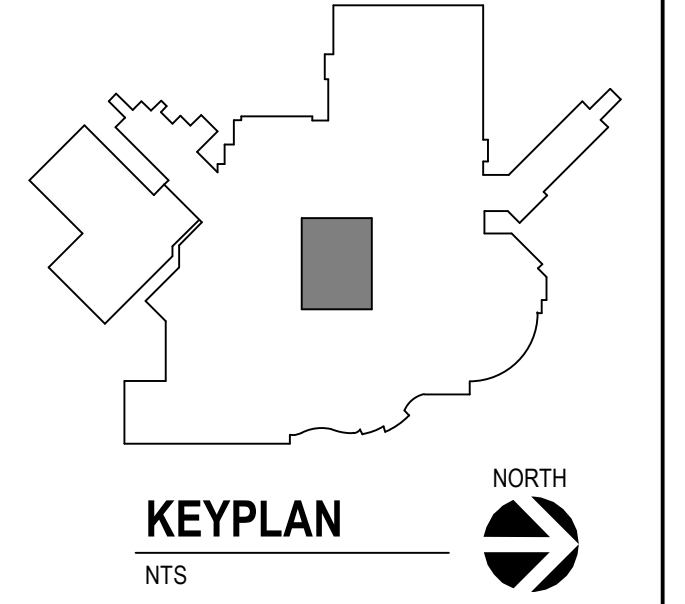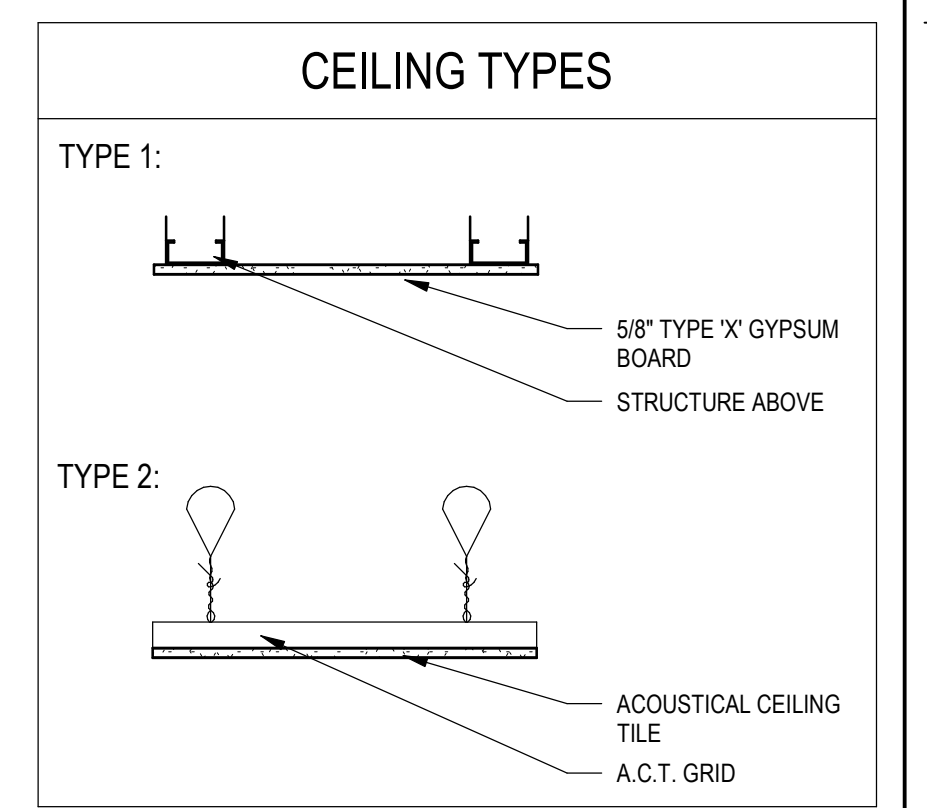

**F4 ENLARGED REFLECTED CEILING PLAN**  
1/2" = 1'-0"

Scale indicators on the left margin:  
 Three inches = one foot  
 one and one half inches = one foot  
 one inch = one foot  
 three quarters inch = one foot  
 one half inch = one foot  
 one quarter inch = one foot  
 three eighths inch = one foot  
 one eighth inch = one foot

2/19/2021 10:06:15 PM  
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Revision#	Description	Date:

**CONSULTANTS**

MECHANICAL / ELECTRICAL / PLUMBING:  
**DUNHAM**  
 32 South Sixth Street, Suite 1100  
 Minneapolis, MN 55402  
 Phone: 612-465-7550

STRUCTURAL:  
**ERA**  
 ERICKSEN ROAD  
 A ASSOCIATES  
 Erickson Road & Associates  
 2501 University Avenue West, Suite 201-S  
 Saint Paul, MN 55114  
 Phone: 651-251-7570

**ARCHITECT OF RECORD**

A/E:  
**Stone Group Architects**  
 600 E 7th Street  
 Sioux Falls, SD 57103  
 605-271-1144

**STONE GROUP ARCHITECTS**

**STAMP**

REGISTERED ARCHITECT  
 SOUtheastern ARCHITECTURE  
 2019  
 2-10-21

Office of Construction and Facilities Management  
**VA** U.S. Department of Veterans Affairs

Drawing Title  
**REFLECTED CEILING PLAN**

Approved: \_\_\_\_\_

Phase  
**BID SET**

Project Title  
**UPGRADE PHARMACY 797**

Location  
**SIoux FALLS, SOUTH DAKOTA**

Issue Date  
 02/10/2021

Checked  
 TRS

Drawn  
 DAN

Project Number  
 VA #438-20-109  
 SGA #201927

Building Number  
 5

Drawing Number  
**AE201**


**GENERAL ELEVATION NOTES:**

- A. ANY DISCREPANCIES OR CONFLICTS FOUND IN THE VARIOUS PARTS OF THE CONSTRUCTION DOCUMENTS SHALL BE BROUGHT TO THE ATTENTION OF THE ARCHITECT AND THE OWNER BEFORE PROCEEDING WITH THE WORK.
- B. FURNITURE IS PROVIDED AND INSTALLED BY OTHERS.
- C. WRITTEN DIMENSIONS TAKE PRECEDENCE OVER SCALED DIMENSIONS. DO NOT SCALE THE DRAWINGS.
- D. CONTRACTOR & SUBCONTRACTORS TO VERIFY ALL EXISTING CONDITIONS AT THE PROJECT SITE. ALL MATERIALS & EQUIPMENT SHALL BE INSTALLED PER MANUFACTURER'S INSTRUCTIONS. DETAILS SHOWN ARE TYPICAL UNLESS OTHERWISE NOTED. SIMILAR DETAILS APPLY IN SIMILAR CONDITIONS.
- E. PROVIDE WOOD BACKING FOR ALL BATH ACCESSORIES, HANDRAILS, OR OTHER ITEMS ATTACHED TO BUILDING WALLS.
- F. GYPSUM USED IN RESTROOMS SHALL BE WATER RESISTANT GYPSUM BOARD. USE DURAROCK® AT ALL PORCELAIN & CERAMIC TILE LOCATIONS.
- G. PROVIDE ADA COMPLIANT SIGNAGE FOR ALL REQUIRED AREAS, ROOMS, & ACCESSIBLE PATHS. HEIGHT OF OPERATIONAL OR DISPENSING PORTION OF ACCESSORIES & FIXTURES NOT TO EXCEED 48" A.F.F.

**GENERAL CASEWORK NOTES:**


- A. ANY DISCREPANCIES OR CONFLICTS FOUND IN THE VARIOUS PARTS OF THE CONSTRUCTION DOCUMENTS SHALL BE BROUGHT TO THE ATTENTION OF THE ARCHITECT AND THE OWNER BEFORE PROCEEDING WITH THE WORK.
- B. COORDINATE DEVICE PENETRATIONS AT COUNTERTOPS W/ MECHANICAL, ELECTRICAL, EQUIPMENT SUPPORTS AT ALL OPEN SPACES APPROXIMATELY 3/4" O.C. BRACKETS TO BE PAINTED TO MATCH SPECIFIED WALL FINISH.
- C. PROVIDE FINISHED END PANELS AT ALL EXPOSED MILLWORK SURFACES. ALL PLAM CABINETS TO HAVE P.V.C. EDGES. MATCH P.V.C. EDGE TO PLAM. SUBMIT SAMPLES FOR APPROVAL.
- D. PROVIDE 4" RESILIENT BASE AT ALL BASE CABINETS (UON).
- E. MILLWORK SUPPLIER SHALL PROVIDE FILLER PANELS & SCRIBE STRIPS WHERE NEEDED FOR COMPLETE INSTALLATION.
- F. CABINETS OVER 30" WIDE SHALL HAVE 1" THICK PARTICLE BOARD CORE.
- G. DO NOT PROVIDE SIDESPLASH UNLESS OTHERWISE NOTED.
- H. UNLESS OTHERWISE INDICATED, PROVIDE PRODUCTS OF QUALITY SPECIFIED BY AIA ARCHITECTURAL WOODWORK QUALITY STANDARDS FOR PREMIUM GRADE.
- I. INSTALL BLOCKING AS REQUIRED IN ALL PARTITIONS TO RECEIVE COUNTERS, SHELVING, HANGERS/GRONNETS, ETC.
- J. VERIFY ALL GRONNET LOCATIONS AND COUNT WITH OWNER.
- K. PROVIDE STAINLESS STEEL (18" PER SIDE) BEHIND HOOD. REFER TO DRAWINGS FOR LOCATIONS.
- L. FINISHES SCHEDULE PROVIDED BY OWNER.
- M. ALL OWNER FURNISHED EQUIPMENT TO BE CONTRACTOR INSTALLED WITH ---- PRIOR TO INSTALL.

SGA KEYNOTES	
Key Value	Keynote Text
8.03	TOUCHLESS ADA ACTUATOR.
9.07	S.S. CORNER GUARD.
9.09	WALL BASE
9.11	BASE AS SCHEDULED.
9.12	RIGID VINYL WALL PROTECTION - 1. WAINSCOT. SEE FINISH SCHEDULE.
9.13	RIGID VINYL WALL PROTECTION - 2. TOP CAP. SEE FINISH SCHEDULE.
9.60	REINSTALL ANTI-FATIGUE FLOORING
10.13	24" X 36" MIRROR WITH STAINLESS STEEL TRIM
11.00	EQUIPMENT BY OWNER.
11.01A	REFRIGERATOR, N.I.C.
11.51	PASSTHROUGH WITH HEPA FILTER.
11.52	TUG ROBOT LOCATION. REINSTALL AFTER PHASE 2 IS COMPLETE.
12.01	FURNITURE, BY OWNER
12.11	LOCKABLE BASE CABINET WITH FIXED SHELVING.
12.12	FOUR DRAWER PULL OUT SHELVING.
12.13	FINISHED END.
12.14	FILLER STRIP.
12.15	COUNTERTOP.
12.16	METAL SURFACE MOUNT COUNTER SUPPORT BRACKET. COLOR TBD BY OWNER.
12.18	LOCKABLE UPPER CABINETS W/ SLOPED TOP AND PULL OUT SHELVING.
12.19	LOCKABLE BASE CABINET W/ DRAWER AND FIXED SHELVING.
12.20	LOCKABLE THREE DRAWER BASE CABINET.
12.21	LOCKABLE UPPER CABINETS W/ PULL OUT SHELVING.
12.22	LOCKABLE UPPER CABINETS.
12.31	WALL MOUNTED COATRACK.
22.01	SINK - SEE PLUMBING.
22.43	SINK WITH EYEWASH STATION - SEE PLUMBING.
23.05	LOW AIR RETURN. SEE MECHANICAL.

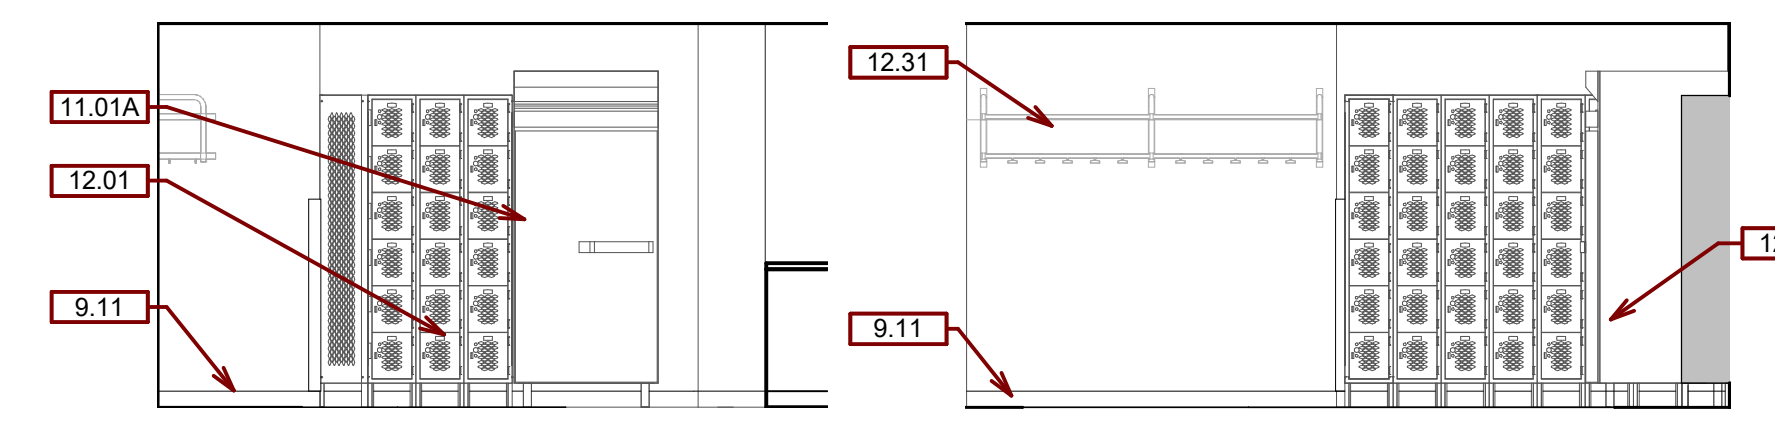


**A7 B92 - BREAK AREA - EAST**  
1/4" = 1'-0"

**A8 B92 - BREAK AREA - NORTH**  
1/4" = 1'-0"

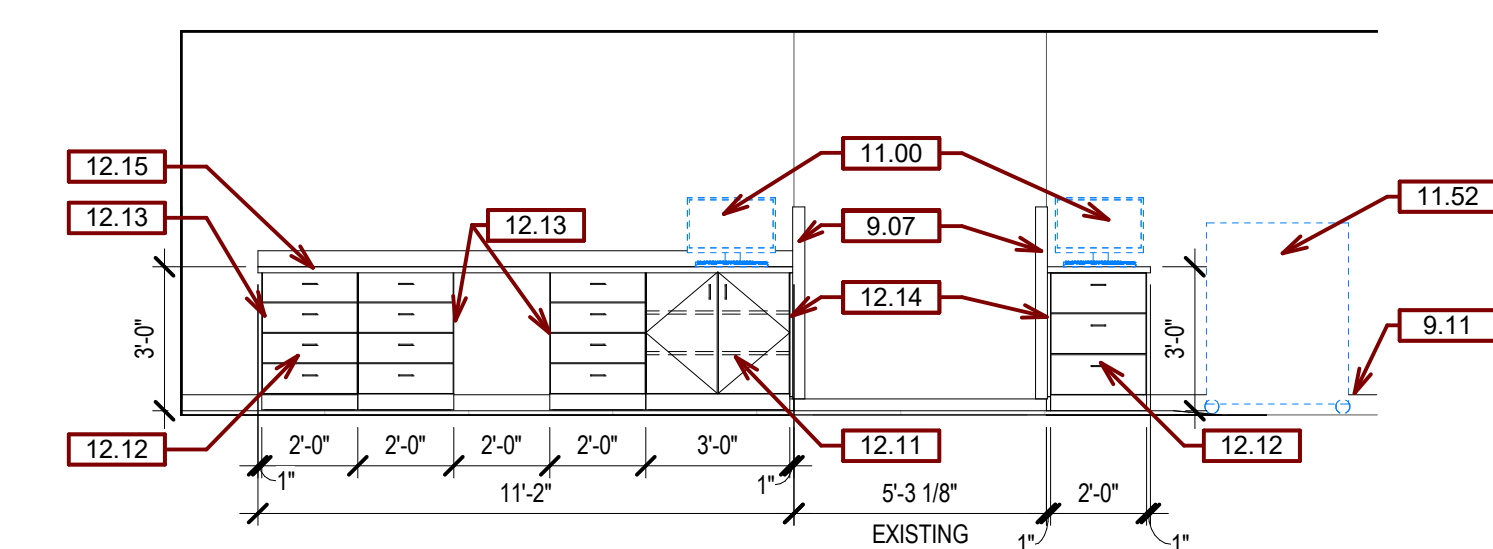


**B5 B92 - WEST WORKSTATIONS**  
1/4" = 1'-0"

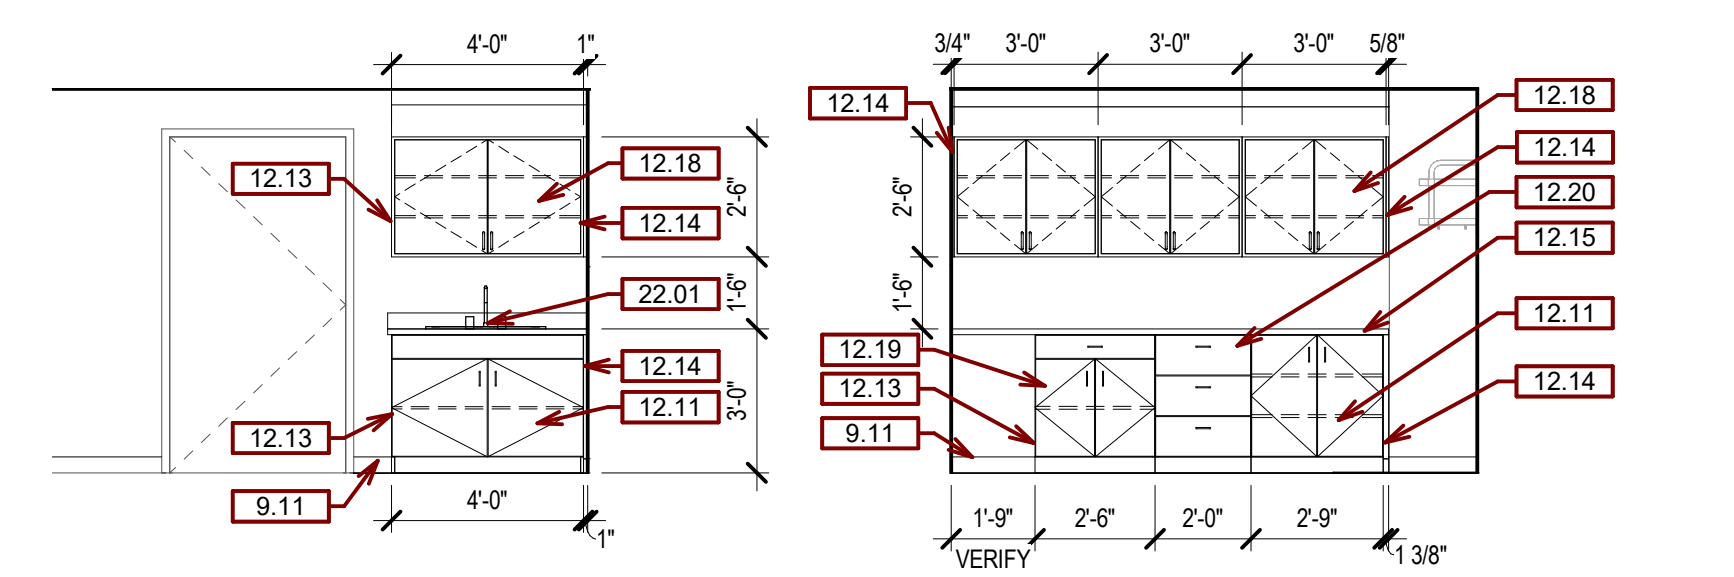


**B7 B92 - SINK STATION**  
1/4" = 1'-0"

**B8 B92 - BREAK AREA - WEST**  
1/4" = 1'-0"

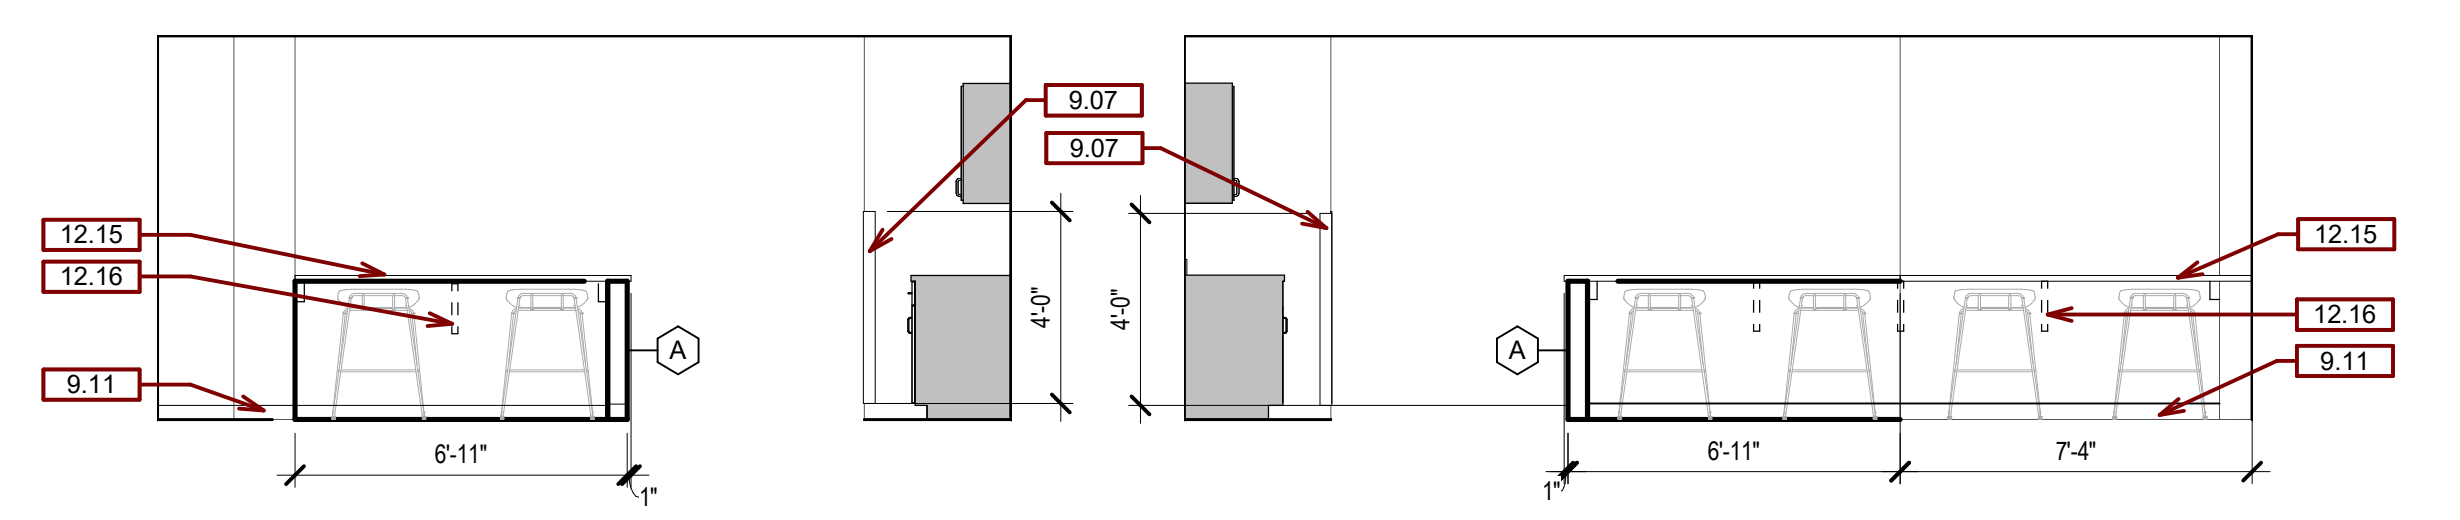


**B4 B92 - PHARM - BREAK AREA - SOUTH**  
1/4" = 1'-0"

**B5 B92 - PHARM - BREAK AREA**  
1/4" = 1'-0"

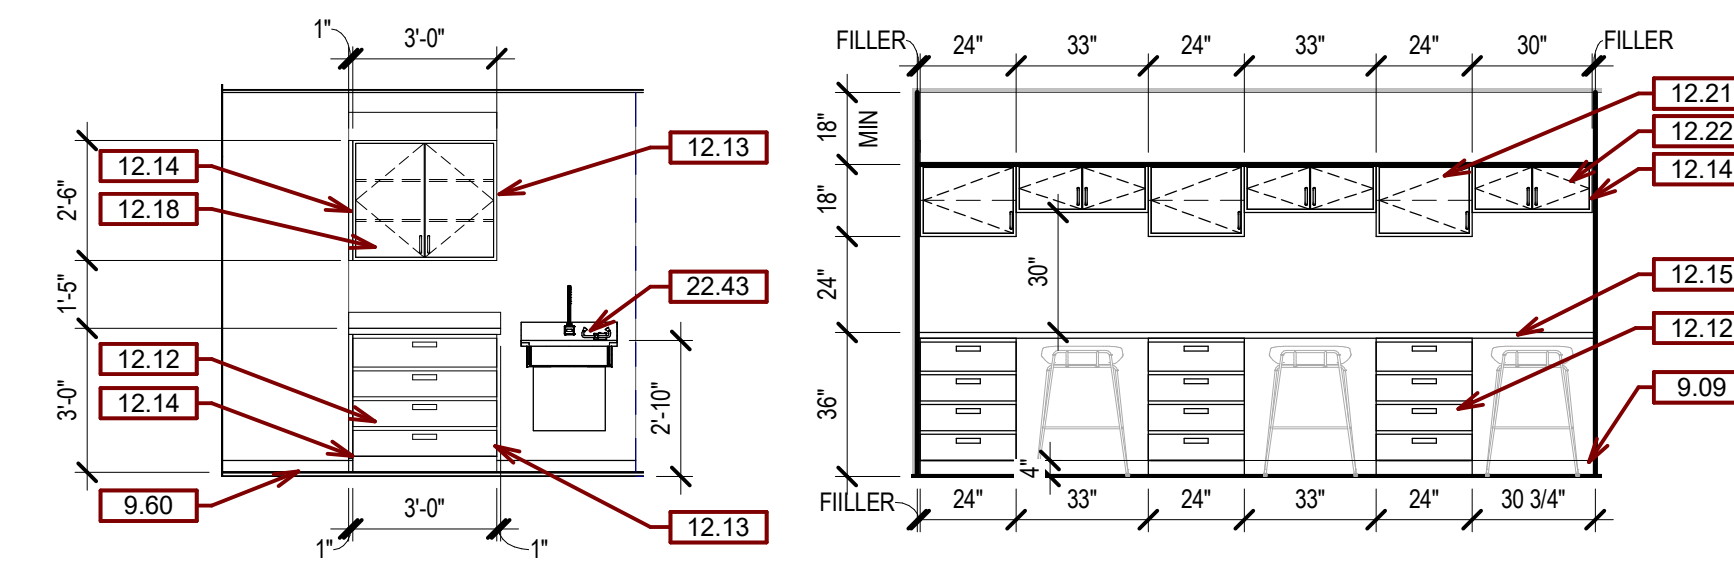


**C7 PHARM B89 - WEST**  
1/4" = 1'-0"


**C8 B92 - PHARM BREAK AREA SOUTH**  
1/4" = 1'-0"

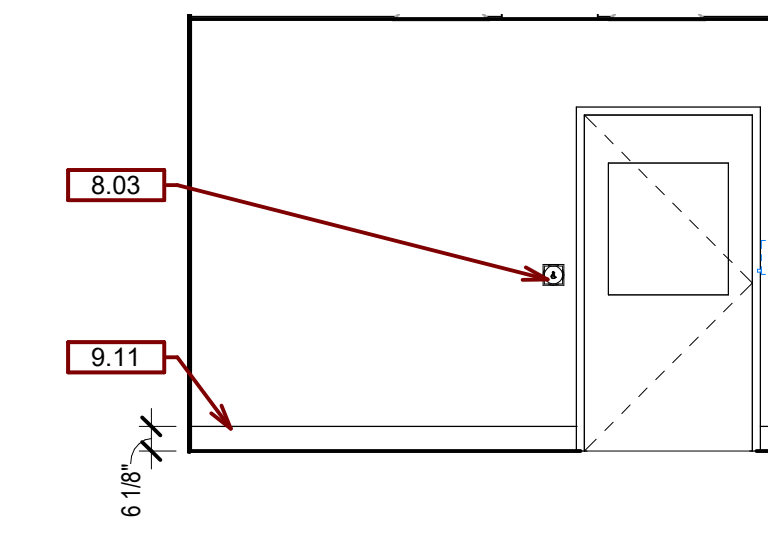


**D5 B93 - CSCA - WEST**  
1/4" = 1'-0"

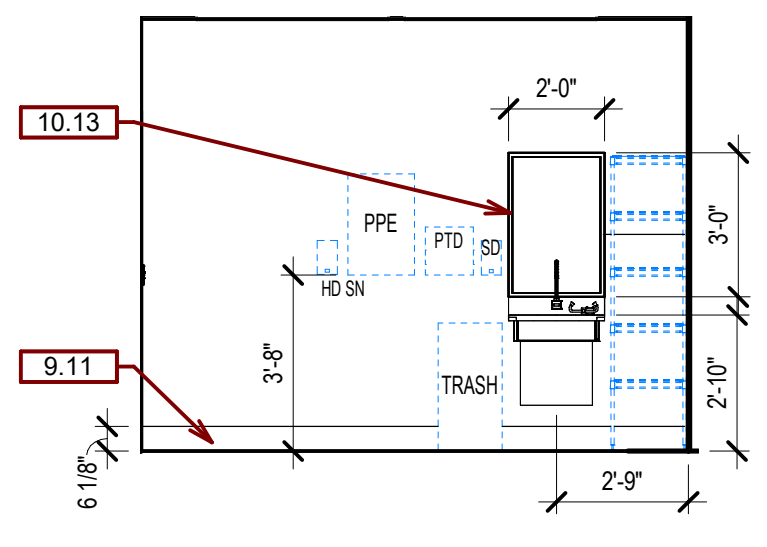


**D6 B93 - CSCA - NORTH**  
1/4" = 1'-0"

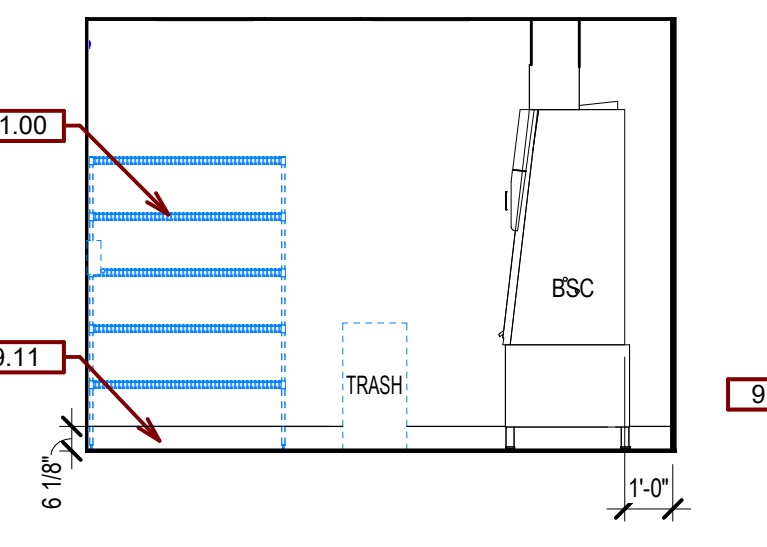


**D7 B93 - CSCA - EAST**  
1/4" = 1'-0"

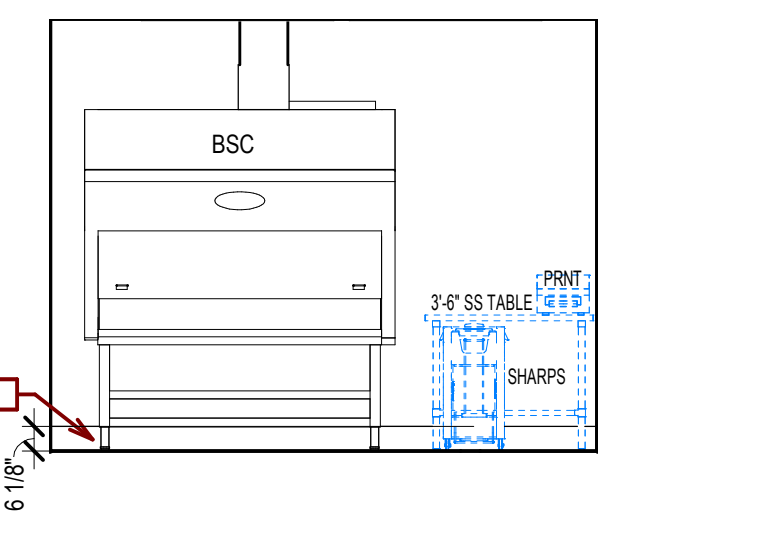


**D8 B93 - CSCA - SOUTH**  
1/4" = 1'-0"

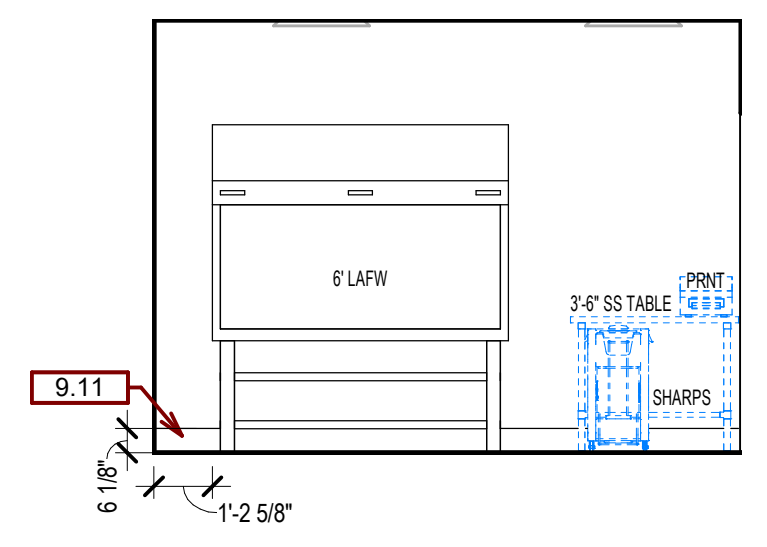


**E4 B93A - IV ROOM - WEST**  
1/4" = 1'-0"

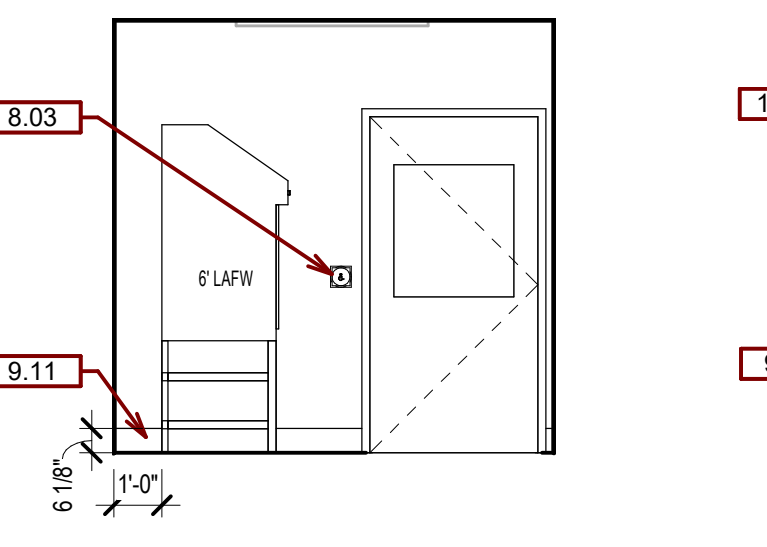


**E5 B93A - IV ROOM - NORTH**  
1/4" = 1'-0"

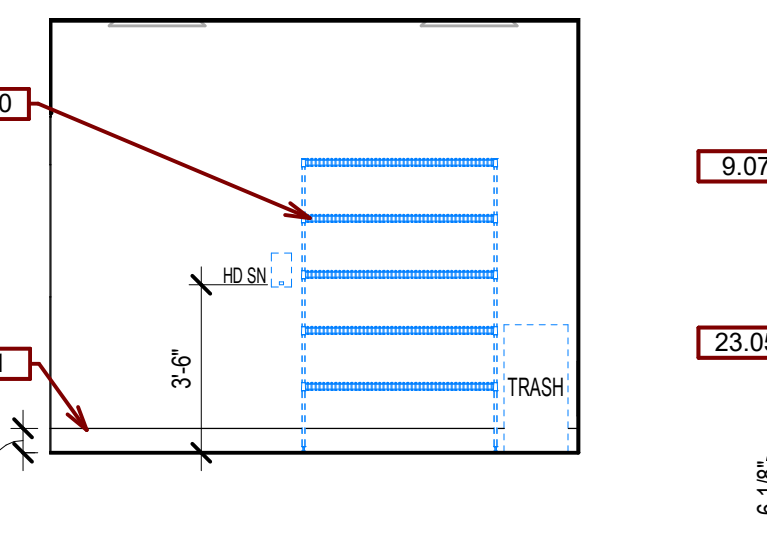


**E6 B93A - IV ROOM - EAST**  
1/4" = 1'-0"

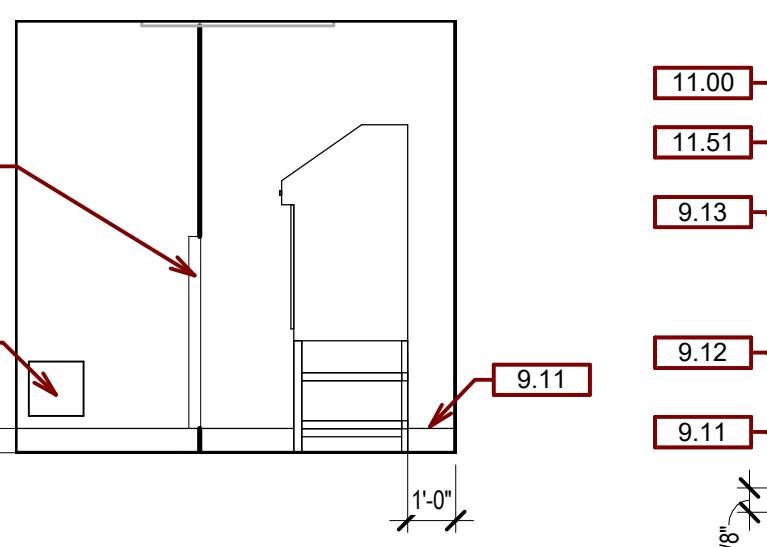


**E7 B93A - IV ROOM - SOUTH**  
1/4" = 1'-0"

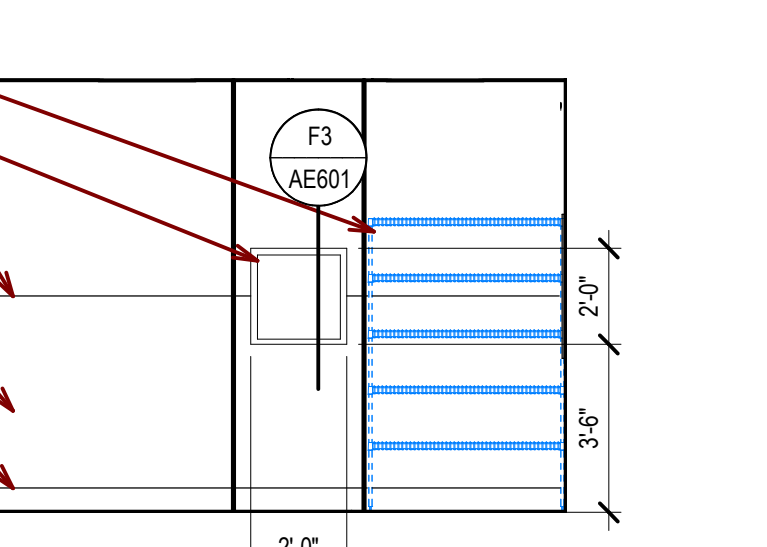


**E8 B92B STORAGE - EAST**  
1/4" = 1'-0"

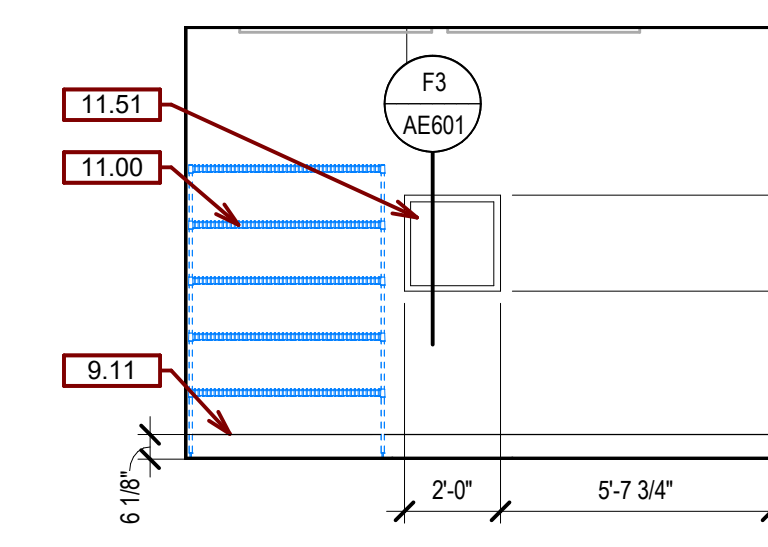


**F5 B93B - ANTE ROOM - WEST**  
1/4" = 1'-0"

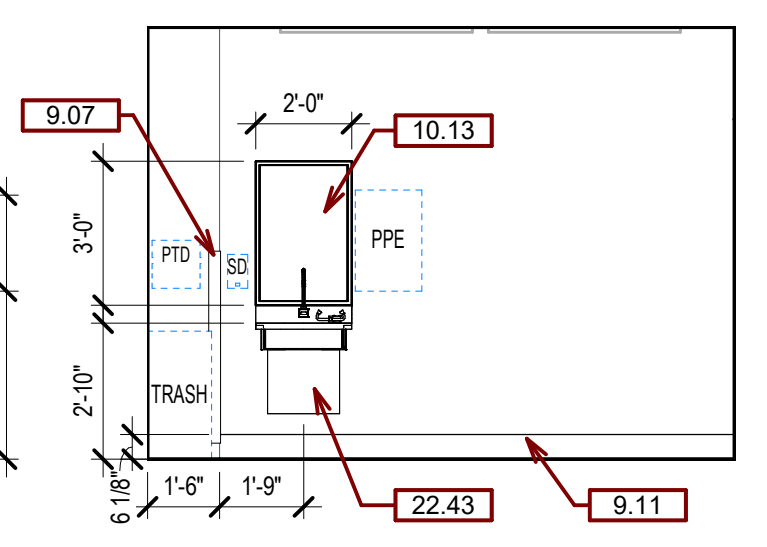


**F6 B93B - ANTE ROOM - EAST**  
1/4" = 1'-0"

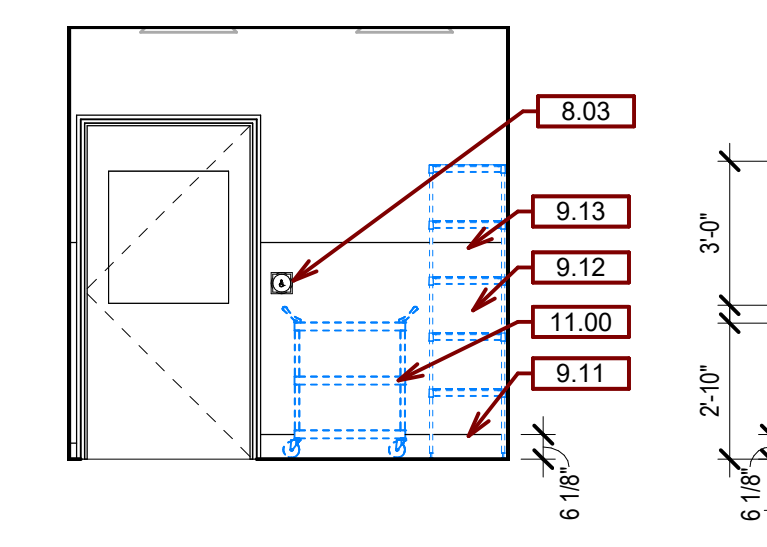

**F7 B93B - ANTE ROOM - SOUTH**  
1/4" = 1'-0"

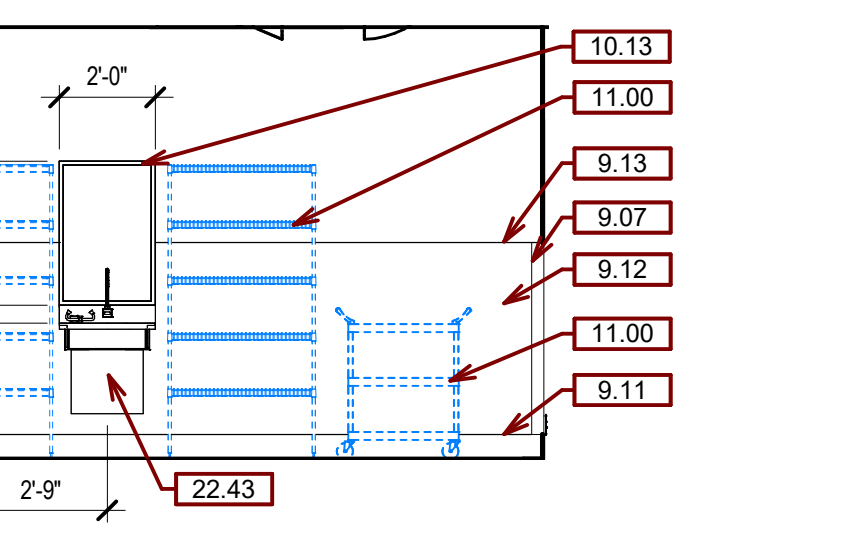

**F8 B92B STORAGE - SOUTH**  
1/4" = 1'-0"

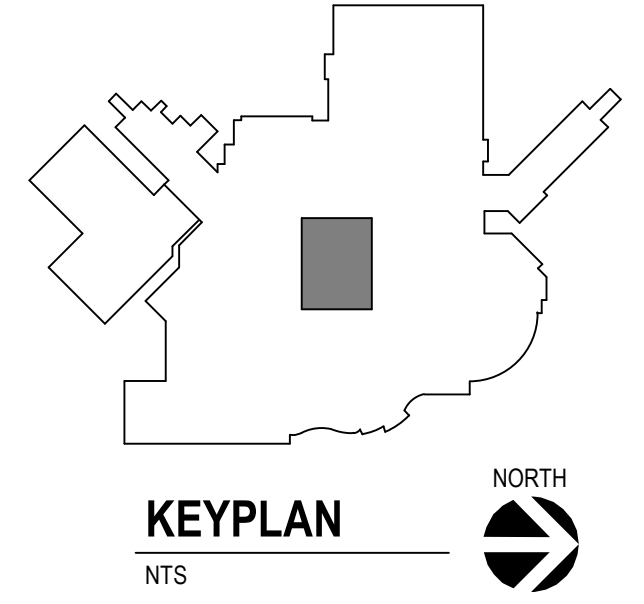

Revision#	Description	Date:

**CONSULTANTS**

MECHANICAL / ELECTRICAL / PLUMBING:  
**DUNHAM**  
32 South Sixth Street, Suite 1100  
Minneapolis, MN 55402  
Phone: 612-465-7550

STRUCTURAL:  
**ERA**  
ERICKSEN ROAD  
A CONSULTANT  
Erickson Road & Associates  
2501 University Avenue West, Suite 201-S  
Saint Paul, MN 55114  
Phone: 651-251-7570

**ARCHITECT OF RECORD**

A/E/C:  
**Stone Group Architects**  
600 E 7th Street  
Sioux Falls, SD 57103  
605-271-1144

**STONE GROUP ARCHITECTS**

**STAMP**

REGISTERED ARCHITECT  
STATE OF SOUTH DAKOTA  
No. 120  
J.D. ...

Office of Construction and Facilities Management  
**VA** U.S. Department of Veterans Affairs

Drawing Title  
**INTERIOR ELEVATIONS**

Phase  
**BID SET**

Approved:

Project Title  
**UPGRADE PHARMACY 797**

Location  
**SIoux FALLS, SOUTH DAKOTA**

Issue Date  
**02/10/2021**

Checked  
**TRS**

Drawn  
**DAN**

Project Number  
**VA #438-20-109**

Building Number  
**5**

Drawing Number  
**AE401**






**GENERAL DOOR AND WINDOW NOTES:**

- A. VERIFY ALL DOOR AND WINDOW OPENINGS WITH MANUFACTURER.
- B. PROVIDE ADA APPROVED LEVER TYPE HARDWARE FOR ALL DOORS UNLESS OTHERWISE NOTED (U.O.N.).
- C. PROVIDE 1" INSULATED GLASS FOR ALL EXTERIOR GLAZING AND 1/4" GLASS FOR ALL INTERIOR GLAZING.
- D. COORDINATE DOOR PROTECTION WITH DOOR SUPPLIER.
- E. COORDINATE DOOR HARDWARE STYLE AND FINISH WITH OWNER.
- F. SPRING HINGE CLOSER ALLOWED @ DOOR CLOSER LOCATIONS. VERIFY WITH OWNER AND 2015 IBC.

DOOR SCHEDULE										
DOOR #	DOOR			FRAME			RATING	HDWR	REMARKS	
	WIDTH	HEIGHT	TYPE	MATERIAL	GLAZING	TYPE				MATERIAL
B92B	3'-6"	7'-0"	G: 03	WDR-1	T	F1	HM	4 7/8"	-	2
B93	3'-6"	7'-0"	G: 03	WDR-1	T	F1	HM	4 7/8"	-	1
B93A	3'-6"	7'-0"	G: 03	WDR-1	T	F1	HM	9 1/4"	-	2a
B93B	3'-6"	7'-0"	G: 03	WDR-1	T	F1	HM	4 7/8"	-	2a





WDR-1: SEE COLOR AND MATERIAL SCHEDULE

GLAZING LEGEND	
T	1/4" TEMPERED GLASS

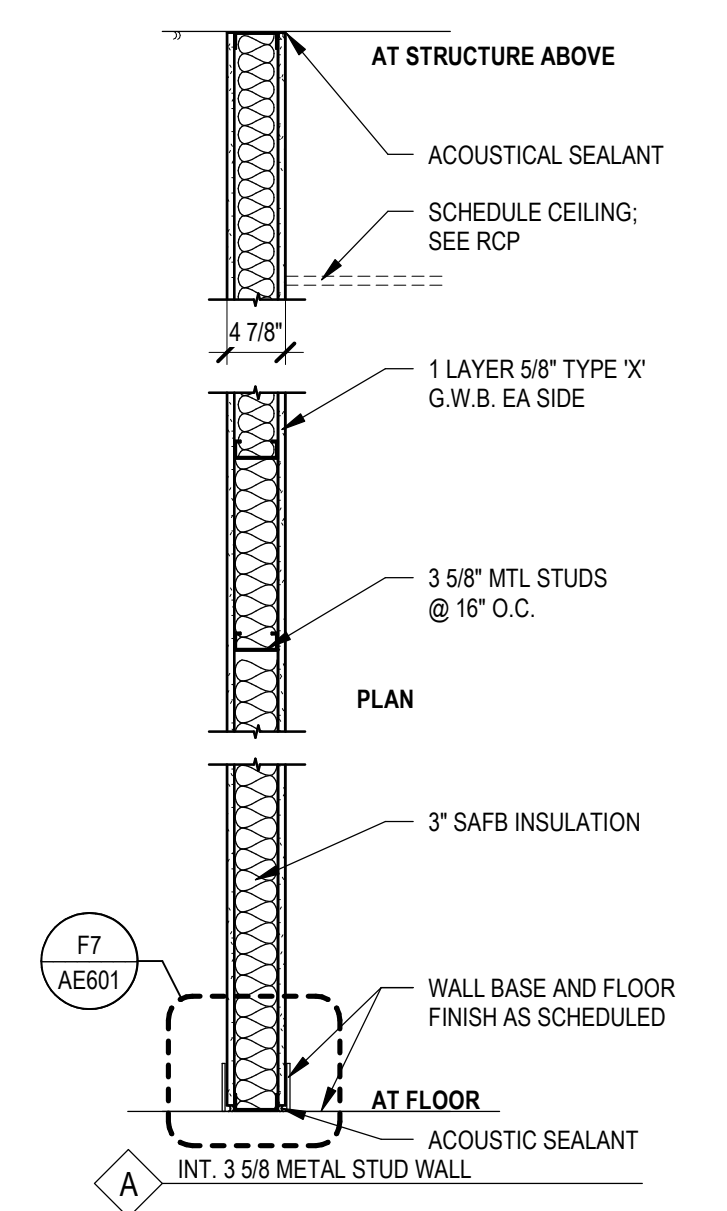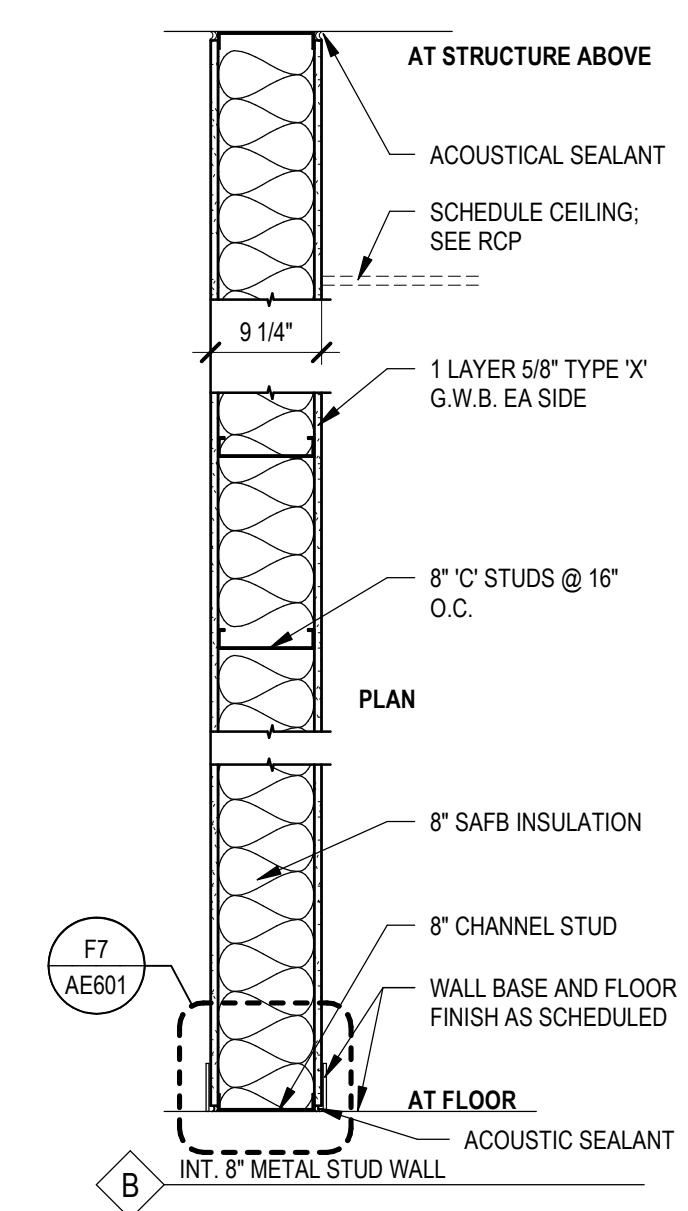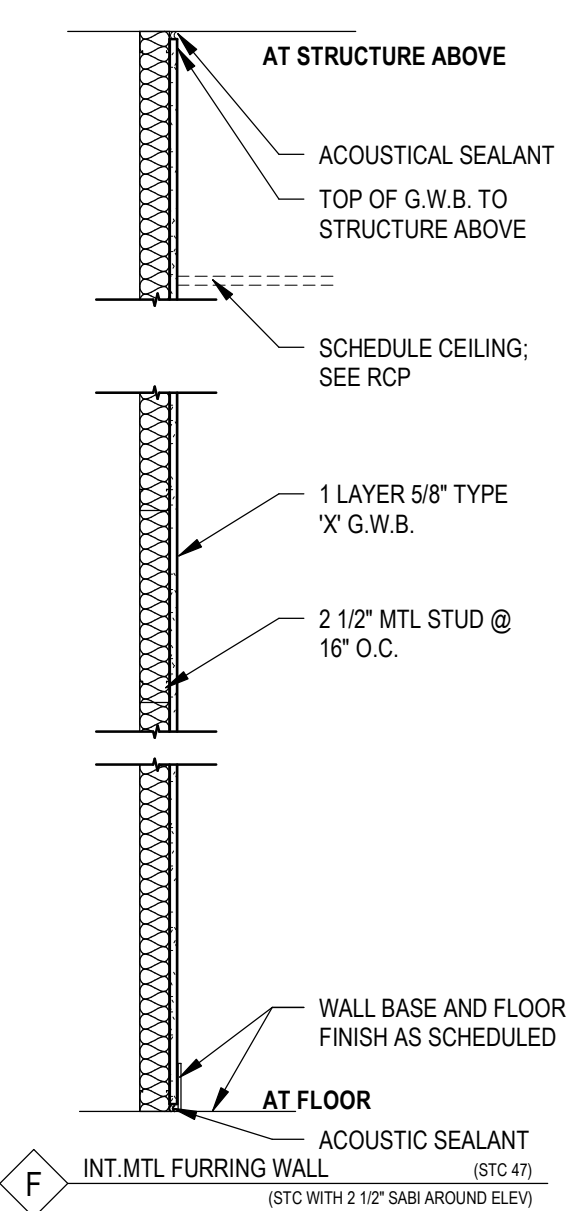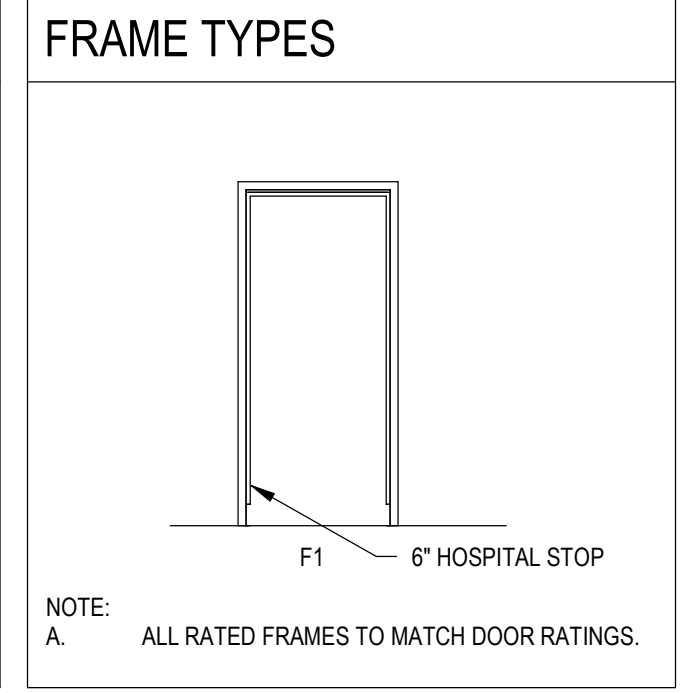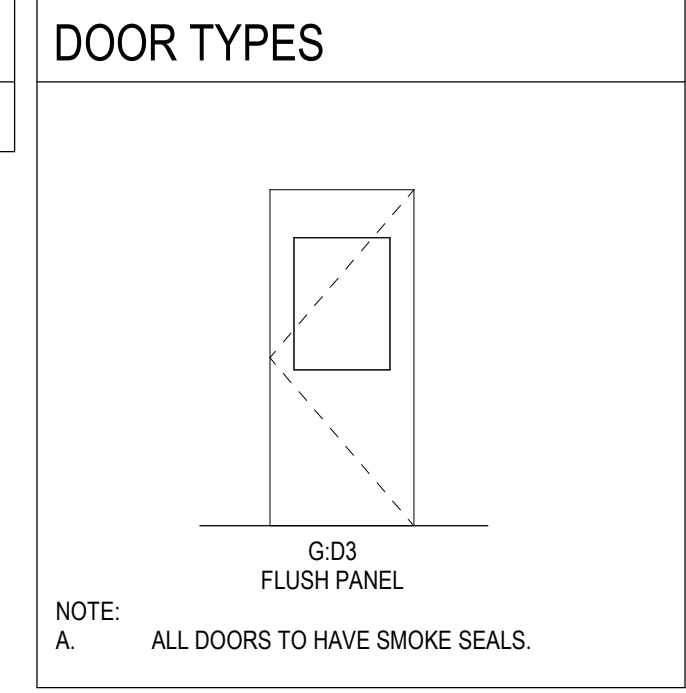

WALL TYPES		INDICATED THUS ON FLOOR PLANS
A	- NON-RATED: 5/8" G.W.B., 3 5/8" MTL STUD, 5/8" G.W.B.	
AA	- NON-RATED: 5/8" G.W.B., 3 5/8" MTL STUD	
B	- NON-RATED: 5/8" G.W.B., 8" MTL STUD, 5/8" G.W.B.	
F	- NON-RATED: 5/8" G.W.B., 2 1/2" MTL STUD	

NOTE: SEE SHEET A-601 FOR MORE DESCRIPTION OF WALL TYPE.

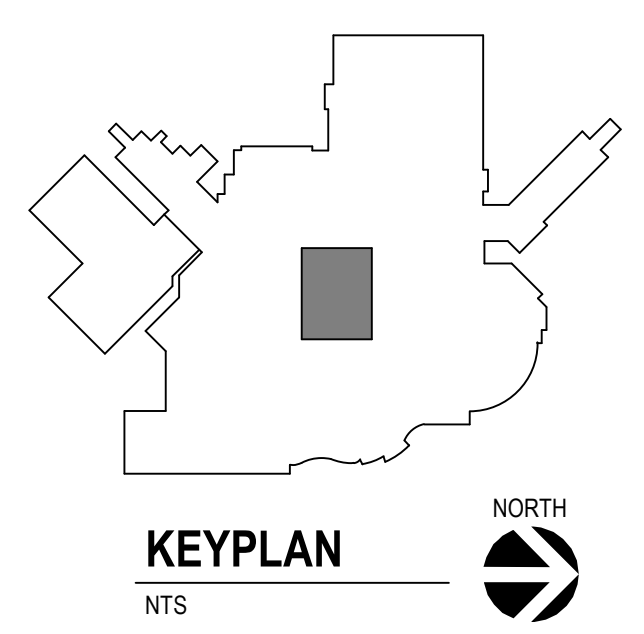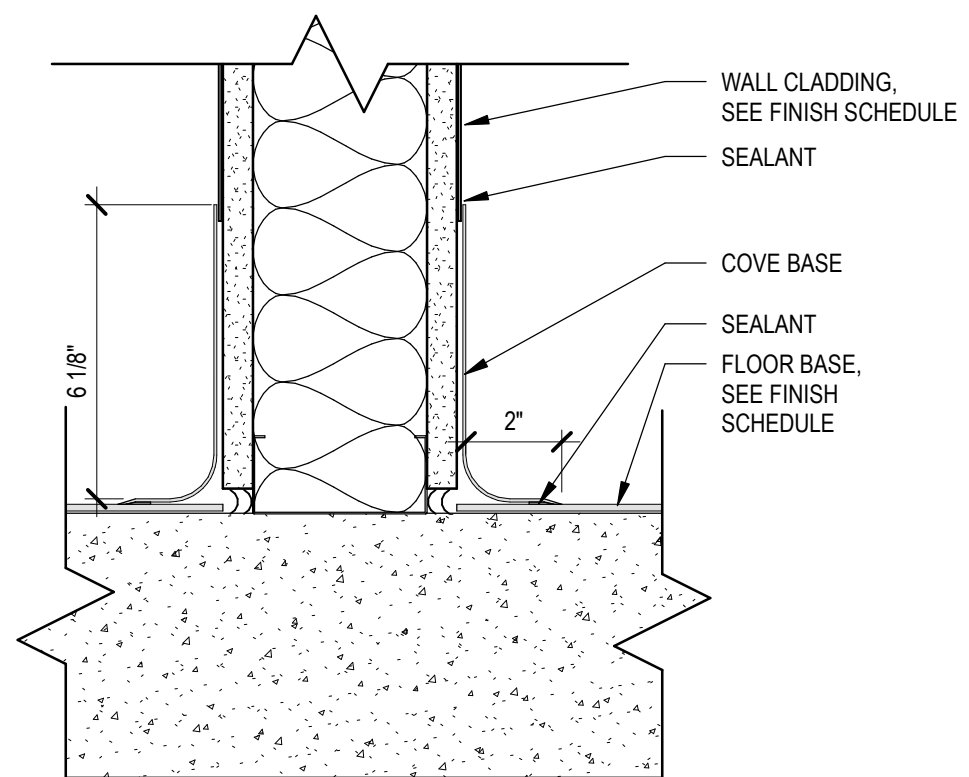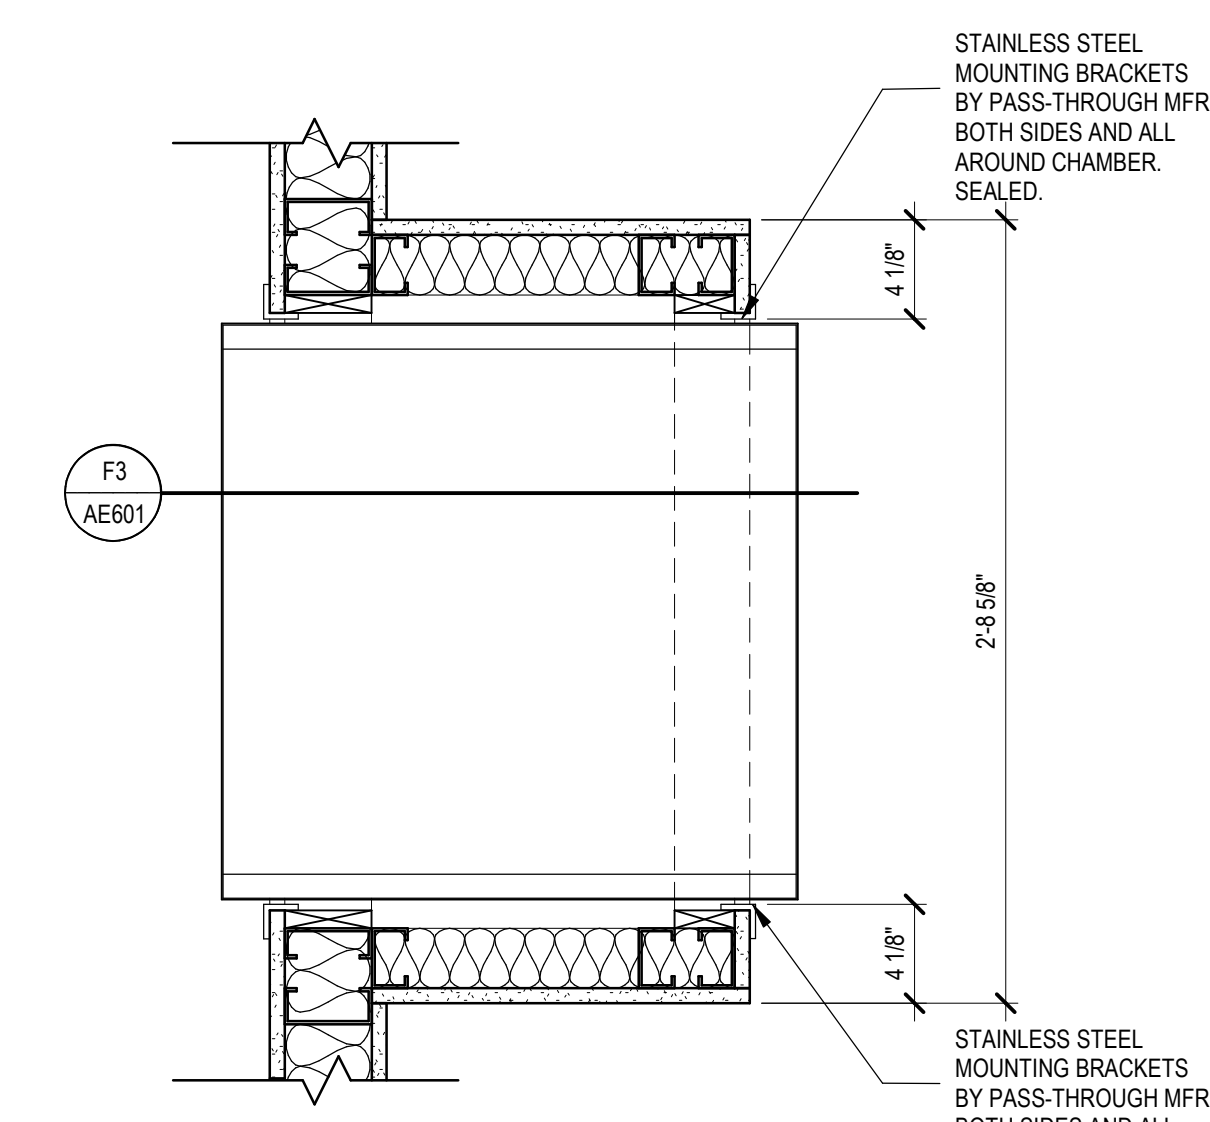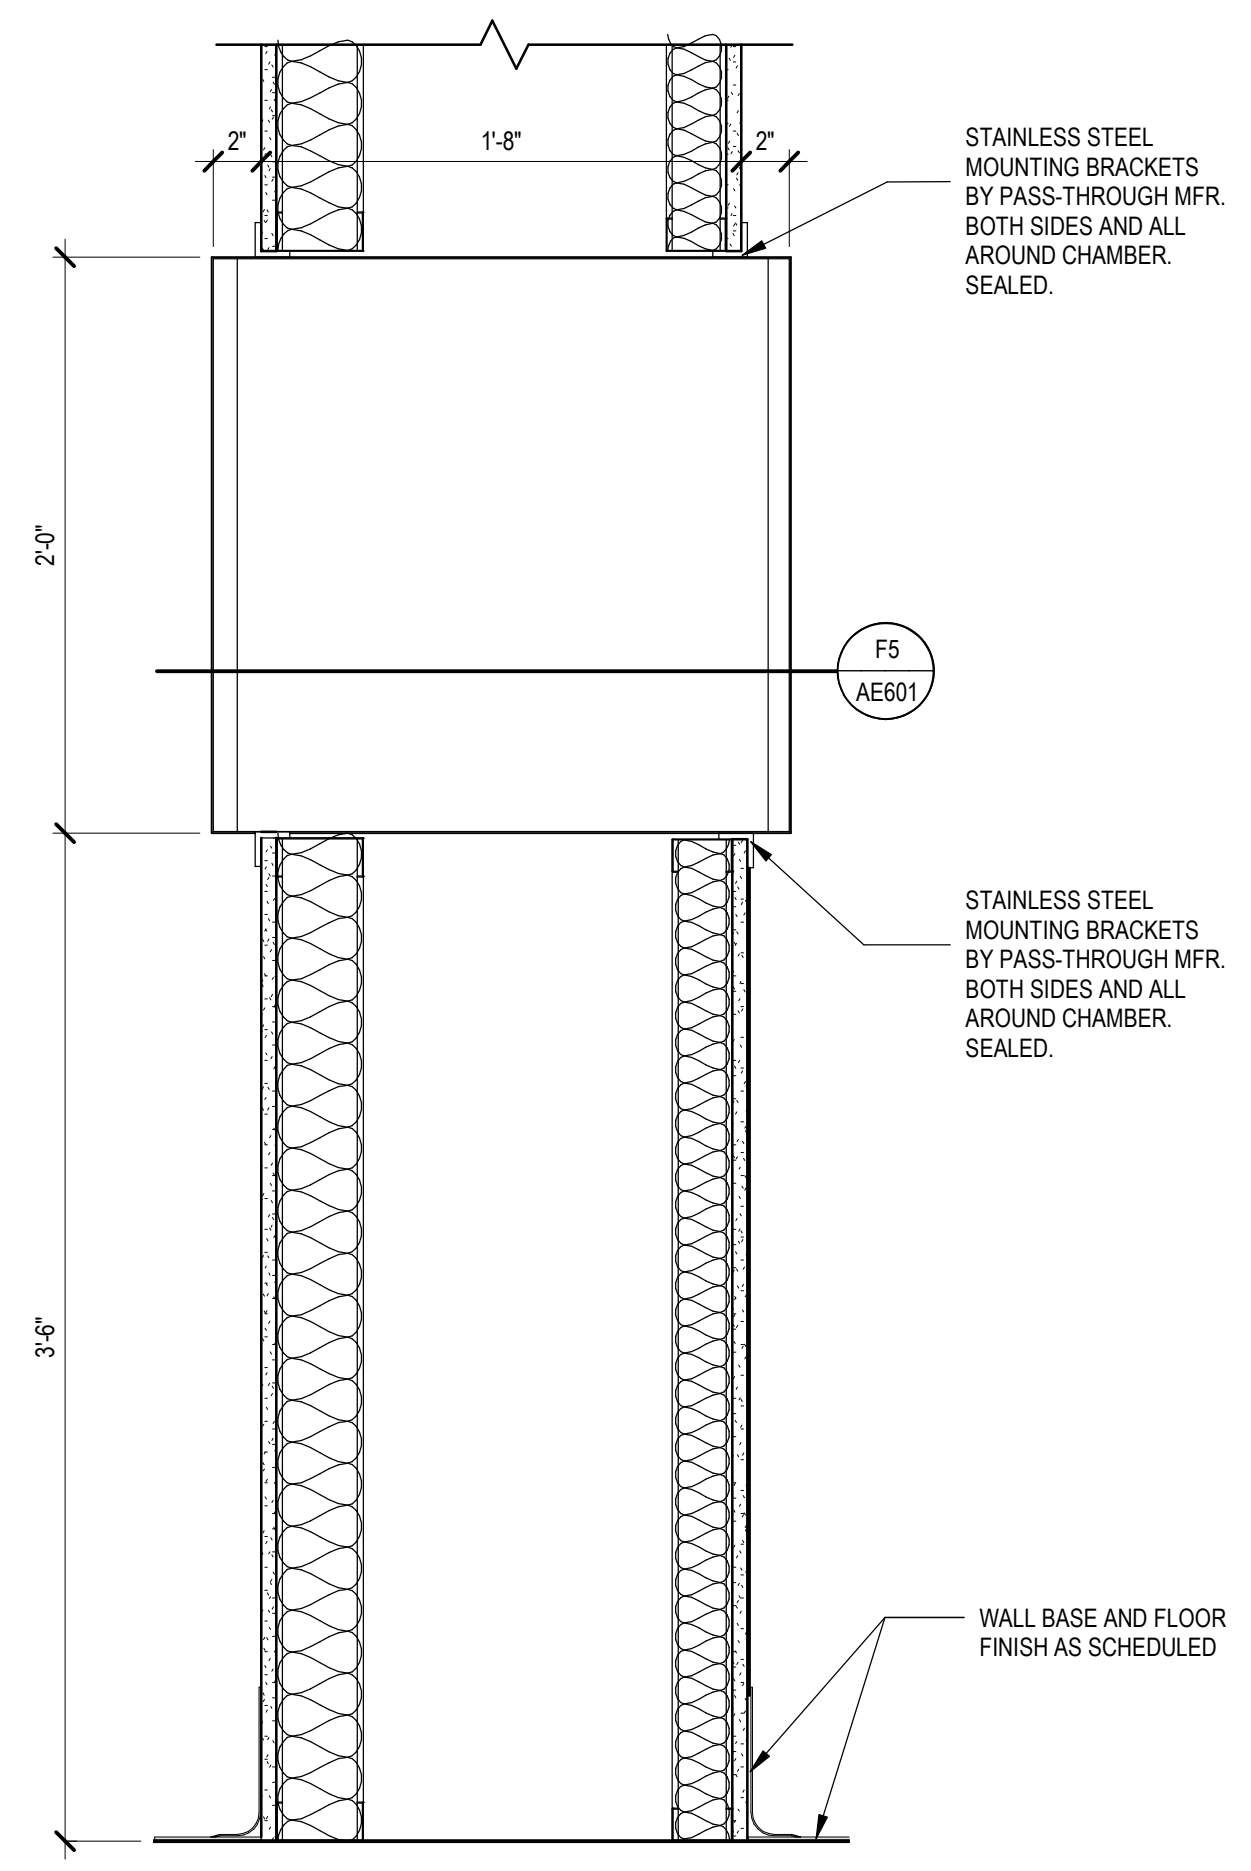

**F3 SECTION DETAIL - PASS THROUGH**  
1 1/2" = 1'-0"

**F5 PLAN DETAIL - PASS THROUGH**  
1 1/2" = 1'-0"

**F7 COVE BASE DETAIL, TYP**  
3" = 1'-0"

Revision#	Description	Date:

**CONSULTANTS**

MECHANICAL / ELECTRICAL / PLUMBING:  
**DUNHAM**  
52 South Sixth Street, Suite 1100  
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**ARCHITECT OF RECORD**

A/E:  
Stone Group Architects  
600 E 7th Street  
Sioux Falls, SD 57103  
605-271-1144

**STONE GROUP ARCHITECTS**

**STAMP**

Office of Construction and Facilities Management  
**VA** U.S. Department of Veterans Affairs

Drawing Title  
**DOOR SCHEDULE AND DETAILS**

Approved:

Phase  
**BID SET**

Project Title  
**UPGRADE PHARMACY 797**

Location  
**SIOUX FALLS, SOUTH DAKOTA**

Issue Date  
02/10/2021

Checked  
TRS

Drawn  
DAN

Project Number  
**VA #438-20-109 SGA #201927**

Building Number  
**5**


Drawing Number  
**AE601**

**GENERAL FLOOR FINISH NOTES:**

- A. ANY DISCREPANCIES OR CONFLICTS FOUND IN THE VARIOUS PARTS OF THE CONSTRUCTION DOCUMENTS SHALL BE BROUGHT TO THE ATTENTION OF THE ARCHITECT AND THE OWNER BEFORE PROCEEDING WITH THE WORK.
- B. FINISH SCHEDULES DENOTE FINISHES THROUGHOUT THE PROJECT. FOR LOCATIONS REFER TO THE FINISH FLOOR PLAN, ROOM FINISH SCHEDULES, REFLECTED CEILING PLANS, AND INTERIOR ELEVATIONS.
- C. SOME SPECIFIED PRODUCTS AND FINISHES MAY HAVE SUBSTANTIAL LEAD TIMES. THE CONTRACTOR SHALL BE RESPONSIBLE FOR PLACING ORDERS IN A MANNER TO ENSURE THEIR TIMELY ARRIVAL. THE CONTRACTOR SHALL BE RESPONSIBLE FOR EXPENSES, INCLUDING DESIGN FEES, RELATED TO ANY RESELECTIONS REQUIRED DUE TO FAILURE TO ORDER PRODUCTS IN A TIMELY MANNER.
- D. ALL FINISH WORK SHALL BE PERFORMED IN COMPLIANCE WITH DRAWINGS AND SPECIFICATIONS. SHOP DRAWINGS, SAMPLES AND PRODUCT DATA SHALL BE SUBMITTED TO THE ARCHITECT FOR THEIR REVIEW PRIOR TO BEGINNING WORK.
- E. WOOD DOORS, FRAME BASE MOLDINGS TO BE FILLED, STAINED, SEALED AND SHOP FINISHED TO MATCH ARCHITECT'S SAMPLE. WORK SHOULD BE PERFORMED IN A DUST FREE ENVIRONMENT.
- F. ALL HOLLOW METAL DOOR FRAMES TO BE PAINTED PT-2, (UON)
- G. EXTEND ALL FLOORING UNDER FURNITURE, DESKS, COUNTERTOPS AND ETC. (UON)
- H. PROVIDE TRANSITION STRIPS AT ALL LOCATIONS THAT HAVE A CHANGE IN FLOORING MATERIALS. REFER TO TYPICAL TRANSITION STRIP DETAILS FOR APPROVED TRANSITION STRIPS. ALL TRANSITIONS TO BE CENTERED UNDER DOORS IN A CLOSED POSITION, (UON). CONTRACTOR IS RESPONSIBLE FOR VERIFYING APPROPRIATE SIZES OF TRANSITION STRIPS BASED ON MATERIAL TYPES.
- I. ALL SCHLUTER TRANSITION STRIPS TO BE INSTALLED PER MANUFACTURER'S RECOMMENDATIONS.
- J. VERIFY GROUT AND MORTAR THICKNESS PER MANUFACTURER'S RECOMMENDATIONS.
- K. FLOOR FINISH LEGEND HATCHES INDICATE FLOORING TYPES, NOT ACTUAL FLOORING PATTERN AND LAYOUT. (UON)
- L. FOR FLOOR PATTERN INSTALL DIRECTION REFER TO THE INSTALLATION SYMBOL.
- M. CORNER GUARDS TO BE SUPPLIED AND INSTALLED BY CONTRACTOR.
- N. IF EXISTING CORNER GUARDS ARE DAMAGED DURING CONSTRUCTION, REPLACE WITH NEW CORNER GUARDS.
- O. VERIFY ALL CORNER GUARD HEIGHTS. INSTALL CORNER GUARDS AT ALL EXPOSED OUTSIDE CORNERS OF GYPSUM BOARD WALLS. (UON)
- P. METAL L-BRACKETS TO BE PAINTED TO MATCH WALL COLOR.
- Q. CONTRACTOR IS TO PROTECT THE EXISTING FLOORING IN ROOM B92 AND PATCH AND SEAL AS REQUIRED TO MATCH EXISTING.

**GENERAL CASEWORK NOTES:**

- A. ANY DISCREPANCIES OR CONFLICTS FOUND IN THE VARIOUS PARTS OF THE CONSTRUCTION DOCUMENTS SHALL BE BROUGHT TO THE ATTENTION OF THE ARCHITECT AND THE OWNER BEFORE PROCEEDING WITH THE WORK.
- B. COORDINATE DEVICE PENETRATIONS AT COUNTERTOPS W/ MECHANICAL & ELECTRICAL.
- C. PROVIDE COUNTERTOP SUPPORTS AT ALL OPEN SPACES APPROXIMATELY 3'-0" O.C. BRACKETS TO BE PAINTED TO MATCH SPECIFIED WALL FINISH.
- D. PROVIDE FINISHED END PANELS AT ALL EXPOSED MILLWORK SURFACES. ALL PLAM CABINETS TO HAVE PVC EDGES. MATCH PVC EDGE TO PLAM. SUBMIT SAMPLES FOR APPROVAL.
- E. PROVIDE 1" RESILIENT BASE AT ALL BASE CABINETS (UON).
- F. MILLWORK SUPPLIER SHALL PROVIDE FILLER PANELS & SCRIBE STRIPS WHERE NEEDED FOR COMPLETE INSTALLATION.
- G. CABINETS OVER 30" WIDE SHALL HAVE 1" THICK PARTICULATE BOARD CORE.
- H. DO NOT PROVIDE SIDESPLASH UNLESS OTHERWISE NOTED.
- I. UNLESS OTHERWISE INDICATED, PROVIDE PRODUCTS OF QUALITY SPECIFIED BY AWI ARCHITECTURAL WOODWORK QUALITY STANDARDS FOR PREMIUM GRADE.
- J. INSTALL BLOCKING AS REQUIRED IN ALL PARTITIONS TO RECEIVE COUNTERS, SHELVING, MARKERBOARDS, ETC.
- K. VERIFY ALL GROMMET LOCATIONS AND COUNT WITH OWNER.
- L. PROVIDE STAINLESS STEEL (18" PER SIDE) BEHIND HOOD. REFER TO DRAWINGS FOR LOCATIONS.
- M. FINISHES SCHEDULE PROVIDED BY OWNER.
- N. ALL OWNER FURNISHED EQUIPMENT TO BE CONTRACTOR INSTALLED WITH --- PRIOR TO INSTALL.

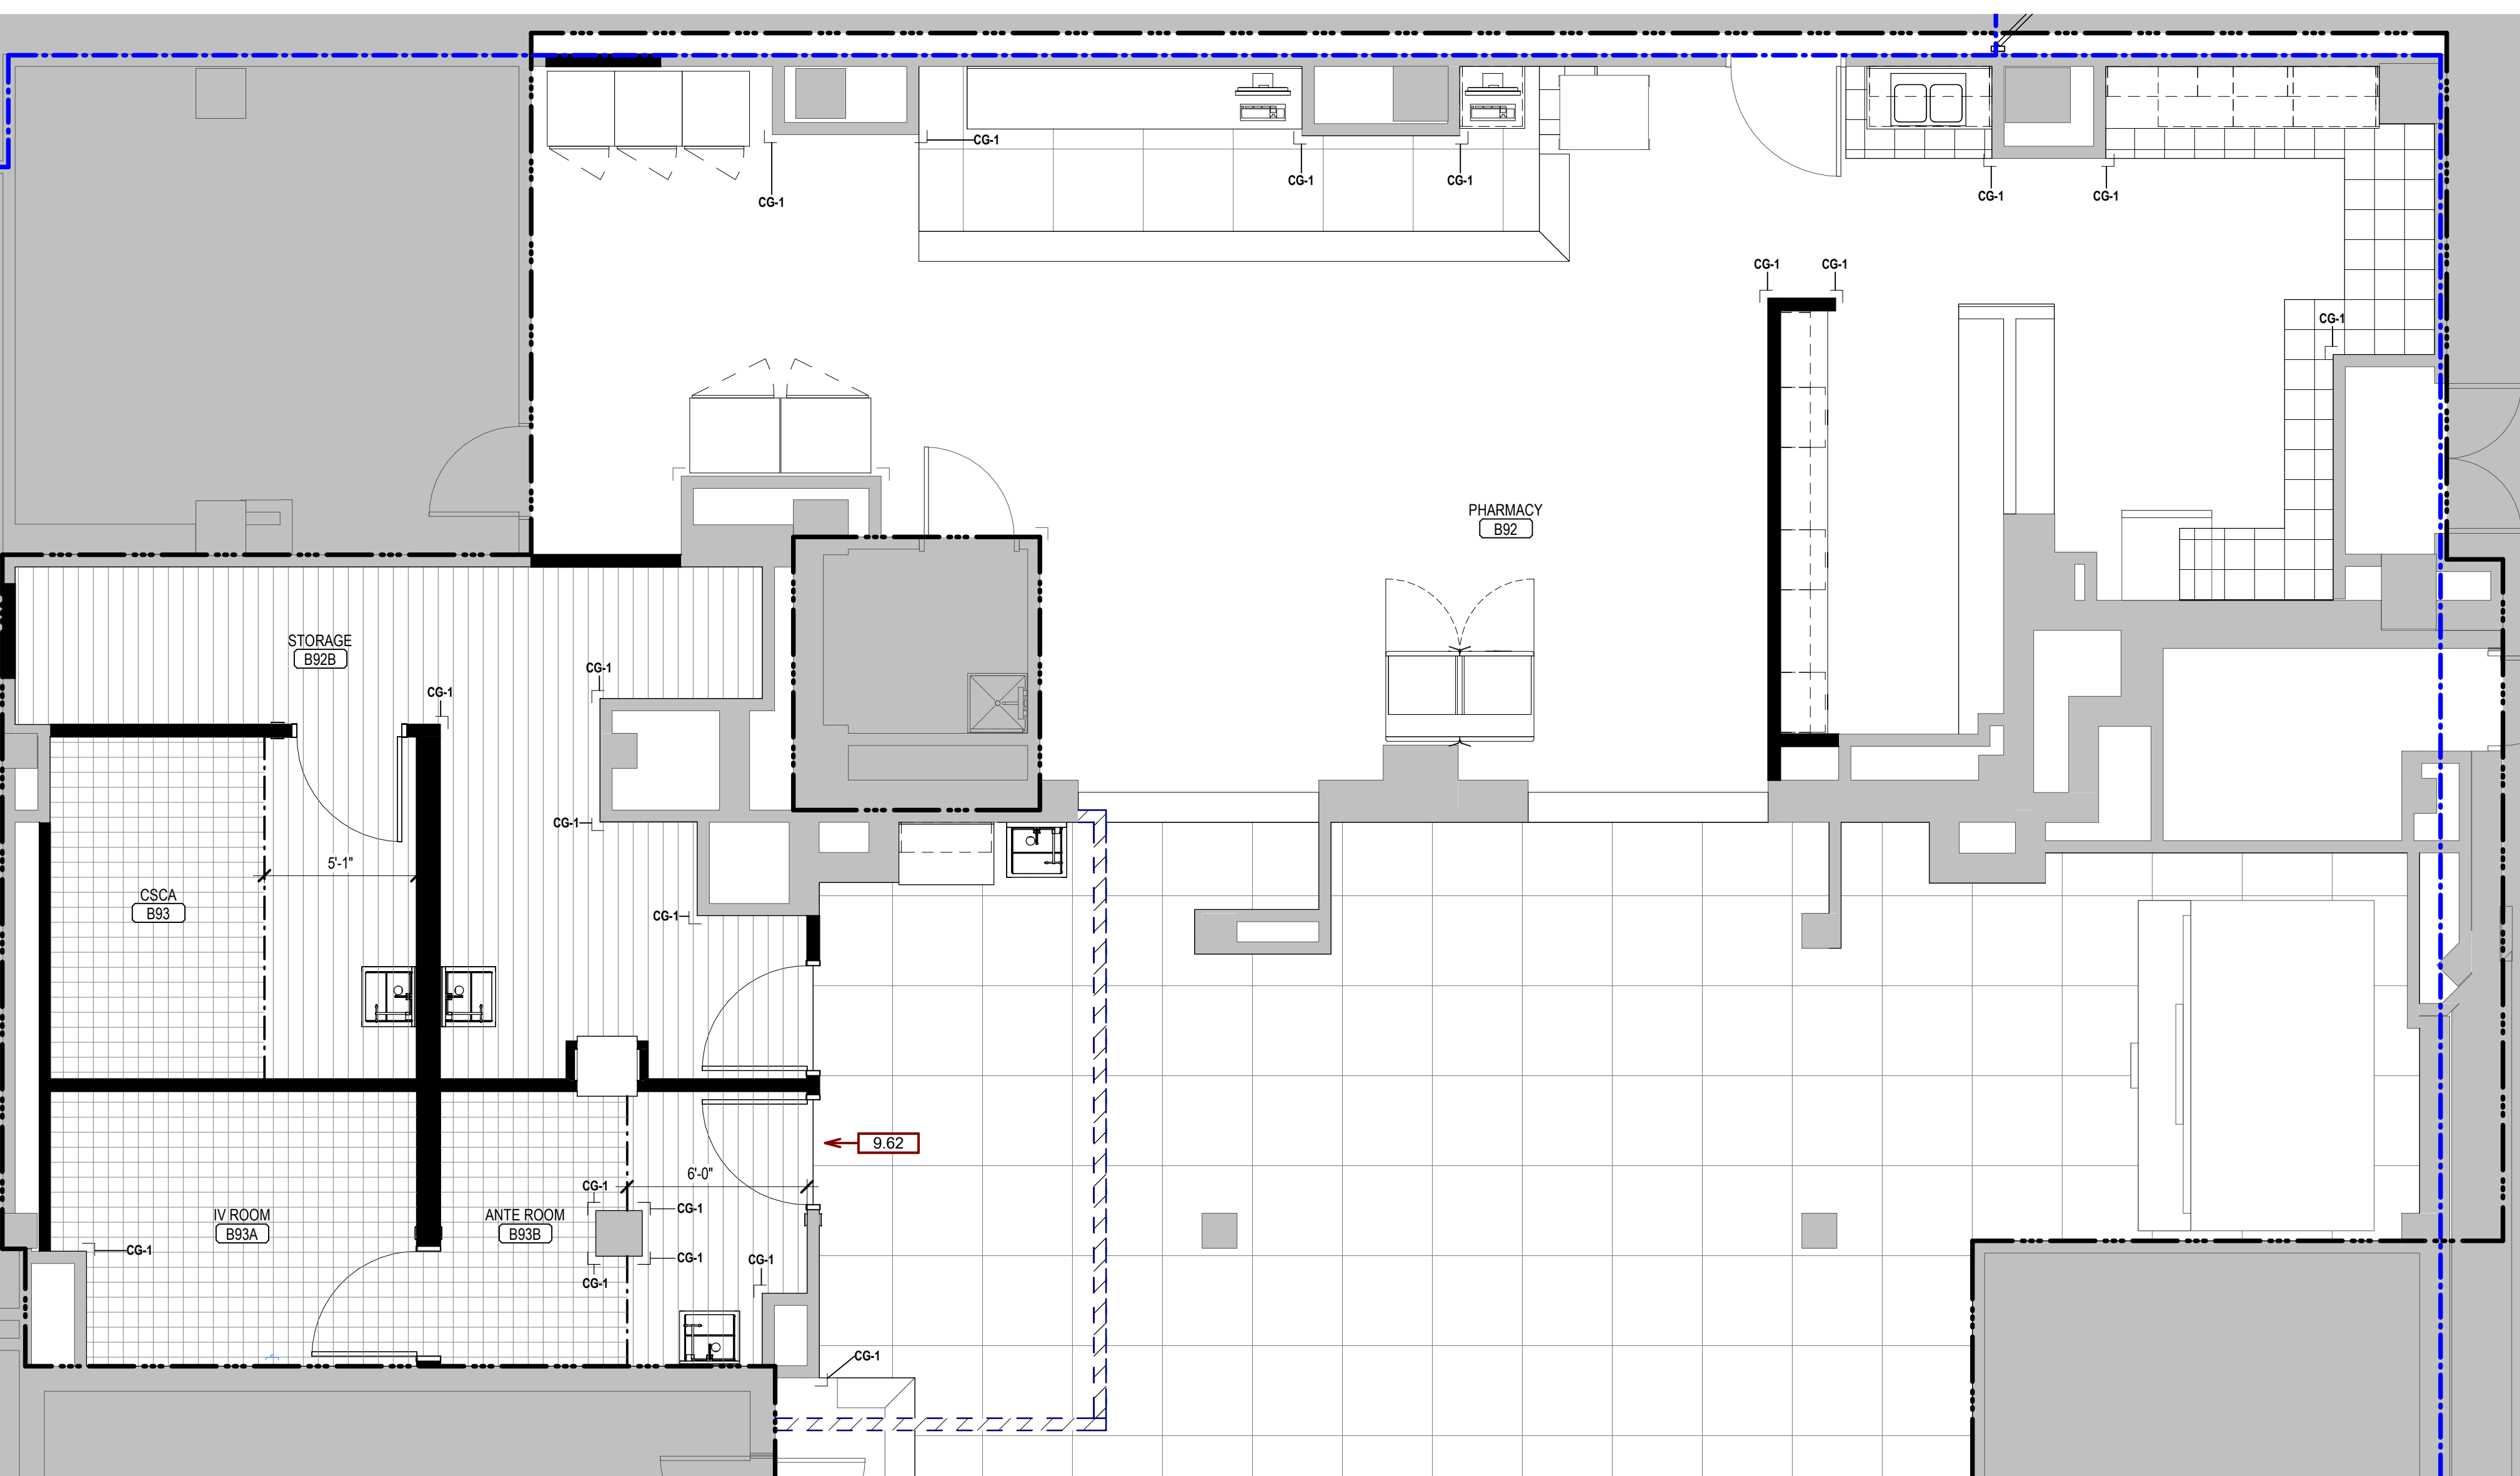


COLOR AND MATERIAL SCHEDULE										
ABBR	Material	Manufacturer	Number	Style Name	Color Name	Size	Texture	Installation Notes	Location	Finish
06 4100 - ARCHITECTURAL WOOD CASEWORK										
PLAM-1	Plastic Laminate	Formica			8626 Neutral Twill		Matte			Casework
06 6100 - SIMULATED STONE FABRICATIONS										
SS-1	Solid Surface	LG Hi-Macs			M 562 Shadow Concrete	1.25"				Countertops
SS-2	Solid Surface	LG Hi-Macs			M 322 Shadow Concrete	5/8"				Countertops
08 1416 - FLUSH WOOD DOORS										
WDR-1	Impact Resistant Doors	Azrolyn	SCL5-NR		1352 Fossil Teak			Match existing size to current frame; use existing hardware		
09 5100 - ACOUSTICAL CEILINGS										
ACT-1	Acoustical Ceiling Tile	Armstrong		Cortega, 15/16" Square Edge	704 White	24" x 24"				See RCP sheets.
09 6500 - RESILIENT FLOORING										
CB-1	Cove Base	Inpro		Use the appropriate style for specified flooring	304 Stainless Steel	6 1/8"				Rooms requiring integral wall base and watertight finish
RF-1	Rubber Flooring	Flaxco		Evolving Styles Creative Elements	CE-125 Light Gray	Sheet, 3.2 mm	Smooth	Weld with recommended color match by manufacturer		Clean Space
RF-2	Rubber Flooring	Flaxco		Evolving Styles Creative Elements	CE-143 Charcoal With Black Pebble	Sheet, 3.2 mm		Weld with recommended color match by manufacturer		Dirty Space
RF-3	Resilient Floor Transition	Johnsonite	CTA-XX	Rolling Traffic Transitions	32			Use where different flooring materials meet, and stainless steel cannot be installed		Rubber
TRIM-3	Metal Trim	Schluter Systems	Reno-U		Stainless Steel			Installer to verify		Sloped floor transitions
TRIM-4	Metal Trim	Schluter Systems	Schene		Stainless Steel			Installer to verify		Same height floor transitions
TRIM-5	Metal Trim	Schluter Systems	Reno-Ramp-K		Satin Anodized Aluminum			Installer to verify		
09 9000 - PAINTING AND COATINGS										
P-1	Paint	Diamond Vogel		Zero Plus 0 VOC Interior Latex	0210 Hidden Cove					Main Paint Color
P-2	Paint	Shenwin Williams	B66W 851	Pro Industrial	0218 DV Drilling Sand					Door Frames
SC-1	Specialty Glazed Coatings	Shenwin Williams	B73W0311	Pro Industrial Water Based Epoxy	0210 Hidden Cove					Walls
SC-2	Specialty Glazed Coatings	Shenwin Williams	B73W0311	Pro Industrial Water Based Epoxy	SW7007 Ceiling Bright					Ceilings
10 2600 - WALL AND CORNER GUARDS										
CG-1	Corner Guards	Pwlling	CG-51-8		Stainless Steel	2" W x .059" thick	#4 Satin	Install above wall base to ceiling		Corners as noted on the plans.
RWP-1	Rigid Vinyl Wall Protection	Inpro	406	Palladium Rigid Vinyl Wall Protection	0119 Pepperdust	4" x 8' sheets, 660 thick	Velvet	Install using rigid sheet trim between panels and corners; top of RWP with RWP-2		
RWP-2	Horizontal Top Cap Board	Inpro	P-3DHTC2	Palladium 3-D Horizontal Top Cap Board	0119 Pepperdust	2" H x 8' L x 1/2" Thick		Top edge trim board at RWP-1		Parks & Rec

ROOM FINISH SCHEDULE									
ROOM NUMBER	ROOM NAME	FLOOR	BASE	WALLS				CEILING	ID FINISH REMARKS
				NORTH	EAST	SOUTH	WEST		
B92	PHARMACY			P-1	P-1	P-1	P-1	ACT	EXISTING FLOORING. PATCH AS REQUIRED TO MATCH EXISTING
B92B	STORAGE	RF-2	CB-1	SC-1, RWP-1/RWP-2	SC-1, RWP-1/RWP-2	SC-1, RWP-1/RWP-2	SC-1, RWP-1/RWP-2	SC-2	
B93	CSCA	RF-1RF-2	CB-1	SC-1	SC-1	SC-1	SC-1	SC-2	SEE FINISH PLAN
B93A	IV ROOM	RF-1	CB-1	SC-1	SC-1	SC-1	SC-1	SC-2	
B93B	ANTE ROOM	RF-1RF-2	CB-1	SC-1	SC-1	SC-1	SC-1	SC-2	SEE FINISH PLAN

ABBREVIATIONS	
PT, G.W.B. =	PAINT GYPSUM WALLBOARD
ACT - # =	SUSPENDED ACT CEILING SYSTEM
G.W.B. =	GYPSUM WALLBOARD
YVC =	VINYL WALL COVERING
RF =	RUBBER FLOORING
VB =	VINYL BASE
VCT =	VINYL COMPOSITE TILE

- NOTES**
- G.W.B. CONTROL JOINTS SHALL BE INSTALLED PER THE LATEST EDITION OF GA-216 AND ASTM C840 UNLESS NOTED OTHERWISE.
  - JOINTS IN FLOORING TILE SHOULD MATCH UP WITH JOINTS IN CONC. SLABS AND ADDITIONAL JOINTS TO BE CUT IF NECESSARY. VERIFY WITH ARCHITECT.
  - CORNER GUARDS AT ALL OUTSIDE CORNERS IN PUBLIC SPACES, TYP. (SEE COLOR & MATERIAL SCHEDULE).
  - SEE FLOOR COVERING PLANS FOR FLOOR PATTERNS.
  - ALL INTERIOR G.W.B. WALLS AND CEILINGS SHALL RECEIVE A LEVEL 3 FINISH WITH LIGHT ORANGE PEEL TEXTURE U.O.N.
  - FLOOR MATERIAL TRANSITIONS SHALL OCCUR @ CENTER OF DOOR, TYP.
  - SEE INTERIOR SIGNAGE DETAIL FOR SIGNAGE LOCATION.

FINISH PLAN LEGEND	
	RUBBER FLOORING - CLEAN (RF-1)
	RUBBER FLOORING - DIRTY (RF-2)
	OWNER FURNISHED, CONTRACTOR INSTALLED (OFCI)
	CORNER GUARD (CG-1)

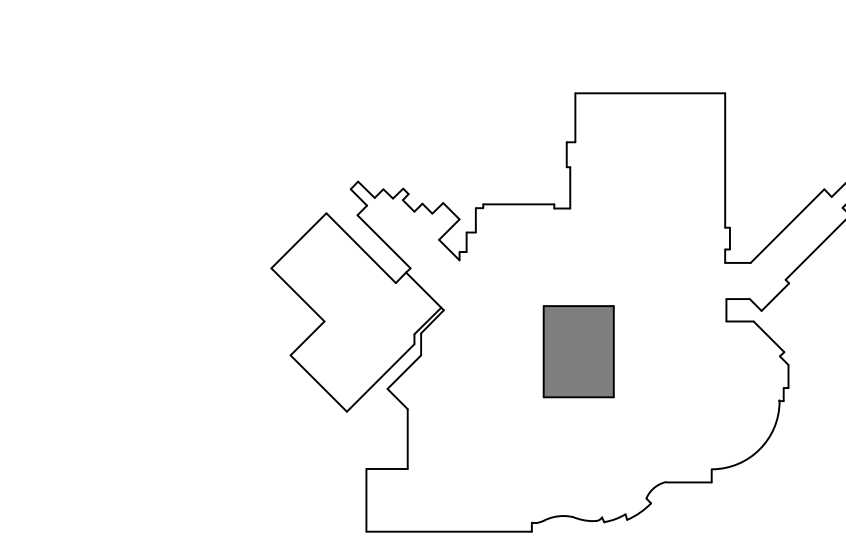

**F1 ENLARGED FINISH PLAN**  
1/4" = 1'-0"

Revision#	Description	Date:

**CONSULTANTS**


MECHANICAL / ELECTRICAL / PLUMBING:  
**DUNHAM**  
22 South Sixth Street, Suite 1100  
Minneapolis, MN 55402  
Phone: 612-465-7550

STRUCTURAL:  
**ERA**  
ERICKSEN ROAD  
A DIVISION OF  
**ERICKSEN ROAD & ASSOCIATES**  
2501 University Avenue West, Suite 201-S  
Saint Paul, MN 55114  
Phone: 651-251-7570

**ARCHITECT OF RECORD**

A/E:  
**Stone Group Architects**  
600 E 7th Street  
Sioux Falls, SD 57103  
605-271-1144

**STONE GROUP ARCHITECTS**

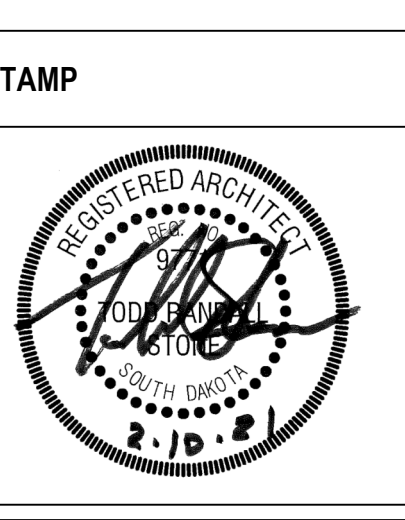

**Office of Construction and Facilities Management**

**VA** U.S. Department of Veterans Affairs

Drawing Title  
**FINISH PLAN AND SCHEDULE**

Approved: \_\_\_\_\_

Phase  
**BID SET**

Project Title  
**UPGRADE PHARMACY 797**

Location  
**SIoux FALLS, SOUTH DAKOTA**

Issue Date  
02/10/2021

Checked  
TRS

Drawn  
DAN

Project Number  
**VA #438-20-109 SGA #201927**

Building Number  
**5**

Drawing Number  
**AF101**

MECHANICAL ABBREVIATIONS			
AD	AREA DRAIN	ISO	ISOLATION EXHAUST
A.F.F.	ABOVE FINISHED FLOOR	KW	KILOWATT
AFMS	AIR FLOW MEASURING STATION	LAT	LEAVING AIR TEMPERATURE
AHU	AIR HANDLING UNIT	LAV	LAVATORY
ANB	ACID NEUTRALIZING BASIN	LWT	LEAVING WATER TEMPERATURE
AP	ACCESS PANEL	MBH	BTU PER HOUR (THOUSANDS)
ARCH	ARCHITECT	MGF	THOUSAND CUBIC FEET
AS	AIR SEPARATOR	MH	MANHOLE
BD	BUTTERFLY DAMPER	NC	NOISE CRITERIA OR NORMALLY CLOSED
B/G	BELOW GRADE	NEG	NEGATIVE
BTU	BRITISH THERMAL UNIT	NIC	NOT IN CONTRACT
BWV	BACKWATER VALVE	NO	NORMALLY OPEN
CCF	HUNDRED CUBIC FEET	NTS	NOT TO SCALE
CFH	CUBIC FEET PER HOUR	OA	OUTSIDE AIR
CFM	CUBIC FEET PER MINUTE	OBD	OPPOSED BLADE DAMPER
CL	CENTER LINE	ORD	OVERFLOW ROOF DRAIN
CLG	CEILING	PD	PRESSURE DROP OR DIFFERENCE
CO	CLEAN OUT	PE	PNEUMATIC-ELECTRIC
CONTR	CONTRACTOR	PLBG	PLUMBING
CONV	CONVECTOR	PRV	PRESSURE REDUCING VALVE OR POWER ROOF VENTILATOR
CUH	CABINET UNIT HEATER	PSIA	POUNDS/SQ INCH ABSOLUTE
CW	COLD WATER	PSIG	POUNDS/SQ INCH GAUGE
DB	DECIBEL	PVC	POLY VINYL CHLORIDE
DF	DRINKING FOUNTAIN	RA	RETURN AIR
DIA	DIAMETER	RCP	REINFORCED CONCRETE PIPE
DIFF	DIFFUSER	RD	ROOF DRAIN
DISCH	DISCHARGE	RECIRC	RECIRCULATING
DMPR	DAMPER	REG	REGISTER
DN	DOWN	RET	RETURN
DR	DRAIN	RH	RELATIVE HUMIDITY
DS	DOWNSPOUT	RHT	REHEAT
DWG	DRAWING	RHC	REHEAT COIL
EAT	ENTERING AIR TEMPERATURE	RHW	RECIRCULATED HOT WATER
EDR	EQUIVALENT DIRECT RADIATION	RLF	RELIEF
EP	ELECTRIC-PNEUMATIC	RM	ROOM
EWC	ELECTRIC WATER COOLER	RPM	REVOLUTIONS PER MINUTE
EWT	ENTERING WATER TEMPERATURE	RS	REDUCED ZONE BACKFLOW PREVENTER
EXH	EXHAUST	SA	SUPPLY AIR
EXP	EXPANSION	SAN	SANITARY
F	FAHRENHEIT	SCFM	CFM, STANDARD CONDITIONS
FC	FAN COIL	SD	SMOKE DAMPER
FCO	FLOOR CLEAN OUT	SP	STATIC PRESSURE
FD	FLOOR DRAIN	SPCS	SPECIFICATIONS
FHC	FIRE HOSE CABINET	SUP	SUPPLY
FHR	FIRE HOSE RACK	SQ	SQUARE
FLR	FLOOR	STM	STEAM
FLEX	FLEXIBLE	TD	TEMPERATURE DIFFERENCE
FM	FIRE MAIN	TEMP	TEMPERATURE
FPM	FEET PER MINUTE	TONS	TONS OF REFRIGERATION
FPS	FEET PER SECOND	T-STAT	THERMOSTAT
FT	FEET OR FOOT	TY	TYPICAL
F&T	FLOAT AND THERMOSTATIC	UB	UP-BLAST
FTG	FOOTING	UG	UNDERGROUND
FTR	FINNED TUBE RADIATION	UH	UNIT HEATER
FV	FACE VELOCITY	UR	URINAL
GA	GAUGE	V	SANITARY VENT
GAL	GALLON	VAV	VARIABLE AIR VOLUME
GEXH	GREASE EXHAUST	VD	VOLUME DAMPER
GPH	GALLONS PER HOUR	VEL	VELOCITY
GPM	GALLONS PER MINUTE	VFD	VARIABLE FREQUENCY DRIVE
GR	GRILLE	VOL	VOLUME
HB	HOSE BIBB	VTR	VENT THROUGH ROOF
HD	HEAD	W	SANITARY WASTE
HOA	HANDS-OFF-AUTOMATIC	W/	WITH
HTG	HEATING	W/O	WITHOUT
HTR	HEATER	WC	WATER CLOSET
HVAC	HEATING, VENTILATION, AND AIR CONDITIONING	WCO	WALL CLEANOUT
HYD	HYDRANT	WH	WALL HYDRANT
HW	HOT WATER	WTR	WATER
GCO	GRADE CLEANOUT		
INSUL	INSULATION		
INV	INVERT		

PLUMBING	
AV	ACID VENT BELOW GRADE
AV	ACID VENT ABOVE GRADE
AW	ACID WASTE BELOW GRADE
AW	ACID WASTE ABOVE GRADE
DI	DEIONIZED WATER
CW	DOMESTIC COLD WATER
CWV	CLEAR WATER VENT
CWW	CLEAR WATER WASTE
FW	FILTERED WATER
GW	GREASE WASTE
HW	DOMESTIC HOT WATER
140 RHW	DOM. RECIRC. HOT WATER (TEMP. INDICATED)
RHW	DOMESTIC RECIRC. HOT WATER
HARD	HARD COLD WATER
NPCW	NON-POTABLE COLD WATER
NPHW	NON-POTABLE HOT WATER
OSD	OVERFLOW STORM DRAIN BELOW GRADE
OSD	OVERFLOW STORM DRAIN ABOVE GRADE
R	REVERSE OSMOSIS WATER
V	SANITARY VENT BELOW GRADE
V	SANITARY VENT ABOVE GRADE
W	SANITARY WASTE
SS	SANITARY SEWER
SDT	SOIL DRAINAGE TILE
SOFT	SOFTENED COLD WATER
SHW	SOFTENED HOT WATER
TW	TEMPERED WATER
SD	STORM DRAIN BELOW GRADE
SD	STORM DRAIN ABOVE GRADE
WW	WELL WATER
-----	EXISTING PLUMBING TO BE REMOVED

MECHANICAL PIPING	
BF	BOILER FEED
CWS	CHILLED WATER SUPPLY
CWR	CHILLED WATER RETURN
10#A	COMPRESSED AIR (PSI INDICATED)
CD	CONDENSATE DRAIN
CS	CONDENSER WATER SUPPLY
CR	CONDENSER WATER RETURN
FOS	FUEL OIL SUPPLY
FOR	FUEL OIL RETURN
FOV	FUEL OIL VENT
FOF	FUEL OIL FILL
GS	GLYCOL SUPPLY
GR	GLYCOL RETURN
HRS	HEAT RECOVERY SUPPLY
HRR	HEAT RECOVERY RETURN
HWS	HEATING WATER SUPPLY
HWR	HEATING WATER RETURN
IG	INTERRUPTIBLE GAS
LV	LABORATORY VACUUM
LA	LABORATORY AIR
LPG	LIQUIFIED PETROLEUM GAS
2#G	NATURAL GAS (PSI INDICATED)
PV	PLANT VACUUM
PC	PUMPED CONDENSATE
RADS	RADIATION WATER SUPPLY
RADR	RADIATION WATER RETURN
RL	REFRIGERANT LIQUID
RS	REFRIGERANT SUCTION
RHG	REFRIGERANT HOT GAS BYPASS
RHS	REHEAT WATER SUPPLY
RHR	REHEAT WATER RETURN
RRS	REMOTE RADIATOR SUPPLY
RRR	REMOTE RADIATOR RETURN
SHWS	SECONDARY HEATING WATER SUPPLY
SHWR	SECONDARY HEATING WATER RETURN
SMS	SNOW MELT SUPPLY
SMR	SNOW MELT RETURN
10#STM	STEAM SUPPLY (PSI INDICATED)
10#R	STEAM RETURN (PSI INDICATED)
-----	EXISTING PIPING TO REMAIN
-----	EXISTING PIPING TO BE REMOVED

PLUMBING / PIPING	
ELBOW DOWN	ELBOW UP
TEE, OUTLET UP	TEE, OUTLET DOWN
CONNECTION, BOTTOM	CONNECTION, TOP
ECCENTRIC REDUCER	CONCENTRIC REDUCER
FLEXIBLE CONNECTION	EXPANSION JOINT
PIPE ANCHOR	ALIGNMENT GUIDE
CHECK VALVE	SHUTOFF VALVE
PLUG VALVE	COMBINATION BALANCE VALVE AND FLOW METER
STRAINER	STRAINER
PRESSURE REDUCING VALVE (SETTING AS NOTED, PSI)	AUTOMATIC CONTROL VALVE, 2-WAY
AUTOMATIC CONTROL VALVE, 3-WAY	AUTOMATIC AIR VENT
MANUAL AIR VENT	PRESSURE RELIEF/SAFETY VALVES (SETTING AS NOTED, PSI)
DRAIN VALVE	BALL VALVE
BUTTERFLY VALVE	DIAPHRAGM
GLOBE ANGLE VALVE	SOLENOID VALVE
0, S & Y, VALVE	FLOW LIMITING VALVE
REFRIGERANT SIGHT GLASS	REFRIGERANT SIGHT GLASS
GLLOBE VALVE	GLYCOL VALVE
GAS PRESSURE REGULATOR VALVE	BACKWATER VALVE
REFRIGERANT DRYER	FLOW DIRECTION
FLOW DIRECTION	FLOW DIRECTION W/PITCH
DUPLEX STRAINER	PIPE UNION
PIPE FLANGE	PUMP
PRESSURE GAUGE W/P/PTAIL & PETCOCK	THERMOMETER
STEAM TRAP (TYPE INDICATED)	FLOW MEASURING STATION (FLOW INDICATED)
GPM	FLOW SWITCH
FLOW SWITCH	PRESSURE SWITCH
SHOCK ABSORBER	GAS COCK VALVE
ELBOW	TEE
FLOOR DRAIN	FLOOR SINK
WALL HYDRANT	HOSE BIBB
CLEANOUT	WALL CLEANOUT
ROOF DRAIN	DRAIN ABOVE
CATCH BASIN	MANHOLE

DUCTWORK	
SUPPLY AIR	RETURN AIR
EXHAUST AIR	STANDARD BRANCH, NO SPLITTER - SUPPLY FLOW TO RIGHT - RETURN/EXHAUST FLOW TO LEFT
BELLMOUTH WITH BALANCING DAMPER	FLEXIBLE DUCT
TURNING VANES	FLEXIBLE CONNECTION
MANUAL VOLUME DAMPER	MOTORIZED DAMPER
FIRE DAMPER & ACCESS PANEL	SMOKE DAMPER & ACCESS PANEL
COMBINATION FIRE/SMOKE DAMPER & ACCESS PANEL	SUPPLY GRILLE OR REGISTER
RETURN OR EXHAUST GRILLE OR REGISTER	SUPPLY DUCT UP, POSITIVE PRESSURE
RETURN DUCT UP, NEGATIVE PRESSURE	EXHAUST DUCT UP, NEGATIVE PRESSURE
SUPPLY DUCT DN, POSITIVE PRESSURE	RETURN DUCT DN, NEGATIVE PRESSURE
EXHAUST DUCT DN, NEGATIVE PRESSURE	SUPPLY DIFFUSER/REGISTER BLANKOFF INDICATED
RETURN GRILLE/REGISTER	EXHAUST GRILLE/REGISTER
LINEAR DIFFUSER	CONCENTRIC DUCT TRANSITION
ECCENTRIC DUCT TRANSITION	RECTANGULAR-TO-ROUND DUCT TRANSITION
VAV BOX	VAV BOX W/REHEAT COIL
REHEAT COIL	DUCT OFFSETS
DUCT OFFSETS	DUCT CUTLINE

ANNOTATION	
QUANTITY	TYPE
SIZE	CFM
CFM	ACTIVE ELEMENT LENGTH
ACTIVE ELEMENT LENGTH	HYDRONIC FINNED TUBE RADIATION & RADIANT PANEL IDENTIFICATION
ACTIVE ELEMENT LENGTH	ELECTRIC BASEBOARD RADIATION IDENTIFICATION
DETAIL NUMBER	SHEET NUMBER
SECTION NUMBER	SHEET NUMBER
EQUIP DESIGNATION	EQUIP NUMBER
POINT OF CONNECTION, NEW TO EXISTING	POINT OF DISCONNECTION

MEDICAL GAS	
MV	MEDICAL VACUUM
WAGD	WASTE ANESTHETIC GAS DISPOSAL
CO2	CARBON DIOXIDE
O	OXYGEN
N	NITROGEN
N2O	NITROUS OXIDE
MA	MEDICAL AIR
IA	INSTRUMENT AIR
ZVB	ZONE VALVE BOX
AAP	AREA ALARM PANEL
MAP	MASTER ALARM PANEL
CAP	COMBINATION AREA/MASTER ALARM PANEL

PROCESS AND LABORATORY	
LA	LABORATORY AIR
LV	LABORATORY VACUUM
CDA	CLEAN DRY AIR
RO	REVERSE OSMOSIS
DI	DEIONIZED WATER
N	NITROGEN
HV	HOUSE VACUUM
PV	PLANT VACUUM
AV	ACID VENT
AW	ACID WASTE

FIRE PROTECTION	
F	FIRE PROTECTION
DFP	FIRE PROTECTION (DRY SYSTEM)
PIV	POST INDICATOR VALVE (PIV)
FDVFC	FIRE HYDRANT WITH SHUTOFF VALVE
FDVGC	RECESSED FIRE DEPT CABINET
FDVGC	SURFACE MOUNTED FIRE DEPT CABINET
FR	FIRE PROTECTION RISER
US	UPRIGHT SPRINKLER HEAD W/GUARD
PS	PENDANT SPRINKLER HEAD
US	UPRIGHT SPRINKLER HEAD
SS	SIDEWALL SPRINKLER HEAD
TS	BUTTERFLY VALVE W/TAMPER SWITCH
DC	DETECTOR CHECK W/BYPASS METER
GF	GRADE FIRE DEPT CONNECTION
FDV	FLUSH FIRE DEPT CONNECTION
FDV	FIRE DEPT VALVE W/CAP AND CHAIN
TS	O.S. & Y. VALVE W/TAMPER SWITCH
DPV	DRY PIPE VALVE
PRV	PREACTION VALVE

MECHANICAL SHEET LIST	
SHEET NUMBER	SHEET NAME
M000	MECHANICAL TITLE SHEET
FP101	GROUND LEVEL FIRE PROTECTION PLANS
PP101	GROUND LEVEL PLUMBING PLANS
PP500	PLUMBING RISERS
MDH101	GROUND LEVEL DEMOLITION HVAC PLAN
MDH111	FIRST LEVEL INTERSTITIAL/ROOF MECHANICAL DEMOLITION
MH101	GROUND LEVEL HVAC PLAN
MH111	FIRST LEVEL INTERSTITIAL/ROOF MECHANICAL PLANS
MDP101	GROUND LEVEL DEMOLITION PIPING PLAN
MP101	GROUND LEVEL PIPING PLAN
M500	MECHANICAL DETAILS
M501	MECHANICAL SEQUENCE OF OPERATIONS
M600	MECHANICAL/ELECTRICAL SCHEDULES
SHEET TOTAL: 13	

Scale bars for various units: 1/8", 1/4", 1/2", 3/4", 1", 1 1/2", 2", 3", 4", 6", 8", 12".

Vertical scale: 1/8" = 1 foot, 1/4" = 2 feet, 1/2" = 4 feet, 3/4" = 6 feet, 1" = 8 feet, 1 1/2" = 12 feet, 2" = 16 feet, 3" = 24 feet, 4" = 32 feet, 6" = 48 feet, 8" = 64 feet, 12" = 96 feet.

Horizontal scale: 1/8" = 1 foot, 1/4" = 2 feet, 1/2" = 4 feet, 3/4" = 6 feet, 1" = 8 feet, 1 1/2" = 12 feet, 2" = 16 feet, 3" = 24 feet, 4" = 32 feet, 6" = 48 feet, 8" = 64 feet, 12" = 96 feet.

Revision table:

Revision#	Description	Date:

**CONSULTANTS**

MECHANICAL / ELECTRICAL / PLUMBING: **DUNHAM**  
32 South Sixth Street, Suite 1100  
Minneapolis, MN 55402  
Phone: 612-465-7550

STRUCTURAL: **ERA**  
ERICKSEN ROAD & ASSOCIATES  
2250 University Avenue West, Suite 201-S  
Saint Paul, MN 55114  
Phone: 651-251-7570

**ARCHITECT OF RECORD**

A/E: **Stone Group Architects**  
600 E 7th Street  
Sioux Falls, SD 57103  
605-271-1144

**STONE GROUP ARCHITECTS**

**STAMP**

REGISTERED PROFESSIONAL ENGINEER  
REG. NO. 14944  
JASON R. GOTWALT  
SOUTH DAKOTA

**Office of Construction and Facilities Management**

VA U.S. Department of Veterans Affairs

Drawing Title: **MECHANICAL TITLE SHEET**

Phase: **BID SET**

Approved: \_\_\_\_\_

Project Title: **UPGRADE PHARMACY 797**

Location: **SIoux FALLS, SOUTH DAKOTA**

Issue Date: 02/10/2021


Checked: JRG

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Project Number: **VA #438-20-109 SGA #201927**



Building Number: **5**

Drawing Number: **M000**

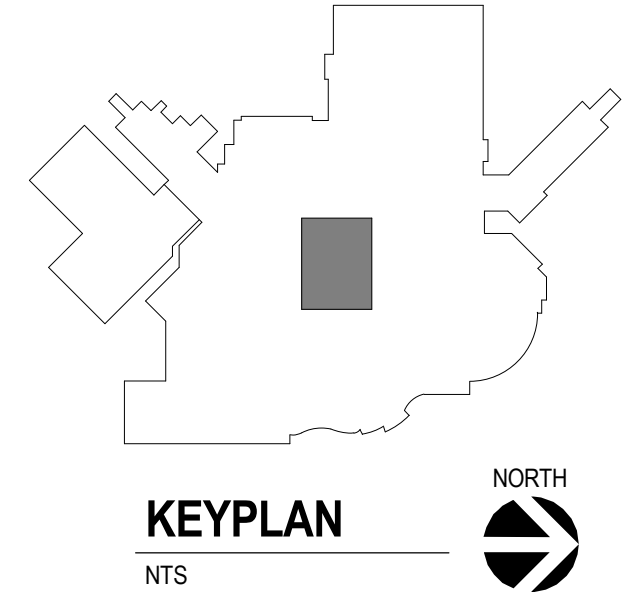


- GENERAL NOTES:**
- PROVIDE 175# PRESSURE RATED PIPING AND FITTINGS.
  - REVISE / REPLACE EXISTING FIRE SPRINKLER PIPING, SPRINKLER HEAD TYPES & LOCATIONS, AND SYSTEM ACCESSORIES AS REQUIRED TO ACCOMMODATE NEW FLOOR LAYOUT, CEILING, AND SYSTEM REQUIREMENTS. ALL AREAS OF CONSTRUCTION SHALL BE FULLY SPRINKLED.
  - THE FIRE SPRINKLER SYSTEM SHALL BE FABRICATED, INSTALLED AND TESTED IN ACCORDANCE WITH THE FOLLOWING CRITERIA:
    - REGULATIONS OF THE LOCAL FIRE PROTECTION AUTHORITIES.
    - REQUIREMENTS OF THE OWNER'S INSURANCE CARRIER.
    - NFPA STANDARDS, INCLUDING BUT NOT LIMITED TO, STANDARD NO. 13 - SPRINKLER SYSTEMS, AND NO. 241 - SAFEGUARDING CONSTRUCTION, ALTERATION AND DEMOLITION OPERATION.
    - THE CONSTRUCTION DOCUMENTS.
  - THE REMODELED AREAS SHALL BE PROVIDED WITH AN AUTOMATIC WET FIRE SPRINKLER SYSTEM SIZED IN ACCORDANCE WITH THE APPLICABLE NFPA STANDARDS AND SHALL PROVIDE 100 PERCENT PROTECTION UNLESS INDICATED OTHERWISE.
  - SPRINKLER SYSTEM DESIGN CRITERIA:
    - LIGHT HAZARD OCCUPANCY - PATIENT CARE, EXAM ROOMS, ADMINISTRATIVE AREAS, AND PUBLIC AREAS.
    - ORDINARY HAZARD 1 - LABORATORIES, MECHANICAL EQUIPMENT ROOMS, TRANSFORMER ROOMS, ELECTRICAL SWITCHGEAR ROOMS, ELECTRICAL CLOSETS AND REPAIR SHOPS.
    - ORDINARY HAZARD 2 - STORAGE ROOMS, TRASH ROOMS, CLEAN AND SOILED LINEN ROOMS, STORAGE AREAS, FILE STORAGE AREAS.
  - AREAS OF SPECIAL DESIGN CONSIDERATION INCLUDE, BUT ARE NOT LIMITED TO THE FOLLOWING:
    - QUICK RESPONSE SPRINKLERS SHALL BE INSTALLED IN ALL SPACES EXCEPT AS NOTED ON THE DRAWINGS.
    - SPRINKLERS SHALL BE LOCATED IN THE CENTER OF THE CEILING TILES.
    - SEE ARCHITECTURAL CEILING PLANS FOR SPECIFIC AESTHETIC CONSIDERATIONS FOR LOCATING SPRINKLERS. FINAL SPRINKLER LOCATIONS WILL BE COORDINATED DURING SUBMITTAL REVIEW.
  - SPRINKLER WORK INCLUDES THE DESIGN AND CONSTRUCTION NECESSARY TO PROVIDE A FULLY SPRINKLED LAYOUT. CONTRACTOR SHALL FIELD VERIFY THE ACCURACY OF THE SHOP DRAWINGS FOR EXISTING AREAS. CONTRACTOR SHALL OBTAIN A CURRENT HYDRANT FLOW TEST AND PERFORM HYDRAULIC CALCULATIONS, AND VERIFY EXACT LOCATION OF THE EXISTING OVERHEAD SYSTEM PRIOR TO DESIGN AND CONSTRUCTION.
  - SPRINKLER DESIGN DENSITIES / DEMAND CRITERIA NFPA 13, UNLESS OTHERWISE NOTED:
    - LIGHT HAZARD - 0.10 GPM / SQ.FT. OVER THE MOST REMOTE 1,500 SQ.FT.
    - ORDINARY HAZARD 1 - 0.15 GPM / SQ.FT. OVER THE MOST REMOTE 1,500 SQ.FT.
    - ORDINARY HAZARD 2 - 0.20 GPM / SQ.FT. OVER THE MOST REMOTE 1,500 SQ.FT.
  - OBTAIN CERTIFIED TEST RESULTS FOR THE RECORD OF ALL ACCEPTANCE TESTS AS REQUIRED BY NFPA 13 FOR THE INSTALLED SPRINKLER SYSTEM. THE TEST RESULTS SHALL BE REPORTED USING NFPA STANDARD FORMS.
  - SPRINKLER HEAD TYPES: PROVIDE QUICK RESPONSE, SEMI-RECESSED, PENDENT SPRINKLERS WITH CHROME ESCUTCHEON. SEE SPECIFICATION FOR ADDITIONAL INFORMATION.
  - CONTRACTOR SHALL PROVIDE APPROVED PENETRATION MATERIAL FOR FIRE RATED WALLS AS REQUIRED AND INSTALL FIREPROOFING MATERIALS AS REQUIRED.
  - CONTRACTOR SHALL PROVIDE PIPE SLEEVES AT ALL FLOOR AND STRUCTURAL WALL OPENINGS, PENETRATIONS THROUGH FLOORS SHALL INCLUDE A 1" WATERPROOFING LIP TO PREVENT WATER FROM PASSING FROM ONE LEVEL TO ANOTHER. ANNULAR SPACE SHALL BE FILLED PER SPECIFICATION.
  - SHOP DRAWINGS SHALL BE ROUTED TO ENGINEER ONLY AFTER ALL OTHER PARTIES HAVE REVIEWED AND STAMPED THEM.
  - FIRE WATCH DURING HOURS OR CONSTRUCTION WILL BE THE RESPONSIBILITY OF THIS CONTRACTOR. ALL REMAINING HOURS WHEN SUBCONTRACTORS ARE NOT ON SITE SHALL BE SCHEDULED WITH THE VA TO HAVE THEIR INTERNAL STAFF PROVIDE FIRE WATCH MONITORING AND DOCUMENTATION.
  - CONTRACTOR SHALL FIELD VERIFY THE ACCURACY OF THE SHOP DRAWINGS FOR EXISTING AREAS. CONTRACTOR SHALL OBTAIN A CURRENT HYDRANT FLOW TEST AND PERFORM HYDRAULIC CALCULATIONS, AND VERIFY EXACT LOCATION OF THE EXISTING OVERHEAD SYSTEM PRIOR TO DESIGN AND CONSTRUCTION.
  - CONTRACTOR SHALL PROVIDE TEMPORARY UPRIGHT SPRINKLER HEADS WITHIN CONSTRUCTION LIMITS TO MAINTAIN CONTINUAL SPRINKLER COVERAGE THROUGHOUT ALL PHASES OF CONSTRUCTION.

- KEY NOTES:**
- PROPOSED AREA OF REMODEL OUTLINED BY DOUBLE DASHED LINE. RELOCATE/REMOVE EXISTING PIPING, FITTINGS AND SPRINKLER HEAD LOCATION AS NECESSARY TO PROVIDE COVERAGE IN REMODELED AREA PER NFPA 13, THE OWNER'S INSURANCE UNDERWRITER, AND THE AUTHORITY HAVING JURISDICTION. REVIEW AND COORDINATE LAYOUT OF FIRE PROTECTION SYSTEM WITH ARCHITECTURAL CEILING PLANS, LIGHTING, HVAC AND OTHER CEILING MOUNTED DEVICES. HEADS THAT ARE REMOVED SHALL BE CAPPED AT THEIR BRANCH CONNECTION. MODIFY SPRINKLER HEADS IN AREAS ADJACENT TO THE REMODEL AS REQUIRED TO PROVIDE NFPA 13 COMPLIANT COVERAGE DUE TO REVISED PARTITIONS. CONTRACTOR TO NOTE THAT EXISTING SPRINKLER HEADS ARE NOT TO BE REUSED, AND THAT ATTEMPTING TO MATCH SPRINKLER RESPONSE AND TEMPERATURE RATING WITH EXISTING HEADS WILL NOT COMPLY WITH VA REQUIREMENTS. THEREFORE IF A HEAD REQUIRES REPLACEMENT, OR RELOCATION, WITHIN ANY SPACE THAN ALL SPRINKLER HEAD WITHIN THE ENCLOSED SPACE OF THAT ROOM/AREA SHALL BE REPLACED WITH NEW HEADS.
  - PROVIDE GASKETED, CLEANROOM TYPE CONCEALED SPRINKLER HEADS WITH WHITE COVER PLATE IN THIS ROOM. NOTE THAT THESE HEADS ARE NOT PERMITTED IN NEGATIVELY PRESSURIZED CLEANROOMS PER VA STANDARDS. SEE KEY NOTE #3 BELOW.
  - PROVIDE SEMI-RECESSED QUICK-RESPONSE HEAD, WITH PROTECTIVE CAGE (IF REQUESTED FOR CLEANING GAIRD), INSIDE C-SCA AREA.
  - PROVIDE SEMI-RECESSED QUICK-RESPONSE HEADS THROUGHOUT AREA INDICATED. DO NOT REUTILIZE EXISTING HEADS, AND REPLACE ALL OTHER HEADS WITHIN SPACE IMPACTED. ATTEMPTING TO MATCH ADJACENT EXISTING HEAD TEMPERATURE RATING AND RESPONSE TIME WILL NOT BE PERMITTED.
  - FIRE PROTECTION CONTRACTOR SHALL ASSUME THAT ALL SPRINKLER PIPING, BOTH MAINS AND BRANCHES, SHALL REQUIRE REMOVAL AND MODIFICATION ABOVE CLEANROOM AND C-SCA AREAS WHERE MOST INTENSIVE DUCTWORK MODIFICATIONS ARE OCCURRING.
  - NEW WALL PARTITION WILL BE 18" BELOW CEILING TO AVOID INTERFERENCE WITH CURRENT FIRE SPRINKLER COVERAGE.
- INTERIM LIFE SAFETY (FIRE WATCH): NOTE THAT CONTRACTOR WILL BE RESPONSIBLE FOR ALL FIRE WATCH ACTIVITIES DURING ANY FIRE SPRINKLER OUTAGE. COORDINATE ANY OUTAGE WITH VA REPRESENTATIVE IN ADVANCE TO ARRANGE FOR ISOLATION OF ZONE AND ASSISTANCE IN DRAINING SYSTEM. EXTENDED OUTAGE DURATIONS BEYOND 1-DAY WILL NEED APPROVAL FROM VA FACILITIES AND INTERIM LIFE SAFETY MEASURES APPLIED AS REQUIRED. AREAS IN CONSTRUCTION SHALL BE CONTINUALLY PROTECTED WITH TEMPORARY UPRIGHT SPRINKLER HEADS AND MODIFIED DURING CONSTRUCTION PHASES TO KEEP SPRINKLER COVERAGE ACTIVE THROUGHOUT ENTIRE CONSTRUCTION PROCESS.

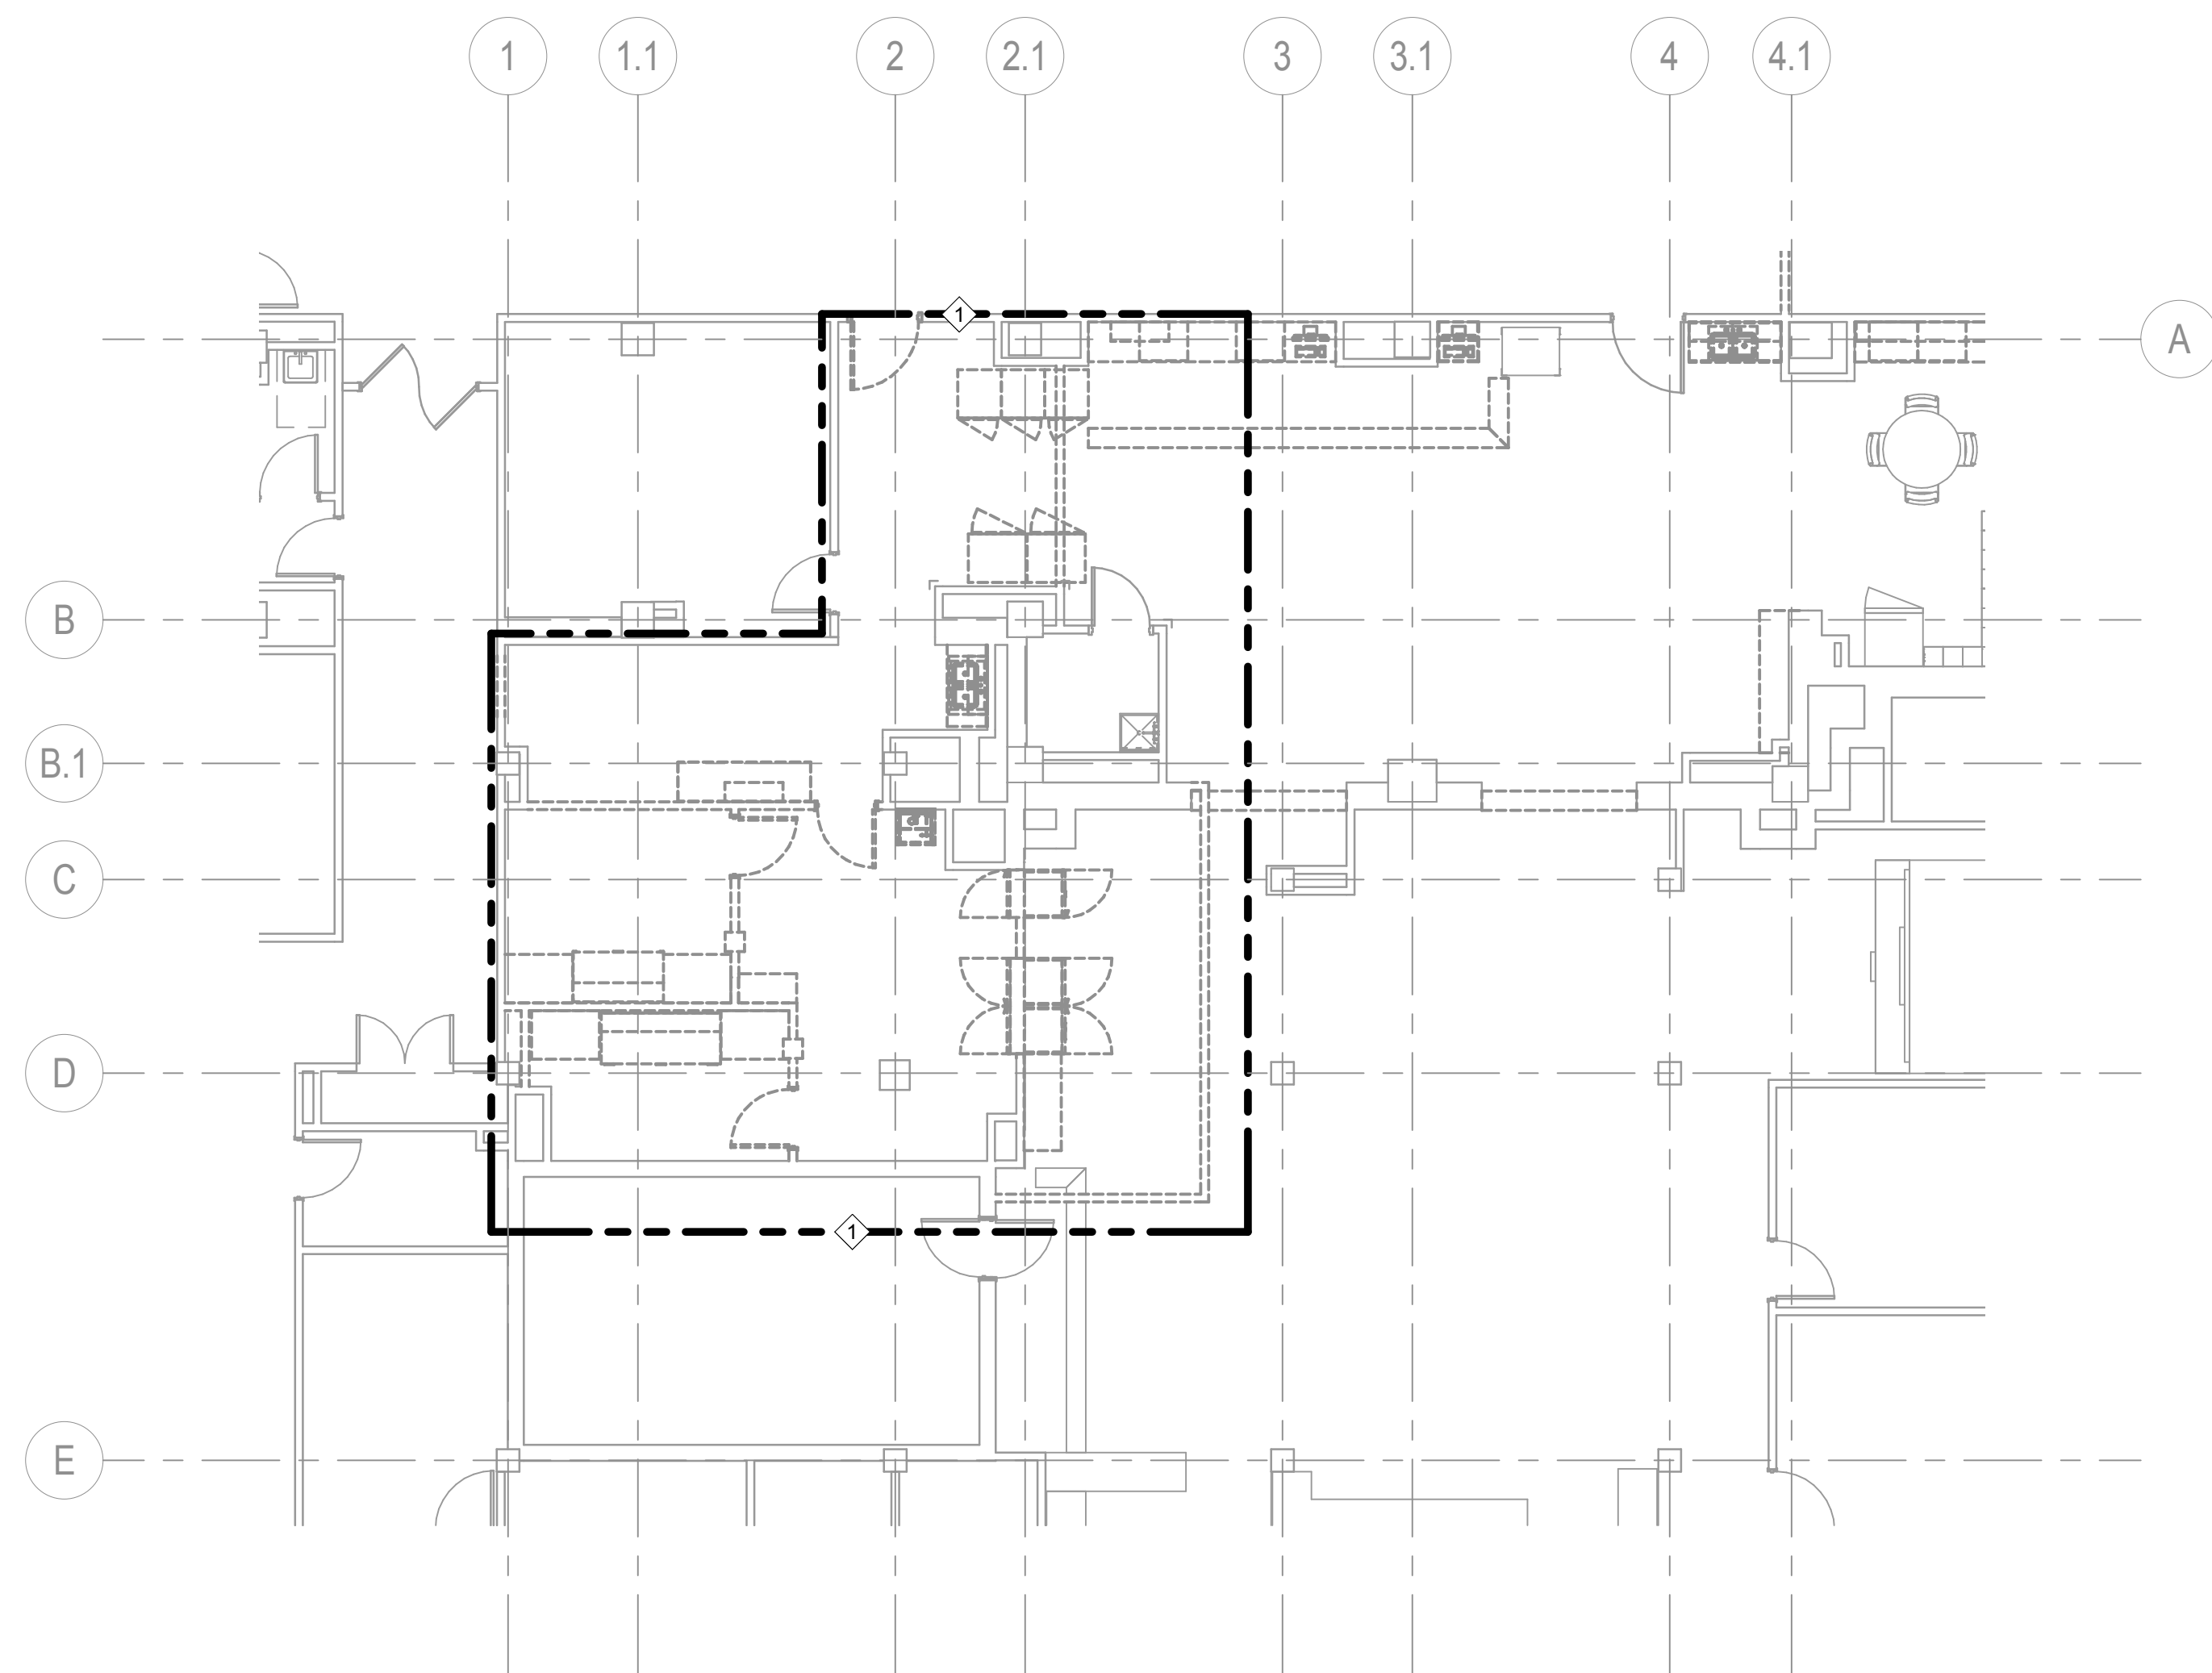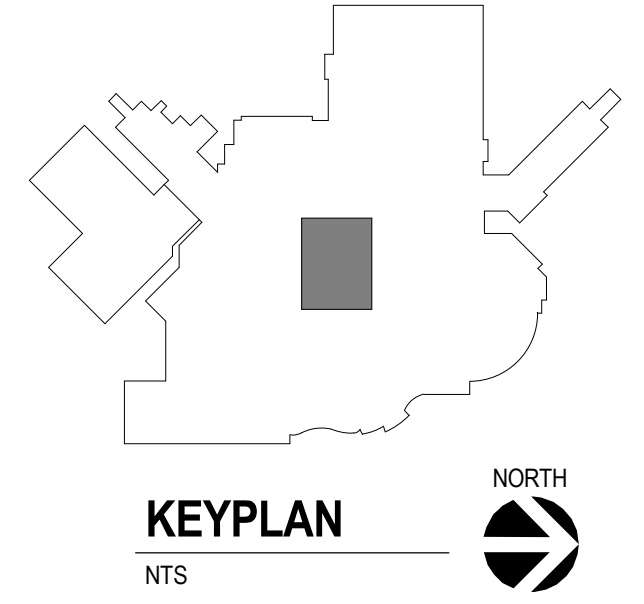

1 GROUND LEVEL DEMOLITION FIRE PROTECTION PLAN  
1/8" = 1'-0"

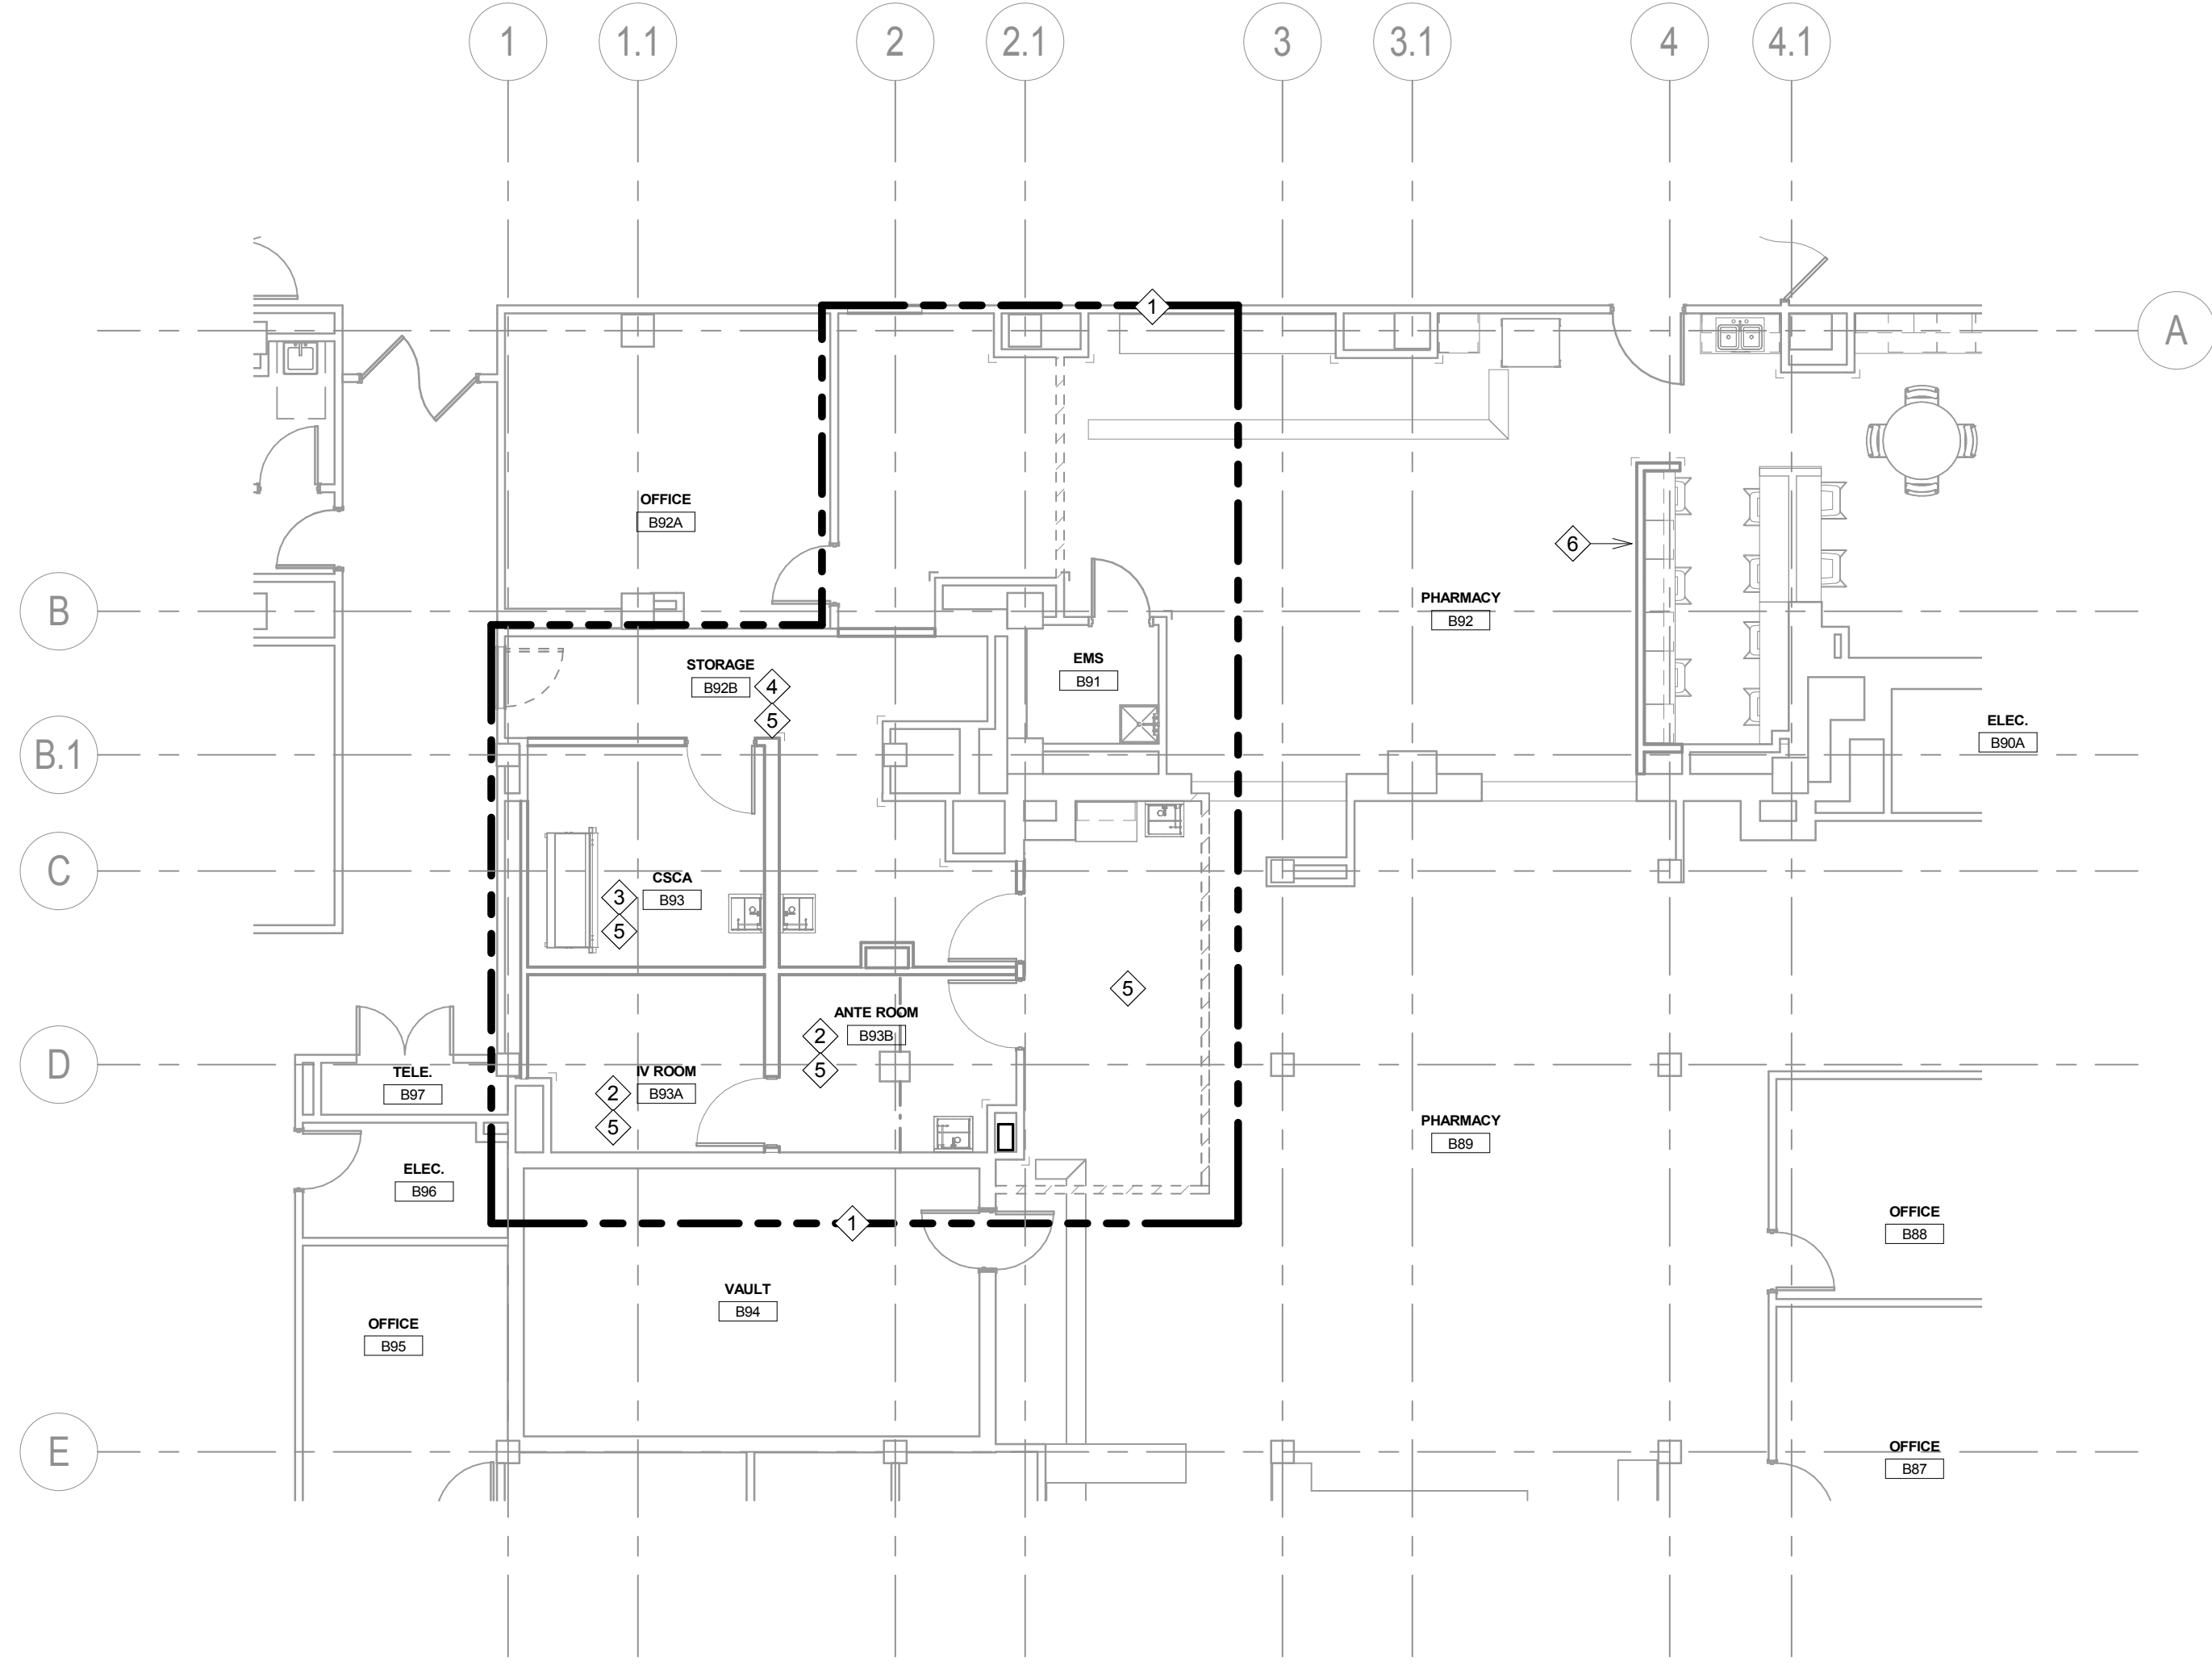

2 GROUND LEVEL FIRE PROTECTION PLAN  
1/8" = 1'-0"

Revision#	Description	Date:

**CONSULTANTS**

MECHANICAL / ELECTRICAL / PLUMBING: **DUNHAM**  
32 South Sixth Street, Suite 1100  
Minneapolis, MN 55402  
Phone: 612-465-7550

STRUCTURAL: **ERA**  
ERICKSEN ROAD  
A DIVISION OF  
Erickson Road & Associates  
2250 University Avenue West, Suite 201-S  
Saint Paul, MN 55114  
Phone: 651-251-7570

**ARCHITECT OF RECORD**

A/E: **Stone Group Architects**  
600 E 7th Street  
Sioux Falls, SD 57103  
605-271-1144

**STONE GROUP ARCHITECTS**

**STAMP**

REGISTERED PROFESSIONAL ENGINEER  
REG. NO. 14944  
**JASON R. GOTTWALT**  
SOUTH DAKOTA

**Office of Construction and Facilities Management**

**VA** U.S. Department of Veterans Affairs

Drawing Title  
**GROUND LEVEL FIRE PROTECTION PLANS**

Approved: \_\_\_\_\_

Phase  
**BID SET**

Project Title  
**UPGRADE PHARMACY 797**

Location  
**SIoux FALLS, SOUTH DAKOTA**

Issue Date  
**02/10/2021**

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Project Number  
**VA #438-20-109 SGA #201927**

Building Number  
**5**


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**FP101**

**GENERAL NOTES:**


- A. CONTRACTOR SHALL REFER TO THE VA MASTER SPECIFICATION MANUAL, EDITED FOR THIS PROJECT ALONG WITH ANY APPLICABLE STANDARDS WITHIN THE VA DESIGN GUIDES. ALL REQUIREMENTS OF THOSE MANUALS SHALL BE MAINTAINED IN ADDITION TO ALL NOTES AND DESCRIPTIONS INDICATED WITHIN THESE DRAWINGS. ANY CONFLICTS BETWEEN THE DOCUMENTS SHOULD BE BROUGHT TO THE ATTENTION OF THE ENGINEER FOR INTERPRETATION.
- B. CONTRACTOR WILL BE RESPONSIBLE TO REVIEW ACCESSIBILITY TO AREAS OUTSIDE THE CONSTRUCTION LIMITS TO DETERMINE APPROXIMATE AMOUNT OF OVERTIME REQUIRED TO PERFORM ALL MECHANICAL WORK INDICATED. COORDINATION OF SCHEDULES WITH ADJACENT DEPARTMENTS AND CLEANING OF ALL DEBRIS AFTER EACH WORK SHIFT SHOULD BE ASSUMED IN THE BASE BID SCOPE.
- C. ANY MAJOR OUTAGES INDICATED ON THESE DRAWINGS SHALL BE SCHEDULED TO BE PERFORMED AFTER NORMAL BUSINESS HOURS OR DURING WEEKEND PERIODS TO MINIMIZE HOSPITAL DISRUPTION. VA HOSPITAL FACILITIES WILL REQUIRE A MINIMUM OF TWO (2) WEEKS NOTICE PRIOR TO ANY SUCH OUTAGE.
- D. COORDINATE ALL NEW PLUMBING PIPING ROUTING WITH ALL OTHER TRADES TO ENSURE ADEQUATE CLEARANCES FOR ELECTRICAL CONDUIT, HVAC DUCTWORK & PIPING, STRUCTURAL SUPPORTS, ETC. ANY UNAVOIDABLE CONFLICTS SHALL BE BROUGHT TO THE ATTENTION OF THE ARCHITECT/ENGINEER OF RECORD. PROVIDE ALL OFFSETS & TRANSITIONS AS REQUIRED FOR A CLEAN INSTALLATION.
- E. THE EXACT LOCATION OF EQUIPMENT ROUGH-INS SHALL BE VERIFIED WITH THE STAMPED APPROVED SHOP DRAWINGS PRIOR TO ANY FIELD INSTALLATION.
- F. SUPPORT ALL PIPING DIRECTLY TO STRUCTURE. DO NOT SUPPORT ANY PIPING FROM DUCTWORK, CONDUIT OR OTHER PIPING ENCOUNTERED.
- G. WHERE MECHANICAL SYSTEMS TO REMAIN ARE DAMAGED OR DISTURBED DURING THE COURSE OF CONSTRUCTION, THE CONTRACTOR WILL BE RESPONSIBLE TO REMOVE DAMAGED PORTIONS AND INSTALL NEW PRODUCTS OF EQUAL QUALITY AND FUNCTIONALITY.
- H. ALL EXISTING PIPING THROUGH NEW FIRE RATED WALLS SHALL BE ADEQUATELY FIRE SEALED AS REQUIRED. PIPING PENETRATIONS THROUGH INTERSTITIAL FLOOR SHALL BE DRILLED OR CUT BY THE CONTRACTOR AND FIRE SEALED AS REQUIRED.
- I. ALL CORE DRILLING OR ANY ACTIVITIES CAUSING EXTREME VIBRATION OR NOISE SHALL BE COORDINATED TO BE PERFORMED AFTER BUSINESS HOURS TO NOT AFFECT CRITICAL HOSPITAL FUNCTIONS WITHIN ADJACENT AREAS. COORDINATE WITH VA REPRESENTATIVE AS REQUIRED.
- J. FIELD VERIFY EXISTING WATER, WASTE, VENT OR OTHER PIPING SYSTEMS FOR CONNECTIONS TO FIXTURES THAT MAY NOT BE IDENTIFIED ON PLANS PRIOR TO SERVICE OUTAGES, DEMOLITION OR ALTERATIONS OF EXISTING PIPE ROUTING. COORDINATE UNKNOWN SERVICE WITH FACILITIES AND ENGINEER OF RECORD.
- K. CONTRACTOR SHALL MAINTAIN ACCURATE RECORD DRAWINGS SHOWING ALL DISCREPANCIES WITH ANY EXISTING PIPING INDICATED OR REVISIONS TO THE NEW PLUMBING OR FIRE PROTECTION LAYOUTS. ALL CHANGES WILL BE UPDATED WITHIN THE FINAL RECORD DRAWING SET.
- L. ALL CONTRACTORS TO REFERENCE THE INFECTION CONTROL NOTES IDENTIFIED WITHIN THE VENTILATION GENERAL NOTES ON THESE DRAWINGS. CONFORM TO ALL ICRA REQUIREMENTS.
- M. THE PLUMBING CONTRACTOR SHALL PROVIDE ALL PIPING, FITTINGS, VALVES & ACCESSORIES AS REQUIRED FOR INSTALLATION OF OWNER PROVIDED EQUIPMENT PER MANUFACTURER'S RECOMMENDATIONS.
- N. EXISTING WASTE PIPING SHOWN IS LOCATED BELOW GROUND LEVEL SLAB IN UNEXCAVATED EARTH.

**KEY NOTES:**


- ◆ DEMOLISH SINK WITH EYEWASH AND ALL ASSOCIATED PIPING BACK TO POINT OF DISCONNECTION. CAP ALL PIPING AT MAINS. NO DEAD LEGS PERMITTED ON DOMESTIC WATER BRANCHES.
- ◆ DEMOLISH FIXTURE ROUGH-IN. DEMOLISH ALL THERMOSTATIC MIXING VALVE AND ASSOCIATED PIPING BACK TO POINT OF DISCONNECT. PROTECT 2" WASTE IN WALL FOR CONNECTION TO NEW. NO DEAD LEGS PERMITTED ON DOMESTIC WATER BRANCHES.
- ◆ DEMOLISH SINK. PROTECT EXISTING ROUGH-IN FOR CONNECTION TO FIXTURE.
- ◆ DEMOLISH SINK AND ALL ASSOCIATED PIPING BACK TO POINT OF DISCONNECTION. CAP ALL PIPING AT MAINS. NO DEAD LEGS PERMITTED ON DOMESTIC WATER BRANCHES.
- ◆ INSTALL NEW FIXTURE. CONNECT TO EXISTING ROUGH-IN.
- ◆ SAWCUT SLAB INDICATED BY HATCHED AREAS FOR REMOVAL/INSTALLATION OF WASTE PIPE. DETERMINE EXACT LOCATION/DEPTH. SCOPE PIPING TO DETERMINE EXACT LOCATION/DEPTH.
- ◆ CONTRACTOR TO NOTE DEPTH, AND EXACT LOCATION, OF UNDERGROUND PIPING IS BASED ON DRAWINGS AND MAY REQUIRE SITE SCOPING OF EXISTING PIPING TO DETERMINE. FOR EXAMPLE, EXISTING 8" WASTE PIPING SHOWN MAY BE IN EXCESS OF 72" DEEP.

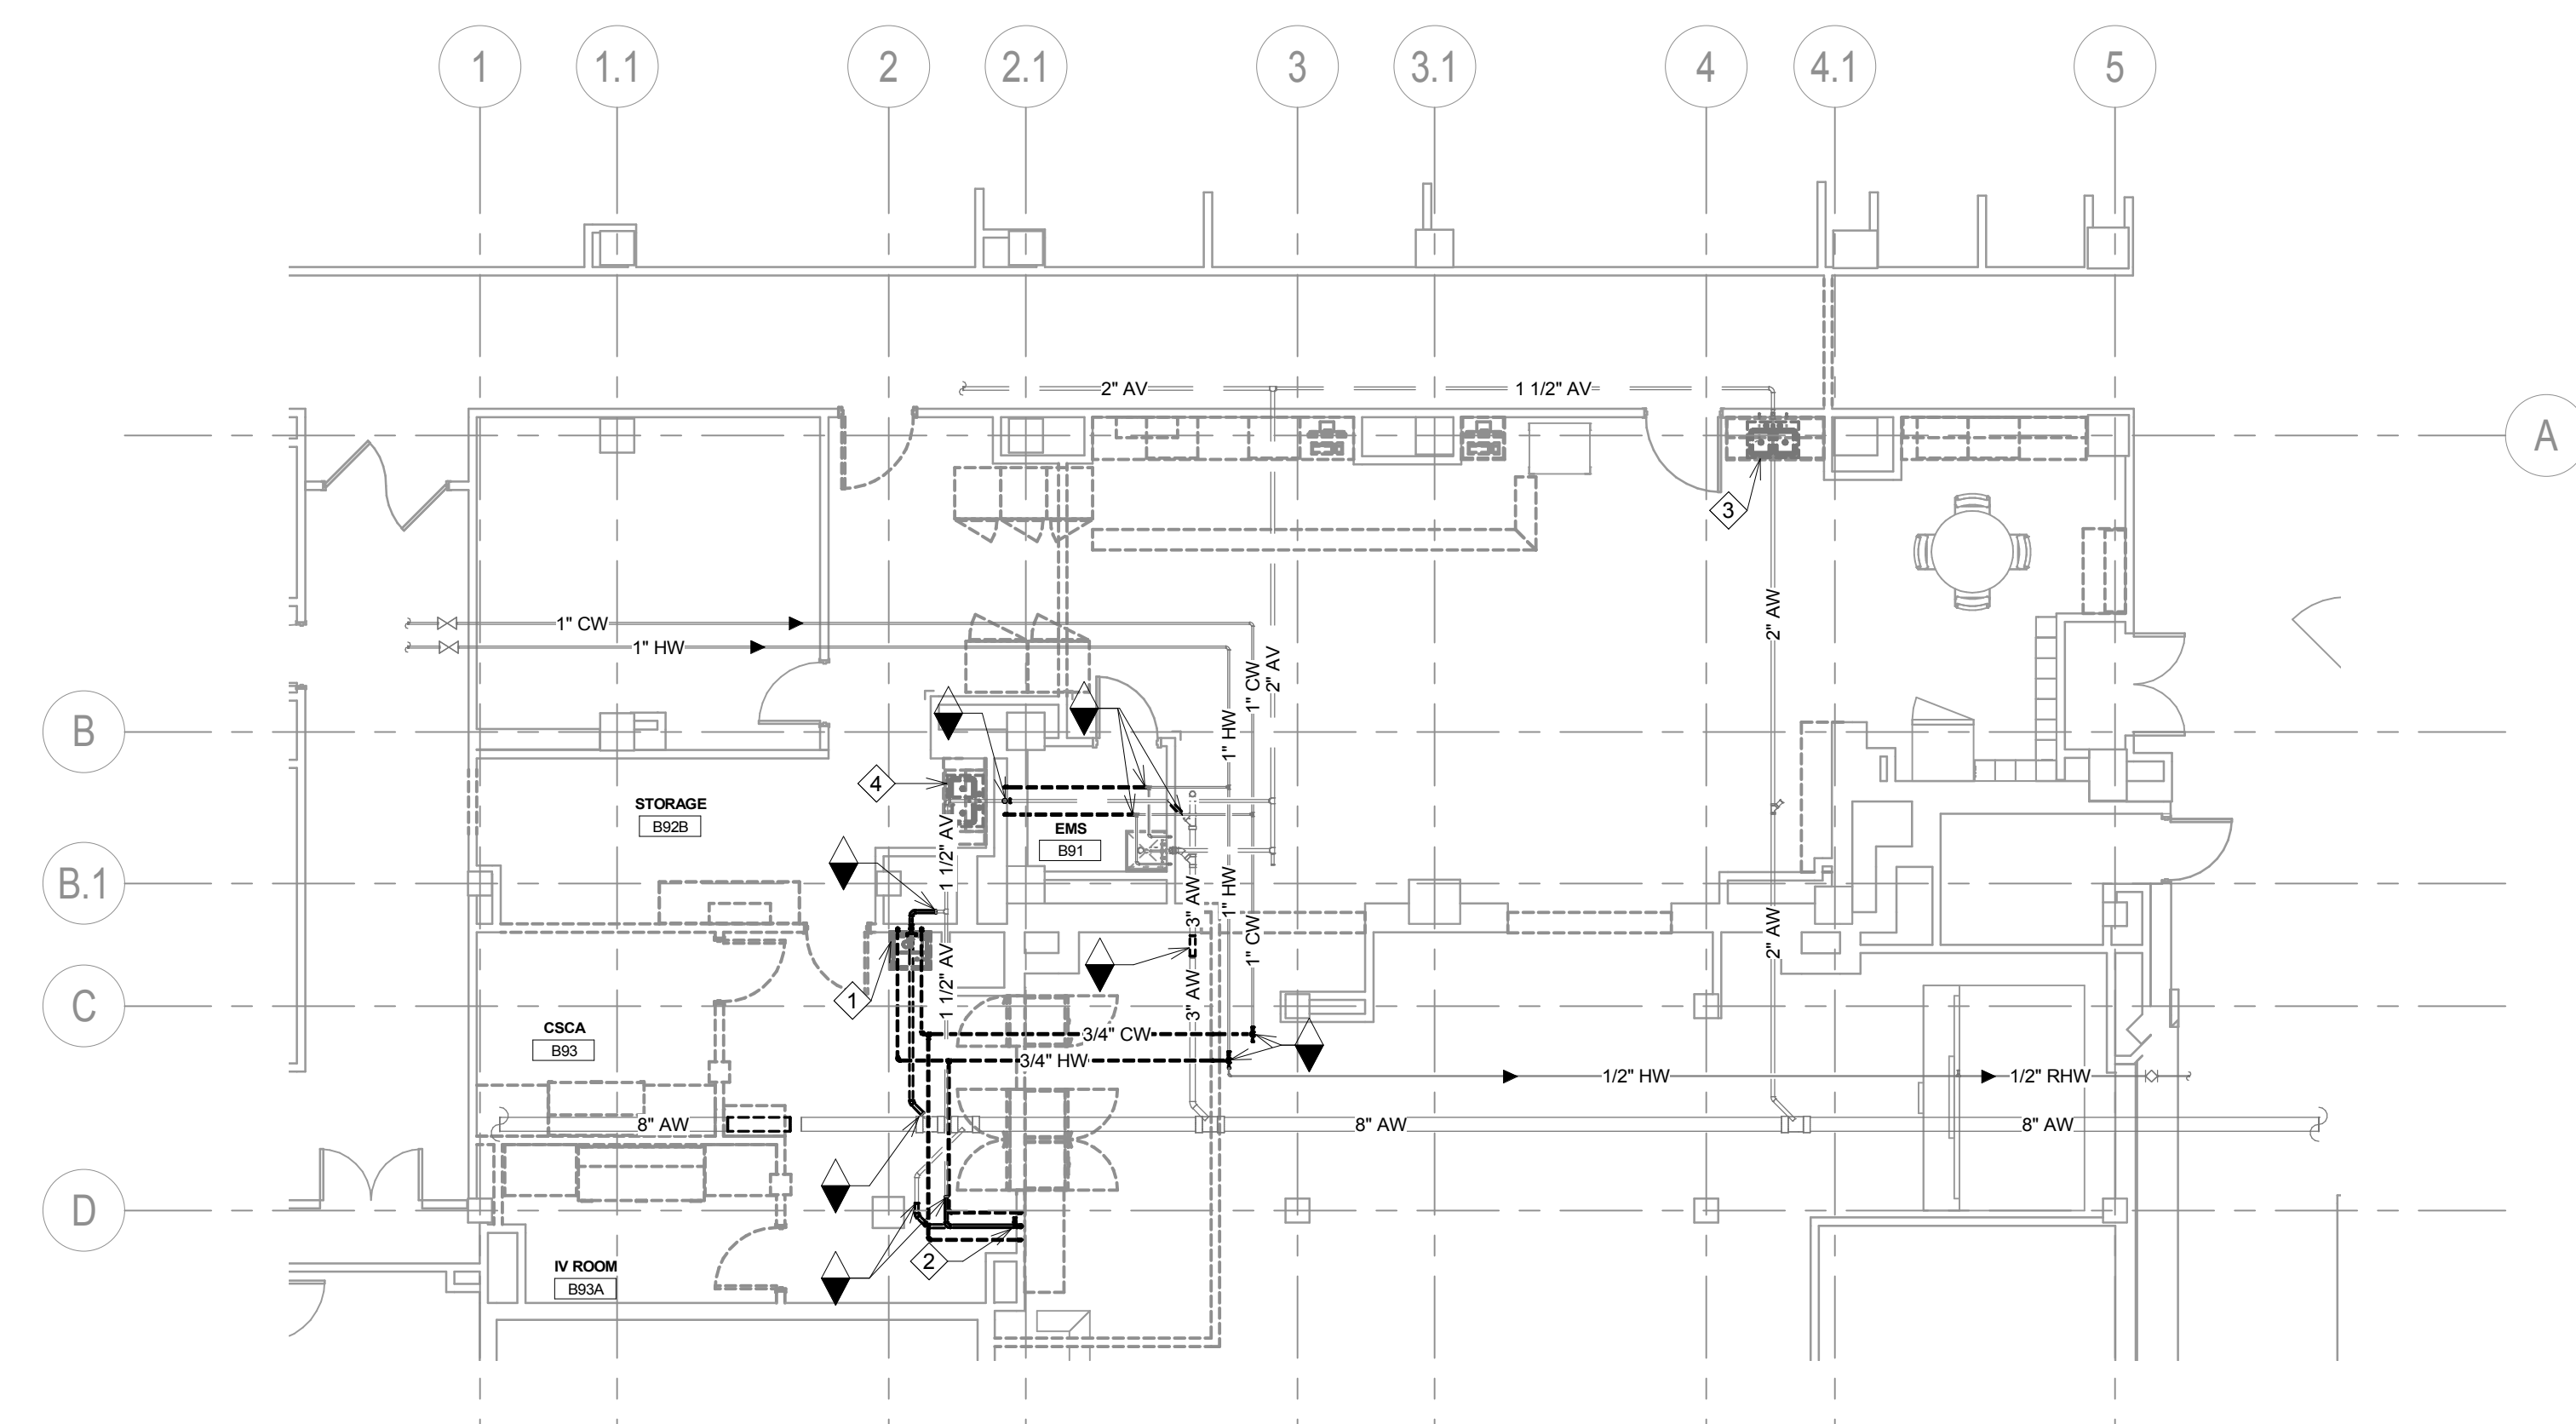

1 GROUND LEVEL DEMOLITION PLUMBING PLAN  
1/8" = 1'-0"

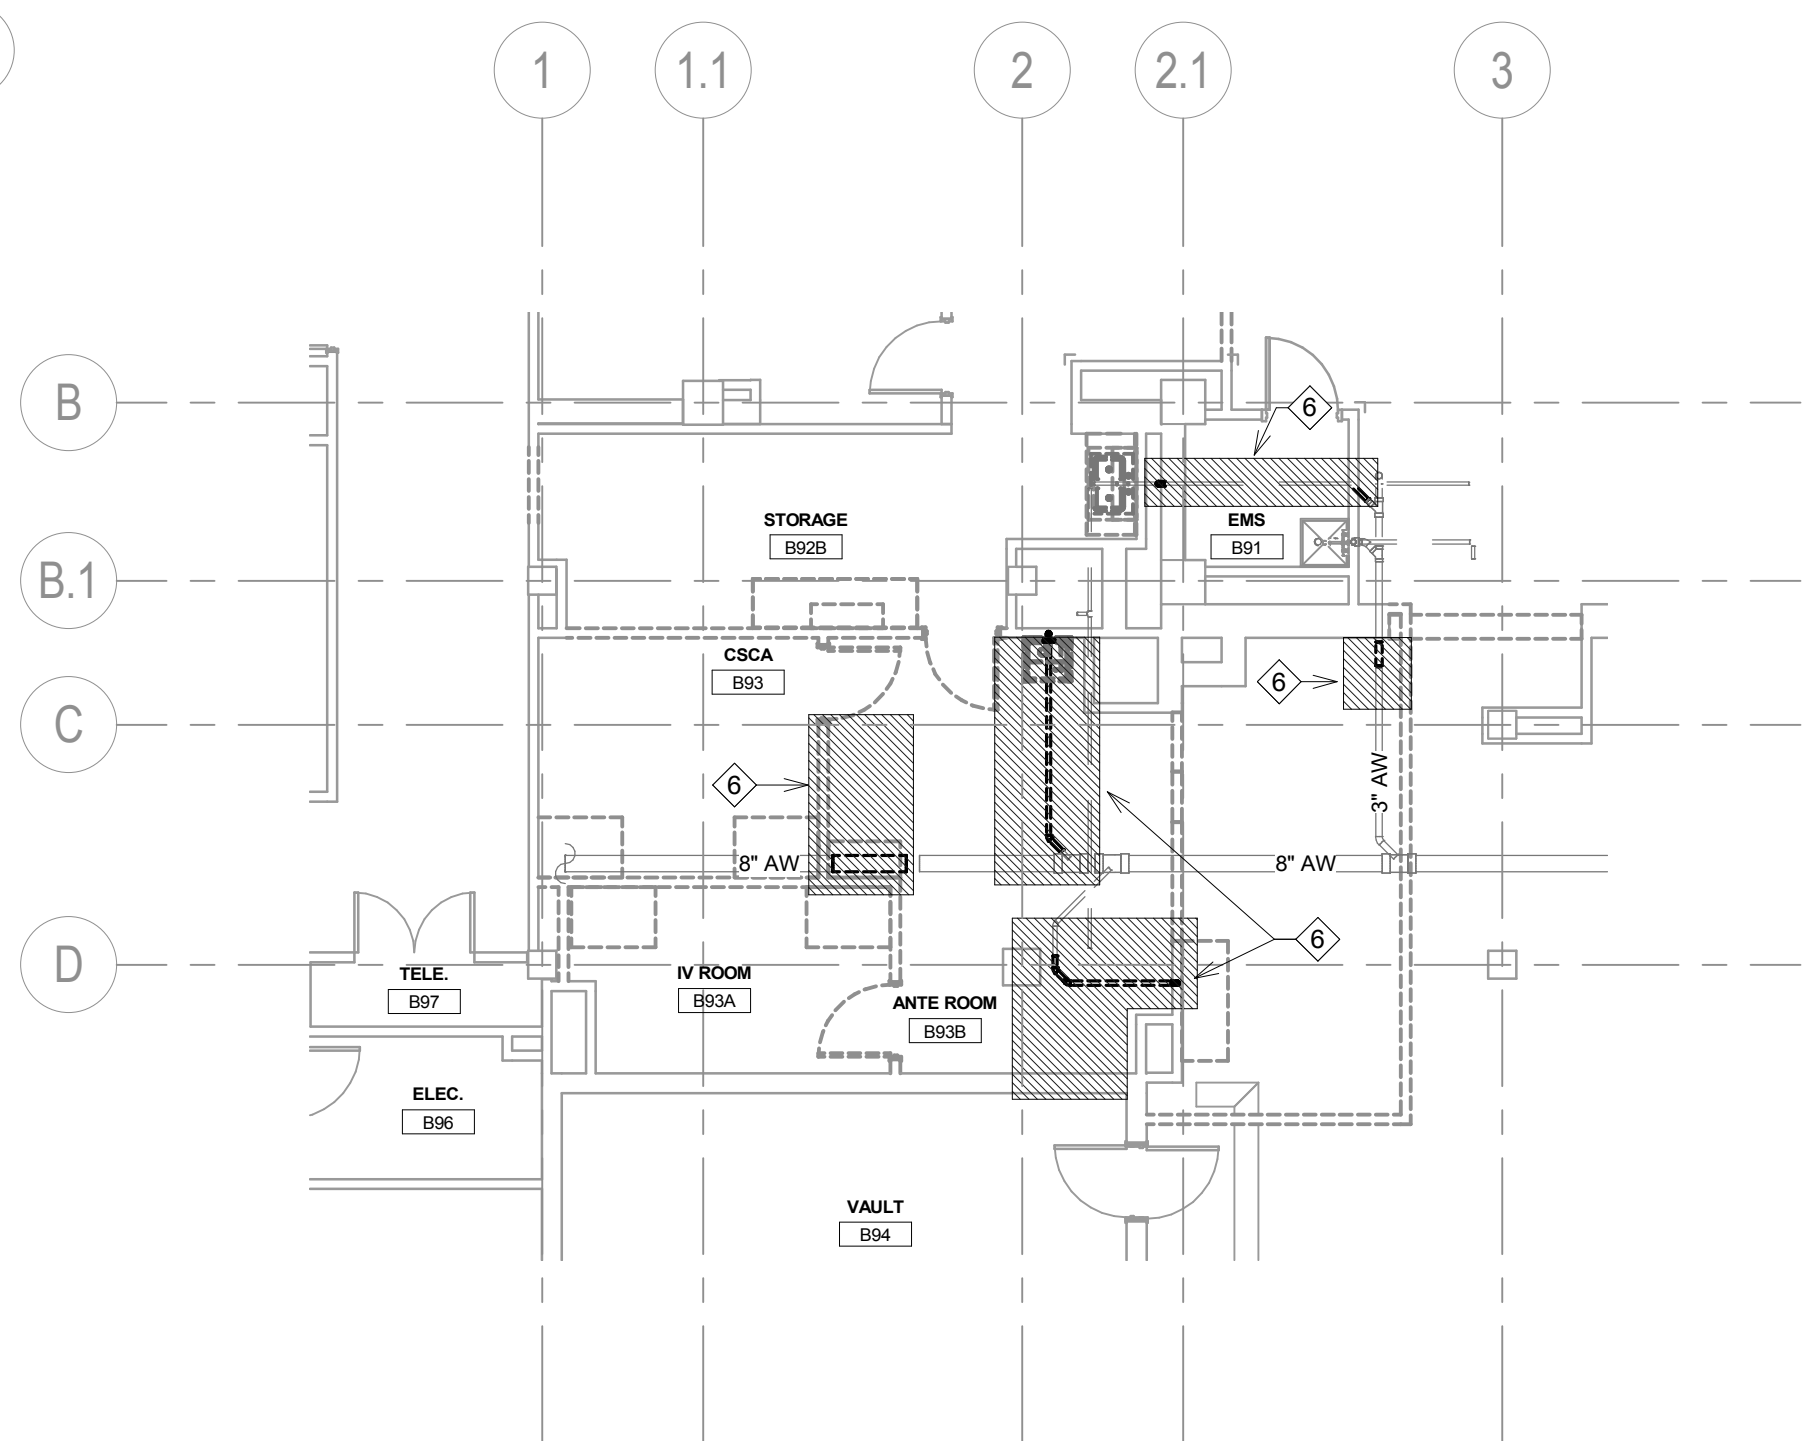


3 GROUND LEVEL - SAWCUT AREAS  
1/8" = 1'-0"

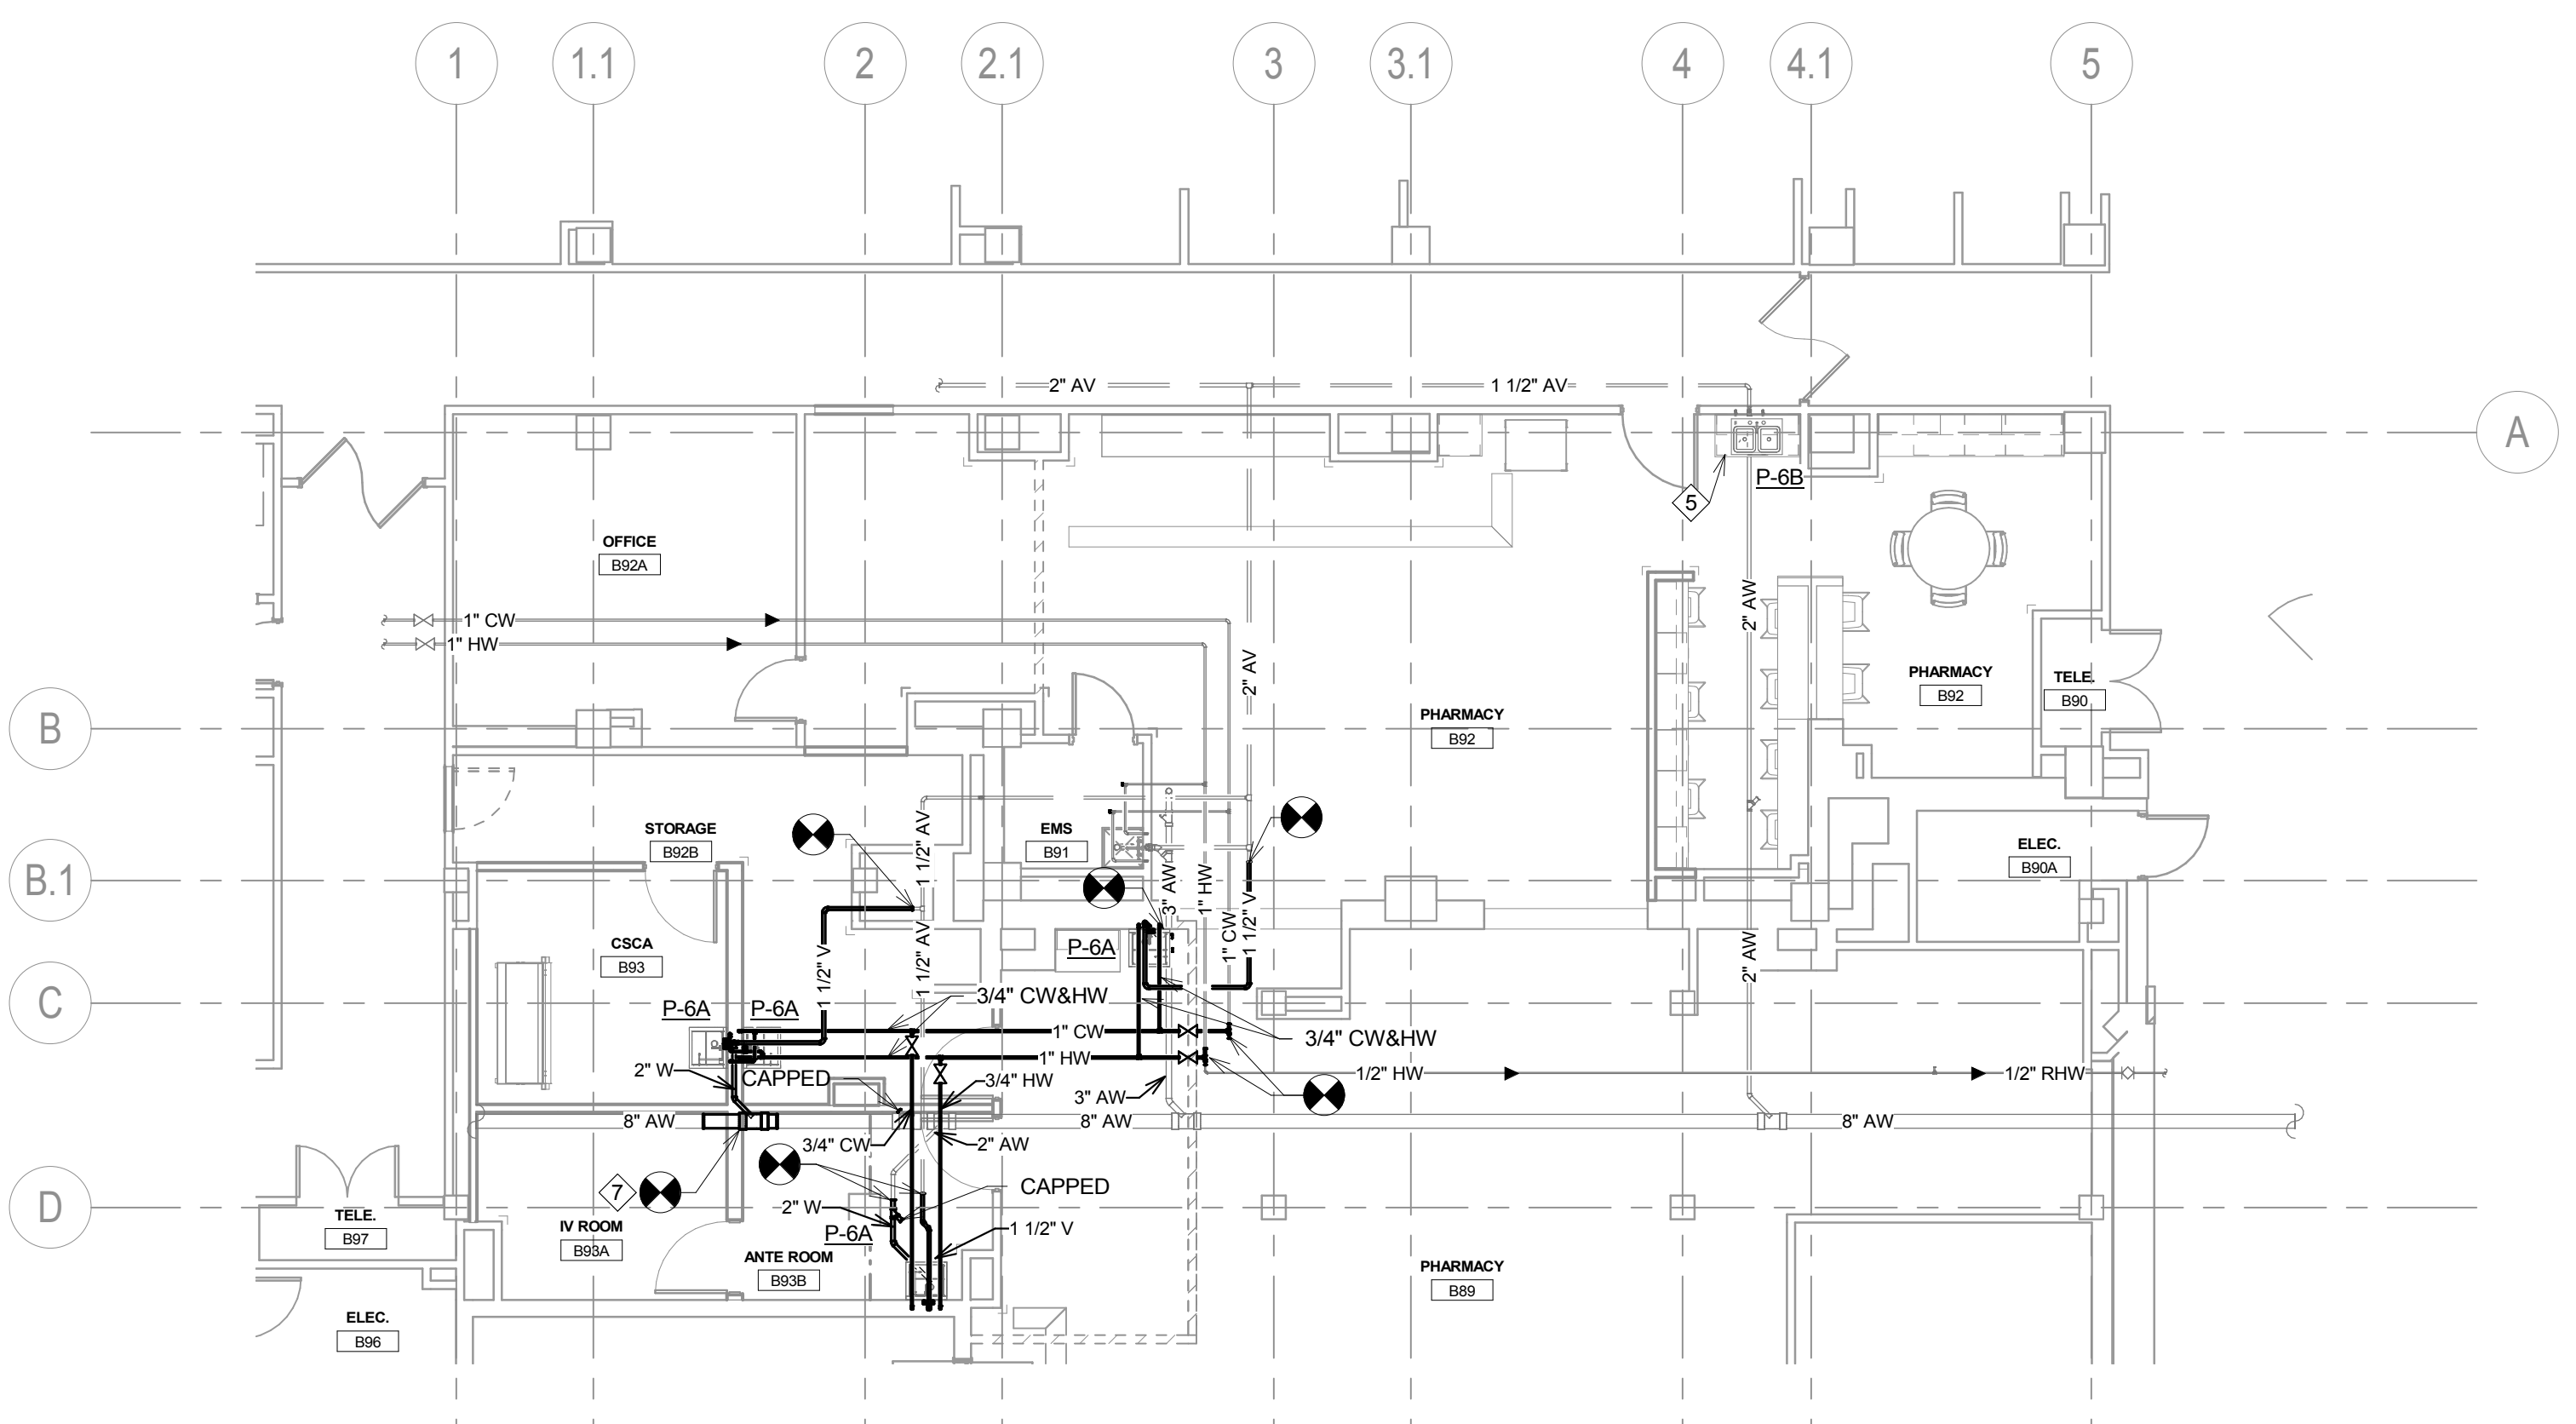

2 GROUND LEVEL PLUMBING PLAN  
1/8" = 1'-0"

**PLUMBING FIXTURE SCHEDULE**

FIXTURE TAG	FIXTURE DESCRIPTION	MOUNTING	ADA	FIXTURE	TRIM	STOP	TRAP	CARRIER	WASTE (IN)	TRAP (IN)	VENT (IN)	CW (IN)	HW (IN)	RO (IN)	MECHANICAL NOTES
P-6A	SINGLE BOWL SINK	WALL	YES	JUST JPH-ADA-2224 CT PHARMACY SERIES, SINGLE STATION WASH-UP STATION WITH EMERGENCY EYEWASH, 16 GAUGE, TYPE 304 STAINLESS STEEL	INTEGRAL JSL-46-AC, BACKSPASH MOUNTED, 5-5/8" GOOSENECK SPOUT, 2.0 GPM LAMINAR FLOW OUTLET, POLISHED CHROME, BATTERY POWERED.	CHICAGO FAUSETS 1017-CSTABCP BRASS BALL VALVE, POLISHED CHROME PLATED CAST BRASS ANGLE VALVE KITS, LOOSE KEY, FLEXIBLE RISERS, ESCUTCHEON	INTEGRAL JT-150 P-TRAP, 1-1/2"x1-1/2" CAST BRASS CHROME PLATED "P" TRAP, TREATED INSIDE & OUTSIDE WITH SANGUARD; EXTEND TO WALL WITH ESCUTCHEON.	SUPPORT BRACKETS INCLUDED.	1-1/2	1-1/2	1-1/2	1/2	1/2	NA	INTEGRAL J-35-SSF-DRAIN, STAINLESS STEEL DRAIN BODY, STAINLESS STEEL FLAT GRID STRAINER AND 1-1/2" O.D. STAINLESS STEEL TAILPIECE 4' LONG. PROVIDE JTM-47 THERMOSTATIC MIXING VALVE AND J61900 EYEWASH.
P-6B	DOUBLE BOWL SINK	COUNTER - DROP IN	NO	JUST DL-2128-A-GR, 18 GAUGE, TYPE 304 STAINLESS STEEL, 28" X 21" X 7-1/2" DEEP, 3 HOLE, UNDERCOATED.	CHICAGO FAUSETS 786-E20XKABCP, DECK MOUNTED, 5-1/4" RIGID SWING GOOSENECK SPOUT, 8" CENTERS, WRISTBLADE HANDLES, CERAMIC CARTRIDGE, 2.2 GPM LAMINAR FLOW OUTLET, POLISHED CHROME	CHICAGO FAUSETS 1017-CSTABCP BRASS BALL VALVE, POLISHED CHROME PLATED CAST BRASS ANGLE VALVE KITS, LOOSE KEY, FLEXIBLE RISERS, ESCUTCHEON	McGUIRE 1-1/2"x1-1/2" CAST BRASS CHROME PLATED "P" TRAP, TREATED INSIDE & OUTSIDE WITH SANGUARD; EXTEND TO WALL WITH ESCUTCHEON.	NA	1-1/2	1-1/2	1-1/2	1/2	1/2	NA	PROVIDE WATTS LFMMV MIXING VALVE. LOCATE BELOW SINK. PROVIDE McGUIRE CAST BRASS CHROME PLATED TAILPIECE & OPEN GRID STRAINER. ALL METAL PARTS TREATED INSIDE & OUTSIDE WITH SANGUARD.

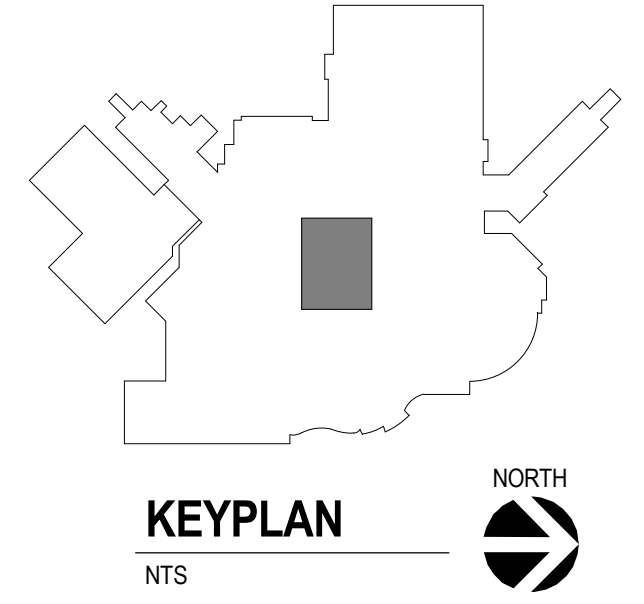

Revision#	Description	Date:

**CONSULTANTS**

MECHANICAL / ELECTRICAL / PLUMBING: **DUNHAM**  
32 South Sixth Street, Suite 1100  
Minneapolis, MN 55402  
Phone: 612-465-7550

STRUCTURAL: **ERA**  
ERICKSEN ROAD  
A SUBSIDIARY  
Erickson Road & Associates  
2250 University Avenue West, Suite 201-S  
Saint Paul, MN 55114  
Phone: 651-251-7570

**ARCHITECT OF RECORD**

A/E: **Stone Group Architects**  
600 E 7th Street  
Sioux Falls, SD 57103  
605-271-1144

**STONE GROUP ARCHITECTS**

**STAMP**

REGISTERED PROFESSIONAL ENGINEER  
REG. NO. 14944  
JASON R. GOTTWALT  
SOUTH DAKOTA

**Office of Construction and Facilities Management**

VA U.S. Department of Veterans Affairs

Drawing Title: **GROUND LEVEL PLUMBING PLANS**

Phase: **BID SET**

Approved: \_\_\_\_\_

Project Title: **UPGRADE PHARMACY 797**

Location: **SIOUX FALLS, SOUTH DAKOTA**

Issue Date: 02/10/2021

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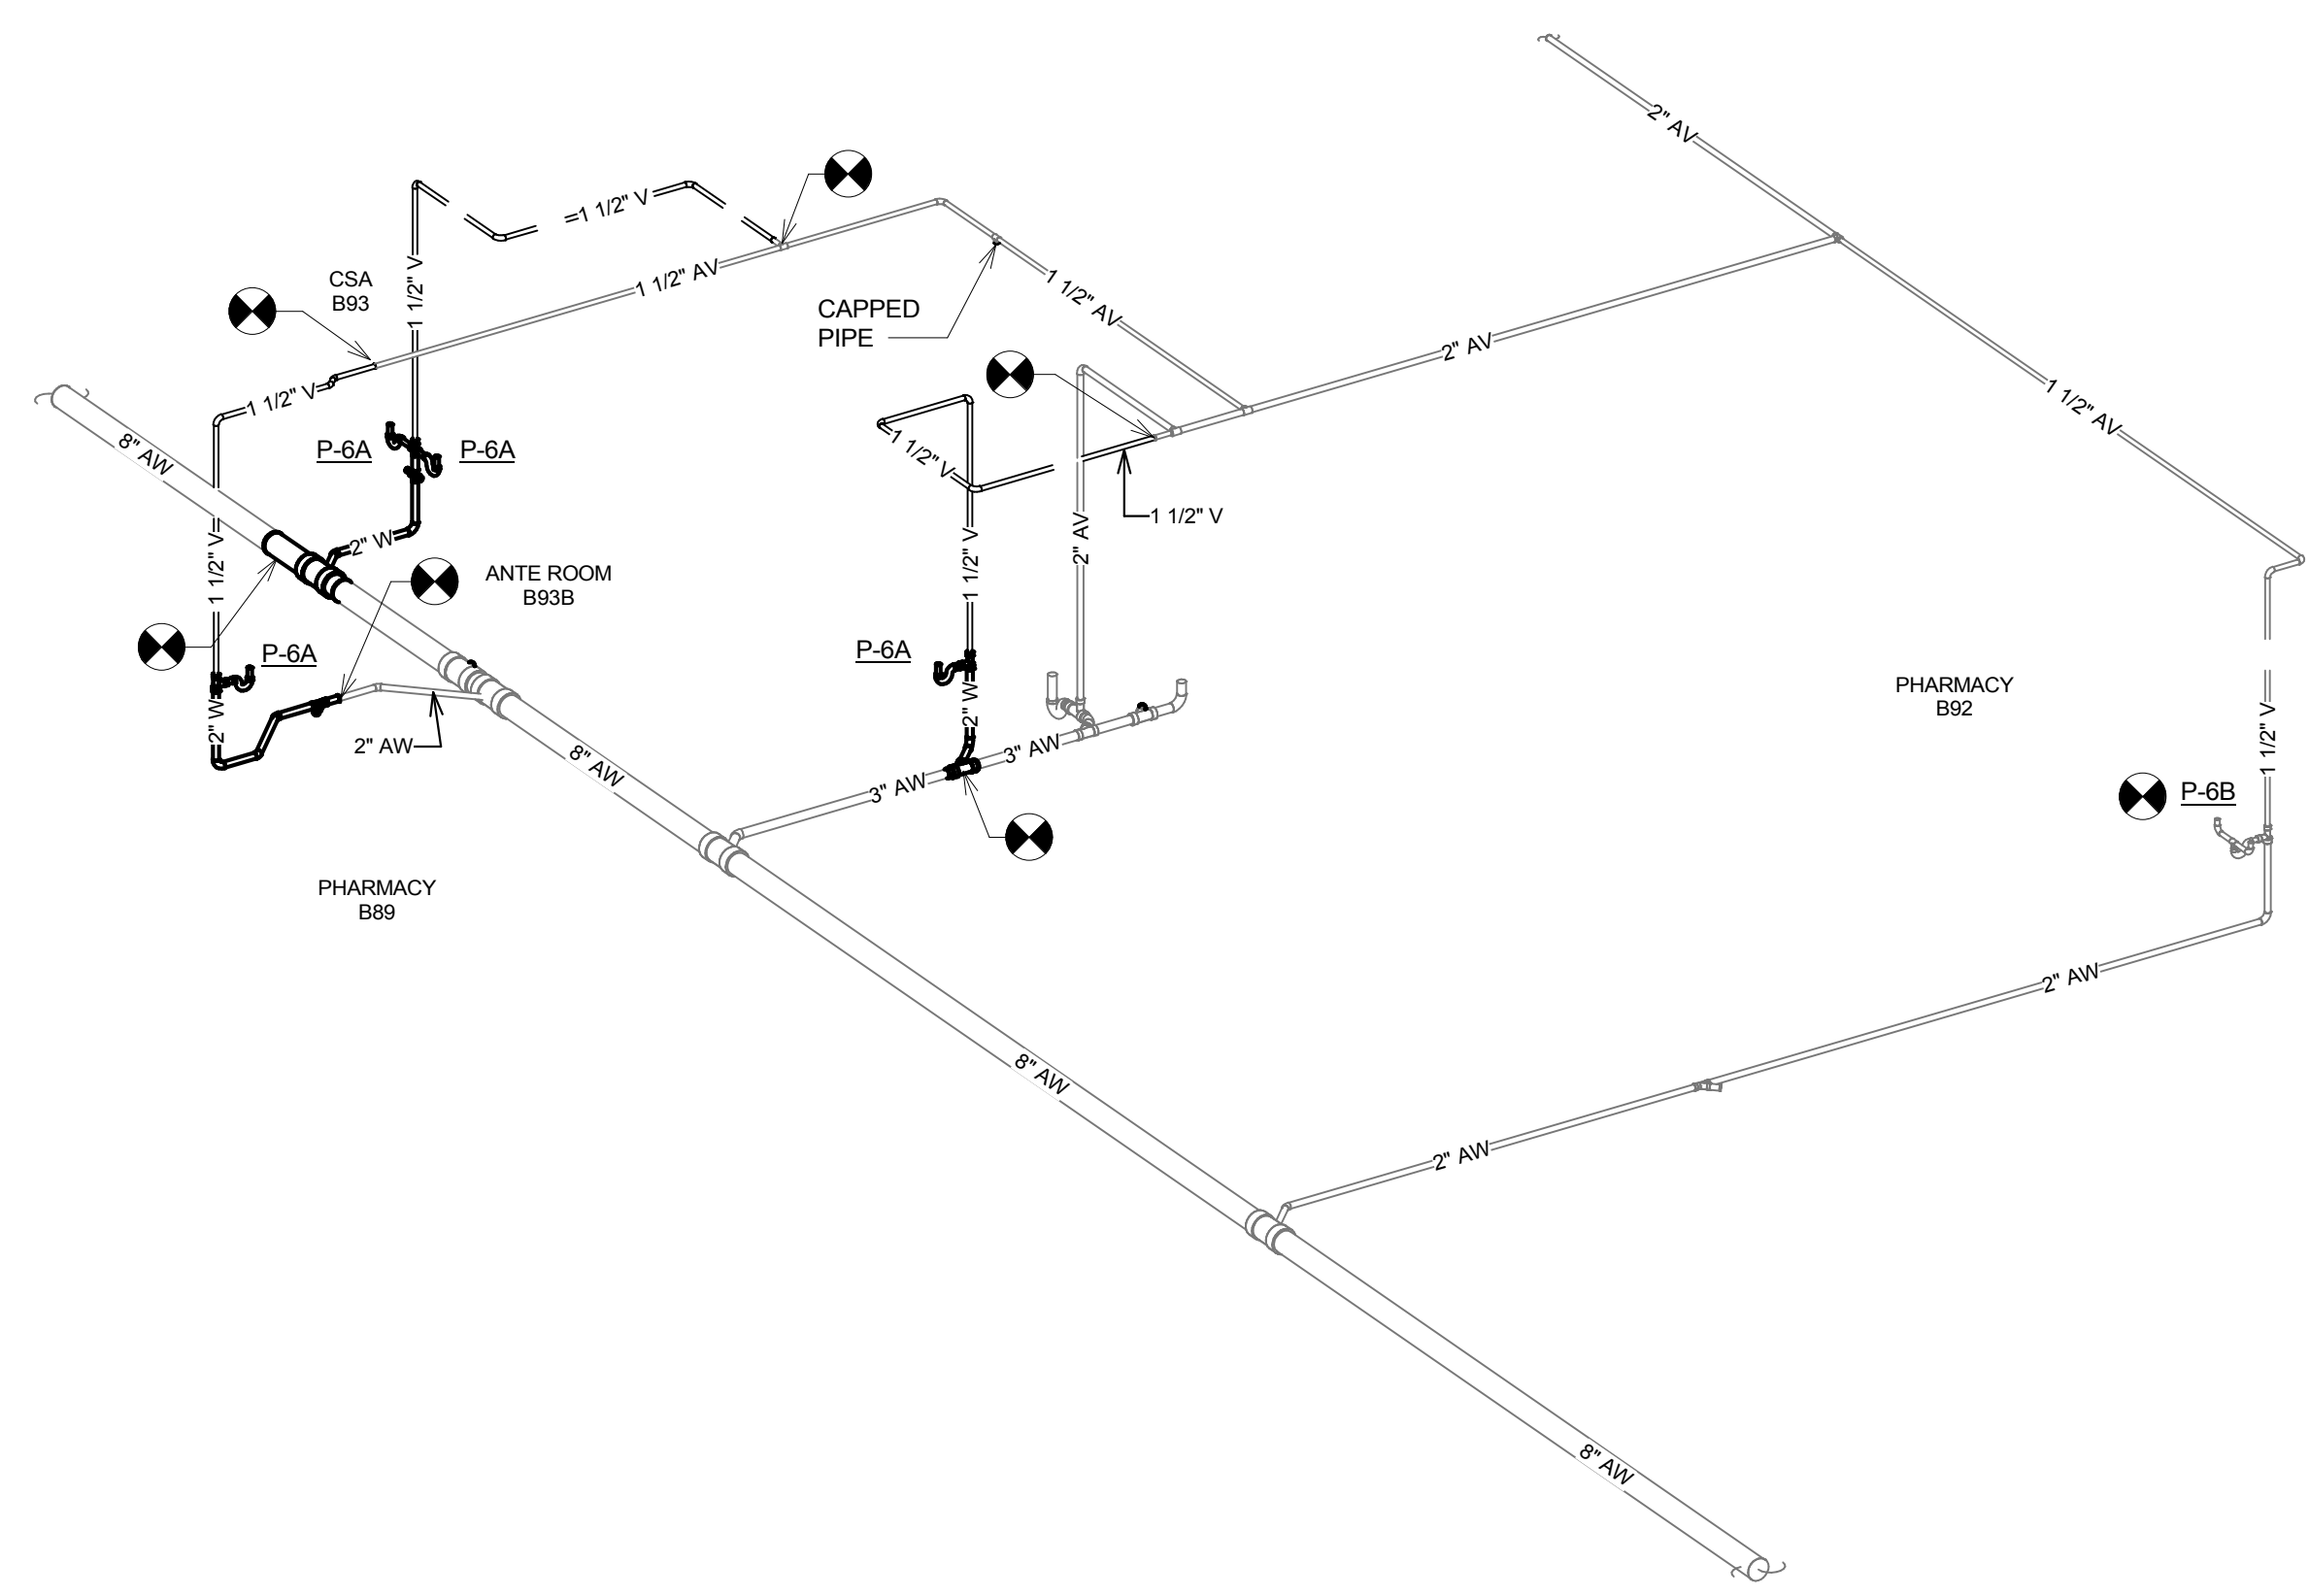
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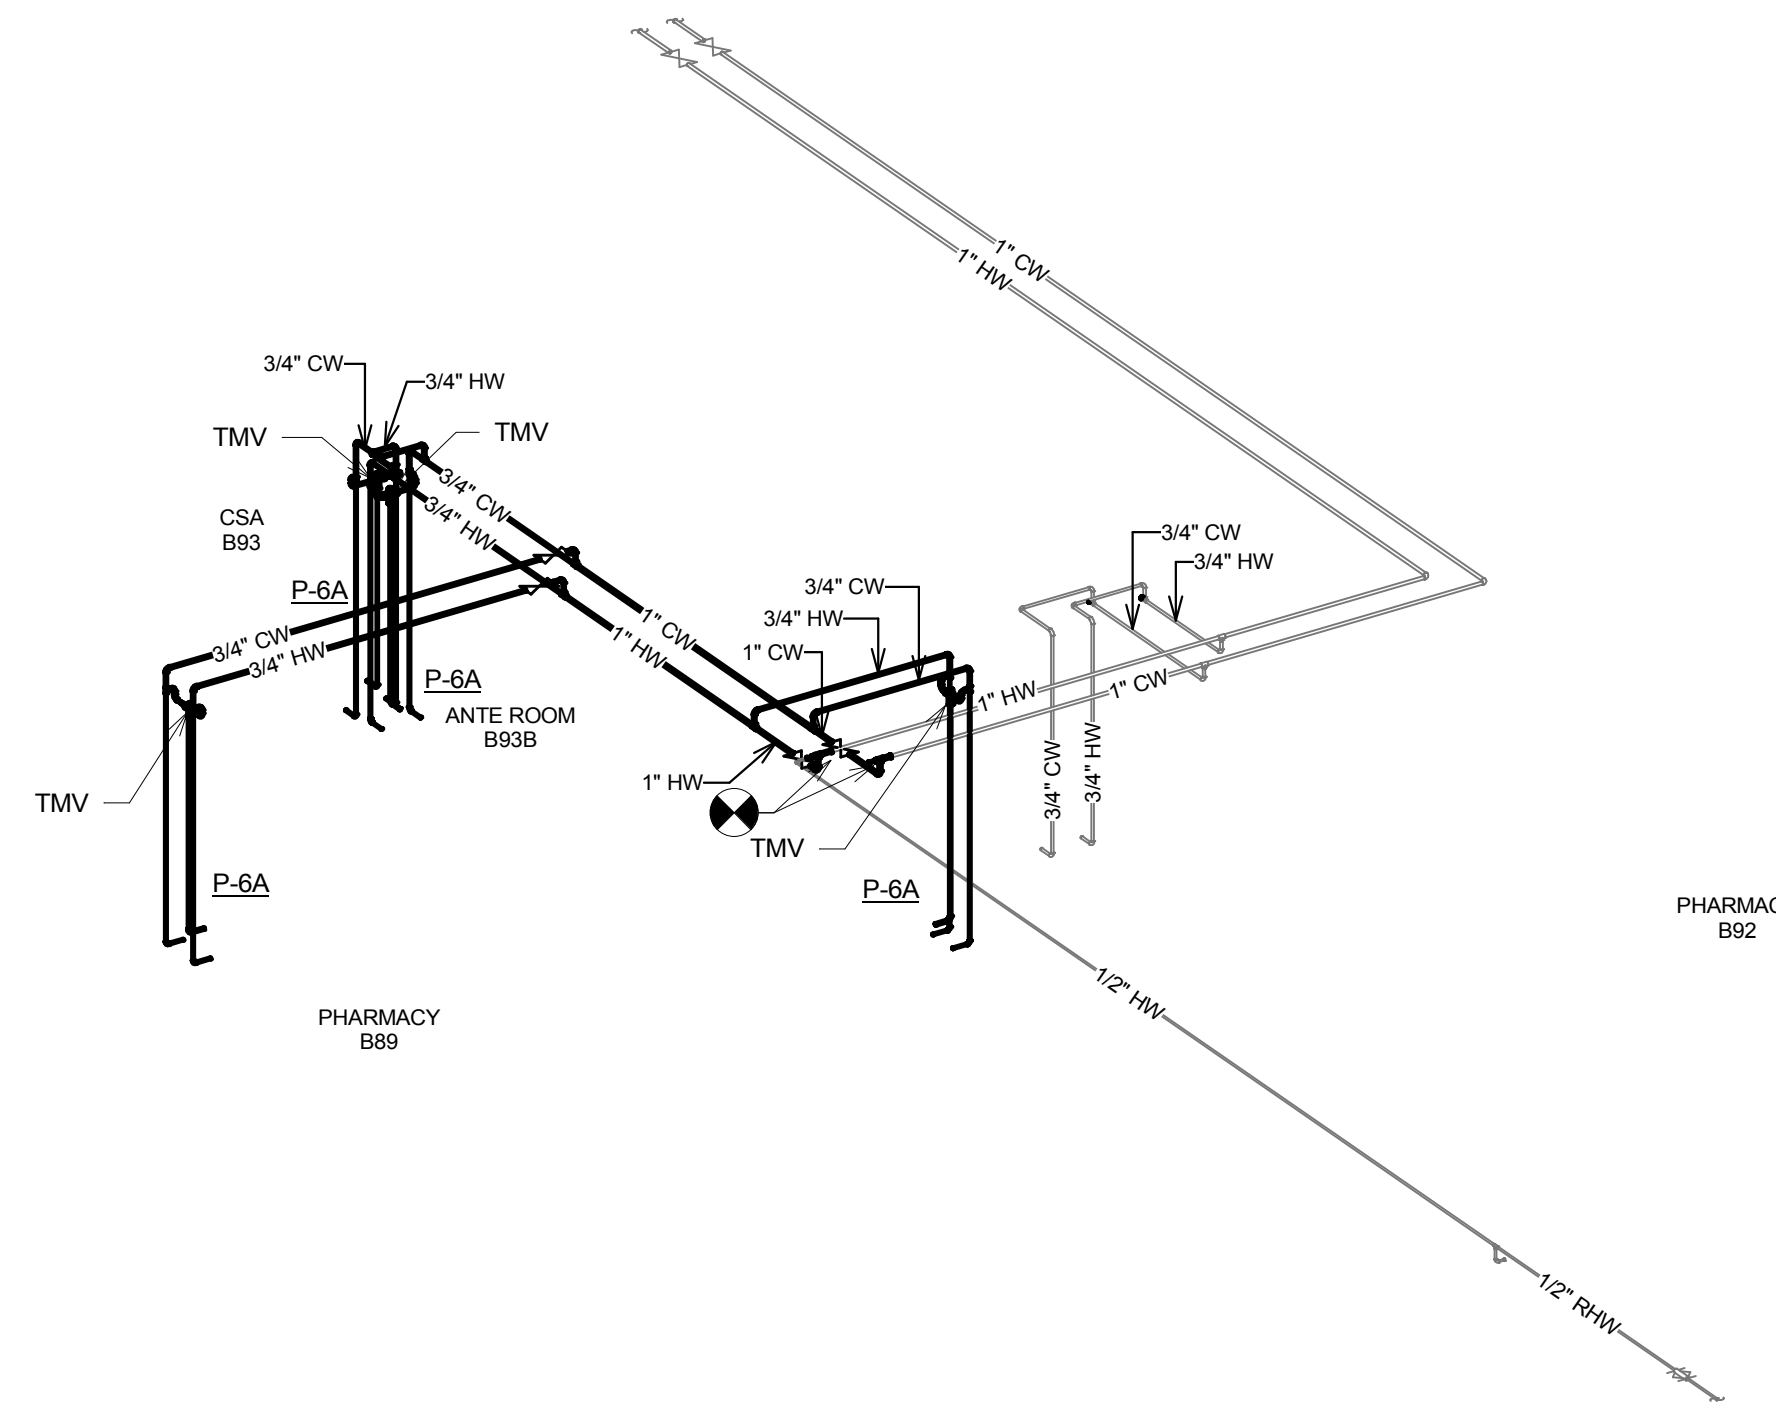
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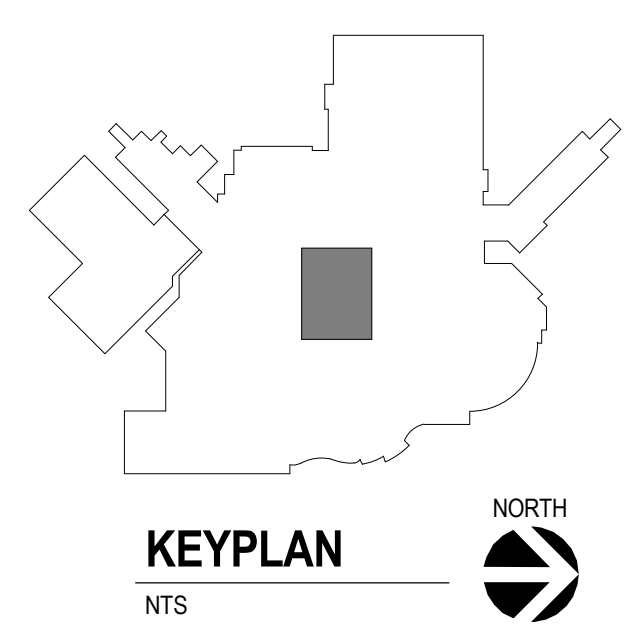
Three inches = one foot  
 one and one half inches = one foot  
 one inch = one foot  
 three quarters inch = one foot  
 one half inch = one foot  
 three eighths inch = one foot  
 one quarter inch = one foot  
 one eighth inch = one foot



1 WASTE AND VENT RISER DIAGRAM



2 DOMESTIC WATER RISER DIAGRAM



Revision#	Description	Date:

**CONSULTANTS**

MECHANICAL / ELECTRICAL / PLUMBING:  
**DUNHAM**  
 32 South Sixth Street, Suite 1100  
 Minneapolis, MN 55402  
 Phone: 612-465-7550

STRUCTURAL:  
**ERA**  
 ERICKSEN ROAD & ASSOCIATES  
 250 University Avenue West, Suite 201-S  
 Saint Paul, MN 55114  
 Phone: 651-251-7570

**ARCHITECT OF RECORD**

A/E:  
**Stone Group Architects**  
 600 E 7th Street  
 Sioux Falls, SD 57103  
 605-271-1144

**STONE GROUP ARCHITECTS**

**STAMP**

REGISTERED PROFESSIONAL ENGINEER  
 REG. NO. 14944  
**JASON R. GOTTWALT**  
 SOUTH DAKOTA

Office of Construction and Facilities Management  
**VA** U.S. Department of Veterans Affairs

Drawing Title  
**PLUMBING RISERS**

Approved:

Phase  
**BID SET**

Project Title  
**UPGRADE PHARMACY 797**

Location  
**SIoux FALLS, SOUTH DAKOTA**

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 02/10/2021


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Project Number  
 VA #438-20-109  
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Building Number  
 5

Drawing Number  
**PP500**




- KEY NOTES:**
- REMOVE EXISTING FAN FILTER UNIT ALONG WITH ALL POWER WIRING PER ELECTRICAL DRAWINGS. UPON VA REQUEST, TURN-OVER FILTER UNIT TO FACILITIES FOR USE IN SALVAGING SPARE PARTS AND DISPOSE OF REMAINING UNIT AS REQUIRED.
  - REMOVE EXISTING FAN COIL AND ASSOCIATED 5-TON CHILLER ON ROOF. REFER TO ROOF AND PIPING DEMOLITION PLANS FOR CONTINUATION OF DEMOLITION. REFER TO ELECTRICAL PLANS FOR DISCONNECTION AND REMOVAL OF POWER CONNECTIONS. CONTRACTOR TO FULLY REMOVE ALL SENSORS, WIRING, AND ASSOCIATED BUILDING AUTOMATION PROGRAMMING.
  - DISCONNECT DUCT TAKE-OFF AND REMOVE EXISTING MOTORIZED DAMPER ASSEMBLY AND ALL CONTROL WIRING AND COMPONENTS. SEAL EXISTING SUPPLY DUCT MAIN AS REQUIRED FOR 3" PRESSURE CLASS AND REINSULATE OVER DAMAGED AREA CAUSED BY DEMOLITION.
  - DISCONNECT AND REMOVE END OF SUPPLY DUCT MAIN. PROVIDE TEMPORARY GAP WHILE DUCTWORK MODIFICATIONS ARE BEING INSTALLED IN THIS AREA. REFER TO KEY NOTE #6 BELOW FOR TEMPORARY CONNECTIONS REQUIRED TO EXISTING VAV BOXES.
  - PROVIDE TEMPORARY CONNECTIONS TO THE EXISTING VAV BOXES CUT OUT OF SERVICE DURING DUCTWORK DEMOLITION IN KEY NOTE #4 ABOVE. TEMPORARY CONNECTIONS MAY UTILIZE FLEXIBLE DUCTWORK TO BE ABLE TO SHIFT DURING CONSTRUCTION PHASING.
  - REMOVE SECTION OF ABANDONED DUCTWORK OBSERVED ABOVE CEILING. CONTRACTOR TO NOTE THAT THIS SHOULD BE CONSIDERED TYPICAL OF ANY ABANDONED DUCTWORK OR PIPING SERVICES ENCOUNTERED WITHIN DIRECT PROXIMITY OF AREAS THEY ARE WORKING INSIDE. REFER TO SPECIFICATION 230511.
  - REMOVE EXISTING VAV BOX. REFER TO PIPING PLANS FOR ASSOCIATED PIPING DEMOLITION.
  - REMOVE EXHAUST DUCTWORK INDICATED COMPLETELY UP THROUGH ROOF ALONG WITH EXISTING FAN. SEE ROOF DEMOLITION PLANS. EXISTING ROOF PENETRATION MAY REMAIN TO BE MODIFIED FOR NEW EXHAUST DUCT PENETRATION, BUT SIZE MAY BE MODIFIED WITH NEW ROOF CURB.
  - REMOVE WELDED STAINLESS STEEL CHEMO EXHAUST TO POINT OF DISCONNECTION INDICATED. NOTE THAT FILM WITHIN THIS DUCT MAY BE CONSIDERED HAZARDOUS (POTENTIALLY CARCINOGEN) AND SHOULD BE SAFELY HANDLED WITH CAUTION.
  - REMOVE EXISTING TRANSFER DUCT AND DAMPER.
  - REMOVE EXISTING WALL SLEEVE AND DAMPER. EXISTING WALL PENETRATION SHOULD BE PATCHED AND SEALED AS REQUIRED.
  - SALVAGE AND CLEAN EXISTING DIFFUSER TO BE RELOCATED.
  - REMOVE EXISTING CHEMO HOOD, AND BIOSAFETY CABINET, TO BE DISPOSED OF PROPERLY. NOTE THAT THESE HOODS MAY HAVE HAZARDOUS MATERIALS OR RESIDUE WITHIN THEM AND SHOULD BE HANDLED WITH APPROPRIATE SAFETY PRECAUTIONS.
  - PRIOR TO DEMOLITION, CONNECT TWO(2) SETS OF 10" ROUND FLEXIBLE DUCT FROM SUPPLY MAIN INTO SECTION OF SUPPLY AIR BRANCH DUCTWORK INDICATED TO TEMPORARILY FEED SUPPLY AIR TO VAV BOXES CUT OUT DURING CONSTRUCTION. PERFORM PRE-DEMOLITION AIRFLOW READING ON BOTH AFFECTED VAV BOXES AND BALANCE BACK TO THOSE AIRFLOW AFTER TEMPORARY DUCTS ARE INSTALLED AND OPERATIONAL.
  - PRIOR TO DEMOLITION, PERMANENTLY RECONFIGURE VAV BOX INLET CONNECTION INTO SECTION OF BRANCH DUCTWORK TO REMAIN TEMPORARILY BACKED AFTER DEMOLITION. REFER TO NOTE #14 ABOVE FOR VAV BOX AIRFLOW READINGS PRIOR TO ANY DEMOLITION TO MATCH ORIGINAL AIR BALANCE TO TEMPORARILY CONNECTED VAV BOX DURING CONSTRUCTION.
  - AT EACH POINT OF DISCONNECTION, THE CONTRACTOR SHALL CLEAN DUCTWORK AT LEAST 120" INTO EXISTING DUCT TO REMAIN (OR AS FAR/DEEP AS POSSIBLE WITHOUT REQUIRING ADDITIONAL ACCESS PANELS). CLEANING SHALL BE WITH AN AGITATING BRUSH AND VACUUM TO REMOVE ALL DUST AND DEBRIS FROM WITHIN EXISTING DUCTWORK. ALLOW VA FACILITIES AN OPPORTUNITY TO INSPECT ON COMPLETION OF CLEANING EFFORTS.

- GENERAL NOTES:**
- MECHANICAL CONTRACTOR SHALL REFER TO THE VA MASTER SPECIFICATION MANUAL EDITED FOR THIS PROJECT ALONG WITH ANY APPLICABLE STANDARDS WITHIN THE VA DESIGN GUIDE. ALL REQUIREMENTS OF THOSE MANUALS SHALL BE MAINTAINED IN ADDITION TO ALL NOTES AND DESCRIPTIONS INDICATED WITHIN THESE DRAWINGS. ANY CONFLICTS BETWEEN THOSE DOCUMENTS SHOULD BE BROUGHT TO THE ATTENTION OF THE ENGINEER FOR INTERPRETATION.
  - MECHANICAL CONTRACTOR WILL BE RESPONSIBLE TO REVIEW ACCESSIBILITY TO AREAS OUTSIDE THE CONSTRUCTION LIMITS TO DETERMINE APPROXIMATE AMOUNT OF OVERTIME REQUIRED TO PERFORM ALL MECHANICAL WORK INDICATED. COORDINATION OF SCHEDULES WITH ADJACENT DEPARTMENTS AND CLEANING OF ALL DEBRIS AFTER EACH WORK SHIFT SHOULD BE ASSURED IN THE BASE BID.
  - ANY MAJOR VENTILATION OUTAGES INDICATED ON THESE DRAWINGS SHALL BE SCHEDULED TO BE PERFORMED AFTER NORMAL BUSINESS HOURS OR DURING WEEKEND PERIODS TO MINIMIZE DISRUPTION. VA HOSPITAL FACILITIES WILL REQUIRE A MINIMUM OF TWO(2) WEEKS NOTICE PRIOR TO ANY SUCH OUTAGE AFFECTING MORE THAN ONE ADJACENT AREA.
  - WHERE MECHANICAL SYSTEMS TO REMAIN ARE DAMAGED, OR DISTURBED, DURING THE COURSE OF CONSTRUCTION THE CONTRACTOR WILL BE RESPONSIBLE TO REMOVE DAMAGED PORTIONS AND INSTALL NEW PRODUCTS OF EQUAL QUALITY AND FUNCTIONALITY.
  - ALL EXISTING DUCTWORK AND PIPING THROUGH NEW FIRE RATED WALLS SHALL BE ADEQUATELY FIRE SEALED AS REQUIRED. PIPING PENETRATIONS THROUGH INTERSTITIAL FLOOR SHALL BE DRILLED OR CUT, BY THE CONTRACTOR AND FIRE SEALED AS REQUIRED.
  - THE EXACT LOCATION OF EQUIPMENT ROUGHINGS SHALL BE VERIFIED WITH THE STAMPED APPROVED SHOP DRAWINGS PRIOR TO ANY FIELD INSTALLATION.
  - THE MECHANICAL CONTRACTOR WILL BE RESPONSIBLE TO MAINTAIN EACH PROJECT SPACE IN A NEGATIVE PRESSURIZATION AND PROVIDE HEPA FILTRATION UNITS AS REQUIRED BY INFECTION CONTROL. IF NECESSARY CONSULT WITH VA, OR ENGINEER OF RECORD, FOR SUGGESTED METHODS THAT MAY BE UTILIZED TO ELIMINATE CONTAMINATED AIR TO OUTSIDE. VISUAL PRESSURIZATION INDICATORS SHALL BE PROVIDED AT EACH ENTRANCE TO THE CONSTRUCTION ZONE AND MONITORED DAILY TO INSURE A CONSTANT NEGATIVE PRESSURE IS MAINTAINED THROUGHOUT EACH PHASE. COORDINATE PRESSURIZATION PLANNING WITH VA FACILITIES AND INFECTION CONTROL REPRESENTATIVE PRIOR TO EACH CONSTRUCTION PHASE.
  - ALL EXISTING RETURN/EXHAUST DUCTWORK NOT TEMPORARILY GAPPED SHALL BE PROTECTED WITH REMOVABLE FILTER MEDIA TO PROTECT EXISTING DUCT SYSTEMS FROM CONSTRUCTION DEBRIS. ALL NEW DUCTWORK SHALL BE PROTECTED AS REQUIRED AND CLEANED PRIOR TO STARTUP. IF CONSTRUCTION DEBRIS IS FOUND INSIDE UNPROTECTED DUCTWORK THEN DUCT CLEANING OF THE ENTIRE SYSTEM SHALL BE PERFORMED AT THE CONTRACTOR'S EXPENSE.
  - ALL WORK OUTSIDE THE PROTECTED PROJECT BOUNDARIES ABOVE EXISTING CEILING SHALL BE COMPLETED WITH CEILING REPLACED IN THE SAME DAY UNLESS FULLY COORDINATED THROUGH INFECTION CONTROL. CLEAN AREA TO ORIGINAL CONDITION ON COMPLETION.
  - CONTRACTOR TO INSTALL TEMPORARY BARRIERS FOR EACH PROJECT PHASE AND/OR AREA. THESE BARRIERS SHALL BE COORDINATED WITH VA HOSPITAL AND, IN MOST CASES, CONTAIN SOME FORM OF AIRLOCK VESTIBULE PRIOR TO ENTERING THE CONSTRUCTION AREA.
  - FLUTTER STRIPS OR AIR PRESSURE GAUGES SHALL BE PROVIDED AT THE ENTRANCES TO EACH CONSTRUCTION AREA. ALL CONTRACTED WORKERS SHALL BE TRAINED TO VISUALLY MONITOR THESE DEVICES FOR ADEQUATE NEGATIVE PRESSURIZATION AS THEY ENTER/EXIT THE CONSTRUCTION AREA. DAILY LOGS SHALL BE KEPT BY THE MECHANICAL CONTRACTOR TO INSURE CONSTANT PRESSURIZATION HAS BEEN MAINTAINED.
  - NEGATIVE PRESSURIZATION SHALL BE MAINTAINED IN EACH CONSTRUCTION AREA. IF LOCATED ON AN EXTERIOR WALL FANS SHOULD BE UTILIZED TO EXHAUST AIR DIRECTLY OUT A NEARBY WINDOW, TAKING PRECAUTIONS TO NOT INTERFERE WITH EXISTING BUILDING AIR INTAKES, PUBLIC AREAS, ETC. IF NO EXTERIOR WALL IS AVAILABLE THEN NEGATIVE AIR MACHINES WITH INTERNAL FILTRATION SHALL BE PROVIDED AND CONNECTION TO THE NEAREST EXHAUST OR RETURN DUCT AVAILABLE (CONTACT ENGINEER TO VERIFY EXISTING DUCTWORK CAPACITY PRIOR TO EXHAUST CONNECTION).
  - TAKEOFFS TO SUPPLY AIR DIFFUSERS AND REGISTERS SHALL BE SAME SIZE AS DUCT CONNECTION SIZE, UNLESS OTHERWISE NOTED.

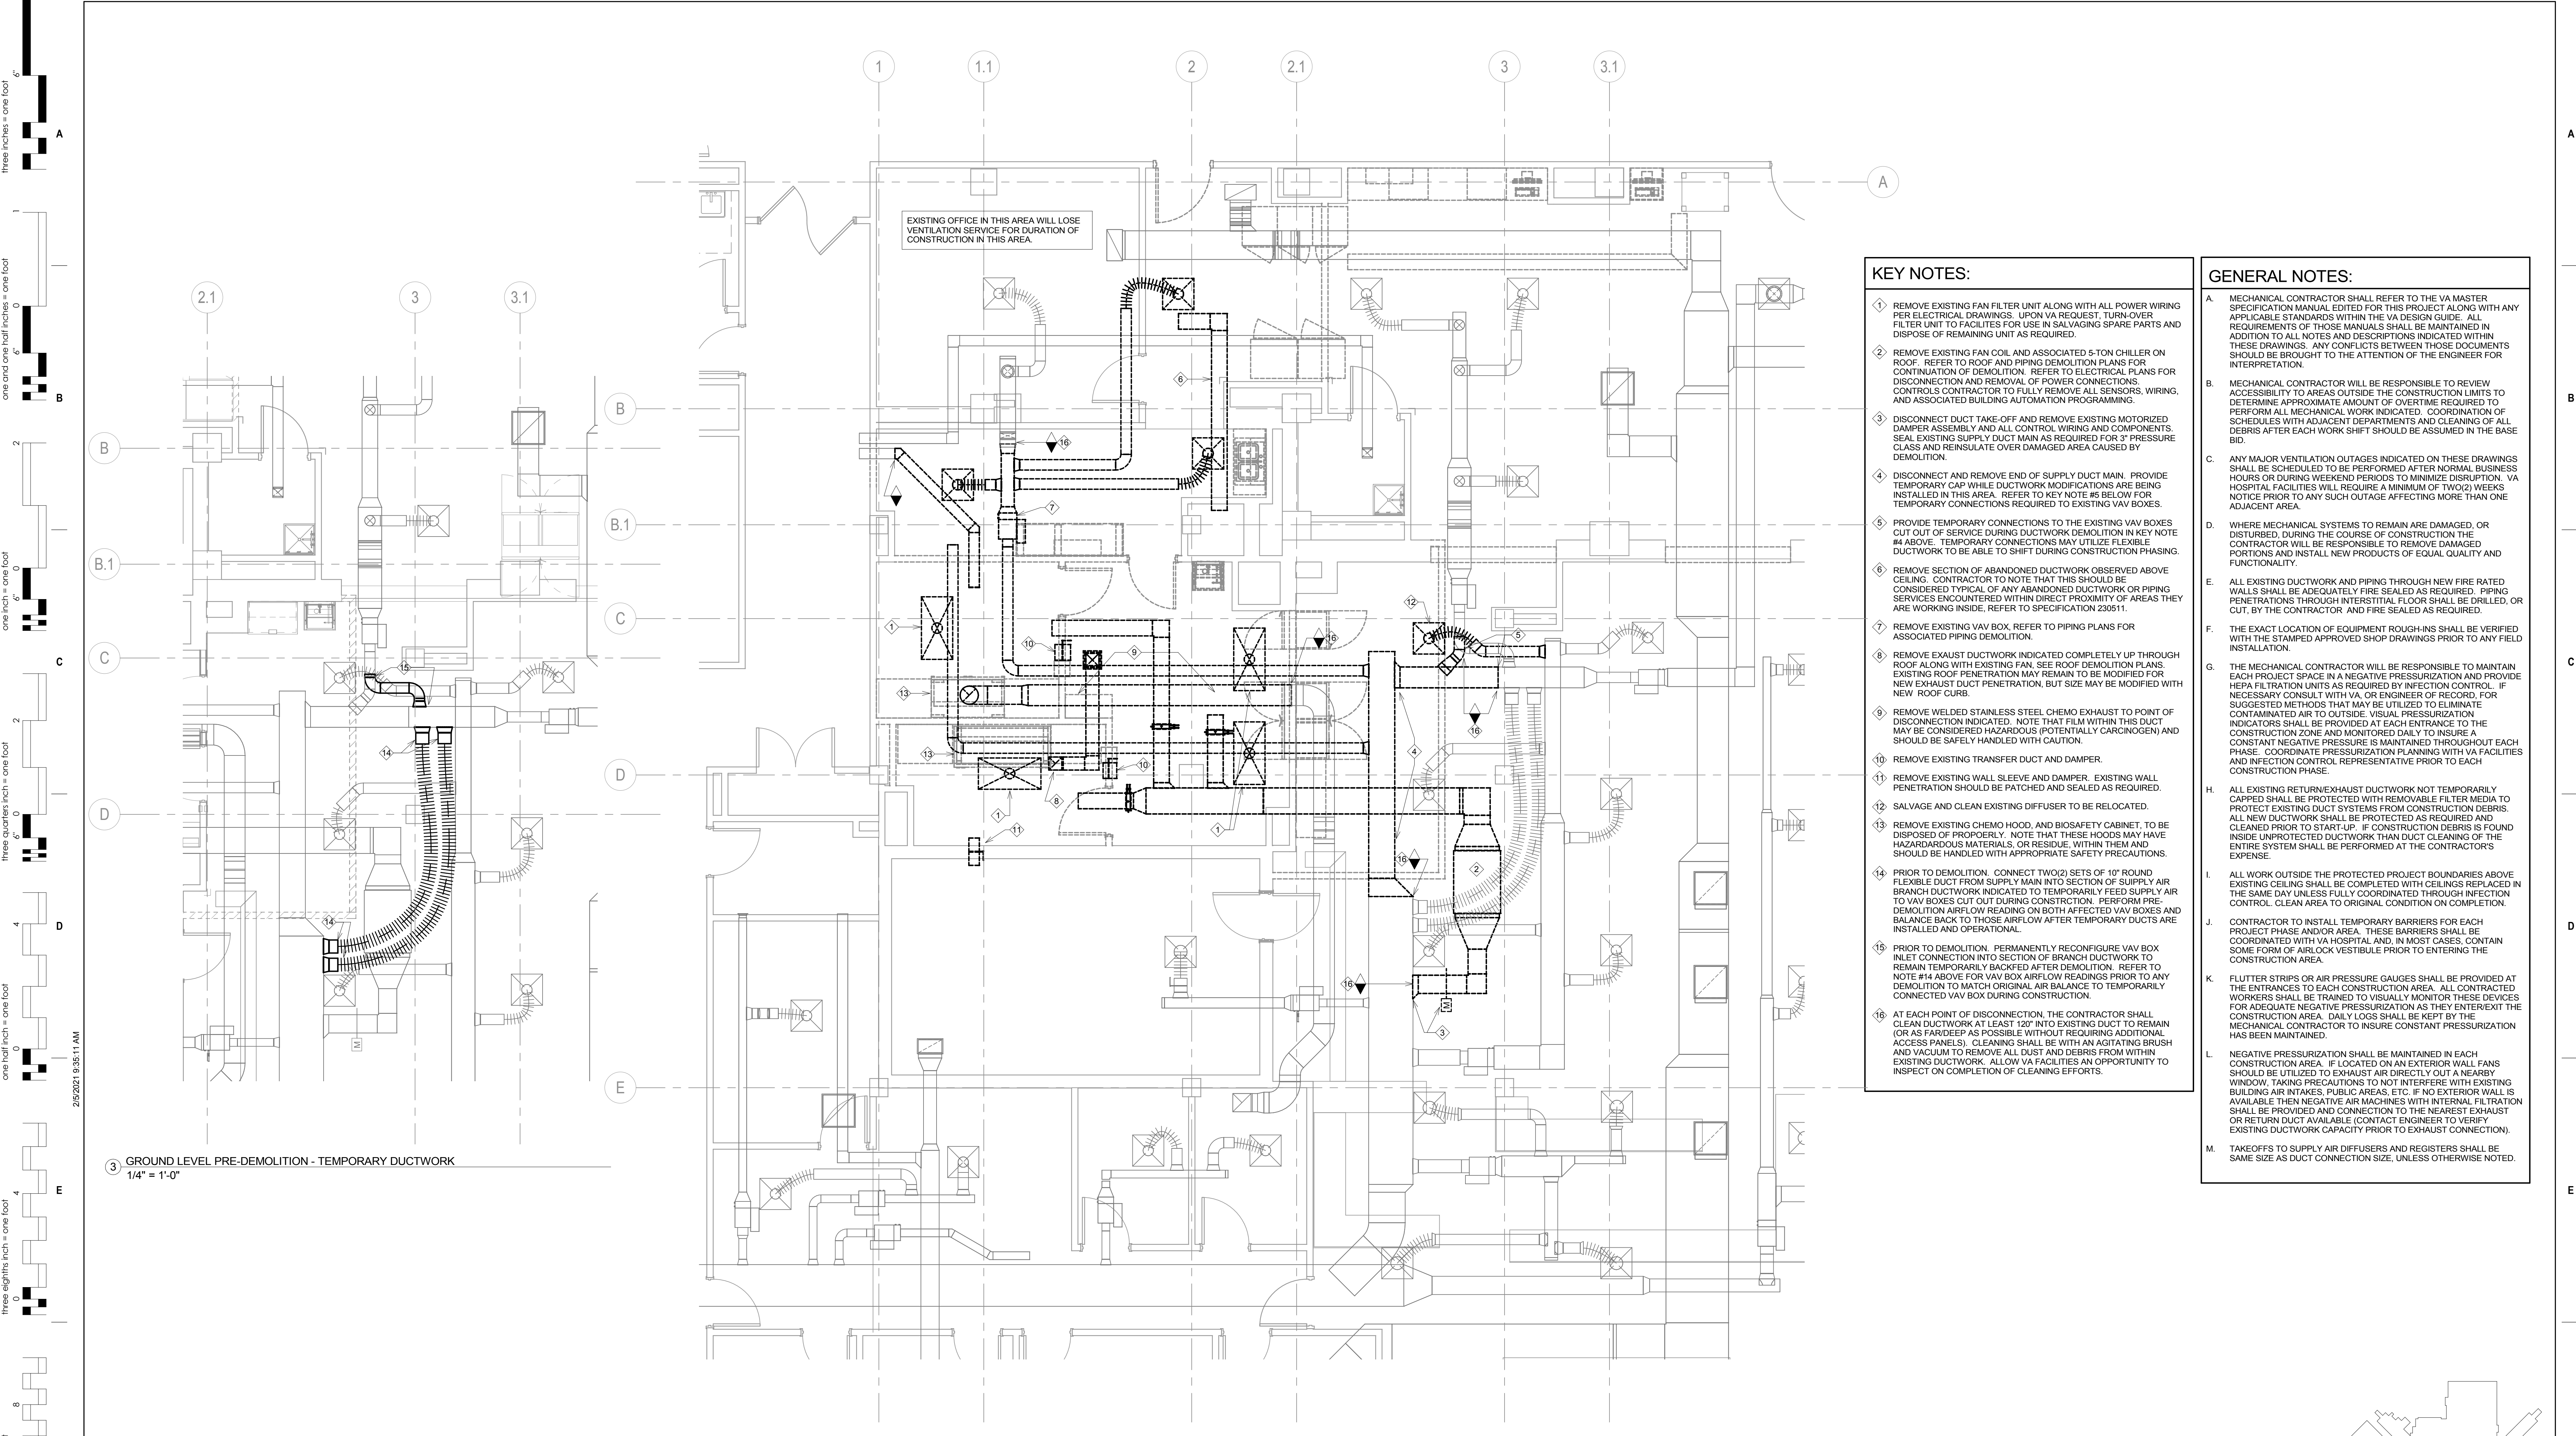3 GROUND LEVEL PRE-DEMOLITION - TEMPORARY DUCTWORK  
1/4" = 1'-0"

1 GROUND LEVEL DEMOLITION HVAC PLAN  
1/4" = 1'-0"

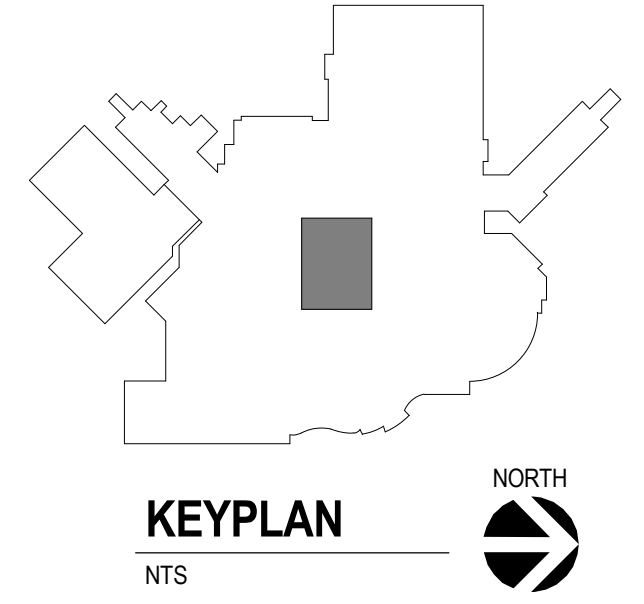

Revision#	Description	Date:

**CONSULTANTS**

MECHANICAL / ELECTRICAL / PLUMBING:  
**DUNHAM**  
DUNHAM  
32 South Sixth Street, Suite 1100  
Minneapolis, MN 55402  
Phone: 612-465-7550

STRUCTURAL:  
**ERA**  
ERICKSEN ROED  
A ASSOCIATES  
Ericksen Road & Associates  
2250 University Avenue West, Suite 201-S  
Saint Paul, MN 55114  
Phone: 651-251-7570

**ARCHITECT OF RECORD**

A/E:  
**Stone Group Architects**  
600 E 7th Street  
Sioux Falls, SD 57103  
605-271-1144

**STONE GROUP ARCHITECTS**

**STAMP**

REGISTERED PROFESSIONAL ENGINEER  
REG. NO. 14944  
**JASON R. GOTTWALT**  
SOUTH DAKOTA

**Office of Construction and Facilities Management**

**VA** U.S. Department of Veterans Affairs

Drawing Title  
**GROUND LEVEL DEMOLITION HVAC PLAN**

Phase  
**BID SET**

Approved:

Project Title  
**UPGRADE PHARMACY 797**

Location  
**SIoux FALLS, SOUTH DAKOTA**

Issue Date  
**02/10/2021**

Checked  
**JRG**

Drawn  
**TNH**

Project Number  
**VA #438-20-109 SGA #201927**


Building Number  
**5**

Drawing Number  
**MDH101**


**GENERAL NOTES:**

A. ANY MODIFICATIONS TO EXISTING ROOF CURBS, FLASHING, OR PATCHING OF EXISTING PENETRATIONS SHALL BE PERFORMED BY THE ORIGINAL ROOFING CONTRACTOR TO MAINTAIN ANY EXISTING ROOF WARRANTIES THAT MAY BE CURRENTLY ACTIVE.

- KEY NOTES:**
1. REMOVE EXISTING 5-TON CHILLER SYSTEM INCLUDING INTERNAL PUMPS, BUFFER TANK, PIPING COMPONENTS, CONTROLS, ETC. FULLY REMOVE ASSOCIATED EQUIPMENT CURB TO BE REPLACED, OR MODIFIED, FOR NEW CONDENSING UNIT EQUIPMENT TO BE INSTALLED IN THIS SAME LOCATION. CONTRACTOR SHALL USE THE ORIGINAL ROOFING CONTRACTOR TO MAINTAIN ANY CURRENT ROOF WARRANTIES IN PLACE.
  2. REMOVE EXISTING CHILLED WATER PIPING DOWN THROUGH ROOF. REFER TO DRAWING MDH101 FOR CONTINUATION. PATCH AND REPAIR REMAINING ROOF PENETRATIONS AS REQUIRED.
  3. REMOVE EXISTING EXHAUST FAN. TEMPORARILY COVER EXISTING ROOF PENETRATION WEATHERTIGHT TO BE MODIFIED FOR NEW FAN INSTALLATION. REFER TO DRAWING MH102.
  4. REMOVE EXISTING CHEMO EXHAUST TO BE REPLACED WITH NEW PLUME STACK EXHAUST FAN. REMOVE ASSOCIATED DUCTWORK BACK TO FLOOR PENETRATION FOR INSTALLATION OF NEW DOUBLE WALL DUCTWORK DIRECTLY ON ROOF. REFER TO DRAWING MH102.

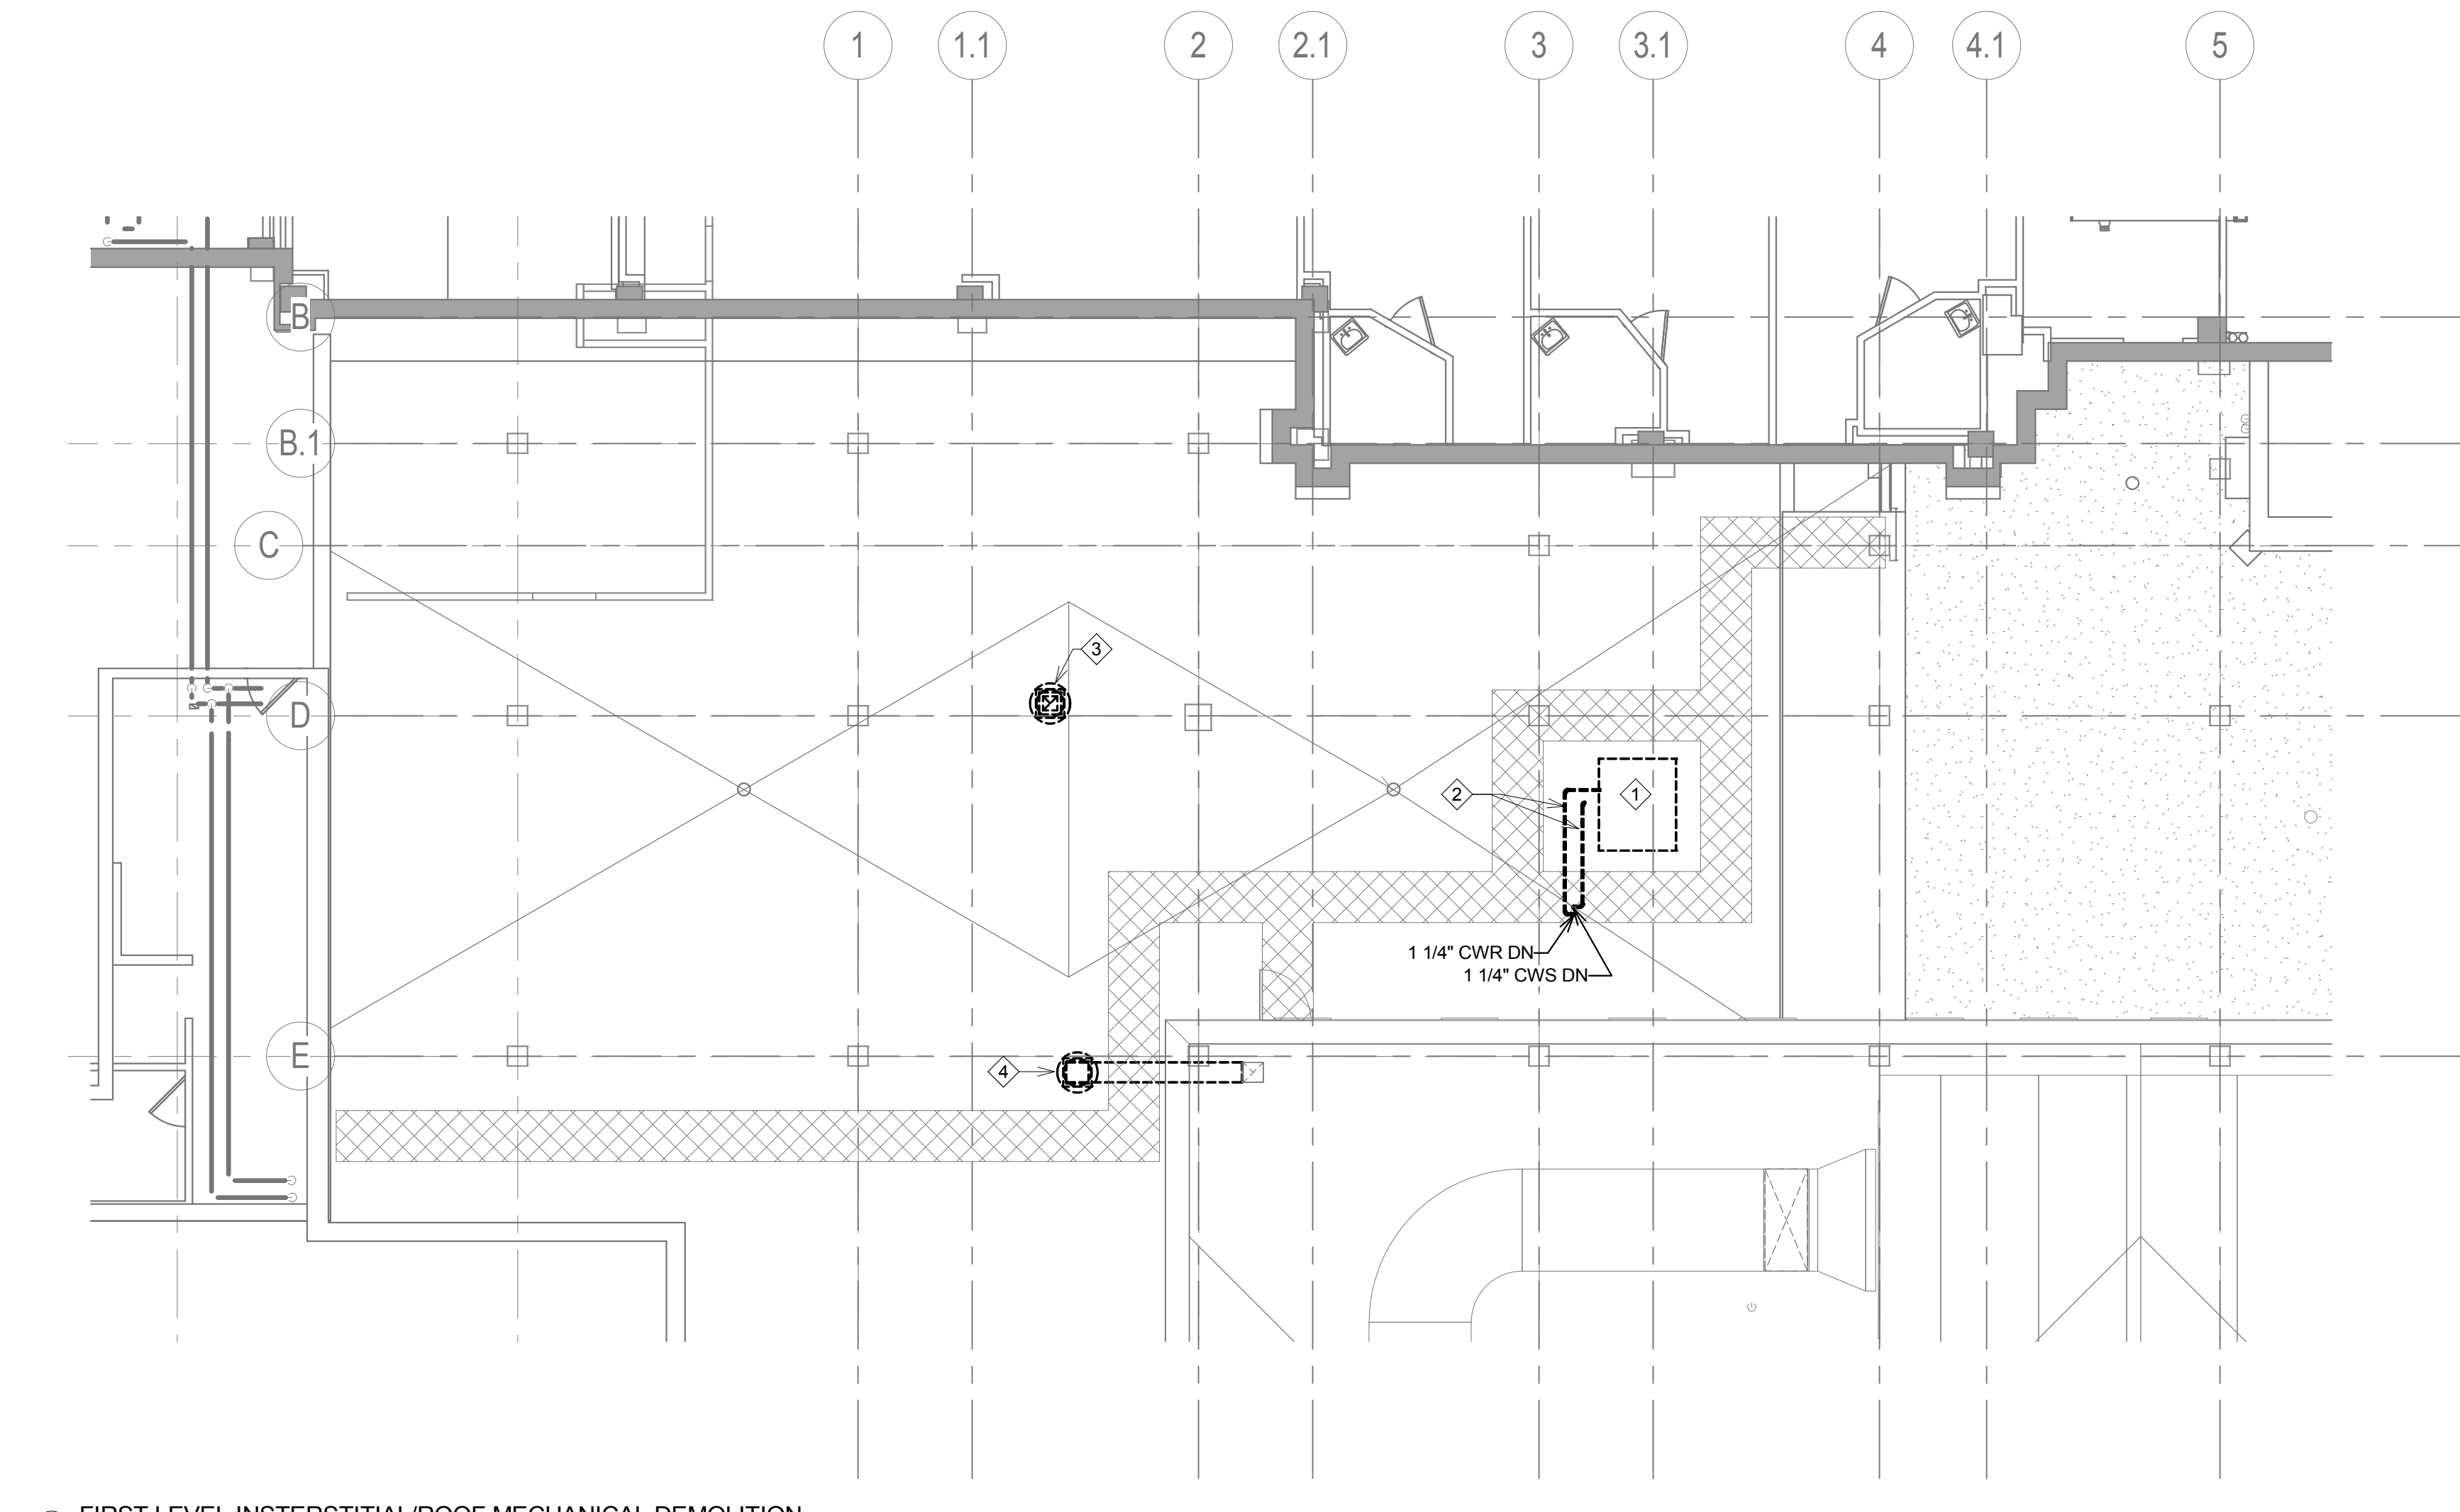

1 FIRST LEVEL INTERSTITIAL/ROOF MECHANICAL DEMOLITION  
1/8" = 1'-0"

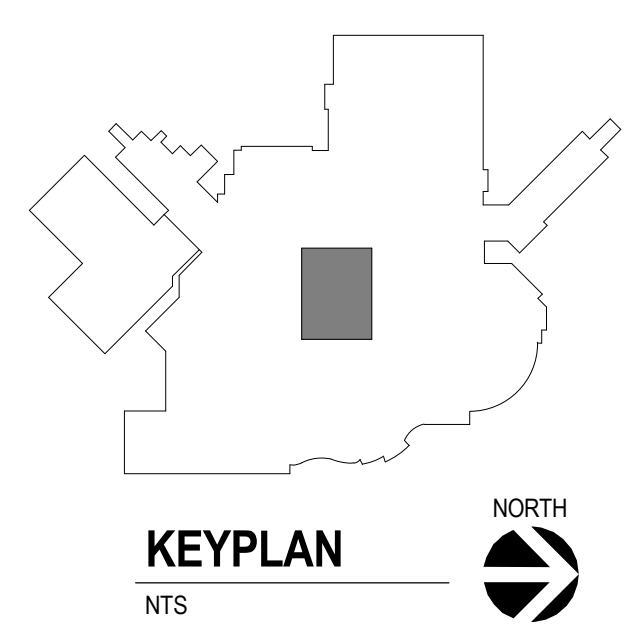

Scale indicators on the left margin: Three inches = one foot, one and one half inches = one foot, one inch = one foot, three quarters inch = one foot, one half inch = one foot, three eighths inch = one foot, one quarter inch = one foot, one eighth inch = one foot.

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Revision#	Description	Date:

**CONSULTANTS**

**MECHANICAL / ELECTRICAL / PLUMBING:**  
**DUNHAM**  
 32 South Sixth Street, Suite 1100  
 Minneapolis, MN 55402  
 Phone: 612-465-7550

**STRUCTURAL:**  
**ERA**  
 ERICKSEN ROAD  
 A ASSOCIATES  
 Erickson Road & Associates  
 2250 University Avenue West, Suite 201-S  
 Saint Paul, MN 55114  
 Phone: 651-251-7570

**ARCHITECT OF RECORD**

**A/E:**  
**Stone Group Architects**  
 600 E 7th Street  
 Sioux Falls, SD 57103  
 605-271-1144

**STONE GROUP ARCHITECTS**

**STAMP**

REGISTERED PROFESSIONAL ENGINEER  
 REG. NO. 14944  
**JASON R. GOTTWALT**  
 SOUTH DAKOTA

**Office of Construction and Facilities Management**

**VA** U.S. Department of Veterans Affairs

Drawing Title  
**FIRST LEVEL INTERSTITIAL/ROOF MECHANICAL DEMOLITION**

Approved:

Phase  
**BID SET**

Project Title  
**UPGRADE PHARMACY 797**

Location  
**SIoux FALLS, SOUTH DAKOTA**

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 02/10/2021

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 JRG

Drawn  
 TNH

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Building Number  
 5

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**MDH111**