



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	CONSTRUCTION LIMITS
	ADJACENT PROPERTY
	BUILDING SETBACKS
	PARKING SETBACK
	DRAINAGE AND UTILITY EASEMENT
	PROPOSED CONCRETE C&G
	PROPOSED BITUMINOUS PAVEMENT
	PROPOSED CONCRETE PAVEMENT
	NO PARKING ZONE
	HANDICAP STALL DESIGNATION
	NUMBER OF PARKING STALL IN SECTION

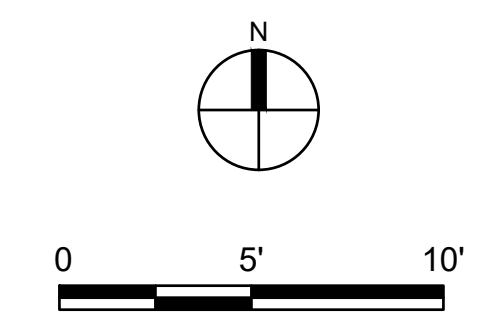

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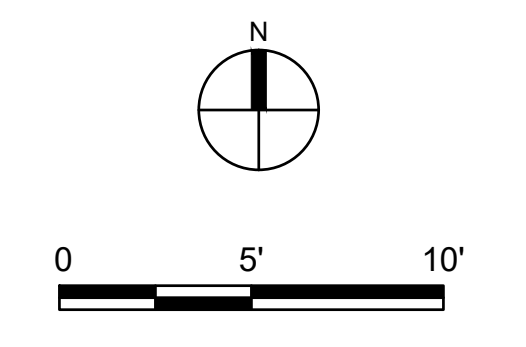
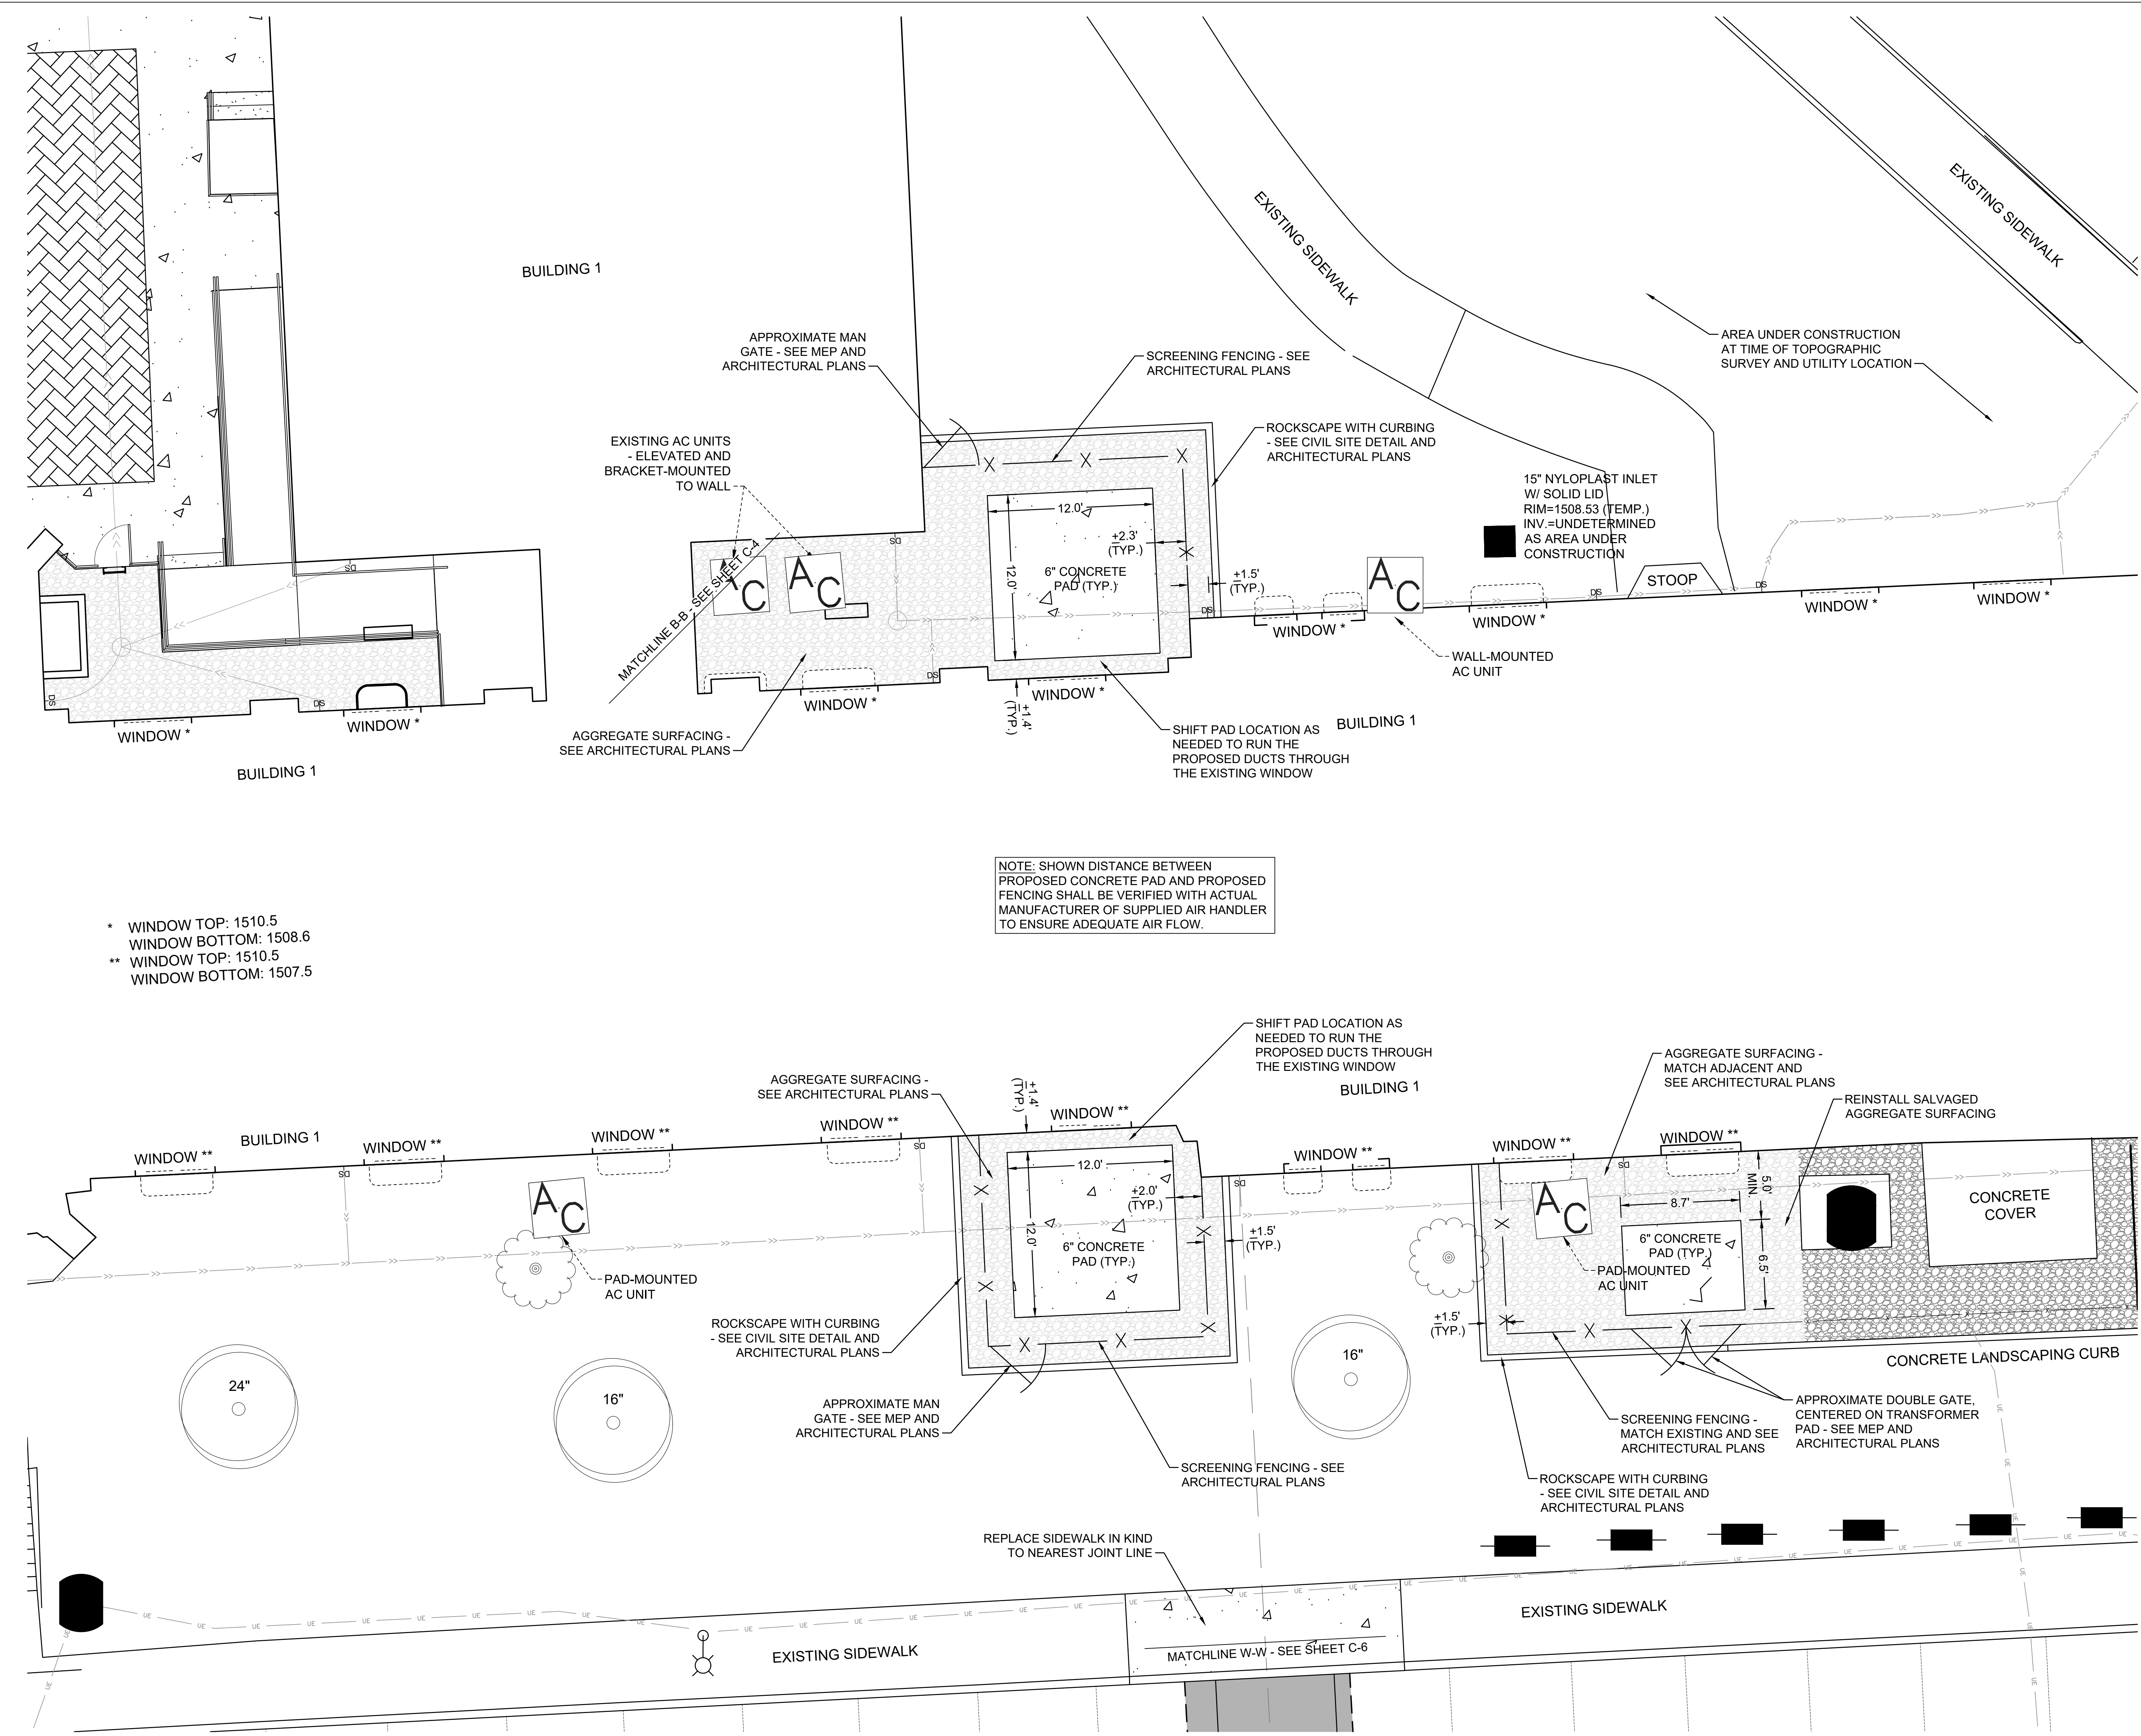
Revisions: 1 2 3 4 5 6 7 8 9 10	CONSULTANT engineering discipline <EDIT TEXT> Consultant firm name Consultant firm street address Consultant firm city, state, zip code Consultant firm phone number Consultant POC	ARCHITECT/ENGINEER OF RECORD 13605 1st Ave. N. #100 Plymouth, MN 55441 P 763.412.4000 F 763.412.4090 ae-mn.com Anderson Engineering of Minnesota, LLC Proj # 15522	STAMP I hereby certify that this plan, specification, or report was prepared by me or under my direct supervision and that I am a duly Licensed Professional Engineer under the laws of the State of Minnesota. JAY RONALD KOESTER PRINT NAME SIGNATURE 44433 REGISTRATION NUMBER 06/17/2020 DATE	Office of Construction and Facilities Management VA U.S. Department of Veterans Affairs	Drawing Title SITE PLAN - PATIO AREA	Phase CONSTRUCTION DOCUMENTS	Project Title RENOVATE OLD CHAPEL AND AUDITORIUM	Project Number 438-19-301
					Approved: Project Director	Location Sioux Falls, South Dakota	Issue Date June 17, 2020	Checked JRK

LEGEND	
	PROPERTY LIMITS
	CONSTRUCTION LIMITS
	ADJACENT PROPERTY
	BUILDING SETBACKS
	PARKING SETBACK
	DRAINAGE AND UTILITY EASEMENT
	PROPOSED CONCRETE C&G
	PROPOSED BITUMINOUS PAVEMENT
	PROPOSED CONCRETE PAVEMENT
	NO PARKING ZONE
	HANDICAP STALL DESIGNATION
	NUMBER OF PARKING STALL IN SECTION



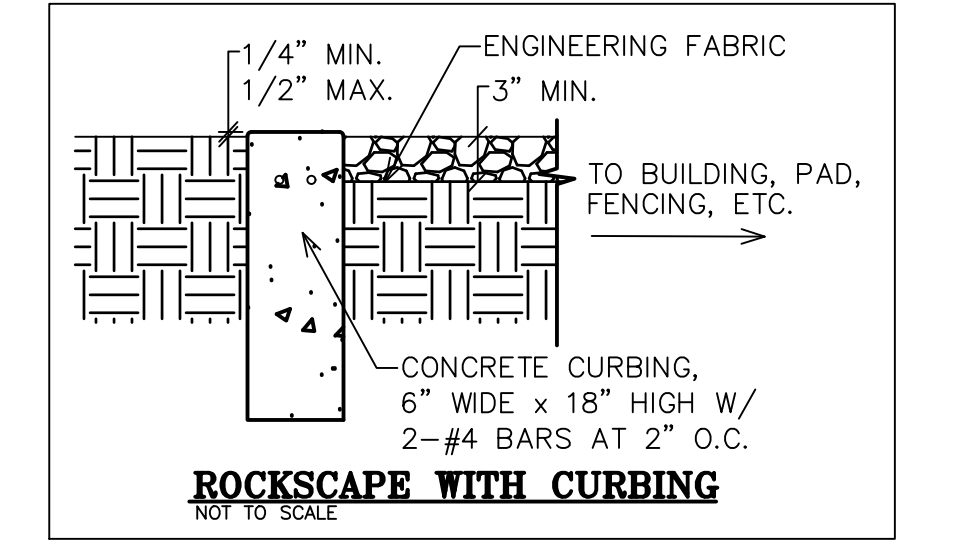
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WINDOW BOTTOM: 1508.6
** WINDOW TOP: 1510.5
WINDOW BOTTOM: 1507.5

NOTE: SHOWN DISTANCE BETWEEN PROPOSED CONCRETE PAD AND PROPOSED FENCING SHALL BE VERIFIED WITH ACTUAL MANUFACTURER OF SUPPLIED AIR HANDLER TO ENSURE ADEQUATE AIR FLOW.




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	CONSTRUCTION LIMITS
	ADJACENT PROPERTY
	BUILDING SETBACKS
	PARKING SETBACK
	DRAINAGE AND UTILITY EASEMENT
	PROPOSED CONCRETE C&G
	PROPOSED BITUMINOUS PAVEMENT
	PROPOSED CONCRETE PAVEMENT
	NO PARKING ZONE
	HANDICAP STALL DESIGNATION
	NUMBER OF PARKING STALL IN SECTION

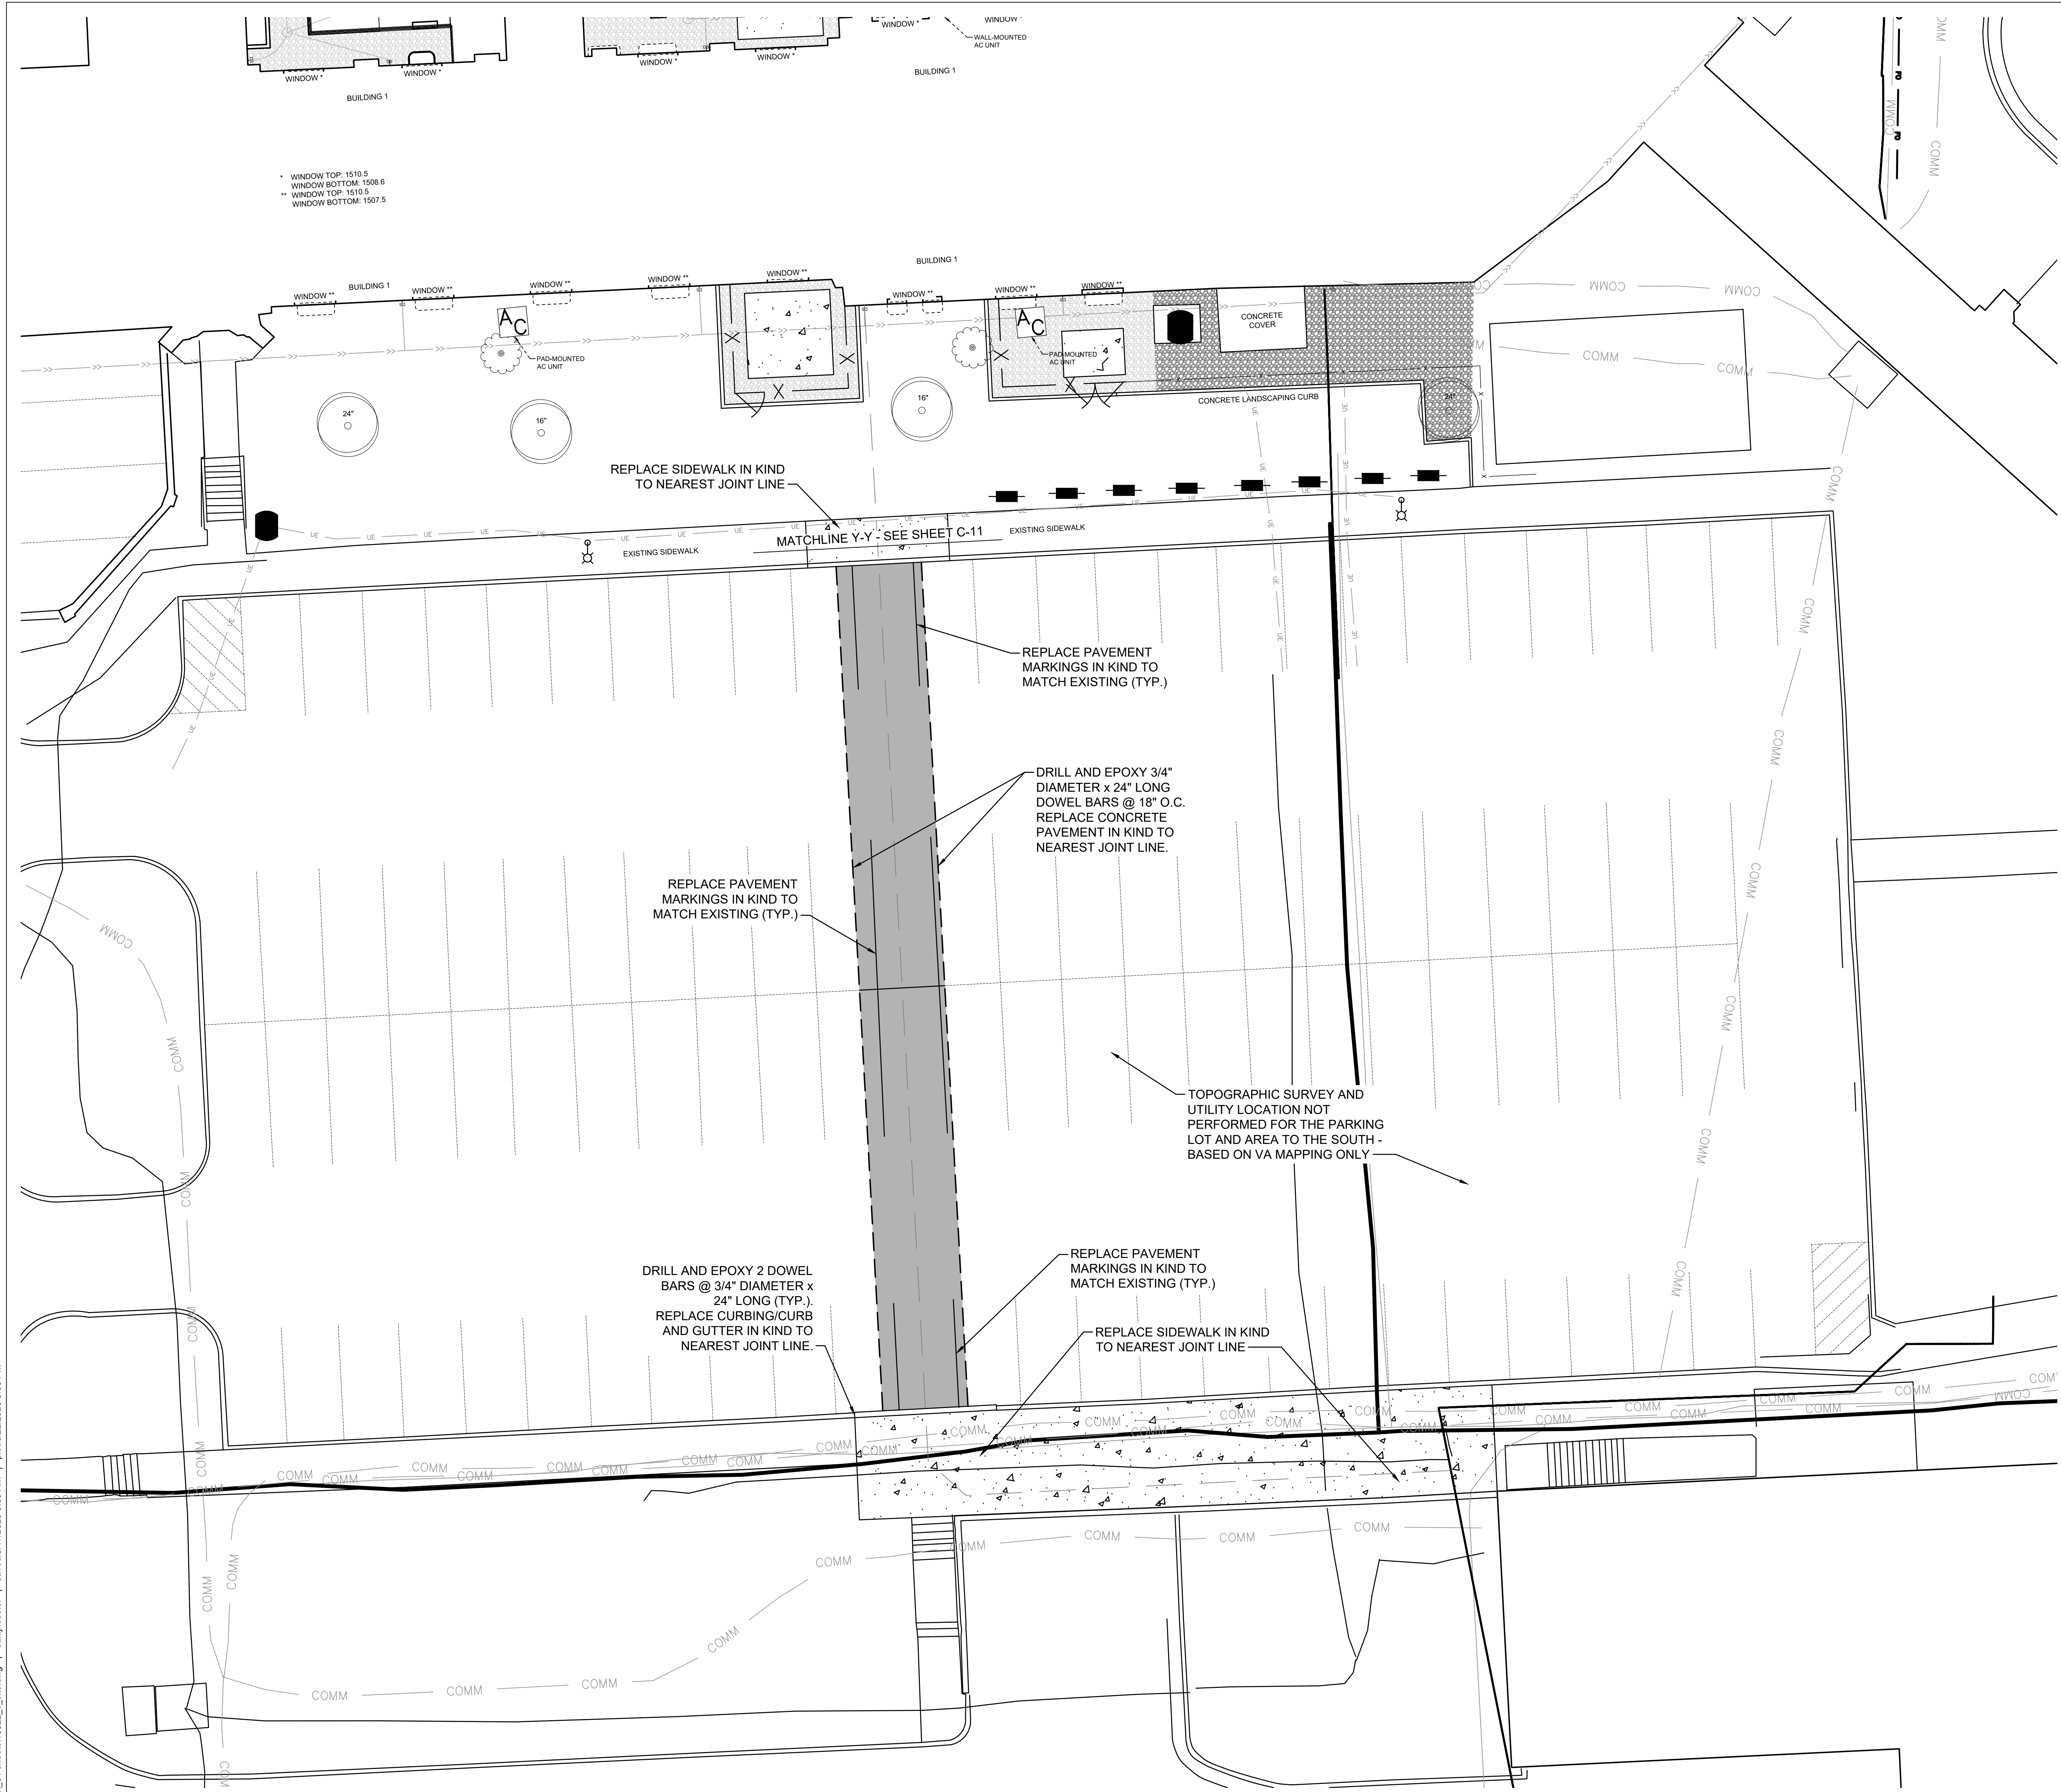

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Revisions:	Date:

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JAY RONALD KOESTER
 PRINT NAME

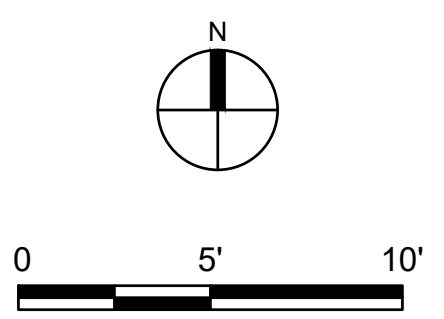 SIGNATURE
 44433
 REGISTRATION NUMBER
 06/17/2020
 DATE

Office of Construction and Facilities Management

VA U.S. Department of Veterans Affairs

Drawing Title
SITE PLAN - GAS LINE AND PARKING AREA

Approved: Project Director

Phase
CONSTRUCTION DOCUMENTS

Project Title
RENOVATE OLD CHAPEL AND AUDITORIUM

Location
 Sioux Falls, South Dakota

Issue Date
 June 17, 2020


Checked
 JRK

Drawn
 JPR

Project Number
 438-19-301

Building Number
 1 and 5

Drawing Number
C-6

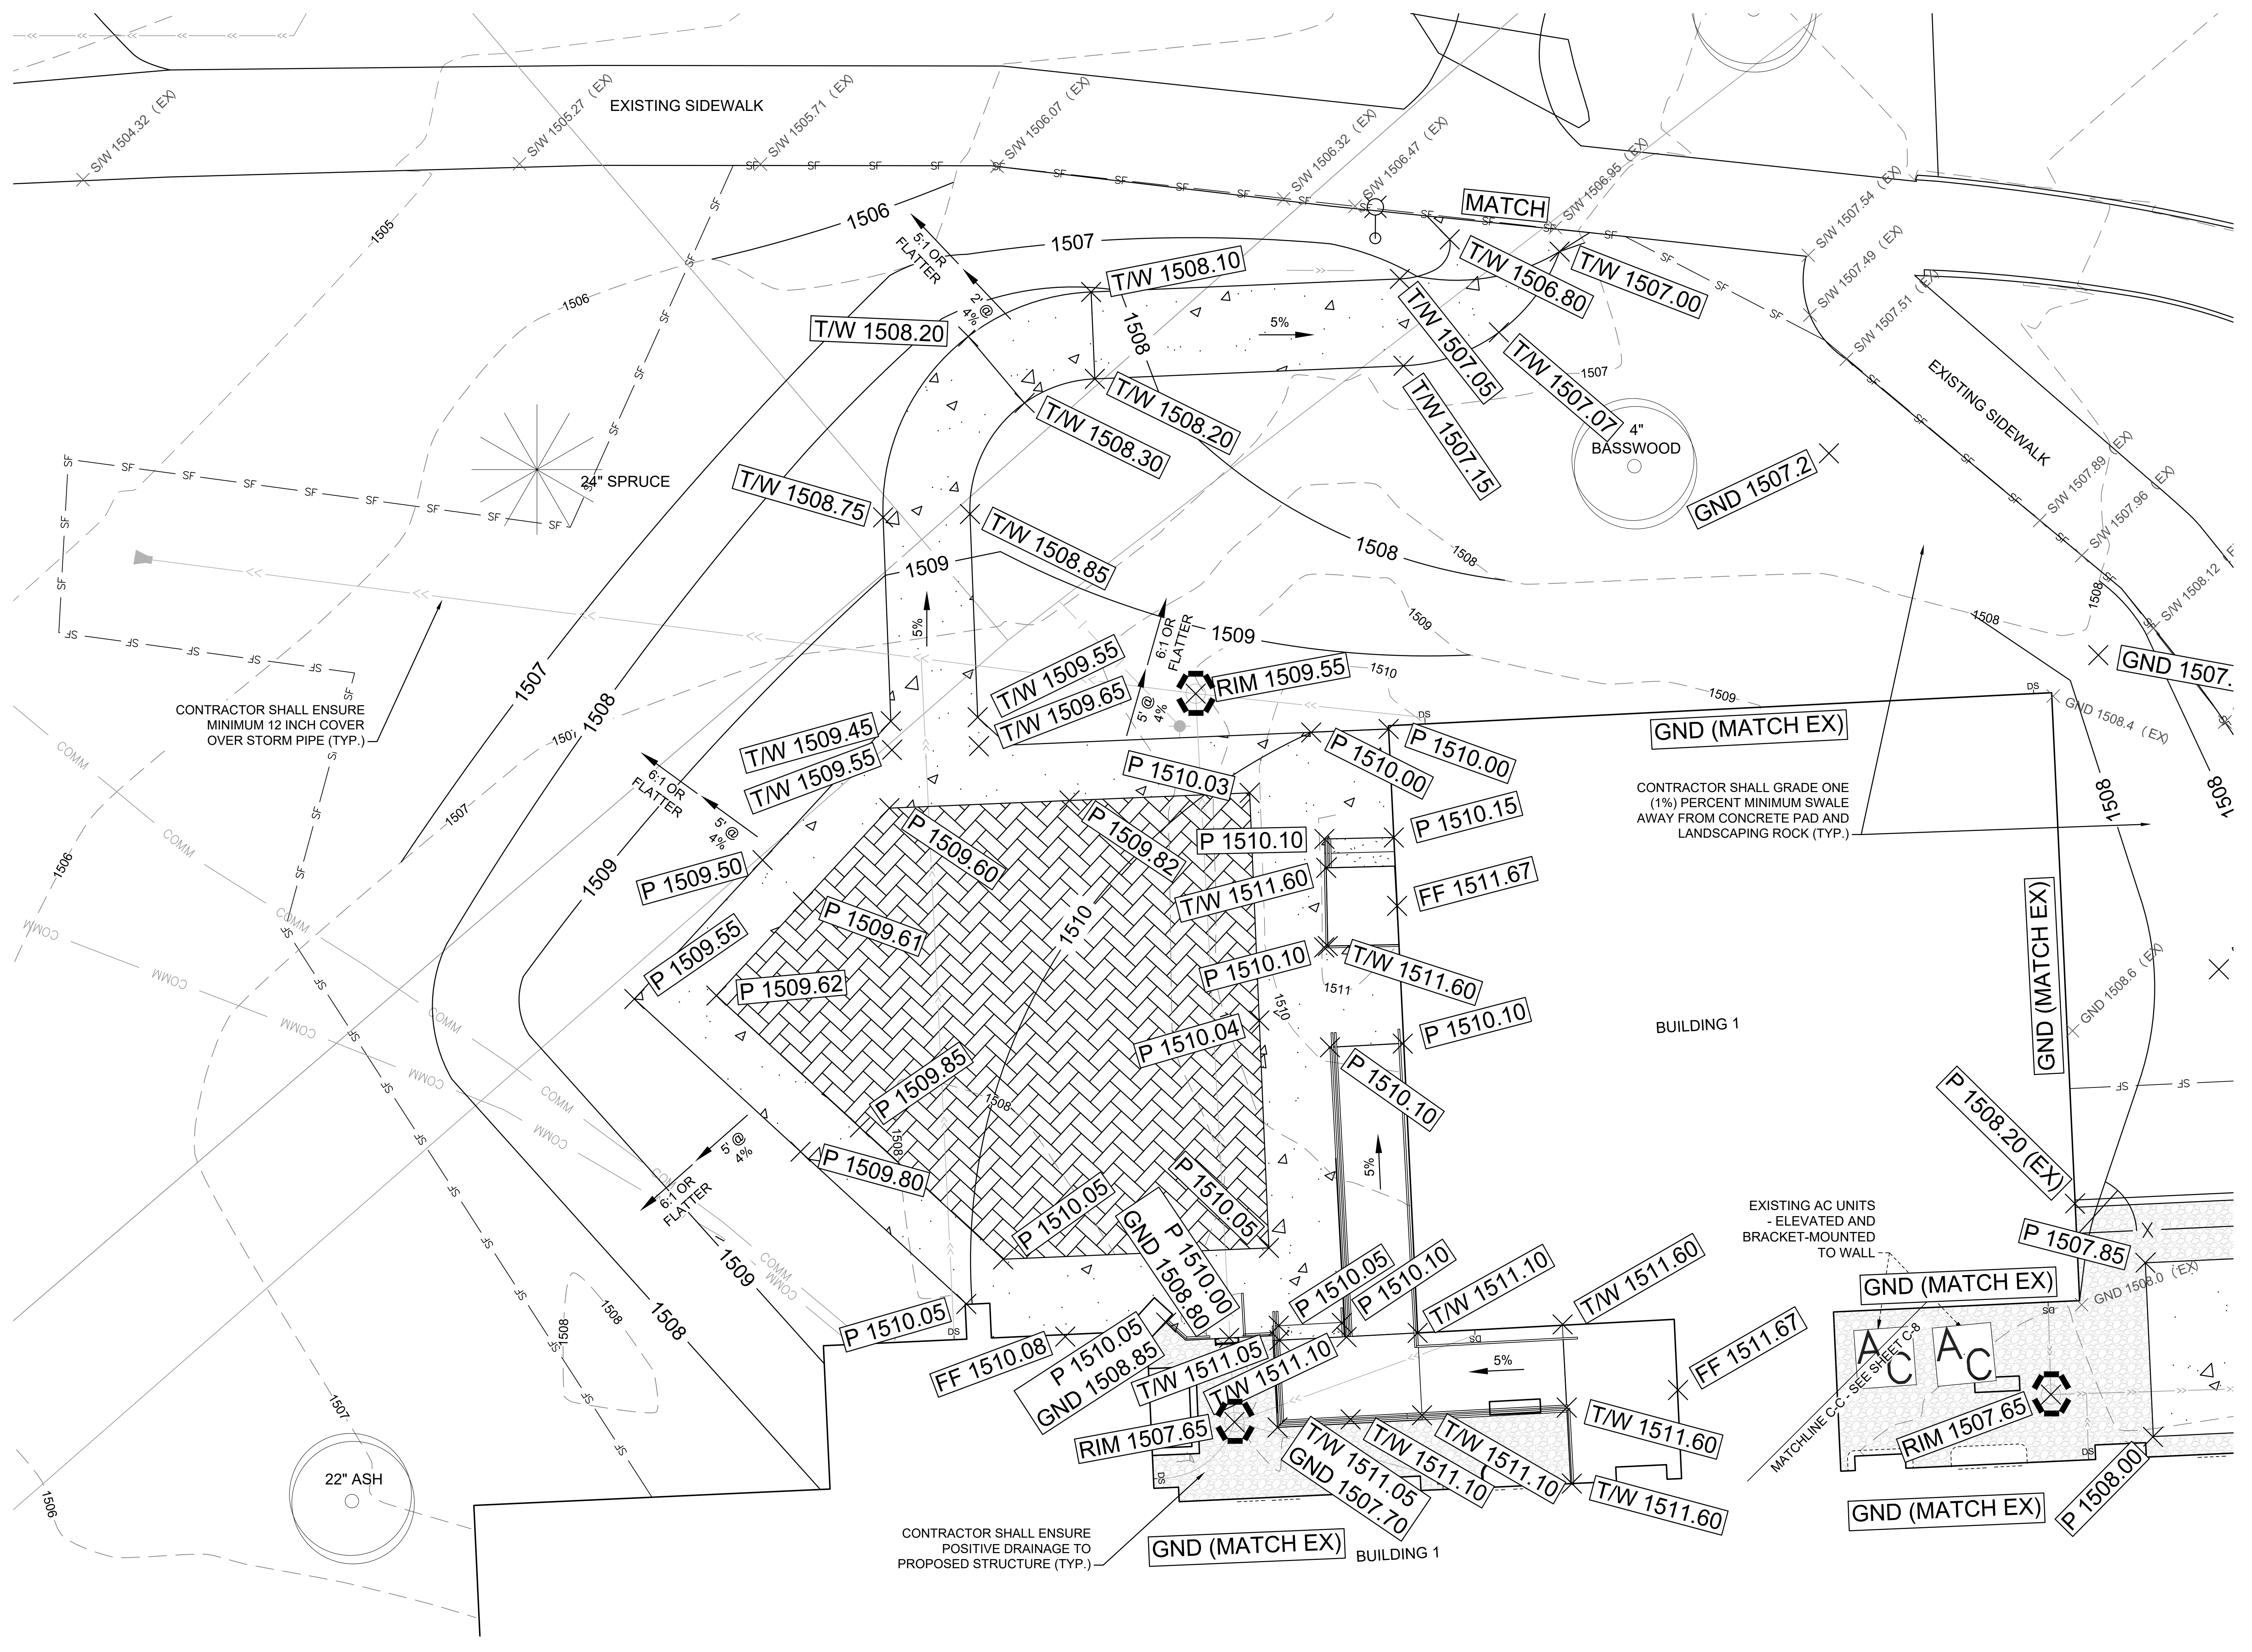

LEGEND

	PROPERTY LIMITS
	CONSTRUCTION LIMITS
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	EXISTING MAJOR CONTOUR
	PROPOSED MINOR CONTOUR
	PROPOSED MAJOR CONTOUR
	EXISTING SPOT ELEVATION
	SOIL BORING LOCATION
	DRAINAGE ARROW
	PROPOSED RETAINING WALL
	PROPOSED CONCRETE C&G
	TIP OUT CURB
	SILT FENCE
	INLET SEDIMENT PROTECTION
	ROCK CONSTRUCTION ENTRANCE
	SPOT ELEVATION
	FLOW LINE OF CURB
	HIGH POINT / FLOW LINE OF CURB
	RIM ELEVATION
	TOP OF WALL
	BOTTOM OF WALL

ABBREVIATIONS

CC	CONCRETE
FF	FINISHED FLOOR
GND	GROUND
P	PAVEMENT
S/W	SIDEWALK
T/W	TOP OF WALL

CONTRACTOR SHALL ENSURE MINIMUM 12 INCH COVER OVER STORM PIPE (TYP.)

CONTRACTOR SHALL GRADE ONE (1%) PERCENT MINIMUM SWALE AWAY FROM CONCRETE PAD AND LANDSCAPING ROCK (TYP.)

CONTRACTOR SHALL ENSURE POSITIVE DRAINAGE TO PROPOSED STRUCTURE (TYP.)

EXISTING AC UNITS - ELEVATED AND BRACKET-MOUNTED TO WALL

MATCHLINE CC - SEE SHEET C-8

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engineering discipline <EDIT TEXT>
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Consultant POC

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Office of Construction and Facilities Management
VA U.S. Department of Veterans Affairs


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GRADING AND EROSION CONTROL PLAN - PATIO AREA	CONSTRUCTION DOCUMENTS
Approved: Project Director	

Project Title	Project Number
RENOVATE OLD CHAPEL AND AUDITORIUM	438-19-301
Location	Building Number
Sioux Falls, South Dakota	1 and 5
Issue Date	Checked
June 17, 2020	JRK
Drawn	JPR

Issue Date	Checked	Drawn	Drawing Number
June 17, 2020	JRK	JPR	C-7


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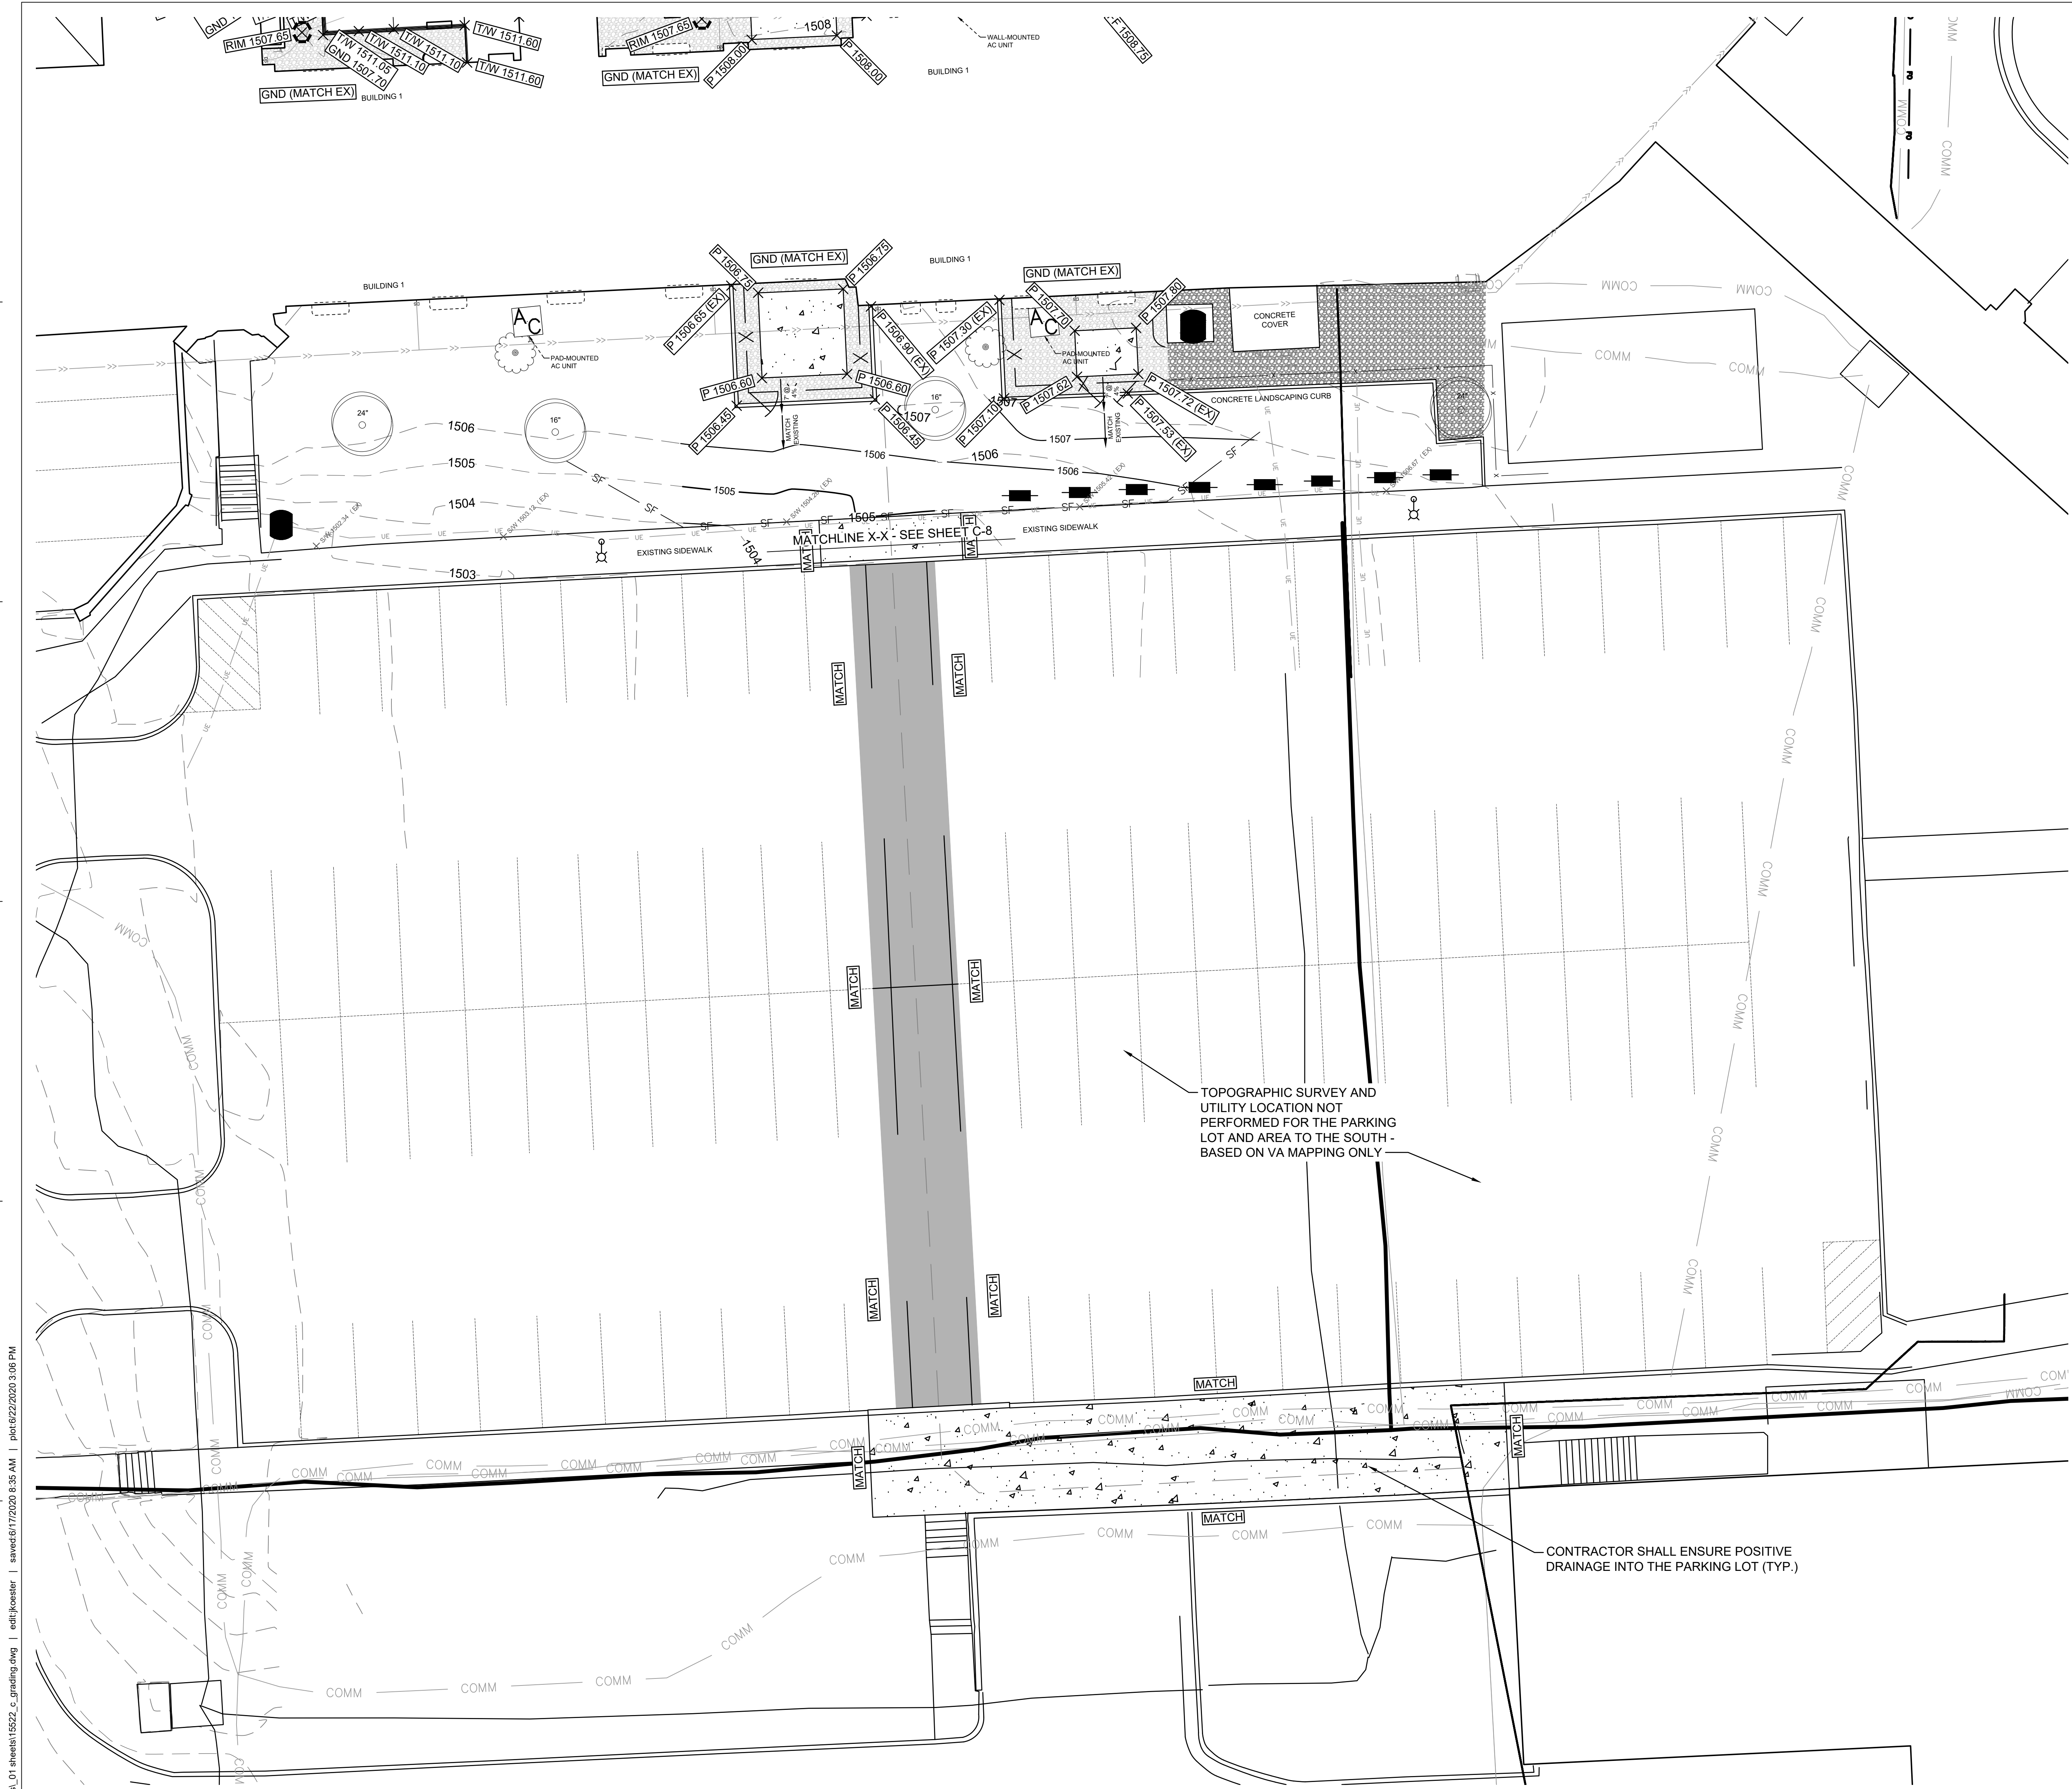


ABBREVIATIONS

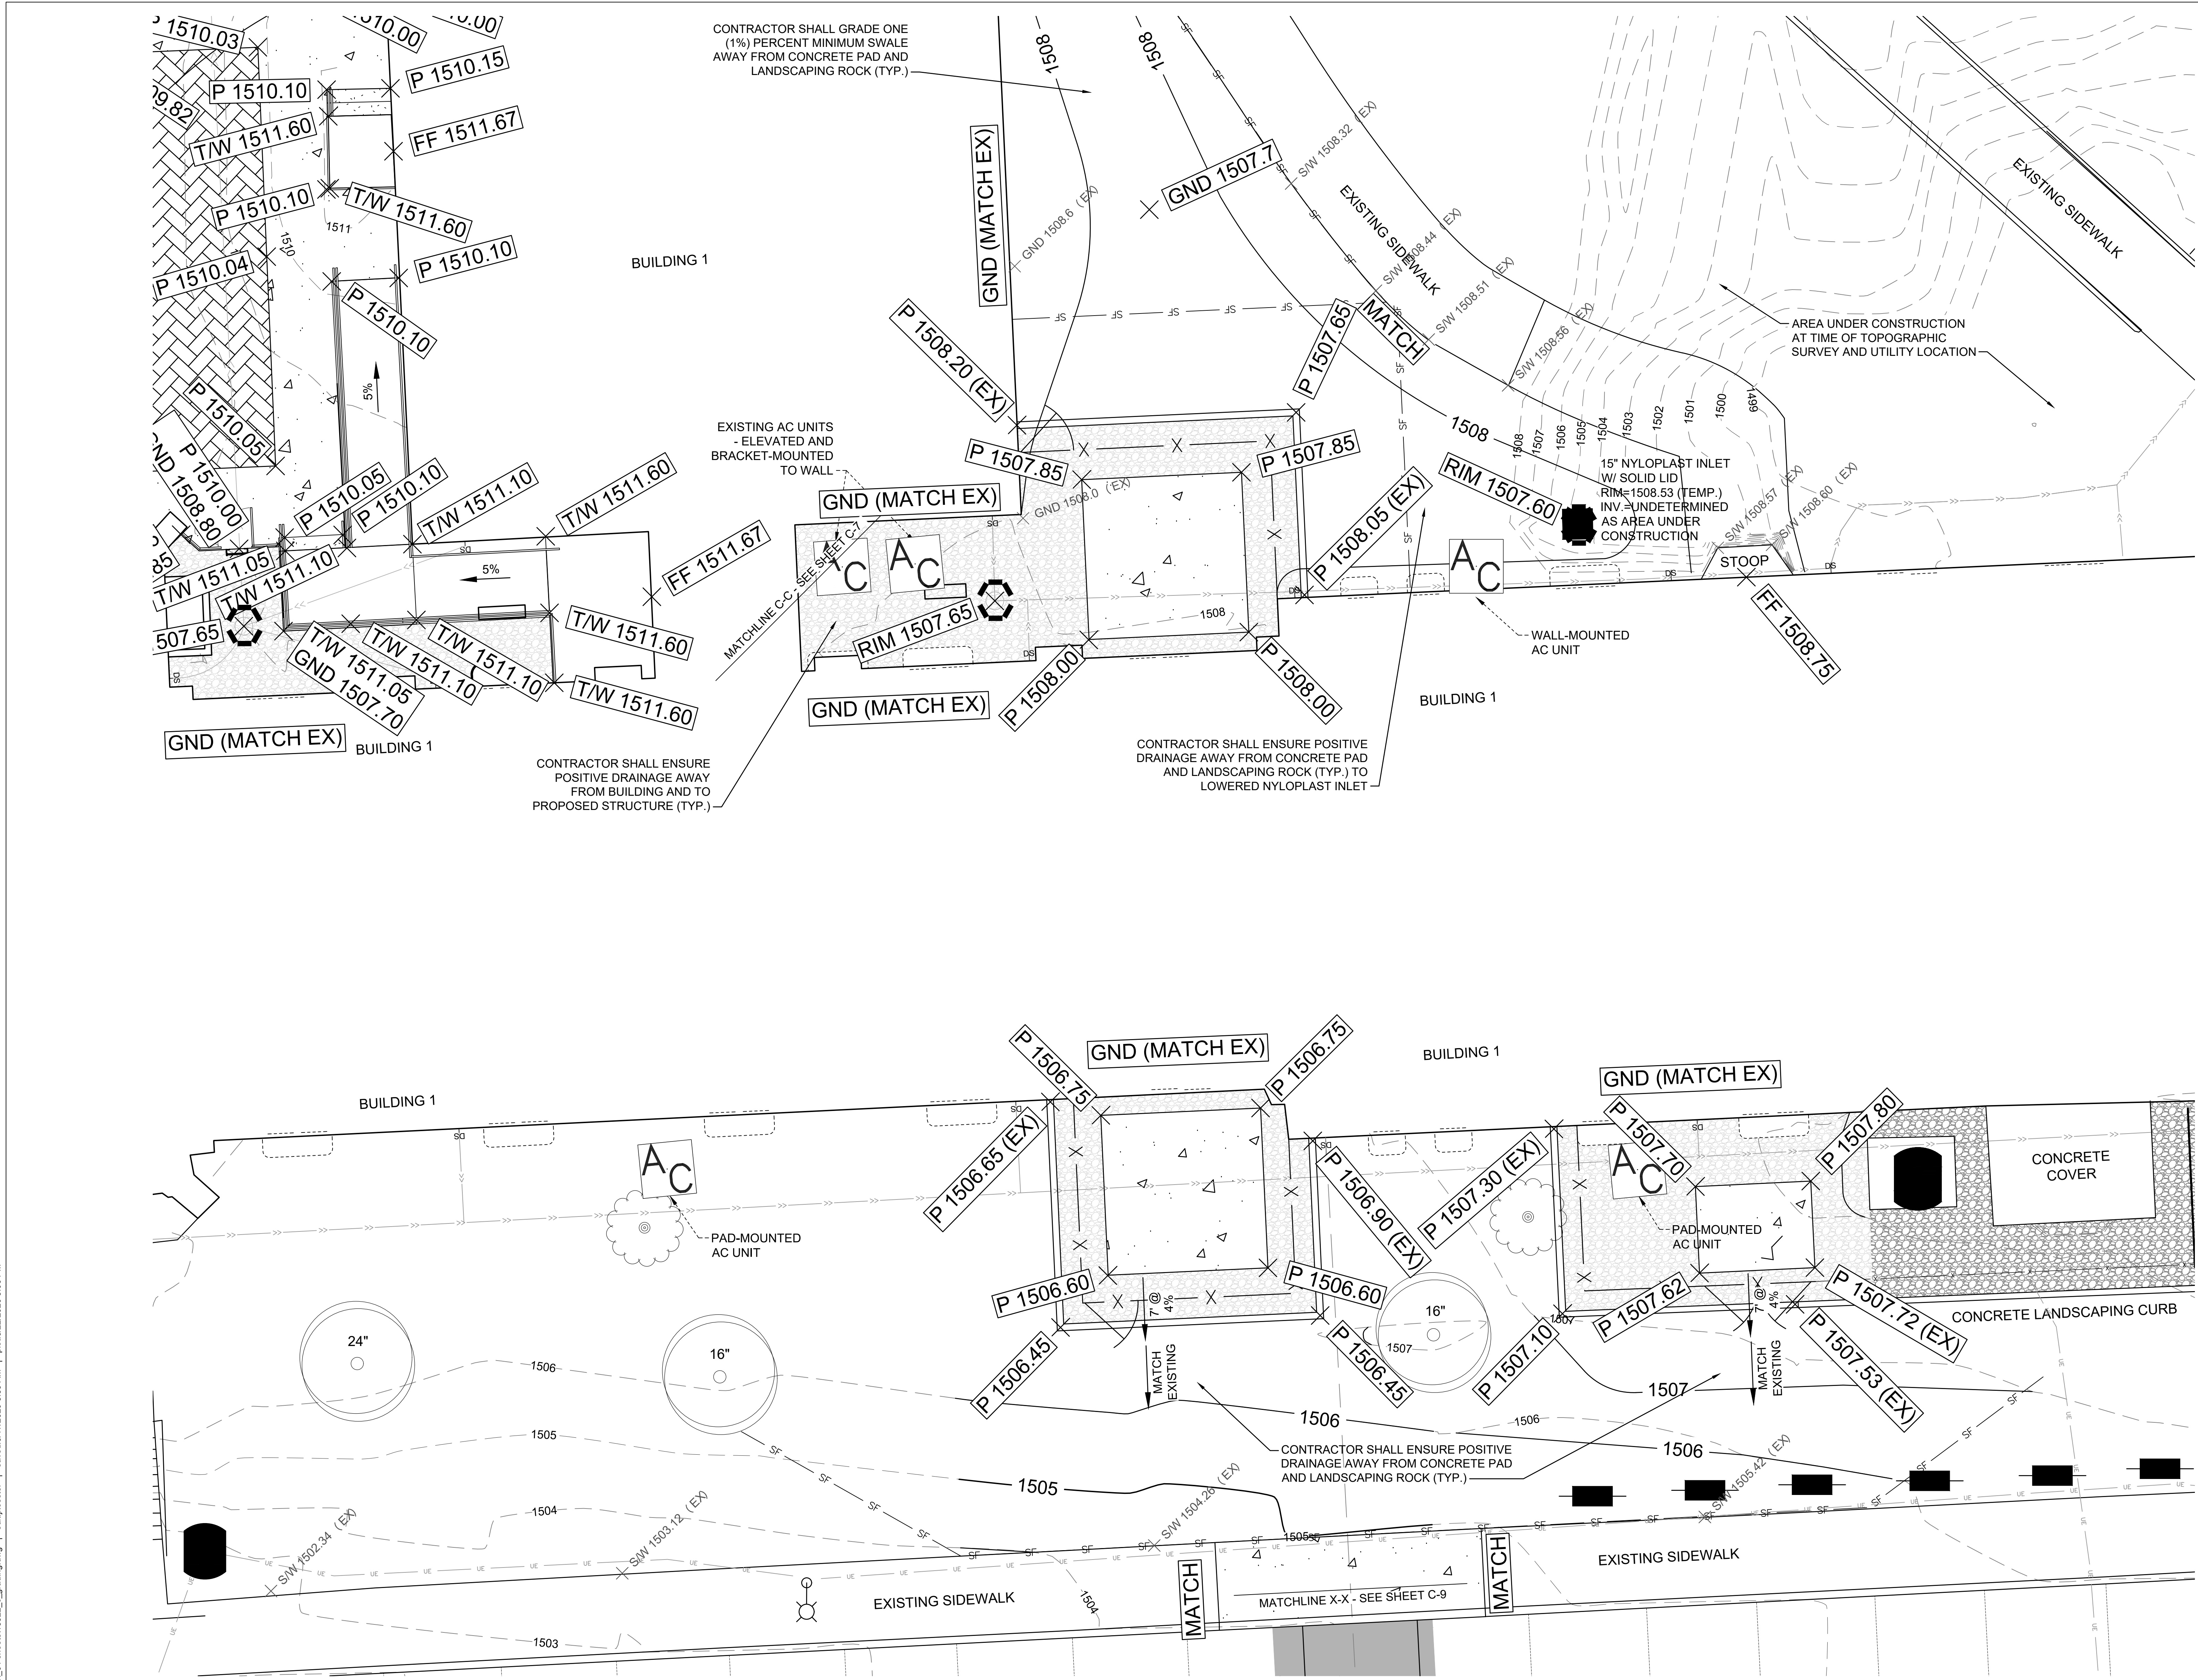CC	CONCRETE
FF	FINISHED FLOOR
GND	GROUND
P	PAVEMENT
SW	SIDEWALK
TW	TOP OF WALL



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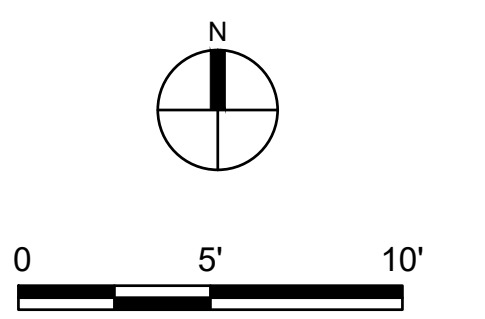
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	PROPOSED MINOR CONTOUR
	PROPOSED MAJOR CONTOUR
	EXISTING SPOT ELEVATION
	SOIL BORING LOCATION
	DRAINAGE ARROW
	PROPOSED RETAINING WALL
	PROPOSED CONCRETE C&G
	TIP OUT CURB
	SILT FENCE
	INLET SEDIMENT PROTECTION
	ROCK CONSTRUCTION ENTRANCE
	SPOT ELEVATION
	FLOW LINE OF CURB
	HIGH POINT / FLOW LINE OF CURB
	RIM ELEVATION
	TOP OF WALL
	BOTTOM OF WALL

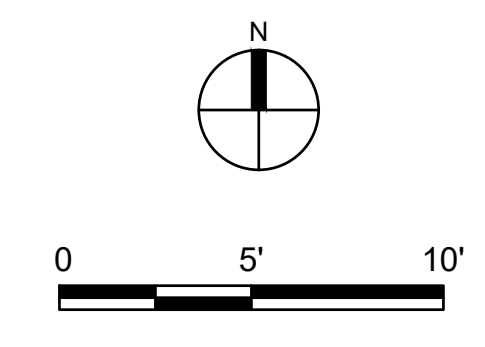ABBREVIATIONS

CC	CONCRETE
FF	FINISHED FLOOR
GND	GROUND
P	PAVEMENT
S/W	SIDEWALK
T/W	TOP OF WALL

TOPOGRAPHIC SURVEY AND UTILITY LOCATION NOT PERFORMED FOR THE PARKING LOT AND AREA TO THE SOUTH - BASED ON VA MAPPING ONLY.

CONTRACTOR SHALL ENSURE POSITIVE DRAINAGE INTO THE PARKING LOT (TYP.)



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Revisions:	Date:

CONSULTANT
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ARCHITECT/ENGINEER OF RECORD

ANDERSON

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 P 763.412.4000 | F 763.412.4090 | ae-mn.com
 Anderson Engineering of Minnesota, LLC | Proj # 15522

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 SIGNATURE
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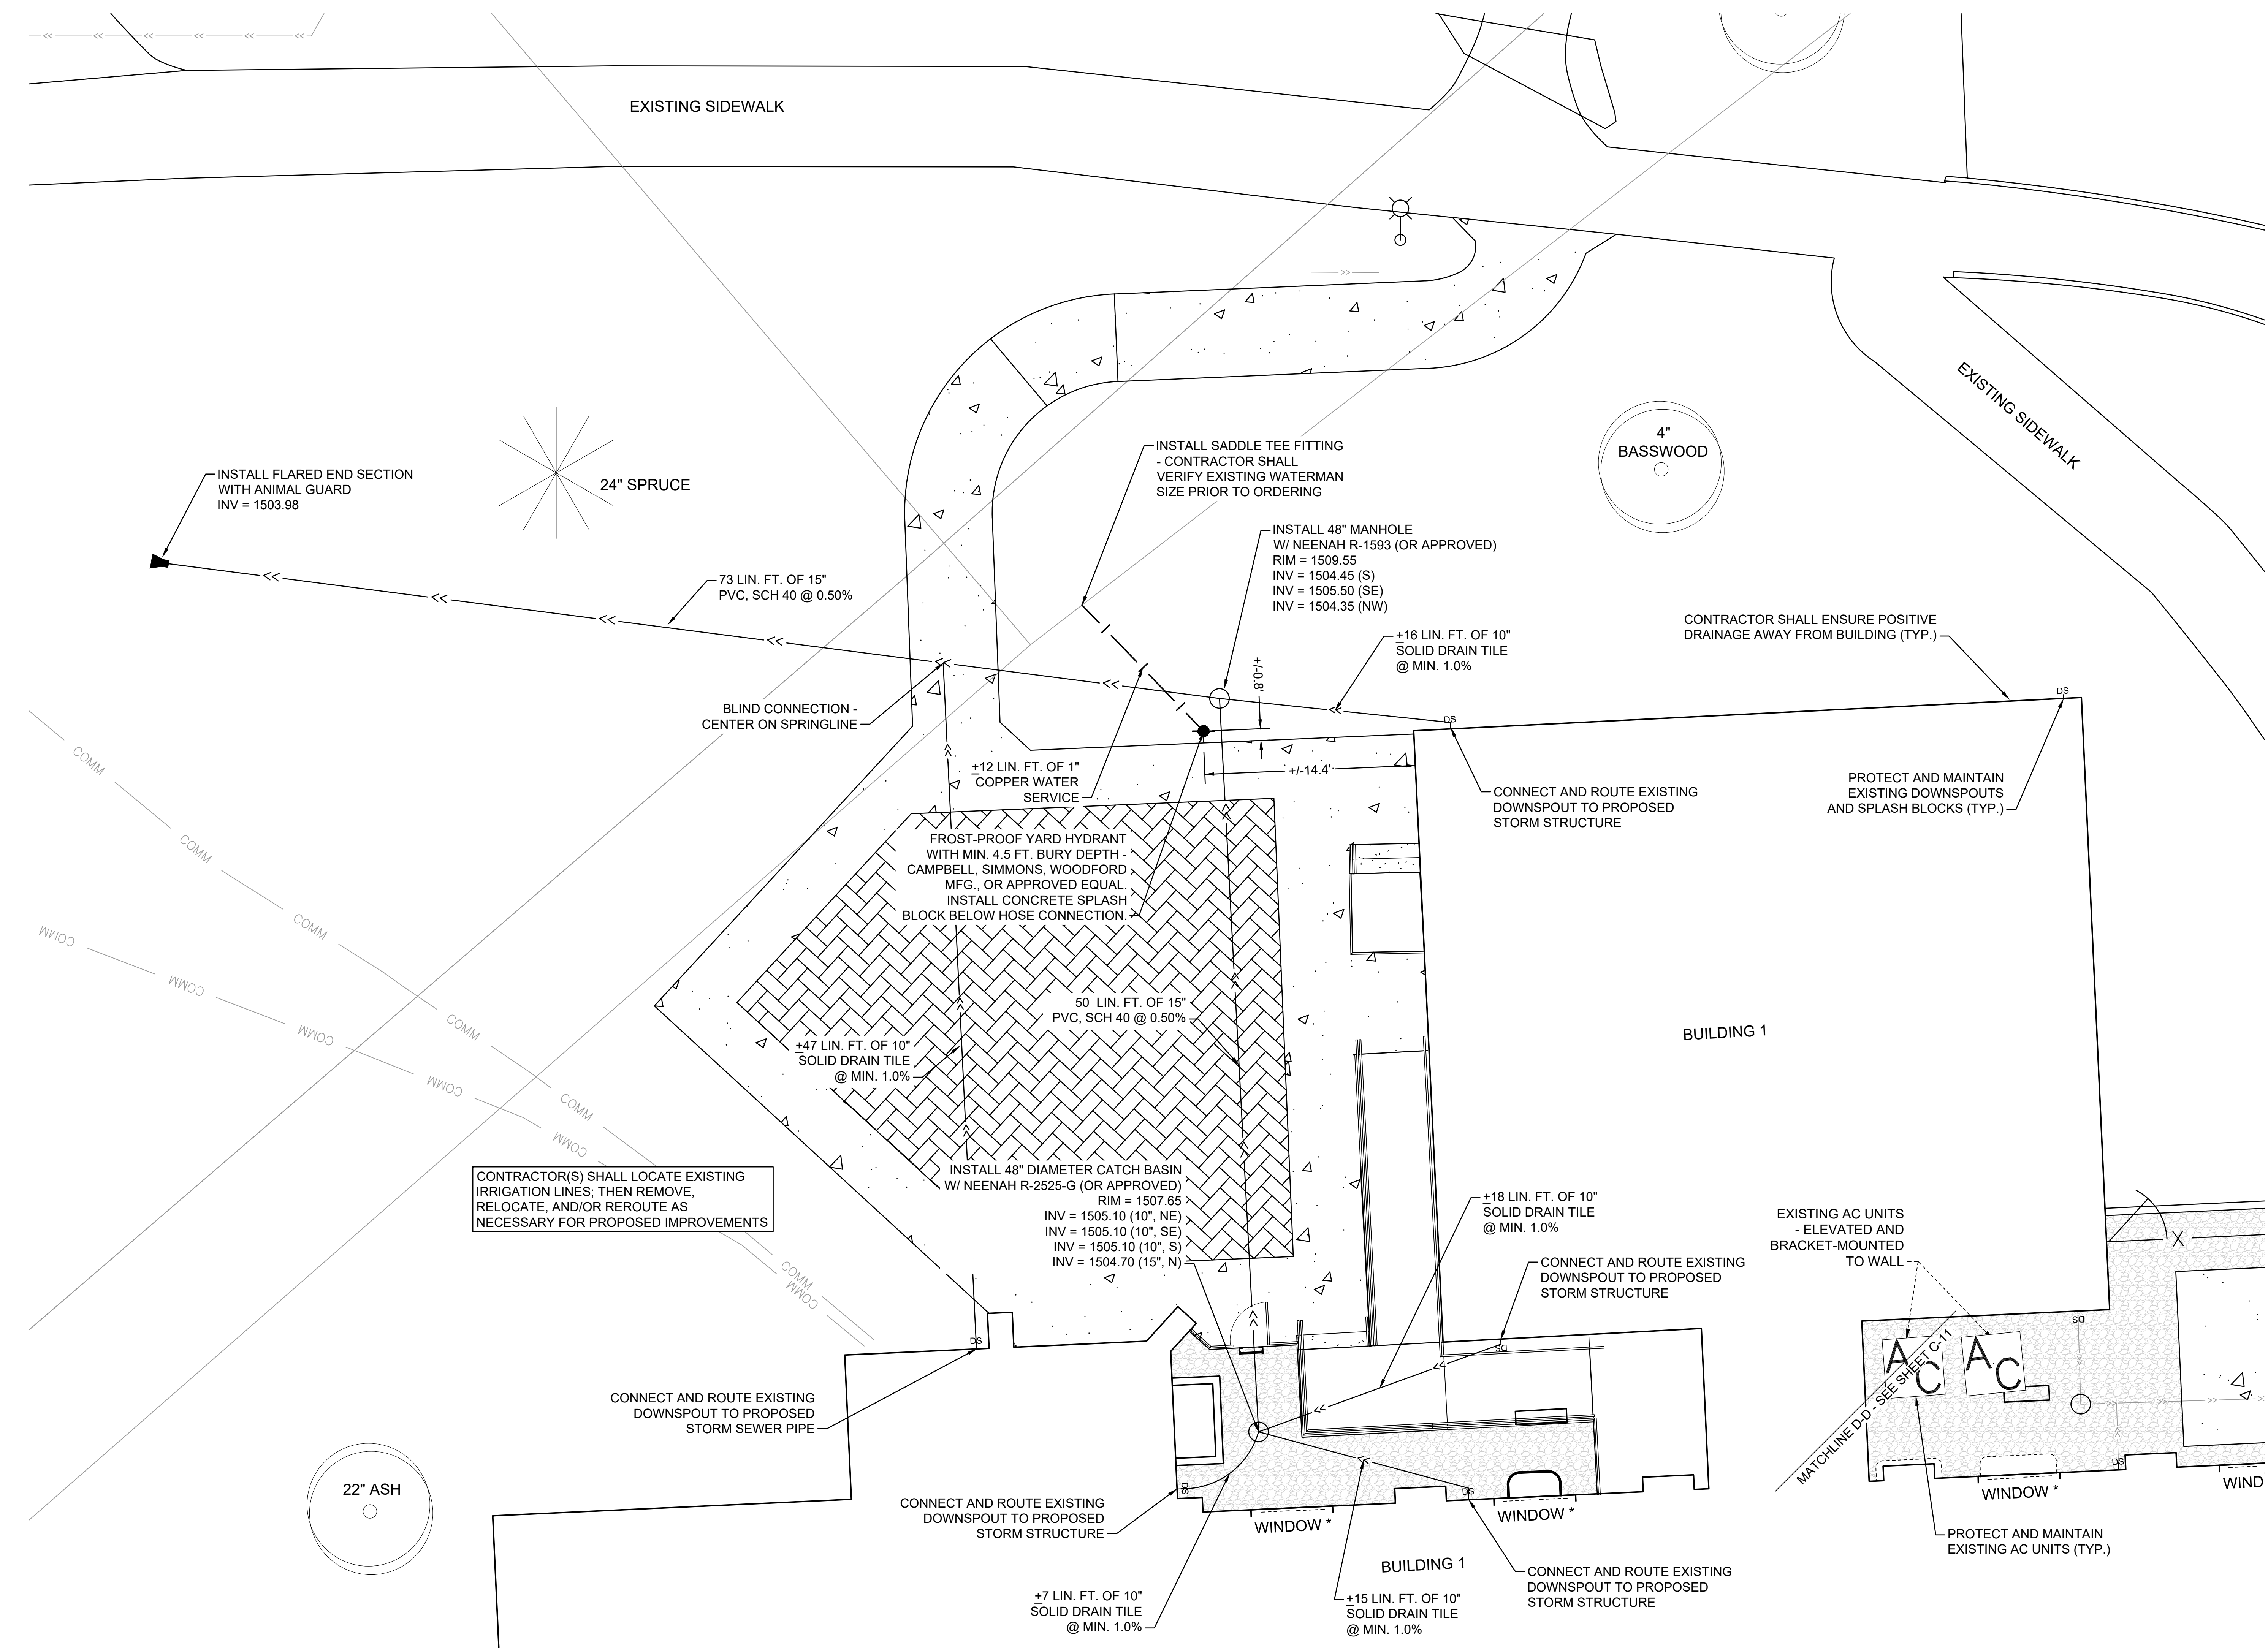
Office of Construction and Facilities Management
VA U.S. Department of Veterans Affairs

GRADING AND EROSION CONTROL PLAN - GAS LINE AND PARKING AREA
 Approved: Project Director


Phase **CONSTRUCTION DOCUMENTS**

Project Title RENOVATE OLD CHAPEL AND AUDITORIUM		Project Number 438-19-301	
Location Sioux Falls, South Dakota		Building Number 1 and 5	
Issue Date June 17, 2020	Checked JRK	Drawn JPR	Drawing Number C-9


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LEGEND	
	PROPERTY LIMITS
	CONSTRUCTION LIMITS
	EXISTING WATERMAIN
	EXISTING SANITARY SEWER
	EXISTING STORM SEWER
	PROPOSED WATERMAIN
	PROPOSED SANITARY SEWER
	PROPOSED STORM SEWER
	PROPOSED DRAINTILE
	PROPOSED WATERMAIN FITTING
	PROPOSED SANITARY MANHOLE AND CLEANOUT
	PROPOSED STORM INLETS
	FES W/ TRASH GUARD AND RIP RAP




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LEGEND

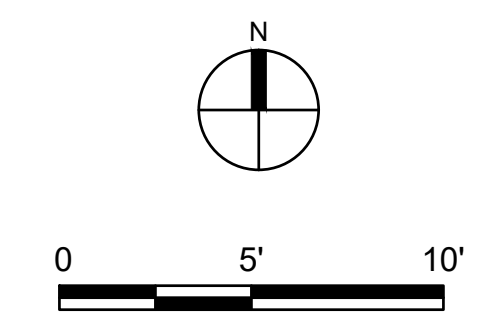- PROPERTY LIMITS
- CONSTRUCTION LIMITS
- EXISTING WATERMAIN
- EXISTING SANITARY SEWER
- EXISTING STORM SEWER
- PROPOSED WATERMAIN
- PROPOSED SANITARY SEWER
- PROPOSED STORM SEWER
- PROPOSED DRAIN TILE
- PROPOSED WATERMAIN FITTING
- PROPOSED SANITARY MANHOLE AND CLEANOUT
- PROPOSED STORM INLETS
- FES W/ TRASH GUARD AND RIP RAP

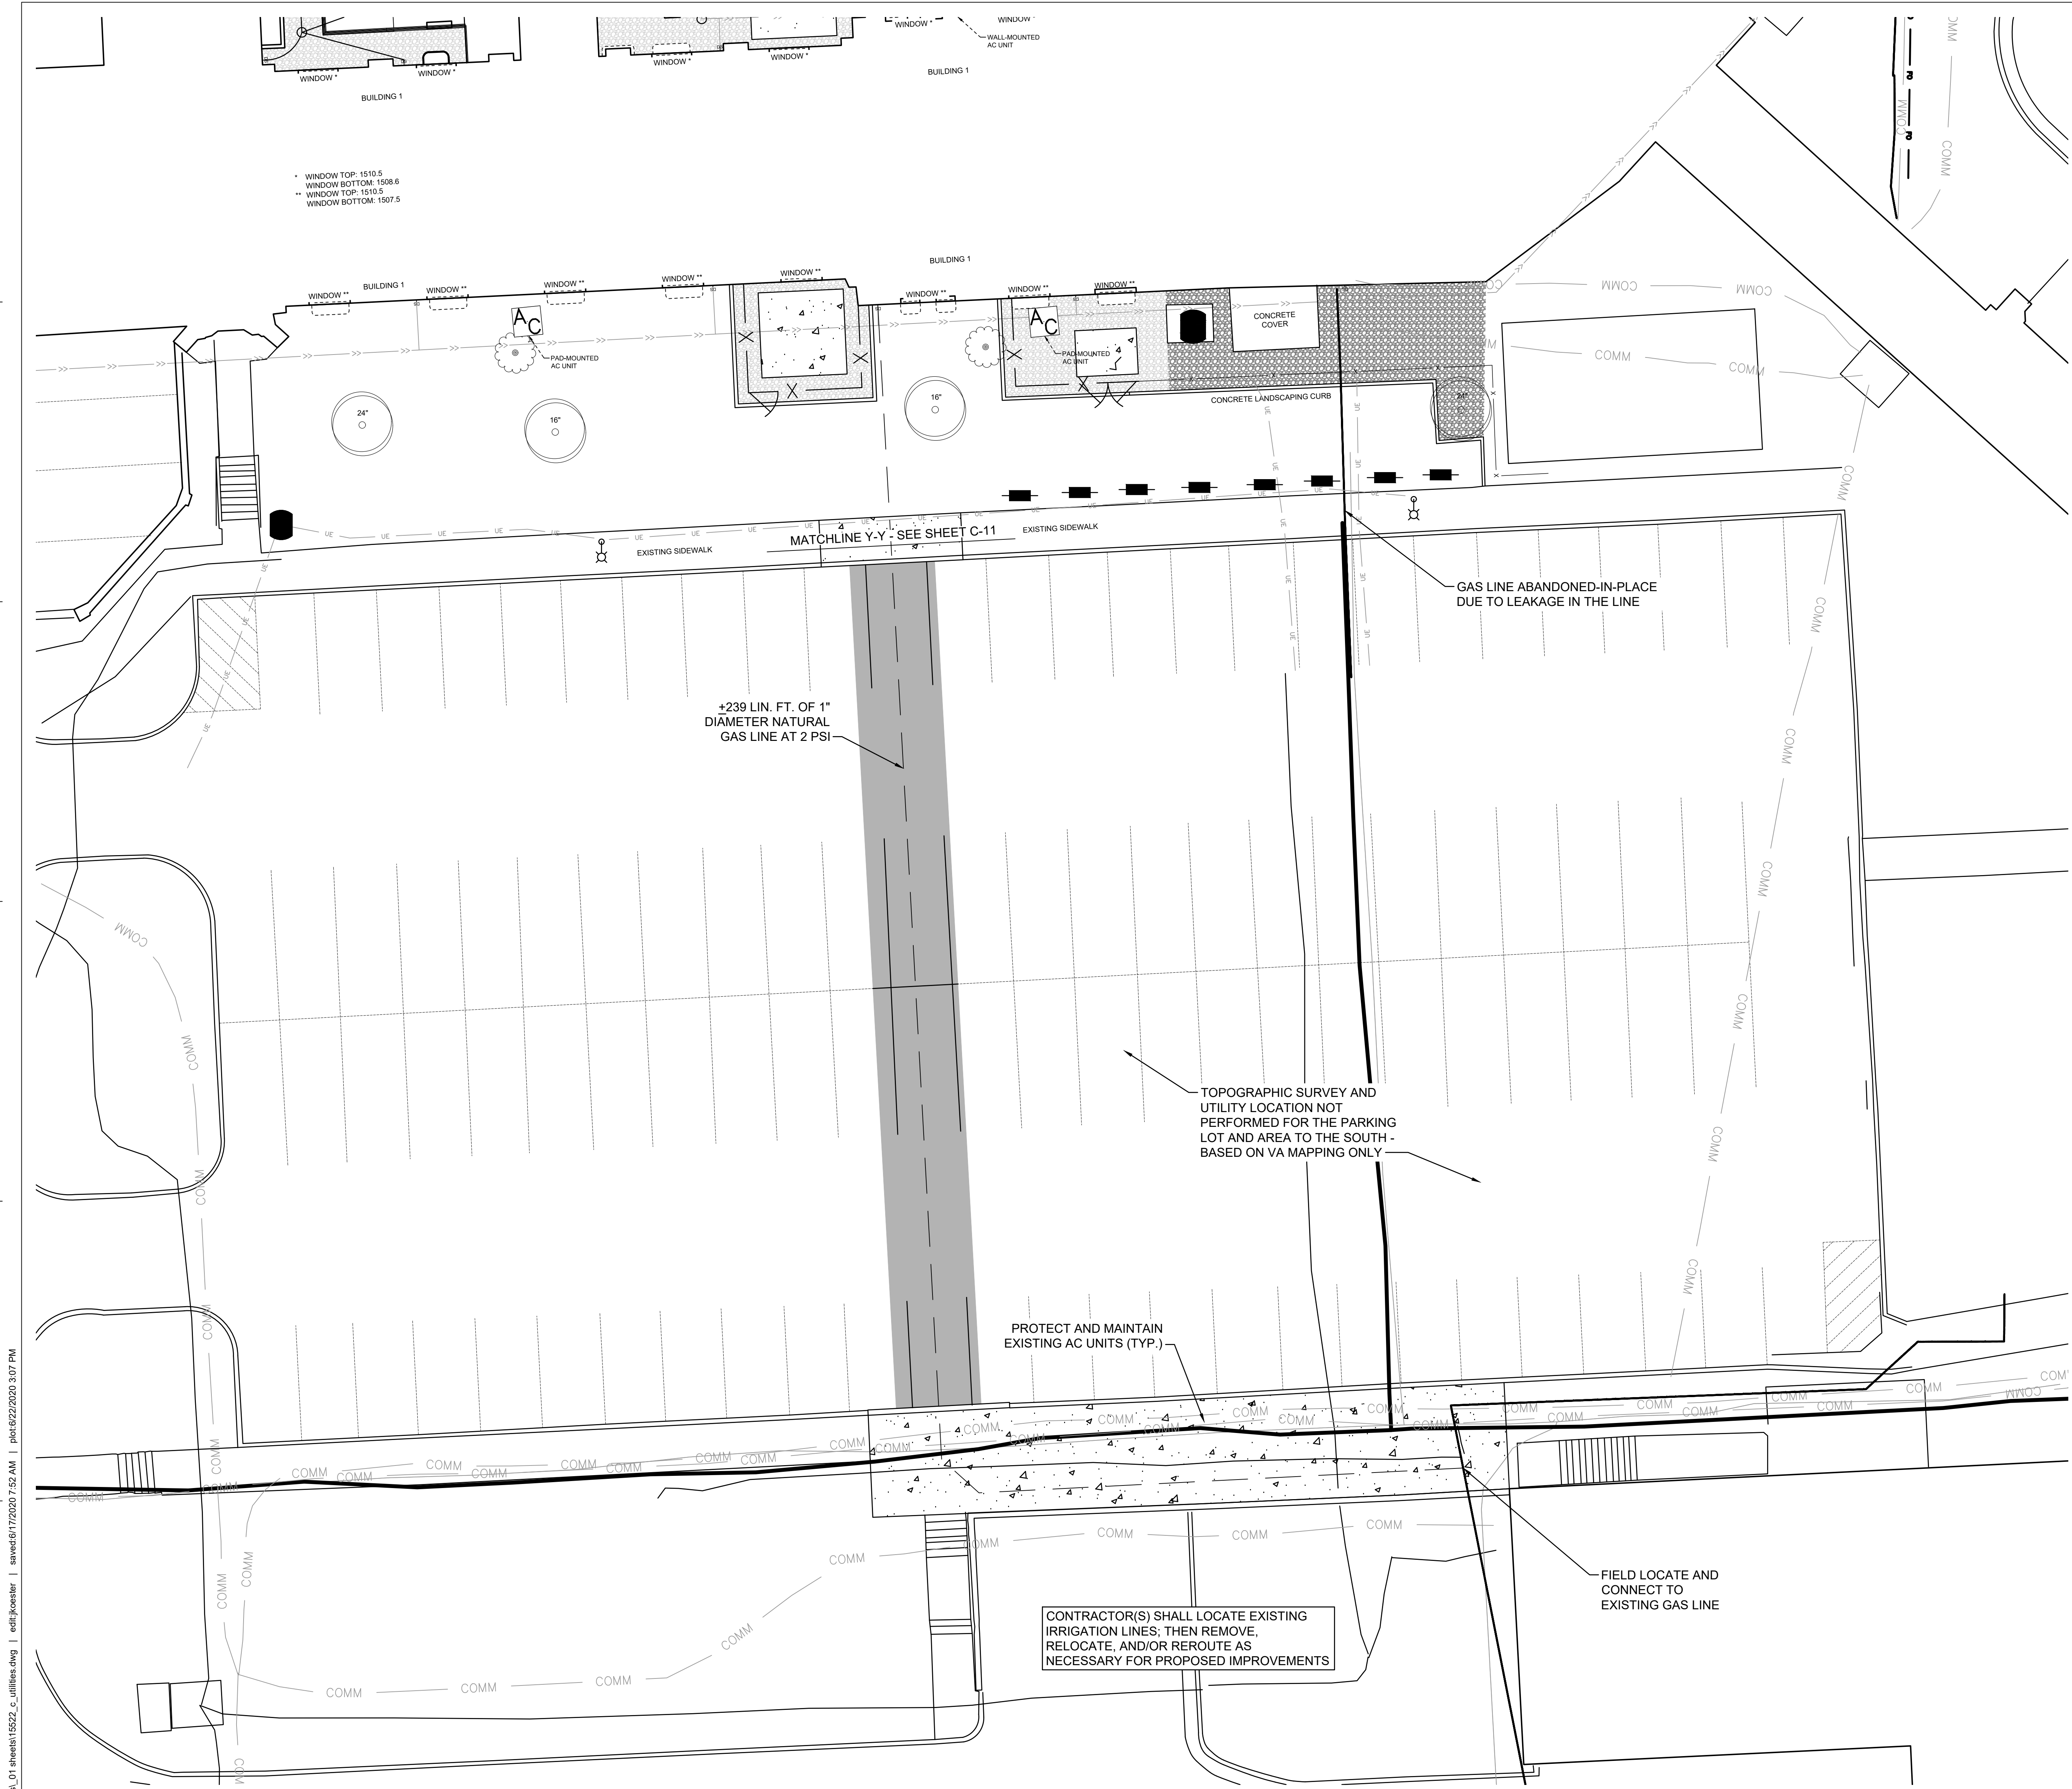

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 PRINT NAME

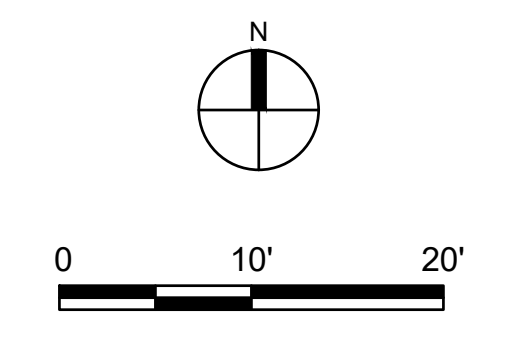 SIGNATURE
 44433
 REGISTRATION NUMBER
 06/17/2020
 DATE

Office of
 Construction
 and Facilities
 Management

VA U.S. Department
 of Veterans Affairs

Drawing Title
**UTILITY PLAN - GAS LINE AND
 PARKING AREA**

Approved: Project Director

Phase
**CONSTRUCTION
 DOCUMENTS**

Project Title
**RENOVATE OLD CHAPEL
 AND AUDITORIUM**

Location
 Sioux Falls, South Dakota

Issue Date
 June 17, 2020


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Drawn
 JPR

Project Number
 438-19-301

Building Number
 1 and 5

Drawing Number
C-12

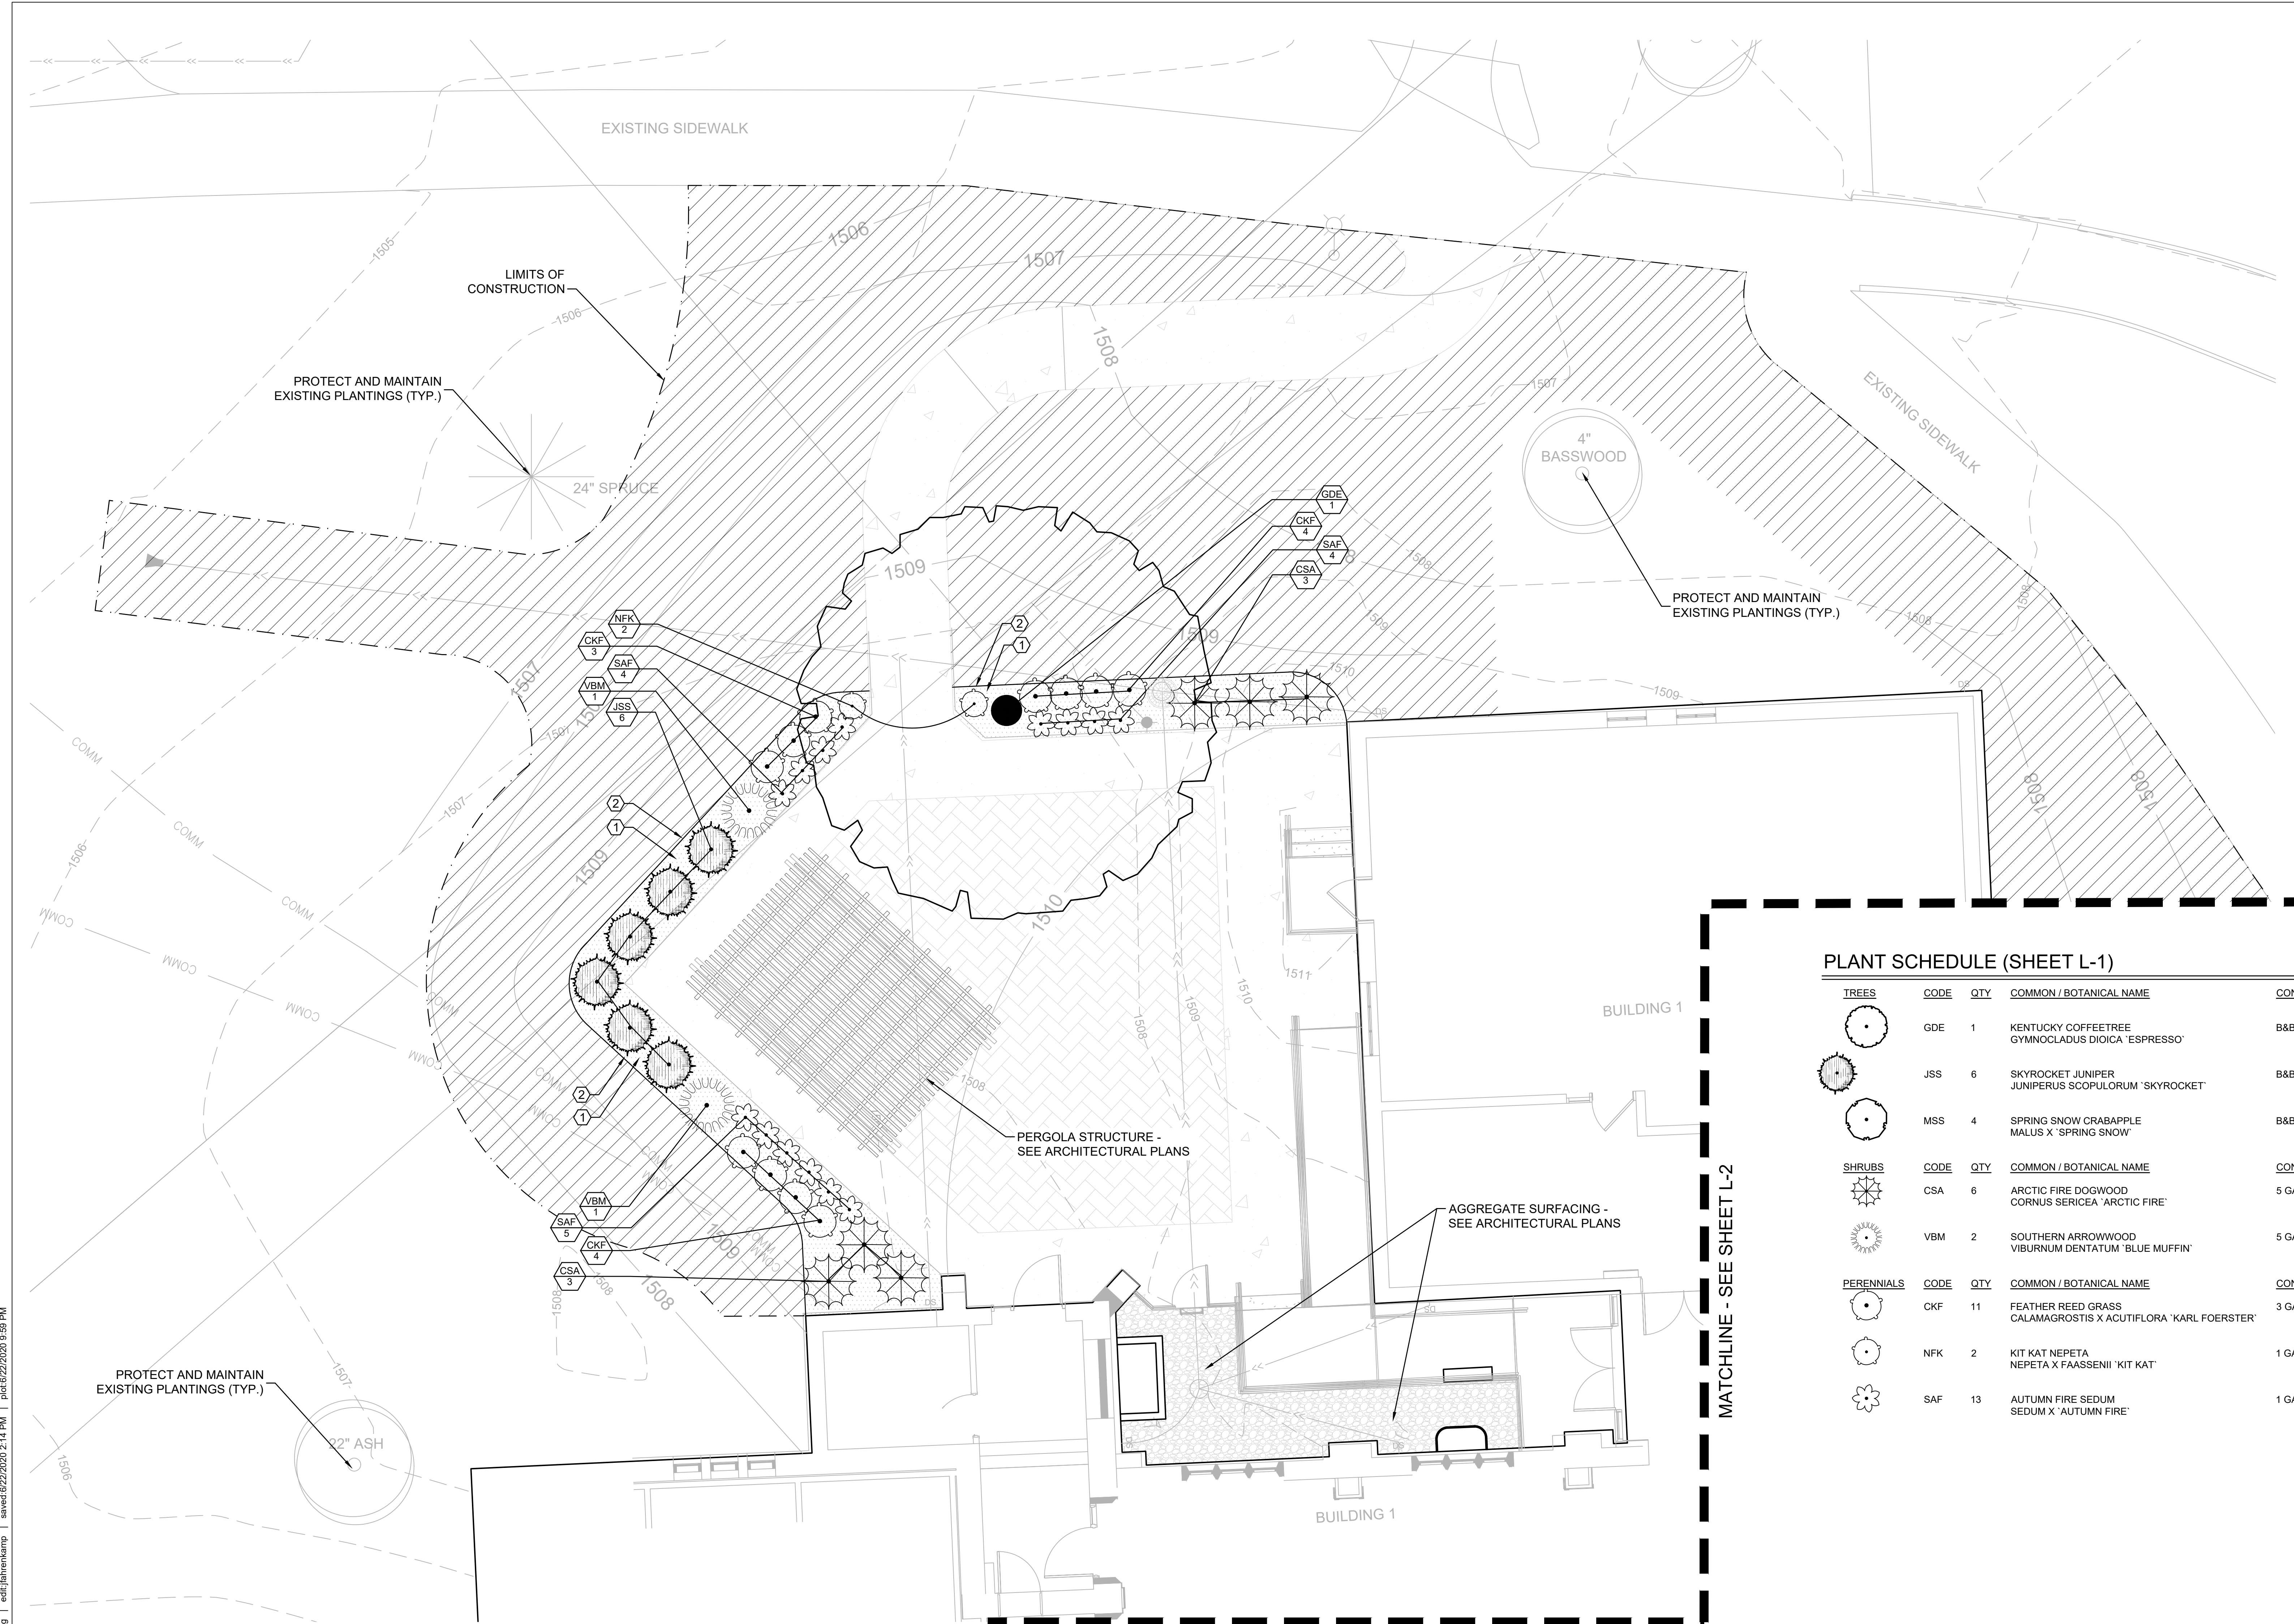

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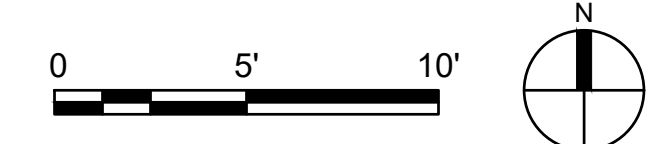
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	CONSTRUCTION LIMITS
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	EXISTING TO REMAIN
	NEW SOD w/IRRIGATION
	3" DEEP, ROCK MULCH OVER LANDSCAPE FABRIC
	LANDSCAPE POLY EDGER

- NOTES**
- ALL PLANTINGS SHALL RECEIVE IRRIGATION
 - SEE 'GRADING PLAN' FOR ADDITIONAL INFORMATION

PLANT SCHEDULE (SHEET L-1)

TREES	CODE	QTY	COMMON / BOTANICAL NAME	CONT	CAL / HT	REMARKS
	GDE	1	KENTUCKY COFFEETREE GYMNOCLADUS DIOICA 'ESPRESSO'	B&B	2 - 1/2" CAL.	NO BRANCHES BELOW 36" HT. SINGLE, STRAIGHT LEADER
	JSS	6	SKYROCKET JUNIPER JUNIPERUS SCOPULORUM 'SKYROCKET'	B&B	6' HT.	
	MSS	4	SPRING SNOW CRABAPPLE MALUS X 'SPRING SNOW'	B&B	2 - 1/2" CAL.	NO BRANCHES BELOW 36" HT. SINGLE, STRAIGHT LEADER
SHRUBS	CODE	QTY	COMMON / BOTANICAL NAME	CONT	REMARKS	
	CSA	6	ARCTIC FIRE DOGWOOD CORNUS SERICEA 'ARCTIC FIRE'	5 GAL.	MINIMUM 5 CANES @ 12" HT.	
	VBM	2	SOUTHERN ARROWWOOD VIBURNUM DENTATUM 'BLUE MUFFIN'	5 GAL.	MINIMUM 5 CANES @ 12" HT.	
PERENNIALS	CODE	QTY	COMMON / BOTANICAL NAME	CONT	REMARKS	
	CKF	11	FEATHER REED GRASS CALAMAGROSTIS X ACUTIFLORA 'KARL FOERSTER'	3 GAL.		
	NFK	2	KIT KAT NEPETA NEPETA X FAASSENII 'KIT KAT'	1 GAL.		
	SAF	13	AUTUMN FIRE SEDUM SEDUM X 'AUTUMN FIRE'	1 GAL.		

1 PLANTING PLAN - PATIO AREA
SCALE: 1" = 5'



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<p>Revisions:</p> <table border="1"> <tr><th>Date:</th><th></th></tr> <tr><td> </td><td> </td></tr> <tr><td> </td><td> </td></tr> <tr><td> </td><td> </td></tr> </table>	Date:								<p>CONSULTANT</p> <p>engineering discipline <EDIT TEXT> Consultant firm name Consultant firm street address Consultant firm city, state, zip code Consultant firm phone number Consultant POC</p>	<p>ARCHITECT/ENGINEER OF RECORD</p> <p>ANDERSON</p> <p>13605 1st Ave. N. #100 Plymouth, MN 55441 P 763.412.4000 F 763.412.4090 a-e-mn.com Anderson Engineering of Minnesota, LLC Proj # 15522</p>	<p>STAMP</p> <p>I hereby certify that this plan, specification, or report was prepared by me or under my direct supervision and that I am a duly Licensed Professional Landscape Architect under the laws of the State of Minnesota.</p> <p>CURT H. CLAEYS PRINT NAME SIGNATURE 45613 REGISTRATION NUMBER 05/15/2020 DATE</p>	<p>Office of Construction and Facilities Management</p> <p>VA U.S. Department of Veterans Affairs</p>	<p>Drawing Title PLANTING PLAN - PATIO AREA</p> <p>Approved: Project Director</p>	<p>Phase CONSTRUCTION DOCUMENTS</p>	<p>Project Title RENOVATE OLD CHAPEL AND AUDITORIUM</p> <p>Location Sioux Falls, SD</p> <p>Issue Date May 15, 2020</p> <p>Checked CHC</p> <p>Drawn JAF</p>	<p>Project Number 438-19-301</p> <p>Building Number 1 and 5</p> <p>Drawing Number L-1</p>
	Date:															
VA FORM 08 - 6231	1	2	3	4	5	6	7	8	9	10						

PLANT SCHEDULE (SHEET L-2)

SHRUBS	CODE	QTY	COMMON / BOTANICAL NAME	CONT	REMARKS
	CSA	5	ARCTIC FIRE DOGWOOD	5 GAL.	MINIMUM 5 CANES @ 12" HT.


LEGEND

- PROPERTY LIMITS
- CONSTRUCTION LIMITS
- EXISTING TO BE REMOVED
- EXISTING TO REMAIN
- NEW SOD w/IRRIGATION
- 3" DEEP, ROCK MULCH OVER LANDSCAPE FABRIC
- LANDSCAPE POLY EDGER


NOTES

1. ALL PLANTINGS SHALL RECEIVE IRRIGATION
2. SEE 'GRADING PLAN' FOR ADDITIONAL INFORMATION

MATCHLINE - SEE SHEET L-1

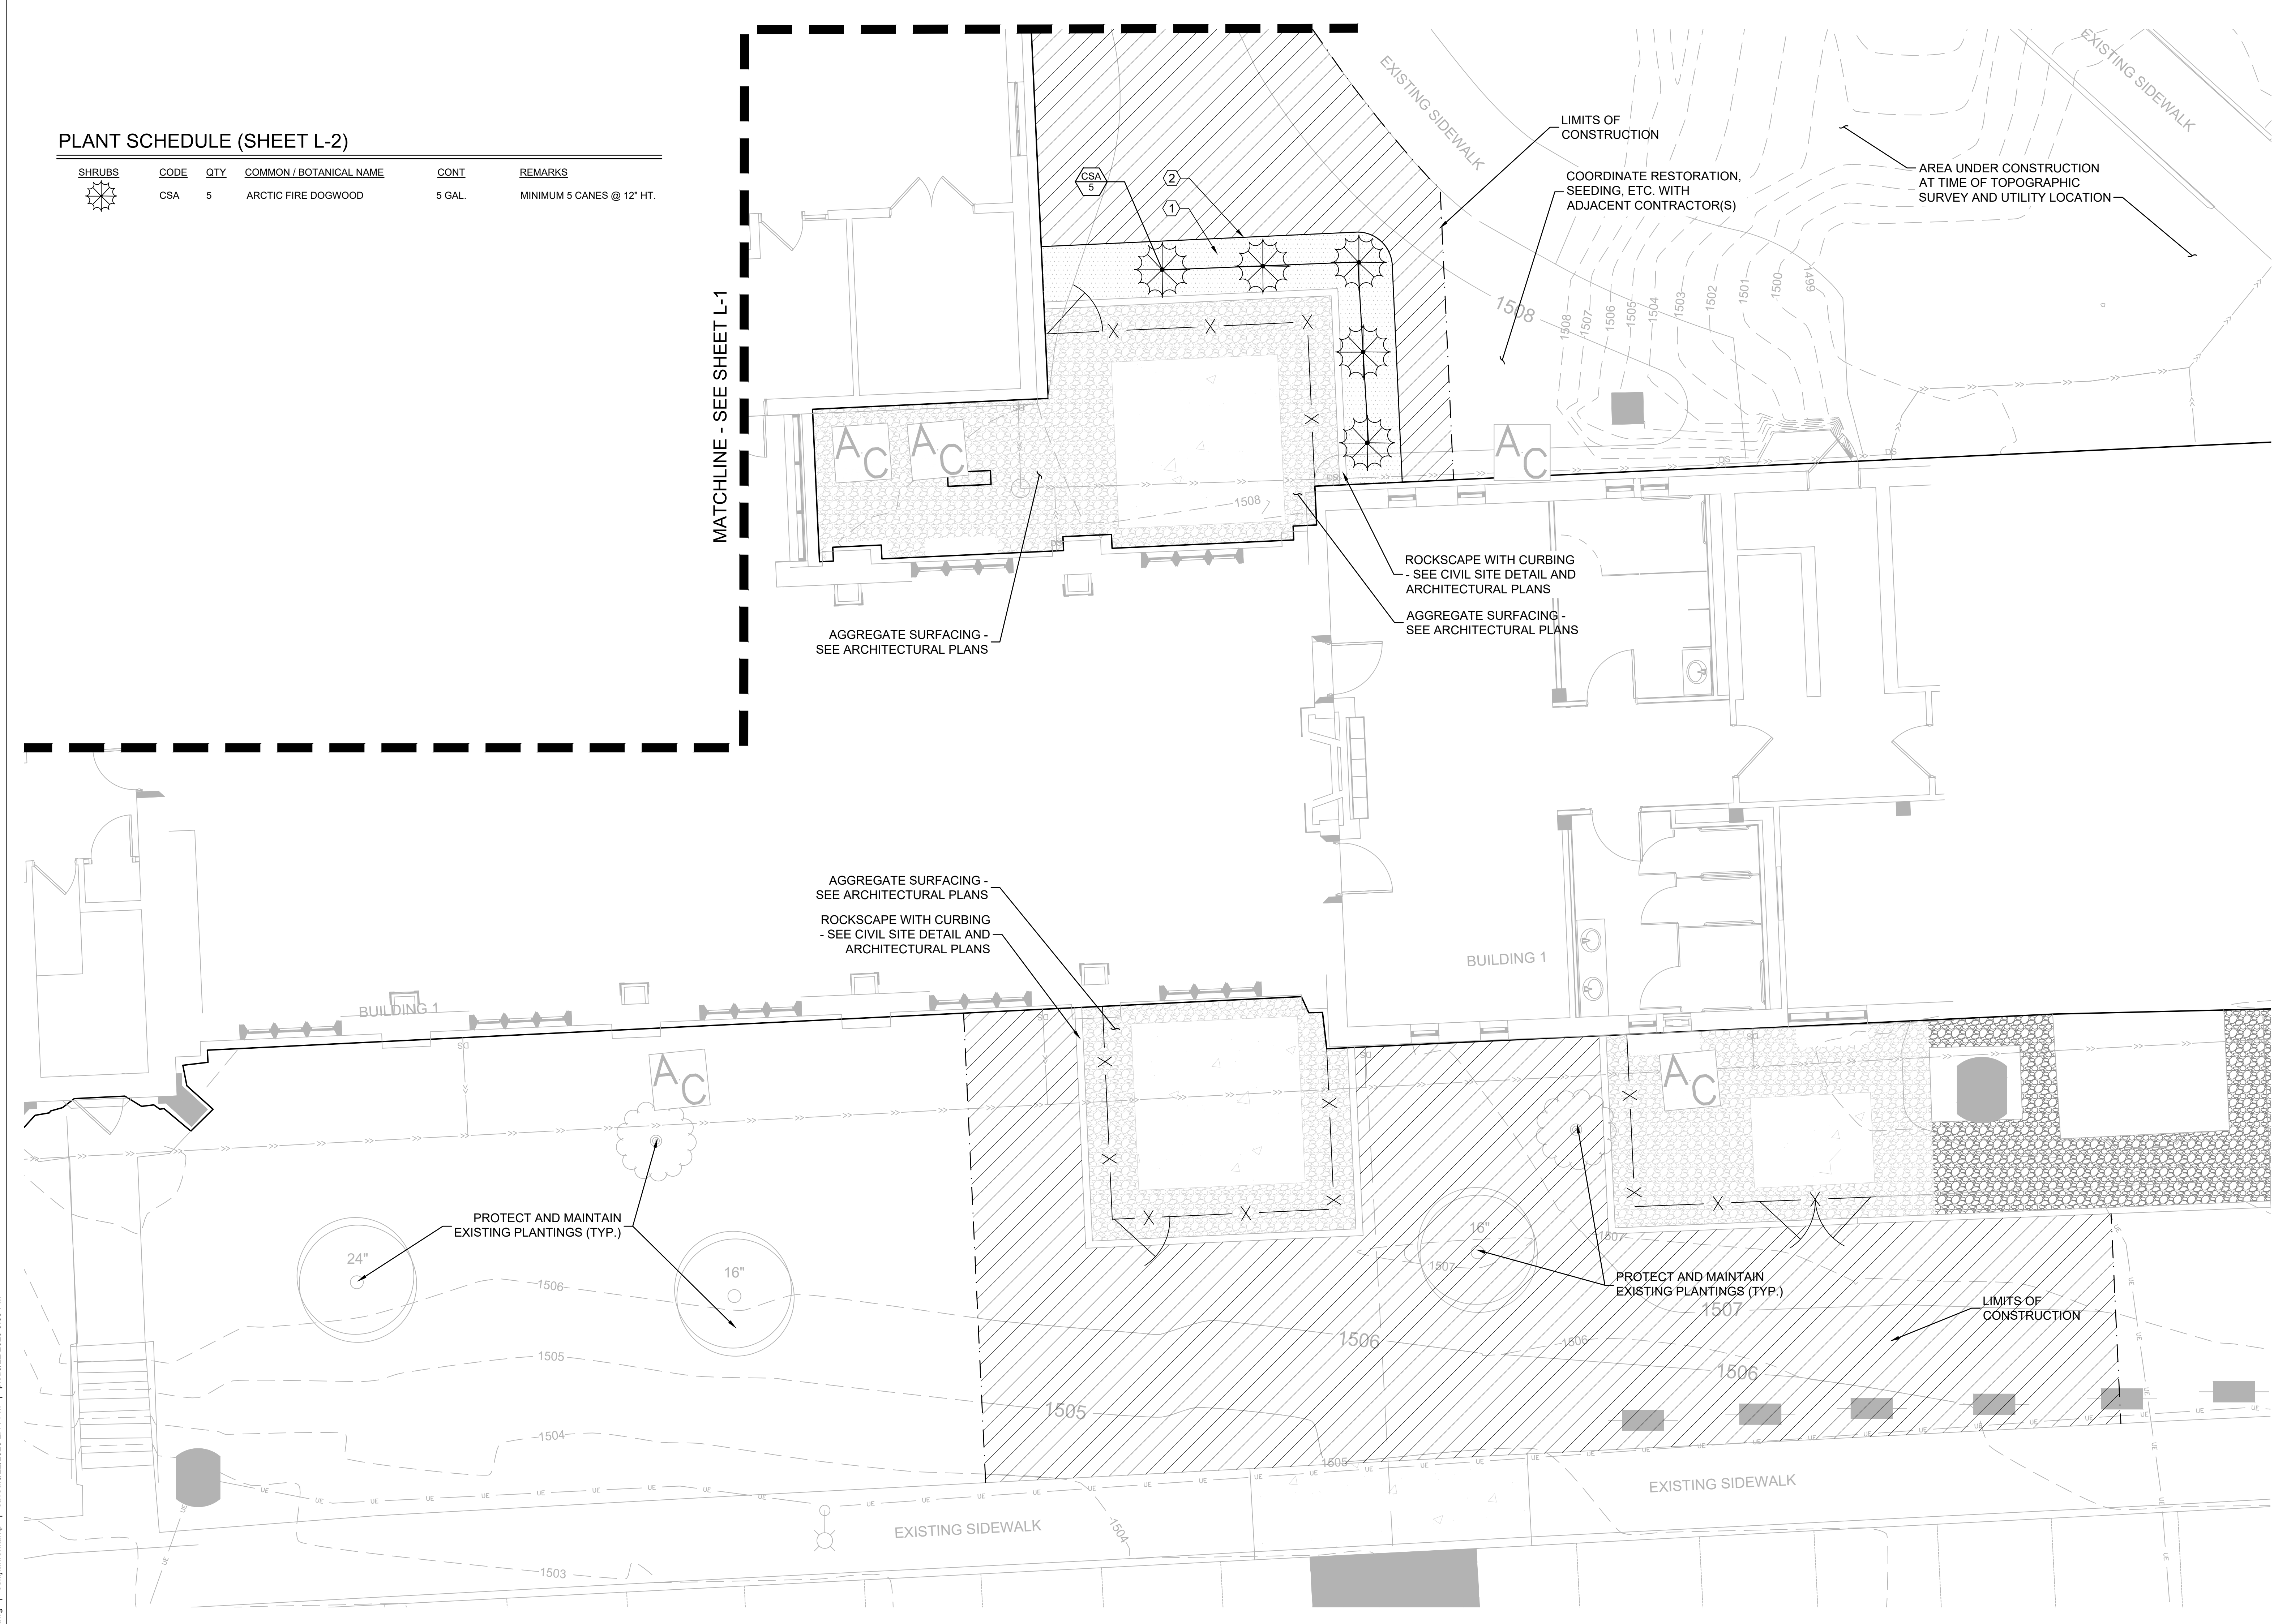


1 PLANTING PLAN - AIR HANDLER AREA
SCALE: 1" = 5'

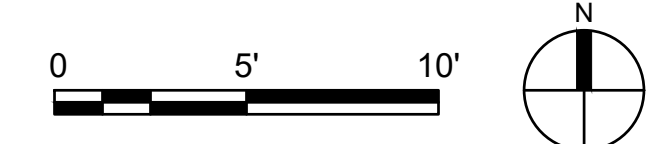


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CONSULTANT engineering discipline <EDIT TEXT> Consultant firm name Consultant firm street address Consultant firm city, state, zip code Consultant firm phone number Consultant POC		ARCHITECT/ENGINEER OF RECORD 13605 1st Ave. N. #100 Plymouth, MN 55441 P 763.412.4000 F 763.412.4090 ae-mn.com Anderson Engineering of Minnesota, LLC Proj # 15522		STAMP I hereby certify that this plan, specification, or report was prepared by me or under my direct supervision and that I am a duly Licensed Professional Landscape Architect under the laws of the State of Minnesota. CURT H. CLAEYS PRINT NAME SIGNATURE 45613 REGISTRATION NUMBER 05/15/2020 DATE		Office of Construction and Facilities Management VA U.S. Department of Veterans Affairs		Drawing Title PLANTING PLAN - AIR HANDLER AREA Approved: Project Director		Phase CONSTRUCTION DOCUMENTS		Project Title RENOVATE OLD CHAPEL AND AUDITORIUM Location Sioux Falls, SD		Project Number 438-19-301 Building Number 1 and 5 Drawing Number L-2	
Revisions: 1 Date:										Issue Date May 15, 2020		Checked CHC		Drawn JAF	


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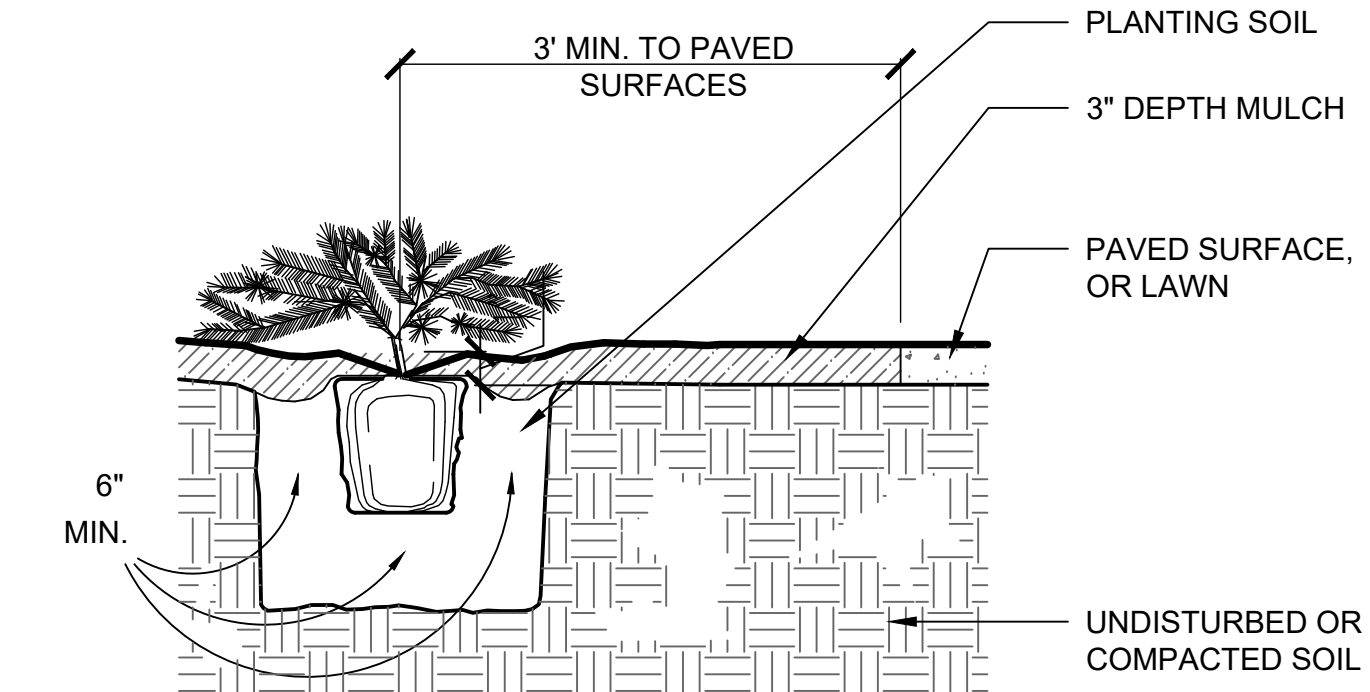
1 SHRUB BED SPACING (TYP.)
SCALE: N.T.S.

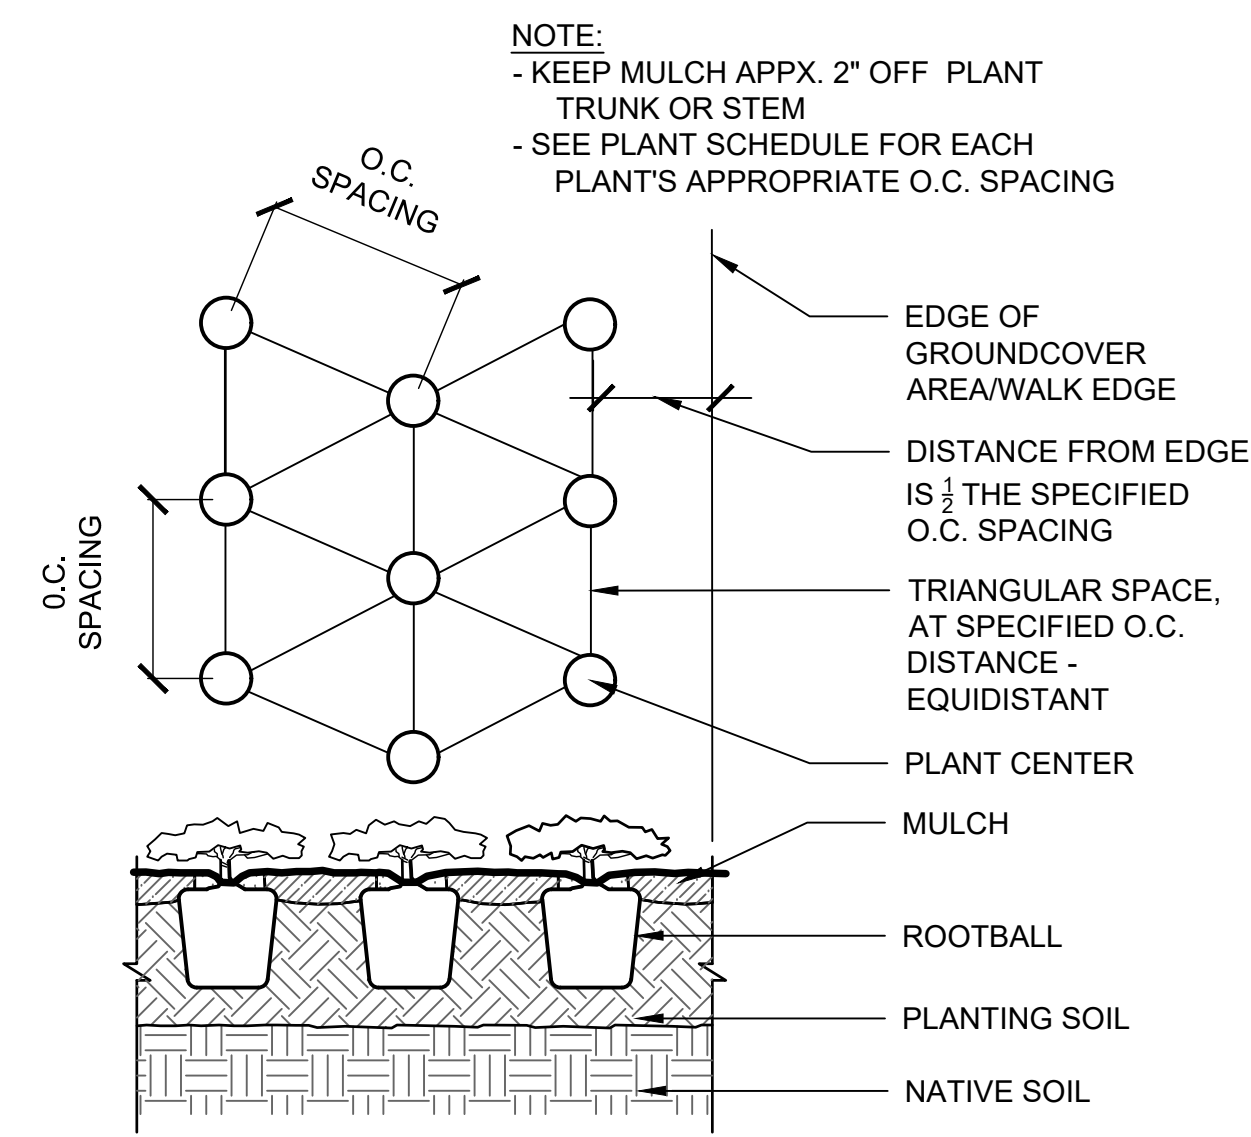


4 DECIDUOUS SHRUB PLANTING (TYP.)
SCALE: N.T.S.

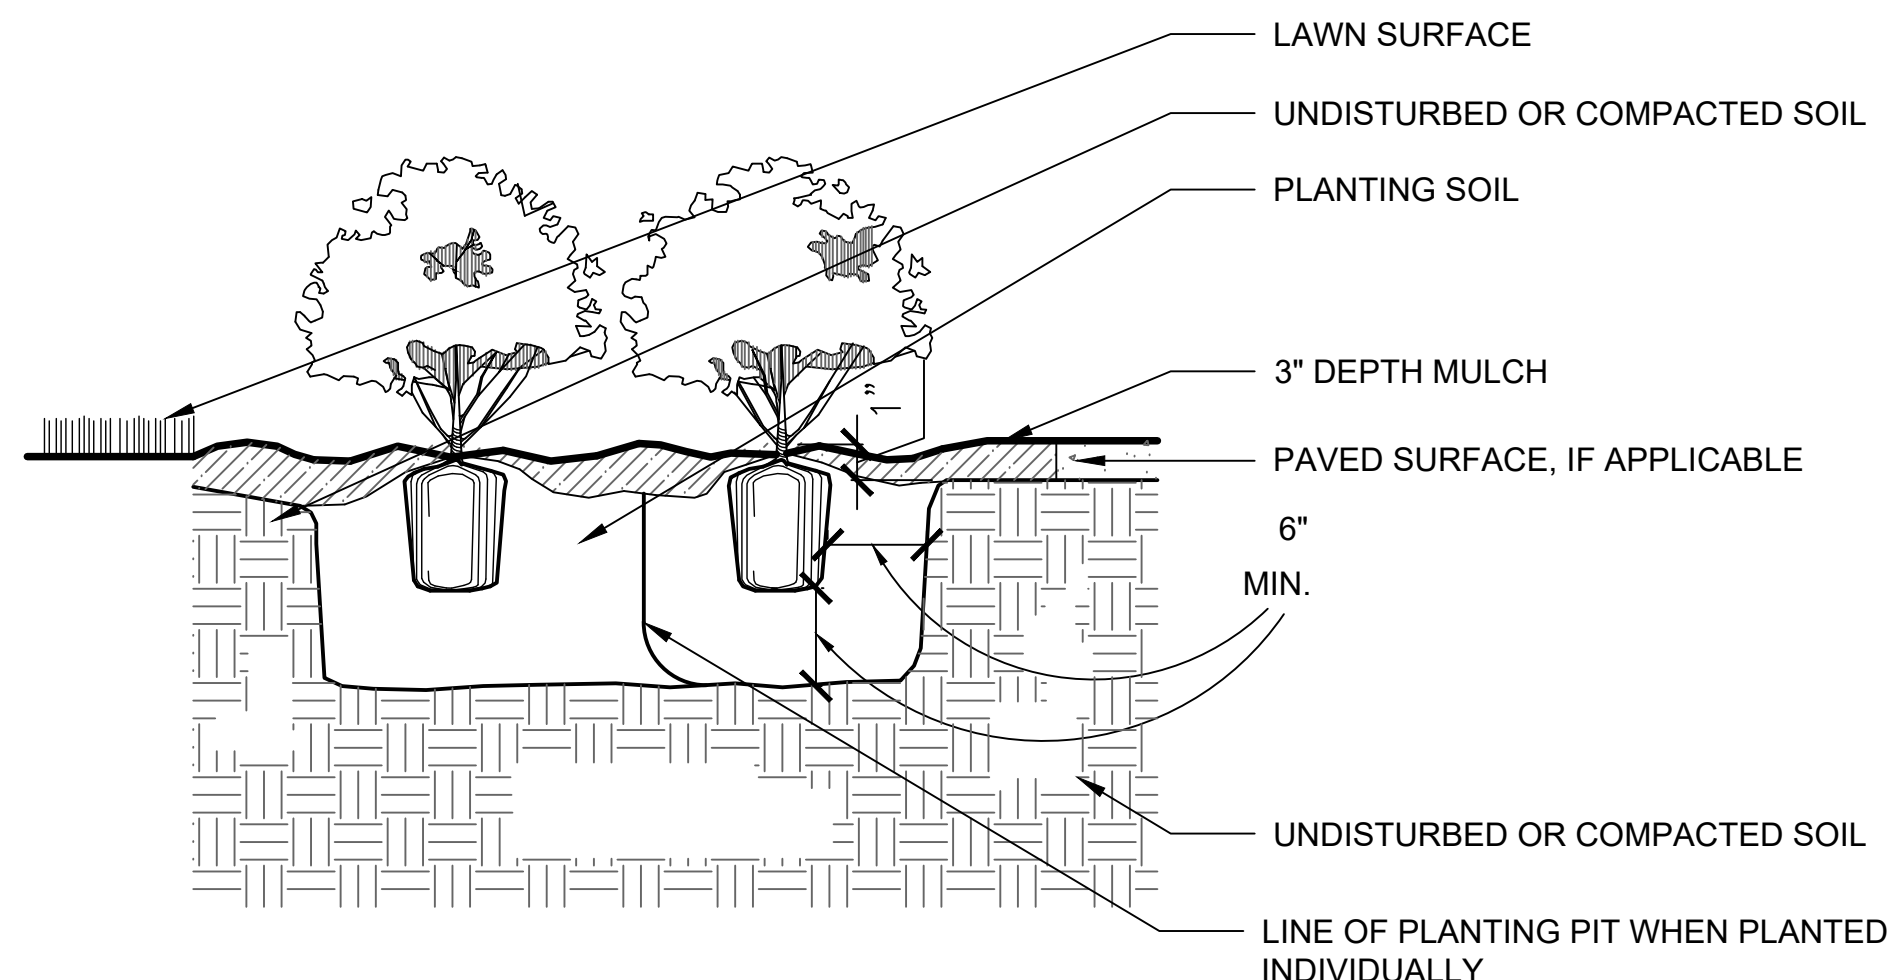

3 POLY EDGER DETAIL
SCALE: N.T.S.

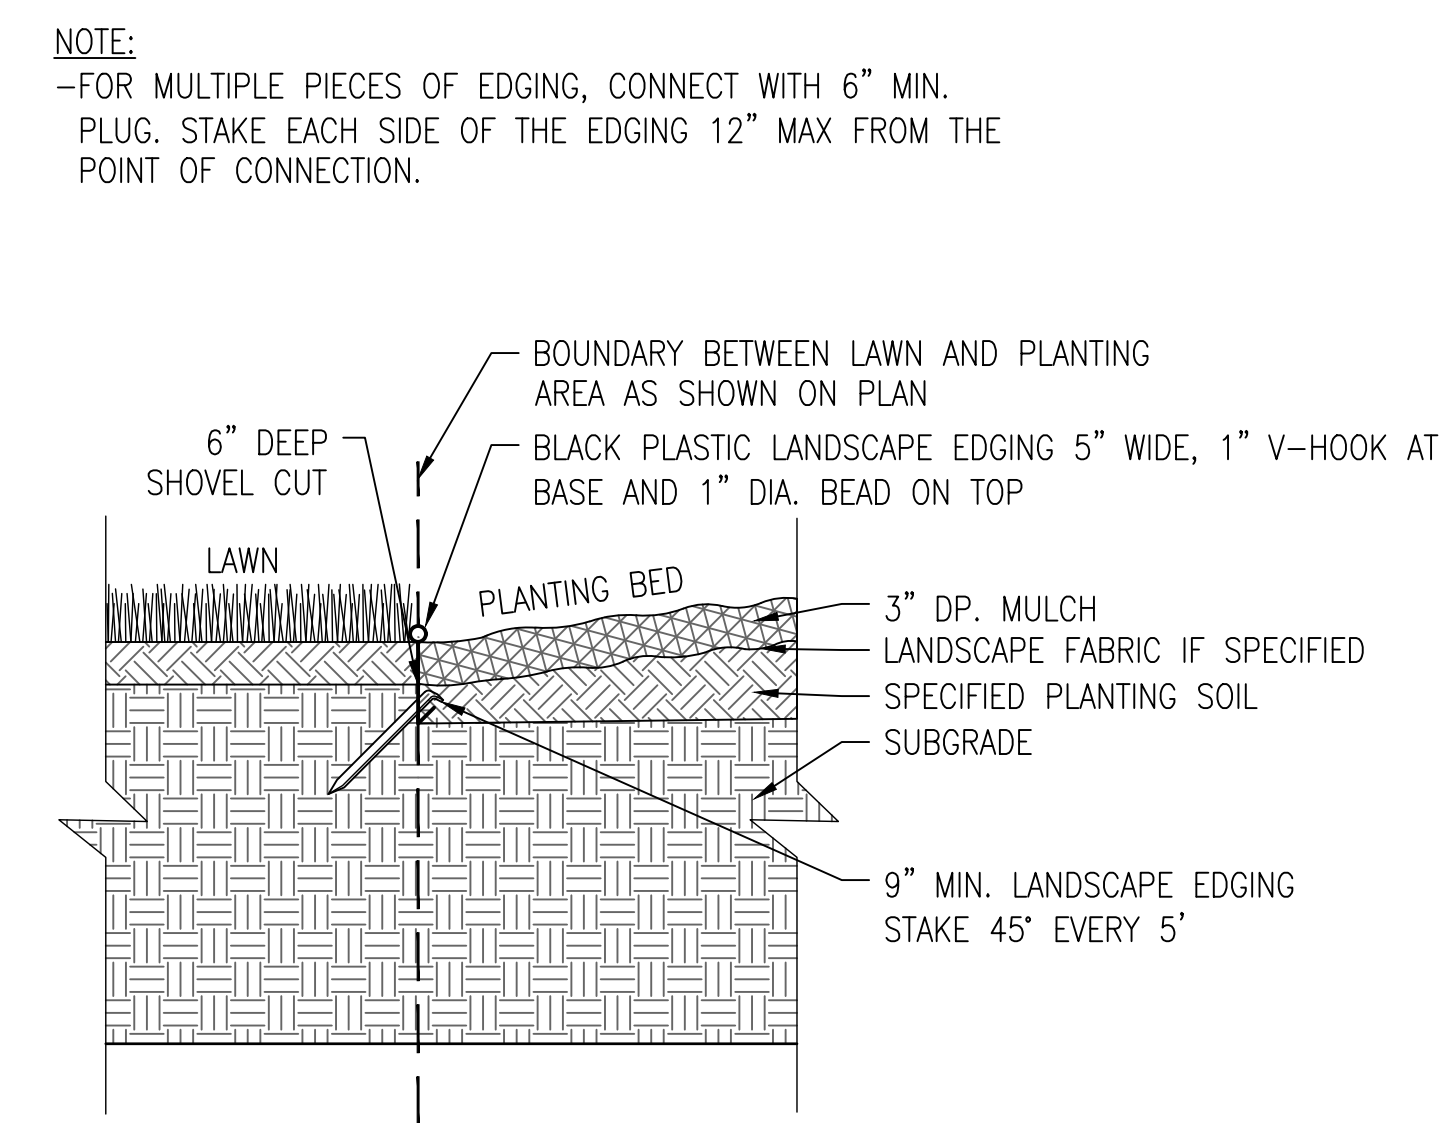
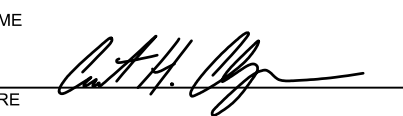



5 EVERGREEN SHRUB PLANTING (TYP.)
SCALE: N.T.S.

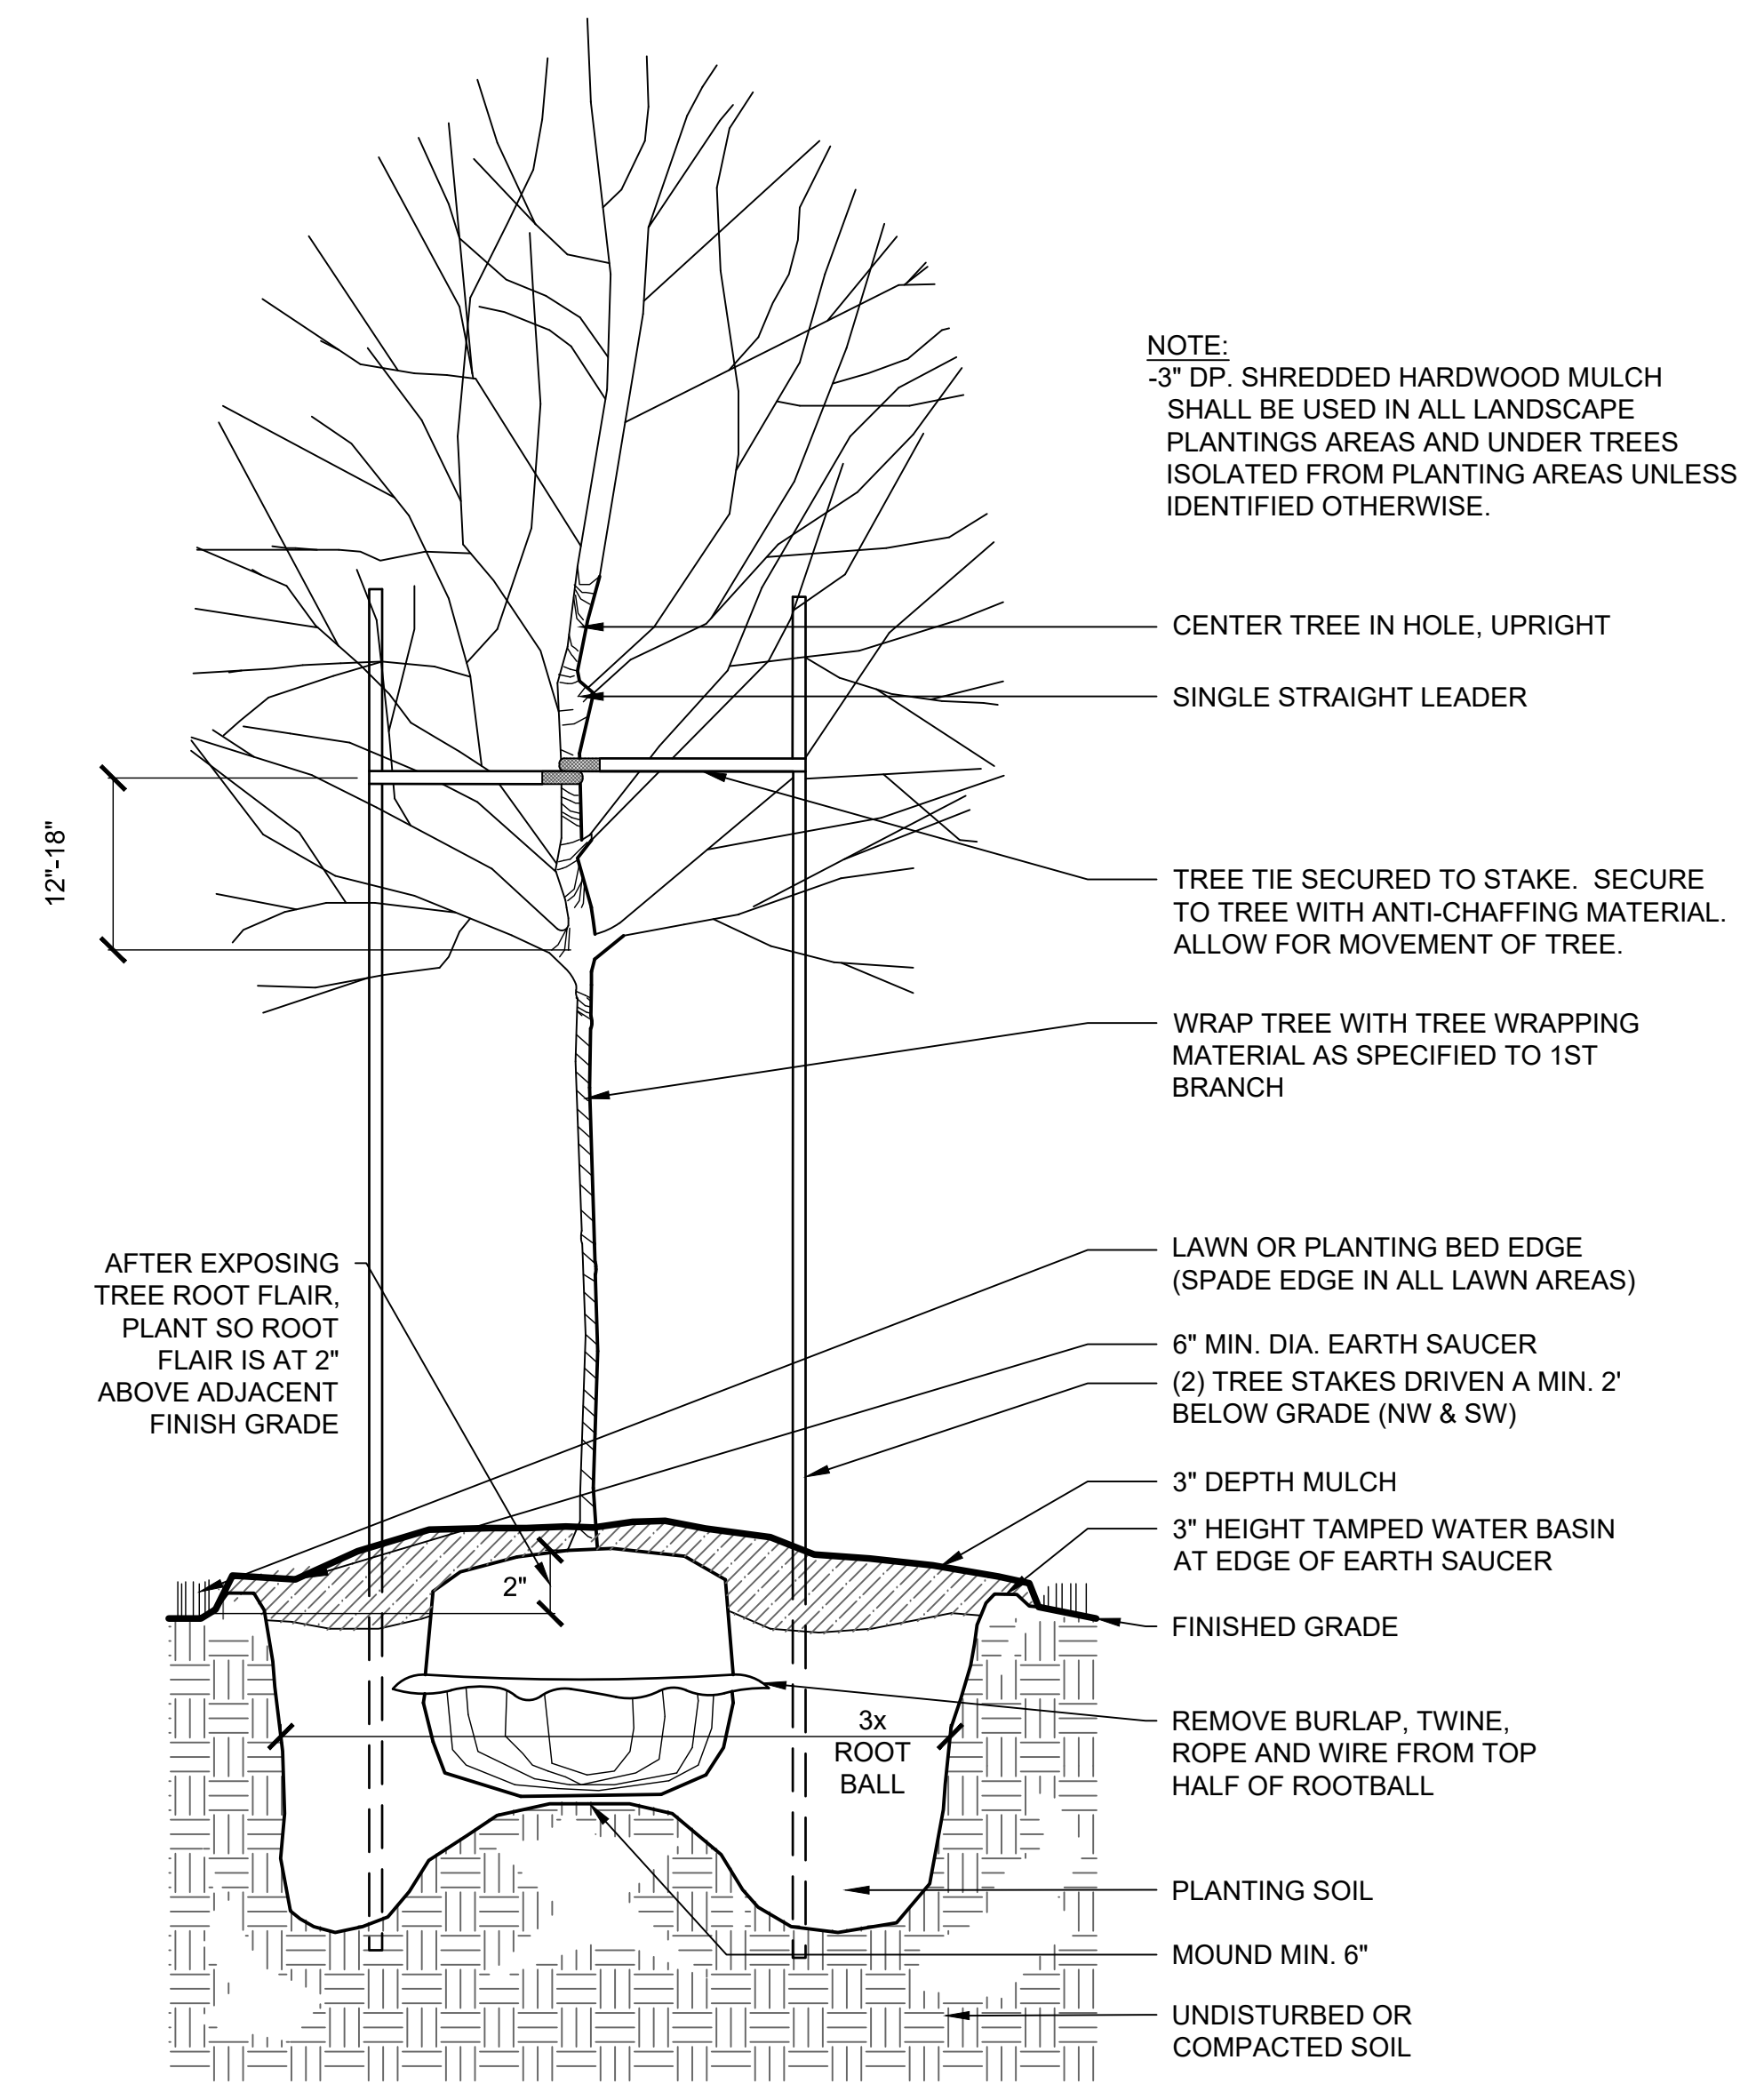

7 DECIDUOUS TREE PLANTING (TYP.)
SCALE: N.T.S.

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A B C D E F

DRAWING SYMBOLS

FOUNDATION PLAN
1/8"=1'-0" (AST S1000)

DRAWING NUMBER: X
DRAWING NAME: FOUNDATION PLAN
AST DETAIL NUMBER: 1
DRAWING SCALE: 1/8"=1'-0" (AST S1000)

- CONCRETE
- FACE BRICK
- CONCRETE BLOCK
- WOOD BLOCKING
- EARTH/ COMPACT FILL
- STEEL
- STEPPED FOOTING LOCATION
- ELEVATION OR WORK POINT

NEW COLUMN NUMBER
EXISTING COLUMN NUMBER

SECTION NUMBER
SHEET NUMBER

SECTION NUMBER
SHEET NUMBER

REVISION AREA CLOUDED

BIM IMAGE ORIENTATION

ABBREVIATIONS

<p>A ANCHOR BOLT ADD'L ADDITIONAL ALT. ALTERNATE ARCH. ARCHITECT(URAL)</p> <p>B BLDG. BUILDING BLK. BLOCK BLKG. BLOCKING BM. BEAM BOT. BOTTOM BRG. BEARING BTWN. BETWEEN</p> <p>C CIP CAST IN PLACE CJ CONTROL JOINT CL CENTER LINE CLR. CLEAR(ANCE) CMU CONCRETE MASONRY UNIT COL. COLUMN COMP. COMPOSITE CONC. CONCRETE CONN. CONNECTION CONST. CONSTRUCTION CONT. CONTINUOUS COORD. COORDINATE CTRD. CENTERED</p> <p>D DBL. DOUBLE DIA. DIAMETER DIAG. DIAGONAL DL DEAD LOAD DO. DITTO DTL. DETAIL DWG. DRAWING</p> <p>E EAST EA. EACH ELEV. ELEVATION EMBED. EMBEDMENT EQ. EQUAL EXIST. EXISTING EXP. EXPANSION EXT. EXTERIOR</p> <p>F FAB. FABRICATE(OR) FD FLOOR DRAIN FNDN. FOUNDATION FTG. FOOTING</p> <p>G GAGE, GAUGE GALV. GALVANIZED GC GENERAL CONTRACT(OR)</p>	<p>H HORIZ. HORIZONTAL HK. HOOK HS HEADED STUDS HSS HOLLOW STRUCTURAL SECTION</p> <p>I INFO. INFORMATION</p> <p>J JBE JOIST BEARING ELEVATION JST. JOIST JT. JOINT</p> <p>K KIP KO KNOCK-OUT KSI KIPS PER SQUARE INCH</p> <p>L LIVE LOAD LL LONG LEG HORIZONTAL LLV LONG LEG VERTICAL</p> <p>M MAS. MASONRY MATL. MATERIAL MAX. MAXIMUM MECH. MECHANICAL MEZZ. MEZZANINE MFG. MANUFACTURE(R) MIN. MINIMUM MISC. MISCELLANEOUS MO MASONRY OPENING</p> <p>N NORTH NIC NOT IN CONTRACT NTS NOT TO SCALE</p> <p>O ON CENTER(S) OH OVERHEAD OPNG. OPENING OPP. OPPOSITE</p> <p>P PC PRECAST CONCRETE PERIM. PERIMETER PL PLATE PLF POUNDS PER LINEAR FOOT PROJ. PROJECT PSF POUNDS PER SQUARE FOOT PSI POUNDS PER SQUARE INCH</p>	<p>Q QTY. QUANTITY</p> <p>R RAD. RADIUS RD ROOF DRAIN REINF. REINFORCE(D), (ING) REQ'D. REQUIRED REV. REVISION, REVISE(D)</p> <p>S SOUTH SCHED. SCHEDULE SIM. SIMILAR SJI STEEL JOIST INSTITUTE SPA. SPACE(S) SQ. SQUARE STD. STANDARD STL. STEEL STRUCT. STRUCTURAL</p> <p>T TBE TOP OF BEAM ELEVATION TDE TOP OF DECK ELEVATION TEMP. TEMPORARY TFE TOP OF FOOTING ELEVATION TPC TOP OF PILE CAP ELEVATION TPE TOP OF PIER ELEVATION TSE TOP OF SLAB ELEVATION TWE TOP OF WALL ELEVATION TYP. TYPICAL</p> <p>U UNO UNLESS NOTED OTHERWISE</p> <p>V VERT. VERTICAL</p> <p>W WEST W/ WITH WP WORK POINT WWR WELDED WIRE REINFORCEMENT</p>
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DRAWING INDEX

SHEET NUMBER	SHEET NAME
S001	TITLE SHEET
S002	STRUCTURAL NOTES
S003	SCHEDULES
S111-01	PATIO FOUNDATION PLAN - BUILDING 1
S111-05	EXISTING PARTIAL FOUNDATION, FIRST AND SECOND FLOOR PLAN - BUILDING 5
S131-05	EXISTING THIRD, FOURTH & FIFTH FLOORS - BUILDING 5
S161-05	EXISTING ROOF FRAMING PLAN - BUILDING 5
S201	SECTIONS AND DETAILS
S202	SECTIONS AND DETAILS

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Revisions:	Date:

CONSULTANT

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Office of Construction and Facilities Management

VA U.S. Department of Veterans Affairs

Drawing Title TITLE SHEET	Phase CONSTRUCTION DOCUMENTS
Approved:	FULLY SPRINKLERED

Project Title RENOVATE OLD CHAPEL AND AUDITORIUM	Project Number SD 1007
Location SIOUX FALLS, SD	Building Number 1 and 5
Issue Date 05/15/2020	Checked MAS
	Drawn AJM
	S001

Project Title RENOVATE OLD CHAPEL AND AUDITORIUM	Project Number SD 1007
Location SIOUX FALLS, SD	Building Number 1 and 5
Issue Date 05/15/2020	Checked MAS
	Drawn AJM
	S001

STRUCTURAL NOTES

I. DESIGN DATA
A. BUILDING CODE
1. INTERNATIONAL BUILDING CODE 2018 EDITION WITH STATE AND LOCAL AMENDMENTS
B. DESIGN LOADS/DESIGN CRITERIA
1. WIND LOAD
BASIC WIND SPEED (3-SECOND GUST)
FLAT ROOF SNOW LOAD
SLOPED ROOF SNOW LOAD
SNOW EXPOSURE FACTOR, Ce
SNOW LOAD IMPORTANCE FACTOR, I
THERMAL FACTOR, Ct
2. FLOOR LOADS - TYPICAL
LIVE LOAD (LL)
DEAD LOAD (SUPERIMPOSED)
3. STAIRS, CORRIDORS & LOBBIES (LL)
LIVE LOAD (LL)
4. SEISMIC DESIGN DATA
SEISMIC IMPORTANCE FACTOR
RISK CATEGORY
MAPPED SPECTRAL RESPONSE ACCELERATIONS
SPECTRAL RESPONSE COEFFICIENTS
SPECTRAL RESPONSE COEFFICIENTS
SITE CLASS
SEISMIC DESIGN CATEGORY
SEISMIC RESPONSE COEFFICIENT
RESPONSE MODIFICATION FACTOR
SEISMIC DESIGN AND ANCHORAGE OF NON-STRUCTURAL COMPONENTS
7. DEFLECTION CRITERIA
ALL MEMBERS SUPPORTING MASONRY ARE DESIGNED FOR A MAXIMUM DEAD LOAD PLUS LIVE LOAD DEFLECTION OF SPAN/600 OR 0.3 INCHES, WHICHEVER IS LESS.
* REDUCED PER IBC, SEC. 1607.10
* PLUS SNOW ACCUMULATION AS REQUIRED BY IBC, CHAPTER 16, SECTION 1608.
C. ALTERNATE DESIGNS
ALTERNATE STRUCTURAL SYSTEMS & DETAILS WILL ONLY BE CONSIDERED PROVIDED THEY ARE SUBMITTED WITH CALCULATIONS CERTIFIED BY A PROFESSIONAL ENGINEER REGISTERED IN THE STATE OF THE PROJECT.
D. EXPANSION JOINTS
EXPANSION JOINTS ARE NOTED ON THE DRAWINGS. NO CONNECTIONS SHALL BE MADE ACROSS THESE JOINTS UNDO.
E. FUTURE EXPANSION
THIS PROJECT IS NOT DESIGNED FOR FUTURE EXPANSION.
F. GENERAL NOTES
1. IN ALL CASES WHERE A CONFLICT MAY OCCUR, SUCH AS BETWEEN REQUIREMENTS IN THE SPECIFICATION AND REQUIREMENTS ON THE DRAWINGS, THE STRUCTURAL ENGINEER OF RECORD SHALL BE IMMEDIATELY NOTIFIED IN WRITING AND THE STRUCTURAL ENGINEER OF RECORD SHALL INTERPRET THE INTENT OF THE CONTRACT DOCUMENT.
2. IN NO CASE, SHALL WORKING DIMENSIONS BE SCALED FROM PLANS, SECTIONS OR DETAILS ON THE STRUCTURAL DRAWINGS.
3. IT SHALL BE THE CONTRACTOR'S RESPONSIBILITY TO VERIFY ALL DIMENSIONS AND CONDITIONS AT THE JOBSITE AND TO CROSS CHECK ALL DETAILS AND DIMENSIONS SHOWN ON THE STRUCTURAL DRAWINGS WITH RELATED REQUIREMENTS ON THE ARCHITECTURAL, MECHANICAL, ELECTRICAL, AND CIVIL DRAWINGS AND NOTIFY THE ENGINEER OF ANY DISCREPANCIES PRIOR TO COMMENCING WORK.
4. IN EXISTING FACILITIES, ALL EXISTING CONDITIONS MUST BE FIELD VERIFIED BY THE CONTRACTOR PRIOR TO CONSTRUCTION. ANY EXISTING CONDITIONS THAT DIFFER FROM THOSE SHOWN ON THE STRUCTURAL DRAWINGS MUST BE BROUGHT TO THE IMMEDIATE ATTENTION OF THE STRUCTURAL ENGINEERING (IN WRITING).
G. REFERENCE STANDARDS - SEE IBC CHAPTER 35 FOR ALL REFERENCE STANDARDS
II. SPECIAL INSPECTIONS
A. THE OWNER SHALL EMPLOY ONE OR MORE SPECIAL INSPECTORS TO PROVIDE 'SPECIAL INSPECTIONS' DURING CONSTRUCTION. THE 'SPECIAL INSPECTIONS' - REQUIRED IN ACCORDANCE WITH THE IBC, SECTIONS 1704 AND 1705 - ARE SUMMARIZED BELOW.
1. SECTION 1705.2 STEEL CONSTRUCTION
2. SECTION 1705.3 CONCRETE CONSTRUCTION
3. SECTION 1705.4 MASONRY CONSTRUCTION
4. SECTION 1705.10 FABRICATED ITEMS
5. SECTION 1705.12 SPECIAL INSPECTIONS FOR SEISMIC RESISTANCE
6. SECTION 1705.13 TESTING FOR SEISMIC RESISTANCE
SEE THE ARCHITECTURAL DRAWINGS AND SPECIFICATIONS FOR INFORMATION REGARDING TESTING AND INSPECTION OF FIELD APPLIED FIREPROOFING AND ASSEMBLIES.
SPECIAL INSPECTOR SHALL SUBMIT AN INSPECTION PLAN THAT SUMMARIZES ALL THE INSPECTIONS THAT WILL BE PROVIDED FOR THE PROJECT PRIOR TO START OF CONSTRUCTION.
III. STRUCTURAL TESTS
A. THE OWNER SHALL EMPLOY ONE OR MORE TESTING AGENCIES TO PROVIDE STRUCTURAL TESTING DURING CONSTRUCTION. THE MINIMUM STRUCTURAL TESTING - REQUIRED IN ACCORDANCE WITH THE IBC IS SUMMARIZED BELOW.
1. CONCRETE CYLINDER COMPRESSION TESTING
2. MASONRY HOLLOW UNIT BLOCK COMPRESSIONS TESTS (UNIT STRENGTH METHOD)
3. ANCHORAGE ** POST-INSTALLED EXPANSION OR ADHESIVE ANCHORS
** WHEN DIRECTED BY THE STRUCTURAL ENGINEER OF RECORD TO PROVIDE POST-INSTALLED ANCHORAGES THE FOLLOWING GUIDELINES SHALL BE FOLLOWED:
1. A REPRESENTATIVE OF THE ANCHOR MANUFACTURER OR PROJECT SPECIAL INSPECTOR SHALL BE ON SITE TO OVERSEE THE INSTALLATION OF THE FIRST FOUR ANCHORS FOR EACH TYPE OF ANCHOR INSTALLED. THIS MEASURE SHALL BE TAKEN FOR EACH INSTALLER OF THE ANCHORS. THIS SERVICE IS TYPICALLY PROVIDED FOR FREE BY THE LOCAL HILTI REPRESENTATIVE.
2. THE FIRST FOUR ANCHORS SHALL BE TENSION TESTED ONCE INSTALLATION IS COMPLETE FOR 100% OF THE SERVICE LEVEL LOAD CAPACITY AS SPECIFIED BY THE STRUCTURAL ENGINEER OF RECORD.
IV. REQUIRED STRUCTURAL SUBMITTALS
A. THE REVIEW OF THE FOLLOWING SUBMITTALS IS INCLUDED IN THE STRUCTURAL ENGINEER OF RECORD'S (SEOR) SCOPE OF SERVICES. THE GENERAL CONTRACTOR SHALL PROVIDE THE ITEMS BELOW TO THE SEOR FOR REVIEW PRIOR TO CONSTRUCTION.
B. SHOP DRAWINGS SHALL BE ORIGINALS AND SHALL NOT BE CREATED, IN WHOLE OR IN PART, FROM THE ELECTRONIC STRUCTURAL CAD FILES OR REPRODUCTIONS OF THE STRUCTURAL DRAWINGS. REPRODUCING THE STRUCTURAL DRAWINGS WITHOUT PRIOR WRITTEN CONSENT OF THE ENGINEER IS A VIOLATION OF COPYRIGHT LAWS AND CODE OF STANDARD PRACTICE. SUBMITTALS NOT ADHERING TO THESE PROVISIONS WILL BE REJECTED WITHOUT REVIEW.
C. SHOP DRAWING PACKAGES MUST BE COMPLETE WHEN SUBMITTED AND MUST INCLUDE CERTIFIED CALCULATIONS IF REQUIRED. INCOMPLETE SHOP DRAWING PACKAGES WILL BE REJECTED WITHOUT REVIEW.
D. PRIOR TO SUBMITTING SHOP DRAWINGS TO SEOR, THE SHOP DRAWINGS MUST BE REVIEWED AND COORDINATED BY THE GENERAL CONTRACTOR.
E. ELECTRONIC VERSION IN PDF FORMAT OF ALL REQUIRED SHOP DRAWINGS AND CALCULATIONS MUST BE SUBMITTED BY THE SUPPLIER AND A MINIMUM OF 10 BUSINESS DAYS MUST BE PROVIDED FOR REVIEW BY THE STRUCTURAL ENGINEER OF RECORD.

Table with 3 columns: CATEGORY, ITEM, COMMENTS. Includes sections for CONCRETE, MASONRY, STEEL, LIGHT GAGE METAL, and OTHER.

V. SITE WORK
GEOTECHNICAL (ASSUMED PROPERTIES)
1. FOUNDATIONS, RETAINING WALLS, FOUNDATION DRAINAGE, SLABS ON GRADE & OTHER ITEMS RELATED TO THE SOILS ARE DESIGNED ON THE ASSUMED DESIGN INFORMATION OUTLINED IN THIS SECTION. THE CONTRACTOR SHALL RETAIN THE SERVICES OF A GEOTECHNICAL ENGINEER, LICENSED IN THE STATE OF THE PROJECT, TO VISIT THE SITE AND CERTIFY IN WRITING THAT THE FOLLOWING ASSUMED DESIGN INFORMATION IS CORRECT.
2. DESIGN NET SOIL BEARING CAPACITY IS AS FOLLOWS:
STRIP FOOTINGS - 1,500 PSF
3. ALLOWABLE PASSIVE PRESSURE - 440 PCF
4. COEFFICIENT OF FRICTION - 0.45
5. MINIMUM DEPTH FROM EXTERIOR GRADE TO BOTTOM OF BUILDING PERIMETER FOOTINGS SHALL BE 4'-0". ALL OPEN AIR FOUNDATIONS HAVE A MINIMUM OF 5'-0" FROST PROTECTION.
6. UNRESTRAINED RETAINING WALLS ARE DESIGNED FOR AN ACTIVE EQUIVALENT FLUID PRESSURE OF 35 PSF/FT. THE BACKFILL MATERIAL SHALL CONSIST OF A WELL-COMPACTED, FREE-DRAINING SAND. SEE THE GEOTECHNICAL REPORT FOR ADDITIONAL INFORMATION ON MATERIAL GRADATION AND BACKFILL OPERATIONS.
VI. CONCRETE
CONCRETE MATERIAL PROPERTIES
1. CONCRETE PROPERTIES (STRENGTH (fc @ 28 DAYS))
FOOTINGS - 3000 PSI
RETAINING WALLS - 4000 PSI
EXTERIOR SLAB ON GRADE - 4000 PSI
CONC. OVER METAL DECK - 3500 PSI
2. CYLINDER TESTING SHALL BE COMPLETED PER ACI-318, SECTION 5.6. TESTING REPORTS SHALL BE PROVIDED TO THE OWNER AND ENGINEER OF RECORD AT A MINIMUM, PREFERABLE DELIVERY METHOD IS VIA E-MAIL.
3. ALL EXTERIOR CONCRETE, PERMANENTLY EXPOSED TO WEATHER (DOES NOT APPLY TO BURIED FOUNDATIONS), SHALL BE AIR ENTRAINED TO GIVE THE CONCRETE AN AIR CONTENT OF 6% +/- 1% BY VOLUME. NATURALLY OCCURRING AIR SHALL NOT EXCEED 3% FOR NON-AIR ENTRAINED MIXES.
4. CONCRETE MIX DESIGNS & SUPPORTIVE DATA MUST BE SUBMITTED FOR APPROVAL ACCORDING TO ACI-318 SECTION 5.3, AND ACI-301, SECTION 1.5.
5. LIGHTWEIGHT CONCRETE SHALL HAVE A MINIMUM DRY UNIT WEIGHT OF 105 PCF & A MAXIMUM DRY UNIT WEIGHT OF 116 PCF WITH AIR CONTENT OF 4% TO 7%.

Table with 4 columns: REINFORCING PROPERTIES, fy KSI, ASTM, and other specifications for steel reinforcement.

C. CAST IN PLACE CONCRETE
1. ALL CONCRETE SHALL BE DESIGNED AND CONSTRUCTED IN ACCORDANCE WITH IBC CHAPTER 19 & ACI-318.
2. ALL REINFORCING SHALL BE DETAILED, FABRICATED & PLACED IN ACCORDANCE WITH CRSI 'MANUAL OF STANDARD PRACTICE.' THE STEEL REINFORCING SUPPLIER SHALL SUBMIT SHOP DRAWINGS FOR ALL ELEMENTS & MEMBERS WITH REINFORCING FURNISHED BY THE SUPPLIER.
3. PER ACI 26.8.2.2, ALL REINFORCEMENT SHALL BE PLACED AND SUPPORTED PRIOR TO PLACING CONCRETE. 'WET STICKING' OF REBAR, INCLUDING DOWELS IS PROHIBITED.
4. SPACING OF CONSTRUCTION OR CONTROL JOINTS IN WALLS EXPOSED TO VIEW SHALL NOT EXCEED 40 FEET UNLESS SPECIFICALLY NOTED OTHERWISE ON THE DRAWINGS. CUT HALF OF THE HORIZONTAL REINFORCING AT CONTROL JOINTS.
5. SLEEVES EMBEDDED IN SLABS AND WALLS SHALL BE LOCATED CLEAR BETWEEN REINFORCING BARS AND SHALL MAINTAIN CLEAR SPACING EQUAL TO THE DIAMETER OF THE LARGEST SLEEVE IN ANY DIRECTION. SLEEVE GROUPS THAT DO NOT COMPLY WITH THE ABOVE REQUIREMENTS SHALL BE CONSIDERED AS AN OPENING AND REINFORCED PER NOTE #5 BELOW.
6. UNLESS NOTED OTHERWISE ON THE DRAWINGS, PROVIDE EXTRA REINFORCING ON ALL SIDES OF ALL MISCELLANEOUS WALL AND SLAB OPENINGS EQUAL TO ONE HALF THE INTERRUPTED REINFORCING BARS EACH SIDE BUT NOT LESS THAN 2 - #5 FOR EACH LAYER OF REINFORCEMENT. EXTEND BARS CLASS 'B' LAP LENGTH BUT NOT LESS THAN 2 FEET BEYOND EDGE OF OPENINGS. PROVIDE 2 - #4x4'-0" DIAGONAL BARS AT EACH CORNER FOR EACH LAYER OF REINFORCEMENT.
7. PROVIDE A 3/4" CHAMFER ON ALL EXPOSED CORNERS OF CONCRETE.
8. PROVIDE ISOLATION JOINTS AROUND COLUMNS AT SLAB ON GRADE AREAS.
9. THE FOLLOWING MINIMUM CONCRETE COVER SHALL BE PROVIDED FOR REINFORCEMENT:
CONCRETE CAST AGAINST & PERMANENTLY EXPOSED TO EARTH - 3
CONCRETE EXPOSED TO EARTH OR WEATHER:
#5 THRU #8 BARS - 2
#5 & SMALLER BARS - 1 1/2
CONCRETE NOT EXPOSED TO WEATHER OR IN CONTACT WITH GROUND:
SLABS & WALLS:
#11 & SMALLER BARS - 3/4
BEAMS & COLUMNS:
PRIMARY REINFORCEMENT, TIES & STIRRUPS - 1 1/2

D. COMPOSITE METAL DECK AND CONCRETE FLOOR SYSTEMS
1. PRE-COMPOSITE (WET CONCRETE) REQUIREMENTS
A. EQUIPMENT FOR CONCRETE PLACING AND FINISHING OPERATIONS ON THE METAL DECK SHALL NOT BE USED WITHOUT PRIOR WRITTEN APPROVAL OF THE ENGINEER OF RECORD.
B. THE PRE-COMPOSITE CONSTRUCTION LIVE LOAD LIMITS THE EQUIPMENT ALLOWED ON THE METAL DECK DURING PLACING OPERATIONS. SEE THE DESIGN LOADS SECTION FOR THE LIVE LOAD USED FOR DESIGN.
C. CONCRETE PUMP LINE EQUIPMENT USED TO MOVE THE LINE DURING PLACING MAY NOT BE USED ON FLOOR SYSTEMS DESIGNED WITH WELDED WIRE REINFORCING (WWR). WHERE FIBER REINFORCING IS USED IN LIEU OF WWR, LINE EQUIPMENT MAY BE USED AS LONG AS IT IS NOT LOCATED ON DECK SPANS WHERE CONCRETE IS ACTIVELY BEING PLACED. PERSONNEL OTHER THAN THE OPERATOR(S) SHALL REMAIN AT LEAST 10 FEET AWAY FROM THE EQUIPMENT.
2. POST-COMPOSITE (CURED CONCRETE) REQUIREMENTS
A. THE GENERAL CONTRACTOR SHALL TAKE APPROPRIATE MEASURES TO PREVENT CRACKING OF THE ELEVATED CONCRETE SLABS DURING CONSTRUCTION AND BUILD-OUT ACTIVITIES. THIS INCLUDES LIMITING MATERIALS, EQUIPMENT AND OPERATIONS TO THOSE THAT DO NOT DAMAGE THE SLABS.
B. NO EQUIPMENT OR MATERIAL MAY BE USED OR STORED ON THE ELEVATED CONCRETE FLOOR WITHIN 7 DAYS OF CONCRETE PLACEMENT. IN ADDITION, CYLINDER TESTS SHALL CONFIRM THAT THE DESIGN COMPRESSIVE STRENGTH HAS BEEN REACHED.
C. LIFTS FOR PERSONNEL OR MATERIAL SHALL NOT BE USED ON THE ELEVATED CONCRETE SLAB WITHOUT PRIOR WRITTEN APPROVAL OF THE ENGINEER OF RECORD. THE DESIGN SHOWN ON THE CONSTRUCTION DOCUMENTS ASSUMES THAT LIFTS DO NOT EXCEED A TOTAL WEIGHT WITH PAYLOAD OF 2500 LBS AND THAT NO AXLE LOAD EXCEEDS 1500 LBS.
D. A MAXIMUM OF (2) TWO LIFTS MAY BE USED IN A GIVEN BAY. A MINIMUM CLEARANCE OF 10 FEET BETWEEN LIFTS MUST BE MAINTAINED AT ALL TIMES.
E. MATERIAL STOCKED OR STORED ON THE ELEVATED SLAB SHALL BE DISTRIBUTED SUCH THAT THE LOAD DOES NOT EXCEED THE DESIGN LIVE LOAD FOR THE FLOOR.
F. OPERATIONS SHALL MINIMIZE IMPACT LOADING BY SLOWLY LOWERING LOADS FROM PALLET JACKS AND OTHER SIMILAR EQUIPMENT.

Table with 4 columns: STEEL MATERIAL PROPERTIES, STEEL PROPERTIES, STRENGTH (PSI), and ASTM specifications.

C. STEEL FLOOR DECK
1. ALL STEEL DECK SHALL BE DESIGNED & CONSTRUCTED IN ACCORDANCE WITH IBC CHAPTER 22, SECTION 2210 - COLD FORMED STEEL AND THE STEEL DECK INSTITUTE SPECIFICATIONS AND RECOMMENDATIONS, UNDO.
2. THE STEEL DECK SUPPLIER SHALL SUBMIT SHOP DRAWINGS FOR ALL ELEMENTS & MEMBERS FURNISHED BY THE DECK SUPPLIER. DECK SUPPLIER SHALL SUBMIT ICC REPORTS SHOWING ALLOWABLE DIAPHRAGM SHEAR VALUES.
3. PRE-APPROVED DECK MANUFACTURERS ARE NUCOR/VULCRAFT/VERCO, WHEELING, AND CAN-AM. OTHER METAL DECK MANUFACTURERS MAY BE APPROVED PROVIDED THAT THE DECK SPECIFICATIONS MEET OR EXCEED THE SPECIFICATIONS OF THE PRE-APPROVED MANUFACTURERS. METAL DECK SIZE, GAGE AND TYPE ARE INDICATED ON THE DRAWINGS.
4. STRUCTURAL SLAB FORM (METAL CENTERING) SHALL BE DESIGNED FOR THE SPANS AND SLAB DEAD LOADS AS SHOWN ON THE DRAWINGS & INSTALLED IN ACCORDANCE WITH SDI SPECIFICATIONS AND MANUFACTURER'S REQUIREMENTS.
5. THE STEEL DECK SHALL SUPPORT THE WEIGHT OF WET CONCRETE AND OTHER CONSTRUCTION LOADS AS AN UN-SHORED FORM DECK. PLACEMENT AND SEQUENCE OF LOADING THE DECK WITH THE WET CONCRETE IS THE RESPONSIBILITY OF THE CONCRETE SUBCONTRACTOR AND SHALL BE COORDINATED WITH THE DECK SUPPLIER IN ADVANCE OF PLACING CONCRETE.
6. DECK FASTENING SHALL BE PER SDI MANUFACTURER'S RECOMMENDATIONS BUT NOT LESS THAN THAT SHOWN ON THE DRAWINGS. BUTTON-PUNCHED OR CRIMPED SIDE LAP FASTENERS SHALL NOT BE USED ON THE COMPOSITE DECK. COMPOSITE DECK MUST BE SCREWED OR WELDED AS INDICATED ON THE DRAWINGS.
7. ALL METAL DECK TO BE SPRAY FIREPROOFED SHALL BE GALVANIZED, CLEANED & DEGREASED PRIOR TO SHIPPING. SEE ARCHITECTURAL DRAWINGS FOR EXTENT OF FIREPROOFING.

Table with 4 columns: LIGHT GAGE METAL STUD FRAMING, LIGHT GAGE FRAMING, and specifications for framing members.

THE DRAWINGS ARE INTENDED TO EXPRESS THE MINIMUM DESIGN PERFORMANCE. ALTERNATE DESIGNS OF EQUIVALENT CAPACITY WILL BE CONSIDERED BY THE STRUCTURAL ENGINEER FOR APPROVAL. THIS WILL BE SUBJECT TO THE REVIEW OF THE FINAL DETAILED SHOP DRAWINGS AND RELATED DESIGN CALCULATIONS CERTIFIED BY A PROFESSIONAL ENGINEER REGISTERED IN THE STATE OF THE PROJECT.
5. SCREW ALL STEEL SECTIONS AT WINDOW HEADS & SILLS TO JAMB STUDS WITH A MINIMUM OF ONE SCREW EACH SIDE EACH MEMBER.
6. ANCHOR EACH STUD TO RUNNERS WITH FOUR #10 SCREWS, TWO TOP AND TWO BOTTOM, WITH ONE SCREW IN EACH FLANGE UNDO.
7. ALIGN RUNNER TRACK ACCURATELY & SECURE TO BASE & HEAD WITH FASTENERS AS SHOWN ON THE DRAWINGS OR EQUIVALENT OR AS NOTED IN THE MANUFACTURER'S STANDARD SPECIFICATION BUT FASTENER SPACING SHALL NOT EXCEED 24" ON CENTER.
8. SELF-DRILLING OR SELF-TAPPING MINIMUM 1/2" TYPE S-12 SCREWS MAY BE USED IN LIEU OF WELDING FOR ASSEMBLING STEEL STUD WALLS. ONE SCREW MAY BE SUBSTITUTED FOR EACH WELD UNDO.

Project information block containing Consultant (AST), Architect/Engineer of Record (Anderson), Office of Construction and Facilities Management, Drawing Title (STRUCTURAL NOTES), Phase (CONSTRUCTION DOCUMENTS), Project Title (RENOVATE OLD CHAPEL AND AUDITORIUM), Location (SIOUX FALLS, SD), Issue Date (05/15/2020), Checked (MAS), Drawn (AJM), and Project Number (SD 1007) / Drawing Number (1 and 5) / S002.

A
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EXISTING CONCRETE COLUMN SCHEDULE		
MARK	SIZE	REMARKS
(E) 10" COL.	(E) 10" COL.	
(E) C1	12"x12"	
(E) C2	14"x14"	
(E) C3	18"x18"	
(E) C4	18"x18"	
(E) C5	20"x20"	
(E) C6	22"x22"	
(E) C7	22"x22"	
(E) C8	24"x24"	
(E) C9	26"x26"	

EXISTING FOOTING SCHEDULE			
MARK	SIZE	REINF. E.W. BOTTOM	REMARKS
(E) F5.3	5'-4"x6'-4"x2'-2"	(10) - #5	
(E) F6.5	6'-6"x6'-6"x2'-2"	(14) - #5	
(E) F6.8	6'-10"x6'-10"x2'-4"	(14) - #5	
(E) F7	7'-0"x7'-0"x2'-0"	(20) - #6	
(E) F7.5	7'-6"x7'-6"x2'-2"	(22) - #6	
(E) F7.5b	7'-6"x7'-6"x2'-4"	(21) - #6	
(E) F8	8'-0"x8'-0"x2'-4"	(22) - #6	
(E) F8.5	8'-6"x8'-6"x2'-4"	(24) - #6	
(E) F8.8	8'-10"x8'-10"x2'-4"	(24) - #6	
(E) F9.2	9'-2"x9'-2"x2'-4"	(28) - #6	
(E) F9.3a	9'-4"x9'-4"x2'-2"	(28) - #6	
(E) F9.3b	9'-4"x9'-4"x2'-6"	(27) - #6	
(E) F9.5	9'-6"x9'-6"x2'-6"	(26) - #6	
(E) F9a	9'-0"x9'-0"x2'-2"	(25) - #6	
(E) F9b	9'-0"x9'-0"x2'-4"	(28) - #6	

BEAM CONNECTION SCHEDULE					
SINGLE SHEAR TAB (FLEXIBLE) CONNECTION USING SHORT-SLOTTED HOLES TRANSVERSE TO DIRECTION OF LOAD					
CONNECTION CAPACITY (Ø Rn)	MINIMUM BEAM SIZE	SHEAR TAB SIZE	WELD SIZE "t"	NUMBER OF ROWS OF 3/4" Ø A325-N BOLTS	REMARKS
14k	W8 W10	PL 1/4"x4 1/2"x0'-6"	3/16"	2	
27k	W12 W14	PL 1/4"x4 1/2"x0'-9"	3/16"	3	
44k	W16	PL 1/4"x4 1/2"x1'-0"	3/16"	4	
62k	W18	PL 1/4"x4 1/2"x1'-3"	3/16"	5	
79k	W21	PL 5/16"x4 1/2"x1'-6"	1/4"	6	2"x4 3/4" MAXIMUM COPE
96k	W27	PL 3/8"x4 1/2"x1'-9"	5/16"	7	2 1/4"x5 3/4" MAXIMUM COPE
113k	W30	PL 7/16"x4 1/2"x2'-0"	3/8"	8	2 1/4"x5 3/4" MAXIMUM COPE
130k	W33	PL 7/16"x4 1/2"x2'-3"	3/8"	9	2 1/4"x5 3/4" MAXIMUM COPE
142k	W36	PL 7/16"x4 1/2"x2'-6"	3/8"	10	2 1/4"x5 3/4" MAXIMUM COPE

NOTES:

- TYPICAL CONNECTION DESIGN IS FOR A MAXIMUM TOP COPE OF 1 1/2" DEEP AND 4" LONG. SHEAR TAB CONNECTION MAY REQUIRE A SMALLER COPE DEPTH. MINIMUM EDGE DISTANCE FOR STANDARD BOLT HOLES IS 1 1/4" (MINIMUM EDGE DISTANCE FOR SHORT SLOTTED HOLES IS 1 3/8").
- FOR SHEAR TAB CONNECTIONS WITH SUPPORTING MEMBER WEB THICKNESS GREATER THAN 3/4" USE 3/8" WELD AND 7/16" PLATE.
- USE DOUBLE ANGLE BOLTED CONNECTION SCHEDULE FOR REACTIONS EXCEEDING CONNECTION CAPACITY GIVEN IN THIS SCHEDULE.
- CONNECTION CAPACITY IS AN ULTIMATE LOAD PER AISC-LRFD THIRD EDITION.
- COORDINATE SHEAR TAB LENGTH WITH OTHER DETAILS ON THIS PROJECT.
- SHORT SLOTTED HOLES ARE IN THE BEAM.
- CONNECTION CAPACITY IS BASED ON SMALLEST BEAM DESIGNATION OF MINIMUM BEAM SIZE.

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Revisions:	Date:

CONSULTANT


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AST PROJECT NUMBER: SD 1007

ARCHITECT/ENGINEER OF RECORD

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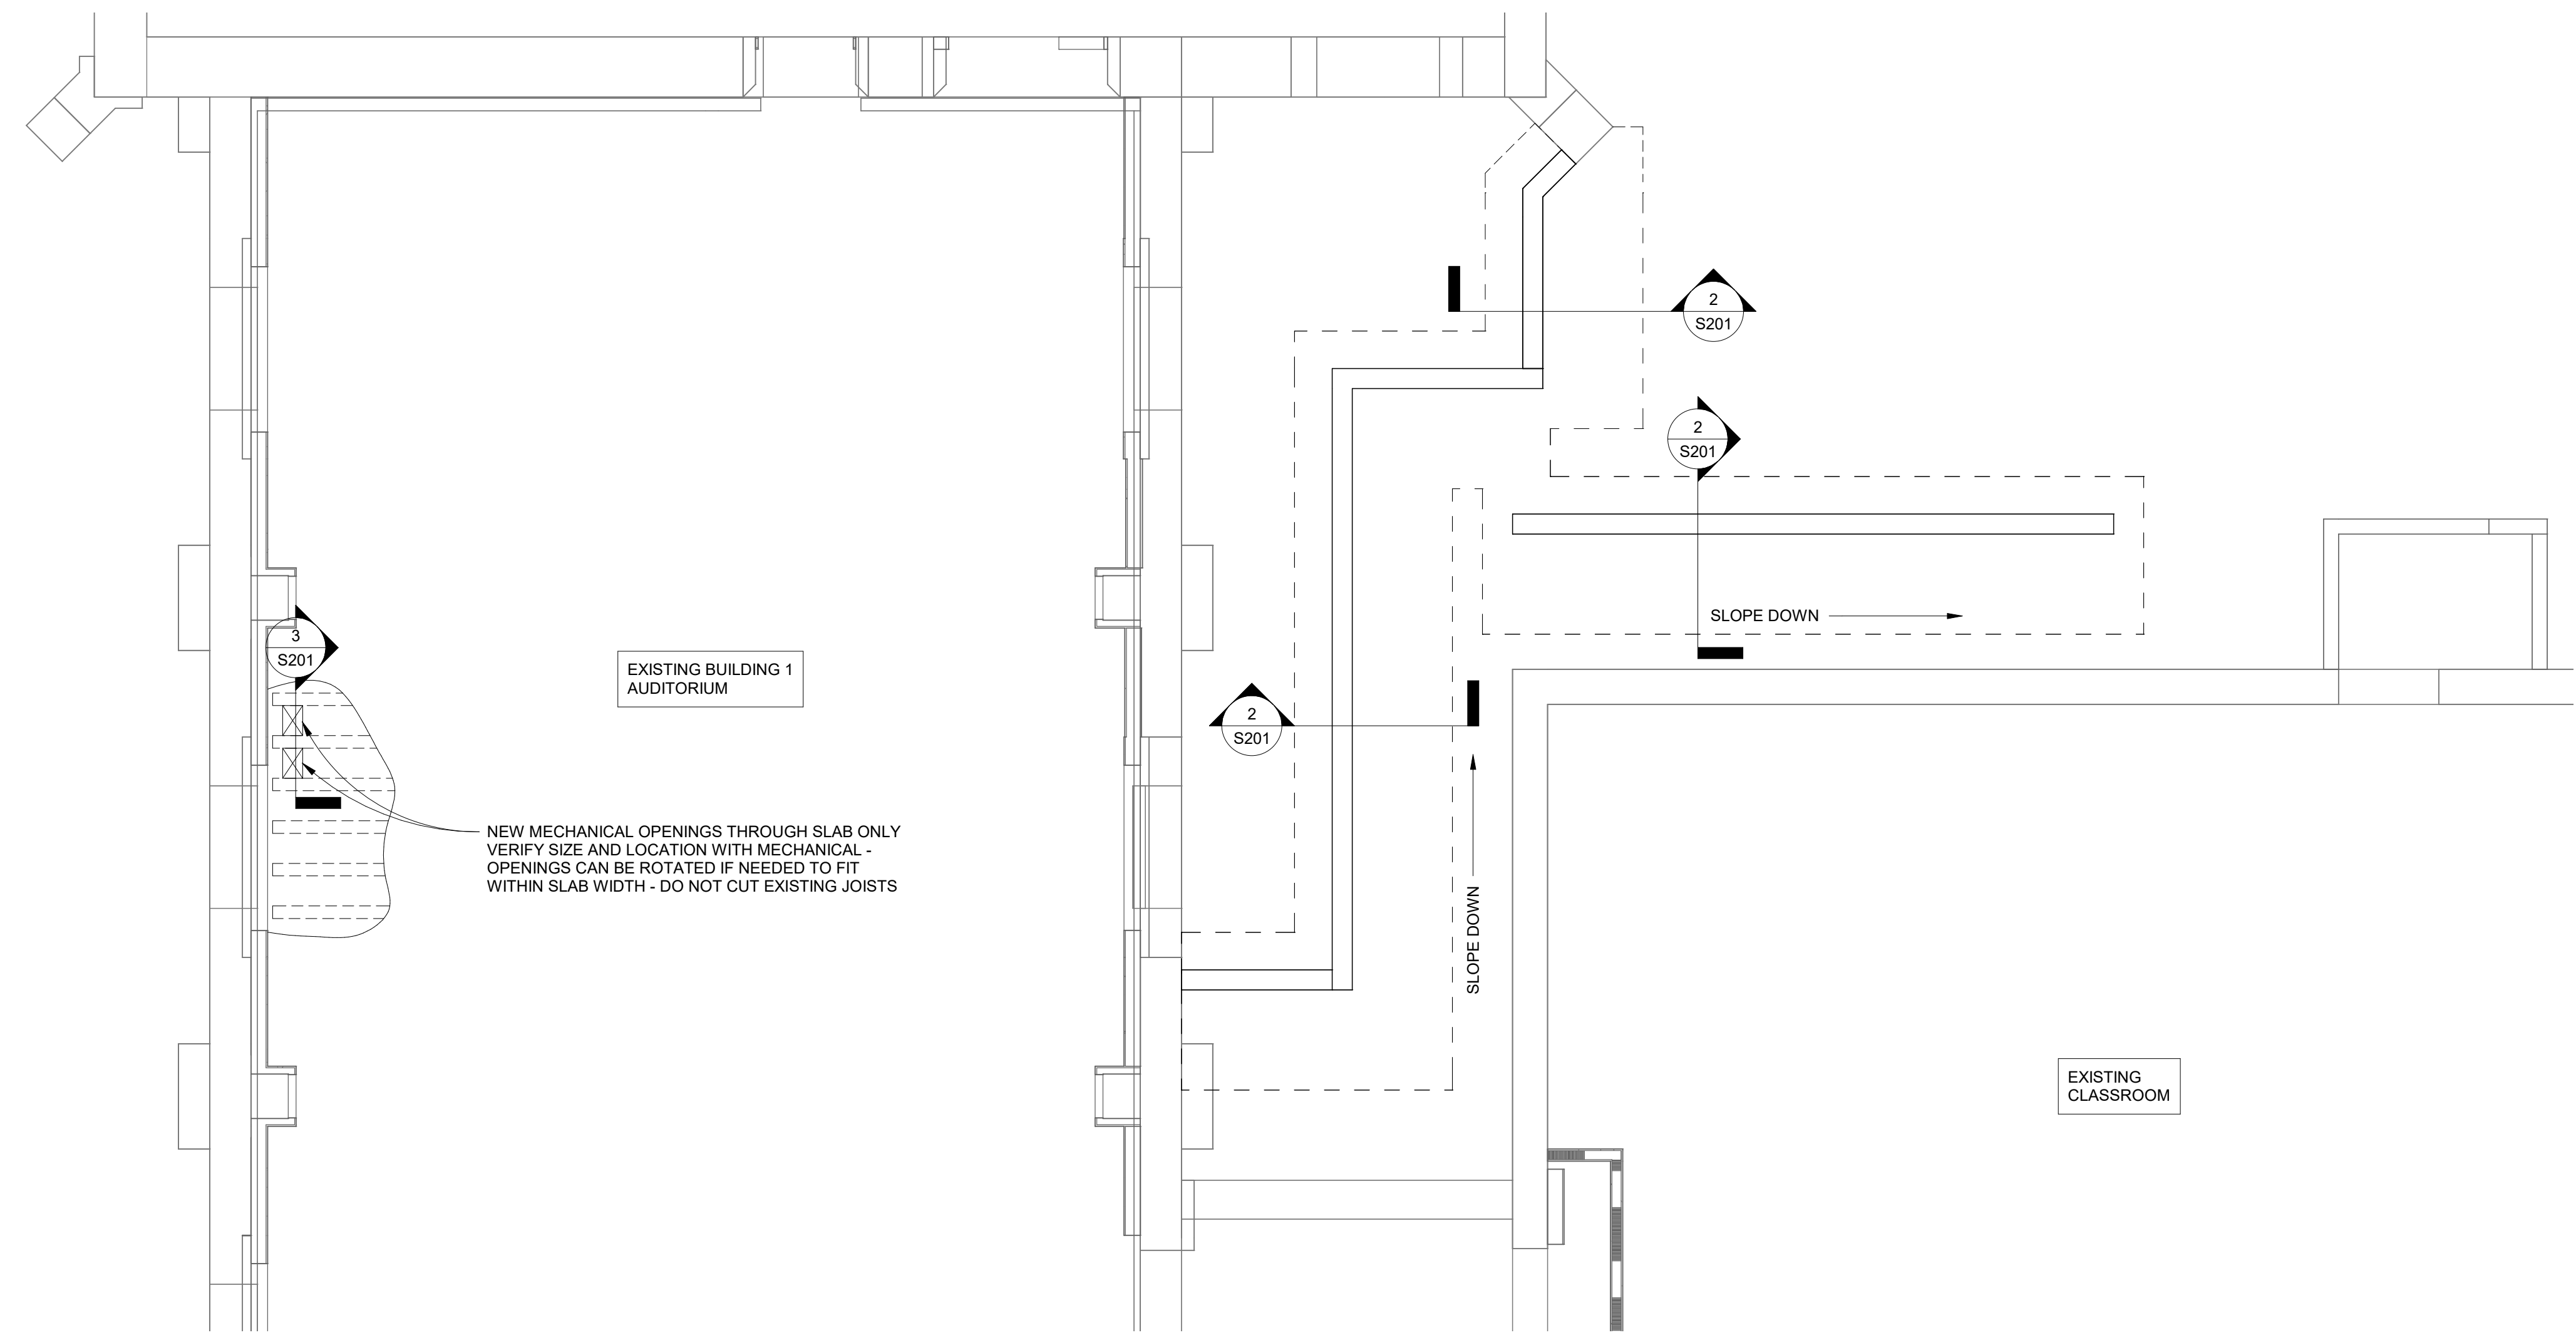
Office of Construction and Facilities Management

U.S. Department of Veterans Affairs

Drawing Title	Project Title
SCHEDULES	RENOVATE OLD CHAPEL AND AUDITORIUM
Approved:	Location
	SIoux FALLS, SD
	Issue Date
	05/15/2020
	Checked
	MAS
	Drawn
	AJM

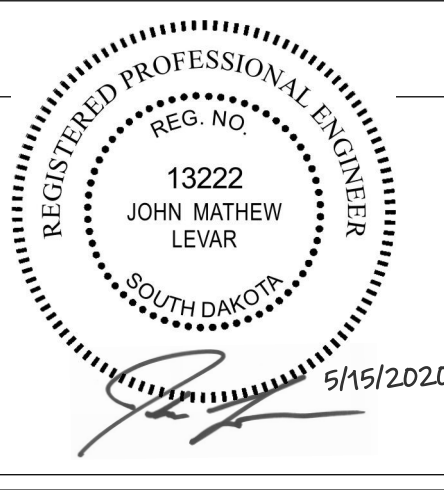Phase	Project Number
CONSTRUCTION DOCUMENTS	SD 1007
FULLY SPRINKLERED	Building Number
	1 and 5
	Drawing Number
	S003

Issue Date	Checked	Drawn
05/15/2020	MAS	AJM



1 PARTIAL EXISTING FOUNDATION/ FIRST FLOOR FRAMING PLAN
1/4" = 1'-0"

- EXISTING FOUNDATION/ FIRST FLOOR FRAMING PLAN NOTES:**
- ALL EXISTING CONDITIONS MUST BE FIELD VERIFIED BY THE CONTRACTOR PRIOR TO CONSTRUCTION. ANY EXISTING CONDITIONS THAT DIFFER FROM THOSE SHOWN ON THE STRUCTURAL DRAWINGS MUST BE BROUGHT TO THE IMMEDIATE ATTENTION OF THE STRUCTURAL ENGINEER (IN WRITING). CONTRACTOR TO ALLOT FOR ADDITIONAL CONSTRUCTION COSTS DUE TO INADEQUATE EXISTING CONDITIONS.
 - THE INFORMATION SHOWN ON THIS DRAWING IS BASED ON THE EXISTING STRUCTURAL DRAWINGS. (DATED MAY 19, 1920)
 - (E) ON PLAN DENOTES EXISTING.
 - CONTRACTOR TO VERIFY ALL NEW ELEMENTS WITH ARCHITECT AND MECHANICAL PRIOR TO CONSTRUCTION. IF ANY DIMENSIONS DO NOT MATCH THOSE SHOWN ON THIS DRAWING, NOTIFY STRUCTURAL ENGINEER IMMEDIATELY IN WRITING.
 - SEE DETAIL 1/S201 FOR EXTERIOR MECHANICAL UNIT CONCRETE PAD DETAIL. VERIFY PAD LOCATION AND DIMENSIONS WITH MECHANICAL/ARCH.

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Revisions:	Date:

CONSULTANT


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ARCHITECT/ENGINEER OF RECORD

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Office of Construction and Facilities Management

U.S. Department of Veterans Affairs

Drawing Title	PATIO FOUNDATION PLAN - BUILDING 1
Approved:	

Phase	CONSTRUCTION DOCUMENTS
	FULLY SPRINKLERED

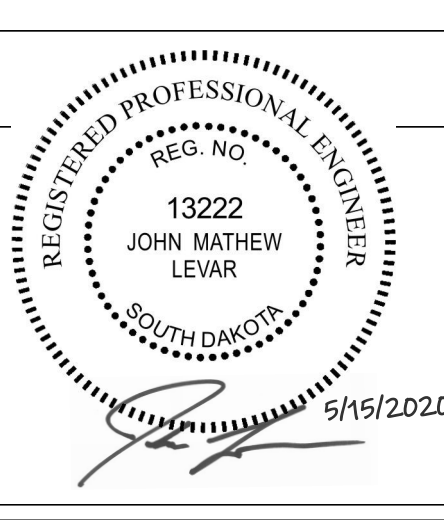Project Title	RENOVATE OLD CHAPEL AND AUDITORIUM
Location	SIoux FALLS, SD
Issue Date	05/15/2020
Checked	MAS
Drawn	AJM

Project Number	SD 1007
Building Number	1 and 5
Drawing Number	S111-01

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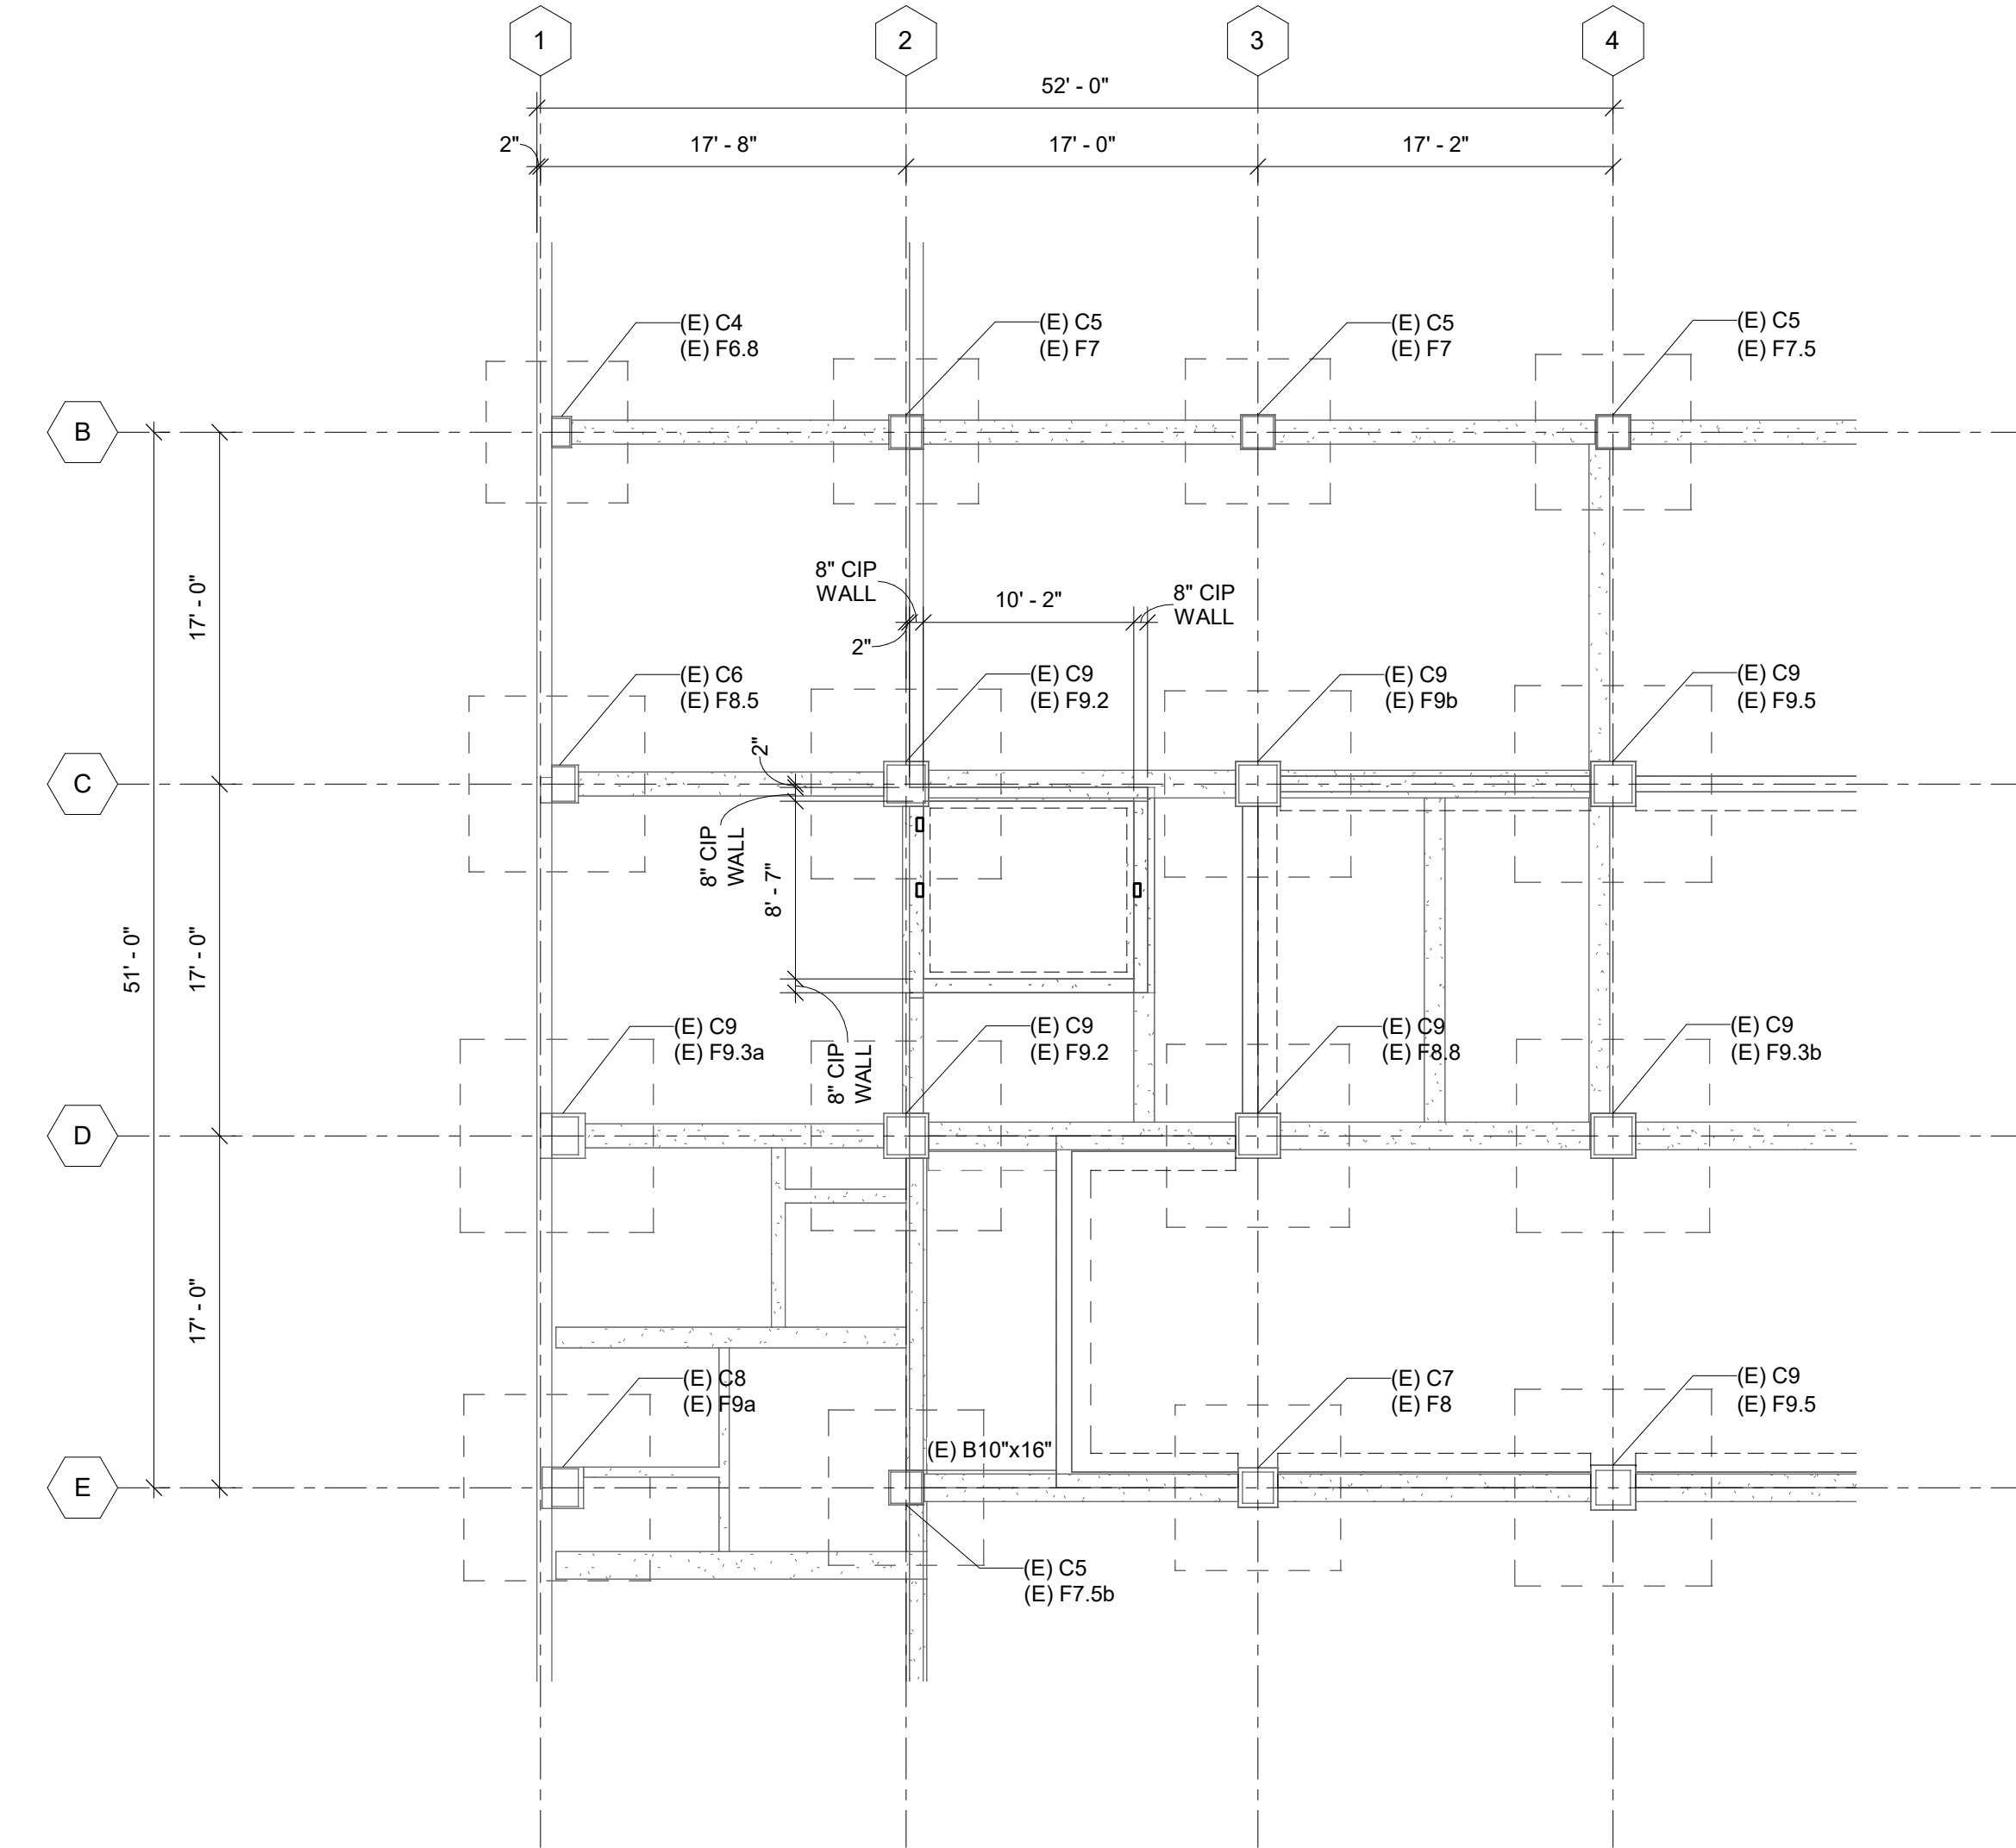
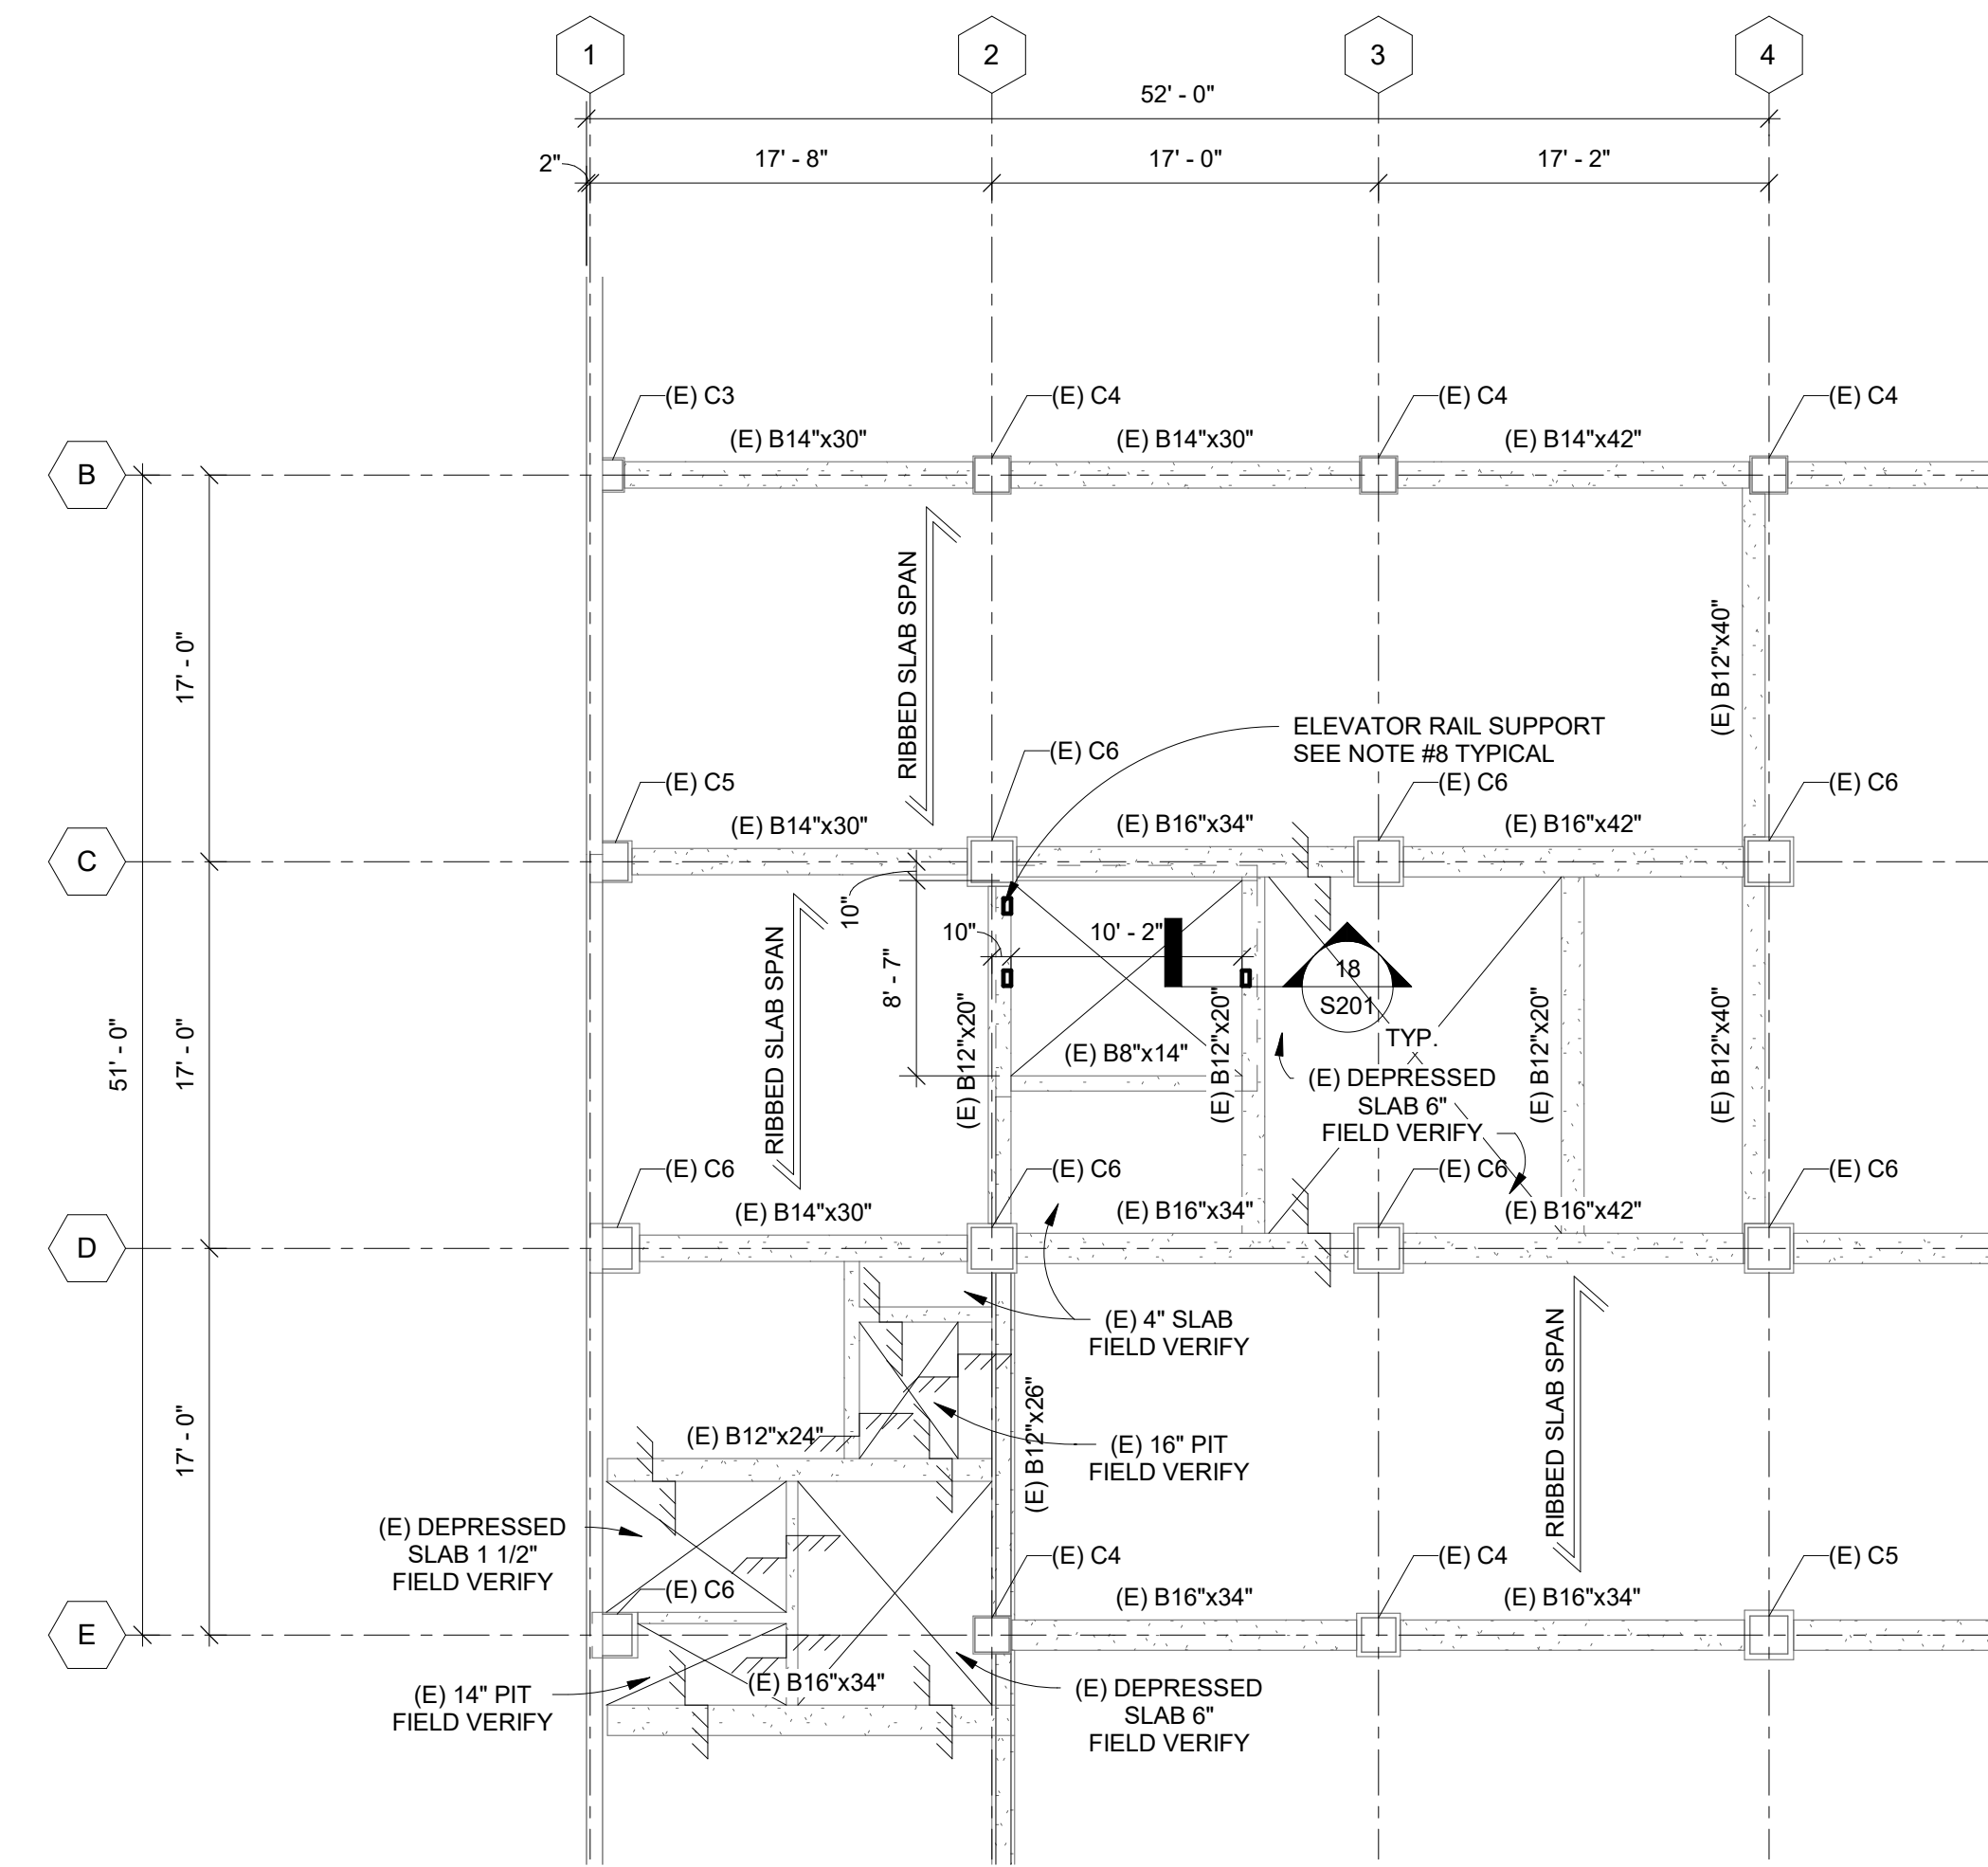
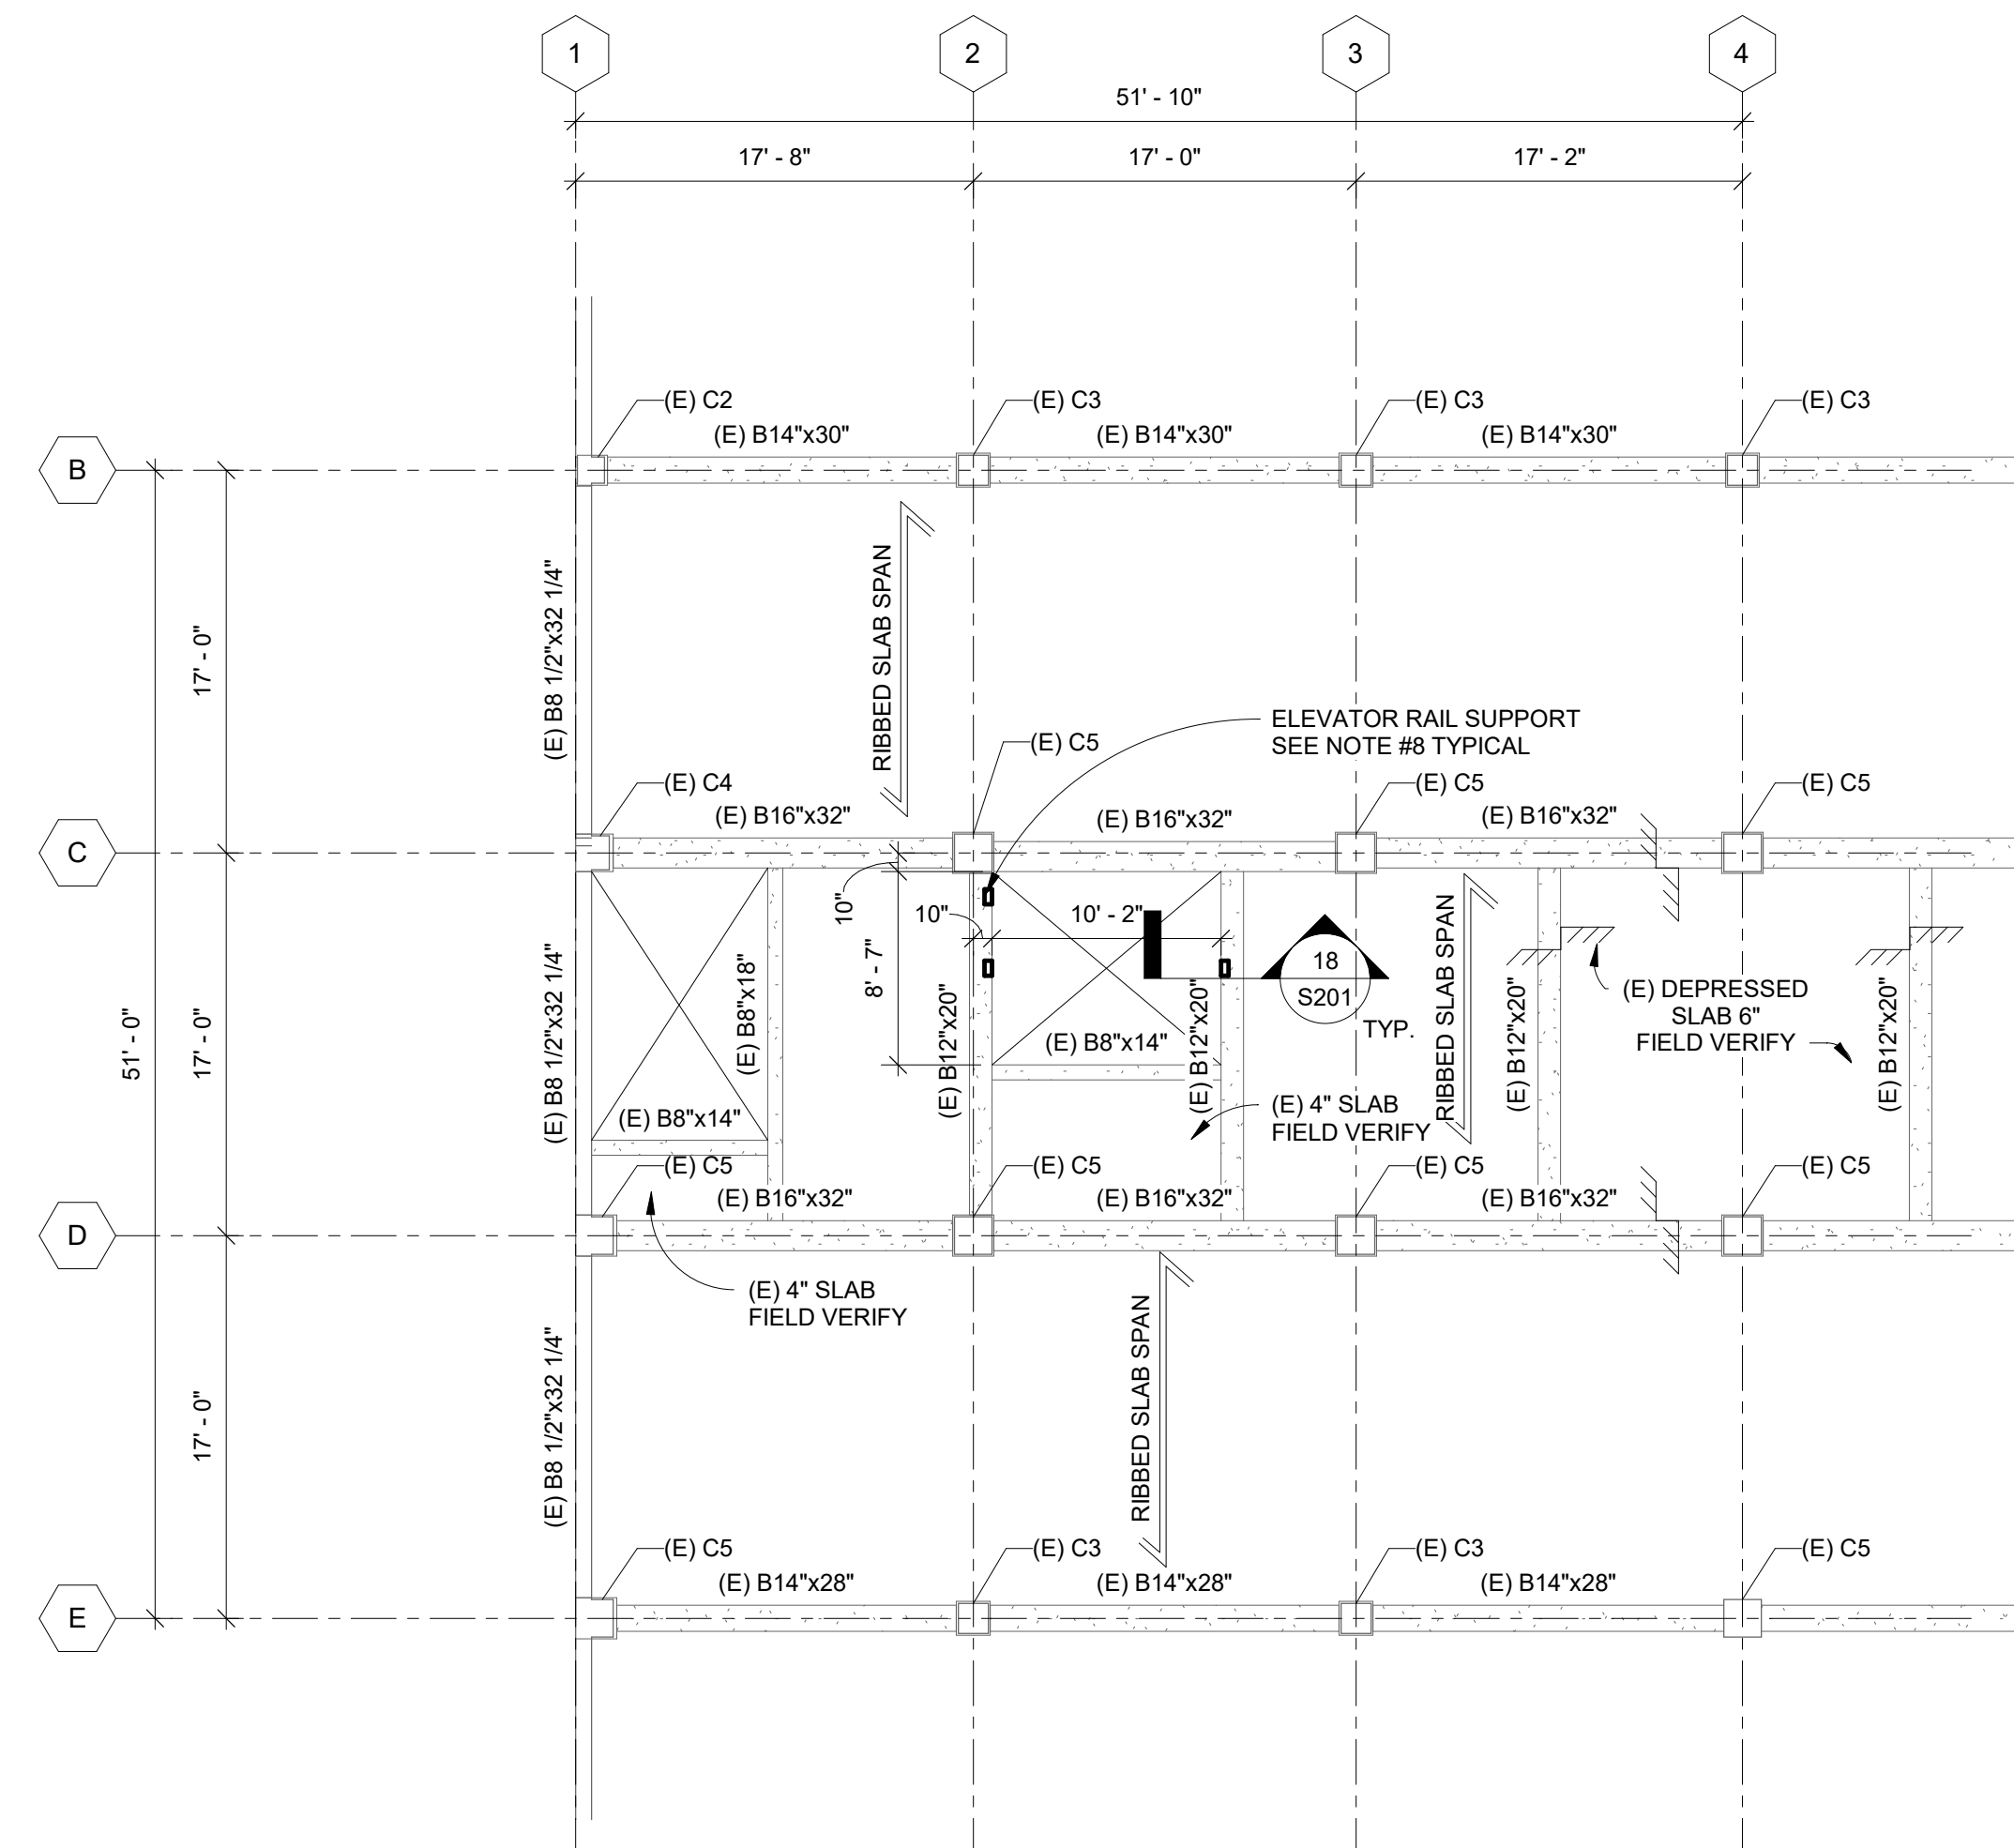
B

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E

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3 PARTIAL EXISTING SECOND FLOOR FRAMING
1/8" = 1'-0"

2 PARTIAL EXISTING FIRST FLOOR FRAMING
1/8" = 1'-0"

1 PARTIAL EXISTING FOUNDATION PLAN
1/8" = 1'-0"

EXISTING SECOND FLOOR PLAN NOTES:

- EXISTING TOP OF SLAB ELEVATION IS 1522.8, FIELD VERIFY.
- EXISTING FLOOR SLAB SYSTEM IS 5"x10" DEEP RIBBED CONCRETE FLOOR SLAB AT 25" OC MAX. WITH 2 1/2" TOPPING, FIELD VERIFY. UNLESS NOTED OTHERWISE ON PLAN.
- ALL EXISTING CONDITIONS MUST BE FIELD VERIFIED BY THE CONTRACTOR PRIOR TO CONSTRUCTION. ANY EXISTING CONDITIONS THAT DIFFER FROM THOSE SHOWN ON THE STRUCTURAL DRAWINGS MUST BE BROUGHT TO THE IMMEDIATE ATTENTION OF THE STRUCTURAL ENGINEER (IN WRITING).
- THE INFORMATION SHOWN ON THIS DRAWING IS BASED ON THE EXISTING STRUCTURAL DRAWINGS. (DATED JULY 15, 1946)
- (E) ON PLAN DENOTES EXISTING.
- CONTRACTOR TO VERIFY ALL NEW ELEMENTS WITH ARCHITECT AND MECHANICAL PRIOR TO CONSTRUCTION. IF ANY DIMENSIONS DO NOT MATCH THOSE SHOWN ON THIS DRAWING, NOTIFY STRUCTURAL ENGINEER IMMEDIATELY IN WRITING.
- ← RIBBED SLAB SPAN → ON PLAN DENOTES EXISTING FLOOR SLAB SPAN DIRECTION.
- PROVIDE HSS 8x4x5/16" VERTICAL ELEVATOR RAIL SUPPORT POSTS AS REQUIRED BY ELEVATOR SUPPLIER. QUANTITY AND LOCATIONS SHOWN ON PLAN ARE APPROXIMATE. VERIFY EXACT LOCATION WITH ELEVATOR SUPPLIER.

EXISTING FIRST FLOOR PLAN NOTES:

- EXISTING TOP OF SLAB ELEVATION IS 1510.9, FIELD VERIFY.
- EXISTING FLOOR SLAB SYSTEM IS 5"x10" DEEP RIBBED CONCRETE FLOOR SLAB AT 25" OC MAX. WITH 2 1/2" TOPPING, FIELD VERIFY. UNLESS NOTED OTHERWISE ON PLAN.
- ALL EXISTING CONDITIONS MUST BE FIELD VERIFIED BY THE CONTRACTOR PRIOR TO CONSTRUCTION. ANY EXISTING CONDITIONS THAT DIFFER FROM THOSE SHOWN ON THE STRUCTURAL DRAWINGS MUST BE BROUGHT TO THE IMMEDIATE ATTENTION OF THE STRUCTURAL ENGINEER (IN WRITING).
- THE INFORMATION SHOWN ON THIS DRAWING IS BASED ON THE EXISTING STRUCTURAL DRAWINGS. (DATED JULY 15, 1946)
- (E) ON PLAN DENOTES EXISTING.
- CONTRACTOR TO VERIFY ALL NEW ELEMENTS WITH ARCHITECT AND MECHANICAL PRIOR TO CONSTRUCTION. IF ANY DIMENSIONS DO NOT MATCH THOSE SHOWN ON THIS DRAWING, NOTIFY STRUCTURAL ENGINEER IMMEDIATELY IN WRITING.
- ← RIBBED SLAB SPAN → ON PLAN DENOTES EXISTING FLOOR SLAB SPAN DIRECTION.
- PROVIDE HSS 8x4x5/16" VERTICAL ELEVATOR RAIL SUPPORT POSTS AS REQUIRED BY ELEVATOR SUPPLIER. QUANTITY AND LOCATIONS SHOWN ON PLAN ARE APPROXIMATE. VERIFY EXACT LOCATION WITH ELEVATOR SUPPLIER.

EXISTING FOUNDATION PLAN NOTES:

- EXISTING TOP OF SLAB ELEVATION IS 1498.98, FIELD VERIFY.
- EXISTING FLOOR SLAB SYSTEM IS 5" CONCRETE SLAB WITH 1" FINISH, FIELD VERIFY. UNLESS NOTED OTHERWISE ON PLAN.
- ALL EXISTING CONDITIONS MUST BE FIELD VERIFIED BY THE CONTRACTOR PRIOR TO CONSTRUCTION. ANY EXISTING CONDITIONS THAT DIFFER FROM THOSE SHOWN ON THE STRUCTURAL DRAWINGS MUST BE BROUGHT TO THE IMMEDIATE ATTENTION OF THE STRUCTURAL ENGINEER (IN WRITING).
- THE INFORMATION SHOWN ON THIS DRAWING IS BASED ON THE EXISTING STRUCTURAL DRAWINGS. (DATED JULY 15, 1946)
- (E) ON PLAN DENOTES EXISTING.
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Revisions:	Date:

CONSULTANT

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AST PROJECT NUMBER: SD 1007

ARCHITECT/ENGINEER OF RECORD

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Office of Construction and Facilities Management
VA U.S. Department of Veterans Affairs

Drawing Title
EXISTING PARTIAL FOUNDATION, FIRST AND SECOND FLOOR PLAN - BUILDING 5

Approved: _____

Phase
CONSTRUCTION DOCUMENTS

FULLY SPRINKLERED

Project Title
RENOVATE OLD CHAPEL AND AUDITORIUM

Location
SIOUX FALLS, SD

Issue Date
05/15/2020



Checked
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Drawn
AJM

Project Number
SD 1007


Building Number
1 and 5

Drawing Number
S111-05

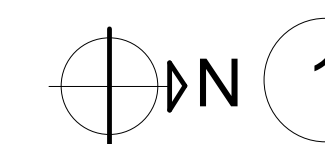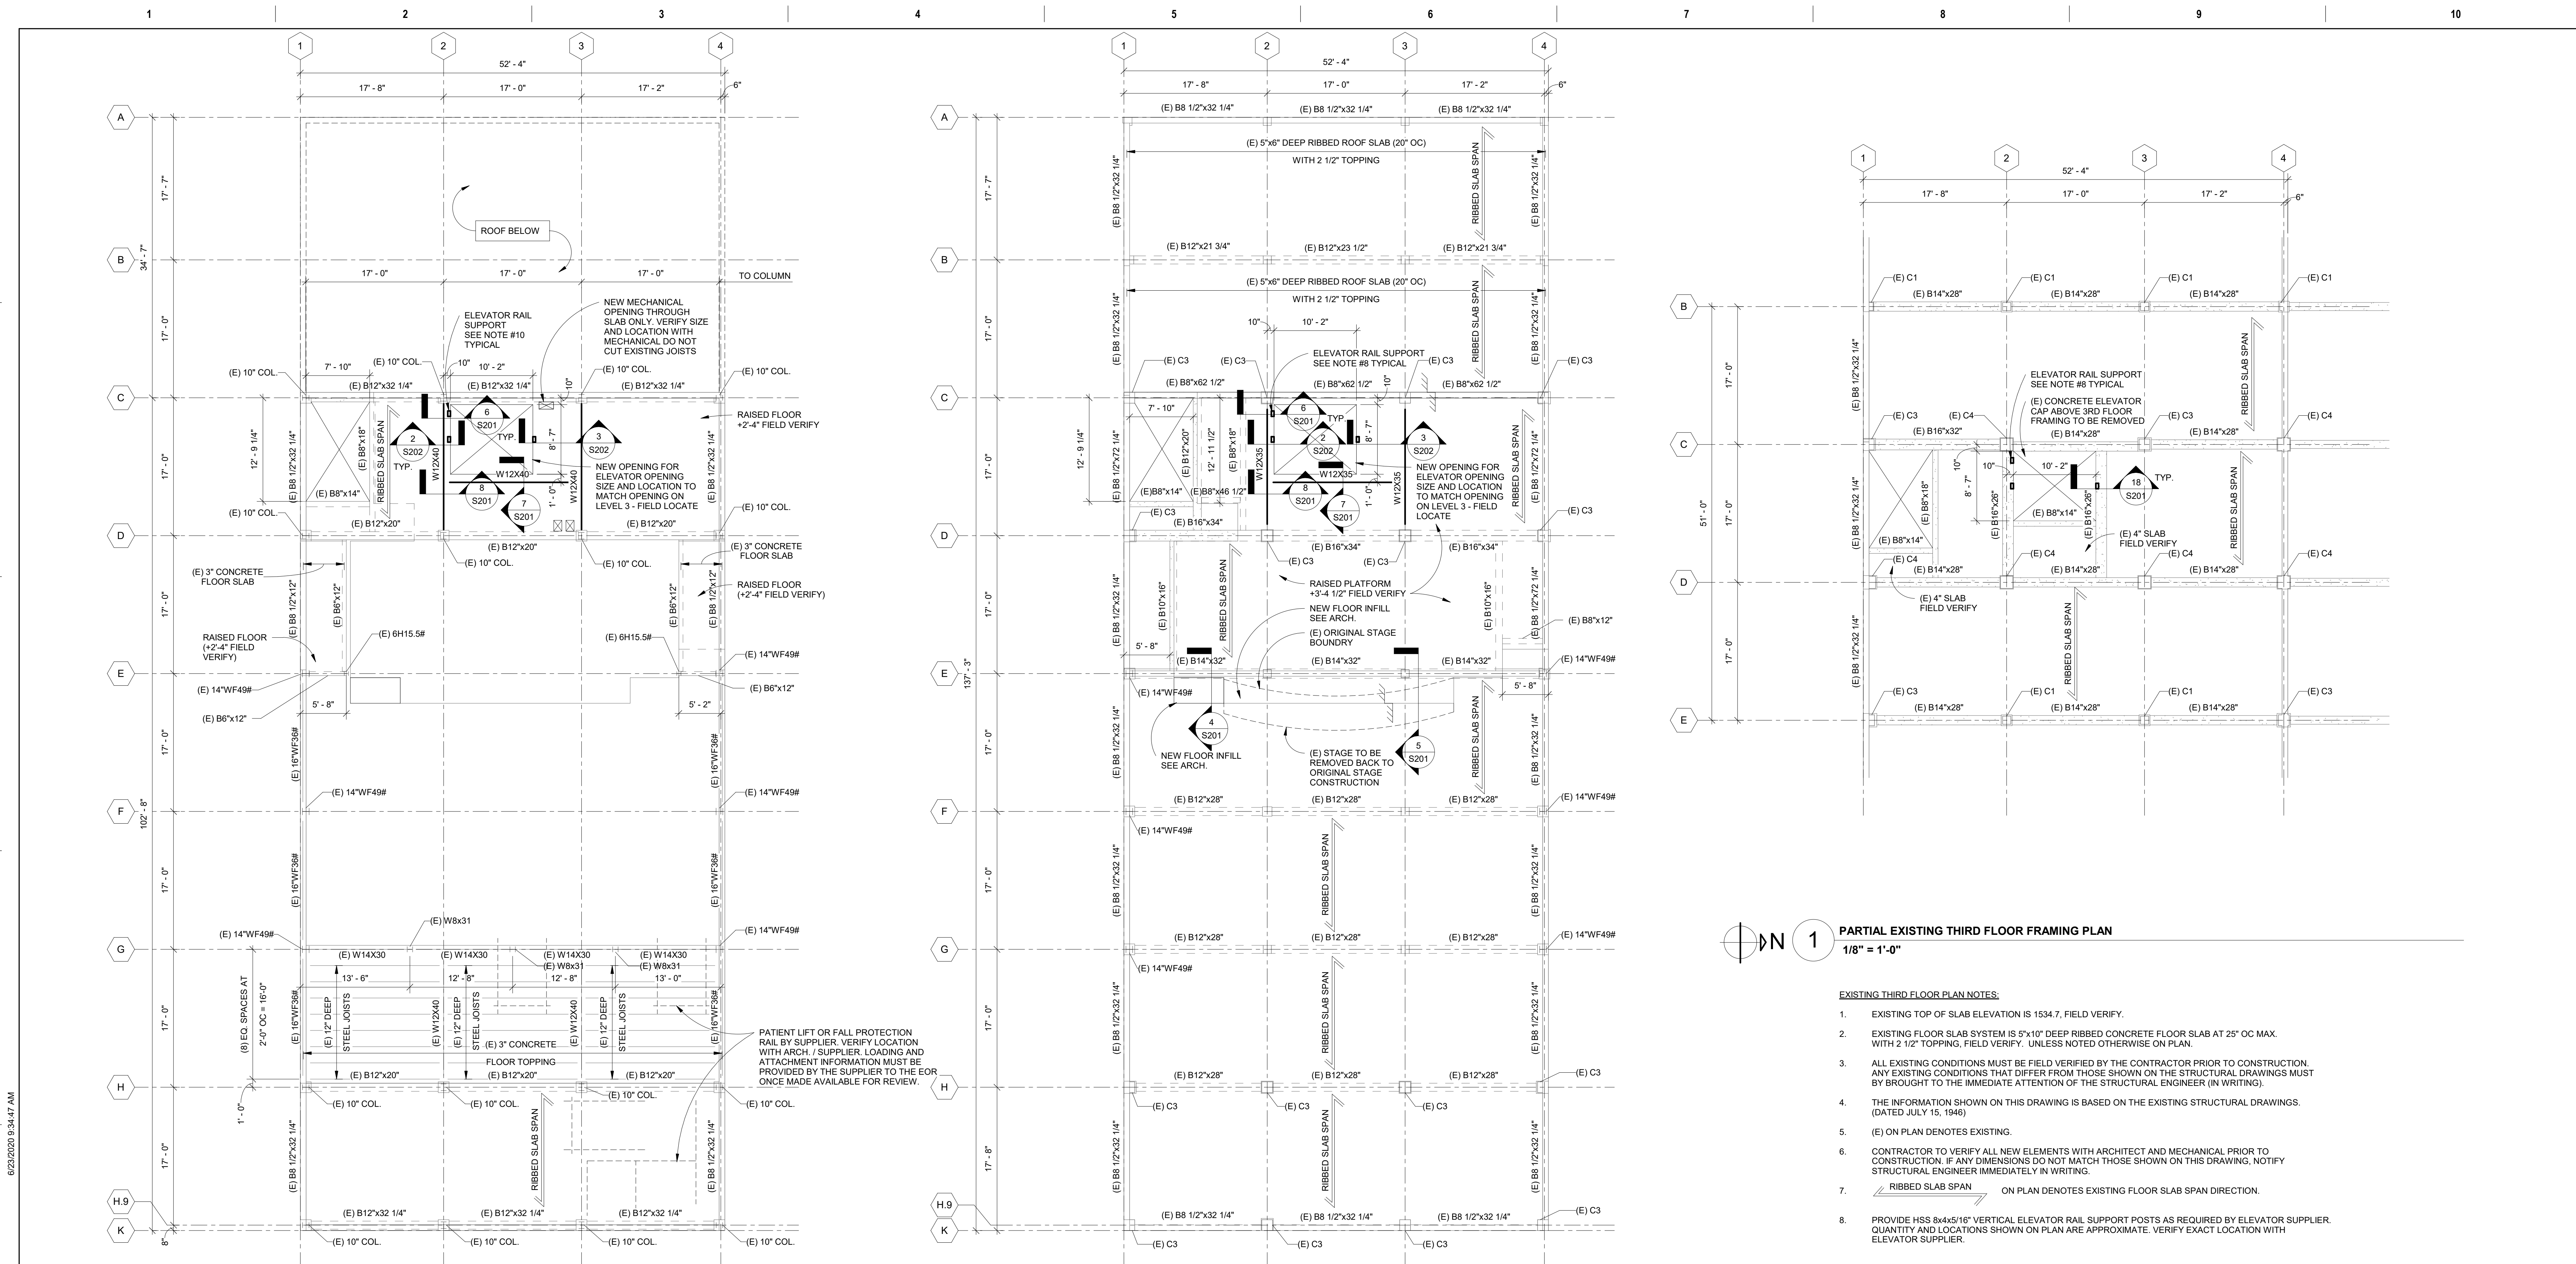


1 PARTIAL EXISTING THIRD FLOOR FRAMING PLAN
1/8" = 1'-0"

- EXISTING THIRD FLOOR PLAN NOTES:**
- EXISTING TOP OF SLAB ELEVATION IS 1534.7, FIELD VERIFY.
 - EXISTING FLOOR SLAB SYSTEM IS 5"x10" DEEP RIBBED CONCRETE FLOOR SLAB AT 25" OC MAX. WITH 2 1/2" TOPPING, FIELD VERIFY. UNLESS NOTED OTHERWISE ON PLAN.
 - ALL EXISTING CONDITIONS MUST BE FIELD VERIFIED BY THE CONTRACTOR PRIOR TO CONSTRUCTION. ANY EXISTING CONDITIONS THAT DIFFER FROM THOSE SHOWN ON THE STRUCTURAL DRAWINGS MUST BE BROUGHT TO THE IMMEDIATE ATTENTION OF THE STRUCTURAL ENGINEER (IN WRITING).
 - THE INFORMATION SHOWN ON THIS DRAWING IS BASED ON THE EXISTING STRUCTURAL DRAWINGS. (DATED JULY 15, 1946)
 - (E) ON PLAN DENOTES EXISTING.
 - CONTRACTOR TO VERIFY ALL NEW ELEMENTS WITH ARCHITECT AND MECHANICAL PRIOR TO CONSTRUCTION. IF ANY DIMENSIONS DO NOT MATCH THOSE SHOWN ON THIS DRAWING, NOTIFY STRUCTURAL ENGINEER IMMEDIATELY IN WRITING.
 - ON PLAN DENOTES EXISTING FLOOR SLAB SPAN DIRECTION.
 - PROVIDE HSS 8x4x5/16" VERTICAL ELEVATOR RAIL SUPPORT POSTS AS REQUIRED BY ELEVATOR SUPPLIER. QUANTITY AND LOCATIONS SHOWN ON PLAN ARE APPROXIMATE. VERIFY EXACT LOCATION WITH ELEVATOR SUPPLIER.

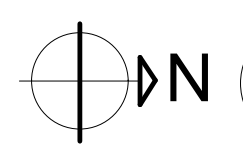

3 EXISTING FIFTH FLOOR - BUILDING 5
1/8" = 1'-0"

- EXISTING FIFTH FLOOR PLAN NOTES:**
- EXISTING TOP OF SLAB ELEVATION IS 1558.6, FIELD VERIFY.
 - EXISTING FLOOR SLAB SYSTEM IS 5"x10" DEEP RIBBED CONCRETE FLOOR SLAB AT 25" OC MAX. WITH 2 1/2" TOPPING, FIELD VERIFY. U.N.O.
 - ALL EXISTING CONDITIONS MUST BE FIELD VERIFIED BY THE CONTRACTOR PRIOR TO CONSTRUCTION. ANY EXISTING CONDITIONS THAT DIFFER FROM THOSE SHOWN ON THE STRUCTURAL DRAWINGS MUST BE BROUGHT TO THE IMMEDIATE ATTENTION OF THE STRUCTURAL ENGINEER (IN WRITING).
 - THE INFORMATION SHOWN ON THIS DRAWING IS BASED ON THE EXISTING STRUCTURAL DRAWINGS. (DATED JULY 15, 1946 AND MAY 29, 1984)
 - (E) ON PLAN DENOTES EXISTING.
 - CONTRACTOR TO VERIFY ALL NEW ELEMENTS WITH ARCHITECT AND MECHANICAL PRIOR TO CONSTRUCTION. IF ANY DIMENSIONS DO NOT MATCH THOSE SHOWN ON THIS DRAWING, NOTIFY STRUCTURAL ENGINEER IMMEDIATELY IN WRITING.
 - ON PLAN DENOTES EXISTING FLOOR SLAB SPAN DIRECTION.
 - SEE MECHANICAL DRAWINGS FOR SIZE AND LOCATION OF EXISTING FLOOR OPENINGS TO BE FILLED SEE DETAIL 13/S201.
 - SEE DETAILS 14, 15, 16 AND 17/S201 FOR ADDED SUPPORT FOR PATIENT LIFTS AND FALL PROTECTION RAILS. VERIFY LOCATION AND LOAD REQUIREMENTS WITH THE SUPPLIER/ARCH.
 - PROVIDE HSS 8x4x5/16" VERTICAL ELEVATOR RAIL SUPPORT POSTS AS REQUIRED BY ELEVATOR SUPPLIER. QUANTITY AND LOCATIONS SHOWN ON PLAN ARE APPROXIMATE. VERIFY EXACT LOCATION WITH ELEVATOR SUPPLIER.
 - SPRINKLER MAIN LOCATIONS, INSERVICE WEIGHTS OF LINES AND HANGER SPACING MUST BE PROVIDED TO SEOR DURING SHOP DRAWING REVIEW FOR APPROVAL.

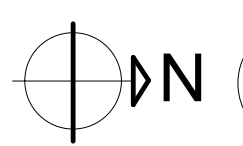

2 EXISTING FOURTH FLOOR - BUILDING 5
1/8" = 1'-0"

- EXISTING FOURTH FLOOR PLAN NOTES:**
- EXISTING TOP OF SLAB ELEVATION IS 1546.7, FIELD VERIFY.
 - EXISTING FLOOR SLAB SYSTEM IS 5"x8" DEEP RIBBED CONCRETE FLOOR SLAB AT 25" OC MAX. WITH 2 1/2" TOPPING, FIELD VERIFY. UNLESS NOTED OTHERWISE ON PLAN.
 - ALL EXISTING CONDITIONS MUST BE FIELD VERIFIED BY THE CONTRACTOR PRIOR TO CONSTRUCTION. ANY EXISTING CONDITIONS THAT DIFFER FROM THOSE SHOWN ON THE STRUCTURAL DRAWINGS MUST BE BROUGHT TO THE IMMEDIATE ATTENTION OF THE STRUCTURAL ENGINEER (IN WRITING).
 - THE INFORMATION SHOWN ON THIS DRAWING IS BASED ON THE EXISTING STRUCTURAL DRAWINGS. (DATED JULY 15, 1946)
 - (E) ON PLAN DENOTES EXISTING.
 - CONTRACTOR TO VERIFY ALL NEW ELEMENTS WITH ARCHITECT AND MECHANICAL PRIOR TO CONSTRUCTION. IF ANY DIMENSIONS DO NOT MATCH THOSE SHOWN ON THIS DRAWING, NOTIFY STRUCTURAL ENGINEER IMMEDIATELY IN WRITING.
 - ON PLAN DENOTES EXISTING FLOOR SLAB SPAN DIRECTION.
 - PROVIDE HSS 8x4x5/16" VERTICAL ELEVATOR RAIL SUPPORT POSTS AS REQUIRED BY ELEVATOR SUPPLIER. QUANTITY AND LOCATIONS SHOWN ON PLAN ARE APPROXIMATE. VERIFY EXACT LOCATION WITH ELEVATOR SUPPLIER.

Revisions:	Date:

CONSULTANT


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EDINA, MN 55439 ASTENG.COM

AST PROJECT NUMBER: SD 1007

ARCHITECT/ENGINEER OF RECORD

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Anderson Engineering of Minnesota, LLC | Proj # SD 1007

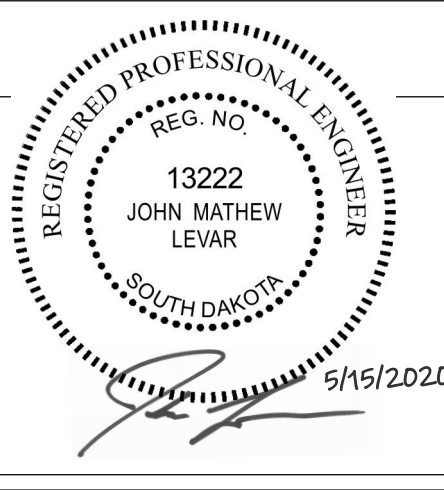

Office of Construction and Facilities Management

U.S. Department of Veterans Affairs

Drawing Title
EXISTING THIRD, FOURTH & FIFTH FLOORS - BUILDING 5

Approved: _____

Phase
CONSTRUCTION DOCUMENTS

FULLY SPRINKLERED

Project Title RENOVATE OLD CHAPEL AND AUDITORIUM			Project Number SD 1007
Location SIOUX FALLS, SD			Building Number 1 and 5
Issue Date 05/15/2020	Checked MAS	Drawn AJM	Drawing Number S131-05

A


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1 EXISTING ROOF FRAMING PLAN
1/8" = 1'-0"

- EXISTING FIFTH FLOOR PLAN NOTES:**
- ALL EXISTING CONDITIONS MUST BE FIELD VERIFIED BY THE CONTRACTOR PRIOR TO CONSTRUCTION. ANY EXISTING CONDITIONS THAT DIFFER FROM THOSE SHOWN ON THE STRUCTURAL DRAWINGS MUST BE BROUGHT TO THE IMMEDIATE ATTENTION OF THE STRUCTURAL ENGINEER (IN WRITING).
 - THE INFORMATION SHOWN ON THIS DRAWING IS BASED ON THE EXISTING STRUCTURAL DRAWINGS. (DATED JULY 15, 1946)
 - (E) ON PLAN DENOTES EXISTING.
 - CONTRACTOR TO VERIFY ALL NEW ELEMENTS WITH ARCHITECT AND MECHANICAL PRIOR TO CONSTRUCTION. IF ANY DIMENSIONS DO NOT MATCH THOSE SHOWN ON THIS DRAWING, NOTIFY STRUCTURAL ENGINEER IMMEDIATELY IN WRITING.
 - PROVIDE HSS 8x4x5/16" VERTICAL ELEVATOR RAIL SUPPORT POSTS AS REQUIRED BY ELEVATOR SUPPLIER. QUANTITY AND LOCATIONS SHOWN ON PLAN ARE APPROXIMATE. VERIFY EXACT LOCATION WITH ELEVATOR SUPPLIER.
 - SEE DETAIL 4/S202 FOR ROOF OPENING SUPPORT FOR NEW MECHANICAL OPENINGS. VERIFY SIZE AND LOCATIONS OF OPENINGS WITH MECHANICAL.

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Revisions:	Date:

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ARCHITECT/ENGINEER OF RECORD

13605 1st Ave. N. #100 Plymouth, MN 55441 P 763.412.4000 | F 763.412.4090 | ae-mn.com Anderson Engineering of Minnesota, LLC | Proj # SD 1007

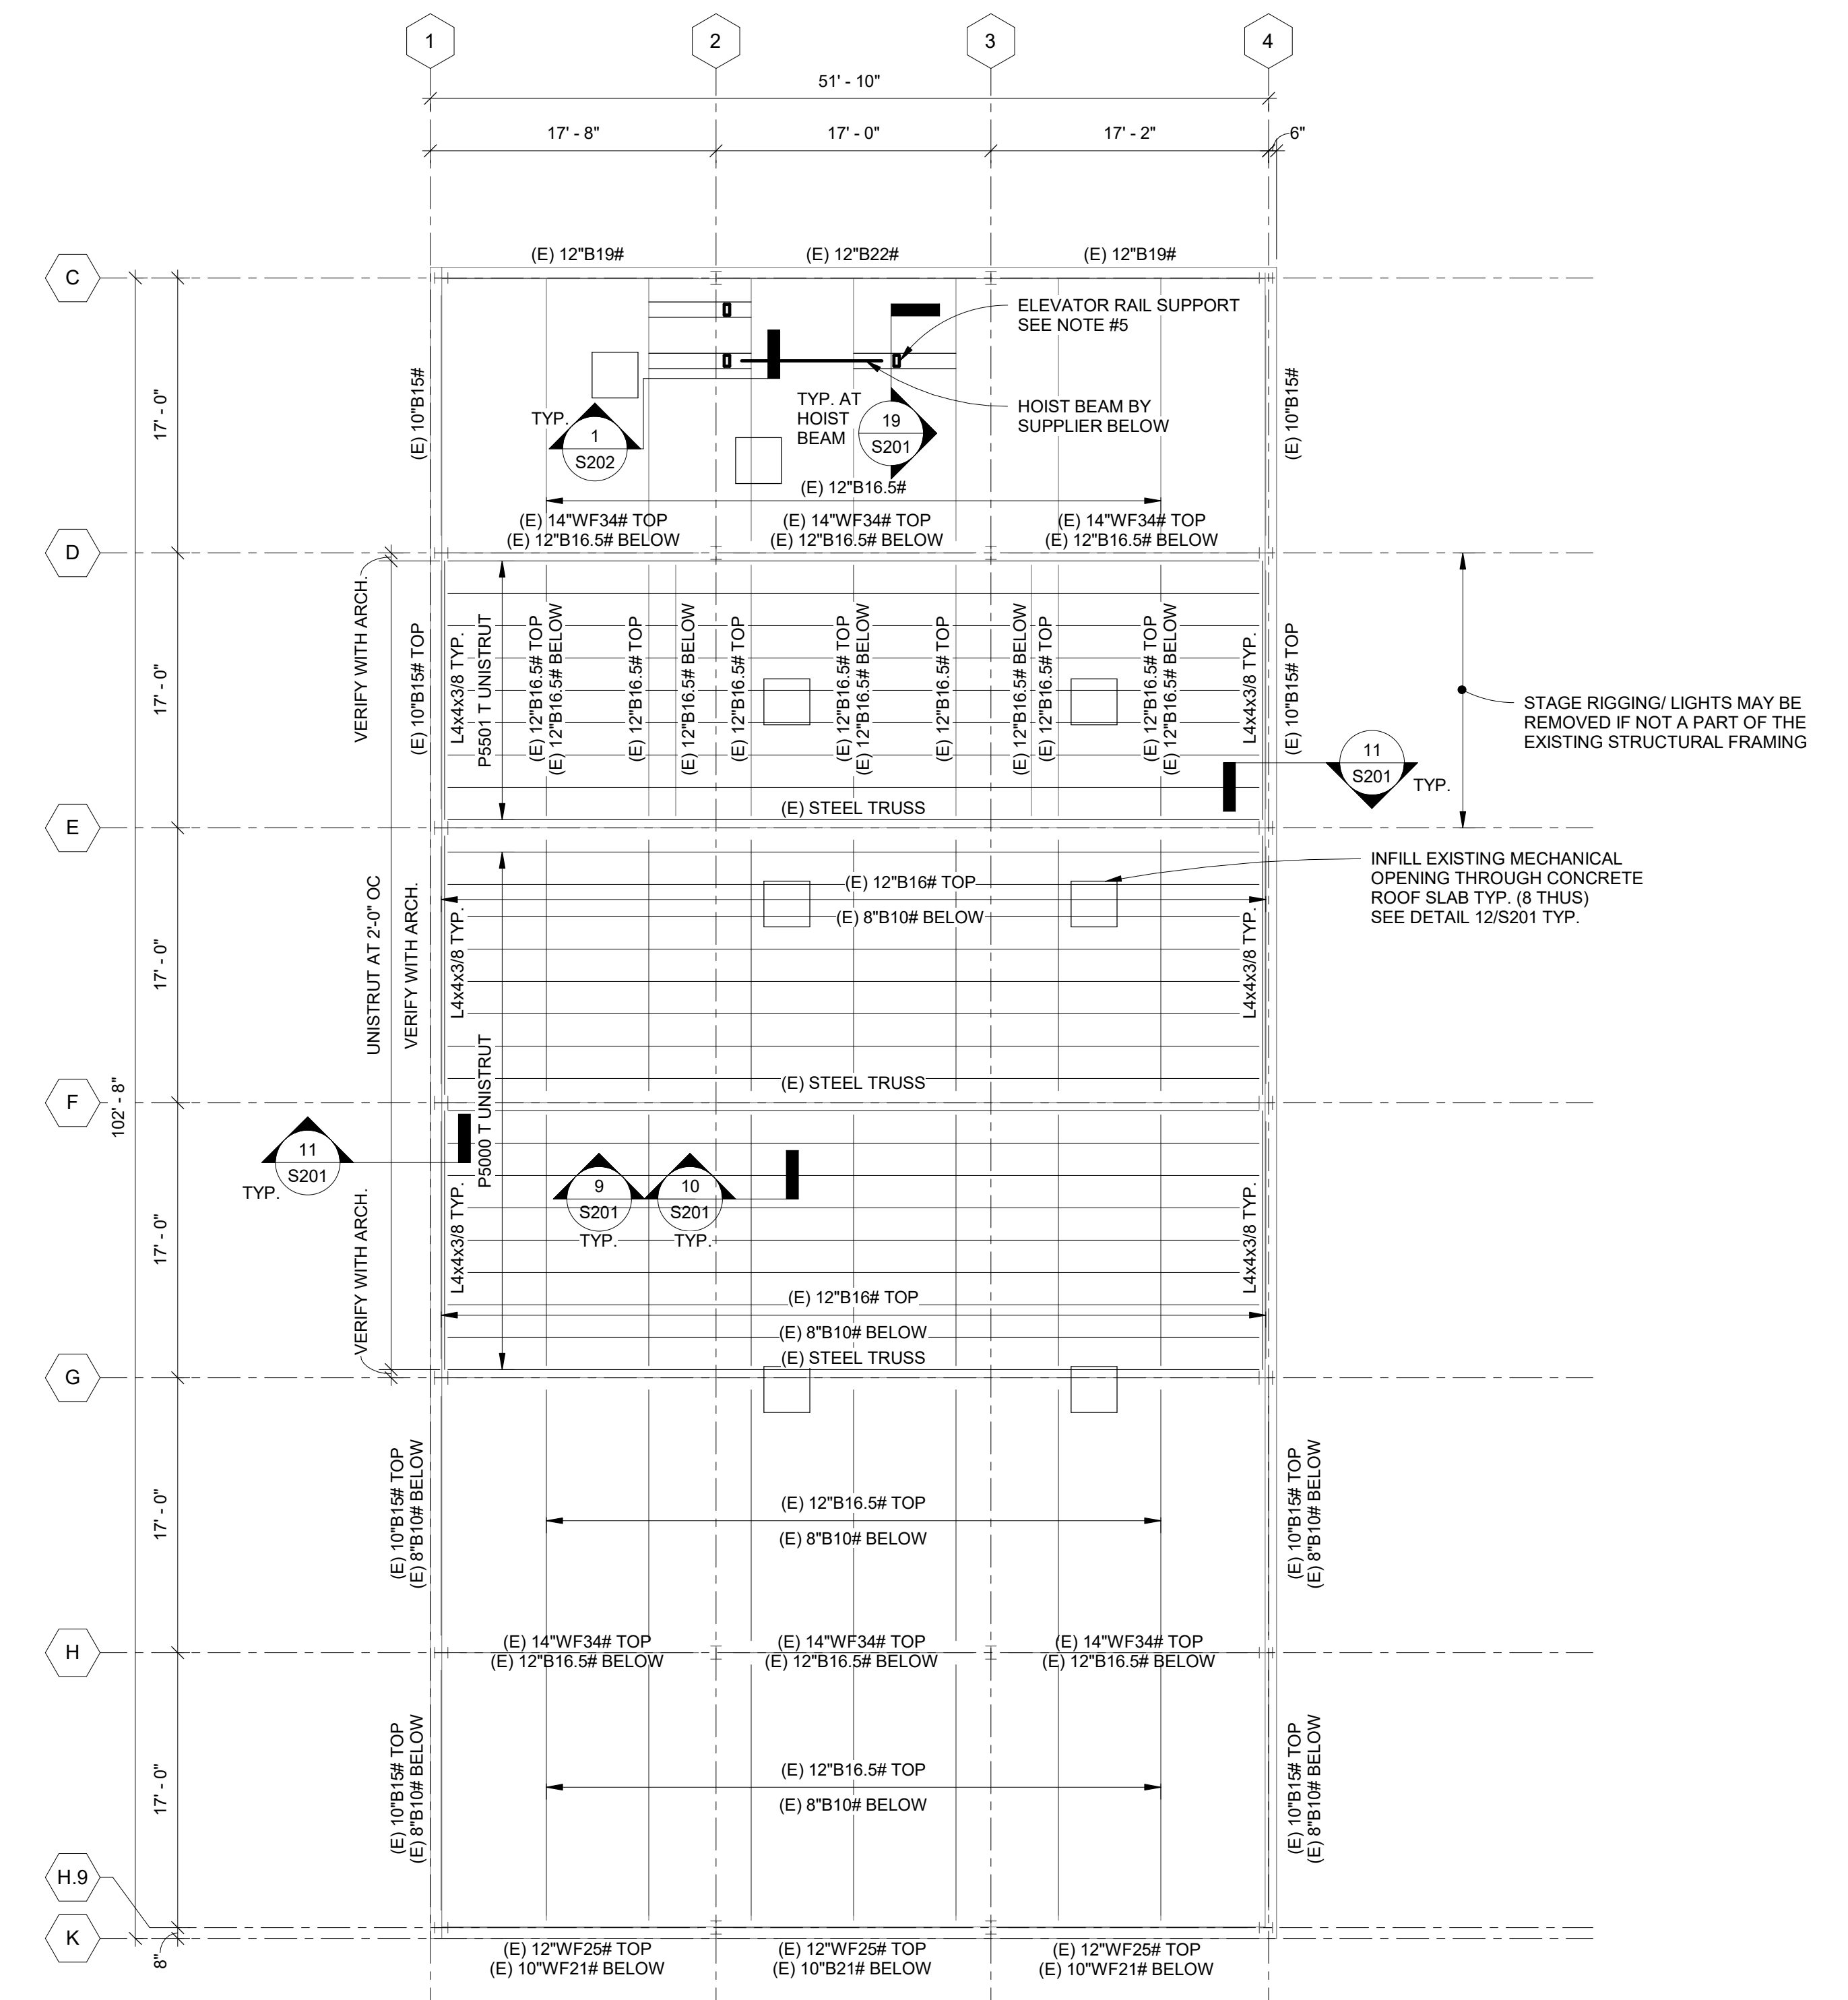Office of Construction and Facilities Management

U.S. Department of Veterans Affairs

Drawing Title
EXISTING ROOF FRAMING PLAN - BUILDING 5

Approved:

Phase
CONSTRUCTION DOCUMENTS

FULLY SPRINKLERED

Project Title
RENOVATE OLD CHAPEL AND AUDITORIUM

Location
SIoux FALLS, SD

Issue Date
05/15/2020

Checked
MAS

Drawn
AJM

Project Number
SD 1007


Building Number
1 and 5

Drawing Number
S161-05


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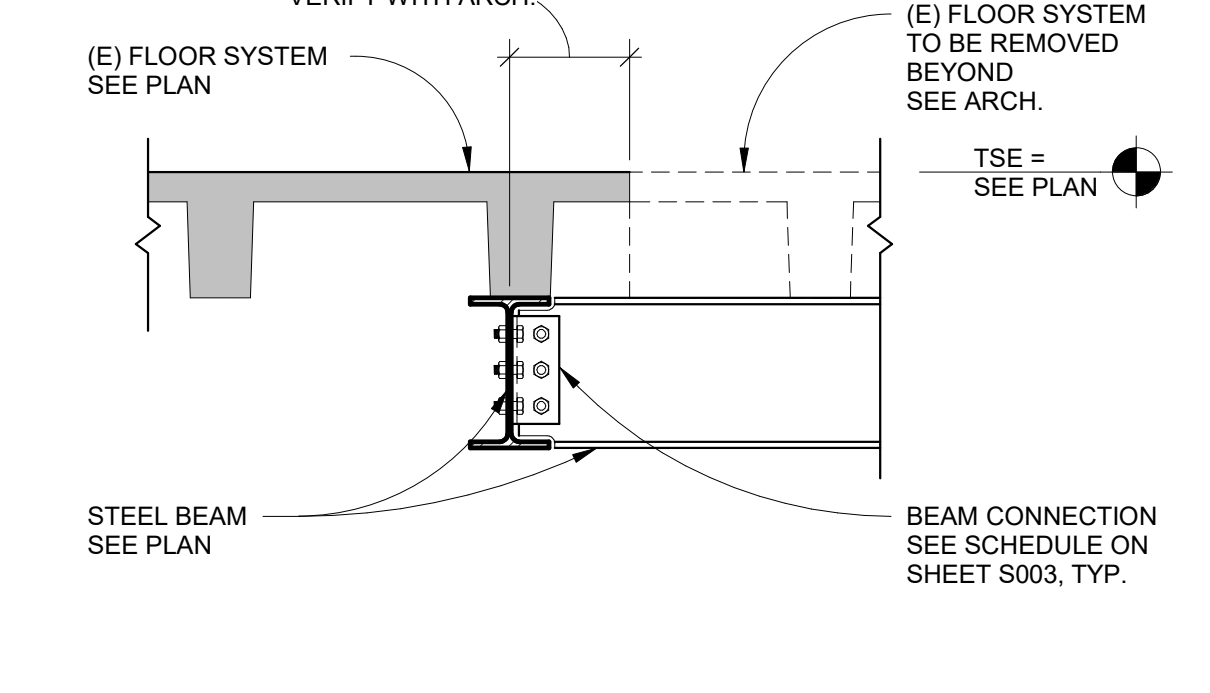
16 DETAIL - PATIENT LIFT / FALL PROTECTION SUPPORT
3/4" = 1'-0"




12 DETAIL - SLAB INFILL AT ROOF
3/4" = 1'-0"

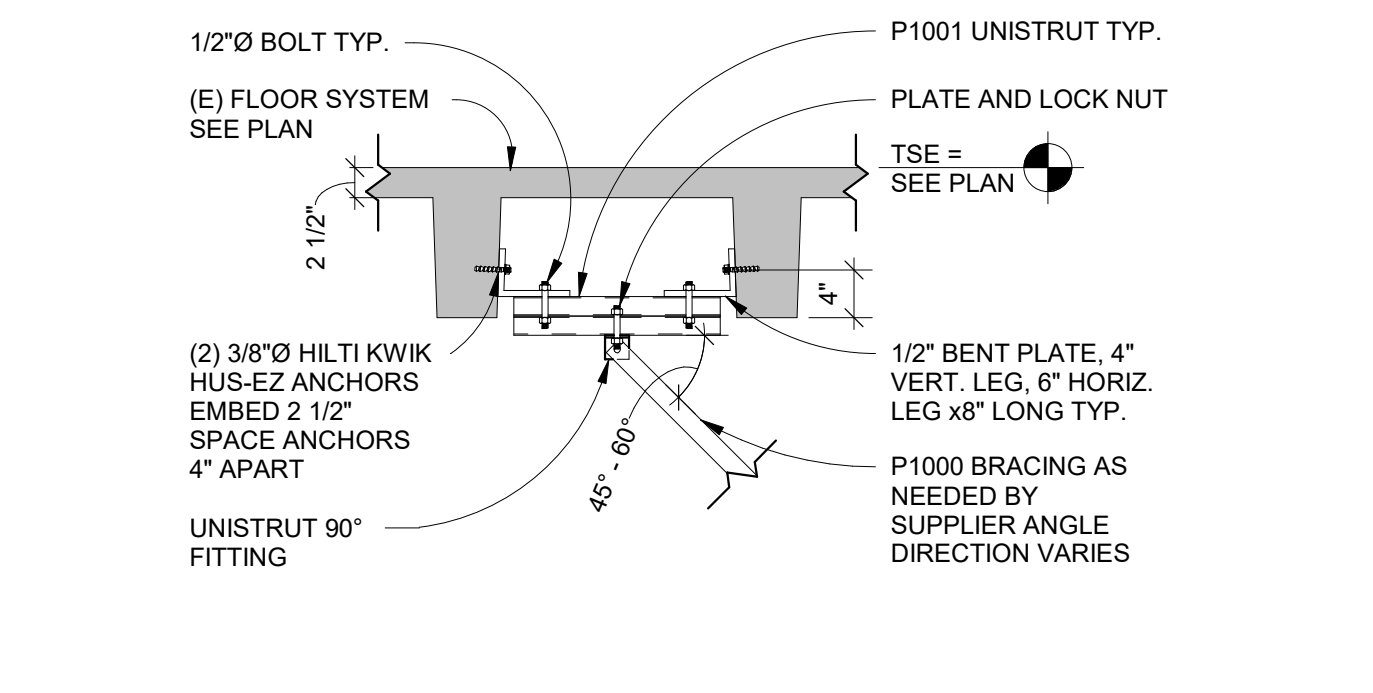


8 SECTION
3/4" = 1'-0"

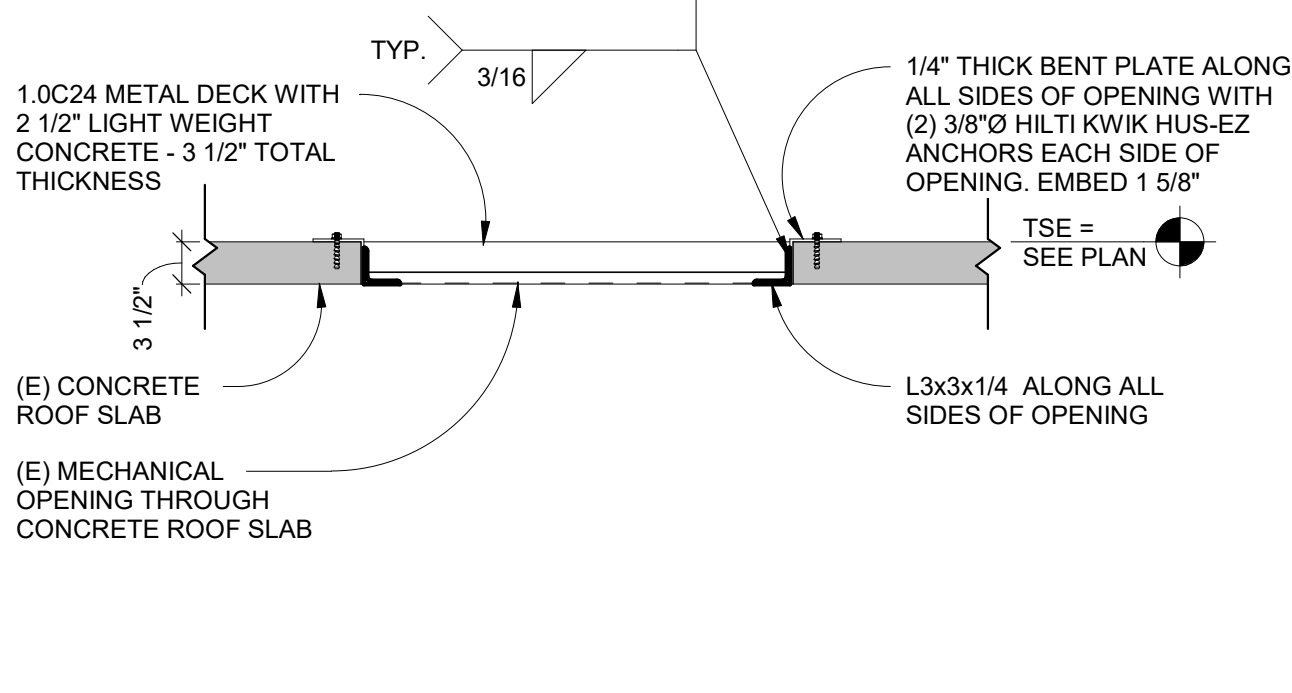


4 SECTION
1/2" = 1'-0"

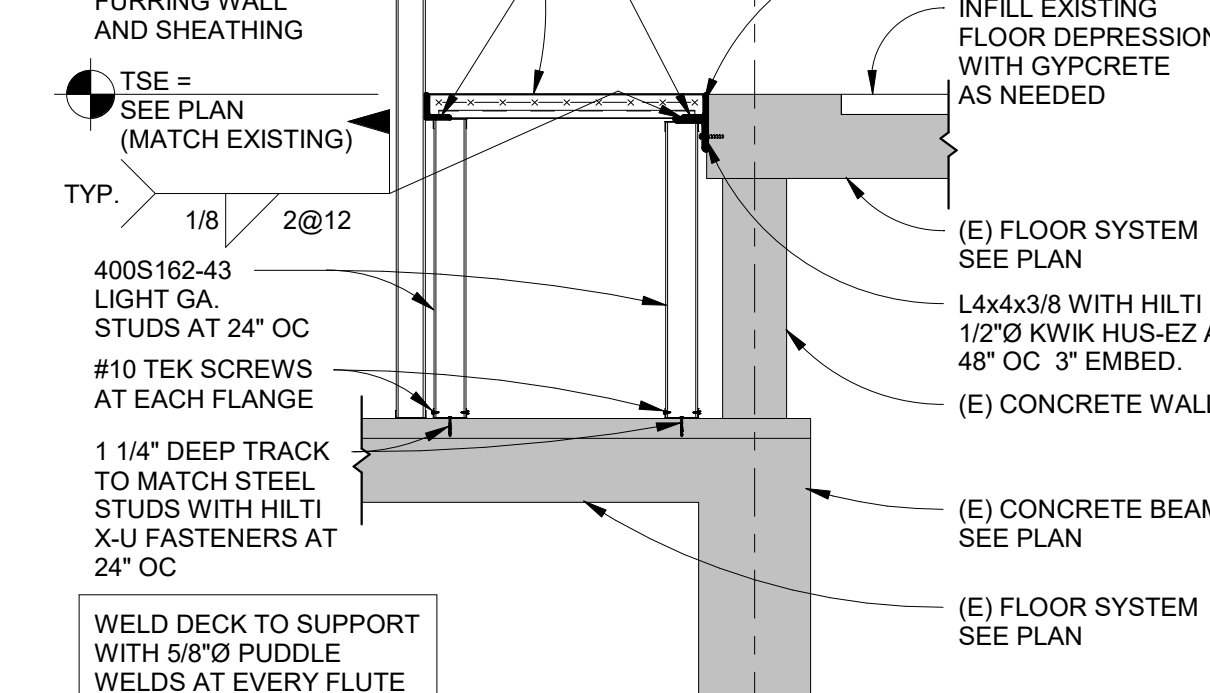


1 SECTION
3/4" = 1'-0" (AST S2000b)

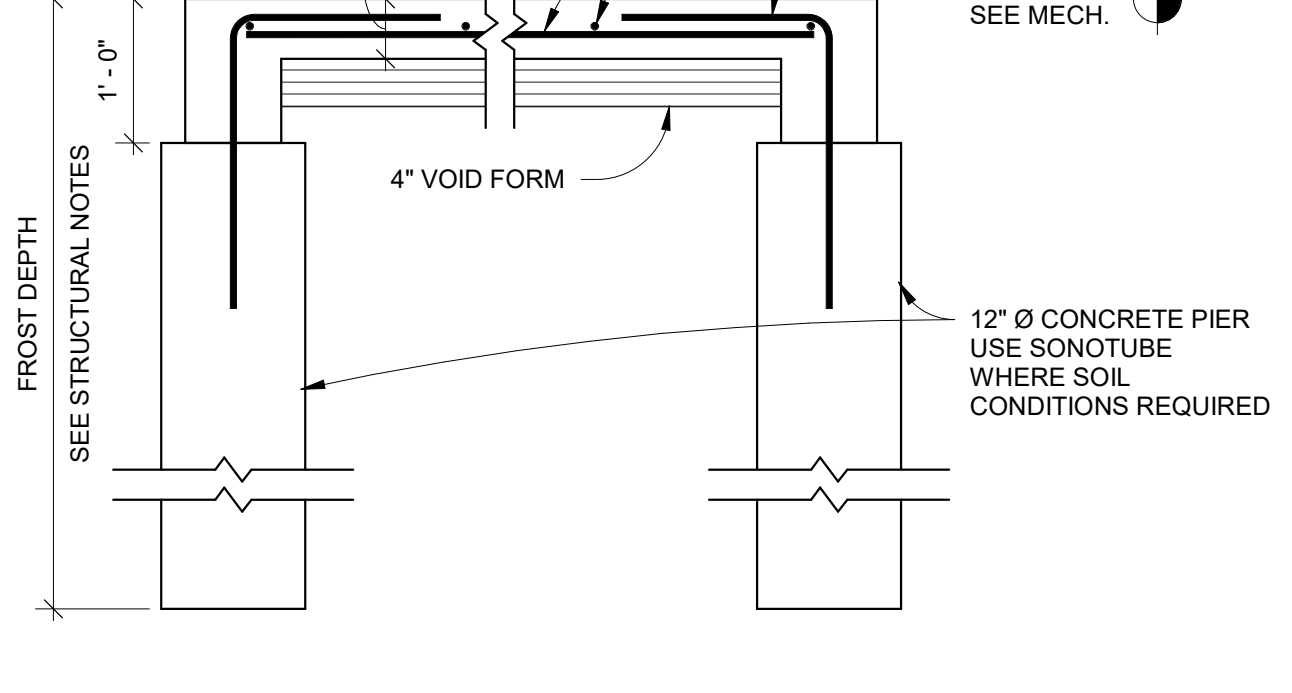


17 DETAIL - PATIENT LIFT / FALL PROTECTION SUPPORT
1 1/2" = 1'-0"

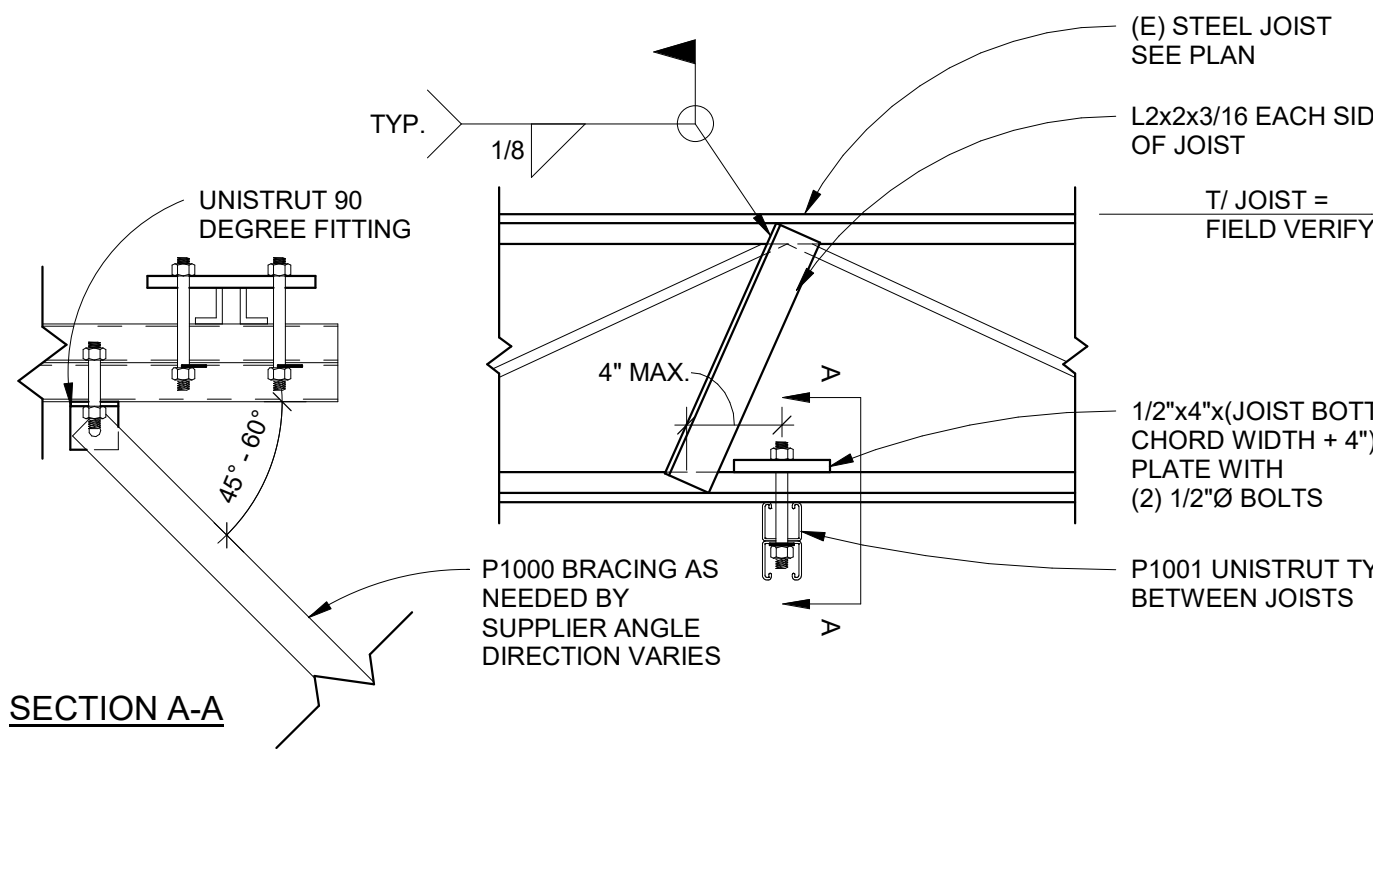


13 DETAIL - SLAB INFILL AT 5TH FLOOR
3/4" = 1'-0"

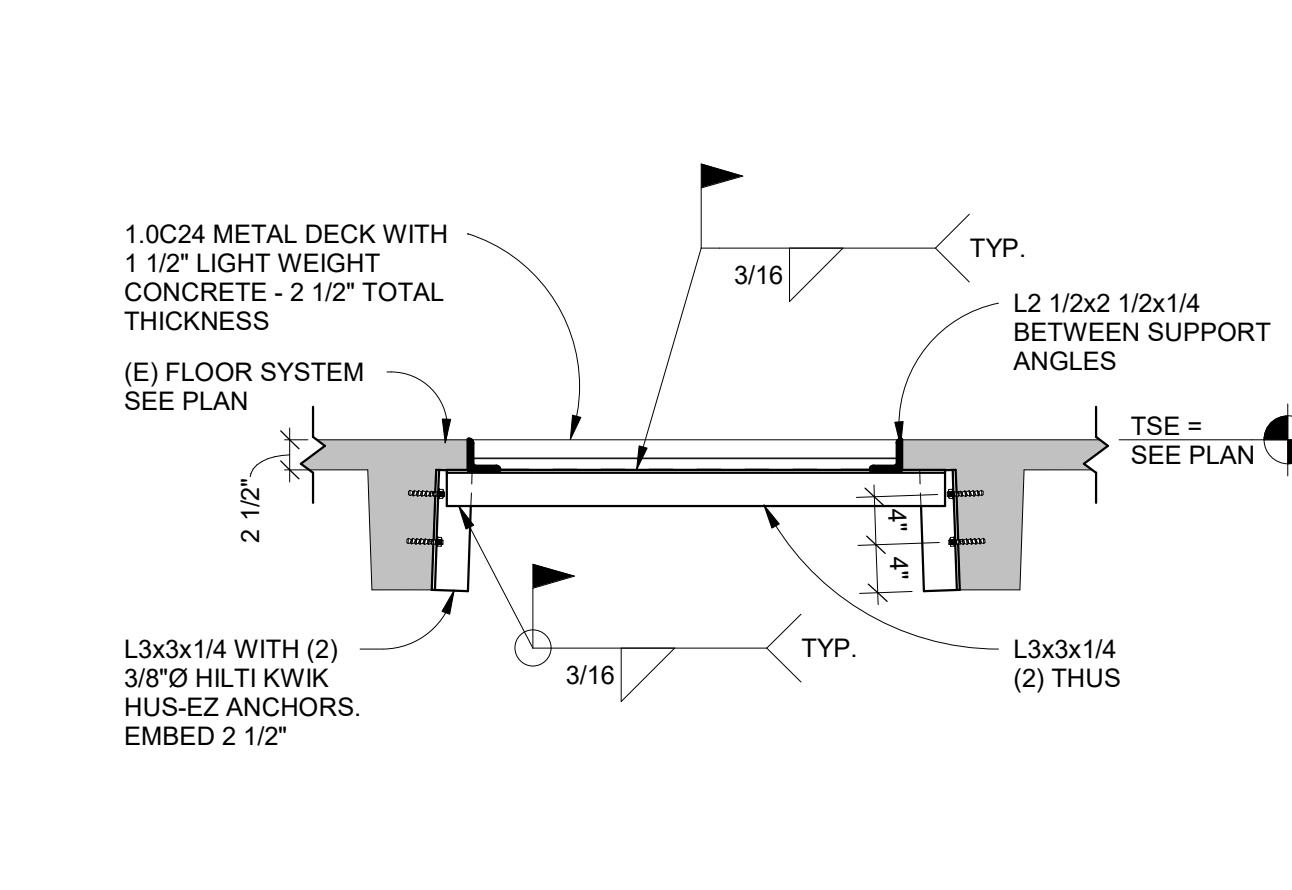


9 SECTION
1 1/2" = 1'-0"

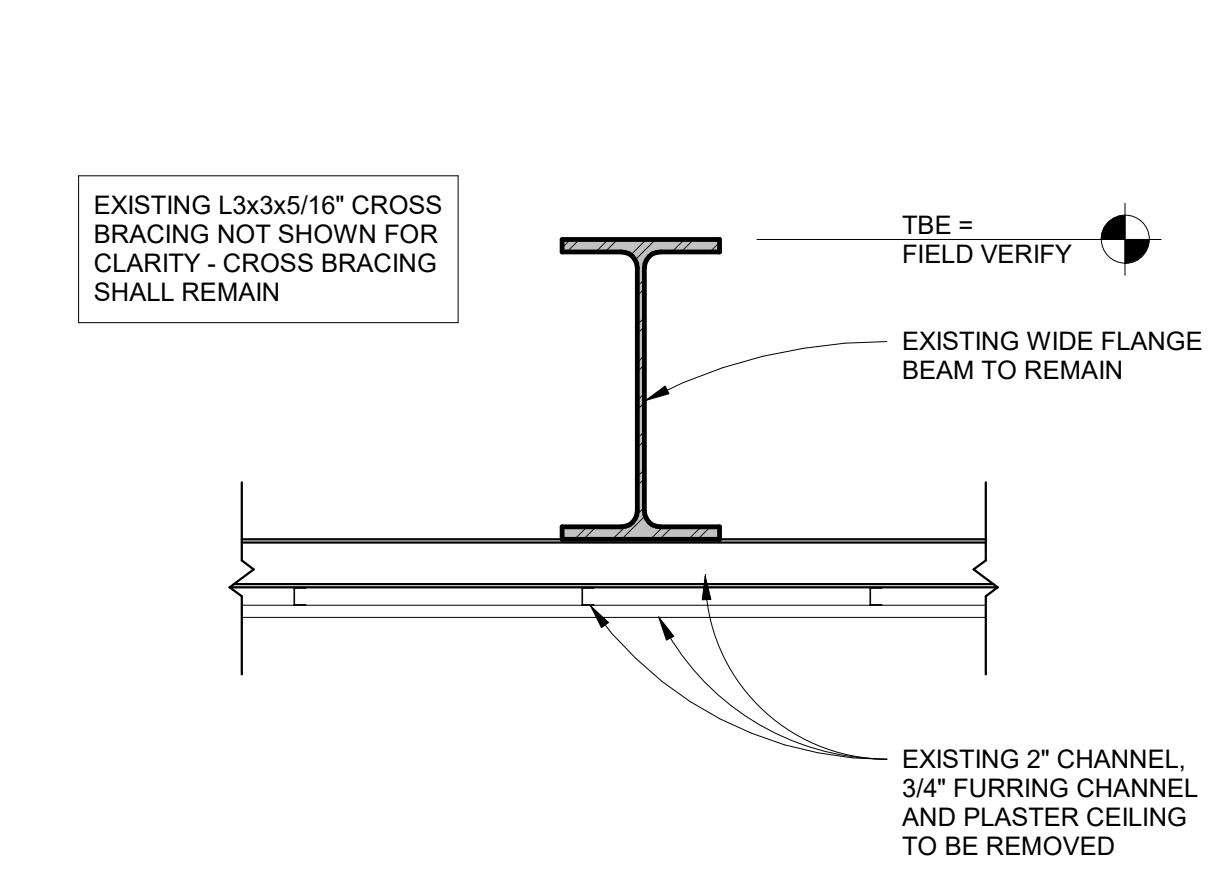


5 SECTION
1/2" = 1'-0"

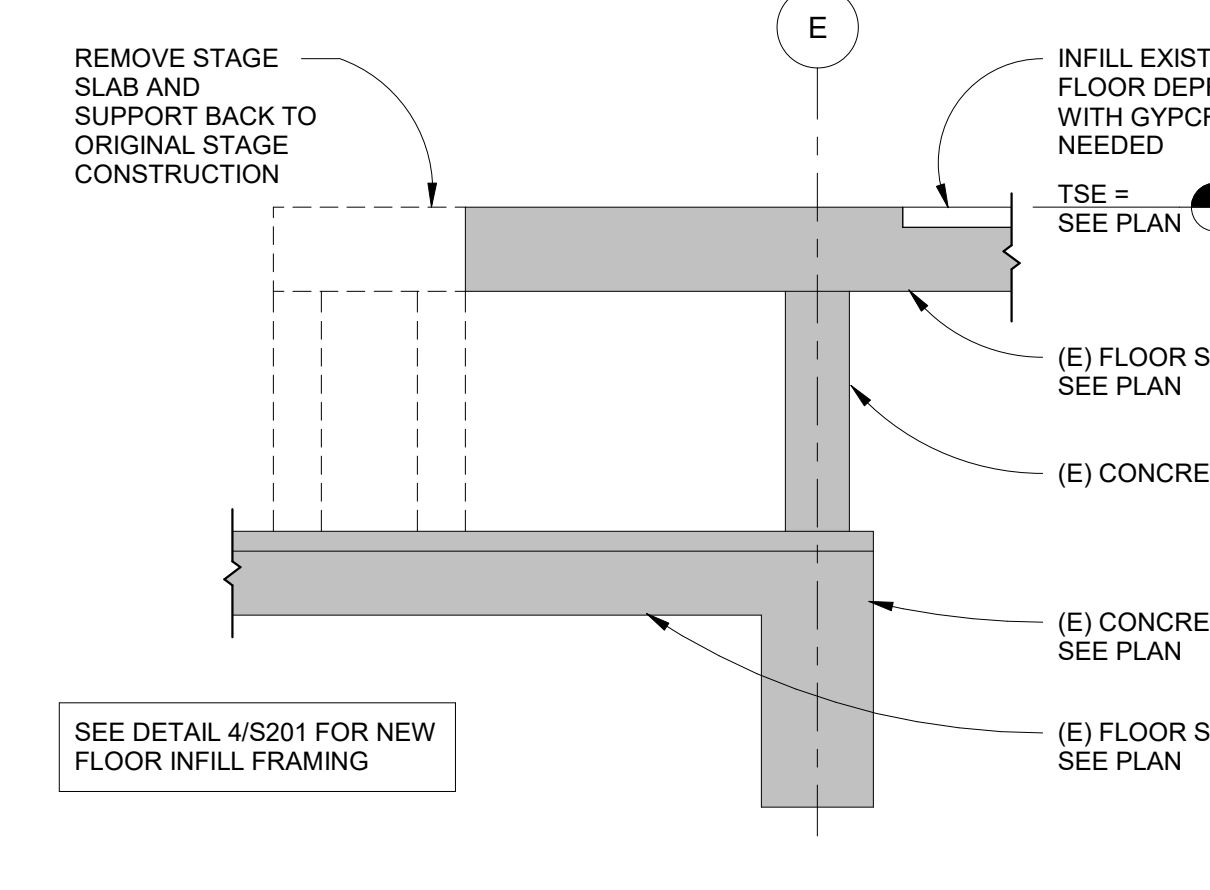


2 SECTION
3/4" = 1'-0" (AST S2024)

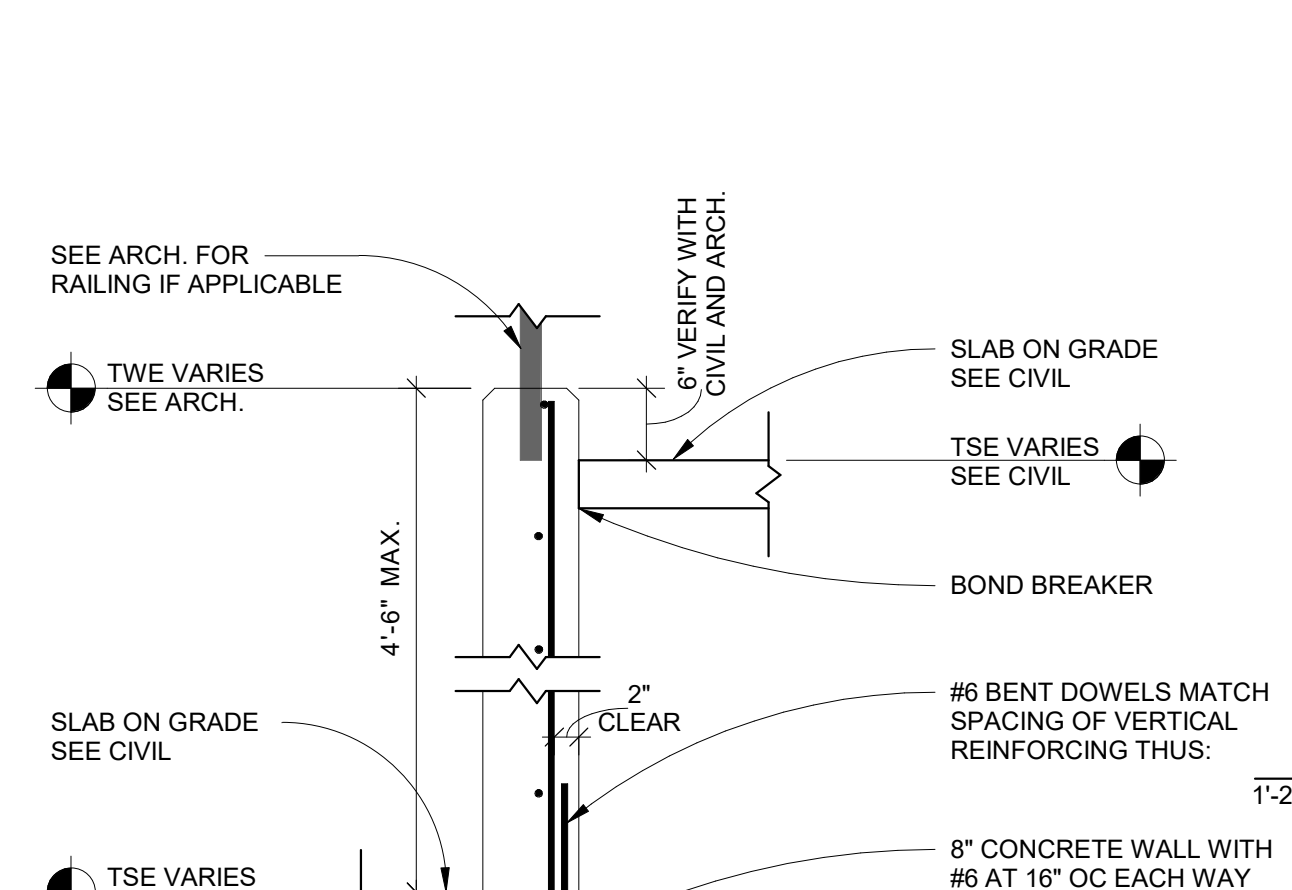


18 SECTION
1" = 1'-0"

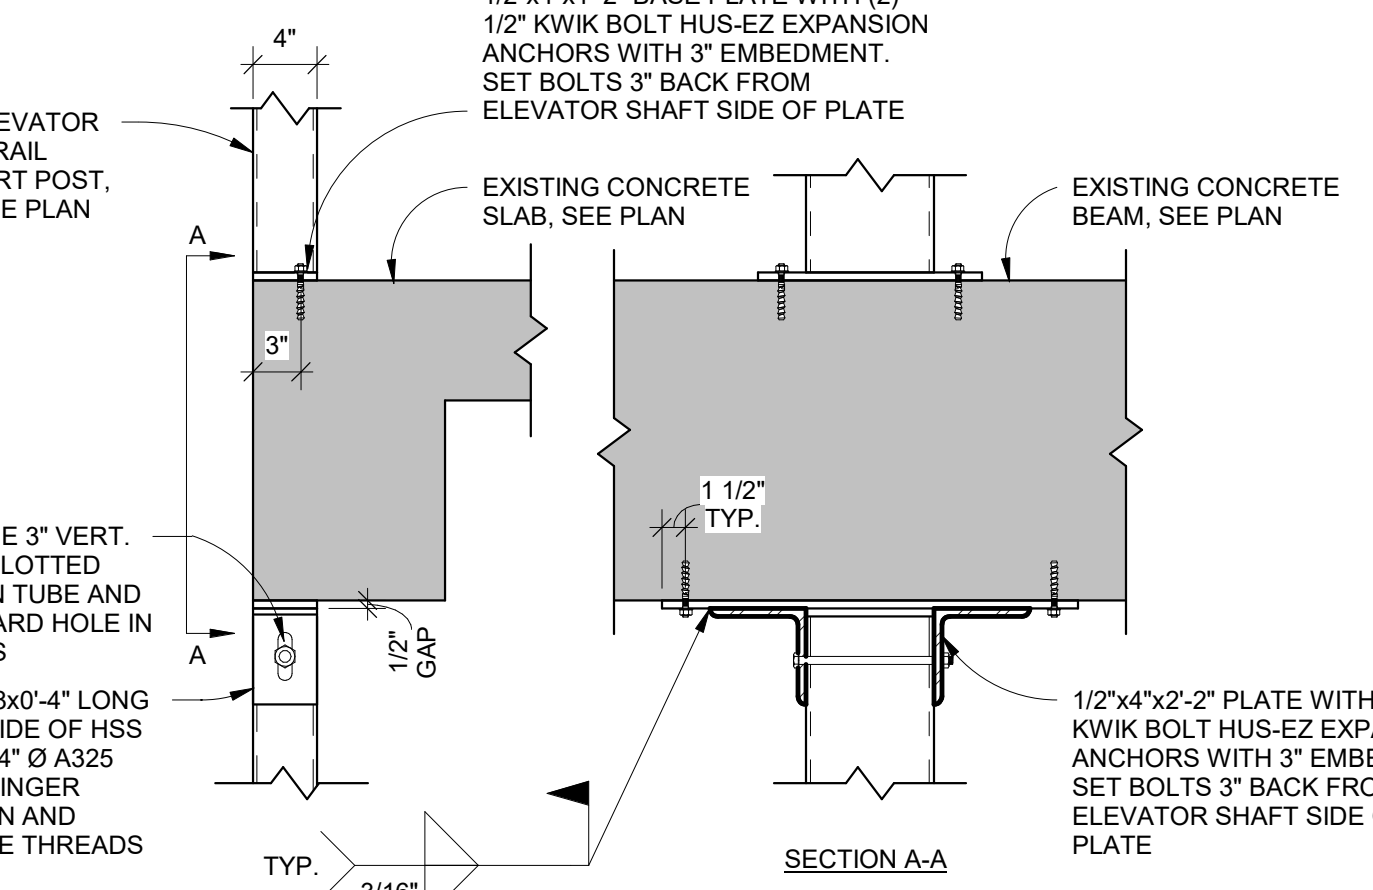


14 DETAIL - PATIENT LIFT / FALL PROTECTION SUPPORT
3/4" = 1'-0"

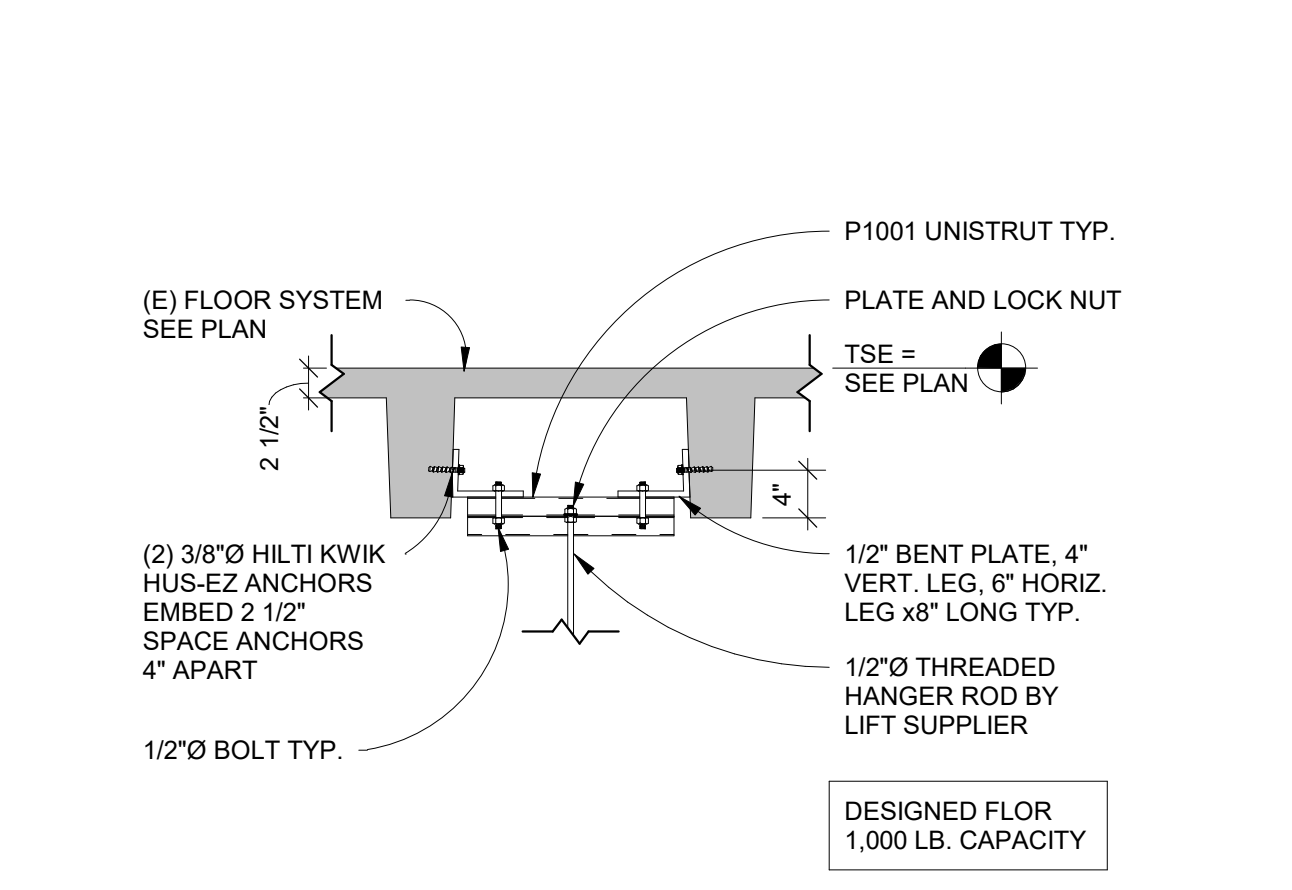


10 DETAIL
1 1/2" = 1'-0"

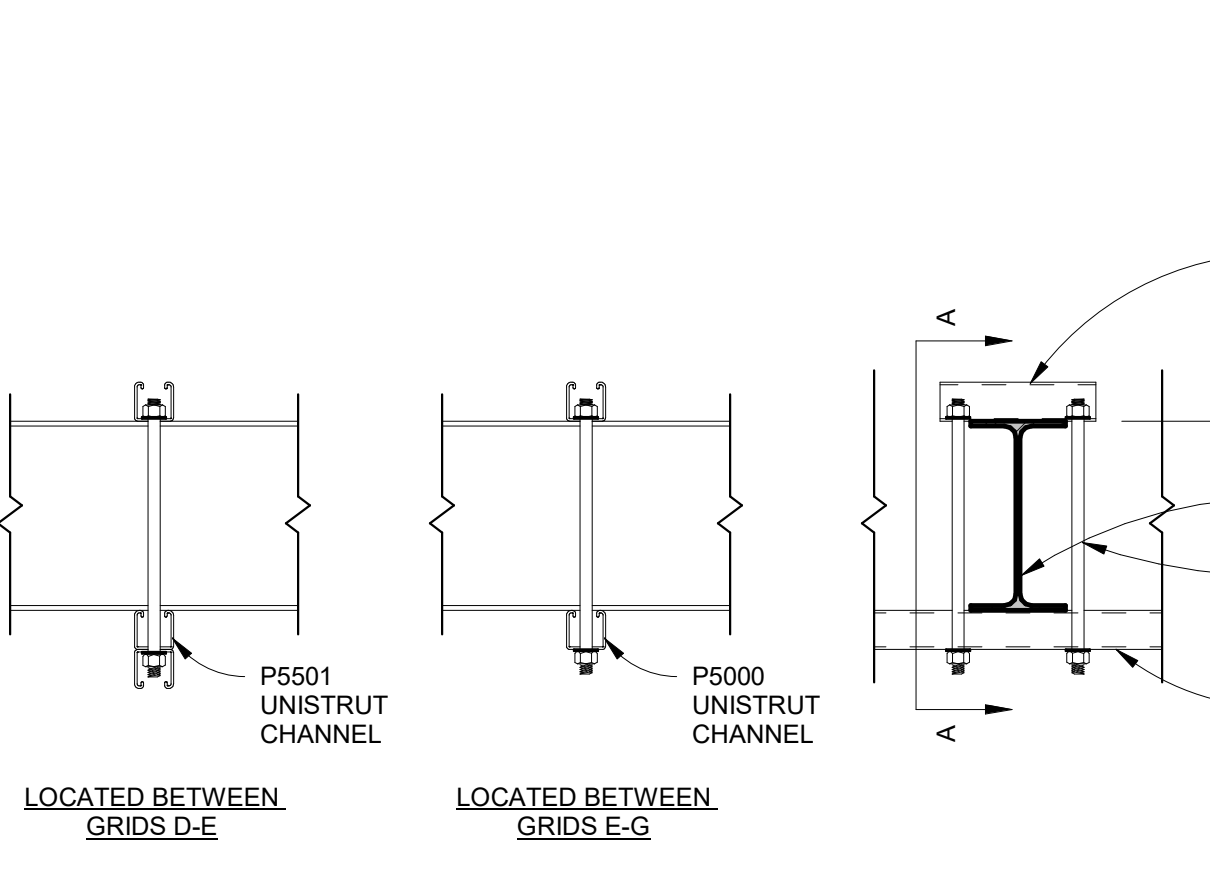


6 SECTION
3/4" = 1'-0"

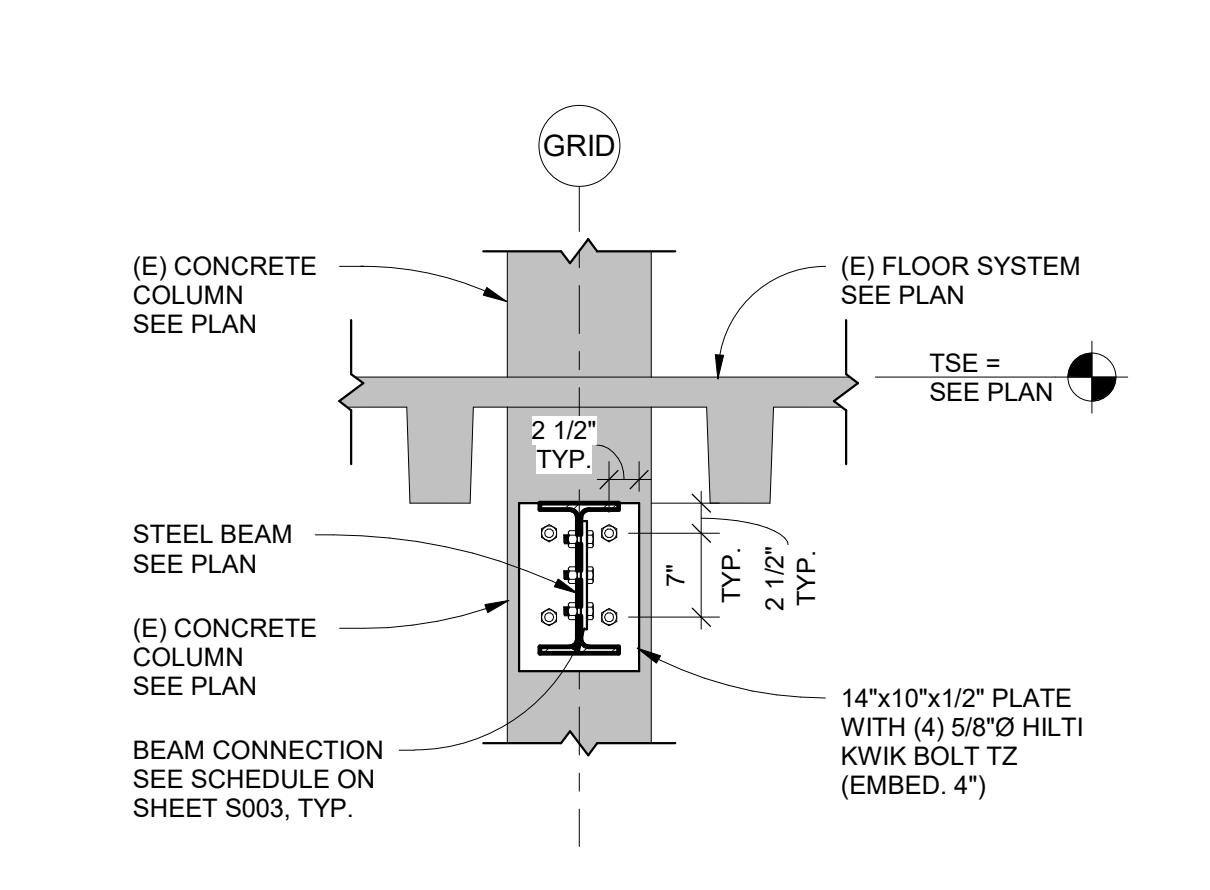


3 SECTION
1" = 1'-0"

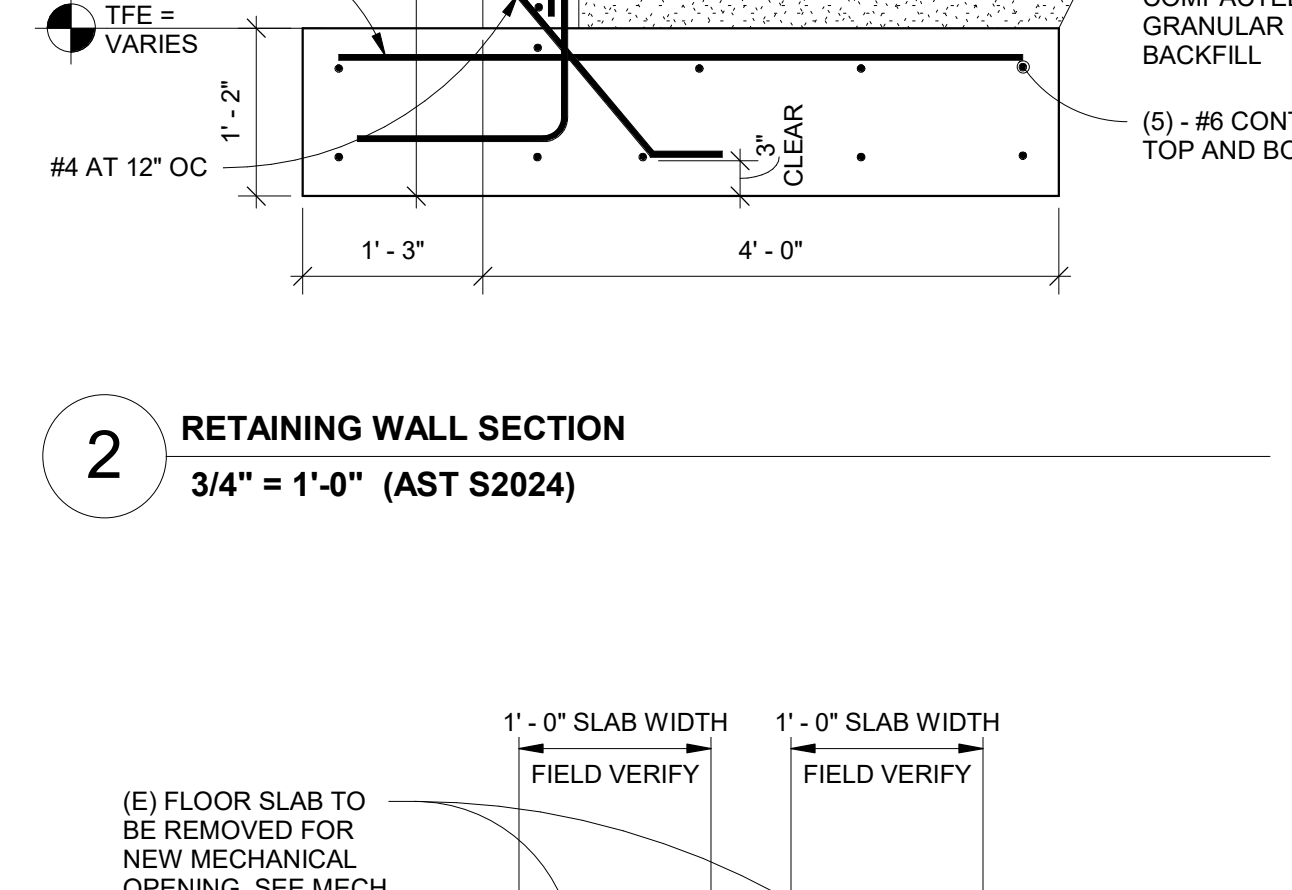


19 SECTION
1" = 1'-0"

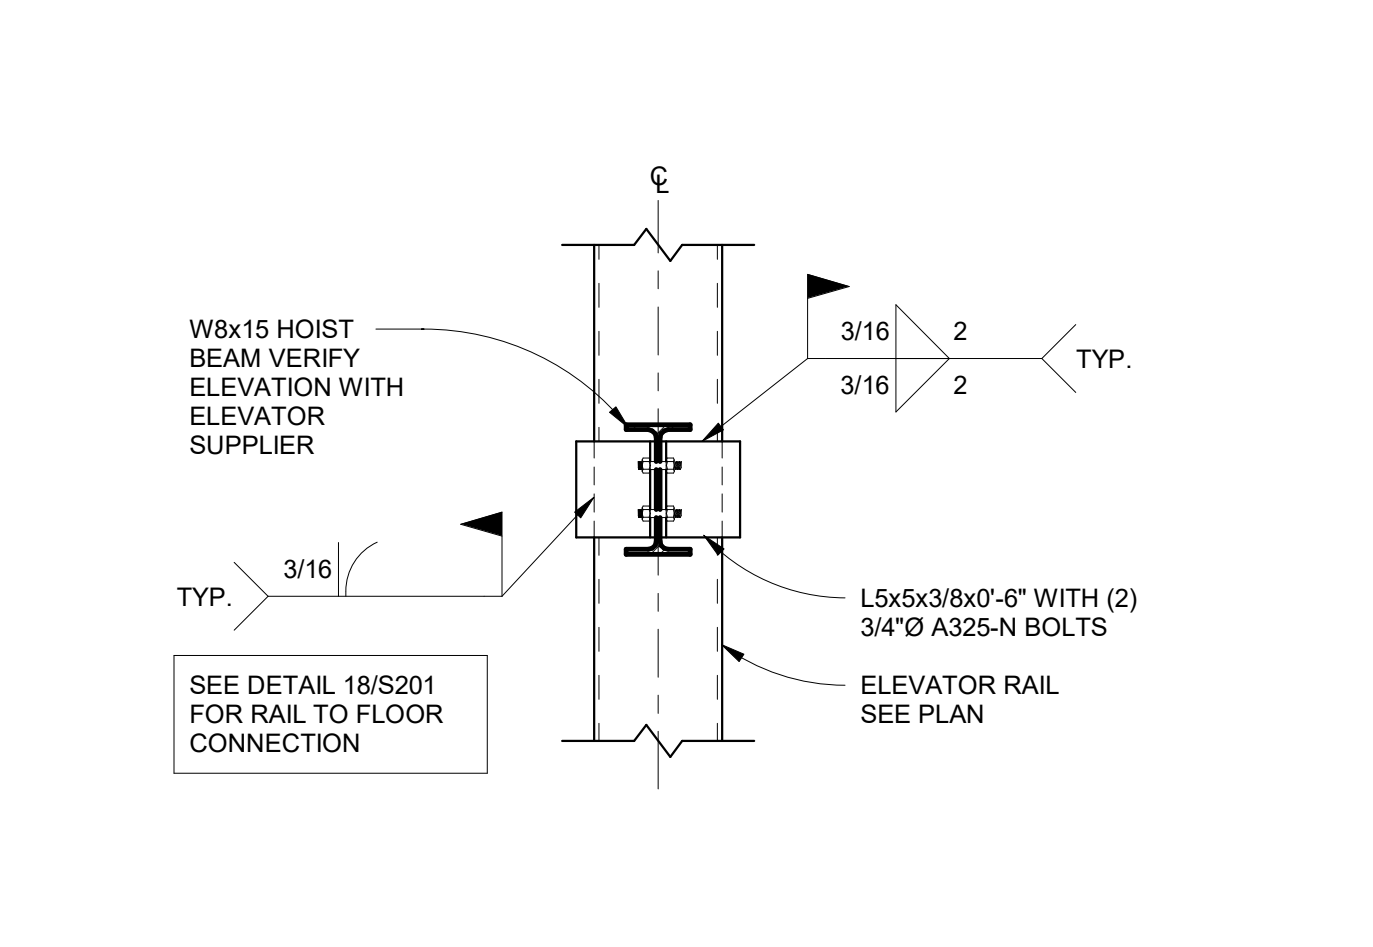


15 DETAIL - PATIENT LIFT / FALL PROTECTION SUPPORT
1 1/2" = 1'-0"

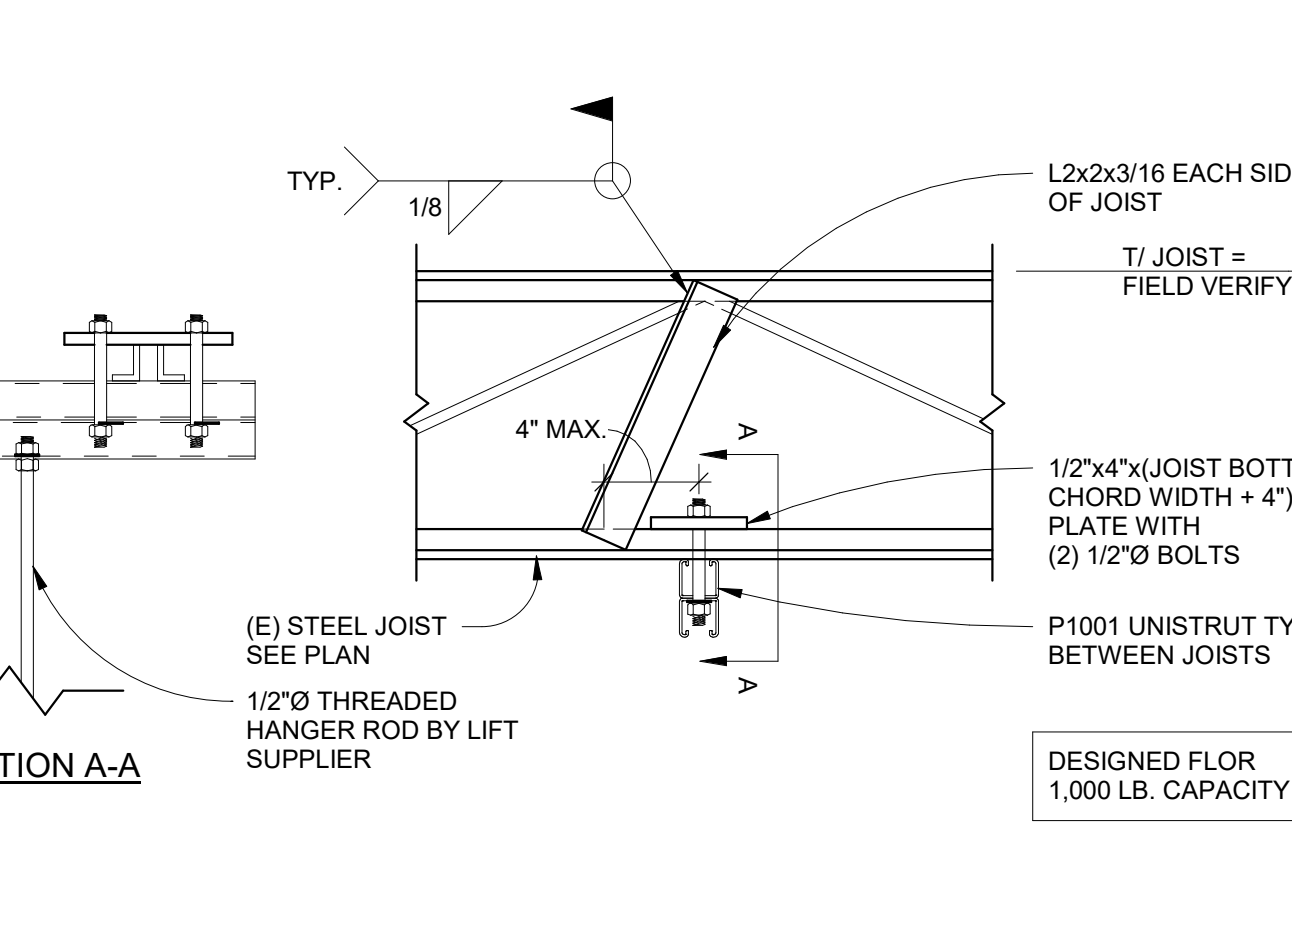

11 DETAIL
3" = 1'-0"

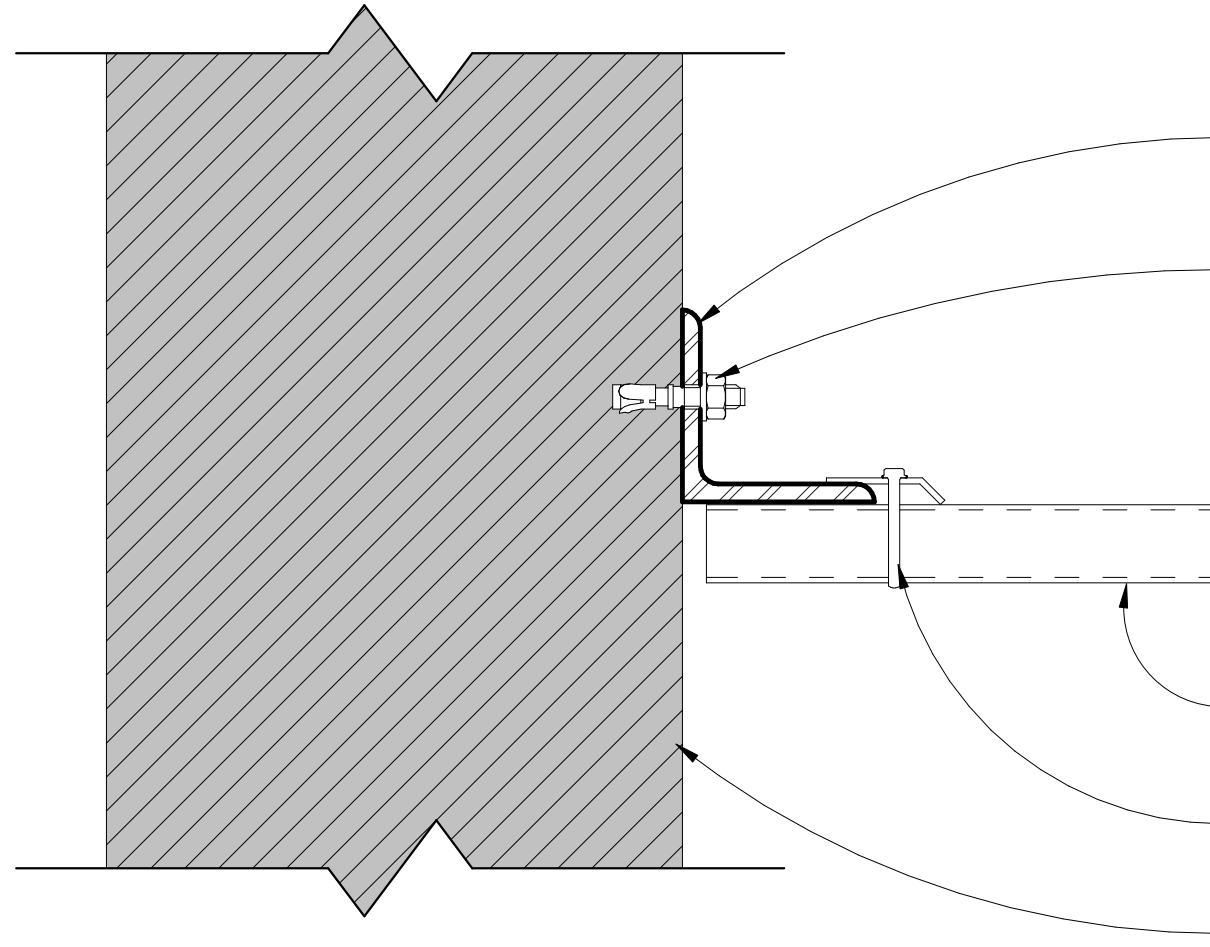

7 SECTION
3/4" = 1'-0"

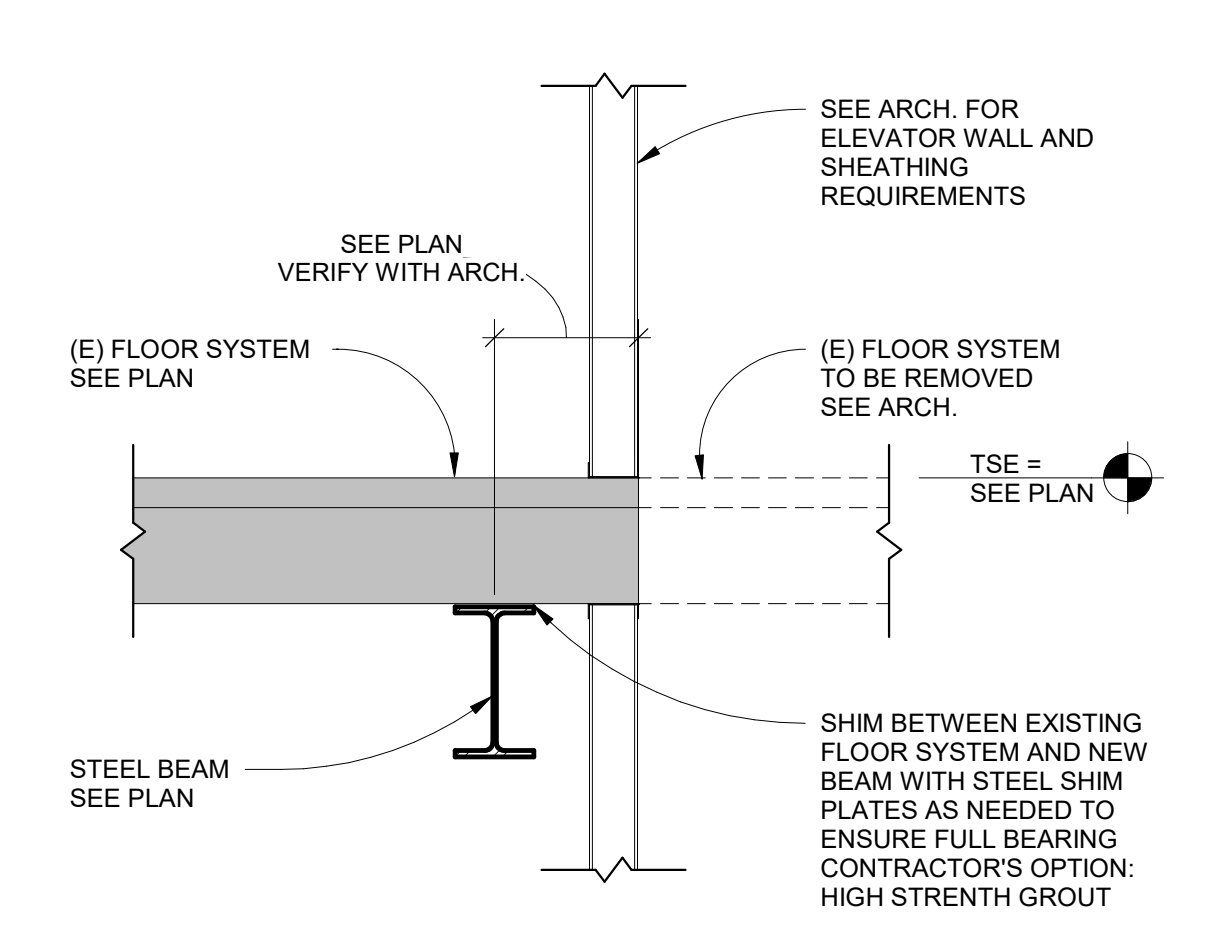

Revisions:	Date:

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AST PROJECT NUMBER: SD 1007

ARCHITECT/ENGINEER OF RECORD

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Office of Construction and Facilities Management

U.S. Department of Veterans Affairs

Drawing Title
SECTIONS AND DETAILS

Approved:

Phase
CONSTRUCTION DOCUMENTS

FULLY SPRINKLERED

Project Title
RENOVATE OLD CHAPEL AND AUDITORIUM

Project Number
SD 1007

Building Number
1 and 5


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Location
SIOUX FALLS, SD


Issue Date
05/15/2020

Checked
MAS


Drawn
AJM

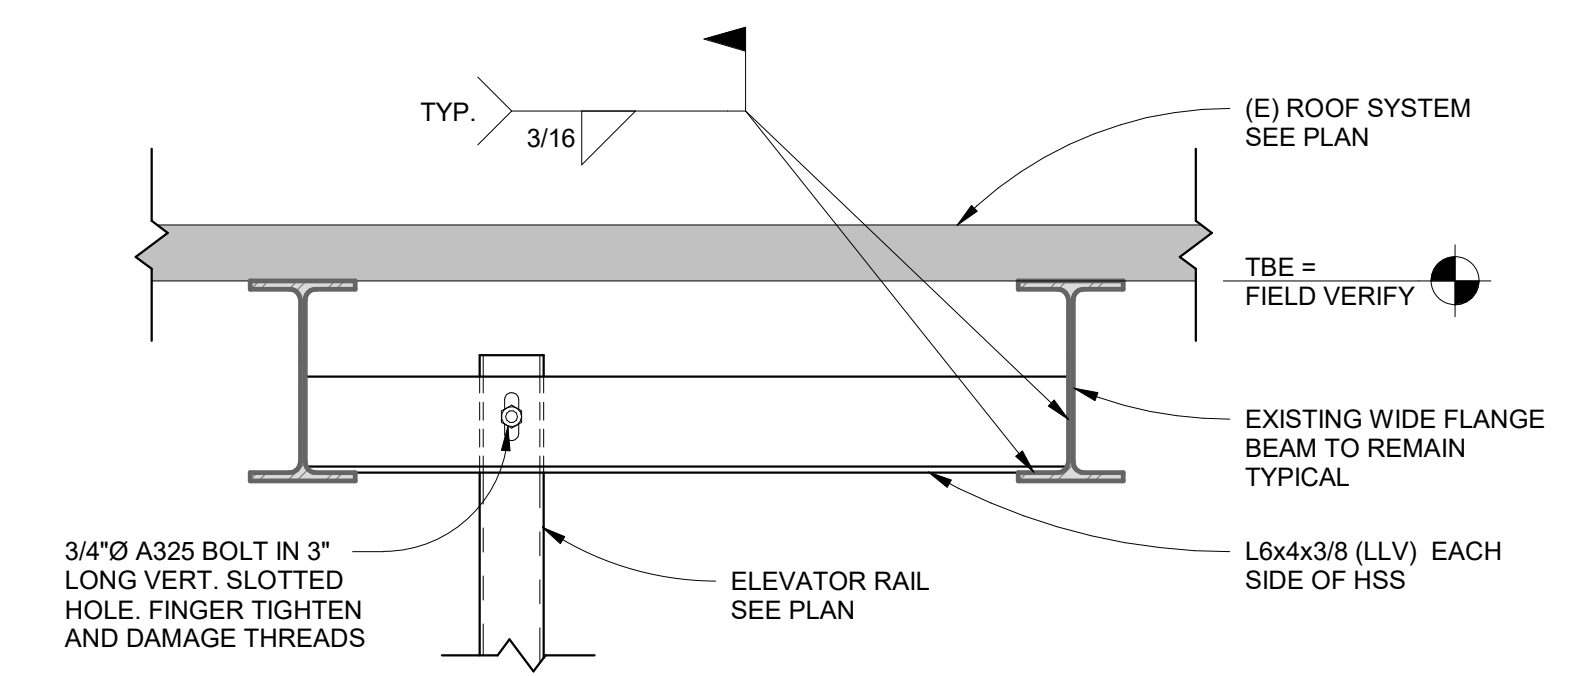


1 SECTION
1" = 1'-0"

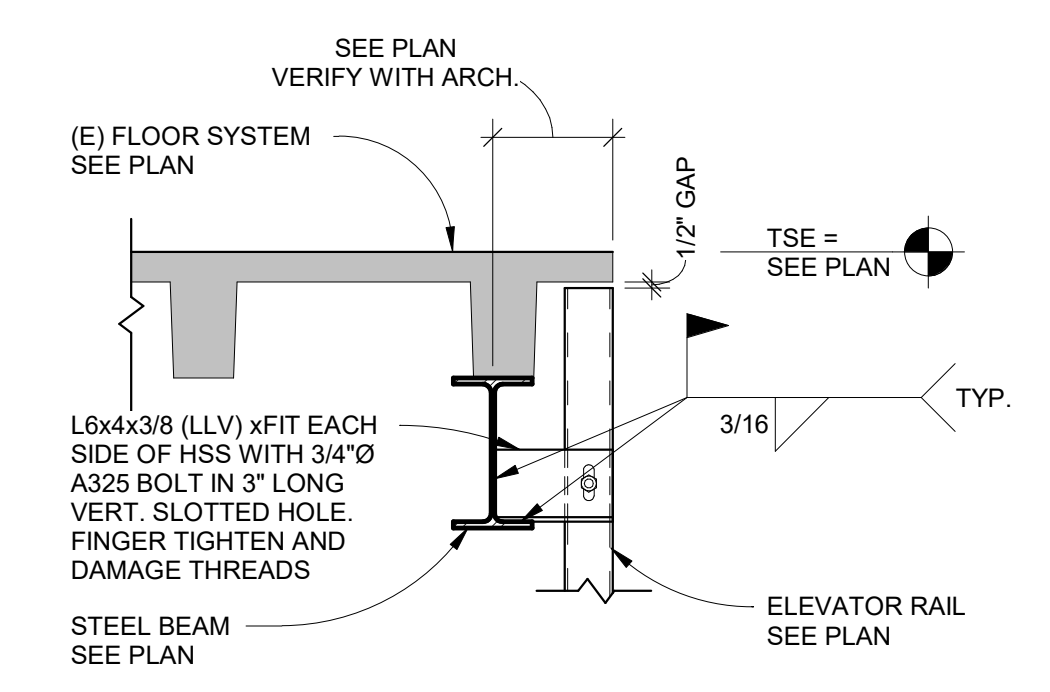

2 SECTION
3/4" = 1'-0"

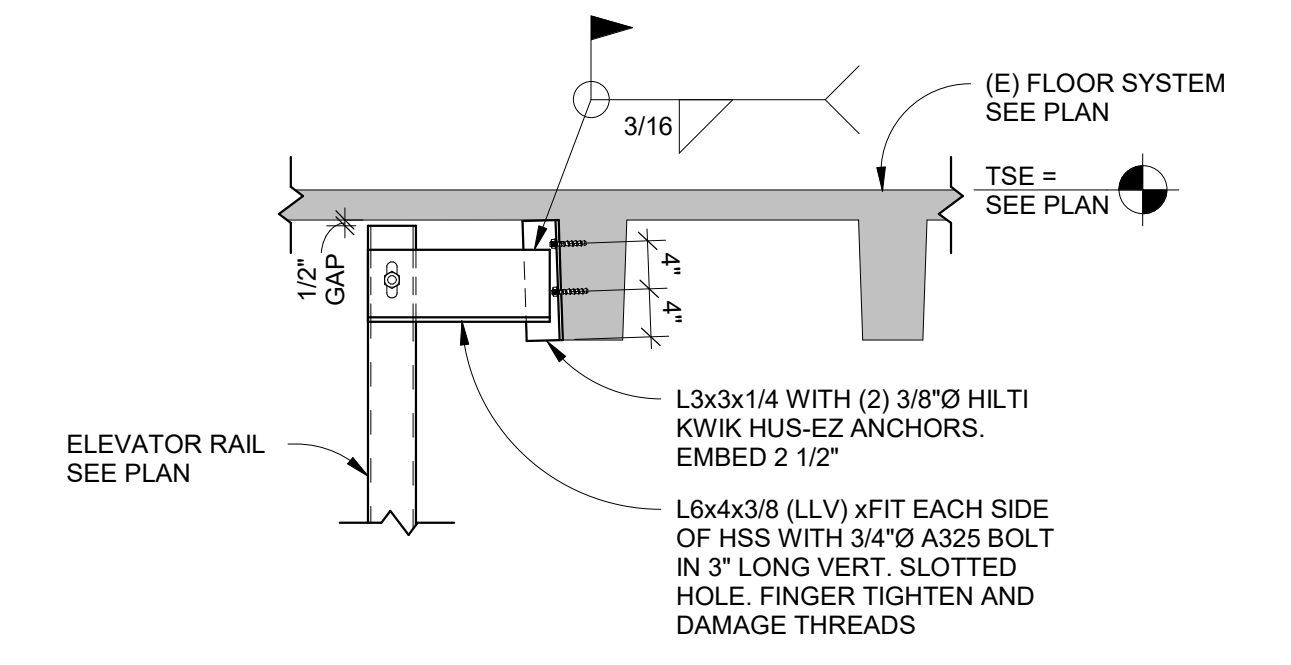

3 SECTION
3/4" = 1'-0"

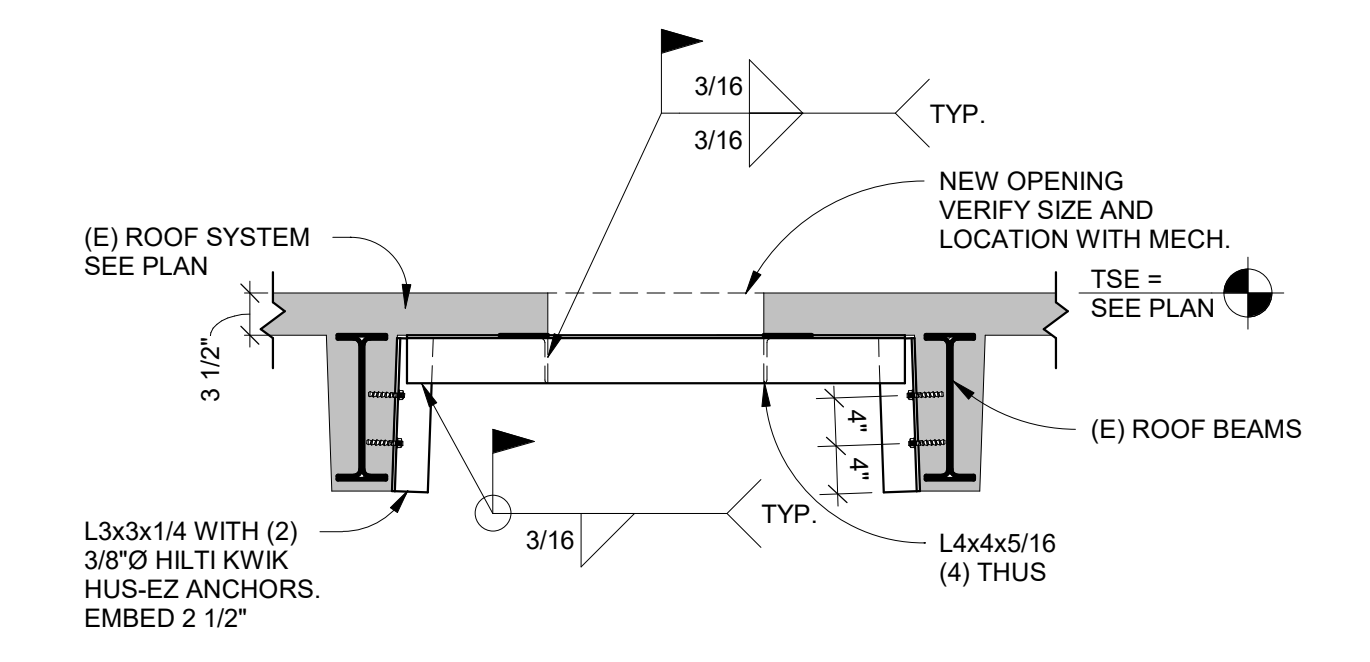

4 DETAIL
3/4" = 1'-0"

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Revisions:	Date:

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


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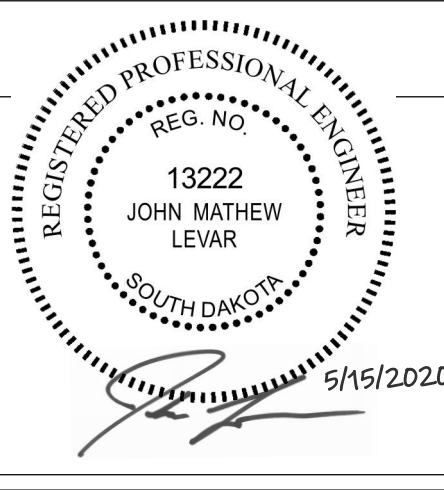
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AST PROJECT NUMBER: SD 1007

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Drawing Title SECTIONS AND DETAILS
Approved:


Phase CONSTRUCTION DOCUMENTS
FULLY SPRINKLERED

Project Title RENOVATE OLD CHAPEL AND AUDITORIUM		
Location SIoux FALLS, SD		
Issue Date 05/15/2020	Checked MAS	Drawn AJM

Project Number SD 1007
Building Number 1 and 5
Drawing Number S202

SITE / STAGING PLAN GENERAL NOTES:

1. FENCE TO BE CHAIN LINK. GATES MUST BE LOCKED AT ALL TIMES OTHER THAN ENTRY/EXIT. REQUEST PADLOCKS FROM COR.
2. MAINTAIN 1.5 SEPARATION FROM FENCE TO SIDEWALKS.
3. PROVIDE SEDIMENT TRACKING DRIVE-OFF AT ALL VEHICLE ACCESSES. ANY TRACKED SEDIMENT MUST BE SWEEPED UP WITHIN 24 HOURS.
4. PROVIDE INLET PROTECTION AT THE CATCH BASINS WITHIN THE STAGING AREA. MAINTAIN THROUGH THE LIFE OF THE PROJECT.
5. KEEP ANY STORM SEWER MANHOLE WITHIN THE STAGING AREA ACCESSIBLE.
6. STORAGE OF COMBUSTIBLE MATERIALS WITHIN 30 FEET OF ANY BUILDING IS NOT PERMITTED.
7. CLEAR AND GRUB TREE AS NOTED. REPLACE WITH 2" BALLED AND BURLAPPED AMERICAN LINDEN, WARRANTY NEW TREE FOR 1 YEAR.
8. ALL DISTURBED AREAS SHALL BE RESTORED WITH 4" MINIMUM SCREENED TOPSOIL AND STABILIZED WITH SALT RESISTANT SOD. WATER AND MAINTAIN SOD UNTIL IT IS ESTABLISHED/FULLY ROOTED. PROVIDE A MINIMUM OF 3 MOWINGS.
9. CONTRACTOR MAY PARK ONE (1) SEMI TRAILER IN AREA MARKED ON SITE PLAN, AND APPROVED BY THE COR. FOR STORAGE OF EQUIPMENT AND MATERIALS. THE CONTRACTOR MAY PARK UP TO _____ WORKER VEHICLES AT _____. ALL OTHER STORAGE AND PARKING MUST BE WITHIN FENCED AREA SHOWN FOR CURRENT AREAS OF CONSTRUCTION. RELOCATION OF THE SEMI TRAILER WITH THIS PARKING AREA MAY BE REQUIRED DURING CONSTRUCTION.

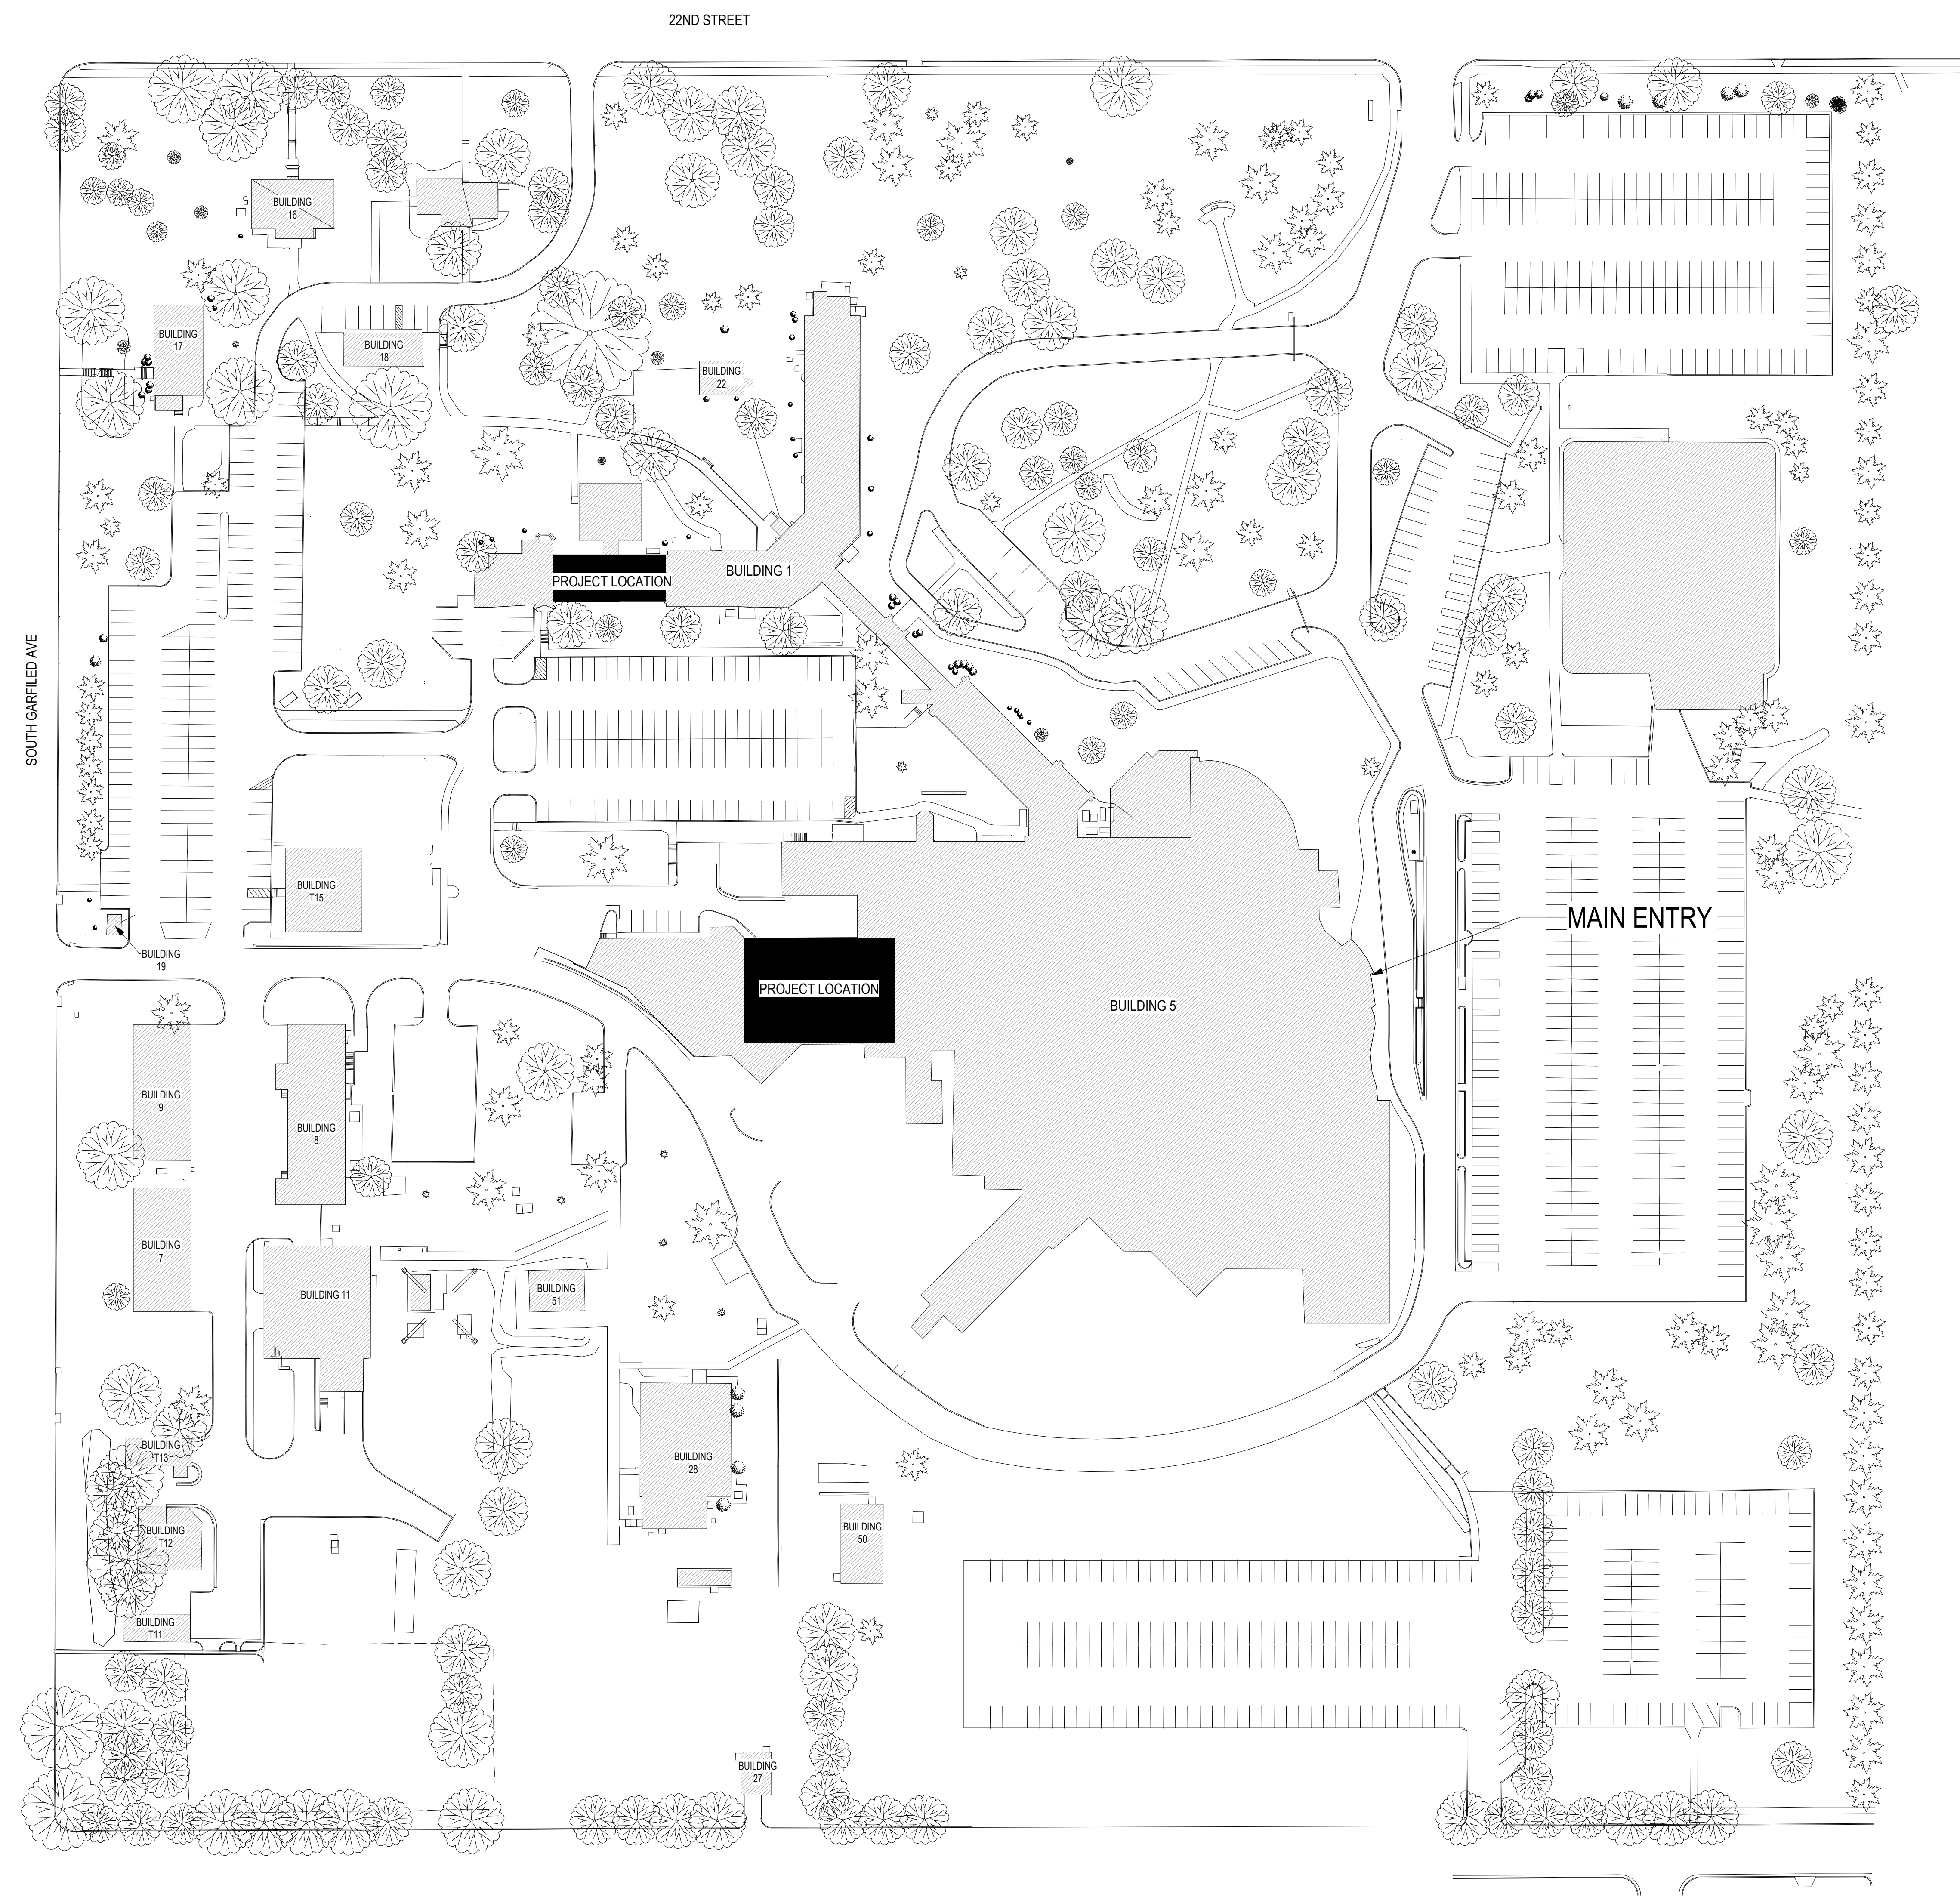


1 SITE PLAN
1" = 60'-0"


Revisions:	Date:

<p>CONSULTANT</p> <p><small>OMAHA LINCOLN COLORADO SPRINGS SIOUX FALLS</small> farris-usa.com</p>	<p>ARCHITECT/ENGINEER OF RECORD</p> <p>13605 1st Ave. N. #100 Plymouth, MN 55441 P 763.412.4000 F 763.412.4090 ae-mn.com Anderson Engineering of Minnesota, LLC Proj # 15622</p>	<p>STAMP</p>	<p>Office of Construction and Facilities Management</p> <p>VA U.S. Department of Veterans Affairs</p>	<p>Drawing Title ARCHITECTURAL SITE & STAGING PLAN</p> <p>Approved: _____</p>	<p>Phase CONSTRUCTION DOCUMENTS</p> <p>FULLY SPRINKLERED</p>	<p>Project Title RENOVATE OLD CHAPEL AND AUDITORIUM</p> <p>Location Sioux Falls, SD</p> <p>Issue Date 05/15/2020</p> <p>Checked Checker</p> <p>Drawn GJB</p>	<p>Project Number 438-19-301</p> <p>Building Number 1 & 5</p> <p>Drawing Number AS100</p>
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1 GROUND FLOOR DEMOLITION PLAN - BUILDING 5
1/8" = 1'-0"

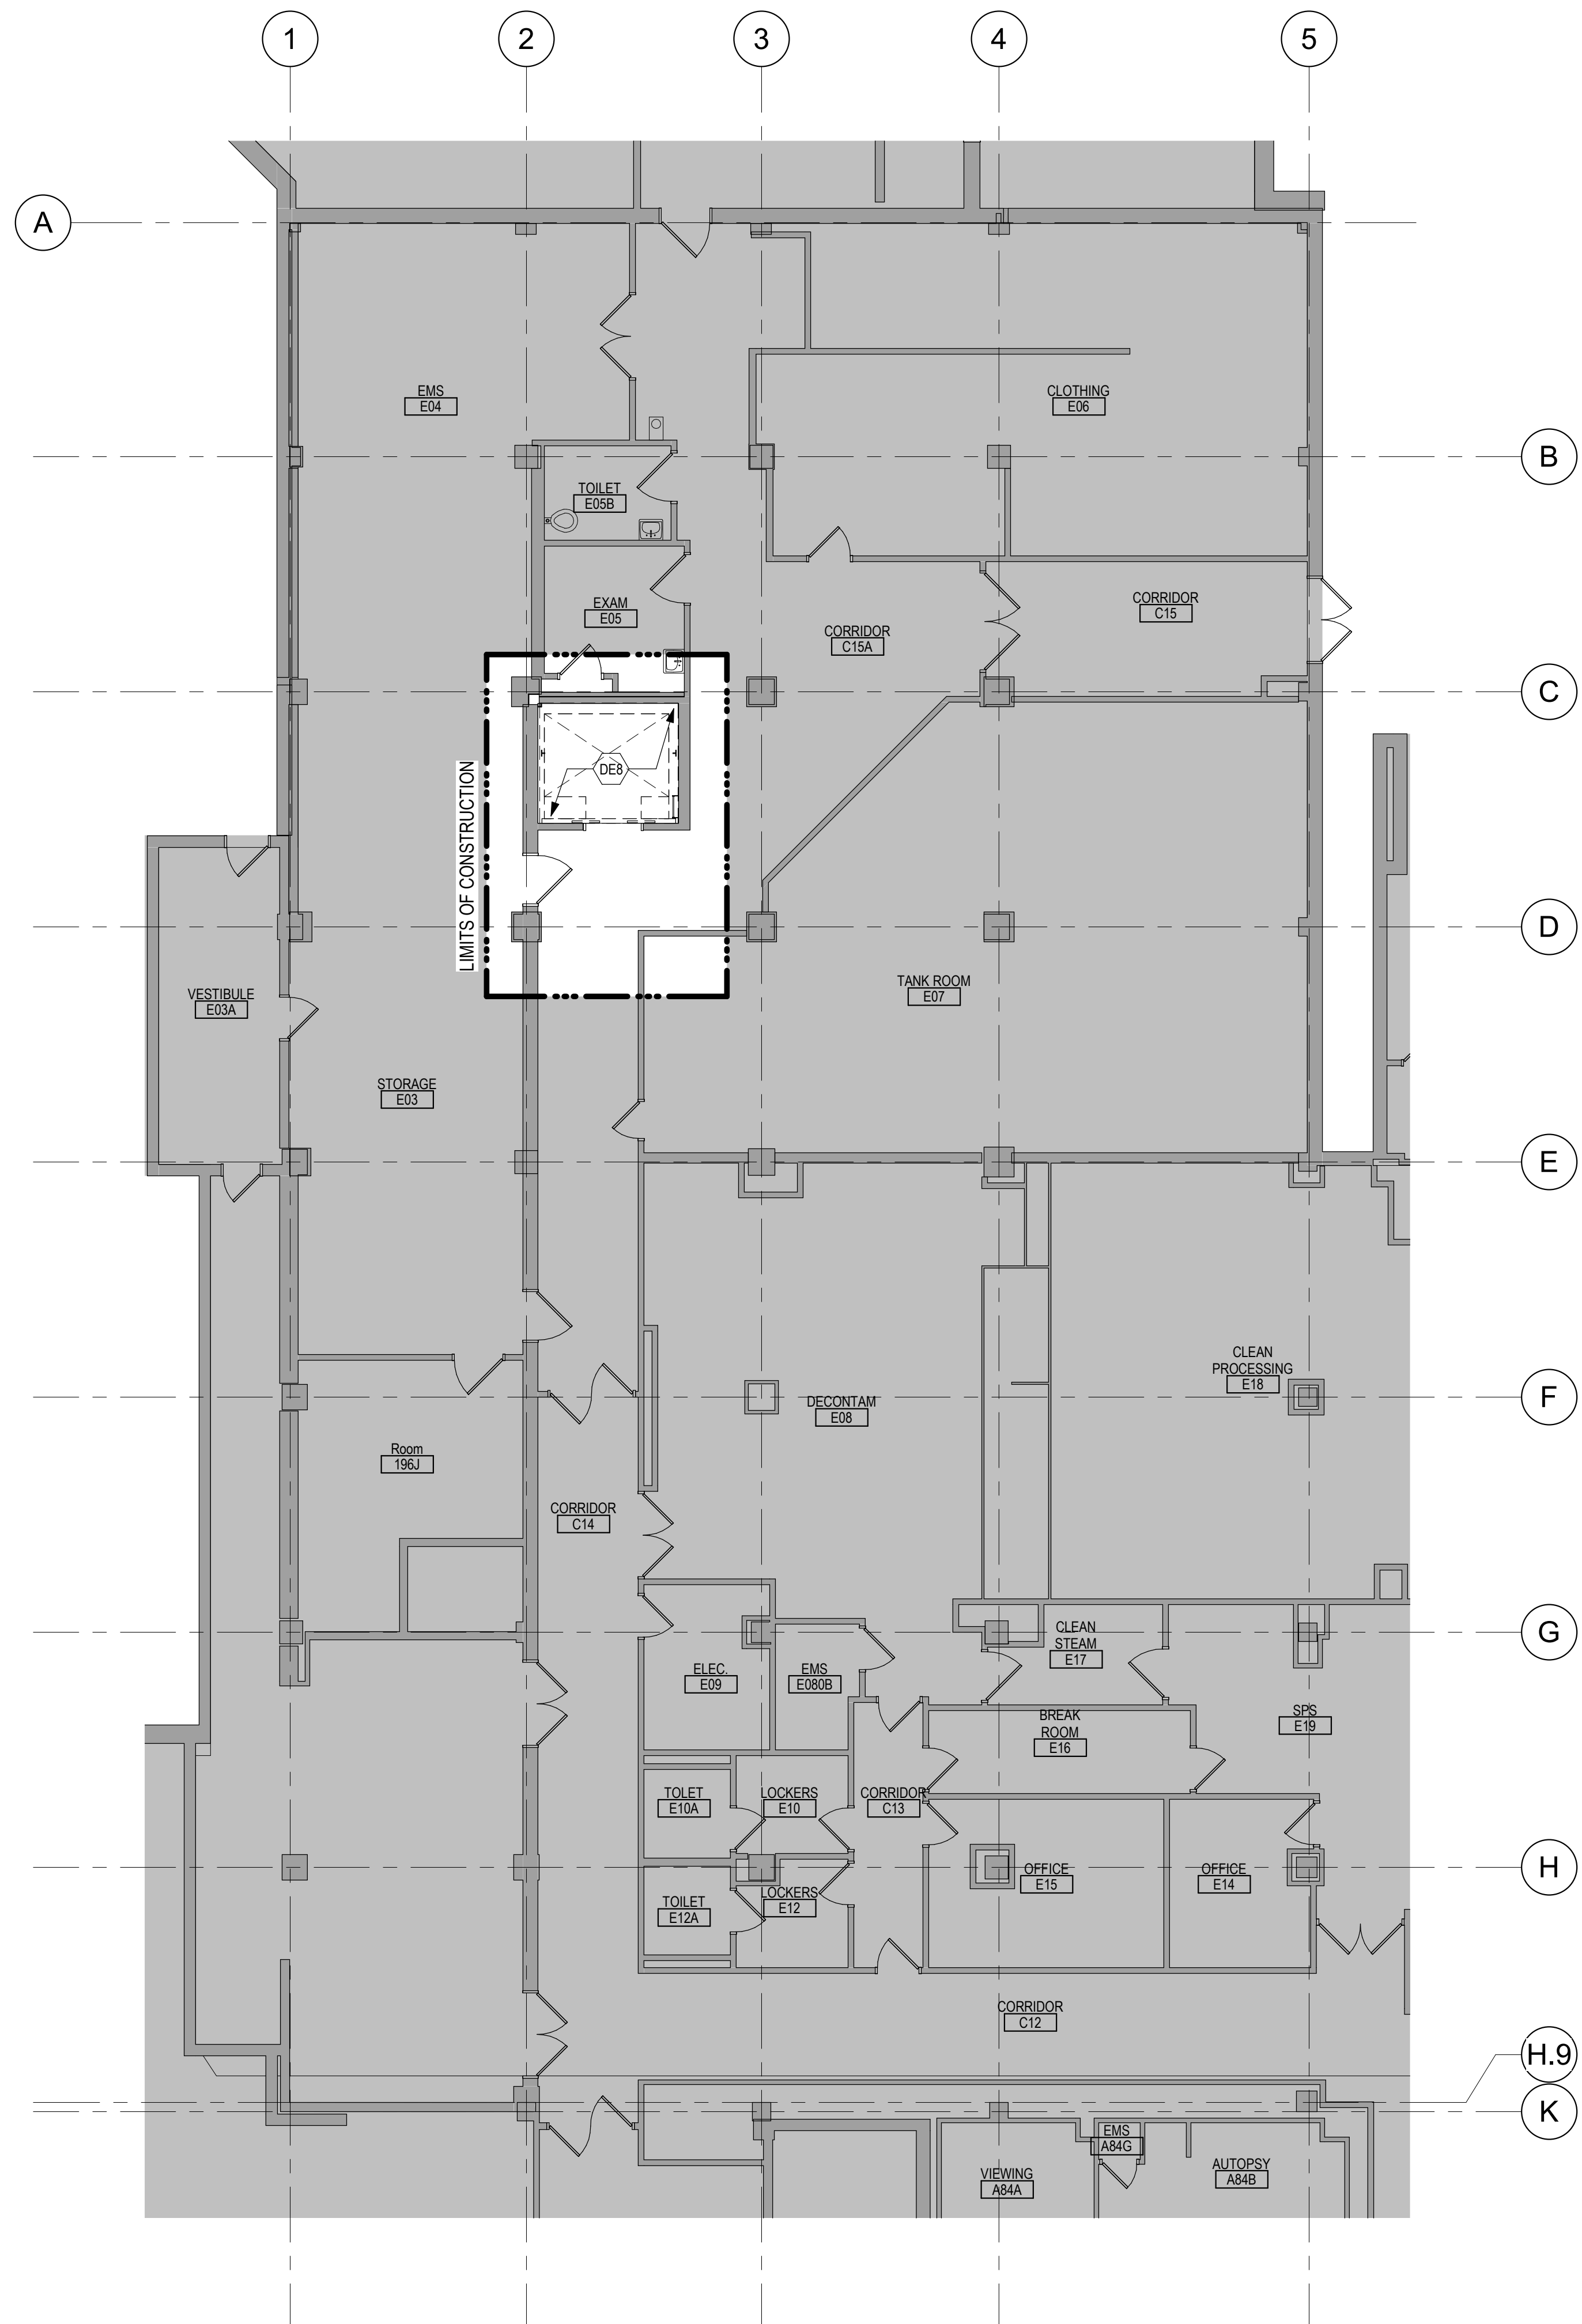

DEMOLITION PLAN KEYED NOTES

- DE1 REMOVE FLOOR FINISH IN ITS ENTIRETY. PATCH & PREP FLOOR FOR SCHEDULED FINISH. SEE SPECIFICATION SECTION 09 05 16 SUBSURFACE PREPARATION FOR FLOOR FINISHES.
DE2 REMOVE CEILING IN ITS ENTIRETY, INCLUDING ALL MECHANICAL & ELECTRICAL ITEMS. SEE MECHANICAL / ELECTRICAL.
DE3 REMOVE GYP BD ON ONE SIDE OF PARTITION AS REQUIRED. SEE PLANS AND MECHANICAL / ELECTRICAL PLANS FOR ADDITIONAL INFORMATION.
DE4 REMOVE WOOD SILL AND TRIM AT WINDOW.
DE5 CUT OPENING IN PARTITION AS REQUIRED FOR INSTALLATION OF DOOR AND FRAME AND/ OR BORROWED LIGHT AS SCHEDULED. SEE PLAN.
DE6 REMOVE PLUMBING FIXTURE AND ALL ASSOCIATED PIPING. -SEE MEP DRAWINGS FOR ADDITIONAL INFORMATION.
DE7 REMOVE BASE CABINETS, UPPER CABINETS, TALL CABINETS AND/ OR COUNTERTOP.
DE8 REMOVE ELEVATOR CAB, DOORS, RAILS AND ALL ASSOCIATED HARDWARE. SEE MEP PLANS FOR ADDITIONAL INFORMATION.
DE9 REMOVE PORTION OF SOFFIT ABOVE AS REQUIRED. SEE PLANS FOR ADDITIONAL INFORMATION.
DE10 REMOVE PORTION OF CEILING AS REQUIRED. SEE PLANS FOR ADDITIONAL INFORMATION.
DE11 SAW CUT CONCRETE FLOOR AS REQUIRED. SEE FLOOR PLANS FOR ADDITIONAL WORK.
DE12 REMOVE BASE CABINETS, UPPER CABINETS, TALL CABINETS AND/ OR COUNTERTOP. SALVAGE FOR REINSTALLATION. SEE PLAN FOR ADDITIONAL INFORMATION.
DE13 REMOVE BUILT UP ROOFING SYSTEM IN ITS ENTIRETY TO TOP OF ROOF DECK. PREP SURFACE FOR REROOFING.
DE14 REMOVE METAL FLASHING, WOOD BLOCKING AND ALL ASSOCIATED HARDWARE AT PARAPET, METAL SUPPERS AND MECHANICAL EQUIPMENT AS REQUIRED. -SEE MECHANICAL AND ELECTRICAL FOR ADDITIONAL INFORMATION.
DE15 REMOVE CONCRETE EQUIPMENT PAD AND/ OR CURB. SEE MECHANICAL FOR ADDITIONAL INFORMATION.
DE16 REMOVE ALUMINUM WINDOW SYSTEM AND ALL ASSOCIATED HARDWARE.
DE17 REMOVE PORTION OF CONCRETE BLOCK WALL, HOLLOW METAL, DOOR FRAMES AND WOOD DOORS. SEE PLANS FOR ADDITIONAL INFORMATION.
DE18 REMOVE METAL COUNTER WEIGHT SYSTEM AND ALL ASSOCIATED HARDWARE.
DE19 REMOVE CONCRETE AND METAL PAN STAIRS, RAILING, STRINGERS AND ALL ASSOCIATED HARDWARE.
DE20 SAW CUT CONCRETE CURB AT BASE OF PARTITION. GRIND FLOOR LEVEL AND PREP FOR FINISHES AS SCHEDULED.
DE21 REMOVE METAL STAIRS, RAILING, STRINGERS AND ALL ASSOCIATED HARDWARE.
DE22 REMOVE ELEVATOR HOIST EQUIPMENT AND SWITCH GEAR. SEE MECHANICAL AND ELECTRICAL FOR ADDITIONAL INFORMATION.
DE23 REMOVE CONCRETE FLOOR STRUCTURE AND CMU WALLS TO FLOOR BELOW. SEE PLAN FOR ADDITIONAL WORK IN THIS AREA.
DE24 REMOVE DOOR, FRAME AND ALL ASSOCIATED HARDWARE. SALVAGE FOR REINSTALLATION. SEE PLAN.
DE25 REMOVE PLYWOOD AND ALL ASSOCIATED INFILL MATERIAL BEHIND PLYWOOD AT OPENING IN WALL. PREP OPENING FOR WINDOW. SEE PLAN FOR ADDITIONAL INFORMATION.
DE26 REMOVE ENTIRELY CONCRETE RAMP-SEE CIVIL DRAWINGS.
DE27 REMOVED RADIATOR. PATCH WALL TO MATCH. SEE MECHANICAL FOR ADDITIONAL INFORMATION.
DE28 REMOVE FRITTED / PRIVACY INSULATED GLASS INSERT, WINDOW FRAME TO REMAIN. SEE PLANS FOR ADDITIONAL INFORMATION.
DE29 REMOVE ROOF MOUNTED HVAC MECHANICAL AND / OR ROOF DRAIN. SEE MECHANICAL, PLUMBING AND ELECTRICAL FOR ADDITIONAL INFORMATION.
DE30 REMOVE WALL AND FLOOR EXPANSION JOINT COVERS AND ALL ASSOCIATED HARDWARE.
DE31 REMOVE SIGN. SALVAGE FOR REINSTALLATION. SEE PLAN FOR ADDITIONAL INFORMATION.
DE32 REMOVE CEILING IN THIS AREA AS REQUIRED FOR MEP WORK. SALVAGE CEILING WHERE APPROPRIATE FOR REINSTALLATION. SEE PLANS FOR ADDITIONAL WORK.
DE33 REMOVE METAL LADDER WITH CAGE AND METAL PLATFORM WITH STEEL SUPPORT SYSTEM ABOVE, APPROXIMATELY 19'-0". SALVAGE AND RETURN TO OWNER.
DE34 REMOVE DOORS. FRAME TO REMAIN.
DE35 REMOVE AND MODIFY TOP PORTION OF WALL FOR NEW MECH PENETRATION. PATCH AS NEEDED.
DE36 REMOVE WDWs AS REQUIRED FOR MECH WORK.
DE37 REMOVE INFILL @ EXISTING DOOR OPENING. RESTORE TO ORIGINAL.
DE38 REMOVE ENTIRELY CURTAINWALL & BRICK/MASONRY SILL WALL. SEE PLAN FOR ADDITIONAL INFORMATION.
DE39 REMOVE CONC STAIRS AS NEEDED TO INSTALL NEW PATIO. SEE CIVIL DRAWINGS FOR ADDITIONAL DEMO.
DE40 REMOVE HOLLOW METAL FRAME(S). SEE PLAN FOR ADDITIONAL INFORMATION.
DE41 REMOVE MASONRY WALL AS REQUIRED FOR DOOR AS SCHEDULED.
DE42 REMOVE TEXTURED GLASS WINDOW PANES FOR NEW WINDOW PANE INSTALL. SALVAGE WINDOW GRILLE FOR REINSTALL SEE ELEVATIONS FOR EXTENT.
DE43 REMOVE LOUVER & PANEL INFILLS AT WINDOW OPENINGS. SEE ELEVATIONS FOR EXTENT.
DE44 REMOVE ENTIRELY PAINT ON STONE TRIM AROUND WINDOW/DOOR OPENING.
DE45 REMOVE CRACKED AND FLAKED PAINT AND CLEAN & PREP ELEMENTS OF FIREPLACE AS NEEDED TO RESTORE TO ORIGINAL. SEE ELEVATION & ENLARGED PLAN FOR NOTES FOR ADDITIONAL PREP WORK.
DE46 SAWCUT OPENINGS IN CONC FLOOR PLANK AS REQUIRED FOR MECH DUCT PENETRATIONS. SEE MECH DRAWINGS FOR ADD NOTES & EXTENT.
DE47 REMOVE MAS BLOCK AND PLASTER FINISH AT ORIGINAL OPENING TO PULPIT. PATCH & PREP WALL & FLOOR TO MATCH ADJACENT FINISHES.
DE48 CLEAN & PREP ALL INTERIOR SURFACES OF WDW FRAMES TO RECEIVE TO FINISH.
NOTE: NOT ALL KEYED NOTES MAY BE USED ON EACH PLAN.

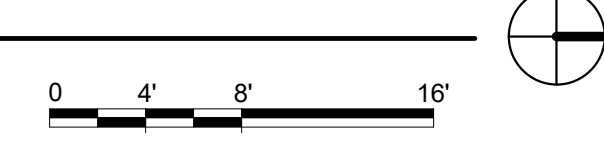DEMOLITION GENERAL NOTES

- 1. GENERAL CONTRACTOR SHALL COORDINATE ALL DEMOLITION WORK, PHASING AND SEQUENCING WITH THE OWNER. ANY INFORMATION REGARDING SEQUENCING PROVIDED IN THESE DOCUMENTS IS FOR ARCHITECT - OWNER PLANNING PURPOSES ONLY, UNLESS NOTED OTHERWISE.
2. GENERAL CONTRACTOR SHALL BE RESPONSIBLE FOR COORDINATING WITH ALL TRADES FOR THE DEMOLITION WORK REQUIRED FOR THIS PROJECT.
3. WHERE PARTITIONS ARE INDICATED TO BE REMOVED, REMOVE PARTITION ALONG WITH ALL ITEMS CONTAINED WITHIN, INCLUDING DOORS, FRAMES, HARDWARE, SIDELIGHTS, WINDOWS, MECHANICAL AND ELECTRICAL EQUIPMENT, ETC. TO STRUCTURE ABOVE, UNLESS NOTED OTHERWISE.
4. WHERE FLOOR FINISH IS INDICATED TO BE DEMOLISHED, REMOVE FINISH TO FLOOR SLAB AS REQUIRED AND PREPARE SLAB SURFACE FOR SCHEDULED FINISHES WITHIN AREA TO BE DEMOLISHED. UNLESS NOTED OTHERWISE, SEE FINISH SCHEDULE FOR EXISTING FLOOR FINISHES TO REMAIN UNDISTURBED.
5. WHERE CEILING IS INDICATED TO BE DEMOLISHED, REMOVE CEILING SUSPENSION SYSTEM ALONG WITH ALL ASSOCIATED MECHANICAL AND ELECTRICAL ITEMS, UNLESS NOTED OTHERWISE. SEE MECHANICAL AND ELECTRICAL DRAWINGS FOR EXTENT OF CONDUIT, PIPING AND DUCTWORK DEMOLITION WITHIN AREA TO BE REMOVED.
6. WHERE INDICATED, REMOVE ALL WALL/PARTITION EXISTING FINISHES AND PREPARE THE SURFACES FOR SCHEDULED FINISHES. SEE FINISH SCHEDULE FOR FINISHES.
7. ALL DISTURBED AREAS, WALLS, PARTITIONS, FLOORS, ETC. DAMAGED BY DEMOLITION WORK SHALL BE PATCHED TO MATCH ADJACENT AREA.
8. OWNER RESERVES THE RIGHT OF FIRST REFUSAL OF ALL SALVAGED ITEMS SUCH AS: DOORS, LIGHT FIXTURES, PLUMBING FIXTURES, ETC.
9. SALVAGED ITEMS SCHEDULED FOR REUSE SHALL BE CLEANED, RESTORED AND/OR REFINISHED TO LIKE NEW CONDITION, UNLESS NOTED OTHERWISE.
10. DO NOT REMOVE ANY EXISTING STRUCTURAL SUPPORT MEMBERS SUCH AS COLUMNS, BEAMS, JOISTS, LOAD-BEARING PARTITIONS, ETC. UNTIL ADEQUATE PERMANENT OR TEMPORARY SUPPORT IS IN PLACE. ALL EXISTING STRUCTURAL MEMBERS SHALL BE ADEQUATELY PROTECTED, COORDINATE WITH STRUCTURAL ENGINEER.
11. SEE STRUCTURAL, MECHANICAL AND ELECTRICAL DRAWINGS FOR RELATED DEMOLITION AND PREP WORK.
12. WALL AND CEILING MOUNTED ITEMS SHOWN DASHED, SUCH AS WALL CABINETS, SHELVING, CURTAIN TRACKS, PROJECTION SCREENS, ETC. SHALL BE REMOVED, UNLESS NOTED OTHERWISE.
13. WITHIN ALL EXISTING ROOMS/SPACES RECEIVING SCHEDULED FLOOR, OR WALL, OR CEILING FINISHES, REMOVE ALL EXISTING FLOOR, OR WALL, OR CEILING FINISHES DOWN TO THE SUBSTRATE. INCLUDE THE REMOVAL OF ALL ITEMS LOCATED WITHIN THE EXISTING FINISH REMOVALS AND PATCH AND PREP ALL SUBSTRATES TO RECEIVE SCHEDULED FINISHES FOR ADDITIONAL INFORMATION. SEE KEYNOTED ITEMS, FINISH PLANS AND/OR SCHEDULES, STRUCTURAL, MECHANICAL AND ELECTRICAL.

DEMOLITION PLAN SYMBOLS

Table with 3 columns: Symbol, Description, Key Note. Includes symbols for existing wall to remain, wall to be removed, dashed line for items to be removed, and gridline.

NOTE: COORDINATE GENERAL DEMOLITION WORK WITH ABATEMENT AND REMEDIATION WORK.

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Revisions table with columns for Revisions and Date.

CONSULTANT: AST and FARRIS ENGINEERING logos and contact information.

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Drawing Title: GROUND LEVEL DEMOLITION PLAN - BUILDING 5. Approved: [Signature]

Phase: CONSTRUCTION DOCUMENTS. FULLY SPRINKLERED.

Project Title: RENOVATE OLD CHAPEL AND AUDITORIUM. Location: Sioux Falls, SD. Issue Date: 05/15/2020. Checked: --. Drawn: GJB.

Project Number: 438-19-301. Building Number: 1 & 5. Drawing Number: AD101-05.