				ICAL SYMBOLS SCHEDULE HENSIVE SYMBOLS SCHEDULE, NOT ALL SYMBOLS ARE APPLICABLE TO THESE DRAWINGS						
MBOLS	DESCRIPTION	SYMBOLS	DESCRIPTION		SYMBOLS	DESCRIPTION	SYMBOLS	DESCRIPTION	SYMBOLS	DESCRIPTION
	PLUMBING		GENERAL PIPING SYMBOLS	DRAWING SYMBOLS		H.V.A.C. SYMBOLS				CONTROLS SYMBOLS
0	CLEANOUT		UNION	DETAIL NUMBER					T	ROOM THERMOSTAT/TRANSMITTER - WALL MOUNT
	FIXTURE TRAP FLOOR DRAIN		PIPE UP	H4 DRAWING NUMBER WHERE DRAWN	\uparrow				M	
	FLOOR SINK	——————————————————————————————————————	PIPE DOWN	SECTION LETTER		SUPPLY DIFFUSER		POWER ROOF VENTILATOR	M	ROOM HUMIDISTAT (MOISTURE)/TRANSMITTER - WALL MOUNT
	VENT THROUGH ROOF	— ю—	TEE OUTLET, UP	A SECTION LETTER DRAWING NUMBER WHERE SHOWN						TEMPERATURE TRANSMITTER
	FIXTURE TRAP (ISOMETRIC DIAGRAM)		TEE OUTLET, DOWN		<u> </u>			SUPPLY DUCT UP	(11)	TEMPERATURE TRANSMITTER, AVERAGING ELEMENT
	FLOOR DRAIN (ISOMETRIC DIAGRAM)	=	CAP ON END OF PIPE	BUILDING NO. WHERE EQUIPMENT IS LOCATED. EQUIPMENT ABBREVIATION (SUPPLY FAN)					(MT)	MOISTURE (HUMIDITY) TRANSMITTER
J	FLOOR SINK (ISOMETRIC DIAGRAM)		CROSS	SUPPLY FAN NO. 3 IN BUILDING NO. 26		RETURN DIFFUSER		SUPPLY DUCT DOWN	PT	PRESSURE TRANSMITTER
	PLUMBING PIPING SANITARY ABOVE GRADE		TEE	TYPICAL UNIT NO.				RETURN DUCT UP	(SPS)	STATIC PRESSURE SENSOR
	SANITARY BELOW GRADE		DIRECTION OF PIPE PITCH (DOWN)	BUILDING NO. WHERE EQUIPMENT IS LOCATED	$\not \!$	EXHAUST DIFFUSER				
	STORM DRAIN ABOVE GRADE		DIRECTION OF FLOW ANCHOR	ITEM (TERMINAL UNIT SHOWN)				RETURN DUCT DOWN	FT	FLOW TRANSMITTER
:===	STORM DRAIN BELOW GRADE		REDUCER OR INCREASER	11X-TU-I-I ITEM NUMBER (TERMINAL UNIT NO. 1)	1.0			EXHAUST DUCT UP		CURRENT TRANSMITTER
	VENT		ECCENTRIC REDUCER INVERTED BUCKET TRAP SET INCLUDING	SERVED BY AIR HANDLER UNIT NO. 1	N B-1 ±	VARIABLE VOLUME BOX		247.667.2667.67	(CT)——	CONDUCTIVITY TRANSMITTER
	ACID SANITARY ABOVE GRADE		PIPING ACCESSORIES SEE DETAIL		- -	SMOKE DAMPER		EXHAUST DUCT DOWN	SD	SMOKE DETECTOR
	ACID SANITARY BELOW GRADE ACID VENT		FLOAT & THERMOSTATIC TRAP SET INCLUDING PIPING ACCESSORIES SEE DETAIL		<u> </u>			AIR CURTAIN	PDT	PRESSURE DIFFERENTIAL TRANSMITTER
	COLD WATER		THERMOSTATIC TRAP SET INCLUDING PIPING ACCESSORIES SEE DETAIL		<u> </u>	FIRE DAMPER		AIR CURTAIN	PDS	PRESSURE DIFFERENTIAL SWITCH
	HOT WATER		TEST PLUG (PRESSURE/TEMPERATURE)	GENERAL NOTES:	F				HS	HAND SWITCH (HAND-OFF-AUTO SWITCH)
	CIRCULATING HOT WATER		AUTOMATIC AIR VENT	DUCT SIZE IS THE SAME AS DIFFUSER NECK SIZE UNLESS OTEHRWISE NOTED.		BALANCING DAMPER		FILTER BANK	ZC	VALVE OR DAMPER POSITION CONTROLLER
	REVERSE OSMOSIS WATER	<u> A'</u>		DIFFUSER LEGEND	i					
—	DEIONIZED WATER	<u>字</u> w	MANUAL AIR VENT	2410S		TURNING VANES		CABINET UNIT HEATER	(KR)	LOCAL RECORDING TIME CLOCK (RUNTIME)
— 	DISTILLED WATER HOSE BIBB	c	QUICK-COUPLE HOSE CONNECTOR	S = SURFACE L = LAY-IN					(TSL)	TEMPERATURE SWITCH, LOW (FREEZESTAT)
- 	WATER HAMMER ARRESTOR	3- ⊘	PRESSURE GAUGE	E = EXISTING INDICATES NECK SIZE EITHER SQUARE DIMENSION OR THE DIAMETER.					(TSH)	TEMPERATURE SWITCH, HIGH (FREEZESTAT)
<u>X</u>	PLUMBING FIXTURE TYPE	3==	TEMPERATURE GAUGE	INDICATES DIFFUSER SIZE, INCHES SQUARE.		STANDARD RADIUS ELBOW		UNIT HEATER	LC	LEVEL CONTROLLER
7	KEY NOTE		VALVE SYMBOLS	REFER TO REFLECTED CEILING PLAN FOR EXACT LOCATIONS OF ALL CEILING DIFFUSERS. ALL DIFFUSERS ARE 4-WAY THROW UNLESS INDICATED OTHERWISE			↓		(LT)	LEVEL TRANSMITTER
-	PIPE SLOPE AS NOTED		GATE VALVE - THREADED/FLANGED	ON PLANS BY A HATCHED AREA.	\^\^	OPPOSED BLADE DAMPER			(PSH)	PRESSURE SWITCH HIGH
5	BACKFLOW PREVENTER		GLOBE VALVE - THREADED/FLANGED GATE VALVE WITH 3/4" HOSE ADAPTER	VARIABLE VOLUME BOX SCHEDULE			\downarrow			
1	CHECK VALVE		CHECK VALVE WYE STRAINER (WITH BALL VALVE AND	THIS SYMBOL ON THE PLANS INDICATES THE	(T)	THERMOSTAT		CEILING MOUNTED CABINET	(PSL)	PRESSURE SWITCH LOW
1	BALANCING VALVE		HOSE CONNECTOR)	VALVE BUNDLE AND THE G.P.M.	H	HUMIDISTAT		UNIT HEATER	(EPT)	ELECTRONIC TO PNEUMATIC TRANSDUCER
		Ta Ta	WYE STRAINER WITH VALVED DRAIN AND QUICK-COUPLE HOSE CONNECTOR)	TYPE 1.0					AT CO2	CARBON DIOXIDE TRANSMITTER
			ANGLE GLOBE VALVE BUTTERFLY VALVE	A-3		IN-LINE FAN	•		AT	CARBON MONOXIDE TRANSMITTER
			MODULATING CONTROL VALVE	SIZE					CO	SALESTANGITE AND THE WAR AND T
		— Й ——	MODULATING CONTROL BUTTERFLY VALVE	BOX SIZE CFM RANGE BOX TYPE	12"~	ROUND DUCT		AIR COOLED CONDENSING UNIT	(AT) OC	OCCUPANCY SENSOR
			TWO POSITION CONTROL VALVE	"A" 0-199 1 33% MIN. AIR FLOW - 40° RISE @ LOW FLOW 2 CONSTANT VOLUME - 40° RISE @ HIGH FLOW		OVAL PUOT			LTCP	LOCAL TEMPERATURE CONTROL PANEL
			THREE-WAY MODULATING CONTROL VALVE	"C" 400-599 3 HIGH - LOW - HIGH - 40° RISE @ HIGH FLOW "D" 600-799 4 33% MIN. AIR FLOW - NO REHEAT		OVAL DUCT	HPS	HIGH PRESSURE STEAM	HVAC	HVAC CONTROL PANEL
			THREE-WAY TWO POSITION CONTROL VALVE	"E" 800-1199 "F" 1200-2400 NOTE: BOX SIZE "F" & "G" MAY BE TWO	12" x 8"	RECTANGULAR DUCT, (FACE OF DUCT IS LISTED FIRST)	PC	CONDENSATE PUMP DISCHARGE	VSMC	VARIABLE SPEED MOTOR CONTROLLER
		イ		"G" 2400 & UP PARALLEL BOXES		INCLINED RISE	LPS	LOW PRESSURE STEAM LOW PRESSURE STEAM CONDENSATE RETURN	(ECC)	INTEGRATE CONTROL POINT ON REMOTE GRAPHICS WORKSTATION
		— 	PRESSURE REGULATING VALVE			IN DIRECTION OF AIR FLOW	LFK	HEAT PUMP SUPPLY		ENERGY CONTROL CENTER
			PRESSURE SAFETY VALVE		D	INCLINED DROP IN DIRECTION OF AIR FLOW		HEAT PUMP RETURN	(TC)	TEMPERATURE CONTROLLER. SEE SEQUENCE OF OPERATION
			AUTOMATIC BALANCING CONTROL VALVE					STEAM SUPPLY	PC	PRESSURE CONTROLLER. SEE SEQUENCE OF OPERATION
			WATER BALANCE DEVICE					CONDENSATE RETURN	(sc)	SPEED CONTROLLER. SEE SEQUENCE OF OPERATION
			CIRCUIT SETTER VALVE				S. M	SNOW MELT SUPPLY	(FC)	FLOW CONTROLLER. SEE SEQUENCE OF OPERATION
			GATE VALVE WITH GLOBE-VALVED BYPASS PLUG VALVE				S. M	SNOW MELT RETURN		FLOW CONTROLLER. SEE SEQUENCE OF OPERATION
			CONTROL VALVE (CV) - FLOAT-OPERATED				G	GAS LINE DRAIN LINE	(FSH)	FLOW SWITCH HIGH
			PRESSURE REDUCING VALVE (PRV)						FSL	FLOW SWITCH LOW
			WATER LEVEL CONTROLLER FLOW METER						(KC)	TIME CLOCK CONTROLLING EQUIPMENT ON A SCHEDULE
			BALL VALVE							TEMPERATURE SENSING ELEMENT FOR
		<u></u> ⋈	GATE VALVE						lee -	TRANSMITTING TEMPERATURE TO EMCS (PROVIDE 12 INCHES [200mm] MINIMUM
			EXPANSION COMPENSATOR OR FLEXIBLE CONNECTOR						ee . ^	LENGTH IN DUCT WHEN SPACE PERMITS.)
		9	PUMP						lee A	SENSOR WITH AVERAGING ELEMENT TO TRANSMIT TEMPERATURE TO EMCS
		[[FLOW CONTROL VALVE							MOTOR STARTER
		(1.0) 	VALVE BUNDLE PRESSURE SENSOR (AIR SIDE)							
		P.D.							M	ELECTRIC OPERATED CONTROL DAMPER/OR VALVE


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					APPROVED: PROJEC

MECHANICAL SYMBOLS AND ABBREVIATIONS	PROJECT TITLE RELOCATE REHAB SERVICES 656-16-277 St. Cloud VA Health Care System	12/03/2018 PLOT SCALE NTS PROJECT NO.
APPROVED: CHIEF OF STAFF DATE:	BUILDING No CHECKED BY DRAWN XXX	
APPROVED: MEDICAL CENTER DIRECTOR DATE:	LOCATION VA MEDICAL CENTER ST. CLOUD, MN 56303	DRAWING NO. MOO 1





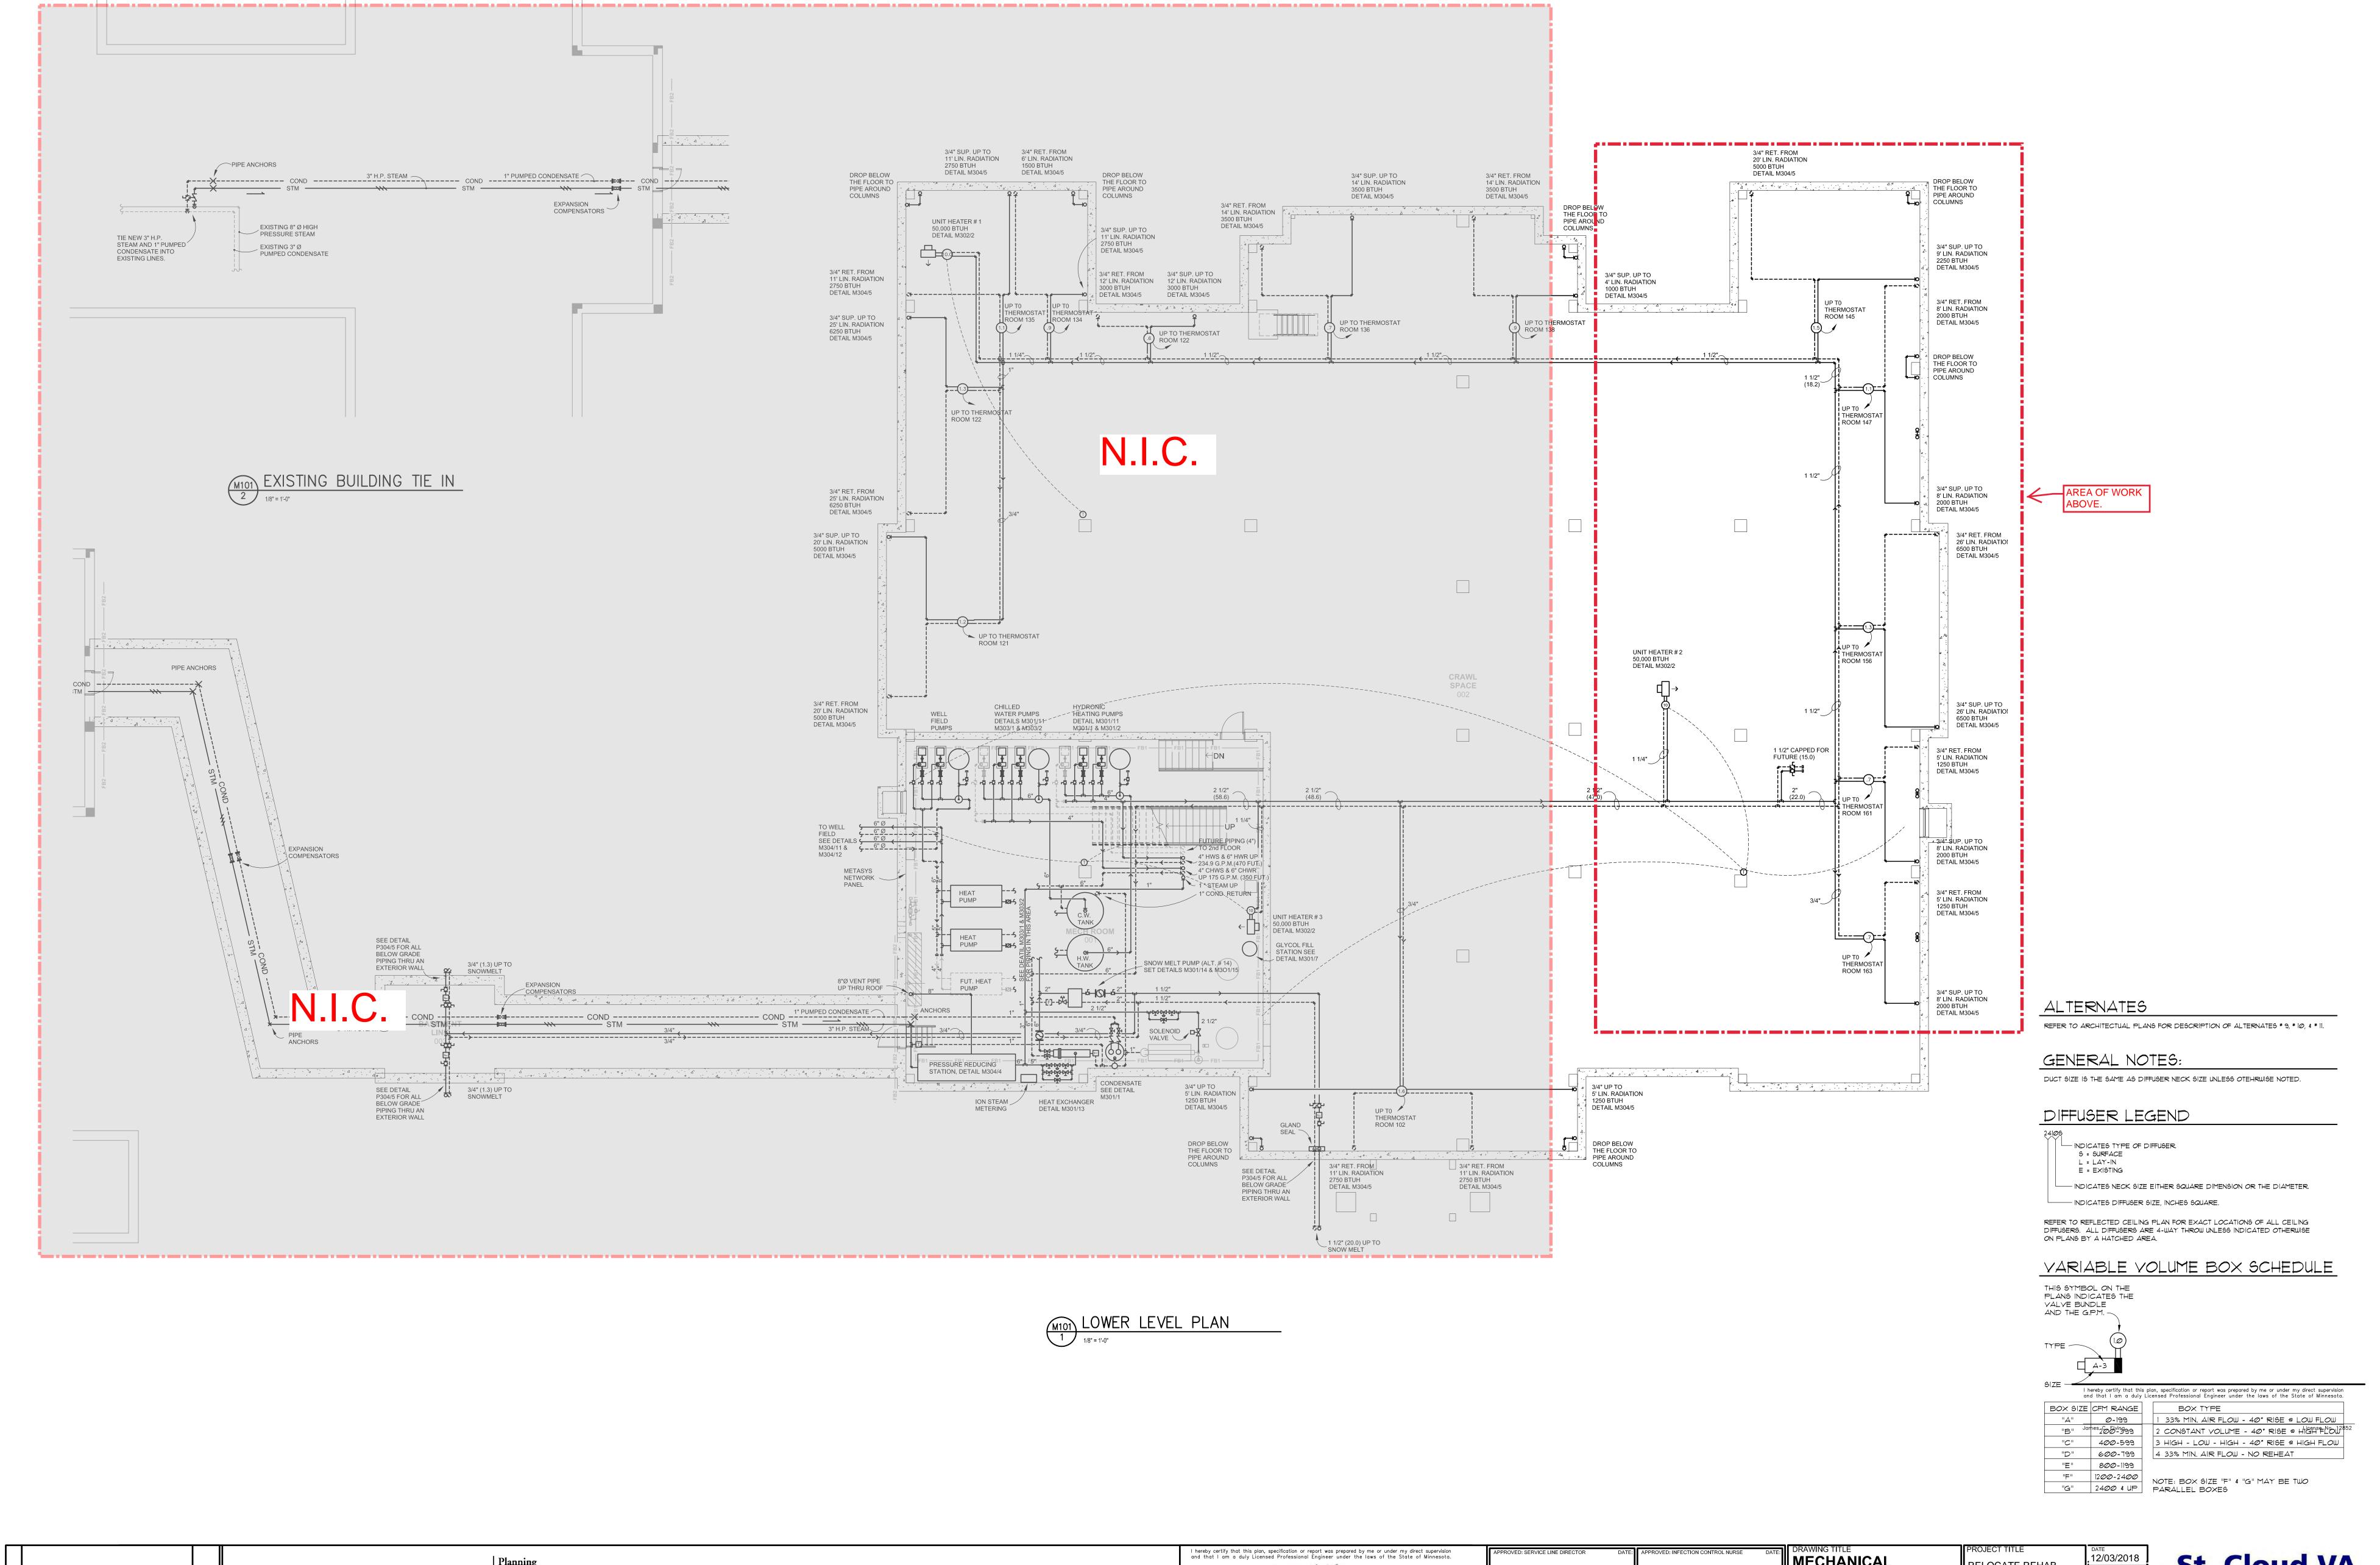

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DRAWING TITLE
MECHANICAL
HYDRONIC PIPING
LOWER LEVEL

APPROVED: PATIENT SAFETY

DATE:

APPROVED: CHIEF OF POLICE

DATE:

APPROVED: SAFETY MANAGER

DATE:

APPROVED: SAFETY MANAGER

DATE:

APPROVED: SAFETY MANAGER

DATE:

APPROVED: CHIEF OF STAFF

APPROVED: CHIEF OF STAFF

PROJECT TITLE
RELOCATE REHAB
SERVICES 656-16-277
St. Cloud VA Health Care System

PROJECT NO.


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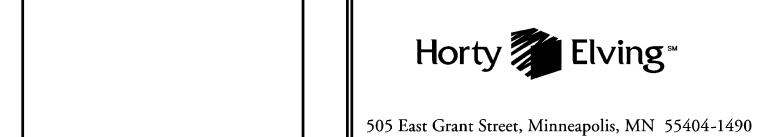
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DATE: LOCATION VA MEDICAL CENTER ST. CLOUD, MN 56303

DATE: VA MEDICAL CENTER ST. CLOUD, MN 56303





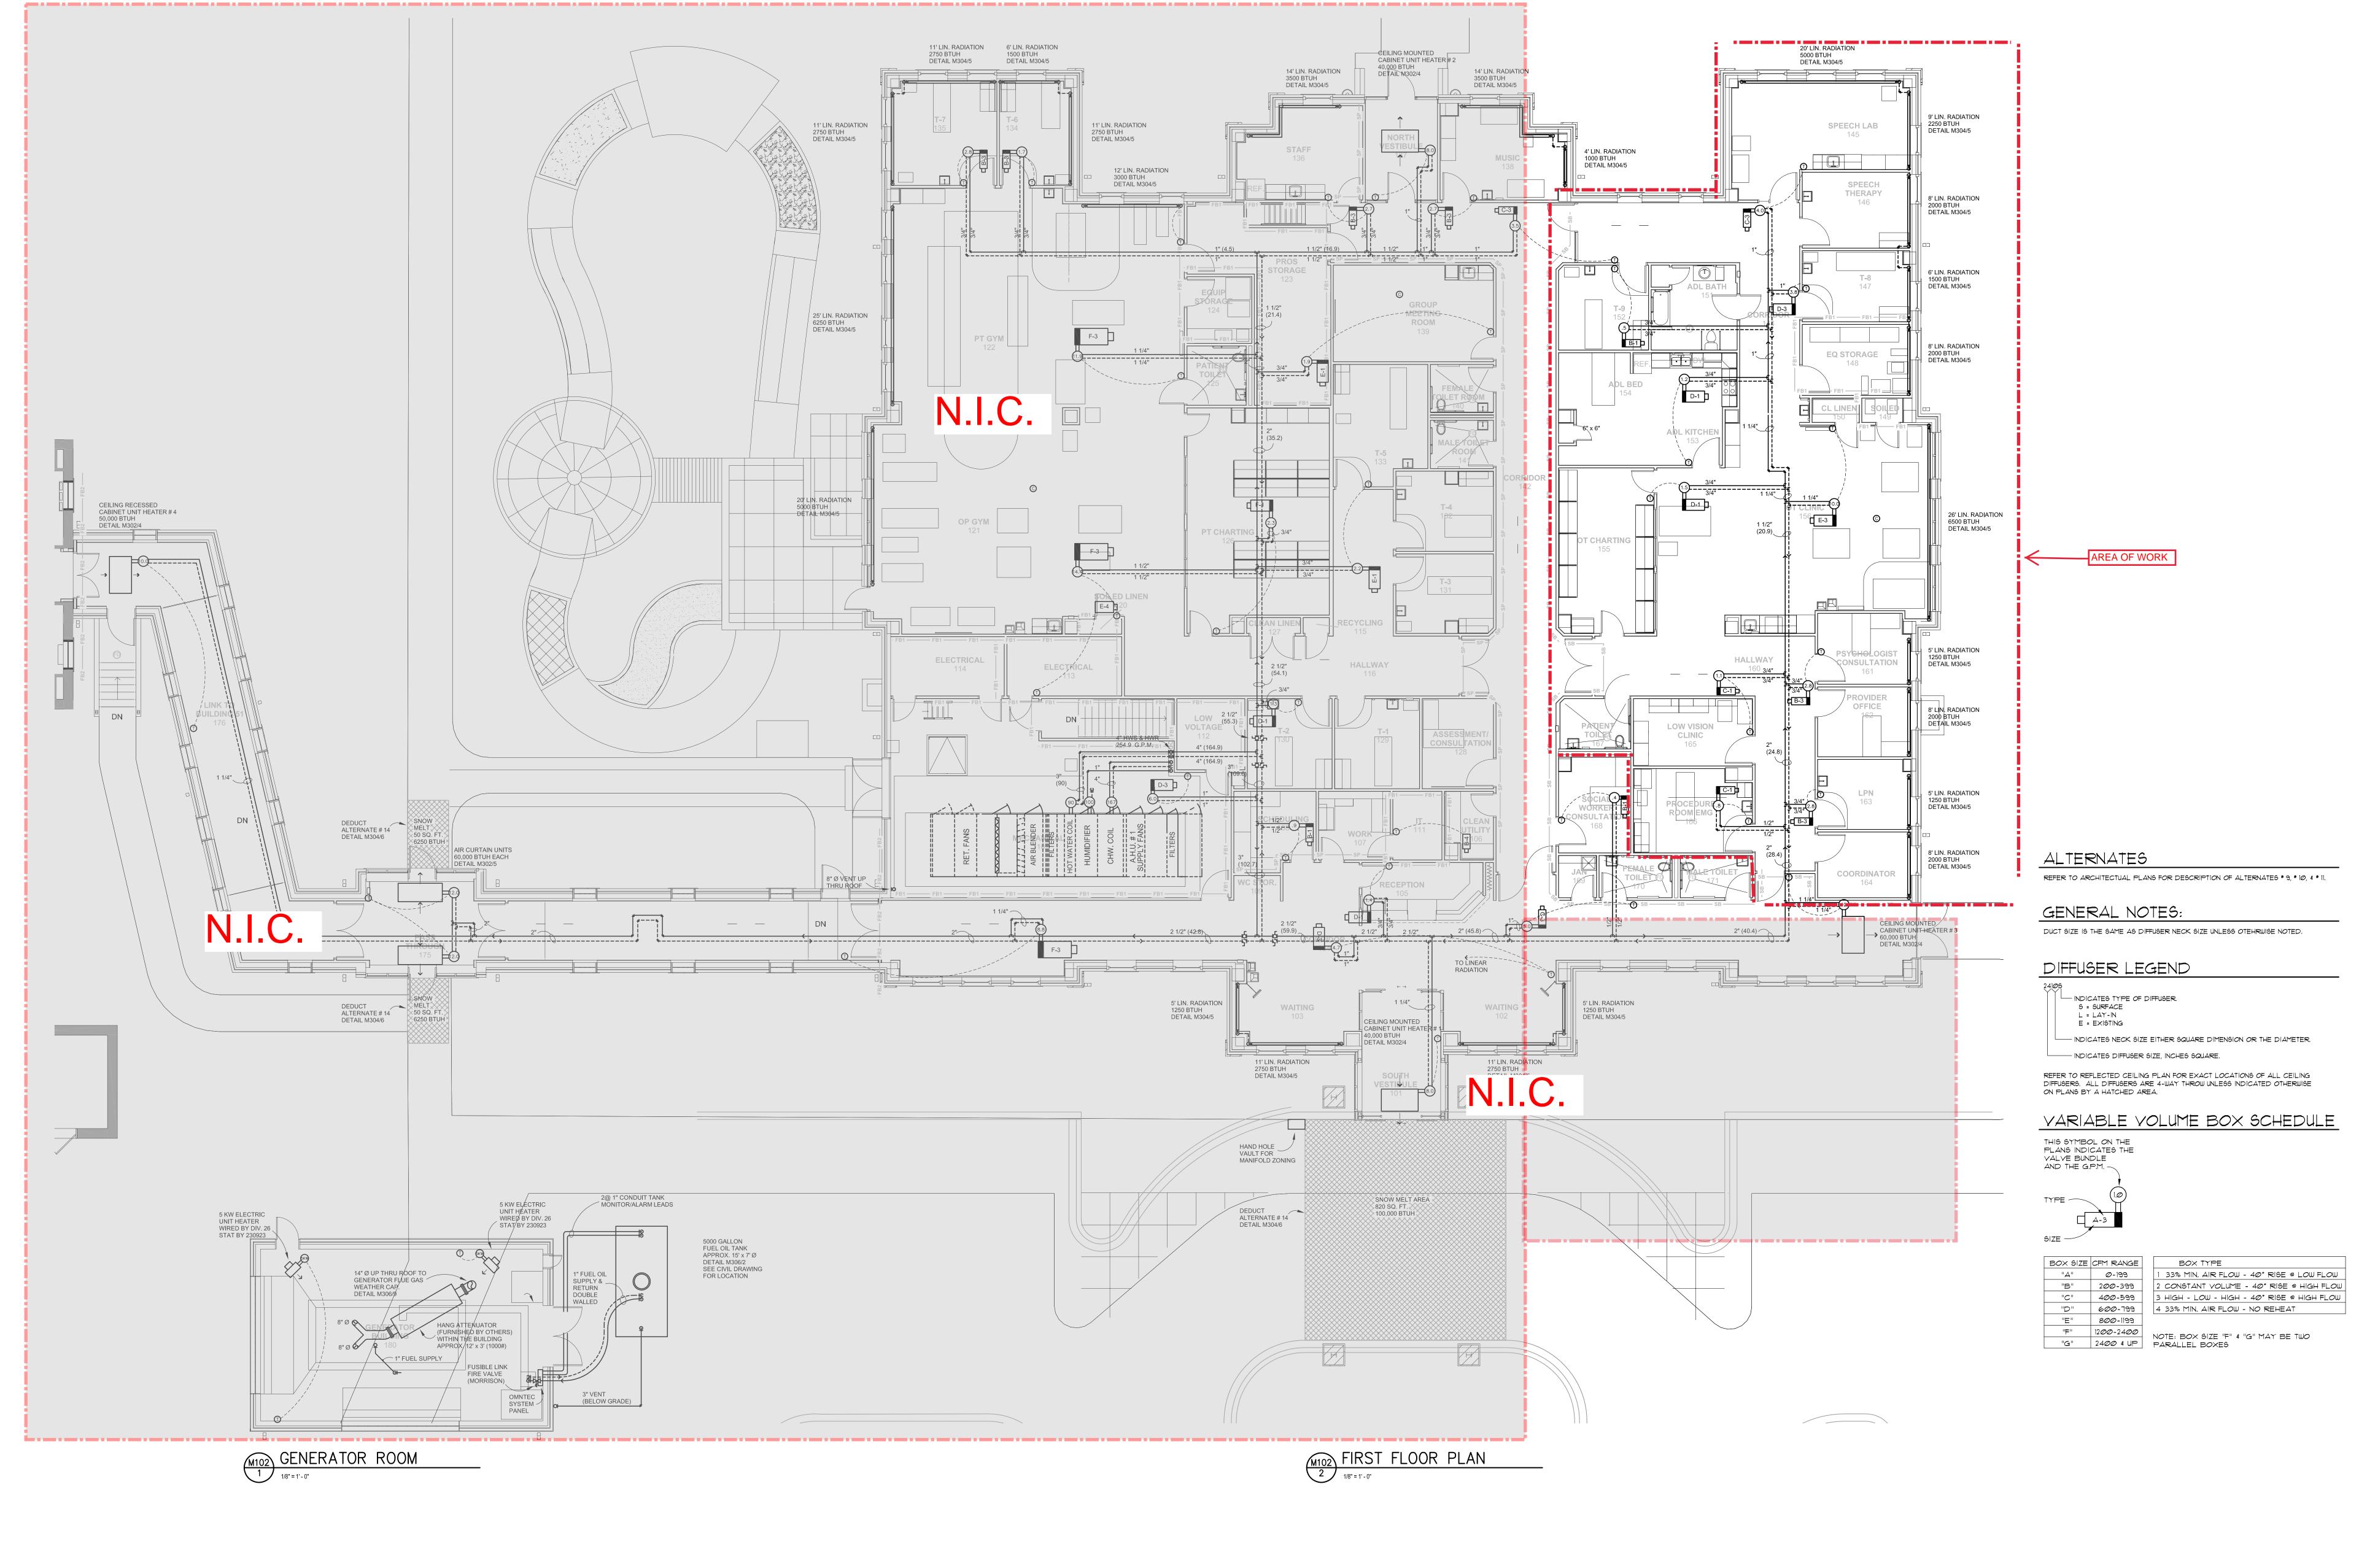

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PROJECT TITLE

MECHANICAL

HYDRONIC PIPING

FIRST FLOOR

APPROVED: CHIEF OF STAFF

DATE:

APPROVED: MEDICAL CENTER DIRECTOR

DATE:

LOCATION

VA MEDICAL CENTER

ST. CLOUD, MN 56303

DATE:

DATE:

12/03/2018

PLOT SCALE

1/8"=1'-0"

PROJECT TITLE

RELOCATE REHAB

SERVICES 656-16-277

St. Cloud VA Health Care System

PROJECT NO.

DATE:

12/03/2018

PLOT SCALE

1/8"=1'-0"

PROJECT TITLE

12/03/2018

PLOT SCALE

1/8"=1'-0"

PROJECT NO.

PROJECT NO.

DATE:

12/03/2018


PLOT SCALE

1/8"=1'-0"

PROJECT NO.

PROJEC



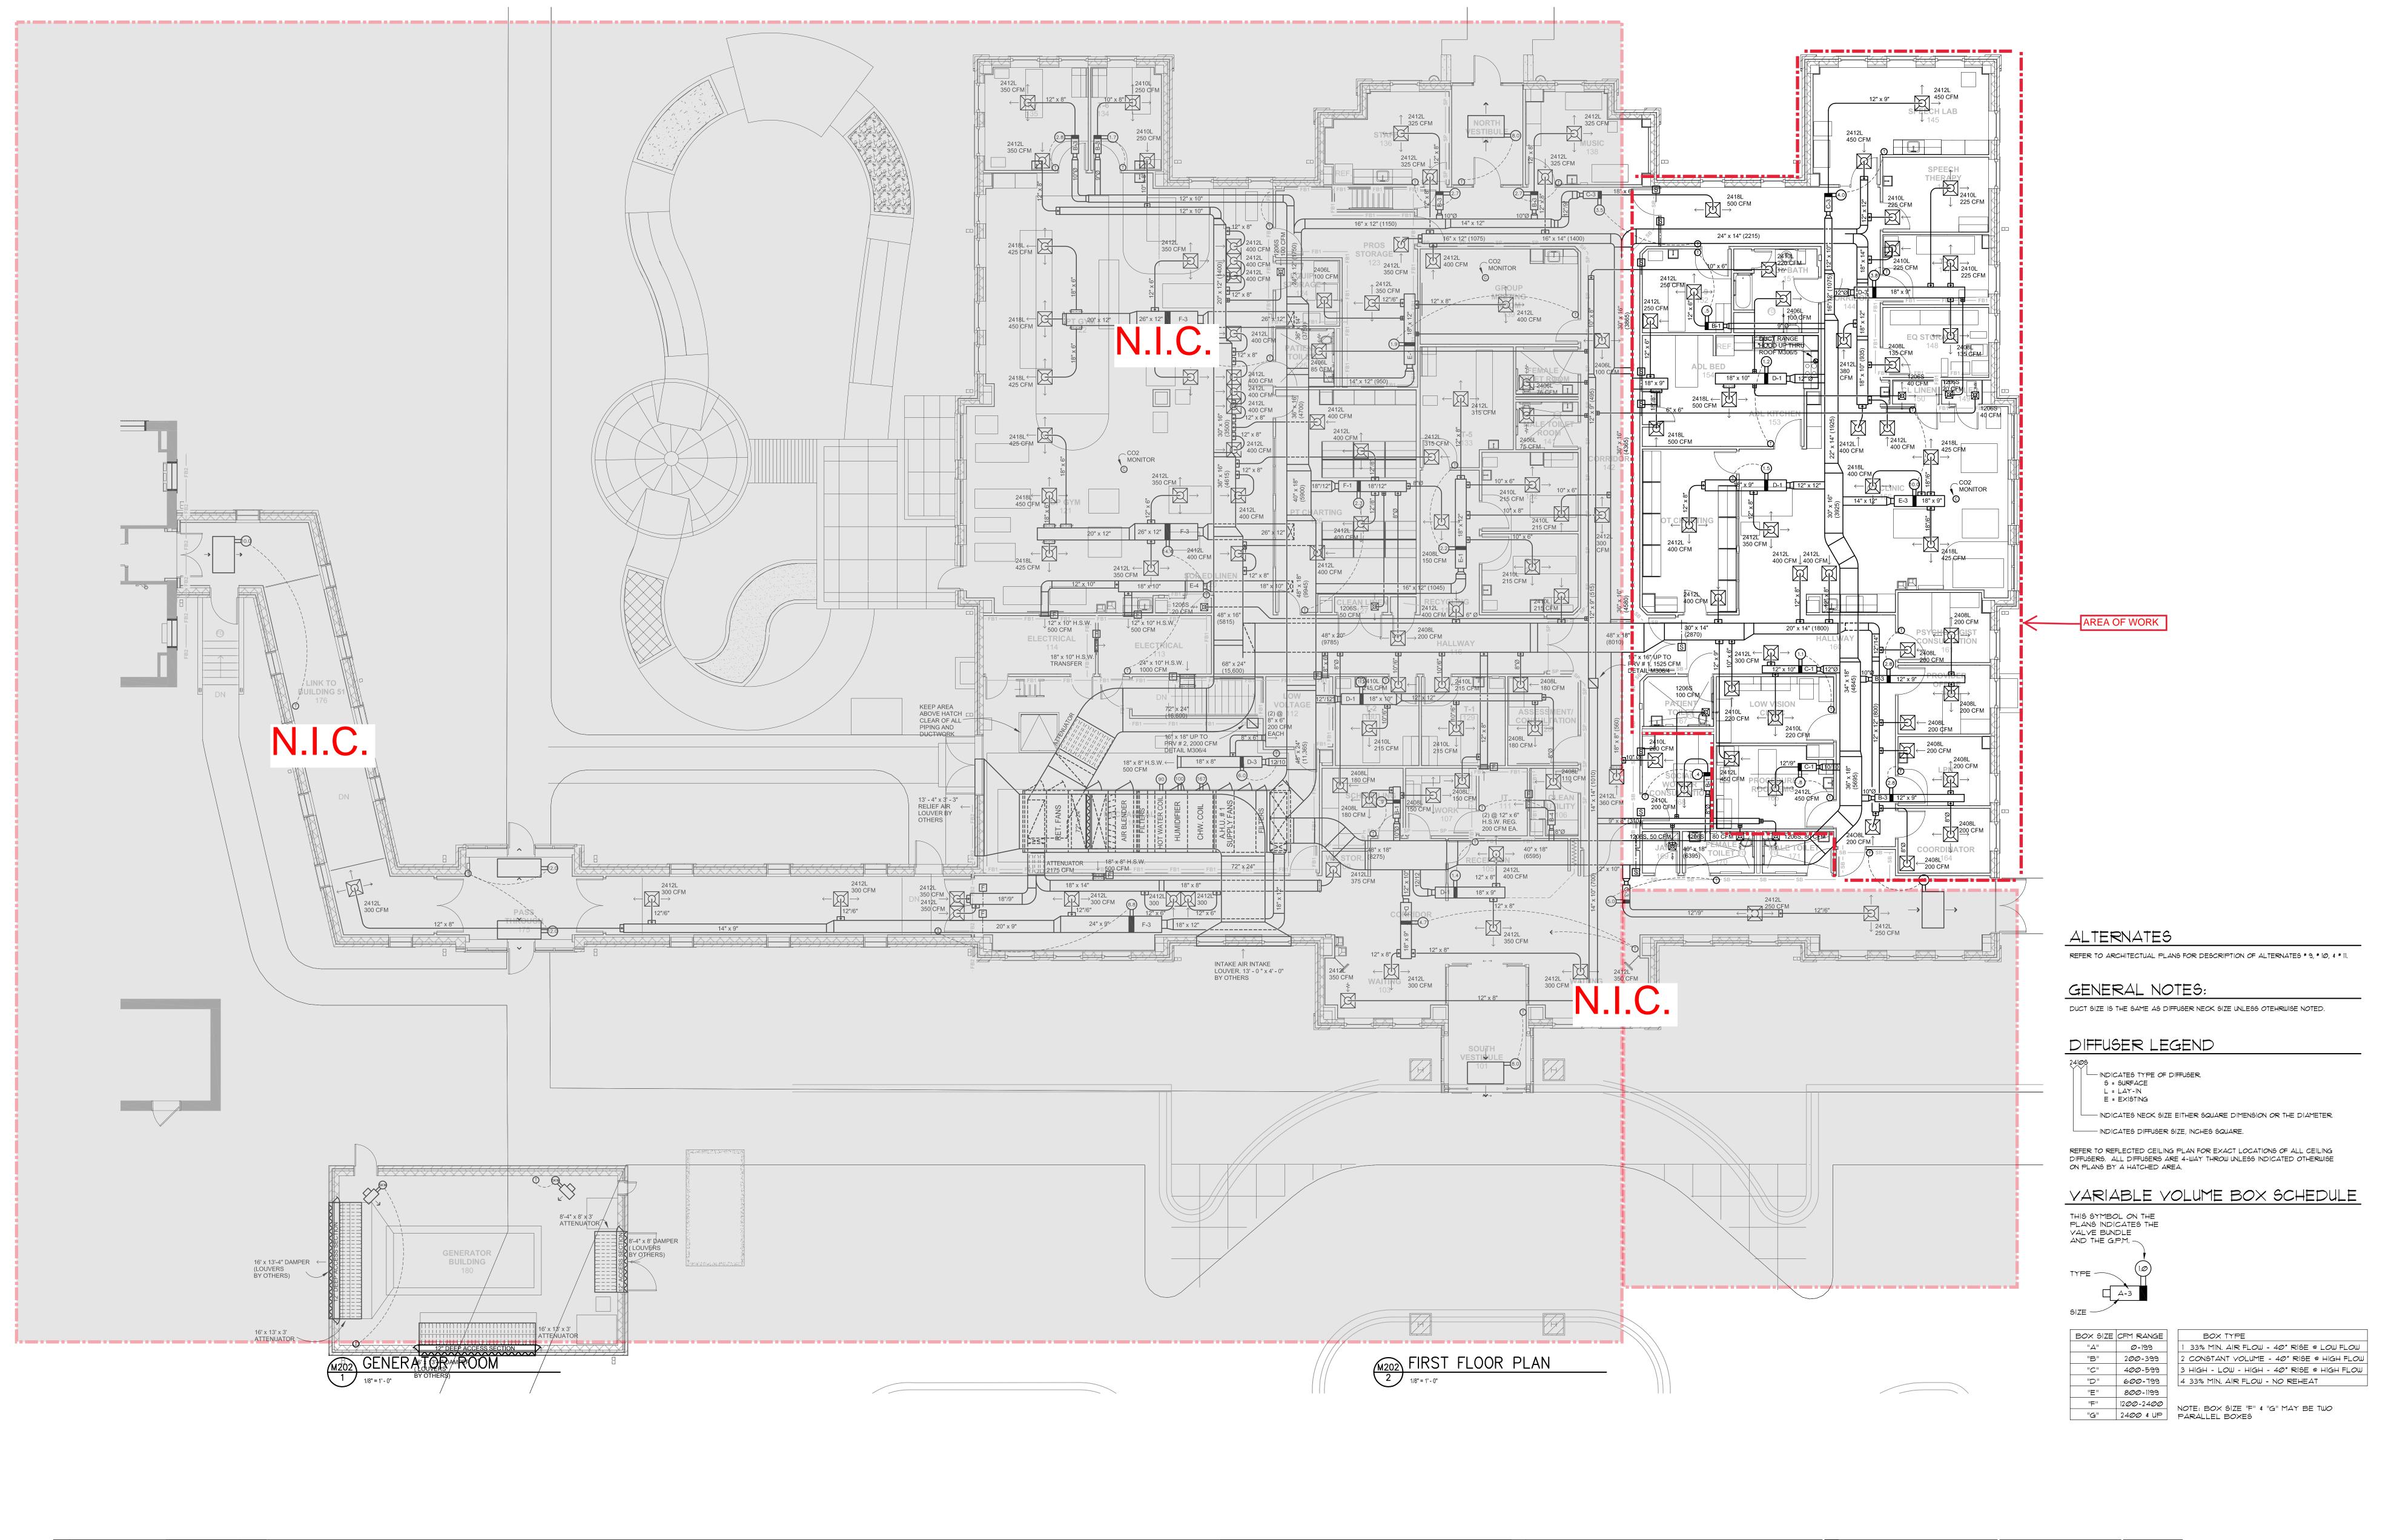



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MECHANICAL
VENTILATION
FIRST FLOOR

APPROVED: CHIEF OF STAFF

PROJECT TITLE

RELOCATE REHAB

SERVICES 656-16-277

St. Cloud VA Health Care System

E: BUILDING No XX


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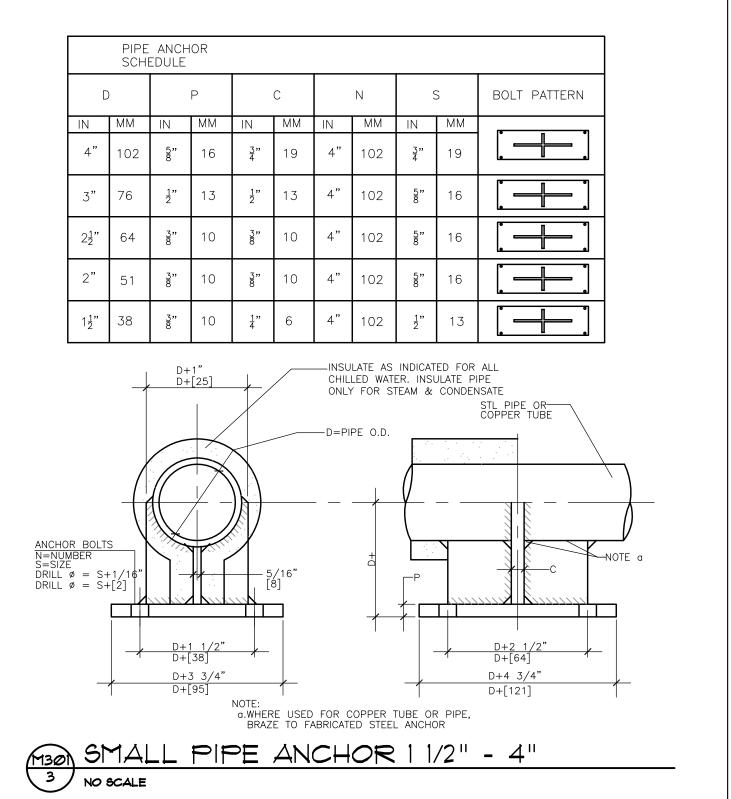
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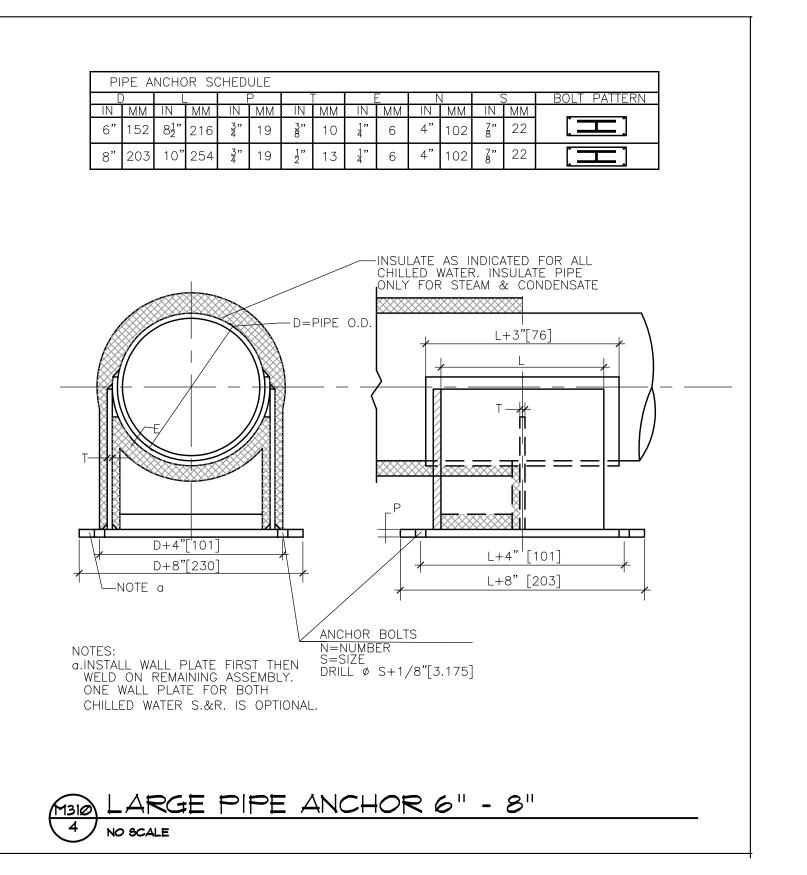
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VA MEDICAL CENTER ST. CLOUD, MN 56303 St. Cloud VA
Health Care System
Brainerd | Montevideo | Alexandria







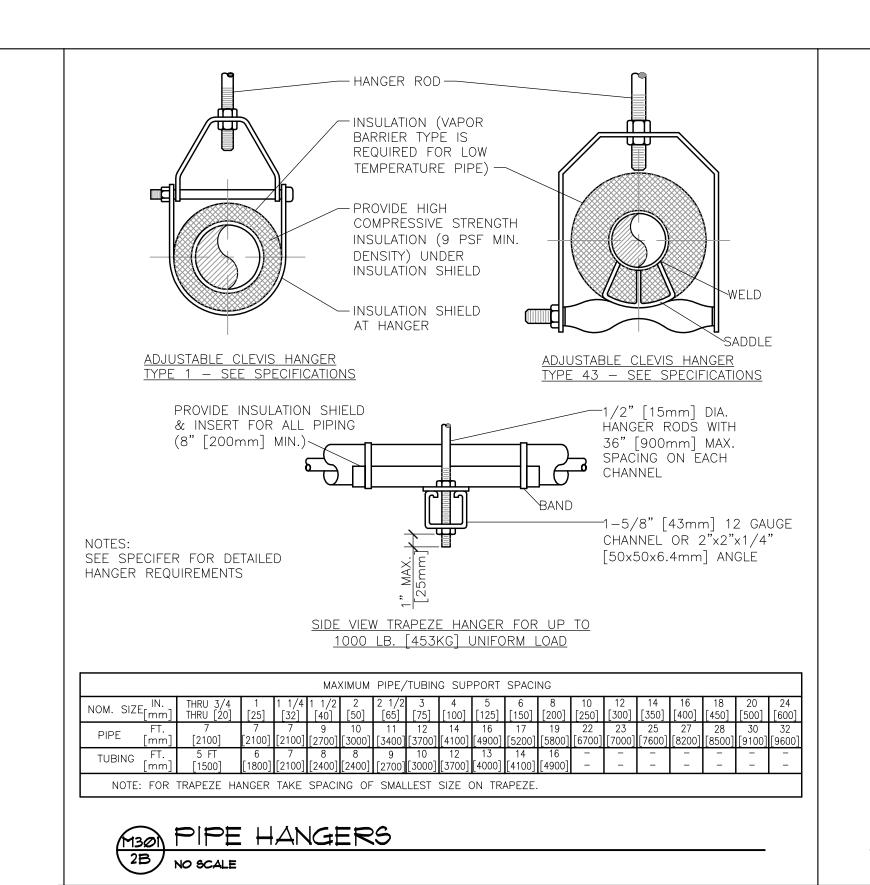

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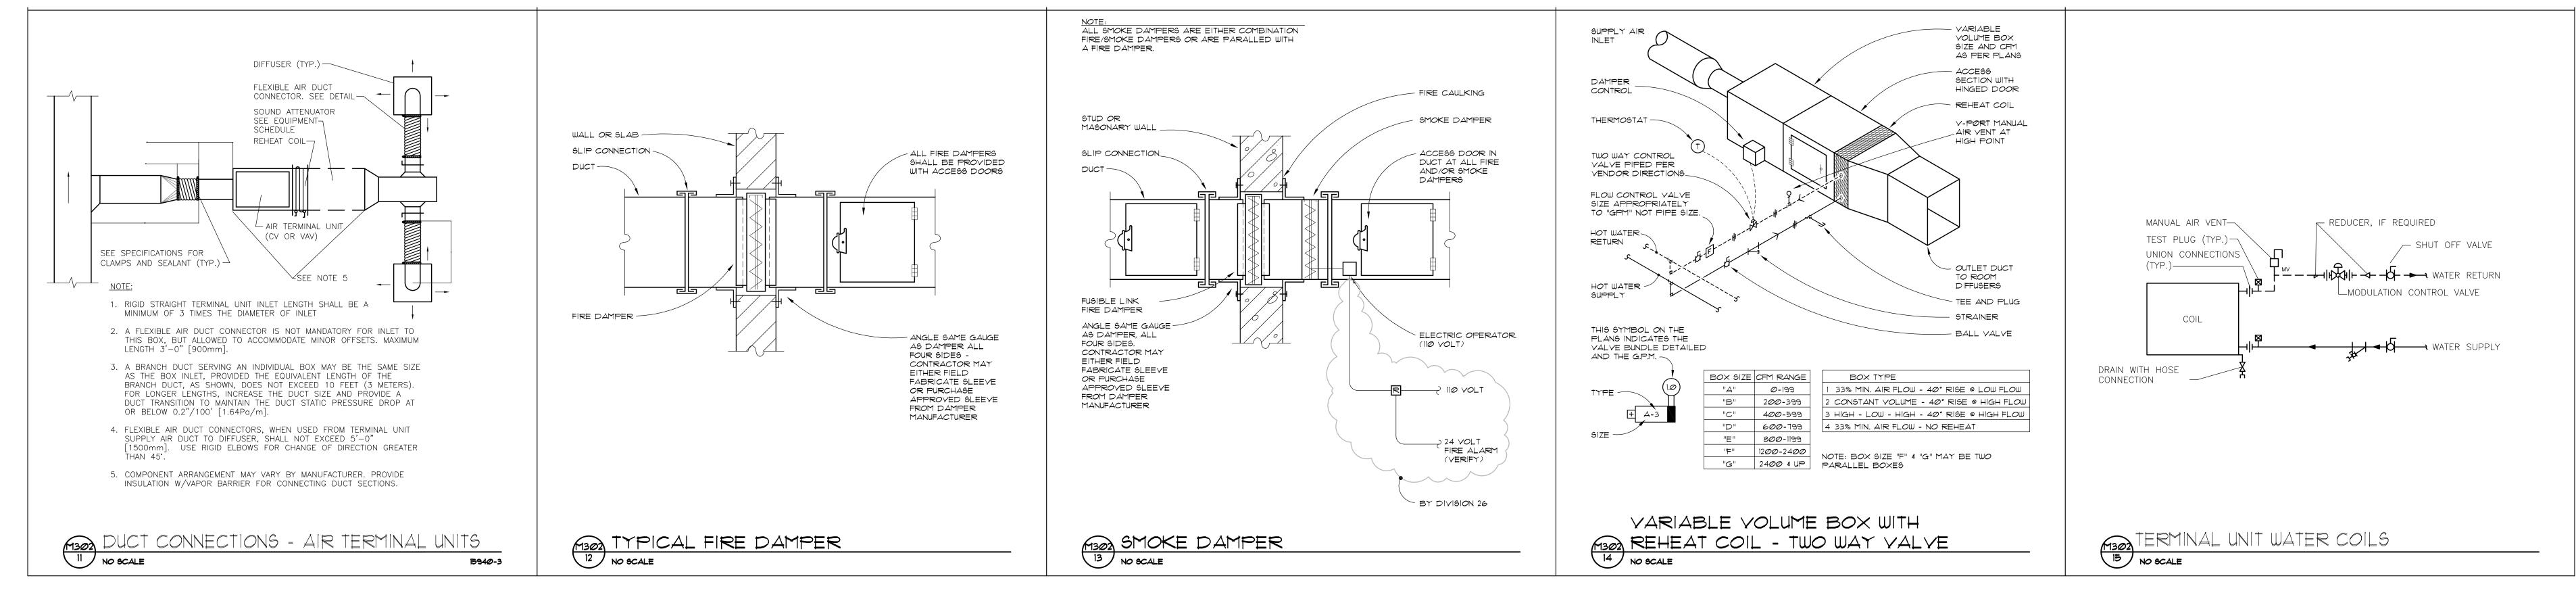
REVISION


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RDINATOR SECTION MANAGER		APPROVED: PATIENT SAFETY APPROVED: CHIEF OF POLICE	DATE:	DETAILS	SERVICES 656-16-277 St. Cloud VA Health Care System	PROJECT
				APPROVED: CHIEF OF STAFF DATE:	BUILDING No CHECKED BY DRAWN XXX	
FMS	DATE:	APPROVED: SAFETY MANAGER	DATE:	APPROVED: MEDICAL CENTER DIRECTOR DATE:	LOCATION VA MEDICAL CENTER ST. CLOUD, MN 56303	DRAWING







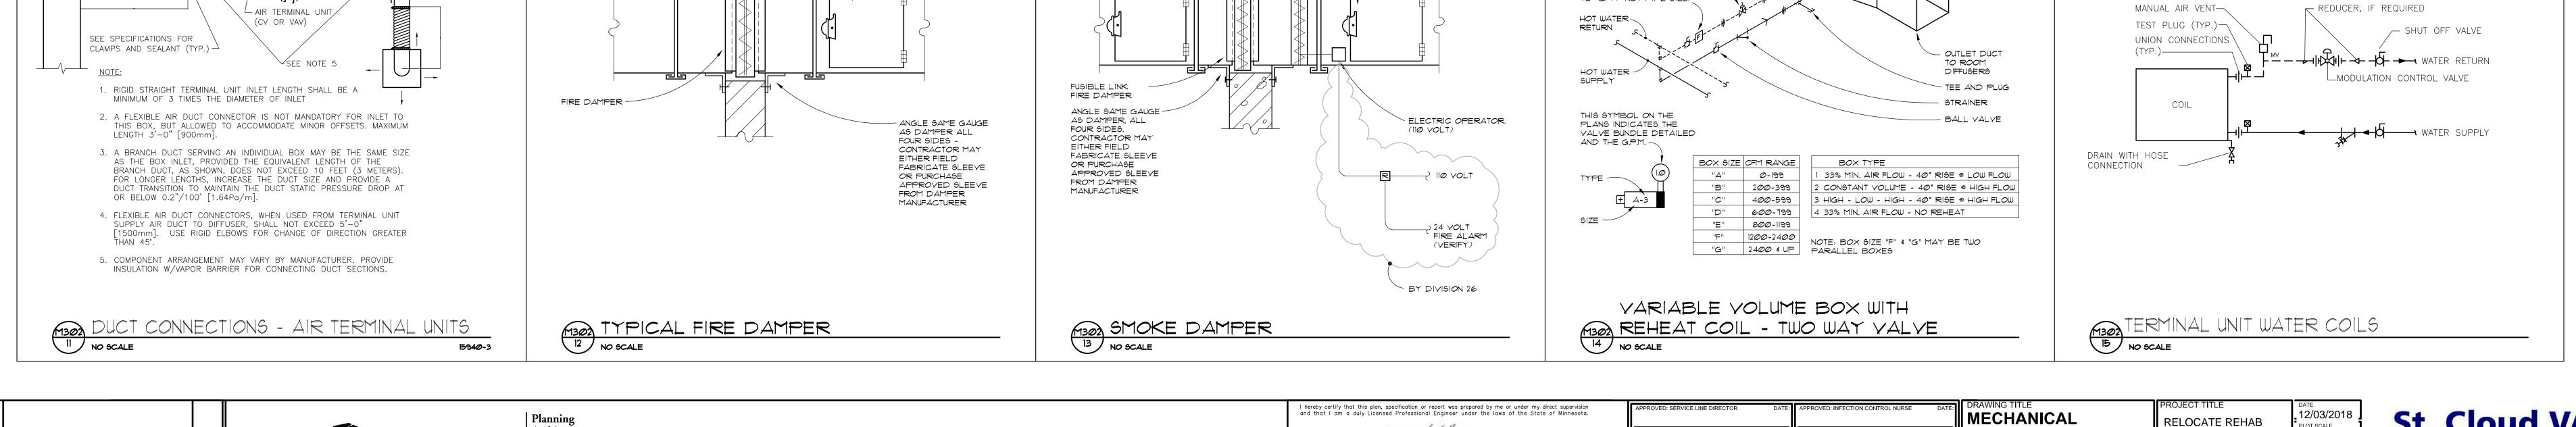


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RAWING TITLE TECHANICAL DETAILS	SERVIC	TTLE ATE REHA ES 656-10 A Health Ca	6-277	DATE 12/03/201 PLOT SCALE NTS PROJECT NO.
ROVED: CHIEF OF STAFF DATE:	BUILDING No	CHECKED BY	DRAWN XXX	
ROVED: MEDICAL CENTER DIRECTOR DATE:	LOCATION VA MEDICA ST. CLOUE	AL CENTER), MN 56303		DRAWING NO.





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DATE:

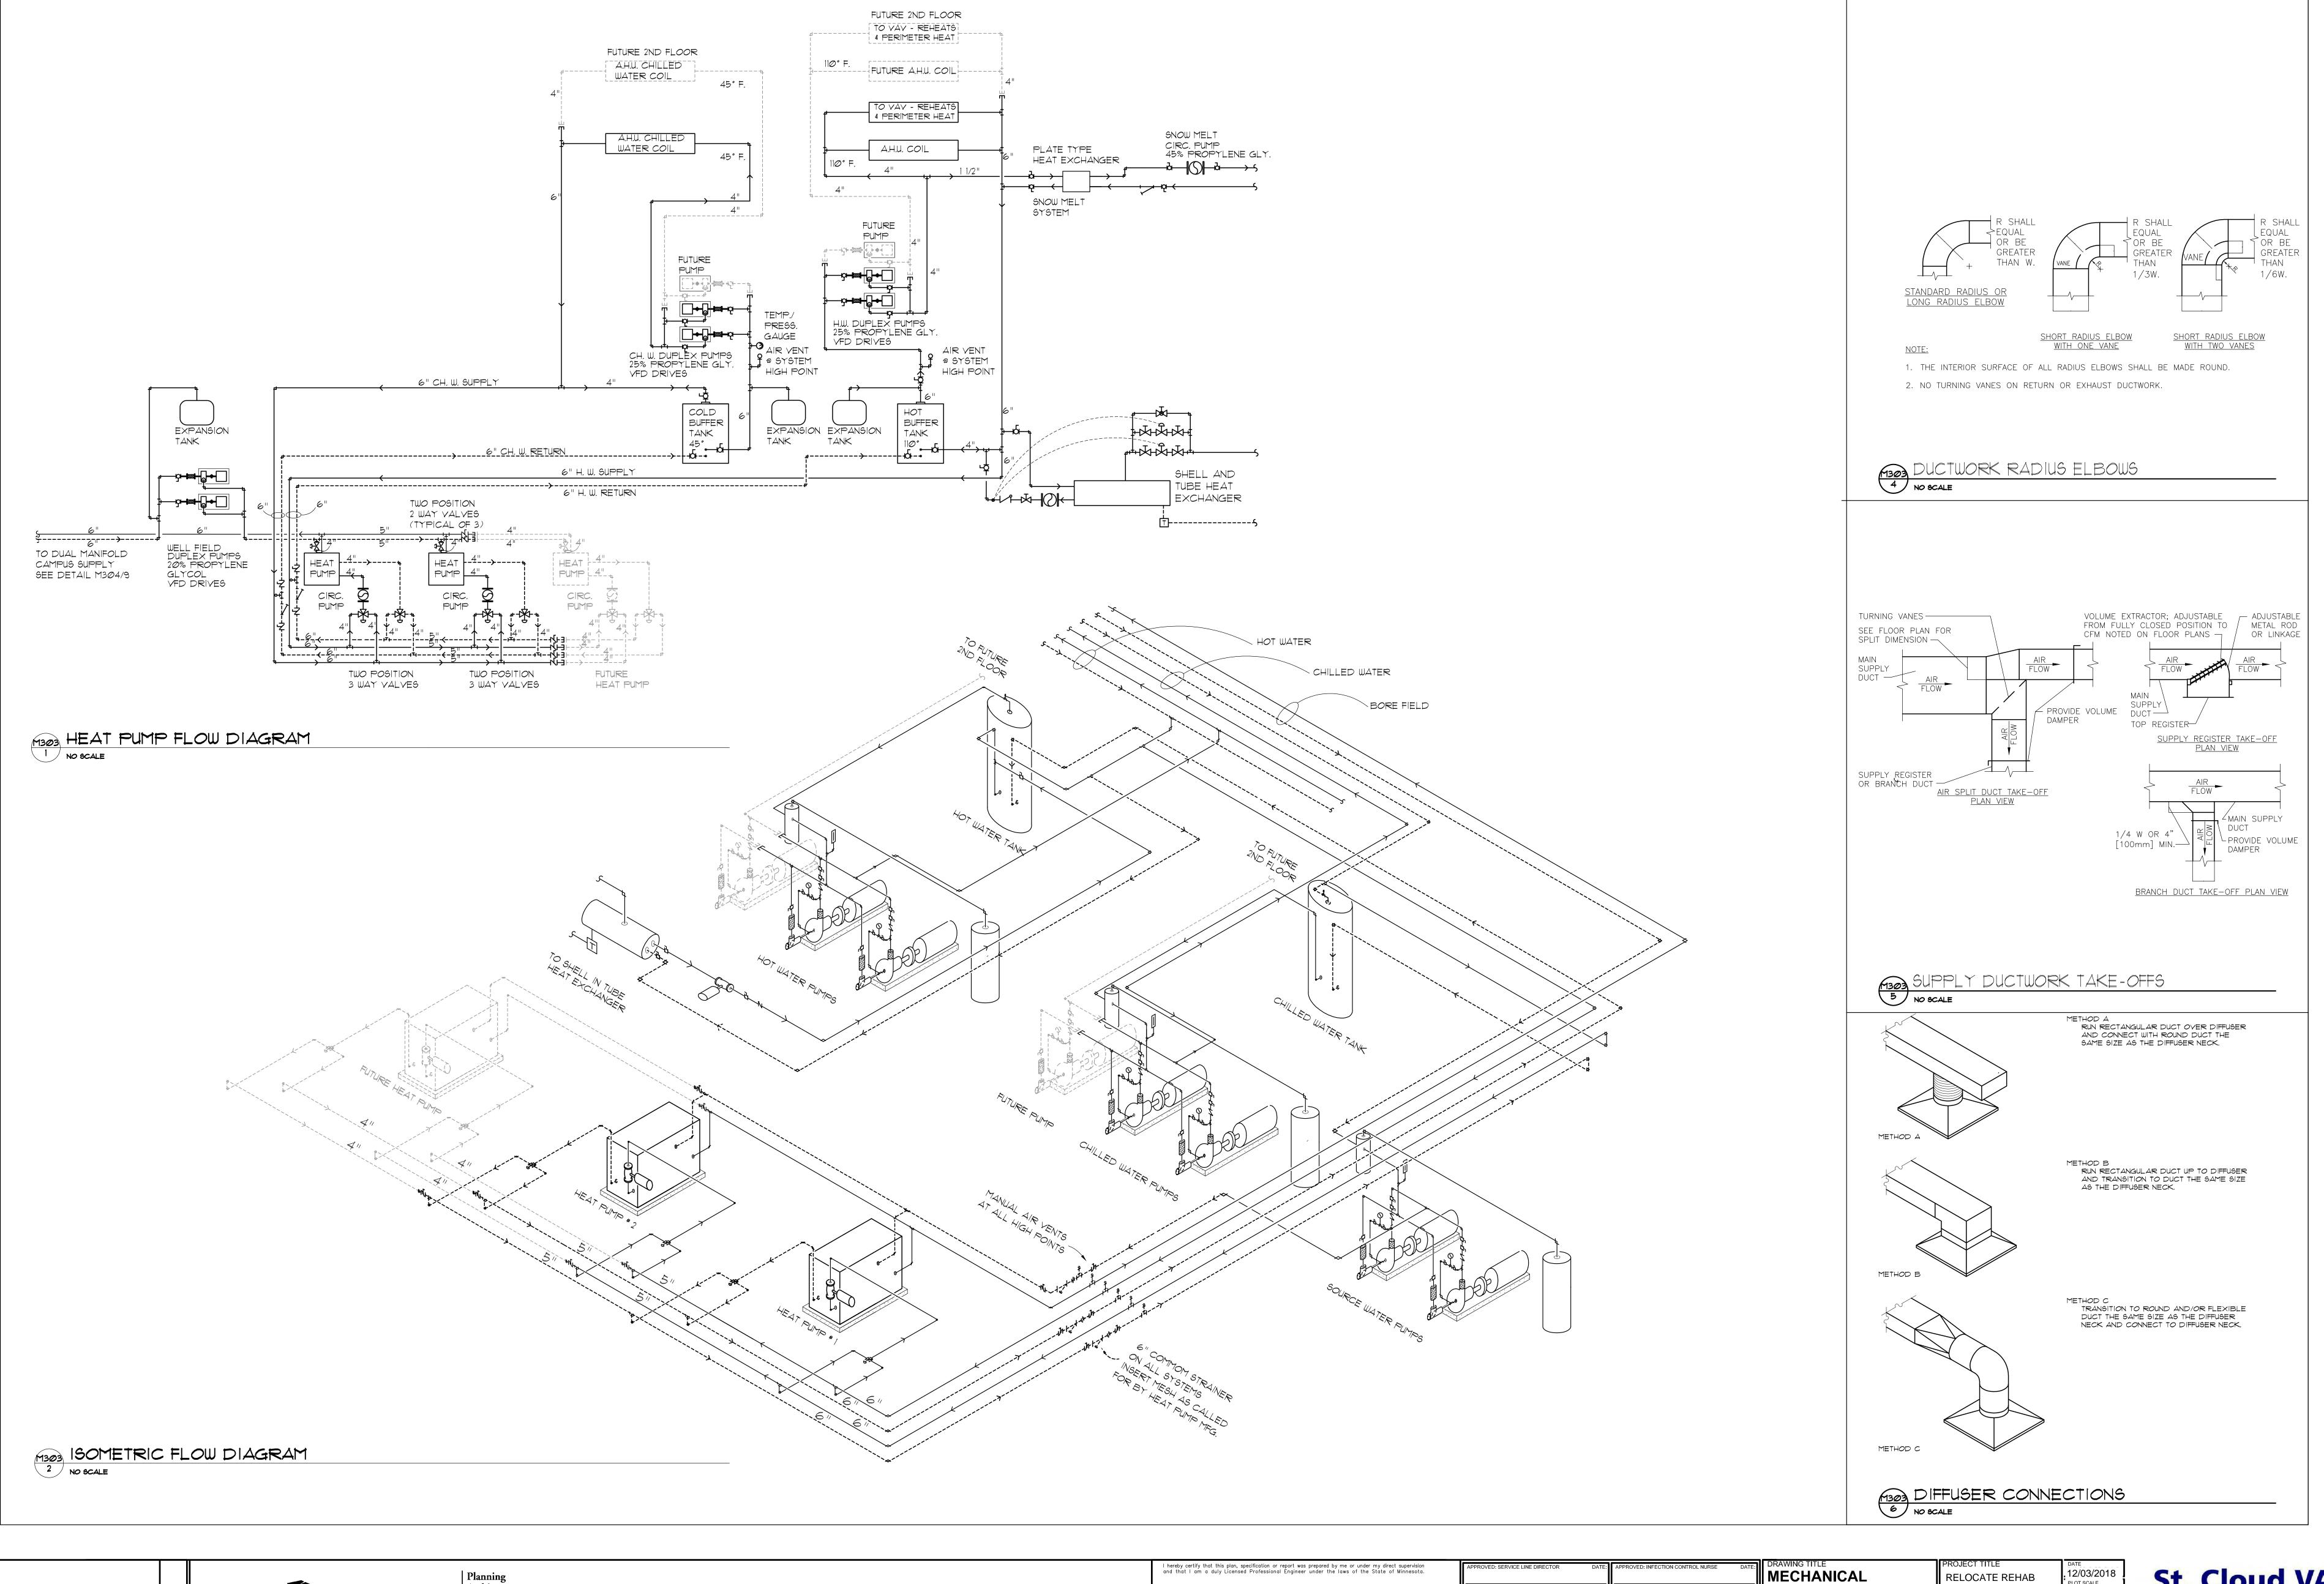ANICAL

RELOCATE REHAB
SERVICES 656-16-277
St. Cloud VA Health Care System

OF STAFF

DATE:

DATE:

NTS

PROJECT TITLE


RELOCATE REHAB
SERVICES 656-16-277
St. Cloud VA Health Care System


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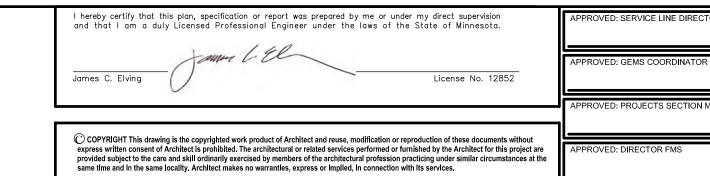
PROJECT NO.








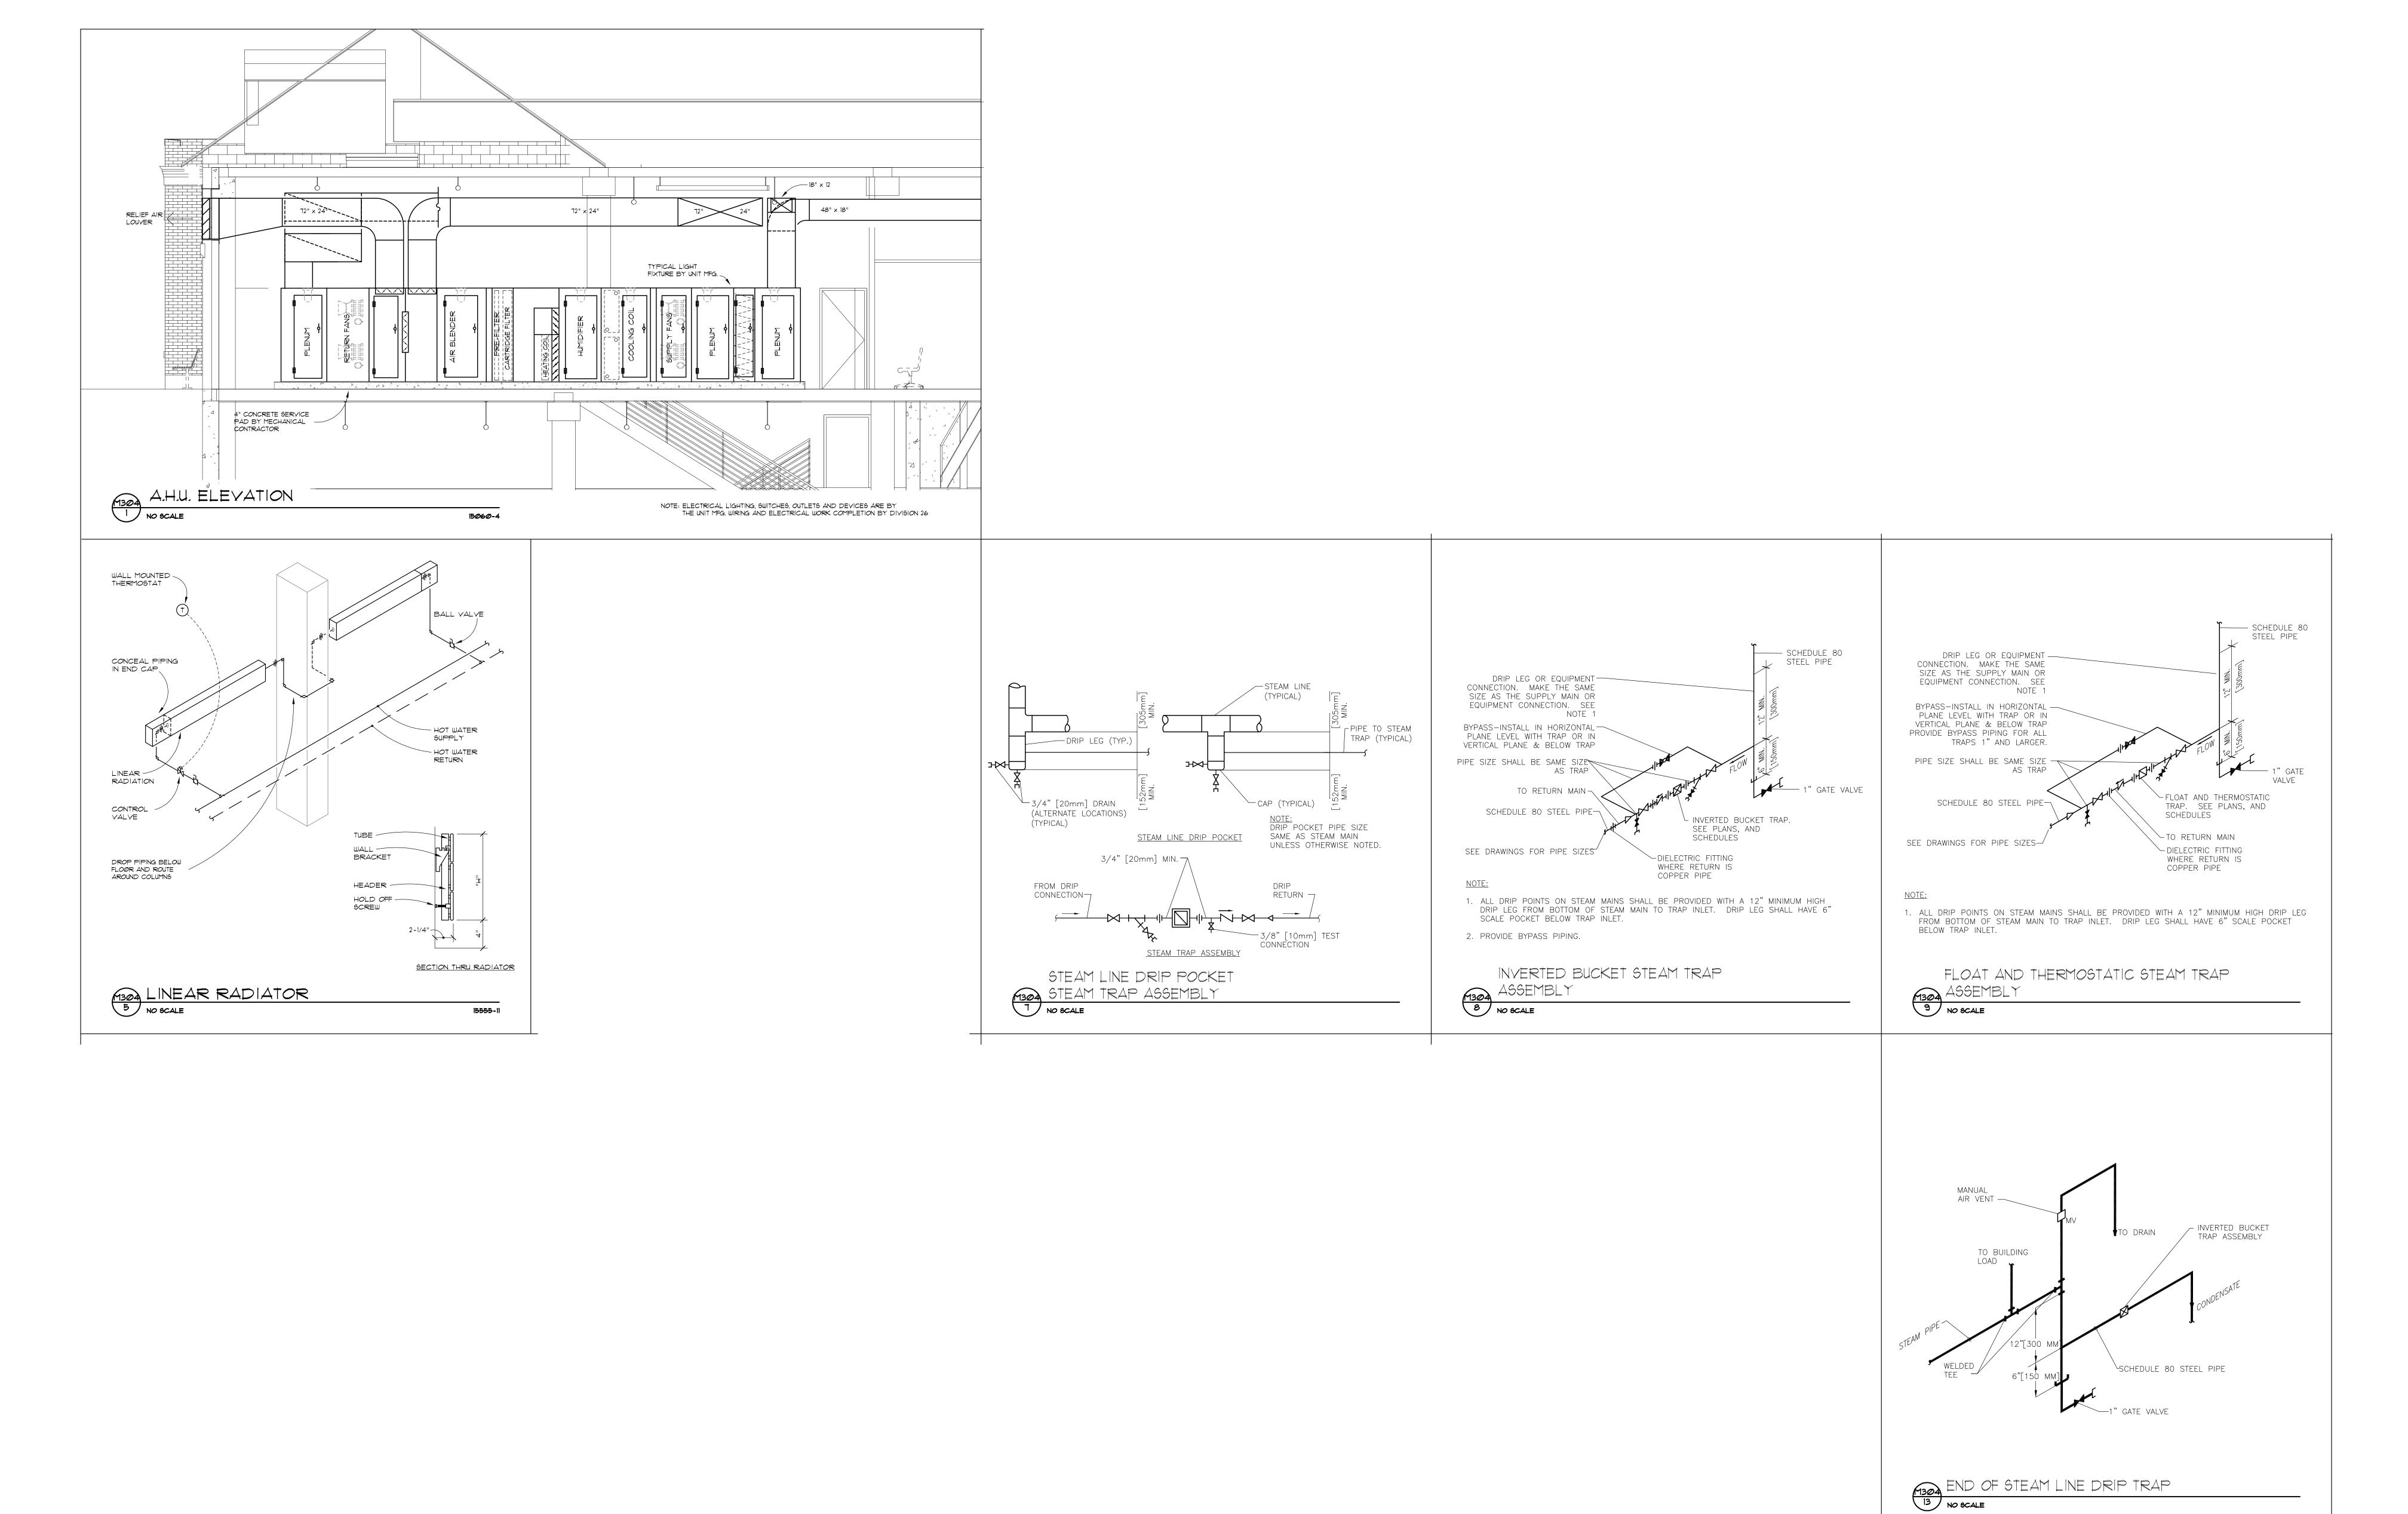

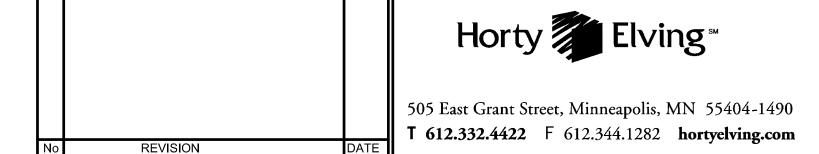

MECHANICAL DETAILS	PROJECT TITLE RELOCATE REHAB SERVICES 656-16-277 St. Cloud VA Health Care System	DATE 12/03/2018 PLOT SCALE NTS PROJECT NO.
APPROVED: CHIEF OF STAFF DATE:	BUILDING NO CHECKED BY DRAWN XXX	
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PROJECT TITLE
RELOCATE REHAB
SERVICES 656-16-277
St. Cloud VA Health Care System

APPROVED: CHIEF OF STAFF

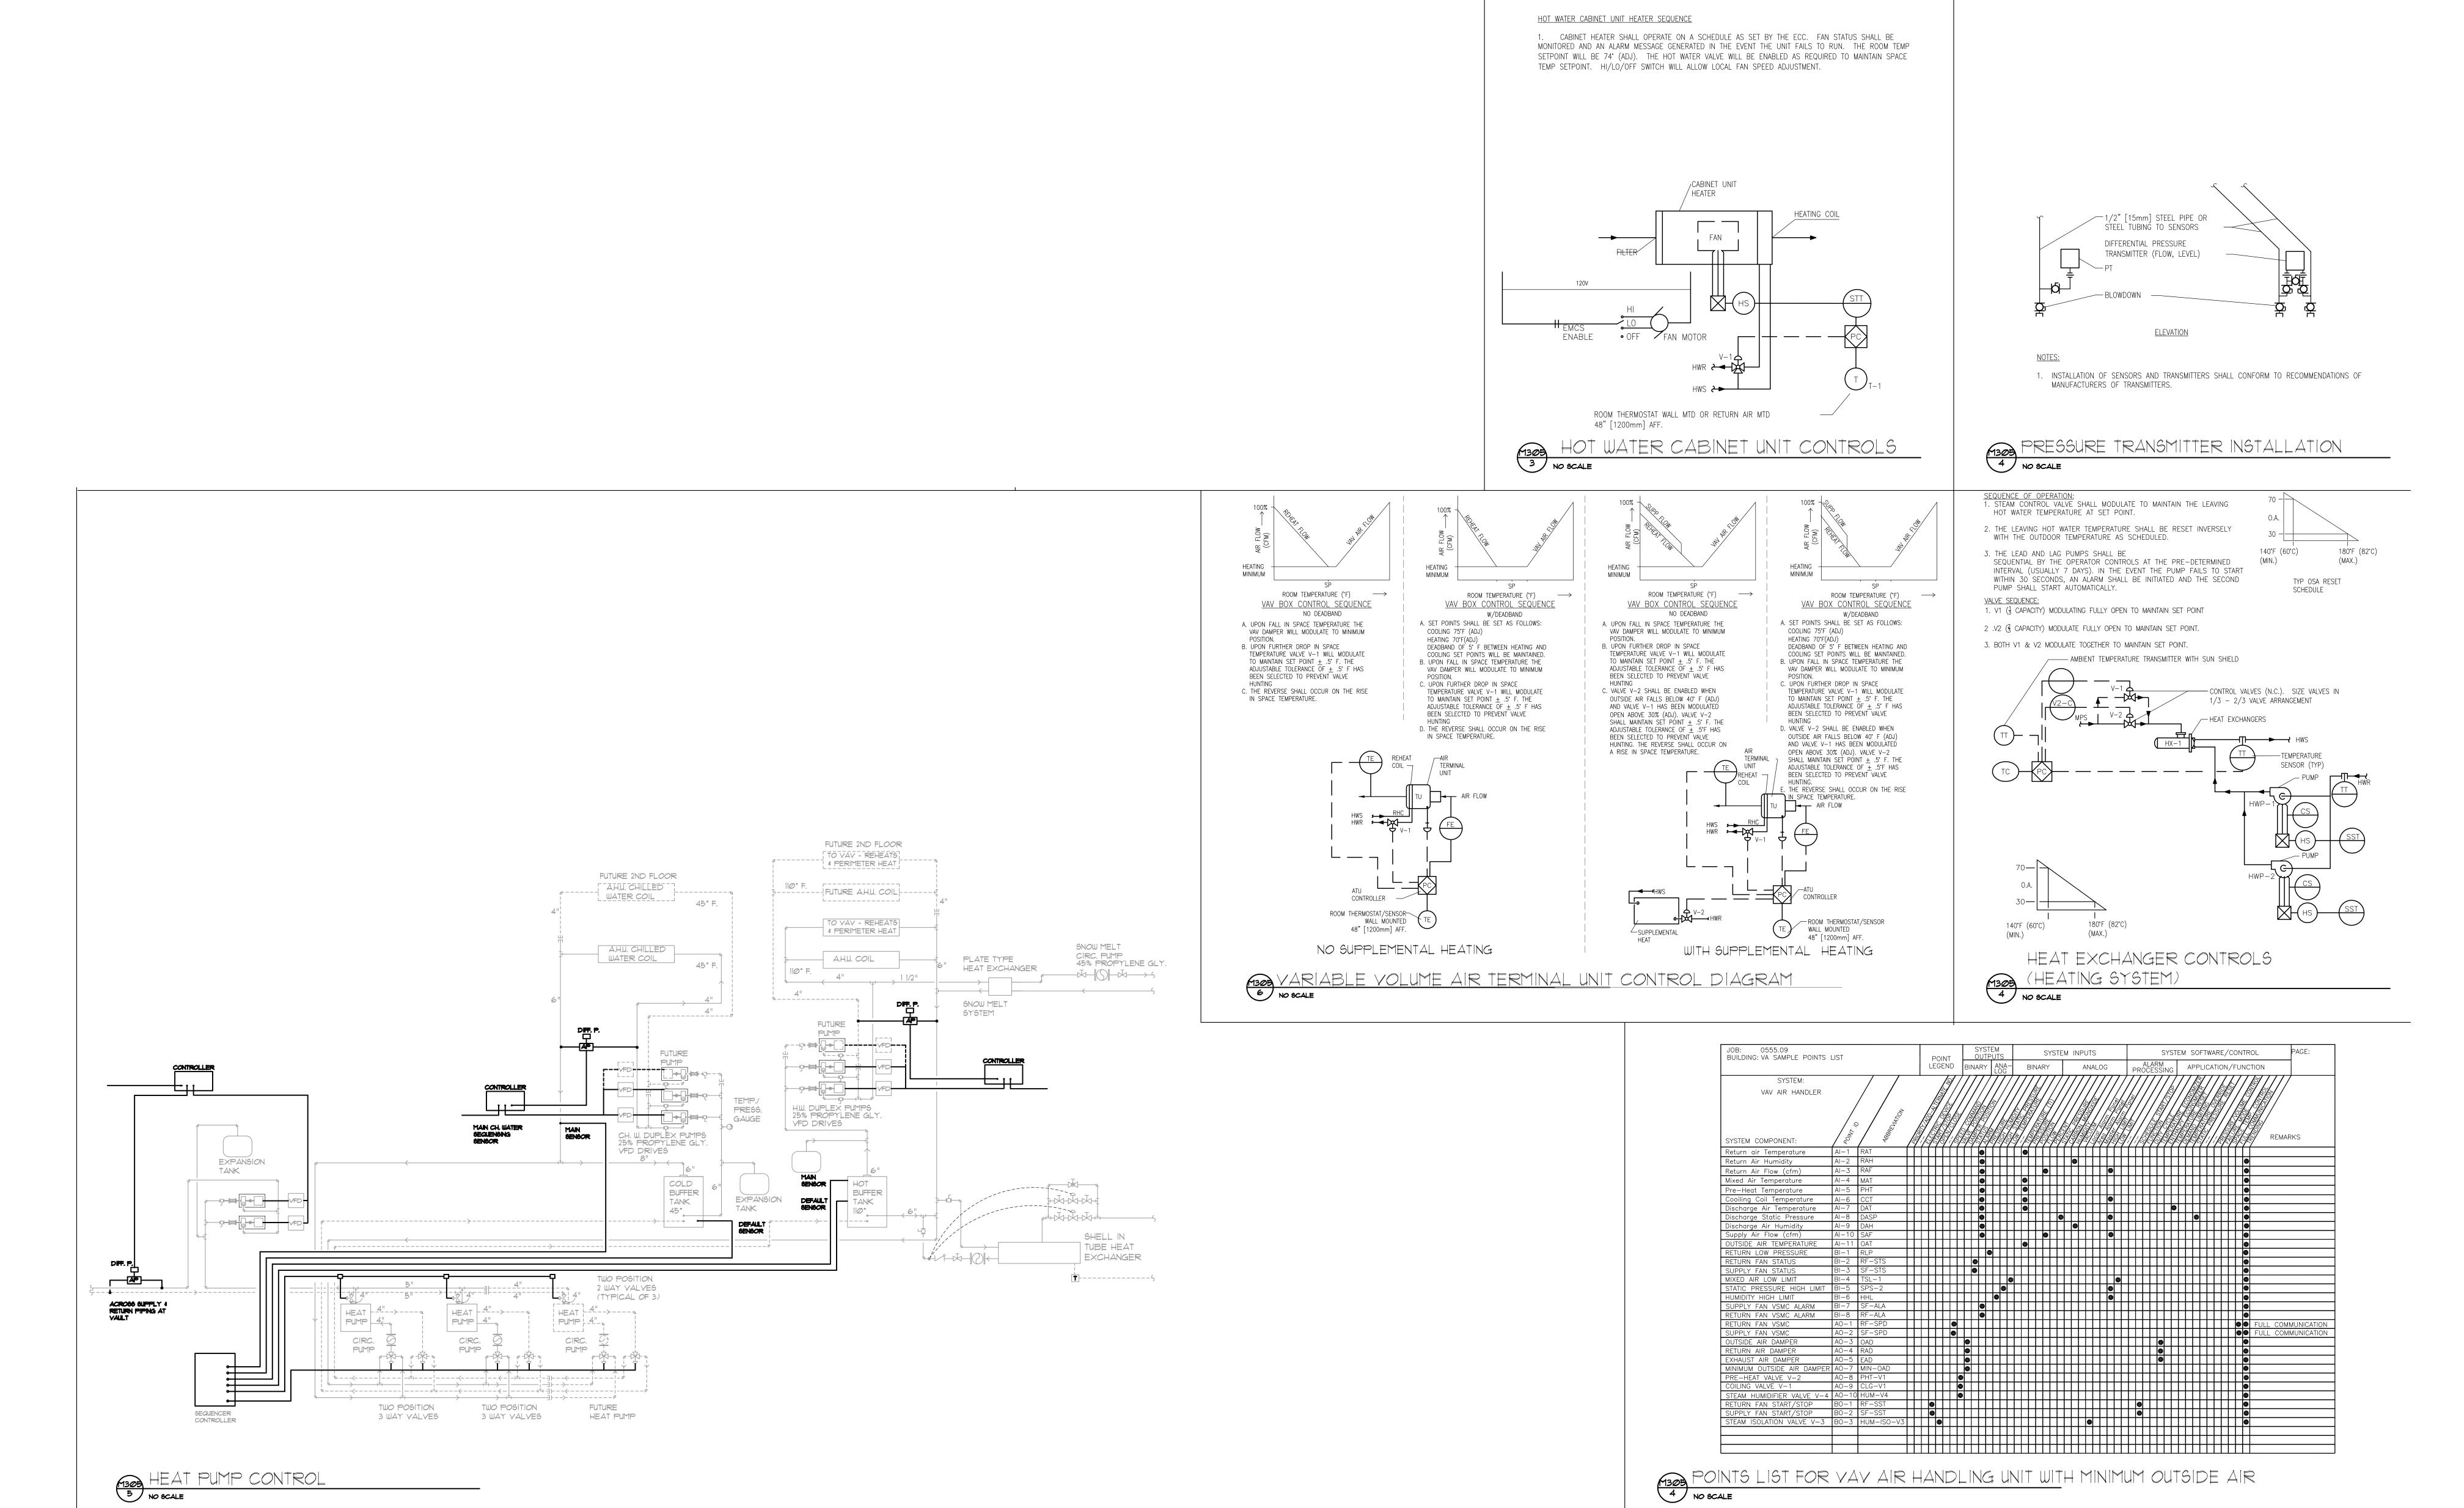DATE:

APPROVED: MEDICAL CENTER DIRECTOR

DATE:

DATE:

LOCATION
VA MEDICAL CENTER
ST. CLOUD, MN 56303

DATE:


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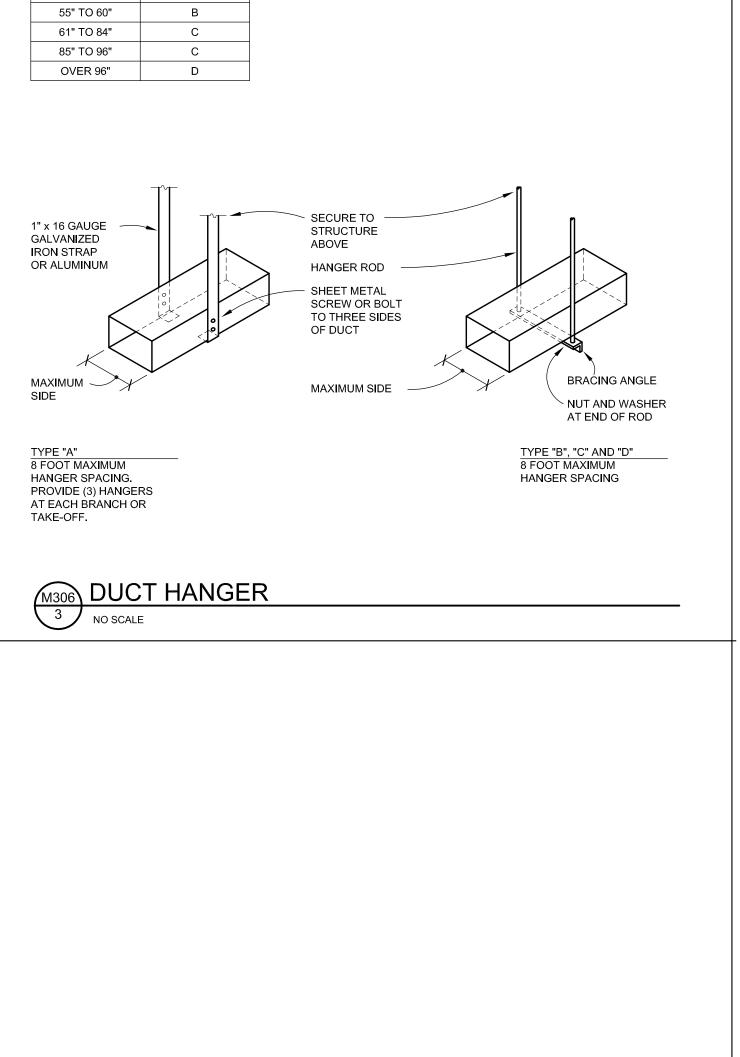
12/03/2018
PLOT SCALE
NTS
PROJECT NO.

DRAWN
XXX

DRAWING NO.
M305





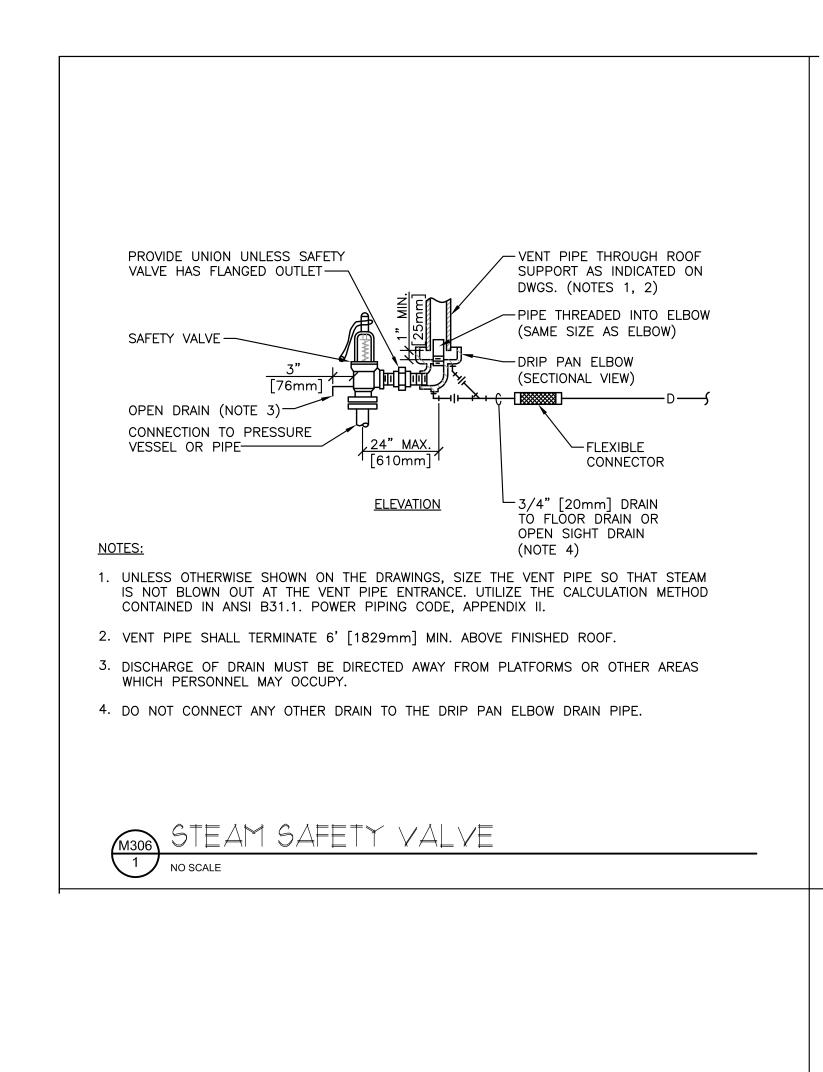

HANGER SCHEDULE

DIAMETER

3/8"

HANGER TYPE

"A"

BRACING ANGLE

1/8" L

3/16" L

1/4" L

DUCT SCHEDULE

HANGER

A/B

DIMENSION


UP TO 12"


13" TO 18"

19" TO 30"

31" TO 42"

43" TO 54"

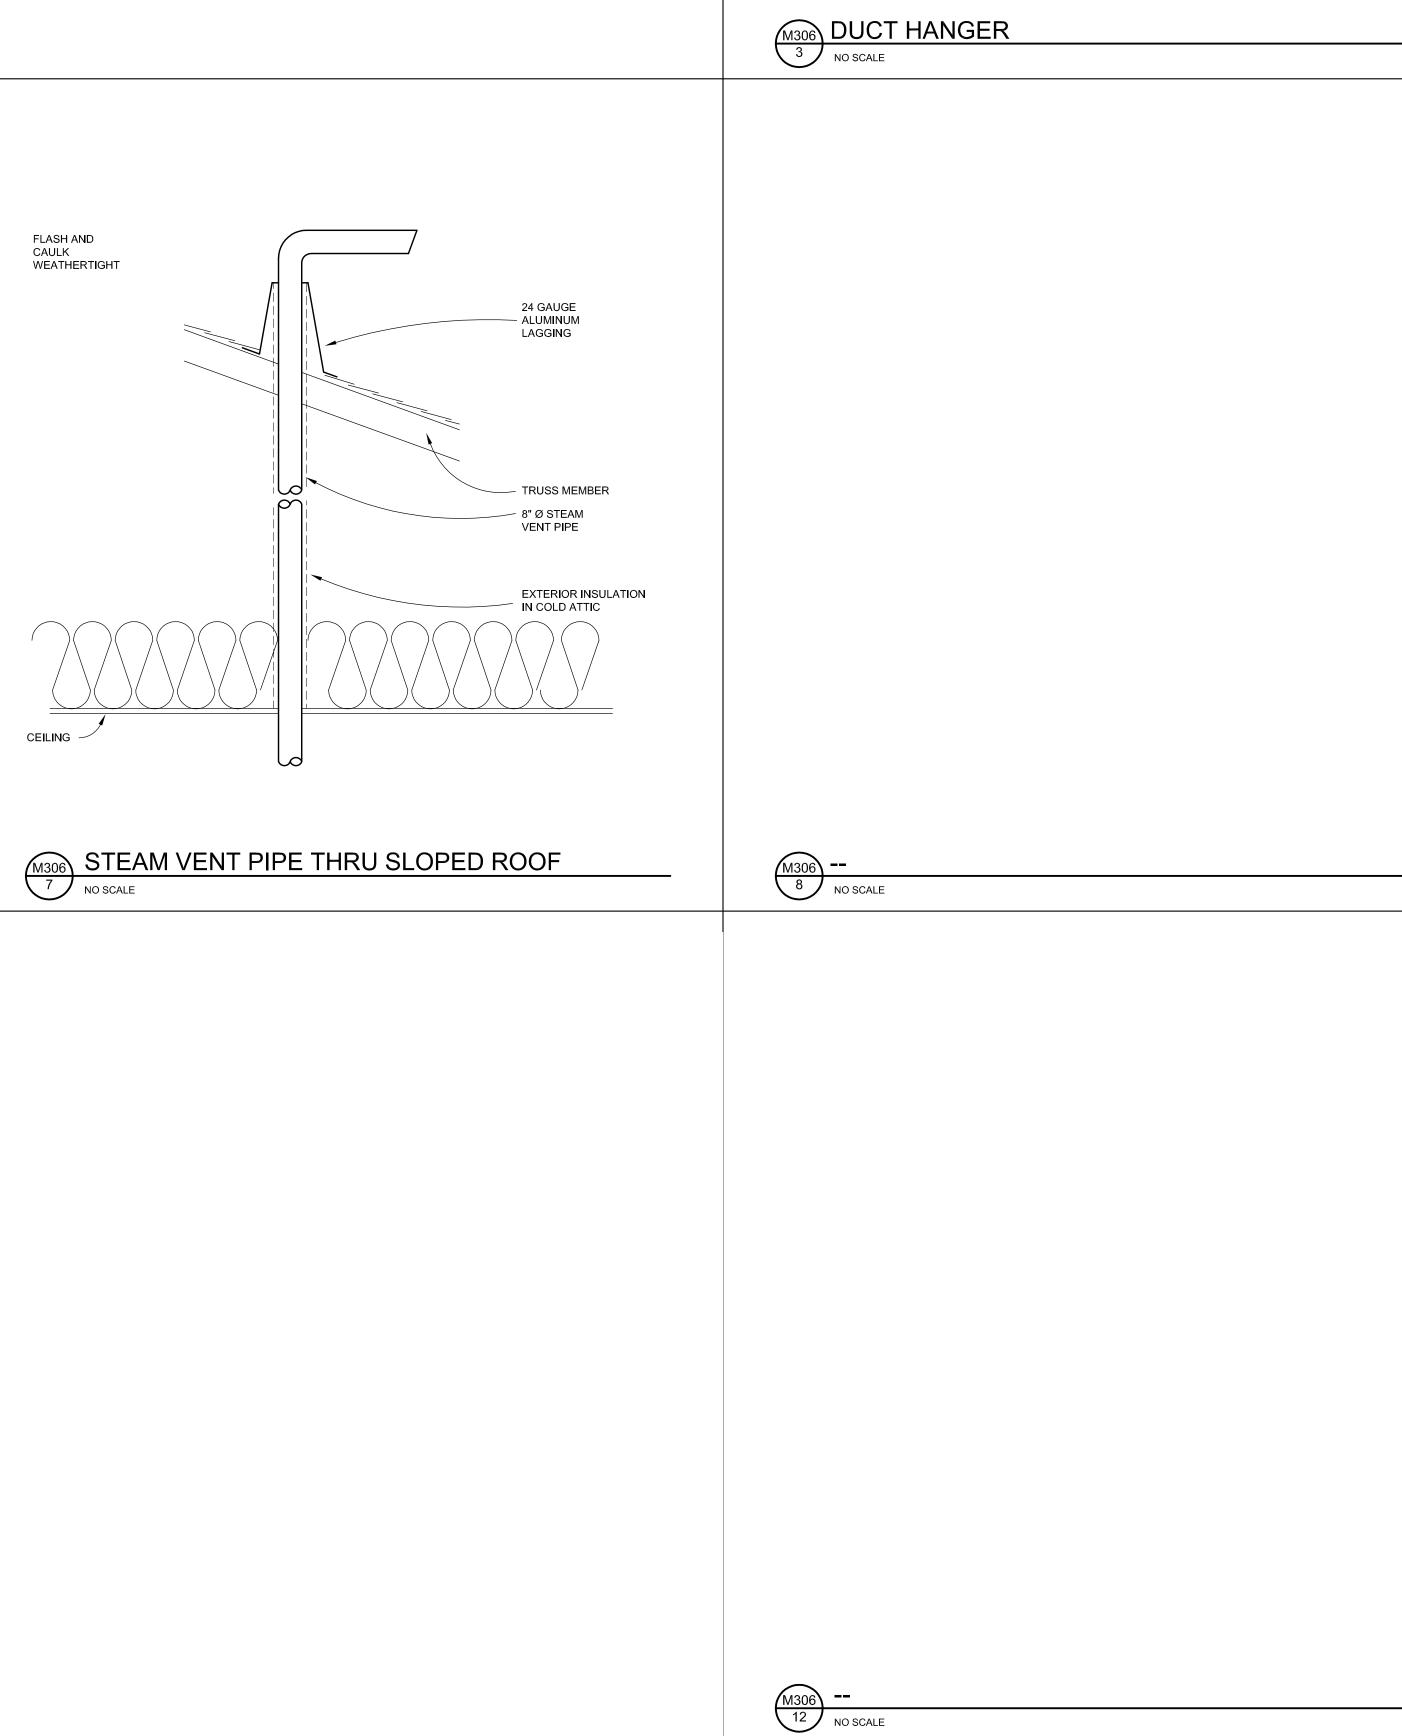

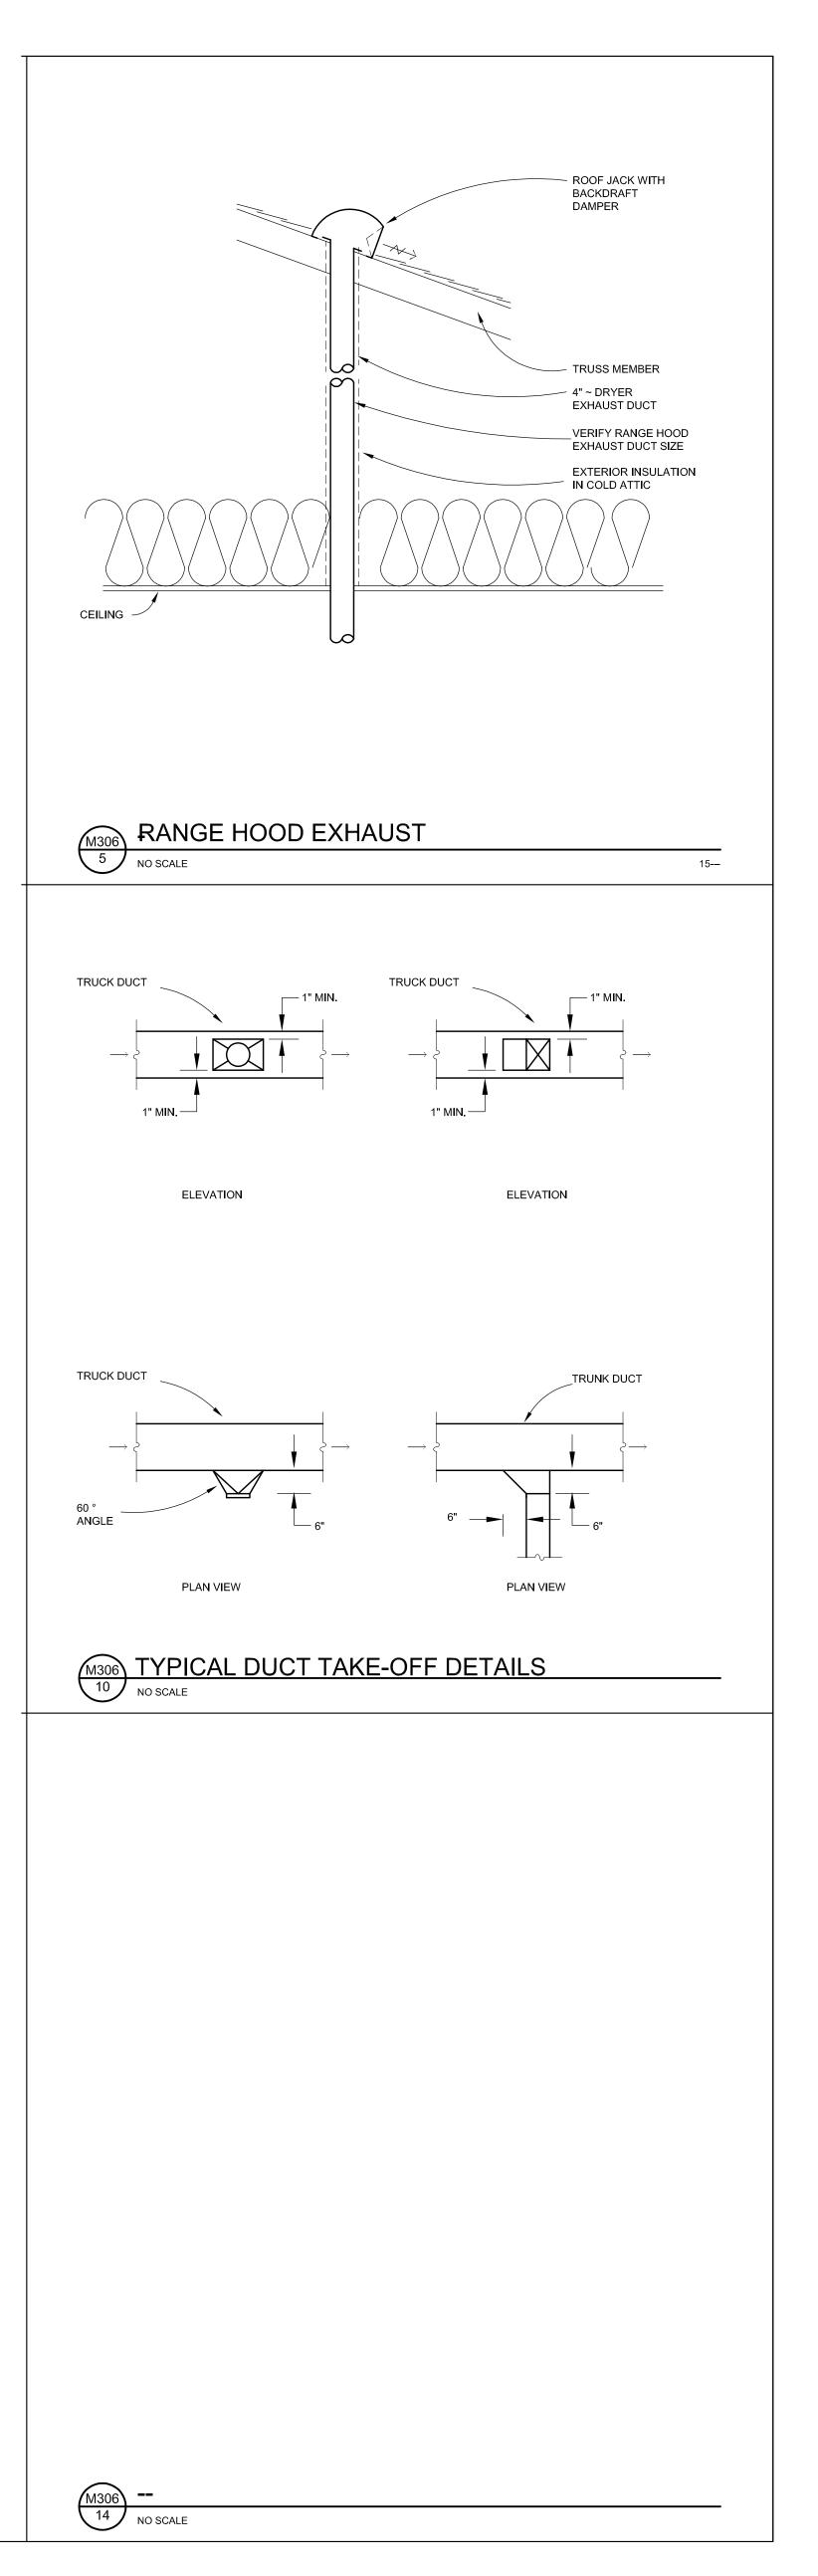



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M306 --13 NO SCALE

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	APPROVED: GEMS COORDINATOR	DATE:	APPROVED: PATIENT SAFETY	DATE:	DI
	APPROVED: PROJECTS SECTION MANAGER	DATE:	APPROVED: CHIEF OF POLICE	DATE:	APPR
e 1e	APPROVED: DIRECTOR FMS	DATE:	APPROVED: SAFETY MANAGER	DATE:	APPR

DRAWING TITLE MECHANICAL DETAILS		PROJECT T RELOCA SERVICE St. Cloud VA	TE REHA ES 656-16	6-277	DATE 12/03/2018 PLOT SCALE NTS PROJECT NO.
APPROVED: CHIEF OF STAFF DA	TE:	BUILDING No	CHECKED BY	DRAWN XXX	
APPROVED: MEDICAL CENTER DIRECTOR DA	TE:	LOCATION VA MEDICA ST. CLOUD	L CENTER		DRAWING NO. M306



AIR HANDLING UNIT SCHEDUL	
UNIT NUMBER	A.H.U. # 1
LOCATION	MECH. 132
SERVES	ENTIRE BUILDING
MODEL NUMBER	CAH050GDGC
SUPPLY FAN	36 1/2" AIRFOIL
CFM	20,840 CFM
TOTAL STATIC PRESSURE	4 1/2"
H.P.	25 H.P.
R.P.M.	1401
VOLTAGE	480/60/3
FILTER BOX	2" PRE-FILTER
	DISCHARGE FILTER
RETURN FAN	40 1/4" AIRFOIL
H.P.	15 H.P.
R.P.M.	1264
HEATING COIL	20° AIR TEMP. RISE
	90 G.P.M. HOT WATER
COOLING COIL	CH. WATER - 175 G.P.M
NOTES	80°/67° TO 54.3°/53.5°
	105° F. M.W.T.
	AIR BLENDER
	STEAM HUMIDIFIER

HEAT EXCHANGERS	,	
SYSTEM	HYDRONIC HEATING	SNOW MELTING
LOCATION	MECH.001	MECH.001
LENGTH	6'-0"	PLATE TYPE
DIAMETER	14"	
MODEL NUMBER	SU-146-2	
PRIMARY MEDIA	STEAM	25% PROP. GYLCOL
STEAM OR GPM (10 psig)	2980#/HR - 1555" START UP	25 GPM
TEMPERATURE IN/OUT	-	110°/100°
PRESSURE DROP	5'	-5'
SECONDARY PRODUCT	25% PROP. GYLCOL	45 % PROP. GLYCOL
GPM	320 GPM	25 GPM
TEMPERATURE IN/OUT	110°/120Ø	95°/105°
PRESSURE DROP	5'	5'

	3	3
(SIZE HEAT EXCHANGE	R FOR FUTURE LOAD

HEAT PUMP SC	HEDULE		
UNIT NUMBER	1	2	······································
RATING	70 TONS	70 TONS	7g.TONS
WELL FIELD G.P.M.	210 G.P.M.	210 G.P.M.	210.G.P.M
WELL FIELD P.D.	5'	5'	
SYSTEM G.P.M.	210 G.P.M.	210 G.P.M.	210 G.P.M
SYSTEM P.D.	4'	4'	4'
HEATING OUTPUT	836 MBH @ MAX. 70 KW	836 MBH @ MAX. 70 KW	836.WBH @ WAX70.KW
	(3.5) COP MIN.	(3.5) COP MIN.	(3.5).COP.MM
COOLING OUTPUT	70 TONS @ 45° F. (14.0) E.E.R. MIN.	70 TONS @ 45° F. (14.0) E.E.R. MIN.	70 TONS @ 46° F (14:0) E.E.R. MIN

POWER ROOF	VENTILATOR SCHED	ULE	
PRV NUMBER	P.R.V. # 1	P.R.V. # 2	PROP. FAN
SYSTEM	GEN EXHAUST	MECH. ROOM 001	CRAWL SPACE VENT.
CFM	1525 CFM	2000 CFM	2500 CFM
S.P.	1 1/4"	3/4"	3/4"
H.P.	1/2 H.P.	1/2 H.P.	1/4 H.P.
CURRENT	110/60/1	110/60/1	110/60/1
MODEL	161HP-5	GB-141-5	

UNIT HEATER S	CHEDULE		
UNIT NUMBER	UNIT HEATER # 1	UNIT HEATER # 2	UNIT HEATER #3
LOCATION	CRAWL SPACE	CRAWL SPACE	MECH ROOM 001
MODE	HOT WATER	HOT WATER	HOT WATER
втин	50,000	50,000	50,000
CFM	1000	1000	1000
RPM	1150	1150	1150
H.P.	1/12	1/12	1/12
CURRENT	110/60/1	110/60/1	110/60/1
MODEL	HORIZONTAL	HORIZONTAL	HORIZONTAL
NOTES	105° M.W.T.	105° M.W.T.	105° M.W.T.

HYDRONIC ACCESSORIES				
SYSTEM	WELL FIELD	HYDRONIC HEATING	CHILLED WATER	SNOW MELT (ALT.)
EXPANSION TANK NUMBER	1	1	1	1
EXPANSION TANK SIZE	100 GALLON	200 GALLON	100 GALLON	`15
TANK FITTING	YES	YES	YES	YES
AIR PURGE	R-6	R-6	R-6	R-2
TANK DRAIN	YES	YES	YES	YES
GAUGE GLASS SETS	_			
RELIEF VALVES	1	1	1	1
RELIEF VALVE PRESSURE SETTING	30 #	30 #	30 #	30 #
COLD WATER SUPPLY	3/4"	3/4"	3/4"	3/4"

CABINET UNIT H	EATER SCHEDULE			
UNIT NUMBER	C.U.H. # 1	C.U.H. # 2	C.U.H. #3	C.U.H. # 4
LOCATION	VEST. 101	VEST. 137	CORR. 104	CORR. 176
MODE	HOT WATER	HOT WATER	HOT WATER	HOT WATER
BTUH	40,000 BTUH	40,000 BTUH	60,000 BTUH	50,000 BTUH
CFM	600 CFM	600 CFM	800 CFM	750 CFM
RPM	1150	1150	1150	1150
H.P.	1/20	1/20	1/20	1/20
CURRENT	110/60/1	110/60/1	110/60/1	110/60/1
MODEL	CEILING RECESSED	CEILING RECESSED	CEILING RECESSED	CEILING RECESSED
NOTES	105° M.W.T.	105° M.W.T.	105° M.W.T.	105° M.W.T.

CIRCULATING P	UMP SCHEDULE													
PUMP NUMBER	PUMP # 1	PUMP # 2	PUMP # 3	PUMP # 4	FUTURE PUMP:#5	PUMP#6	PUMP # 7	FUTURE PUMP # 8	PUMP # 9	PUMP # 10	FUTURE.PUMP.#.11	PUMP # 12	PUMP # 13	PUMP # 14
LOCATION	MECH. 001	MECH. 001	MECH. 001	MECH. 001	MECH.:001	MECH. 001	MECH. 001	₩ĘCH,:001	MECH. 001	MECH. 001	M₽CH.001	MECH. 001	MECH. 001	MECH. 001
SYSTEM	WELL FIELD	WELL FIELD	HYDRONIC HEATING	HYDRONIC HEATING	·····HYDRONIC HEATING·····	CH. WATER	CH. WATER	CH, WATER	HEAT PUMP	HEAT PUMP	······HEXT.PUMP······	HEAT EXCHANGER	SNOW MELT	CONDENSATE
STYLE	BASE MOUNT	BASE MOUNT	BASE MOUNT	BASE MOUNT	······BASE MOUNT······	BASE MOUNT	BASE MOUNT	········BASE MOUNT······	IN-LINE	IN-LINE	······IN-LINE	IN-LINE	IN-LINE	DUPLEX PUMPS
GPM	660 GPM	660 GPM	310	310	265	175 G.P.M.	175 G.P.M.	175	220 G.P.M.	220 G.P.M.	220 G.A.M	329	25	10 G.P.M.
HEAD	60'	60'	50'	50'	45:	65'	65'	55!	58'	58'	:60:	25'	50'	20 P.S.I.G.
RPM	1750	1750	1750	1750	1750	1750	1750	1750	1750	1750	1750	1750	1750	1750
MEDIA	20% PROPYLENE	20% PROPYLENE	25% PROPYLENE	25% PROPYLENE	25% PROPYLENE	25% PROPYLENE	25% PROPYLENE	25% PROPYLENE	25% PROPYLENE	25% PROPYLENE	25% PROPYLENE	25% PROPYLENE	45% PROPYLENE	COND.
H.P.	15 H.P.	15 H.P.	7 1/2 H.P.	7 1/2 H.P.	·····7.1/2.H.P.	5 H.P.	5 H.P.	5.H.P.	5 H.P.	5 H.P.	5.H.P.	3 H.P.	1 H.P.	2 @ 3/4 H.P.
CURRENT	480/60/3	480/60/3	480/60/3	480/60/3	····· 480/60/3·····	480/60/3	480/60/3	480/60/3	480/60/3	480/60/3	······480/60/3······	480/60/3	480/60/3	480/60/3
MODEL	B & G 1510 - 4BC	B & G 1510 - 4BC	B & G 1510 - 2 1/2 BB	B & G 1510 - 2 1/2 BB	B:&:G:1510:≓3BC	B & G 1510 - 2 BC	B & G 1510 - 2 BC	B.&.G.15102.1/2BB	B & G SERIES 80 - 3x3x9-1/2B	B & G SERIES 80 - 3x3x9-1/2	B B.&.G.SERIES.803X3X9-1/2B	B & G SERIES 80SC - 4x4x7	IN-LINE	COND. SET
NOTES	DUPLEX VAR. FREQ. DRIVE	DUPLEX VAR. FREQ. DRIVE	VARIABLE FREQ. DRIVE	VARIABLE FREQ. DRIVE	VARIAÐLE FREQ: DRIVE	VARIABLE FREQ. DRIVE	VARIABLE FREQ. DRIVE	···VARIAÐLE FREQ: DRIVE···				IN-LINE	B & G SERIES 80 1 1/2x1 1/2x7B	40 GALLON RECEIVER

AUXILIARY HE	ATING UNIT SCHEDUL	.E
LOCATION	175	175
HEATING DEVICE	AIR CURTAIN	AIR CURTAIN
SIZE	1CA2072	1CA2072
втин	60,000 BTUH	60,000 BTUH
GPM	12	12
CONTROL	THERMOSTAT	THERMOSTAT
NOTES	4500 CFM - 78" WIDE TWO MOTORS @ 1/2 H.P.	4500 CFM - 78" WIDE TWO MOTORS @ 1/2 H.P.

NOTE:	105°	F.	MEAN	WATER	TEMP.

SYSTEM	RETURN AIR	RETURN AIR	GENERATOR INTAKE	GENERATOR EXHAUST
CFM	16,600 CFM	2175 CFM	77,500 CFM	73,500 CFM
OCTAVE BAND CENTER FREQUENCY (HZ)	FOURTH	FOURTH	FOURTH	FOURTH
MINIMUM DYNAMIC INSERTION LOSS (DB)	11 dba	11 dba	27 dba	27 dba
FACE VELOCITY FPM	1383 F.P.M.	750 F.P.M.	480 F.P.M.	480 F.P.M.
APPROXIMATE SIZE	72" x 24"	30" x 14"	10' x 15'	10' x 15'
LENGTH	5'-0"	3'-0"	3'-0"	3'-0"

JMIDIFIER SCH	HEDULE	FUEL OIL TANK	
OM NUMBER	A.H.U. # 1	TYPE	BELOW GRADE
M	20,000 CFM	CAPACITY	5000 GALLON
TEAM	150 #/HR	APPROX. DIMENSIONS	15' x 7'
HUMIDITY	20 %	MATERIAL	DOUBLE WALLED
М			ASTM A36 STEEL
OBE LENGTH		NOTES	
TES	VERIFY LENGTH WITH UNIT MFG.		

STEEL FLAT PLATE BASEBOARD		
TYPE	LINEAR RADIATION	
CAPACITY	250 BTUH/ LIN. FT.	
LENGHT	SEE PLANS	
SIZE	SEE SPECIFICATIONS	
NOTES	105° F. M.W.T.	

VARIABLE AIR VOLUME SCHEDULE

102 & 103

105 107 & 108

110 & 112

111 113 & 114

115, 126, 127

121

122

123, 124, 125, 139

106, 128, 129, 130

131, 132, 133, 142

135

138

145

146, 147, 148, 150

151, 152, 153

155, 156

160,165

161, 162

163, 164

168 175 & 176

D-3 H-L-H

F-3 H-L-H

F-3 H-L-H

C-3 H-L-H

B-3 H-L-H

B-3 H-L-H

B-3 H-L-H

B-3 H-L-H

C-3 H-L-H

D-3 H-L-H

E-3 H-L-H

B-3 H-L-H

B-3 H-L-H

C-3 H-L-H

B-1

F-3 H-L-H

NOTE: 105° F. MEAN WATER TEMP.

REHEAT BTUH

22,500

30,000

11,500

66,000

10,700

17,600

12,400

13,900

13,100

12,100

18,100

7,800

5400

13,700

14,200

25,000

1700

CFM MINIMUM

200

215

240

115

110

210

170

CFM MAXIMUM

1000

1200

2000

2000

1045

350

325

500

850

520

1200

REVISION

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505 East Grant Street, Minneapolis, MN 55404-1490 **T 612.332.4422** F 612.344.1282 hortyelving.com

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PPROVED: SERVICE LINE DIRECTOR	DATE:	APPROVED: INFECTION CONTROL NURSE	DATE:	MECHANI
PPROVED: GEMS COORDINATOR	DATE:	APPROVED: PATIENT SAFETY	DATE:	SCHEDUL
PPROVED: PROJECTS SECTION MANAGER	DATE:	APPROVED: CHIEF OF POLICE	DATE:	APPROVED: CHIEF OF STAFF
PPROVED: DIRECTOR FMS	DATE:	APPROVED: SAFETY MANAGER	DATE:	APPROVED: MEDICAL CENTE

DRAWING TITLE MECHANICAL SCHEDULES	PROJECT TITLE RELOCATE REHAB SERVICES 656-16-277	DATE 12/03/2018 PLOT SCALE NTS
	St. Cloud VA Health Care System	PROJECT NO.
APPROVED: CHIEF OF STAFF DATE:	BUILDING No CHECKED BY DRAWN XXX	
APPROVED: MEDICAL CENTER DIRECTOR DATE:	LOCATION VA MEDICAL CENTER ST. CLOUD, MN 56303	DRAWING NO. M307



VAV

4.7

6.0

2.3

11.9

1.9

1.3

2.2

3.5

1.7

2.8

2.5

4.0

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40°

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30°

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30°